09-18-2015 LETTING ITEM 065

FOR INDEX OF SHEETS, SEE SHEET NO. 2

FOR LIST OF STATE AND LOCAL STANDARDS, SEE SHEET NO. 2

PROJECT LOCATED WITHIN THE VILLAGE OF BURR RIDGE

TRAFFIC DATA - GERMAN CHURCH ROAD POSTED SPEED: 40 MPH CURRENT ADT (2010): 4.400 VPD **FUNCTIONAL CLASS: MINOR ARTERIAL** 

DESIGN DESIGNATION SIDEWALK


STATE OF ILLINOIS **DEPARTMENT OF TRANSPORTATION DIVISION OF HIGHWAYS** 

# PLANS FOR PROPOSED FEDERAL AID PROJECT

**FAU ROUTE 1552 (GERMAN CHURCH ROAD)** S COUNTY LINE ROAD TO GREYSTONE COURT PEDESTRIAN IMPROVEMENTS PROJECT SECTION NO.: 14-00050-00-SW PROJECT NO.: M-4003 (422) VILLAGE OF BURR RIDGE COOK COUNTY

JOB NO.: C-91-139-15

#### R 12E 3RD PRINCIPAL MERIDIAN

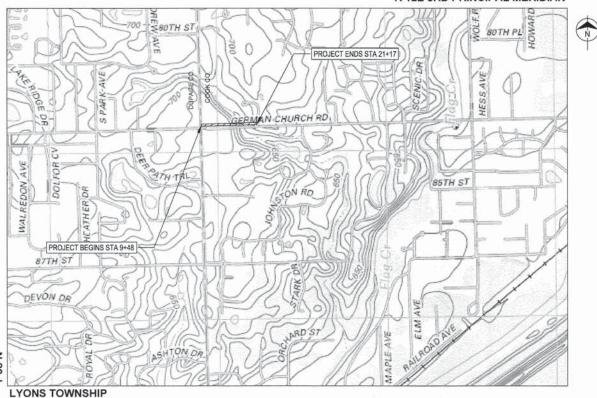

**LOCATION MAP** 

LYONS TOWNSHIP RANGE: 12E

GROSS LENGTH OF PROJECT = 1200 FEET (0.23 MILES) NET LENGTH OF PROJECT = 1200 FEET (0.23 MILES)



Releasing for Bid Based on Limited

ANTHONY J. BRYANT, P.E. FXP DATE: 11/30/2015



EXP. DATE: 11/30/2016 SHEET NO. 17 PRINTED BY THE AUTHORITY

OF THE STATE OF ILLINOIS

FULL SIZE PLANS HAVE BEEN PREPARED USING STANDARD ENGINEERING SCALES, REDUCED SIZED PLANS WILL NOT CONFORM TO STANDARD SCALES, IN MAKING MEASUREMENTS ON REDUCED PLANS, THE ABOVE SCALES MAY BE USED. JOINT UTILITY LOCATION INFORMATION FOR EXCAVATION 1-800-892-0123

**CONTRACT NO. 61B38** 

@bibiol / B. CGMOALBON

COOK

FEDERAL RD. DIST. NO. | ILLINOIS | CONTRACT NO. 61B38



APRIL 1, 2015

1552 14-00050-00-SW

#### INDEX OF SHEETS

SHEET TYPE / TITLE COVER SHEET INDEX OF SHEETS, STANDARDS, AND GENERAL NOTES SUMMARY OF QUANTITIES TYPICAL SECTIONS SCHEDULE OF QUANTITIES ALIGNMENT, TIES AND BENCHMARKS TO REMOVAL PLAN TO PROPOSED PLAN AND PROFILE MAINTENANCE OF TRAFFIC PLANS EROSION AND SEDIMENT CONTROL PLAN 14 LANDSCAPING PLAN 15 TO DETAILS DISTRICT 1 STANDARDS 18 TO 20 21 TO CROSS SECTIONS

DETRICAS

#### DISTRICT 1 STANDARDS

RAWING	TITI.
UMBER	31.11

(17A TO 17B

TC-10 TRAFFIC CONTROL AND PROTECTION FOR SIDE ROADS, INTERSECTIONS, AND DRIVEWAYS TC-13 DISTRICT ONE TYPICAL PAVEMENT MARKINGS

TC-22 ARTERIAL ROAD INFORMATION SIGN

#### HIGHWAY STANDARDS

DRAWING	TITLE
NUMBER	TITLE

424001-08 PERPENDICULAR CURB RAMPS

701301-04 URBAN LANE CLOSURE, 2L, 2W, UNDIVIDED

701501-06 LANE CLOSURE 2L, 2W, SHORT TIME OPERATIONS 701701-09 URBAN LANE CLOSURE, MULTILANE INTERSECTION

701801-05 SIDEWALK, CORNER, OR CROSSWALK CLOSURE

701901-04 TRAFFIC CONTROL DEVICES

701006-05 OFF-ROAD OPERATIONS, 2L, 2W

701311-03 LANE CLOSURE 2L, 2W MOVING OPERATIONS - DAY ONLY

#### GENERAL NOTES:

- THE VILLAGE OF BURR RIDGE SHALL BE NOTIFIED AT LEAST SEVEN (7) WORKING DAYS PRIOR TO COMMENCEMENT OF CONSTRUCTION AND 72 HOURS PRIOR TO DEMOLITION WORK.
- 2. PRIOR TO COMMENCEMENT OF ANY EXCAVATION. THE CONTRACTOR SHALL CALL "JULIE" AT 1-800-892-0123 FOR FIELD LOCATIONS OF BURIED ELECTRIC, TELEPHONE, GAS, WATER, SEWER, AND CABLE TELEVISION FACILITIES (48 HOURS NOTIFICATION REQUIRED).
- THE CONTRACTOR IS RESPONSIBLE FOR CONTACTING ALL UTILITY OWNERS INCLUDING THE VILLAGE SO THAT THEIR FACILITIES MAY BE LOCATED AND ADJUSTED OR MOVED PRIOR TO COMMENCEMENT OF ANY SUBSURFACE WORK. THE CONTRACTOR SHALL BE RESPONSIBLE FOR DETERMINING THE EXACT LOCA ION OF THESE UTILITY LINES IN THE FIELD AND THE PROTECTION OF THEM FROM DAMAGE DUE TO CONSTRUCTION
- THE LOCATION OF PUBLIC OR PRIVATE UTILITIES SHOWN ON THE PLANS ARE APPROXIMATE AND THE VILLAGE AND ENGINEER DOES NOT GUARANTEE THEIR ACCURACY, THE CONTRACTOR SHALL BE RESPONSIBLE FOR THE PROTECTION OF ALL ABOVE AND BELOW GROUND UTILITIES EVEN THOUGH THEY MAY NOT BE SHOWN ON THE PLAN. ANY UTILITY THAT IS DAMAGED DURING CONSTRUCTION SHALL BE REPAIRED OR REPLACED TO THE SATISFACTION OF THE ENGINEER. THIS WORK SHALL BE AT THE EXPENSE OF THE CONTRACTOR.
- 5. IF EXISTING UTILITY LINES OF ANY NATURE ARE ENCOUNTERED WHICH CONFLICT WITH NEW CONSTRUCTION. THE CONTRACTOR SHALL NOTIFY THE OWNER'S REPRESENTATIVE IMMEDIATELY SO THAT THE CONFLICT MAY BE RESOLVED.
- THE CONTRACTOR SHALL MAKE ARRANGEMENT FOR THE PROPER BRACING, SHORING, AND OTHER REQUIRED PROTECTION OF ALL UTILITIES PRIOR TO CONSTRUCTION. THE CONTRACTOR SHALL BE RESPONSIBLE FOR ANY DAMAGE TO THE UTILITIES AND ASSOCIATED STRUCTURES AND SHALL MAKE REPAIRS AS NECESSARY TO THE SATISFACTION OF THE UTILITY OWNER.
- EXCEPT WHERE MODIFIED BY THE CONTRACT DOCUMENTS, ALL WORK PROPOSED HEREIN SHALL BE IN ACCORDANCE WITH THE FOLLOWING SPECIFICATIONS, WHICH ARE HEREBY MADE A PART HEREOF:
  - (A) "STANDARD SPECIFICATIONS FOR ROAD AND BRIDGE CONSTRUCTION IN ILLINOIS." AS PREPARED BY IDOT, LATEST EDITION.
  - (B) "STANDARD SPECIFICATIONS FOR WATER AND SEWER MAIN CONSTRUCTION IN ILLINOIS," LATEST EDITION
  - "ILLINOIS RECOMMENDED STANDARDS FOR SEWAGE WORKS," AS PUBLISHED BY THE IEPA, LATEST EDITION

THE STANDARD SPECIFICATIONS LISTED ON THESE CONSTRUCTION DRAWINGS AND SUBSEQUENT DETAILS ARE ALL TO BE CONSIDERED AS PART OF THE CONTRACT DOCUMENTS. INCIDENTAL ITEMS OR ACCESSORIES NECESSARY TO COMPLETE THIS WORK MAY NOT BE SPECIFICALLY NOTED BUT ARE TO BE CONSIDERED A PART OF THE CONTRACT.

- NO CONSTRUCTION DRAWINGS SHALL BE USED FOR CONSTRUCTION UNLESS SPECIFICALLY MARKED 'FOR CONSTRUCTION'. PRIOR TO COMMENCEMENT OF SPECHICALLY MARKED FOR COMSTRUCTION. PRIOR TO COMMENCEMENT OF CONSTRUCTION, THE CONTRACTOR SHALL VERIFY ALL DIMENSIONS AND CONDITIONS AFFECTING THEIR WORK WITH THE ACTUAL CONDITIONS AT THE JOB SITE. IF THERE ARE ANY DISCREPANCIES FROM WHAT IS SHOWN ON THE CONSTRUCTION DRAWINGS, CONTRACTOR MUST IMMEDIATELY REPORT SAME TO THE OWNER'S REPRESENTATIVE BEFORE DOING ANY WORK, OTHERWISE THE CONTRACTOR ASSUMES FULL RESPONSIBILITY. IN THE EVENT OF DISAGREEMENT BETWEEN THE CONSTRUCTION DRAWINGS, STANDARD SPECIFICATIONS AND/OR SPECIAL DETAILS, THE CONTRACTION SHAWINGS,
  STANDARD SPECIFICATIONS AND/OR SPECIAL DETAILS, THE CONTRACTOR
  SHALL SECURE WRITTEN INSTRUCTIONS FROM THE ENGINEER PRIOR TO
  PROCEEDING WITH ANY PART OF THE WORK AFFECTED BY OMISSIONS OR
  DISCREPANCIES. FALING TO SECURE SUCH INSTRUCTION, THE CONTRACTOR
  WILL BE CONSIDERED TO HAVE PROCEEDED AT ITS OWN RISK AND EXPENSE.
- THE ENGINEER AND OWNER ARE NOT RESPONSIBLE FOR THE CONSTRUCTION MEANS, METHODS, TECHNIQUES, SEQUENCES OR PROCEDURES, TIME OF PERFORMANCE, PROGRAMS OR FOR ANY SAFETY PRECAUTIONS USED BY THE CONTRACTOR. THE CONTRACTOR IS SOLELY RESPONSIBLE FOR EXECUTION OF THE WORK IN ACCORDANCE WITH THE CONTRACT DOCUMENTS AND SPECIFICATIONS.
- 10. CONSTRUCTION INGRESS/EGRESS SHALL BE RESTRICTED TO PUBLIC ROADWAYS. CONSTRUCTION ENTRANCES/EXITS SHALL BE CLEANED DAILY AS NEEDED OR AS DIRECTED BY THE ENGINEER.
- 11. EXISTING DRAINAGE ROUTES SHALL BE MAINTAINED THROUGHOUT THE DURATION OF CONSTRUCTION. LOOSE MATERIALS DEPOSITED IN THE FLOW LINE OF GUTTERS, DRAINAGE STRUCTURES, DITCHES, ETC. SUCH THAT THE NATURAL FLOW LINE IS OBSTRUCTED, SHALL BE REMOVED BY THE CLOSE OF EACH WORKING
- 12. THE CONTRACTOR SHALL PROVIDE DUST CONTROL MEASURES AS DIRECTED
- 13. THE CONTRACTOR SHALL BE RESPONSIBLE FOR THE INSTALLATION AND MAINTENANCE OF ADEQUATE TRAFFIC CONTROLS SIGNS AND DEVICES. BARRICADES AND WARNING SIGNS SHALL BE PROVIDED IN ACCORDANCE WITH I.D.O.T. STANDARD SPECIFICATIONS AND "MANUAL ON UNIFORM TRAFFIC CONTROL DEVICES."
- 14. PRIOR TO CONSTRUCTION, ALL EXISTING TRAFFIC/STREET SIGNS SHALL BE REMOVED AND RETURNED TO THE VILLAGE OF BURR RIDGE. THE VILLAGE WILL REPLACE STREET SIGNS AT THE CONCLUSION OF THE PROJECT.
- 15. THE CONTRACTOR SHALL KEEP A SET OF "APPROVED" CONSTRUCTION DRAWINGS ON THE JOB SITE, AND SHALL MAINTAIN A RECORD ON SAID DRAWINGS OF ANY UNANTICIPATED UTILITIES ENCOUNTERED, ANY MODIFICATIONS/ALTERATIONS TO ALIGNMENT AND/OR TO DRAWINGS AND SPECIFICATIONS OF PROPOSED IMPROVEMENTS. UPON COMPLETION OF THE CONTRACTOR'S WORK, SAID DRAWINGS AND INFORMATION SHALL BE PROVIDED TO THE OWNER'S REPRESENTATIVE.
- 16. THE CONTRACTOR SHALL BE RESPONSIBLE FOR CONSTRUCTION SURVEY AND STAKEOUT.
- 17. THE CONTRACTOR SHALL PERFORM A PRE-CONSTRUCTION VIDEO TAPING OF THE PROJECT SITE AND SURROUNDING AREA. THE VIDEO TAPE(S) MUST BE APPROVED BY THE ENGINEER PRIOR TO COMMENCEMENT
- 18. THE CONTRACTOR SHALL USE INLET FILTER BASKETS, SILT FENCE AND ANY OTHER EROSION CONTROL MEASURES AS DIRECTED BY THE
- 19. THE CONTRACTOR SHALL BE RESPONSIBLE FOR MAKING ALL ARRANGEMENTS AND PAYING FOR ALL COSTS ASSOCIATED WITH ANY TEMPORARY UTILITIES THAT MAY BE NECESSARY FOR THE PROJECT.
- 20. WATER REQUIRED FOR CONSTRUCTION OPERATIONS MAY BE OBTAINED FROM VILLAGE FIRE HYDRANTS IN THE AREA. THE CONTRACTOR IS RESPONSIBLE FOR OBTAINING A WATER METER AND BACKFLOW PREVENTER FROM THE VILLAGE AND PURCHASING WATER AT THE APPLICABLE RATE.
- 21. THE CONTRACTOR SHALL PROVIDE PORTABLE SANITARY FACILITIES FOR THEIR USE THROUGHOUT THE DURATION OF THE PROJECT.
- 22. ALL DISTURBED GRASS AREAS SHALL BE RESTORED WITH SOD. SUPPLEMENTAL WATERING SHALL BE APPLIED AS DIRECTED BY THE ENGINEER, IN ACCORDANCE WITH IDOT STANDARD SPECIFICATIONS AND SPECIAL PROVISIONS.
- 23. THE CONTRAGTOR SHALL TEMPORARILY RELOCATE AND PERMANENTLY RESET MAILBOXES AS DIRECTED BY THE LOCAL POSTMASTER. PER IDOT SPECIFICATION, SECTION 107.20, THIS WORK SHALL BE CONSIDERED INCLUDED IN THE COST OF THE CONTRACT.

- 24. THE CONTRACTOR SHALL USE FLAT TOP SLABS IN LIEU OF CONICALLY TAPERED TOPS FOR MANHOLES AND CATCH BASINS WHEREVER NECESSARY TO AVOID CONFLICTS WITH EXISTING UTILITIES. FLAT SLAB TOPS WILL NOT BE MEASURED FOR PAYMENT, BUT INCLUDED IN THE UNIT COST OF THE ASSOCIATED DRAINAGE STRUCTURE(S).
- 25. THE CONTRACTOR IS RESPONSIBLE FOR SECURING AND POSTING A BOND WITH THE COOK COUNTY DEPARTMENT OF TRANSPORTATION AND HIGHWAYS BEFORE
- 26. THE CONTRACTOR IS RESPONSIBLE FOR PROVIDING TRAFFIC CONTROL IN ACCORDANCE WITH ALL IDOT STANDARDS, WORK IN THE NORTH LANE OF GERMAN CHURCH ROAD SHALL BE DONE UNDER FLAGGERS BETWEEN 9:00AM AND 3:00PM.
- 27. NO TRAFFIC SIGNAL APPARATUS SHALL BE IMPACTED BY THE PROPOSED WORK. THE TRAFFIC SIGNAL APPARATUS NEAR THE CORNER OF COUNTY LINE ROAD AND GERMAN CHURCH ROAD SHALL IN NO WAY BE IMPACTED. ANY DAMAGE TO TRAFFIC SIGNAL EQUIPMENT SHALL BE REPAIRED TO THE SATISFACTION OF THE COOK COUNTY DEPARTMENT OF TRANSPORTATION AND HIGHWAYS, AT THE
- 28. SPECIAL ATTENTION IS CALLED TO ARTICLE 107.30 OF THE STANDARD SPECIFICATIONS. ANY DEFACED WORK SHALL BE CORRECTED OR REPLACED BY THE CONTRACTOR AT HIS SOLE EXPENSE PRIOR TO FINAL PAYMENT.

#### COOK COUNTY DEPARTMENT OF TRANSPORTATION AND HIGHWAYS NOTES:

- 1. CARE IS TO BE TAKEN AS NOT TO DAMAGE ANY OF THE EXISTING TRAFFIC SIGNAL CONDUITS, AND EQUIPMENT. IF ANY OF THE TRAFFIC SIGNAL CONDUITS, CABLES AND/OR EQUIPMENT IS DAMAGED, THE CONTRACTOR SHALL REPAIR AND/OR REPLACE. THE CONDUITS, CABLES AND/OR EQUIPMENT AT NO COST TO THE COUNTY.
- THE COUNTY IS NOT PART OF JULIE FOR LOCATION OF TRAFFIC SIGNAL EQUIPMENT, CONTACT THE MECHANICAL, ELECTRICAL, ARCHITECTURAL AND LANDSCAPING DIVISION CONTACT THE MECH AT 312-603-1730.
- 3. FOR THE LOCATION OF UNDERGROUND COUNTY MAINTAINED FACILITIES, SEE COUNTY SPECIAL RPOVISION "TRAFFIC SIGNAL WORK GENERAL".

#### COMMITMENTS:

NONE, 01-22-2015

#### LEGEND

	LEGEND
EXISTING	
o <sup>gy</sup>	GAS VALVE
Ÿ	DECORATIVE LIGHT
LISTONE	BOULDER
as.T	TEMPORARY SIGN
Φ.	SIGN
WIT	TELEPHONE CABINET
⊠T	TELEPHONE PEDESTAL
Δ	CONTROL POINT
S	CONTROL POINT (CHIS "X"
⊠ <sup>CTV</sup>	CATV PEDESTAL
o <sup>BB</sup>	<b>BUFFALO BOX</b>
⊗ <sub>WV</sub>	WATER VALVE
0 E	CATCH BASIN
CATV	CATV LINE
OH	OVERHEAD LINE
ss	SANITARY SEWER
sr	STORM SEWER
ss	COMBINED SEWER

EF HAMES	USER DAME TO	DESIGNED	AJB	REVISED	\$ 6616217015°			F.A.U RTE.	SECTION	COUNTY	TOTAL SHEET SHEETS NO.
		DRAWN -	TRD	REVISED		STATE OF ILLINOIS	INDEX OF SHEETS, STANDARDS, AND GENERAL NOTES	1552	14-00050-00-SW	COOK	23 2
	RSOT QUALE (a)	CHECKED -	MAP	REVISED	1 32 4 4	DEPARTMENT OF TRANSPORTATION		GERMAN	CHURCH ROAD PED IMPROVEMENT	CONTRAC	CT NO. 61B38
	PLOT DATE #	DATE -	01/28/2015	REVISED			SCALE: NONE SHEET 1 OF 1 SHEETS STA. TO STA.	FED. RO	AD DIST. NO. 1 ILLINOIS FED. AF	D PROJECT	Principal Color Color

+	20200100	EARTH EXCAVATION	CU YD	1258	1258
1	20200100	POSTER PROPERTIENA	CUTO	1230	1258
F	20201200	REMOVAL AND DISPOSAL OF UNSUITABLE MATERIAL	CU YD	197	197
	4				
L	20400800	FURNISHED EXCAVATION	CU YD	318	318
L	120.40.00.00				
H	20900110	POROUS GRANULAR BACKFILL	CU YD	165	165
H	21101615	TOPSOIL FURNISH AND PLACE, 4*	SQ YD	2278	2278
$\vdash$	21101010	TOT SOIL TOTAL PINO PENOL, 4	50,10	2210	2210
1	25000400	NITROGEN FERTILIZER NUTRIENT	POUND	42	42
ŀΓ	25000500	PHOSPHORUS FERTILIZER NUTRIENT	POUND	42	42
4	25000600	POTASSIUM FERTILIZER NUTRIENT	POUND	42	42
-					
4	25100630	EROSION CONTROL BLANKET	SQ YD	2014	2014
+					
$\perp$	125 / 15 / 1- / 1- / 1- / 1- / 1-			000707	
1	25200110	SODDING, SALT TOLERANT	SQ YD	2278	2278
T	-111				
	28000400	PERIMETER EROSION BARRIER	FOOT	342	342
L	28000510	INLET FILTERS	EACH	6	6
L					
F	28100127	STONE RIPRAP, CLASS 84	SQ YD	40	40
$\vdash$	35101600	AGGREGATE BASE COURSE, TYPE B 4"	SQ YD	600	500
$\vdash$	35101600	AGGREGATE BASE COURSE. TYPE 8 4	SQTD	590	590
H	42400200	PORTLAND CEMENT CONCRETE SIDEWALK 5 INCH	SQ FT	5310	5310
T					
	42400800	DETECTABLE WARNING	SQ FT	32	32
L	44000100	PAVEMENT REMOVAL	SQ YD	37	37
F					
-	44000200	DRIVEWAY PAVEMENT REMOVAL	SQ YD	41	41
H	44000500	COMBINATION CURB & GUTTER REMOVAL	FOOT	20	20
-	4400000	COMPLEXITOR GOLD & GOLD EN PLINOVAL	1001	2.0	. 20
-	44000600	SIDEWALK REMOVAL	SQ FT	50	50
	44201765	CLASS D PATCHES, TYPE II, 10 INCH	SQ YD	37	37
L					
-	50200100	STRUCTURE EXCAVATION	CU YD	414	414
1	50200225	CANCELLE STOLICTURES	CILVE	~~	
-	50300225	CONCRETE STRUCTURES	CU YD	112	112
-	50800205	REINFORCEMENT BARS, EPOXY COATED	POUND 4	14741	1471
-		The contract of the contract o		11/18	CI/
T	54213657	PRECAST REINFORCED CONCRETE FLARED END SECTIONS 12"	EACH	2	2
	550A0340	STORM SEWERS, CLASS A, TYPE 2, 12"	FOOT	497	497
L					
L	59100100	GEOCOMPOSITE WALL DRAIN	SQ YD	200	200

DESIGNED

CHECKED

DRAWN

AJB

TRD

01/28/2015

MAP

A 6010217018

REVISED

REVISED.

REVISED

ITEM

CODE NO.

20100210 TREE REMOVAL (OVER 15 UNITS DIAMETER)

20101300 TREE PRUNING (1 TO 10 INCH DIAMETER)

20101350 TREE PRUNING (OVER 10 INCH DIAMETER)

20101200 TREE ROOT PRUNING

CONSTRUCTION CODE STP FUNDS

75% FED, 25% LOCAL

(BURR RIDGE)

CODE NO.

60600605

STATE OF ILLINOIS

**DEPARTMENT OF TRANSPORTATION** 

UNIT

EACH

EACH

EACH

TOTAL QUANT

03800 COMBINATION CONCRETE CURB AND GUTTER, TYPE B-6.12	FOOT	20	20
800310 GUARDRAIL REMOVAL	FOOT	137	137
100100 MOBILIZATION	L SUM	1	1
201110 PAINT PAVEMENT MARKING - LINE 4*	FOOT	18	18
001130 PAINT PAVEMENT MARKING - LINE 6"	FOOT	90	90
001150 PAINT PAVEMENT MARKING - LINE 12"	FOOT	96	96
001180 PAINT PAVEMENT MARKING - LINE 24*	FOOT	15	15
000200 MAINTENANCE OF EXISTING TRAFFIC SIGNAL INSTALLATION	EACH	1	1
	EACH	1	1
002376 REBUILD EXISTING HANDHOLE	EACH		
C02501 TREE, CERCIS CANADENSIS (REDBUD), 1" CALIPER, CONTAINER GROWN	EACH	7	7
TREE, CRATAEGUS VIRDIS WINTER KING (WINTER KING GREEN HAWTHORN), 3° CALIPER, BALLED AND BURLAPPED	EACH	4	4
SHRUB, RHUS AROMATICA GRO-LOW (GRO-LOW FRAGRANT SUMAC), 15" WIDTH, BALLED AN BURLAPPED	ID EACH	100	100
0088Y2 SEEDLING-OSTRYA VIRGINIANA (AMERICANHOPHORNBEAM), 2-YEAR OLD, BARE ROOT	Uni+ I	0.01	0.01
9130G3 SEEDLING-QUERCUS BICOLOR (SWAMP WHITE OAK), 3-GALLON CONTAINER	EACH	4	4
0160Y2 SEEDLING-QUERCUS RUBRA (RED OAK), 2-YEAR OLD, BARE ROOT	Unit I	0.04	0.04
324450 SEGMENTAL CONCRETE BLOCK WALL, SPECIAL	SQ FT	1059	1059
990810 PEDESTRIAN RAIL (SPECIAL)	FOOT	195	195
010216 TRAFFIC CONTROL AND PROTECTION, (SPECIAL)	L SUM	1	1
008858 RAILING	FOOT	118	118
013798 CONSTRUCTION LAYOUT	L SUM	1	1
046304 PIPE UNDERDRAINS FOR STRUCTURES 4*	FOOT	200	200
073002 TEMPORARY SOIL RETENTION SYSTEM	SQ FT	1755	1755
D 3668 PRECONSTRUCTION VIDEOTAPING * *	L SUM	1	
PRECONSTRUCTION VIDEOTA	PING ♥♥	PING ♥ L SUM	PING ♥ L SUM 1

ITEM

CATCH BASINS, TYPE A, 4' DIAMETER, TYPE 1 FRAME, OPEN LID

INLETS, TYPE A, TYPE 1 FRAME, OPEN LID

CONCRETE CURB, TYPE B

CONSTRUCTION CODE

STP FUNDS

75 % FED. 25 % LOCAL

(BURR RIDGE)

125

FED. ROAD DIST, NO. 1 ILLINOIS FED. AID PROJECT

UNIT

EACH

EACH

FOOT


SUMMARY OF QUANTITIES


TO STA.

SCALE: NONE SHEET 1 OF 1 SHEETS STA.

TOTAL QUANT

125

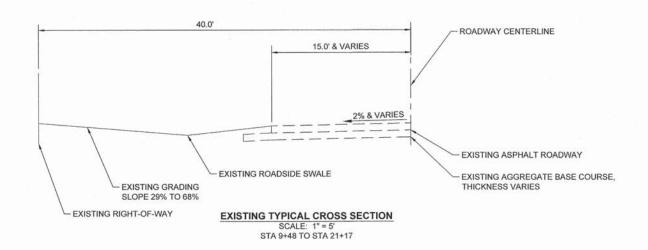

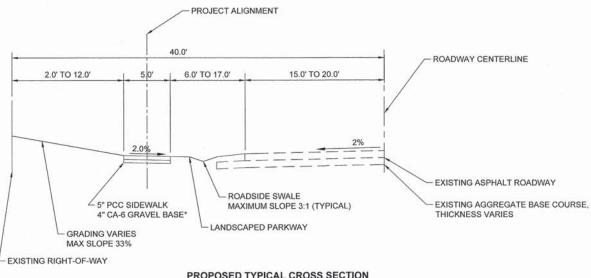

#### PROPOSED TYPICAL CROSS SECTION

SCALE: 1" = 5' STA, 9+48 TO STA, 14+25 STA. 16+73 TO STA. 17+04

PROPOSED SIDEWALK 7' WIDE WHEN LOCATED STA. 17+04 TO STA. 18+11

CLASS D PATCH, 8", 5.5' WIDE LOCATED STA. 16+75 TO STA. 16+92

CLASS D PATCH, 8", 2' WIDE LOCATED STA. 16+92 TO STA. 17+04

8" WIDE RETAINING WALL LOCATED STA. 14+25 TO STA. 18+71

> \*AGGREGATE BASE COURSE, TY. B, 4" THICK, (CA-6) (INCLUDED IN THE COST OF PCC SIDEWALK, 5 INCH)

PROJECT ALIGNMENT 40.0' ROADWAY CENTERLINE 2.0' TO 12.0' 6.0' TO 17.0' 15.0' TO 20.0' GRADING VARIES -MAX SLOPE 40% EXISTING ASPHALT ROADWAY - ROADSIDE SWALE - EXISTING AGGREGATE BASE COURSE, MAXIMUM SLOPE 3:1 (TYPICAL) RETAINING WALL THICKNESS VARIES 5.5' HIGH MAXIMUM - LANDSCAPED PARKWAY - 5" PCC SIDEWALK 4" CA-6 GRAVEL BASE\* - EXISTING RIGHT-OF-WAY PROPOSED TYPICAL CROSS SECTION

STA 14+25 TO STA. 16+73 8" WIDE RETAINING WALL LOCATED STA. 14+25 TO STA. 18+71

- PROJECT ALIGNMENT ROADWAY CENTERLINE 8.0" 13.0' TO 18.0' 16.0 EXISTING RIGHT-OF-WAY WALKWAY RAILING EXISTING ASPHALT ROADWAY CLASS D PATCH, 8" EXISTING AGGREGATE BASE COURSE, - 6" BARRIER CURB THICKNESS VARIES **EXISTING GRADING -**WYOMING RAILING SLOPE 30% TO 73 % 5" PCC SIDEWALK 4" CA-6 GRAVEL BASE\*

PROPOSED TYPICAL CROSS SECTION

SCALE: 1" = 5' STA. 17+04 TO STA. 18+11

8" WIDE RETAINING WALL LOCATED

STA. 14+25 TO STA. 18+71

RETAINING WALL

5.5' HIGH MAXIMUM

HOT-MIX ASPHALT MIXTURE REQUIREMENTS MIXTURE TYPE AIR VOIDS @Ndes PATCHING CLASS D PATCHES (HMA BINDER IL-19 MM) 4% @ 70 Gyr.

THE "AC TYPE" FOR POLYMERIZED HMA MIXES SHALL BE "SBS/SBR PG 76-22" AND FOR NON-POLYMERIZED HMA THE "AC TYPE" SHALL BE "PG 64-22" UNLESS MODIFIED BY DISTRICT ONE SPECIAL PROVISIONS. FOR HMA FULL DEPTH "AC TYPE" SEE SPECIAL PROVISIONS.

FOR USE OF RECYCLED MATERIALS SEE SPECIAL PROVISIONS.

COUNTY TOTAL SHEE TYPICAL SECTIONS COOK 14-00050-00-SW GERMAN CHURCH ROAD PED IMPROVEMENT | CONTRACT NO. 61B38 SCALE: 1" = 5' SHEET 1 OF 1 SHEETS STA. TO STA. FED. ROAD DIST. NO. 1 ILLINOIS FED. AID PROJECT

NAME=	USER NAME =	DESIGNED — AJB	REVISED —
		DRAWN — TRD	REVISED —
	PLOT SCALE =	CHECKED — MAP	REVISED —
	PLOT DATE =	DATE - 01/28/2015	REVISED -

STATE OF ILLINOIS **DEPARTMENT OF TRANSPORTATION** 

DIAMETER (INCHES)	STATION	OFFSET	TREE REMOVAL
24	11+57	3.21 R	Y
10	11+69	3.06 L	Y
10	12+63	0.31 L	Y
9	12+89	0	Y
6	12+91	2.09 L	Y
9	13+48	3.65 L	Y
8	13+57	2.83 L	Y
8	13+64	5.58 L	Y
8	13+78	5.83 L	Y
6	13+81	4.46 L	Y
9	13+87	5.48 L	Y
8	13+91	10.44 L	Y
15	14+20	7.64 L	Y
12	14+29	7.40 L	Y
18	14+32	10.37 L	Y
18	14+42	5.30 L	Y
7	14+68	2.31 L	Y
7	14+78	3.33 L	Y
7	14+87	0.14 R	Y
9	14+89	5.25 L	Y
9	14+96	3.82 L	Y
8	14+95	1.53 L	Y

DIAMETER (INCHES)	STATION	OFFSET	TREE REMOVAL							
6	15+08	0.92 L	Y							
6	15+09	3.08 L	Y							
7	15+23	1.74 R	Y							
7	15+39	1.03 L	Y							
7	15+51	0.67 L	Y							
9	15+51	9.28 L	Y							
6	15+66	0.62 L	Y							
14	15+68	8.42 L	Y							
6	15+82	2.69 L	Y							
7	15+86	7.48 L	Y							
6	15+86	0.81 R	Y							
6	16+04	1.48 R	Y							
6	16+16	1.02 R	Y							
6	16+19	1.81 L	Y							
6	16+23	3.60 L	Y							
18	16+36	4.57 L	Y							
8	16+39	2.33 L	Y							
10	16+50	9.24 L	Y							
7	16+54	2.47 L	Y							
7	16+57	1.21 L	Y							
7	16+58	3.28 L	Y							
6	16+62	6.02 L	Y							


EARTHWORK SCHEDULE							
LOCATION (GERMAN CHURCH ROA	D)	EARTH EXCAVATION (CU. YD.) 20200100	FURNISHED EXCAVATION (CU. YD.) 20400800	TOPSOIL FURNISH AND PLACE, 4" (SQ. YD.) 21101615			
9+48 to 14+00		158	6	737			
14+00 to 18+50		938	31	1026			
18+50 to 21+17		162	135	515			
	TOTAL	1258	172	2278			


DIAMETER (INCHES)	STATION	OFFSET	TREE REMOVAL
24	18+68	6.13 R	Y
9	18+84	16.64 R	Y
6	18+86	12.20 R	Y
9	18+91	15.33 R	Y
6	19+06	16.74 R	Y
18	19+06	8.18 R	Y
6	19+14	12.14 R	Y
6	19+21	10.62 R	Y
7	19+37	5.03 R	Y
6	19+47	10.94 R	Y
30	19+53	12.77 R	Y
16	19+84	1.95 L	Y
16	19+99	1.30 R	Y
10	20+03	3.67 R	Y
6	20+10	3.88 R	Y

_				
NO.	CODED PAY ITEM	DESCRIPTION	STATION	OFFSET
1	F30130G3	SEEDLING-QUERCUS BICOLOR (SWAMP WHITE OAK), 3-GALLON CONTAINER	11+80	5L
2	F30130G3	SEEDLING-QUERCUS BICOLOR (SWAMP WHITE OAK), 3-GALLON CONTAINER	12+18	5R
3	F30130G3	SEEDLING-QUERCUS BICOLOR (SWAMP WHITE OAK), 3-GALLON CONTAINER	12+68	5R
4	F30098Y2	SEEDLING-OSTRYA VIRGINIANA (AMERICANHOPHORNBEAM), 2-YEAR OLD, BARE ROOT	13+26	5R
5	A2C02501	TREE, CERCIS CANADENSIS (REDBUD), 1" CALIPER, CONTAINER GROWN	13+65	5L
6	A2C02501	TREE, CERCIS CANADENSIS (REDBUD), 1" CALIPER, CONTAINER GROWN	13+75	6L
7	A2C02501	TREE, CERCIS CANADENSIS (REDBUD), 1" CALIPER, CONTAINER GROWN	13+80	7L
8	A2C02501	TREE, CERCIS CANADENSIS (REDBUD), 1" CALIPER, CONTAINER GROWN	13+88	8L
9	F30130G3	SEEDLING-QUERCUS BICOLOR (SWAMP WHITE OAK), 3-GALLON CONTAINER	14+30	8L
10	A2C02501	TREE, CERCIS CANADENSIS (REDBUD), 1" CALIPER, CONTAINER GROWN	14+67	8L
11	A2C02501	TREE, CERCIS CANADENSIS (REDBUD), 1" CALIPER, CONTAINER GROWN	14+82	8L
12	A2C02501	TREE, CERCIS CANADENSIS (REDBUD), 1" CALIPER, CONTAINER GROWN	14+94	8L
13	B2002222	TREE, CRATAEGUS VIRDIS WINTER KING (WINTER KING GREEN HAWTHORN), 3" CALIPER, BALLED AND BURLAPPED	16+20	10L
14	B2002222	TREE, CRATAEGUS VIRDIS WINTER KING (WINTER KING GREEN HAWTHORN), 3" CALIPER, BALLED AND BURLAPPED	16+32	10L
15	B2002222	TREE, CRATAEGUS VIRDIS WINTER KING (WINTER KING GREEN HAWTHORN), 3" CALIPER, BALLED AND BURLAPPED	16+43	10L
16	F30160Y2	SEEDLING-QUERCUS RUBRA (RED OAK), 2-YEAR OLD, BARE ROOT	18+35	5L
17	B2002222	TREE, CRATAEGUS VIRDIS WINTER KING (WINTER KING GREEN HAWTHORN), 3" CALIPER, BALLED AND BURLAPPED	18+63	10R
18	F30160Y2	SEEDLING-QUERCUS RUBRA (RED OAK), 2-YEAR OLD, BARE ROOT	19+17	10R
19	F30160Y2	SEEDLING-QUERCUS RUBRA (RED OAK), 2-YEAR OLD, BARE ROOT	19+46	10R
20	F30160Y2	SEEDLING-QUERCUS RUBRA (RED OAK), 2-YEAR OLD, BARE ROOT	19+85	8R

FILE NAME=	USER NAME =	DESIGNED - AJB	REVISED —
		DRAWN — TRD	REVISED -
	PLOT SCALE =	CHECKED - MAP	REVISED —
	PLOT DATE =	DATE - 01/28/2015	REVISED -

									F.A.U RTE.	SECTION	COUNTY	TOTAL	SHEET NO.
						OF QUA			1552	14-00050-00-SW	COOK	23	5
									GERMAN	CHURCH ROAD PED IMPROVEMENT	CONTRAC	T NO.	51B38
CALE:	NONE	SHEET	1	OF	1.	SHEETS	STA.	TO STA.	FED. RO	DAD DIST. NO. 1 ILLINOIS FED. A	ID PROJECT		

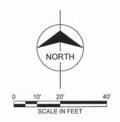

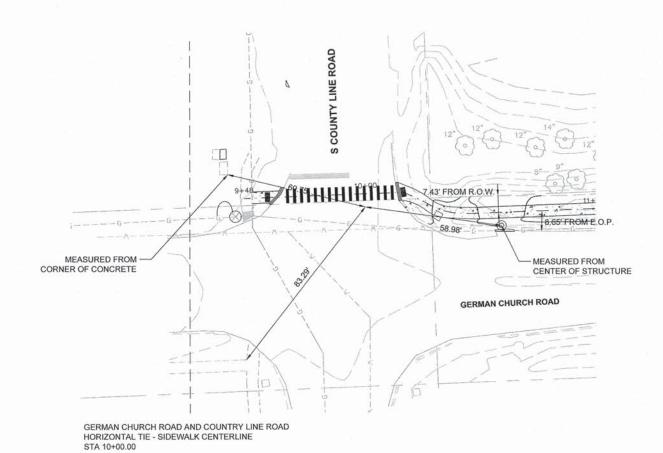

MEASURED FROM
CENTER OF STRUCTURE

O B 4 33' FROM R.O.W.

A3.18

O 61.31'


19.56 FROM E.O.P.

GERMAN CHURCH ROAD

O B 4 35' FROM C.L.

GERMAN CHURCH ROAD


GERMAN CHURCH ROAD AND GREYSTONE COURT HORIZONTAL TIE - SIDEWALK CENTERLINE STA 20+50.00

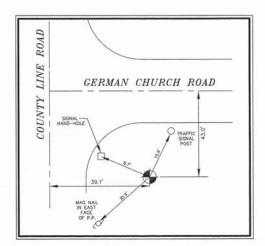



### BENCHMARK

VILLAGE BENCHMARK #107
LOCATED AT THE SOUTHEAST CORNER OF COUNTY
LINE ROAD AND GERMAN CHURCH ROAD
BERNTSEN MONUMENT, 9/16" DIA, STEEL ROD INSIDE
1" DIA, GRESE FILLED PVC
ELEVATION: 696.35
NORTHING: 1947514.62
EASTING: 1098431.16

FILE NAME=	USER NAME =	DESIGNED — AJB	REVISED —					HERM	ese company	HOUGHE		PROGRAMMY		F.A.U RTE.	SECTION	COUNTY	TOTAL	SHEET S NO.
		DRAWN TRD	REVISED -	STATE OF ILLINOIS				ALIG	NMENT,	TIES A	ND BENCH	IMARK		1552	14-00050-00-SW	COOK	23	6
	PLOT SCALE =	CHECKED - MAP	REVISED —	DEPARTMENT OF TRANSPORTATION	11									GERMAN	N CHURCH ROAD PED IMPROVEMENT	CONTRA	ACT NO.	61B38
	PLOT DATE =	DATE - 01/28/2015	REVISED -		SCALE:	1"=20"	SHEE	ET 1	OF	1 SHI	EETS STA.		TO STA.	FED. R	OAD DIST. NO. 1 ILLINOIS FED.	ND PROJECT	118	

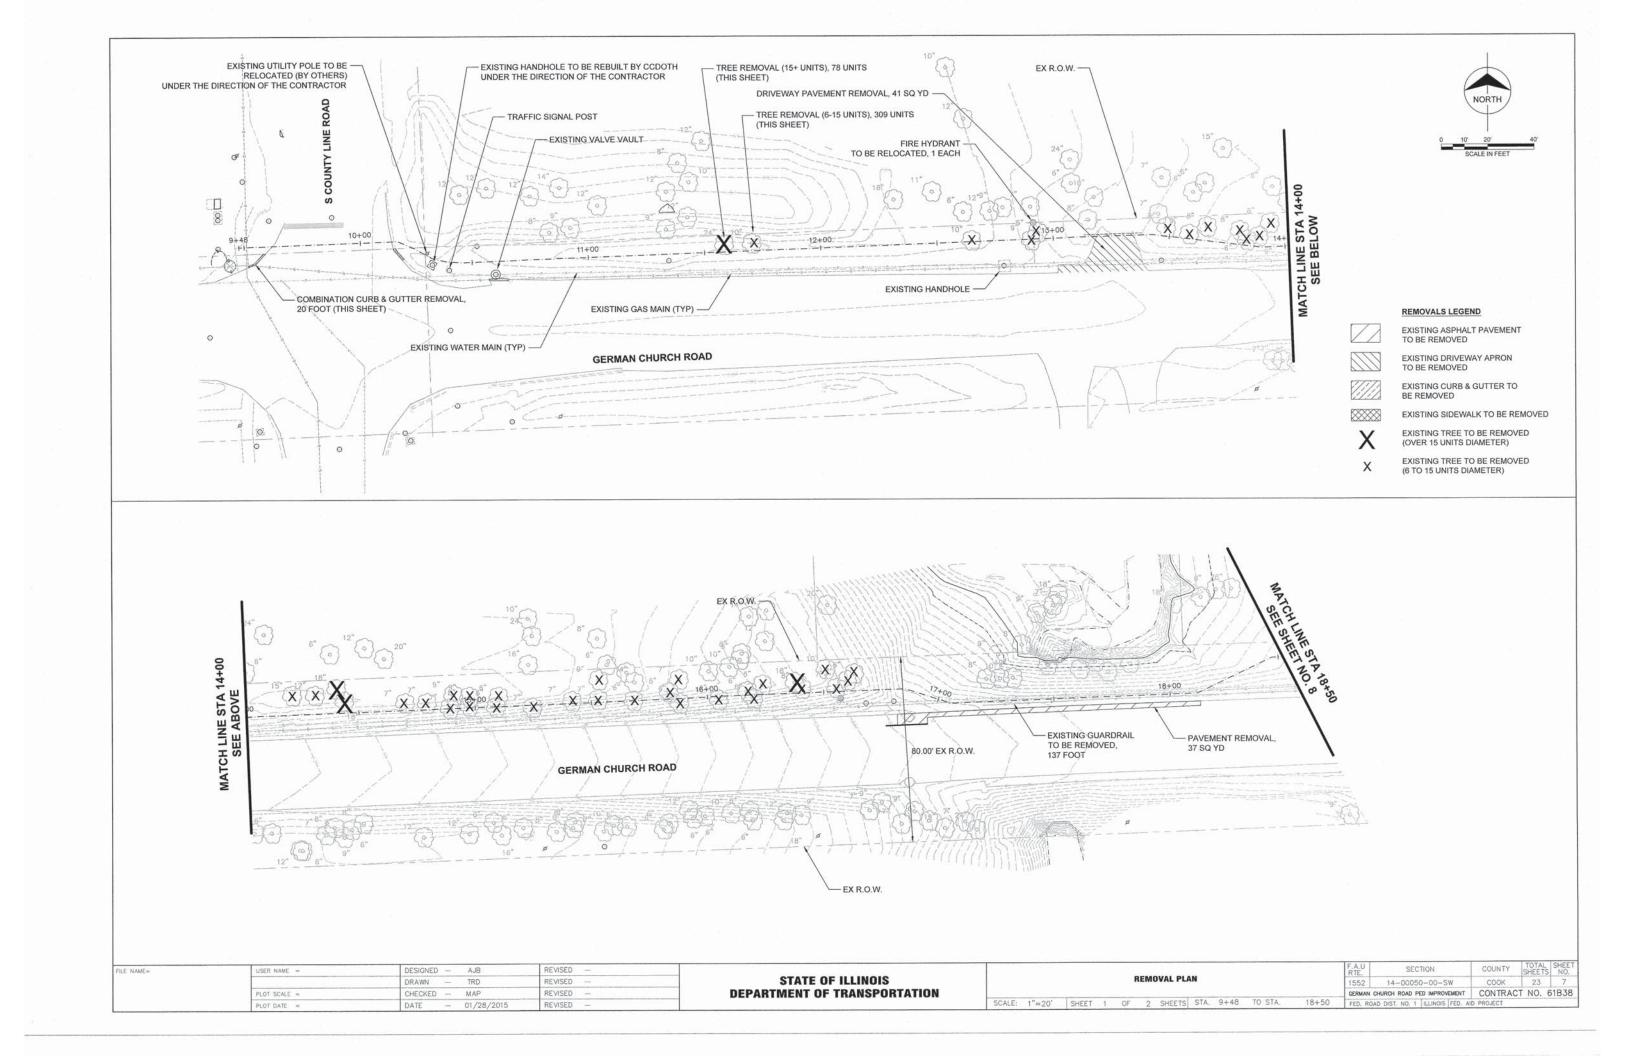

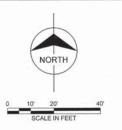

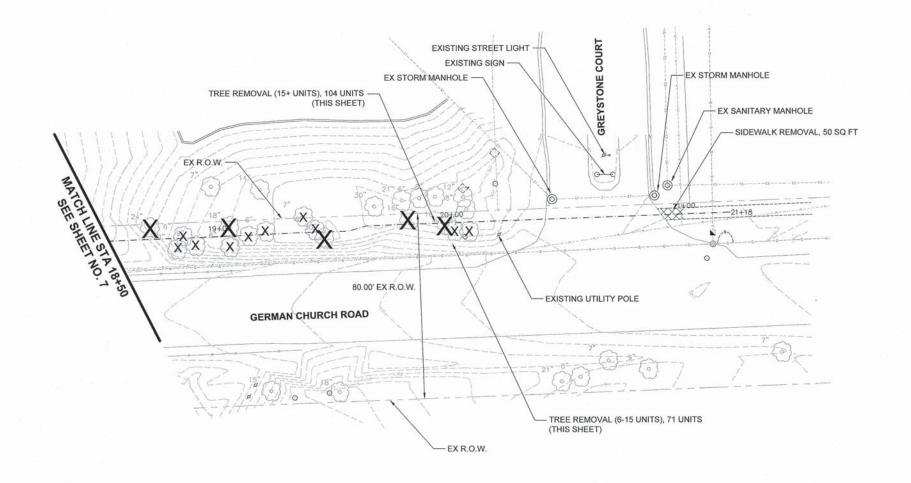

#### REMOVALS LEGEND

EXISTING ASPHALT PAVEMENT TO BE REMOVED



EXISTING DRIVEWAY APRON TO BE REMOVED



EXISTING ASPHALT/GRAVEL SHOULDER TO BE REMOVED



EXISTING SIDEWALK TO BE REMOVED





EXISTING TREE TO BE REMOVED (OVER 15 UNITS DIAMETER)





EXISTING TREE TO BE REMOVED (6 TO 15 UNITS DIAMETER)

FILE NAME=	USER NAME =	DESIGNED - AJB	REVISED —	SECTION STREET, WITH SHE		F.A.U RTE.	SECTION	COUNTY	TOTAL SHEET NO.
		DRAWN - TRD	REVISED —	STATE OF ILLINOIS	REMOVAL PLAN	1552	14-00050-00-SW	COOK	23 8
	PLOT SCALE =	CHECKED - MAP	REVISED -	DEPARTMENT OF TRANSPORTATION		GERMAN CHUR	RCH ROAD PED IMPROVEMENT	CONTRAC	T NO. 61B38
	PLOT DATE =	DATE - 01/28/2015	REVISED —		SCALE: 1"=20' SHEET 2 OF 2 SHEETS STA. 18+50 TO STA. 21+17	FED. ROAD D	DIST. NO. 1   ILLINOIS   FED. A	D PROJECT	

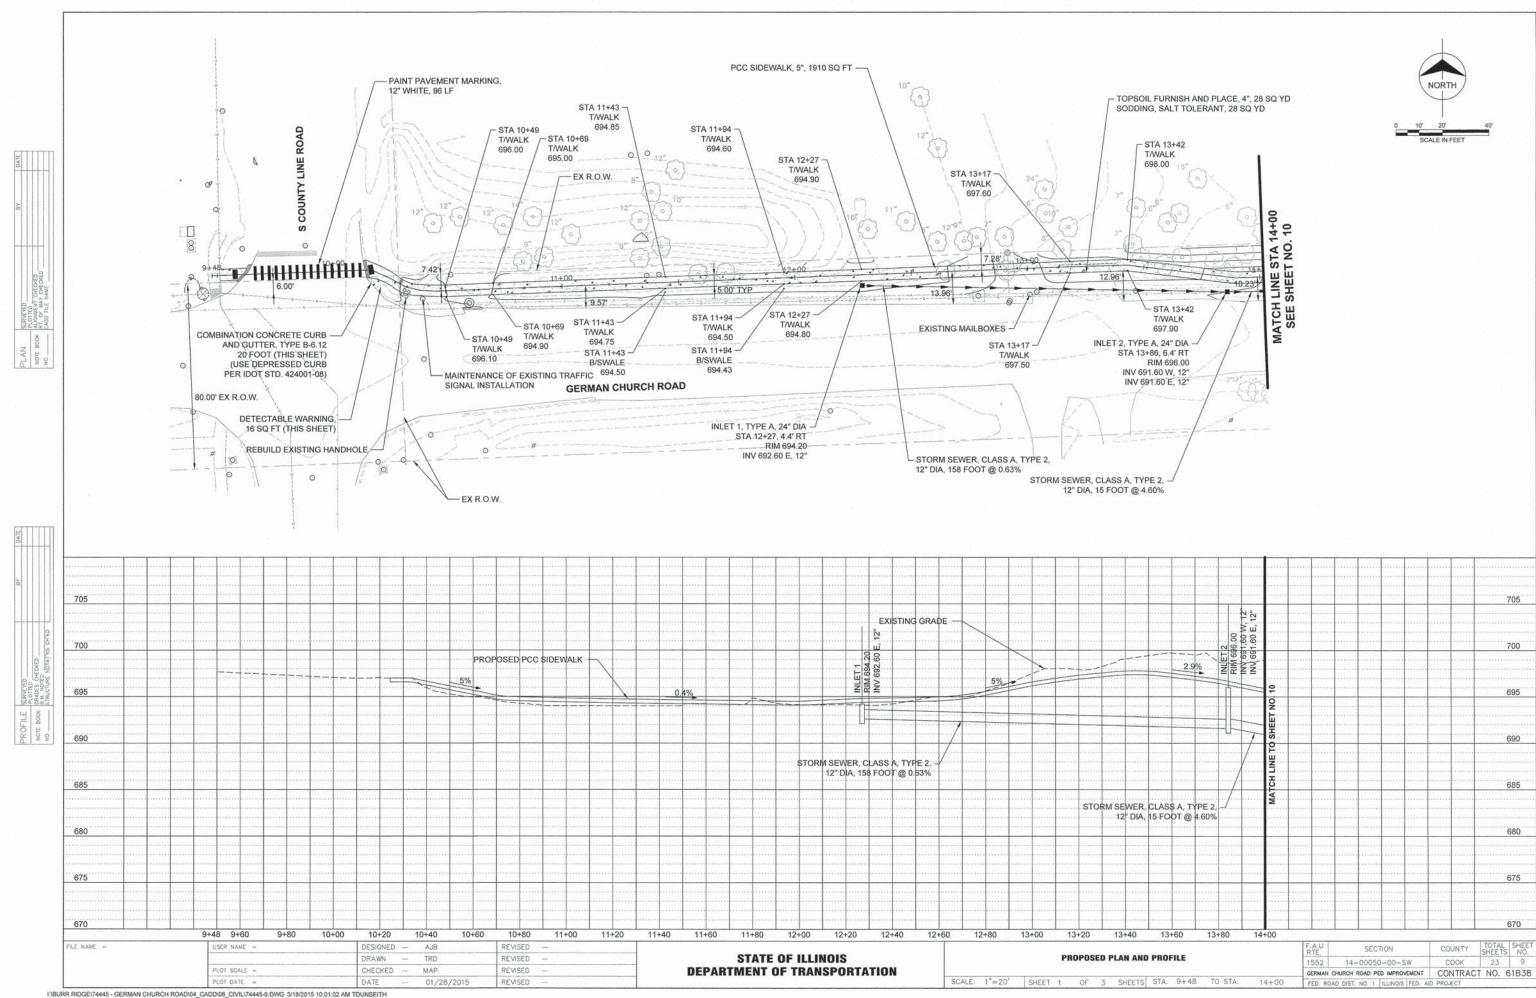

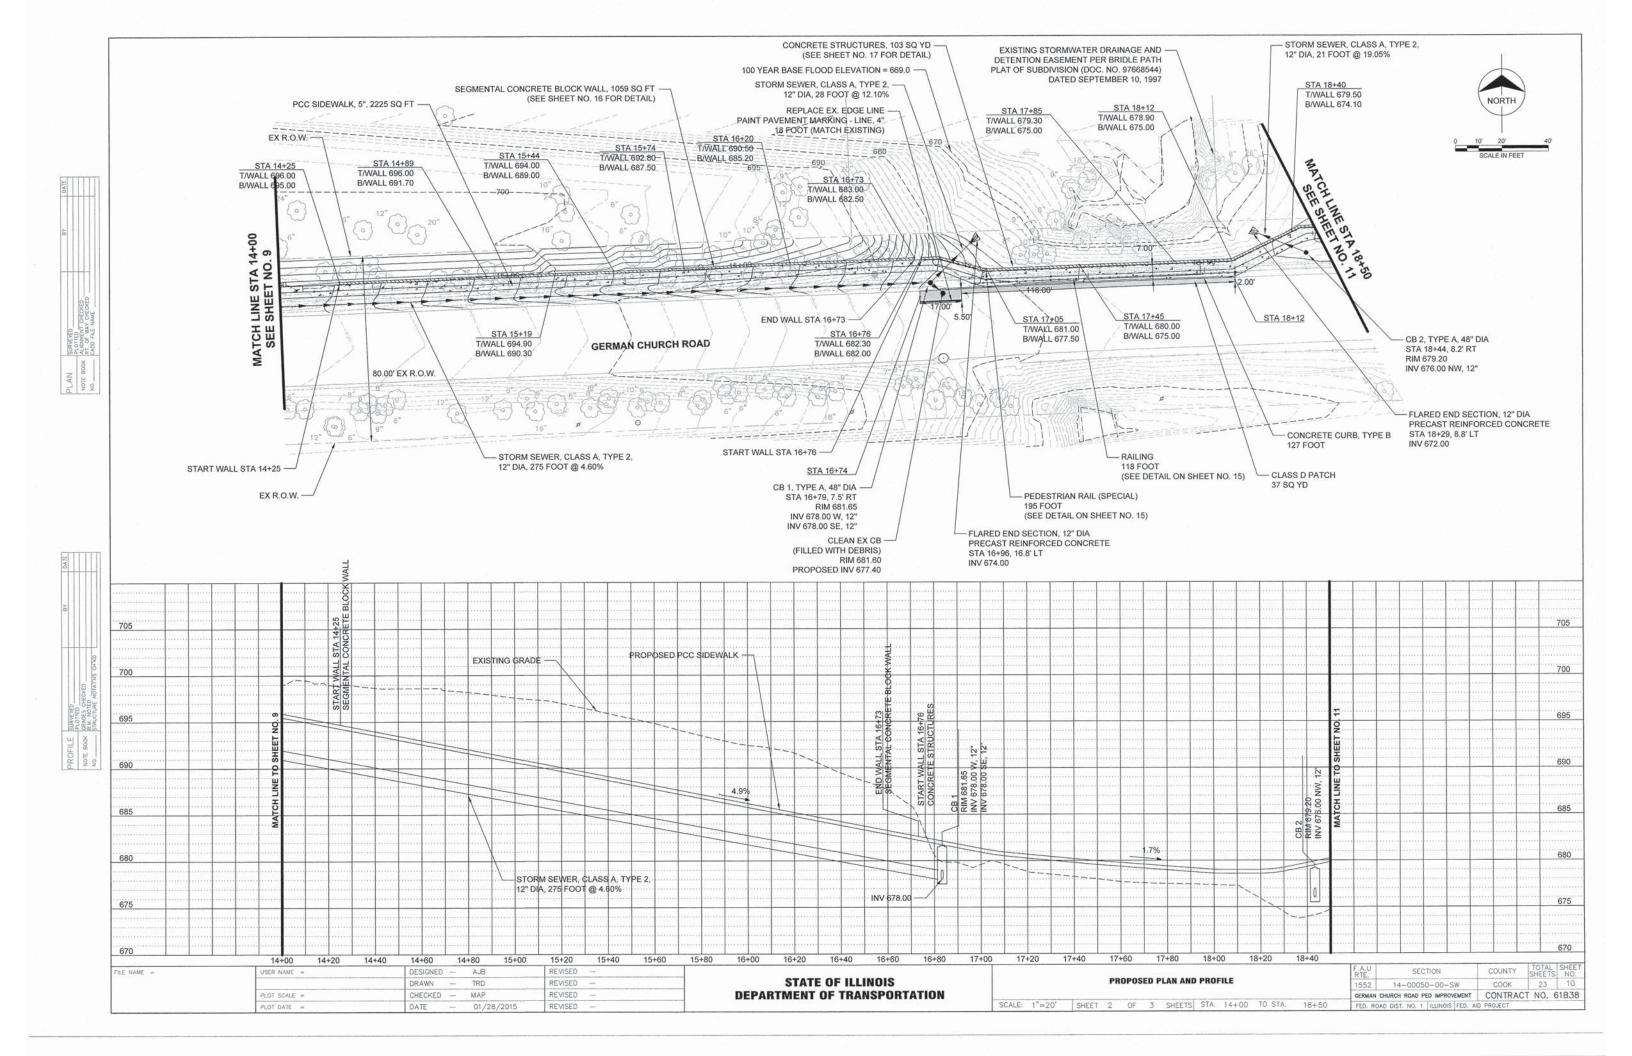

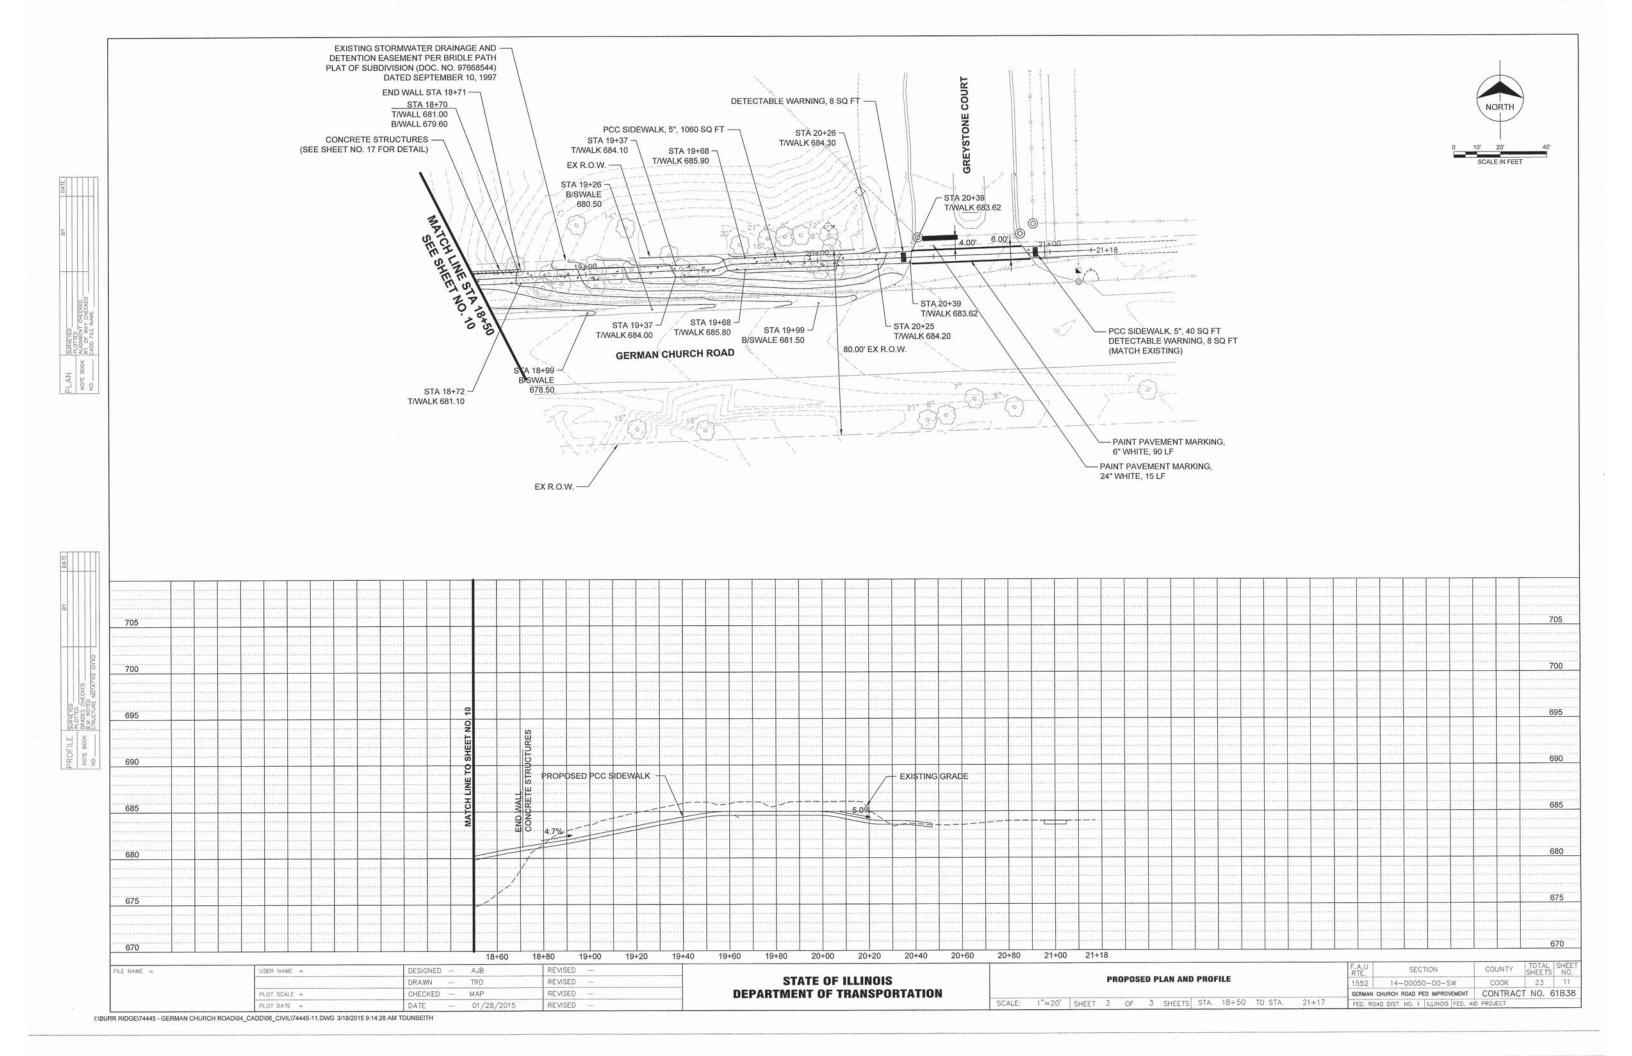

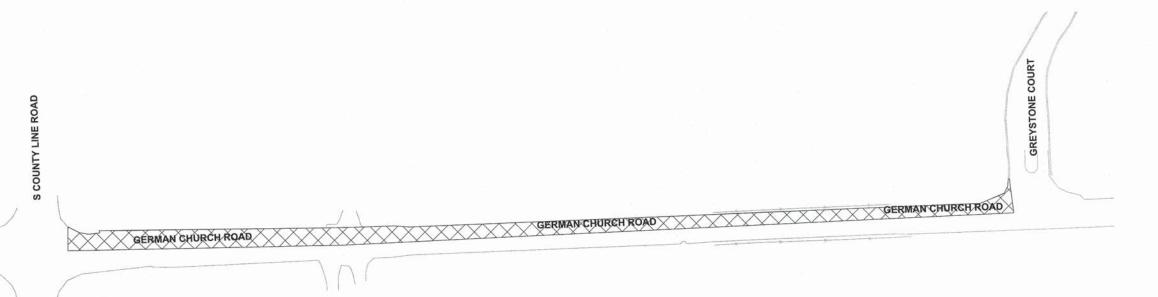



### MAINTENANCE OF TRAFFIC GENERAL NOTES

ALL TRAFFIC CONTROL AND PROTECTION MEASURES SHALL BE IN ACCORDANCE WITH SECTION 701 OF THE STANDARD SPECIFICATIONS, THE TRAFFIC PLAN AND THE LATEST EDITION OF THE MUTCD.

THE CONTRACTOR SHALL OBTAIN WRITTEN APPROVAL OF THE ENGINEER FOR ANY METHODS OF TRAFFIC CONTROL AND PROTECTION DIFFERENT THAN THAT SHOWN ON THE PLANS. NO ADDITIONAL COMPENSATION WILL BE ALLOWED TO THE

THE CONTRACTOR SHALL NOT CHANGE THE CONSTRUCTION STAGING PLANS WITHOUT WRITTEN APPROVAL OF THE ENGINEER AND ANY ADDITIONAL COSTS RESULTING FROM AN APPROVED CHANGE SHALL BE THE RESPONSIBILITY OF THE CONTRACTOR.

THE CONTRACTOR SHALL PROVIDE ALL SIGNS, BARRICADES AND TEMPORARY BARRIER WALLS AND PROTECTION NECESSARY FOR THE MAINTENANCE OF TRAFFIC AS NOTED IN THE CONTRACT DOCUMENTS, OR AS DIRECTED BY THE ENGINEER.

THE CONTRACTOR MUST NOTIFY ALL EMERGENCY SERVICES (POLICE, FIRE, ETC.), LOCAL SCHOOL DISTRICTS, AND LOCAL MUNICIPALITIES (VILLAGES, COUNTIES, TOWNSHIPS) AND POST OFFICE A MINIMUM OF 72 HOURS IN ADVANCE OF ANY SIDE ROAD CLOSURES OR DETOURS.

BURR RIDGE POLICE DEPARTMENT (NON-EMERGENCY): 630-654-8181 BURR RIDGE FIRE DEPARTMENT (NON-EMERGENCY): 708-352-9229 BURR RIDGE PUBLIC WORKS DEPARTMENT: 630-323-4733

SOLID WHITE LINES SHALL BE USED TO DEFINE OUTSIDE LANE LINES DURING MAINTENANCE OF TRAFFIC WHERE CURB AND GUTTER DOES NOT SERVE AS THE EDGE OF THE TRAFFIC LANE.

THE CONTRACTOR IS RESPONSIBLE FOR PROVIDING TEMPORARY DRAINAGE AND DE-WATERING ACTIVITIES TO ENSURE NO FLOODING OF ADJACENT PROPERTIES OR STANDING WATER IN THE CONSTRUCTION SITE.

ALL WARNING SIGNS SHALL BE BLACK LEGEND AND BORDER ON ORANGE REFLECTORIZED BACKGROUND UNLESS OTHERWISE SPECIFIED. ALL WARNING SIGNS TO BE 48" X 48".

THE CONTRACTOR SHALL MAINTAIN ACCESS TO ALL DRIVEWAYS AND SIDE STREETS DURING CONSTRUCTION. TEMPORARY ACCESS CLOSURES WILL BE ALLOWED ONLY AT THE DIRECTION OF THE ENGINEER.

ALL ADVANCE WARNING SIGNS FOR THE PROJECT SHALL BE INSTALLED PRIOR TO THE START OF CONSTRUCTION.

ALL TEMPORARY OR PERMANENT PAVEMENT MARKING PROPOSED WITHIN THE WORK AREA SHALL BE COMPLETED PRIOR TO THE CONSTRUCTION PHASE CHANGE.

THE COST OF FLAGGER SIGNING SHALL BE INCLUDED IN THE COST OF TRAFFIC CONTROL AND PROTECTION (SPECIAL).

CONTRACTOR SHALL COORDINATE ALL DETOUR SIGNS WITH ADJACENT CONSTRUCTION CONTRACTS (DO NOT KNOW OF ANY ADJACENT CONSTRUCTION CONTRACTS AT THIS TIME).

FLAGGER SIGNAGE SHALL BE COORDINATED WITH IDOT, COOK COUNTY, AND VILLAGE OF BURR RIDGE

#### CONSTRUCTION STAGING NOTES

THE NORTH LANE OF GERMAN CHURCH ROAD SHALL BE CLOSED ON WORKING DAYS BETWEEN 9:00AM AND 3:00PM. TWO FLAGGERS WILL MAINTAIN TRAFFIC ON THE SOUTH LANE OF GERMAN CHURCH ROAD.

PERFORM NECESSARY TREE REMOVAL AND CLEARING.

INSTALL FLAGGER ROAD SIGNS, INSTALL TEMPORARY TRAFFIC CONTROL MEASURES AS REQUIRED.

INSTALL TEMPORARY FENCING FOR TREE PROTECTION AND INLET FILTERS ON ALL EXISTING OPEN GRATE STRUCTURES.

REMOVE PAVEMENT AND ANCILLARY ITEMS AS REQUIRED WITHIN THE STAGE 1 CONSTRUCTION ZONE.

CONSTRUCT STORM SEWERS AND ASSOCIATED STRUCTURES IN STAGE 1 CONSTRUCTION ZONE.

CONSTRUCT THE NEW PAVEMENT WITHIN THE STAGE 1 CONSTRUCTION ZONE.

CONSTRUCT ASSOCIATED CURB AND GUTTER, SIDEWALK AND ANCILLARY ITEMS WITHIN THE STAGE 1 CONSTRUCTION ZONE.

STAGE 2: USE HIGHWAY STANDARDS AS NEEDED TO COMPLETE OTHER MINOR ITEMS AND CLEAN UP.


INSTALL LANDSCAPING.


REMOVE ALL TEMPORARY SIGNING AND TRAFFIC STAGING.


INSTALL PAVEMENT MARKINGS.

UNCOVER PERMANENT SIGNS

FILE NAME=	USER NAME =	DESIGNED — AJB	REVISED —			F.A.U RTE. SEC	CTION	COUNTY	TOTAL SHEET NO.
		DRAWN - TRD	REVISED —	STATE OF ILLINOIS	MAINTENANCE OF TRAFFIC PLAN	1552 14-0005	50-00-SW	COOK	23 12
	PLOT SCALE =	CHECKED - MAP	REVISED —	DEPARTMENT OF TRANSPORTATION		GERMAN CHURCH ROAD P	PED IMPROVEMENT	CONTRACT	T NO. 61B38
	PLOT DATE =	DATE - 01/28/2015	REVISED -		SCALE: 1"=50' SHEET 1 OF 1 SHEETS STA. TO STA.	FED. ROAD DIST. NO. 1	ILLINOIS FED. AID	PROJECT	

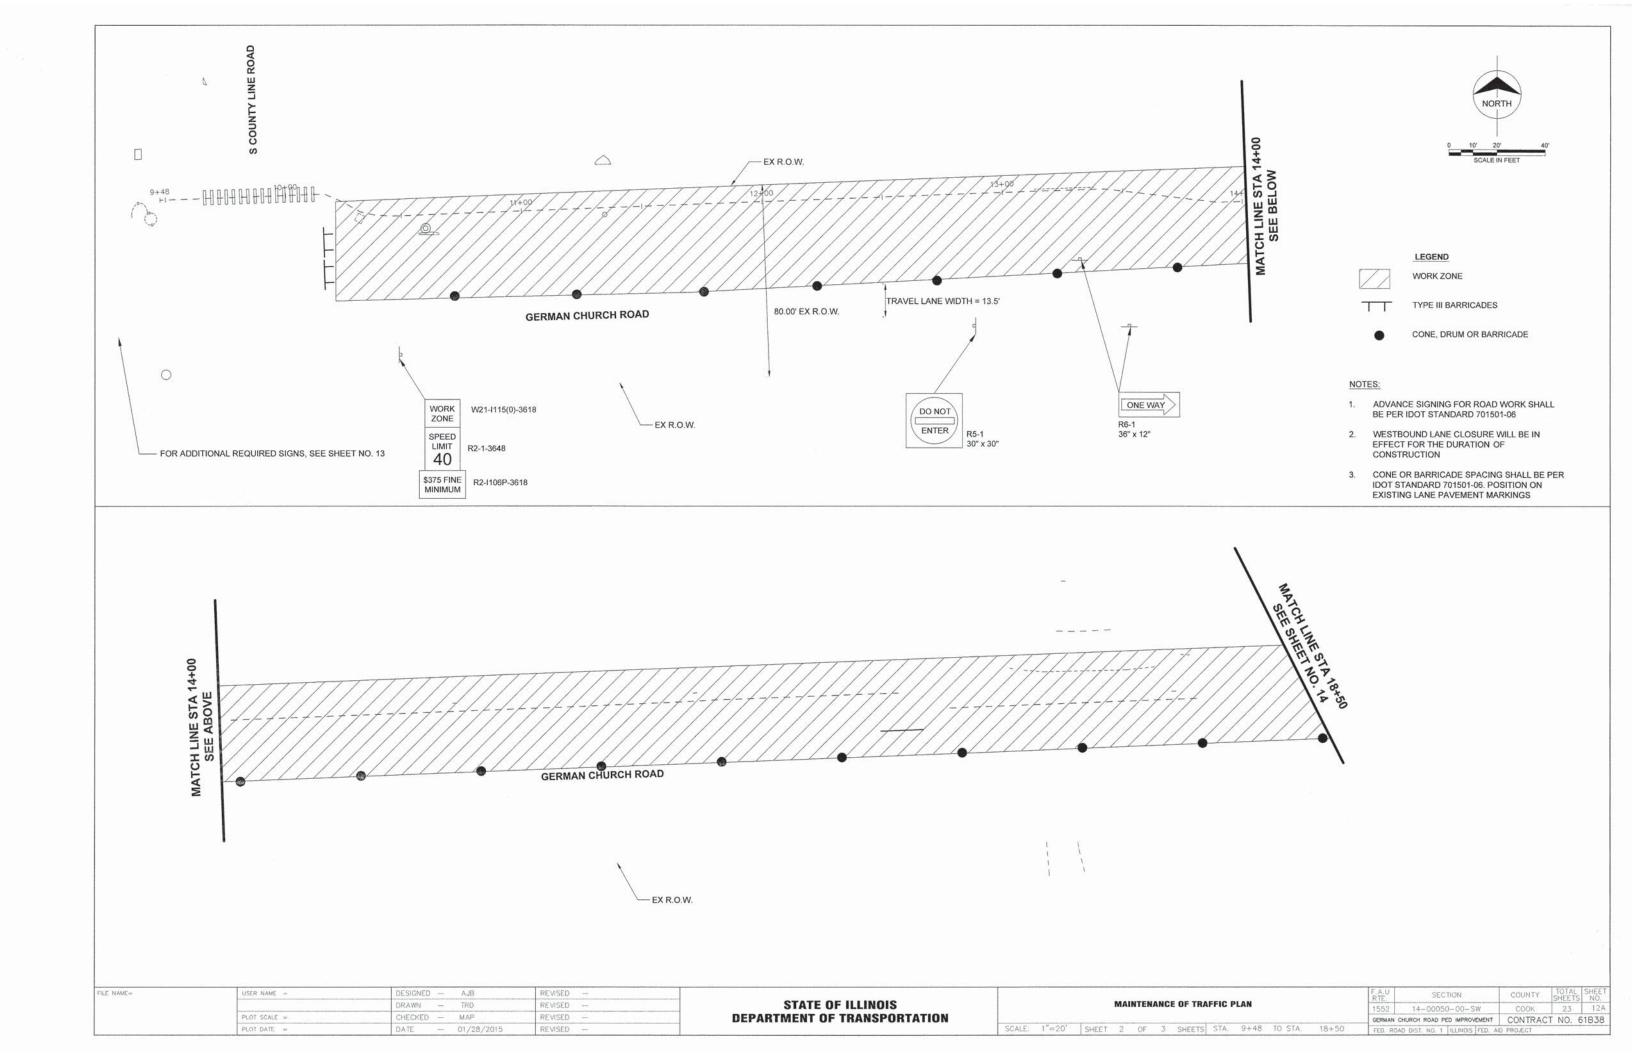

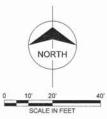


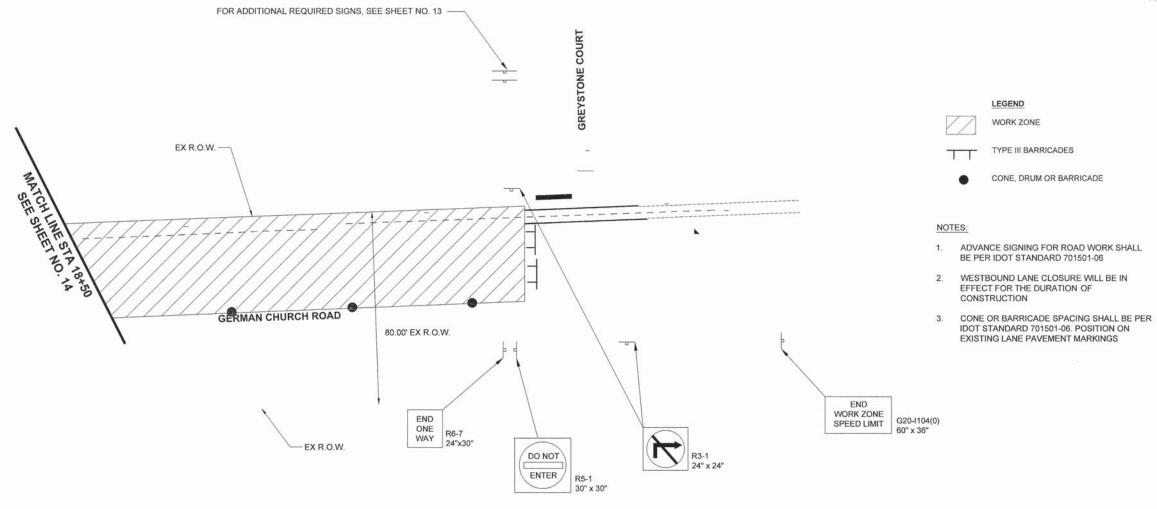



USER NAME =	DESIGNED - AJB	REVISED	-
	DRAWN - TRD	REVISED	
PLOT SCALE =	CHECKED - MAP	REVISED	-
PLOT DATE =	DATE - 01/2	28/2015 REVISED	7776) (100)


STATE O	F ILLINOIS
DEPARTMENT OF	TRANSPORTATION

	MA	INTEN	ANC	E OF TRA	FFIC	PLAN			RTE.	SECTION 14-00050-00-SW	COUNTY	SHEETS	NO.
									1992		COUR	23	120
									GERMAN (	CHURCH ROAD PED IMPROVEMENT	CONTRAC	T NO. 6	51B38
SHEET	3	OF	- 3	SHEETS	STA.	18+50	TO STA	21+17	EED BOA	ID DIST NO 1 HUNDIS FED AL	D PROJECT		

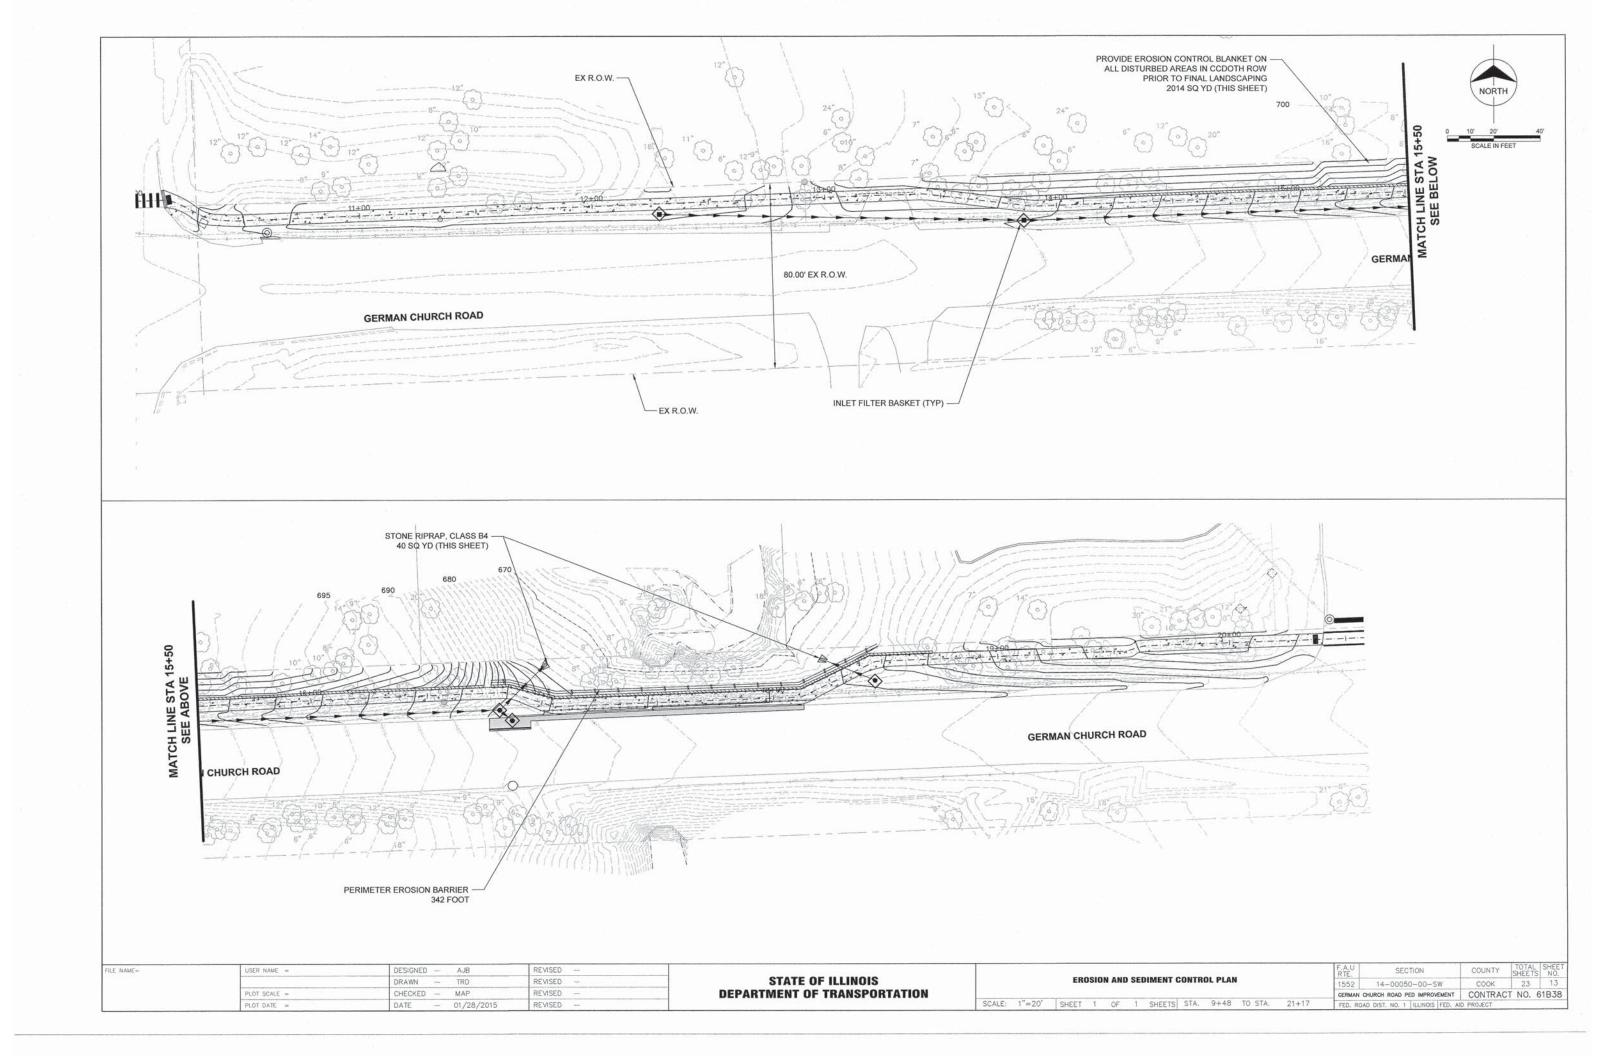

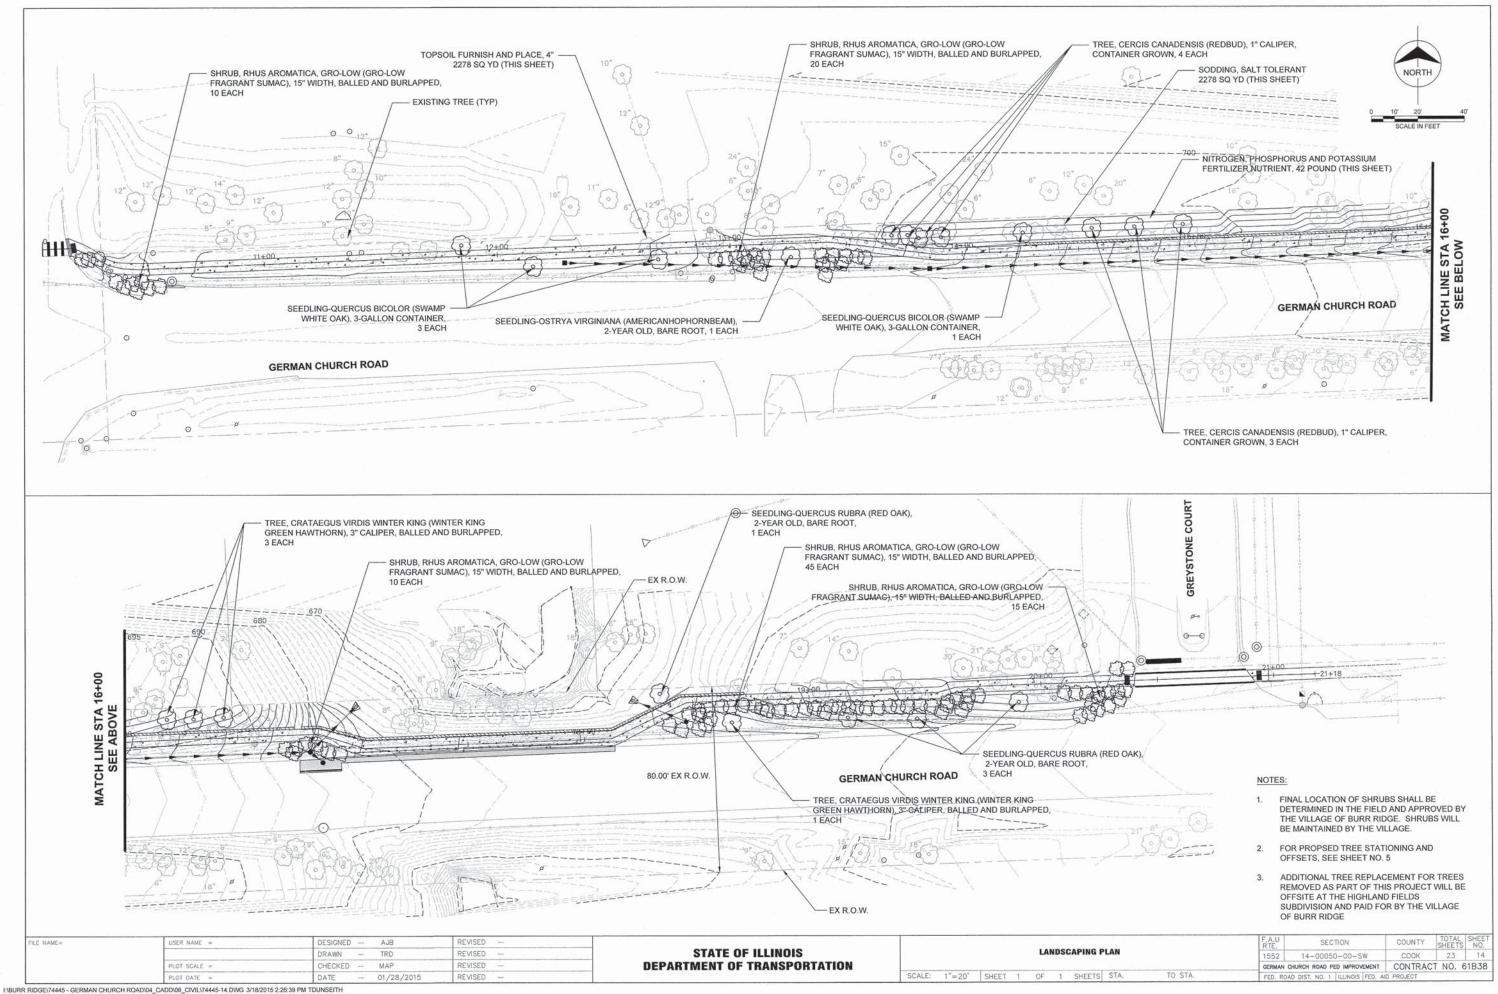

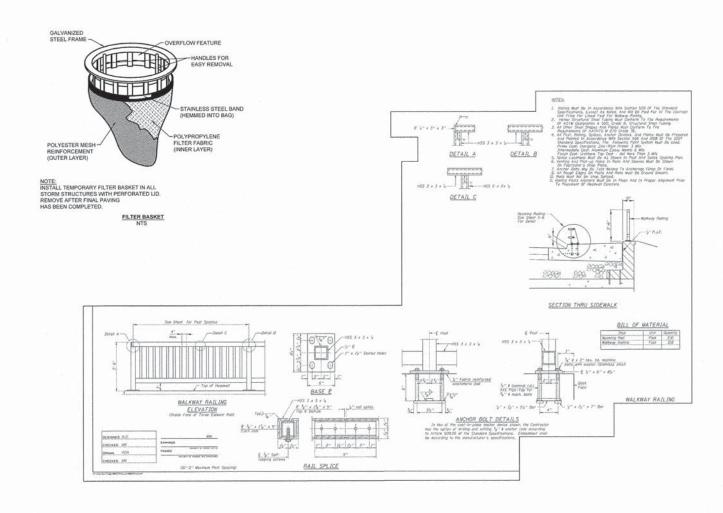

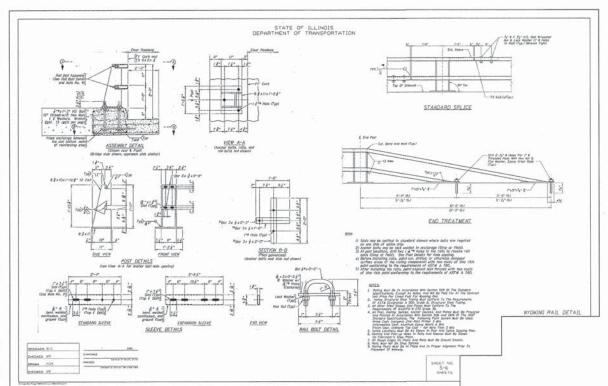


DRAWN - TRD

MAP

01/28/2015

CHECKED -

PLOT SCALE =

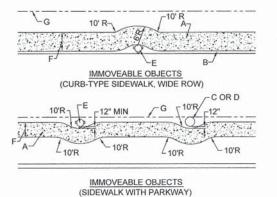

# SIDEWALK OBSTRUCTIONS

NOT TO SCALE

PLAN

SIDEWALK DETAIL

P.C.C. SIDEWALK 5"

NOT TO SCALE

#### CONSTRUCTION NOTE:

- A. SIDEWALK
- B CURB
- C. SERVICE POLE, SEE NOTES 1 AND 2.
- D. TREE TRUNK, SEE NOTE 1 E. FIRE HYDRANT, SEE NOTES 1 AND 2.
- F. SIDEWALK WIDTH. G. RIGHT-OF-WAY (ROW)

- 1. A FIRE HYDRANT, SERVICE POLE OR TREE TRUNK SHALL BE CONSIDERED IMMOVEABLE ONLY WHEN DIRECTED BY THE VILLAGE ENGINEER.
- 2. WHEN A SERVICE POLE OR FIRE HYDRANT IS LOCATED WITHIN THE SIDEWALK AREA, AND IS CONSIDERED IMMOVEABLE, A ½" EXPANSION JOINT SHALL BE INSTALLED ENCIRCLING THE OBJECT. THIS WORK SHALL BE INCIDENTAL TO THE SIDEWALK COST.

- A. 5' NORMAL WIDTH OR AS INDICATED ON PLANS
- B. AGGREGATE BASE COURSE, TY. B, 4" THICK, (CA-6)
- C. P.C.C. SIDEWALK

LEGEND

- D. SLOPE 1/4" PER FOOT MAXIMUM TO STREET SIDE, OR AS NOTED ON PLAN
- E. JOINTS, SEE NOTES 3 AND 4
- F. SLOPE 2% TO 8% TOWARDS STREET, OR AS NOTED ON PLAN
- G. CONCRETE THICKNESS, SEE NOTE 1
- H. COMPACTED SUBGRADE TO 95% OF THE STANDARD LABORATORY DENSITY

#### GENERAL NOTES

- STANDARD THICKNESS OF PCC SIDEWALK SHALL BE A MINIMUM OF 5 INCHES. THICKNESS SHALL BE 8 INCHES ACROSS DRIVEWAY ENTRANCE.
- 2. WHERE WOODEN FORMS ARE USED, 2x4's ARE NOT ALLOWED. ONLY 2x6's SHALL BE USED.
- PREFORMED ¾" EXPANSION JOINTS SHALL BE CONSTRUCTED AT MAX. SPACING OF 40'.
- 4. FORMED OR SAW-CUT CONTRACTION JOINTS SHALL BE SPACED GENERALLY 5' APART, BUT NO LESS THAN 4' AND NO MORE THAN 6'.
- ½" FOAM EXPANSION JOINTS SHALL BE INSTALLED WHERE SIDEWALK ABUTS BUILDINGS, TRAFFIC SIGNAL FOUNDATIONS, SERVICE POLES, AND OTHER IMMOVABLE STRUCTURES.
- 6. CONCRETE TO BE MINIMUM 6-BAG MIX.

# flantery Core flowlery   Cor	THE STANDARD SPLICE
TOTAL STATE OF THE	( Cas Part  ( Cas
Figure 2 & \$ 1 - 0 - 0 - 0 - 0 - 0 - 0 - 0 - 0 - 0 -	EIG. TEGATMENT.  Il Scots may be contred to standard diverse where lotts are required  2) Scots may be contred to standard diverse where lotts are required  2) Scots with any lot led velocity to enchange of their contrel  2) Scots with a second second second second second second second  2) Scots Scots of their Second second for free angular  2) Scots second
SEEVE DETAILS    See   S	ACTION OF THE PLANTAGE TO A CONTROL TO A CON

		S-G S-G S-ES	
-	DESIGNED - AJB	REVISED —	

STATE OF ILLINOIS


**DEPARTMENT OF TRANSPORTATION** 

REVISED

REVISED

					102				F.A.U RTE.	SECTION	COUNTY	TOTAL	SHEET NO.
						DETAILS			1552	14-00050-00-SW	COOK	23	15
									GERMAN (	CHURCH ROAD PED IMPROVEMENT	CONTRACT	NO. 6	51B38
SCALE:	NONE	SHEET	1	OF	3	SHEETS	STA.	TO STA.	FED. ROA	D DIST. NO. 1 ILLINOIS FED. AL			

### WOVEN WIRE FENCE (MIN 14 GA. W/MAX

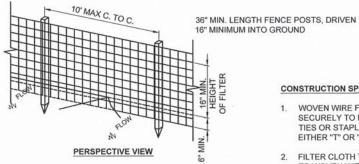

W.FLOW

**SECTION VIEW** 

STANDARD SYMBOL

COMPACTED SOIL

36" MIN FENCE POST


- UNDISTURBED GROUND

WOVEN WIRE FENCE TO BE FASTENED SECURELY TO FENCE POSTS WITH WIRE TIES OR STAPLES. POSTS SHALL BE STEEL EITHER "T" OR "U" TYPE OR HARDWOOD.


CONSTRUCTION SPECIFICATIONS


- 2. FILTER CLOTH TO BE FASTENED SECURELY TO WOVEN WIRE FENCE WITH TIES SPACED EVERY 24" AT TOP AND MID SECTION. FENCE SHALL BE WOVEN WIRE, 6" MAXIMUM MESH OPENING.
- 3. WHEN TWO SECTIONS OF FILTER CLOTH ADJOIN EACH OTHER THEY SHALL BE OVERLAPPED BY SIX INCHES AND FOLDED. FILTER CLOTH SHALL BE EITHER FILTER X, MIRAFI 100X, STABILINKA T140N, OR APPROVED EQUIVALENT.
- 4. PREFABRICATED UNITS SHALL BE GEOFAB. ENVIROFENCE, OR APPROVED EQUIVALENT.
- MAINTENANCE SHALL BE PERFORMED AS NEEDED AND MATERIAL REMOVED WHEN "BULGES" DEVELOP IN THE SILT FENCE.

### **EROSION CONTROL SILT FENCE DETAIL**

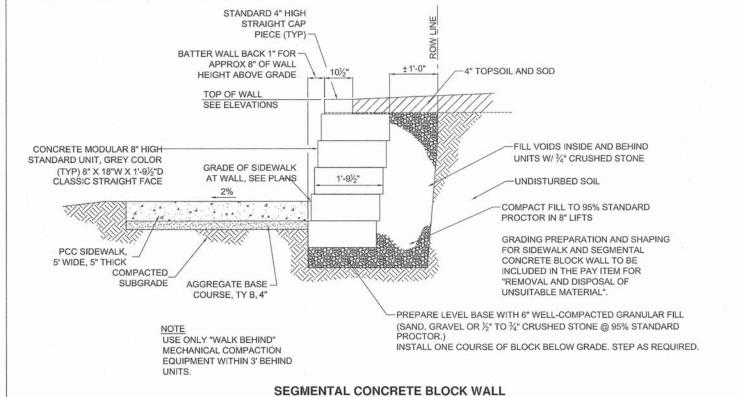

TYPICAL SECTION NOT TO SCALE

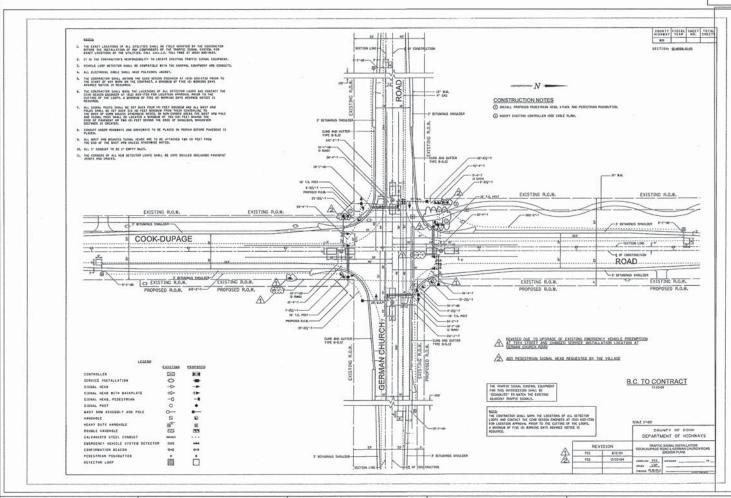


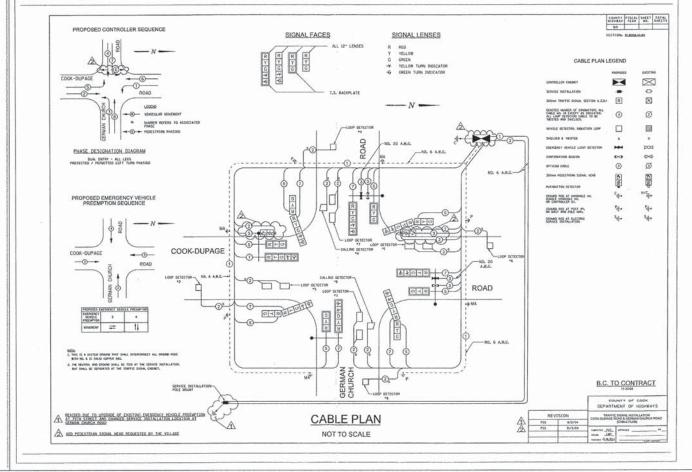


DRAWN REVISED PLOT SCALE = CHECKED -MAP REVISED DATE 01/28/2015

STATE OF ILLINOIS **DEPARTMENT OF TRANSPORTATION** 

DETAILS COOK GERMAN CHURCH ROAD PED IMPROVEMENT | CONTRACT NO. 61B38 SCALE: NONE SHEET 2 OF 3 SHEETS STA. TO STA.

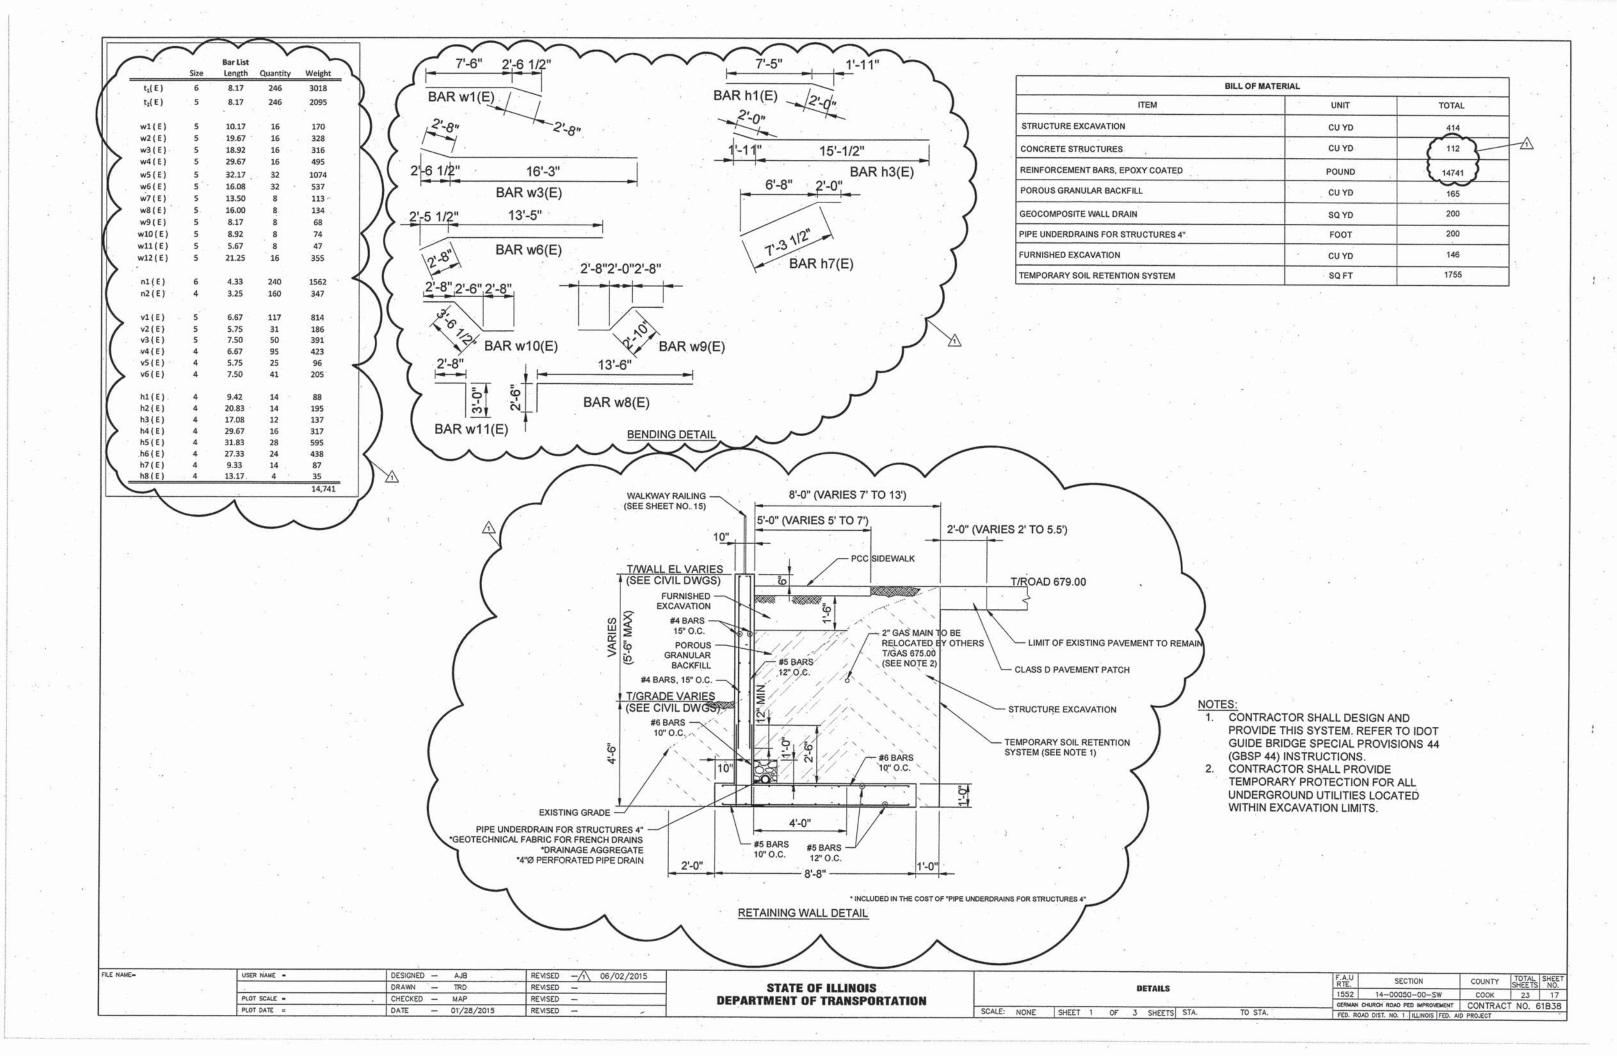

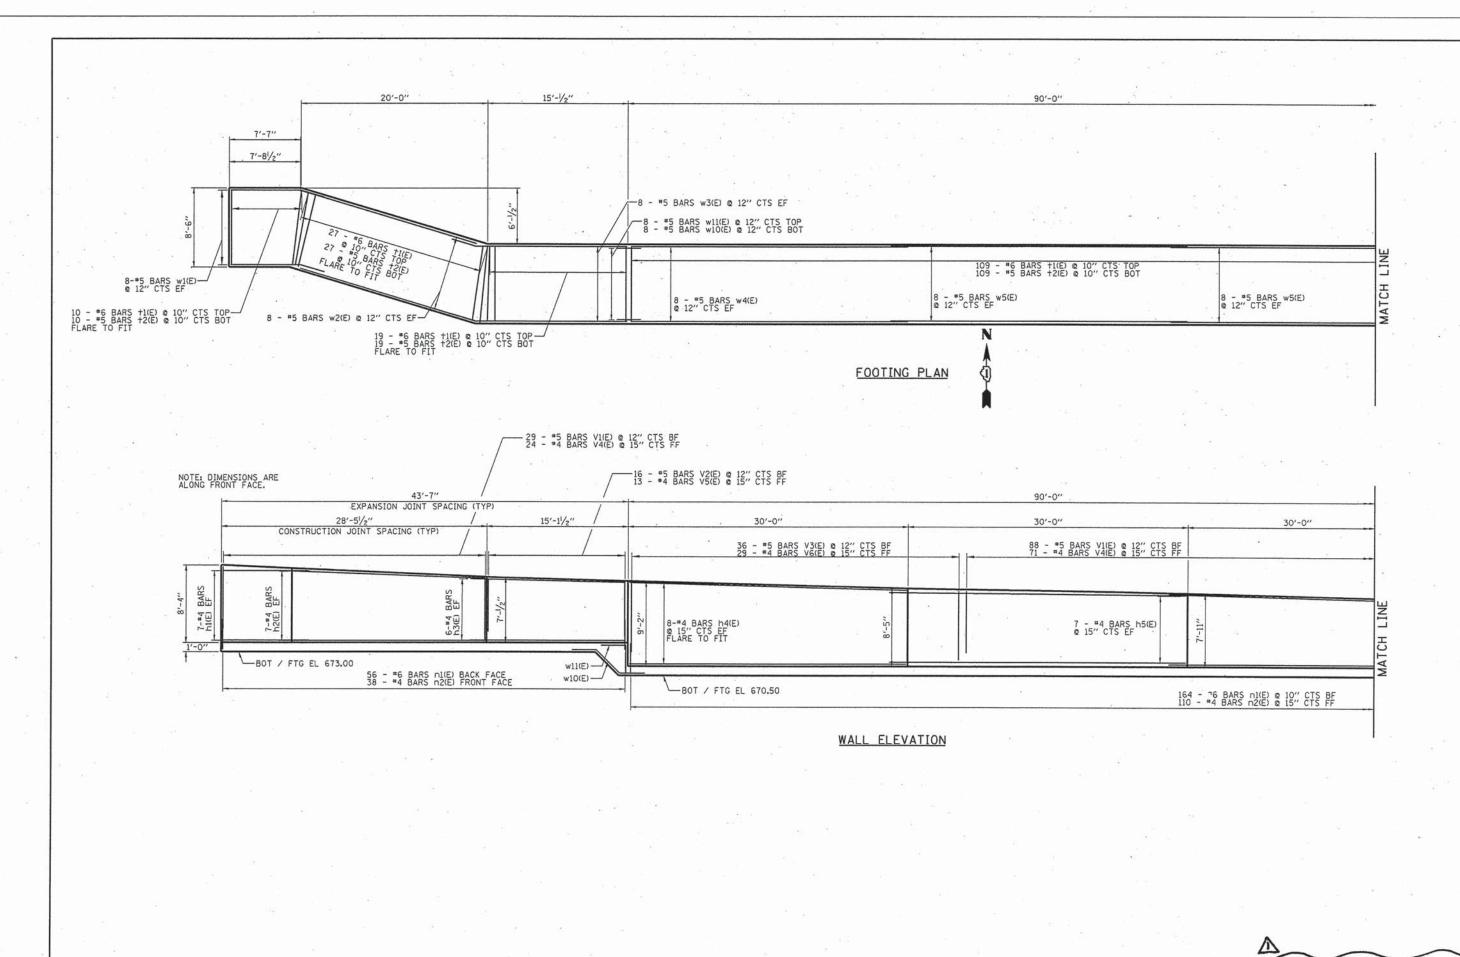


FILE NAME =	USER NAME ≈ mpapirnik .	DESIGNED - JAR	REVISED - 106/02/2015
74445-sht_rwalll.dgn		DRAWN - MAP	REVISED -
	PLOT SCALE = 5.8888 ' / in.	CHECKED - JAR	REVISED -
Sections	PLOT DATE = 6/2/2015	DATE -	REVISED -


STATE OF ILLINOIS
DEPARTMENT OF TRANSPORTATION

RETAINING WALL
PLAN AND ELEVATION


SCALE: 1"=10' SHEET 1 OF 2 SHEETS STA.

TO STA.

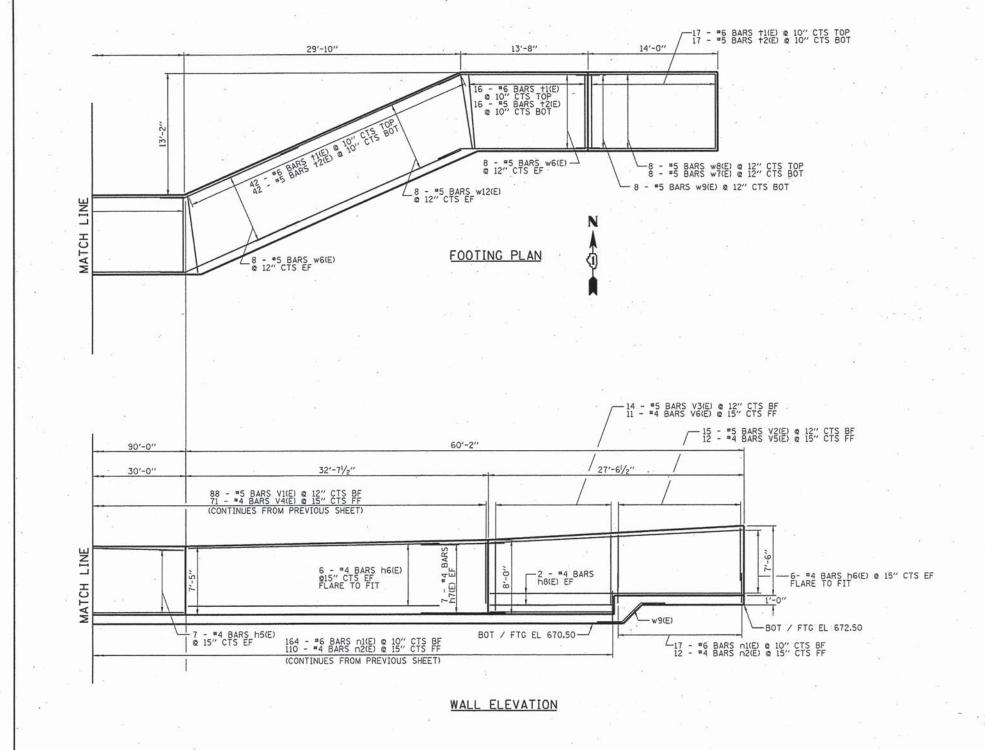

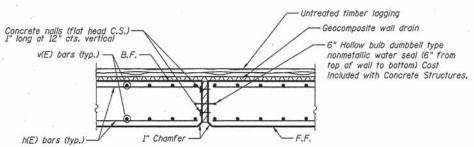


EXPANSION JOINT DETAIL

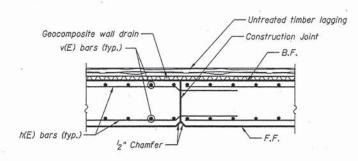

CONSTRUCTION JOINT DETAIL



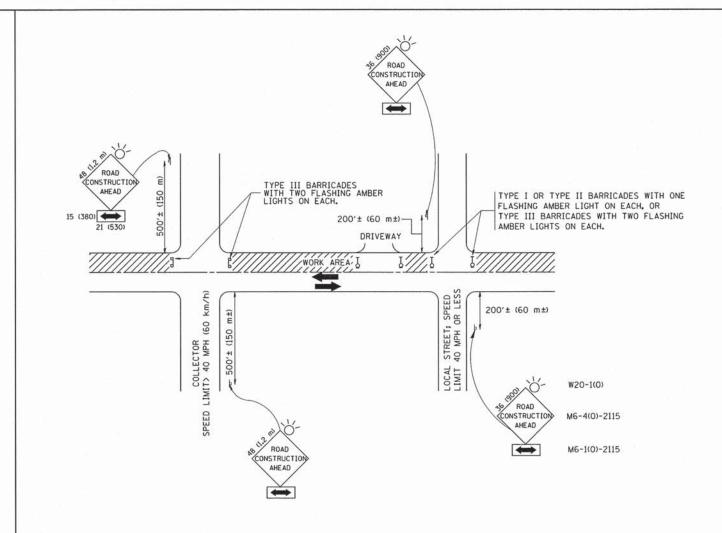

#### TRAFFIC CONTROL AND PROTECTION FOR SIDE ROADS, INTERSECTIONS, AND DRIVEWAYS

### NOTES:

- A. FOR NO LANE RESTRICTION ON THE SIDE ROAD OR DRIVEWAYS
- SIDE ROAD WITH A SPEED LIMIT OF 40 MPH (60 km/h) OR LESS AS SHOWN ON THE DRAWING AND AS DIRECTED BY THE ENGINEER:
- O) ONE ROAD CONSTRUCTION AHEAD SIGN 36 x 36 (900x900) WITH A FLASHER AND FLAG MOUNTED ON IT APPROXIMATELY 200' (60 m) IN ADVANCE OF THE MAIN ROUTE.
- b) THE CLOSED PORTION OF THE MAIN ROUTE SHALL BE PROTECTED BY BLOCKING WITH TYPE I, TYPE II OR TYPE III BARRICADES, 1/3 OF THE CROSS SECTION OF THE CLOSED PORTION.
- SIDE ROAD WITH A SPEED LIMIT GREATER THAN 40 MPH (60 km/h)
  AS SHOWN ON THE DRAWING AND AS DIRECTED BY THE ENGINEER:
- O) ONE ROAD CONSTRUCTION AHEAD SIGN 48 x 48 (1.2 m x 1.2 m) WITH A FLASHER MOUNTED ON IT APPROXIMATELY 500' (150 m) IN ADVANCE OF THE MAIN ROUTE.
- b) THE CLOSED PORTION OF THE MAIN ROUTE SHALL BE PROTECTED BY BLOCKING WITH TYPE III BARRICADES, 1/2 OF THE CROSS SECTION OF THE CLOSED PORTION.
- 3. WHEN THE SIDE ROAD LIES BETWEEN THE BEGINNING OF THE MAINLINE SIGNING AND THE WORK ZONE, A SINGLE HEADED ARROW (MG-1) SHALL BE USED IN LIEU OF THE DOUBLE HEADED ARROW (MG-4).

SCALE: NONE


- B. FOR A LANE CLOSURE ON A SIDE ROAD OR DRIVEWAY:
- USE APPLICABLE PORTIONS OF THE TYPICAL APPLICATION OF TRAFFIC CONTROL DEVICES (STD. 701501, STD. 701606 OR THE APPROPRIATE STANDARD). THE SPACING OF SIGNS AND BARRICADES SHALL BE ADJUSTED FOR FIELD CONDITIONS AS DIRECTED BY THE ENGINEER. THE DIRECTIONAL ARROW SHALL BE COVERED OR REMOVED WHEN NO LONGER CONSISTENT WITH THE SIDE ROAD LANE CLOSURE.
- C. ADVANCE WARNING SIGNS ARE TO BE OMITTED ON DRIVEWAY UNLESS OTHERWISE NOTED.
- D. THE TRAFFIC CONTROL AND PROTECTION FOR SIDE ROADS, INTERSECTIONS, AND DRIVEWAYS SHALL BE INCIDENTAL TO THE COST OF SPECIFIED TRAFFIC CONTROL STANDARDS OR ITEMS.

All dimensions are in millimeters (inches) unless otherwise shown.

FILE NAME =	USER NAME = geglienobt	DESIGNED - LHA	REVISED - J. OBERLE 10-18-95
W:\d:ststd\22×34\tal0.dgn		DRAWN -	REVISED - A. HOUSEH 03-06-96
	PLOT SCALE = 50,000 ' / IN.	CHECKED -	REVISED - A. HOUSEH 10-15-96
	PLOT DATE = 1/4/2008	DATE - 06-89	REVISED -T. RAMMACHER 01-06-00

STATI	E OI	FILLINOIS
DEPARTMENT	OF	TRANSPORTATION


TRAFFIC CONTR	OL AND P	ROTECTION	FOR	F.A RTE.	SECTION	COUNTY	SHEETS	SHEET NO.
CIDE BOADS INTE	DOFOTIONS	AND DOW	TIMAVO	1552	14-00500-00-SW	COOK	23	18
SIDE ROADS, INTE	RSECTIONS	, AND DRIV	EWATS		TC-10	CONTRACT	NO.	61B38
SHEET NO. 1 OF 1	SHEETS	STA.	TO STA.	FED. R	OAD DIST. NO. 1 TILLINOIS FE	D. AID PROJECT		

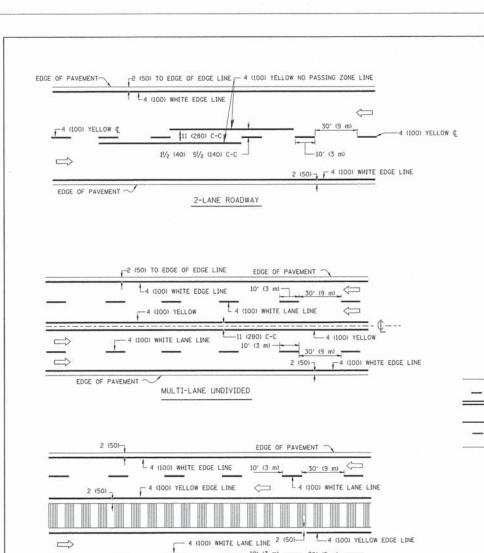


MULTI-LANE DIVIDED
WITH MOUNTABLE MEDIAN
NOTE: MEDIANS WITH BARRIER CURB DO NOT REOUIRE AN EDGE LINE

### TYPICAL LANE AND EDGE LINE MARKING


10' (3 m) 10' | 30' (9 m)

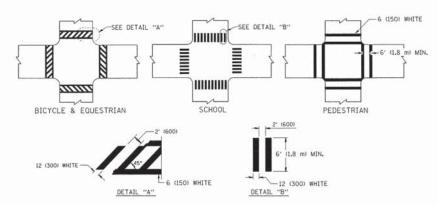

TYPICAL CROSSWALK MARKING

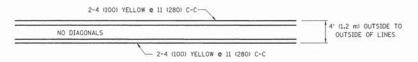


#### 4' (1.2 m) WIDE MEDIANS ONLY

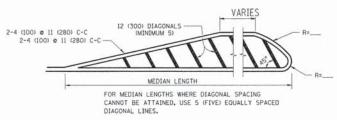

DIAGONAL LINE SPACING: 50' (15 m) C-C (LESS THAN 30MPH (50 km/h))
75' (25 m) C-C 30MPH (50 km/h) TO 45MPH (70 km/h))
150' (45 m) C-C (MORE THAN 45MPH (70 km/h))

#### MEDIANS OVER 4' (1.2 m) WIDE

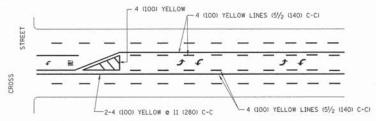


A MINIMUM OF TWO PAIRS OF TURN ARROWS SHALL BE USED, WHITE IN COLOR, ADDITIONAL PAIRS SHALL BE PLACED AT 200' (60 m) TO 300' (90 m) INTERVALS.



MEDIAN WITH TWO-WAY LEFT TURN LANE

### TYPICAL PAINTED MEDIAN MARKING

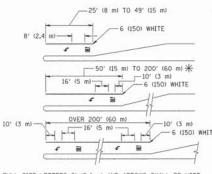



FULL SIZE LETTERS 8' (2.4 m) AND ARROWS SHALL BE USED.  $\P$  AREA = 15.6 SO. FT. (1.5 m² )  $\P$  AREA = 20.8 SO. FT. (1.9 m²)

\* TURN LANES IN EXCESS OF 400' (120 m) IN LENGTH MAY HAVE AN ADDITIONAL SET OF ARROW - "ONLY" INSTALLED MIDWAY BETWEEN THE OTHER TWO SETS OF ARROW - "ONLY".

TYPICAL LEFT (OR RIGHT) TURN LANE

#### TYPICAL TURN LANE MARKING

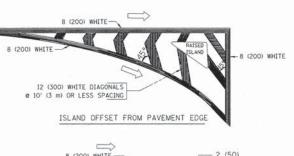

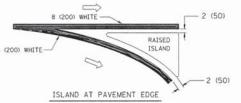

#### TYPICAL ISLAND MARKING

TYPE OF MARKING	WIDTH OF LINE	PATTERN	COLOR	SPACING / REMARKS
CENTERLINE ON 2 LANE PAVEMENT	4 (100)	SKIP-DASH	YELLOW	10' (3 m) LINE WITH 30' (9 m) SPACE
CENTERLINE ON MULTI-LANE UNDIVIDED PAVEMENT	2 @ 4 (100)	SOLID	YELLOW	11 (280) C-C
NO PASSING ZONE LINES: FOR ONE DIRECTION FOR BOTH DIRECTIONS	4 (100) 2 © 4 (100)	SOLID SOLID	YELLOW	5½ (140) C-C FROM SKIP-DASH CENTERLINE 11 (280) C-C OMIT SKIP-DASH CENTERLINE BETWEEN
LANE LINES	4 (100) 5 (125) ON FREEWAYS	SKIP-DASH SKIP-DASH	WHITE WHITE	10' (3 m) LINE WITH 30' (9 m) SPACE
DOTTED LINES (EXTENSIONS OF CENTER, LANE OR TURN LANE MARKINGS)	SAME AS LINE BEING EXTENDED	SKIP-DASH	SAME AS LINE BEING EXTENDED	2' (600) LINE WITH 6' (1.8 m) SPACE
EDGE LINES	4 (100)	SOLID	YELLOW-LEFT WHITE-RIGHT	OUTLINE MOUNTABLE MEDIANS IN YELLOW: EDGE LINES ARE NOT USED NEXT TO BARRIER CURB
TURN LANE MARKINGS	6 (150) LINE: FULL SIZE LETTERS & SYMBOLS (8' (2.4m))	SOLID	WHITE	SEE TYPICAL TURN LANE MARKING DETAIL
TWO WAY LEFT TURN MARKING	2 & 4 (100) EACH DIRECTION	SKIP-DASH AND SOLID	YELLOW	10' (3 m) LINE WITH 30' (9 m) SPACE FOR SKIP-DASH; 5½ (140) C-C BETWEEN SOLID LINE AND SKIP-DASH LINE
	8' (2.4m) LEFT ARROW	IN PAIRS	WHITE	SEE TYPICAL TWO-WAY LEFT TURN MARKING DETAIL
CROSSWALK LINES (PEDESTRIAN) A. DIAGONALS (BIKE & EQUESTRIAN) B. LONGITUDINAL BARS (SCHOOL)	2 © 6 (150) 12 (300) © 45° 12 (300) © 90°	SOLID SOLID SOLID	WHITE WHITE WHITE	NOT LESS THAN 6' (I.8 m) APART 2' (500) APART 2' (600) APART SEE TYPICAL CROSSWALK MARKING DETAILS.
STOP LINES	24 (600)	SOLID	WHITE	PLACE 4' (1.2 m) IN ADVANCE OF AND PARALLEL TO CROSSWALK, IF PRESENT, OTHERWISE, PLACE AT DESIRED STOPPING POINT. PARALLEL TO CROSSROAD CENTERLINE, WHERE POSSIBLE
PAINTED MEDIANS	2 @ 4 (100) WITH 12 (300) DIAGONALS @ 45° NO DIAGONALS USED FOR 4' (1.2 m) WIDE MEDIANS	SOLID	YELLOW: TWO WAY TRAFFIC WHITE: ONE WAY TRAFFIC	11 (280) C-C FOR THE DOUBLE LINE SEE TYPICAL PAINTED MEDIAN MARKING.
GORE MARKING AND CHANNELIZING LINES	8 (200) WITH 12 (300) DIAGONALS @ 45°	SOLID	WHITE	DIAGONALS: 15' (4,5 m) C-C (LESS THAN 30MPH (50 km/h)) 20' (6 m) C-C 30MPH (50 km/h) TO 45MPH (70 km/h)) 30' (9 m) C-C (0VER 45MPH (70 km/h))
RAILROAD CROSSING	24 (600) TRANSVERSE LINES: "RR" IS 6' (1.8 m) LETTERS; 16 (400) LINE FOR "X"	SOLID	WHITE	SEE STATE STANDARD 780001 AREA OF: "R"=3.6 SO. FT. (0.33 m²) EACH "X"=54,0 SO. FT. (5.0 m²)
SHOULDER DIAGONALS	12 (300) @ 45°	SOLID	WHITE - RIGHT YELLOW - LEFT	50' (15 m) C-C (LESS THAN 30MPH (50 km/h)) 75' (25 m) C-C (30 MPH (50 km/h) T0 45MPH (70 km/h) 150' (45 m) C-C (OVER 45MPH (70 km/h))


FOR FURTHER DETAILS ON PAVEMENT MARKING REFER TO STANDARD SPECIFICATIONS FOR ROAD AND BRIDGE CONSTRUCTION AND STATE STANDARD 780001.

All dimensions are in inches (millimeters) unless otherwise shown.

FILE NAME =	USER NAME = drivekosgn	DESIGNED - EVERS	REVISED -T. RAMMACHER 10-27-94
c:\pw_work\pwidot\drivakosgn\d0108315\tc	3.dgn	DRAWN -	REVISED -C. JUCIUS 09-09-09
	PLOT SCALE = 50.000 ' / IN.	CHECKED -	REVISED -
	PLOT DATE = 9/9/2009	DATE - 03-19-90	REVISED -

STATE	: 01	ILLINOIS
DEPARTMENT	0F	TRANSPORTATION

DISTRICT ONE						SECTION	COUNTY	TOTAL SHEETS	SHEET NO.
					1552	14-00500-00-SW	COOK	23	19
TYPICAL PAVEMENT MARKINGS						TC-13	CONTRACT	NO.	61B38
SCALE: NONE	SHEET NO. 1 OF 1	EET NO. 1 OF 1 SHEETS STA. TO STA. FED. ROAD DIST. NO. 1   ILLINOIS FED. AID PROJECT							

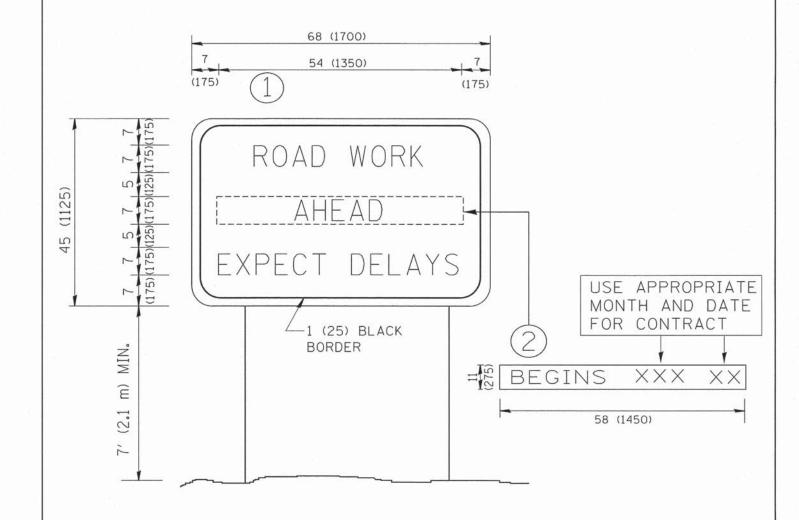



## NOTES:


- 1. USE BLACK LETTERING ON ORANGE BACKGROUND.
- 2. ERECT SIGNS IN ADVANCE OF THE LOCATION FOR THE "ROAD CONSTRUCTION AHEAD" SIGN AT LOCATIONS AS DIRECTED BY THE ENGINEER.
- 3. ERECT SIGN (1) WITH INSTALLED PANEL (2) ONE WEEK PRIOR TO THE START OF CONSTRUCTION.
- 4. REMOVE PANEL (2) SOON AFTER THE START OF CONSTRUCTION.
- 5. SEE SPECIAL PROVISION FOR "TEMPORARY INFORMATION SIGNING" FOR ADDITIONAL INFORMATION.
- 6. ONE SIGN ASSEMBLY EQUALS 25.70 SQ. FT. (2.3 SQ. M.)
- 7. SHALL BE PAID FOR AS TEMPORARY INFORMATION SIGNING.


ALL DIMENSIONS ARE IN INCHES (MILLIMETERS) UNLESS OTHERWISE SHOWN.

FILE NAME =	USER NAME = geglienobt	DESIGNED -	REVISED - R. MIRS 09-15-97			ARTERIAL ROAD		F.A.	SECTION	COUNTY	SHEETS NO.
W:\diststd\22x34\tc22.dgn		DRAWN -	REVISED - R. MIRS 12-11-97	STATE OF ILLINOIS				1552	14-00500-00-SW	COOK	23 20
li .	PLOT SCALE = 50.000 ' / IN.	CHECKED -	REVISED -T. RAMMACHER 02-02-99	DEPARTMENT OF TRANSPORTATION		INFORMATION SIGN			TC-22	CONTRAC	T NO. 61B38
	PLOT DATE = 1/4/2008	DATE -	REVISED - C. JUCIUS 01-31-07		SCALE: NONE	SHEET NO. 1 OF 1 SHEETS STA.	TO STA.	FED. ROA	AD DIST. NO. 1   ILLINOIS FED.	AID PROJECT	

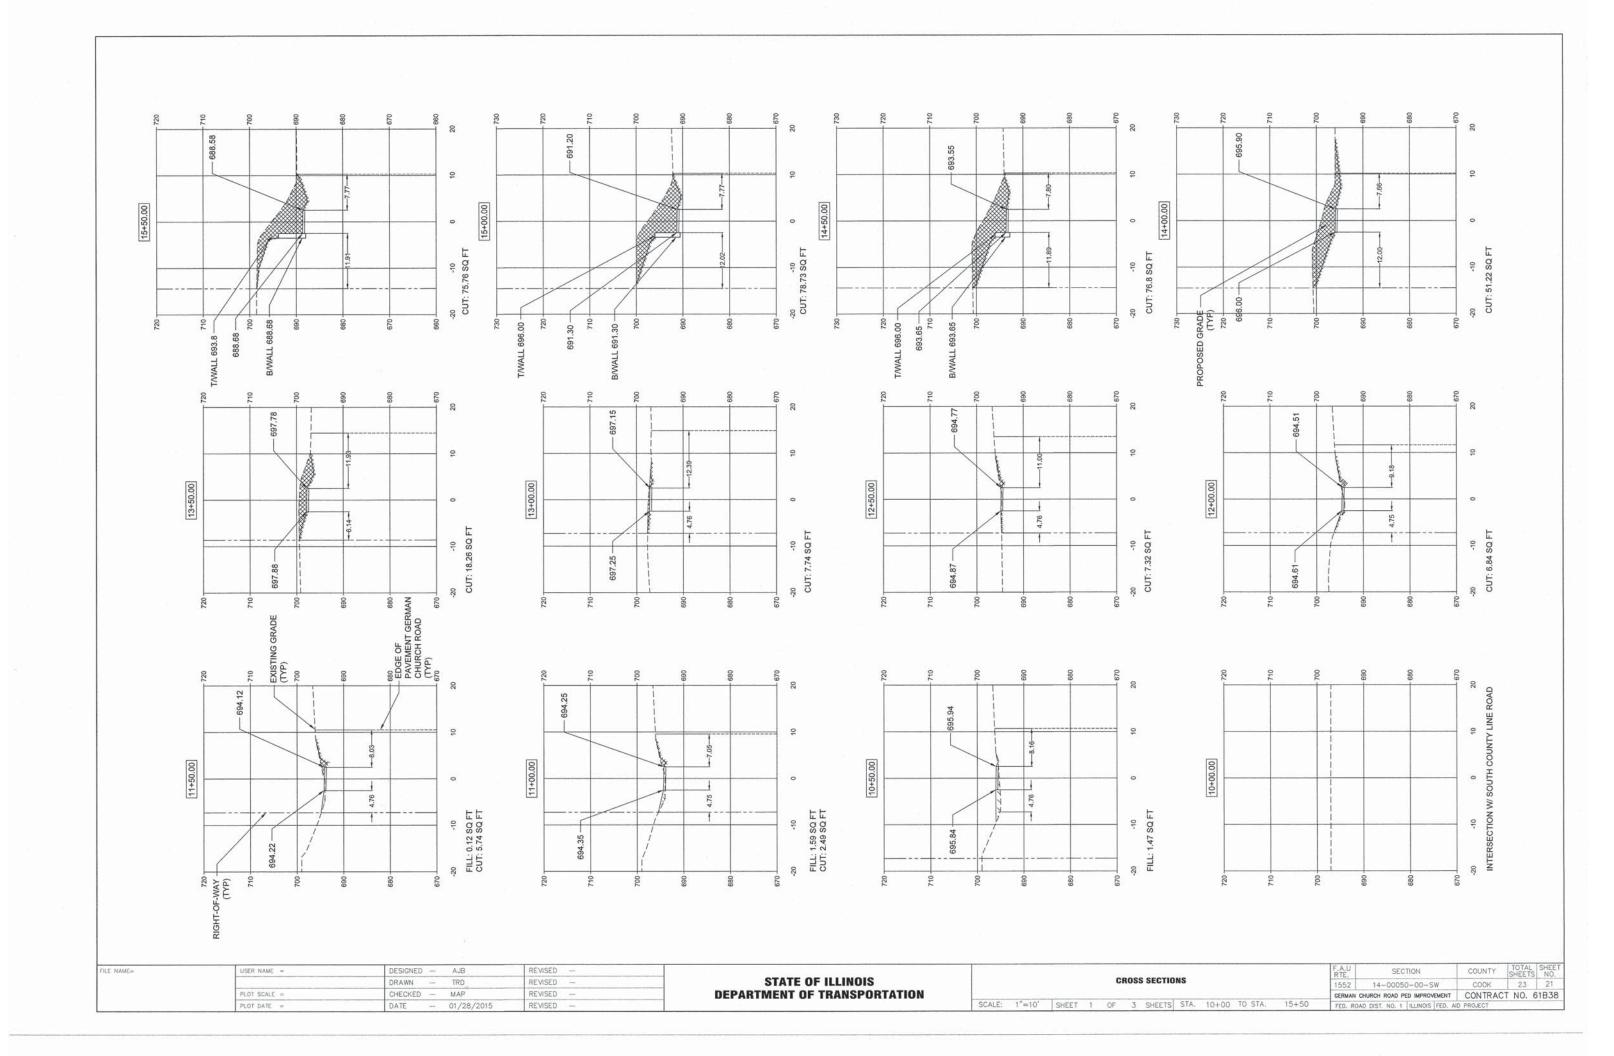

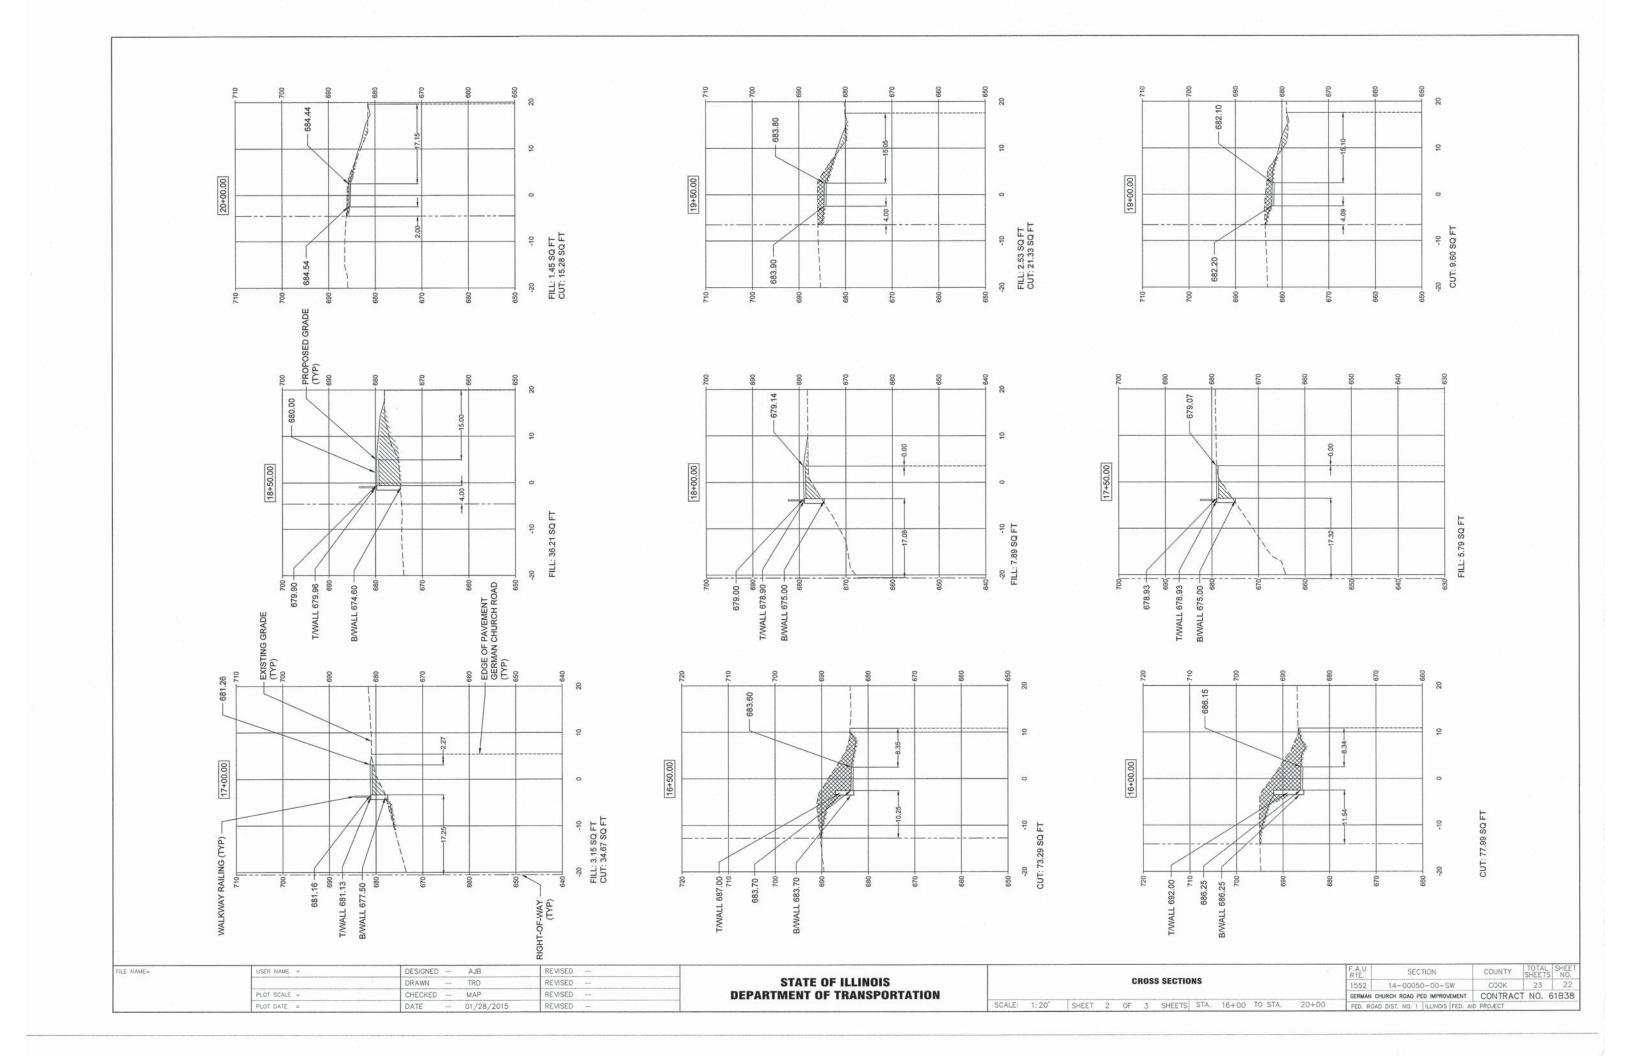

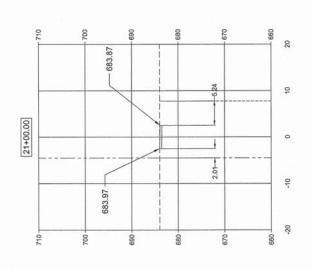

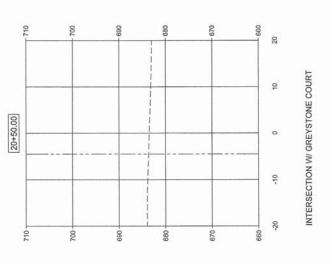

FILE NAME=	USER NAME =	DESIGNED — AJB	REVISED —			F.A.U SECTION	COUNTY TOTAL SHEET NO.
		DRAWN - TRD	REVISED —	STATE OF ILLINOIS	CROSS SECTIONS	1552 14-00050-00-SW	COOK 23 23
1	PLOT SCALE =	CHECKED - MAP	REVISED —	DEPARTMENT OF TRANSPORTATION		GERMAN CHURCH ROAD PED IMPROVEMENT	CONTRACT NO. 61B38
	PLOT DATE =	DATE - 01/28/2015	REVISED -		SCALE: 1:20' SHEET 3 OF 3 SHEETS STA. 20+50 TO STA. 21+00	FED. ROAD DIST, NO. 1 ILLINOIS FED. A	AID PROJECT