INDEX OF SHEETS ON SHEET NO. 2

STATE OF ILLINOIS DEPARTMENT OF TRANSPORTATION DIVISION OF HIGHWAYS PLANS FOR PROPOSED FEDERAL AID PROJECT LOCAL AGENCY PAVEMENT PRESERVATION (LAPP) FAU ROUTE 2713 (WESTCHESTER BOULEVARD)

DESIGN DESIGNATION COLLECTOR

POSTED SPEED LIMIT = 25 MPH **DESIGN SPEED LIMIT = 30 MPH**

TRAFFIC DATA ADT (2009) = 3,300

> PROJECT LOCATED IN THE VILLAGE OF WESTCHESTER



Know what's **below**. **Call** before you dig.

SCALE: 1" = 10'

SCALE: 1" = 20'

SCALE: 1" = 30'

SCALE: 1" = 40'

FULL SIZE PLANS HAVE BEEN PREPARED USING STANDARD

ENGINEERING SCALES. REDUCED SIZED PLANS WILL NOT

ON REDUCED PLANS, THE ABOVE SCALES MAY BE USED.

CONFORM TO STANDARD SCALES. IN MAKING MEASUREMENTS


SCALE: 1" = 50"

CONTRACT NO. 63257

PROJECT BEGINS

STATION 2+10

CANTERBURY STREET TO ROOSEVELT ROAD SECTION NO. 09-00074-00-RS PROJECT ARA-9003(324) VILLAGE OF WESTCHESTER COOK COUNTY JOB NO. C-91-631-09

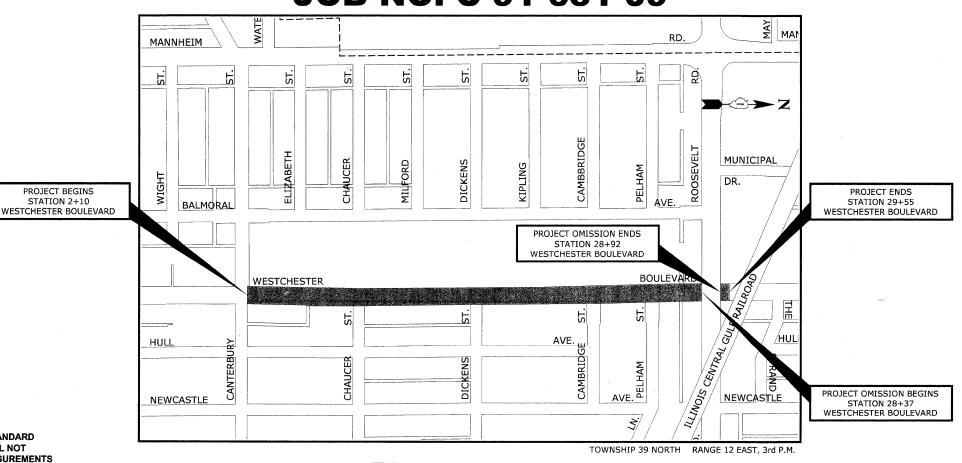

- AREA OF IMPROVEMENT **NOT TO SCALE** GROSS LENGTH OF IMPROVEMENT = 2,745 FT = 0.52 MI. **NET LENGTH OF IMPROVEMENT = 2.690 FT = 0.51 MI.**

FAU 2713 09-00074-00-RS COOK

ILLINOIS PROJECT ARA-9003(324)

LOCATION OF SECTION INDICATED THUS:

STATE OF ILLINOIS ILLINOIS DEPARTMENT OF TRANSPORTATION **DIVISION OF HIGHWAYS** M. O'Krafer (PRINTED BY AUTHORITY OF THE STATE OF ILLINOIS

07-14-09 LICENSE EXPIRES:

EDWIN HANCOCK ENGINEERING COMPANY 9933 ROOSEVELT ROAD PHONE: (708) 865-0300 WESTCHESTER, ILLINOIS 60154

DISTRICT ONE - DETECTOR LOOP INSTALLATION DETAILS FOR ROADWAY RESURFACING (TS 07)

I.D.O.T. STANDARD DRAWINGS

STANDARD NO	D. TITLE OR DESCRIPTION
000001-05	STANDARD SYMBOLS, ABBREVIATIONS AND PATTERNS
424001-05	CURB RAMPS FOR SIDEWALKS
442101-07	CLASS B PATCHES
604001-03	FRAMES AND LIDS, TYPE 1
701301-03	LANE CLOSURE, 2-LANE, 2-WAY, SHORT TIME OPERATIONS
701501-05	URBAN LANE CLOSURE, 2-LANE, 2-WAY, UNDIVIDED
701606-06	URBAN LANE CLOSURE, MULTILANE, 2-WAY, WITH MOUNTABLE MEDIAN
701701-06	URBAN LANE CLOSURE, MULTILANE INTERSECTION
701801-04	LANE CLOSURE, MULTILANE, 1W OR 2W CROSSWALK OR SIDEWALK CLOSURE
701901-01	TRAFFIC CONTROL DEVICES
780001-02	TYPICAL PAVEMENT MARKINGS
886006-01	TYPICAL LAYOUTS FOR DETECTION LOOPS

LEGEND OF SYMBOLS

(TO BE USED IN CONJUNCTION WITH I.D.O.T. STANDARD 000001-05)

SYMBOL	DESCRIPTION
В	EXISTING HOT-MIX ASPHALT AREA
C	EXISTING CONCRETE AREA
G	EXISTING GRASS AREA
T + + +	PROPOSED HOT-MIX ASPHALT BUTT JOINT
+ + +	EXISTING CONCRETE SIDEWALK OR DRIVEWAY REMOVAL
292	PROPOSED CONCRETE AREA, 5" SIDEWALK, 7" DRIVEWAY PROPOSED HOT-MIX ASPHALT PAVING AREA
	PROPOSED CLASS C PATCHES
00000	PROPOSED DETECTABLE WARNINGS
A	STRUCTURE TO BE ADJUSTED
Δ*	STRUCTURE TO BE ADJUSTED (SPECIAL)
1C	NEW FRAME AND LID, TYPE 1, CLOSED LID
1P	NEW FRAME AND LID, TYPE 1, OPEN LID
Ø	EXISTING DOMESTIC WATER SERVICE BOX
A	EXISTING FIRE HYDRANT
8	EXISTING WATER VALVE BOX
	EXISTING WATER MAIN VALVE VAULT
	EXISTING STORM SEWER INLET
\circ	EXISTING STORM SEWER CATCH BASIN
(a)	EXISTING SEWER MANHOLE
\$	EXISTING STREET LIGHT POLE
Ø	EXISTING POWER POLE
○ Þ	EXISTING TRAFFIC SIGNAL POLE
O 4	EXISTING TRAFFIC SIGNAL MAST ARM
	EXISTING HANDHOLE
	DOUBLE HANDHOLE
\boxtimes	EXISTING TRAFFIC SIGNAL OR STREET LIGHT CONTROLLER
S	EXISTING TRAFFIC SIGNAL MANHOLE
	EXISTING CURB AND GUTTER

PROPOSED COMBINATION CONCRETE CU	RB
AND GUTTER REMOVAL AND REPLACEME	ŀΝΤ

DESIGNED TG REVISED DRAWN TG REVISED 9933 Rosevelt Reed
PLOT SCALE
Phone: 198/855-0300
Fat: 198/955-1212
PLOT DATE CHECKED JG REVISED 07/14/09 REVISED

STATE OF ILLINOIS DEPARTMENT OF TRANSPORTATION INDEX OF SHEETS, I.D.O.T. STANDARD DRAWINGS. **AND LEGEND OF SYMBOLS**

SHEET NO. OF SHEETS STA.

SCALE: NONE

COUNTY FAU 2713 COOK 18 2 CONTRACT NO. 63257

FED. ROAD DIST. NO. 1 ILLINOIS FED. AID PROJECT ARA-9003(324)

E.H.E. PROJECT NO. 838-09-10201

REFERENCES TO STANDARDS THROUGHOUT THE PLANS OR SPECIAL PROVISIONS SHALL BE INTERPRETED TO BE THE LATEST STANDARD OF THE ILLINOIS DEPARTMENT OF TRANSPORTATION AS SHOWN ON THE INDEX OF SHEETS IN THE PLANS. ALL CONSTRUCTION SHALL BE DONE IN ACCORDANCE WITH THE STANDARD SPECIFICATIONS FOR ROAD AND BRIDGE CONSTRUCTION ADOPTED JANUARY 1, 2007, THE "SUPPLEMENTAL SPECIFICATIONS AND RECURRING SPECIAL PROVISIONS" ADOPTED JANUARY 1, 2009, THE LATEST EDITION OF THE "ILLINOIS MANUAL ON UNIFORM TRAFFIC CONTROL DEVICES FOR STREETS AND HIGHWAYS," "THE STANDARD SPECIFICATIONS FOR WATER AND SEWER MAIN CONSTRUCTION IN ILLINOIS" MAY 1996 FIFTH EDITION, THE "DETAILS" IN THE PLANS, AND THE "SPECIAL PROVISIONS" INCLUDED IN THE CONTRACT DOCUMENTS

UNDERGROUND UTILITIES

BEFORE STARTING EXCAVATION, THE CONTRACTOR SHALL CALL "JULIE" AT 811 FOR FIELD LOCATIONS OF BURIED ELECTRICAL, TELEPHONE AND GAS FACILITIES. (48 HOURS NOTIFICATION IS REQUIRED).

THE LOCATIONS OF THE UNDERGROUND UTILITIES IF SHOWN ON THE PLANS HAVE BEEN OBTAINED BY FIELD SURVEYS AND SEARCHES OF AVAILABLE RECORDS. IT IS BELIEVED THAT DATA IS ESSENTIALLY CORRECT, BUT THE VILLAGE OF WESTCHESTER, THE ILLINOIS DEPARTMENT OF TRANSPORTATION AND/OR OTHER OFFICES AND AGENCIES ASSOCIATED WITH THE DEVELOPMENT OF THESE PLANS DO NOT GUARANTEE THEIR ACCURACY OR COMPLETENESS. THE CONTRACTOR WILL BE REQUIRED TO VERIFY THE EXACT LOCATION OF EACH FACILITY WITH THE UTILITY COMPANY, AND SHALL TAKE DUE CARE IN ALL PHASES OF THE CONSTRUCTION TO PROTECT ANY SUCH FACILITIES WHICH MAY BE AFFECTED BY THE WORK. ANY DAMAGE TO EXISTING UTILITIES SHALL BE REPAIRED AT THE CONTRACTOR'S EXPENSE.

THE CONTRACTOR SHALL COORDINATE CONSTRUCTION ACTIVITIES WITH UTILITY COMPANIES AND THE VILLAGE OF WESTCHESTER.

FRAMES AND LIDS

THE TYPE OF FRAMES AND LIDS REQUIRED FOR ALL MANHOLES AND VALVE VAULTS LISTED IN THE SUMMARY OF QUANTITIES MAY BE FOUND ON THE PLANS AT THEIR RESPECTIVE LOCATIONS. WHERE LIDS ARE CALLED FOR ON THE PLANS, THEY SHALL BE IN ACCORDANCE WITH ARTICLE 604.04 OF THE STANDARD SPECIFICATIONS AND THE TERM LID IS USED IN LIEU OF GRATE. ALL LIDS ON SANITARY MANHOLES, COMBINED SEWER MANHOLES, AND VALVE VAULTS SHALL BE OF THE SELF SEALING TYPE.

ON ALL IMPROVEMENTS, THE FRAMES AND LIDS OF EXISTING CATCH BASINS, INLETS, MANHOLES, AND VALVE VAULTS WHICH ARE TO BE ABANDONED DUE TO CONSTRUCTION OF THIS IMPROVEMENT ARE TO REMAIN THE PROPERTY OF THE VILLAGE OF WESTCHESTER AND BE SALVAGED. THESE ITEMS SHALL BE DELIVERED TO THE VILLAGE OF WESTCHESTER PUBLIC WORKS DEPARTMENT.

MANHOLE OR VALVE COVERS

THE WORD "WATER", "SANITARY", OR "STORM" SHALL BE CAST INTO THE LID OF EACH RESPECTIVE MANHOLE OR VALVE VAULT.

MAINTENANCE OF SEWER FLOWS

THE CONTRACTOR SHALL CONDUCT HIS/HER OPERATIONS TO MAINTAIN AT ALL TIMES FLOW THROUGH EXISTING STORM AND SANITARY SEWER SYSTEMS. HE/SHE SHALL ALSO PROVIDE AND MAINTAIN AN EFFICIENT PUMPING PLANT IF NECESSARY AND A TEMPORARY OUTLET AND BE PREPARED AT ALL TIMES TO DISPOSE OF THE WATER COLLECTED IN A SAFE MANNER WITHOUT DAMAGE OF ANY KIND TO ADJACENT PROPERTIES. THE ENDS OF EXISTING DRAINAGE LINES WHICH ARE NOT TO BE INCORPORATED INTO THE PROJECT ARE TO BE SEALED AS SPECIFIED IN THE SPECIAL PROVISIONS. EXISTING STRUCTURES ARE TO BE INSPECTED BEFORE CONSTRUCTION STARTS - ACCUMULATION OF MATERIAL IN THE STRUCTURE DUE TO CONSTRUCTION OPERATIONS SHALL BE REMOVED BY THE CONTRACTOR AT HIS/HER EXPENSE.

MAINTENANCE OF EXISTING DRAINAGE STRUCTURES

WHEN DURING THE CONSTRUCTION OPERATIONS, LOOSE MATERIAL IS DEPOSITED IN THE FLOW LINE OF GUTTERS AND DRAINAGE STRUCTURE SO THAT THE NATURAL FLOW OF WATER IS OBSTRUCTED, IT SHALL BE REMOVED AT THE CLOSE OF EACH WORKING DAY. AT THE CONCLUSION OF THE CONSTRUCTION OPERATIONS, ALL DRAINAGE FACILITIES SHALL BE CLEAN AND FREE OF ALL OBSTRUCTIONS DUE TO CONSTRUCTION OPERATIONS. THE COST OF THIS WORK SHALL BE INCLUDED IN THE COST OF THE CONTRACT.

SAW CUTTING

THE CONTRACTOR SHALL SAW CUT ASPHALT PAVEMENT AS INDICATED ON THE PLANS TO SEPARATE THE EXISTING PAVEMENT TO BE REMOVED BY APPROVED MEANS OR AN APPROVED CONCRETE SAW TO A DEPTH AS DIRECTED BY THE ENGINEER. SUITABLE GUIDELINES OR DEVICES SHALL BE USED TO ASSURE CUTTING A NEAT, STRAIGHT LINE AS SHOWN ON THE PLANS. CARE SHALL BE TAKEN BY THE CONTRACTOR NOT TO DAMAGE THE REMAINING PAVEMENT DIRECTLY ADJACENT TO THE PAVEMENT TO BE REMOVED. DAMAGE TO THE EXISTING PAVEMENT RESULTING FROM PAVEMENT REMOVAL OPERATIONS SHALL BE REPAIRED AT THE CONTRACTOR'S EXPENSE. THE COST OF SAW CUTTING DESCRIBED ABOVE SHALL BE INCLUDED IN THE COST OF ITEM BEING REMOVED.

FRAMES AND LIDS TO BE ADJUSTED (SPECIAL)

THIS ITEM ONLY PERTAINS TO STRUCTURES LOCATED IN THE CONCRETE OR HOT-MIX ASPHALT ROADWAY PAVEMENT AREAS THAT WILL REQUIRE CONCRETE OR HOT-MIX SURFACE REMOVAL. THE ENGINEER WILL MARK IN THE FIELD ALL STRUCTURES TO BE DONE UNDER THIS ITEM. SEE DETAIL SHEET FOR "FRAMES AND LIDS ADJUSTMENT WITH MILLING."

PRIME COAT

PRIME COAT MUST BE INSTALLED NO EARLIER THAN TWENTY-FOUR (24) HOURS PRIOR TO PLACEMENT OF HOT-MIX ASPHALT.

FIELD OFFICE

THE CONTRACTOR WILL NOT BE ALLOWED TO SET UP A YARD OR FIELD OFFICE ON STATE OR VILLAGE PROPERTY ROW WITHOUT WRITTEN PERMISSION FROM THE DEPARTMENT OR THE VILLAGE .

BARRICADES

THE CONTRACTOR SHALL PROVIDE AND INSTALL TWO (2) WEIGHTED SANDBAGS ON EACH TYPE I OR TYPE II BARRICADE USED, ONE (1) WEIGHTED SANDBAG ACROSS EACH BOTTOM RAIL

BUTT JOINTS

BUTT JOINTS WILL BE INSTALLED AT THE ENDS OF ALL RESURFACING (WHERE RESURFACING MEETS EXISTING PAVEMENT). IN ACCORDANCE WITH THE "BUTT JOINT AND HMA TAPER DETAILS" SHEET INCLUDED IN THE PLANS, UNLESS OTHERWISE SPECIFIED.

MILLED PAVEMENT OPEN TO TRAFFIC

SCALE: NONE

WHEN MILLED PAVEMENT IS OPEN TO TRAFFIC THE MAXIMUM GRADE DIFFERENTIAL BETWEEN PASSES OF THE MILLING MACHINE SHALL NOT EXCEED 1-1/2 INCHES (40 MM) WHERE THE SPEED LIMIT IS 45 MPH (80 KM/H) OR LESS AND 1 INCH (25 MM) WHERE THE SPEED LIMIT IS GREATER THAN 45 MPH (80 KM/H). WITH WRITTEN APPROVAL FROM THE ENGINEER, A MAXIMUM GRADE DIFFERENTIAL OF 3 INCHES (75 MM) MAY BE ALLOWED IF THE EDGE OF THE MILLING IS SLOPED A MINIMUM 1:3 (V:H)

PAVING OPERATIONS

FROM STATION 2+10 TO STATION 26+15 THE CONTRACTOR MUST PAVE THE ROADWAY (19' E-E) ON EACH SIDE OF THE LANDSCAPED MEDIAN IN ONE PASS.

PAVEMENT PATCHING

LOCATIONS OF PATCHES ON PLANS ARE APPROXIMATE. EXACT LOCATIONS WILL BE DETERMINED IN FIELD BY ENGINEER. HIGH-EARLY-STRENGTH PORTLAND CEMENT CONCRETE (PP 3200PSI IN FORTY-EIGHT (48) HOURS) SHALL BE USED.

TTANCOCK	USER NAME	DESIGNED TG	REVISED	
ENGINEERING		DRAWN TG	REVISED	
◆ Civil Engineers Watchester, Ellinois 40154-2790 Municipal Consultants Phon: 78785-000	PLOT SCALE	CHECKED JG	REVISED	
◆ Municipal Consultants Phon: 708/365-6000 ◆ Established 1911 Fax: 708/365-1212	PLOT DATE	DATE 07/14/09	REVISED	

STAT	E OF	ILLINO	S
DEPARTMENT	OF T	RANSPO	RTATION

- ★ DENOTES SPECIALTY ITEM
- DENOTES THAT A SPECIAL PROVISION HAS BEEN PROVIDED

HANCOCI ENGINEERIN	IG.
◆ Civil Engineers	903 Westchester, II
♦ Municipal Consultants	Weskinster, 11
◆ Established 1911	


	USER NAME	DESIGNED	TG	REVISED	
		DRAWN	TG	REVISED	
1 Reserveit Road Intels 60154-2780	PLOT SCALE	CHECKED	JG	REVISED	
ne: 709/865-0300 sx: 708/865-1212	PLOT DATE	DATE	07/14/09	REVISED	

STATE OF ILLINOIS
DEPARTMENT OF TRANSPORTATION

 SUMMARY OF QUANTITIES
 NO. FAU 2713
 0

 SCALE: NONE
 SHEET NO. OF SHEETS STA. TO STA.
 FED. ROAD DIST, NO.

EXISTING TYPICAL SECTION WESTCHESTER BOULEVARD STATION 2+10 TO STATION 24+93

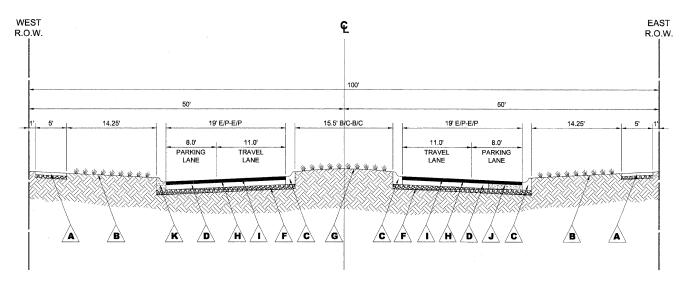


PROPOSED TYPICAL SECTION **WESTCHESTER BOULEVARD** STATION 2+10 TO STATION 24+93

LEGEND OF SYMBOLS

SYMBOL	DESCRIPTION	SYMBOL	DESCRIPTION
A	EXISTING PORTLAND CEMENT CONCRETE SIDEWALK	G	EXISTING LANDSCAPED MEDIAN
B	EXISTING SODDED PARKWAY	H	PROPOSED LEVELING BINDER, 1"
C	EXISTING COMBINATION CONCRETE CURB & GUTTER, TYPE B-6.12	1	PROPOSED HOT-MIX ASPHALT COURSE, 2"
D	EXISTING PORTLAND CEMENT CONCRETE BASE COURSE, 7"	À	PROPOSED CLASS B PATCH, 7"
E	EXISTING HOT-MIX ASPHALT BINDER & SURFACE COURSES, 3"	K	PROPOSED INTERMITTENT COMBINATION CONCRETE CURB AND GUTTER REMOVAL AND REPLACEMENT
F	EXISTING SUB-BASE GRANULAR MATERIAL, TYPE B, 4"		

WEST EAST R.O.W. R.O.W. 52' E/P-E/P 12.0' 12.0' LEFT TURN RIGHT TURN TRAVEL TRAVEL LANE LANE BBBBBB AND THE RESIDENCE OF THE PARTY A **∠c**\ E F E D /c\ B

EXISTING TYPICAL SECTION WESTCHESTER BOULEVARD STATION 24+93 TO STATION 28+37 STATION 28+92 TO STATION 29+55

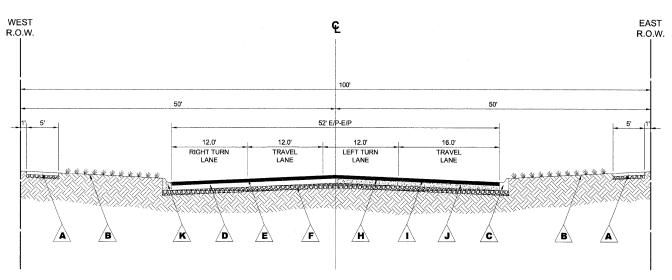

PROPOSED TYPICAL SECTION **WESTCHESTER BOULEVARD STATION 24+93 TO STATION 28+37 STATION 28+92 TO STATION 29+55**


HOT-MIX ASPHALT (HMA) MIXT	URE REQUIR	EMENTS
ITEM	A C TYPE	VOIDS
RESURFACING		
HOT-MIX ASPHALT SURFACE COURSE, MIX "D", N50, (IL - 9.5 mm)	PG 64 - 22	4% @ 50 GYR.
LEVELING BINDER (MACHINE METHOD), N50 (IL - 9.5 mm)	PG 64 - 22 *	4% @ 50 GYR.
PATCHING		
BITUMINOUS MIXTURE FOR PATCHING POTHOLES (HOT MIX), MIX "C", N50	PG 64 - 22	4% @ 50 GYR.
INCIDENTAL HOT-MIX ASPHALT SURFACING, MIX "C", N50	PG 64 - 22	4% @ 50 GYR.

THE UNIT WEIGHT USED TO CALCULATE ALL HMA SURFACE COURSE IS 112 LBS/SQYD/IN.


WHEN RAP EXCEEDS 20 %, THE NEW ASPHALT BINDER IN THE MIX SHALL BE PG 58 - 22.

THANCOCK		USER NAME	-	DESIGNED	TG	REVISED	 	STATE OF ILLINOIS	EVICEINA						ROUTE NO.	SECTION	COUNTY	TOTAL SHEETS	SHEETS NO.	Ŧ
■ ENGINEERIN Civil Engineers	G 9933 Receivelt Road Westchester, Ultaols 60154-2780	PLOT SCALE		CHECKED	.IG	REVISED		DEPARTMENT OF TRANSPORTATION	EXISTING	AND PRO	POSE	D TY	ICAL CI	ROSS SECTIONS	FAU 2713	09-00074-00-RS	соок	18	. 5	
 ◆ Municipal Consultants ◆ Established 1911 	Phone: 708/865-0300 Pax: 708/865-0212	PLOT DATE .		DATE	07/14/09	REVISED	 	DEPARTMENT OF TRANSPORTATION	SCALE: NONE	SHEET NO.	OF	SHEETS	STA.	TO STA.	FED. ROAD DI	ST. NO. 1 ILLINOIS FED	CONTRACT ND PROJECT A	T NO. (63257 (324)	-
												***************************************					EUE DOOLE	CT NO 92	0 00 4020	7


COMBINATION CONCRETE CURB & GUTTER TYPE B-6.12 (MODIFIED)

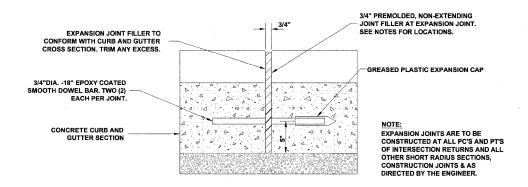

TYPICAL CURB AND GUTTER EXPANSION JOINT

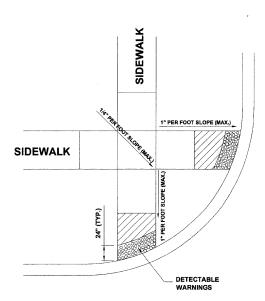

A.D.A. RAMP

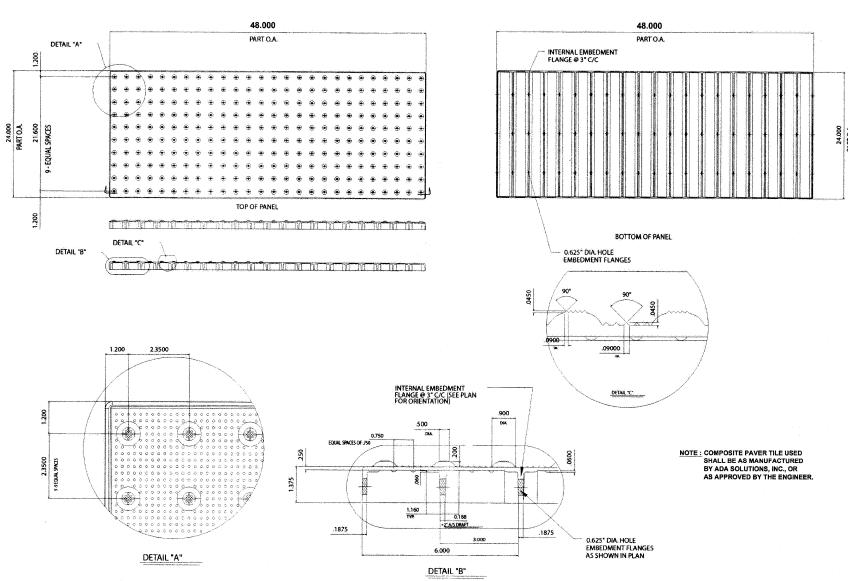


SCALE: NONE


AMP CAST-IN-PLACE DETECTABLE WARNINGS


TTANCOCK	USER NAME	DESIGNED	TG	REVISED
ENGINEERING		DRAWN	TG	REVISED
Civil Engineers Westbester, Hants 6018-2009 Municipal Consultants Process 26185-2009	PLOT SCALE	CHECKED	JG	REVISED
◆ Finalicipal Consultants Phone: 700865-000 ◆ Established 1911 Fax: 7007065-1212	PLOT DATE	DATE	07/14/09	REVISED

STATE OF ILLINOIS
DEPARTMENT OF TRANSPORTATION

DETAIL 0		ROUTE NO.	SECTION	COUNTY	SHEETS	SHEET NO.
DETAILS	FAU 2713	09-00074-00-RS	соок	18	6	
				CONTRACT	NO. 63	3257
SHEET NO. OF SHEETS STA.	TO STA.	FED. ROAD	DIST. NO. 1 ILLINOIS FED.	AID PROJECT AL	RA-9003(32	24)
				E.H.E. PROJEC	T NO. 838-	09-10201

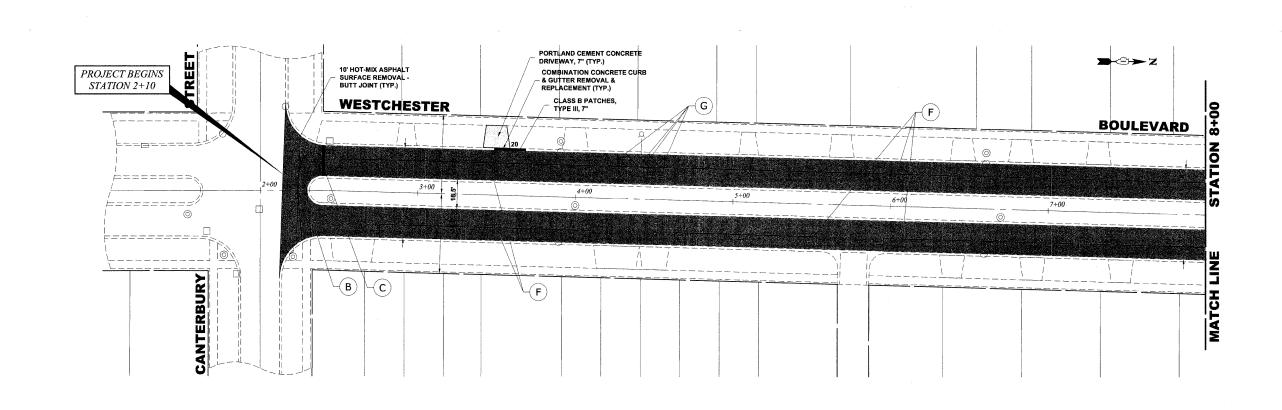

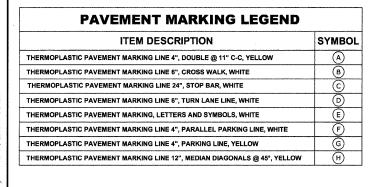

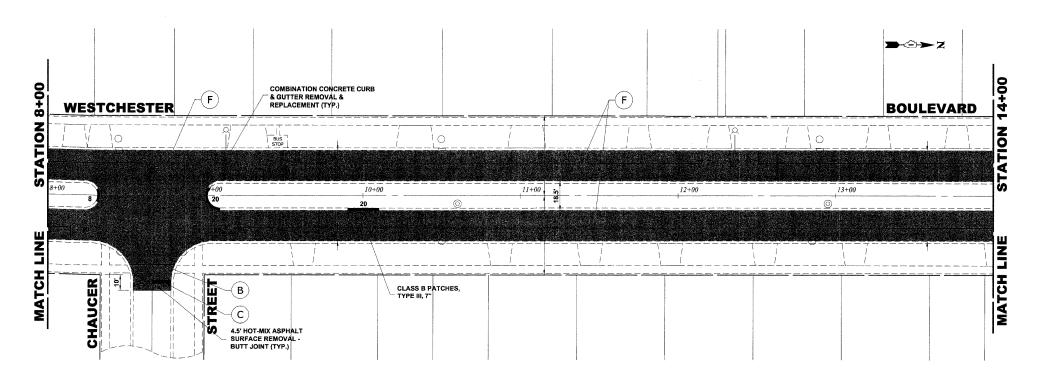


,	HANCOCI ENGINEERIN	
	◆ Civil Engineers	Westchester,
	♦ Municipal Consultants	Pi
	A 12-4-12-1-3 1011	

	USER NAME	DESIGNED	TG	REVISED	
		DRAWN	TG	REVISED	
Roservett Road ola 60154-1789	PLOT SCALE	CHECKED	JG	REVISED	
1: 708/965-0300 1: 708/965-1212	PLOT DATE	DATE	07/14/09	REVISED	

STAT	E OF	ILLINOIS	
DEPARTMENT	OF T	TRANSPORTATION	

DAVINO DI ANI						ROUTE NO.	SECTION	COUNTY	TOTAL SHEETS	SHEE NO.	
PAVING PLAN					FAU 2713	09-00074-00-RS	соок	18	7		
									CONTRACT	NO. 63	3257
:30"	SHEET NO), (OF	SHEETS	STA.	TO STA.	FED. ROAD	DIST. NO. 1 ILLINOIS FED. A	ID PROJECT AR	A-9003(32	(4)

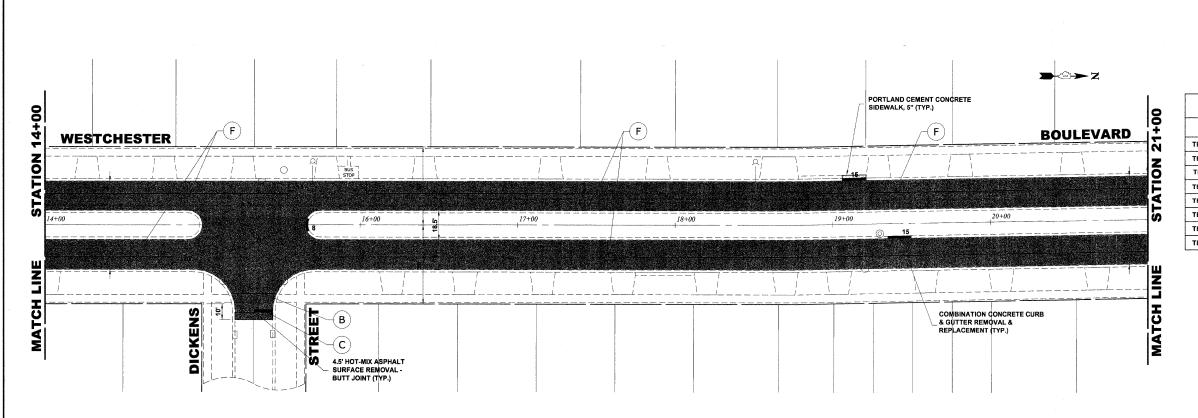

DRAWN TG

CHECKED JG

07/14/09

REVISED

REVISED

PAVEMENT MARKING LEGEND					
ITEM DESCRIPTION	SYMBOL				
THERMOPLASTIC PAVEMENT MARKING LINE 4", DOUBLE @ 11" C-C, YELLOW	(A)				
THERMOPLASTIC PAVEMENT MARKING LINE 6", CROSS WALK, WHITE	(B)				
THERMOPLASTIC PAVEMENT MARKING LINE 24", STOP BAR, WHITE	(c)				
THERMOPLASTIC PAVEMENT MARKING LINE 6", TURN LANE LINE, WHITE	(D)				
THERMOPLASTIC PAVEMENT MARKING, LETTERS AND SYMBOLS, WHITE	(E)				
THERMOPLASTIC PAVEMENT MARKING LINE 4", PARALLEL PARKING LINE, WHITE	(F)				
THERMOPLASTIC PAVEMENT MARKING LINE 4", PARKING LINE, YELLOW	G				
THERMOPLASTIC PAVEMENT MARKING LINE 12", MEDIAN DIAGONALS @ 45°, YELLOW	Н				


FAU 2713

09-00074-00-RS

FED. ROAD DIST. NO. 1 ILLINOIS FED. AID PROJECT ARA-9003(324)

COOK 18 8

CONTRACT NO. 63257

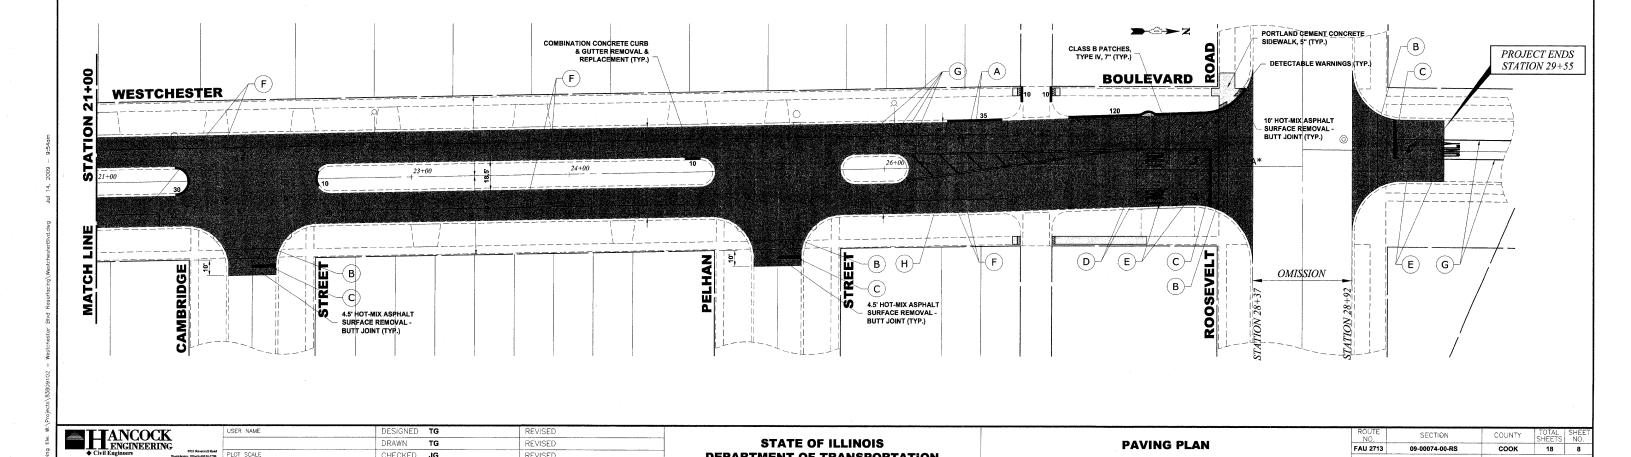


STATE OF ILLINOIS


DEPARTMENT OF TRANSPORTATION

PAVING PLAN

SCALE: 1'=30"

SHEET NO.

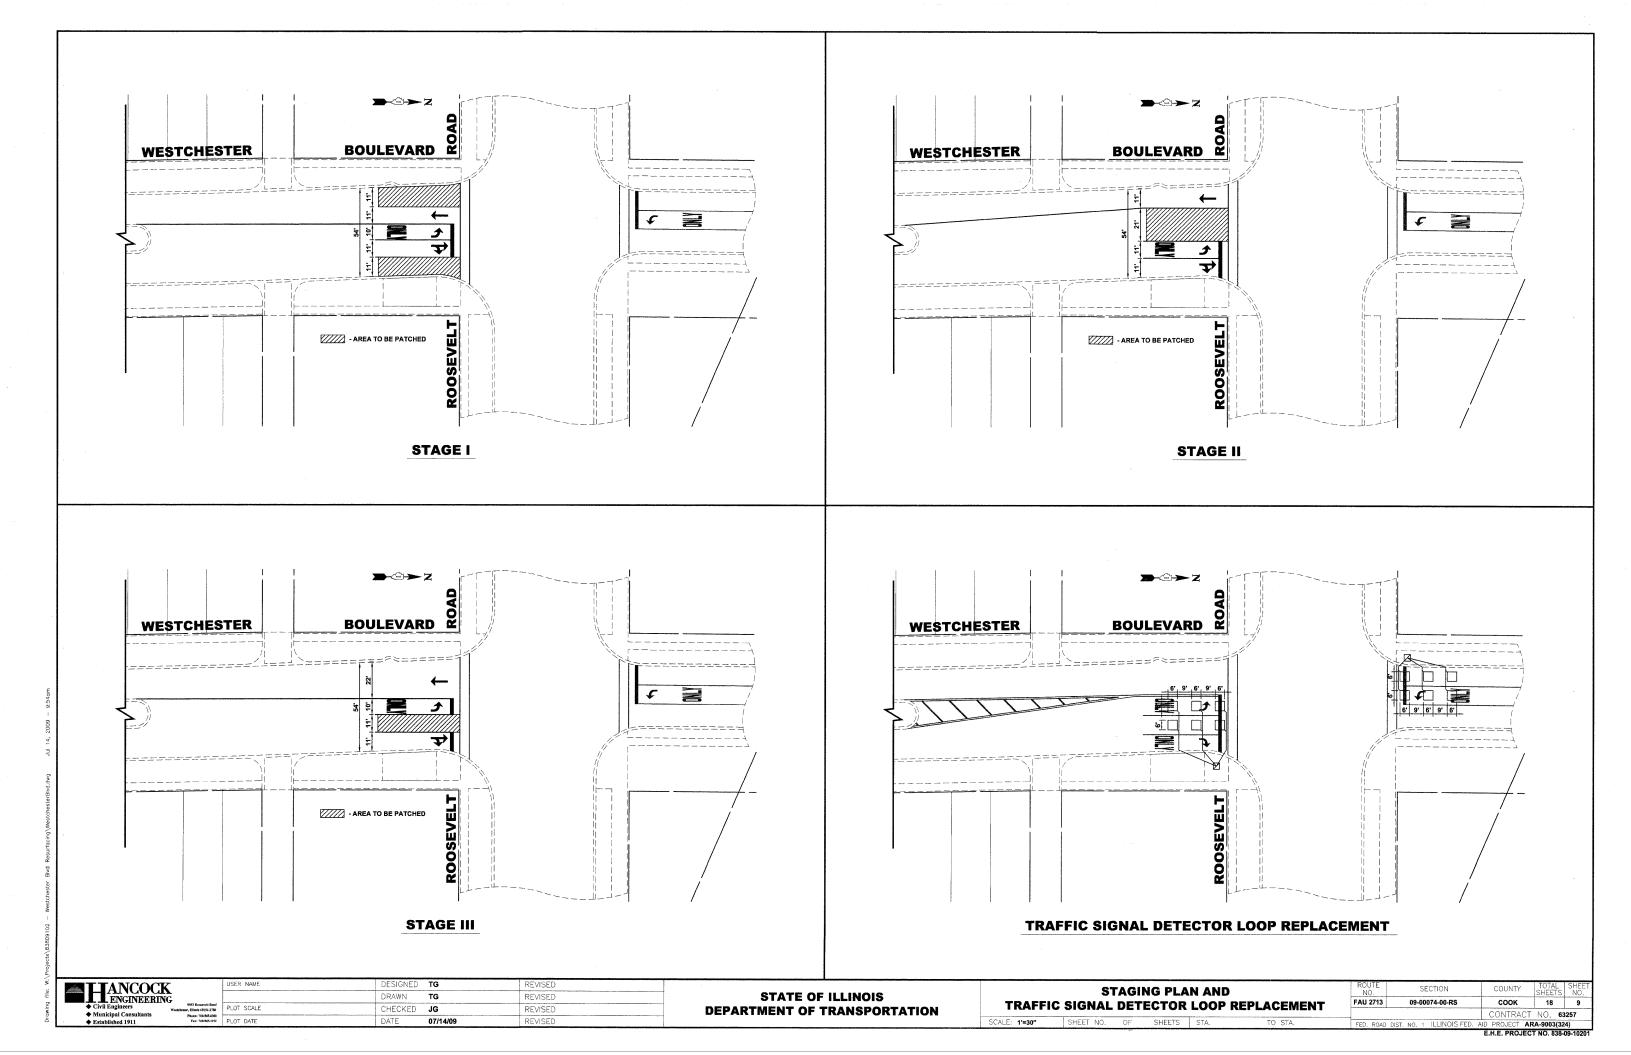

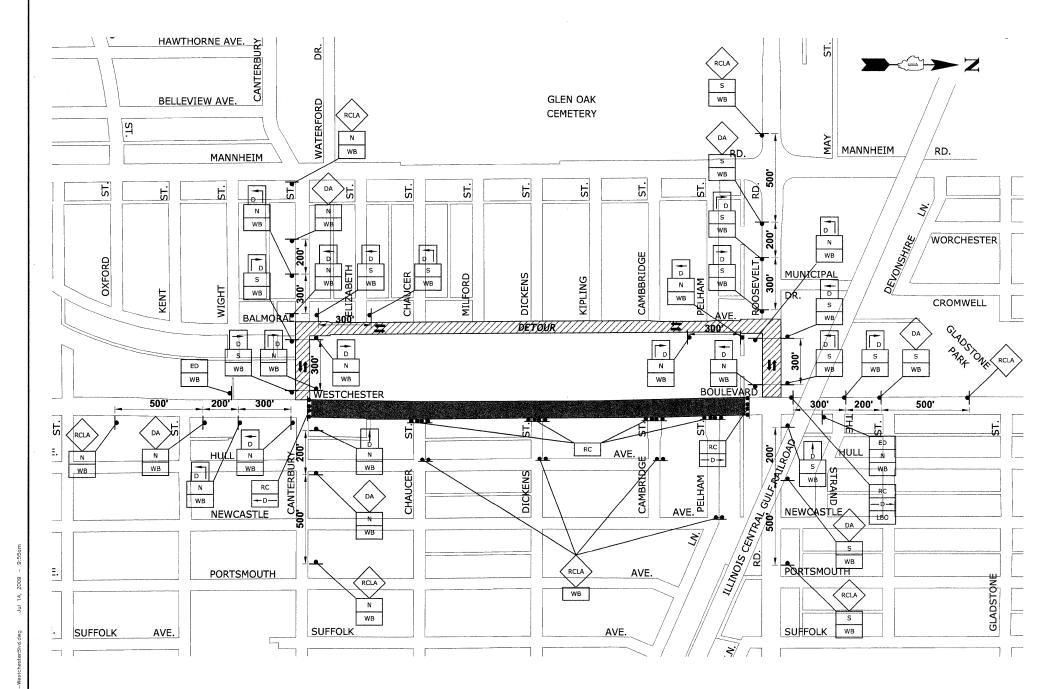

LEGEND OF SYMBOLS								
SYMBOL	DESCRIPTION	CODE & SIZE	SYMBOL	DESCRIPTION	CODE & SIZE			
RCLA	ROAD CLOSED AHEAD	W20-3 48"x48"	ED	END DETOUR	M4-8 24"x18" M4-8			
DA	DETOUR AHEAD	W20-2 48"x48"	LBO	BUSINESSES OPEN	36"x24" M4-9 30"x24"			
		W1-2 24"x24"	D	DETOUR	M4-9 30"x24"			
		W1-2 24"x24"	D	DETOUR	M4-9 30"x24" M4-9R 24"x30"			
NP		R8-3 24"x24"	D	DETOUR	M4-9L 24"x30"			
· RC	ROAD CLOSED	R11-4 60"x30"	— D—	DETOUR	M4-10 48"X18"			
RC TTT	ROAD CLOSED TO THRU TRAFFIC	R11-4 60"x30"	 D-	DETOUR	M4-10 48"X18"			
N	NORTH	M3-1 24"X12"	NP	NO PARKING	R8-3 12"x18" R8-3a 12"x6"			
. S	south	M3-1 24"X12"	NP	NO PARKING	R8-3 12"x18" R8-3a 12"x6"			
WB	WESTCHESTER BLVD	M4-8 36"X12"						


NOTES:

- ANY LOCAL DETOURS SHALL BE APPROVED BY THE VILLAGE AT LEAST 48 HOURS PRIOR TO INSTALLATION.
- 2. CONTRACTOR TO NOTIFY IDOT ARTERIAL TRAFFIC CONTROL SUPERVISOR (847)705-4470, SEVENTY-TWO (72) HOURS IN ADVANCE OF SETTING UP DETOUR ROUTE.

TTANCOCK	USER NAME	DESIGNED TG	REVISED	
LENGINEERING		DRAWN TG	REVISED	
♦ Civil Engineers 9933 Reserved S-4289 Workhester, Illinois 64(2-828) ♦ Municipal Consultants Phone: 78(264-428)	PLOT SCALE	CHECKED JG	REVISED	DEPAR
◆ Municipal Consultants Phone: 108.005-0100 ◆ Established 1911 Pax: 708-065-1212	PLOT DATE	DATE 07/14/09	REVISED	

STATI	OF ILLINOIS	
DEPARTMENT	F TRANSPOR	TATION

	NO.	SECTION	COUNTY	SHEETS	NO.
DETOUR FOR THROUGH TRAFFIC	FAU 2713	09-00074-00-RS	соок	18	10
			CONTRACT	NO. 63	257
SHEET NO. OF SHEETS STA. TO STA.	FED. ROAD DIST. NO. 1 ILLINOIS FED. AID PROJECT ARA-9003(324)				
			E.H.E. PROJEC	T NO. 838-	09-10201

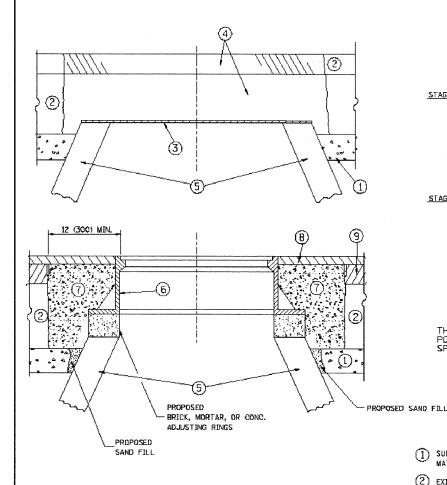

EXISTING BROKEN FRAMES AND LIDS SHALL BE REMOVED AND DISPOSED OF BY THE CONTRACTOR AND SHALL BE REPLACED AS DIRECTED BY THE ENGINEER. REPLACEMENT FRAMES AND LIDS WILL BE PAID FOR IN ACCORDANCE WITH ARTICLE 109.04 OF THE STANDARD SPECIFICATIONS UNLESS A SEPARATE PAY ITEM HAS BEEN PROVIDED.

IF THE EXISTING LIDS ARE OPEN, THE FRAME WILL BE ADJUSTED TO THE ELEVATION OF THE MILLED PAVEMENT SURFACE PRIOR TO THE MILLING OPERATION. THE FRAME WILL NOT BE REMOVED AND COVERED BY THE METAL PLATE.

CITY OF CHICAGO CASTINGS ARE THE PROPERTY OF THE CITY AND THE CONTRACTOR SHALL NOTIFY THE CITY FOR REMOVAL AND DISPOSITION OF THE CASTINGS.

THE METAL PLATE USED TO COVER THE STRUCTURE SHALL REMAIN THE PROPERTY OF THE CONTRACTOR.

WHEN STRUCTURES ARE TO BE ADJUSTED OR RECONSTRUCTED, THE LOWERING AND RAISING OF THE FRAMES AND LIDS WILL NOT BE PAID FOR SEPARATELY BUT WILL BE INCLUDED IN THE

CONSTRUCTION PROCEDURES

STAGE 1 (BEFORE PAVEMENT MILLING)

- A) REMOVE A MINIMUM OF 12 (300) OF THE PAVEMENT FROM AROUND THE STRUCTURE.
- B) REMOVE THE EXISTING FRAME AND LID FROM THE STRUCTURE.
- C) COVER THE STRUCTURE OPENING WITH A 36 (900) DIAMETER METAL PLATE.
- D) BACKFILL WITH CRUSHED STONE AND A MINIMUM 11/2 (40) THICK HMA SURFACE MIX APPROVED BY THE ENGINEER.

STAGE 2 (AFTER PAVEMENT MILLING)

- A) REMOVE THE HMA SURFACE MIX AND CRUSHED STONE.
- B) INSTALL THE FRAME AND LID; ADJUST THE FRAME TO ITS FINAL SURFACE ELEVATION.
- CI THE SURROUNDING SPACE SHALL BE FILLED WITH CLASS SI CONCRETE, OR HMA SURFACE COURSE OR HMA BINDER COURSE TO THE ELEVATION OF THE SURFACE OF THE EXISTING BASE COURSE OR THE BINDER COURSE.

THE PROCEDURE EXPLAINED ABOVE SHALL CONFORM TO THE APPLICABLE PORTIONS OF SECTIONS 363, 406, 602, AND 603 OF THE STANDARD SPECIFICATIONS.

LEGEND

- SUB-BASE GRANULAR
 MATERIAL
- 6 FRAME AND LID (SEE NOTES)
- 2 EXISTING PAVEMENT
- CLASS SI CONCRETE, HMA SURFACE COURSE OR HMA BINDER COURSE
- 3 36 (900) DIAMETER METAL PLATE
- 8 PROPOSED HMA SURFACE COURSE
- 4 PROPOSED CRUSHED STONE AND HMA SURFACE MIX (5) EXISTING STRUCTURE
- 9 PROPOSED HMA BINDER

COURSE

LOCATION OF STRUCTURES:

THE CONTRACTOR WILL BE REQUIRED TO KEEP A RECORD OF THE LOCATIONS OF THE BURIED STRUCTURES ACCORDING TO THE STATION AND DISTANCE LEFT OR RIGHT OF THE CENTERLINE OF PAVEMENT. UPON COMPLETION OF THE WORK, THE CONTRACTOR WILL DELIVER THE RECORD TO THE ENGINEER.

BASIS OF PAYMENT: THIS WORK WILL BE PAID FOR AT THE CONTRACT UNIT PRICE PER EACH FOR "FRAMES AND LIDS TO BE ADJUSTED, SPECIAL"

NEW FRAMES AND LIDS, WHEN SPECIFIED, WILL BE PAID FOR SEPARATELY.


DETAILS FOR FRAMES AND LIDS ADJUSTMENT WITH MILLING

ALL DIMENSIONS ARE IN INCHES (MILLIMETERS) UNLESS

FILE NAME = DESIGNED - R. SHAH USER NAME = gaglianobt REVISED - R. SHAH 03-10-95 DRAWN REVISED - A. ABBAS 03-21-97 PLOT SCALE = 55.0900 '/ INL REVISED - R. WIEDEMAN 05-14-04 PLOT DATE = 1/4/2008 DATE - 10-25-94 REVISED - R. BORO 01-01-07

STATE OF ILLINOIS DEPARTMENT OF TRANSPORTATION

COUNTY DETAILS FOR 2713 09-00074-00-RS COOK 18 11 FRAMES AND LIDS ADJUSTMENT WITH MILLING 80808-03 (BD-8) CONTRACT NO. 63257 SHEET NO. 1 OF 1 SHEETS STA. FED. ROAD DIST. NO. 1 | ILLINOIS FED. AID PROJECT

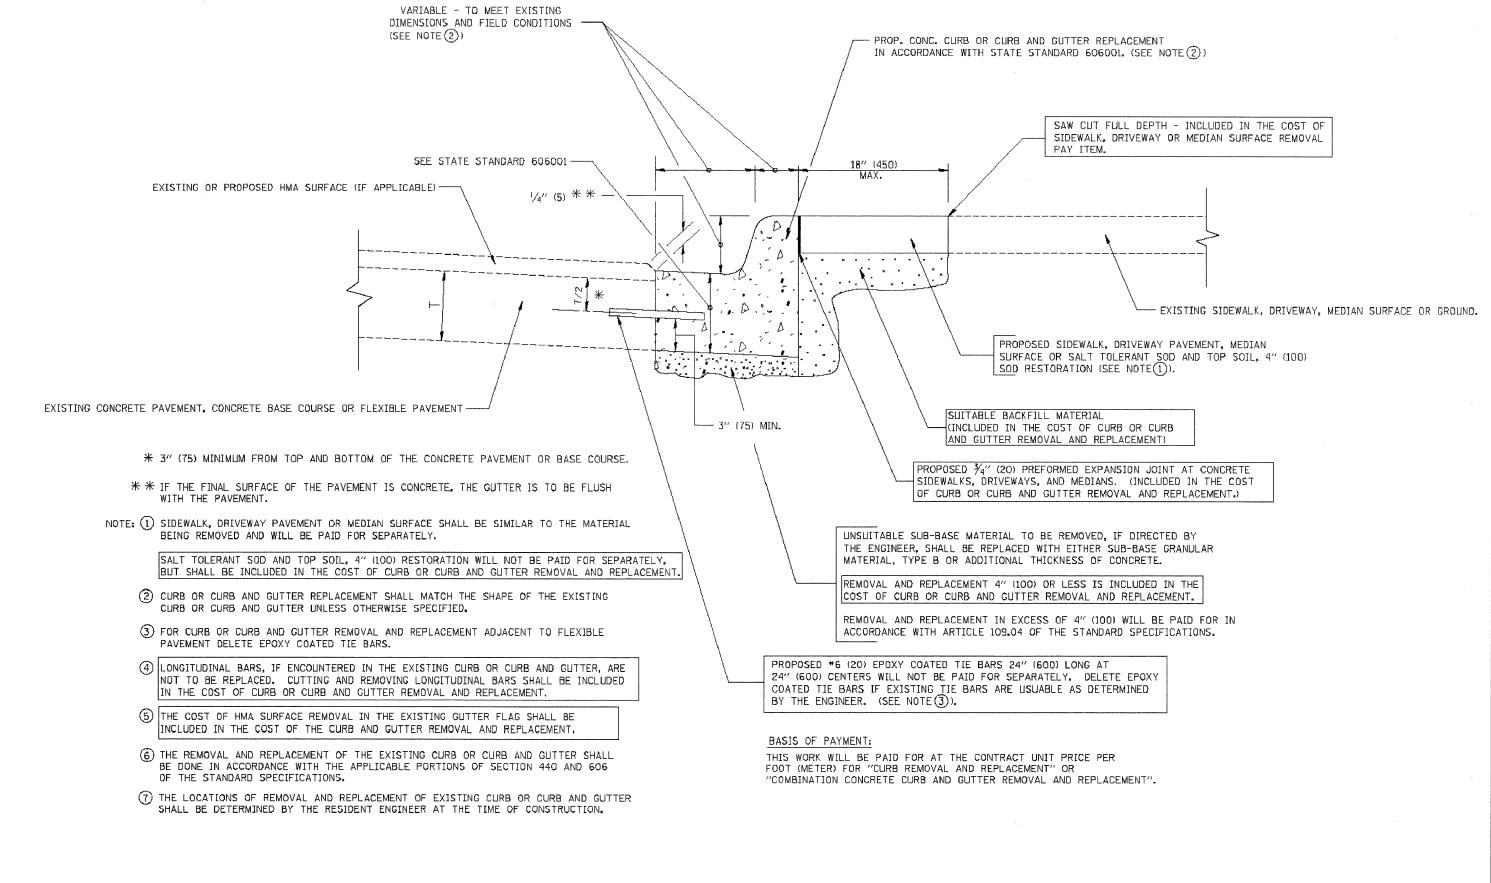

CURB OR CURB AND GUTTER REMOVAL AND REPLACEMENT


ALL DIMENSIONS ARE IN INCHES (MILLIMETERS) UNLESS OTHERWISE SHOWN.

FILE NAME = USER NAME = gaglianobt DESIGNED - A. HOUSEH REVISED - R. SHAH 10-03-96 COUNTY TOTAL SHEET NO.

COOK 18 12 CURB OR CURB AND GUTTER Vi\dastatd\22x34\bd24.dgr - A. ABBAS 03-21-97 DRAWN REVISED STATE OF ILLINOIS 2713 REMOVAL AND REPLACEMENT PLOT SCALE = 68.000 ' / IN CHECKED -REVISED - M. GOMEZ 01-22-01 **DEPARTMENT OF TRANSPORTATION** BD800-06 (BD-24) CONTRACT NO. 63257 PLOT DATE = 1/4/2008 DATE - 03-11-94 REVISED - R. BORO 01-01-07 SCALE: NONE SHEET NO. 1 OF 1 SHEETS STA. TO STA. E.H.E. PROJECT NO. 838-09-10201

OPTION 1


(FOR BUTT JOINT AND HMA TAPER SEE DETAIL BELOW)

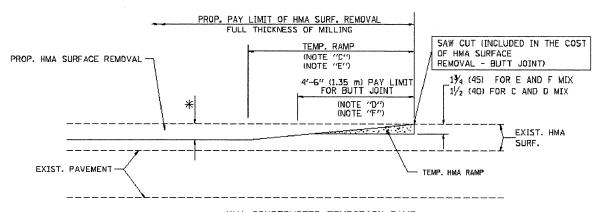

HMA CONSTRUCTED TEMPORARY RAMP (FOR BUTT JOINT AND HMA TAPER SEE DETAIL BELOW)

OPTION 2

TYPICAL TEMPORARY RAMP

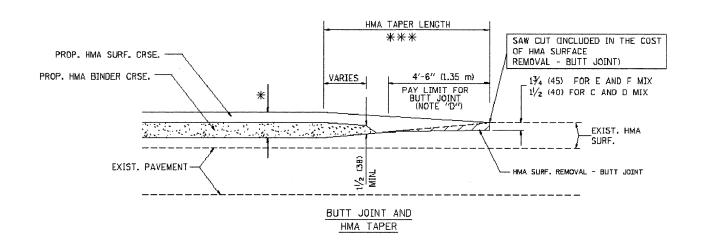

TYPICAL BUTT JOINT AND HMA TAPER FOR MILLING AND RESURFACING


USER NAME = geglienobt DESIGNED - M. DE YONG REVISED - R. SHAH 10-25-94 ngb.SEbd/FEaSS/brarecb/:W - A. ABBAS 03-21-97 PLOT SCALE = 50.0000 '/ IN. CHECKED -REVISED - M. GOMEZ 04-06-01 PLOT DATE = 1/4/2008 DATE - 05-13-90 REVISED - R. BORO 01-01-07

FILE NAME =

STATE OF ILLINOIS **DEPARTMENT OF TRANSPORTATION**

COUNTY **BUTT JOINT AND** 2713 09-00074-00-RS COOK 18 13 HMA TAPER DETAILS BD400-05 BD32 CONTRACT NO. 63257 SHEET NO. 1 OF 1 SHEETS STA.

PROP. HMA OR PCC SURFACE REMOVAL - BUTT JOINT EXIST. HMA OR PCC SURFACE SAW CUT (INCLUDED IN THE COST 30'-0" (9.0 m) (NOTE "A") OF HMA OR P.C.C. SURFACE REMOVAL 15'-0" (4.5 m) (NOTE "B") - BUTT JOINT) (NOTE "D") 11/4 (45) FOR E AND F MIX 11/2 (40) FOR C AND D MIX ¥ ¥ EXIST. PAVEMENT BUTT JOINT DETAIL

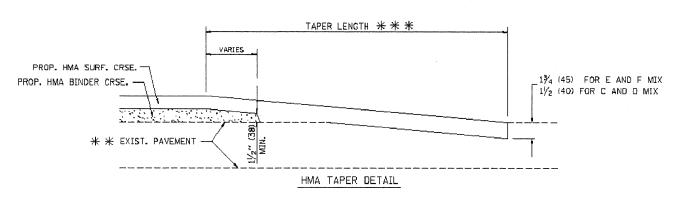

TYPICAL BUTT JOINT AND HMA TAPER FOR RESURFACING ONLY

* * PC CONCRETE, HMA OR HMA RESURFACED PAVEMENT.

NOTES

- A: MAINLINE ROADWAYS AND MAJOR SIDE ROADS.
- B: MINOR SIDE ROADS.
- C: THE TEMP. RAMP SHALL BE CONSTRUCTED IMMEDIATELY UPON REMOVAL OF THE EXISTING HMA SURFACE.
- D: THE BUTT JOINT SHALL BE CONSTRUCTED IMMEDIATELY PRIOR TO PLACING THE PROPOSED HMA COURSES.
- E: TAPER THE TEMP. RAMP AT A RATE OF 3'-0" (900 mm) PER 1 INCH (25 mm) OF MILLING THICKNESS.
- F: INSTALLATION AND REMOVAL OF THE 4'-6" (1.35 m) TEMP. RAMP IS INCLUDED IN COST OF HMA SURFACE REMOVAL - BUTT JOINT
- G: SEE ARTICLE 406.08 AND 406.14 OF THE STANDARD SPECIFICATIONS FOR "HMA AND/OR PCC SURFACE REMOVAL, BUTT JOINT".
- * SEE TYPICAL SECTIONS FOR MILLING THICKNESS.
- ** ** ** 20'-0" (6.1 m) PER 1 (25) RESURFACING (NOTE "A") 10'-0" (3.0 m) PER 1 (25) RESURFACING (NOTE "B")

BASIS OF PAYMENT:

THE BUTT JOINT WILL BE PAID FOR AT THE CONTRACT UNIT PRICE PER SQUARE YARD (SQUARE METER)
FOR "HOT-MIX ASPHALT SURFACE REMOVAL - BUTT JOINT" OR FOR "PORTLAND CEMENT CONCRETE SURFACE REMOVAL- BUTT JOINT".

ALL DIMENSIONS ARE IN INCHES (MILLIMETERS) UNLESS OTHERWISE SHOWN.

ROAD CONSTRUCTION AHEAD ba ROA CONSTRUCTION TYPE III BARRICADES -WITH TWO FLASHING AMBER LIGHTS ON EACH. AHEAD TYPE I OR TYPE II BARRICADES WITH ONE FLASHING AMBER LIGHT ON EACH, OR 15 (380) TYPE III BARRICADES WITH TWO FLASHING 200'± (60 m±)---21 (530) AMBER LIGHTS ON EACH. DRIVEWAY WORK AREA J 200'± (60 m±) SPE OB L 99 STREET; COLLECTOR LIMIT> 40 MPH (LOCAL W20-1(0) ROAD SPEED CONSTRUCTION M6-4(0)-2115 AHEAD ROAD M6-1(0)-2115 CONSTRUCTION AHEAD 4

TRAFFIC CONTROL AND PROTECTION FOR SIDE ROADS, INTERSECTIONS, AND DRIVEWAYS

NOTES:

- A. FOR NO LANE RESTRICTION ON THE SIDE ROAD OR DRIVEWAYS
- 1. SIDE ROAD WITH A SPEED LIMIT OF 40 MPH (60 km/h) OR LESS AS SHOWN ON THE DRAWING AND AS DIRECTED BY THE ENGINEER:
- d) ONE ROAD CONSTRUCTION AMEAD SIGN 36 x 36 (900x900) WITH A FLASHER AND FLAG MOUNTED ON IT APPROXIMATELY 200' (60 m) IN ADVANCE OF THE MAIN ROUTE.
- b) THE CLOSED PORTION OF THE MAIN ROUTE SHALL BE PROTECTED BY BLOCKING WITH TYPE I, TYPE II OR TYPE III BARRICADES, 1/3 OF THE CROSS SECTION OF THE CLOSED PORTION.
- SIDE ROAD WITH A SPEED LIMIT GREATER THAN 40 MPH (60 km/h)-AS SHOWN ON THE DRAWING AND AS DIRECTED BY THE ENGINEER:
- 0) ONE ROAD CONSTRUCTION AHEAD SIGN 48×48 (i.2 m \times 1.2 m) WITH A FLASHER MOUNTED ON IT APPROXIMATELY 500° (150 m) IN ADVANCE OF THE MAIN ROUTE.
- b) THE CLOSED PORTION OF THE MAIN ROUTE SHALL BE PROTECTED BY BLOCKING WITH TYPE III BARRICADES, 1/2 OF THE CROSS SECTION OF THE GLOSED PORTION.
- 3, WHEN THE SIDE ROAD LIES BETWEEN THE BEGINNING OF THE MAINLINE SIGNING AND THE WORK ZONE, A SINGLE HEADED ARROW (MG-1) SHALL BE USED IN LIEU OF THE DOUBLE HEADED ARROW (MG-4).

SCALE: NONE

- B. FOR A LANE CLOSURE ON A SIDE ROAD OR DRIVEWAY:
- USE APPLICABLE PORTIONS OF THE TYPICAL APPLICATION OF TRAFFIC CONTROL DEVICES (STD. 701501, STD. 701505 OR THE APPROPRIATE STANDARD). THE SPACING OF SIGNS AND BARRICADES SHALL BE ADJUSTED FOR FIELD CONDITIONS AS DIRECTED BY THE ENGINEER, THE DIRECTIONAL ARROW SHALL BE COVERED OR REMOVED WHEN NO LONGER CONSISTENT WITH THE SIDE ROAD LANE CLOSURE.
- C. ADVANCE WARNING SIGNS ARE TO BE OMITTED ON DRIVEWAY UNLESS OTHERWISE NOTED.
- D. THE TRAFFIC CONTROL AND PROTECTION FOR SIDE ROADS, INTERSECTIONS, AND DRIVEWAYS SHALL BE INCIDENTAL TO THE COST OF SPECIFIED TRAFFIC CONTROL STANDARDS OR ITEMS.

All dimensions are in millimaters (inches) unless otherwise shown.

FILE NAME = USER NAME = geglianobt DESIGNED - LHA REVISED - J. 08ERLE 10-18-95

WildestartAl22x34\ta18.dgn - DRAWN - REVISED - A. HOUSEH 03-08-96

PLOT SCALE = 66.888 '/ IN. CHECKED - REVISED - A. HOUSEH 10-15-96

PLOT DATE = 1/4/2888 DATE - 06-89 REVISED -T. RAMMACHER 01-06-00

STATE OF ILLINOIS
DEPARTMENT OF TRANSPORTATION


TRAFFIC CONTROL AND PROTECTION FOR SIDE ROADS, INTERSECTIONS, AND DRIVEWAYS


SHEET NO. 1 OF 1 SHEETS STA. TO STA.

F.A. SECTION COUNTY TOTAL SHEET NO.


2713 09-00074-00-RS COOK 18 14

TC-10 CONTRACT NO. 63257

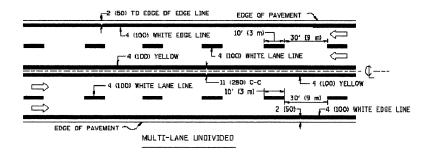


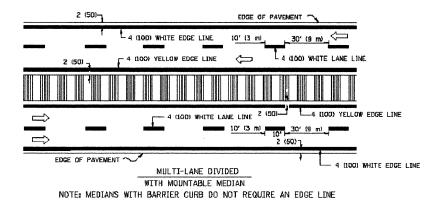


TYPICAL LANE AND EDGE LINE MARKING

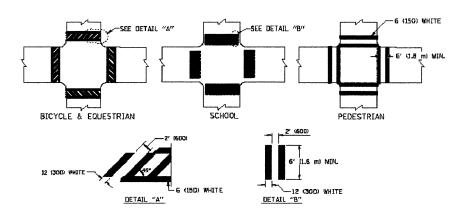

TYPICAL CROSSWALK MARKING

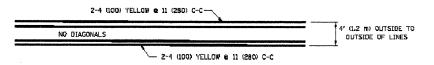

4' (1.2 m) WIDE MEDIANS ONLY

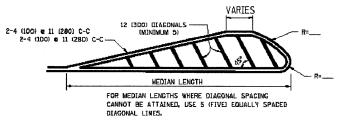


DIAGONAL LINE SPACING: 50' (15 m) C-C (LESS THAN 30MPH (50 km/h))


75' (25 m) C-C 30MPH (50 km/h) TO 45MPH (TD km/h))

150' (45 m) C-C (MORE THAN 45MPH (TD km/h))

MEDIANS OVER 4' (1.2 m) WIDE

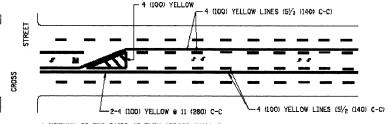


A MINIMUM OF TWO PAIRS OF TURN ARROWS SHALL BE USED, WHITE IN COLOR. ADDITIONAL PAIRS SHALL BE PLACED AT 200' (60 m) TO 300' (90 m) INTERVALS.

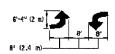

MEDIAN WITH TWO-WAY LEFT TURN LANE

TYPICAL PAINTED MEDIAN MARKING

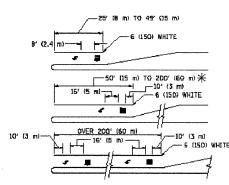


FULL SIZE LETTERS 8' (2.4 m) AND ARROWS SHALL BE USED. \P AREA = 15.6 SQ. FT. (1.5 m²) [11] AREA = 20.8 SQ. FT. (1.9 m²)

* TURN LANES IN EXCESS OF 400' (120 m) IN LENDTH MAY HAVE AN ADDITIONAL SET OF APROW - "ONLY" INSTALLED MIDWAY BETWEEN THE OTHER TWO SETS OF

TYPICAL LEFT (OR RIGHT) TURN LANE

TYPICAL TURN LANE MARKING

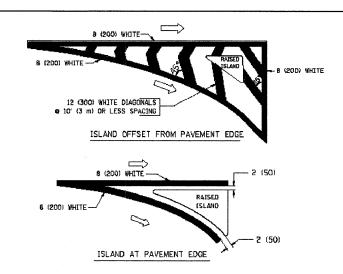

TYPICAL ISLAND MARKING

			r	
TYPE OF MARKING	WIDTH OF LINE	PATTERN	COLÓR	SPACING / REMARKS
CENTERLINE ON 2 LANE PAVEMENT	4 (1DD)	SKIP-DASH	YELLOW	3D' (3 m) LINE WITH 3O' (9 m) SPACE
CENTERLINE ON MULTI-LANE UNDIVEDED PAVEMENT	2 @ 4 (100)	SOLID	YELLOW	11 (280) C-C
NO PASSING ZONE LINES: FOR ONE DIRECTION FOR BOTH DIRECTIONS	4 (100) 2 @ 4 (199)	SOLID SOLID	YELLOW YELLOW	5/2 (14D) C-C FROM SKIP-DASH CENTERLINE 11 (28G) C-C OMIT SKIP-DASH CENTERLINE BETWEEN
LANE LINES	4 (100) 5 (125) ON FREEWAYS	SKIP-DASH SKIP-DASH	WHITE . WHITE	10' (3 m) LINE WITH 30' (9 m) SPACE
DOTTED LINES LEXTENSIONS OF CENTER, LANE OR TURN LANE MARKINGS)	SAME AS LINE BEING EXTENDED	SKIP-DASH	SAME AS LINE BEING EXTENDED	2' (600) LINE WITH 6' (1.8 m) SPACE
EOGE LINES	4 (100)	SOLID	YELLOW-LEFT WHITE-RIGHT	OUTLINE MOUNTABLE MEDIANS IN YELLOW, EDGE LINES ARE NDT USED NEXT TO BARRIER CURB
TURN LANE MARKINGS	6 (150) LINE: FULL SIZE LETTERS & SYMBOLS (B' (2.4m))	SOLIO	WHITE	SEE TYPICAL TURN LANE MARKING DETAIL
TWO WAY LEFT TURN MARKING	2 @ 4 (100) EACH DIRECTION	SKIP-DASH AND SOLID	YELLOW	10' (3 m) LINE WITH 30' (8 m) SPACE FOR SKIP-DASH; 5½ (140) C-C BETWEEN SOLID LINE AND SKIP-DASH LINE
	6' (2.4m) LEFT ARROW	IN PAIRS	WHITE	SEE TYPICAL TWO-WAY LEFT TURN MARKING DETAIL
CROSSWALK LINES (PEDESTRIAN) A. DIAGONALS (BIKE & EQUESTRIAN) B. LONGITUBINAL BARS (SCHOOL)	2 @ 5 (150) 12 (300) @ 45° 12 (300) @ 90°	SOLID SOLID	WHITE WHITE WHITE	NDT LESS THAN 6' (LB m) APART 2' (500) APART 2' (500) APART 5' (500) APART SEE TYPICAL CROSSWALK MARKING DETAILS.
STOP LINES	24 (600)	SOLIO	WHITE	PLACE 4' 11.2 ml IN ADVANCE OF AND PARALLEL TO CROSSMALK, IF PRESENT. OTHERWISE, PLACE AT DESIRED STROPPING POINT. PARALLEL TO CROSSROAD CENTERLINE, WHERE POSSIBLE
PAINTED MEDIANS	2 @ 4 (100) WITH 12 (300) DIAGONALS @ 45°	SOLID	YELLOW: TWO WAY TRAFFIC	11 (280) C-C FOR THE DOUBLE LINE SEE TYPICAL PAINTED MEDIAN MARKING.
	ND DIAGONALS USED FOR 4' (1.2 m) WIDE MEDIANS		WHITE: DNE WAY TRAFFIC	SEE TITLEME PAINTED MEDIAN MARKENS.
CORE MARKING AND CHANNELIZING LINES	8 (200) WITH 12 (300) DIAGONALS & 45°	SOLID	WHITE	DIAGDNALS: 15' (4.5 m) C-C (LESS THAN 30MPH (50 km/h)) 20' (6 m) C-C 30MPH (50 km/h) TO 45MPH (70 km/h)) 30' (9 m) C-C (DVER 45MPH (70 km/h))
RAILROAD CROSSING	Z4 (600) TRANSVERSE LINES, "RR" IS 5' (1.8 ml LETTERS; 16 (400) LINE FOR "X"	SOLIO	WHITE	SEE STATE STANDARD 78000L AREA OF: "R": 3.6 SQ. FT. (0.33 m²) EACH "X"=54.0 SQ. FT. (5.0 m²)
SHOULDER DIAGONALS	12 (300) @ 45°	SOLID	WHITE - RIGHT YELLOW - LEFT	50' (15 m) C-C (LESS THAN 30MPH (50 km/h)) 75' (25 m) C-C (30 MPH (50 km/h) TO 45MPH (70 km/h)) 150' (45 m) C-C (OVER 45MPH (70 km/h))


FOR FURTHER DETAILS ON PAVEMENT MARKING REFER TO STANDARD SPECIFICATIONS FOR ROAD AND BRIDGE CONSTRUCTION AND STATE STANDARD 780001.

All dimensions are in inches imilimeters) unless otherwise shown.

FILE NAME =	USER NAME = geglienabt	DESIGNED - EVERS	REVISED -T. RAMMACHER 10-27-94
Wildestatel\22x94\ta19.dgn		DRAWN -	REVISED -A. HOUSEH 10-09-96
	PLOT SCALE = 58.090 ' / IN.	CHECKED -	REVISED -A. HOUSEH 10-17-96
	PLOT DATE = 1/4/2008	DATE - 03-19-90	REVISED - T. RAMMACHER 01-05-00

STATE OF ILLINOIS
DEPARTMENT OF TRANSPORTATION

DISTRICT ONE			F.A RTE.	SECTION	COUNTY	TOTAL	SHEET NO.	
TYPICAL PAVEMENT MARKINGS				2713	09-00074-00-RS	соок	18	15
					TC-13	CONTRACT NO. 63257		257
SCALE: NONE SHE	EET NO. 1 OF 1 SHEETS	STA.	TO STA.	FED. ROAD DIST. NO. 1 ILLINOIS FED. AID PROJECT				

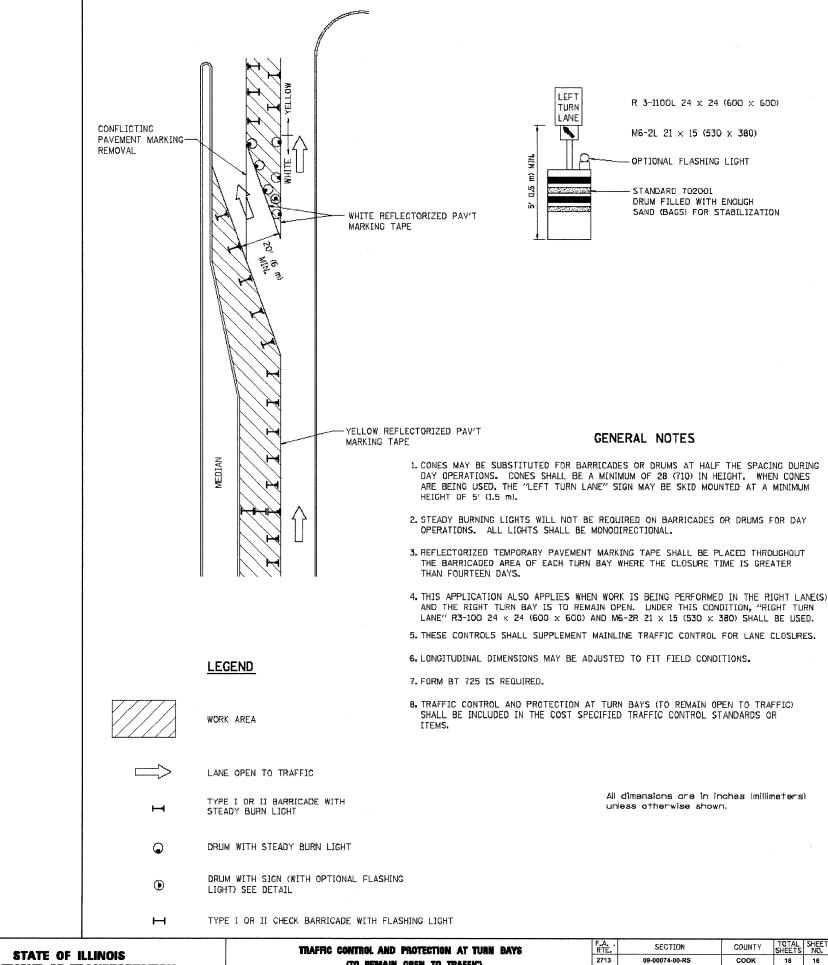


ie: W:\Projects\83809102 = Westchester Blvd Resurfacing\Markings=WestchesterBlvd.dwg Jul 14, 2009 = 10:22a

STATE OF ILLINOIS
DEPARTMENT OF TRANSPORTATION

SCALE: NONE

RTE.	SHEET'S NO.			
2713	09-0074-00-RS	COOK	18	16
TC-14	CONTRACT NO. 63257			
FEG. ROAD GIST. NO. 1	ILLINOIS FED. AID PROJECT			

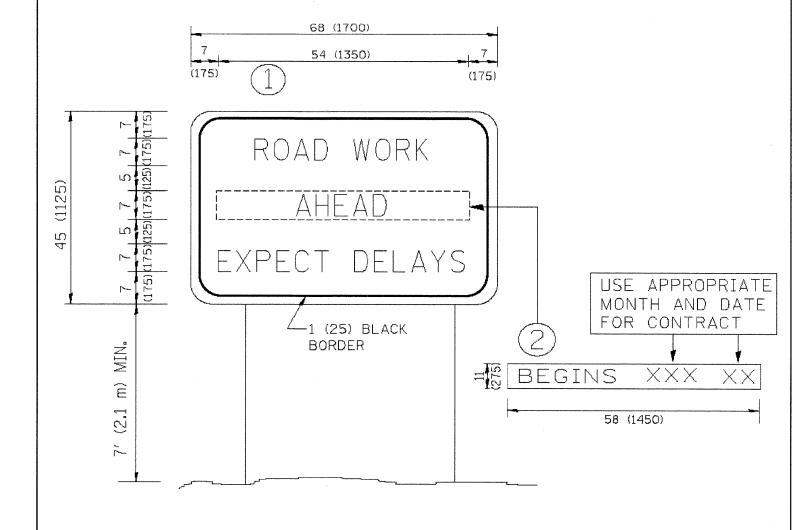

NOTES:


- 1. USE BLACK LETTERING ON ORANGE BACKGROUND.
- 2. ERECT SIGNS IN ADVANCE OF THE LOCATION FOR THE "ROAD CONSTRUCTION AHEAD" SIGN AT LOCATIONS AS DIRECTED BY THE ENGINEER.
- 3. ERECT SIGN (1) WITH INSTALLED PANEL (2) ONE WEEK PRIOR TO THE START OF CONSTRUCTION.
- 4. REMOVE PANEL (2) SOON AFTER THE START OF CONSTRUCTION.
- 5. SEE SPECIAL PROVISION FOR "TEMPORARY INFORMATION SIGNING" FOR ADDITIONAL INFORMATION.
- 6. ONE SIGN ASSEMBLY EQUALS 25.70 SQ. FT. (2.3 SQ. M.)
- 7. SHALL BE PAID FOR AS TEMPORARY INFORMATION SIGNING.

ALL DIMENSIONS ARE IN INCHES (MILLIMETERS) UNLESS OTHERWISE SHOWN.

DESIGNED -USER NAME = gagliandot REVISED - R. MIRS 09-15-97 SECTION ARTERIAL ROAD STATE OF ILLINOIS Wildstand\22x34\na22.dor DRAWN -REVISED - R. MIRS 12-11-97 09-00074-00-RS COOK 18 17 INFORMATION SIGN PLOT SCALE = 60.000 '/ IN. CHECKED -REVISED -T. RAMMACHER 02-02-99 **DEPARTMENT OF TRANSPORTATION** TC-22 CONTR CONTRACT NO. 63257 PLOT DATE = 1/4/2008 DATE REVISED - C. JUCIUS 01-31-07 SHEET NO. 1 OF 1 SHEETS STA. SCALE: NONE TO STA.

LOOPS NEXT TO SHOULDERS

PROVIDE A PAVEMENT REPLACEMENT NOTE WHICH SHOULD EDUAL 3' (900 mm) X WIDTH OF PAVED SHOULDER.

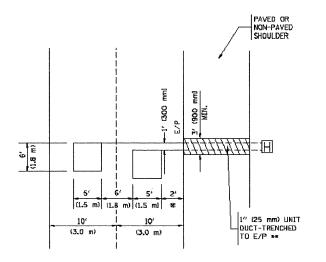


* = (600 mm)

* * UNIT DUCT IS TO BE SHOWN ON PLAN SHEETS BUT SHALL NOT BE INCLUDED IN THE PAY ITEMS.

LEFT TURN LANES WITH MEDIANS VOLUME DENSITY ("FAR OUT" DETECTION) ON SAME APPROACH


(PROTECTED / PERMITTED LEFT TURN PHASING)

HANDHOLE LOCATION MAY
VARY DEPENDING ON GEOMETRICS
AND DESIGN OF TRAFFIC SIGNALS.
HEAVY-DUTY HANDHOLES TO BE
USED WHEN THE MEDIAN IS
MOUNTABLE. REFER TO STANDARD
BI4OOL TO ENSURE THAT HANDHOLE
FITS IN MEDIAN.

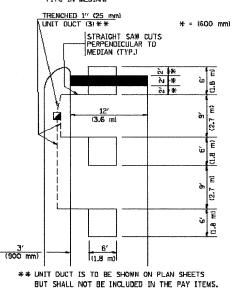

NOTE: DUAL LEFT TURNS NOT SHOWN REFER TO PLAN SHEET FOR DETECTOR LOOP REPLACEMENT LEFT TURN LANES WITHOUT MEDIANS
VOLUME DENSITY ("FAR OUT" DETECTION)
ON SAME APPROACH

(PROTECTED / PERMITTED LEFT TURN PHASING)

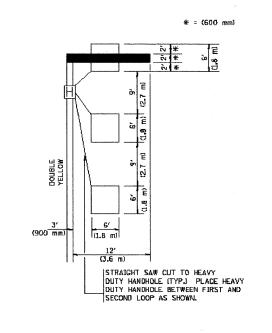



NOTE: DUAL LEFT TURNS NOT SHOWN REFER TO PLAN SHEET FOR DETECTOR LOOP REPLACEMENT

SCALE: NONE

ARTERIAL-VOLUME DENSITY ("FAR OUT" DETECTION)
CROSS STREET-VOLUME DENSITY ("FAR OUT" DETECTION)

ARTERIAL-VOLUME DENSITY ("FAR OUT" DETECTION)
CROSS STREET-NON VOLUME DENSITY ("UPTIGHT" PRESENCE DETECTION)

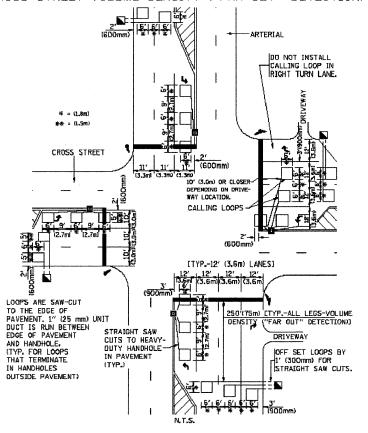

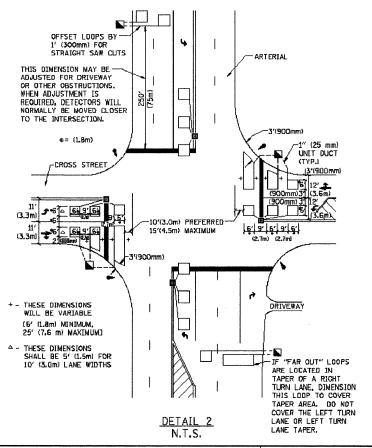

NOTES

VEHICLES LOOP DETECTORS

- * ALL LEAD IN CABLE SHALL BE TWO CONDUCTOR NO. 14 TWISTED, SHIELDED.
- * EACH DETECTOR LOOP SHALL HAVE ITS DWN SAW CUT FROM THE LOOP TO THE EDGE OF PAVEMENT OR TO A HANDHOLE IN THE PAVEMENT.
- * EACH DETECTOR LOOP SHALL HAVE ITS OWN ONE INCH (25 mm) UNIT DUCT BETWEEN THE EDGE OF PAVEMENT AND THE FIRST HANDHOLE OR JUNCTION BOX. EACH UNIT DUCT RUN SHALL BE SHOWN ON THE PLANS BY THE DESIGNER, BUT SHALL NOT BE PAID FOR SEPARATLY. THIS ITEM IS INCIDENTAL TO THE PAY ITEM FOR DETECTOR LOOPS.
- * ONE DIMENSION OF <u>ALL</u> DETECTOR LOOPS SHALL BE SIX FEET (1.8 m)
- * EACH LANE OF NON-LOCKING, PRESENCE DETECTION AND EACH LANE OF A DOUBLE LEFT TURN LANE REQUIRES A SEPARATE INDUCTIVE LOOP DETECTOR AND LEAD IN CABLE.
- * WHEN NON-LOCKING, PRESENCE DETECTION IS USED, <u>MORE</u>
 THAN ONE LOOP PER LANE IS REQUIRED BEHIND THE STOP BAR
 (1.e. 1-1/2, 1-3/4, 2).
- ** WHEN SYSTEM LOOPS ARE REQUIRED ON AN APPROACH OF AN INTERSECTION, THE LOOPS USED FOR VOLUME DENSITY AND INTERSECTION TIMING SHALL ALSO BE USED AS SYSTEM DETECTORS. <u>EACH</u> ONE OF THESE TYPE OF LOOPS REQUIRES A <u>SEPARATE</u> TWO CONDUCTOR NO. 14 TWISTED SHIELDED CABLE AND A <u>SEPARATE</u> INDUCTIVE LOOP DETECTOR WHEN NEW CONTROLLERS ARE UTILIZED. THE DESIGNER SHALL LABEL THESE TYPES OF LOOPS AS "INTERSECTION AND SAMPLING (SYSTEM) DETECTORS" ON THE SIGNAL LAYOUT, THE INTERCONNECT PLAN AND THE SYSTEM CABLE PLAN. WHEN AN EXISTING CONTROLLER IS UTILIZED FOR THIS TYPE OF DETECTION, THE PAY ITEM "INDUCTIVE LOOP DETECTOR WITH SYSTEM OUTPUT" SHOULD BE USED.

PLACEMENT OF DETECTORS

THE FOLLOWING FIGURES REPRESENT THE MOST COMMON DETECTOR LOOP LOCATIONS AND SIZES, ADJUSTMENTS WILL BE NECESSARY FOR SPECIFIC GEOMETRIC CONSIDERATIONS.

LOCATIONS AND DEMENSIONS OF DETECTOR LOOPS ARE REQUIRED ON ALL SIGNAL LAYOUT PLAN SHEETS.

"FAR OUT" DETECTION REFERS TO LOCKING, PRESENCE TYPE DETECTION LOCATED IN THRU LANES, RIGHT TURN LANES, AND RIGHT TURN LANE TAPER AREAS (IF APPLICABLE), USUALLY 250' (75 m) IN ADVANCE OF STOP BARS. "UPTIGHT" DETECTION REFERS TO NON-LOCKING PRESENCE TYPE DETECTION LOCATED IN ALL LANES AND 10'-15' (3.0 m-4.5 m) BEHIND THE CROSSING STREET'S EDGE OF PAVEMENT EXTENDED.

NOTE:

ALL DETAILS AND NOTES SHOWN ARE FROM THE I.D.O.T. DISTRICT 1 TRAFFIC SIGNAL DESIGN GUIDELINES DATED JANUARY 1995

THIS DRAWING HAS BEEN PREPARED TO ASSIST THE RESIDENT ENGINEER FOR ALL ROADWAY RESURFACING OR S.M.A.R.T. PROJECTS WHERE THE DIMENSIONS ARE NOT SHOWN ON THE PLANS AND THE FINAL LOCATIONS FOR CROSSWALKS OR STOP BARS ARE NOT DETERMINED.

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DETAIL

N.T.5.

STATE OF ILLINOIS
DEPARTMENT OF TRANSPORTATION

DISTRICT 1 - DETECTOR LOOP INSTALLATION
DETAILS FOR ROADWAY RESURFACING

SHEET NO. 1 OF 1 SHEETS STA. TO STA.