INDEX OF SHEETS

FORT KASKASKIA SITE ENTERANCE SIGN FORT KASKASKIA PLAYGROUND AREA SPEED BUMP

STATE OF ILLINOIS

RANDOLPH 16 1 CONTRACT NO. 46003

COVER SHEET

DEPARTMENT OF TRANSPORTATION

SUMMARY OF QUANTITIES, STANDARDS, AND GENERAL NOTES SCHEDULE OF QUANTITIES

DIVISION OF HIGHWAYS

TYPICAL SECTIONS

SHEET TITLE

SHEET NO.

11-12

13

-0-0-0-0-

0

0

PROPOSED

FORT KASKASKIA CAMPGROUND ENTRANCE

FORT KASKASKIA CAMPGROUND

HIGHWAY PLANS

10 PIERRE MENARD HOME DETAILS

IDOT /IHPA STATEWIDE PIERRE MENARD/FORT KASKASKIA STATE HISTORIC SITES

14 PIERRE MENARD HOME ELECTRICAL PLANS AND NOTES 15 ELECTRICAL DETAILS AND NOTES

PIERRE MENARD EAST PARKING LOT RESTRIPING

KASKASKIA RV PARK ELECTRICAL PLANS AND NOTES

SIDEWALK AND CAMPGROUND **RANDOLPH COUNTY**

ELECTRICAL DETAILS

C-30-046-08

LEGEND

EXISTING GUARD RAIL

EXISTING ABOVE GROUND SPLICE BOX

EXISTING POWER POLE

EXISTING CONIFEROUS TREE

EXISTING DECIDUOUS TREE

EXISTING CLEAN OUT

EXISTING SIGN

EXISTING WATER VALVE

PROPOSED IMPROVEMENTS

VANSVILLE WAI SH SCHULINE STEELEVILLE ELLIS GROVE WELGE MISSOURI 4 KASKASKIA CHESTER ST. MARY ILLINOIS LITHIUM OCKWOOD MCBRIDE SERENO

PROFESSIONAL SEAL OF DAVID URY P.E. COVERS THE FOLLOWING SHEETS: 13-16

PROFESSIONAL SEALS PROFESSIONAL SEAL OF ROBERT H. DALTON P.E. COVERS THE FOLLOWING SHEETS: 1-12



FULL SIZE PLANS HAVE BEEN PREPARED USING STANDARD ENGINEERING SCALES. REDUCED SIZED PLANS WILL NOT CONFORM TO STANDARD SCALES. IN MAKING MEASUREMENTS ON REDUCED PLANS, THE ABOVE SCALES MAY BE USED.

JOINT UTILITY LOCATION INFORMATION FOR EXCAVATION 1-800-892-0123

PROJECT ENGINEER PROJECT MANAGER

CONTRACT NO. 46003

STATE OF ILLINOIS **DEPARTMENT OF TRANSPORTATION** DIVISION OF HIGHWAYS

LOCATION OF SECTION INDICATED THUS: - -

PRINTED BY THE AUTHORITY OF THE STATE OF ILLINOIS

...\250\250-061-H\SHT001.dgn 8/24/2009 2:34:48 PM

1000 1001.STATE

SUMMARY	OF QUANTITIES		
CODE #	PAY ITEM	UNITS	TOTA
20100110	TREE REMOVAL (6 TO 15 UNITS DIAMETER)	UNIT	10
20100210	TREE REMOVAL (OVER 15 UNITS DIAMETER)	UNIT	. 20
20200100	EARTH EXCAVATION	CU YD	212
	TOPSOIL FURNISH AND PLACE, VARIABLE DEPTH	SQ YD	267
	GRADING AND SHAPING DITCHES	FOOT	123
V	SEEDING, CLASS 1	ACRE	0.30
	NITROGEN FERTILIZER NUTRIENT	POUND	27
	PHOSPHORUS FERTILIZER NUTRIENT	POUND	27
	POTASSIUM FERTILIZER NUTRIENT	POUND	27
	AGRICULTURAL GROUND LIMESTONE	TON	0.60
	MULCH, METHOD 2	ACRE	0.30
	SUB-BASE GRANULAR MATERIAL, TYPE B 4"	SQ YD	255.1
	AGGREGATE BASE COURSE, TYPE B 8"	SQ YD	
	BITUMINOUS MATERIALS (PRIME COAT)	GALLON	
	AGGREGATE (PRIME COAT)	TON	0.26
	HOT-MIX ASPHALT SURFACE REMOVAL-BUTT JOINT	SQ YD	13
	HOT-MIX ASPHALT SURFACE COURSE, MIX "C", N70	TON	69.5
	PORTLAND CEMENT CONCRETE PAVEMENT 8"	SQ YD	255.1
	PAVEMENT FABRIC	SQ YD	255
	PORTLAND CEMENT CONCRETE SIDEWALK 5 INCH	SQ FT	25
	PORTLAND CEMENT CONCRETE SIDEWALK, SPECIAL	SQ FT	797
,,,	DETECTABLE WARNINGS	SQ FT	67
	SIDEWALK REMOVAL	SQ FT	25
	CURB REMOVAL (SPECIAL)	FOOT	206
	SIDEWALK REMOVAL (SPECIAL)	SQ FT	1297
	CRACK ROUTING (PAVEMENT)	FOOT	2300
	CRACK FILLING	POUND	2300
	PIPE CULVERT REMOVAL	FOOT	101
	MOBILIZATION	L SUM	1
	SIGN PANEL-TYPE 1	SQ FT	5.5
*73000100	WOOD SIGN SUPPORT	FOOT	10
	PAINT PAVEMENT MARKING - LETTERS AND SYMBOLS	SQ FT	9.2
	PAINT PAVEMENT MARKING - LINE 6"	FOOT	634
	CONDUIT IN TRENCH, 3/4" DIA., GALVANIZED STEEL	FOOT	385
	CONDUIT IN TRENCH, 1" DIA., GALVANIZED STEEL	FOOT	70
	CONDUIT IN TRENCH, 3/4" DIA., PVC	FOOT	150
	CONDUIT IN TRENCH, 1" DIA., PVC	FOOT	460
	EXECTRIC CABLE IN CONDUIT, 600V (XLP-TYPE USE) 3-1/C NO. 6	FOOT	270
	ELECTRIC CABLE IN CONDUIT, 600V (XLP-TYPE USE) 3-1/C NO. 8	FOOT	435
	TRENCH AND BACKFILL FOR ELECTRICAL WORK	FOOT	
	ELECTRIC CABLE IN TRENCH, 600V (XLP-TYPE USE) 1/C NO. 2	FOOT	2810
	ELECTRIC CABLE IN TRENCH, 600V (XLP-TYPE USE) 1/C NO. 2/0	FOOT	772
	ELECTRIC CABLE IN TRENCH, 600V (XLP-TYPE USE) 1/C NO. 4/0	FOOT	10914
	TREE, QUERCUS PALUSTRIS (PIN OAK), 1-1/2" CALIPER, BALLED AND BURLAPPED	EACH	2
	POWER DISTRIBUTION CENTER, PEDESTAL MOUNT	EACH	24
	CHARCOAL PEDESTAL GRILL	EACH	1
	REMOVE EXISTING LIGHTING SYSTEM	L SUM	1
	BOLLARDS	EACH	2
	SIGN REMOVAL	EACH	2
	LIGHTING SYSTEM COMPLETE	L SUM	1
	MINOR SIGN COMPLETE		2
		EACH	
	CUT STONE CAP	SO FT	5
* XXUU5944	FLOOD LIGHT, GROUND MOUNTED, 175 WATTS, METAL HALIDE	EACH	6
	REMOVE AND RESET BUMPER BLOCKS	EACH	13

* SPECIALTY ITEMS

FILE NAME = USER NAME = #USER# DESIGNED - T.T.P. REVISED - 7/8/09 #FILEL# | DRAWN - S.D.K. REVISED - 8/24/09 | PLOT SCALE = #SCALE# CHECKED - R.H.D. REVISED - PLOT DATE = #0ATE# DATE - 2/3/09 REVISED - |

STATE OF ILLINOIS DEPARTMENT OF TRANSPORTATION

SUMMARY OF QUANTITIES, STANDARDS, & GENERAL NOTES PIERRE MENARD/FORT KASKASKIA STATE HISTORIC SITES SHEET NO. 2 OF 16 SHEETS STA. TO STA.

LIST OF STANDARDS

420701-02 PAVEMENT FABRIC

424001-05 CURB RAMPS FOR SIDEWALKS

701301-03 LANE CLOSURE, 2L, 2W, SHORT TIME OPERATIONS

701901-01 TRAFFIC CONTROL DEVICES

BLR17-4 TRAFFIC CONTROL DEVICES - DAY LABOR CONSTRUCTION

GENERAL NOTES

- 1) ALL ELEVATIONS ARE REFERENCED TO ELEVATIONS ESTABLISHED BY VASCONCELLES ENGINEERING CORP.
- WHERE SECTION OR SUBSECTION MONUMENTS ARE ENCOUNTERED.
 THE ENGINEER SHALL BE NOTIFIED BEFORE SUCH MONUMENTS ARE
 REMOVED. THE CONTRACTOR SHALL PROTECT AND CAREFULLY
 PRESERVE ALL PROPERTY MARKERS AND MONUMENTS UNTIL THE
 OWNER AND AUTHORIZED SURVEYOR OR AGENT HAS WITNESSED OR
 OTHERWISE REFERENCED THEIR LOCATION. IF THE ENGINEER DECIDES
 TO HAVE THE CONTRACTOR RESET THE MONUMENT, THIS WORK WILL
 BE PAID FOR IN ACCORDANCE WITH ARTICLE 109.04.
- 3) THE CONTRACTOR SHALL CONTACT J.U.L.I.E. PRIOR TO ANY EXCAVATION TO HAVE ALL PUBLIC AND PRIVATE UTILITIES LOCATED.
- 4) THE CONTRACTOR SHALL BE RESPONSIBLE FOR PROTECTING UTILITY PROPERTY FROM CONSTRUCTION OPERATIONS AS OUTLINED IN ARTICLE 107.26 OF THE STANDARD SPECIFICATIONS. THE J.U.L.I.E. NUMBER IS (800) 892-0123. A MINIMUM OF 48 HOURS ADVANCE NOTICE IS REQUIRED. SEE SPECIAL PROVISIONS FOR STATUS OF UTILITIES, WITH UTILITY COMPANIES LISTED.
- 5) ANY REFERENCE TO THE STANDARDS THROUGHOUT THE PLANS SHALL BE INTERPRETED TO BE THE LATEST STANDARDS OF THE DEPARTMENT AS INCLUDED IN THE PLANS.
- 6) ALL DETAILS IN THE PLANS SHALL GOVERN CONSTRUCTION OF THIS PROJECT, AND IN CASE OF CONFLICT WITH ANY STANDARD DRAWINGS INCLUDED, THE SAID DETAILS SHALL TAKE PRECEDENCE AND GOVERN.
- 7) SITE RANGER FOR FORT KASKASKIA IS CHESTER WINGERTER.
- 8) SITE ADMINISTRATOR FOR PIERRE MENARD IS ANDREW COOPERMAN.

	SIGNIN	S SCHEDULE				
LOCATION	MESSAGE	MUTCD NO.	WOOD SIGN SUPPORT	SIGN PANEL T-1	MINOR SIGN COMP.	SIGN REMOVAL
			(FOOT)	(SQ FT)	(EACH)	(EACH)
PIERRE MENARD EAST PARKING LOT STA. 54+88, 106' LT STA. 54+88, 122' LT	\$250 FINE \$250 FINE	R7-I101 R7-I101		0.5 0.5		-
PIERRE MENARD WEST SIDEWALK SITE OFFICE STA. 49+39.39, 73.71' LT			10	2.25 2.25		
FORT KASKASKIA SITE ENTRANCE STA. 12+70, 25' RT	WELCOME SIGN				1	1
CAMPGROUND ENTRANCE STA. 9+33, 7' RT	WELCOME SIGN				1	1
TOTAL=			10	5.5	2	2

RANDOLPH 16 2 CONTRACT NO. 46003

...\250\250-061-H\sht002.dgn 8/24/2009 2:33:07 PM

						PAVING S	CHEDULE									
LOCATION	EARTH EXCAVATION	BIT MATLS PR CT	AGG PR CT	HMA SC "C" IL-9.5 N70	AGG BASE CSE B 8	BASE CSE REMOV SPL	PAVEMENT FABRIC	PC CONC SIDEWALK 5	PC CONC SIDEWALK SPC	DETECTABLE WARNINGS	PC CONC PAVEMENT 8"	SUB-BASE GRAN MAT'L TYPE B 4"	HMA SURF REM BUTT JT	REM RESET BUMPER BLKS	CRACK ROUTING	CRACK FILLING
	(CU YD)	(GALLONS)	(TON)	(TON)	(SQ YD)	(SQ YD)	(SQ YD)	(SQ FT)	(SQ FT)	(SQ FT)	(SQ FT)	(SQ FT)	(SQ YD)	(EACH)	(FOOT)	(POUND)
FORT KASKASKIA CAMPGROUND											-			_		
11+83.06	13	22.8		6.8	48.2					-				1		
12+29.58	15	25.2		7.5	55.3								1	1		
12+83.88	1	1.1		0.3	3.1									1		
13+20.26	1	1.1		0.3	3.0									1		
13+68.15	16	26.8	l	8.0	59.1								1	1		
14+16.20	1	1.1		0.3	3,2					1		1		1		
14+30.53	15	20.4		6.1	55.1								1.5	1		
14+74.26	16	21.3		6.4	57.6	1				1				1		
15+34.89	19	26.0		7.7	70.1	1				1		İ	-	1		
15+85.14	1	1.2		0.3	3.2							į		1		
16+21.51	17	23.8	l	7.1	64.1	1								1		
16+73.66	1	1.1		0.3	3.1	1										
15+88 TO 16+06	24	34.6	0.24	15.5	97.1					ļ						
EXISTING ADA PAD								1						1		
NEW ADA PAD	71						255	25		67	255.1	255.1		1		
PARK ROAD AT PLAYGROUND AREA	1	5.5	0.02	2.9	2.2	1							13			
MENARD HOME								1								
STA. 49+36, 68.50' LT TO 51+22.20, 87.68' LT							_	1	690							
STA. 49+47, 30' LT						1			107							
STA. 51+74, 33' LT TO 51+73, 78' LT						228		1								
ENTIRE PROJECT															2300	2300
							<u> </u>					ļ				*
TOTAL =	212	212	0.26	69.5	524.4	228	255	25	797	67	255.1	255.1	13	13	2300	2300

					ELEC1	TRICAL I	TEMS							
LOCATION (STATION TO STATION)	CON T 3/4 GALVS	CON T 1 GALVS	CON T 3/4 PVC	CON T 1 PVC	EC C XLP USE 3-1C 6	EC C XLP USE 3-1C 8	TR & BKFIL F ELECT WK	EC T XLP USE 1C 2	EC T XLP USE 1C 2/0	EC T XLP USE 1C 4/0	REM EX LIGHTING SYSTEM	F L GR M 175W MET HAL	POWER DISTRI CENTER	LIGHTIN SYSTEM COMPLE
	(FOOT)	(FOOT)	(F00T)	(FOOT)	(FOOT)	(FOOT)	(FOOT)	(FOOT)	(FOOT)	(FOOT)	(L SUM)	(EACH)	(EACH)	(L SUM
FORT KASKASKIA COMAPGROUND							2580	2810	772	10914				
10+47.67, 40.17' RT													1	
1+03.17, 37.25 RT						İ							1	
1+42, 28' RT													1	
1+91.08, 22.08' RT													1	
2+18.92, 16.42' RT													1	
2+62.92, 16.17' RT													1	
3+10.67, 13.17' RT													1	
3+59.25, 6.58' RT													1	
4+02.58, 10.25' RT		,											1	
4+44.75, 14.25' RT				ļ									1	
4+79.83, 13.50' RT				1									1	
5+32.58, 7.50' RT													1	
1+44, 143' RT													1	
2+03, 144' RT					İ								1	l
2+53, 153' RT													1	
2+92, 137' RT													1	
3+39, 145' RT													1	
3+97**, 121' RT													1	
4+36, 136' RT					1								1	
4+53**, 129' RT													1	
5+08, 172' RT													1	
5+68, 166' RT										ľ			1	
6+19*, 149' RT													1	
6+57, 130' RT													1	
IERRE MENARD HOME	385	70	150	460	270	435	650				1			1
0+15.83, 170.33 LT	000	'	100								•	2		
1+49.50, 28.25' LT												1		
2+02.67, 32.83' LT]								1		
52+69.25, 175.08' LT				1		1						2		
						1								
								-						
				l .										ļ
TOTAL =	385	70	150	460	270	435	3230	2810	772	10914	1	6	24	1

REVISED - 7/8/09
REVISED - 8/24/09

REVISED -

DESIGNED - T.T.P.
DRAWN - S.D.K.

CHECKED - R.H.D.

DATE - 2/3/09

USER NAME = \$USER\$

PLOT SCALE = \$SCALE\$
PLOT DATE = \$DATE\$

STATE	OF	: ILLINOIS	
DEPARTMENT	OF	TRANSPORTATION	

TOTAL =

										8
	SCHEDULE OF Q	UANTITIES		F.A. RTE.	SE	CTION	COUNTY	TOTAL	SHEET NO.	320
PIE	RRE MENARD/FORT KASKASKI	ISTORIC SITES				RANDOLPH	16	3	o	
							CONTRACT	NO. 46	003] z
SCALE:	SHEET NO. 3 OF 16 SHEETS	STA.	TO STA.	FED. RO	AD DIST. NO.	ILLINOIS FED. A	D PROJECT			ļģ
										•

267 123 0.30 27

MISCELLANEOUS SCHEDULE						
LOCATION	T-QUERCUS PALUS 1-1/2		BOLLARDS	CUT STONE CAP		
	(EACH)	(EACH)	(EACH)	(SQ. FT.)		
MENARD HOME						
STA. 51+74, 30' LT - STA. 51+81, 31' LT				5		
FORT KASKASKIA CAMPGROUND						
ADA PAD	2	1	2			
TOTAL =	2	1	2	5		

PAVEMENT MARKING S	CHEDULE	
LOCATION	PT PVT MK LTRS & SYMB	PAINT PVT MK LINE 6
	(SQ. FT.)	(FOOT)
PIERRE MENARD EAST PARKING LOT BUS STALL STRIPING CAR STALL STRIPING NEW ADA STALL STRIPING FORT KASKASKIA CROSSWALK, NEW AND EXISTING ADA PADS	9.2	10 160 234 107
TOTAL =	9.2	634
NOTE: <u>LETTERS AND SYMBOLS</u> HANDICAP SYMBOL = 4.6 SQ	FT	-

27

27 0.60 0.30


	RE	MOVAL I	TEMS			
LOCATION (STATION)	TREE REMOV 6 TO 15	TREE REMOV OVER 15	CURB REMOVAL (SPL)	SIDEWALK REM	SIDEWALK REM (SPECIAL)	PIPE CULVERT REMOV
	(UNIT)	(UNIT)	(FOOT)	(SQ FT)	(SQ FT)	(FOOT)
CAMPGROUND AREA ADA PAD	10	20		25	-	
MENARD HOME						1

	(UNIT)	(UNIT)	(FOOT)	(SQ FT)	(SQ FT)	(FOOT)
CAMPGROUND AREA ADA PAD	10	20		25		
MENARD HOME						
STA. 49+52, 39' LT TO 51+74, 33' LT					815	
STA. 51+63, 29' LT TO 51+93, 15' LT					170	
STA. 51+74, 33' LT TO 51+73, 78' LT		-			312	
STA. 51+47, 10' RT TO 52+16, 9' RT			206		1	71
STA. 51+63, 29' LT TO 51+93, 15' LT						30
TOTAL =	10	20	206	25	1297	101

		SEEDING	SCHEDU	_E				. [
LOCATION (STATION TO STATION)	TOPSOIL F & P VAR DP	GRADING & SHAP DITCH	SEEDING CL 1	NITROGEN FERT NUTR	PHOSPHORUS FERT NUTR	POTASSIUM FERT NUTR	AGR GROUND LIMESTONE	MULCH METHOD 2
	(SQ YD)	(FOOT)	(ACRE)	(LBS.)	(LBS.)	(LBS.)	(TON)	(ACRE)
MENARD HOME STA. 49+30, 35' LT TO 51+22, 88' LT	122							
STA. 49+52, 39' LT TO 51+74, 33' LT	91							
STA. 51+63, 29' LT TO 51+93, 15' LT	19	·						
STA. 51+73, 78' LT TO 51+78, 30' LT	. 35							
STA. 51+41, 9' RT TO 52+21, 10' RT	·	80						
STA. 51+59, 18' LT TO 52+02, 17' LT		43						
ENTIRE SITE			0.19	17	17	17	0.38	0.19
FORT KASKASKIA CAMPGROUND ENTIRE SITE		·	0.11	10	10	10	0.22	0.11

FILE NAME =


\$FILEL\$

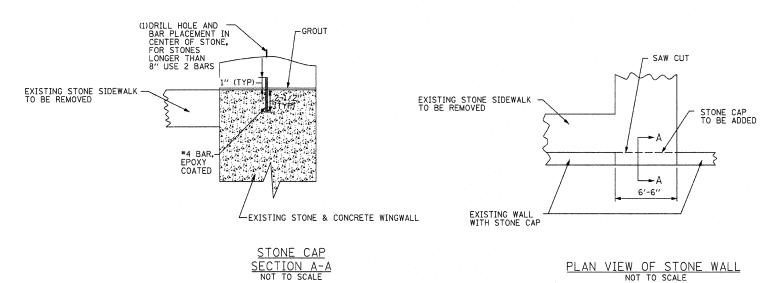

MIXTURES USE(S):	BITUMINOUS SURFACE					
AC/PG	PG 64-22					
RAP% (MAX)	10%					
DESIGN AIR VOIDS	4.0% @ N DESIGN 70					
MIX COMP	IL 9.5					
FRICTION AGG.	MIX C					

PRIME APPLI	CATION RATES
BIT MATLS PR CT	AGG PRIME COAT
0.375 GAL/ SQ YD	5 LB/ SQ YD


MIXES AND APPLICATION RATE TABLES

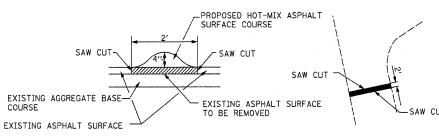

SPEED BUMP DETAIL


NOT TO SCALE

(D) (E)

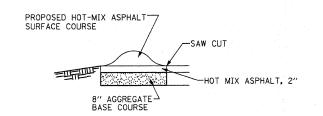


FLAGSTONE PAVED WALK SET IN MORTAR BED, 3/4" MIN. SETTING 3" MORTAR SETTING BED 4" CONC. REINFORCED WITH 6×6×W1.4×W1.4 W.W.F. 3000000 4 4" SUB-BASE GRANULAR MATERIAL TYPE B

PORTLAND CEMENT CONCRETE SIDEWALK SPECIAL

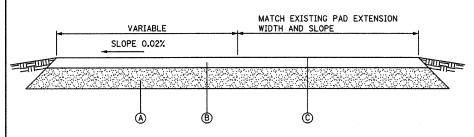

- PROPOSED 8" AGGREGATE BASE COURSE TYPE B
- PROPOSED HOT-MIX ASPHALT SURFACE COURSE, MIX C, N 70, 2" MATCH EXISTING CAMPER PAD WIDTH & SLOPE

EXTENSIONS OF CAMPER PADS AND PICNIC AREA

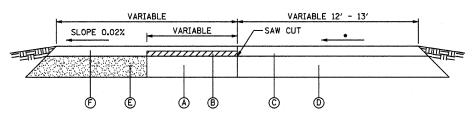

- SLOPE VARIES
- EXISTING AGGREGATE PICNIC AREA

PLAN VIEW OF STONE WALL
NOT TO SCALE

- EXISTING AGGREGATE PICNIC AREA TO BE REMOVED
- EXISTING HOT-MIX ASPHALT SURFACE COURSE
- EXISTING AGGREGATE BASE COURSE
- PROPOSED 8" AGGREGATE BASE COURSE TYPE B PROPOSED HOT-MIX ASPHALT SURFACE COURSE, MIX C, N70, 2"

SLOPE VARIES

- SAW CUT

- SLOPE TO MATCH EXISTING ROAD
- EXISTING AGGREGATE BASE COURSE
- EXISTING HOT-MIX ASPHALT BINDER COURSE 11/2" EXISTING HOT-MIX ASPHALT SURFACE COURSE 11/2"

CAMPGROUND ROAD

- PROPOSED 8" AGGREGATE BASE COURSE TYPE B
- PROPOSED HOT-MIX ASPHALT SURFACE COURSE, MIX C, N 70, 3"


WIDENING OF PICNIC AREAS AT EXISTING CAMPER PAD AREA


FILE NAME =	USER NAME = \$USER\$	DESIGNED -	R.H.D.	REVISED -	8/24/09	
\$FILEL\$		DRAWN -	J.H.F.	REVISED -	•	
	PLOT SCALE = \$SCALE\$	CHECKED -	T.T.P.	REVISED -		DEP/
	PLOT DATE = \$DATE\$	DATE -	8/1/08	REVISED -	•	


STATE OF ILLINOIS PARTMENT OF TRANSPORTATION

TYPICAL SECTIONS	F.A. SECTION COUNTY TOTAL SHEET NO.
PIERRE MENARD/FORT KASKASKIA STATE HISTORIC SITES	RANDOLPH 16 4
TIEINE MENTINETON INTOINTOINT OFFIE	CONTRACT NO. 46003
SCALE: 1"=20' SHEET NO. 4 OF 17 SHEETS STA. TO STA.	FED. ROAD DIST. NO. ILLINOIS FED. AID PROJECT

...\250\250-061-H\sht004.dgn 8/24/2009 2:28:44 PM

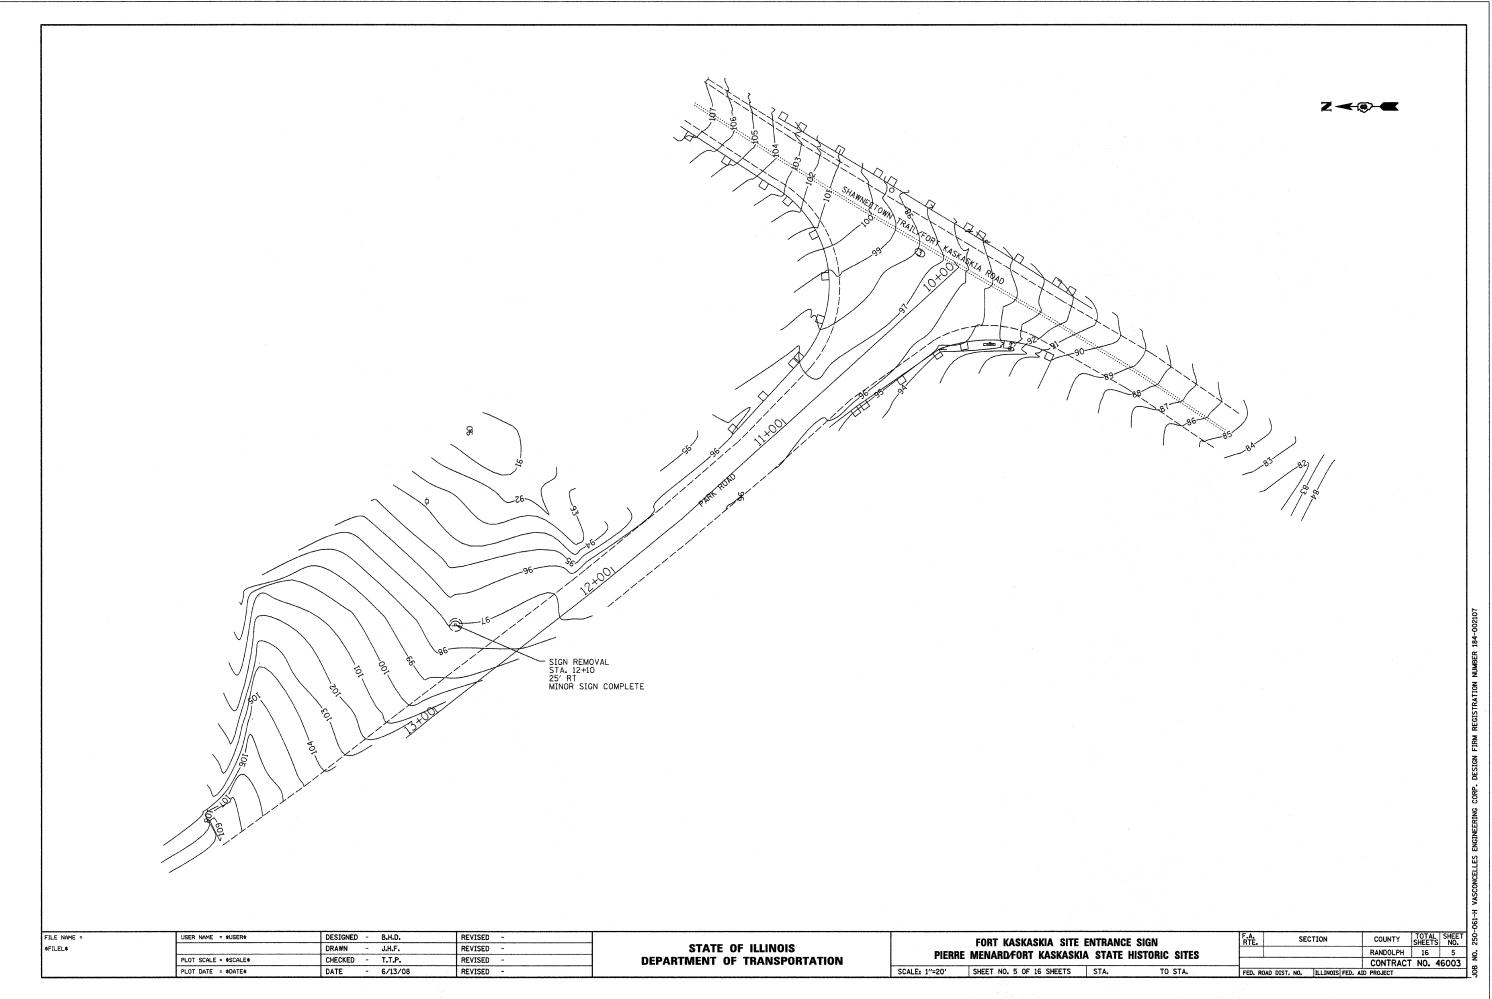

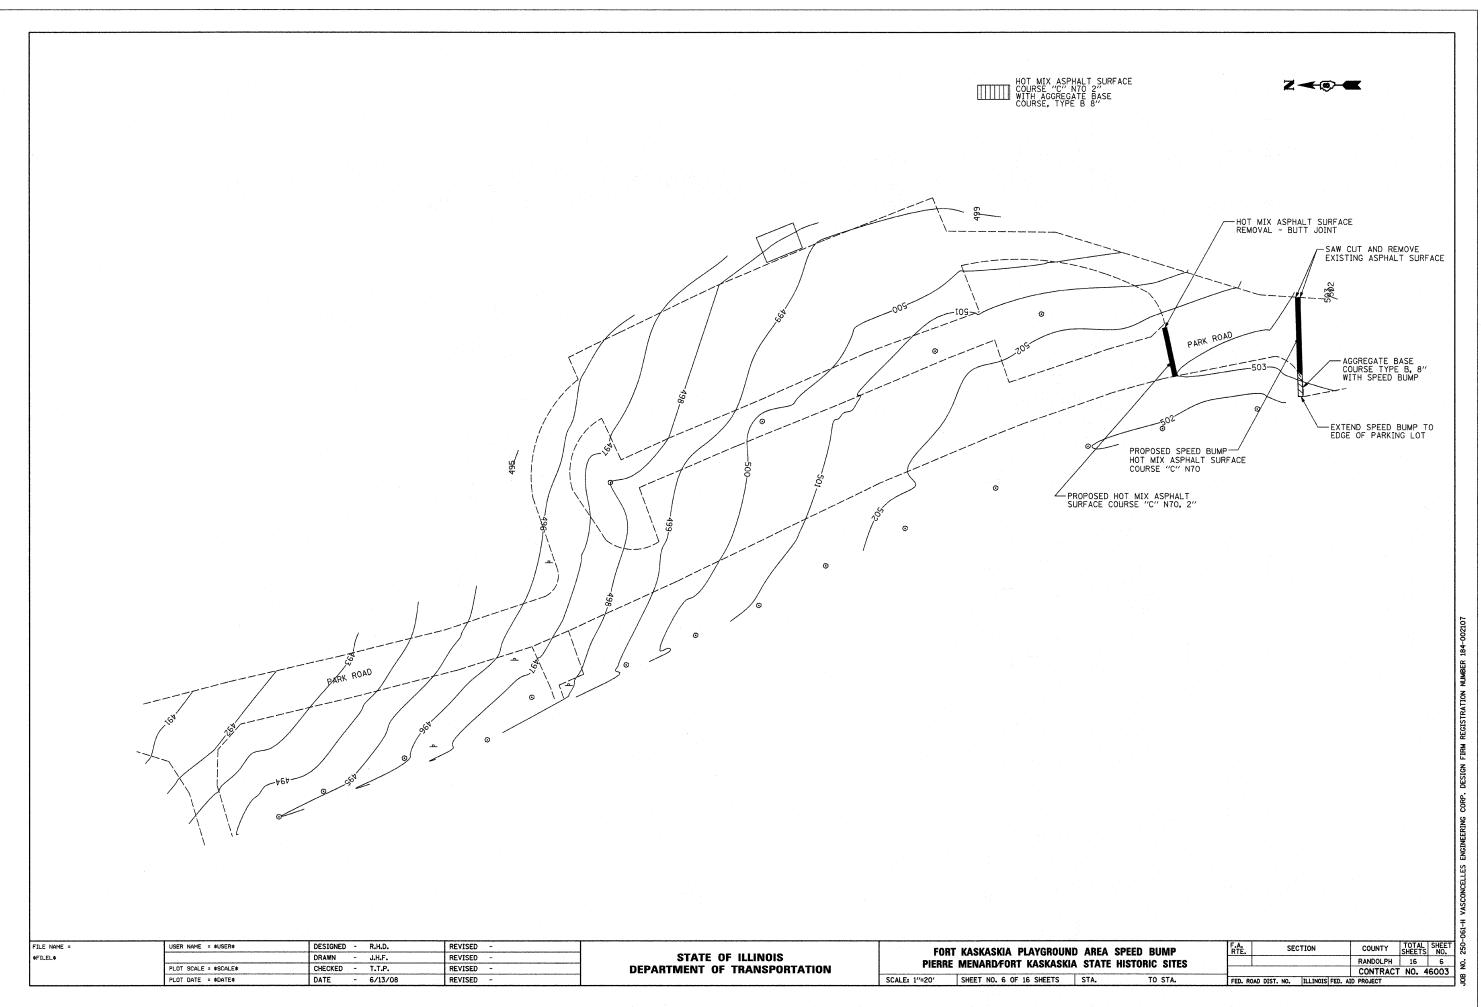

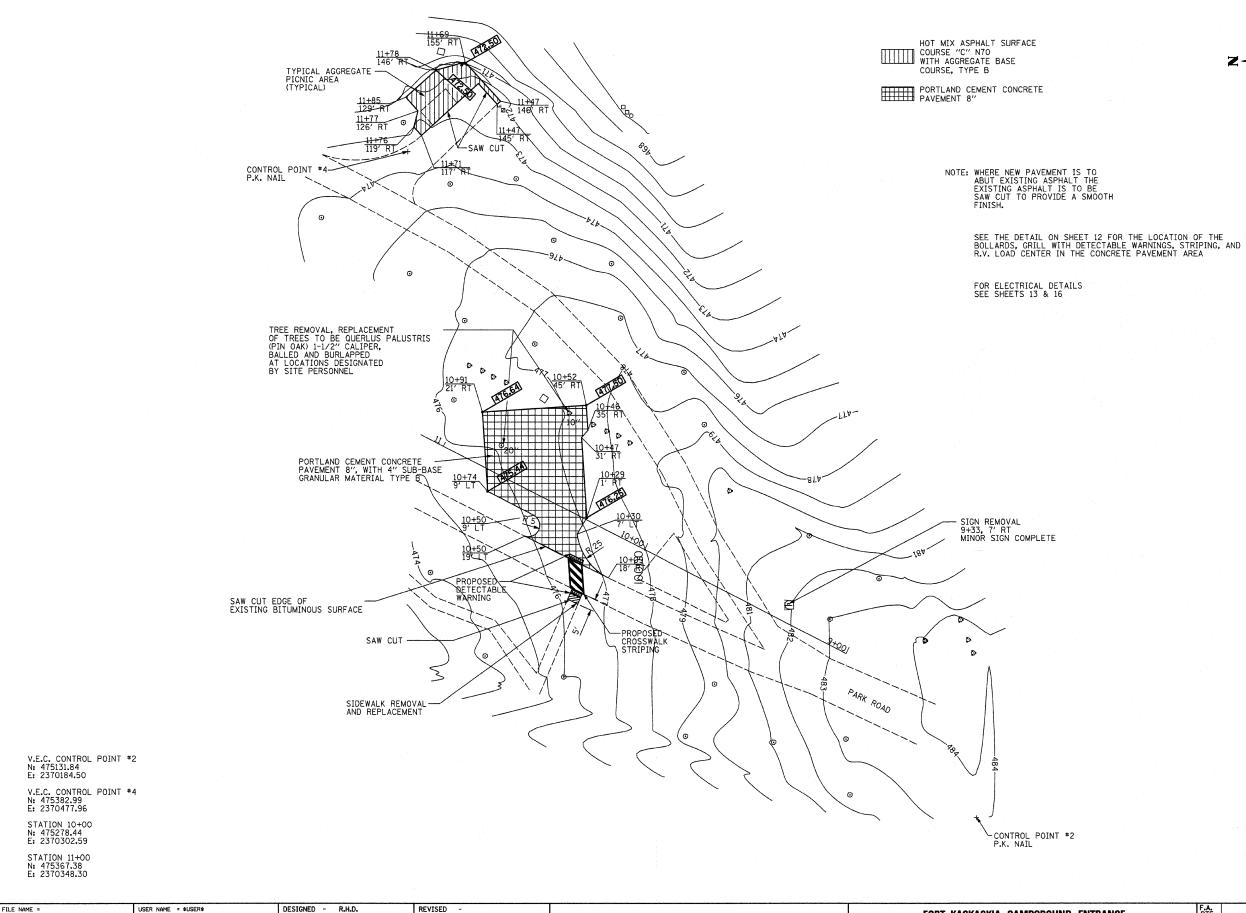

STATE OF ILLINOIS

DEPARTMENT OF TRANSPORTATION

FORT KASKASKIA CAMPGROUND ENTRANCE
PIERRE MENARD/FORT KASKASKIA STATE HISTORIC SITES

SCALE: 1"=20' SHEET NO. 7 OF 16 SHEETS STA. TO STA.

F.A. SECTION COUNTY SHEETS NO.

RANDOLPH 16 7

CONTRACT NO. 46003

...\250\250-061-H\sht007.dgn 8/24/2009 2:23:00 PM

\$FILEL\$

DRAWN

DATE

PLOT SCALE = #SCALE#

PLOT DATE = \$DATE\$

- J.H.F.

- 6/13/08


CHECKED - T.T.P.


REVISED -


REVISED -


REVISED


Z-®--

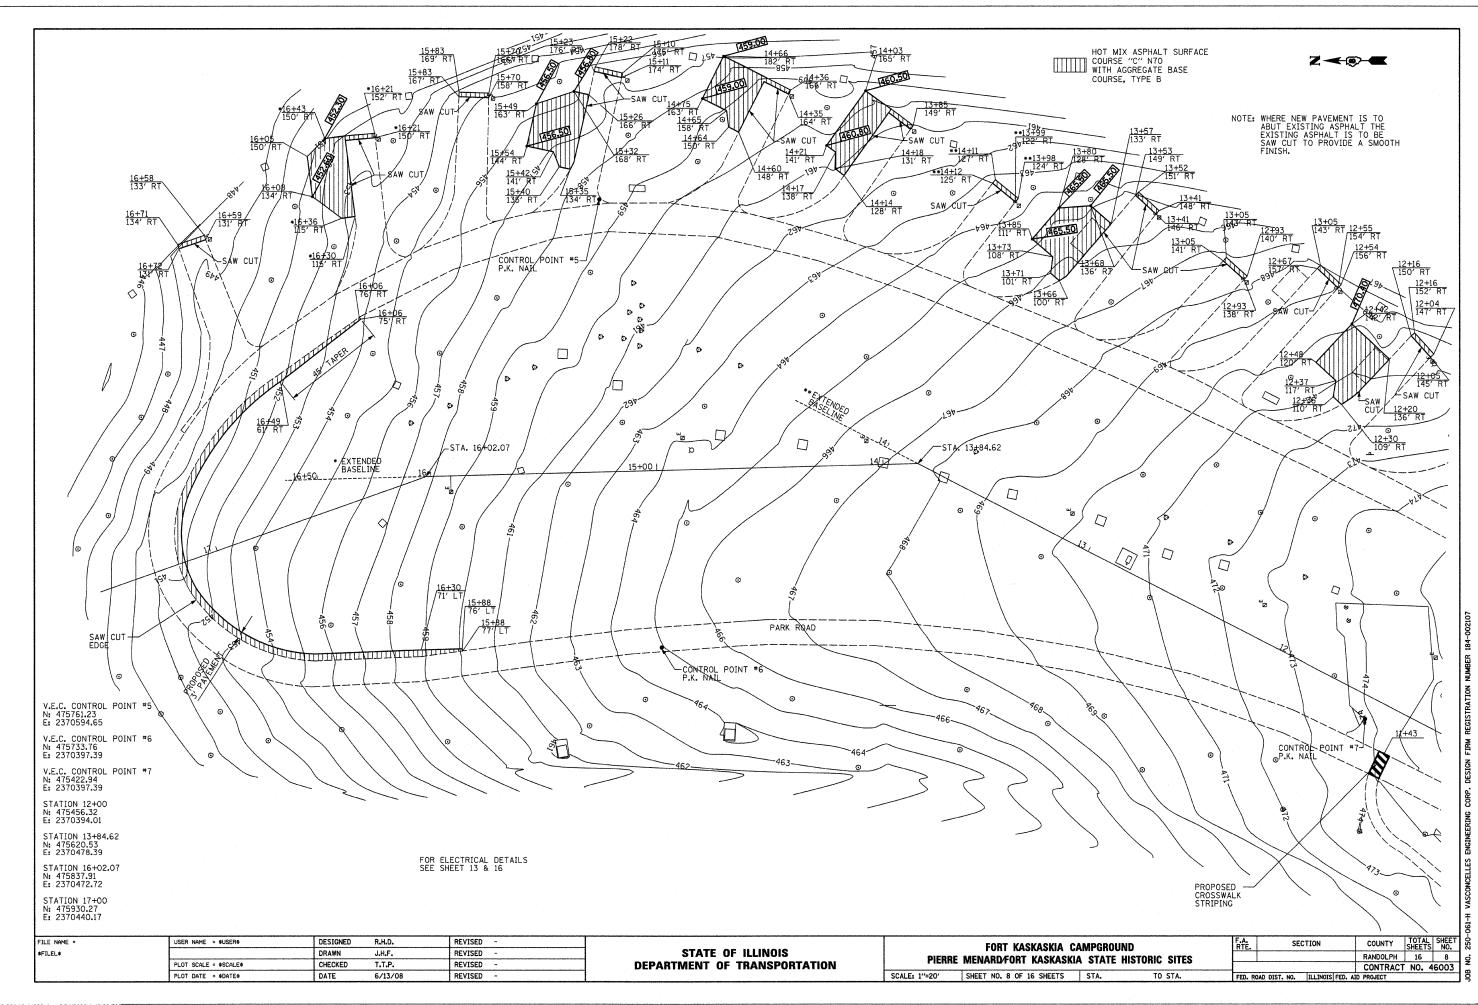

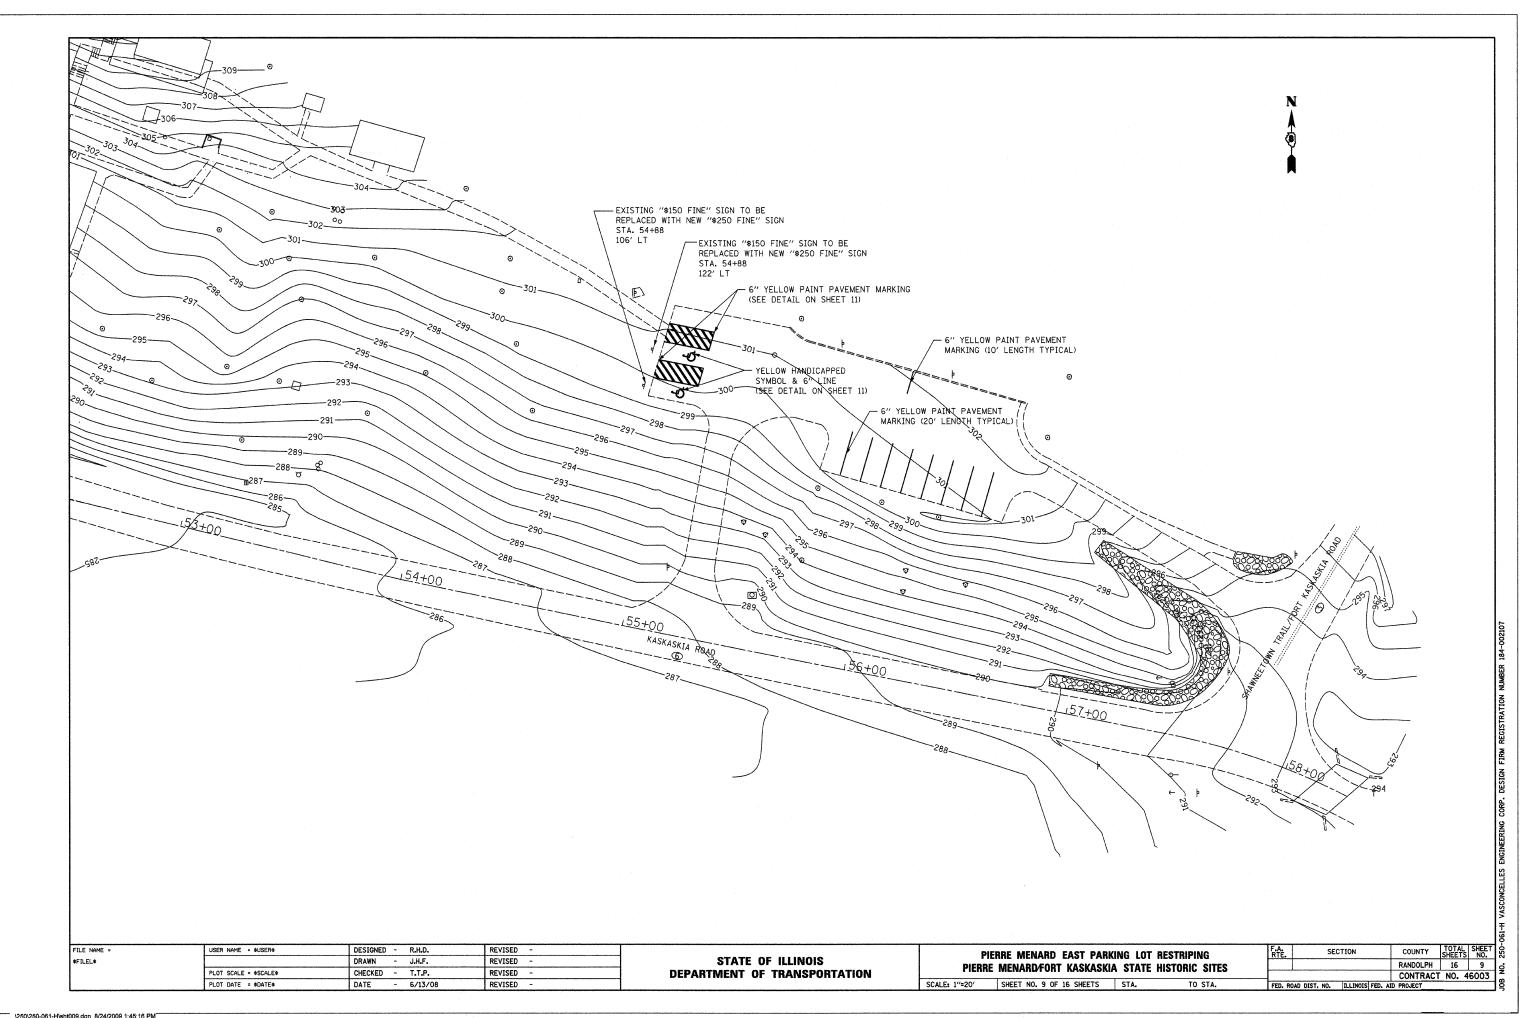


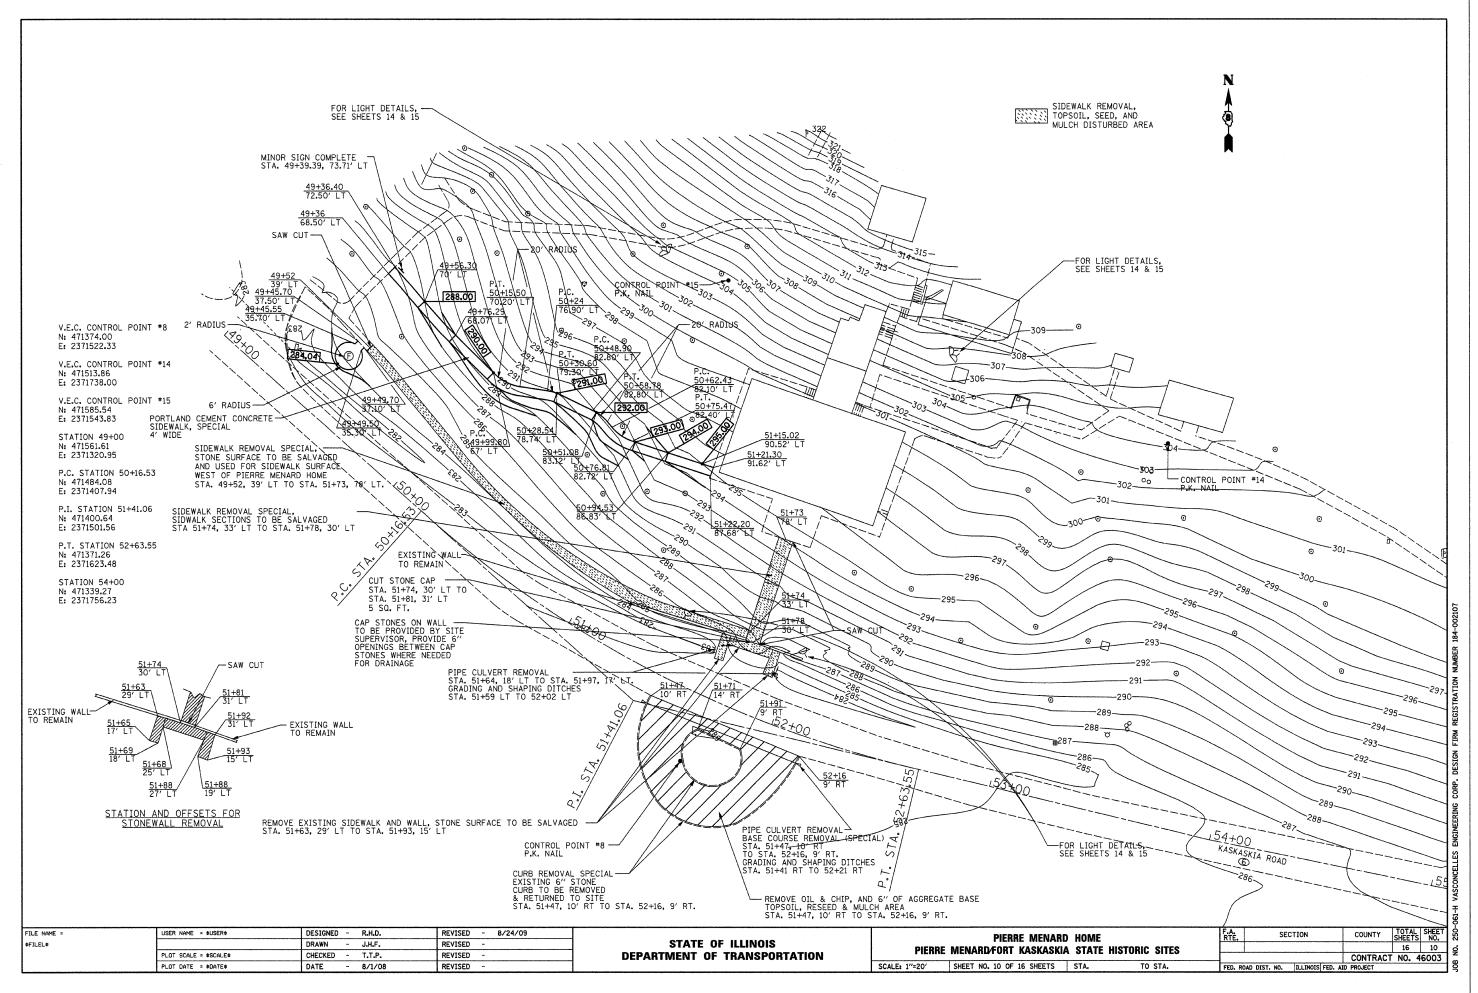

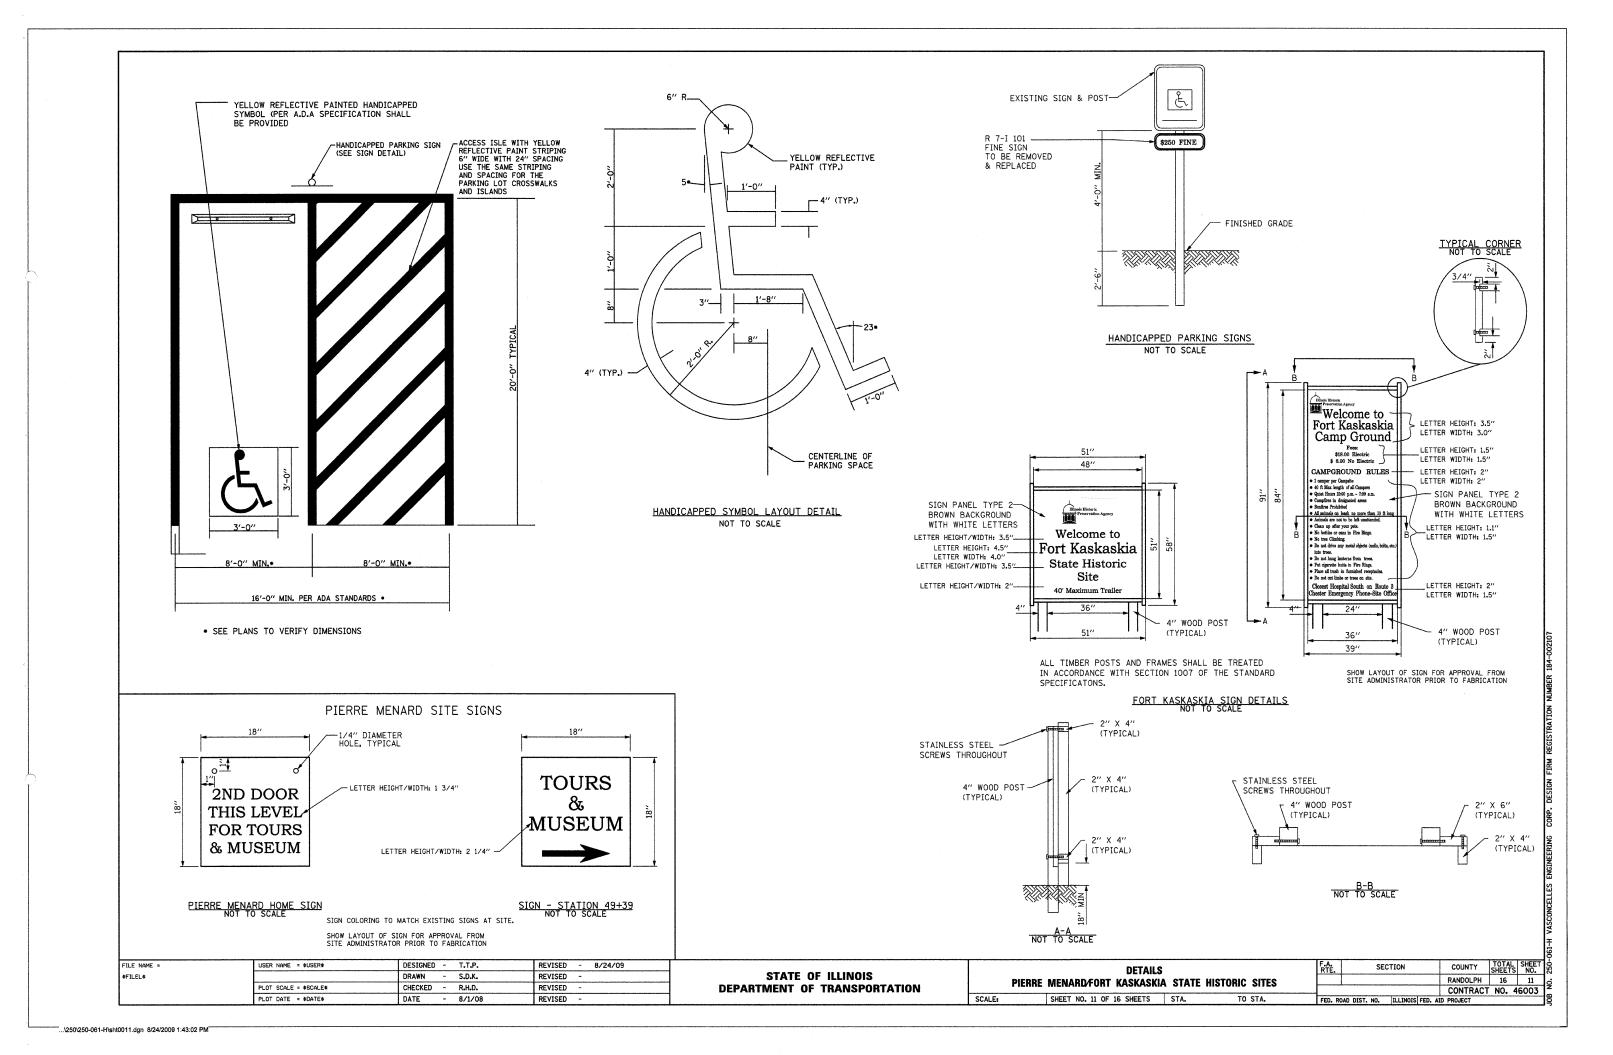


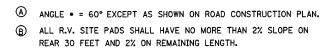

- © CONTRACTOR SHALL COORDINATE THEIR WORK FOR R.V. PEDESTAL LOCATION RELATIVE TO CAP PAD CENTERLINE AND REAR OF THE R.V. STAND ACCORDING TO THESE DWG. AND NEC 551-76d
- D NO R.V. SITE PAD SHALL BE CLOSER THAN 10' FROM ANY OTHER ONE.
- © GRILL (BLACK)
- F RESET BUMPER BLOCKS (TIMBER) TO BE INSTALLED
 AS SHOWN. SECURE TO CAMP PAD WITH 3/4" REBAR 36" LONG,
 SINK REBAR 1" BELOW TOP OF BUMPER. 3 REQUIRED PER BUMPER AT 3'-6" CENTERS.
- @ DESIGNATED R.V. PARKING PAD AREA WITH A 6" WIDE PAINTED YELLOW LINE.

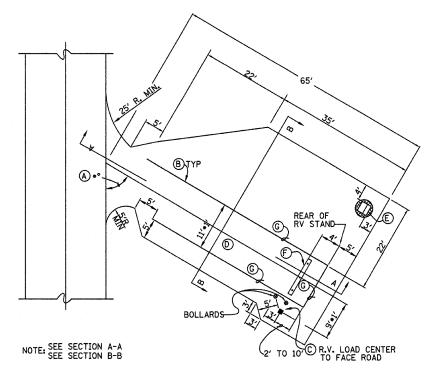


TYPICAL HANDICAP BACK IN CAMPSITE
NOT TO SCALE

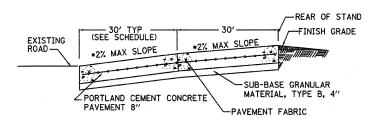


SECTION A-A (NEW CONSTRUCTION)
NOT TO SCALE



SECTION B-B (NEW CONSTRUCTION)
NOT TO SCALE

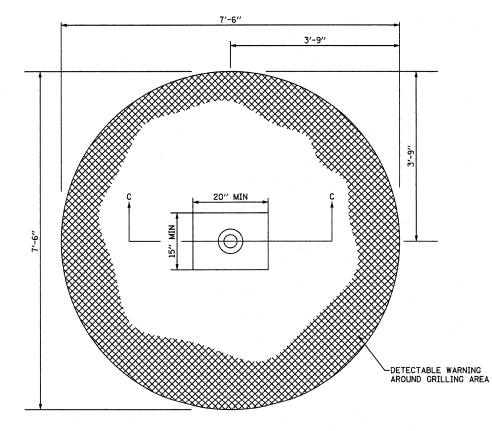


GRILL AREA

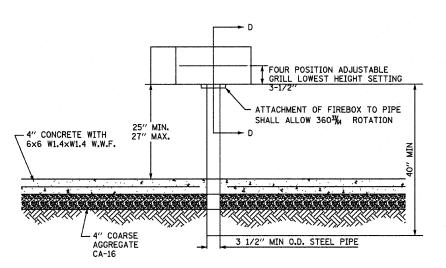

SECTION C-C

THE COOKING GRATE, 300 SQUARE INCHES MINIMUM, SHALL BE CONSTRUCTED OF 1/2" OR LARGER DIAMETER A-36 STEEL BARS ON 1-1/8" CENTERS.


ALL CONNECTIONS, HARDWARE, AND ANCHORING SHALL BE IN ACCORDANCE WITH THE MANUFACTURER'S RECOMMENDATIONS.

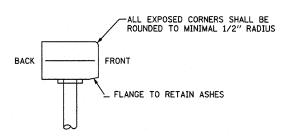


THE BACK, SIDES, AND BOTTOM OF THE FIREBOX SHALL BE 3/16" PLATE STEEL THE FRONT SHALL BE OPEN THE ENTIRE UNIT SHALL BE FINISHED IN HIGH TEMPERATURE, HEAT RESISTANT, NON-TOXIC BLACK ENAMEL


SECTION D-D NOT TO SCALE

FILE NAME =	USER NAME = \$USER\$	DESIGNED -	T.T.P.	REVISED -			DETAILS			F.A.	SECTION	COUNTY
\$FILEL\$		DRAWN -	S.D.K.	REVISED -	STATE OF ILLINOIS	PIERRE MENARD/FORT KAKSKASKIA STATE HISTORIC SITE				1111-1		TANDALPH
	PLOT SCALE = \$SCALE\$	CHECKED -	R.H.D.	REVISED -	DEPARTMENT OF TRANSPORTATION	Pi	IERHE MENAKU/FURI KAKSKASK	IA SIAIE	HISTORIC SITE			CONTRACT
	PLOT DATE = \$DATE\$	DATE -	8/24/09	REVISED -		SCALE:	SHEET NO. 12 OF 16 SHEETS	STA.	TO STA.		ILLINOIS FED. A	
•												***************************************

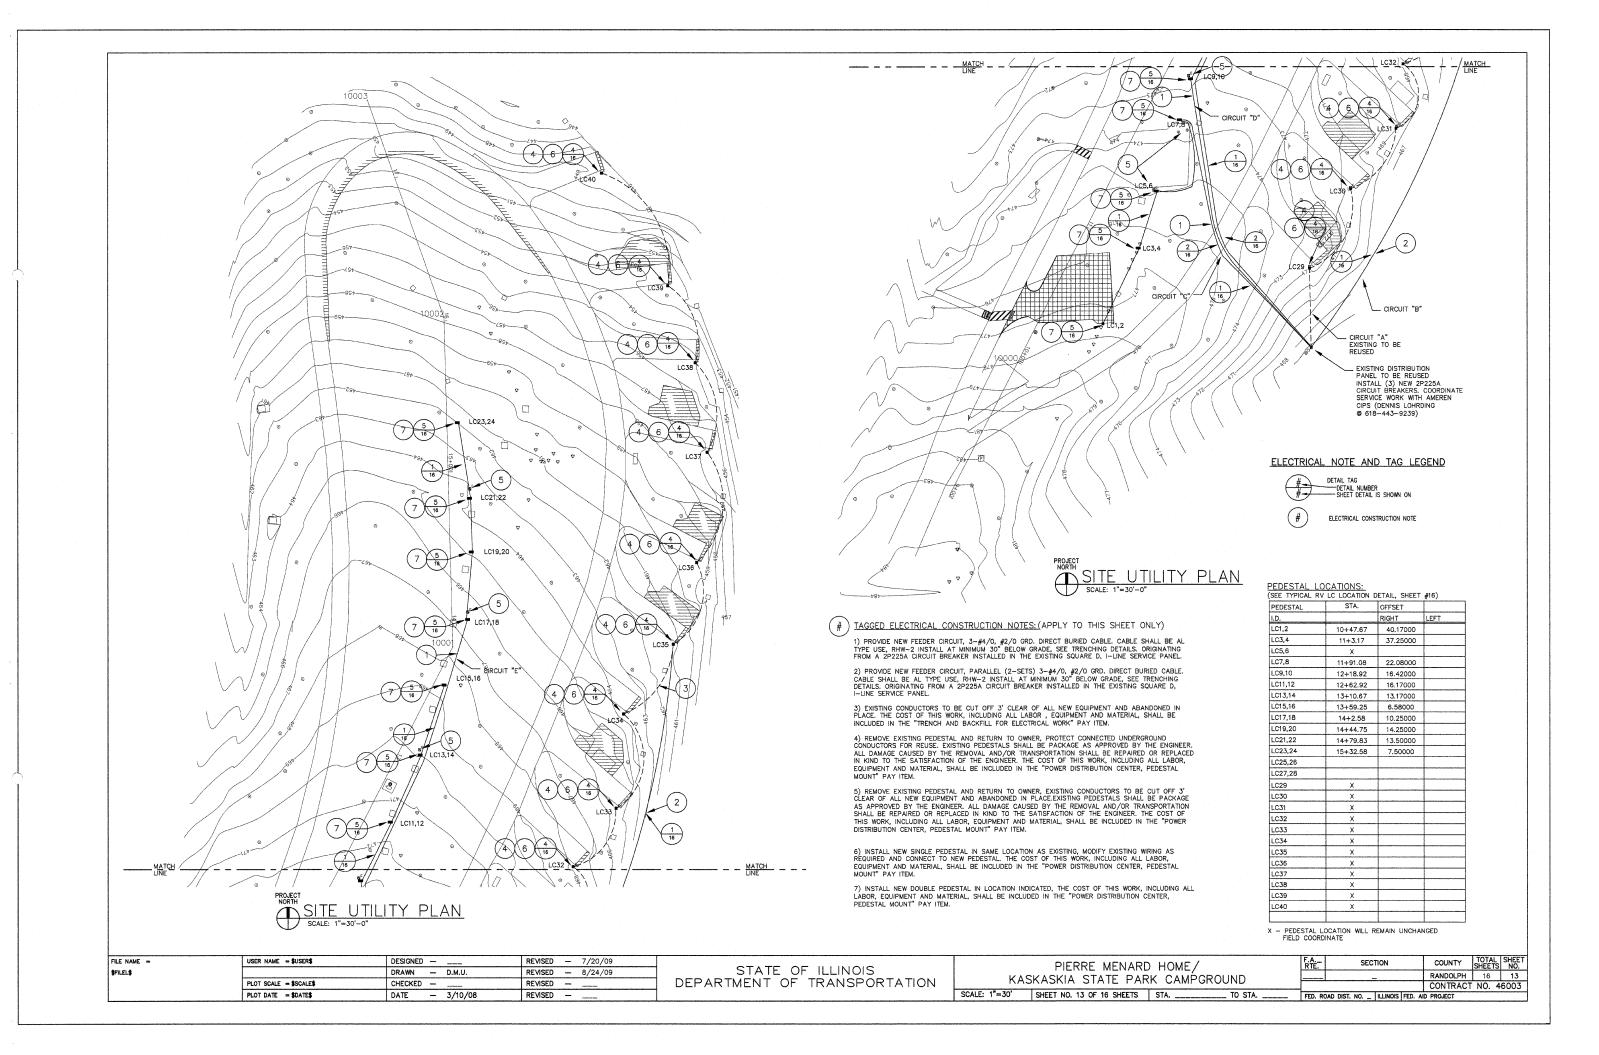

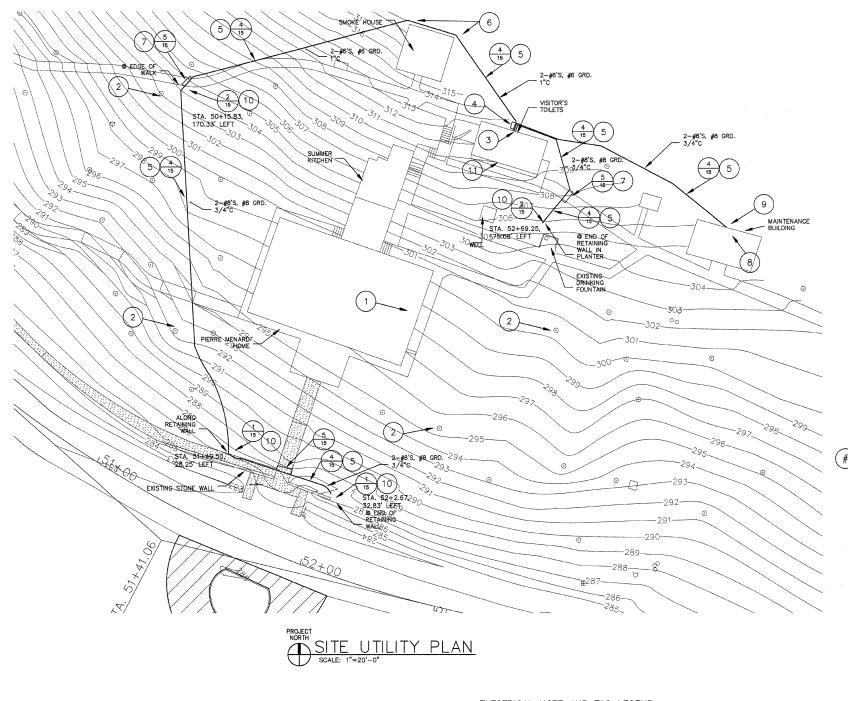

ELECTRICAL NOTE AND TAG LEGEND

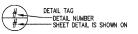

ELECTRICAL CONSTRUCTION NOTE

D— FIXTURE, AND BASE AS DETAILED

GENERAL ELECTRICAL CONSTRUCTION NOTES:


- 1) CONTRACTOR SHALL CUT AND PATCH AS REQUIRED DURING THE COURSE OF INSTALLATION OR AS SPECIFIED ON THE DRAWINGS.
- 2) ALL NEW ELECTRICAL WORK SHALL BE INSTALLED IN ACCORDANCE WITH THE LATEST EDITION OF THE NATIONAL ELECTRICAL CODE AND ALL OTHER LOCAL, STATE AND NATIONAL CODES WHICH APPLY AS INTERPRETED I.D.O.T..
- 3) ALL WORK IS TO BE COORDINATED WITH ALL OTHER TRADES ON THIS PROJECT AND ELECTRICAL WORK INSTALLED IN A NEAT AND ORDERLY FASHION.
- 4) THE ELECTRICAL DRAWINGS ARE SCHEMATIC AND SHOW THE GENERAL ARRANGEMENT OF EQUIPMENT, THE DRAWINGS SHALL NOT BE SCALED TO DETERMINE EQUIPMENT CONNECTION OR ROUGH—IN, REFER TO EQUIPMENT CUT—SHEETS AND RESPONSIBLE TRADES.
- 5) ALL CONDUCTORS OF THE ELECTRICAL SYSTEM SHALL BE COPPER, 600V, XLP TYPE USE. CONDUCTORS FOR DIRECT BURIAL TO SERVE RV PEDESTALS SHALL BE ALUMINUM, RHW-2, TYPE USE.
- 6) ALL CONDUIT SHALL BE MINIMUM 3/4" TRADE SIZE, IMC WHEN INSTALLED INDOORS IN DRY LOCATIONS, RMC WHEN INSTALLED OUTDOOR OR INDOORS IN DAMP\WET LOCATIONS, RMC, LFNC WHEN EXPOSED OUTDOORS AND, RMC OR RNC-40 WHEN INSTALLED IN CONCRETE OR BELOW GRADE. FINAL CONNECTIONS TO ALL EQUIPMENT, WHICH PRODUCE VIBRATION SHALL BE WITH FLEXIBLE NON-METALLC CONDUIT SUITABLE FOR THE SURROUNDING ENVIRONMENT. CONDUIT TURNING UP FROM BELOW GRADE OR FROM WITHIN CONCRETE SHALL BE RMC.
- 7) RACEWAY FILL, WHEN RACEWAY SIZE IS NOT SPECIFICALLY INDICATED, SHALL BE BASED ON APPLICABLE ARTICLES OF THE NEC.
- 8) CIRCUIT ROUTING, IN GENERAL, IS NOT SPECIFIED UNLESS SPECIFIC REQUIREMENTS EXIST, ROUTING OF CIRCUITS WILL HAVE EFFECTS ON CIRCUIT VOLTAGE DROPS. CONTRACTOR SHALL COORDINATE ROUTING LENGTH WITH CONNECTED LOAD AND ADJUST CONDUCTOR SIZE FOR A VOLTAGE ROPP LESS THAN 3%.
- 9) ALL CONDUITS SHALL BE INSTALLED CONCEALED IN SPACES OF NEW CONSTRUCTION, WHICH ARE TYPICALLY OCCUPIED. CONTRACTOR SHALL COORDINATE THE LOCATION OF ALL EQUIPMENT WITH EXISTING CONDITIONS TO MAINTAIN ACCESS REQUIRED BY THE N.E.C. AND EQUIPMENT MANUFACTURERS.
- 10) SERVICE VOLTAGE AND ELECTRICAL REQUIREMENTS OF ALL EQUIPMENT SHALL BE VERIFIED BY THE CONTRACTOR PRIOR TO ELECTRICAL ROUGH—IN, DISCREPANCIES BETWEEN THE ELECTRICAL DRAWINGS AND EQUIPMENT REQUIREMENTS SHALL BE REPORTED TO THE ENGINEER BEFORE ANY ASSOCIATED WORK IS INSTALLED.
- 11) INDEXES OF ELECTRICAL PANELS SHALL BE REVISED TO REFLECT COMPLETED WORK.
- 12) CONTRACTOR SHALL REFERENCE THE PROJECT SITE PLANS FOR ELECTRIC, TELEPHONE, CABLE T.V. AND ALL OTHER UTILITIES. EXECUTION OF NEW WORK SHALL BE COMPLETED TO AVOID AND PROTECT EXISTING UTILITIES. ANY DAMAGE TO EXISTING UTILITIES. AS THE RESULT OF THIS PROJECT SHALL BE REPAIRED OR REPLACED BY THE CONTRACTOR AT NO COST TO THE DEPARTMENT.
- 13) THIS FACILITY WILL BE IN OPERATION DURING CONSTRUCTION, ALL OPEN EXCAVATION SHALL BE BARRICADED WHEN CONTRACTOR IS NOT PRESENT.
- 14) ALL TRENCHING SHALL MAINTAIN CLEARANCES FROM TREES, SINGLE TREES— TRENCH SHALL NOT PASS UNDER CANOPY, ADJACENT TREES— TRENCH SHALL PASS BETWEEN TREES AT A DISTANCE FROM EACH TREE PROPORTIONAL TO THE RESPECTIVE TREE CANOPY.
- (#) TAGGED ELECTRICAL CONSTRUCTION NOTES: (APPLY TO THIS SHEET ONLY)
 - 1) REMOVE EXISTING TIME CLOCK, LOCATED IN BASEMENT, SERVING OUTDOOR BUILDING LIGHTING, PROTECT TO REUSE. REMOVE ALL CIRCUITS CONDUCTORS AND CONDUIT WITHIN BUILDING CURRENTLY SERVING LIGHTING TO BE REMOVED. SEAL CONDUIT END WATERTICHT AT BUILDING BOUNDARYLABEL ABANDONED OVERCURRENT DEVICES AS SPARE. THE COST OF THIS WORK, INCLUDING ALL LABOR, EQUIPMENT AND MATERIAL, SHALL BE INCLUDED IN THE "REMOVE EXISTING LIGHTING SYSTEM" PAY ITEM.
 - 2) REMOVE EXISTING TREE MOUNT LIGHT FIXTURE, BOXES AND HARDWARE. CARE SHALL BE TAKEN NOT TO DAMAGE TREE. REMOVE BRANCH CIRCUIT CONDUIT AND CONDUCTORS TO 1' BELOW FINISHED GRADE, BACKFILL THE HOLE, AND ABANDON REMAINING CABLE AND CONDUIT. THE COST OF THIS WORK, INCLUDING ALL LABOR, EQUIPMENT AND MATERIAL, SHALL BE INCLUDED IN THE "REMOVE EXISTING LIGHTING SYSTEM" PAY ITEM.
 - 3) INSTALL A NEW 1P20A CIRCUIT BREAKER IN THE EXISTING PANEL AND FEED PHOTO CELL AND NEW SITE LIGHTING.
 INSTALL A 1P20A CIRCUIT BREAKER IN EXISTING PANEL TO SERVE NEW LIGHTS AND RECEPTACLE IN EXISTING MAINTENANCE
 BUILDING. ALL WORK WITHIN THIS SPACE WILL BE EXPOSED. LOOP SITE LIGHT CIRCUIT THROUGH TIME CLOCK. THE COST OF
 THIS WORK, INCLUDING ALL LABOR, EQUIPMENT AND MATERIAL, SHALL BE INCLUDED IN THE "LIGHTING SYSTEM COMPLETE"
 PAY ITEM.
 - 4) CIRCUITS SHALL PENETRATE BUILDING WALL (SEAL WATERTIGHT) USING RMC TRANSVERSE SPACE BETWEEN BUILDING AND RETAINING WALL AND PENETRATE RETAINING WALL WALL SHALL BE PATCHED AND REPAIRED TO ORIGINAL CONDITIONS. ONCE AT 24" BELOW GRADE CHANGE TO RNC. THE COST OF THIS WORK, INCLUDING ALL LABOR, EQUIPMENT AND MATERIAL, SHALL BE INCLUDED IN THE APPROPRIATE CONDUIT PAY ITEM.
 - 5) PROVIDE TRENCHING, CONDUIT INSTALLATION, BACK FILL AND SURFACE RESTORATION. ALL ROCK SHALL BE REMOVED TO MAINTAINED MINIMUM CONDUIT BURIAL OF 24", ROCK SHALL NOT BE USED FOR BACK FILL WHEN IN CONTACT WITH CONDUIT OR PLACE ON SURFACE. ROUTING OF CONDUITS SHALL AVOID TREE ROOTS WHEN POSSIBLE. THE COST OF THIS WORK, INCLUDING ALL LABOR, EQUIPMENT AND MATERIAL, SHALL BE INCLUDED IN THE "TRENCH AND BACKFILL FOR ELECTRICAL WORK" PAY ITEM.
 - 6) CONDUITS SHALL BE ROUTED TO AVOID BUILDING FOUNDATIONS.
 - 7) INSTALLATION OF CONDUIT UNDER SIDEWALKS SHALL BE COMPLETE SO AS NOT TO DISTURB SIDEWALK. EXCAVATE ON BOTH SIDES, JACK OR DRIVE SLEEVE UNDER SIDEWALKS SHALL NOT BE ALTERED IN ANYWAY. DAMAGE TO SIDEWALKS WILL BE REPAIR WITH LIKE MATERIALS TO MATCH EXISTING IN COLOR AND EXTURE AT THE CONTRACTORS EXPENSE. THE COST OF THIS WORK, INCLUDING ALL LABOR, EQUIPMENT AND MATERIAL, SHALL BE INCLUDED IN THE ADEPENDED LATED. CONJULT BAY 1EM.
 - 8) CONTRACTOR SHALL FURNISH AND INSTALL (2) FLUORESCENT FIXTURE EVENLY SPACE WITH IN THE BUILDING ON THE BOTTOM OF THE ROOD TRUSS, FIXTURES SHALL BE LITHONIA CAT.# EUS 2 32 120 GEB, OR APPROVED EQUAL, WITH ELECTRONIC BALLAST AND WIRE GUARDS. CONTROL LIGHT WITH WALL SWITCH ADJACENT TO DOOR. INSTALL TWO GFI DUPLEX RECEPTACLE ONE ON EACH INTERIOR SUPPORT POSTS. ALL CONDUIT WITHIN BUILDING SHALL BE INC SUFFACE MOUNTED EXPOSED. THE COST OF THIS WORK, INCLUDING ALL LABOR, EQUIPMENT AND MATERIAL, SHALL BE INCLUDED IN THE "LIGHTING SYSTEM COMPLETE" PAY ITEM.
 - 9) RISE FROM BELOW GRADE WITH RMC AND L.B. INTO BUILDING, SEAL PENETRATION WATERTIGHT. THE COST OF THIS WORK, INCLUDING ALL LABOR, EQUIPMENT AND MATERIAL, SHALL BE INCLUDED IN THE APPROPRIATED CONDUIT PAY ITEM.
 - 10) INSTALL NEW FIXTURE(S) AND FOUNDATIONS AS DETAILED.
 - 11) INSTALL NEW PHOTO CELL WITH VIEW WESTERN HORIZON, LOOP OUTSIDE LIGHTING CIRCUIT SO AS TO CONTROL BASED ON AMBIENT OUTDOOR SUN LIGHT. THE COST OF THIS WORK, INCLUDING ALL LABOR, EQUIPMENT AND MATERIAL, SHALL BE INCLUDED IN THE "LIGHTING SYSTEM COMPLETE" PAY ITEM.


FILE NAME =	USER NAME = \$USER\$	DESIGNED -	REVISED — 7/8/09
\$FILEL\$		DRAWN — D.M.U.	REVISED 8/24/09
	PLOT SCALE = \$SCALE\$	CHECKED	REVISED -
	PLOT DATE = \$DATE\$	DATE - 3/10/08	REVISED


STATE OF ILLINOIS
DEPARTMENT OF TRANSPORTATION

SCALE: 1"

PIERRE MENARD HOME/	F.A RTE.	SECTION	COUNTY	TOTAL SHEETS	SHEET NO.
KASKASKIA STATE PARK CAMPGROUND		<u></u>	RANDOLPH	16	14
777.0777.07777.0777.0777.0777.0777.0777.0777.0777.0777.0777.07777.0			CONTRACT	NO. 4	6003
'=20' SHEET NO. 15 OF 16 SHEETS STA TO STA	EED. RO	DAD DIST, NO ILLINOIS FED. A	D PROJECT		

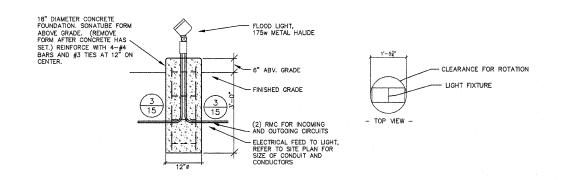

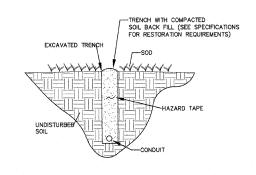


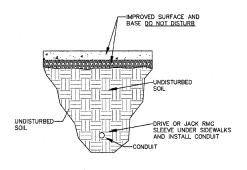

TYPICAL OPEN TRENCH CONDUIT DETAIL 4 15


TYPICAL DRIVEN CONDUIT DETAIL



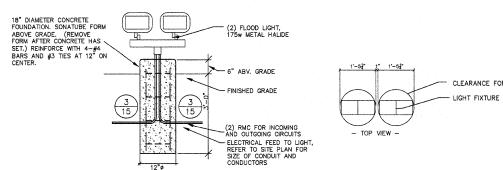

CLEARANCE FOR ROTATION - LIGHT FIXTURE

TYPICAL DUAL FLOOD LIGHTING MOUNTING DETAIL

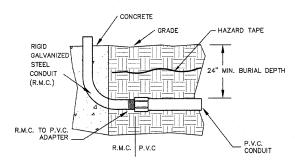

TYPICAL CONDUIT TRANSITION DETAIL

	FLOOD LIGHT, 175W METAL HALIDE (TYP.)	
GROUNDING SYSTEM BONDED AT EACH FIXTURE (TYPICAL)		
PROPOSED JUNCTION BOX EXISTING TIME CLOCK RELOCATE WIRED PER MANUFACTURES REQUIREMENTS		
EXISTING BRANCH PANEL	20A N 120V	
	FLOOD LIGHT CIRCUIT DIAGRAM	
	NONE	

TLE NAME =	USER NAME = \$USER\$	DESIGNED	_		REVISED	_	7/8/09
FILEL\$		DRAWN		D.M.U.	REVISED	_	8/24/09
	PLOT SCALE = \$SCALE\$	CHECKED	_	Anna adam Anna	REVISED	_	
	PLOT DATE = \$DATE\$	DATE	_	3/10/08	REVISED	-	

STATE OF ILLINOIS DEPARTMENT OF TRANSPORTATION

PIERRE MENARD HOME/
KASKASKIA STATE PARK CAMPGROUND
SCALE: 1"=20' SHEET NO. 15 OF 16 SHEETS STA TO STA

SECTION

