



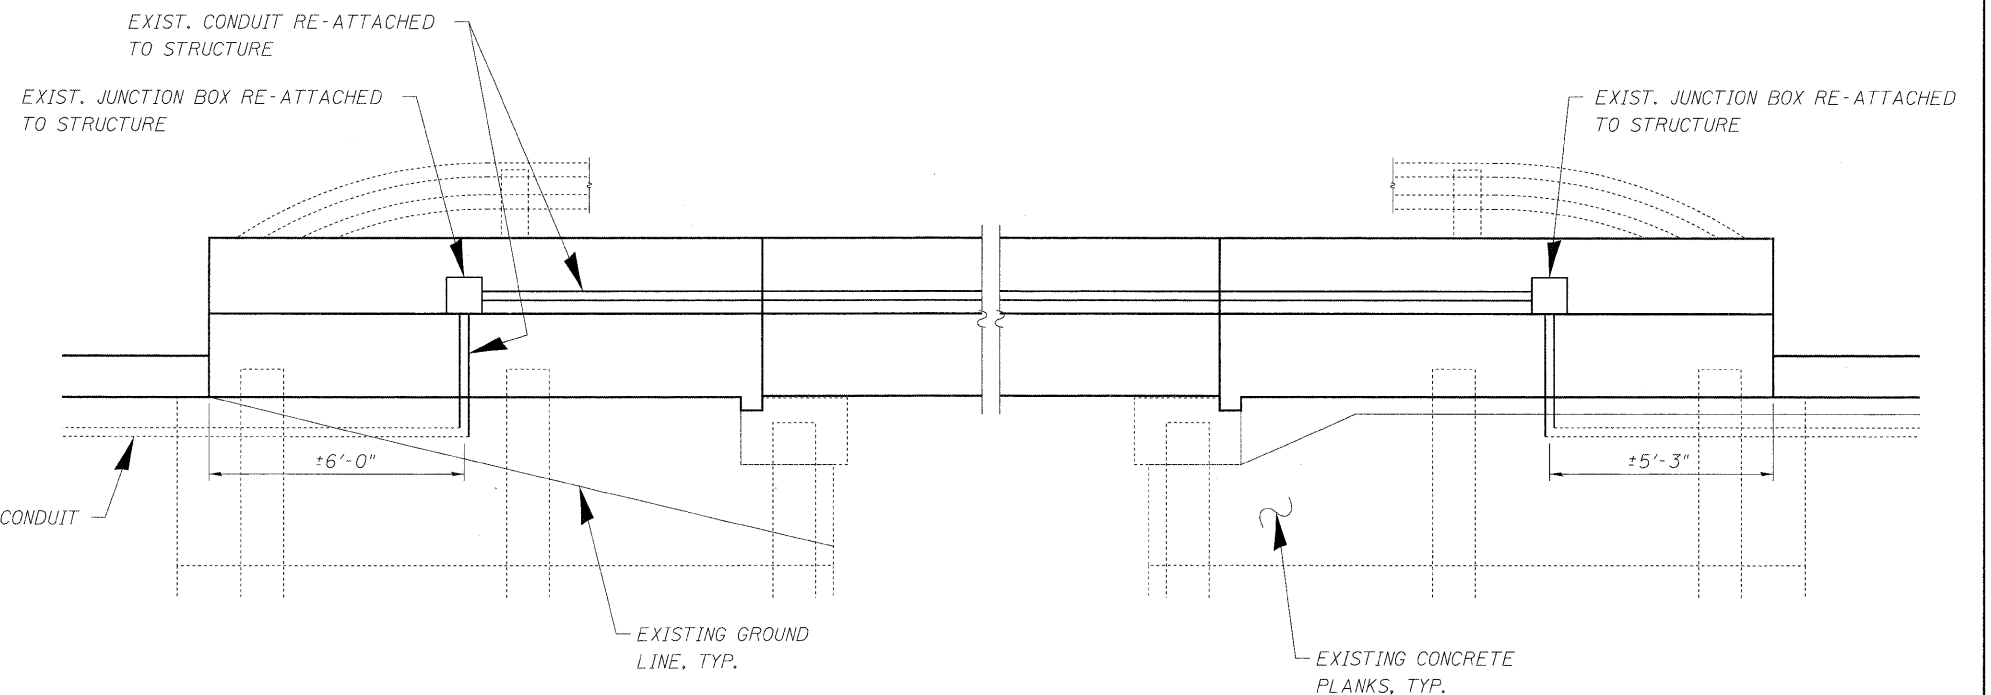

**NOTES**

1. REMOVE EXISTING CONDUIT & EXISTING JUNCTION BOXES FROM THE EXISTING PARAPET WALL, AND MAINTAIN EXISTING ELECTRIC SERVICE DURING THE INSTALLATION OF THE BRIDGE SCOPE OF WORK. AFTER THE BRIDGE WORK IS COMPLETE, THE CONTRACTOR SHALL RE-ATTACH THE EXISTING SYSTEM TO THE NEW PARAPET WALL, COST SHALL BE INCLUDED IN REMOVE EXISTING CONDUIT ATTACHED TO STRUCTURE AND REMOVE EXISTING JUNCTION BOX. THE PAY ITEMS FOR CONDUIT ATTACHED TO STRUCTURE, 2" DIA., GALVANIZED STEEL AND JUNCTION BOX, STAINLESS STEEL, ATTACHED TO STRUCTURE, 12"x12"x6" ARE TO BE USED ONLY IF THE ENGINEER DETERMINES THAT REPLACEMENT ITEMS ARE NECESSARY.

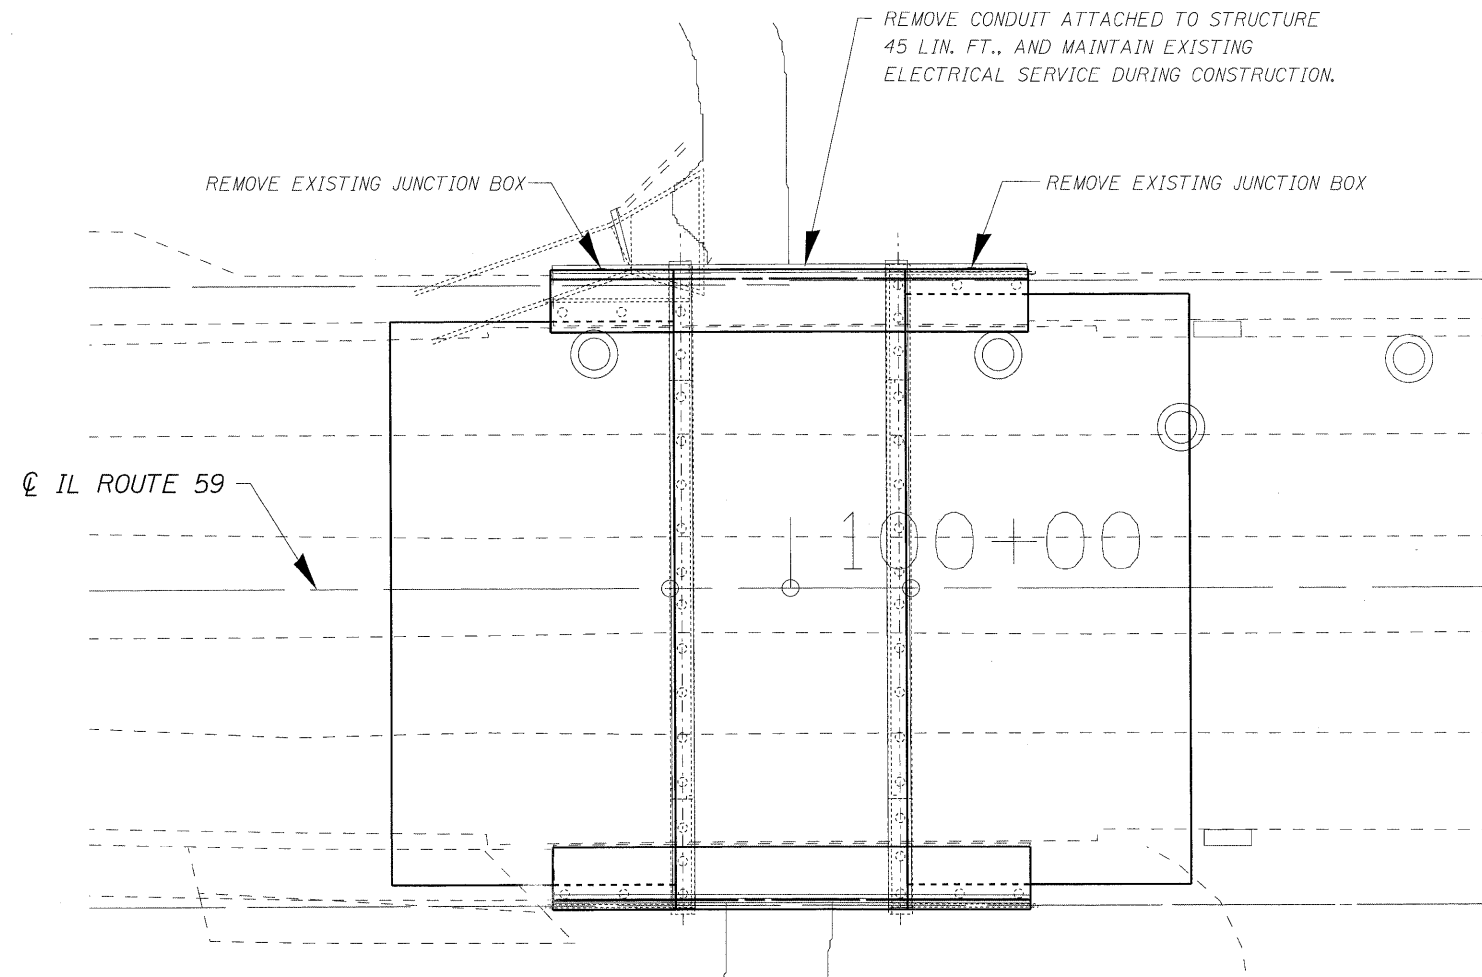

**LOCO, INC.**  
CONSULTING ENGINEERS  
1560 WALL ST., SUITE 222  
NAPERVILLE, ILLINOIS 60563 PH: (630) 577-9100

DESIGNED - MJY  
DRAWN - SLV  
CHECKED - MJY  
DATE - 03/26/2010

REVISED -  
REVISED -  
REVISED -

**STATE OF ILLINOIS  
DEPARTMENT OF TRANSPORTATION**

**ELECTRICAL PLAN  
IL ROUTE 59 OVER FLINT CREEK TRIBUTARY**

SCALE: 1" = 30'

SHEET NO. 1 OF 1 SHEETS

STA. 98+00 TO STA. 101+60

F.A.P. RTE.	SECTION	COUNTY	TOTAL SHEETS	SHEET NO.
338	108 B-1	LAKE	40	12
D-91-289-09			CONTRACT NO. 60F92	
FED. ROAD DIST. NO.		ILLINOIS FED. AID PROJECT		