



EROSION CONTROL LEGEND

-  INLET AND PIPE PROTECTION
-  TEMPORARY DITCH CHECK
-  PERIMETER EROSION BARRIER
-  TEMPORARY EROSION CONTROL SEEDING WITH MULCH METHOD 2
-  TEMPORARY CHAIN LINK FENCE
-  EC, TEMPORARY PIPE SLOPE DRAIN
-  INLET FILTER
-  STABILIZED CONSTRUCTION ENTRANCE
-  STONE OUTLET STRUCTURE SEDIMENT TRAP
-  DITCH FLOW
-  SWALE
-  DRAINAGE SUMMIT

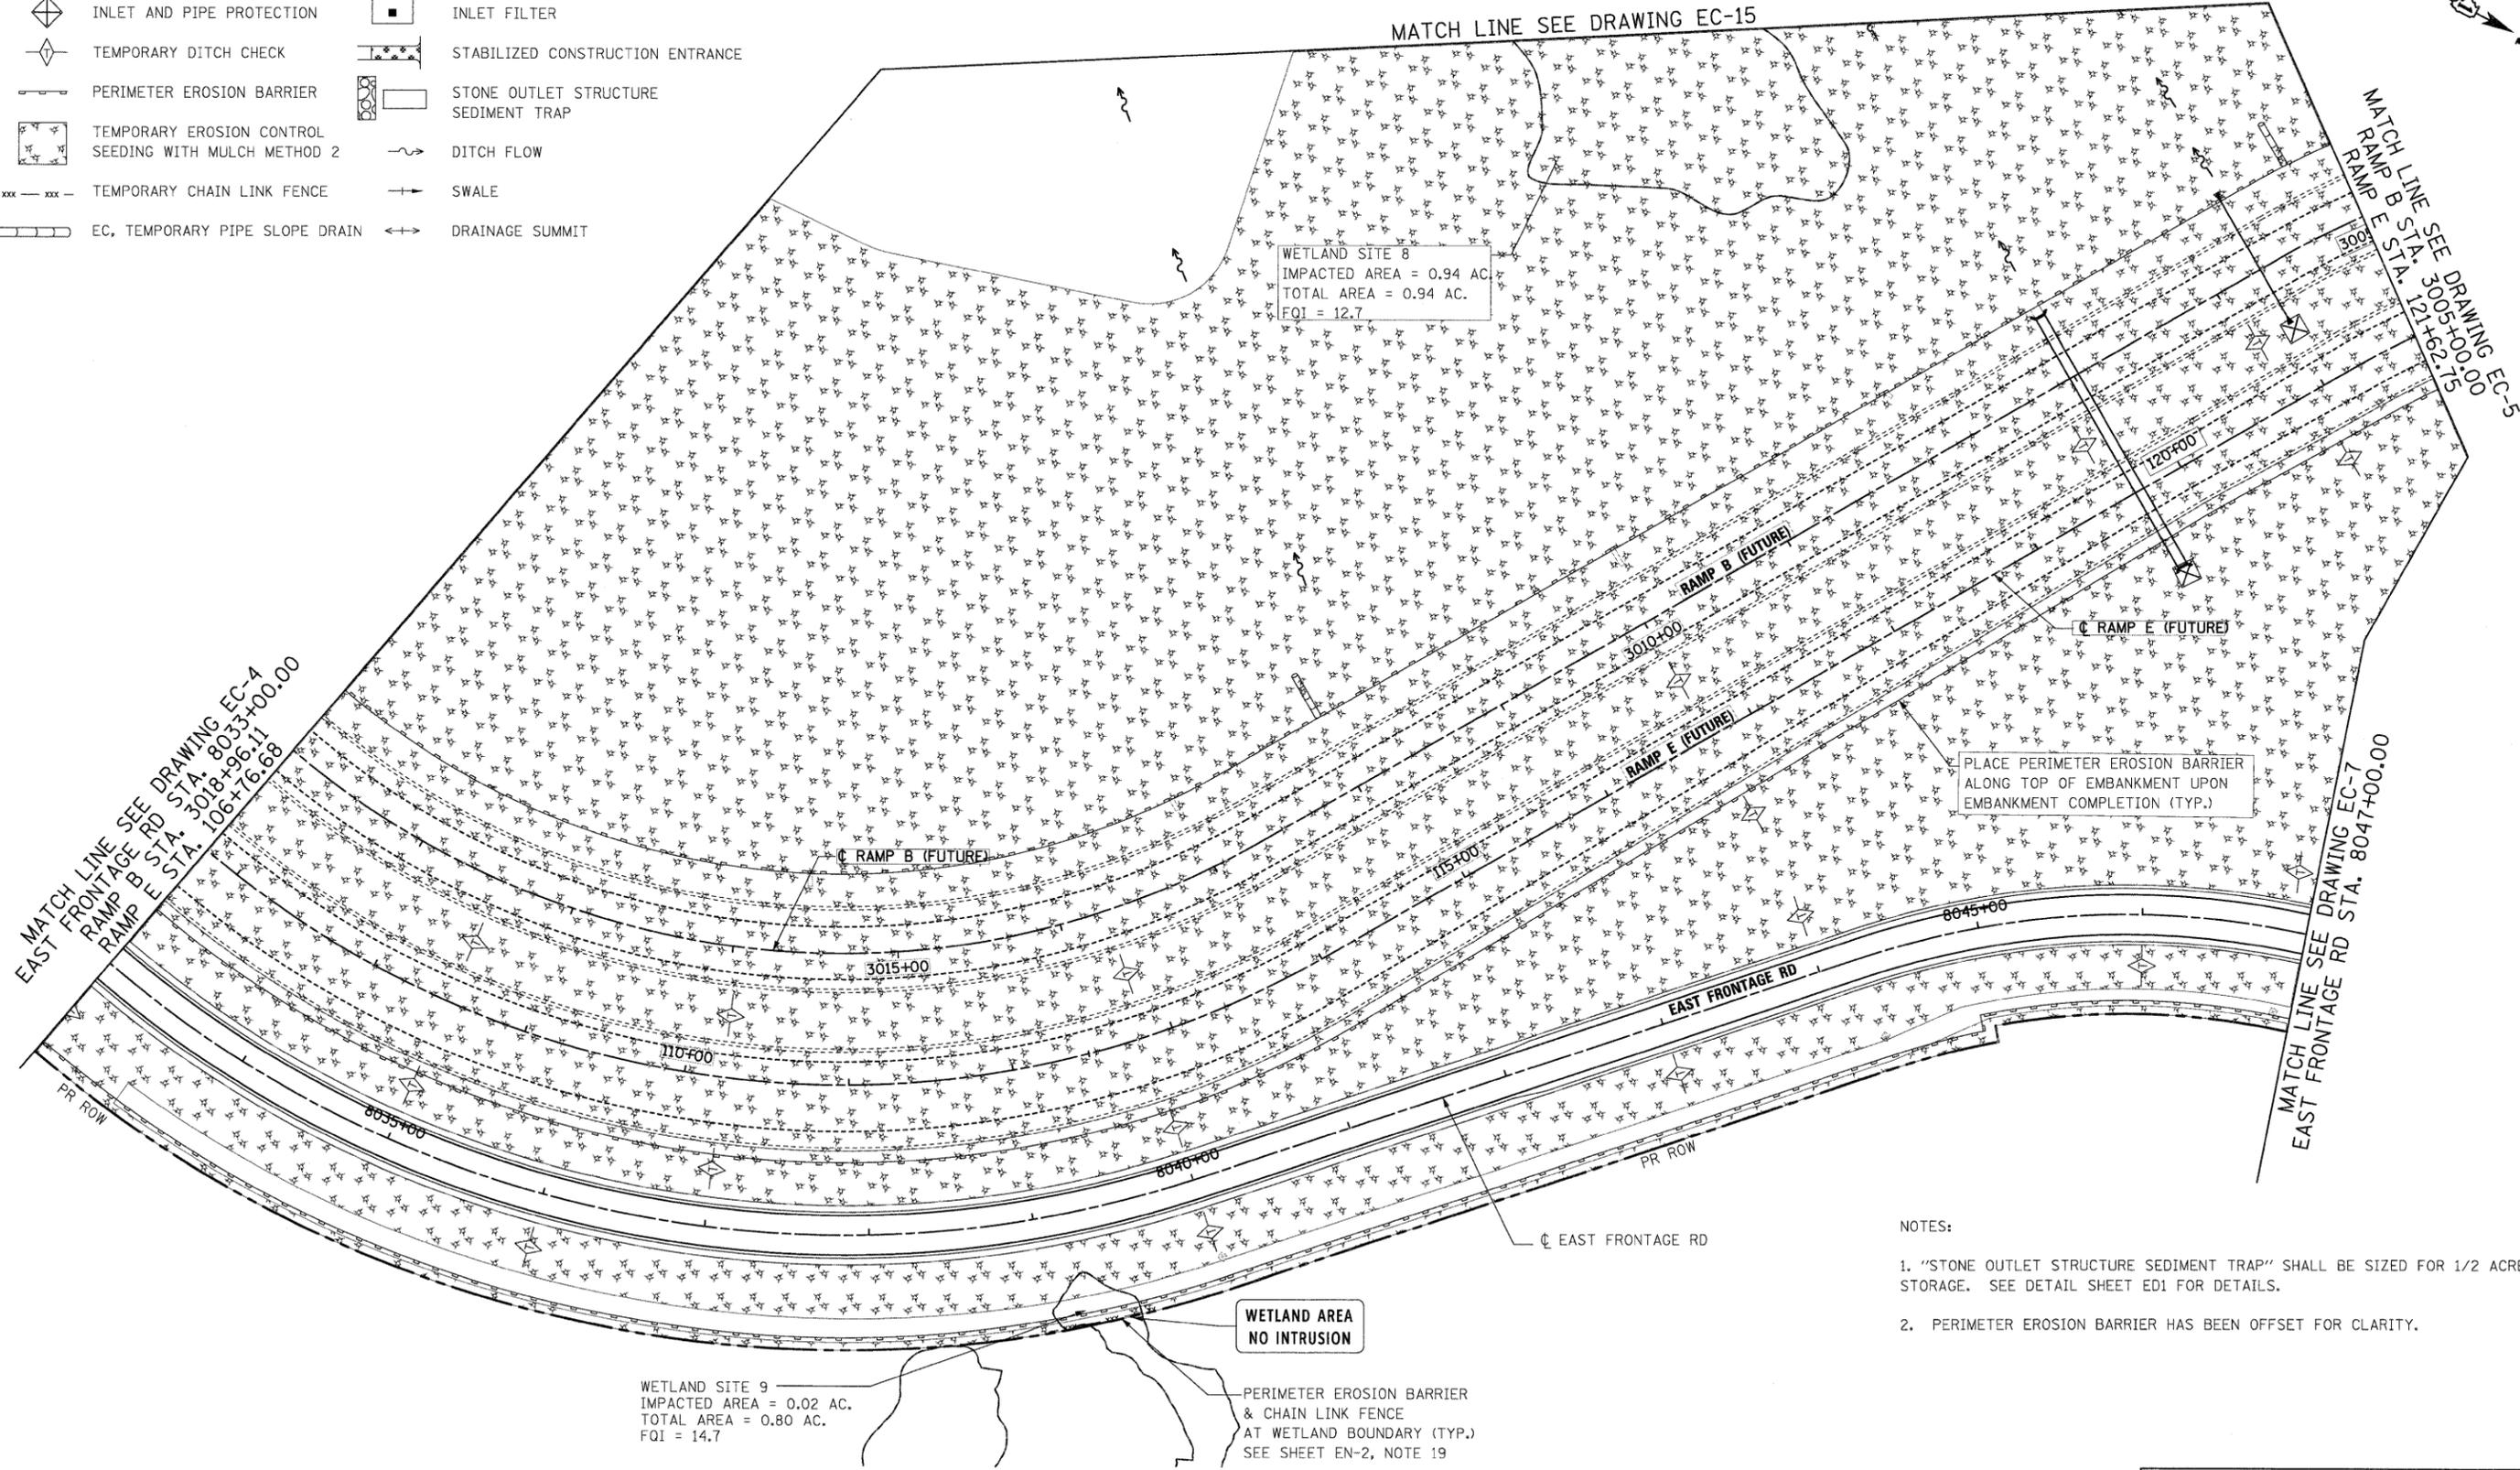

- NOTES:
1. "STONE OUTLET STRUCTURE SEDIMENT TRAP" SHALL BE SIZED FOR 1/2 ACRE STORAGE. SEE DETAIL SHEET ED1 FOR DETAILS.
 2. PERIMETER EROSION BARRIER HAS BEEN OFFSET FOR CLARITY.

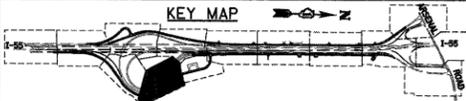

McDonough Associates Inc.
 Engineers / Architects
 130 East Randolph Street, Chicago, Illinois 60601

| | | | |
|---------------------------------------|----------------------|-----------------|-----------|
| FILE NAME = D160C31-SHT-EROS16.dgn | USER NAME = TKluegel | DESIGNED - JCL | REVISED - |
| PLOT SCALE = 1:50' | CHECKED - DLT | DRAWN - JCL | REVISED - |
| PLOT DATE = 12/11/2009 | DATE - 12/18/09 | CHECKED - DLT | REVISED - |
| | | DATE - 12/18/09 | REVISED - |

**STATE OF ILLINOIS
DEPARTMENT OF TRANSPORTATION**

EROSION AND SEDIMENT CONTROL PLAN

SCALE: 1"=50' SHEET NO. 6 OF 15 SHEETS STA. TO STA.

| F.A.I. RTE. | SECTION | COUNTY | TOTAL SHEETS | SHEET NO. |
|---|--------------|--------|--------------|-----------|
| 55 | (99-1&2)AC-3 | WILL | 524 | 133 |
| CONTRACT NO. 60C31 | | | | |
| FED. ROAD DIST. NO. 1 ILLINOIS FED. AID PROJECT | | | | |