INDEX OF SHEETS SHEET NO. DESCRIPTION GENERAL NOTES HIGHWAY STANDARDS AND LEGEND 3 SUMMARY OF QUANTITIES 4-5

DRAINAGE PLANS

10

11-40

SCHEDULE OF QUANTITIES REMOVAL AND RELOCATION PLANS

LANDSCAPING PLANS AND DETAILS

BENCHMARK AND CONTROL POINT LOCATION MAP

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STATE OF ILLINOIS DEPARTMENT OF TRANSPORTATION **DIVISION OF HIGHWAYS**

PLANS FOR PROPOSED STREET IMPROVEMENTS


PROFILE HORIZ. 1 INCH = 20 FEET
PROFILE VERT. 1 INCH = 5 FEET
CROSS SECTIONS HORIZ. 1 INCH = 10 FEET

TOWN OF NORMAL McLEAN COUNTY, ILLINOIS **SECTION: 10-00243-02-LS PROJECT NO. TE-00D5(096)** JOB NO. C-95-322-11

FUNDING: ENHANCEMENT & LOCAL MATCH

UPTOWN NORMAL GATEWAY PLAZA

ILLINOIS HIGHWAY STANDARD DRAWINGS (SEE SHEET NO. 3)

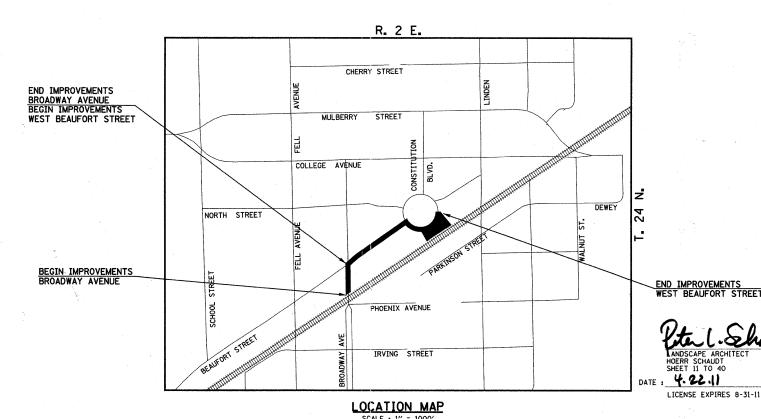

TOWN OF NORMAL APPROVED ADRIL 22 2011 DISTRICT FIVE ENGINEER OF MAU EPUTY DIRECTOR OF HIGHWAYS, REGION THREE ENGINEER STATE OF ILLINOIS DEPARTMENT OF TRANSPORTATION

LOCATION OF SECTION INDICATED THUS:

PETER L. SCHAUDT

157-000214

Sean M. Widener

LICENSE EXPIRES 11-30-11

DATE: 4.22.11

SECTION

10-00243-02-LS

MCLEAN

ILLINOIS CONTRACT NO. 91461

40

PRINTED BY THE AUTHORITY OF THE STATE OF ILLINOIS



CONFORM TO STANDARD SCALES. IN MAKING MEASUREMENTS ON REDUCED PLANS, THE ABOVE SCALES MAY BE USED.

ENGINEERING SCALES. REDUCED SIZED PLANS WILL NOT

JOINT UTILITY LOCATION INFORMATION FOR EXCAVATION 1-800-892-0123 OR 811

CONTRACT NO. 91461

PROJECT GENERAL NOTES

- 1. WHEREVER IN THE PLANS OR SPECIFICATIONS THE TERM "STANDARD SPECIFICATIONS" IS USED IT SHALL BE UNDERSTOOD BY THE CONTRACTOR TO MEAN THE "STANDARD SPECIFICATIONS FOR ROAD AND BRIDGE CONSTRUCTION" AS PREPARED BY THE DEPARTMENT OF TRANSPORTATION OF THE STATE OF ILLINOIS AND ADOPTED ON JANUARY 1, 2007.
- 2. WHEREVER IN THE PLANS OR SPECIFICATIONS THE TERM "STANDARD SPECIFICATIONS FOR SEWER CONSTRUCTION" IS USED IT SHALL BE UNDERSTOOD BY THE CONTRACTOR TO MEAN THE "STANDARD SPECIFICATIONS FOR WATER AND SEWER MAIN CONSTRUCTION IN ILLINOIS" AS PREPARED BY I.S.P.E., A.G.C.I., I.M.L.,
- 3. ANY REFERENCE TO STANDARDS THROUGHOUT THE PLANS SHALL BE INTERPRETED TO BE THE LATEST STANDARDS OF THE DEPARTMENT AS SHOWN ON SHEET 3.
- 4. IT IS THE CONTRACTOR'S RESPONSIBILITY TO ASCERTAIN EXISTING FIELD CONDITIONS BEFORE BIDDING ON THE PROJECT.
- 5. THE CONTRACTOR WILL BE REQUIRED TO COMPLY WITH STATE REGULATIONS REGARDING AIR, WATER, AND NOISE POLLUTION.
- 6. THE CONTRACTOR SHALL TAKE CARE NOT TO STORE OR DISPOSE OF DEBRIS OR UNSUITABLE MATERIALS WITHIN LIMITS OF THE IMPROVEMENT AND TAKE CARE TO LIMIT CONSTRUCTION TO WITHIN THE RIGHT-OF-WAY AND EASEMENT AREAS. UNNECESSARY ENCROACHMENTS ONTO PRIVATE OR PUBLIC AREAS WILL NOT
- 7. WHERE SECTION OR SUBSECTION MONUMENTS, BENCHMARKS, OR IRON PIPE MONUMENTS ARE ENCOUNTERED, THE ENGINEER SHALL BE NOTIFIED BEFORE SUCH MONUMENTS ARE REMOVED. THE CONTRACTOR SHALL PROTECT AND CAREFULLY PRESERVE ALL MONUMENTS UNTIL AN ILLINOIS REGISTERED LAND SURVEYOR OR AGENT HAS WITNESSED OR OTHERWISE REFERENCED THEIR LOCATION. THE CONTRACTOR WILL BE RESPONSIBLE FOR HAVING AN ILLINOIS REGISTERED LAND SURVEYOR RE-ESTABLISH ANY MONUMENTS UNNECESSARILY DESTROYED BY HIS OPERATIONS.
- 8. THE CONTRACTOR SHALL COORDINATE CONSTRUCTION ACTIVITIES WITH UTILITY COMPANIES.
- 9. THE CONTRACTOR SHALL BE RESPONSIBLE FOR PROTECTING UTILITY PROPERTY FROM CONSTRUCTION OPERATIONS AS OUTLINED IN ARTICLE 107.31 OF THE STANDARD SPECIFICATIONS. THE JULIE NUMBER IS 800-892-0123. A MINIMUM OF 48 HOURS ADVANCE NOTICE IS REQUIRED.

TOWN OF NORMAL 100 E. PHOENIX AVE. NORMAL, ILLINOIS 61761 (309)-454-9574

AMEREN IP BLOOMINGTON, ILLINOIS 61702 (309) 823-9271

1844 FERRY ROAD NAPERVILLE, ILLINOIS 60563 (888) 642-6748

102 EAST SHAFFER ST. FORSYTH, ILLINOIS ZIP 62535 (217) 876-7194

2319 W. MARKET ST. BLOOMINGTON, ILLINOIS 61704 (309) 663-3144

1202 W. DIVISION STREET NORMAL, ILLINOIS 61761 (309) 827-4396

- 11. THE TOP-OF-FRAME ELEVATIONS REFERRED TO IN THE DRAINAGE STRUCTURE CALL-OUTS FOR A SPECIAL FRAME AND LID ARE TAKEN ADJACENT TO THE PAVEMENT OR GROUND
- 12. WHEN CONNECTIONS ARE TO BE MADE TO EXISTING PIPING AND STRUCTURES, THE LOCATION AND ELEVATION OF THE EXISTING PIPING SHALL BE FIELD VERIFIED AND NOTIFICATION GIVEN TO THE ENGINEER IF THE EXISTING PIPING IS FOUND TO BE DIFFERENT THAN THAT SHOWN ON THE DRAWINGS. WHERE SUCH DISCREPANCY IS FOUND,
- 13. WHEN PROPOSED STORM SEWERS ARE TO BE CONNECTED INTO EXISTING MANHOLES OR EXISTING STORM SEWERS THE CONNECTIONS SHALL BE MADE IN A WORKMANLIKE MANNER AND MASONRY CONSTRUCTED AROUND THEM SO AS TO PREVENT LEAKAGE. THE COST OF MAKING ANY SEWER CONNECTIONS TO AN EXISTING DRAINAGE STRUCTURE OR PIPING SHALL BE CONSIDERED INCLUDED WITHIN THE CONTRACT UNIT PRICE FOR THE NEW SEWER.
- 14. EXISTING PAVEMENTS, CURBS AND GUTTERS, AND SIDEWALKS IN WHICH THE TOP SURFACE IS TO BE JOINED TO THE PROPOSED WORK SHALL BE SO JOINED THROUGH SAW CUT JUNCTURES. 3/4" EXPANSION JOINT MATERIAL SHALL BE PLACED AT THESE JUNCTURES AS DIRECTED BY THE ENGINEER.
- 15. WHERE THE PROPOSED COMBINATION CONCRETE CURB AND GUTTER JOINS THE EXISTING CURB AND GUTTER, A TRANSITION MAY BE REQUIRED IN THE SHAPE OF THE PROPOSED CURB AND GUTTER. THIS WORK SHALL BE CONSIDERED INCLUDED WITHIN THE CONTRACT UNIT PRICE FOR THE PROPOSED CURB AND GUTTER.
- 16. THE TOWN OF NORMAL SHALL BE RESPONSIBLE FOR NOTIFYING THE PUBLIC, THE UNITED STATES POSTAL SERVICE, AND THE EMERGENCY SERVICE AGENCIES OF ALL ROAD CLOSURES AND CHANGES IN THE TRAFFIC CONTROL PLANS. THE CONTRACTOR SHALL NOTIFY THE TOWN OF NORMAL OF ALL ROAD CLOSURES AND DETOURS A MINIMUM OF 48 HOURS IN ADVANCE OF ANY ROAD CLOSURES OR CHANGES SO THAT NOTIFICATION CAN BE GIVEN.
- 17. THE CONTRACTOR SHALL BE RESPONSIBLE FOR CLEANUP OF THE SITE PRIOR TO FINAL ACCEPTANCE IN ACCORDANCE WITH ARTICLE 104.06 OF THE STANDARD SPECIFICATIONS. THIS WORK SHALL INCLUDE CLEANING ALL DRAINAGE FACILITIES OF FOREIGN MATERIALS IN ACCORDANCE WITH ARTICLE 602.15 OF THE STANDARD SPECIFICATIONS. THIS WORK SHALL BE PERFORMED AS DIRECTED BY THE ENGINEER AND NO ADDITIONAL COMPENSATION WILL BE ALLOWED.
- 19. THE FOLLOWING FACTORS HAVE BEEN ASSUMED IN CALCULATING PLAN QUANTITIES:

AGGREGATE MATERIALS 2.05 TONS/CU/YD HOT-MIX ASPHALT (ALL TYPES) 112 LBS/SQ YD/IN THICK

EXISTING FIELD CONDITIONS

DUE TO ONGOING DEVELOPMENT IN THE VICINITY OF THIS PROJECT, THE EXISTING TOPOGRAPHIC FEATURES MAY BE DIFFERENT FROM THE FEATURES SHOWN ON THE PLANS. THE CONTRACTOR SHALL NOTIFY THE ENGINEER OF ANY CHANGED FIELD CONDITIONS THAT ARE DISCOVERED PRIOR TO PERFORMING THE WORK. NO ADDITIONAL COMPENSATION WILL BE ALLOWED DUE TO CHANGED FIELD CONDITIONS.

SURVEY NOTES

THE TOPOGRAPHIC SURVEY AND EXISTING RIGHT-OF-WAY CONFIGURATIONS FOR THIS PROJECT, INCLUDING THE VERTICAL DATUM, WERE PROVIDED BY THE FARNSWORTH GROUP, BLOOMINGTON, IL. SEE THE BENCHMARK AND CONTROL POINT LOCATION MAY SHEET FOR THE BENCHMARK AUCONTROL POINT LOCATION MAY SHEET FOR THE BENCHMARK ALCOVATIONS AND DESCRIPTIONS.

THE UTILITIES SHOWN WERE LOCATED FROM A COMBINATION OF FIELD INFORMATION AND INFORMATION PROVIDED BY THE RESPECTIVE UTILITY COMPANIES AND THE TOWN OF NORMAL ENGINEERING DEPARTMENT. THE EXACT LOCATION OF SAID UTILITIES SHOULD BE VERIFIED IN THE FIELD PRIOR TO THE START OF CONSTRUCTION OPERATIONS.

THE COORDINATES AND ELEVATIONS ARE BASED ON THE LOCAL CONTROL MONUMENTS ESTABLISHED BY AFRO-METRIC ENGINEERS, INC., SHEBOYGAN, WISCONSIN. THE CONTROL WAS ESTABLISHED IN 1995 AS A PART OF THE ORIGINAL MCLEAN COUNTY AFRIAL USED FOR THE MCLEAN COUNTY GIS SYSTEM.

REMOVAL GENERAL NOTES

- 1. THE CONTRACTOR WILL BE HELD RESPONSIBLE FOR ANY UNNECESSARY DAMAGE TO TREES, SHRUBS, IRRIGATION SYSTEMS, OR LANDSCAPING AS DETERMINED BY THE ENGINEER.
- 2. TREES TO BE REMOVED: THE INDICATED TREES (INCLUDING STUMPS) TO BE REMOVED SHALL BE SUITABLY MARKED BY THE ENGINEER BEFORE TREE REMOVAL OPERATIONS BEGIN. ALL TREES, STUMPS, AND ROOTS SHALL BE COMPLETELY REMOVED AND DISPOSED OF THIS WORK SHALL BE INCLUDED IN THE COST OF THE TREE REMOVAL AND NO ADDITIONAL COMPENSATION WILL BE ALLOWED.
- 3. ALL EXISTING SIGNS LOCATED ON PUBLIC RIGHT-OF-WAY WHICH INTERFERE WITH THE WORK SHALL BE REMOVED BY THE TOWN OF NORMAL UNLESS DIRECTED OTHERWISE BY THE ENGINEER, THE TOWN WILL REMOVE AND REPLACE ANY SIGN INSTALLATION AT NO CHARGE TO THE CONTRACTOR PROVIDING THE CONTRACTOR PROVIDES THE ENGINEER WITH NOT LESS THAN TWO (2) WORKING DAYS NOTICE FOR SIGN REMOVAL. THE ENGINEER WILL NOTIFIY THE TOWN OF NORMAL FOR SIGN REMOVAL ALONG THE SIDE ROADS. ANY CONTRACTOR OR PRIVATE PARTY REMOVING ANY SIGN WILL BE BILLED FOR THE REPLACEMENT COSTS ASSOCIATED WITH THE REINSTALLATION OF THE SIGN AND MAY BE CHARGED WITH VIOLATION
- 4. THE EXCAVATION FOR THIS PROJECT IS CLASSIFIED AS EARTH EXCAVATION IN ACCORDANCE WITH SECTION 202 OF THE STANDARD SPECIFICATIONS. THE EARTH EXCAVATION SHALL INCLUDE THE REMOVAL OF EARTH AND UNCLASSIFIED MATERIALS, AND THE TRANSPORTATION AND PLACEMENT OF SUITABLE EXCAVATED MATERIALS IN EMBANKMENTS. THE REMAINING EXCAVATION IS CLASSIFIED AS REMOVAL AND DISPOSAL OF UNSUITABLE MATERIAL, CURB REMOVAL, PAVEMENT REMOVAL, DRIVEWAY PAVEMENT REMOVAL, AND
- ABANDONED UNDERGROUND UTILITIES THAT CONFLICT WITH CONSTRUCTION SHALL BE REMOVED AND DISPOSED OUTSIDE THE LIMITS OF THE RIGHT OF WAY ACCORDING TO ARTICLE 202.03 OF THE STANDARD SPECIFICATIONS AND AS APPROVED BY THE ENGINEER. THIS WORK WILL NOT BE PAID FOR SEPARATELY BUT SHALL BE CONSIDERED INCLUDED IN THE CONTRACT UNIT PRICE FOR EARTH EXCAVATION.
- 6. THE FINISHED EARTHWORK SHALL HAVE VEGETATIVE SUSTAINING SOIL AS SHOWN ON THE LANDSCAPING PLANS.
- 7. ONLY EXISTING PAVEMENT, BASE COURSES AND DRIVEWAY PAVEMENTS COMPOSED OF PORTLAND CEMENT CONCRETE OR HOT-MIX ASPHALT SHALL BE MEASURED AND PAID FOR AS "PAVEMENT REMOVAL" AND "DRIVEWAY PAVEMENT REMOVAL" IN ACCORDANCE WITH SECTION 440 OF THE STANDARD SPECIFICATIONS. REMOVAL OF OTHER TYPES OF PAVEMENT COMPOSITION SUCH AS AGGREGATE OR OIL AND CHIP SHALL BE MEASURED AND PAID FOR AS "EARTH EXCAVATION" IN ACCORDANCE WITH SECTION 202 OF THE STANDARD SPECIFICATIONS.

MAINTENANCE OF TRAFFIC GENERAL NOTES

- 1. TRAFFIC CONTROL AND PROTECTION SHALL BE IN ACCORDANCE WITH THE APPLICABLE PORTIONS OF THE STANDARD SPECIFICATIONS FOR ROAD AND BRIDGE CONSTRUCTION; THE APPLICABLE GUIDELINES CONTAINED IN THE MANUAL ON UNIFORM TRAFFIC CONTROL DEVICES FOR STREETS AND HIGHWAYS, STANDARDS 701301, 701501, 701701, 701801, AND 701901. THE STAGE CONSTRUCTION AND MAINTENANCE OF TRAFFIC DETAILS AND THE SPECIAL PROVISIONS.
- 2. TRAFFIC CONTROL AND PROTECTION WILL BE PAID FOR AT THE CONTROL LUMP SUM PRICE FOR TRAFFIC CONTROL AND PROTECTION, (SPECIAL). THE TRAFFIC CONTROL AND PROTECTION INSTALLATION FOR EACH WORK AREA WILL NOT BE PAID FOR SEPARATELY AND ADDITIONAL TRAFFIC CONTROL DEVICES AND SIGNS MAY BE REQUIRED AS DETERMINED BY THE ENGINEER. NO ADDITIONAL COMPENSATION WILL BE ALLOWED
- 3. TRAFFIC CONTROL SURVEILLANCE WILL NOT BE PAID FOR SEPARATELY FOR THIS PROJECT. THE CONTRACTOR SHALL BE RESPONSIBLE FOR INSPECTING AND MAINTAINING ALL TRAFFIC CONTROL DEVICES AT ALL TIMES INCLUDING NIGHTIME, WEEKENDS, AND ANY TIME WORKERS ARE NOT PRESENT. THIS WORK SHALL BE PERFORMED IN ACCORDANCE WITH THE RECURRING SPECIAL PROVISION LRS3. THE COST OF ALL LABOR, MATERIALS, AND EQUIPMENT REQUIRED FOR THE INSPECTION AND MAINTENANCE OF THE TRAFFIC CONTROL DEVICES SHALL BE INCLUDED IN THE LUMP SUM PRICE OF TRAFFIC CONTROL AND PROTECTION, (SPECIAL).
- 4. THE FOLLOWING TRAFFIC CONTROL STANDARDS ARE THE MINIMUM REQUIREMENTS FOR THE TRAFFIC CONTROL FOR THIS PROJECT.

STANDARD

701301

SHORT TERM LANE CLOSURE FOR LANDSCAPING WORK, DEBRIS CLEAN UP, ETC.

701501 & 701701 701801

LANE CLOSURE FOR LANDSCAPING WORK SIDEWALK CLOSURES WITHIN PROJECT LIMITS

701901

TRAFFIC CONTROL DEVICES

- 5. SIDEWALKS (INCLUDING CONSTITUTION TRAIL) SHALL REMAIN OPEN AT ALL TIMES. PARTIAL CLOSURES WILL BE ALLOWED AS APPROVED BY THE ENGINEER. THE CONTRACTOR SHALL MAINTAIN A MINIMUM SIDEWALK WIDTH OF FOUR FEET (4') FOR PEDESTRIAN TRAFFIC. ACCESS TO BUSINESSES SHALL REMAIN OPEN AT ALL TIMES.
- 6. THE CONTRACTER SHALL PROVIDE AND INSTALL TWO (2) WEIGHTED SAND BAGS ON EACH TYPE II BARRICADE USED. (ONE WEIGHTED SAND BAG ACROSS EACH BOTTOM RAIL) AND AND A MINIMUM OF FOUR (4) WEIGHTED SAND BAGS ON EACH TYPE III BARRICADES USED.

LANDSCAPING GENERAL NOTES

- 1. ACTUAL LAYOUT OF PLANTINGS AS INDICATED IN THE LANDSCAPING PLANS ARE APPROXIMATE, THE ENGINEER OR DESIGNATED REPRESENTATIVE SHALL CONFIRM ALL PLANT LOCATIONS WITH THE CONTRACTOR PRIOR TO INSTALLATION
- 18. FOR THIS CONTRACT, DESIGNATED REPRESENTATIVES OF THE ENGINEER MAY INCLUDE THE PROJECT LANDSCAPE ARCHITECT AND/OR TOWN OF NORMAL PARKS AND RECREATION STAFF.

 2. THE CONTRACTOR SHALL BE RESPONSIBLE FOR BECOMING FAMILIAR WITH THE SURFACE CONDITIONS AND SHALL NOT PROCEED WITH WORK UNTIL ALL UNSATISFACTORY CONDITIONS ARE CORRECTED. PLANTS MAY NOT BE INSTALLED INTO SATURATED OR FROZEN SOILS, OR DURING INCLIMATE WEATHER SUCH AS RAIN, SNOW. OR EXCESSIVELY WINDY CONDITIONS.
 - CONTRACTOR SHALL BE AWARE OF EXISTING IRRIGATION SYSTEMS WITHIN THE PROJECT LIMITS. THE CONTRACTOR SHALL BE RESPONSIBLE FOR ANY UNNECESSARY DAMAGES AS DETERMINED BY THE ENGINEER. IF DAMAGES OCCUR, THE CONTRACTOR SHALL BE RESPONSIBLE FOR REPAIRING THE IRRIGATION TO THE SATISFACTION OF THE ENGINEER AT THE CONTRACTOR'S EXPENSE. NO ADDITIONAL COMPENSATION WILL BE ALLOWED. THE USE OF THE EXISTING AND PROPOSED IRRIGATION SYSTEMS WILL BE ALLOWED FOR WATERING THE PLANTS AFTER INSTALLATION AND SHALL BE COORDINATED WITH THE TOWN OF NORMAL.
 - 4. THE CONTRACTOR SHALL BE RESPONSIBLE FOR STAKING ALL PLANTING AREAS AND NOTIFYING JULIE (1-800-892-0123) PRIOR TO EXCAVATION TO DETERMINE THE LOCATION OF UNDERGROUND UTILITIES TO AVOID POSSIBLE DAMAGE.
 - 5. THE CONTRACTOR SHALL BE RESPONSIBLE FOR ALL PREPARATION OF THE SITE AND INSTALLATION OF PLANTS IN ACCORDANCE WITH THE SPECIAL PROVISIONS, INCLUDING PROTECTION OF PLANTS AND MATERIALS DURING CONSTRUCTION AND THE GUARANTEE PERIODS.
 - 6. THE CONTRACTOR SHALL BE RESPONSIBLE FOR FINISHING OF THE AREA, INCLUDING MULCHING, WEED CONTROL, WATERING, AND CLEAN UP IN ACCORDANCE WITH THE SPECIAL PROVISIONS.
 - 7. THE CONTRACTOR SHALL GUARANTEE ALL PLANTS IN ACCORDANCE WITH THE SPECIAL PROVISIONS.
 - THE CONTRACTOR SHALL BE RESPONSIBLE FOR ALL PREPARATION, QUALITY ASSURANCE, AND CARE OF PLANTS BEFORE INSTALLATION, IN ACCORDANCE WITH THE SPECIAL PROVISIONS. PLANTS SHALL BE SUBJECT TO PRE-DELIVERY INSPECTIONS AND APPROVALS AND IN THE CASE OF REJECTION THE CONTRACTOR SHALL BE RESPONSIBLE FOR REPLACEMENT OR SUBSTITUTION WITH WRITTEN APPROVAL BY THE ENGINEER.
 - 9. ALL DISTURBED AREAS SHALL BE SODDED, SEEDED, OR LANDSCAPED AS SHOWN ON THE LANDSCAPE PLANS. EXISTING TURF WHICH IS DAMAGED OUTSIDE THE LIMITS OF CONSTRUCTION SHALL BE RE-ESTABLISHED WITH SOD AS DIRECTED BY THE ENGINEER AT THE CONTRACTOR'S EXPENSE.

DESIGNED - K.L.R. REVISED -FILE NAME = GENERAL NOTES p:\N0240094\Plans\sheets\ 03 GENERAL NOTES.dgm REVISED STATE OF ILLINOIS DRAWN K.L.R. DEPARTMENT OF TRANSPORTATION CHECKED - S.M.W. REVISED PLOT DATE = SCALE : NONE SHEET NO. 2 OF 40 SHEETS STA. TO STA. 4/22/2011 11:12:57 AM DATE - 4-11 REVISED -

TOTAL SHEE SHEETS NO.

40 2

MCLEAN

CONTRACT NO. 91461

10-00243-02-LS

ILLINOIS HIGHWAY STANDARD DRAWINGS

000001-06 STANDARDS SYMBOLS, ABBREVIATIONS, AND PATTERNS
101301-04 LANE CLOSURE, 2L, 2W SHORT TIME OPERATIONS
101501-06 URBAN LANE CLOSURE, 2L, 2W UNDIVIDED
101701-07 URBAN LANE CLOSURE, MULTILANE INTERSECTION
101801-04 LANE CLOSURE, MULTILANE, 1W OR 2W CROSSWALK OR SIDEWALK CLOSURE
101901-01 TRAFFIC CONTROL DEVICES

SEE DRAINAGE AND LANDSCAPE PLAN SHEETS FOR LEGEND ITEMS SPECIFIC TO THE RESPECTIVE SHEETS

LEGEND

PROPOSED

WATER LINE

GAS LINE

OVERHEAD ELECTRIC

UNDERGROUND ELECTRIC

OVERHEAD TELEPHONE

UNDERGROUND TELEPHONE

CABLE TELEVISION

COMMUNICATION LINE

FIBER OPTIC LINE

STEAM LINE

FORCE MAIN

SANITARY SEWER

STORM SEWER

INLET OR CATCH BASIN

MANHOLE
UTILITY WARNING SIGN

SERVICE BOX SHUTOFF

VALVE

WATER MANHOLE

WATER METER

FIRE HYDRANT

GAS METER

GAS REGULATOR

GAS VENT PIPE

ELECTRIC MANHOLE

ELECTRIC METER

ELECTRIC PEDESTAL

ELECTRIC JUNCTION BOX

POWER POLE

POWER POLE W/LIGHT

POWER POLE W/TRANSFORMER

ROADWAY LIGHT CONTROLLER
ROADWAY STREET LIGHT

ORNAMENTAL STREET LIGHT

GUY POLE

GUY WIRE

TELEPHONE POLE

TELEPHONE MANHOLE

TELEPHONE PEDESTAL PEDESTAL PAY PHONE

PHONE BOOTH

--- STORM SEWER WATER MAIN QUALITY ---

EXISTING

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MONUMENT

IRON PIN/PIPE FOUND

RIGHT-OF-WAY MARKER

SOIL BORING

TRAFFIC SIGNAL CONTROL BOX

TRAFFIC SIGNAL POST

TRAFFIC SIGNAL MAST ARM

PEDESTRIAL PUSH BUTTON POST

TRAFFIC SIGNAL HANDHOLE

TRAFFIC SIGNAL JUNCTION BOX

RR CROSSING GATE

RR FLASHING SIGNAL

RR CROSSBUCK

STREET SIGN TRAFFIC SIGN

DELINEATOR

PARKING LOT LIGHT

YARD LIGHT

MAILBOX

PARKING METER

IRRIGATION CONTROL BOX

IRRIGATION HEAD

TANK FILLER CAP

INSPECTION WELL

CLEANOUT

DOWNSPOUT

BOLLARD

FENCE POST

GATE POST

FLAG POLE

FLOOD LIGHT

TREE STUMP

BUSH

CONIFEROUS TREE

DECIDUOUS TREE

PROPERTY PARCEL NUMBER

HOUSE ADDRESS NUMBER

PROPOSED

FILE NAME = p:\N0240094\Plans\sheets\ 02 STANDARDS AND LEGEND.dgn	DESIGNED - K.L.R. DRAWN - K.L.R. CHECKED - S.M.W.	REVISED - REVISED - REVISED -		STATE OF ILLINOIS DEPARTMENT OF TRANSPORTATION		HIGHWAY STANDARDS AND LEGEND	F.A.U. SECTION 10-00243-02-LS	COUNTY TOTAL SHEET NO. MCLEAN 40 3
PLOT DATE = 4/22/2011 11:13:13 AM	DATE - 4-11	REVISED -	TOWN OF NORMAL	SECTION NO. 10-00243-02-LS	SCALE : NONE MCLEAN COUNTY	SHEET NO. 3 OF 40 SHEETS STA. TO STA.	FED. ROAD DIST. NO. ILLINOIS FED.	CONTRACT NO. 91461 NO240094

SUMMARY OF QUANTITIES

	CONSTRUCT	ION CODE	0031	0031	0031
CODE NO.	ITEM	UNIT	TOTAL QUANTITY	100% LOCAL (US DOT TIGER) QTY	80% ITEP 20% LOCAL QTY
* 20100110	TREE REMOVAL (6 TO 15 UNITS DIAMETER)	UNIT	6	6	
* 20101000	TEMPORARY FENCE	FOOT	1000	1000	
20200100	EARTH EXCAVATION	CU YD	1400	1400	
* 20201200	REMOVAL AND DISPOSAL OF UNSUITABLE MATERIAL	CU YD	140	140	
* 21000300	GRANULAR EMBANKMENT, SPECIAL	TON	287	287	
Δ 25200110	SODDING, SALT TOLERANT	SQ YD	426	426	
	SUPPLEMENTAL WATERING	UNIT	7	7	
39000400	PERIMETER EROSION BARRIER	FOOT	200		5
28000400	FEATMETER ENGLIN DANNER	F001	200	200	
28000510	INLET FILTERS	EACH	19	19	
35101800	AGGREGATE BASE COURSE, TYPE B 6"	SQ YD	1493	1493	
* 40201000	AGGREGATE FOR TEMPORARY ACCESS	TON	20	20	
40800050	INCIDENTAL HOT-MIX ASPHALT SURFACING	TON	24	24	
42400300	PORTLAND CEMENT CONCRETE SIDEWALK 6 INCH	SQ FT	7966	7966	
* 44000100	PAVEMENT REMOVAL	SQ YD	622	622	
44000300	CURB REMOVAL	FOOT	230	230	
44000600	SIDEWALK REMOVAL	SQ FT	5426	5426	
* 50901760	PIPE HANDRAIL	FOOT	66	66	
	PIPE DRAINS 6"	FOOT	35	35	
	PIPE UNDERDRAINS 6"	F00T	642	642	
	MANHOLES TO BE ADJUSTED	EACH	6	6	
60257900	MANHOLES TO BE RECONSTRUCTED	EACH	1	1	
* 60600505	CONCRETE CURB (SPECIAL)	F00T	106	106	
67100100	MOBILIZATION	LSUM	1	1	
Δ 81012100	CONDUIT IN TRENCH, 1/2" DIA. PVC	FOOT	925	925	
△81012200	CONDUIT IN TRENCH, 3/4" DIA., PVC	FOOT	370	370	
Δ81013200	CONDUIT IN TRENCH, 6" DIA., PVC	FOOT	250	250	
Δ 81702100	ELECTRIC CABLE IN CONDUIT, 600V (XLP-TYPE USE) 1/C NO. 12	FOOT	1930	1930	
△ 81702110	ELECTRIC CABLE IN CONDUIT, 600V (XLP-TYPE USE) 1/C NO. 10	FOOT	175	175	
% * 81900302	TRENCH AND BACKFILL WITH SCREENINGS OR SAND	FOOT	1545	1545	
∆∗ K0012990	PERENNIAL PLANTS, ORNAMENTAL TYPE, GALLON POT	UNIT	8.21		8.21
∆∗ K1003455	LANSCAPE FILL SOIL	CU YD	219	219	
\ * K1005481	SHREDDED BARK MULCH 3"	SQ YD	130	130	
	LIGHT POLE, SPECIAL (DECORATIVE ORNAMENTAL)	EACH	1	1	
	FLAG POLES	EACH	1	- 1	
	LUMINAIRE, METAL HALIDE, 175 WATT	EACH	1	1	
* X0325586		SQ YD	8	8	
	IN GRADE FIXTURE FOR UPLIGHTING	EACH	16	16	
•	IAL PROVISIONS		to		

A SPECIALTY ITEMS

FILE NAME =	DESIGNED - K.L.R.	REVISED -					F.A.U. RTE.	SECTION	COUNTY	TOTAL SHEE SHEETS NO.
p:\N0240094\Plans\sheets\ 04 SOQ.dgn	DRAWN - K.L.R.	REVISED -	STATE OF ILLINOIS		SUMMARY OF QUANTITIES		10-	00243-02-LS	MCLEAN	40 4
PLOT DATE =	CHECKED - S.M.W.	REVISED -	DEPARTMENT OF TRANSPORTATION							NO. 91461
4/22/2011 11:02:37 AM	DATE ^- 4-11	REVISED -	·	SCALE : NONE	SHEET NO. 4 OF 40 SHEETS STA.	TO STA.	FED. ROAD DIST. NO	D. ILLINOIS FED.		

SUMMARY OF QUANTITIES

_ [CONSTRUCT	ION CODE	0031	0031	0031
	CODE NO.	ITEM	UNIT	TOTAL QUANTITY	100% LOCAL (US DOT TIGER) QTY	80% ITEP 20% LOCAL QTY
Δ*	X2110100	TOPSOIL FURNISH AND PLACE, SPECIAL	CU YD	392	392	
*	X6023508	INLETS, TYPE A, WITH SPECIAL FRAME AND GRATE	EACH	2	2	
*	X6024503	INLETS TO BE ADJUSTED WITH NEW FRAME AND GRATE (SPECIAL)	EACH	4	4	
*	X7010216	TRAFFIC CONTROL AND PROTECTION, (SPECIAL)	LSUM	1	1	
Δ*	X8360120	LIGHT POLE FOUNDATION, SPECIAL	EACH	1	1	
Δ*	X8950130	MODIFY EXISTING LIGHTING CONTROLLER	EACH	1	1	
∆*	X8950205	REBUILD EXISITING HANDHOLE, SPECIAL	EACH	1	1	
* 2	XX000300	CONCRETE STEPS	SQ FT	467	467	2
*	XX001244	RETAINING WALL	FOOT	153	153	
*	XX003219	UNIT PAVERS	SQ FT	5470	5470	
△*	XX003885	IRRIGATION SYSTEM	LSUM	1	1	
1		INTERLOCKING CONCRETE PAVERS	SQ FT	4364	4364	
		LANDSCAPING PLANTERS	LSUM	1	1	
		PLANTER CURB	FOOT	32	32	
		REMOVE AND RE-ERECT SEGMENTAL BLOCK RETAINING WALL	SQ FT	160	160	
		TREES (SPECIAL)	EACH	10		10
· [TREE WELL	EACH	158	: 10.	158
			EACH	8		8
. [TREE GRATE ASSEMBLY, COMPLETE				
		UPLIGHTS	EACH	3	3	
		TRASH RECEPTACLE, FURNISH & INSTALL	EACH	1	1	
*	(X007860	AGGREGATE BASE COURSE, SPECIAL	SQ YD	485	485	
*	XX008159	PORTLAND CEMENT CONCRETE BAND FOR PAVER BRICKS	FOOT	1211	1211	
Δ*	(X008207	LIGHTS, PEDESTRIAN	EACH	15	15	
*	Z0003855	BICYCLE RACKS	EACH	6	6	
*	Z0004002	BOLLAROS	EACH	29	29	· · · · · · · · · · · · · · · · · · ·
*	20013798	CONSTRUCTION LAYOUT	LSUM	1	1	
* 2	Z0048665	RAILROAD PROTECTIVE LIABILITY INSURANCE	LSUM	1	1	
*	Z0050600	REMOVE AND RESET ORNAMENTAL FENCE	FOOT	110	110	
*)	(X008553	RETAINING WALL, SPECIAL	FOOT	54	54	
*	XXXX8554	CONCRETE SEATWALL WITH BENCH	LSUM	1	1	
Δ.	81200198	CONDUIT EMBEDDED IN STRUCTURE, 1/2" DIA., PVC	FOOT	150	150	
Δ*	81702101	ELECTRIC CABLE IN CONDUIT, 600V (XLP-TYPE USE) 1/C NO. 14	FOOT	130	130	
Δ*	K0012995	PERENNIAL PLANTS, ORNAMENTAL TYPE, 5-GALLON POT	UNIT	0.49		0.49
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• SEE SPECIAL PROVISIONS \$\Delta \text{SPECIALTY ITEMS}\$

FILE NAME = p:\N0240094\Plans\sheets\ 04 800.dgn PLOT DATE = 5/10/2011 2:16:34 PM

DESIGNED	-	K.L.R.	REVISED	-
DRAWN	-	K.L.R.	REVISED	-
CHECKED	-	S.M.W.	REVISED	-
DATE	-	4-11	REVISED	-

STATE OF ILLINOIS DEPARTMENT OF TRANSPORTATION SUMMARY OF QUANTITIES

SCALE: NONE | SHEET NO. 5 OF 40 SHEETS | STA.

SCHEDULE OF QUANTITIES

CANOPY TREES								
Botanic Name	Common Name	Size	Spacing	Mature Size	Unit	Quantities	Notes	
Commandador dinima Mala	Kentucky Coffeetree-Male	9" caliper			EACH	1	Spring Dig Only	
Gymnocladus dioicus-Male	кептиску соптееттее-мате	11" caliper			EACH	1	Spring Dig Only	
Quercus Bicolor	Swamp White Oak	4" caliper			EACH	5		
Ulmus x frontier	Frontier Elm	5" caliper			EACH	3		

DECIDUOUS SHRUBS					LOCATION		TOTAL QTY.	
DECIDOOUS SHROBS					Unit	East Island	Broadway Ave.	IOIALQIT.
Weigela florida 'Minuet'	Minuet Weigela	24" (5 gal.)	30"	3'h x 3's	EACH	10	16	26

ERGREEN SHRUBS							LOCATION		
Botanic Name	Common Name	Size	Spacing	Mature Size	Unit	East Island	Broadway Ave.	TOTAL QTY.	
Buxus 'Green Velvet'	Green Velvet Boxwood	24" (5 gal.)	48"	3'h x 5's	EACH		14	14	
Buxus 'Green Velvet'	Green Velvet Boxwood	36" (5 gal.)	48"	3'h x 5's	EACH	6	3	9	

GRASSES						LOCATION	TOTAL QTY.	
Botanic Name	Common Name	Size	Spacing	Mature Size	Unit	East Island	Broadway Ave.	TOTAL QIT.
Helitotrichon sempervirens 'Sapphire'	Sapphire Blue Oat Grass	#1 cont.	18"	18"h x 18"s	EACH	20	21	41

GROUNDCOVER LOCATION						TOTAL QTY.		
Botanic Name	Common Name		Spacing	Mature Size	Unit	East Island	Broadway Ave.	IOIAL QIT.
Liriope muscari 'Big Blue'	Big Blue' Lily-turf	#1 cont.	12" o.c.	12"h x 18"s	EACH	Varies	Varies	780

SODDING, SALT TOLERANT (25200110)

LOCATION		SQ YE
WEST ISLAND (PLAZA)		258
EAST ISLAND (PLAZA)		142
TIERED PLANTER		26
		:
	TOTAL	426

PIPE UNDERDRAINS 6" (60107700)

LOCATION	FOOT
WEST ISLAND (PLAZA)	364
EAST ISLAND (PLAZA)	278
	TOTAL 642

AGGREGATE BASE COURSE, SPECIAL (XX007860)

LOCATION		SQ YD
UNDER PERVIOUS PAVERS		485
	TOTAL	485

TREE WELL (XX006677)

LOCATION		EACH
UPTOWN CIRCLE		90
BEAUFORT ST.		68
7		
	TOTAL	158

(20200100)

LANDSCAPE FILL SOIL (K1003455)

LOCATION		CU YE
VARIOUS LOCATIONS (SEE PLANS)		219
	TOTAL	219

AGGREGATE BASE COURSE, TYPE B 6" (35101800)

LOCATION		SQ YD
UNDERNEATH SIDEWALK (SEE DETAILS)		885
UNDERNEATH UNIT PAVERS (SEE DETAILS)		608
	TOTAL	1493

PERENNIAL PLANTS, ORNAMENTAL TYPE, GALLON POT (KOO12990)

LOCA	TION						UNIT
EAST	ISLAND	(PLAZA)	&	BROADWAY	AVE.		8.21
						TOTAL	8.21

PERENNIAL PLANTS, ORNAMENTAL TYPE, 5-GALLON POT

LOCAT	ION			UNIT
EAST	ISLAND	(PLAZA)		0.16
WEST	ISLAND	(PLAZA)		0.33
			TOTAL	0.49

EARTH EXCAVATION

LOCATION			CU Y
PROJECT LIMITS			1400
			7
	1 144	TOTAL	1400

(X2110100)		
LOCATION	CU YD	
VARIOUS LOCATIONS (SEE PLANS)	392	
TOTAL	392	

DRAINAGE PLANS, AND LANDSCAPING PLANS.

TOPSOIL FURNISH AND PLACE, SPECIAL

PORTLAND CEMENT CONCRETE SIDEWALK, 6" (42400300)

LOCATION		SQ FT
BROADWAY		7605
BEAUFORT & UPTOWN CIRCLE		361
	TOTAL	7066

SHREDDED BARK MULCH 3" (K1005481)

CATION		SQ YD
OKEN QUANTITY		130
	TOTAL	130

UNIT PAVERS (XX003219)

LOCATION		SQ FT
HEXAGONAL PAVERS. TYPE 1		
WITHIN PLAZA AREA		2378
CONCRETE PAVERS, TYPE 2		
WITHIN PLAZA AREA		3036
TRUNCATED DOME PAVERS, TYPE 4		
BEAUFORT & UPTOWN CIRCLE		19
BEAUFORT & BROADWAY		37
	TOTAL	5470

NOTES

- 1. THE INDICATED EARTHWORK VOLUMES ARE ESTIMATES BASED ON THE "AVERAGE END AREA" METHOD OF CALCULATION. EARTHWORK VOLUMES WILL VARY WITH ACTUAL SOIL CONDITIONS ENCOUNTERED DURING CONSTRUCTION. THESE ESTIMATES ARE PROVIDED FOR THE CONVENIENCE OF THE CONTRACTOR ONLY AND SHOULD BE CONSIDERED APPROXIMATE. ACTUAL VOLUMES OF EARTH EXCAVATION AND EMBANKMENT WILL BE PAID FOR IN ACCORDANCE WITH THE STANDARD SPECIFICATIONS.
- 2. EXCESS EARTH MATERIALS FROM SEWER OR UTILITY TRENCHES AND EXCAVATIONS FOR STRUCTURES ARE NOT INCLUDED IN THE EARTHWORK CALCULATIONS. EXCESS EARTH MATERIAL SHALL BE DISPOSED OF OFF-SITE BY THE CONTRACTOR. THE COST OF DISPOSING OF EXCESS EARTH MATERIAL WILL NOT BE PAID FOR SEPARATELY AND SHALL BE INCLUDED IN THE COST OF EARTH EXCAVATION.
- 3. AN ESTIMATED QUANTITY FOR THE REMOVAL AND DISPOSAL OF UNSUITABLE MATERIALS HAS BEEN INCLUDED IN THE CONTRACT. THE REMOVAL AND DISPOSAL OF UNSUITABLE MATERIALS WILL BE AS DIRECTED BY THE ENGINEER AND WILL BE MEASURED AND PAID FOR AS DESCRIBED IN THE SPECIAL PROVISIONS.
- 4. SEE THE LANDSCAPE PLANS FOR ADDITIONAL INFORMATION.

PIPE DRAINS 6" (60100915)

LOCATION		FOOT
ACROSS CONSTITUTION TRAIL		35
	TOTAL	35

TREES (SPECIAL) (XX006570) TAL

TOTAL		
OCATION		EACH
EAST ISLAND (PLAZA)		1
WEST ISLAND (PLAZA)		1
UPTOWN CIRCLE		3
BEAUFORT ST.		5
	TOTAL	10

INTERLOCKING CONCRETE PAVERS (XX003995)

OCATION							SQ FT
PERVIOUS	PAVERS,	TYPE	3,	WITHIN	PLAZA	AREA	4364
						TOTAL	4364

FOR ADDITIONAL SCHEDULES OF QUANTITIES SEE THE REMOVALS/RELOCATIONS PLANS,

COUNTY TOTAL SHEET NO.


MCLEAN 40 6 DESIGNED - K.L.R. REVISED -FILE NAME = SECTION p:\N0240094\Plans\sheets\ 05 SCHEDUL OF QTY.dgn SCHEDULE OF QUANTITIES DRAWN - K.I.R. REVISED -STATE OF ILLINOIS 10-00243-02-LS DEPARTMENT OF TRANSPORTATION CHECKED - S.M.W. REVISED CONTRACT NO. 91461 PLOT DATE = 4/25/2011 11:32:29 AM DATE - 4-11 REVISED SCALE : NONE SHEET NO. 6 OF 40 SHEETS STA. FED. ROAD DIST. NO. | ILLINOIS | FED. AID PROJECT


TOWN OF NORMAL

SECTION NO. 10-00243-02-LS

McLEAN COUNTY


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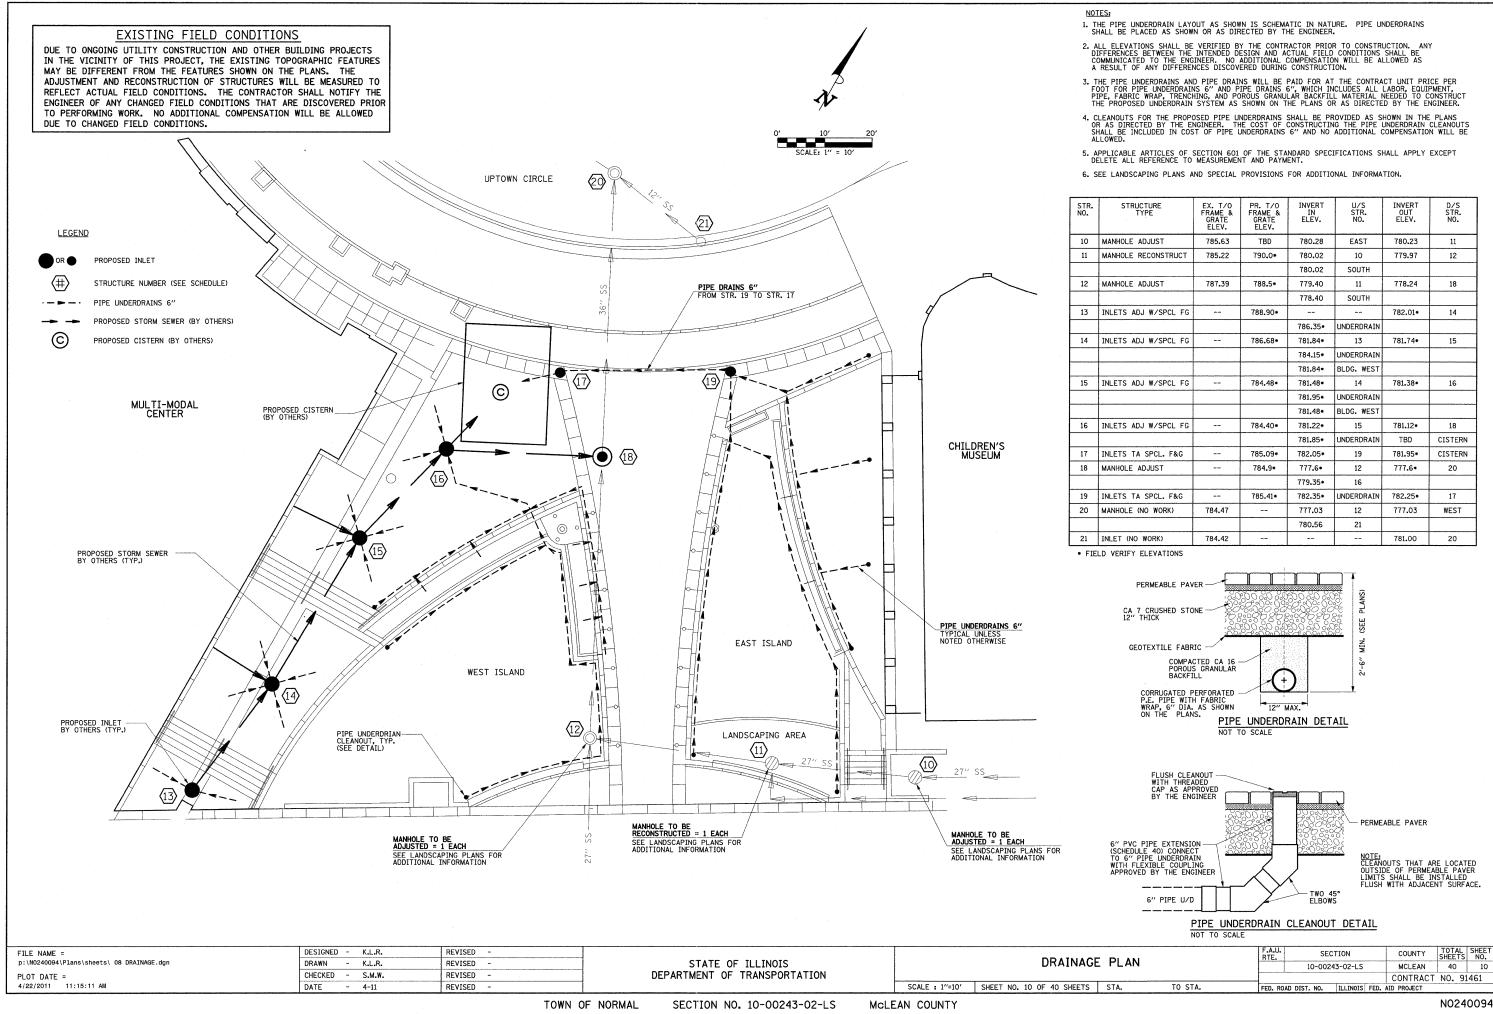


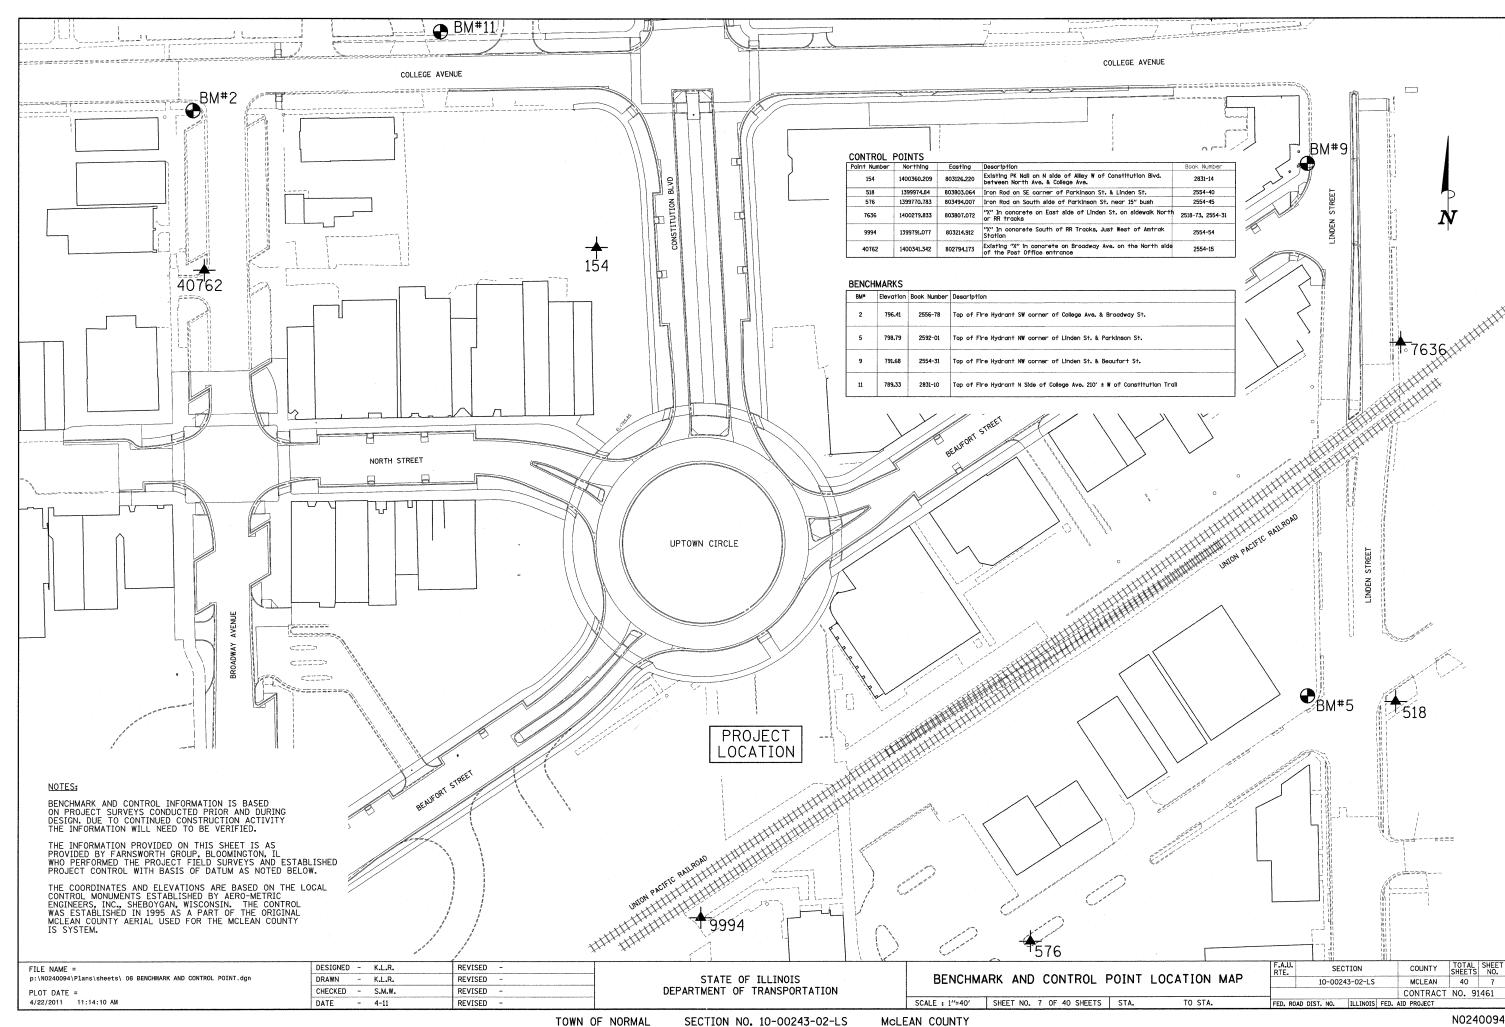

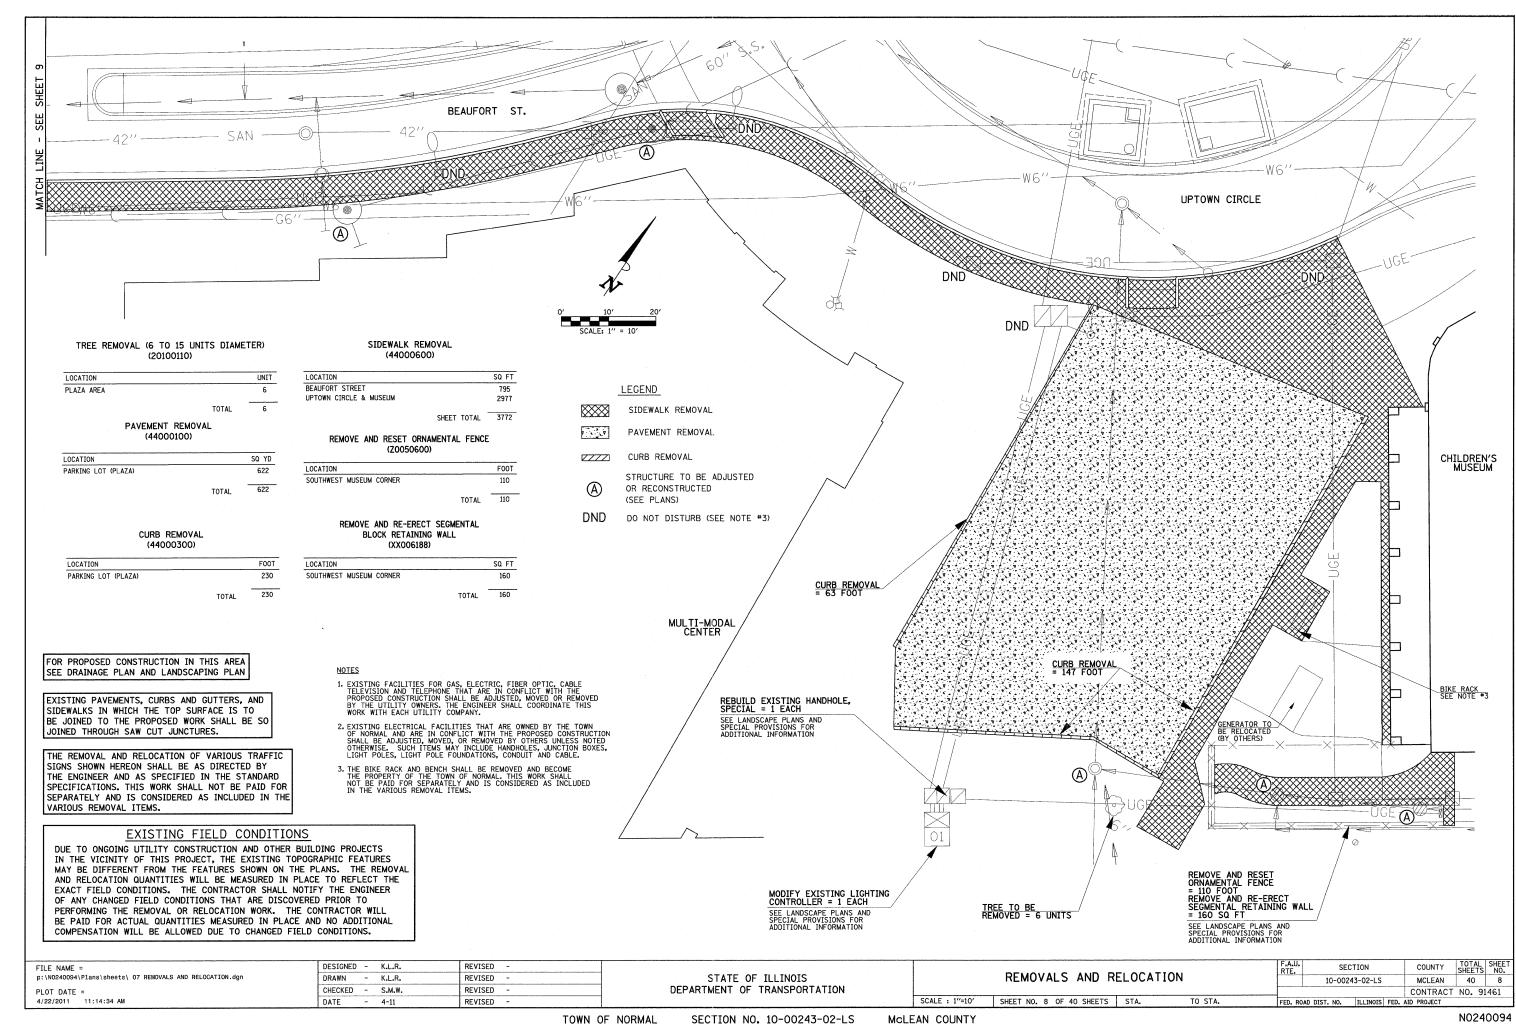SECTION NO. 10-00243-02-LS

McLEAN COUNTY



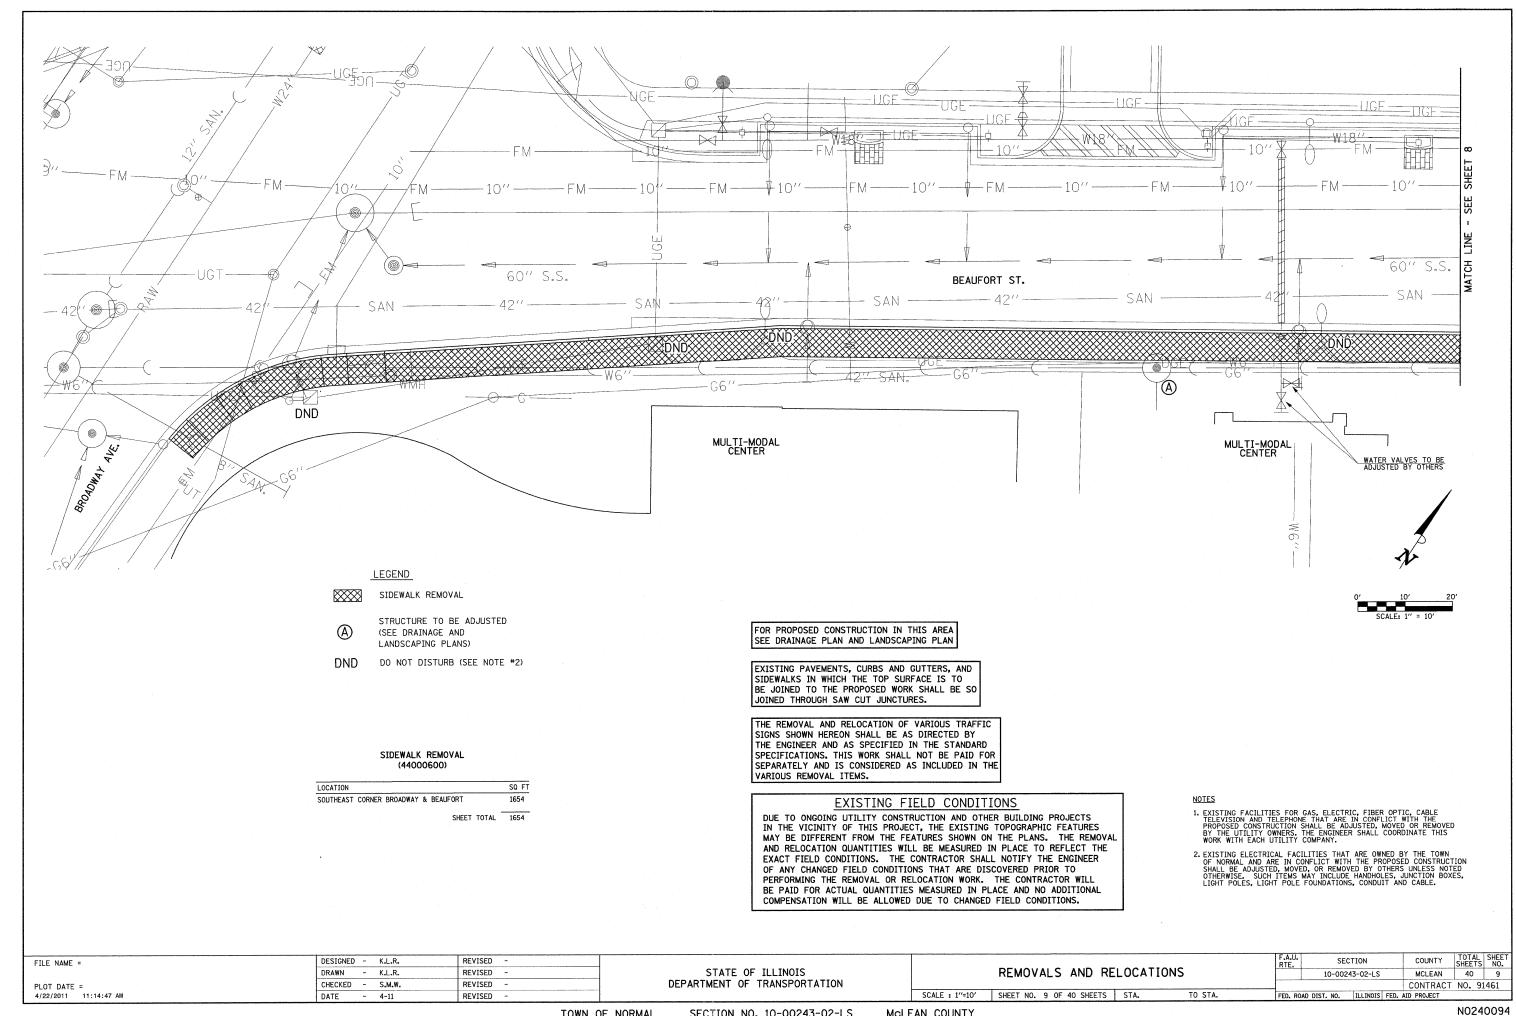



NORMAL MULTI-MODAL TRANSPORTATION PLAZA AND STREETSCAPE NORMAL, ILLINOIS

PSE SUBMITTAL: APRIL 22, 2011

DRAWING INDEX:

DIAMINO INDEA.	
Sheet Title	Sheet Number
L 0.0 Cover Sheet	11
L 0.1 Existing Conditions	12
Landscape Layout / Materials	
L 1.0 - 1.1 Layout Plans	13-14
L 1.2 - 1.3 Material Plans	15-16
L 1.4 - 1.5 Landscape Lighting Plan	17-18
Landscape Soils and Grading	
L 2.0 - 2.1 Soil Plans	19-20
L 2.2 - 2.3Grading Plans	21-22
L 2.4 - 2.5 Wall and Footing Plans	23-24
L 2.6 - 2.7 Wall Elevations	25-26
Landscape Hardscape / Paving	
L 3.0 - 3.5 Hardscape Details	27-32
Landscape Planting	
L 4.0 - 4.1 Planting Plans	33-34
L 4.2 Landscape Sections	35
L 4.3 - 4.4 Planting Detail	36-37
Irrigation	
L 5.0 - 5.1 Irrigation Plans	38-39
L 5.2 Irrigation Details	40
5	

PROJECT TEAM

CLIENT:

Town of Normal 100 E. Phoenix Avenue Normal, Illinois 61761-0589 Contact: Wayne Aldrich Phone: 309-454-9760 Fax: 309 - 452-2366 email: waldrich@normal.org

LANDSCAPE ARCHITECT:

Hoerr Schaudt Landscape Architects 850 West Jackson Blvd, Ste 800 Chicago, Illinois 60607 Contact: Rick Reineke Phone: 312-492-6501 Fax: 312-492-7101 email: rreineke@hoerrschaudt.com

CIVIL ENGINEER:

Clark - Dietz, Inc. 125 West Church Street Champaign, Illinois 61820-3510 Contact: Jerry Payonk Phone: 217-373-8945 Fax: 217-373-8923

IRRIGATION CONSULTANT:

Landtech Irrigation Consultants 8420 Zionville Road Indianapolis, Indiana 46268 Contact: Jeff Reising Phone: 317-334-7632 Fax: 317-879-2331 email: Jerry.Payonk@clarkdietz.com email:jeff.reising@landtechdesign.com

FILE NAME = PLOT DATE =

REVISED — 04-01-11 DESIGNED - P.L.S. DRAWN — R.N.R REVISED — 04-22-11 CHECKED - J.M.B. REVISED DATE - 3-11 REVISED

STATE OF ILLINOIS DEPARTMENT OF TRANSPORTATION


SECTION COUNTY LO.O - COVER PAGE 10-00243-02-LS MCLEAN 40 11 CONTRACT NO. 91461 SHEET NO. 11 OF 40 SHEETS STA. TO STA. FED. ROAD DIST. NO. ___ ILLINOIS | FED. AID PROJECT

SCALE :

GENERAL NOTES

- 1. The Contractor shall determine exact location of all public and private utilities prior to start of landscape operations. The Contractor shall also be responsible for maintaining all utility locations, as marked by the utility companies, and owner's representative throughout the duration of landscape construction.
- 2. The Contractor shall verify all site conditions in the field. Any discrepancies between the drawing and actual site conditions shall be brought immediately to the attention of the Landscape Architect.
- 3. The Contractor shall obtain a permit to remove, spray or in any way affect the general health and/or the structures of trees.
- 4. The Contractor shall take great care not to damage existing pavement and/or structures during excavation and planting
- 8. The Contractor shall take great care not to disturb the root systems of existing trees. When trenching within the dripline of any tree the operation should be performed by hand working in a wheel and spoke manner from the trunk outward. Damaged or torn roots shall be immediately repaired with a smooth, clean cut. The Contractor shall take great care during tillage operations within the specified tree protection zones of trees to remain. When major roots are encountered, the Contractor shall excavate soil by hand to avoid damage to roots.
- 9. Substitutions shall only be allowed when the Contractor has exhausted all sources for the specified material, and has proven the specified material is not available. The Contractor must provide name and variety of substitutions to the Landscape Architect for approval prior to procurement and/or installation. Contractor shall
- 10. The Contractor shall stake or place all plants in field as indicated on the drawings or as directed by the Landscape Architect for approval by the Owner or authorized representative prior to planting. The Landscape Architect requires a minimum of 72 hours notice prior to field layout and/or approval.
- 11. The Contractor shall perform all maintenance activities within the scope area through completion of the construction project and until final walkthrough with Landscape Architect and a written note
- 12. The Contractor shall be responsible for restoring all areas damaged by their construction operations whether within the construction limits or not.

13. Upon completion of construction and any necessary repairs. the contractor or Owner will contact the Landscape Architect to arrange a final walkthrough. Landscape Architect to provide a formal letter of acceptance to the client prior to turn over.

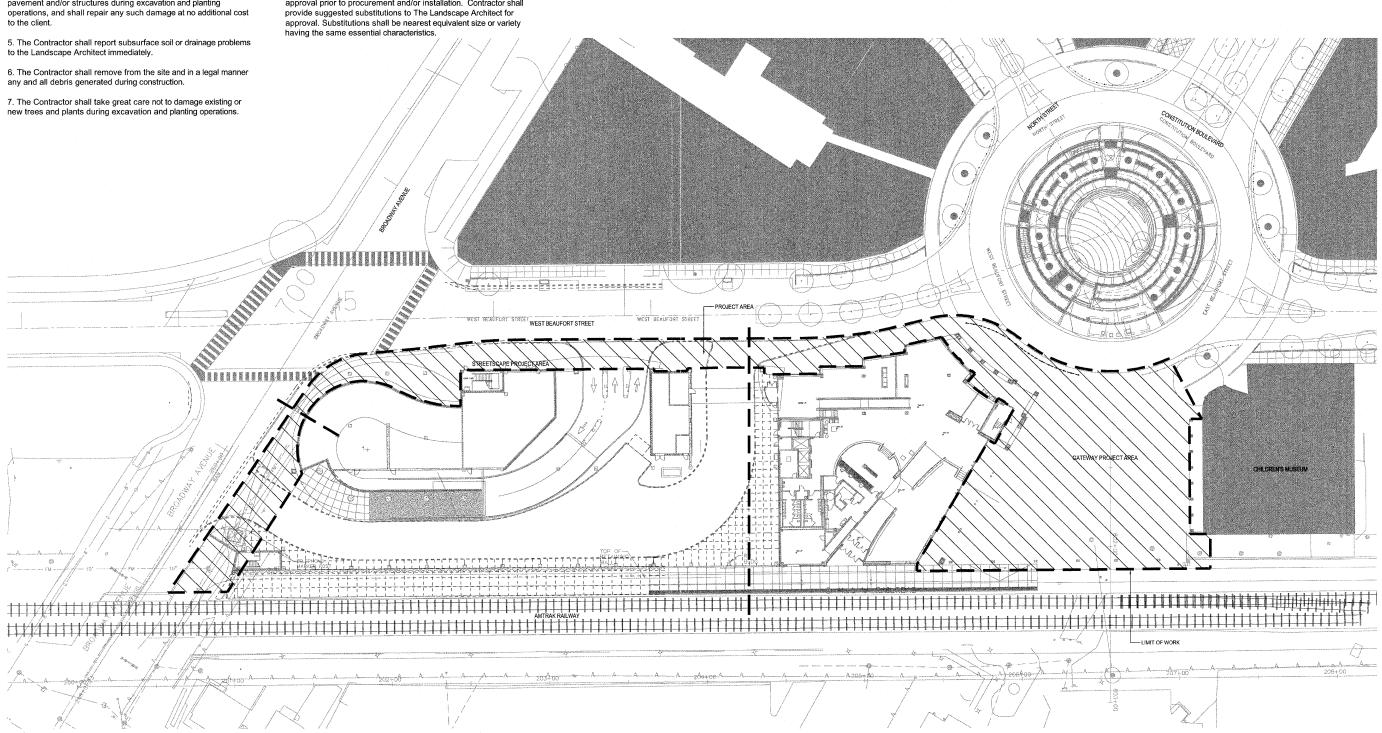

EXISTING CONDITIONS PLAN


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STATE OF ILLINOIS DEPARTMENT OF TRANSPORTATION LO.1 - EXISTING SITE CONDITIONS

TO STA.

SCALE : 1"=30'-0" | SHEET NO. 12 OF 40 SHEETS | STA.


10-00243-02-LS MCLEAN 40 12 CONTRACT NO. 91461

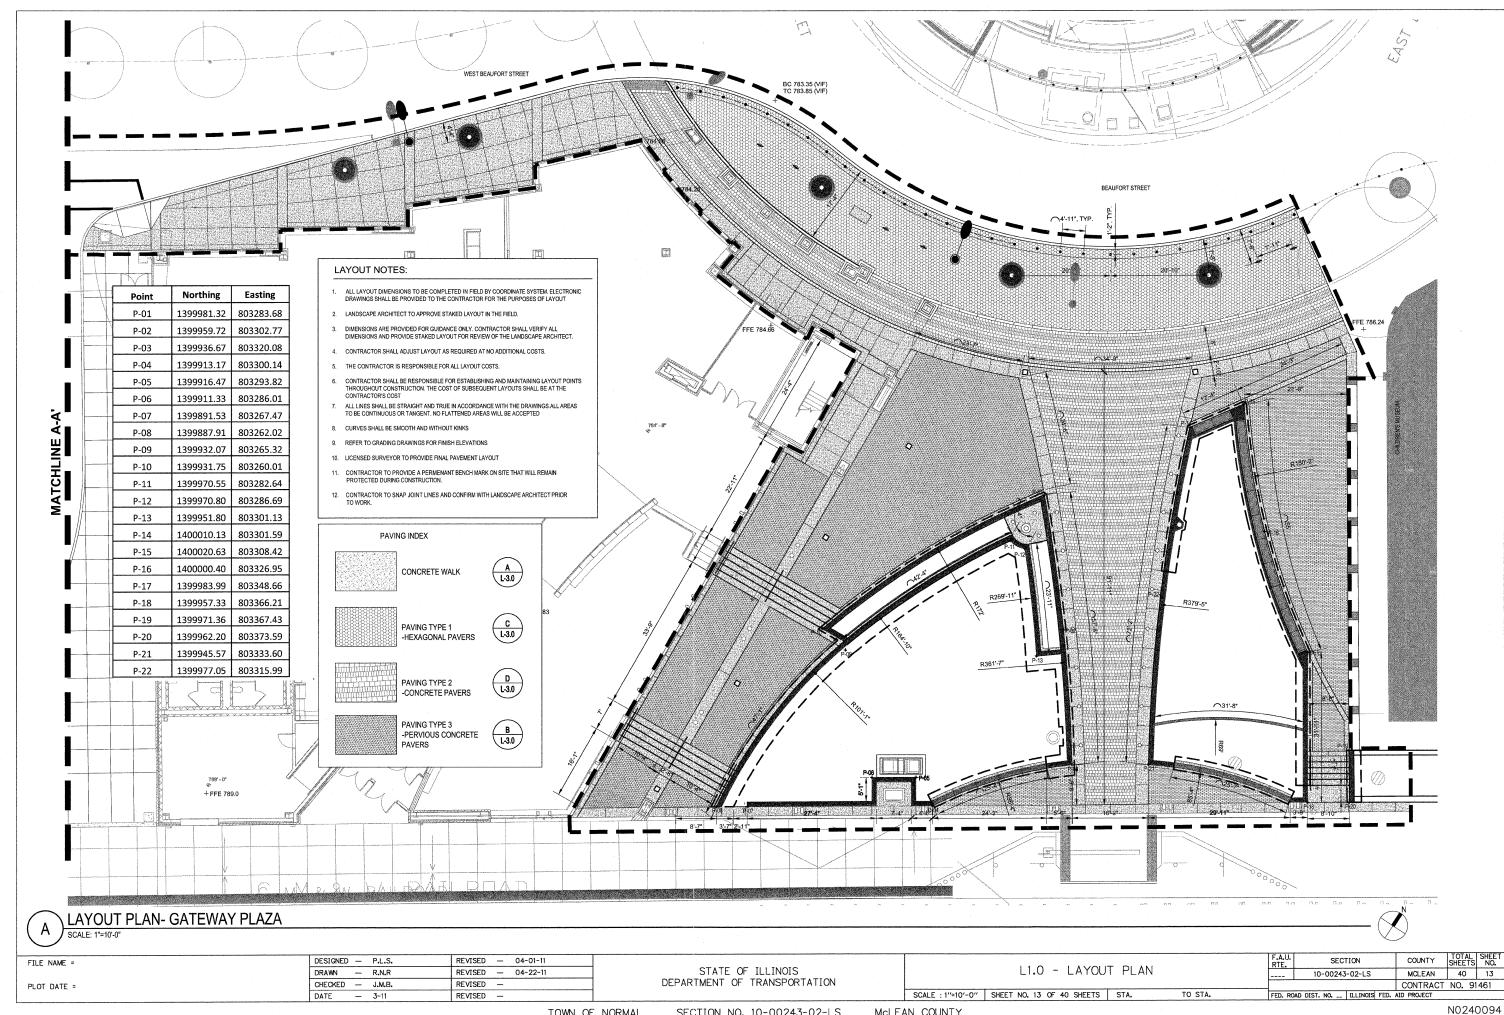



TOWN OF NORMAL


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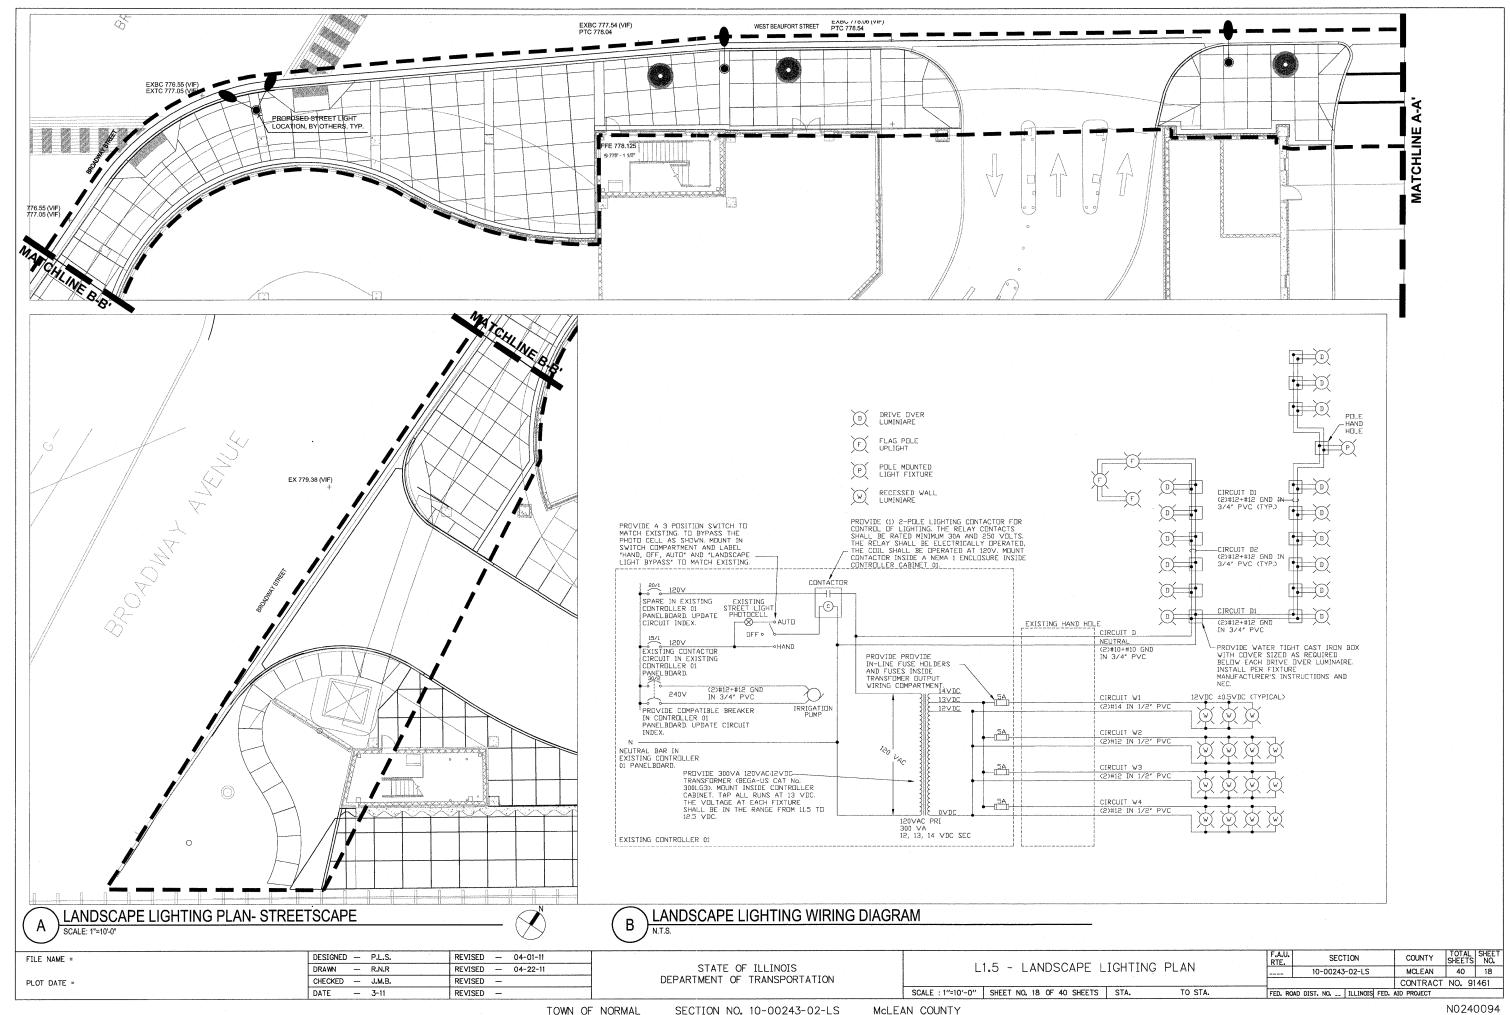
McLEAN COUNTY




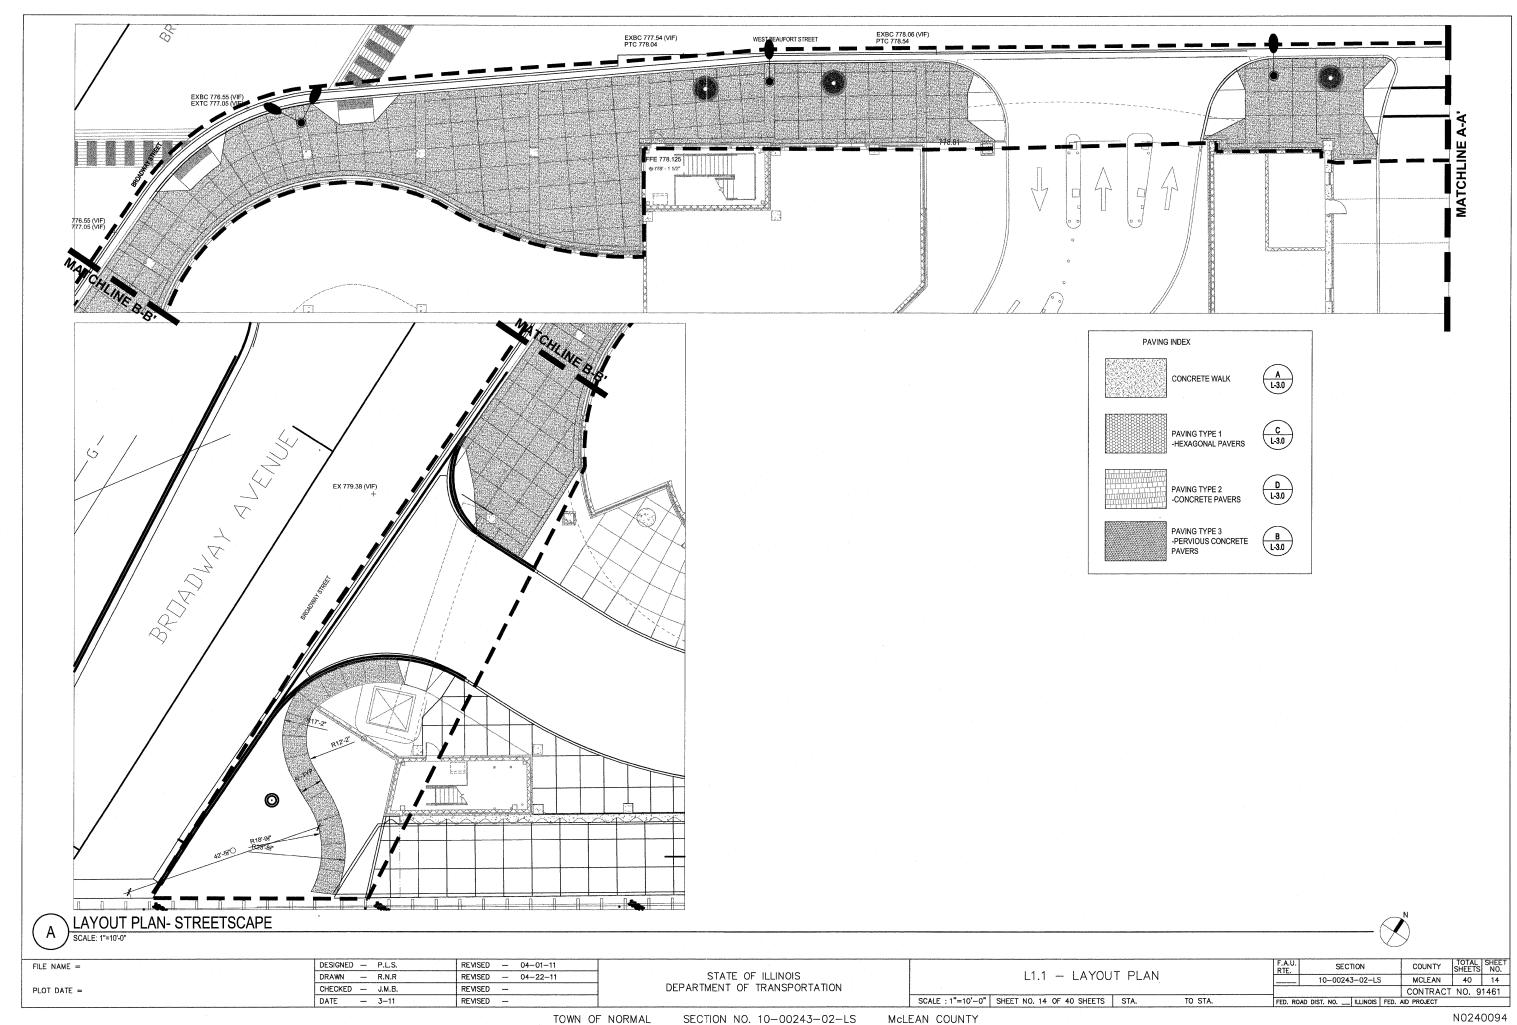


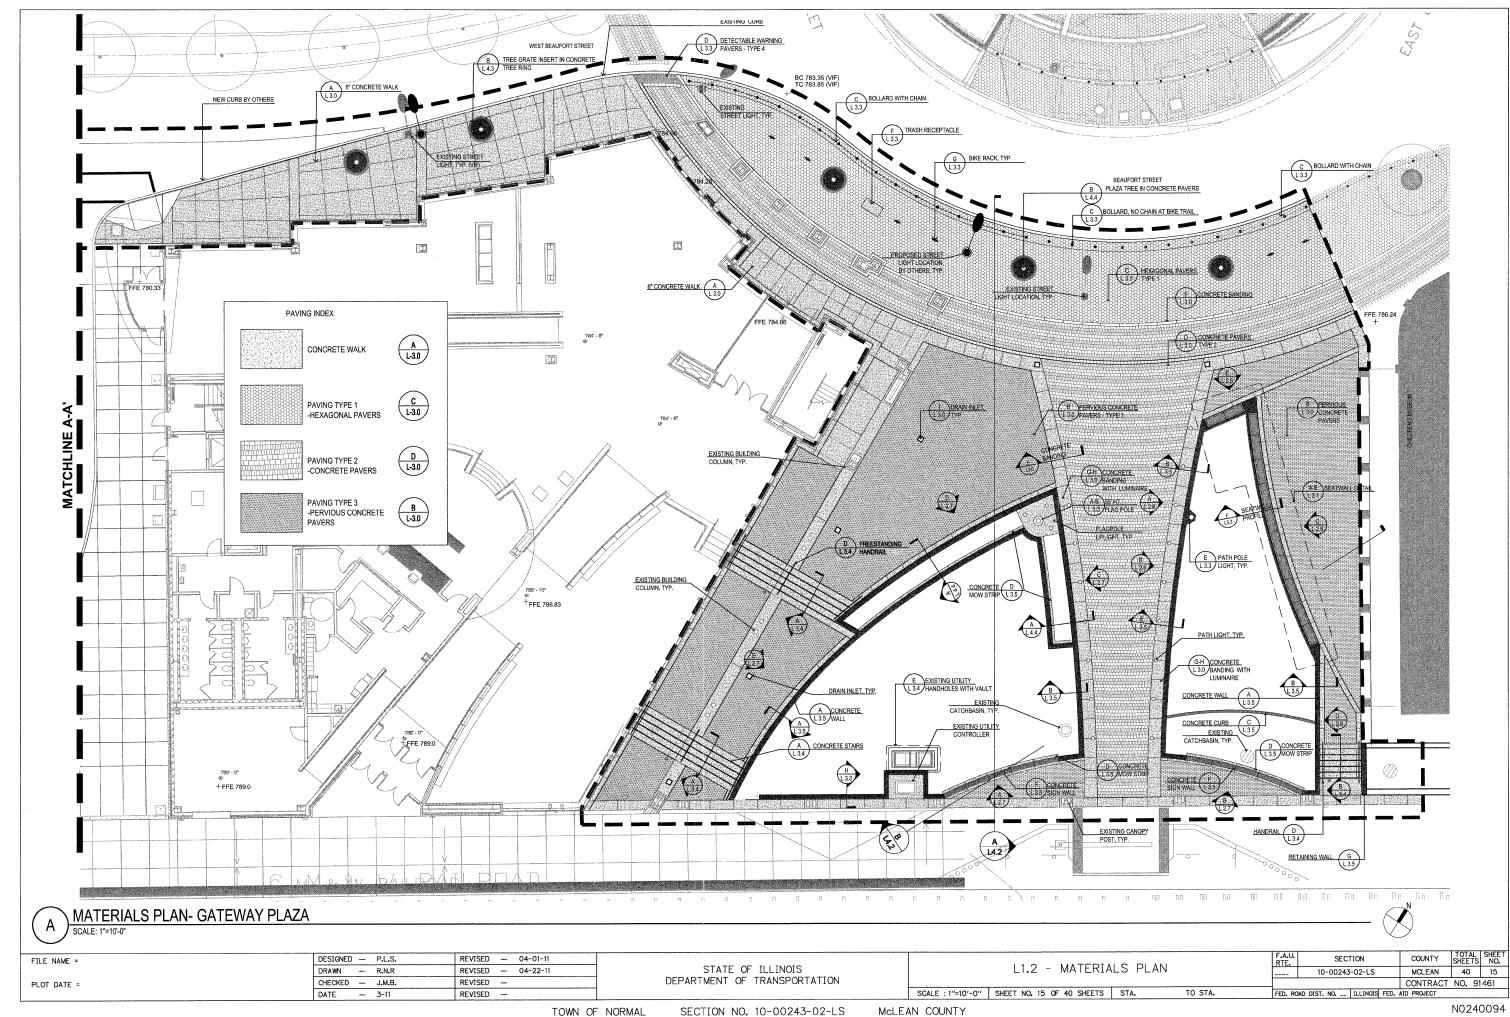


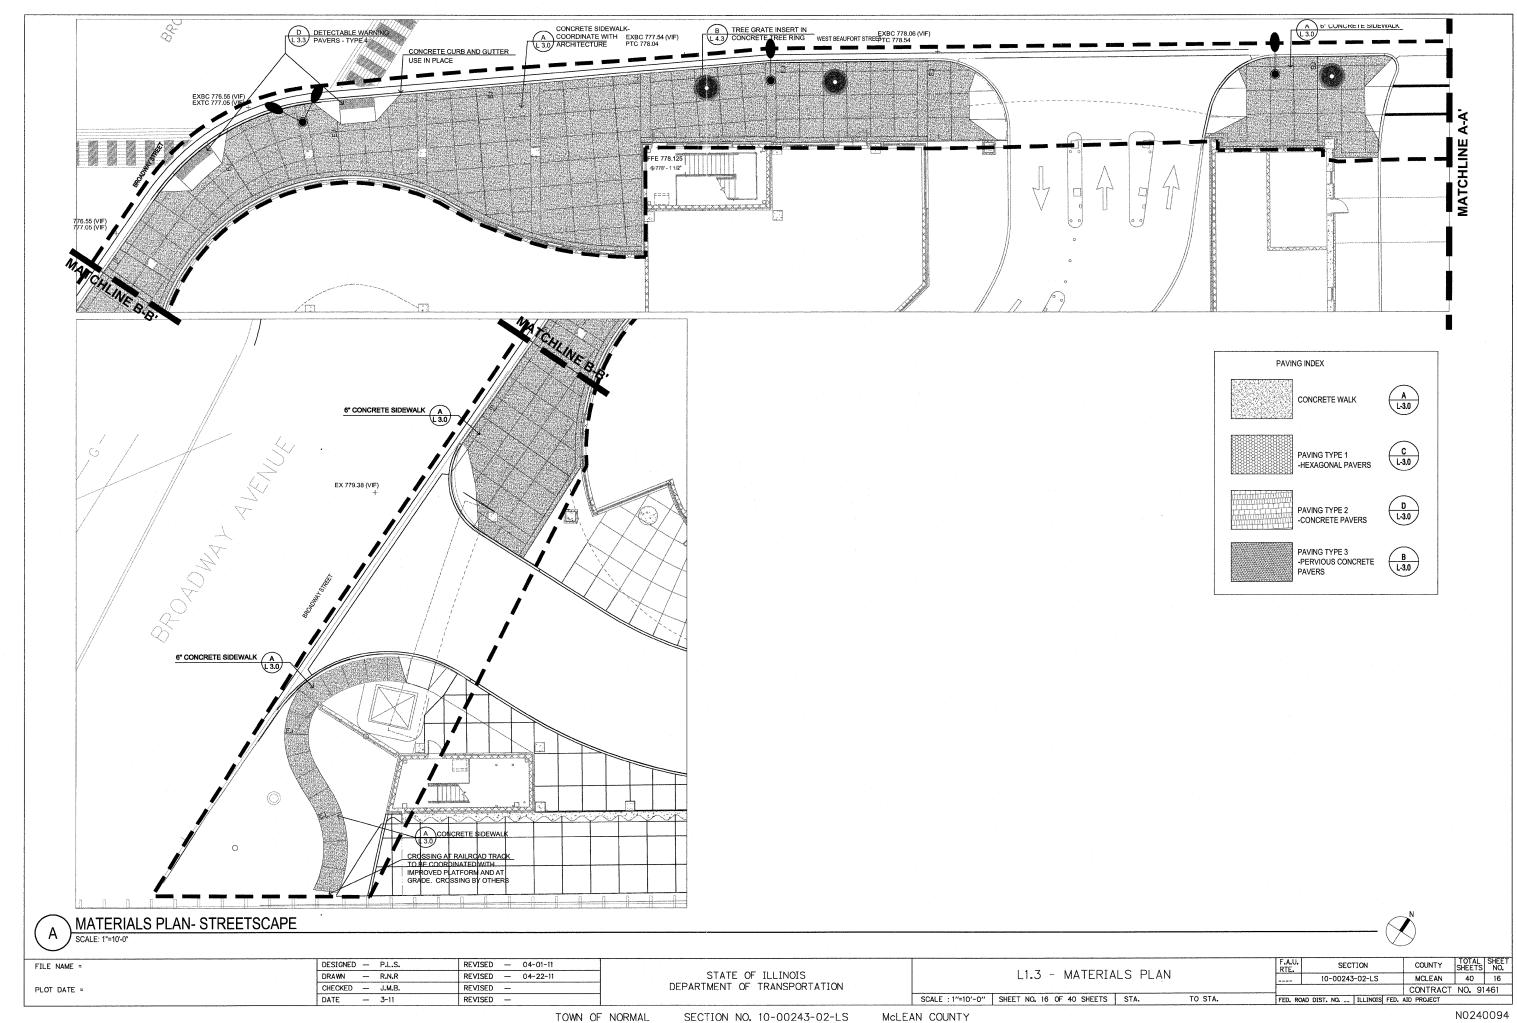


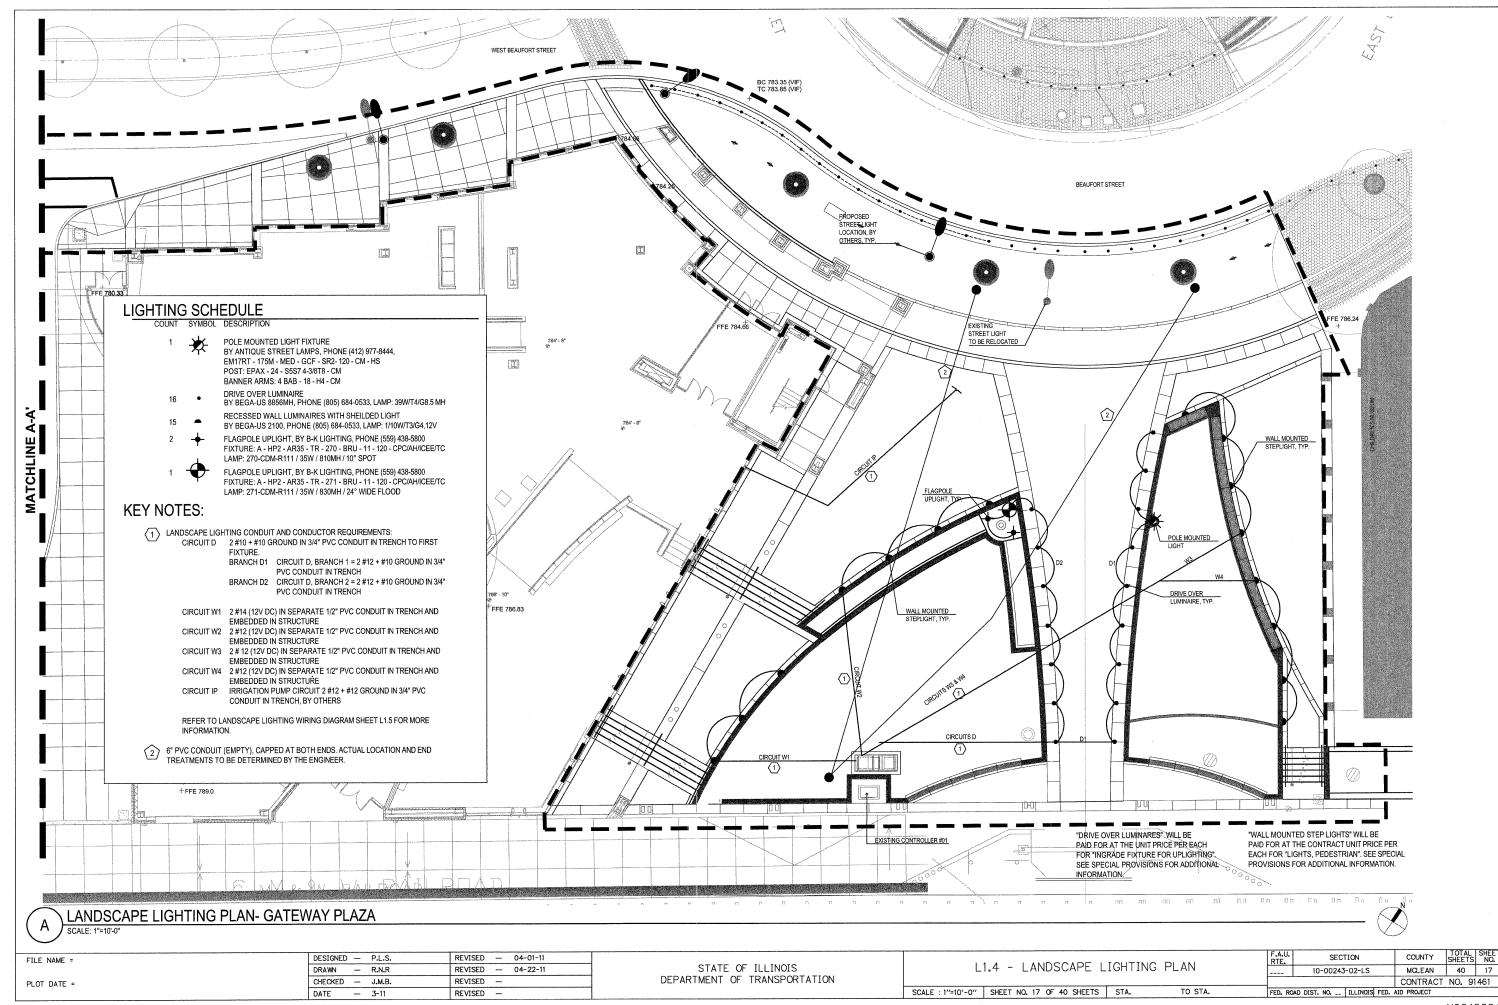


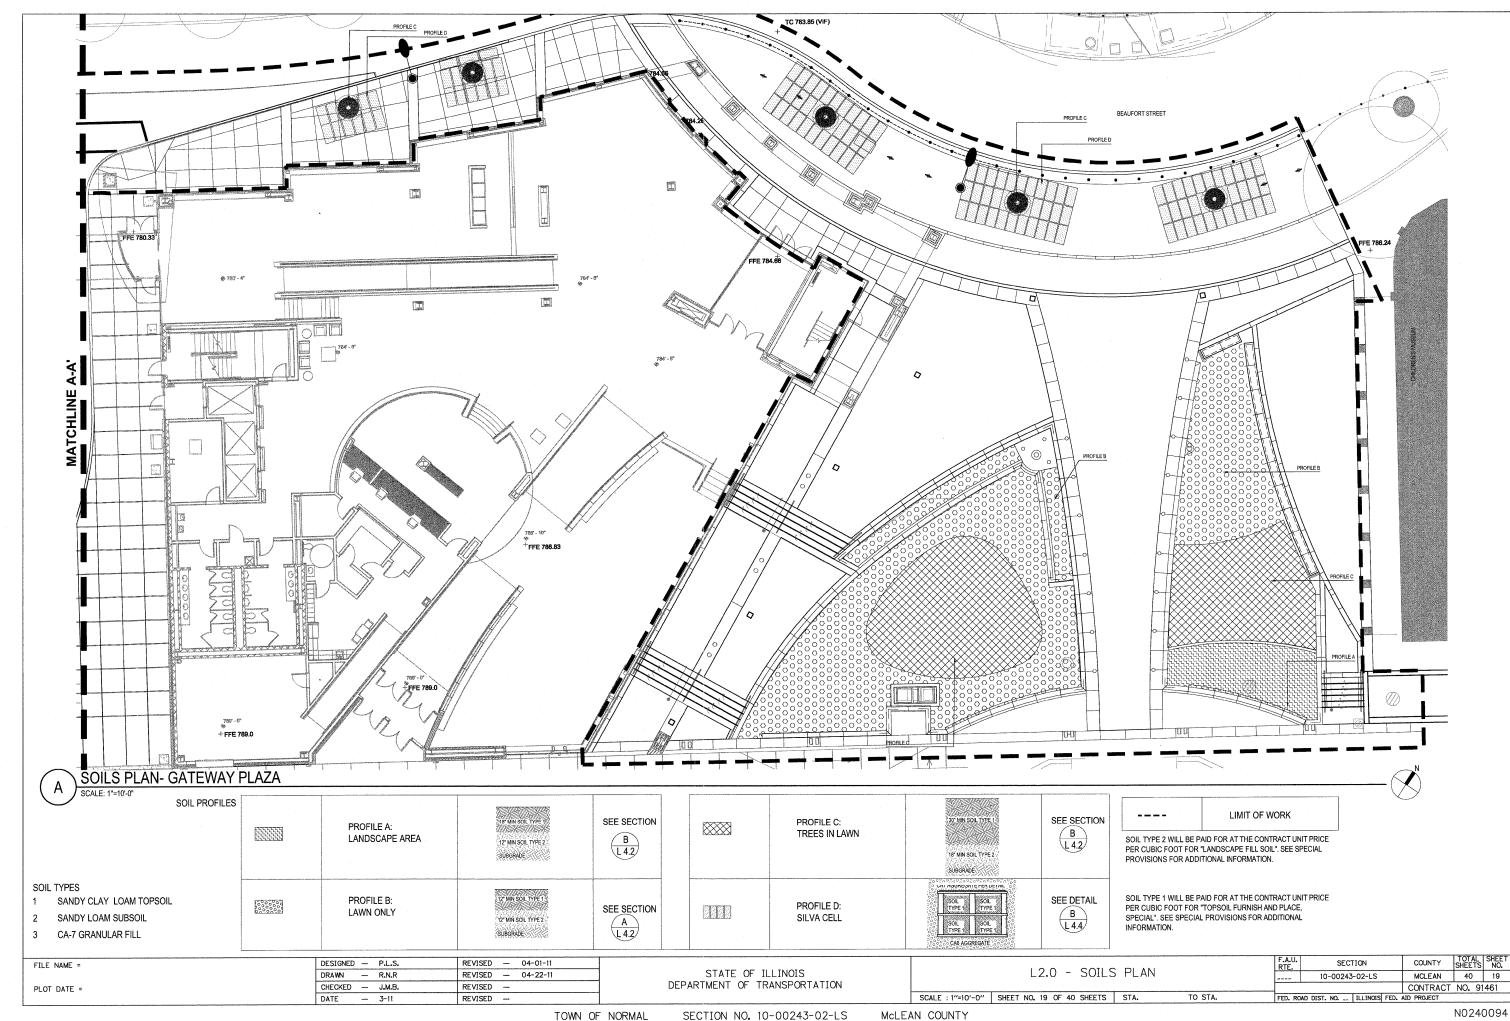


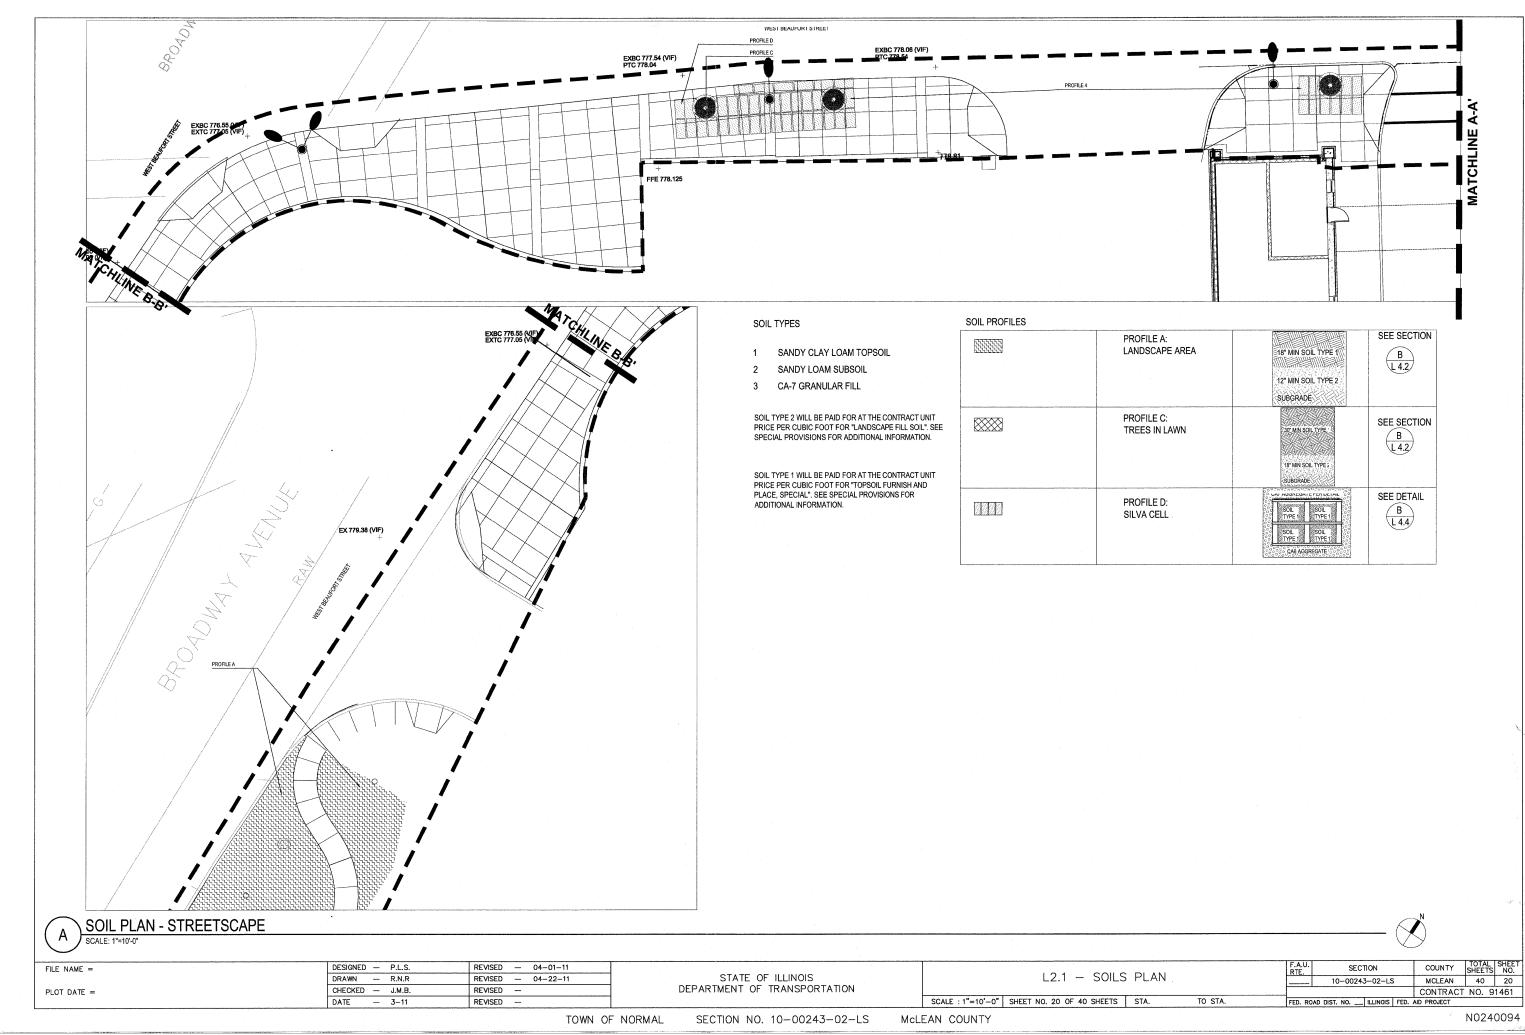


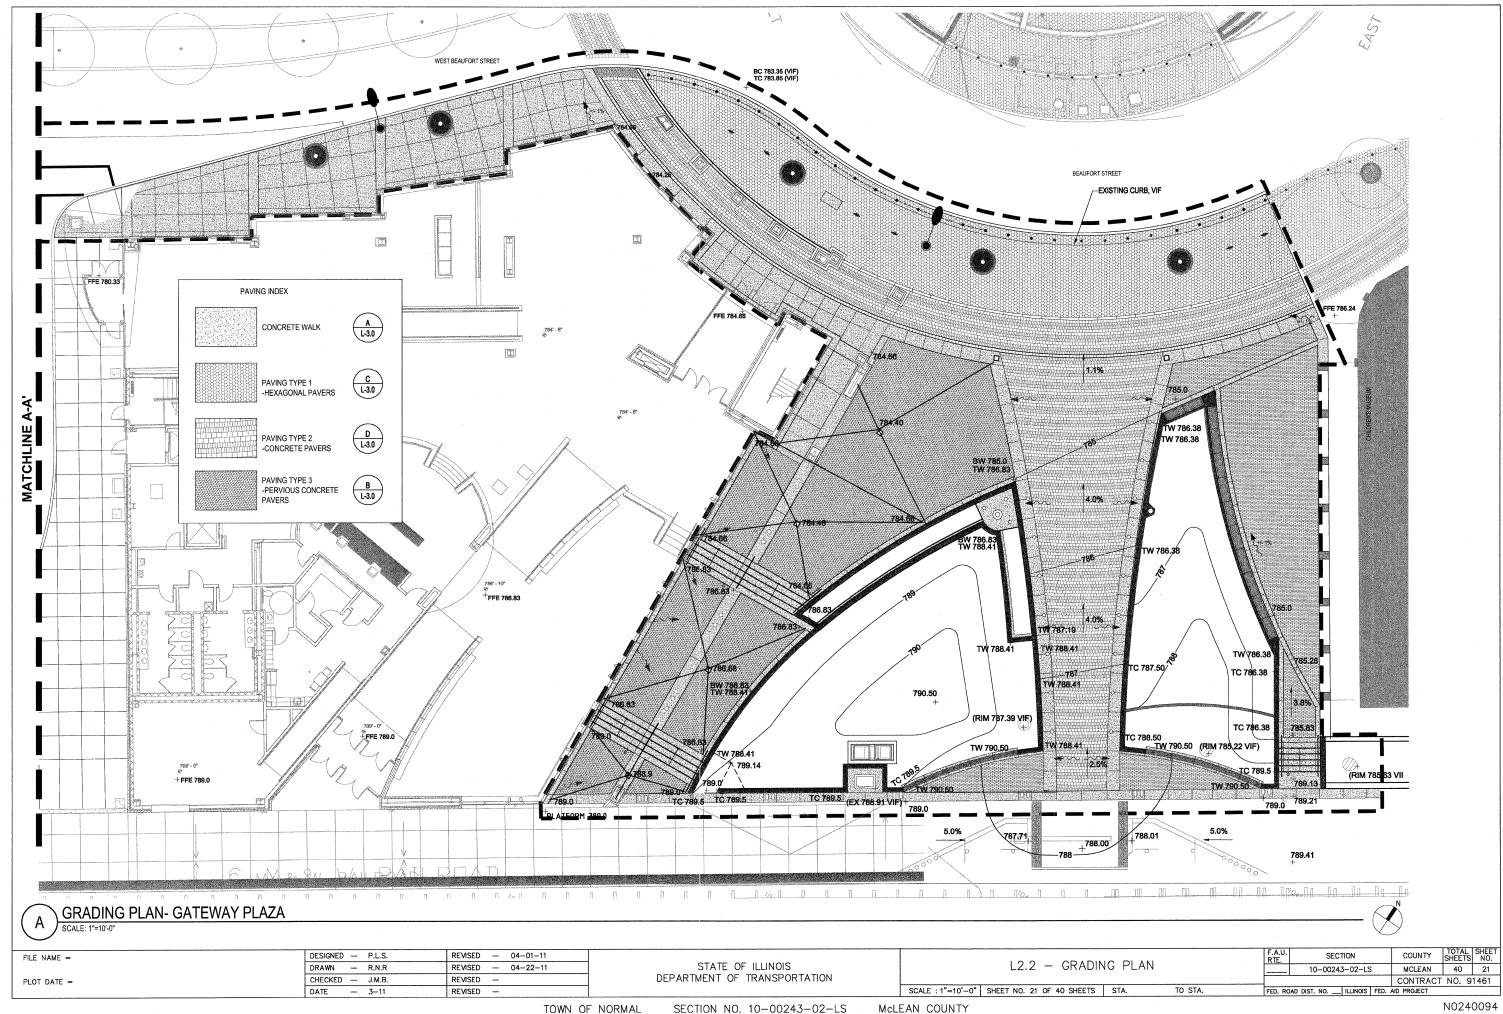


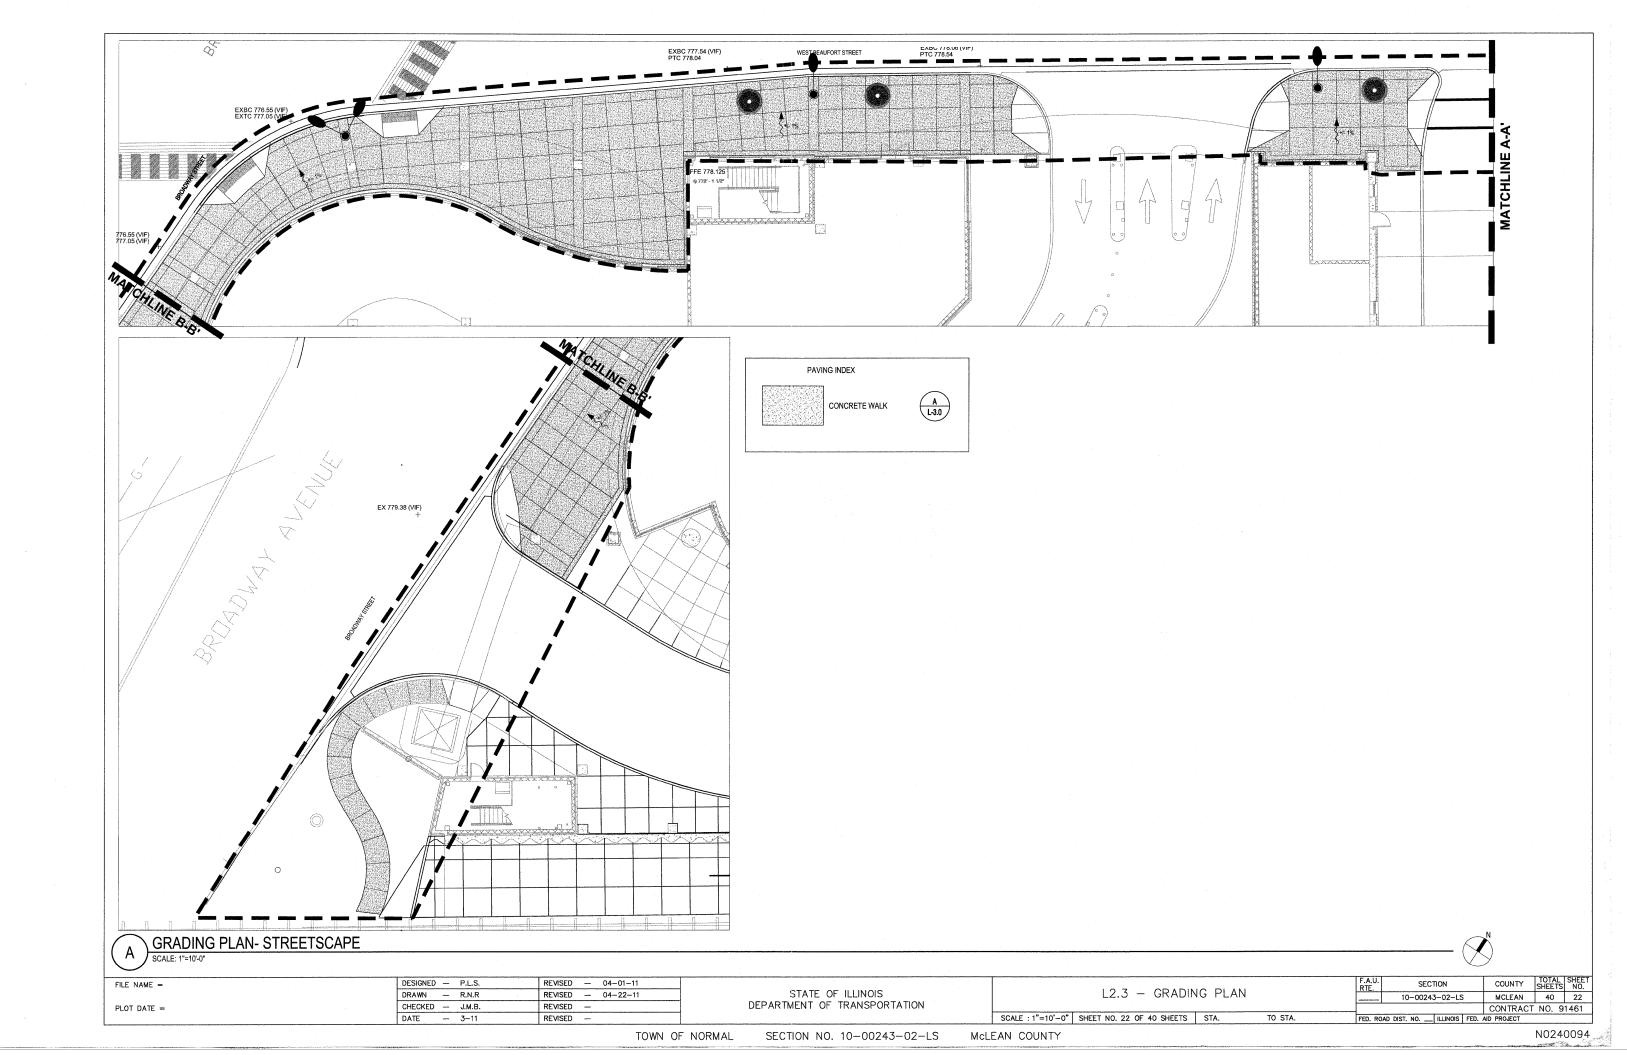


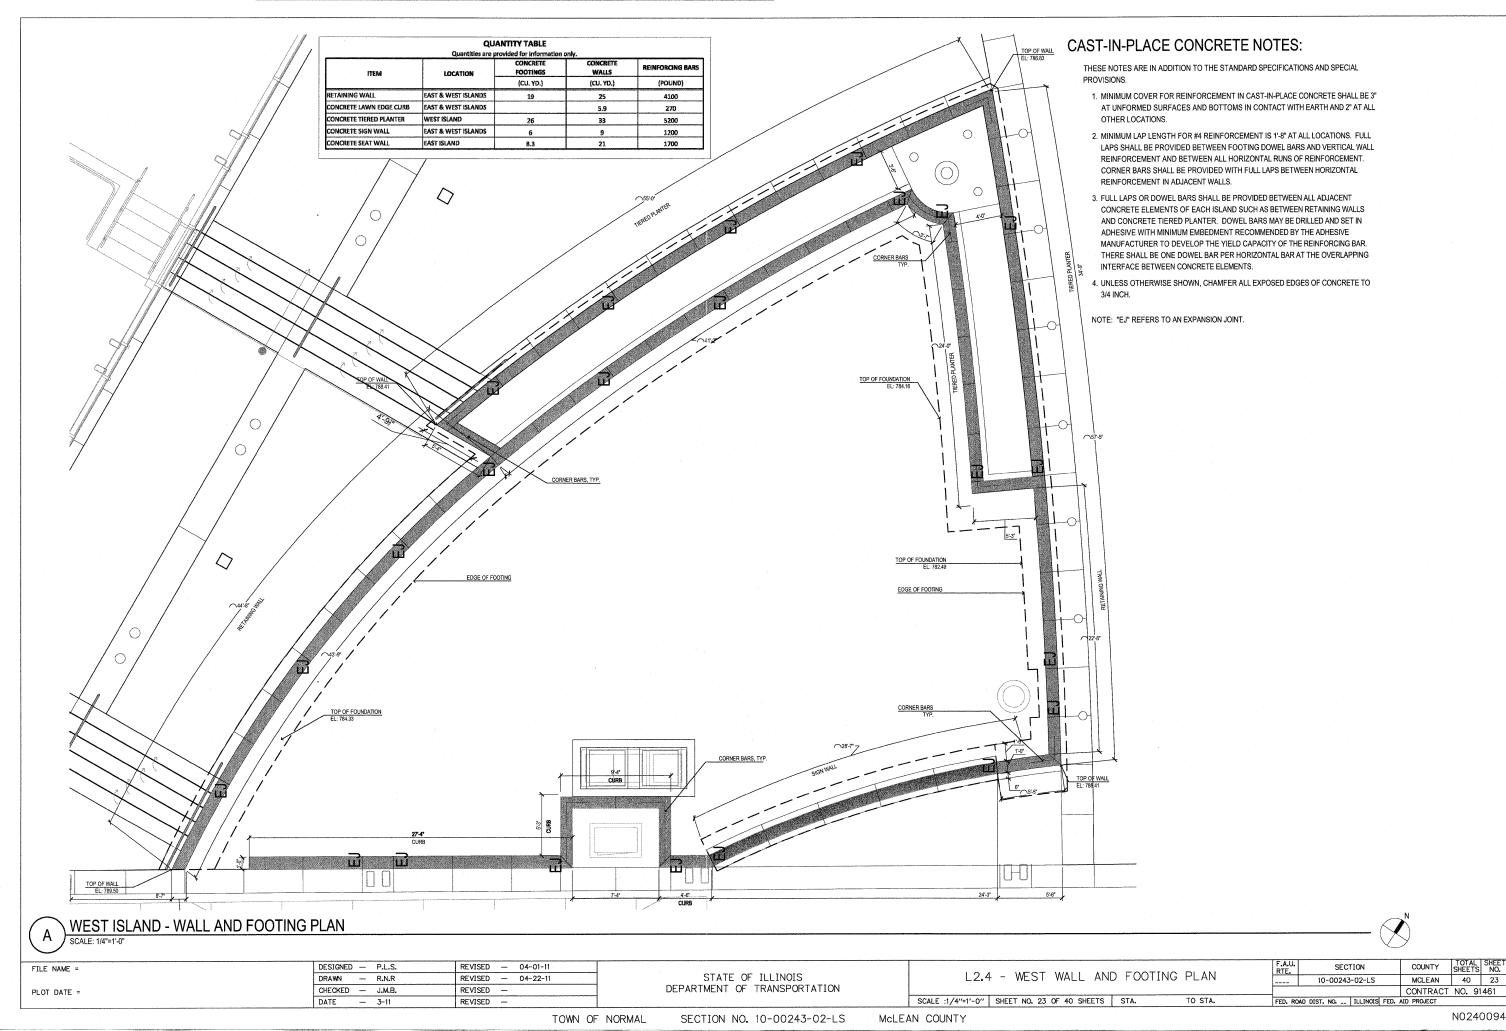


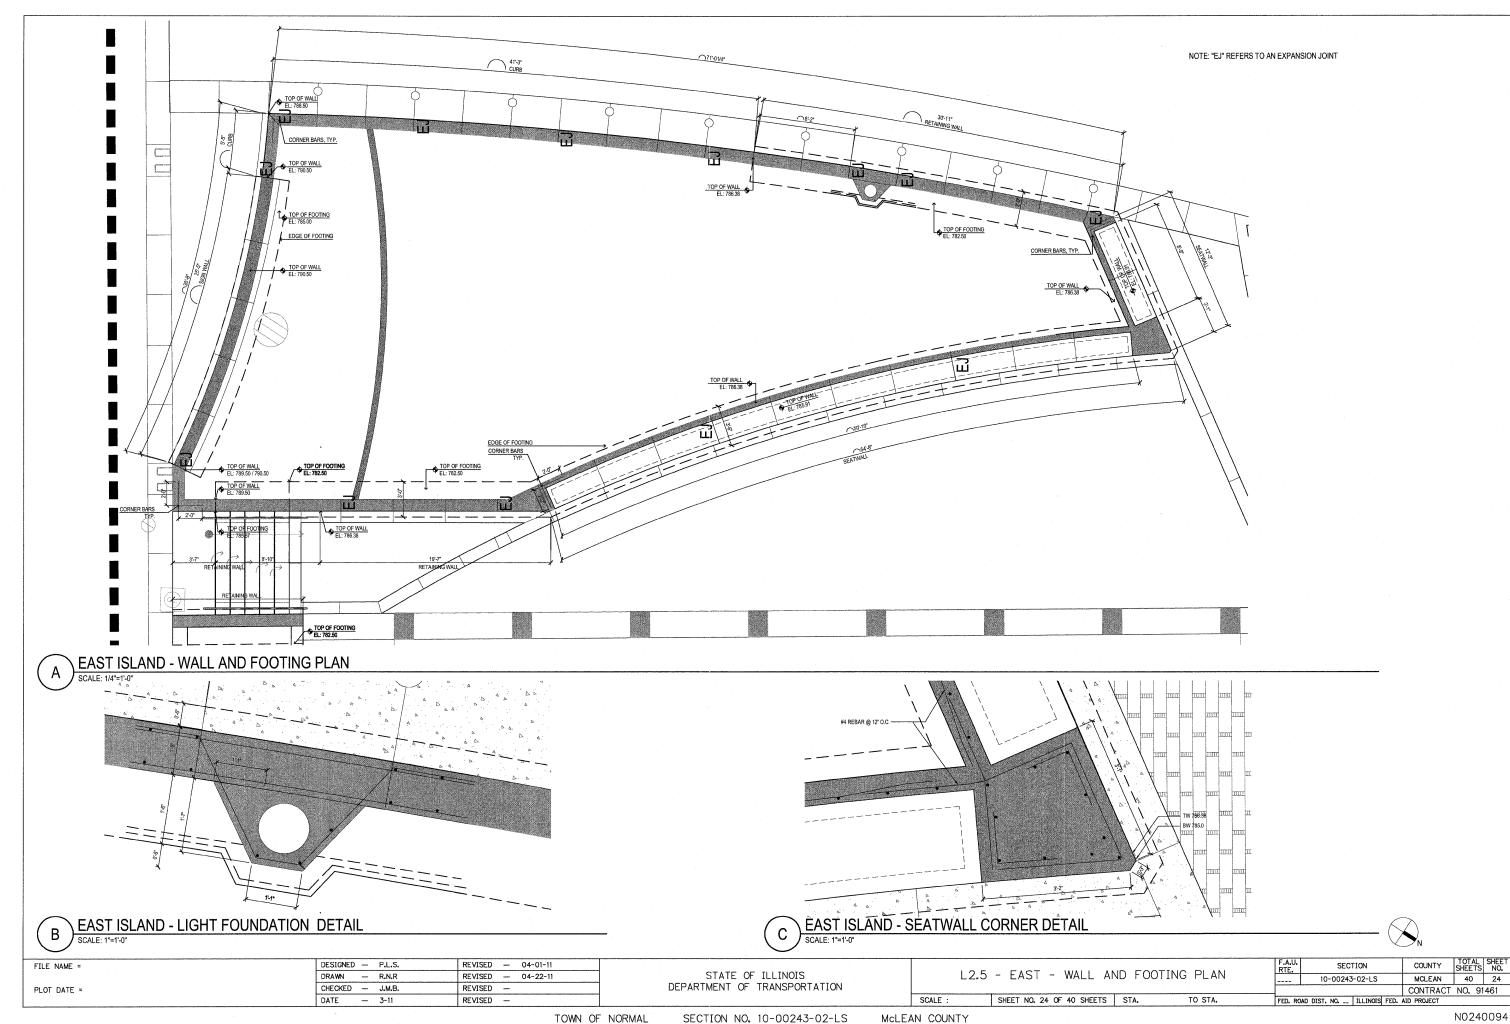


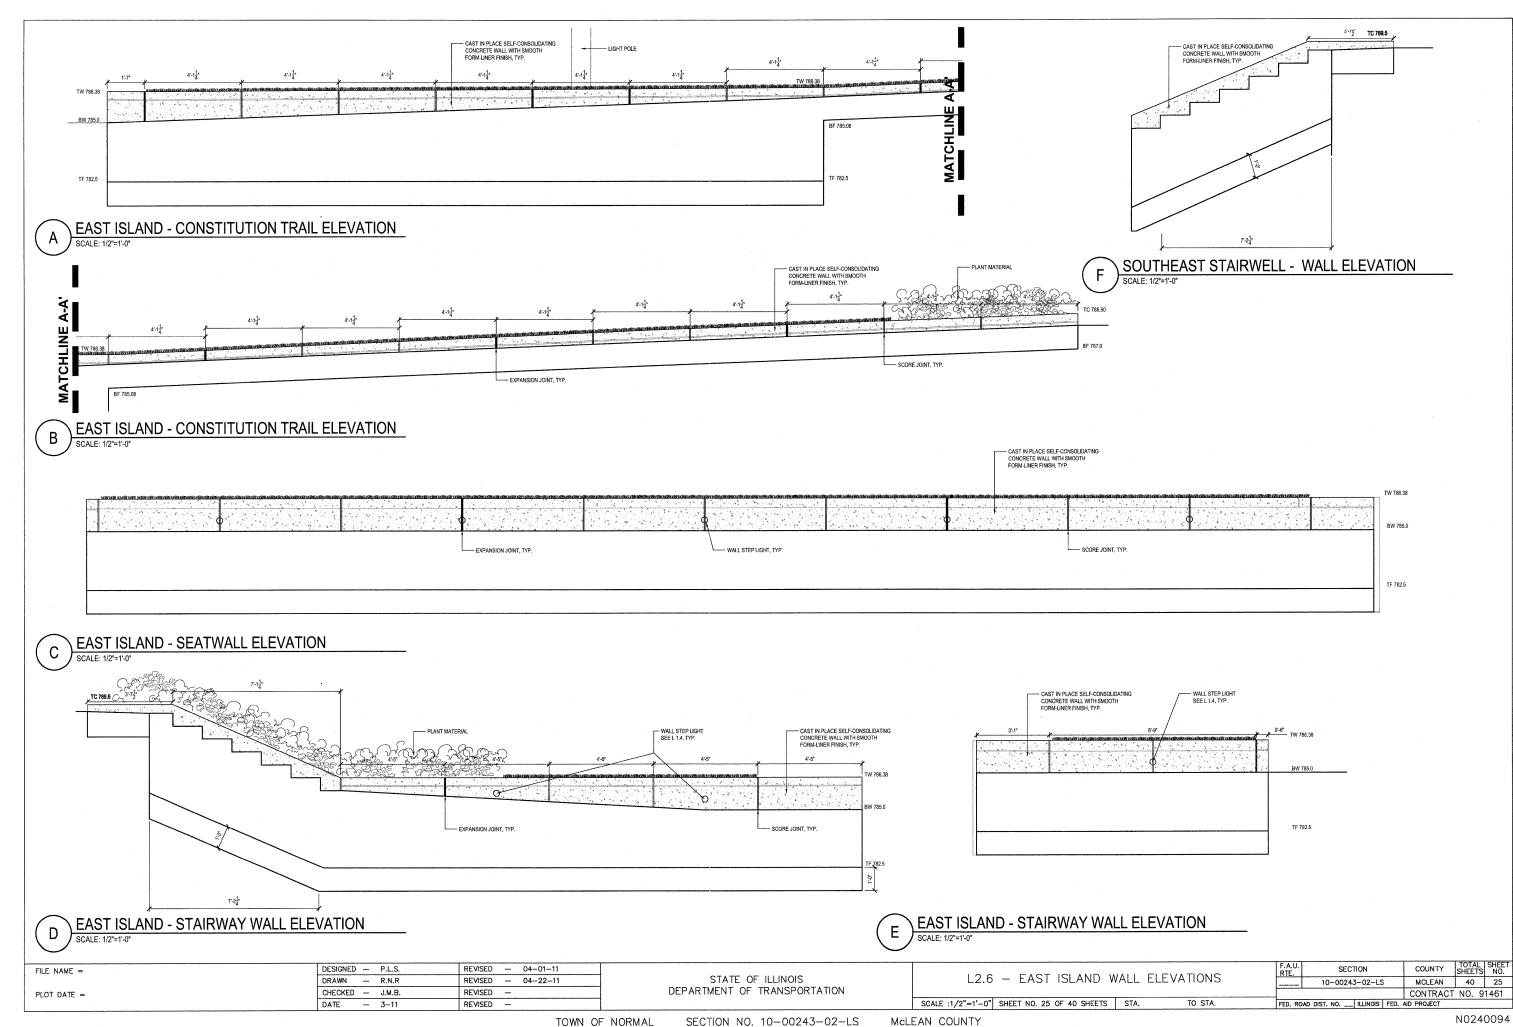


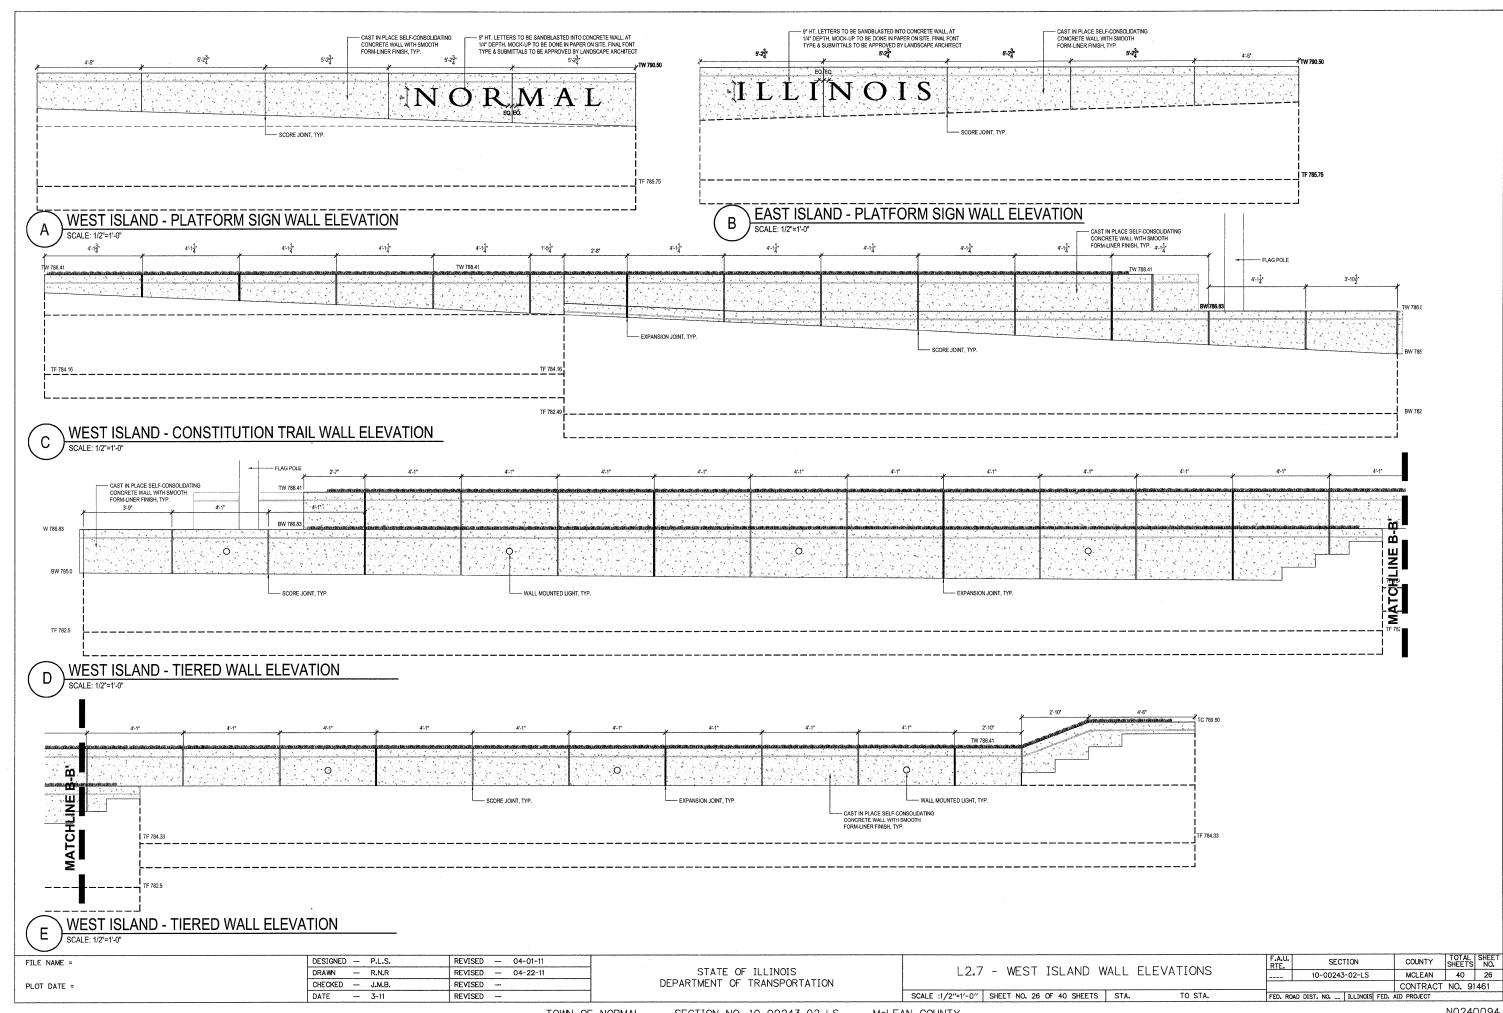


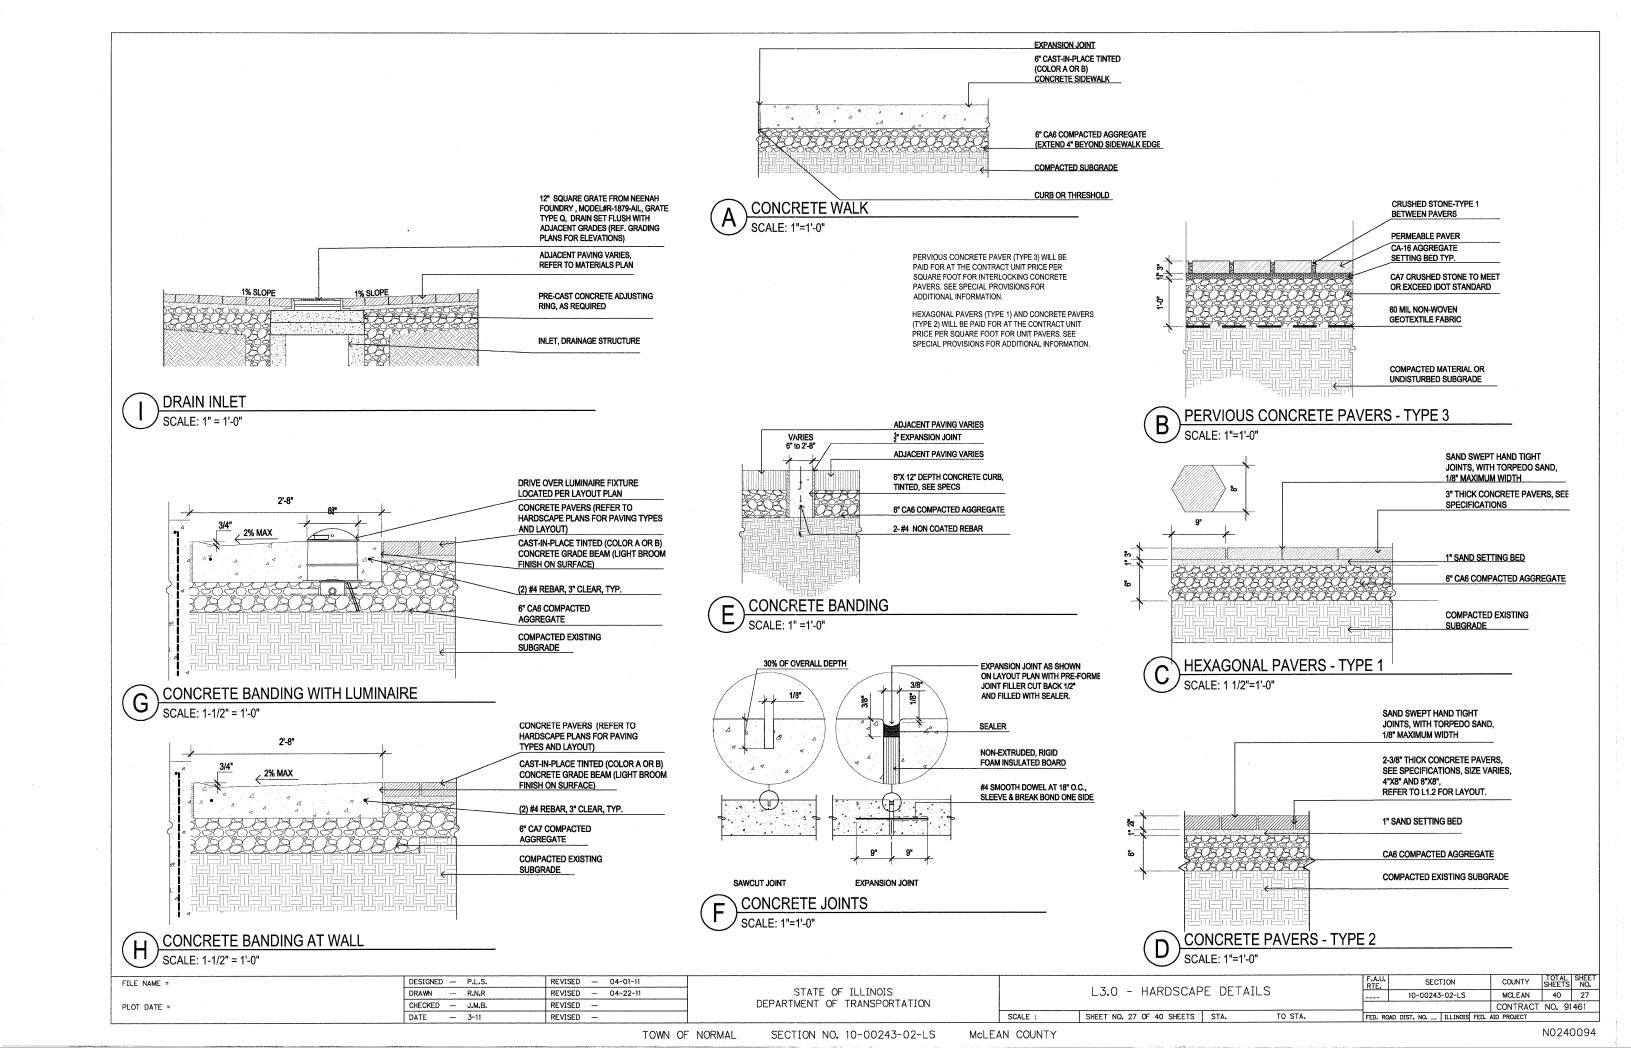


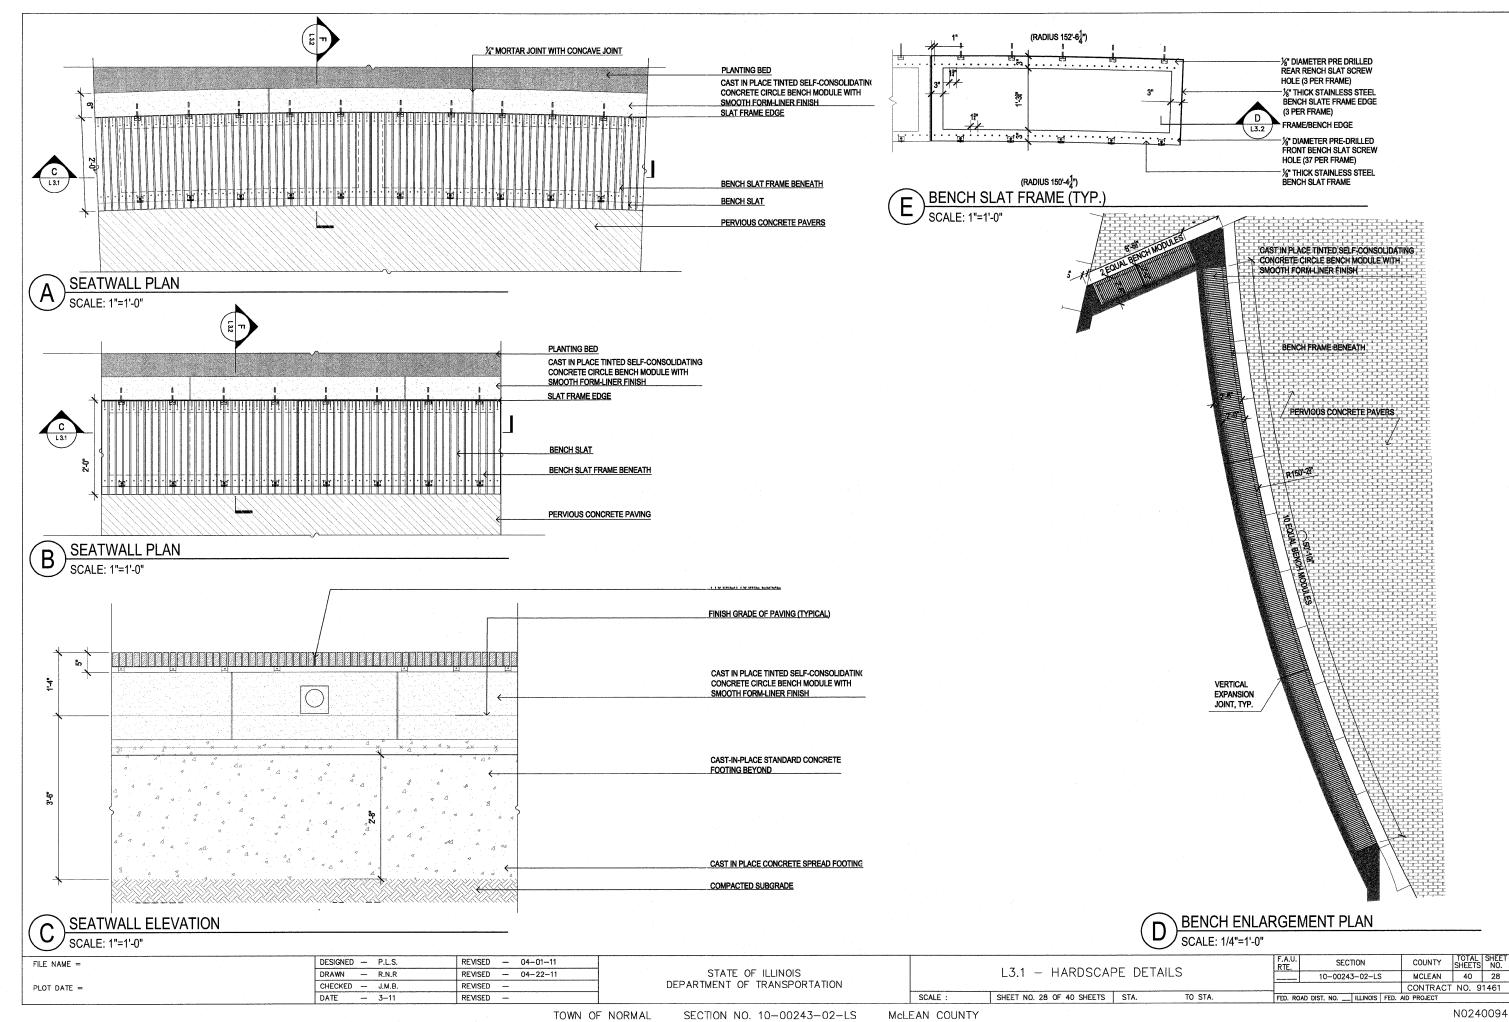


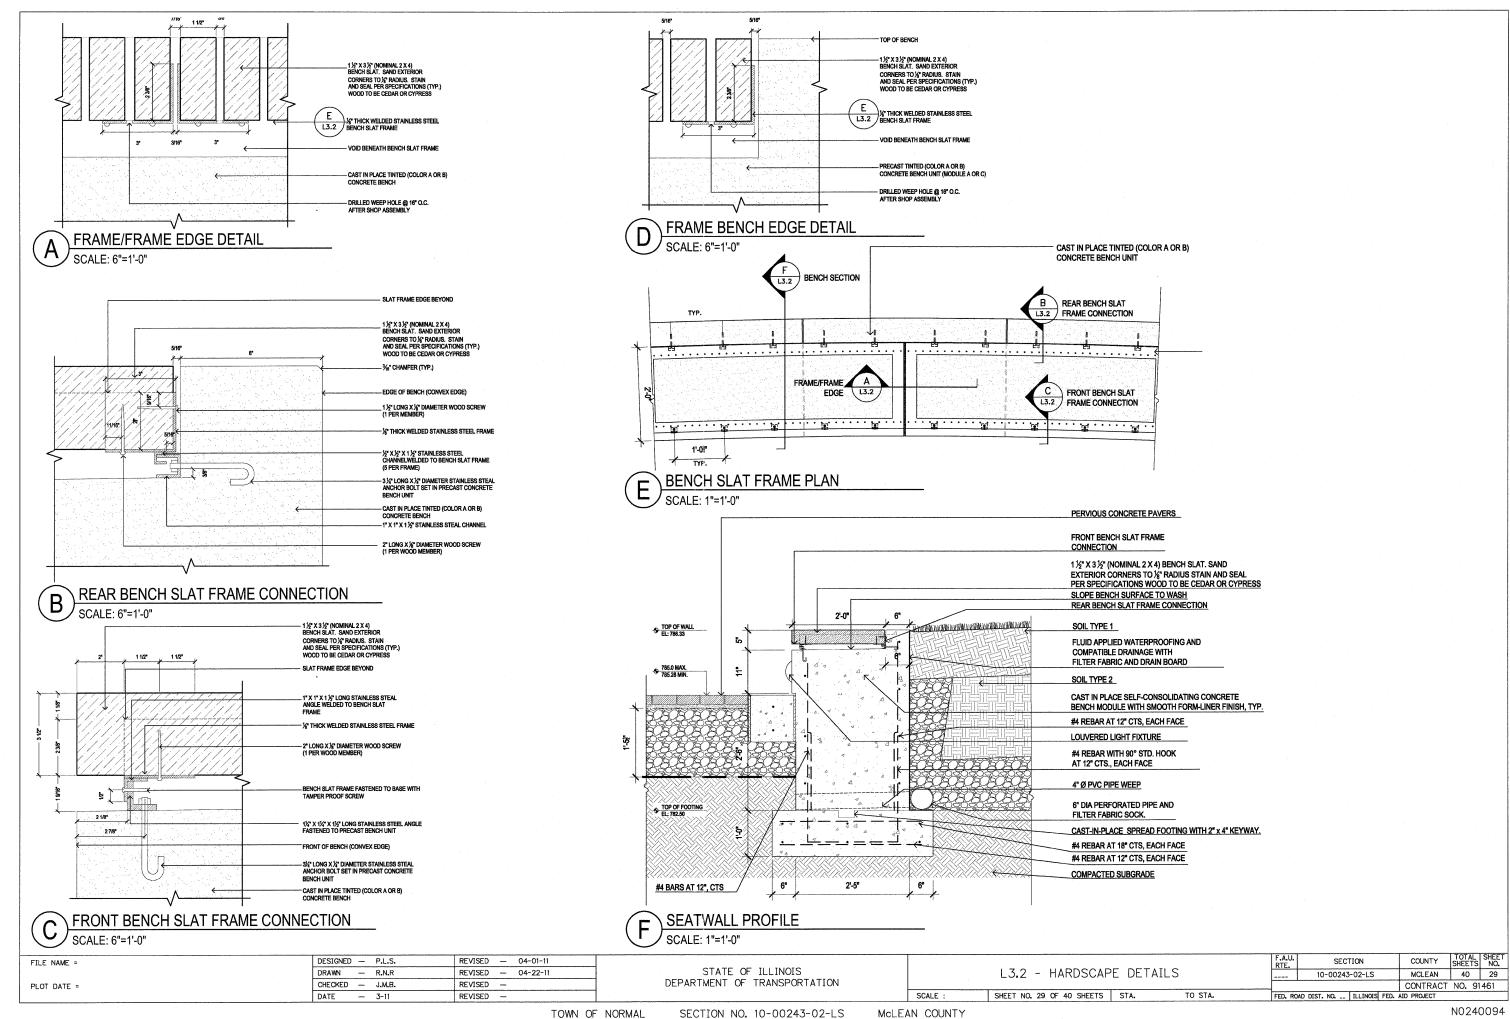


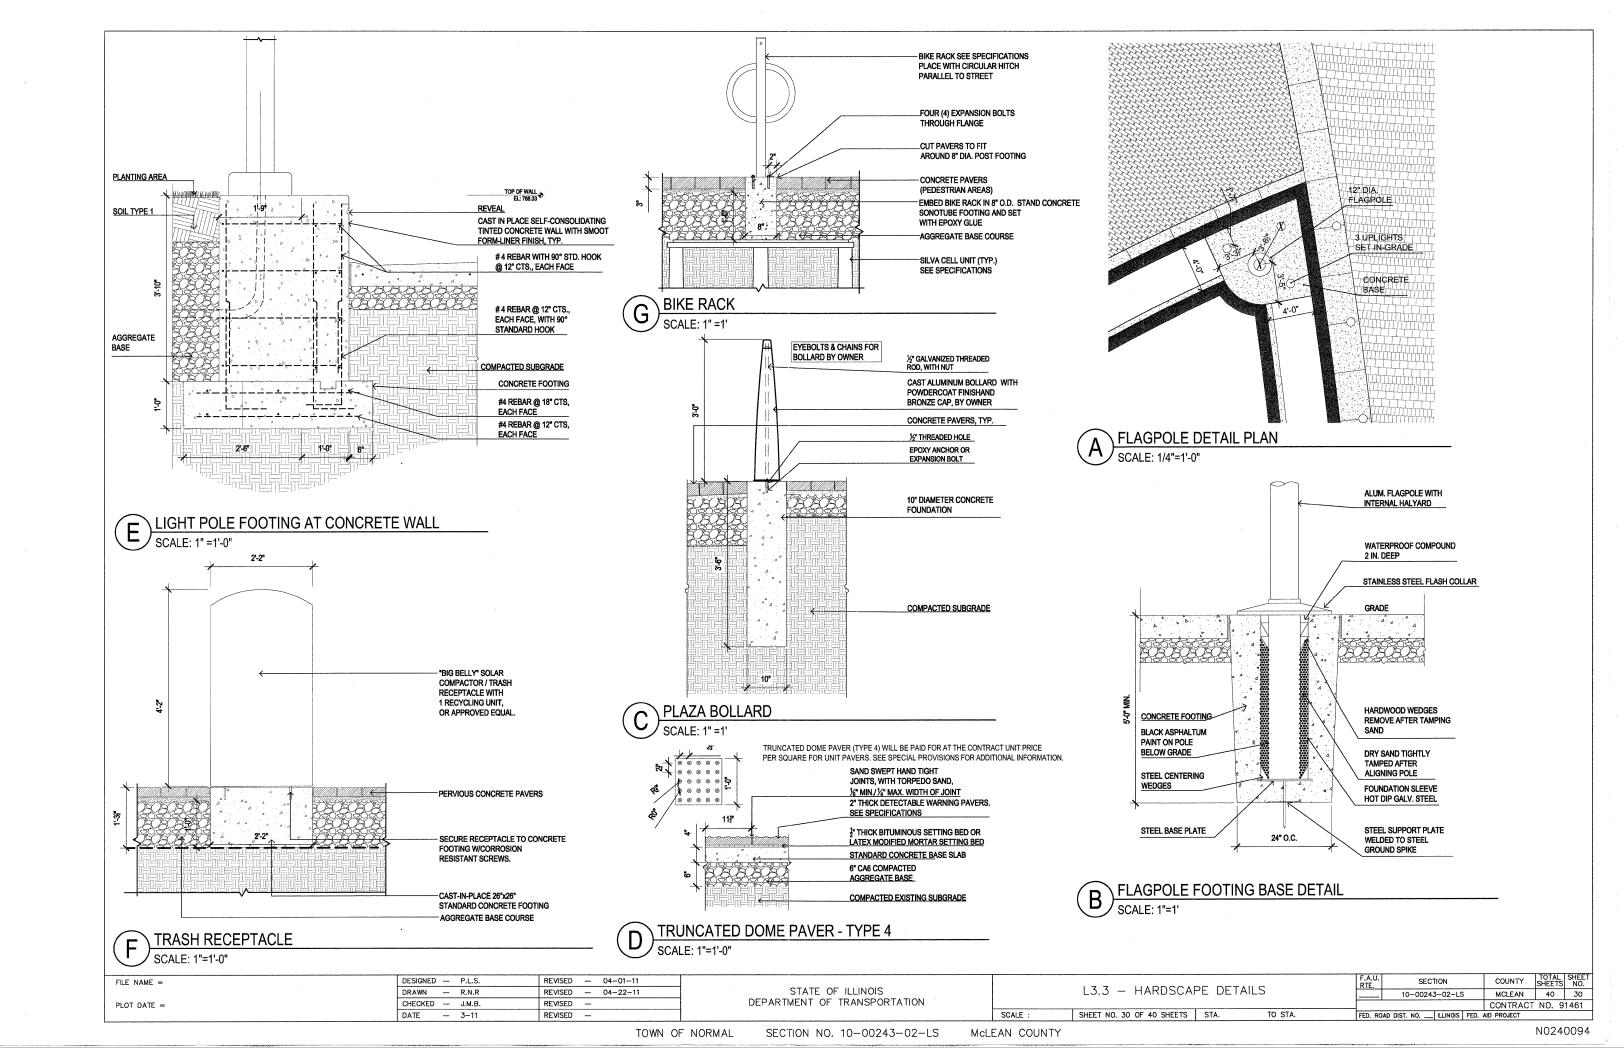


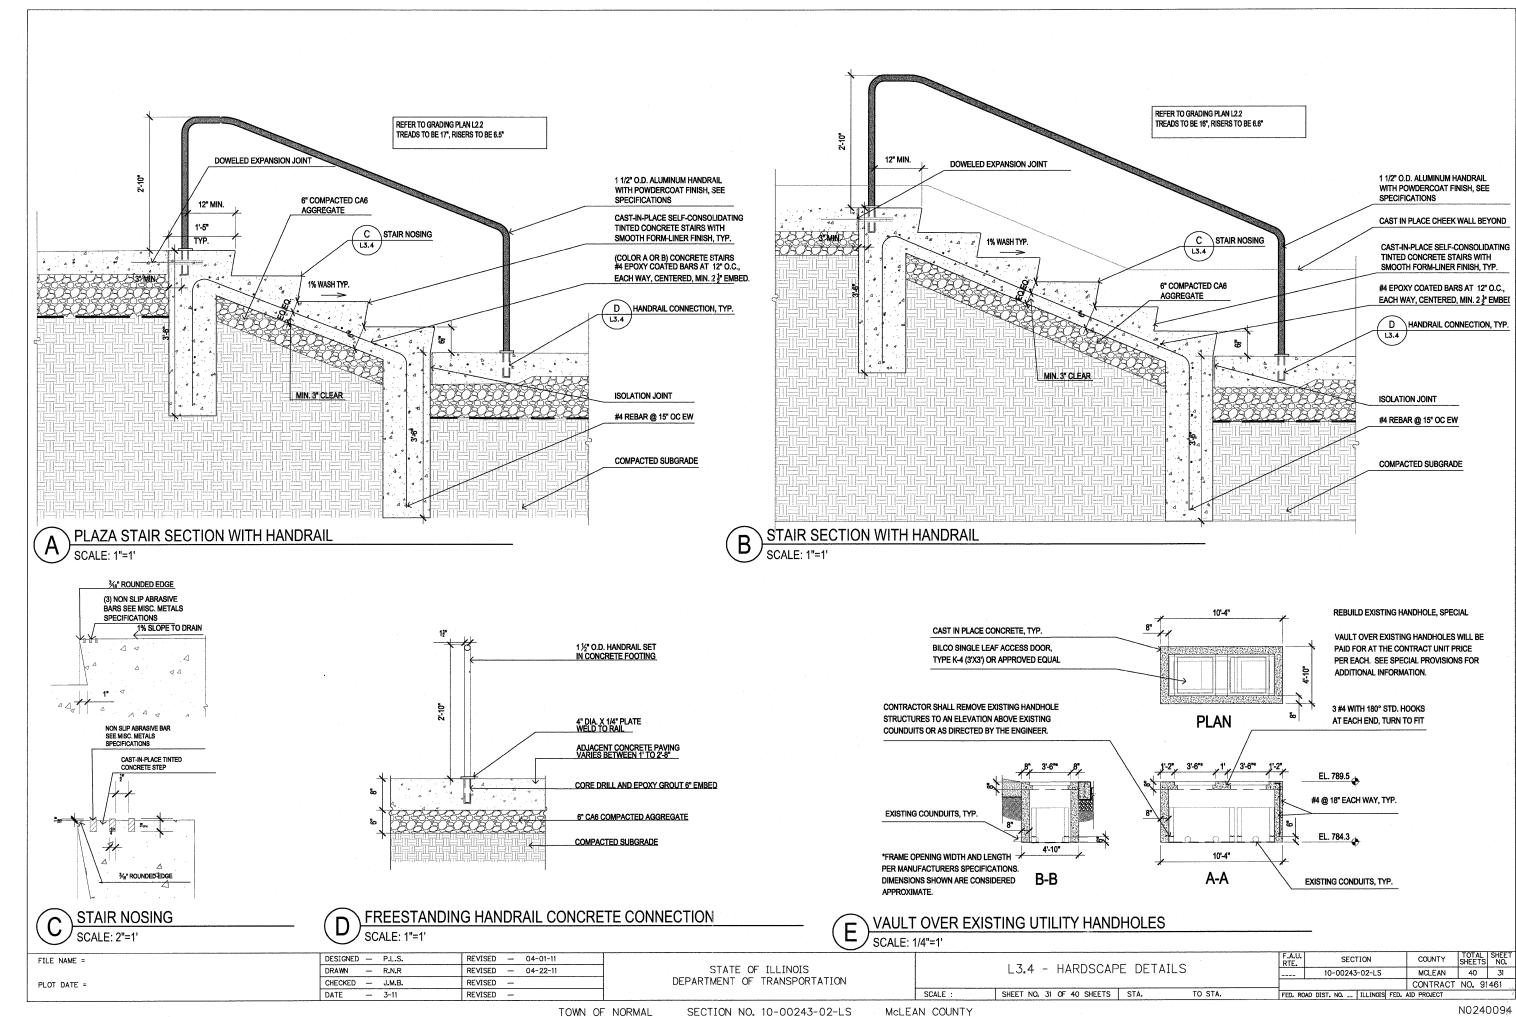

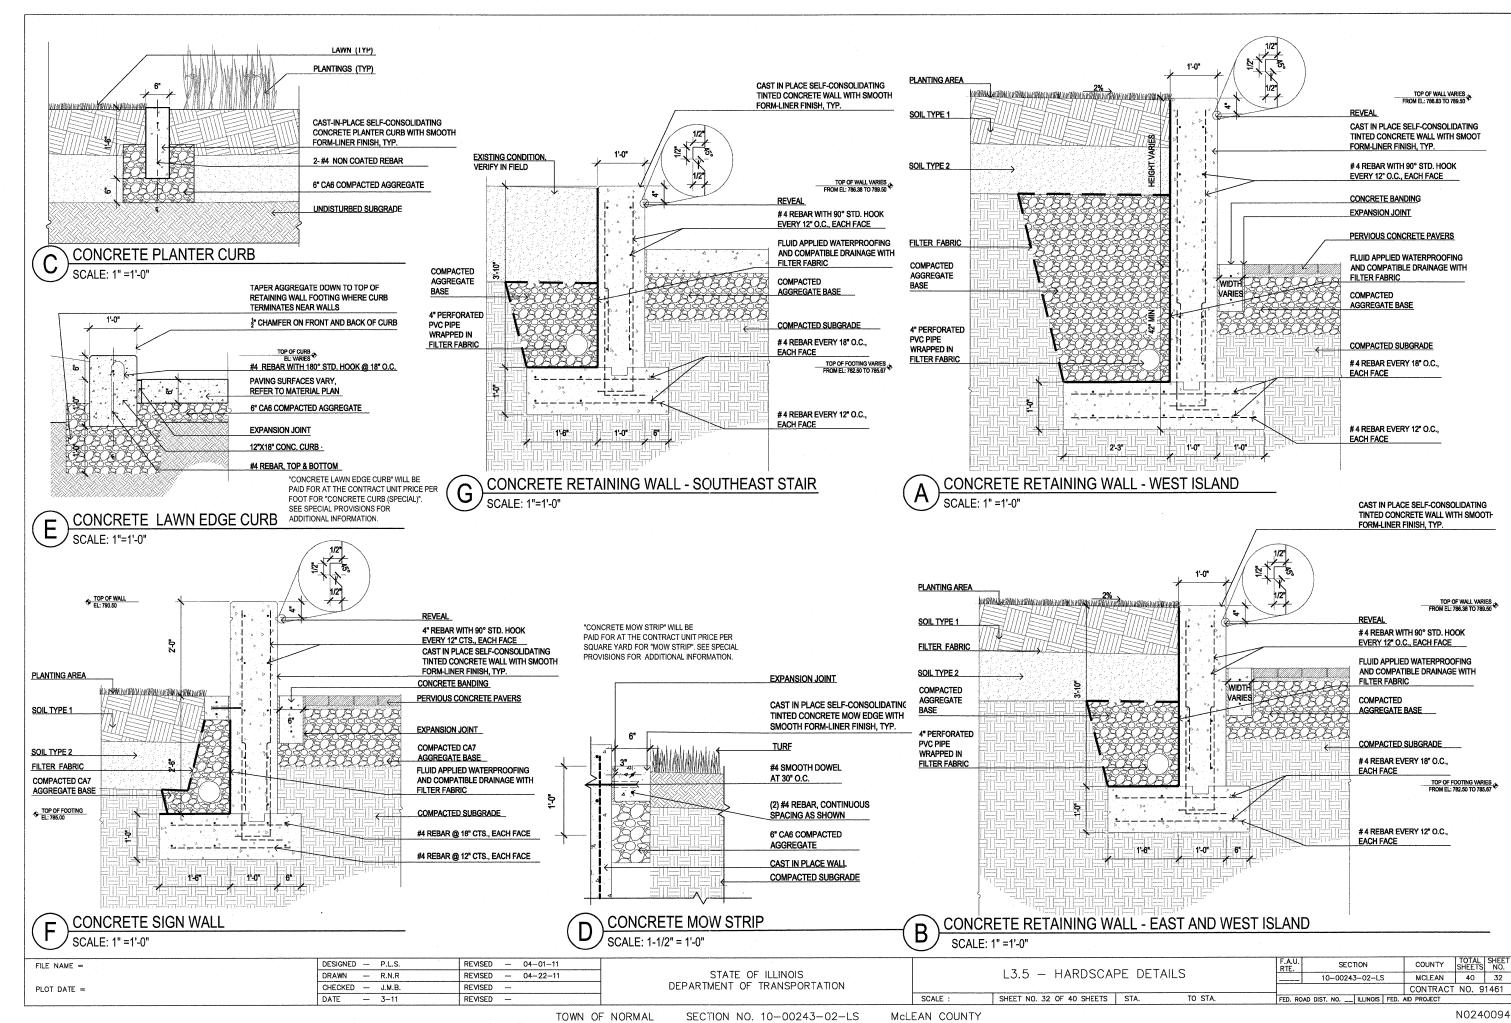


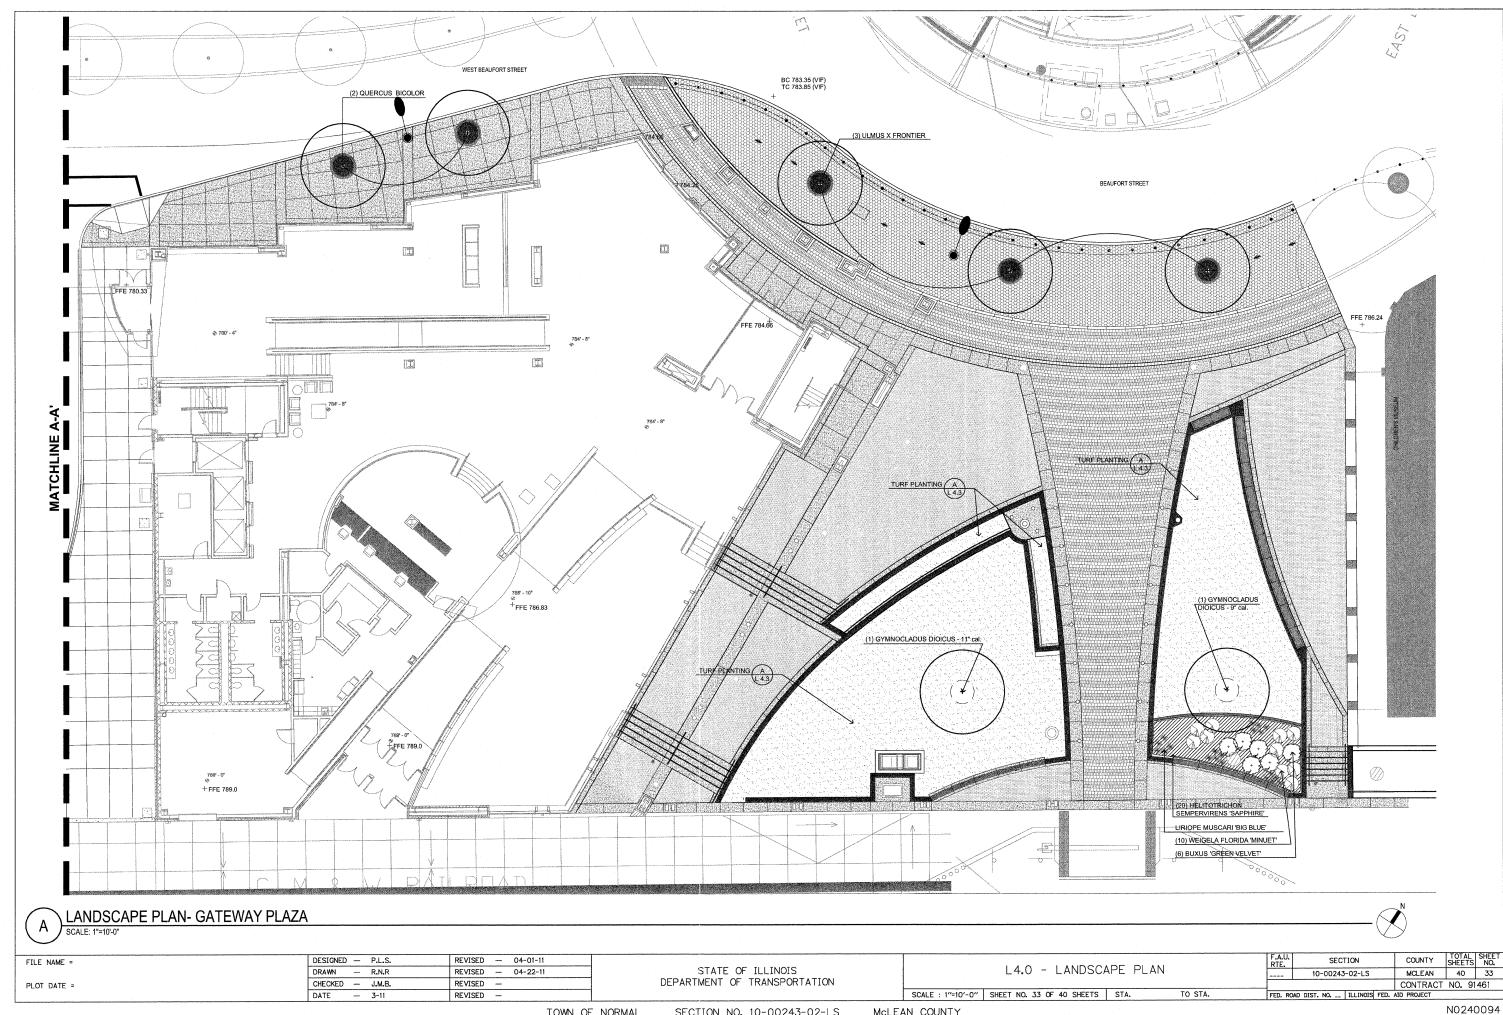

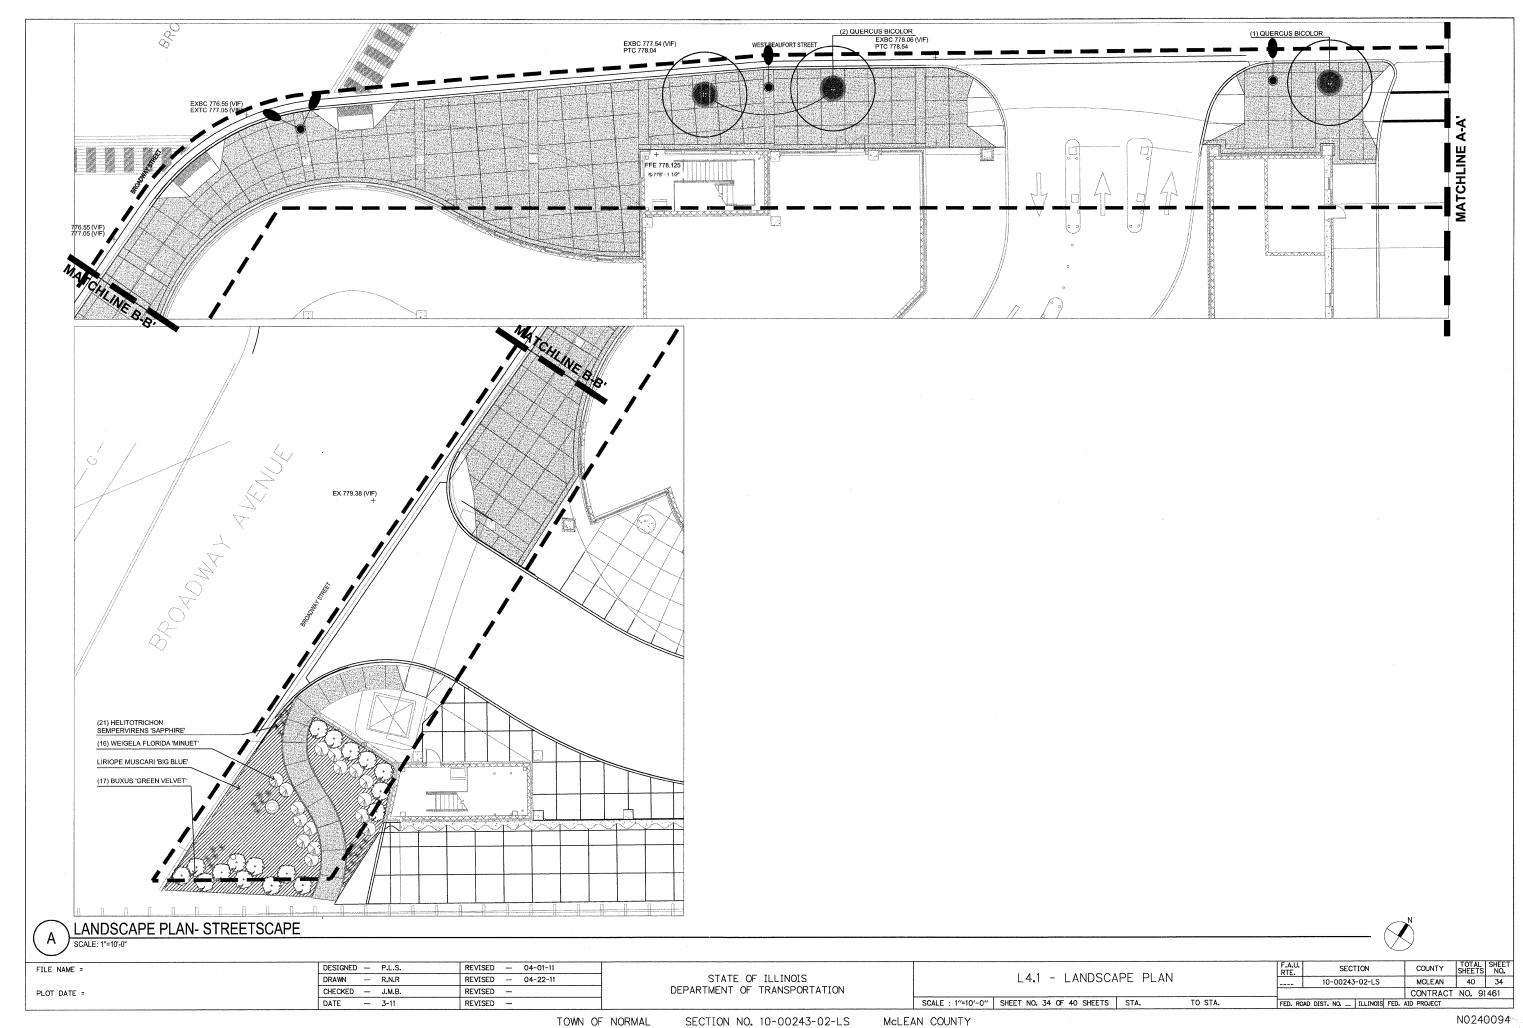

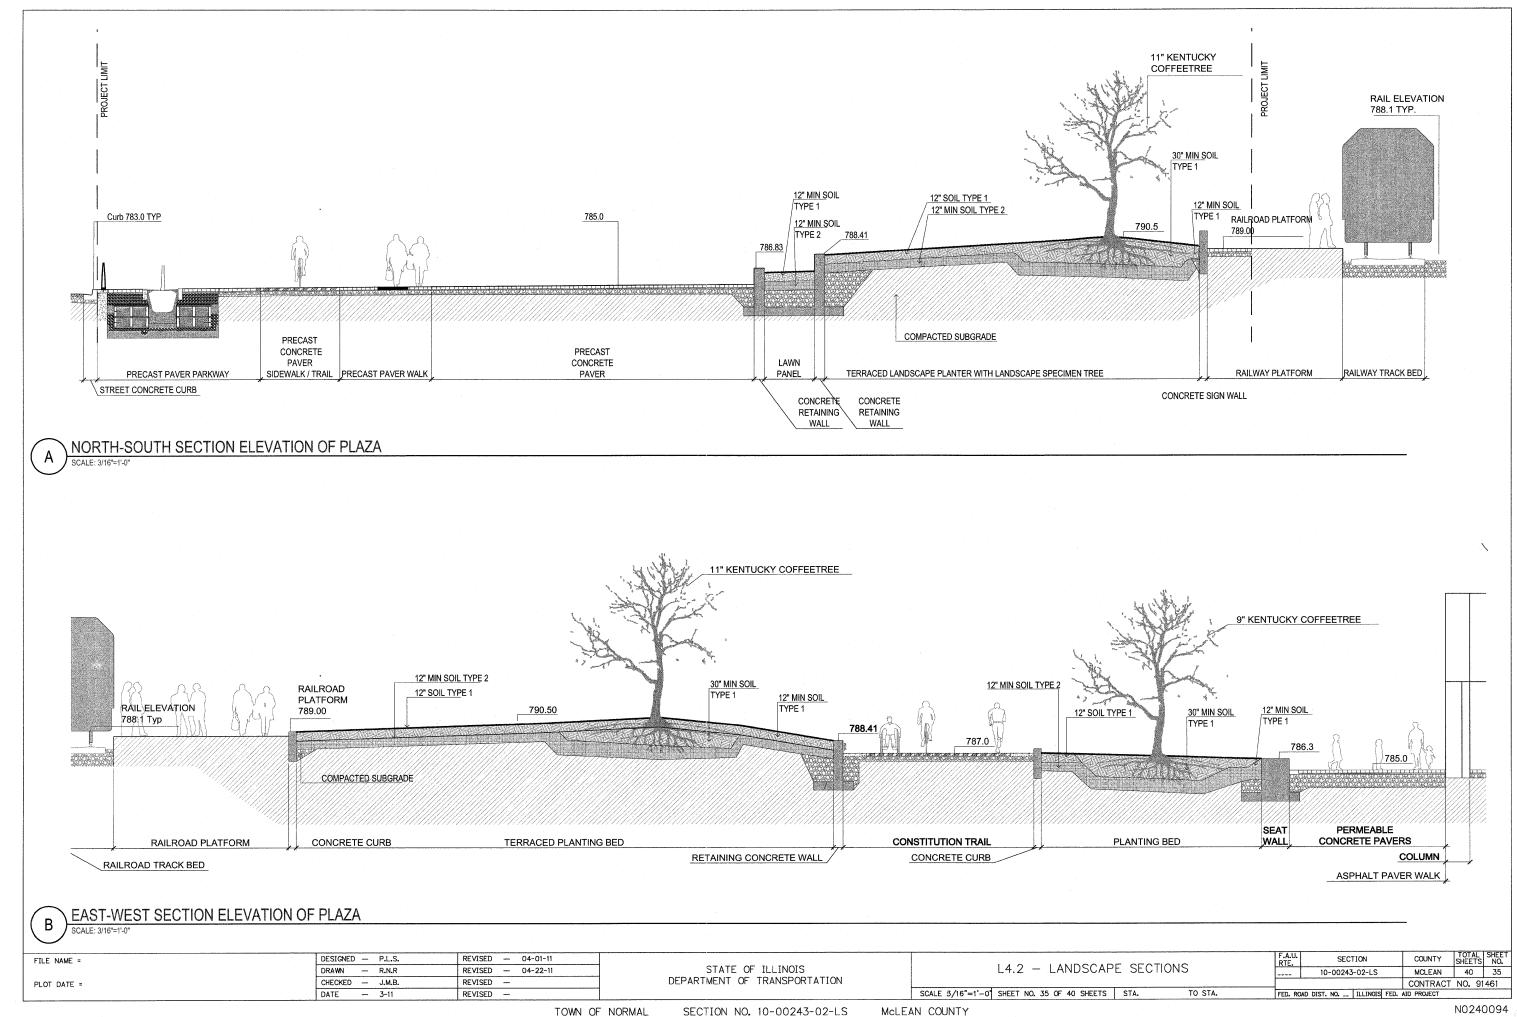

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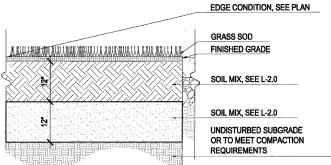
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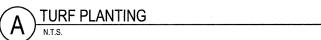
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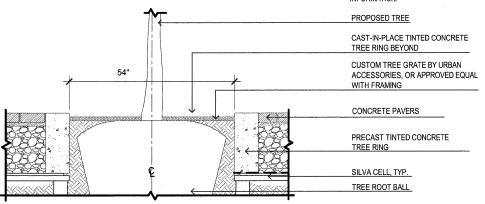
— 3-11

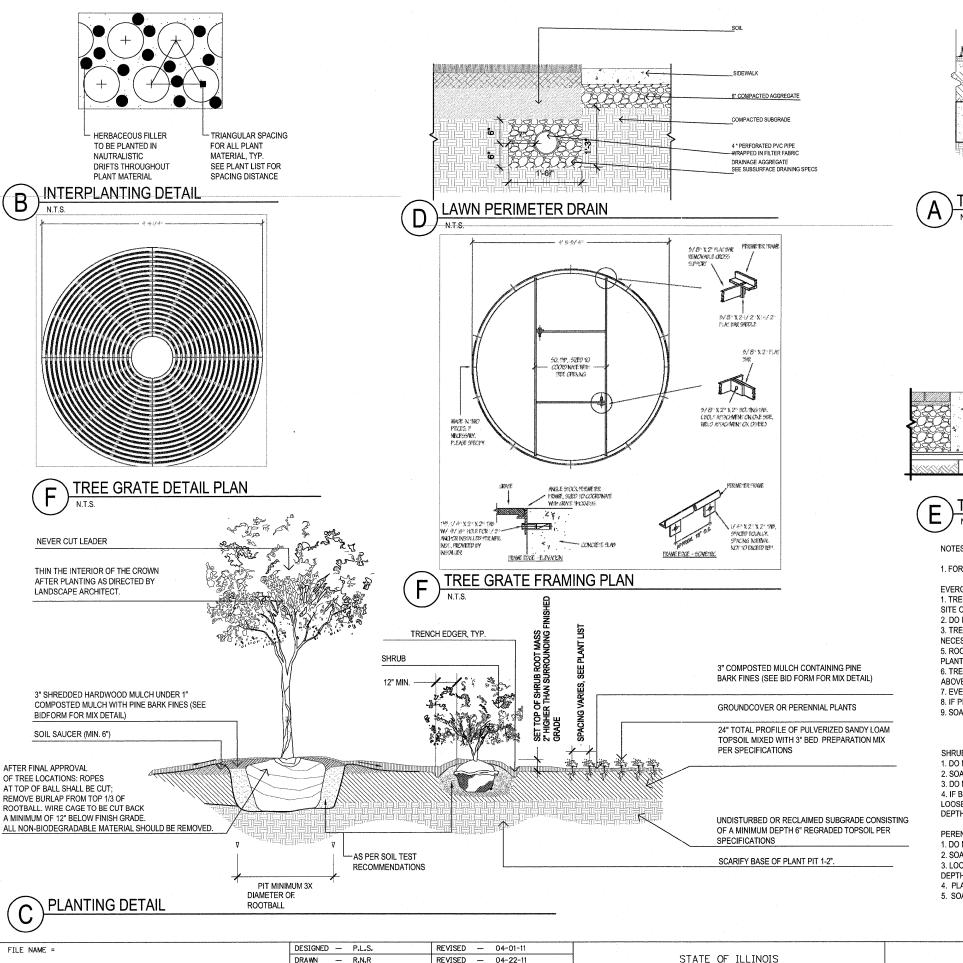PLOT DATE =





"CONCRETE TREE RING WITH GRATE" WILL BE PAID FOR AT THE CONTRACT UNIT PRICE PER EACH FOR "TREE GRATE ASSEMBLY, COMPLETE". SEE SPECIAL PROVISIONS FOR ADDITIONAL



TREE GRATE IN PRECAST TREE RING

NOTES:

1. FOR ALL SOIL PLACEMENT REFER TO SHEETS L2.0 & L2.1

EVERGREEN & DECIDUOUS TREES:

- 1. TREES SHALL BEAR SAME RELATION TO FINISHED GRADE AS THEY DID TO PREVIOUSLY EXISTING GRADE ON SITE OR IN NURSERY
- 2. DO NOT ALLOW AIR POCKETS TO FORM IN SOIL WHEN BACKFILLING.
 3. TREE STAKING/GUYING SHOULD BE REVIEWED WITH LANDSCAPE ARCHITECT WHEN CONTRACTOR DEEMS IT. NECESSARY
- 5. ROOT FLARE OF TREE TO BE SET NO MORE THAN 3" ABOVE FINISHED GRADE IN BORDERS & MASS PLANTINGS.
- 6. TREES PLANTED WITHIN OR ADJACENT TO PAVING SHALL BE PLANTED WITH ROOT FLARE NO MORE THAN 1' ABOVE ADJACENT GRADE.
- 7. EVERGREEN TREES WITH TIGHTLY SHEARED FORM WILL BE REJECTED.
- 8. IF PITS ARE MACHINE EXCAVATED, & GLAZING IS PRONOUNCED, ALL SIDES OF PIT ARE TO BE SCARIFIED.
- 9. SOAK PLANTS WITH WATER IMMEDIATELY AFTER INSTALLATION.

- 1. DO NOT ALLOW AIR POCKETS TO FORM IN SOIL WHILE BACKFILLING.
- 2. SOAK PLANTS WITH WATER IMMEDIATELY AFTER INSTALLATION.
- 3. DO NOT BREAK ROOTBALL.
- 4. IF B&B MATERIAL, REMOVE BURLAP & STRING FROM AROUND TOP 1/3 OF ROOTBALL. IF CONTAINERIZED, LOOSEN ROOT MASS SIGNIFICANTLY BY HAND OR CUT ROOT MASS VERTICALLY WITH KNIFE ON 4 SIDES TO A DEPTH OF 1" & CUT BOTTOM OF ROOT MASS IN SAME MANNER IN AN 'X' PATTERN.


PERENNIALS & GROUNDCOVER:

- 1. DO NOT ALLOW AIR POCKETS TO FORM IN SOIL WHILE BACKFILLING.
- 2. SOAK PLANTS IMMEDIATELY WITH WATER AFTER INSTALLATION.
- 3. LOOSEN ROOT MASS SIGNIFICANTLY BY HAND OR CUT ROOT MASS VERTICALLY WITH KNIFE ON 4 SIDES TO A DEPTH OF 1" & CUT BOTTOM OF ROOT MASS IN SAME MANNER IN AN 'X' PATTERN.
- 4. PLANT APPROXIMATELY 1" ABOVE PLANTING MEDIA TO ALLOW FOR TYPICAL DRESSING OF MULCH.
- 5. SOAK PLANTS WITH WATER IMMEDIATELY AFTER INSTALLATION.


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	L4.3 - LANDSCAPE DETAILS				10-00243-02-LS	MCLEAN	40	36		
					_		CONTRACT NO. 91461		461	
	SCALE :	SHEET NO. 36 OF 40 SHEETS	FED. RC	AD DIST. NO ILLINOIS FED.	AID PROJECT					

DEPARTMENT OF TRANSPORTATION

TOTAL TOURET

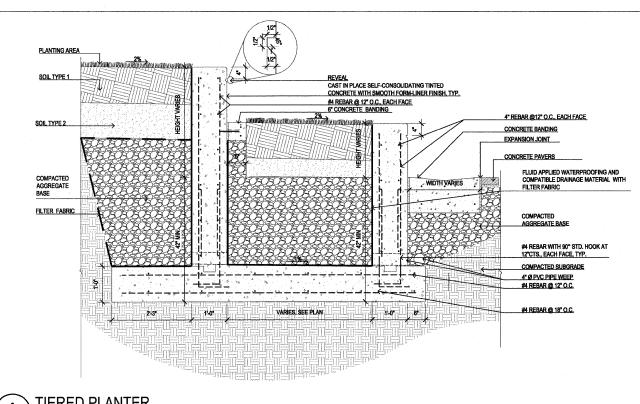

TIERED PLANTER
SCALE: 3/4"=1'

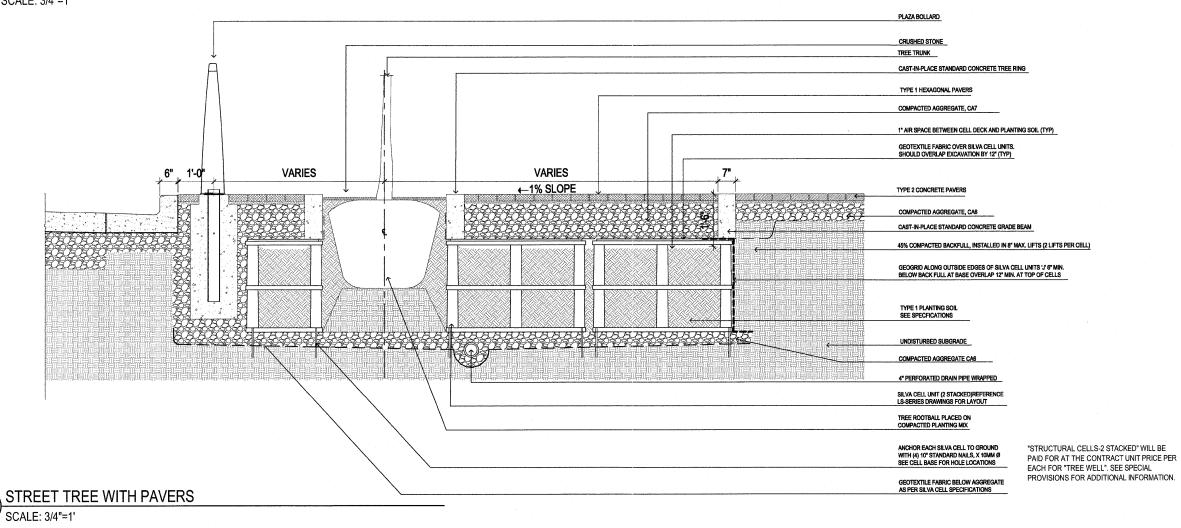

FILE NAME =

В

 DESIGNED
 — P.L.S.
 REVISED
 — 04-01-11

 DRAWN
 — R.N.R
 REVISED
 — 04-22-11


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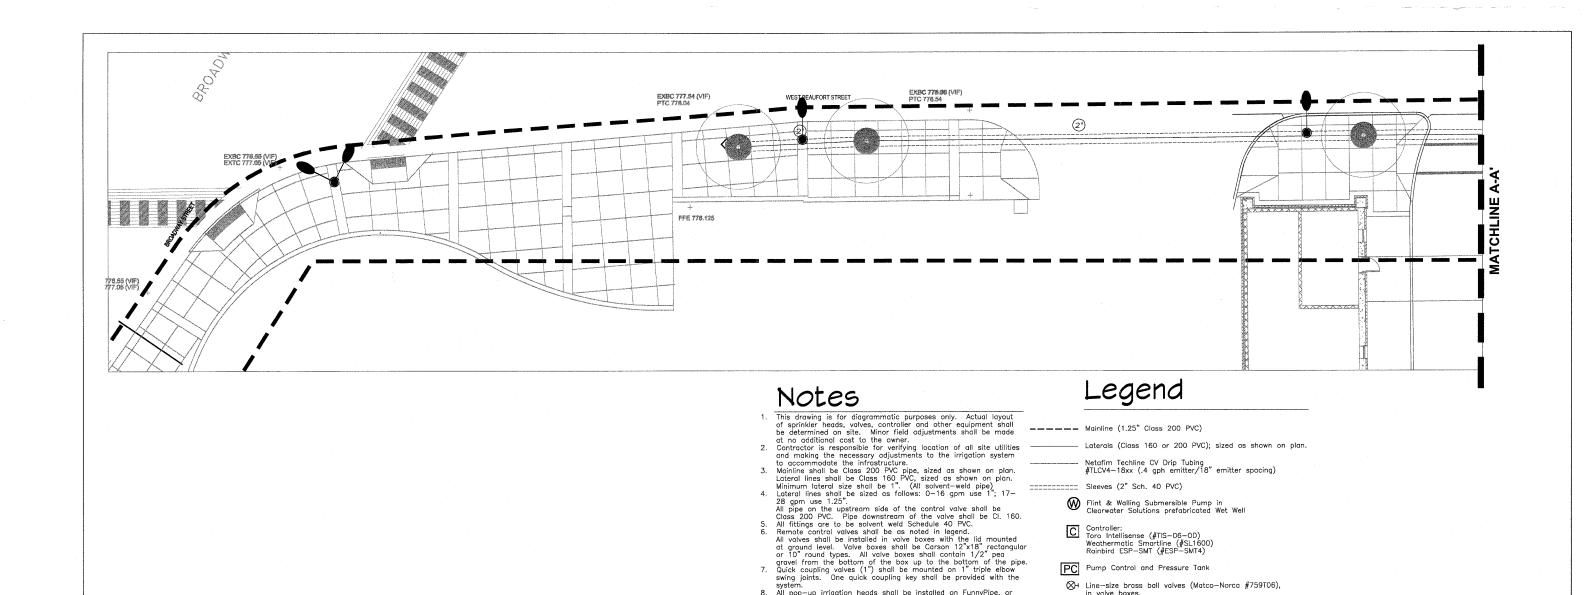
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 REVISED
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STATE OF ILLINOIS DEPARTMENT OF TRANSPORTATION L4.4 - LANDSCAPE DETAILS

SCALE :3/4"=1'-0" SHEET NO. 37 OF 40 SHEETS STA.

TO STA.



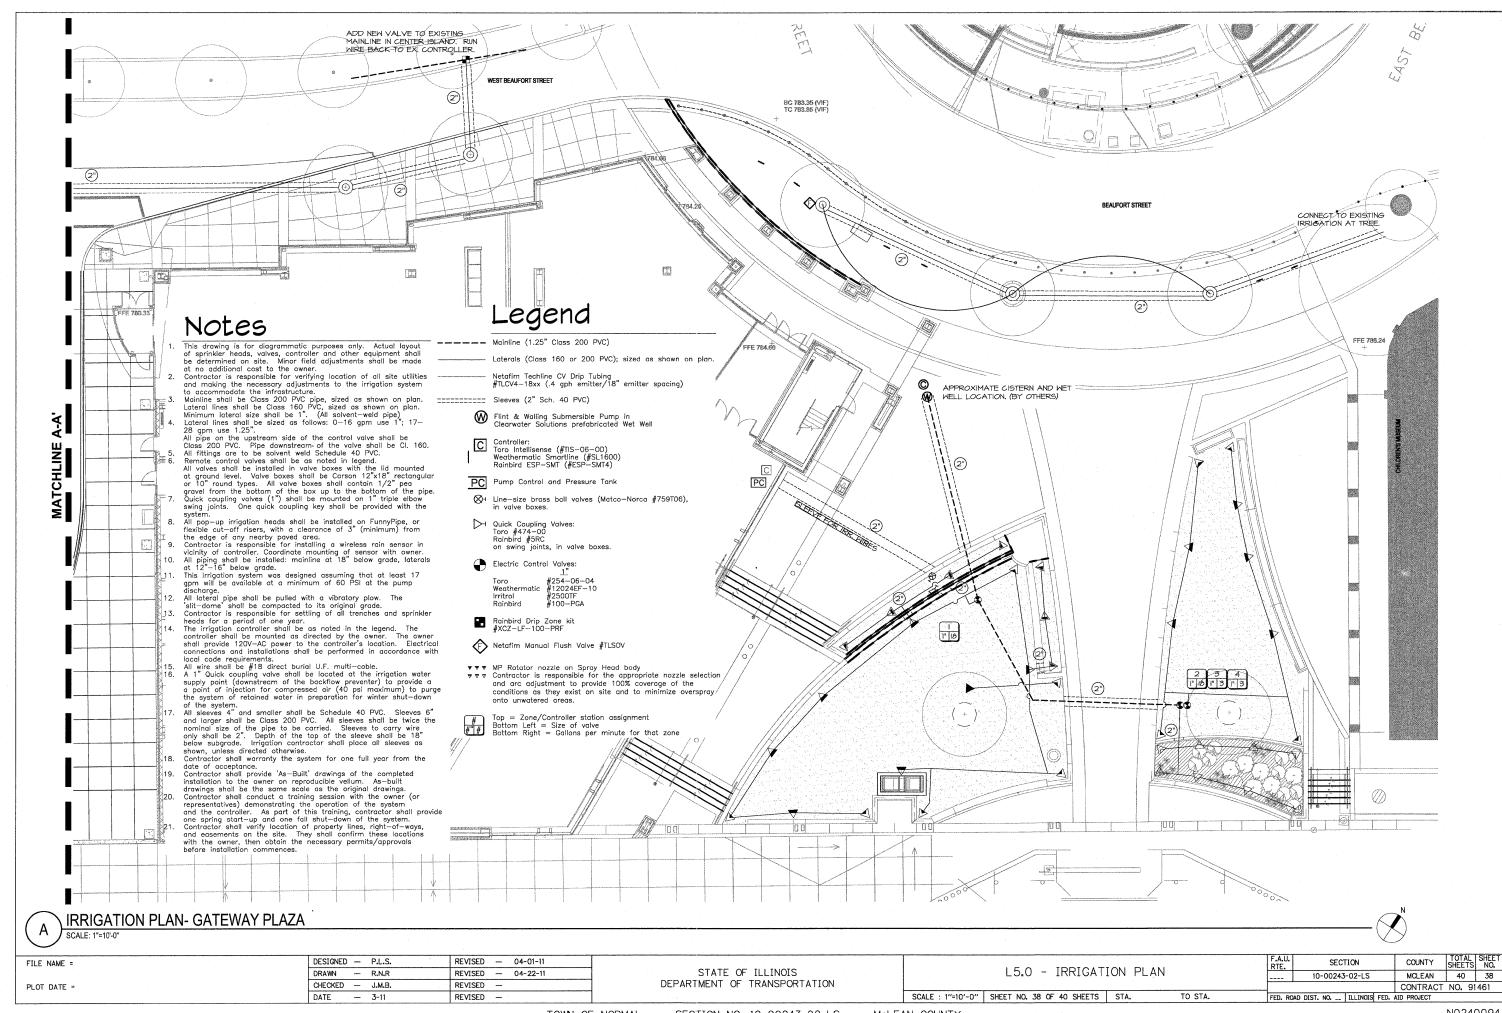

Ouick Coupling Valves:
Toro #474-00
Rainbird #5RC
on swing joints, in valve boxes.

Electric Control Valves: #254-06-04 #12024EF-10 #2500TF #100-PGA Weathermatic Irritrol Rainbird

Rainbird Drip Zone kit #XCZ-LF-100-PRF

Netafim Manual Flush Valve #TLSOV

▼▼▼ MP Rotator nozzle on Spray Head body
▼▼▼ Contractor is responsible for the appropriate nozzle selection
and are adjustment to provide 100% coverage of the
conditions as they exist on site and to minimize overspray onto unwatered areas.

Top = Zone/Controller station assignment Bottom Left = Size of valve Bottom Right = Gallons per minute for that zone

IRRIGATION PLAN- STREETSCAPE SCALE: 1"=10'-0"

FILE NAME =

PLOT DATE =

REVISED -- 04-01-11 DESIGNED - P.L.S. DRAWN - R.N.R REVISED - 04-22-11 REVISED -CHECKED - J.M.B. DATE -- 3-11 REVISED -

STATE OF ILLINOIS DEPARTMENT OF TRANSPORTATION

before installation commences.

system.

8. All pop—up irrigation heads shall be installed on FunnyPipe, or flexible cut—off risers, with a clearance of 3" (minimum) from the edge of any nearby paved area.

9. Contractor is responsible for installing a wireless rain sensor in vicinity of controller. Coordinate mounting of sensor with owner.

10. All piping shall be installed: mainline at 18" below grade, laterals at 12"—16" below grade.

11. This irrigation system was designed assuming that at least 17 gpm will be available at a minimum of 60 PSI at the pump discharge.

gpm will be available at a minimum of or Foll at the pump discharge.

12. All lateral pipe shall be pulled with a vibratory plow. The 'slit-dome' shall be compacted to its original grade.

13. Contractor is responsible for settling of all trenches and sprinkler heads for a period of one year.

14. The irrigation controller shall be as noted in the legend. The controller shall be mounted as directed by the owner. The owner shall provide 120V-AC power to the controller's location. Electrical connections and installations shall be performed in accordance with local code requirements.

connections and installations shall be performed in accordance with local code requirements.

15. All wire shall be #18 direct burial U.F. multi-cable.

16. A 1" Quick coupling valve shall be located at the irrigation water supply point (downstream of the backflow preventer) to provide a a point of injection for compressed air (40 psi maximum) to purge the system of retained water in preparation for winter shut-down of the system.

a point of injection for compressed air (40 psi maximum) to jurge the system of retained water in preparation for winter shut-down of the system.

17. All sleeves 4" and smaller shall be Schedule 40 PVC. Sleeves 6" and larger shall be Class 200 PVC. All sleeves shall be twice the nominal size of the pipe to be carried. Sleeves to carry wire only shall be 2". Depth of the top of the sleeve shall be 18" below subgrade. Irrigation contractor shall place all sleeves as shown, unless directed otherwise.

18. Contractor shall warranty the system for one full year from the date of acceptance.

19. Contractor shall provide 'As-Built' drawings of the completed installation to the owner on reproducible vellum. As-built drawings shall be the same scale as the original drawings.

20. Contractor shall conduct a training session with the owner (or representatives) demonstrating the operation of the system and the controller. As part of this training, contractor shall provide one spring start—up and one fall shut—down of the system.

21. Contractor shall verify location of property lines, right—of-ways, and easements on the site. They shall confirm these locations with the owner, then obtain the necessary permits/approvals before installation commences.

L5.1 - IRRIGATION PLAN

TO STA.

SCALE : 1"=10'-0" SHEET NO. 39 OF 40 SHEETS STA.


COUNTY SHEETS NO.

MCLEAN 40 39 SECTION 10-00243-02-LS CONTRACT NO. 91461 FED. ROAD DIST. NO. .. ILLINOIS FED. AID PROJECT

TOWN OF NORMAL

SECTION NO. 10-00243-02-LS

McLEAN COUNTY

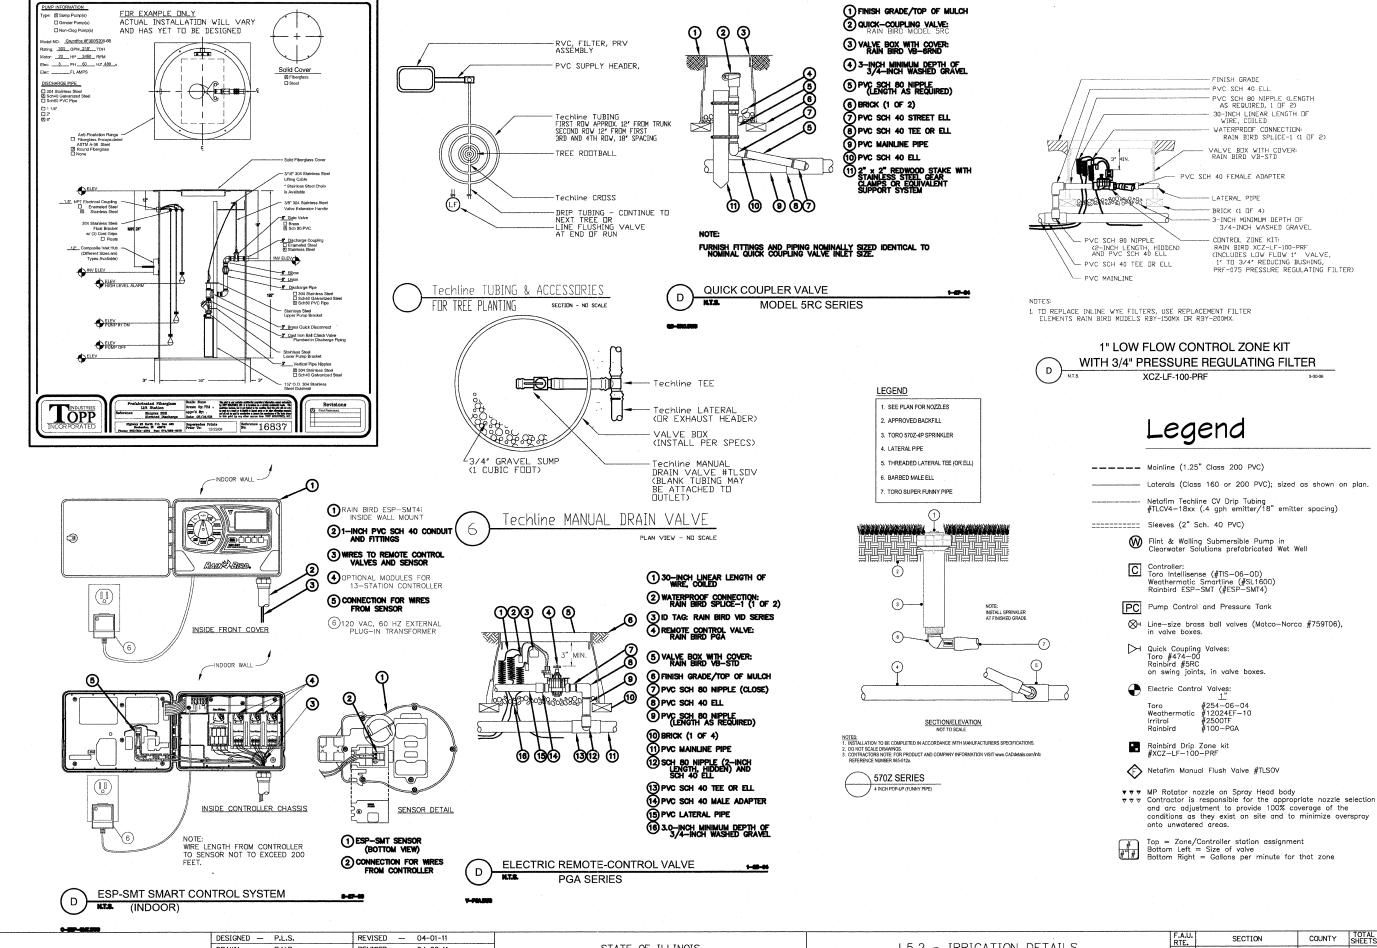

FILE NAME =
PLOT DATE =

 DESIGNED
 P.L.S.
 REVISED
 — 04-01-11

 DRAWN
 — R.N.R
 REVISED
 — 04-22-11

 CHECKED
 — J.M.B.
 REVISED
 —

 DATE
 — 3-11
 REVISED
 —

STATE OF ILLINOIS
DEPARTMENT OF TRANSPORTATION

L5.2 - IRRIGATION DETAILS

TO STA.

SCALE : VARIES SHEET NO. 40 OF 40 SHEETS STA.