# STATE OF ILLINOIS DEPARTMENT OF TRANSPORTATION DIVISION OF HIGHWAYS

# PLANS FOR PROPOSED FEDERAL AID HIGHWAY

FAU 1374 (BELMONT AVENUE)
77TH COURT TO 76TH COURT
STREETSCAPE
SECTION No. 10-00112-00-LS
PROJECT No. TE - 00D1(838)
VII.LAGE OF ELMWOOD PARK
COOK COUNTY
JOB NO. C-91-115-11

# DISTRICT ONE DETAILS

INDEX OF SHEETS

**GENERAL NOTES, IDOT STANDARDS AND SUMMARY OF QUANTITIES** 

SHEET NO.

12-14

15-17

19-23

PAVEMENT PATCHING OR HMA SURFACED PAVEMENT BD22

TYPICAL PAVEMENT MARKINGS TC13

TRAFFIC CONTROL & PROTECTION FOR SIDEROADS, INTERSECTIONS AND DRIVEWAY

TRAFFIC DATA (BELMONT AVENUE)
DESIGN DESIGNATION: MINOR ARTERIAL (URBAN)
ADT = 21,700 VPD (2009)

POSTED SPEED LIMIT = 35 MPH

TRAFFIC DATA (77TH COURT)
DESIGN DESIGNATION: MINOR ARTERIAL (URBAN)

ADT = <5000 VPD

DESCRIPTION

TYPICAL SECTIONS

CONSTRUCTION DETAILS

LIGHTING GENERAL NOTES

LIGHTING PLAN

LIGHTING DETAILS

DISTRICT ONE DETAILS

77TH COURT CROSS SECTIONS

**BELMONT AVENUE CROSS SECTIONS** 

ALIGNMENTS, TIES & BENCHMARKS


EXISTING CONDITIONS & REMOVAL PLAN

77TH COURT PROPOSED PLAN & PROFILE

BELMONT AVENUE PROPOSED PLAN & PROFILE

TITLE SHEET

POSTED SPEED LIMIT = 25 MPH

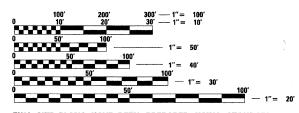

FULL SIZE PLANS HAVE BEEN PREPARED USING STANDARD ENGINEERING SCALES. REDUCED SIZED PLANS WILL NOT CONFORM TO STANDARD SCALES. IN MAKING MEASUREMENTS ON REDUCED PLANS, THE ABOVE SCALES MAY BE USED.

J.U.L.I.E.

JOINT UTILITY LOCATION INFORMATION FOR EXCAVATION 1-800-892-0123

**CONTRACT NO. 63608** 





N.T.S.

GROSS LENGTH OF PROJECT = 850 LF (0.16 MI)

NET LENGTH OF PROJECT = 850 LF (0.16 MI)



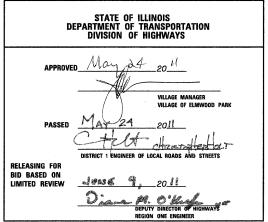

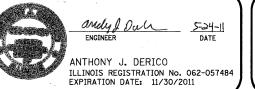

**PROJECT ENDS** 

STA. 17 + 70.63





CHRIS 9575 W

CHRISTOPHER B. BURKE ENGINEERING LTD.

9575 West Higgins Road, Suite 600 Rosemont, Illinois 60018 (847

(847) 823-0500

#### GENERAL NOTES

- ANY EXISTING OR PROPOSED STORM SEWER DAMAGED BY THE CONTRACTOR DURING CONSTRUCTION SHALL BE REPLACED BY THE CONTRACTOR AT NO ADDITIONAL COST.
- ALL DOMESTIC METER VAULTS AND DOMESTIC WATER SERVICE BOXES SHALL BE ADJUSTED TO THE PROPOSED GRADE AS DIRECTED BY THE ENGINNER. THIS WORK SHALL BE PAID FOR AS DOMESTIC WATER SERVICE BOXES TO BE ADJUSTED.
- 3. EXPOSED SUBGRADE MUST BE COVERED WITHIN 24 HOURS OF EXCAVATION, UNSTABLE SUBGRADE AREAS, AS DETERMINED BY THE ENGINEER, RESULTING FROM THE CONTRACTOR'S FAILURE TO COVER THE SUBGRADE SHALL BE EXCAVATED AND BACKFILLED WITH POROUS GRANULAR EMBANKMENT, SUBGRADE AT NO ADDITIONAL COST.
- 4. THE CONTRACTOR SHALL BE RESPONSIBLE FOR CONTACTING THE OWNERS OF ALL EXISTING UTILITY FACILITIES SO THAT THE UTILITIES AND THEIR APPURTENANCES MAY BE LOCATED AND/OR ADJUSTED, IF NECESSARY, PRIOR TO THE START OF CONSTRUCTION OPERATIONS.
- THE LOCATIONS OF EXISTING DRAINAGE STRUCTURES, STORM AND SANITARY SEWERS, WATER SERVICE LINES AND OTHER UTILITY LINES ARE APPROXIMATE, AND THE VERTICAL LOCATIONS ARE TO BE DETERMINED IN THE FIELD BY THE CONTRACTOR AT HIS OWN EXPENSE.
- 6. THE CONTRACTOR SHALL BE RESPONSIBLE FOR THE PROTECTION OF ALL UNDERGROUND OR SURFACE UTILITIES EVEN THOUGH THEY MAY NOT BE SHOWN ON THE PLANS, ANY UTILITY THAT IS DAWAGED BY THE CONTRACTOR DURING CONSTRUCTION SHALL BE REPAIRED TO THE SATISFACTION OF THE ENGINEER, OR REPLACED. SUCH WORK WILL BE AT THE CONTRACTOR'S EXPENSE.
- 7. WHEN IT IS NECESSARY TO SHUT OFF A WATER MAIN, THE CONTRACTOR SHALL PROVIDE THE VILLAGE OF ELMWOOD PARK (TEL. 708-452-7300) A MINIMUM 48 HOUR ADVANCE NOTICE, AND THE CONTRACTOR WILL BE RESPONSIBLE FOR NOTIFYING ALL AFFECTED RESIDENTS AND BUSINESSES, THE VILLAGE OF ELMWOOD PARK WILL PROVIDE THE NECESSARY FORMS AND DETERMINE THE LIMITS OF AFFECTED AREAS.
- 8. THE CONTRACTOR SHALL NOT OPEN OR SHUT ANY WATER VALVES OR FIRE HYDRANTS. IF WATER IS NEEDED DURING CONSTRUCTION ACTIVITIES THE CONTRACTOR MUST CONTACT THE ELMWOOD PARK WATER DEPARTMENT AT (708) 452-3945.
- 9. BEFORE STARTING ANY EXCAVATION, THE CONTRACTOR SHALL CALL "J.U.L.I.E." AT 800-892-0123 FOR FIELD LOCATIONS OF BURIED ELECTRIC, TELEPHONE, CABLE AND GAS FACILITIES, THE VILLAGE OF ELMWOOD PARK PUBLIC WORKS DEPT. AT (708) 452-3945 FOR FIELD LOCATIONS OF BURIED WATER, SANITARY AND STORM FACILITIES (48-HOUR ADVANCE NOTIFICATION IS REQUIRED) AND MEADE ELECTRIC FOR FIELD LOCATIONS OF THE STATE'S ELECTRICAL FACILITIES AT 773-287-7600.
- 10. TOP-OF-FRAME ELEVATIONS SHOWN ON THE PLANS FOR DRAINAGE STRUCTURES IN THE CURB LINE ARE PROPOSED FLOW LINE ELEVATIONS.
- 11. DURING CONSTRUCTION OPERATIONS, WHENEVER ANY LOOSE MATERIAL IS DEPOSITED IN THE FLOW LINES OF DRAINAGE STRUCTURES SUCH THAT THE NATURAL FLOW OF WATER IS OBSTRUCTED, IT SHALL BE REMOVED AT THE CLOSE OF EACH WORKING DAY. AT THE CONCLUSION OF CONSTRUCTION, ALL DRAINAGE AND UTILITY STRUCTURES SHALL BE FREE OF DIRT AND DEBRIS.
- 12. ALL SEWER AND WATER SERVICES CROSSED BY NEW STORM SEWERS SHALL BE PROPERLY LOCATED AND PROTECTED DURING CONSTRUCTION. ANY DAMAGE DONE TO SAID SERVICES NOT CONSIDERED TO BE IN CONFLICT WITH THE PROPOSED CONSTRUCTION SHALL BE REPAIRED BY THE CONTRACTOR AT HIS OWN EXPENSE.
- 13. THE COST OF CONNECTING PROPOSED STRUCTURES AND THE FIRST 5 FEET OF ASSOCIATED PIPE TO THE EXISTING DRAINAGE SYSTEM SHALL BE CONSIDERED INCLUDED IN THE COST OF THE STRUCTURE.
- THE ENDS OF EXISTING DRAINAGE LINES AND HOLES IN EXISTING MANHOLES WHICH ARE NOT TO BE INCORPORATED INTO THE PROPOSED IMPROVEMENTS DESIGNATED BY THE ENGINEER SHALL BE SEALED WITH A PORTLAND CEMENT MORTAR TO THE SATISFACTION OF THE ENGINEER. COST OF THIS WORK SHALL BE INCLUDED IN THE COST OF THE CONTRACT.
- 15. THE CONTRACTOR SHALL CONFIRM ALL EXISTING STORM SEWER PIPE SIZES AND INVERTS PRIOR TO ORDERING STRUCTURES. ANY MODIFICATION OF STRUCTURES DUE TO THE FAILURE OF THE CONTRACTOR TO PEFFORM THIS TASK SHALL BE AT THE CONTRACTOR'S EXPENSE AND MAY LEAD TO THE REJECTION OF THE STRUCTURE IN THE FIELD. PIPE TYPES INDICATED ON THESE PLANS AT THE STRUCTURE CALL-OUTS ARE THE EXISTING TYPES IDENTIFIED IN THE FIELD.
- 16. THE CONTRACTOR SHALL PROVIDE ACCESS TO ABUTTING PROPERTIES AT ALL TIMES DURING THE CONSTRUCTION OF THIS PROJECT EXCEPT FOR PERIODS OF SHORT DURATION AS APPROVED BY THE ENGINEER. THIS WORK SHALL BE INCLUDED IN THE COST OF THE CONTRACT.
- 17. IT SHALL BE THE CONTRACTOR'S RESPONSIBILITY TO VERIFY ALL DIMENSIONS AND CONDITIONS EXISTING IN THE FIELD PRIOR TO ORDERING MATERIALS AND BEGINNING CONSTRUCTION.
- 18. PAY ITEMS IN THE SUMMARY OF QUANTITIES HAVE BEEN ESTIMATED.

  IF, IN THE ENGINEER'S OPINION, THE WORK IS NOT REQUIRED, THE ITEM WILL

  BE DEDUCTED FROM THE CONTRACT AND NO ADDITIONAL COMPENSATION WILL BE ALLOWED.
- 19. ALL SAWCUTTING SHALL BE INCLUDED IN REMOVAL ITEMS AND SHALL BE PERFORMED PRIOR TO BEGINNING REMOVAL. ANY ITEMS OF WORK REMOVED PRIOR TO SAWCUTTING WILL NOT BE MEASURED FOR PAYMENT.
- 20. THE CONTRACTOR SHALL BE RESPONSIBLE FOR RE-ERECTING ANY SIGNS AND POSTS REMOVED DURING CONSTRUCTION. RELOCATION OF EXISTING SIGNS SHALL BE CONSIDERED INCLUDED IN THE CONTRACT. IF DURING CONSTRUCTION THE CONTRACTOR DAMAGES ANY EXISTING SIGNS, HE WILL REPLACE THE SIGN AT NO COST.
- 21. THE CONTRACTOR SHALL SAWCUT AND REMOVE ONLY THE NECESSARY AREA OF EXISTING PAVEMENT NEEDED TO INSTALL PROPOSED STORM SEWER, THIS AREA SHALL BE BACKFILLED TO EXISTING PAVEMENT GRADE USING TRENCH BACKFILL, SPECIAL.
- 22. THE CONTRACTOR SHALL BE RESPONSIBLE FOR NOTIFYING ALL RESIDENTS/BUSINESSES WITHIN THE PROJECT LIMITS AND THE VILLAGE OF ELMWOOD PARK PRIOR TO ANY ROAD CLOSURE.
- 23. ANY DEFECTS FOUND IN THE "NEW" CONCRETE CURB & GUTTER AS IDENTIFIED BY THE RESIDENT ENGINEER SHALL BE REMOVED AND REPLACED AT THE CONTRACTORS EXPENSE PRIOR TO PLACEMENT OF BITUMINOUS MATERIALS.
- 24. IT SHALL BE THE CONTRACTOR'S RESPONSIBILITY TO VERIFY THAT CURB IS DEPRESSED AS INDICATED ON THE PLANS. (SEE IDOT STANDARD 424001).
- 25. AT THE END OF EACH DAY, IT SHALL BE THE CONTRACTORS RESPONSIBILITY TO ASSURE THAT ALL STREETS ADJACENT TO THE PROJECT ARE FREE OF ALL CONSTRUCTION RELATED DEBRIS INCLUDING DIRT, STONE, NAILS ETC. THIS WORK SHALL BE DONE TO THE SATISFACTION OF THE ENGINEER.
- 26. THE CONTRACTOR SHALL COMPLETE ALL UTILITY WORK PRIOR TO PAVEMENT REMOVAL. THE CONTRACTOR SHALL ONLY REMOVE THE PORTION OF PAVEMENT NECESSARY TO INSTALL PROPOSED UTILITIES. PAVEMENT REMOVED FOR UTILITY WORK SHALL BE RESTORED AS INDICATED ON THE PLANS. ALL PAVEMENT REMOVED FOR UTILITY WORK MUST BE SAWCUT.

- 27. THE CONTRACTOR AND ENGINEER SHALL FIELD VERIFY ALL DRAINAGE STRUCTURES TO DETERMINE WHAT WORK IS REQUIRED AT EACH LOCATION.
- 28. THE CONTRACTOR AND ENGINEER SHALL FIELD VERIFY ALL THE EXISTING CONCRETE PAYEMENT AFTER THE EXISTING BITUMINOUS SURFACE IS REMOVED TO DETERMINE THE AREAS THAT PATCHING IS REQUIRED.
- 29. PAVEMENT MARKINGS TO BE FIELD LOCATED BY ENGINEER

30. REMOVAL OF ASPHALT ON CURB AND GUTTER SHALL BE INCLUDED IN CURB AND GUTTER REMOVAL.

- 31. CURB HEICHTS SHOWN ON THE PLANS ARE ESTIMATED. CONTRACTOR SHALL LOWER THE CURB HEIGHT AS NECESSARY TO ACHIEVE POSITIVE DRAINAGE FROM THE FRONT OF WALK TO THE BACK OF CURB. NO CURB SHALL BE POURED LESS THAN 3 INCHES.
- 32. THE GENERAL CONTRACTOR IS REQUIRED TO HIRE AN ENVIRONMENTAL FIRM TO CONTINUOUSLY MONITOR FOR WORKERS SAFETY AND SOIL CONTAMINATION AT SEVERAL AREAS. SEE SPECIAL PROVISION AND SUPPLEMENTAL SPECIFICATIONS FOR DETAILS.

#### HIGHWAY STANDARDS

000001-06 STANDARD SYMBOLS, ABBREVIATIONS, AND PATTERNS

424001-05 CURB RAMPS FOR SIDEWALKS

442201-03 CLASS C AND D PATCHES

602301-03 INLET - TYPE A

604001-03 FRAMES AND LIDS TYPE 1

701801-04 LANE CLOSURE MULTI LANE 1 WAY OR 2 WAY

701901-01 TRAFFIC CONTROL DEVICES


780001-02 TYPICAL PAVEMENT MARKINGS

#### SUMMARY OF QUANTITIES

							Non-
Item No.	Pay Item Description	Unit	Total Quantity	00 31	00.31	0031	Participatin
20201200	REMOVAL AND DISPOSAL OF UNSUITABLE MATERIAL	CUYD	10				10
21001000	GEOTECHNICAL FABRIC FOR GROUND STABILIZATION	SQ YD	30				30
28000510	INLET FILTERS	EACH	2	2			
31101400	SUBBASE GRANULAR MATERIAL, TYPE B, 6"	SQ YD	225				225
40600100	BITUMINOUS MATERIALS (PRIME COAT)	GALLON	105	55			50
40600300	AGGREGATE (PRIME COAT)	TON	2	11			1
40603080	HOT-MIX ASPHALT BINDER COURSE, IL 19.0, N50	TON	50				50
40603310	HOT-MIX ASPHALT SURFACE COURSE, MIX "C", N50	TON	45				45
40603340	HOT-MIX ASPHALT SURFACE COURSE, MIX "D", N70	TON	50	50			
42300400	PORTLAND CEMENT CONCRETE DRIVEWAY PAVEMENT, 8 INCH	SQ YD	105				105
42400200	PORTLAND CEMENT CONCRETE SIDEWALK, 5 INCH	SQ FT	4565	4310			255
42400800	DETECTABLE WARNINGS	SQ FT	80	48	***		32
44000100	PAVEMENT REMOVAL	SQ YD	325	195			130
44000157	HOT-MIX ASPHALT SURFACE REMOVAL, 2"	SQ YD	860	550			310
44000200	DRIVEWAY PAVEMENT REMOVAL	SQ YD	170				170
44000500	COMBINATION CURB AND GUTTER REMOVAL	FOOT	895	570			325
44000600	SIDEWALK REMOVAL	SQ FT	11395	11260			135
44201747	CLASS D PATCHES, TYPE IV, 8 INCH	SQ YD	45				45
550A0050	STORM SEWERS, CLASS A, TYPE 1, 12"	FOOT	16	16			
60234200	INLETS, TYPE A, TYPE 1 FRAME, OPEN LID	EACH	2	2			
60600605	CONCRETE CURB, TYPE B	FOOT	260			260	
66900200	NON-SPECIAL WASTE DISPOSAL	CUYD	215	215			
66900450	SPECIAL WASTE PLANS AND REPORTS	L. SUM	1	1			
66900530	SOIL DISPOSAL ANALYSIS	EACH	4	4			
67100100	MOBILIZATION	L. SUM	1	1			1
78000200	THERMOPLASTIC PAVEMENT MARKING -LINE 4"	FOOT	240				240
78000400	THERMOPLASTIC PAVEMENT MARKING -LINE 6"	FOOT	180	180			1.
83600200	LIGHT POLE FOUNDATION, 24" DIAMETER	FOOT	78		78		1
<b>K</b> 81603090	Unit Duct, 600V, 3-1C No. 4, 1/C No. 6 Ground, (XLP-Type Use), 1 1/4" Dia. Polyethylene	FOOT	1300	<del></del>	1300		
* 81900200	TRENCH BACKFILL FOR ELECTRICAL WORK	FOOT	750		750		1
<b>★</b> 84200500	REMOVAL OF LIGHT UNIT, SALVAGE	EACH	6		6		
84200804	REMOVAL OF POLE FOUNDATION	EACH	6		6		-
4-04200004	TREE, PYRUS CALLERYANA CLEVELAND (CLEVELAND SELECT CALLERY PEAR), 2" CALIPHER,	EACH					
₩ B0237345	TREE FORM BALLED AND BURLAPPED	EACH	4			4	
C2C040G3	SHRUB, ITEA VIRGINICA (VIRGINIA SWEETSPIRE)CONTAINER GROWN, 3-GALLON	EACH	8	·		8	+
X4060826	POLYMERIZED LEVELING BINDER (MACHINE METHOD), IL-4.75, N50	TON	40	25			15
X4240430	PORTLAND CEMENT CONCRETE SIDEWALK 5 INCH, SPECIAL	SQFT	7710			7710	13
X6064200	COMBINATION CONCRETE CURB AND GUTTER, TYPE B-6.12 (SPECIAL)	FOOT	920	578		7710	342
X7010216		L. SUM	1	1			342
XX000959	TRAFFIC CONTROL AND PROTECTION (SPECIAL)	EACH	4	I		4	-
XX000959 XX005425	TRASH RECEPTACLES  LANDSCAPE BOLLARDS	EACH	4		4	+	<del> </del>
		EACH	1	-	1		
XX006834	ELECTRICAL CONNECTION TO EXISTING LIGHTING SYESTEM	<del></del>					
XX008367	DECORATIVE LIGHTING UNIT, TYPE "D1"	EACH	6 4		6 4		
XX008368	DECORATIVE LIGHTING UNIT, TYPE "D2"	EACH			4	8	-
Z0003850	BENCHES	EACH	8			8	
Z0013798	CONSTRUCTION LAYOUT	L. SUM		1 1 7 7 7 7 7 7 7 7 7 7 7 7 7 7 7 7 7 7			-
Z0018100	DRAINAGE STRUCTURE ADJUSTMENT (SPECIAL)	EACH	20	15			5
X Z0033026	MAINTAINENCE OF EXISTING LIGHTING SYSTEM, COMPLETE	L. SUM	1		1		
Z0042002	POROUS GRANULAR EMBANKMENT, SUBGRADE	CUYD	10				10


\*SPECIALTY ITEMS

FILE NAME =	USER NAME = ESIDORCZ	DESIGNED -	REVISED -		T	GENERAL NOTES, IDOT	STANDARDS	F.A.U. RTF.	SECTION	COUNTY	TOTAL SHEET
N:\ELMW00DPARK\95Ø253.ØØØØ4\C1v1\NOT_9	50253.SHT	DRAWN -	REVISED -	STATE OF ILLINOIS				1374	10-00112-00-LS	COOK	23 2
	PLOT SCALE = 20'	CHECKED -	REVISED -	DEPARTMENT OF TRANSPORTATION		& SUMMARY OF O	WANTITIES		1	CONTRAC	CT NO. 63608
	PLOT DATE = 6/2/2011	DATE -	REVISED -		SCALE:	SHEET NO. OF SHEETS	STA. TO STA.		ILLINOIS FED.	AID PROJECT	

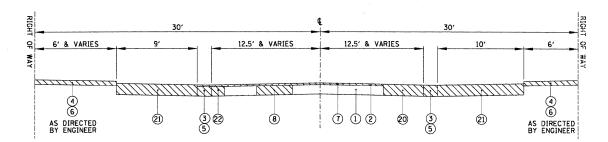


### **EXISTING TYPICAL SECTION & REMOVAL ITEMS**

77TH CT (ALLEY TO BELMONT) STA. 30+37.03 TO STA. 31+93.28

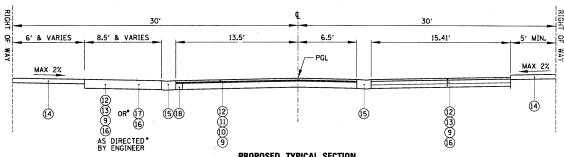


# PROPOSED TYPICAL SECTION

77TH CT (ALLEY TO BELMONT) STA. 30+37.03 TO STA. 31+93.28

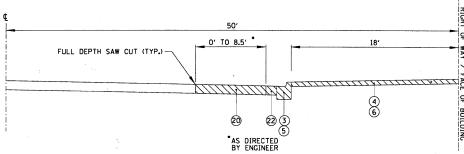

### **EXISTING TYPICAL SECTION & REMOVAL ITEMS**

BELMONT AVENUE (77TH COURT TO 76TH COURT) STA. 10+20.31 TO STA.17+53.42

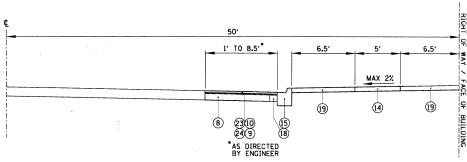

#### PROPOSED TYPICAL SECTION

BELMONT AVENUE (77TH COURT TO 76TH COURT) STA. 10+20.31 TO STA.17+53.42

#### USER NAME = ESIDORCZ DESIGNED REVISED FILE NAME = N:\ELMWOODPARK\950253.00004\C1v1\TYP 50253.SH1 DRAWN REVISED CHECKED REVISED DATE PLOT DATE = 5/24/2011 REVISED

## STATE OF ILLINOIS **DEPARTMENT OF TRANSPORTATION**

TYPICAL SECTIONS					F.A.U. RTE.	SECTION	COUNTY	TOTAL	SHE
				9	1374	10-00112-00-LS	COOK	23	3
							CONTRACT	NO. E	360
١.	OF	SHEETS	STA.	TO STA.		ILLINOIS FED. A	ID PROJECT		

## **HOT-MIX ASPHALT MIXTURE REQUIREMENTS**

ITEM PARTIAL RECONSTRUCTION & RESURFACING	VOIDS
HOT-MIX ASPHALT SURFACE COURSE, MIX "C", N50 (1 1/2 ") (IL-9,5 MM)	4% <b>c</b> 50 GYR
HOT-MIX ASPHALT SURFACE COURSE, MIX "D", N7O (1 1/2 ") (IL-9.5 MM)	4% @ 70 GYR
POLYMERIZED LEVELING BINDER (MACHINE METHOD), IL-4.75, N5O (3/4" AND VARIES)	4% <b>e</b> 50 GYR
DRIVEWAY REPLACEMENT	
HOT-MIX ASPHALT SURFACE COURSE, MIX "C", N50 (1 1/2 ") (IL-9.5 MM)	4% <b>e</b> 50 GYR
HOT-MIX ASPHALT BINDER COURSE, IL-19.0, N50 (4 1/2 ") (IN 2 LIFTS)	4% <b>©</b> 50 GYR
PAVEMENT PATCHING	
CLASS D PATCHING, 8" (HMA BINDER IL-19 MM) (IN 3 LIFTS)	4% @ 70 GYR


- NOTE: 1. THE UNIT WEIGHT USED TO CALCULATE ALL HOT-MIX ASPHALT SURFACE MIXTURES IS 112 LBS/SO YD/IN.
- 2. THE "AC TYPE" FOR POLYMERIZED HMA MIXES SHALL BE "SBS /SBR PG 70-22" AND FOR NON-POLYMERIZED HMA THE "AC TYPE" SHALL BE "PG 64-22" UNLESS MODIFIED BY DISTRICT ONE SPECIAL PROVISIONS. FOR "PERCENT OF RAP" SEE DISTRICT ONE SPECIAL PROVISIONS.


#### LEGEND


- ITEMS TO BE REMOVED
- 1 EXISTING PORTLAND CEMENT CONCRETE BASE COURSE, 8"
- 2 EXISTING BITUMINOUS BINDER AND SURFACE COURSE
- 3 EXISTING COMBINATION CONCRETE CURB AND GUTTER
- 4 EXISTING PORTLAND CEMENT CONCRETE SIDEWALK
- 5 COMBINATION CURB AND GUTTER REMOVAL
- 6 SIDEWALK REMOVAL
- 7 HOT-MIX ASPHALT SURFACE REMOVAL, 2"
- 8 CLASS D PATCHES, TYPE IV. 8 INCH
- 9 BITUMINOUS MATERIALS (PRIME COAT)
- 10 AGGREGATE (PRIME COAT)
- (1) POLYMERIZED LEVELING BINDER (MACHINE METHOD), IL- 4:75, N50 (3/4")
- 12) HOT-MIX ASPHALT SURFACE COURSE, MIX "C", N50 1.5"
- (13) HOT-MIX ASPHALT BINDER COURSE, IL 19.0, N50 4.5"
- (14) PORTLAND CEMENT CONCRETE SIDEWALK, 5 INCH
- (15) COMBINATION CONCRETE CURB AND GUTTER, TYPE B-6.12 (MODIFIED) (SPECIAL)
- 16 SUBBASE GRANULAR MATERIAL, TYPE B, 6"
- 17) PORTLAND CEMENT CONCRETE. DRIVEWAY PAVEMENT, 8"
- (18) PORTLAND CEMENT CONCRETE BASE COURSE, 8" (INCIDENTAL TO CURB AND GUTTER)
- 19 PORTLAND CEMENT CONCRETE SIDEWALK, 5 INCH, SPECIAL


SHEET NO.


- (21) DRIVEWAY PAVEMENT REMOVAL
- PORTLAND CEMENT CONCRETE BASE COURSE REMOVAL (INCIDENTAL)
- 23 POLYMERIZED LEVELING BINDER (MACHINE METHOD), IL-4.75, N50 (3/4")
- (24) HOT-MIX ASPHALT SURFACE COURSE, MIX "D", N70 (1 1/2")

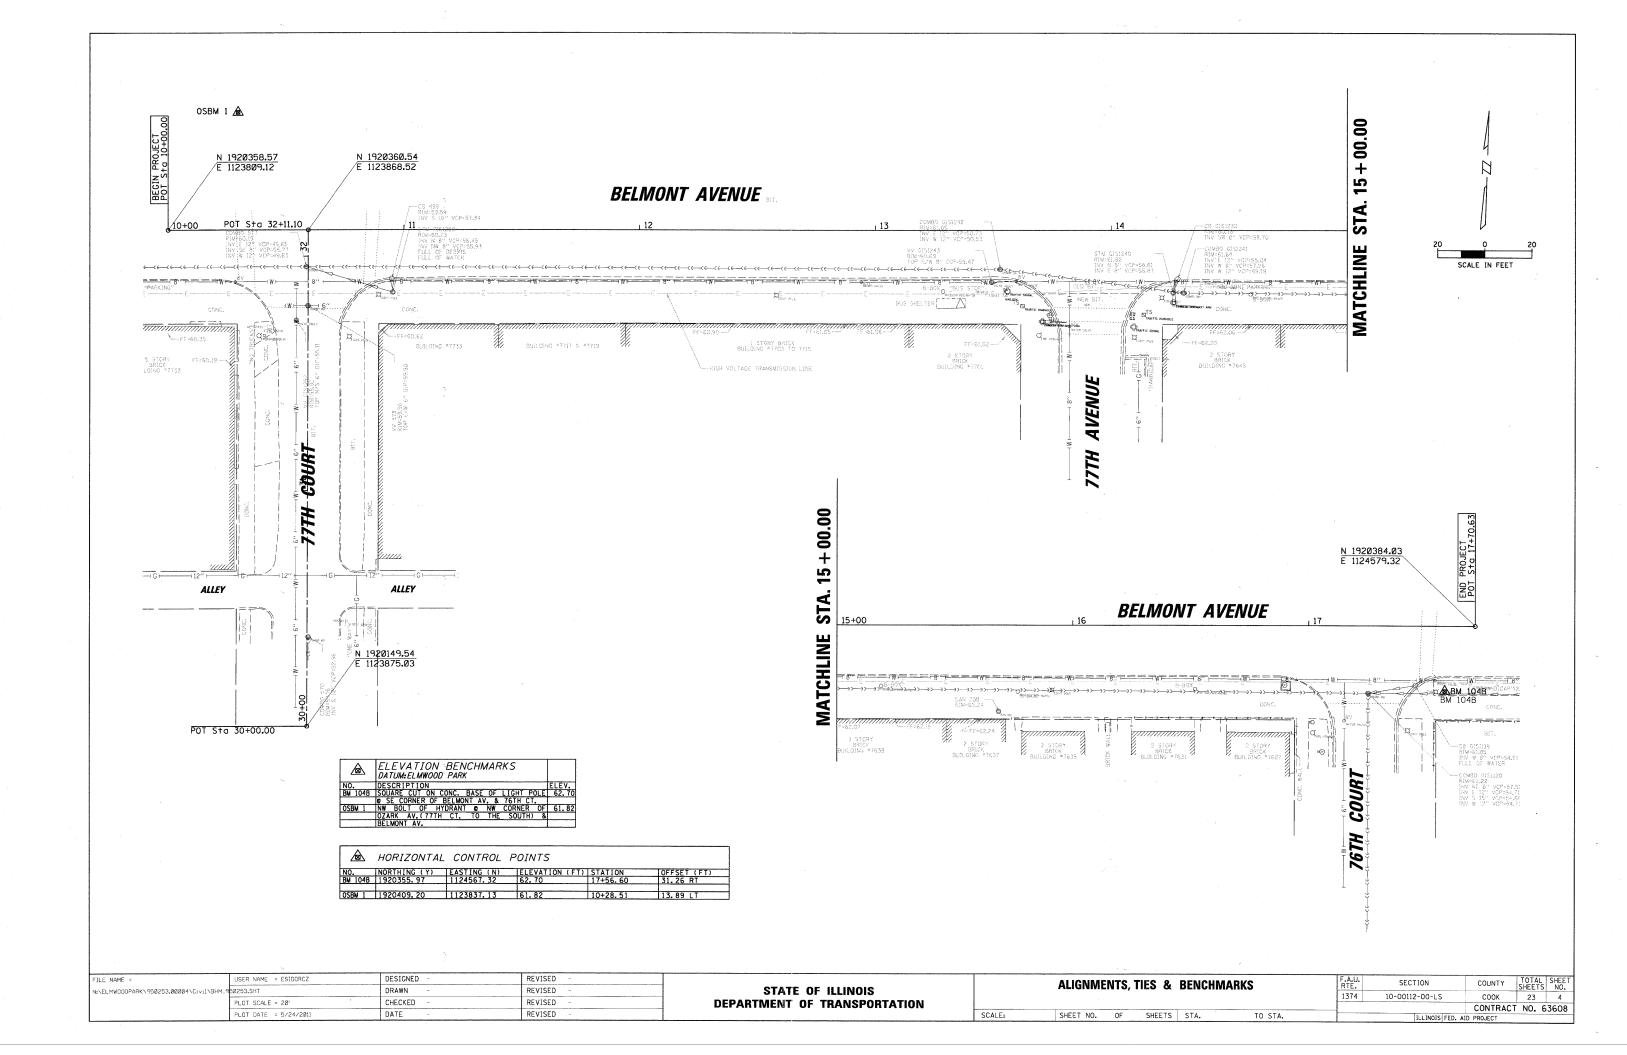


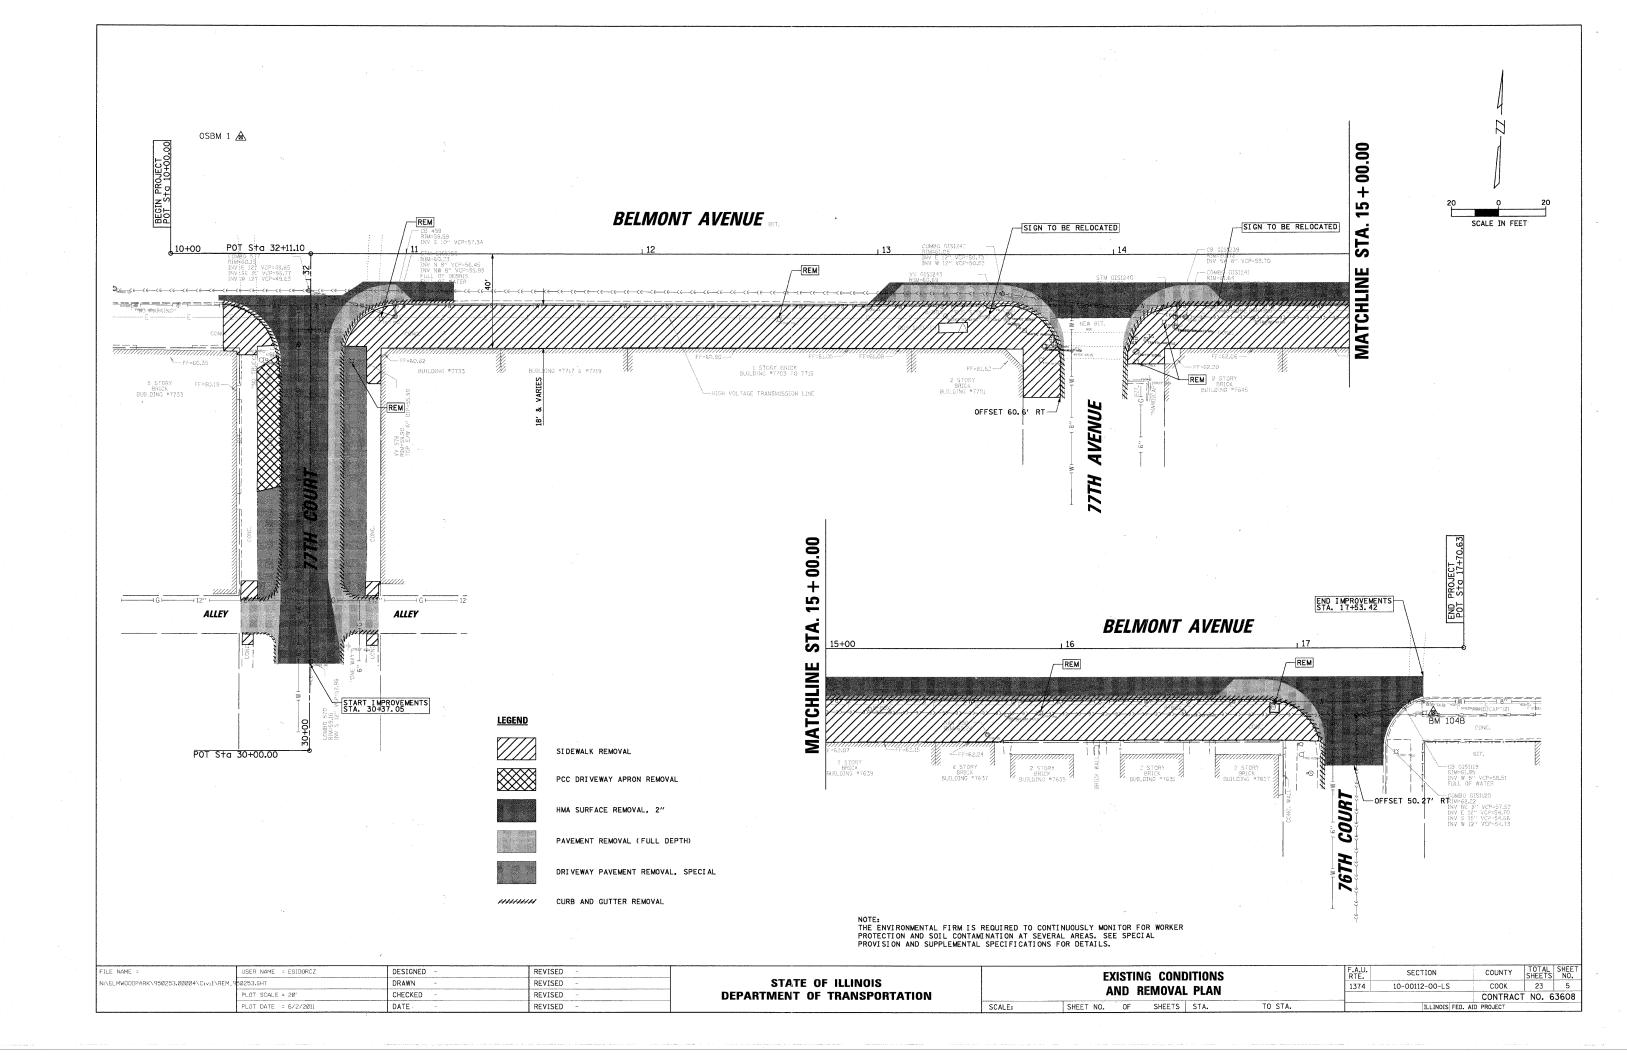

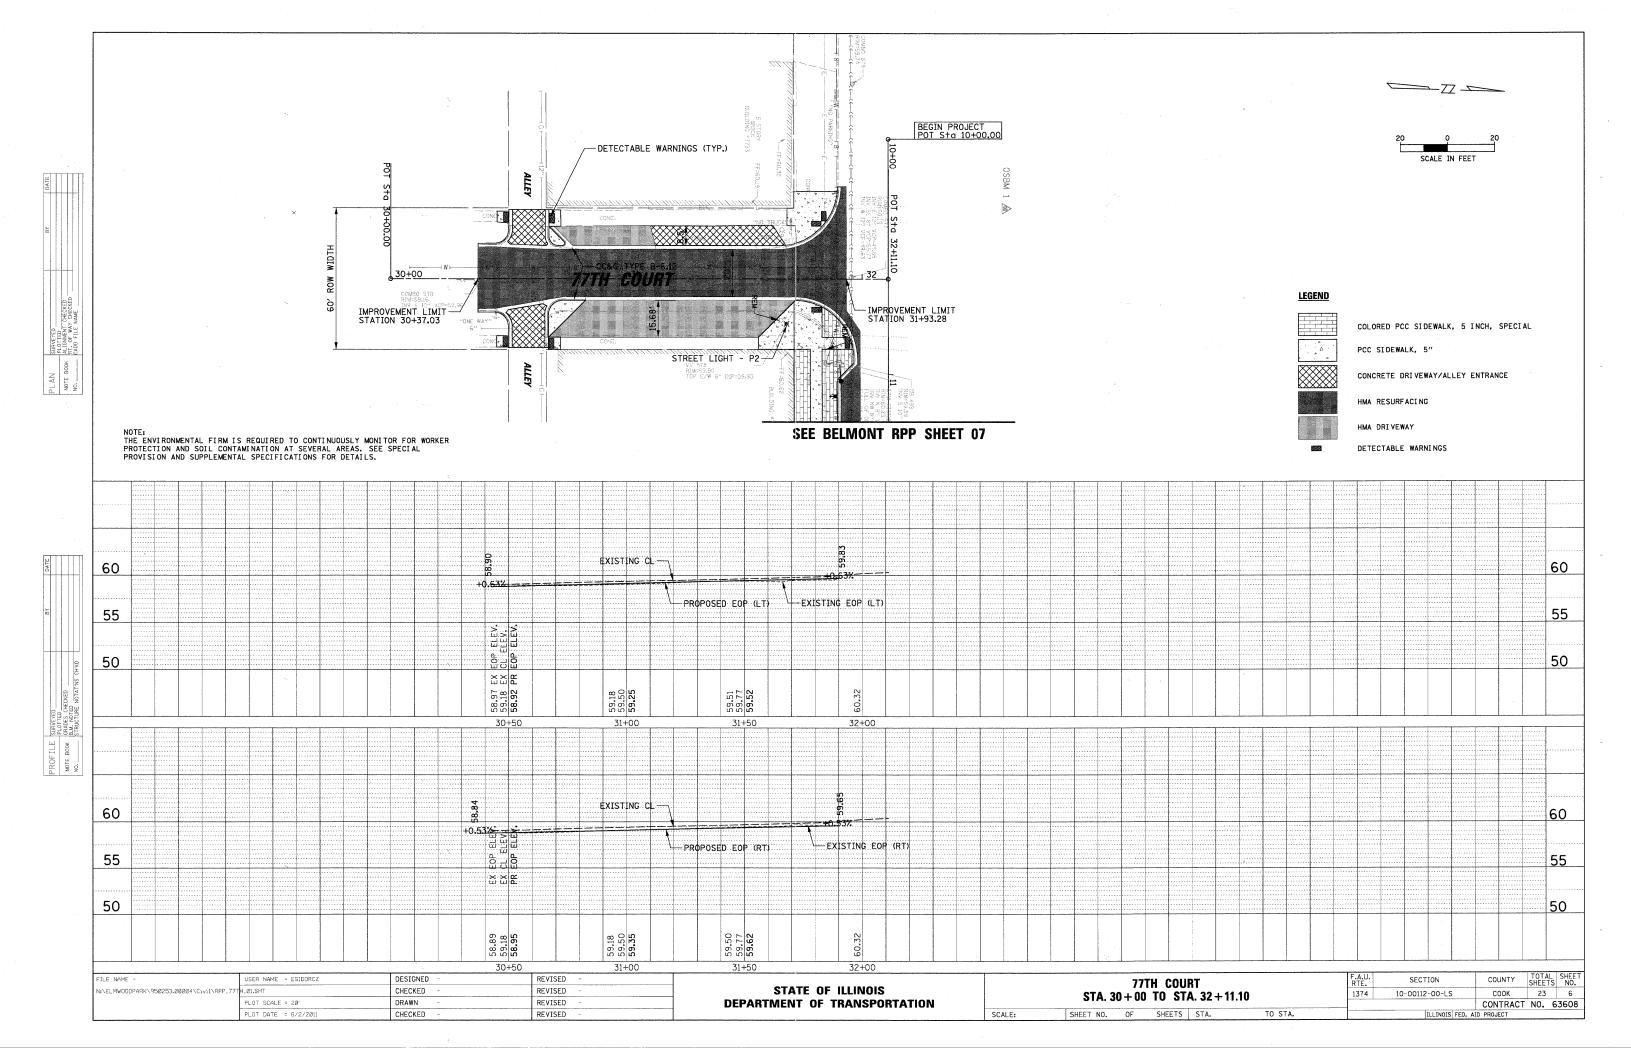


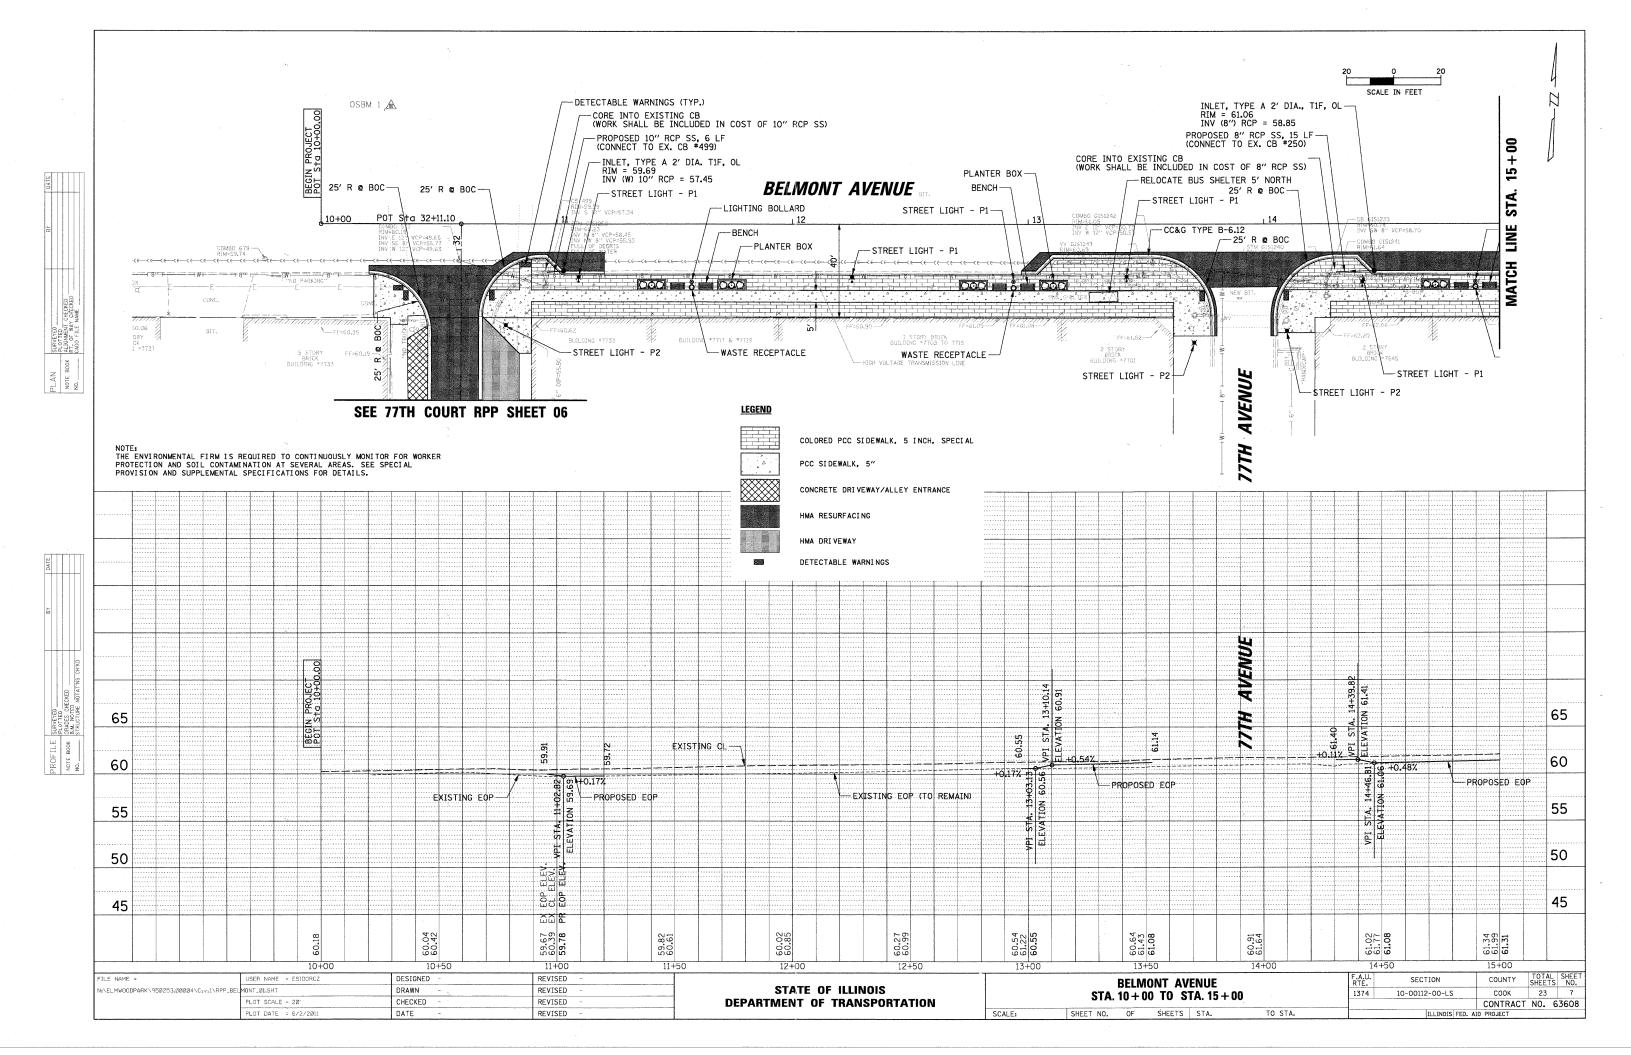

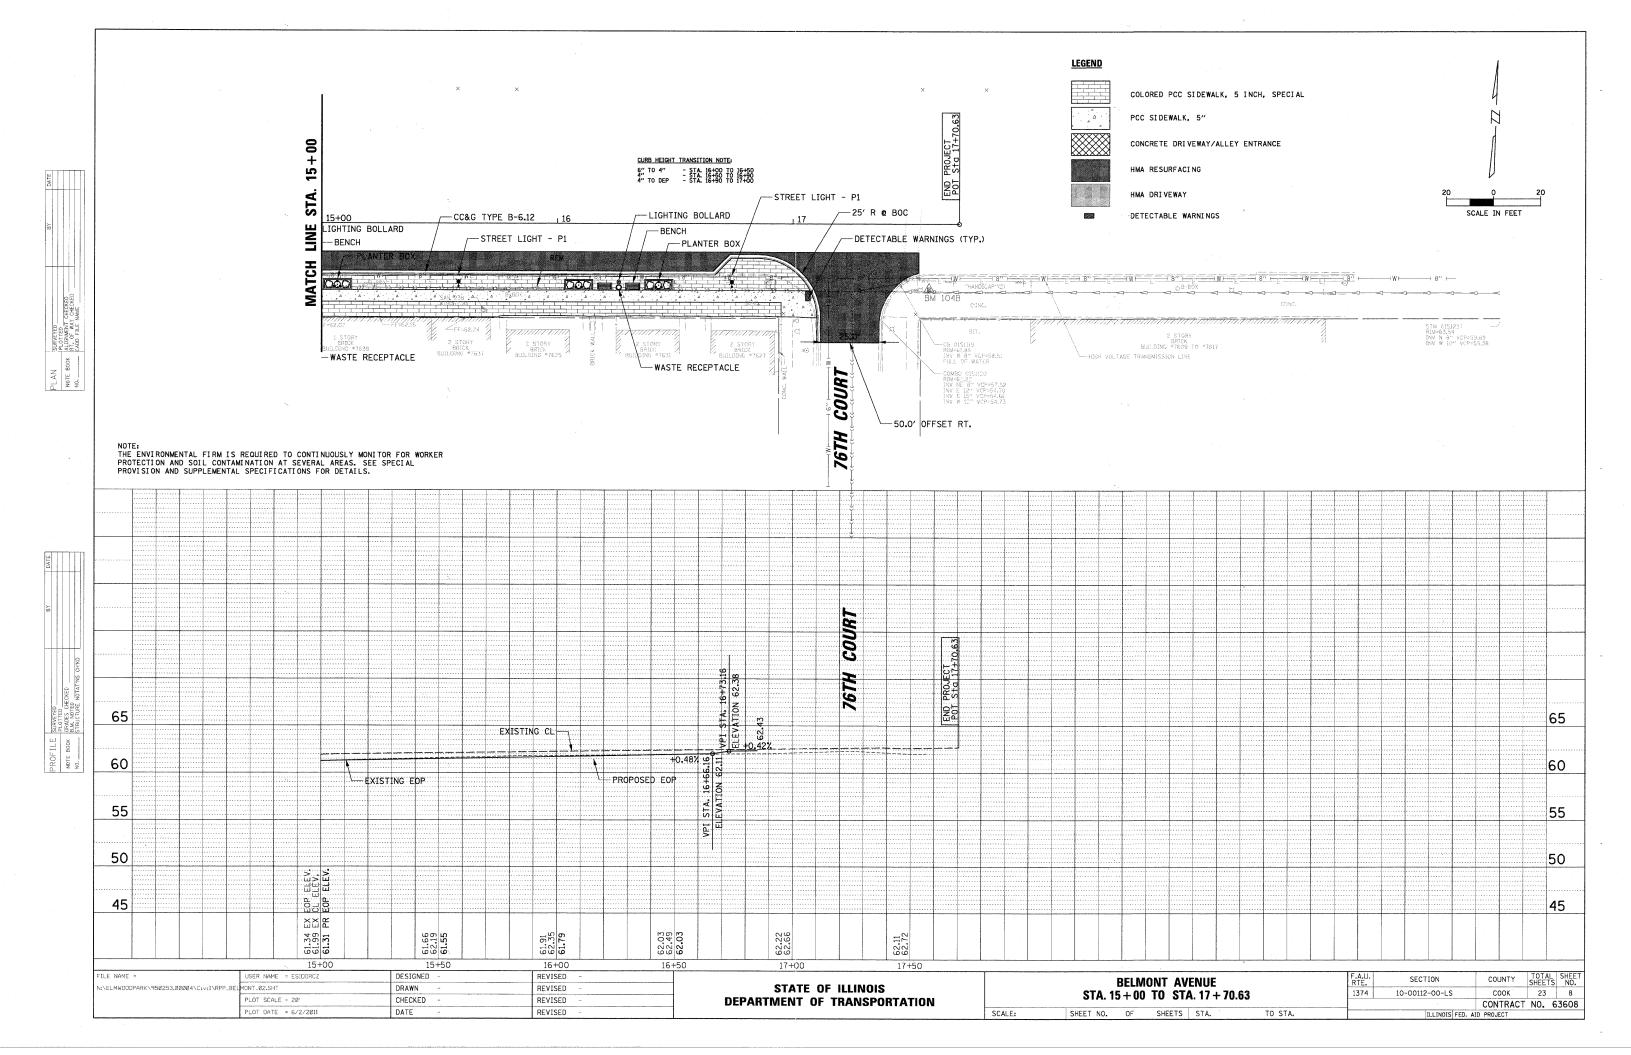

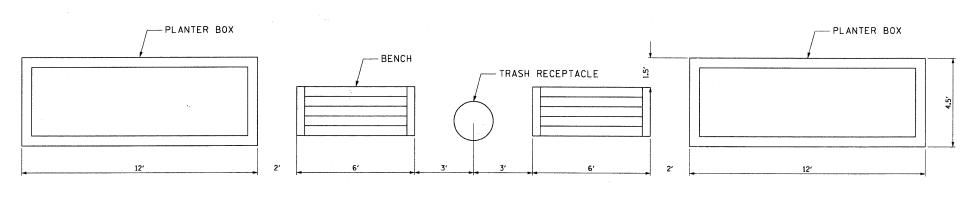

SPACING DETAIL
BELMONT AVENUE PARKWAY

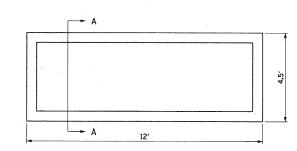

## **PLANTER BOX**

SECTION A-A

CONCRETE CURB — TYPE B


DECORATIVE STAMPED CONCRETE

-RED MULCH TO MATCH EXISTING


-PLANTING SOIL

-SUBBASE GRANULAR MATERIAL TYPE B


--- PCC SIDEWALK, 5"

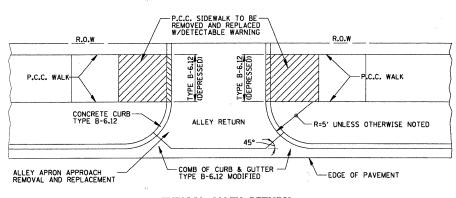


TYPICAL ALLEY RETURN
N.T.S.

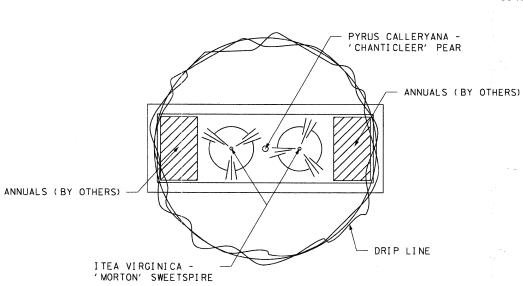

<u>PLANTINGS</u>

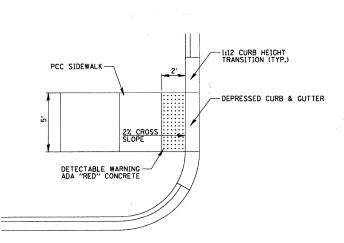

**DETECTABLE WARNING DETAIL** N.T.S.

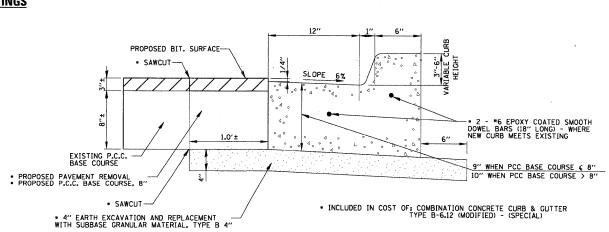

COMBINATION CONCRETE CURB & GUTTER, TYPE B-6.12 - (SPECIAL)
N.T.S.

FILE NAME =	USER NAME = ESIDORCZ	DESIGNED -	REVISED ~			CONSTRUCTION DETA	ALLC	F.A.U.	SECTION	COUNTY	TOTAL SHEET
N:\ELMWOODPARK\950253.00004\C1v1\DET_9	0253_01.SHT	DRAWN -	REVISED -	STATE OF ILLINOIS	1	CONSTRUCTION DETA	AIL3	1774	SECTION 10 10	000111	SHEETS NO.
	PLOT SCALE = 20'	CHECKED -	REVISED -	DEPARTMENT OF TRANSPORTATION				1314	10-00112-00-LS	CONTRACT	23 9
	PLOT DATE = 5/24/2011 :	DATE	REVISED -		SCALE:	SHEET NO. OF SHEETS STA.	TO STA.		ILLINOIS FED. AI	PROJECT	NO. 63608

## LIGHTING GENERAL NOTES

- 1. ELECTRICAL CONTRACTOR SHALL BE RESPONSIBLE FOR OBTAINING A PERMIT FROM THE VILLAGE OF ELMWOOD PARK BEFORE THE START OF WORK, ANY COST FOR PERMIT SHALL BE INCIDENTAL.
- 2. THE EXACT LOCATIONS OF ALL UTILITIES SHALL BE VERIFIED BY THE CONTRACTOR BEFORE THE INSTALLATION OF ANY COMPONENTS OF THE LIGHTING SYSTEM. FOR THE LOCATIONS OF THE UTILITIES, CALL JULIE TOLL FREE AT (800) 892-0123.
- 3. BEFORE INSTALLING LIGHT STANDARDS NEAR OVERHEAD AND UNDERGROUND ELECTRIC UTILITIES SHALL CALL COM ED FOR LOCATION APPROVAL AND MINIMUM CLEARANCE REQUIREMENTS.
- 4. THE WORK PERFORMED UNDER THIS CONTRACT SHALL IN NO WAY INTERFERE WITH THE NORMAL OPERATION OF ANY EXISTING UTILITY SERVICE. THE CONTRACTOR SHALL FURNISH ALL NECESSARY ITEMS OF EQUIPMENT REQUIRED TO MAINTAIN SUCH NORMAL OPERATION AT NO ADDITIONAL COST TO THE OWNER. THE COST ASSOCIATED FOR THIS WORK SHALL BE CONSIDERED INCIDENTAL TO THE COST OF THE CONTRACT, AND NO ADDITIONAL COMPENSATION SHALL BE AWARDED.
- 5. ALL REMOVAL OR EXCAVATION ITEMS BEING DISPOSED OF AT AN UNCONTAMINATED SOIL FILL OPERATION OR CLEAN CONSTRUCTION AND DEMOLITION DEBRIS (CCDD) FILL SITE SHALL MEET THE REQUIREMETNS OF PUBLIC ACT 96-1416. ALL COSTS ASSOCIATED WITH MEETING THESE REQUIREMENTS SHALL BE INCLUDED IN THE UNIT PRICE COST FOR THE ASSOCIATED REMOVAL OR EXCAVATION ITEMS IN THE CONTRACT. THESE COSTS SHALL INCLUDE BUT ARE NOT LIMITED TO ALL REQUIRED TESTING, LAB ANALYSIS, CERTIFICATION BY A LICENSED PROFESSIONAL ENGINEER, AND STATE AND LOCAL TIPPING FEE.
- 6. ALL DISTURBED AREAS WHERE RESTORATION IS NOT COVERED BY APPLICABLE SECTIONS OF THE SPECIAL PROVISIONS MUST BE RESTORED TO THE SATISFACTION OF THE ENGINEER. THE WORK WILL BE CONSIDERED INCIDENTAL TO THE CONTRACT. SEPARATE PAYMENT WILL NOT BE MADE.
- THE CONTRACTOR SHALL BE SOLELY RESPONSIBLE FOR JOB SITE SAFETY AS WELL AS SUPERVISION/ DIRECTION AND MEANS/METHODS OF CONSTRUCTION.
- 8. ALL WORK SHALL BE IN ACCORDANCE WITH THE LATEST EDITION OF THE FOLLOWING SPECIFICATIONS, WHICH ARE HEREBY MADE A PART HEREOF:
  - A. "STANDARD SPECIFICATIONS FOR ROAD AND BRIDGE CONSTRUCTION", AS PREPARED BY IDOT.
  - B. "THE NATIONAL ELECTRICAL CODE".
  - C. MUNICIPAL CODES & STANDARDS.
- 9. NO MATERIALS SHALL BE DELIVERED TO THE JOB SITE UNTIL ALL PERTINENT EQUIPMENT SUBMITTALS HAVE BEEN REVIEWED BY THE ENGINEER.
- 10. ALL TREE TRIMMING REQUIRED, OR AS DIRECTED BY THE ENGINEER, SHALL BE PERFORMED BY THE CONTRACTOR, AND SHALL BE INCIDENTAL TO THE COST OF THE LIGHT POLE.
- 11. CAST A GROUND ROD INSIDE EVERY CONCRETE POLE FOUNDATION AND CONNECT TO THE POLE GROUNDING LUG VIA A \*6 SOLID COPPER WIRE WITH A MECHANICAL CONNECTION AT THE GROUND ROD AND PIGTAIL SPLICE INSIDE THE POLE HANDHOLE.
- 12. THE INSTALLATION OF BURIED WARNING TAPE, SPECIFIED AS PART OF "TRENCH AND BACKFILL FOR ELECTRICAL WORK", SHALL BE REVIEWED BY THE ENGINEER PRIOR TO BACKFILLING OR DURING PLOWING OPERATIONS, AS APPLICABLE.
- 13. THE CONTRACTOR SHALL LABEL ALL WIRES WITH WIRE MARKERS INDICATING THE CIRCUIT ID IN EVERY CONTROLLER, POLE BASE, HAND HOLE AND SPLICE/CONNECTION POINT. WIRE MARKERS SHALL BE MECHANICALLY FASTENED WHITE PLASTIC, TYPE "PLM" AS MANUFACTURED BY PANDUIT OR APPROVED EQUAL.
- 14. UNIT DUCT SHALL BE 11/4" DIAMETER SCH 40 HDPE WITH 2-1/C \*4, 1/C \*4 NEUTRAL & 1/C \*6 GROUND XLP-TYPE USE CABLES, INSTALLED IN TRENCH, OR AS INDICATED ON THE PLANS.
- 15. LUMINAIRES SHALL BE LEVEL & HAVE A TIGHT FIT ON MAST ARMS TO THE ENGINEER'S SATISFACTION.
  THIS WORK SHALL INCLUDE FIELD ADJUSTING OF THE LUMINAIRE WHICH WILL BE INCIDENTAL TO THE
  COST OF THE CONTRACT.
- 16. NO POLES SHALL BE ERECTED UNTIL THE RESPECTIVE FOUNDATIONS HAVE CURED, (IF APPLICABLE) AND HAVE BEEN REVIEWED BY THE ENGINEER.
- 17. TO MAINTAIN THE STRUCTURAL INTEGRITY OF LIGHT POLES WITH MAST ARMS, THEY SHALL NOT BE ERECTED AND LEFT TO STAND WITHOUT LUMINAIRES.
- 18. ALL POLE HANDHOLES SHALL FACE AWAY FROM TRAFFIC.

PLOT DATE = 5/24/201

- 19. THE CONTRACTOR SHALL BE RESPONSIBLE FOR THE ESTABLISHMENT OF THE TOP OF FOUNDATION ELEVATION WITH THE FINISHED GRADE.
- 20. EQUIPMENT GROUND CONDUCTORS SHALL BE SPLICED AND BONDED AT EACH LIGHT POLE OR OTHER PIECE OF EQUIPMENT.
- 21. IT SHALL BE THE CONTRACTOR'S RESPONSIBILITY TO MARK THE PROPOSED LOCATIONS OF ALL LIGHT POLES FOR EXAMINATION AND CONFIRMATION WITH THE ENGINEER, ALL UTILITIES SHALL BE LOCATED PRIOR TO MARKING PROPOSED LOCATIONS.
- 22. THE ELECTRICAL CONTRACTOR SHALL FURNISH TWO SETS OF FULL SIZE RECORD DRAWINGS TO THE ENGINEER UPON COMPLETION OF THE LIGHTING AND ELECTRICAL IMPROVEMENTS. THE DRAWINGS SHALL SHOW THE INSTALLED LOCATIONS OF ALL LIGHT POLES, UNDERGROUND CONDUITS/WIRING, HANDHOLES, JUNCTION BOXES & CONTROLLER CABINETS. THE DRAWINGS WILL BE REVIEWED BY THE ENGINEER.
- 23. PRIOR TO PERFORMING ANY ELECTRICAL WORK, OR TRANSFERING THE MAINTENANCE OF THE EXISTING LIGHTING SYSTEM, THE CONTRACTOR SHALL PERFORM, AND RECORD, ELECTRICAL TESTING OF THE EXISTING LIGHTING SYSTEM. ELECTRICAL TESTING SHALL BE PERFORMED IN THE PRESENCE OF THE ENGINEER, AND IN ACCORDANCE WITH ARTICLE 80.13 OF THE STANDARD SPECIFICATIONS FOR ROAD AND BRIDGE CONSTRUCTION. THE CONTRACTOR SHALL BE REQUIRED TO PERFORM FULL MAINTENANCE OF THE EXISTING LIGHTING SYSTEMS (REFER TO THE SPECIAL PROVISIONS FOR A DESCRIPTION OF
- 24. UPON COMPLETION OF THE PROPOSED LIGHTING IMPROVEMENTS, THE CONTRACTOR SHALL AGAIN PERFORM ELECTRICAL TESTING AND VERIFY THAT THE INSTALLTION COMPLIES WITH THE LATEST EDITION OF THE STANDARD SPECIFICATIONS FOR ROAD AND BRIDGE CONSTRUCTION IN ILLINOIS.

#### 

DATE

REVISED

# STATE OF ILLINOIS DEPARTMENT OF TRANSPORTATION

SCALE:

	LIGH	ITING	GENER/	AL NOTES		F.A.U. RTE.	SECTION	COUNTY	TOTAL	SHEE NO.
						1374	10-00112-00-LS	соок	23	10
F N.T.C	CUEET NO		OUEETO.					CONTRAC	NO. 6	3608
E: N.T.S.	SHEET NO.	OF	SHEETS	STA.	TO STA.		ILLINOIS FED. A	D PROJECT		

# LIGHTING BILL OF MATERIALS


DESCRIPTION	UNIT	QUANTITY
UNIT DUCT, 600V, 3-1C NO.4, 1/C NO.6 GROUND, (XLP-TYPE USE),	FOOT	900
IN 11/4" DIA. POLYETHYLENE		
UNIT DUCT, 600V, 3-1C NO.4, 1/C NO.6 GROUND, (XLP-TYPE USE),	FOOT	400
IN 11/4" DIA. POLYETHYLENE, BORED AND PULLED		
TRENCH AND BACKFILL FOR ELECTRICAL WORK	FOOT	750
LIGHT POLE FOUNDATION, 24" DIAMETER	FOOT	78
REMOVAL OF LIGHT UNIT, SALVAGE	EACH	6
REMOVAL OF POLE FOUNDATION	EACH	6
LANDSCAPE BOLLARDS	EACH	4
ELECTRICAL CONNECTION TO EXISTING LIGHTING SYSTEM	EACH	1
DECORATIVE LIGHTING UNIT, TYPE "D1"	EACH	6
DECORATIVE LIGHTING UNIT, TYPE "D2"	EACH	4
MAINTENANCE OF EXISTING LIGHTING SYSTEM COMPLETE	LSUM	1


# **ABBREVIATIONS**

RIDGID GALVANIZED STEEL

# NOTICE TO CONTRACTOR

THE CONTRACTOR IS SPECIFICALLY CAUTIONED THE LOCATION AND/OR ELEVATION OF EXISTING AND PROPOSED UTILITIES AS SHOWN ON THESE PLANS. THE INFORMATION IS NOT TO BE RELIED ON AS BEING EXACT OR COMPLETE. THE CONTRACTOR MUST CALL THE LOCAL UTILITY LOCATION CENTER AT LEAST 72 HOURS BEFORE ANY EXCAVATION TO REQUEST EXACT FIELD LOCATIONS OF THE UTILITIES. IT SHALL BE THE RESPONSIBILITY OF THE CONTRACTOR TO INFORM ENGINEER OF ANY EXISTING UTILITIES WHICH CONFLICT WITH THE PROPOSED IMPROVEMENTS.

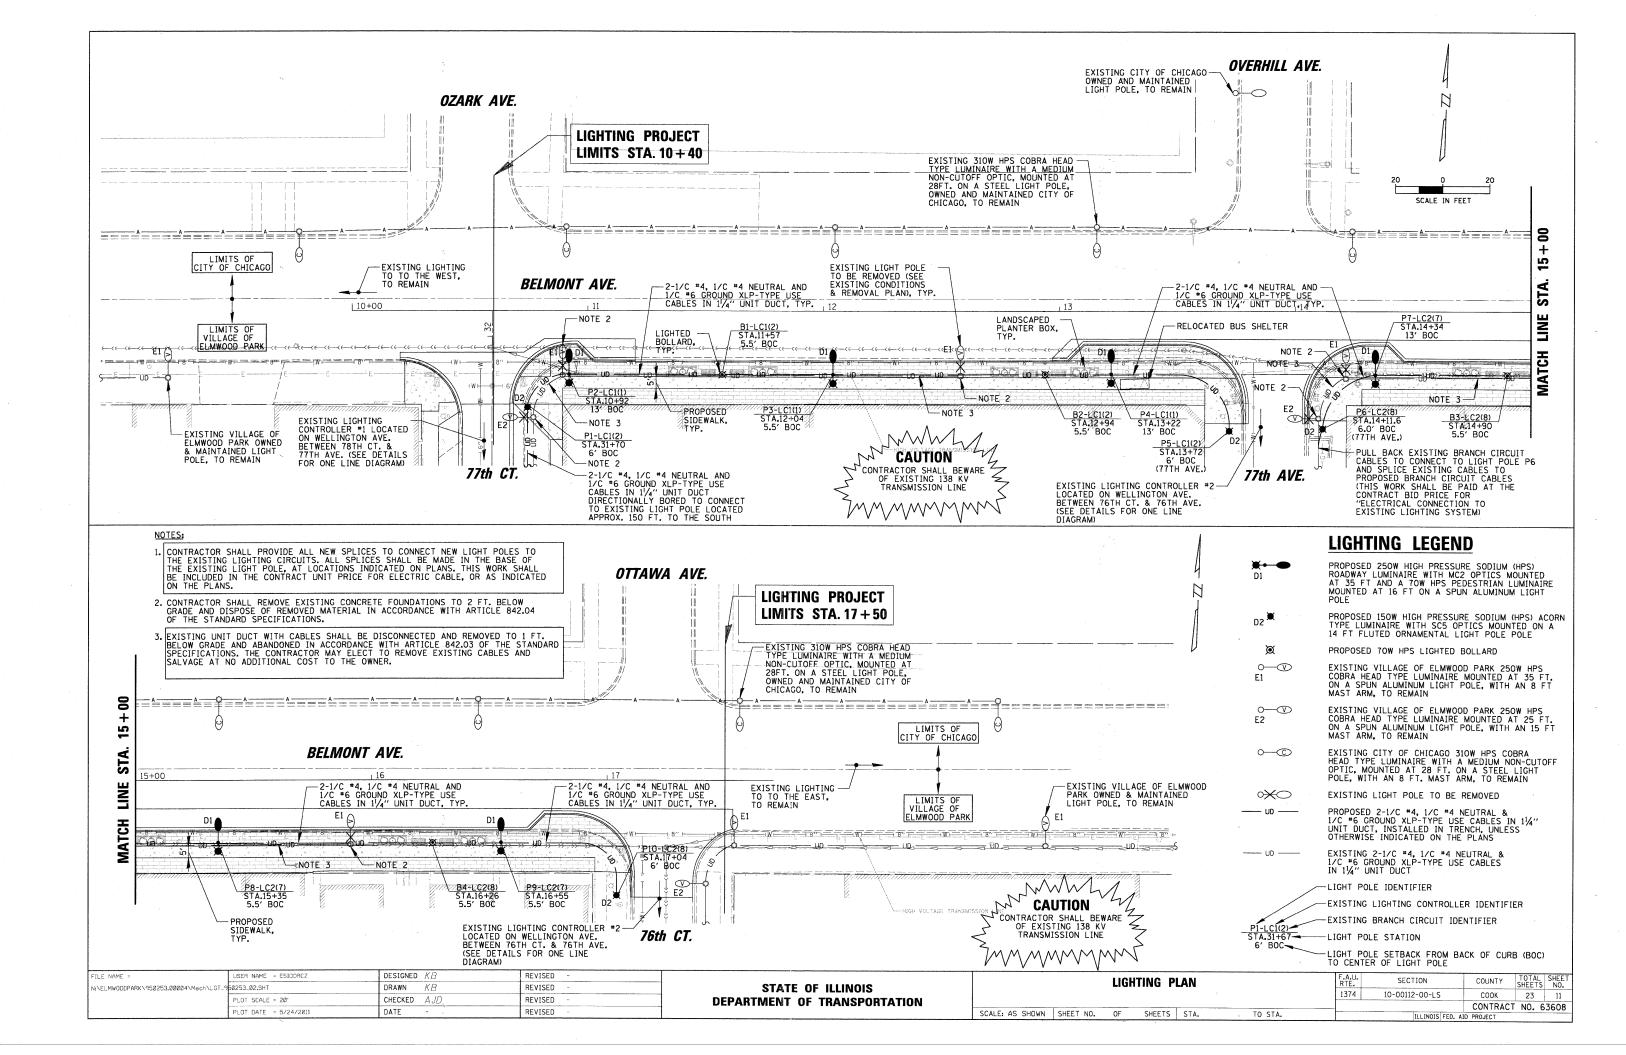

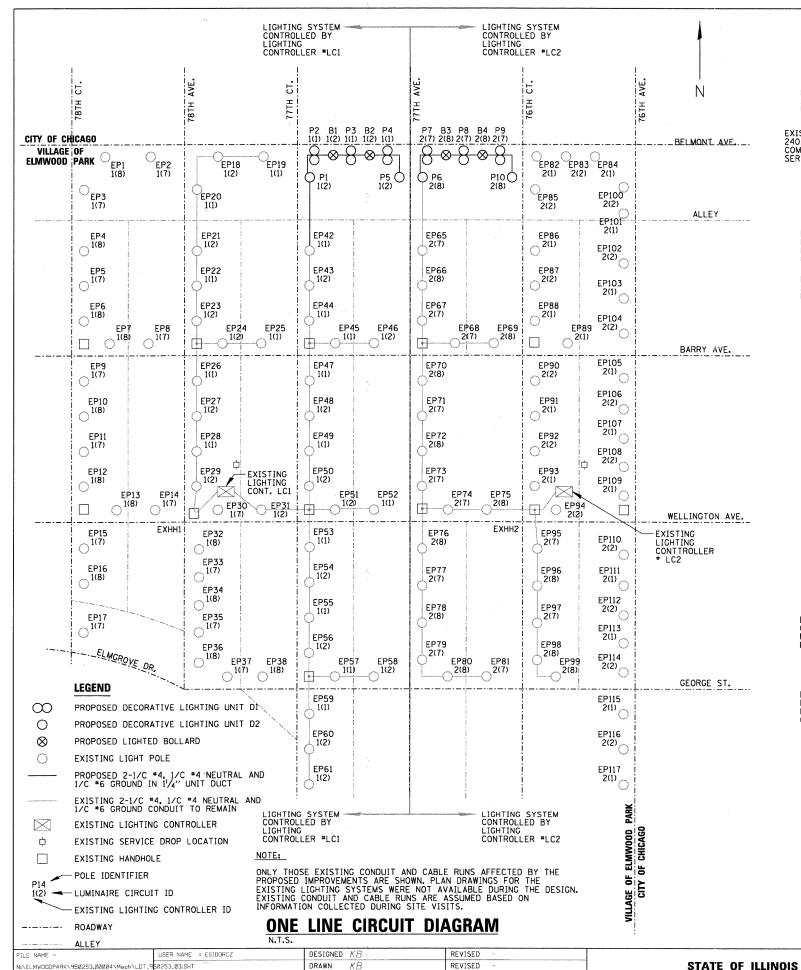


PLOT SCALE = 20

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# DESCRIPTION OF WORK

CONTRACTOR SHALL TAKE FULL MAINTENANCE OF EXISTING LIGHTING CONTROLLER & LIGHTING SYSTEM DURING CONSTRUCTION OF THIS CONTRACT. THIS WORK SHALL INCLUDE MAINTENANCE OF LIGHTING UNITS, CABLE RUNS AND LIGHTING CONTROLS. IN CASE OF A POLE KNOCKDOWN OR EQUIPMENT DAMAGED BY EITHER THE MOTORING PUBLIC OR CONTRACTOR OPERATIONS, THE CONTRACTOR SHALL CLEAR AND RESTORE THE EXISTING SYSTEM TO ORIGINAL CONDITION (SEE CONTRACT SPECIFICATIONS).


PROPOSED LIGHTING SHALL BE CONNECTED TO EXISTING BRANCH LIGHTING CIRCUITS, AS SHOWN ON THE PLANS. NO WORK IS PROPOSED TO THIS CONTROLLER, IT IS SHOWN FOR INFORMATIONAL PURPOSES ONLY.

LIGHTING CONTRO	LLER LOADS
DESCRIPTION OF LOAD	LOAD (AMPS)
EX. BRANCH CKT NO. 1	25.9 A (240V)
EX. BRANCH CKT NO. 2	24.5 A (240V)
EX. BRANCH CKT NO. 7	16.0 A (240V)
EX. BRANCH CKT NO. 8	15.0 A (240V)
TOTAL LOAD ON EX. CONTROLLER "LC1"	40.7 A (480V, 1Ø)

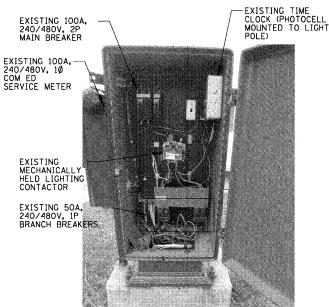NOTE: TABULATED LOADS INCLUDE PROPOSED LIGHT POLES.

# **EXISTING LIGHTING CONTROLLER "LC1"**

LOCATED ON NORTH SIDE OF WELLINGTON AVE. BETWEEN 78TH AVE. AND 77TH CT.

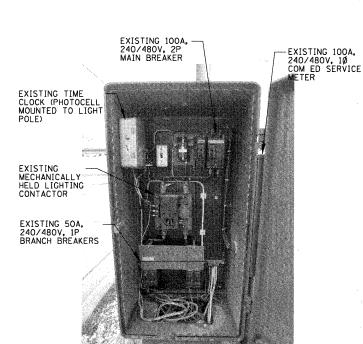

**DEPARTMENT OF TRANSPORTATION** 

# **DESCRIPTION OF WORK**

CONTRACTOR SHALL TAKE FULL MAINTENANCE OF EXISTING LIGHTING CONTROLLER & LIGHTING SYSTEM DURING CONSTRUCTION OF THIS CONTRACT. THIS WORK SHALL INCLUDE MAINTENANCE OF LIGHTING UNITS, CABLE RUNS AND LIGHITNG CONTROLS, IN CASE OF A POLE KNOCKDOWN OR EQUIPMENT DAMAGED BY EITHER THE MOTORING PUBLIC OR CONTRACTOR OPERATIONS, THE CONTRACTOR SHALL CLEAR AND RESTORE THE EXISTING SYSTEM TO ORIGINAL CONDITION (SEE CONTRACT SPECIFICATIONS).

PROPOSED LIGHTING SHALL BE CONNECTED TO EXISTING BRANCH LIGHTING CIRCUITS, AS SHOWN ON THE PLANS. NO WORK IS PROPOSED TO THIS CONTROLLER, IT IS SHOWN FOR INFORMATIONAL PURPOSES ONLY.


LIGHTING CONTRO	LLER LOADS
DESCRIPTION OF LOAD	LOAD (AMPS)
EX. BRANCH CKT NO. 1	21.8 A (240V)
EX. BRANCH CKT NO. 2	17.8 A (240V)
EX. BRANCH CKT NO. 7	19.4 A (240V)
EX. BRANCH CKT NO. 8	16.7 A (240V)
TOTAL LOAD ON EX. CONTROLLER "LC2"	37.9 A (480V, 1Ø)

NOTE: TABULATED LOADS INCLUDE PROPOSED LIGHT POLES.

# **EXISTING LIGHTING CONTROLLER "LC2"**

LOCATED ON NORTH SIDE OF WELLINGTON AVE. BETWEEN 76TH AVE. AND 76TH CT.

			LIGHT	TING DE	TAILS	*	F.A.U. RTE.	SECTION	COUNTY	TOTAL	SHEET NO.
							1374	10-00112-00-LS	соок	23	12
					,				CONTRACT	NO.	63608
 SCALE: N.T.S.	SHEET I	١0.	OF	SHEETS	STA.	TO STA.		ILLINOIS FED.	AID PROJECT		

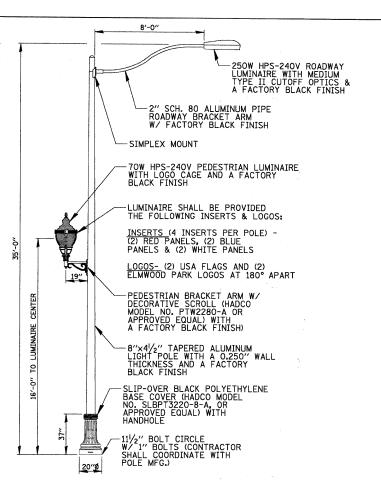



	LUMI	NA	IRE MODEL INFORMATION	
POLE TYPE	FIXTURE TYPE		LUMINAIRE MANUFACTURER AND MODEL INFORMATION	IES PHOTOMETRIC CURVE
	ROADWAY LUMINAIRE	А	GENERAL ELECTRIC: MDCA25S0A12FMC22U	GE451001.IES
1		А	AEL: 32525SCAMT2R2FGBKUL NRLCECCFHP	325_40S_R2_HP.IES
1	PEDESTRIAN	В	HADCO: R54BABA2ATND70SG	R54-15S5V-T.IES
	LUMINAIRE	В	HOLOPHANE: AW70DHP24B8MRB RBMX	AW10DHP00X8NXX RBMX.IFS

#### NOTES:

- LIGHT POLES SHALL MEET WIND LOADING & VIBRATION REQUIREMENTS ACCORDING TO THE LATEST AASHTO STANDARDS AND ARTICLE 1069.01 IN STANDARD SPECIFICATIONS FOR ROAD AND BRIDGE CONSTRUCTION.
   ALL STEEL SHALL BE FROM A DOMESTIC SOURCE.
   THE LIGHT POLES SHALL MEET THE ILLUMINATION REQUIREMENTS AS SPECIFIED IN THE LUMINAIRE PERFORMANCE TABLES IN THE SPECIFICATIONS. ALL LUMINAIRES SHALL HAVE A MULTI-TAP BALLAST WIRED FOR 240 VOLTS OPERATION.
   LIGHT POLE SHALL BE U/L LISTED.

# **DECORATIVE LIGHTING UNIT D1**

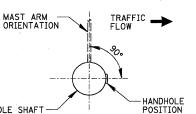

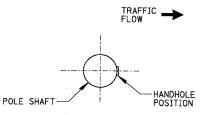


FOR DECORATIVE

POLE SHAFT

FOR DECORATIVE LIGHTING UNIT D2 AND LANDSCAPE BOLLARD

# POSITION OF HANDHOLE DETAIL

FILE NAME = DESIGNED KA REVISED DRAWN REVISED CHECKED AJE OT SCALE = 20 REVISED DATE INT DATE = 6/13/201: REVISED

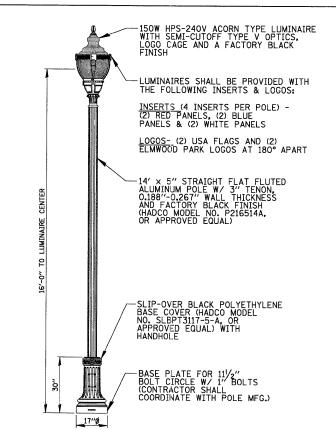


	LUMINAIRE MODEL INFORMATION									
POLE TYPE	FIXTURE TYPE		LUMINAIRE MANUFACTURER AND MODEL INFORMATION	IES PHOTOMETRIC CURVE						
2	PEDESTRIAN	A	HADCO: R54BABA2ATND150SG	R54-15S5V-T.IES						
	LUMINAIRE	В	HOLOPHANE: AW15DHP24B8MRB RBMX	AW15DHPOOX8NXX RBMX.IES						

#### NOTES:

- LIGHT POLES SHALL MEET WIND LOADING & VIBRATION REQUIREMENTS ACCORDING
  TO THE LATEST AASHTO STANDARDS AND ARTICLE 1069.01 IN STANDARD
  SPECIFICATIONS FOR ROAD AND BRIDGE CONSTRUCTION.
   ALL STEEL SHALL BE FROM A DOMESTIC SOURCE.
   THE LIGHT POLES SHALL MEET THE ILLUMINATION REQUIREMENTS AS SPECIFIED
  IN THE LUMINAIRE PERFORMANCE TABLES IN THE SPECIFICATIONS. ALL LUMINAIRES
  SHALL HAVE A MULTIT-TAP BALLAST WIRED FOR 240 VOLTS OPERATION.
   LIGHT POLE SHALL BE U/L LISTED.


# **DECORATIVE LIGHTING UNIT D2**

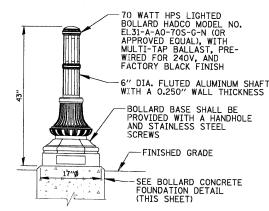

1. CONTRACTOR SHALL COORDINATE SIZE AND ORIENTATION OF BOLT CIRCLE.

# LANDSCAPE BOLLARD

STATE OF ILLINOIS **DEPARTMENT OF TRANSPORTATION** 

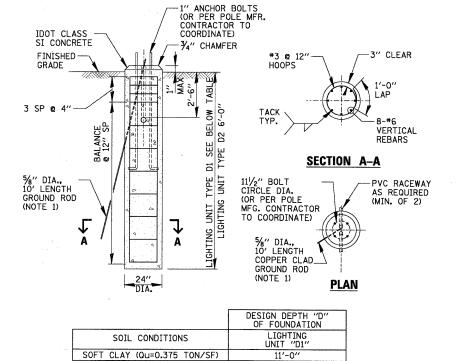

9'-0"

7'-6"

9'-6"

9'-0"

#### NOTES:

GROUND ROD SHALL BE CAST INTO CONCRETE FOUNDATION WITH 8 FEET IN CONTACT WITH SOIL.

MEDIUM CLAY (Qu=0.75 TON/SF)

STIFF CLAY (Qu=1.50 TON/SF)


LOOSE SAND (Ø=34")

MEDIUM SAND (Ø=37.5")

DENSE SAND (Ø=40")

- 2. FOUNDATIONS SHALL BE VIBRATED IN ACCORDANCE WITH IDOT STANDARD PRACTICES.
- 3. ALL ABOVE ITEMS INCLUDING CONCRETE, GROUND ROD, REINFORCEMENT, RACEWAYS AND FORMWORK SHALL BE INCLUDED IN THE "LIGHT POLE

# **CONCRETE FOUNDATION DETAIL**

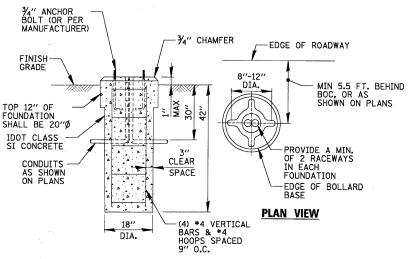


SCALE: N.T.S.


- 1. CONTRACTOR SHALL COORDINATE SIZE AND ORIENTATION OF BOLT CIRCLE, WITH BOLLARD MANUFACTURER.
- CONCRETE FOUNDATION, ANCHOR BOLTS, SPARE RACEWAYS AND FASTENERS SHALL BE INCLUDED IN THE CONTRACT UNIT PRICE FOR "LANDSCAPE BOLLARD".

# **BOLLARD CONCRETE FOUNDATION DETAIL**

SECTION LIGHTING DETAILS 1374 10-00112-00-LS COOK 23 CONTRACT NO. 63608 SHEET NO. OF SHEETS STA. TO STA. ILLINOIS FED. AID PROJECT

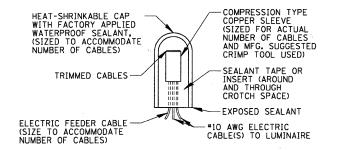


# SPLICING ELECTRIC CABLE

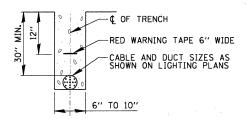

# **ELECTRIC CONDUIT INSTALLATION**

N.T.S.

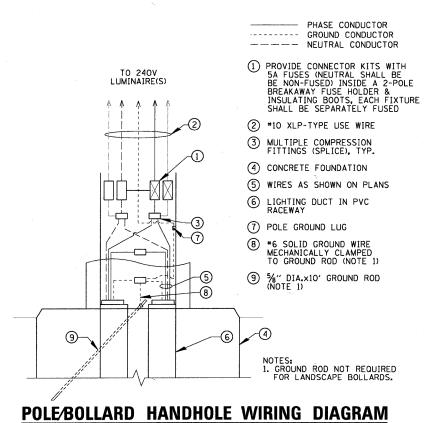


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DATE

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STATE OF ILLINOIS
DEPARTMENT OF TRANSPORTATION

	LIGHTING DETAILS					F.A.U. RTE.	SECTION	COUNTY TOTAL SHEET SHEETS NO.			
						1374	10-00112-00-LS	COOK	23	14	
SCALE: N.T.S.	SHEET NO.	OF	SHEETS	STA.	TO STA.			CONTRAC	T NO. 6	3608	
 30ALL: 11.11.3.	JINEET NO.	01	JIILLIJ	JIM.	IU SIA.	ILLINOIS FED. AID PROJECT					



### NOTES:

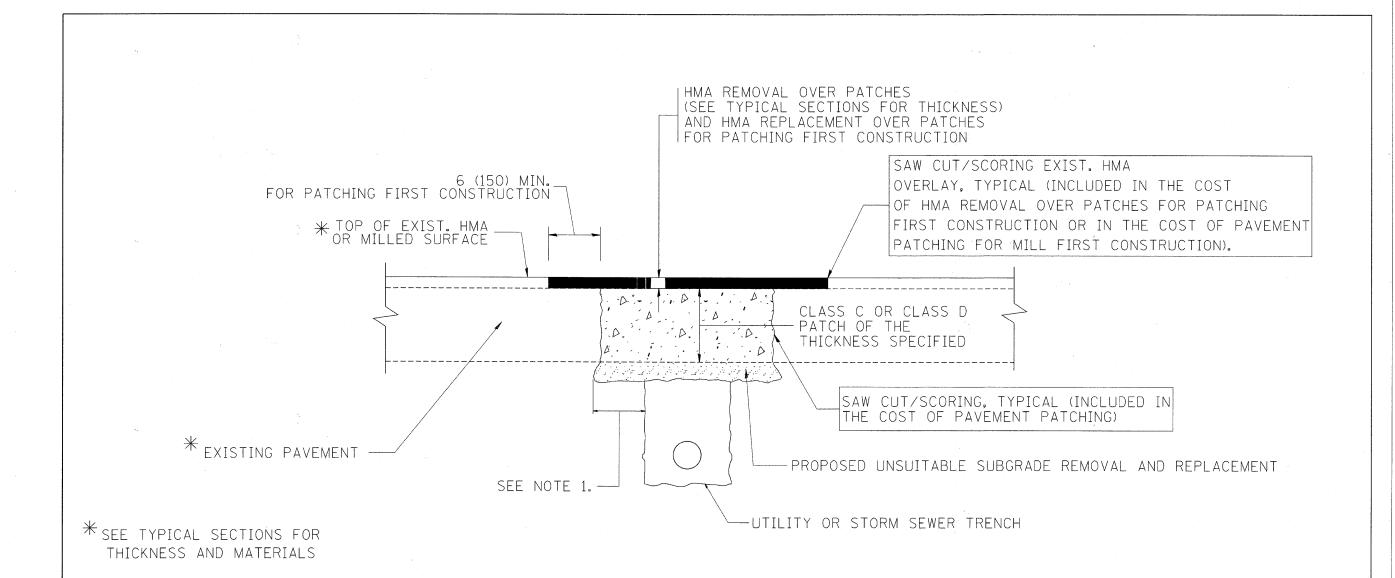- 1. THE WIDTH OF THE FULL DEPTH PATCH OVER A TRENCH SHALL BE 12 (300) WIDER ON EACH SIDE OF THE TRENCH.
- 2. FOR METHOD OF MEASUREMENT AND BASIS OF PAYMENT, SEE RECURRING SPECIAL PROVISION "PATCHING WITH HOT-MIX ASPHALT OVERLAY REMOVAL".

# SEQUENCE OF CONSTRUCTION (PATCHING FIRST)

- 1. REMOVE THE EXISTING HMA MATERIAL OVER THE AREA TO BE PATCHED.
- 2. REMOVE AND REPLACE WITH CLASS C OR D PATCH.
- 3. REPLACE HMA MATERIAL OVER THE AREA TO BE PATCHED.


# SEQUENCE OF CONSTRUCTION (MILLING FIRST)

- 1. MILL HMA FIRST IF THERE IS AT LEAST 41/2 INCHES OR MORE OF HMA MATERIAL ON TOP OF THE EXISTING PAVEMENT OR IF THE PAVEMENT IS FULL DEPTH HMA. A MINIMUM OF 2 INCHES OF HMA MATERIAL SHALL BE IN PLACE AFTER MILLING.
- 2. REMOVE AND REPLACE WITH FULL DEPTH CLASS D PATCHES TO TOP OF MILLED SURFACE.

ALL DIMENSIONS ARE IN INCHES (MILLIMETERS) UNLESS OTHERWISE SHOWN.

FILE NAME =	USER NAME = bauerdl	DESIGNED - R. SHAH	REVISED - A. ABBAS 04-27-98		DAYFRENT DATOUNG COD	F.A. SECTION COUNTY TOTAL SHEET
c:\projects\diststd22x34\bd22.dgn		DRAWN -	REVISED - R. BORO 01-01-07	STATE OF ILLINOIS	PAVEMENT PATCHING FOR	RIE. SHEETS NO.
	PLOT SCALE = 50,000 '/ IN.	CHECKED -	REVISED - R. BORO 09-04-07	DEPARTMENT OF TRANSPORTATION	HMA SURFACED PAVEMENT	BD400-04 (BD-22) CONTRACT NO.
	PLOT DATE = 10/27/2008	DATE - 10-25-94	REVISED - K. ENG 10-27-08		SCALE: NONE SHEET NO. 1 OF 1 SHEETS STA. TO STA.	FED. ROAD DIST. NO. 1 ILLINOIS FED. AID PROJECT
					<u> </u>	

FILE NAME =	USER NAME = ESIDORCZ	DESIGNED -	REVISED -		DISTRICT ONE DETAILS	F.A.U.	SECTION	COUNTY	TOTAL SHEET
N:\ELMW00DPARK\950253.00004\C;v;1\DET_9	50253_02.SHT	DRAWN -	REVISED -	STATE OF ILLINOIS	DISTRICT VINE DETAILS	1374	10 00110 00 1.0	СООК	SHEETS NO.
	PLOT SCALE = 20'	CHECKED -	REVISED -	DEPARTMENT OF TRANSPORTATION		1317	10-00112-00-LS	CONTRAC	CT NO 63600
	PLOT DATE = 5/24/2011	DATE -	REVISED -		SCALE: SHEET NO. OF SHEETS STA. TO STA.		ILLINOIS FED.	AID PROJECT	C1 NO. 03000

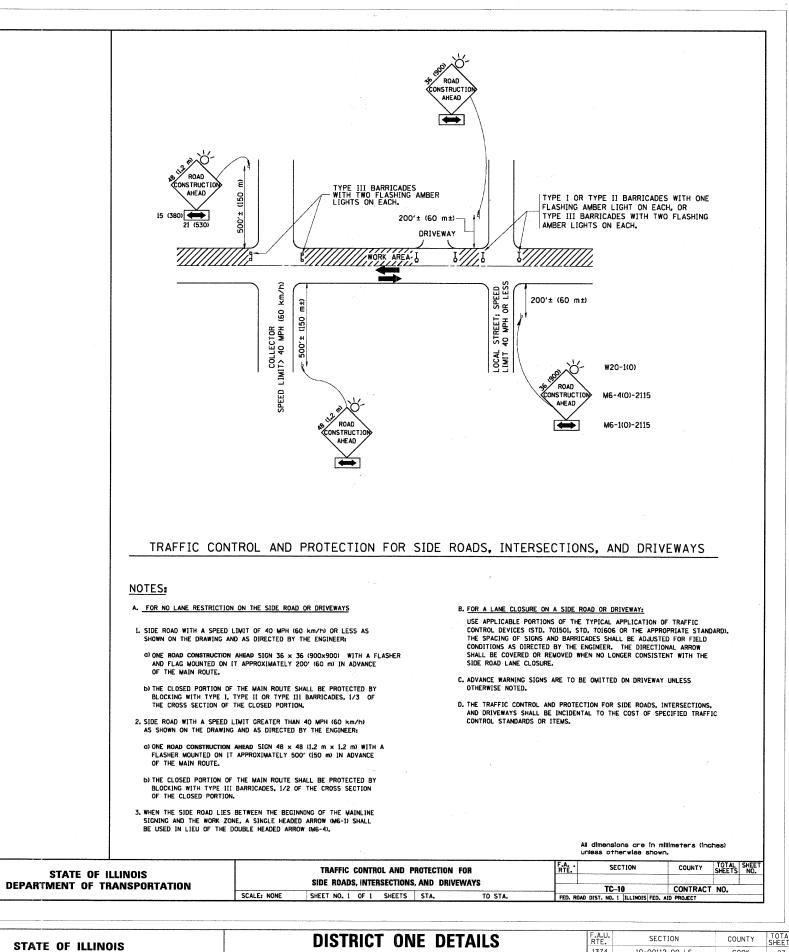

FILE NAME = USER NAME = ESIDORCZ DESIGNED REVISED N:\ELMW00DPARK\950253,00004\C1v1\DET DRAWN REVISED PLOT SCALE = 20' CHECKED PLOT DATE = 5/24/2011 DATE REVISED

USER NAME = gaglianobt

PLOT SCALE = 50.000 '/ IN.

PLOT DATE = 1/4/2008

DESIGNED - LHA

CHECKED

REVISED J. OBERLE 10-18-95

REVISED - A. HOUSEH 03-06-96

REVISED - A. HOUSEH 10-15-96

REVISED -T. RAMMACHER 01-06-00

FILE NAME =

STATE OF ILLINOIS **DEPARTMENT OF TRANSPORTATION** 

SCALE:

SHEET NO. OF SHEETS STA.

1374 10-00112-00-LS COOK 23 CONTRACT NO. 63608 ILLINOIS FED. AID PROJECT

