INDEX OF SHEETS

- 1 TITLE SHEET
- 2 GENERAL NOTES, IDOT STANDARD DETAILS, AND SUMMARY OF QUANTITIES
- 3 TYPICAL SECTIONS
- 4-5 ALIGNMENT AND TIES PLAN
- 6-11 EXISTING CONDITIONS
- 12-17 LIGHTING AND ELECTRICAL PLANS
- 18 WEST BARTLETT ROAD WIRING DIAGRAM
- 19-24 LANDSCAPE PLANS
- 25-29 CONSTRUCTION DETAILS
- 30 DETAILS AND PLANT LIST

STATE OF ILLINOIS
DEPARTMENT OF TRANSPORTATION
DIVISION OF HIGHWAYS

PLANS FOR PROPOSED FEDERAL AID HIGHWAY

FAU 1344 (WEST BARTLETT ROAD)

EAST OF IL ROUTE 59 TO WESTERN AVENUE


STREETSCAPE IMPROVEMENTS SECTION NO. 10-00085-00-LT

PROJECT NO. TE-00D1(833)

VILLAGE OF BARTLETT

COOK COUNTY


C--91-778-10

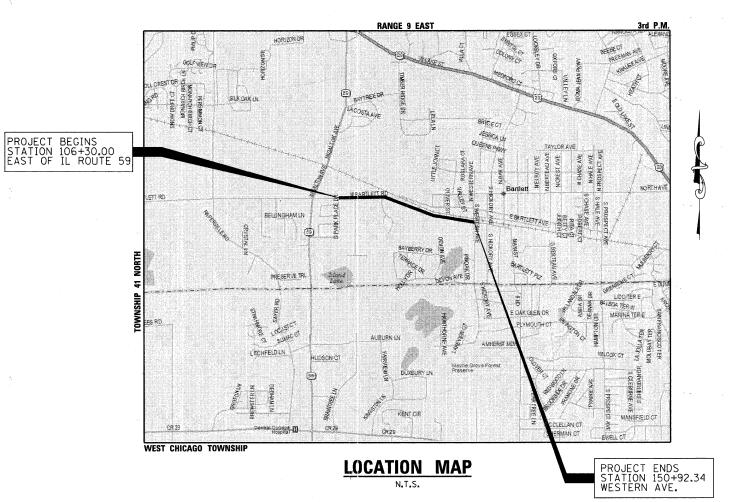

ROADWAY CLASSIFICATION
WEST BARTLETT ROAD - MINOR URBAN ARTERIAL

TRAFFIC DATA 2006 - 11,000 ADT 2030 - 16,000 ADT

SPEED POSTED - 35 /40 /45 MPH

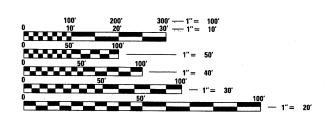


FULL SIZE PLANS HAVE BEEN PREPARED USING STANDARD ENGINEERING SCALES. REDUCED SIZED PLANS WILL NOT CONFORM TO STANDARD SCALES. IN MAKING MEASUREMENTS ON REDUCED PLANS, THE ABOVE SCALES MAY BE USED.


J.U.L.I.E.
JOINT UTILITY LOCATION INFORMATION FOR EXCAVATION
1–800–892–0123
OR 811



PROJECT ENGINEER: HEIDI E. VOIROL, P.E., LEED AP PROJECT MANAGER: MICHAEL J. RECHTORIK, P.E.

GROSS LENGTH = 4462 FEET (0.845 MILES)
NET LENGTH = 4462 FEET (0.845 MILES)

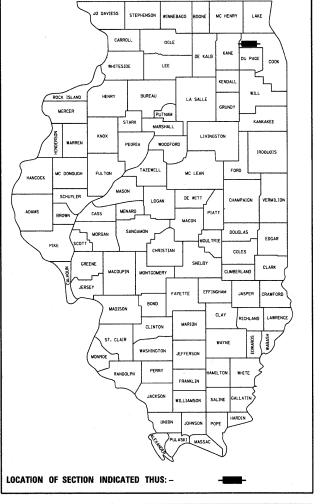

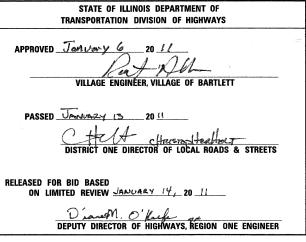



PRINTED BY THE AUTHORITY OF THE STATE OF ILLINOIS

PROGRAM AND OFFICE ENGINEER: CHARLES F. RIDDLE, P.E. 847-705-44

CONTRACT NO. 63512

LIST OF IDOT STANDARDS

000001-06 STANDARD SYMBOLS, ABBREVIATIONS AND PATTERNS
701502-04 URBAN LANE CLOSURE 2L, 2W, WITH BIDIRECTIONAL LEFT TURN LANE
701901-01 TRAFFIC CONTROL DEVICES
814001-02 HANDHOLES

GENERAL NOTES:

- 1. ALL CONSTRUCTION SHALL BE IN ACCORDANCE WITH THE "STANDARD SPECIFICATIONS FOR ROAD AND BRIDGE CONSTRUCTION" ADOPTED JANUARY 1, 2007: THE "SUPPLEMENTAL SPECIFICATIONS AND RECURRING SPECIAL PROVISIONS" ADOPTED JANUARY 1, 2011: THE LATEST EDITION OF THE "ILLINOIS MANUAL ON UNIFORM TRAFFIC CONTROL DEVICES FOR STREETS AND HIGHWAYS" (MUTCD): THE DETAILS IN THE PLANS; AND THE "SPECIAL PROVISIONS" INCLUDED IN THE CONTRACT DOCUMENT.
- 2. ALL REFERENCES TO "ENGINEER" SHALL BE INTERPRETED TO MEAN THE RESIDENT ENGINEER.
- 3. PRIOR TO COMMENCEMENT OF CONSTRUCTION, THE CONTRACTOR SHALL VERIFY ALL DIMENSIONS AFFECTING THE WORK WITH THE ACTUAL CONDITIONS AT THE JOB SITE. IF THERE ARE DISCREPANCIES FROM WHAT IS SHOWN ON THE CONSTRUCTION PLANS, HE/SHE MUST REPORT SAME TO THE ENGINEER BEFORE DDING WORK. IN THE EVENT OF DISAGREEMENT BETWEEN THE CONSTRUCTION PLANS, STANDARD SPECIFICATION AND / OR SPECIAL DETAILS, THE CONTRACTOR SHALL SECURE WRITTEN INSTRUCTION FROM THE ENGINEER PRIOR TO PROCEEDING WITH THE WORK AFFECTED BY OMISSION OR DISCREPANCIES, FAILING TO SECURE SUCH INSTRUCTION, THE CONTRACTOR WILL BE CONSIDERED TO HAVE PROCEEDED AT HIS/HER OWN RISK AND EXPENSE. IF DOUBT OR QUESTIONS ARISE WITH RESPECT TO THE TRUE MEANING OF THE CONSTRUCTION PLANS OR SPECIFICATIONS, THE DECISION OF THE ENGINEER SHALL BE FINAL.
- 4. THE CONTRACTOR SHALL BE RESPONSIBLE FOR THE ESTABLISHMENT OF FINISHED GRADE. THE RESIDENT ENGINEER MAY ASSIST THE CONTRACTOR. AS APPLICABLE. BUT THE RESPONSIBILITY FOR COORDINATING THE FINISHED GRADE ELEVATION WITH THE TOP OF THE FOUNDATION HEIGHTS AND THE LIGHT SHALL REMAIN WITH THE CONTRACTOR.
- 5. IT IS THE CONTRACTOR'S RESPONSIBILITY TO ASCERTAIN EXISTING FIELD CONDITIONS BASED ON A FIELD INSPECTION PRIOR TO BIDDING ON THE PROJECT.
- 6. BEFORE STARTING EXCAVATION. THE CONTRACTOR SHALL CALL "JULIE: (JOINT UTILITY LOCATION INFORMATION FOR EXCAVATIONS) AND THE VILLAGE OF BARTLETT PUBLIC WORKS FOR FIELD LOCATIONS OF BURIED UTILITIES (48 HOURS NOTIFICATION IS REQUIRED). CONTRACTOR TO VERIFY LOCATION OF ALL UNDERGROUND UTILITIES BEFORE TRENCHING OR AUGERING.
- 7. NO WORK SHALL COMMENCE UNTIL TRAFFIC CONTROL REQUIREMENTS ARE MET TO THE SATISFACTION OF THE ENGINEER.
- 8. THE CONTRACTOR SHALL PROTECT AND CAREFULLY PRESERVE ALL SECTION OR SUBSECTION MONUMENTS, PROPERTY CORNERS, AND REFERENCE MARKERS UNTIL THE OWNERS, HIS AGENT, OR AND AUTHORIZED SURVEYOR HAS WITNESSED OR OTHERWISE REFERENCED THEIR LOCATION.
- UNLESS OTHERWISE AUTHORIZED BY THE ENGINEER. ACCESS TO ALL EXISTING DRIVES SHALL BE MAINTAINED AT ALL TIMES BY THE CONTRACTOR.
- 10. ALL WORK SHALL CONFORM TO THE NATIONAL ELECTRICAL CODE AND ANY APPLICABLE LOCAL CODES.
- 11. BEFORE INSTALLING STANDARDS NEAR OVERHEAD FACILITIES CALL COMED FOR APPROVAL OF LOCATION. CONTACT KATHY NYSTROM. GENERAL SERVICE REPRESENTATIVE AT 847-608-2331.
- 12. THE CONTRACTOR SHALL STAKE THE LOCATIONS OF ALL LIGHT POLE FOUNDATIONS FOR REVIEW BY THE VILLAGE. ENGINEER, AND COMED. IF CONFLICTS EXIST WITH UNDERGROUND AND/OR OVERHEAD UTILITIES. THE POLE LOCATIONS MAY BE SHIFTED TO AVOID UTILITY CONFLICTS. THE FINAL DECISION WILL BE MADE BY THE VILLAGE.
- 13. CONDUIT MUST BE POSITIONED IN THE FIELD TO AVOID CONFLICTS WITH TREES, BUSHES, DRAINS AND OTHER UTILITIES AND LANDSCAPING.
- 14. ALL CONDUIT SHALL BE PUSHED UNDER ROADWAYS, DRIVEWAYS, SIDEWALKS AND BIKEPATHS UNLESS NOTED ON PLANS OR DIRECTED BY THE ENGINEER.
- 15. ANY TREE TRIMMING REQUIRED AS DIRECTED BY THE ENGINEER SHALL BE PERFORMED BY THE CONTRACTOR, AND THE COST OF THIS WORK SHALL BE INCLUDED IN THE COST OF THE LIGHT POLE ITEMS.

SUMMARY OF QUANTITIES


						•	:
Γ					CON: ROADWAY	STRUCTION TYPE (ROADWAY	CODE ROADWAY
	PAY ITEM NUMBER	DESCRIPTION	UNITS	TOTAL QUANTITY	80% FEDERAL	50% FEDERAL	0% FEDERAL
1	71071101117				20% LOCAL 0031	50% LOCAL 0021	100% LOCAL 0021
*	20101700	SUPPLEMENTAL WATERING	UNIT	143	143		~
			ACRE	0.9	0.9		-
*	25000210	SEEDING, CLASS 2A					
*	25000400	NITROGEN FERTILIZER NUTRIENT	POUND	9	9	•	-
*	25000500	PHOSPHORUS FERTILIZER NUTRIENT	POUND	9	9		-
*	25000600	POTASSIUM FERTILIZER NUTRIENT	POUND	9	9		-
*	25100630	EROSION CONTROL BLANKET	SQ YD	4341	4341	-	-
ŀ	67100100	MOBILIZATION	LSUM	1	1	-	-
ļ	70102622	TRAFFIC CONTROL AND PROTECTION, STANDARD 701502	LSUM	1	1		-
þ	80400100	ELECTRIC SERVICE INSTALLATION	EACH	1		1	-
ŀ	80400200	ELECTRIC UTILITY SERVICE CONNECTION	LSUM	1	_	1	-
ŀ	81000600	CONDUIT IN TRENCH, 2" DIA., GALVANIZED STEEL	FOOT	40	-	40	-
F	81018900	CONDUIT PUSHED, 4" DIA., GALVANIZED STEEL	FOOT	984	-	984	··
F	81400100	HANDHOLE	EACH	2	-	2	-
F	81603025	UNIT DUCT, 600V, 2-1C NO.4, 1/C NO.4 GROUND, (XLP-TYPE USE), 1" DIA. POLYETHYLENE	FOOT	500	_	500	-
	81603035	UNIT DUCT, 600V, 2-1C NO.6, 1/C NO.6 GROUND, (XLP-TYPE USE), 1" DIA. POLYETHYLENE	FOOT	540		540	
ŀ	81603100	UNIT DUCT, 600V, 4-1C NO.6, 1/C NO.6 GROUND, (XLP-TYPE USE), 1 1/4" DIA. POLYETHYLENE	FOOT	2433	-	2433	-
	81603105	UNIT DUCT, 600V, 4-1C NO.4, 1/C NO.4 GROUND, (XLP-TYPE USE), 1 1/2" DIA. POLYETHYLENE	FOOT	5193	-	5193	-
ŀ	81702150	ELECTRIC CABLE IN CONDUIT, 600V (XLP-TYPE USE) 1/C NO. 2	FOOT	80	-	80 -	-
L	81900200	TRENCH AND BACKFILL FOR ELECTRICAL WORK	FOOT	7453	•	7453	-
F	X83601ZO	LIGHT POLE FOUNDATION, SPECIAL	EACH	35		35	-
F	84200500	REMOVAL OF LIGHTING UNIT, SALVAGE	EACH	1	. •	1	-
ļ	84200804	REMOVAL OF POLE FOUNDATION	EACH	1	*	1	
*	A2000320	TREE, ACER MIYABEI MORTON (STATE STREET MIYABE MAPLE), 2-1/2" CALIPER, BALLED AND BURLAPPED	EACH	8	8	*	
*	A2006520	TREE, QUERCUS BICOLOR (SWAMP WHITE OAK), 2-1/2" CALIPER, BALLED AND BURLAPPED	EACH	8	8		-
*	A2007120	TREE, QUERCUS RUBRA (RED OAK), 2-1/2" CALIPER, BALLED AND BURLAPPED	EACH	18	18	-	-
*	B2000770	TREE, AMELANCHIER X GRANDIFLORA AUTUMN BRILLIANCE (AUTUMN BRILLIANCE SERVICE BERRY),	EACH	39	39	-	-
*	B2001116	2" CALIPER, TREE FORM, BALLED AND BURLAPPED TREE, CERCIS CANADENSIS (EASTERN REDBUD), 2" CALIPER, TREE FORM, BALLED AND BURLAPPED	EACH	11	11	-	-
*	B2001620	TREE, CRATAEGUS CRUSGALLI INERMIS (THORN LESS COCKSPUR HAWTHORN), 2-1/2" CALIPER TREE	EACH	18	18	-	*
*	B2006316	FORM, BALLED AND BURLAPPED TREE, SYRINGA RETICULATA IVORY SILK (IVORY SILK JAPANESE TREE LILAC), 2" CALIPER, TREE	EACH	57	57	•	-
-	X8250500	FORM, BALLED AND BURLAPPED LIGHTING UNIT COMPLETE, SPECIAL	EACH	35	-	35	
F	X8250505	LIGHTING CONTROLLER, SPECIAL	EACH	1	_	1	_
-	Z0013798	CONSTRUCTION LAYOUT	LSUM	1	1	-	-
*	XX004533	SOIL PLANTING MIXTURE	CU YD	2.3	2.3	_	
	XX004333	POLE MOUNTED PLANTER BASKET	EACH	70	2.3	-	70
*				700	· · · · · · · · · · · · · · · · · · ·		70
ار	XX008195	EXPLORATION EXCAVATION (UTILITY)	FOOT		700	-	0.00
*	XX008491	SEASONAL ANNUALS	UNIT	9.92	-	-	9.92
	B2007068	TREE, MALUS PURPLE PRINCE (PURPLE PRINCE CRABAPPLE), 2-1/2" CALIPER, TREE FORM, BALLED AND BURLAPPED	EACH	25	25	-	-
	82013470	TREE, MALUS GOLDEN RAINDROPS (GOLDEN RAINDROPS CRABAPPLE), 2-1/2" CALIPER, TREE FORM, BALLED AND BURLAPPED	EACH	34	34	-	-
*	B200 4 7/2	TREE, MALUS ROYAL RAINDROPS (ROYAL RAINDROPS CRABAPPLE), 2-1/2" CALIPER, TREE FORM, BALLED AND BURLAPPED	EACH	16	16	- ′	-
				•			

* SPECIALTY ITEMS

SCALE: NONE


V3 Companies 7325 Janes Avenue	USER NAME = \$USER\$	DESIGNED - HEV	REVISED -
Woodridge, IL 60517 630.724.9200 phone		DRAWN - DRP	REVISED -
630.724.9202 fax www.v3cc.com	PLOT SCALE = \$SCALE\$	CHECKED - MJR	REVISED -
Visio, Vertere, Virtute The Vision to Transform with Excellence*	PLOT DATE = 1/18/2011	DATE - 12-22-10	REVISED -

(GENER	AL	N	OTE	S, I	IDOT	STA	NDARD	DETAILS	,
		AN	D	SUI	VIN	//ARY	0F	QUANT	ITIES	
	CHEET	NO	1	OF	1	CHEET	re			***********

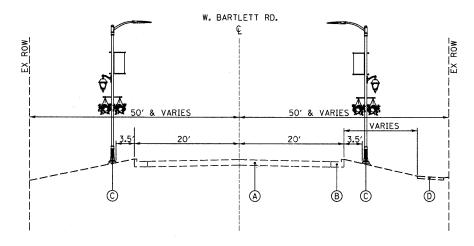

PROPOSED TYPICAL SECTION

STA. 106+30 TO STA. 145+30 (LOOKING EAST), W. BARTLETT ROAD

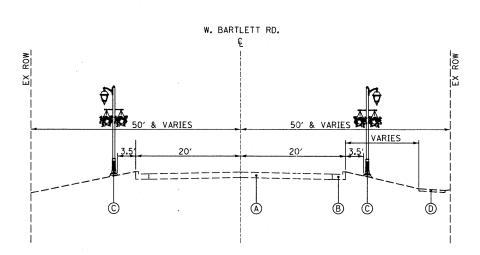


PROPOSED TYPICAL SECTION


STA. 145+30 TO STA. 150+30 (LOOKING EAST), W. BARTLETT ROAD


LEGEND


- A EXISTING PAVEMENT
- B EXISTING CONCRETE CURB AND GUTTER (TYPE VARIES)
- C PROPOSED LIGHT POLE
- D EXISTING SIDEWALK / BIKE PATH


| V3 Companies | T325 Janes Avenue | T325 Jane

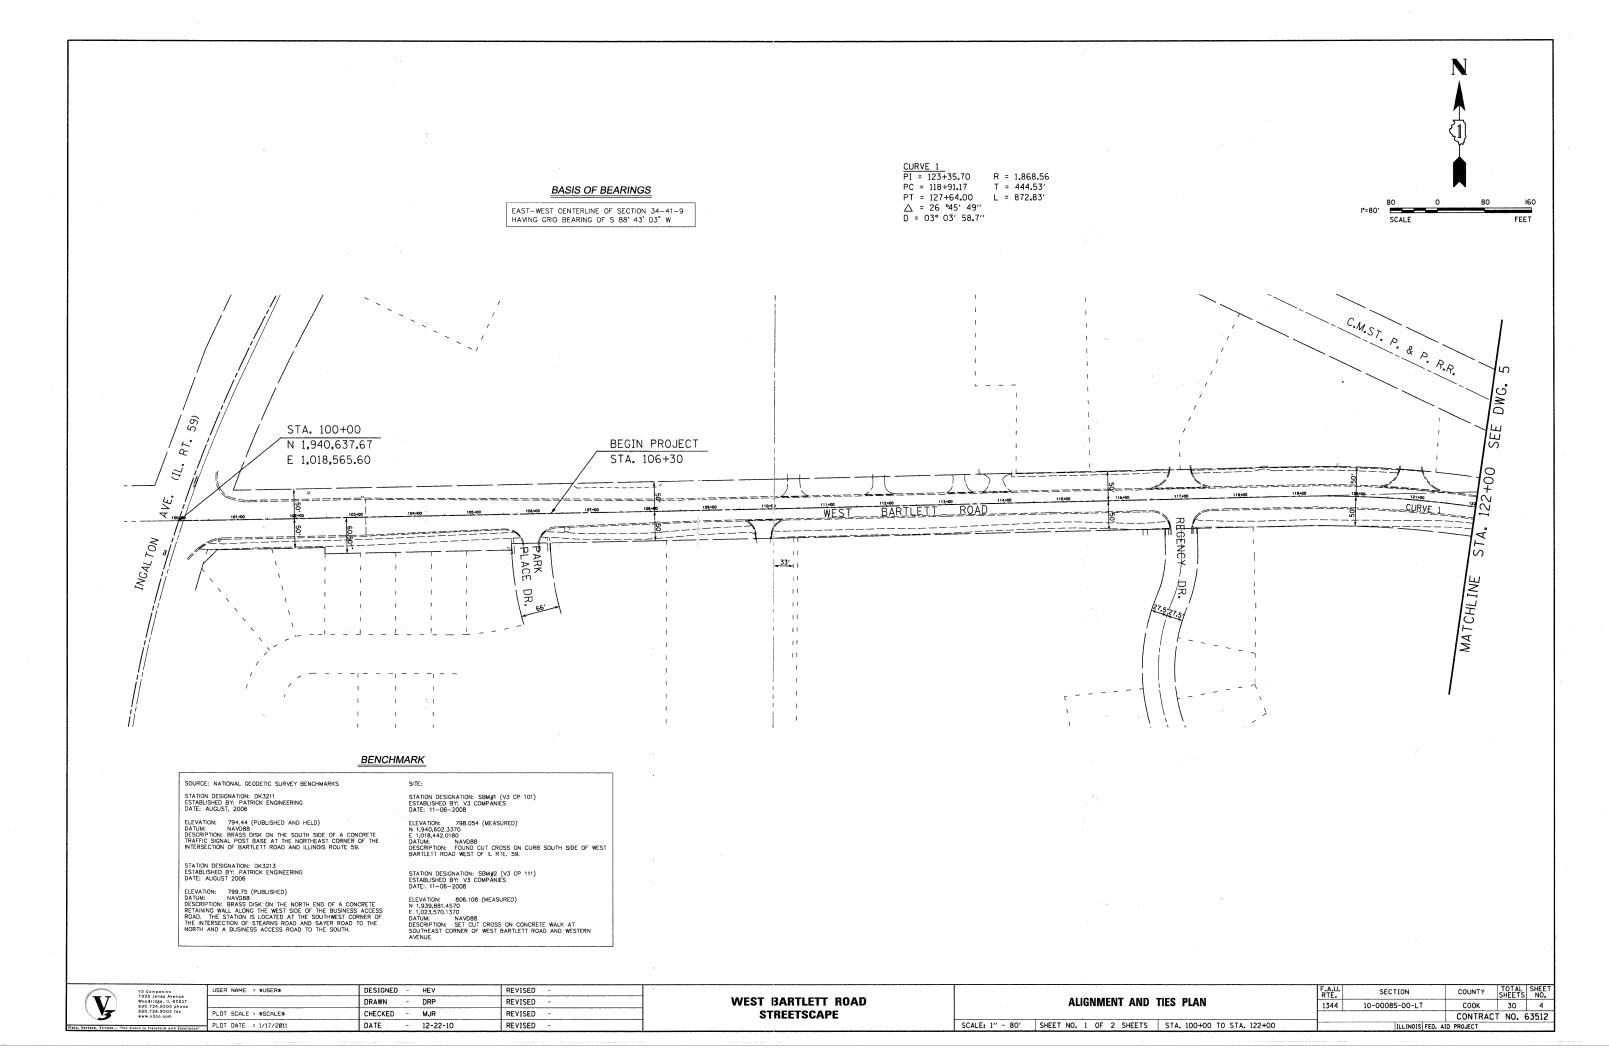


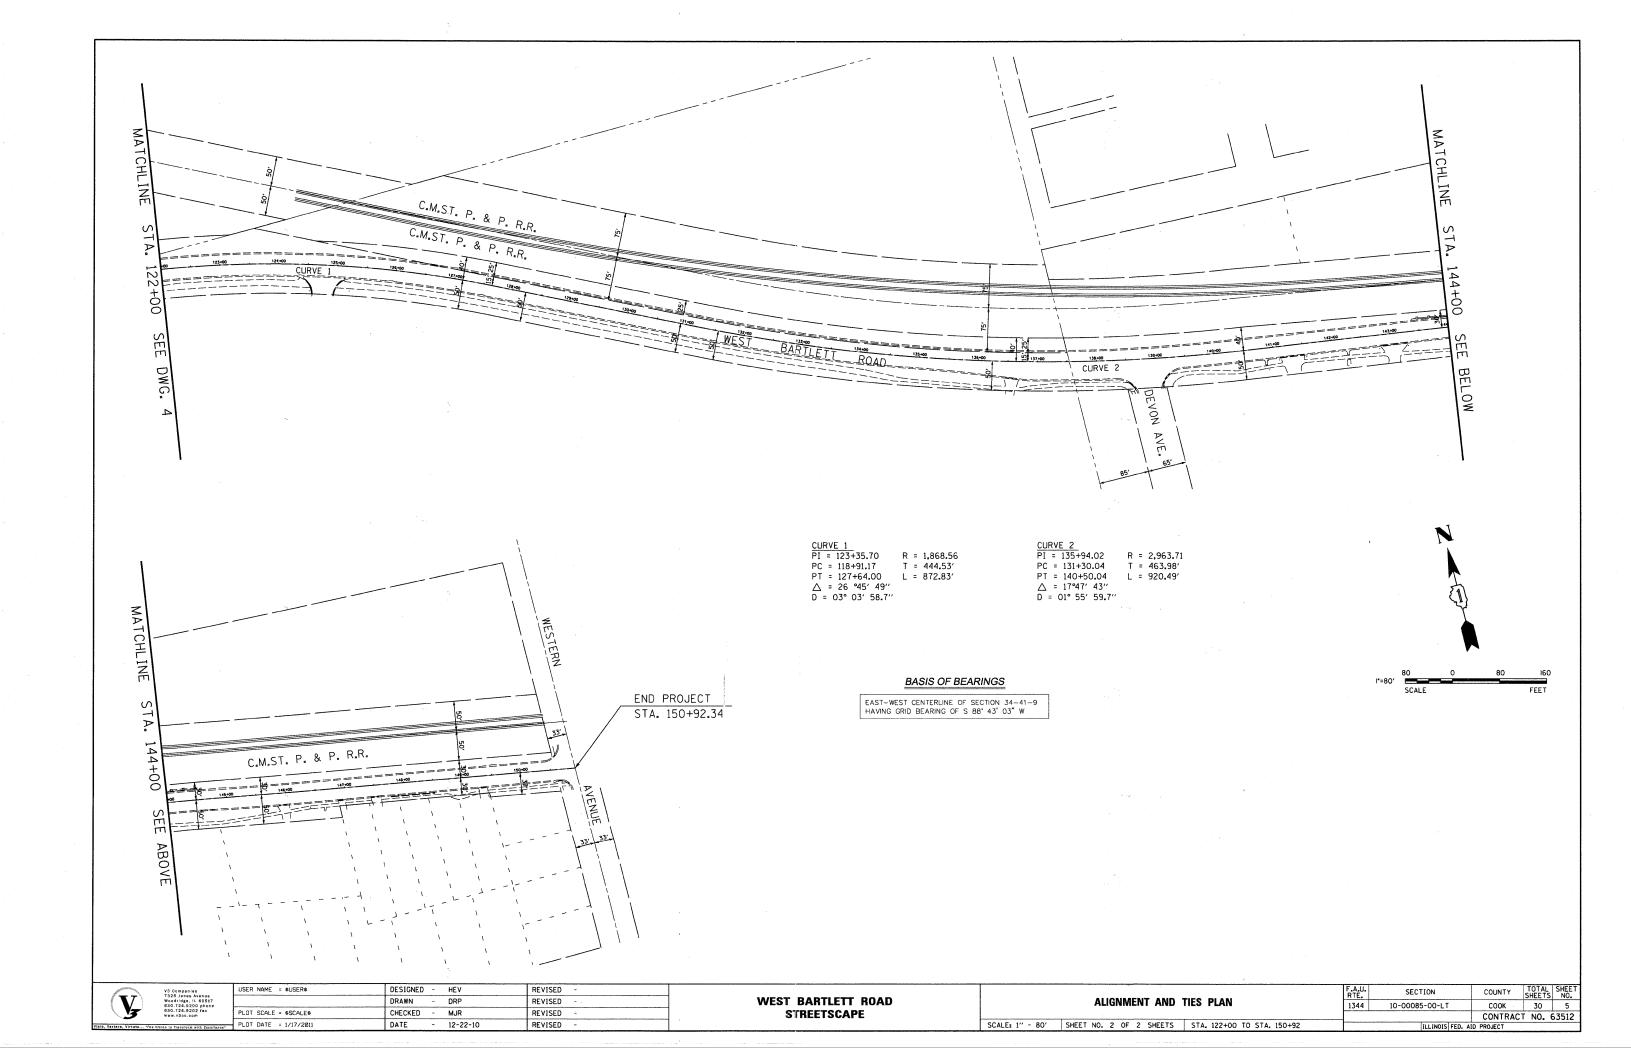

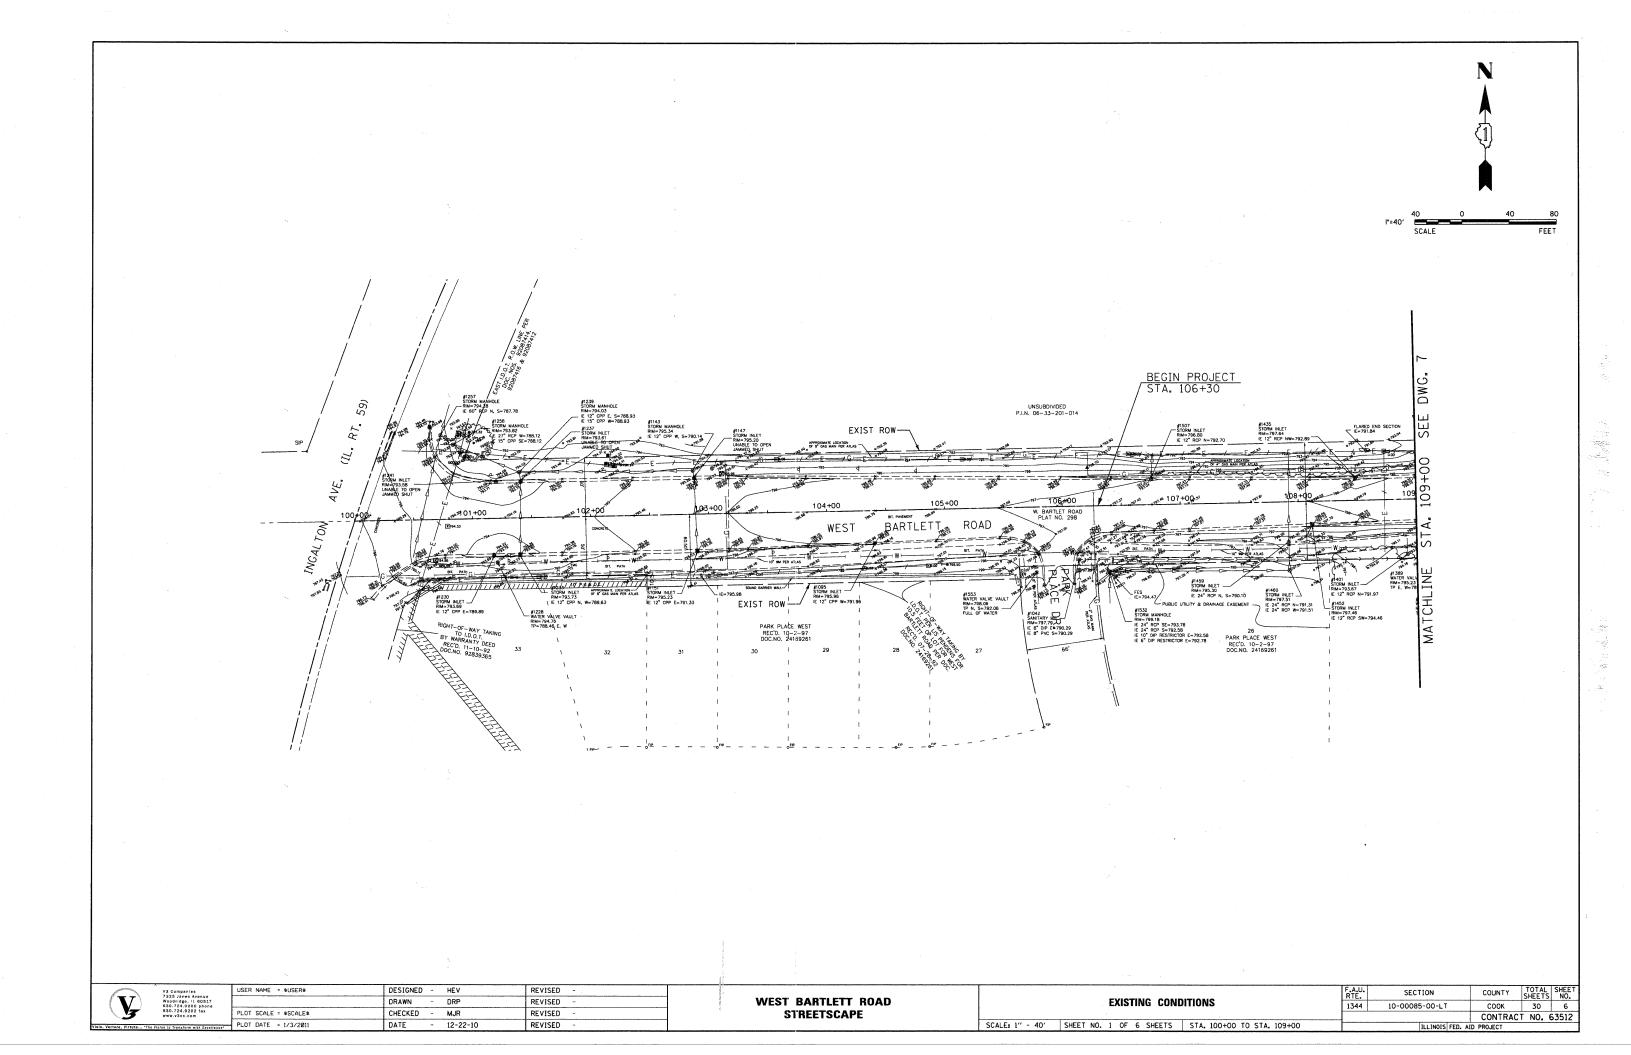


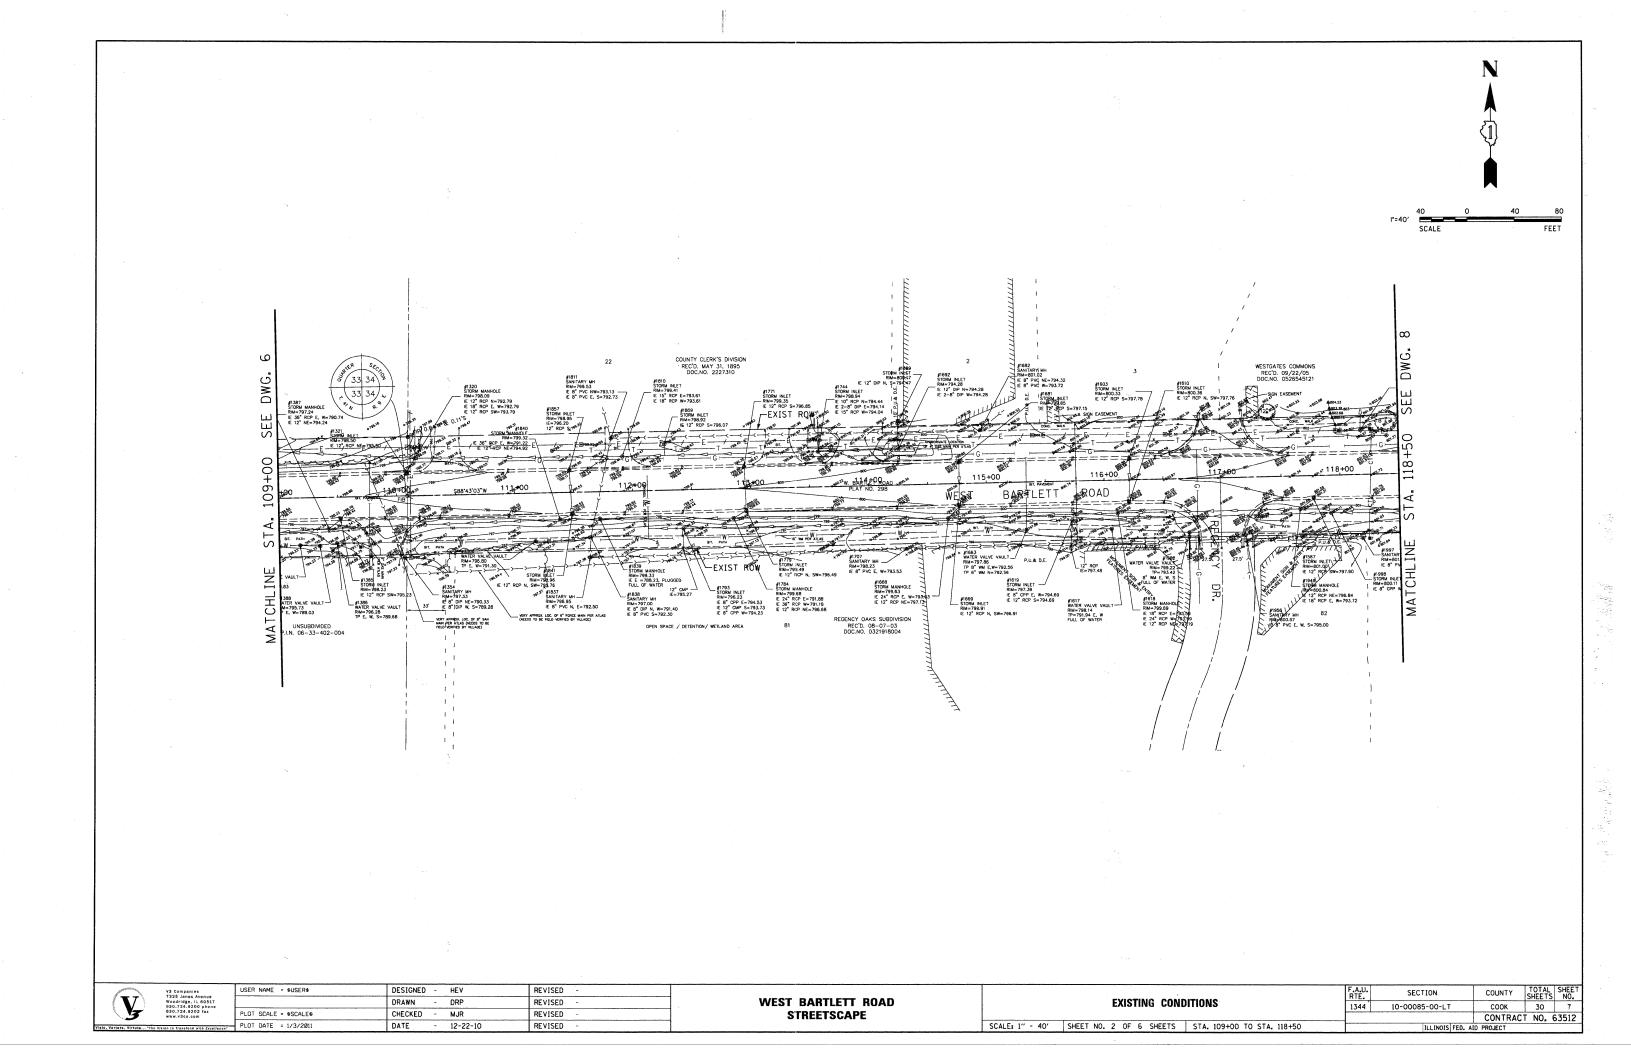


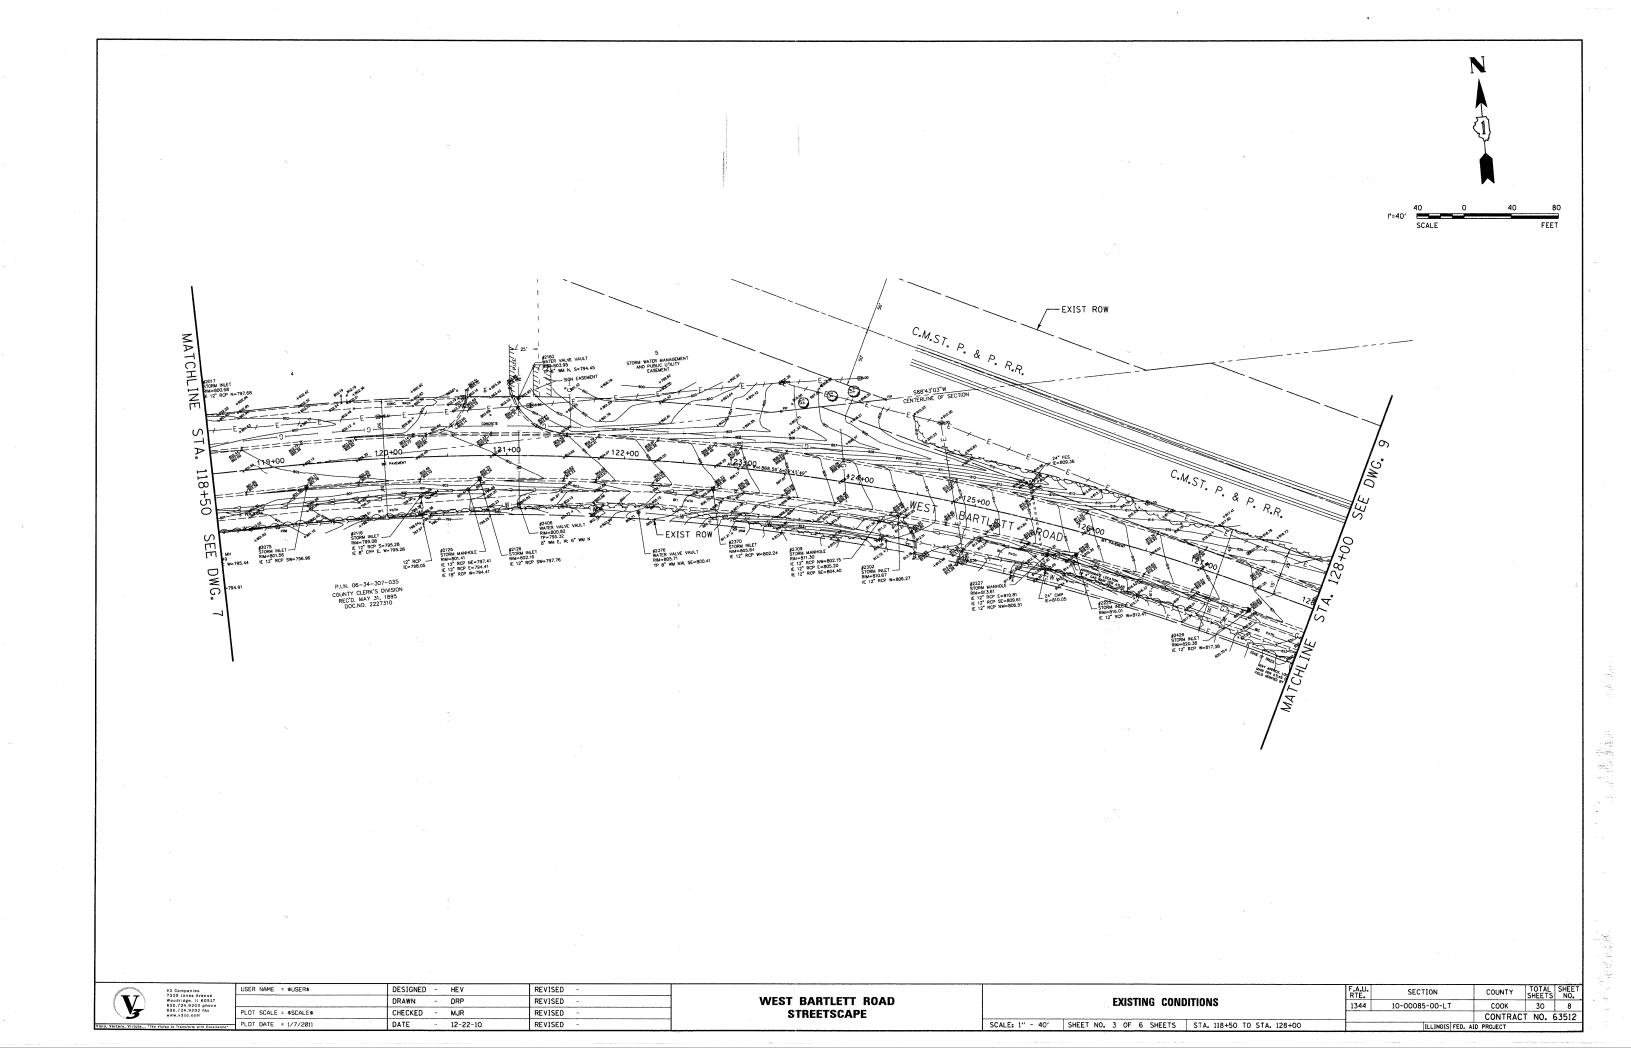


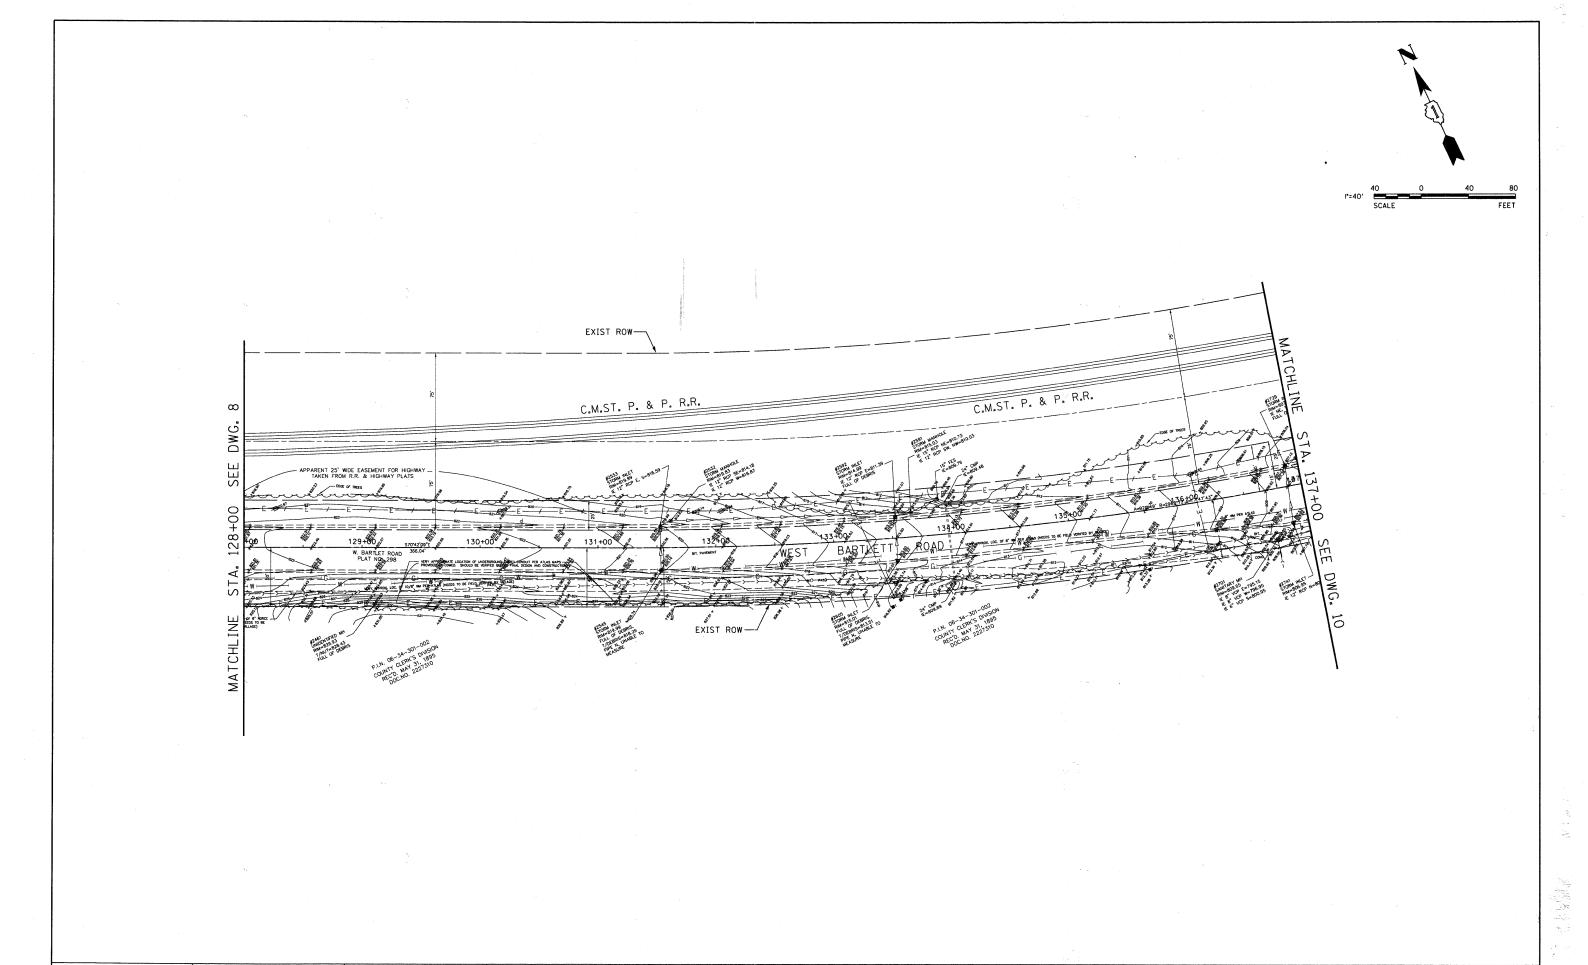


V3 Companies
1223 Janes Avenues
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201724-2020 phan

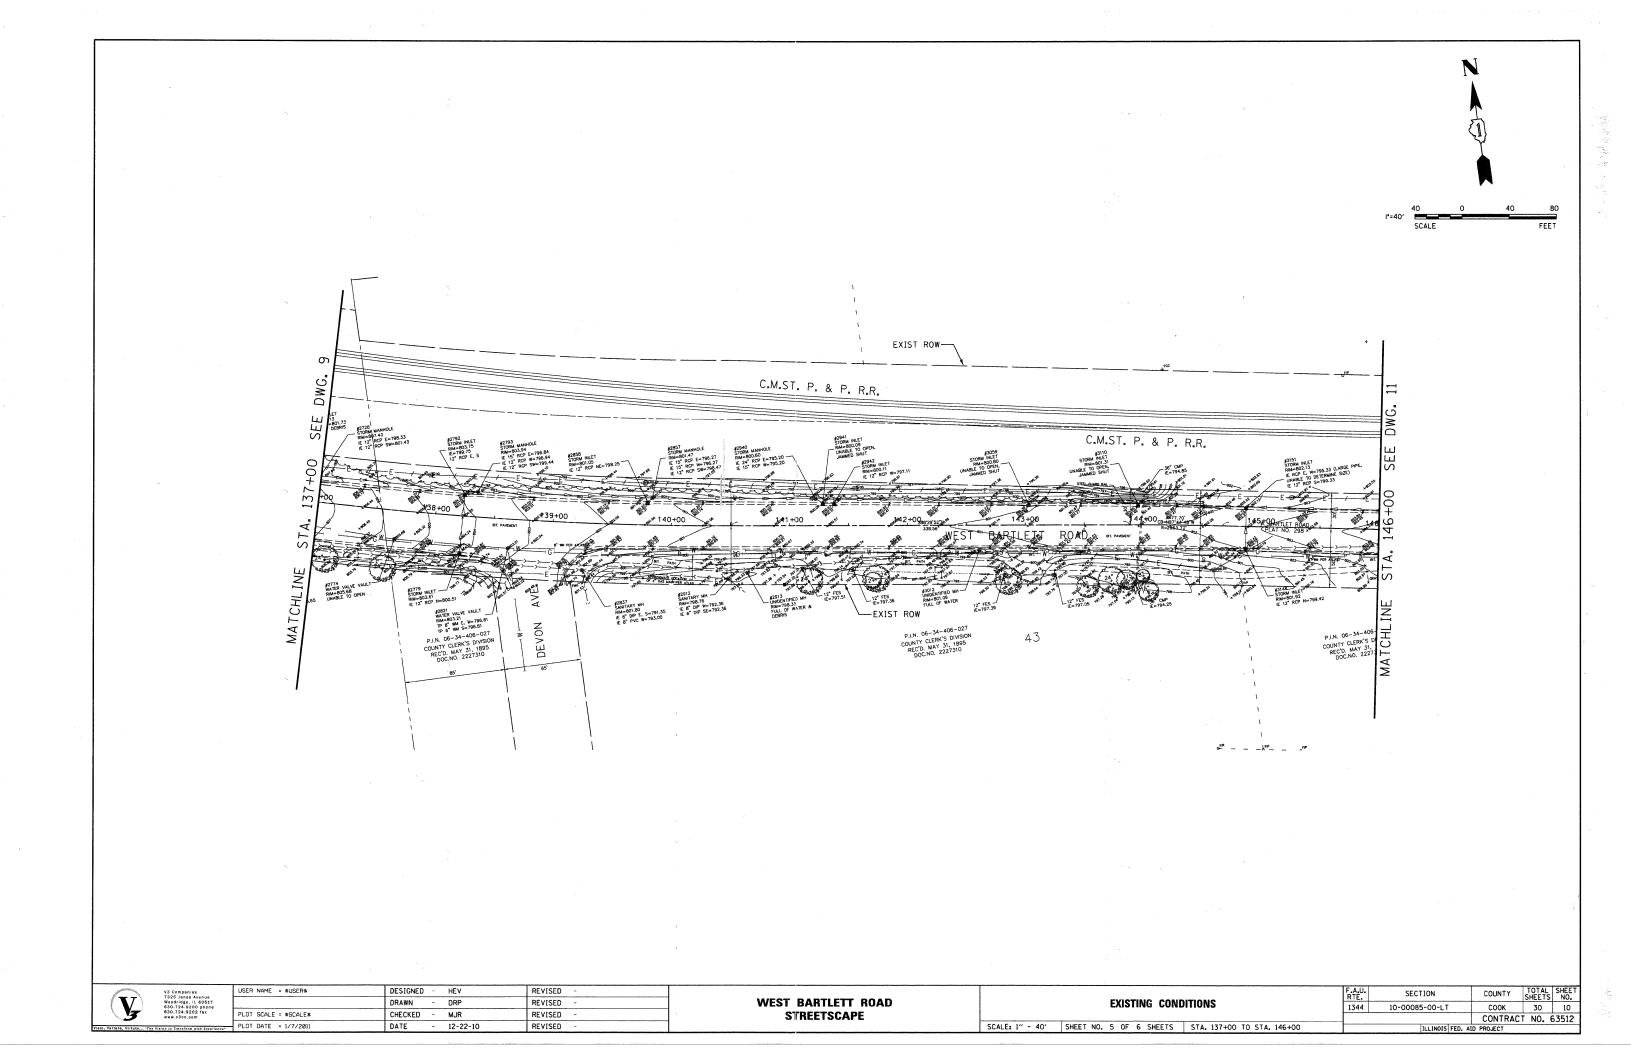


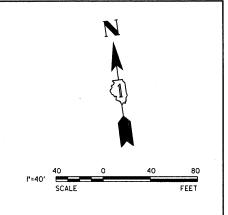


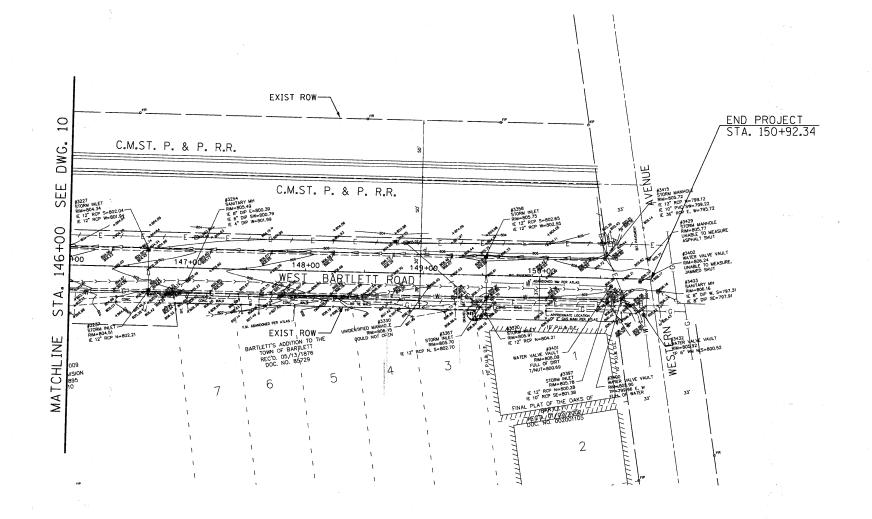



ppan ppan	V3 Companies	USER NAME = \$USER\$	DESIGNED - HEV	REVISED -	,		F.A.U.	SECTION	COUNTY	TOTAL	SHEET
/	Woodridge, IL 60517		DRAWN - DRP	REVISED -	WEST BARTLETT ROAD	EXISTING CONDITIONS	1344	10-00085-00-LT	COOK	SHEETS	NU.
	630.724.9202 fax www.v3co.com	PLOT SCALE = \$SCALE\$	CHECKED - MJR	REVISED -	STREETSCAPE		1344	10-00065-00-L1	CONTRAC	CT NO	63512
Viela Varrara Vie		PLOT DATE = 1/7/2011	DATE - 12-22-10	REVISED -		SCALE: 1" - 40' SHEET NO. 6 OF 6 SHEETS STA. 146+00 TO STA. 150+92	-			CI NO.	33312
viole, vertere, vi-	rater" . I've Aibles to Linualolu Mitt Excellence.		DE 10 10	NE 110ED		SCALLE 1 40 SILL 1 NO. 0 01 0 SHEETS STA. 140400 TO STA. 150432	1	(ILLINOIS) FED.	AID PROJECT		

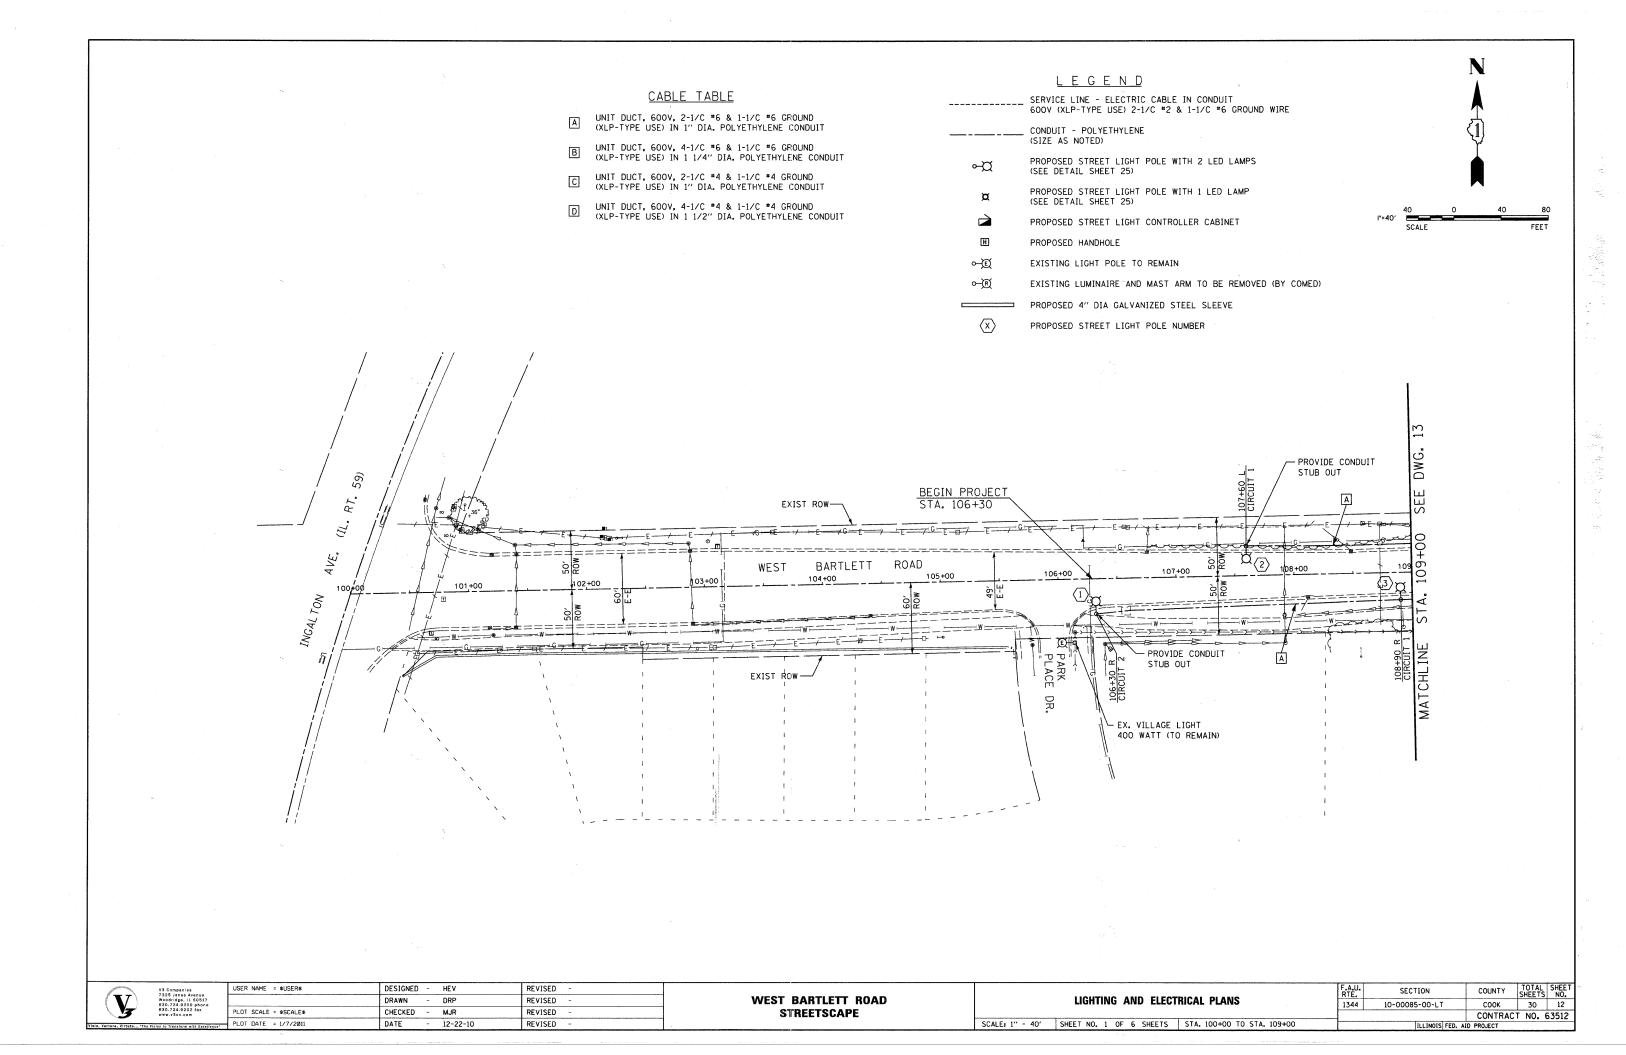


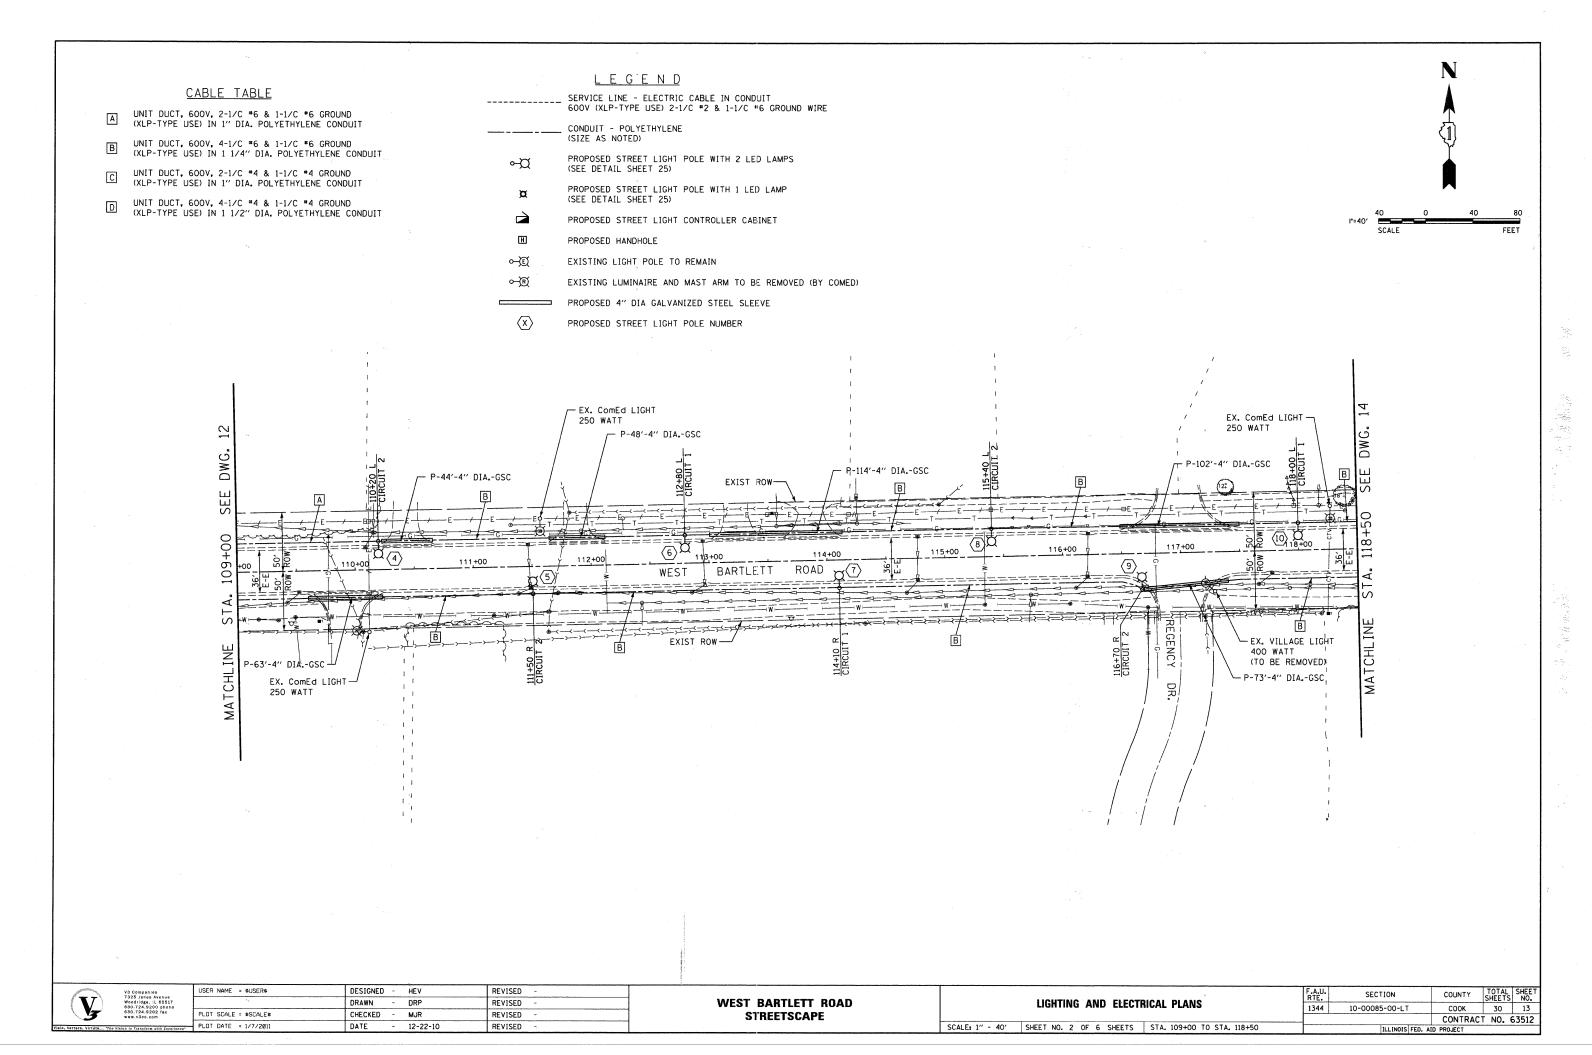


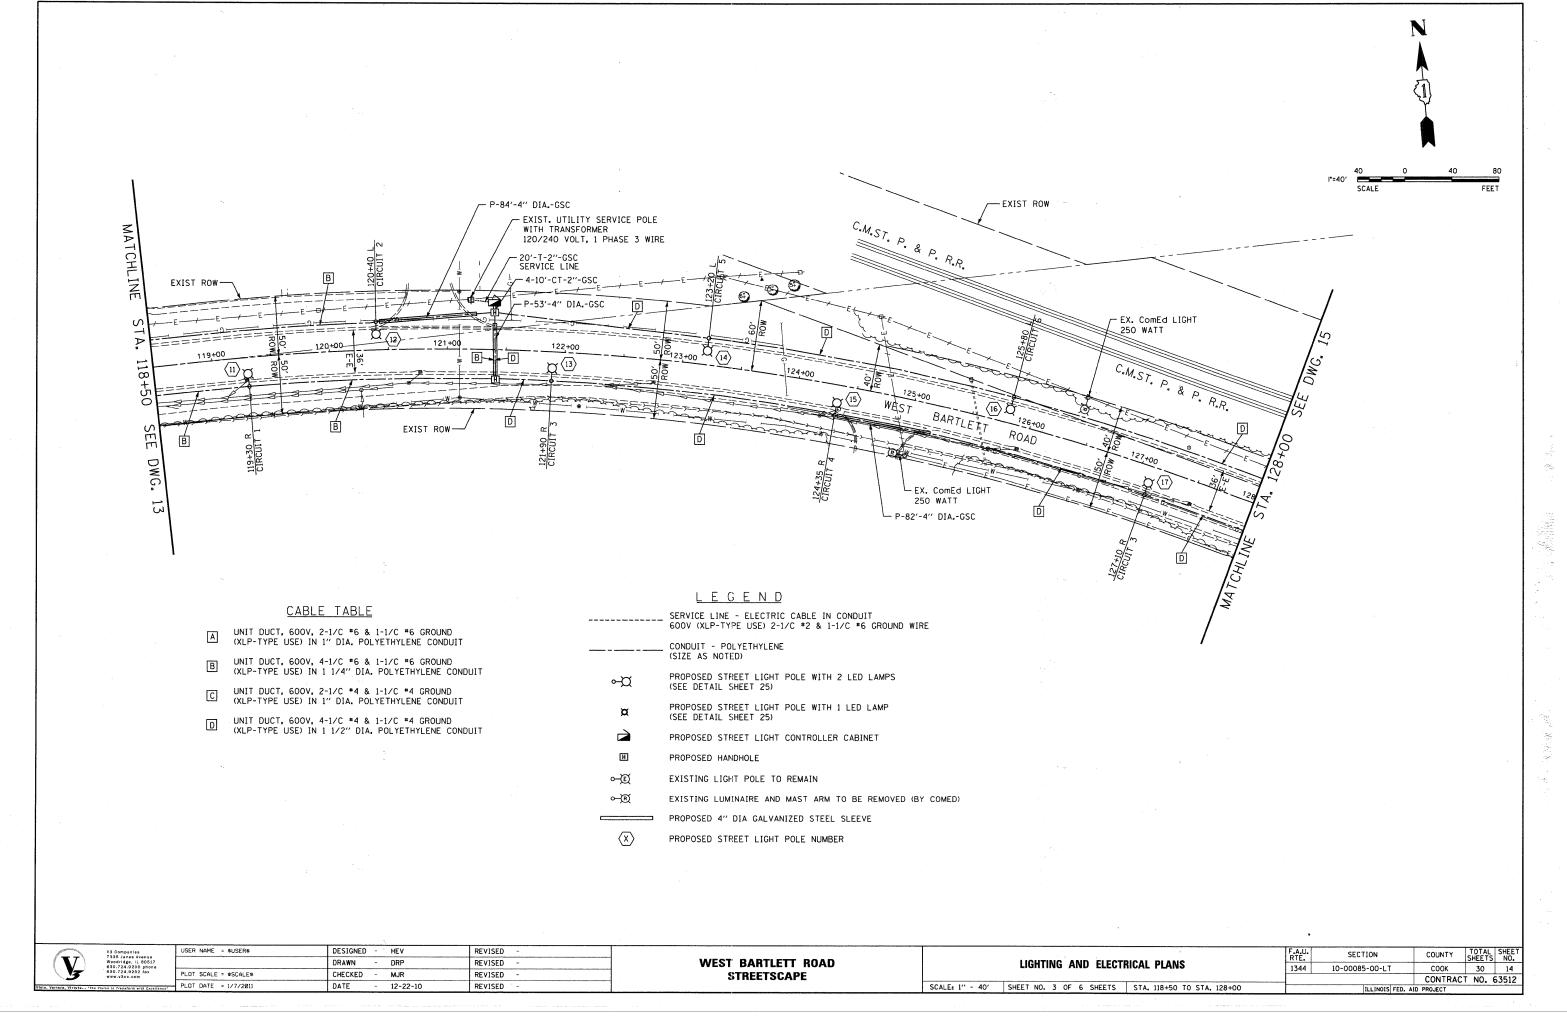

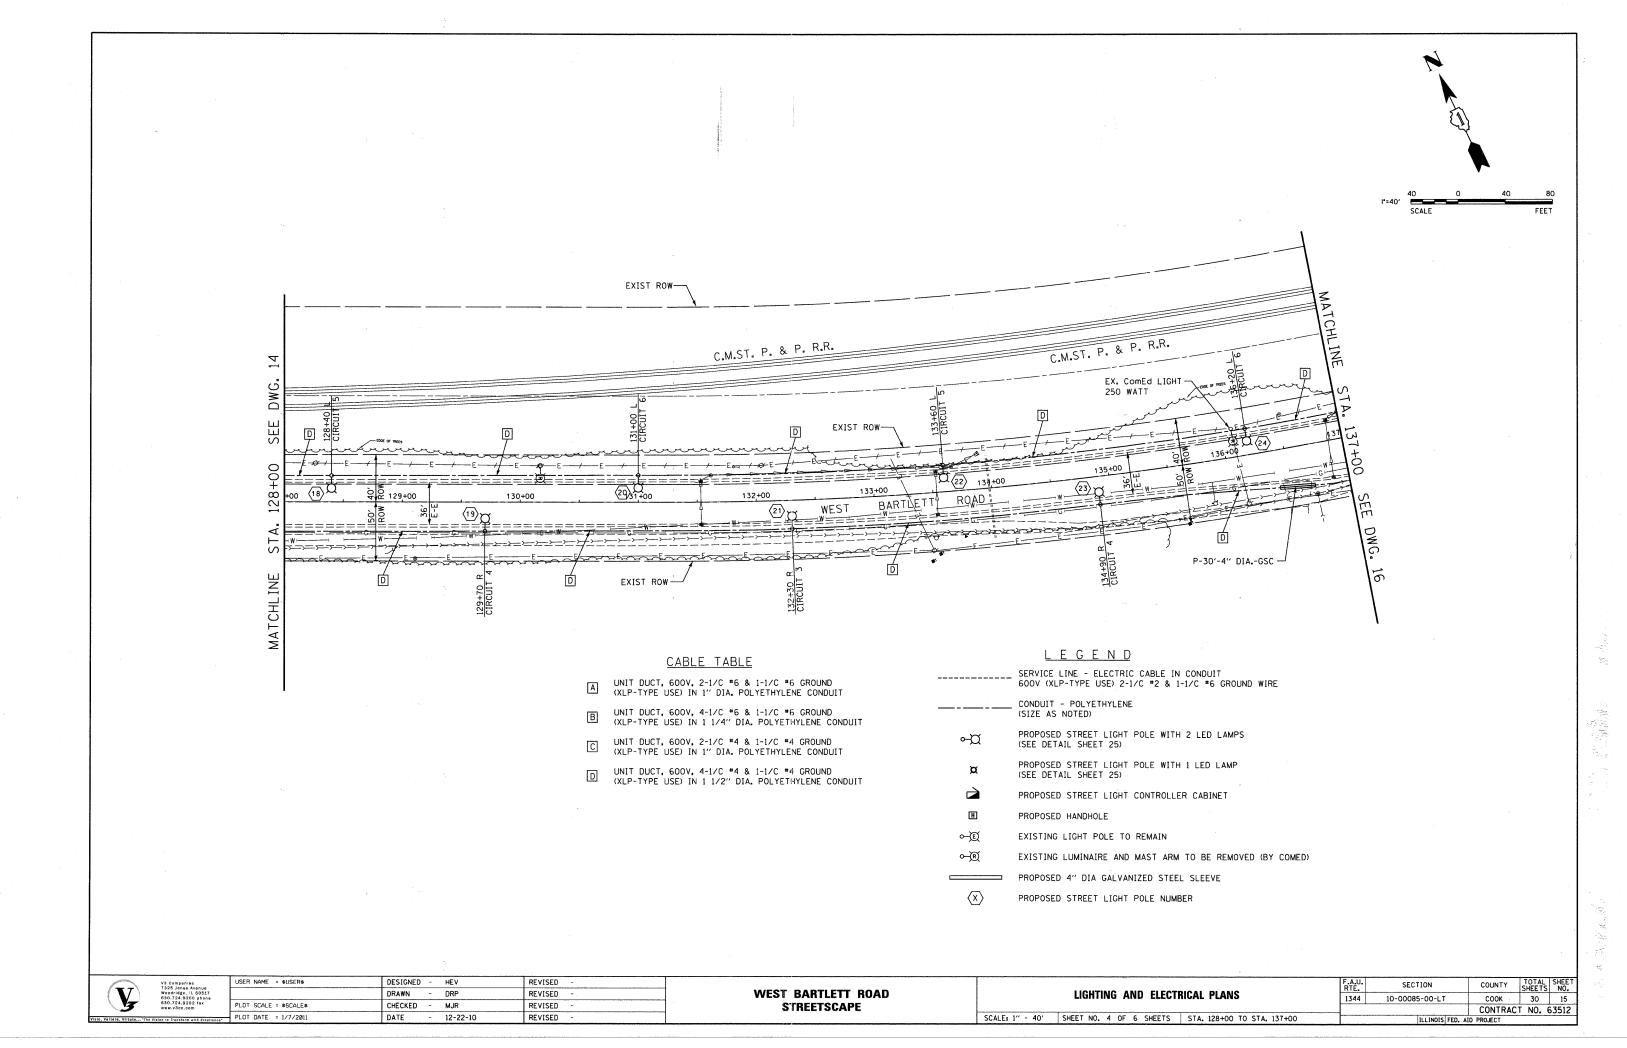

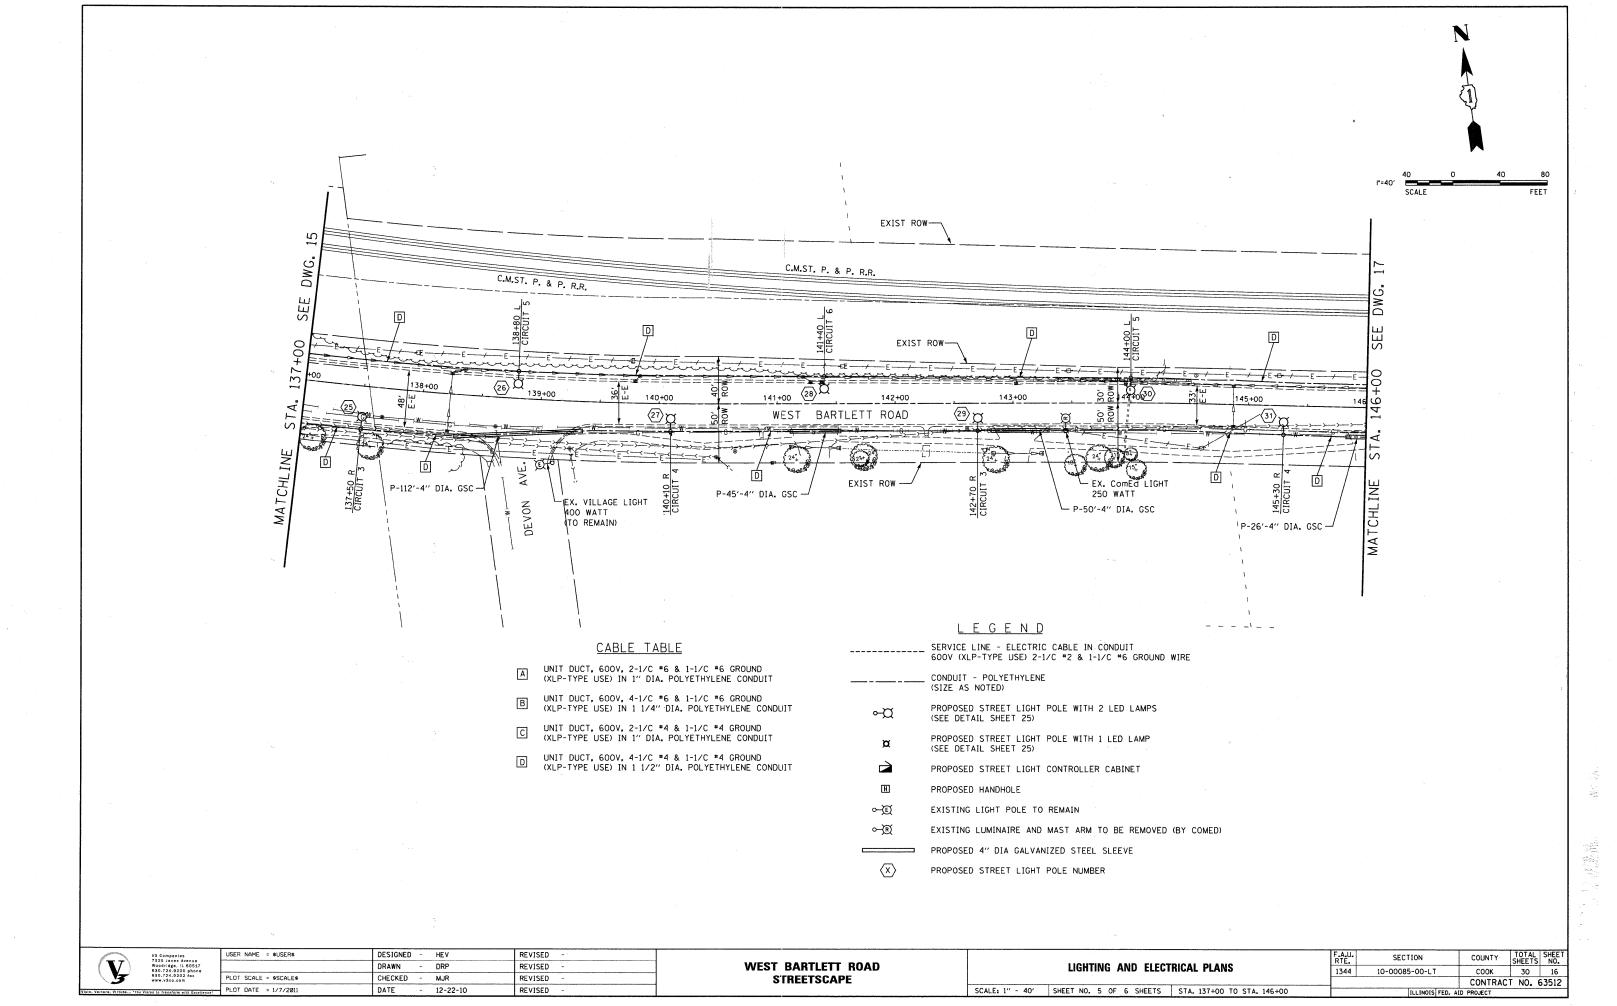

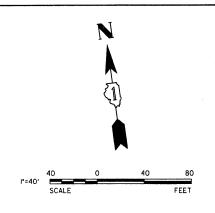

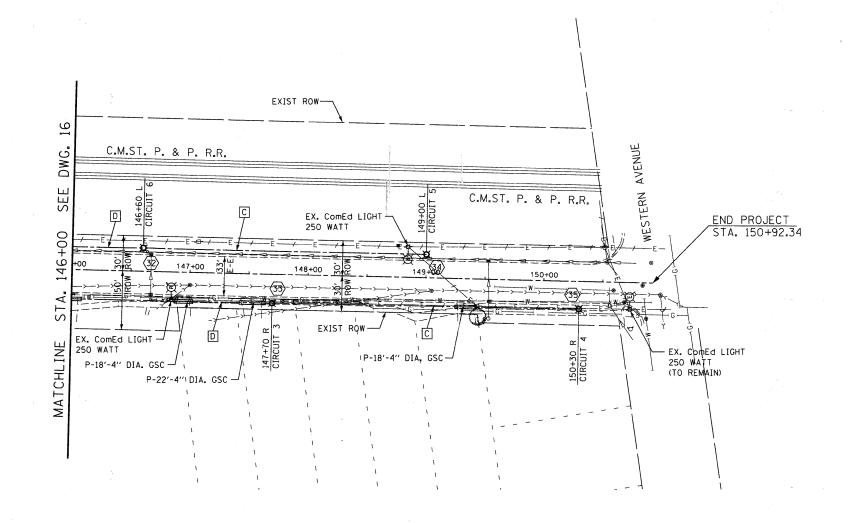

CABLE TABLE

- A UNIT DUCT, 600V, 2-1/C #6 & 1-1/C #6 GROUND (XLP-TYPE USE) IN 1" DIA. POLYETHYLENE CONDUIT
- B UNIT DUCT, 600V, 4-1/C *6 & 1-1/C *6 GROUND (XLP-TYPE USE) IN 1 1/4" DIA. POLYETHYLENE CONDUIT
- UNIT DUCT, 600V, 2-1/C *4 & 1-1/C *4 GROUND (XLP-TYPE USE) IN 1" DIA. POLYETHYLENE CONDUIT
- UNIT DUCT, 600V, 4-1/C *4 & 1-1/C *4 GROUND (XLP-TYPE USE) IN 1 1/2" DIA. POLYETHYLENE CONDUIT

LEGEND

SERVICE LINE - ELECTRIC CABLE IN CONDUIT
600V (XLP-TYPE USE) 2-1/C #2 & 1-1/C #6 GROUND WIRE

__ CONDUIT - POLYETHYLENE (SIZE AS NOTED)

PROPOSED STREET LIGHT POLE WITH 2 LED LAMPS (SEE DETAIL SHEET 25)

PROPOSED STREET LIGHT POLE WITH 1 LED LAMP (SEE DETAIL SHEET 25)

PROPOSED STREET LIGHT CONTROLLER CABINET

H PROPOSED HANDHOLE

œ.


○—Œ EXISTING LIGHT POLE TO REMAIN


EXISTING LUMINAIRE AND MAST ARM TO BE REMOVED (BY COMED)


PROPOSED 4" DIA GALVANIZED STEEL SLEEVE


X PROPOSED STREET LIGHT POLE NUMBER


	V3 Companies	USER NAME = \$USER\$	DESIGNED - HEV	REVISED -			F.A.U.	SECTION	COUNTY	TOTAL SHEET
	Woodridge, IL 60517 830.724.9200 phone	DRAWN - DRP	DRAWN - DRP	REVISED -	WEST BARTLETT ROAD	LIGHTING AND ELECTRICAL PLANS	1344	``L.	COOK 3	30 17
4 3	630.724.9202 fax www.v3co.com	PLOT SCALE = \$SCALE\$	CHECKED - MJR	REVISED -	STREETSCAPE					CT NO. 63512
Vicio, Vertere, Virtute "Yn	e Vision to Transform with Excellence	PLOT DATE = 1/7/2011	DATE - 12-22-10	REVISED -		SCALE: 1" - 40' SHEET NO. 6 OF 6 SHEETS STA. 146+00 TO STA. 150+92		ILLINOIS FED. A		

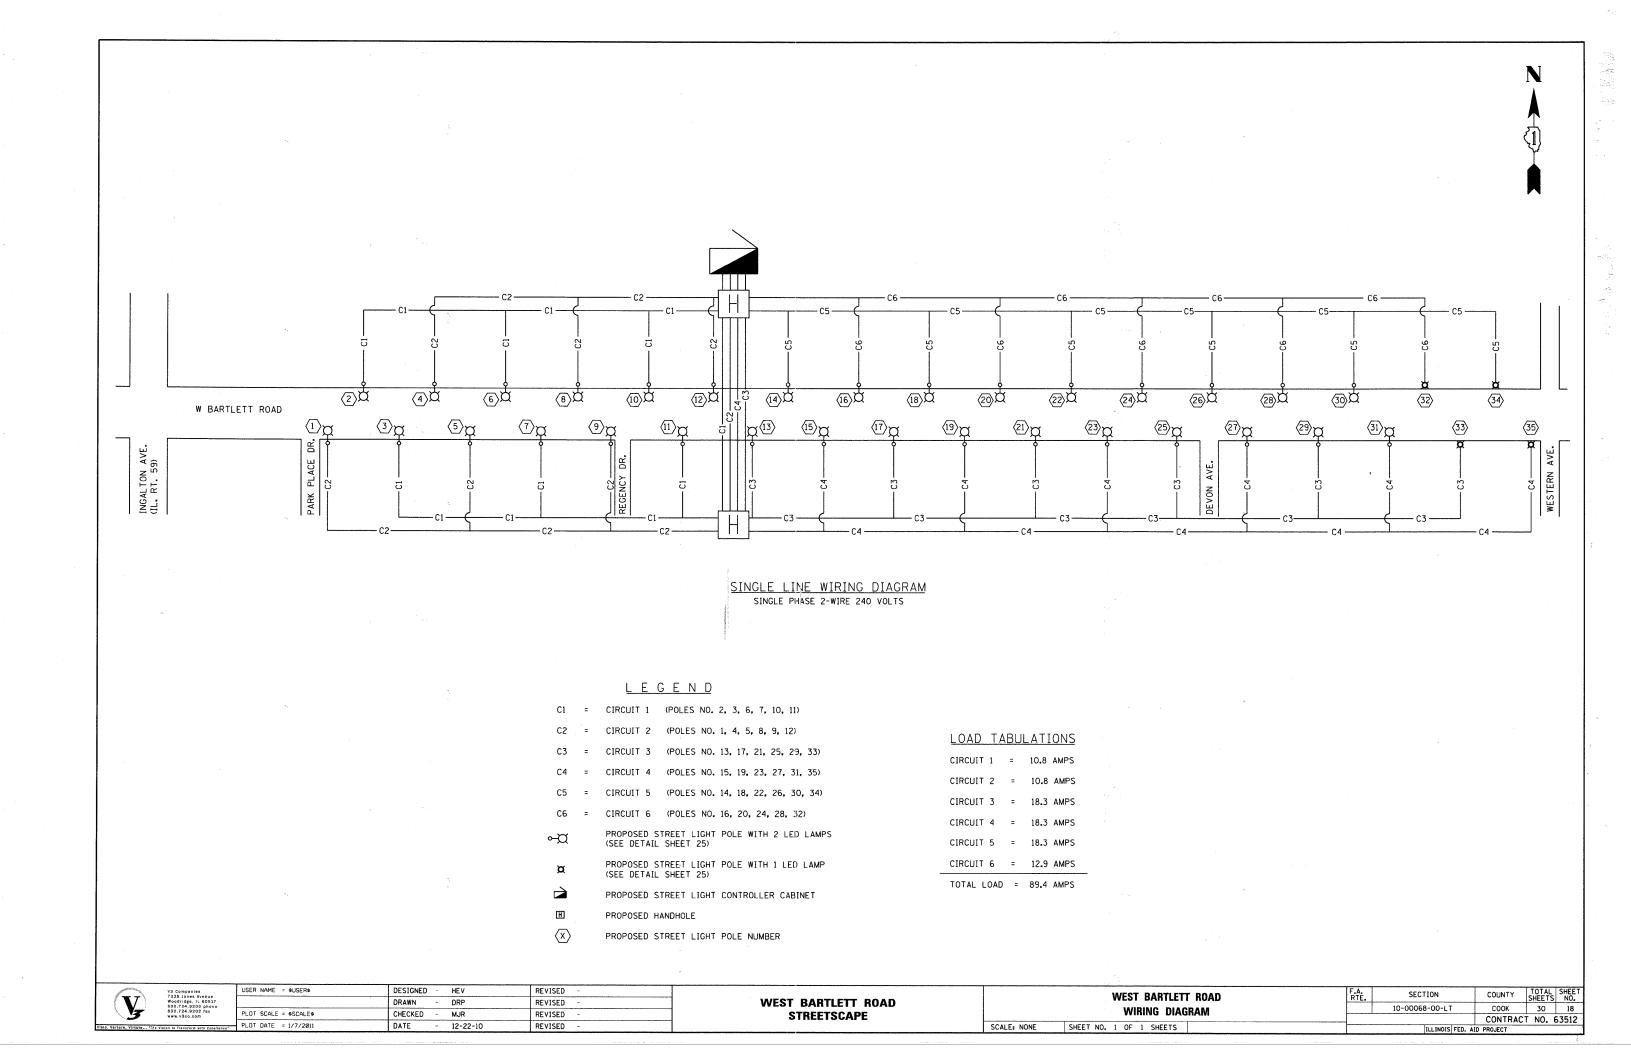


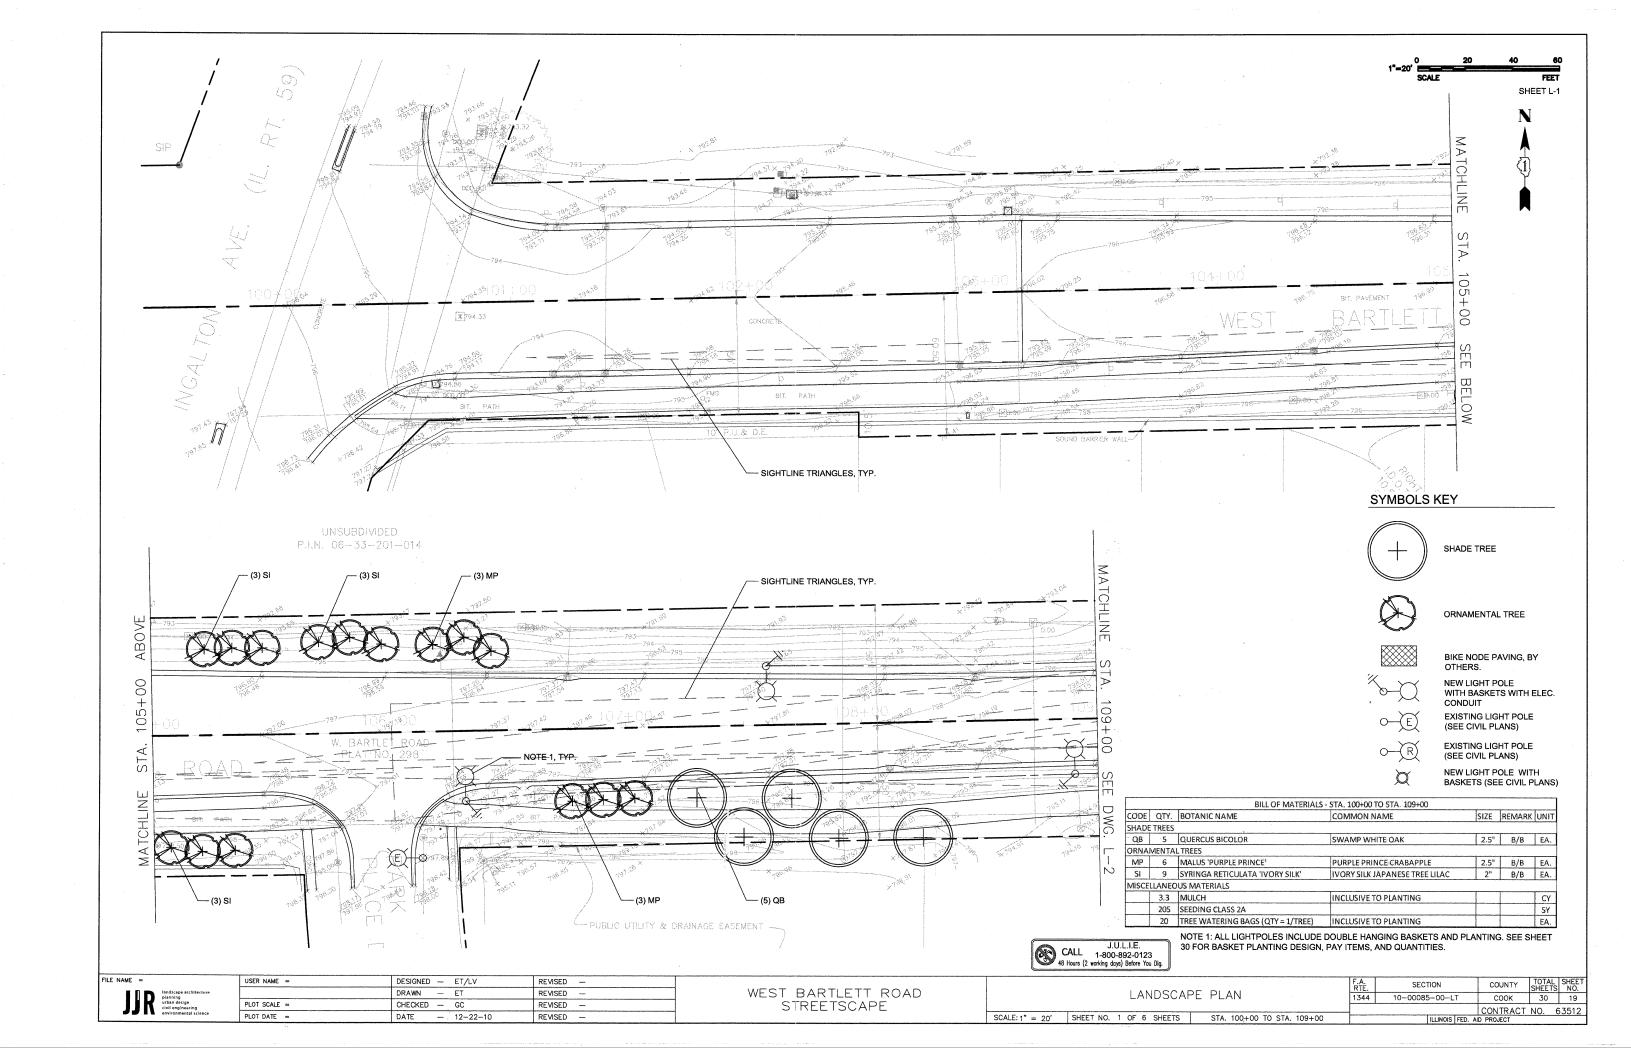


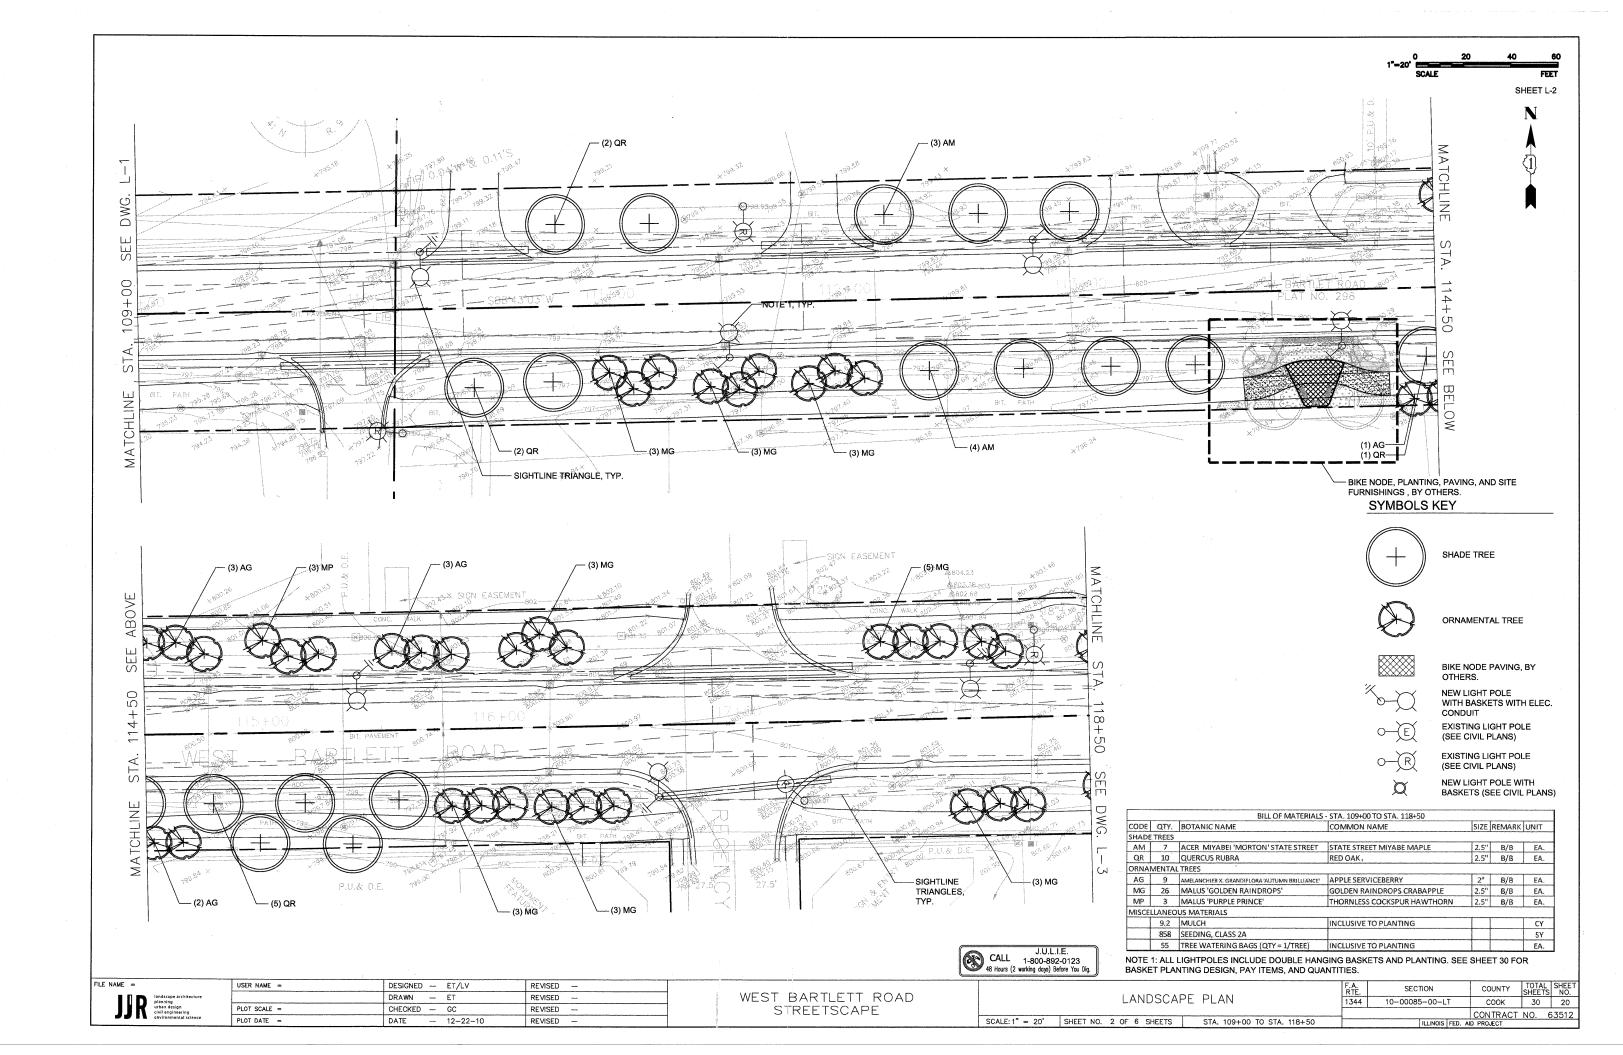


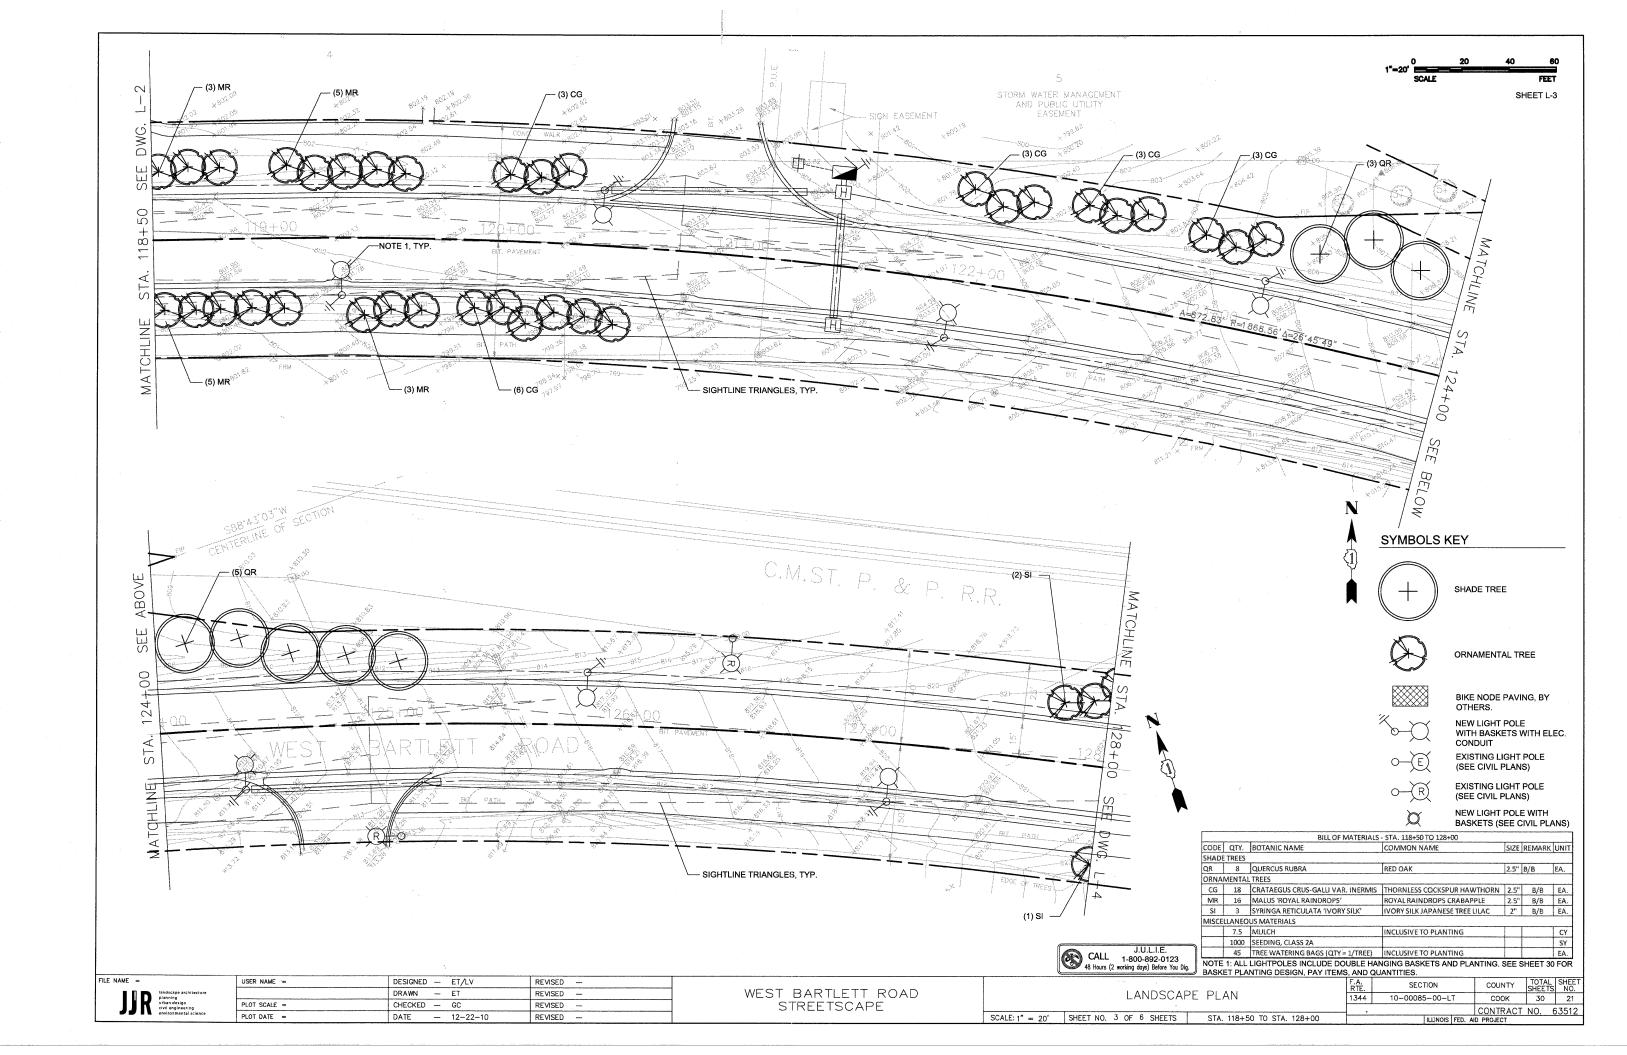


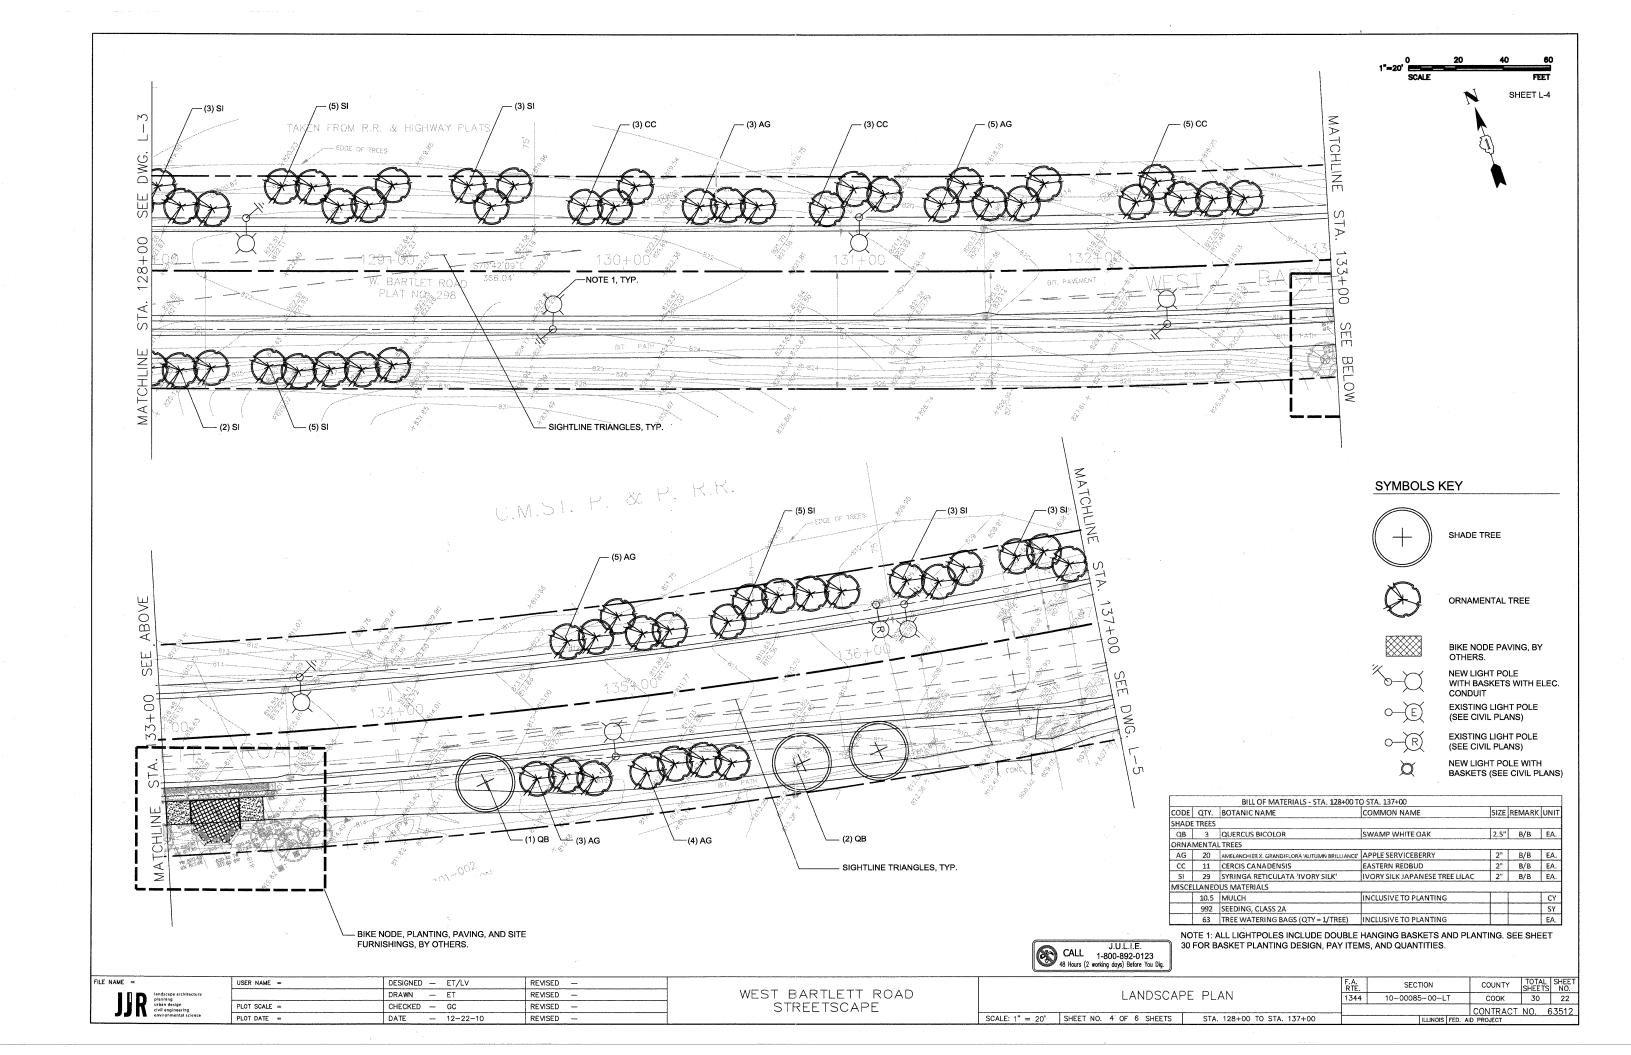

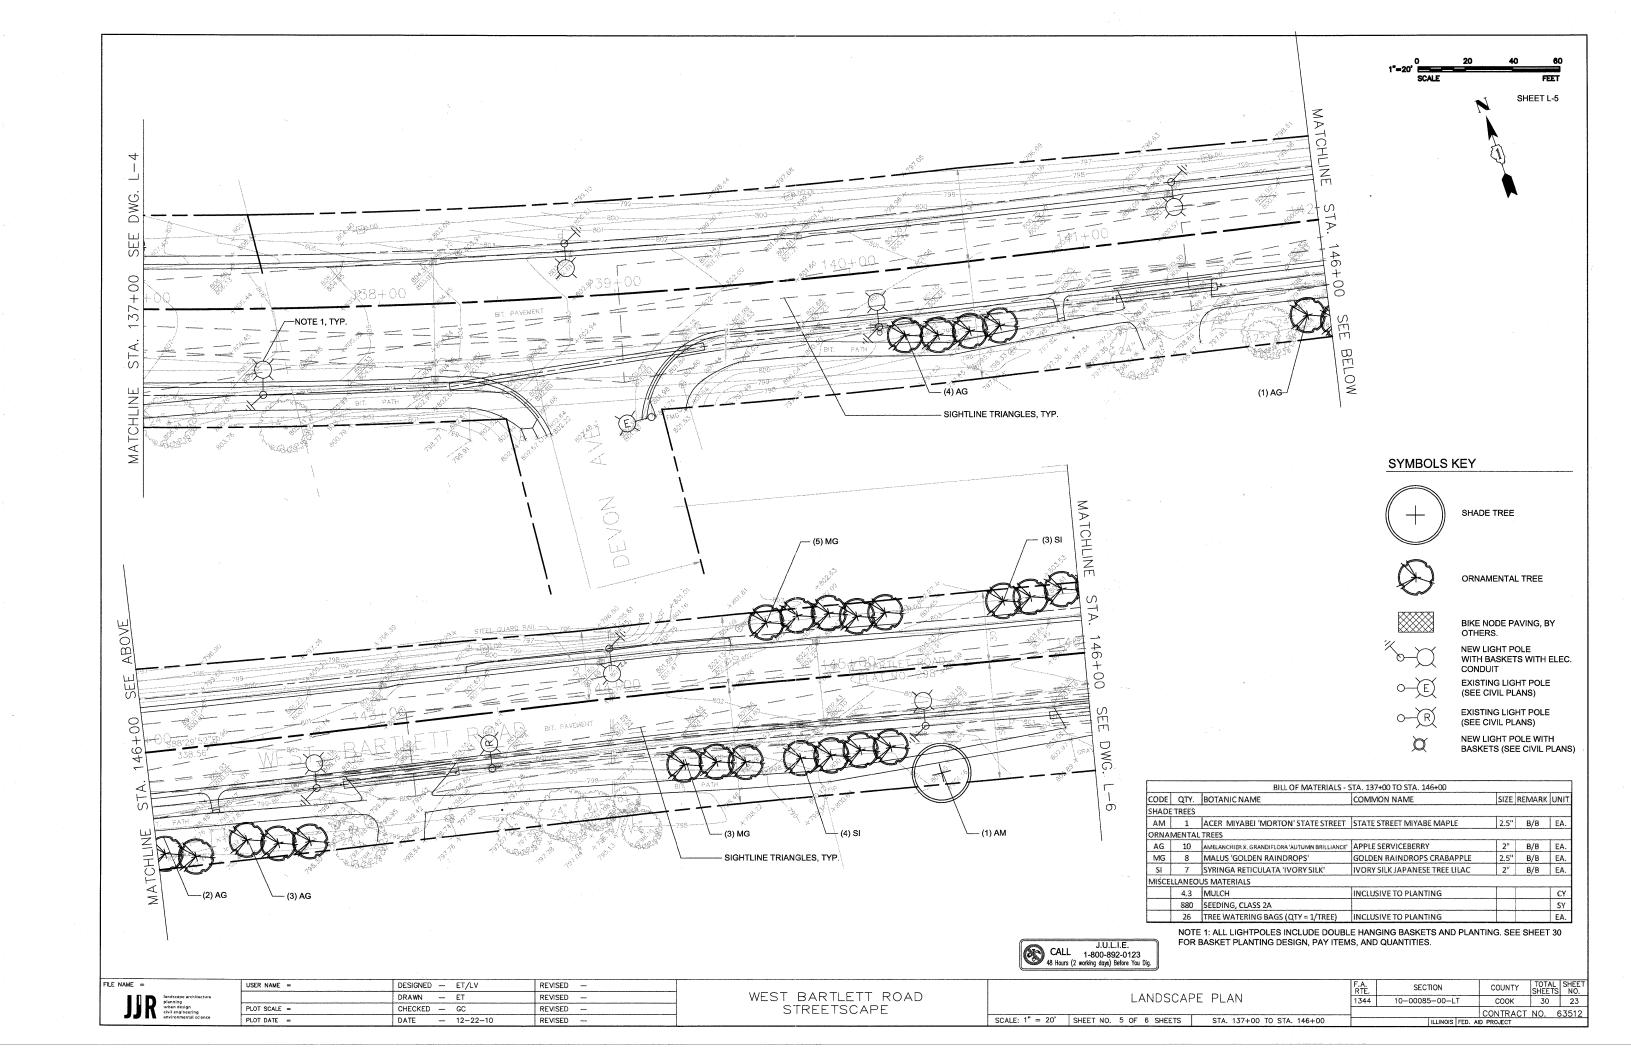


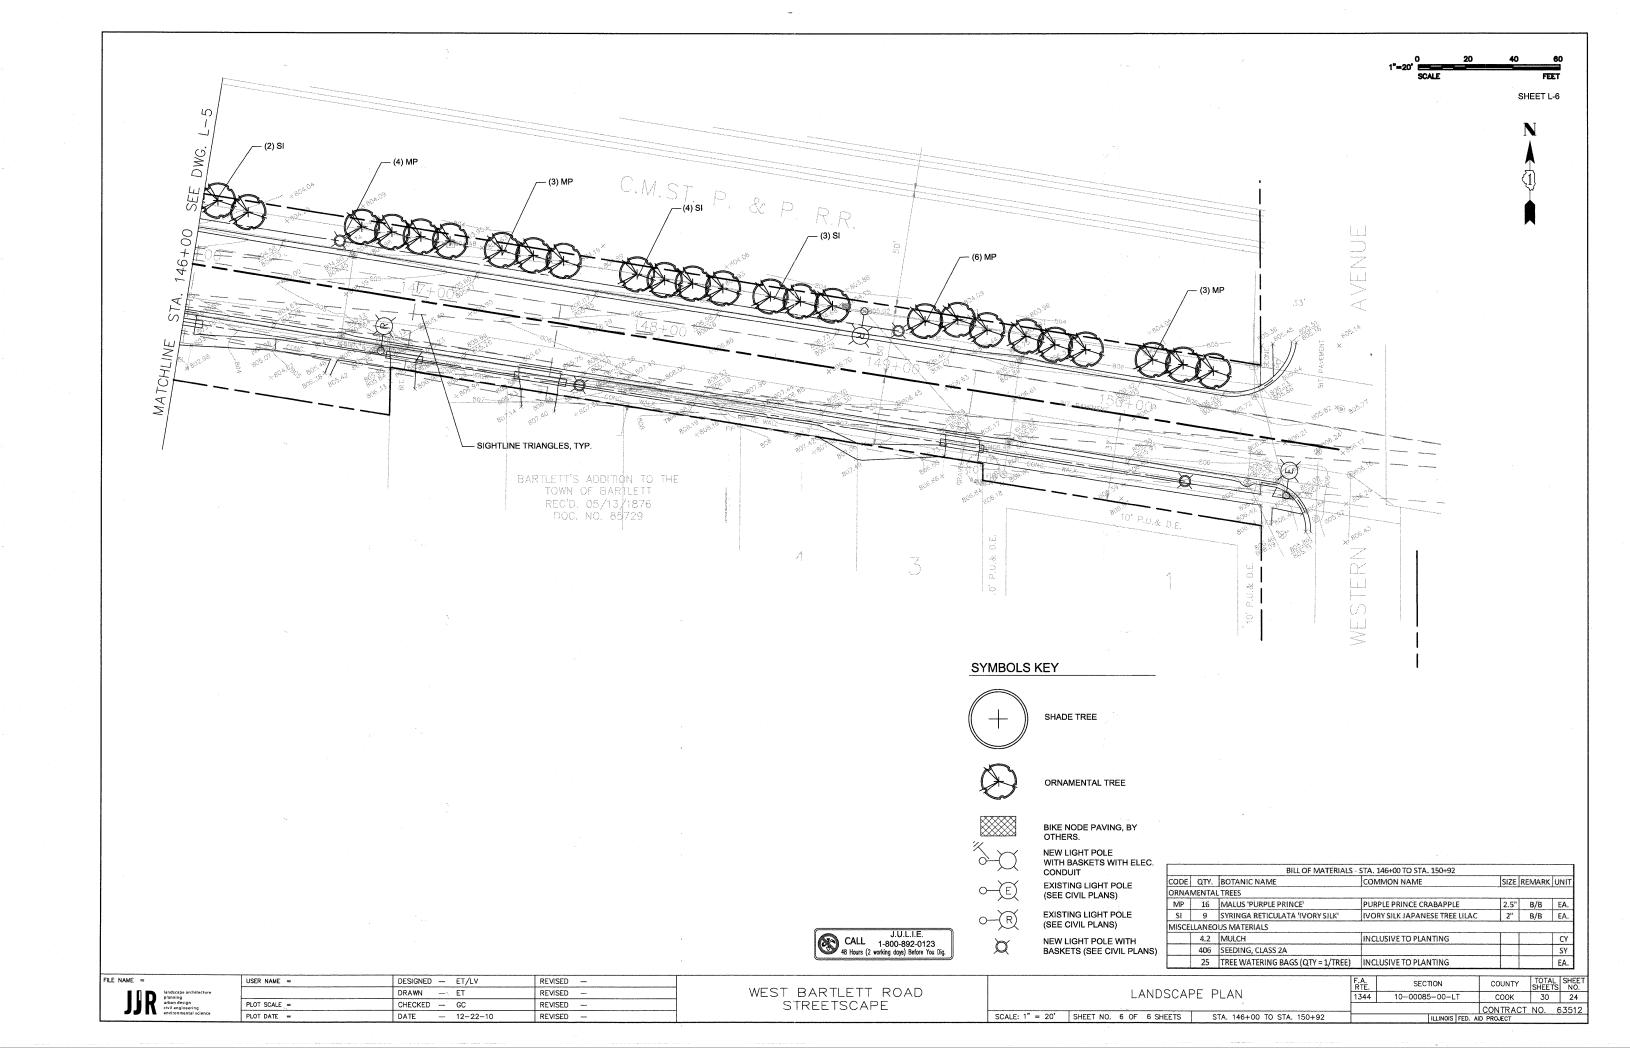

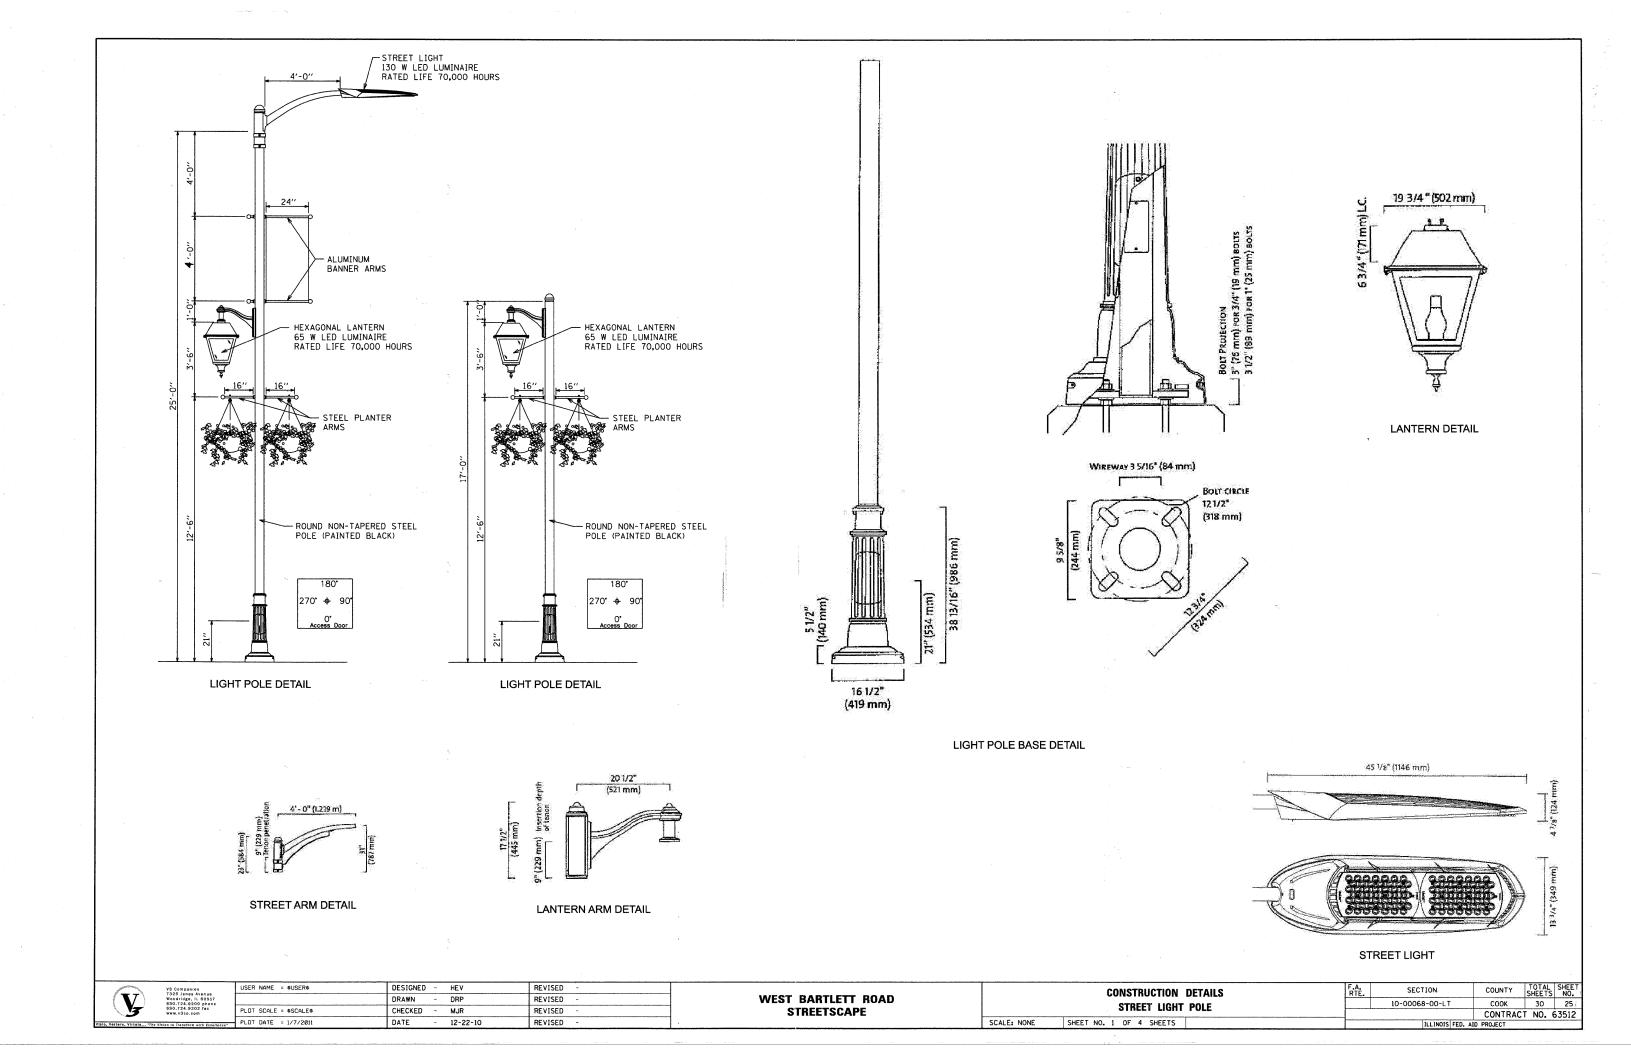

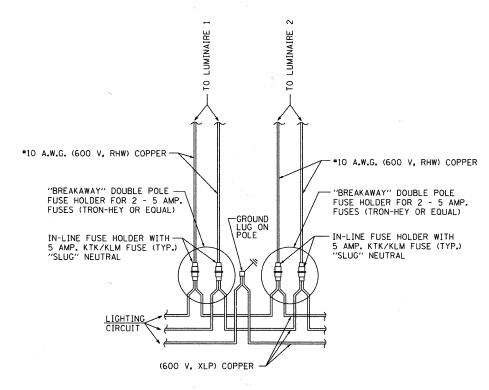

LIGHT POLE WIRING

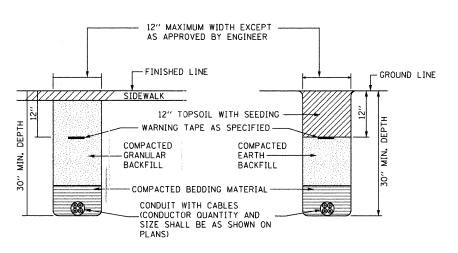

PAVED AREAS

NON-PAVED AREAS

SCALE: NONE

CONDUIT TRENCH BACKFILL DETAIL

V3 Companies 7325 Janes Avanue Woodridge, It. 60537 630.724.9200 phone 630.724.9202 fax www.y3co.com Vialo, Vertare, Virtute The Vision to Treasferm with Exertinge?	USER NAME = \$USER\$ PLOT SCALE = \$SCALE\$ PLOT DATE = 1/7/2011	DESIGNED - HEV DRAWN - DRP CHECKED - MJR DATE - 12-22-10	REVISED -	WEST BARTLETT ROAD STREETSCAPE
www.v3co.com	PLOT DATE - 1/7/2011			STREETSCAPE

CONSTRUCTION DETAILS
MISCELLANEOUS ELECTRICAL

SHEET NO. 2 OF 4 SHEETS

HEAT-SHRINKABLE CAP WITH FACTORY APPLIED

NUMBER OF CABLES).

WATERPROOF SEALANT (SIZED TO ACCOMMODATE

ELECTRIC FEEDER CABLES

SUCH AS UNIT DUCT (SIZE . AS NOTED ON CONTRACT

> ELECTRIC CABLE TO LUMINAIRE (SIZE AS NOTED ELSEWHERE IN THESE PLANS).

DRAWINGS).

---TRIMMED CABLES

COMPRESSION TYPE

COPPER SLEEVE (SIZED FOR CABLES AND MFR. SUGGESTED CRIMP TOOL USED)


SEALANT TAPE OR _INSERT (AROUND AND THROUGH


CROTCH OF SPLICE).

EXPOSED SEALANT NOTE THAT NUMBER OF CABLES IN

SPLICE MAY VARY

SPLICING ELECTRIC CABLES BASIC MATERIALS & METHODS

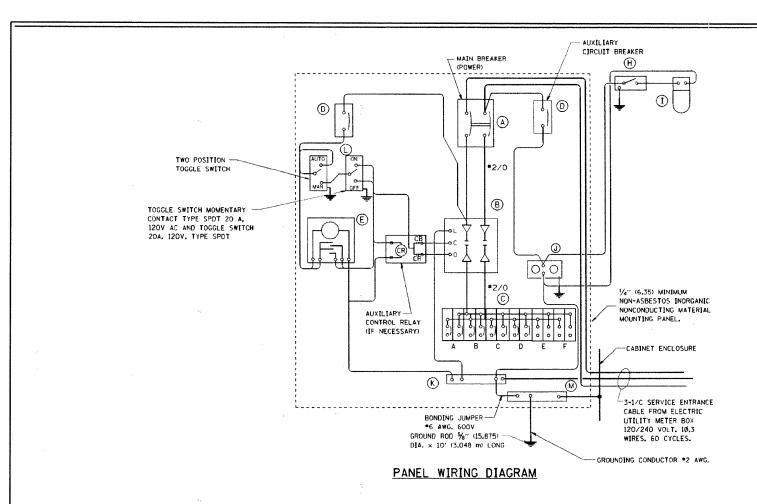

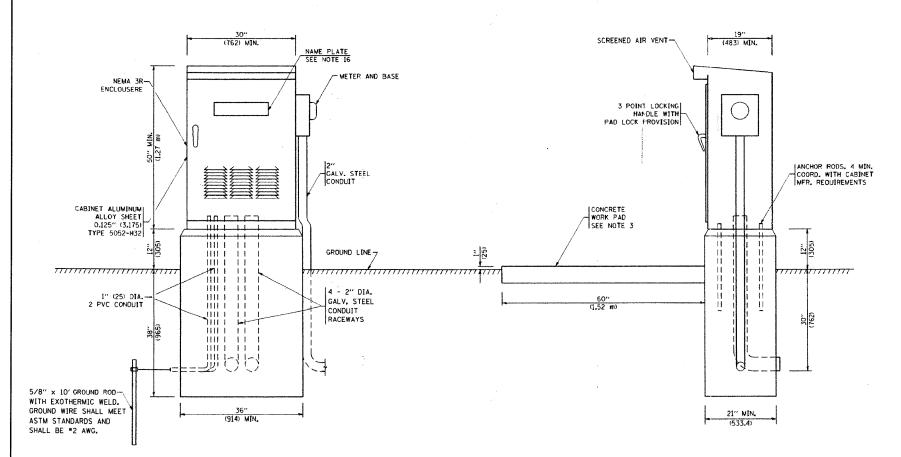

PANEL EQUIPMENT

		BILL OF MATERIAL
ITEM	QUANTITY	DESCRIPTION
А	1	MAIN CIRCUIT BREAKER, 2 POLE, 600 VOLT 100 AMP. FRAME, 100 AMP. NON-INTERCHANGEABLE TRIP INTERRUPTING RATING NEMA-22000 AMP. AT 240 VOLT.
В	1	REMOTE CONTROL SWITCH, ELECTRICALLY OPERATED, MECHANICALLY HELD, 2 POLE, SINGLE THROW, 100 AMP., 600 VOLTS CONTROL CIRCUIT 120 VOLT.
С	6	CIRCUIT BREAKERS, 2 POLE, 100AMP. FRAME, 30 AMP. NON-INTERCHANGEABLE TRIP INTERRUPTING RATING NEMA-10,000 AMP. AT 240 V.
D	2	CONTROL CIRCUIT-CIRCUIT BREAKER. 1 POLE, 120 V., 100 AMP. FRAME, 15 AMP. NON-INTERCHANGEABLE TRIP INTERRUPTING RATING NEMA-5000 AMP. AT 120 V.
Ε	1	INTERMATIC MODEL NO. ET173C CONTROLLER (TIME SWITCH WIRED IN SERIES WITH PHOTOCELL) WITH PHOTOCELL MOUNTED IN VENT SLOTS OF CABINETS OVERHANG.
	·	
н	1	SPST 20A SWITCH ON DOOR, TO TURN LIGHT ON WHEN DOOR IS OPEN,
I	1	INCANDESCENT LIGHTING FIXTURE ENCLOSED AND GASKETED WITH 60 WATT, 120 V. LAMP.
J	1	20 A., 120 V., DUPLEX RECEPTACLE, GFCI.
К	<u>,</u> 1	COPPER NEUTRAL BUS 1/4" (6.35) X 1" (25.4) X 12" (304.8 mm) LONG MOUNTED ON PANEL WITH LUGS AND 4 SPARE LUGS
L	2	TOGGLE SWITCHES MOUNTED IN 4" (101.6) X 4" (101.6 mm) BOX.
М	1	COPPER GROUND BUS 1/4" (6.35) X 1" (25.4) X 12" (304.8 mm) LONG MOUNTED ON PANEL WITH LUGS AND SPARE LUGS

NOTES:


- 1. ALL DIMENSIONS ARE IN INCHES (MILLIMETERS) UNLESS OTHERWISE SHOWN.
- 2. FOUNDATION SIZE SHALL BE COORDINATED WITH CABINET SIZE AND MFR.
- 3. IN FRONT OF CONTROL CABINET DOOR, REMOVE IN FRONT OF CONTROL CABINET DOOR, REMOVE
 VEGETATION AND 2" (50.8 mm) TOP SOIL, LEVEL THE
 AREA AND ON TOP, PLACE LENGTH WISE PARALLEL

 12. ALL WIRING WITHIN THE CABINET SHALL BE
 COLOR CODED AS INDICATED.


 W = WHITE TO CONTROL CABINET, A CONCRETE PAD $36'' (914.4 \text{ mm}) \times 60'' (18.288 \text{ m}) \times 4'' (101 \text{ mm})$ MIN. SIZE. THE COST OF LABOR AND MATERIALS ARE INCLUDED IN THE COST OF THE CONTROLLER.
- 4. DOOR SHALL BE CONSTRUCTED FROM SAME TYPE OF MATERIAL AND THICKNESS AS CABINET.
- 5. DOOR SHALL BE EQUIPPED WITH THREE POINT LATCHING MECHANISM WITH NYLON ROLLERS AT TOP THE BOTTOM.
- 6. DOOR HINGE SHALL BE A HEAVY GAUGE CONTINUOUS HINGE WITH A 1/4" (6.35 mm) DIA. STAINLESS STEEL HINGE PIN.
- 7. ALL EXTERNAL HARDWARE SHALL BE STAINLESS STEEL.
- 8. CONTROL WIRING TO BE #12 AWG, 600V, TYPE "SIS" GRAY SWITCH BOARD WIRE, STRANDED
- 9. METER BOX SHALL BE MOUNTED ON THE SIDE OF CONTROL CABINET, NEAR TO THE SERVICE POLE.

- 10. CABINETS SHALL BE PRIMED AND PAINTED AS SPECIFIED.
- 11. THE HEADS OF CONNECTORS SCREWS SHALL BE PAINTED WHITE FOR NEUTRAL BAR CONNECTION AND GREEN FOR GROUND BAR CONNECTORS.
- BL = BLUE Y = YELLOW B = BLACK
- 13. PROVIDE SEALING GROMMETS FOR ALL OPEN WIRING EXTENDED FROM DEVICES IN BOXES OR CABINETS WITHIN THE CONTROL CABINET.
- 14. ALL WIRING SHALL BE NEATLY DRESSED AND SUPPORTED.
- 15. THE CONTROLLER SHALL BE CONSTRUCTED TO U.L. STD. 508 AND BEAR THE U.L. LABEL "ENCLOSED INDUSTRIAL CONTROL PANEL".
- 16. 12" (304.8) X 16" (406.4 mm) STAINLESS STEEL EXTERIOR NAMEPLATE SHALL BE ENGRAVED TO "VILLAGE OF BARTLETT LIGHTING CONTROLS" UNLESS OTHERWISE SPECIFIED.
- 17. PHOTOCELL SHOULD CONTROL THE SYSTEM. TIME CLOCK SHOULD HAVE THE ABILITY TO OVERRIDE THE PHOTOCELL.

//	V3 Companies	USER NAME = \$USER\$	DESIGNED - HEV	REVISED -		CONSTRUCTION DETAILS	F.A.	SECTION	COUNTY	TOTAL SHEET
	Woodridge, IL 60517 630,724,9200 phone	3	DRAWN - DRP	REVISED -	WEST BARTLETT ROAD		KIE.	10-00068-00-LT	СООК	30 27
1 3	630.724.9202 fax www.v3co.com	PLOT SCALE = \$SCALE\$	CHECKED - MJR	REVISED -	STREETSCAPE	LIGHTING CONTROL - SINGLE DOOR	<u> </u>	10 00000 00 11	CONTRAC	T NO. 63512
Visio, Vertere, Virtute	. 'The Vision to Transform with Execilence'	PLOT DATE = 1/17/2011	DATE - 12-22-10	REVISED -		SCALE: NONE SHEET NO. 3 OF 4 SHEETS		ILLINOIS FED. AI	D PROJECT	1 1102 03312

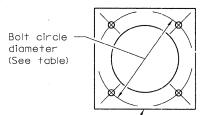

Wiring window location identification marks shall be notched in side of plate or stamped on top.

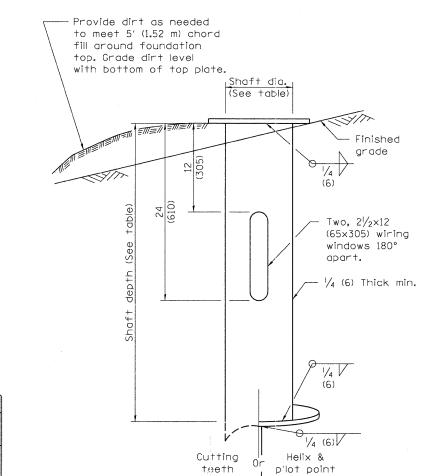

HELIX FOUNDATION SIZE

POLE MOUNTING HEIGHT	BOLT CIRCLE	SHAFT DIAMETER	SHAFT LENGTH	BASEPLATE
25 FT.	12 ½"	85%"	6 FT.	18''×18''×1 ¹ ⁄4''


METAL HELIX FOUNDATION MATERIALS

ITEM	MATERIAL REQUIREMENT
BASEPLATE	AASHTO M 270M, GRADE 36 (M270M, GRADE 250)
SHAFT	ASTM A 252, GRADE 2 (PHOSPHOROUS 0.04% MAXIMUM, SULFUR 0.05% MAXIMUM)
HELIX SCREW	AASHTO M 183 (ASTM A 635)
PILOT POINT	AASHTO M 270 (ASTM A 575)
ANCHOR RODS/STUDS	AASHTO M 314 (ASTM F 1554)
HEXAGON NUTS	AASHTO M 291M (ASTM A 563) GRADE DH, OR AASHTO M 292 (ASTM A 194) GRADE 2H
WASHERS	AASHTO M 293 (ASTM F 436)

Notes:

- 1. All dimensions are in inches (millimeters) unless otherwise shown.
- 2. All foundations are designed to be located on slopes not exceeding 2:1 where soils have an unconfined compressive strength of at least 1.0 TSF. The Contractor shall monitor installation resistance of metal foundations and notify the Engineer if other conditions are encountered.
- 3. All material shall be galvanized according to AASHTO M111, unless otherwise specified.
- 4. All welds shall be continuous and not less than $\frac{1}{4}$ " (6.35 mm) fillet welds. The welded foundation shall be capable of withstanding 10,000 FT/LBS (13558.18 n.m.) of installation torque applied about the axis of the foundation.
- 5. The helix foundation shaft shall be installed vertical and the base plate shall be in level.
- 6. The cable trench shall be backfilled and firmly compacted before the installation of the light pole.
- 7. Any voids within the metal foundation shall be filled with fine aggregate.
- 8. Metal foundations shall be installed in undisturbed soil. Predrilling a pilot hole and/or backfilling around the foundation is not allowed.
- 9. The metal foundation shall not be installed to a torque which exceeds the manufacturer's maximum torque rating nor shall it be installed to an installation torque value or less than 3,500 FT LB (4,750 KNM). Metal foundations that are not installed to full installation depth or do not achieve the minimum installation torque shall be removed and replaced with a concrete foundation at no additional cost.
- 10. The base plate shall be perpendicular to the shaft axis (\pm 1°) and the hole centerline shall be concentric (\pm 0.188) to the shaft axis.
- 11. The pilot point and shaft axis shall be concentric (\pm 0.125) and in line (\pm 2%.
- 12. The base plate shall be stamped with the manufacturer's name and date of manufacture.
- 13. All light poles shall be grounded to the metal foundations.

(=>	V3 Companies 7325 Janes Avenue	USER NAME = \$USER\$	DESIGNED - HEV	REVISED -			CONSTRUCTION DETAILS		F.A.	SECTION	COUNTY	TOTAL !	SHEET
\perp (\mathbf{V})	Woodridge, IL 60517 630.724.9200 phone		DRAWN ~ DRP	REVISED -	WEST BARTLETT ROAD		LIGHT POLE FOUNDATION	- METAL		10-00068-00-LT	СООК	30	28
\3	630.724.9202 fax www.v3co.com	PLOT SCALE = \$SCALE\$	CHECKED - MJR	REVISED -	STREETSCAPE					CONTRAC	T NO. 6	3512	
Visio, Vertere, Virtute	"The Vision to Transform with Excellence"	PLOT DATE = 1/17/2011	DATE - 12-22-10	REVISED -		SCALE: NONE	SHEET NO. 4 OF 4 SHEETS			ILLINOIS FED. AI	D PROJECT		

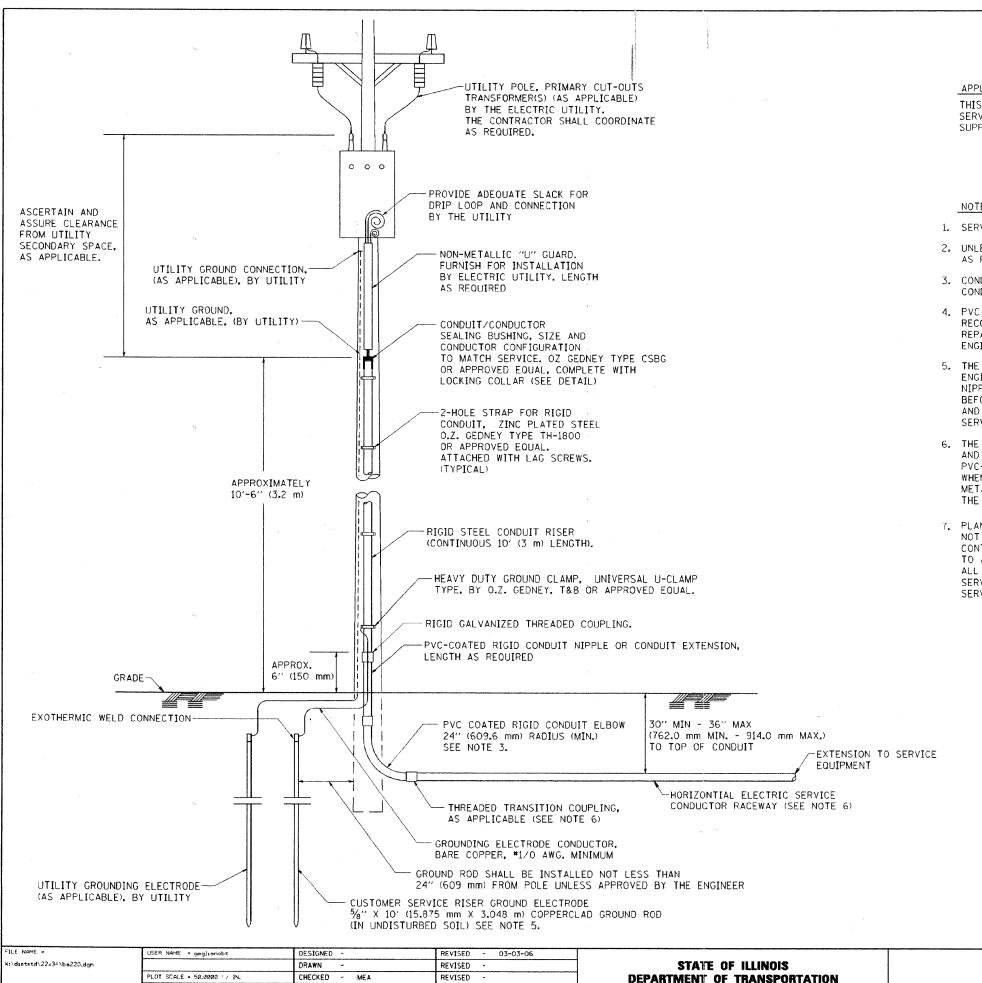

REVISED


PLOT DATE = 1/4/2008

DATE

APPLICATION


THIS DETAIL APPLIES FOR LOW VOLTAGE ELECTRIC SERVICE (660 V OR LESS) FROM AN OVERHEAD UTILITY SUPPLY TO SEPERATLY-MOUNTED SERVICE EQUIPMENT.


- SERVICE VOLTAGE SHALL BE AS INDICATED ELSEWHERE IN THE DRAWINGS.
- UNLESS OTHERWISE INDICATED, ITEMS AND WORK SHALL BE INCLUDED AND PAID AS PART OF THE ELECTRIC UTILITY SERVICE INSTALLATION PAY ITEM.
- 3. CONDUIT AND CONNECTOR DIAMETER SHALL MATCH THE DIAMETER OF THE SERVICE CONDUCTOR RACEWAY AS INDICATED ON THE PLANS.
- 4. PVC COATED RACEWAYS AND ACCESSORIES SHALL BE CAREFULLY INSTALLED WITH MFR RECOMMENDED TOOLS AND PROCEDURES TO AVOID DAMAGE. ANY DAMAGE SHALL BE REPAIRED WITH COMPATIBLE PVC TOUCH-UP MATERIAL TO THE SATISFACTION OF THE ENGINEER OR THE DAMAGED MATERIAL SHALL BE REPLACED AT NO ADDITIONAL COST.
- 5. THE CONTRACTOR SHALL OBTAIN INSPECTION AND APPROVAL BY THE ENGINEER OF SERVICE RISER GROUND ELECTRODE, RISER ELBOW, NIPPLE AND CONNECTION TO SERVICE CONDUCTOR RACEWAY EXTENSION BEFORE BACKFILL AND SHALL ALSO OBTAIN INSPECTION OF SERVICE RISER AND SEALING BUSHING BEFORE UTILITY "U" GUARD INSTALLATION AND SERVICE CONNECTION.
- 6. THE HORIZONTAL ELECTRIC SERVICE CONDUCTOR RACEWAY SHALL BE AS INDICATED AND SHALL BE MEASURED SEPARATELY FOR PAYMENT. WHEN THE RACEWAY IS PVC-COATED RIGID GALVANIZED STEEL, THE COUPLING SHALL BE THE SAME. WHEN THE RACEWAY IS PVC CONDUIT (IN CONCRETE), THE COUPLING SHALL BE A METALIC TO NON METALIC ADAPTER. WHEN THE RACEWAY IS ENCASED IN CONCRETE. THE CONCRETE SHALL EXTEND TO COVER THE COUPLING.
- PLANS AND DETAILS INDICATE THE GENERAL NATURE AND REQUIREMENTS. THEY DO NOT SHOW EVERY ACCESSORY AND ATTACHMENT, AND THEY DO NOT RELIEVE THE CONTRACTOR OF THE REQUIREMENTS OF THE SPECIFICATIONS AND SPECIAL PROVISIONS TO ASCERTAIN UTILITY REQUIREMENTS AND TO COORDINATE ACCORDINGLY, FURNISHING ALL ITEMS AND WORK NOT PROVIDED BY THE UTILITY, BUT NECESSARY FOR A COMPLETE SERVICE INSTALLATION IS REQUIRED AND SHALL BE INCLUDED IN THE ELECTRIC UTILITY SERVICE INSTALLATION PAY ITEM.

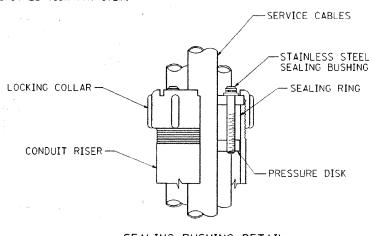


SEALING BUSHING DETAIL

	ELECTRIC S	ERVICE IN	STALLATION		RTE.	SECTION	COUNTY	SHEETS	NO.		
	AFRIAL R	FMOTE DIS	CONNECT			10-00085-00-LT	соок	30	29		
			·	 	BE-220 CONTRACT NO. 6						
 SCALE: NONE	SHEET NO. 1 OF 1	SHEETS	STA.	 TO STA.	FED. R	OAD DIST. NO. 1 ILLINOIS FED. A	ID PROJECT				

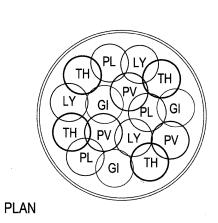

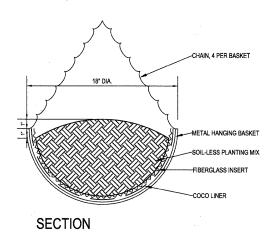

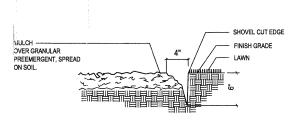


1


PLANTER BASKET PLANTING, TYP. OF 70 BASKETS (35 POLES)


SCALE: N.T.S.


		BILL OF MATERIALS - HANGING BASI	KET - EACH (TYP. OF 70) - SUMMER PLANTIN	G		
CODE	QTY.	BOTANIC NAME	ME COMMON NAME			UNIT
ANNUA	\LS					
GI	3	GIBASIS GENICULATA	TAHITIAN BRIDAL VINE	4" POT		EA.
LY	3	LYSIMACHIA NUMMULARIA 'AUREA'	MONEYWORT	4" POT		EA.
PV	3	PETUNIA X HYBRIDA	PETCHOA SUPER CAL VELVET	4" POT		EA.
PL	3	PETUNIA X HYBRIDA	PETUNIA MINI ME LILAC VINE	4" POT		EA.
TH	4	THUNBERGIA ALATA SUSIE WHITE BLACK EYE	WHITE FLOWER BLACK EYED SUSAN VINE	4" POT		EA.
MISCEL	LANEO	JS MATERIALS				-
	1	BASKET PLANTER, 18"				EA.
	1	BASKET PLANTER LINER, 18"				EA.
L	1	SOIL PLANTING MIXTURE	SOIL-LESS PLANTING MIX			CF

SPADED EDGE SCALE: N.T.S.

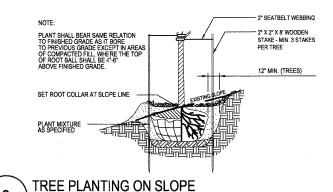

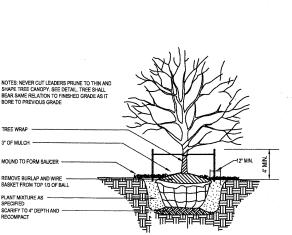

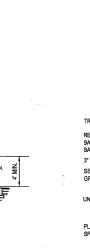

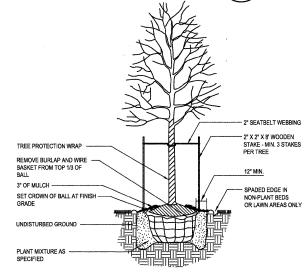

4 ORNAMENTAL TREE
SCALE: N.T.S.

5 SHADE TREE SCALE: N.T.S.

J.U.L.I.E. CALL 1-800-892-0123 48 Hours (2 working days) Before You Dig.

LANDSCAPE NOTES:

- 1. AN AUTOCAD FILE WILL BE PROVIDED TO THE CONTRACTOR FOR USE IN LAYOUT AND STAKING ALL PLANT MATERIALS.
- 2. CONTRACTOR IS RESPONSIBLE FOR BECOMING FAMILIAR WITH THE EXISTING CONDITIONS. SHOULD ANY DISCREPANCIES, CONFLICTS, OR CONDITIONS THAT MAY BE HARMFUL TO THE HEALTH OF PLANT MATERIAL BE DISCOVERED, THE CONTRACTOR IS RESPONSIBLE FOR NOTIFYING THE RESIDENT ENGINEER IMMEDIATELY UPON DISCOVERY OF SUCH CONDITION.
- 3. ELECTRICAL CONDUIT RUNS FOR LIGHTPOLE INSTALLATION WHICH ARE SHOWN WITHIN THE DRAWINGS ARE SCHEMATIC IN NATURE ONLY. ELECTRICAL CONTRACTOR AND LANDSCAPE CONTRACTOR SHALL COORDINATE INSTALLATION AND ALIGNMENT OF CONDUIT RUNS SO AS NOT TO CONFLICT WITH TREE PLANTING LOCATIONS AND OTHER BURIED UTILITIES.
- 4. CONTRACTOR SHALL STAKE ALL TREE LOCATIONS WITH 2" X 2" WOOD STAKES, CLEARLY MARKED WITH NAME OF TREE AND SIZE. CONTRACTOR IS RESPONSIBLE FOR CONTACTING RESIDENT ENGINEER WHEN STAKING IS COMPLETE. ALL STAKING LOCATIONS WILL BE REVIEWED BY RESIDENT ENGINEER AND LANDSCAPE ARCHITECT, AND MUST BE APPROVED PRIOR TO INSTALLATION OF ANY PLANT MATERIAL.
- 5. ALL TREES SHALL BE SPECIMEN QUALITY, VIGOROUS, DISEASE FREE, STRAIGHT TRUNKED, UNIFORM IN HABIT, AND WITH FIRM ROOTBALLS.
- 6. FOR STREETSCAPE PLANTING: PROVIDE SHADE TREES WITH MINIMUM 6' CLEARANCE BETWEEN BOTTOM OF TREE CROWN AND ROOTBALL AND ORNAMENTAL TREES WITH MINIMUM 4' CLEARANCE BETWEEN BOTTOM OF TREE CROWN AND TOP OF ROOTBALL.
- 7. TREE PLANTING DETAILS ARE SHOWN FOR BOTH LEVEL AND SLOPED PLANTING CONDITIONS. WHEN SOIL CONDITIONS CONTAIN HEAVY CLAY SOILS, THE TYPICAL DETAILS SHOWN SHOULD BE ADJUSTED TO SHOW TREES SET UP TO 2 " HIGHER THAN SURROUNDING GRADES, WITH THE MAKEUP IN ADDITIONAL TOPSOIL.
- 8. TREE PLANTING MIX, USED FOR BACKFILL, IS COMPOSED OF 2/3 SALVAGED AND IMPORTED TOPSOILS AND 1/3 COMPOST, MATERIALS AS DEFINED BY IDOT ARTICLE 1081.05.
- 9. PROVIDE 4' WIDE MULCH RING, CENTERED ON TREE, WITH SPADED EDGE PER DETAIL.
- 10. MULCH ALL TREES WITH 3" DEPTH OF MULCH. MULCH SHALL BE SHREDDED HARDWOOD BARK MULCH, CLEAN, DEVOID OF ANY DELETERIOUS MATERIALS, WITH NO PARTICLES LARGER THAN 2" IN ANY DIRECTION.
- 11. WATER EACH TREE UTILIZING DOUBLE HORTICULTURAL TREE WATERING BAGS, SUCH AS GATOR BRAND BAGS, OR APPROVED EQUAL. ALL BAGS WILL BECOME THE PROPERTY OF VILLAGE OF BARTLETT.
- 12. WRAP ALL TREES IN FALL WITH TREE WRAP MADE OF DOUBLE SIDED CREPE PAPER WITH ASPHALTIC BINDER .
 TIE OFF WITH JUTE TWINE. REMOVE IN SPRING AFTER ALL DANGER OF FROST.
- 13. LAWN REPAIR AREAS FROM EXCAVATION AND UTILITIES TRENCHING ARE NOT SHOWN, BUT WILL BE ROUGHLY 4' WIDTH ALONG COURSE OF UNDERGROUND ELECTRIC SERVICE BETWEEN LIGHTPOLES.
- 14. EACH LIGHTPOLE INCLUDES TWO HANGING BASKETS MOUNTED TO SINGLE LIGHTPOLE. PLANTINGS WITHIN BASKETS ARE ANNUAL PLANTS. CONTRACT CALLS FOR INITIAL YEAR INSTALLATION. FOLLOWING YEAR'S INSTALLATION IS NOT IN CONTRACT, AND WILL BE BY OTHERS.

			LANDSCAPE BILL OF I	MATERIALS - TOTAL				
ART.#	CODE	QTY.	BOTANIC NAME	COMMON NAME	SIZE	REMARK	UNIT	
SHADE TRE	ES							
253	AM	8	ACER MIYABEI 'MORTON' STATE STREET	STATE STREET MIYABE MAPLE	2.5"	B/B	EA.	
253	QB	8	QUERCUS BICOLOR	SWAMP WHITE OAK	2.5"	B/B	EA.	
253	QR	18	QUERCUS RUBRA	RED OAK	2.5"	8/8	EA.	
ORNAMEN	TAL TRE	ES						
253	AG	.39	AMÉLANCHIER X. GRANDIFLORA AUTUMN BRILLIANCE	APPLE SERVICEBERRY	2"	B/B	EA.	
253	CC	11	CERCIS CANADENSIS	EASTERN REDBUD	2"	B/B	EA.	
253	CG	18	CRATAEGUS CRUS-GALLI VAR. INERMIS	THORNLESS COCKSPUR HAWTHORN	2.5"	B/B	€A.	
253	MG	34	MALUS 'GOLDEN RAINDROPS'	GOLDEN RAINDROPS CRABAPPLE	2.5"	B/B	EA.	
253	MP	25	MALUS 'PURPLE PRINCE'	PURPLE PRINCE CRABAPPLE	2.5"	B/B	EA.	
253	MR	16	MALUS 'ROYAL RAINDROPS'	ROYAL RAINDROPS CRABAPPLE	2.5"	B/B	EA.	
253	SI	57	SYRINGA RETICULATA 'IVORY SILK'	IVORY SILK JAPANESE TREE LILAC	2"	B/B	EA.	
ANNUALS	*	·····				***************************************		
254	GI	_210	GIBASIS GENICULATA	TAHITIAN BRIDAL VEIL	4" POT	T T	EA.	
254	LY	210	LYSIMACHIA NUMMULARIA 'AUREA'	MONEYWORT	4" POT		EA.	
254	PV	210	PETUNIA X HYBRIDA	PETCHOA SUPER CAL VELVET	4" POT		EA.	
254	PL	210	PETUNIA X HYBRIDA	PETÜNIA MINI ME LILAC VINE	4" POT		EA.	
254	TH	280	THUNBERGIA ALATA SUSIE WHITE BLACK EYE	WHITE FLOWER BLACK EYED SUSAN VINE	4" POT		EA.	
		1120	TOTAL 11:2 UNITS/100				***********	
MISCELLAN	VEOUS N	MATERIA	LS					
253/1081.06		39	MULCH	INCLUSIVE TO PLANTING	T	3" DEPTH	CY	
250		0.9	SEEDING, CLASS 2A		1	1	ACRE	
		62	BASKET PLANTER, 18"		1		EA.	
		62	BASKET PLANTER LINER, 18"		1	†	EA.	
1081		2.3	SOIL PLANTING MIXTURE	SOIL-LESS PLANTING MIX	1	 	CY	
253		234	TREE WATERING BAGS (QTY = 1/TREE)	INCLUSIVE TO PLANTING	 	 	EA.	

FILE NAME =

 USER NAME
 =
 DESIGNED
 — ET/LV
 REVISED
 —

 DRAWN
 — ET
 REVISED
 —

 PLOT SCALE
 =
 CHECKED
 — GC
 REVISED
 —

 PLOT DATE
 =
 DATE
 — 12—22—10
 REVISED
 —

WEST BARTLETT ROAD STREETSCAPE

		F.A. RTE.	SECTION	COUNTY	TOTAL	SHE	
DETAILS AND PLANT	LIST	1344	10-00085-00-LT	COOK	30	30	
	\$			CONTRACT	NO. 6	3351	
T NO. 1 OF 1 SHEETS STA.	TO STA.	ILLINOIS FED. AID PROJECT					