STATE OF ILLINOIS **DEPARTMENT OF TRANSPORTATION DIVISION OF HIGHWAYS**

FOR INDEX OF SHEETS, SEE SHEET NO. 2

PROPOSED HIGHWAY PLANS

THIS IMPROVEMENT IS LOCATED IN THE VILLAGE OF WADSWORTH

F.A.P 346:US ROUTE 41 AT IL 173 (WEIGH STATION) SECTION: 124 N **AUXILIARY LANE ADDITION** LAKE COUNTY C-91-207-05

TRAFFIC DATA

IL RTE. 41: 2003 ADT= 26000 POSTED SPEED LIMIT= 45 MPH

R 11 E IMPROVEMENT ENDS WISCONSIN STA. 124+62.61 IMPROVEMENT BEGINS STA. 113+00 NEWPORT TOWNSHIP

ENGINEERING SCALES, REDUCED SIZED PLANS WILL NOT CONFORM TO STANDARD SCALES. IN MAKING MEASUREMENTS ON REDUCED PLANS, THE ABOVE SCALES MAY BE USED.

JOINT UTILITY LOCATION INFORMATION FOR EXCAVATION 1-800-892-0123

CONTRACT NO. 62954

GROSS AND NET LENGTH OF IMPROVEMENT = 1162.61 FT = .22 MILES


D-91-207-05

COUNTY

RTE. SECTION 346 124 N

124 N



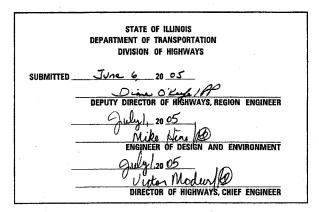

PRINTED BY THE AUTHORITY OF THE STATE OF ILLINOIS

c:BprojectsBd100005Bconsult_v8Bc04_typ~sec.dgn

DISTRICT ONE DESIGN PLAN PREPARATION KEN ENG/ISSAM RAYYAN (847) 705-4240

CONTRACT NO. 62954

INDEX OF SHEETS

* INCLLIDES IZA.

SHEET NO.	DESCRIPTION
1	COVER SHEET
2	INDEX OF SHEETS, STANDARDS AND GENERAL NOTES
3	SUMMARY OF QUANTITIES
4	TYPICAL SECTION
5	SCHEDULE OF QUANTITIES
6	SUGGESTED MAINTAINEANCE OF TRAFFIC PLAN
7-8	EXISTING AND PROPOSED ROADWAY & EROSION CONTROL PLANS
9	PAVEMENT MARKING PLAN
¥ 10−17	DISTRICT DETAILS
18-19	CROSS SECTIONS

LIST OF STATE STANDARDS

STD. NO.	DESCRIPTION
280001-02	TEMPORARY EROSION CONTROL SYSTEMS
482001	BITUMINOUS SHOULDER ADJACENT TO FLEXIBLE PAVEMENT
606001-02	CONCRETE CURB TYPE B AND COMBINATION CONCRETE CURB AND GUTTER
630001-05	STEEL PLATE BEAM GUARDRAIL
630101~05	GUARDRAIL MOUNTED ON EXISTING CULVERTS
630201-03	PCC/BITUMINOUS STABILIZATION AT STEEL PLATE BEAM GUARDRAIL
631011-02	TRAFFIC BARRIER TERMINAL, TYPE 2
631031-05	TRAFFIC BARRIER TERMINAL, TYPE 6
635006-02	REFLECTOR AND TERMINAL MARKER PLACEMENT
701411-03	LANE CLOSURE, MULTILANE AT ENTRANCE OR EXIT RAMP FOR SPEED > 45 MPH
701422-01	LANE CLOSURE, MULTILANE, FOR SPEED > 45 MPH TO 55 MPH
702001-05	TRAFFIC CONTROL DEVICES
720001	SIGN PANEL MOUNTING DETAILS
720006	SIGN PANEL ERECTION DETAILS.
780001-01	TYPICAL PAVEMENT MARKINGS
601001	SUB-SURFACE DRAINS

GENERAL NOTES

BEFORE STARTING ANY EXCAVATION, THE CONTRACTOR SHALL CALL "JULIE" AT 800-892-0123 FOR FIELD LOCATIONS OF BURIED ELECTRIC, TELEPHONE AND GAS FACILITIES. (48 HOUR NOTIFICATION IS REQUIRED)

THE CONTRACTOR SHALL COORDINATE CONSTRUCTION ACTIVITIES WITH UTILITY COMPANIES AND THE VILLAGES OF LEMONT

THE CONTRACTOR WILL NOT BE ALLOWED TO SET UP A YARD OR FIELD OFFICE ON STATE PROPERTY WITHOUT WRITTEN PERMISSION FROM THE DEPARTMENT.

WHEN MILLED PAVEMENT IS OPEN TO TRAFFIC THE MAXIMUM GRADE DIFFERENTIAL BETWEEN PASSES OF THE MILLING MACHINE SHALL NOT EXCEED 40 MM (1½ INCHES) WHERE THE SPEED LIMIT IS 80 KM/H (45 MPH) OR LESS AND 25 MM (1 INCH) WHERE THE SPEED LIMIT IS GREATER THAN 80 KM/H (45 MPH). WITH WRITTEN APPROVAL FROM THE ENGINEER, A MAXIMUM GRADE DIFFERENTIAL OF 75 MM (3 INCHES) MAY BE ALLOWED IF THE EDGE OFTHE MILLING IS SLOPED A MINIMUM 1:3 (V:H).

BUTT JOINTS WILL BE INSTALLED AT THE ENDS OF ALL RESURFACING (WHERE RESURFACING MEETS EXISTING PAVEMENT), IN ACCORDANCE WITH THE "BUTT JOINT AND BITUMINOUS TAPER DETAILS" SHEET INCLUDED IN THE PLANS, UNLESS OTHERWISE SPECIFIED.

UNLESS OTHER CONDITIONS WARRANT EXTENDED LANE CLOSURE AS DETERMINED AND APPROVED IN WRITING BY THE ENGINEER OR AS PROVIDED FOR IN THE CONTRACT SPECIFICATIONS. OVERNIGHT CLOSURES SHALL NOT BE ALLOWED FOR REHABILITATION PROJECTS INVOLVING DAYTIME MILLING AND RESURFACING OPERATIONS AND CLASS D PATCHING.

PRIOR TO EMBANKMENT PLACEMENT, ALL VEGETATION, LOOSE MATERIAL, AND UNSTABLE MATERIAL SHALL BE REMOVED TO DEPTH ENCOUNTERED AND REPLACED WITH SUITABLE EMBANKMENT MATERIAL. ANY EMBANKMENT WIDENING ON EXISTING SLOPES SHALL BE BENCHED IN ACCORDANCE WITH ARTICLE 205.04 OF THE STANDARD SPECIFICATIONS FOR ROAD AND BRIDGE CONSTRUCTION.

ALL PAVEMENT MARKING SHALL BE PLACED THROUGHOUT THE IMPROVEMENT ACCORDING TO DISTRICT 1 TYPICAL PAVEMENT MARKING

ON STATE STANDARDS 482001 AND 483001 AGGREGATE SUBGRADE 300 MM (12") SHALL BE USED AS THE IMPROVED SUBGRADE. THE ADDITIONAL THICKNESS OF AGGREGATE SUBGRADE UNDER THE SHOULDER SHALL BE INCLUDED IN THE COST PER SQUARE METER (SQ YARD) OF AGGREGATE SUBGRADE 300 MM (12")

THE RESIDENT ENGINEER SHALL CONTACT MS. DEBBIE HANLON AREA TRAFFIC FIELD TECHNICIAN AT (847) 438-2300 A MINIMUM OF 2 WEEKS PRIOR TO PLACEMENT OF PERMANENT PAVEMENT MARKIMG.

THE RESIDENT ENGINEER SHALL VERIFY THE LOCATIONS OF ALL EXISTING PAVEMENT MARKING PRIOR TO MILLING OR RESURFACING.

REVISIONS		TILIMOTS	DEPARTMENT OF TRANSPORTATION
NAME	DATE	ILLINOIS	DEFAILMENT OF TRANSPORTATION
		F.A	.P. 346 (IL RTE. 41)
		1	© IL 173
		INDEX OF	SHEETS, STANDARDS, AND
		INDEX OF	GENERAL NOTES
		1	OLIVEITAL HOTES
		SCALE: VERT.	DRAWN BY
		DATE HORIZ.	

LOT DATE = 6/8/2005 ILE NAME = criprojects/d100005/consult_v8/ LOT SCALE = 56.00000 // IN. SER NAME = chobona

F.A.	SECTION	COUNT	Y	TOTAL SHEETS	SHEET NO.		
346	124 N	LAK	E	19	3		
FED.	ROAD DIST. NO. 1	ILL	INOIS	HIG	HWAY PR	DJECT	
62954							

	SUMMARY OF QUANTITIES			URBAN	CONSTRU	CTION TYPE	CODE			SUMMARY OF QUANTITIES			URBAN	 JONSTRUCT	ION TYPE C	JUDE
······································	SUMMART OF QUANTITIES			100 %							1	TOTAL	100 %			
0005 NO		UNIT	TOTAL	STATE					CODE NO	ITEM	UNIT	QUANTITIES	STATE	 		
CODE NO	ITEM	UNIT	QUANTITIES	1000-2A				-	CODE NO	1164	J. C.	44	I000-2A	 		
				1000 24										 		
20200100	EARTH EXCAVATION	CU YD	1313	1313					72400600	RELOCATE SIGN PANEL ASSEMBLY - TYPE B	EACH	1	1			
20201200	REMOVAL AND DISPOSAL OF UNSUITABLE MATERIAL	CU YD	113	113					78000100	THERMOPLASTIC PAVEMENT MARKING - LETTERS AND SYMBOLS	SQ FT	150	150			
21001000	GEOTECHNICAL FABRIC FOR GROUND STABILIZATION	SQ YD	715	715				دا	78000200	THERMOPLASTIC PAVEMENT MARKING - LINE 4"	FOOT	1446	1446			
1101625	TOPSOIL FURNISH AND PLACE, 6"	sa yo	665	665					78000400	THERMOPLASTIC PAVEMENT MARKING	F00T	70	70			
5000210	SEEDING, CLASS 2A	ACRE	0.14	0.14					79000000	THERMOPLASTIC PAVEMENT MARKING	FOOT	144	144			
5000400	NITROGEN FERTILIZER NUTRIENT	POUND	13	13					78000600	- LINE 12"	, 007	•				
5000500	PHOSPHORUS FERTILIZER NUTRIENT	POUND	13	13					78000650	THERMOPLASTIC PAVEMENT MARKING	FOOT	24	24			
5000600	POTASSIUM FERTILIZER NUTRIENT	POUND	13	13					70160100	- LINE 24"	EACH	12	12			
5100630	EROSION CONTROL BLANKET	SQ YD	678	678					78100100	RAISED REFLECTIVE PAVEMENT MARKER		2	2			
8000300	TEMPORARY DITCH CHECKS	EACH	2	2					78201000	TERMINAL MARKER - DIRECT APPLIED	EACH	_				
0600200	BITUMINOUS MATERIALS (PRIME COAT)	TON	0.5	0.5					X0322256	TEMPORARY INFORMATION SIGNING	SQ FT	48	48			
0600300	AGGREGATE (PRIME COAT)	TON	2.5	2.5					X0322752	WORK ZONE PAVEMENT MARKING REMOVAL	FOOT	1500	1500			
0600980	BITUMINOUS SURFACE REMOVAL - BUTT JOINT	SQ YD	40	40	4				X0323973	SEDIMENT CONTROL, SILT FENCE POLYMERIZEO	F00T	1000	1000			
4000100	PAVEMENT REMOVAL	SQ YD	417	417					X4066548	IBITUMINOUS CONCRETE SURFACE COURSE, SUPERPAVE, MIX "F", N90	TON	166	166			
4000500	COMBINATION CURB AND GUTTER REMOVAL	FOOT	300	300					X4066658	POLYMERIZED (BITUMINOUS CONCRETE BINDER COURSE, SUPERPAVE, IL-19.0, N90	TON	1000	1000			
4001430	BITUMINOUS SHOULDER REMOVAL	SQ YD	746	746					X7240505	RELOCATE SIGN PANEL AND POST	EACH	8	8			
8101200	AGGREGATE SHOULDERS, TYPE B	TON	94	94					Z0001050	AGGREGATE SUBGRADE 12"	SQ YD	1857	1857			
3200600	BITUMINOUS SHOULDERS 8"	SQ YD	585	585						CONSTRUCTION LAYOUT	L SUM	1	1			
0107600	PIPE UNDERDRAINS 4"	FOOT	934	934					Z0013798			20	20			
0603800	COMBINATION CONCRETE CURB AND GUTTER, TYPE B-6.12	FOOT	30	30					1	TRAFFIC BARRIER TERMINALTYPE !,	SQ.FT.	/	,			
3000000	STEEL PLATE BEAM GUARD RAIL, TYPE A	FOOT	300	300					T (0)100161	SPECIAL (TANGENT)		,	1000			
	STEEL PLATE BEAM GUARD RAIL, ATTACHED TO STRUCTURES	FOOT	4	4					X0323974	SEDIMENT CONTROL, SICT FENCE MAINTENANCE	F00T	1000	7888			
3100045	TRAFFIC BARRIER TERMINAL, TYPE 2	EACH	1	1												
3200310	GUARDRAIL REMOVAL	FOOT	102	102												
7000400	ENGINEER'S FIELD OFFICE, TYPE A	CAL MO	2	2												
7100100	MOBILIZATION	L SUM	1	1												
0101800	TRAFFIC CONTROL AND PROTECTION (SPECIAL)	L SUM	1	1												
0300520	PAVEMENT MARKING TAPE, TYPE III 4"	FOOT	1636	1636												


REVISIONS ILLINOIS DEPARTMENT O
NAME DATE SUMMARY OF (

ILLINOIS DEPARTMENT OF TRANSPORTATION SUMMARY OF QUANTITIES


X SPECIALTY ITEMS


Rev.

PLOT DATE:_6/9/2005

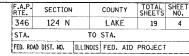

CONTRACT NO. 62954

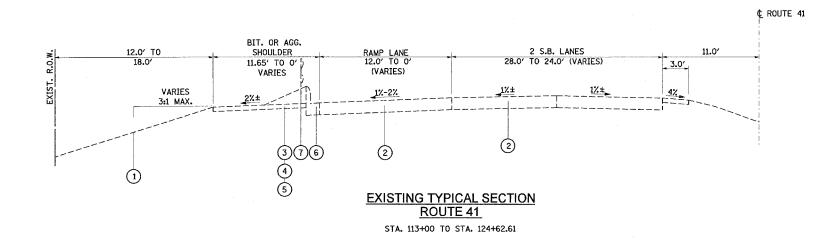

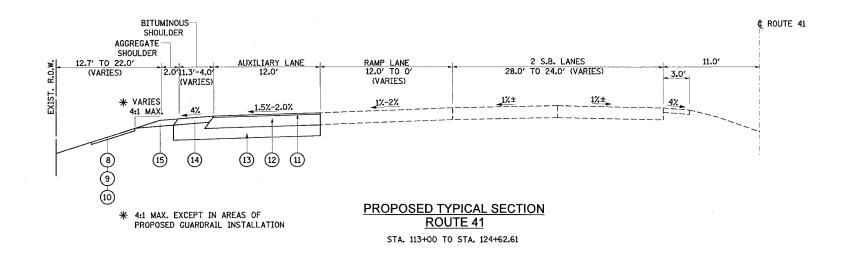


EXISTING AND PROPOSED LEGEND

- EXISTING GROUND
- (2) EXISTING PAVEMENT
- (3) EXISTING SHOULDER
- (4) EXISTING PAVED SHOULDER REMOVAL
- (5) EXISTING AGGREGATE SHOULDER REMOVAL (PAID FOR AS EARTH EXCAVATION)
- (6) EXISTING COMBINATION CURB AND GUTTER REMOVAL
- (7) EXISTING GUARDRAIL REMOVAL
- 8 PROPOSED TOPSOIL FURNISH AND PLACE, 6 INCHES
- 9 PROPOSED SEEDING CLASS 2A
- (10) PROPOSED NITROGEN, PHOSHORUS AND POTASSIUM FERTILIZER NUTRIENTS
- 1) POLY. BITUMINOUS CONCRETE SURFACE COURSE, SUPERPAVE, MIX "E", N90, 2 INCHES
- (12) POLY. BITUMINOUS CONCRETE BINDER COURSE, SUPERPAVE, IL-19.0, N90, 12 INCHES
- (13) PROPOSED AGGREGATE SUB-GRADE, 12 INCHES
- 14) PROPOSED BITUMINOUS SHOULDERS, 8 INCHES
- 15 PROPOSED AGGREGATE SHOULDERS-TY B, 8 INCHES

BITUMINOUS MIXTURE REQUIREMENTS CHART

MIXTURE	AC TYPE	VOIDS	MAX RAP.
POLYMERIZED BITUMINOUS CONCRETE SURFACE COURSE, SUPERPAVE, MIX "F", N90	SBS/SBR PG 70 -22	4% @ 90 GYR.	0%
POLYMERIZED BITUMINOUS CONCRETE BINDER COURSE, SUPERPAVE, IL-19.0, N90	SBS/SBR PG 70 -22	4% @ 90 GYR.	0%

NOTE: THE WEIGHT USED FOR ALL BITUMINOUS SURFACE MIXTURES IS 112 LB/SQ. YD./IN.

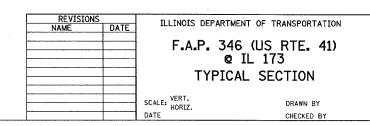

01 DATE = 6/24/2006 E NAME : orbrojesta/di20705\consult_v8\c084_typ-71 SCALE = 56.0008 // IM. ER NAME : absebson

CONTRACT NO. 62954

EARTHWORK SCHEDULE


STATION	STATION LENGTH	EXCAVATION END AREA (S.F)	EMBANKMENT END AREA (S.F.)	EXCAVATION (CU. YD)	EXCAVATION USED AS EMBANKMENT (SHRINKAGE 15%) (CU. YD.)	EMBANKMENT (CU. YD)	EARTHWORK BALANCE SURPLUS (+) OR SHORTAGE (-) (CU. YD.)	UNSUITABLE MATERIAL (CU. YD.)
115+08.03		14.76	0.00					
116+00	91.97	44.65	0.10	101.21	86.03	0.17		
117+00	100	34.53	0.04	146.63	124.64	0.26		
118+00	100	35.80	0.00	130.24	110.70	0.07		
119+00	100	36.90	0.00	134.60	114,41	0.00		
120+00	100	33.00	2.34	129.44	110.02	4.33		
120+70.05	70.05	33.63	1.95	86.43	73.47	5.57		
121+00	29.95	36.45	4.15	38.87	33.04	3.38		
122+00	100	47.83	0.00	156.07	132,66	7.69		
123+00	100	52.64	0.08	186.06	158.15	0.15		
124+00	100	52.10	0.00	193.96	164.87	0.15		
124+62.61	62.61	53,60	0.00	122.55	104.17	0.00		
		SUB	TOTAL	1426	1212.16	21.17	+ 1191	113


NOTE:

A THICKNESS OF 6 INCHES OF TOPSOIL STRIPPING SHALL BE USED FOR REMOVAL AND DESPOSAL OF UNSUITABLE MATERIAL.


REVISIO NAME	NS DATE	ILLINOIS DEPARTMENT OF TRANSPORTATION				
		F.A.P. 346 (
***************************************		SCHEDULE OF	2.0			
		SCALE: VERT. HORIZ. DATE	DRAWN BY			

.E NAME = 01/07-03-05-05/08/08/05/00-05-01/07-09/08/09/04.typ-1 TSCALE = 50.0000 / IN. TSCALE = 01.0000 / IN.

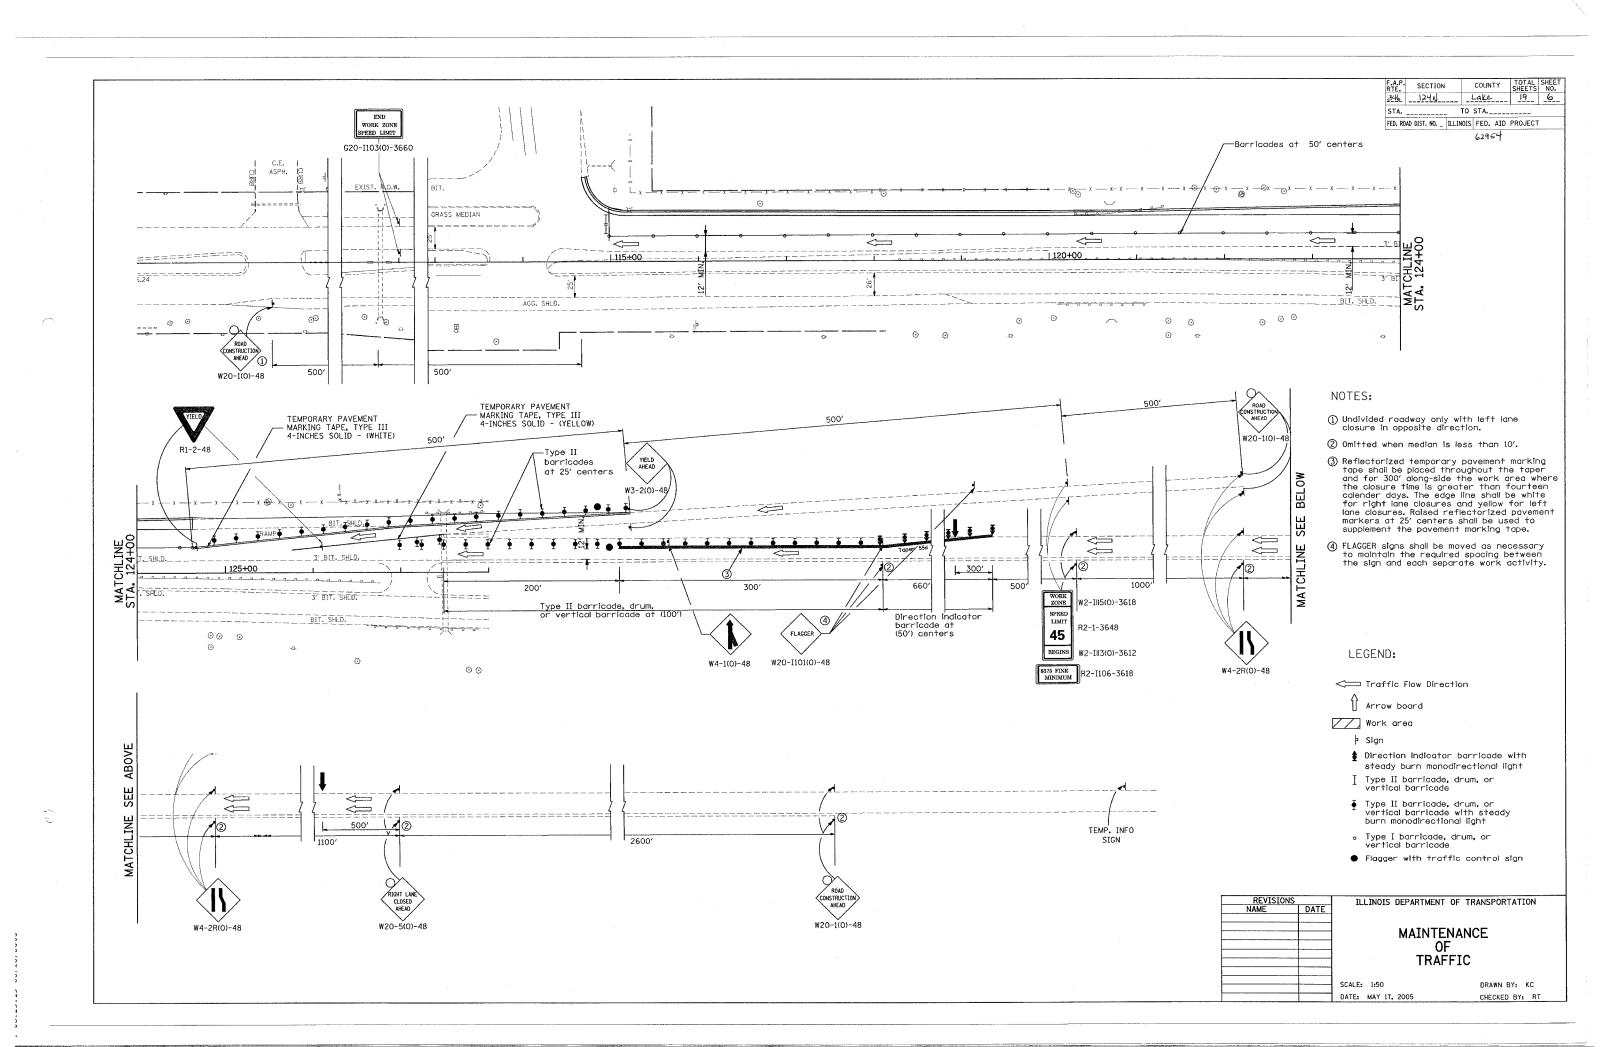


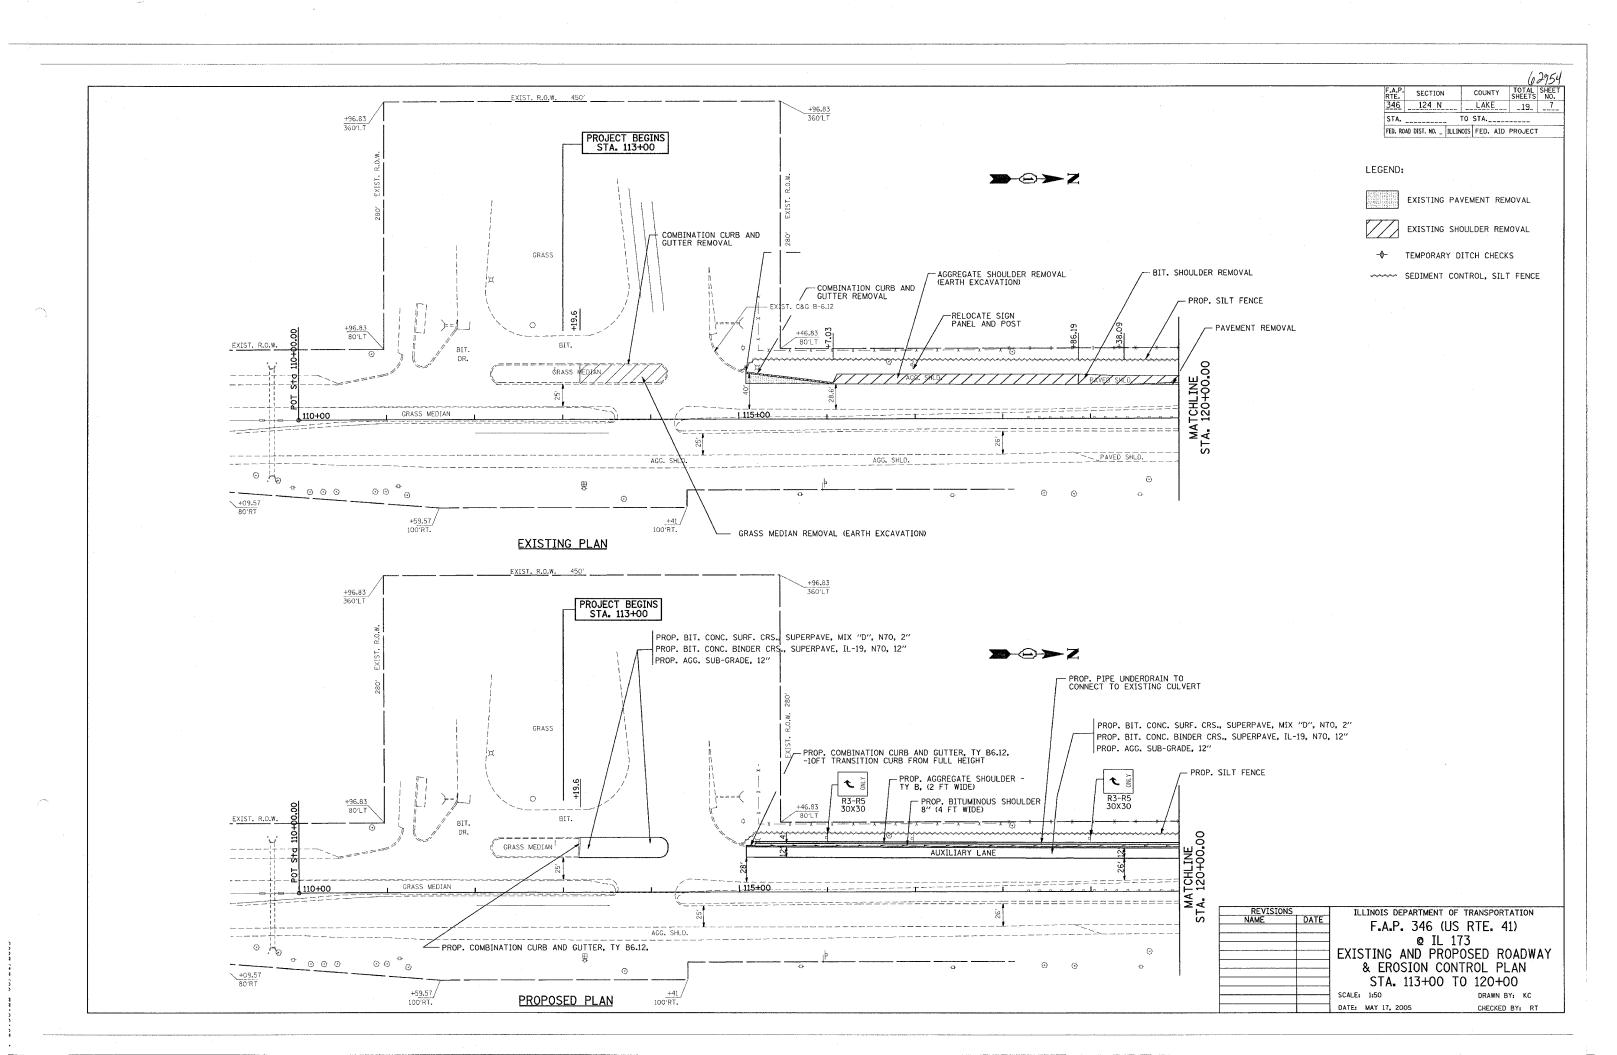

>2

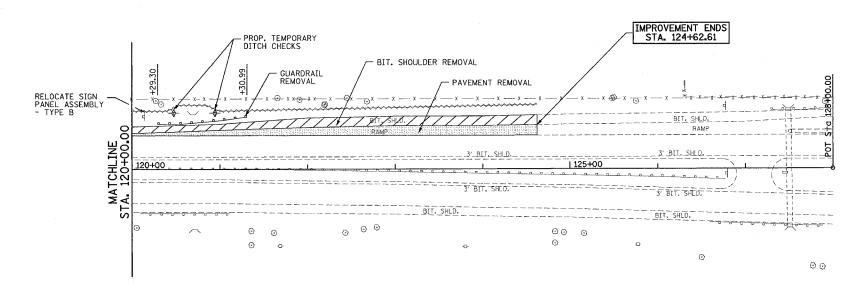

EXISTING PLAN

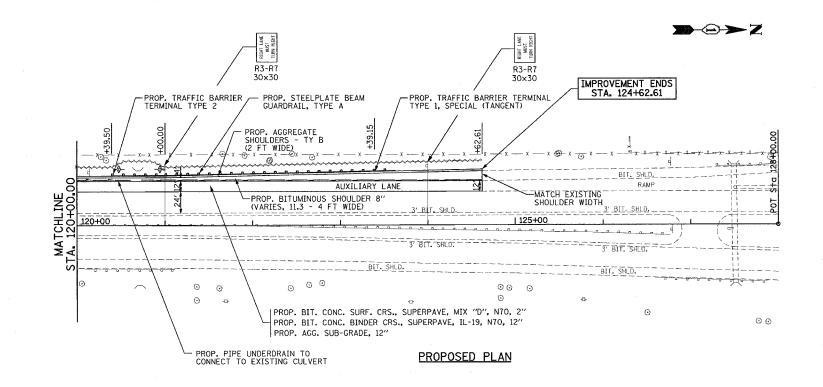

LEGEND:

EXISTING PAVEMENT REMOVAL



EXISTING SHOULDER REMOVAL

-♦~

TEMPORARY DITCH CHECKS

SEDIMENT CONTROL, SILT FENCE

REVISIONS
NAME
DATE

F.A.P. 346 (US RTE. 41)

© IL 173

EXISTING AND PROPOSED ROADWAY


& EROSION CONTROL PLAN


STA. 120+00 TO 125+00

SCALE: 1:50

DATE: MAY 17, 2005

CHECKED BY: RT

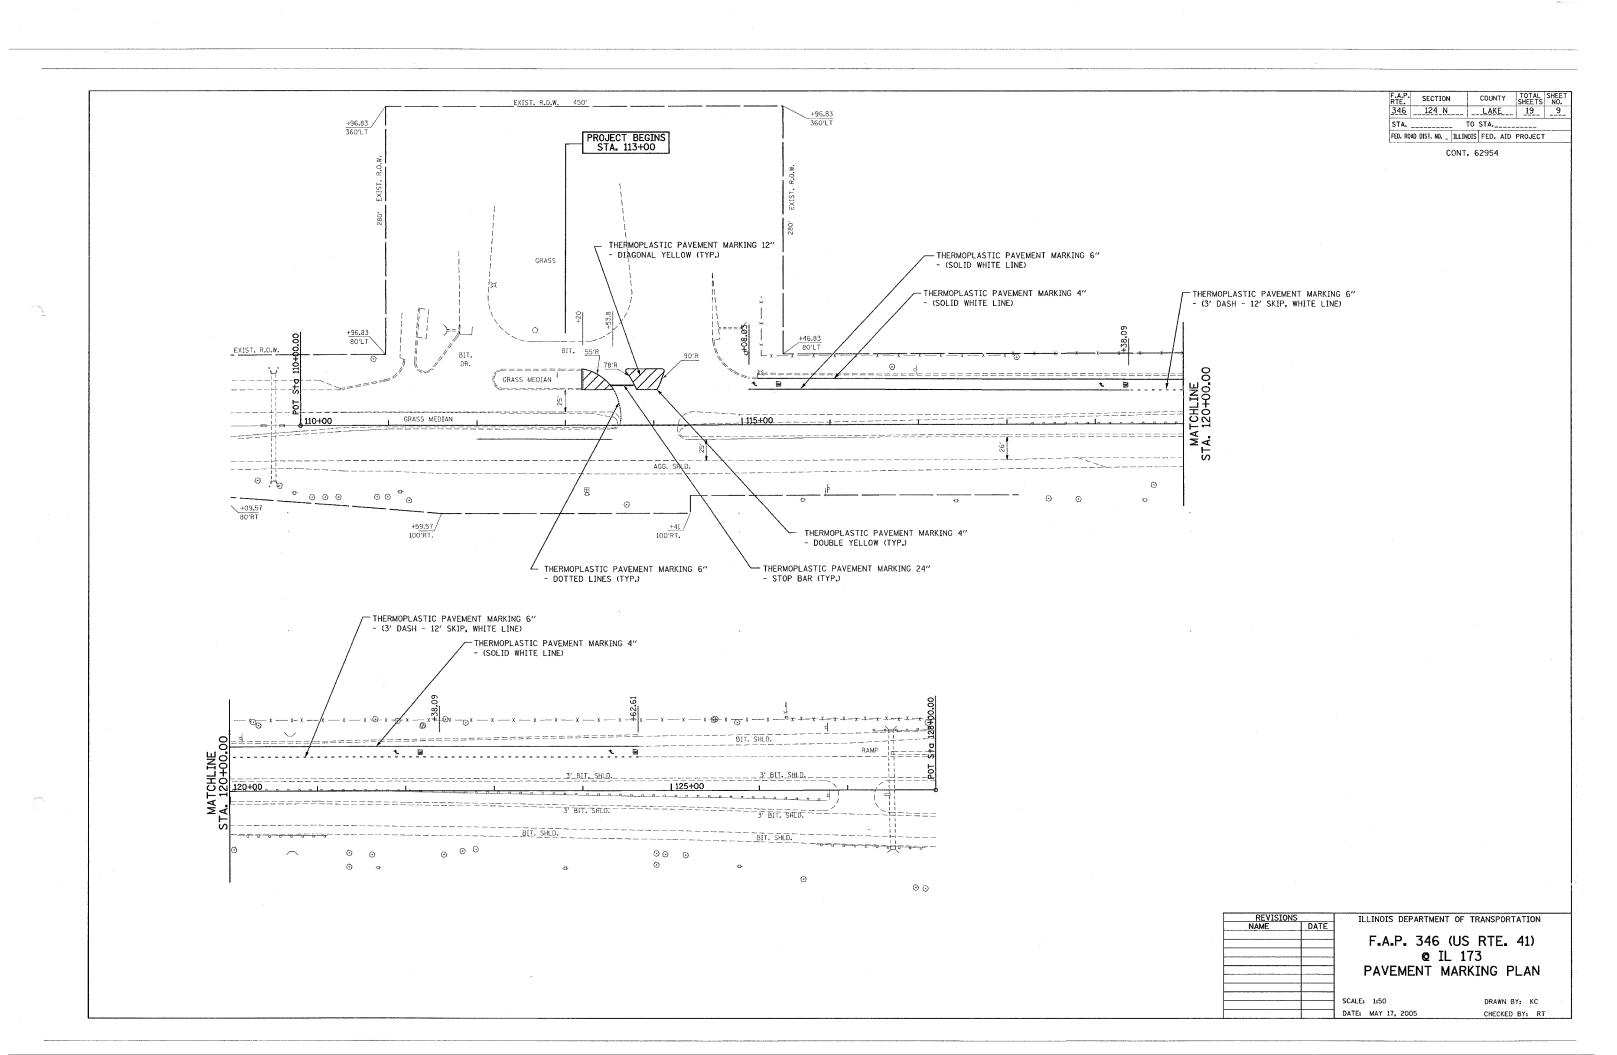

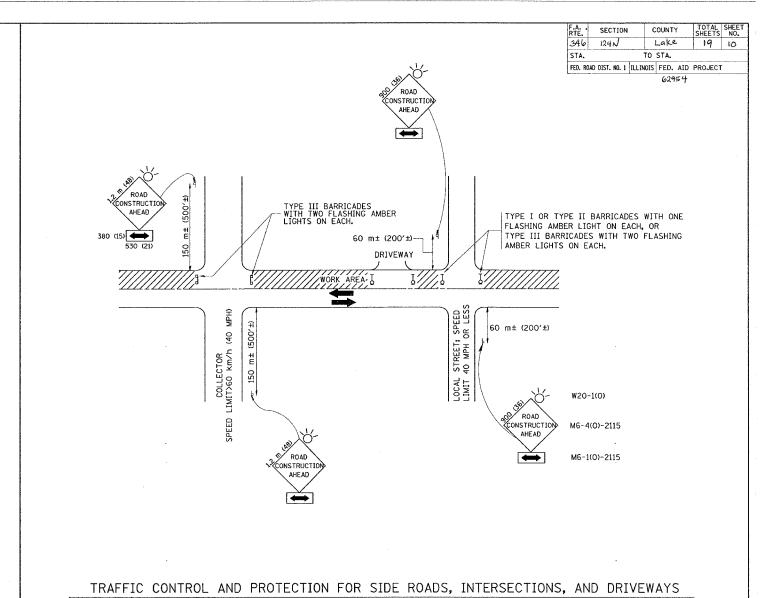

NOTES:

- A. FOR NO LANE RESTRICTION ON THE SIDE ROAD OR DRIVEWAYS
- 1. SIDE ROAD WITH A SPEED LIMIT OF 60 km/h (40 MPH) OR LESS AS SHOWN ON THE DRAWING AND AS DIRECTED BY THE ENGINEER:
- O) ONE ROAD CONSTRUCTION AHEAD SIGN 900×900 (36×36) WITH A FLASHER AND FLAG MOUNTED ON IT APPROXIMATELY 60 m (200') IN ADVANCE OF THE MAIN ROUTE.
- b) THE CLOSED PORTION OF THE MAIN ROUTE SHALL BE PROTECTED BY BLOCKING WITH TYPE I, TYPE II OR TYPE III BARRICADES, 1/3 OF THE CROSS SECTION OF THE CLOSED PORTION.
- 2. SIDE ROAD WITH A SPEED LIMIT GREATER THAN 60 km/h (40 MPH) AS SHOWN ON THE DRAWING AND AS DIRECTED BY THE ENGINEER:
- g) ONE ROAD CONSTRUCTION AHEAD SIGN 1.2 m x 1.2 m (48x48) WITH A FLASHER MOUNTED ON IT APPROXIMATELY 150 m (500') IN ADVANCE OF THE MAIN ROUTE.
- b) THE CLOSED PORTION OF THE MAIN ROUTE SHALL BE PROTECTED BY BLOCKING WITH TYPE III BARRICADES, 1/2 OF THE CROSS SECTION OF THE CLOSED PORTION.
- 3. WHEN THE SIDE ROAD LIES BETWEEN THE BEGINNING OF THE MAINLINE SIGNING AND THE WORK ZONE, A SINGLE HEADED ARROW (MG-1) SHALL BE USED IN LIEU OF THE DOUBLE HEADED ARROW (M6-4).

B. FOR A LANE CLOSURE ON A SIDE ROAD OR DRIVEWAY:

USE APPLICABLE PORTIONS OF THE TYPICAL APPLICATION OF TRAFFIC CONTROL DEVICES (STD. 701501, STD. 701606 OR THE APPROPRIATE STANDARD). THE SPACING OF SIGNS AND BARRICADES SHALL BE ADJUSTED FOR FIELD CONDITIONS AS DIRECTED BY THE ENGINEER. THE DIRECTIONAL ARROW SHALL BE COVERED OR REMOVED WHEN NO LONGER CONSISTENT WITH THE SIDE ROAD LANE CLOSURE.

- C. ADVANCE WARNING SIGNS ARE TO BE OMITTED ON DRIVEWAY UNLESS
- D. THE TRAFFIC CONTROL AND PROTECTION FOR SIDE ROADS, INTERSECTIONS, AND DRIVEWAYS SHALL BE INCIDENTAL TO THE COST OF SPECIFIED TRAFFIC CONTROL STANDARDS OR ITEMS.

REVISIO	NS	
NAME	DATE	
LHA	6/89	-
T. RAMMACHER	09/08/94	
J. OBERLE	10/18/95	
A. HOUSEH	03/06/96	
A. HOUSEH	10/15/96	
T. RAMMACHER	01/06/00	
		۱.
		٦

ILLINOIS DEPARTMENT OF TRANSPORTATION TRAFFIC CONTROL AND PROTECTION FOR


SIDE ROADS, INTERSECTIONS, AND DRIVEWAYS

SCALE: VERT. HORIZ. DATE 5/24/2005


CHECKED BY

5/24/2005 w:\diststd\tclO.dgn abebawa


REVISION DATE: 01/06/00

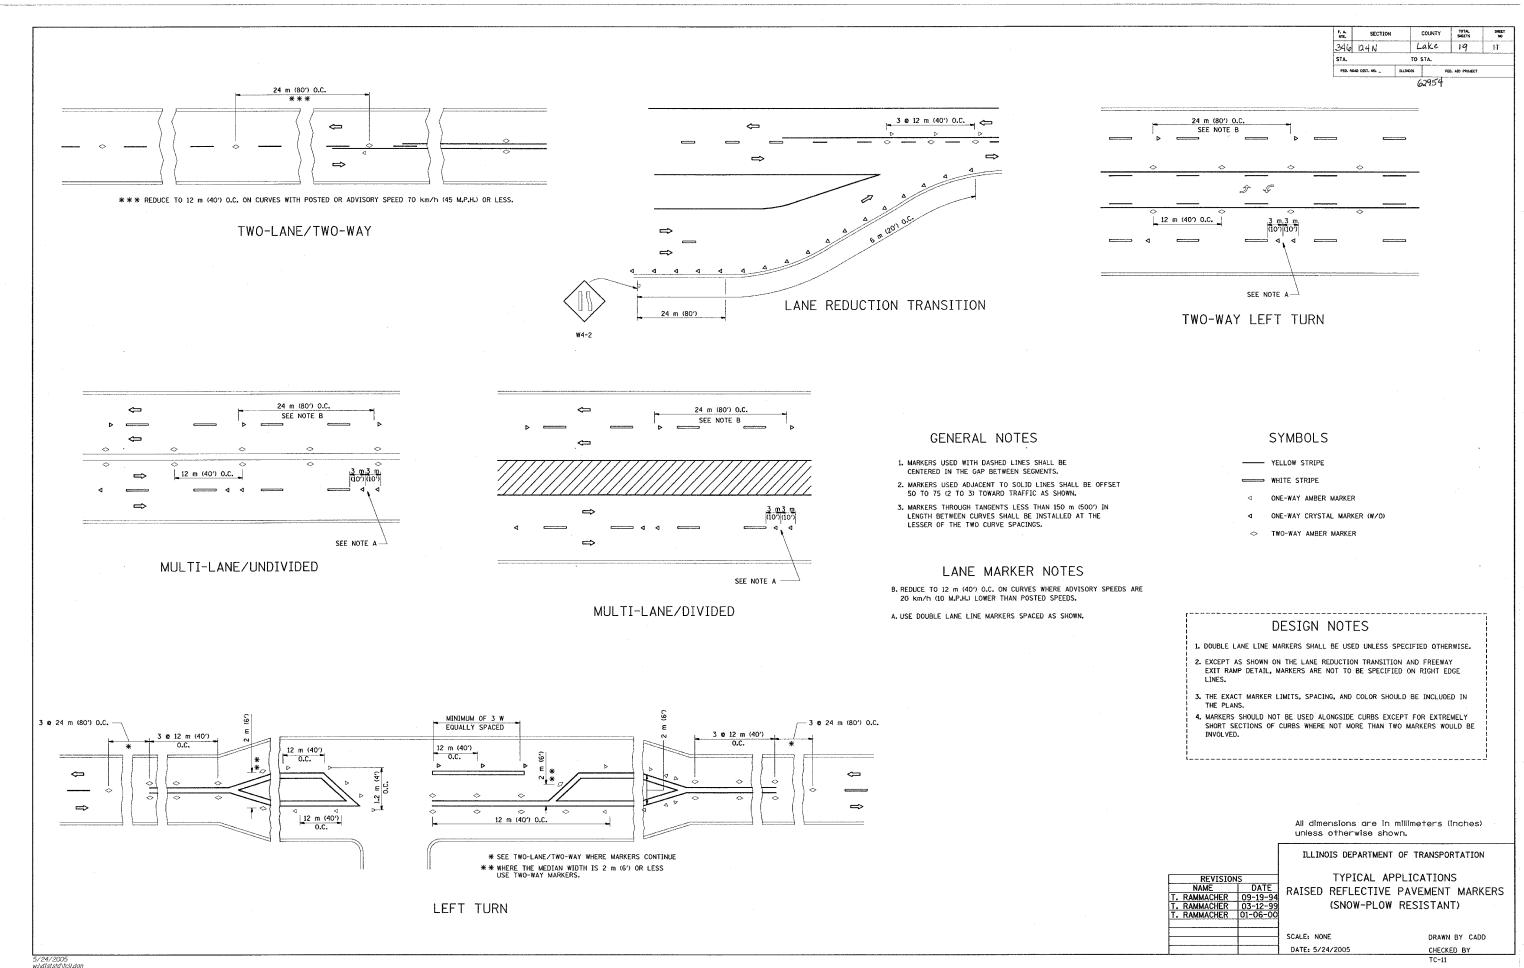


REVISION DATE: 01/06/00

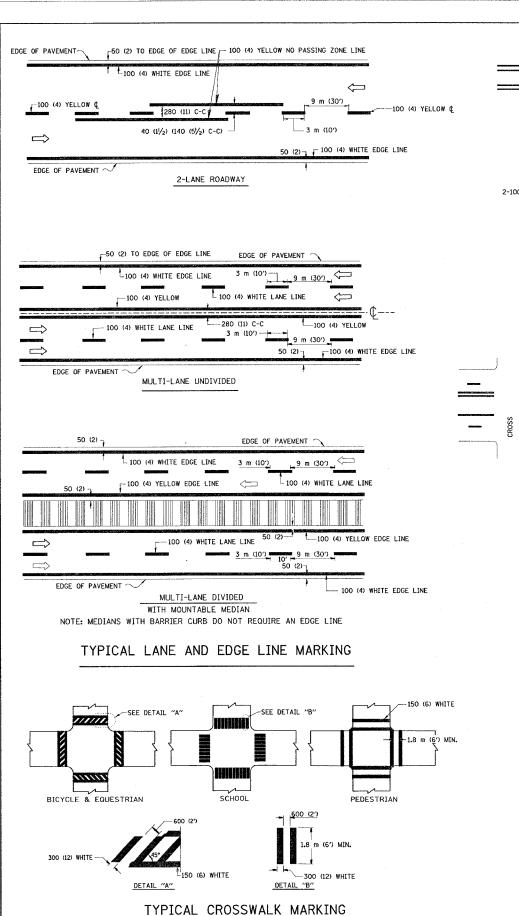

5/24/2005 w:\dlststd\tcl3.dgn

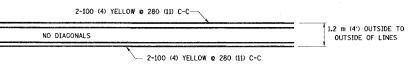


1.2 m (4') WIDE MEDIANS ONLY

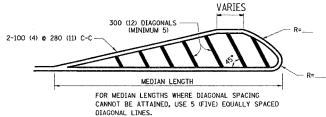


DIAGONAL LINE SPACING: 15 m (50') C-C (LESS THAN 50 km/h (30 MPH)) 25 m (75') C-C (50 km/h (30 MPH) TO 70 km/h (45 MPH)) 45 m (150') C-C (MORE THAN 70 km/h (45 MPH))

MEDIANS OVER 1.2 m (4') WIDE

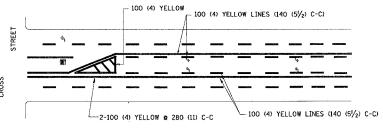


A MINIMUM OF TWO PAIRS OF TURN ARROWS SHALL BE USED, WHITE IN COLOR. ADDITIONAL PAIRS SHALL BE PLACED AT 60 m (200') TO 90 m (300') INTERVALS.

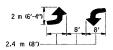

MEDIAN WITH TWO-WAY LEFT TURN LANE

TYPICAL PAINTED MEDIAN MARKING

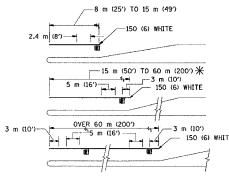



FULL SIZE LETTERS 2.4 m (8") AND ARROWS SHALL BE USED. \P AREA = 1.5 m² (15.6 SQ. FT.) ONLY AREA = 1.9 m² (20.8 SQ. FT.)

 \divideontimes TURN LANES IN EXCESS OF 120 m (400") IN LENGTH MAY HAVE AN ADDITIONAL SET OF ARROW - "ONLY" INSTALLED MIDWAY BETWEEN THE OTHER TWO SETS OF

TYPICAL LEFT (OR RIGHT) TURN LANE

TYPICAL TURN LANE MARKING

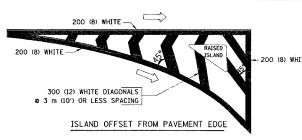

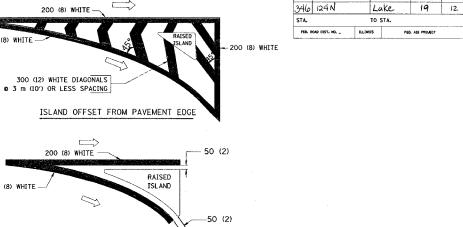

TYPICAL ISLAND MARKING

ISLAND AT PAVEMENT EDGE

TYPE OF MARKING	WIDTH OF LINE	PATTERN	COLOR	SPACING / REMARKS
CENTERLINE ON 2 LANE PAVEMENT	100 (4)	SKIP-DASH	YELLOW	3 m (10') LINE WITH 9 m (30') SPACE
CENTERLINE ON MULTI-LANE UNDIVEDED PAVEMENT	2 @ 100 (4)	SOLID	YELLOW	280 (II) C-C
NO PASSING ZONE LINES: FOR ONE DIRECTION FOR BOTH DIRECTIONS	100 (4) 2 2 100 (4)	SOLID SOLID	YELLOW YELLOW	140 (5)/ ₂) C-C FROM SKIP-DASH CENTERLINE 280 (II) C-C OMIT SKIP-DASH CENTERLINE BETWEEN
LANE LINES	100 (4) 125 (5) ON FREEWAYS	SKIP-DASH SKIP-DASH	WHITE WHITE	3 m (10') LINE WITH 9 m (30') SPACE
DOTTED LINES (EXTENSIONS OF CENTER, LANE OR TURN LANE MARKINGS)	SAME AS LINE BEING EXTENDED	SKIP-DASH	SAME AS LINE BEING EXTENDED	600 (2') LINE WITH 1.8 m (6') SPACE
EDGE LINES	100 (4)	SOLID	YELLOW-LEFT WHITE-RIGHT	OUTLINE MOUNTABLE MEDIANS IN YELLOW; EDGE LINES ARE NOT USED NEXT TO BARRIER CURB
TURN LANE MARKINGS	150 (6) LINE; FULL SIZE LETTERS & SYMBOLS (2.4 m (8'))	SOLID	WHITE	SEE TYPICAL TURN LANE MARKING DETAIL
TWO WAY LEFT TURN MARKING	2 @ 100 (4) EACH DIRECTION	SKIP-DASH AND SOLID	YELLOW	3 m (10') LINE WITH 9 m (30') SPACE FOR SKIP-DASH; 140 (5½) C-C BETWEEN SOLID LINE AND SKIP-DASH LINE
	2.4 m (8') LEFT ARROW	IN PAIRS	WHITE	SEE TYPICAL TWO-WAY LEFT TURN MARKING DETAIL
CROSSWALK LINES (PEDESTRIAN) A. DIAGONALS (BIKE & EQUESTRIAN) B. LONGITUDINAL BARS (SCHOOL)	2 @ 150 (6) 300 (12) @ 45° 300 (12) @ 90°	SOLID SOLID SOLID	WHITE WHITE WHITE	NOT LESS THAN 1.8 m (6') APART 600 (2') APART 600 (2') APART SEE TYPICAL CROSSWALK MARKING DETAILS.
STOP LINES	600 (24)	SOLID	WHITE	PLACE 1.2 m (4') IN ADVANCE OF AND PARALLEL TO CROSSWALK, IF PRESENT. OTHERWISE, PLACE AT DESIRED STOPPING POINT. PARALLEL TO CROSSROAD CENTERLINE, WHERE POSSIBLE
PAINTED MEDIANS	2 @ 100 (4) WITH 300 (12) DIAGONALS @ 45° NO DIAGONALS USED FOR 1.2 m (4') WIDE MEDIANS	SOLID	YELLOW: TWO WAY TRAFFIC WHITE: ONE WAY TRAFFIC	280 (11) C-C FOR THE DOUBLE LINE SEE TYPICAL PAINTED MEDIAN MARKING.
GORE MARKING AND CHANNELIZING LINES	200 (8) WITH 300 (12) DIAGONALS @ 45°	SOLID	WHITE	DIAGONALS: 4.5 m (15') C-C (LESS THAN 50 km/h (30 MPH)) 6 m (20') C-C (50 km/h (30 MPH) TO 70 km/h (45 MPH) 9 m (30') C-C (OVER 70 km/h (45 MPH))
RAILROAD CROSSING	600 (24) TRANSVERSE LINES; "RR" IS 1,8 m (6') LETTERS; 400 (16) LINE FOR "X"	SOLID	WHITE	SEE STATE STANDARD 780001 AREA OF: "X"=0.33m2 (3.6 SQ. FT.) EACH "X"=5.0 m2 (54.0 SQ. FT.)
SHOULDER DIAGONALS	300 (12) @ 45°	SOLID	WHITE - RIGHT YELLOW - LEFT	15 m (50') C-C (LESS THAN 50 km/h (30 MPH)) 25 m (75') C-C (50 km/h (30 MPH) T0 70 km/h (45 MPH) 45 m (150') C-C (OVER 70 km/h (45 MPH))

FOR FURTHER DETAILS ON PAVEMENT MARKING REFER TO STANDARD SPECIFICATIONS FOR ROAD AND BRIDGE CONSTRUCTION AND STATE STANDARD 780001.

All dimensions are in millimeters (inches) unless otherwise shown.

COUNTY

F. A. RTE.

SECTION

TOTAL SHEETS

ILLINOIS DEPARTMENT OF TRANSPORTATION


REVISIONS					
NAME	DATE				
VERS	03-19-90				
RAMMACHER	10-27-94				
ex househ	10-09-96				
EX HOUSEH	10-17-96				
RAMMACHER	01-06-00				


DISTRI	CT	ONE	
TYPICAL	PΑ	VEMENT	
MAR	KIN	GS	

SCALE: NONE DATE 5/24/2005 DRAWN BY CADD CHECKED BY TC-13


REVISION DATE: 01/06/00



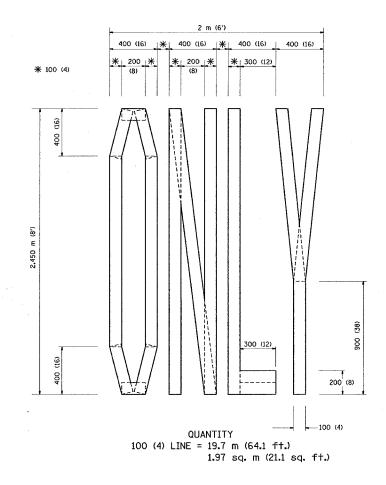

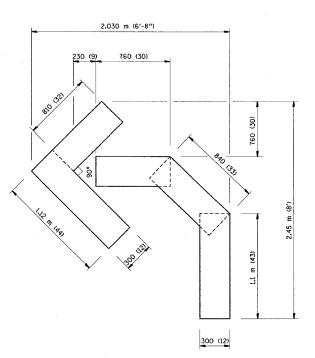

QUANTITY 100 (4) LINE = 13.9 m (45.5 ft.) 1.39 sq. m (15.2 sq. ft.)

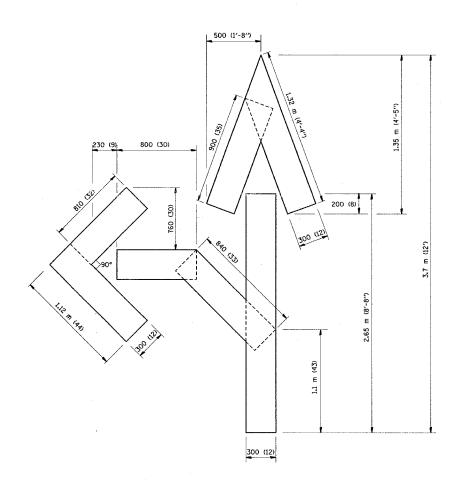

QUANTITY 100 (4) LINE = 25.3 m (82.5 ft.) 2.53 sq. m (27.5 sq. ft.)

All dimensions are in millimeters (inches) unless otherwise shown.


ILLINOIS DEPARTMENT OF TRANSPORTATION

REVISIONS
NAME DATE
T. RAMMACHER 09/18/94
J. OBERLE 06/01/96
T. RAMMACHER 06/05/96
T. RAMMACHER 11/04/97
T. RAMMACHER 03/02/98
E. GOMEZ 08/28/00 PAVEMENT MARKING LETTERS AND SYMBOLS FOR TRAFFIC STAGING

SCALE: NONE DATE 6/24/2005 DRAWN BY CADD

CHECKED BY TC-16

REVISION DATE: 08/28/00

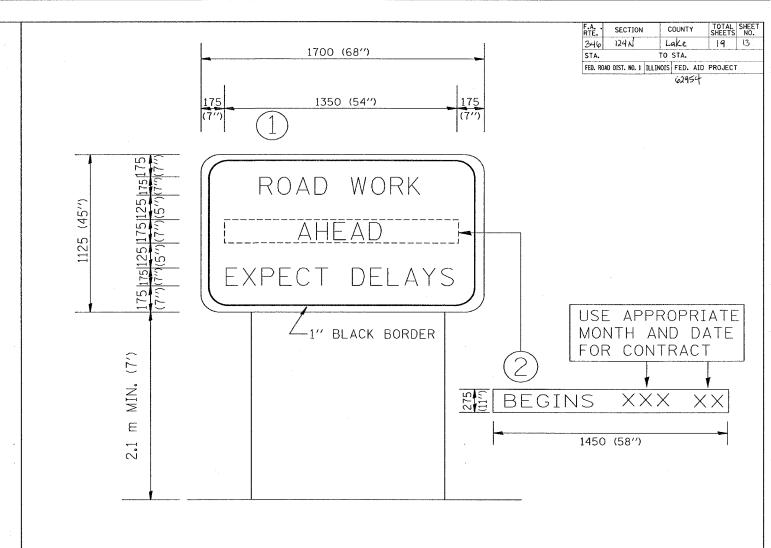

NOTES:

- 1. USE BLACK LETTERING ON ORANGE BACKGROUND.
- 2. ERECT SIGNS IN ADVANCE OF THE LOCATION FOR THE "ROAD CONSTRUCTION AHEAD" SIGN AT LOCATIONS AS DIRECTED BY THE ENGINEER.
- 3. ERECT SIGN (1) WITH INSTALLED PANEL (2) ONE WEEK PRIOR TO THE START OF CONSTRUCTION.
- 4. REMOVE PANEL 2 SOON AFTER THE START OF CONSTRUCTION.
- 5. SEE SPECIAL PROVISION FOR "TEMPORARY INFORMATION SIGNING" FOR ADDITIONAL INFORMATION.
- 6. ONE SIGN ASSEMBLY EQUALS 2.3 SQ. M. (25.70 SQ. FT.)

ALL DIMENSIONS ARE IN MILLIMETERS (INCHES)

UNLESS OTHERWISE SHOWN.

REVISIONS


NAME
DATE
R. MIRS
2-11-91
T. RAMMACHER
2-2-99

SCALE:
DRAWN BY: BUR. OF DESIGN
DATE 5/24/2005

TEQ2

REVISION DATE:02/02/99

5/24/2005 w:BdiststdBtc22.dgn VI=1022

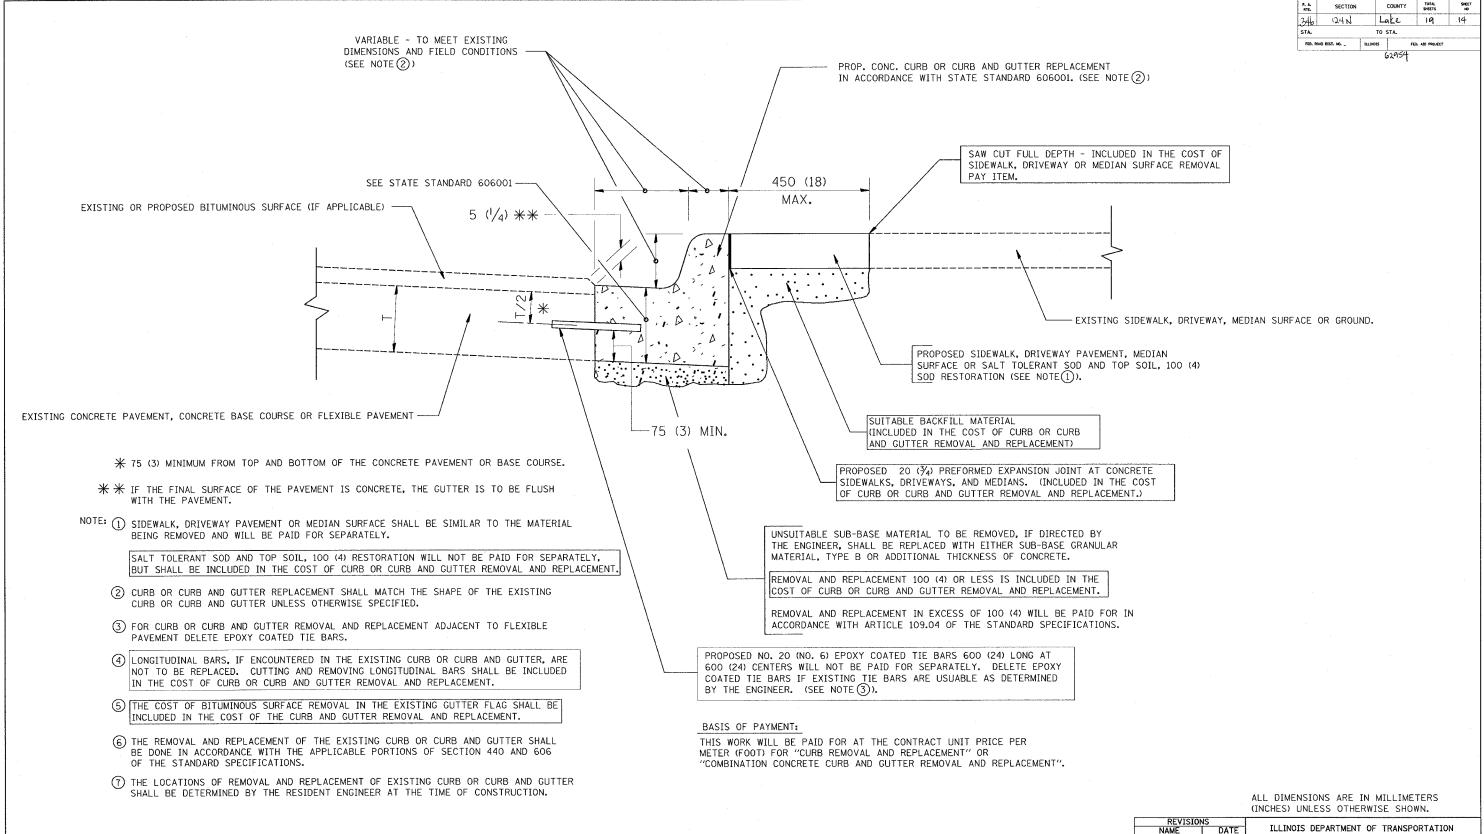

CURB OR CURB AND GUTTER REMOVAL AND REPLACEMENT

M. DE YONG 05/28/9 A. HOUSEH 03/11/94 R. SHAH 02/24/99 R. SHAH 08/19/96 R. SHAH R. SHAH R. SHAH R. SHAH A. ABBAS


CURB OR **CURB AND GUTTER REMOVAL AND REPLACEMENT**


SCALE: NONE

01/22/01 DATE 5/24/2005

BD600-06 (BD-24)

REVISION DATE: 12/06/88

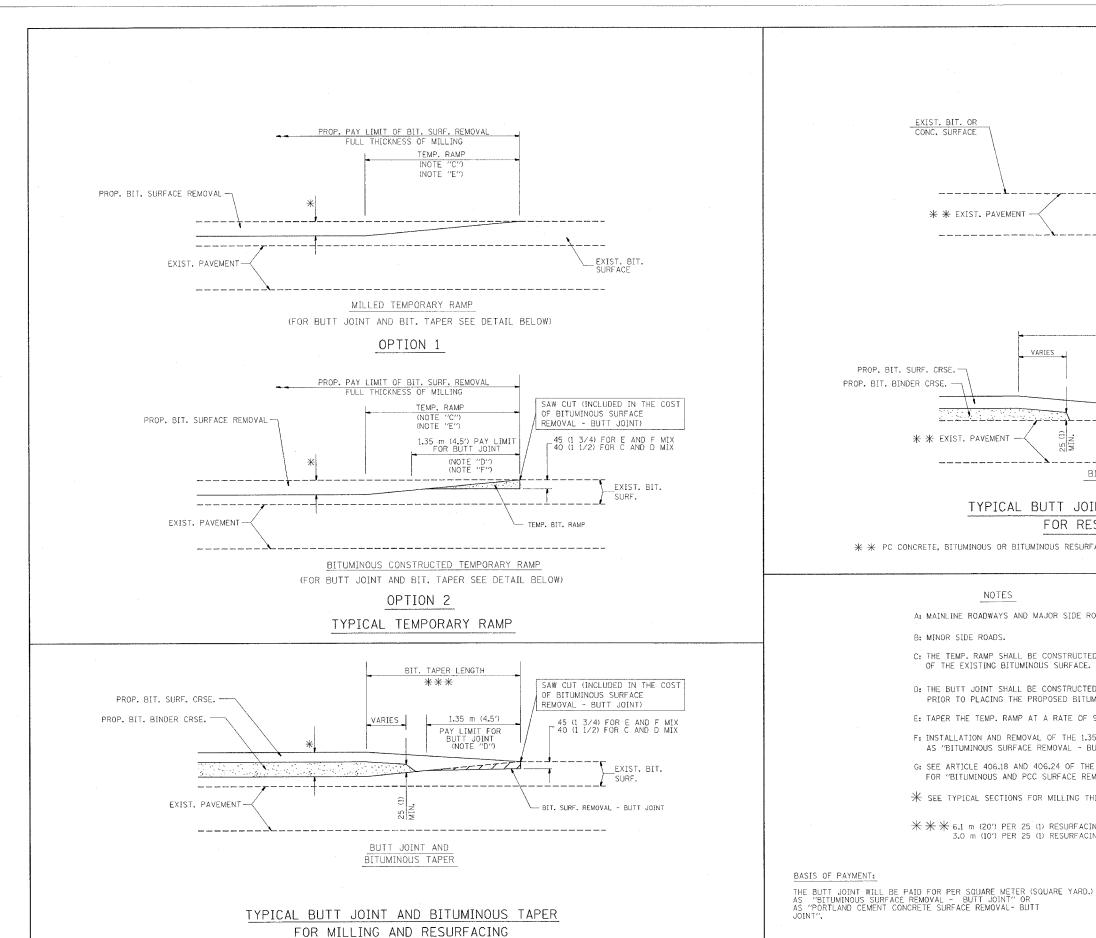

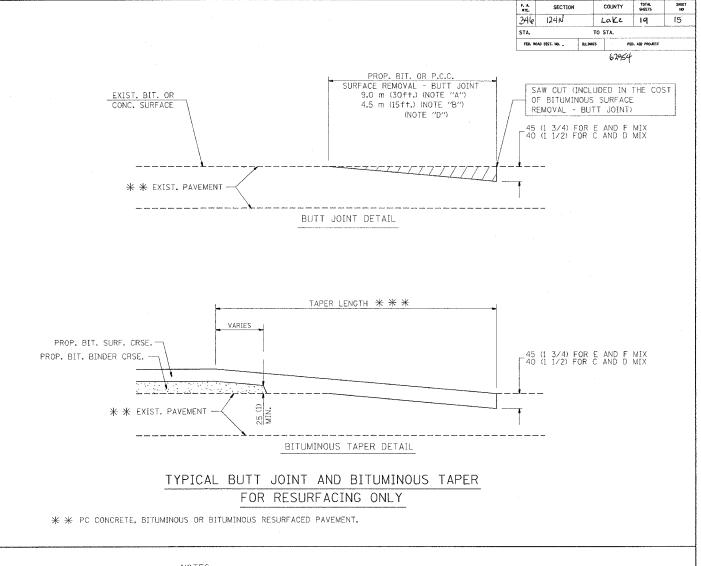

NOTES

- A: MAINLINE ROADWAYS AND MAJOR SIDE ROADS.
- B: MINOR SIDE ROADS.
- C: THE TEMP. RAMP SHALL BE CONSTRUCTED IMMEDIATELY UPON REMOVAL OF THE EXISTING BITUMINOUS SURFACE.
- D: THE BUTT JOINT SHALL BE CONSTRUCTED IMMEDIATELY PRIOR TO PLACING THE PROPOSED BITUMINOUS COURSES.
- E: TAPER THE TEMP. RAMP AT A RATE OF 900 (3 ft.) PER INCH OF MILLING THICKNESS.
- F: INSTALLATION AND REMOVAL OF THE 1.35 m (4.5') TEMP. BIT. RAMP WILL BE PAID AS "BITUMINOUS SURFACE REMOVAL - BUTT JOINT".
- G: SEE ARTICLE 406.18 AND 406.24 OF THE STANDARD SPECIFICATIONS FOR "BITUMINOUS AND PCC SURFACE REMOVAL, BUTT JOINT".
- * SEE TYPICAL SECTIONS FOR MILLING THICKNESS.

 $\mbox{\em \star}\mbox{\em \star}$

ALL DIMENSIONS ARE IN MILLIMETERS (INCHES) UNLESS OTHERWISE SHOWN.

ILLINOIS DEPARTMENT OF TRANSPORTATION

BUTT JOINT AND BITUMINOUS TAPER

DETAILS


SCALE: NONE

M. DE YONG

04/06/01 DATE PLOTTED:5/24/2005

5/24/2005 W:\diststd\bd32.dgn VI-BD32

Etabl/20132.dgn 5/24/2005 10: 14:37 AM Unar-abecuna

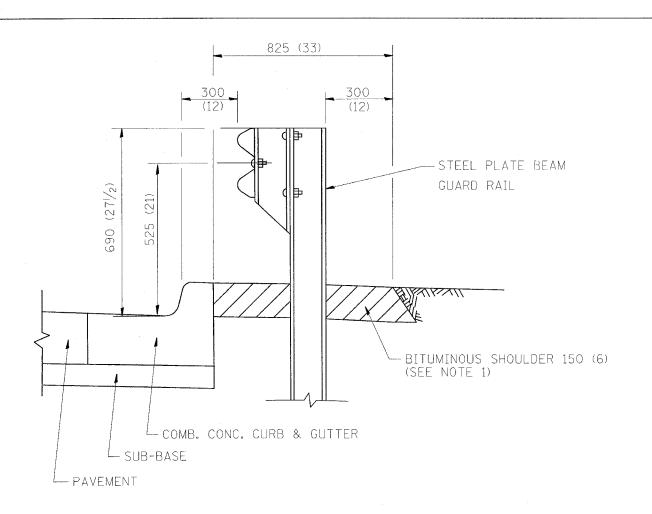

NOTES: 1. THE BITUMINOUS SHOULDER SHALL EXTEND UNDER THE TRAFFIC BARRIER TERMINAL

2. GUARD RAIL MAY BE PLACED AT THE BACK OF CURB WHEN DIRECTED BY THE ENGINEER.

BASIS OF PAYMENT: BITUMINOUS SHOULDER 150 (6) WILL BE PAID FOR AT THE CONTRACT UNIT PRICE PER m² (sq. yd.) AS "BITUMINOUS SHOULDER 150 (6)."

> STEEL PLATE BEAM GUARD RAIL AND TRAFFIC BARRIER TERMINAL, OF THE TYPE SPECIFIED WILL BE PAID FOR SEPARATELY.

DETAILS FOR STEEL PLATE BEAM GUARD RAIL ADJACENT TO CURB AND GUTTER FFOR ROADWAY SPEED 60 kmh (35 MPH) TO 70 kmh (45 MPH)]

346 124N TO STA. FED. ROAD DIST. NO. _ ILLINOIS PED, AID PROJECT OFFSET BASED ON MANUFACTURERS' SPECIFICATIONS GUARDRAILTBT TAPER OR FLARE
BASED ON MANUFACTURER'S SPECIFICATIONS DISTANCE FROM FACE OF RAIL 0.9 m (3'-0")

- EDGE OF PAVEMENT EDGE OF SHOULDER OR BACK OF CURB & GUTTER 1:10 MAX CROSS SLOPE VARIES _|3.0 m (10'-0") UNLESS OTHERWISE NOTED 750 mm (2'-6") SHOULDER EDGE OF SHOULDER STABILIZATION -825 mm (2'-9") CURB & GUTTER EDGE OF SHOULDER STABILIZATION BASED ON MANUFACTURER'S SPECIFICATIONS 11.4 m (37.5FT.) MIN. 15.2 m (50'-0") MAX. DEPRESSED CURB FOR URBAN CROSS SECTION WITH CURB AND GUTTER

STABILIZATION AT TBT TY. 1 SPL.

ALL DIMENSIONS ARE IN MILLIMETERS (INCHES) UNLESS OTHERWISE SHOWN.

COUNTY TOTAL SHEETS

Lake 19

ILLINOIS DEPARTMENT OF TRANSPORTATION

DETAILS FOR STEEL PLATE BEAM GUARD RAIL ADJACENT TO CURB AND GUTTER STABILIZATION AT TBT TY 1 SPL.


SCALE: NONE

DRAWN BY jls CHECKED BY

REVISION DATE: 08/28/00

DATE 5/24/2005 BD600-10 (BD 34)

5/24/2005 W:\diststd\bd34.dgn Vi=BD34

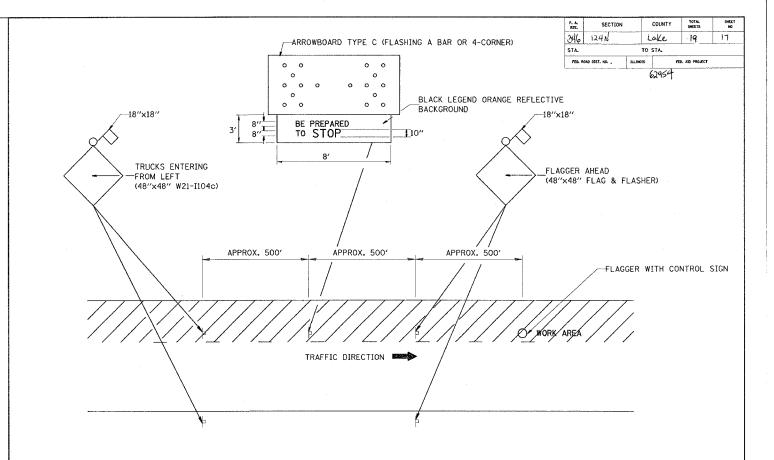

METHOD OF FLAGGING

NOTE:

- 1. SIGNS SHALL BE MOUNTED AT A MINIMUM CLEARANCE HEIGHT OF 5 FEET
- 2. ALL SIGNS SHALL BE REMOVED WHEN THE FLAGGING OPERATION CEASES.
- 3. THIS CASE ALSO APPLIES WHEN THE WORK ZONE IS ON THE RIGHT. UNDER THESE CONDITIONS "TRUCKS ENTERING FROM RIGHT" SIGNS SHALL BE SUBSTITUTED FOR "TRUCKS ENTERING FROM LEFT" SIGNS. ALSO THE ARROWBOARD AND "BE PREPARED TO STOP" SIGNS SHALL BE RELOCATED TO THE RIGHT SIDE OF THE ROAD.
- 4. WORK ZONE ACCESS POINTS SHOULD BE A MINIMUM OF ONE HALF MILE APART. MEDIAN WORK ZONE ACCESS POINTS SHOULD NOT BE LOCATED OPPOSITE OF EACH OTHER.
- 5. NIGHTTIME FLAGGING OPERATIONS: THE FLAG STATION SHALL BE LIGHTED WITH ADDITIONAL LIGHTS OTHER THAN STREET LIGHTS. THE FLAGGER CONTROL SIGN AND THE FLAGGER'S VEST SHALL BE REFLECTORIZED. IN ADDITION, THE FLAGGER SHALL HAVE A FLASHLIGHT OR LIGHTED WAND.

ILLINOIS DEPARTMENT OF TRANSPORTATION

METHOD OF FLAGGING

SCALE: NOT TO SCALE DATE 5/24/2005

DRAWN BY C.A.D. CHECKED BY

REVISION DATE: 05/10/00

5/24/2005 w:\diststd\bmi4.dgn Vi=BMI4

Stati/Lbm14.og: 5/24/2005 10:18:34 AM User-abobasa

