




SGN-21

3321

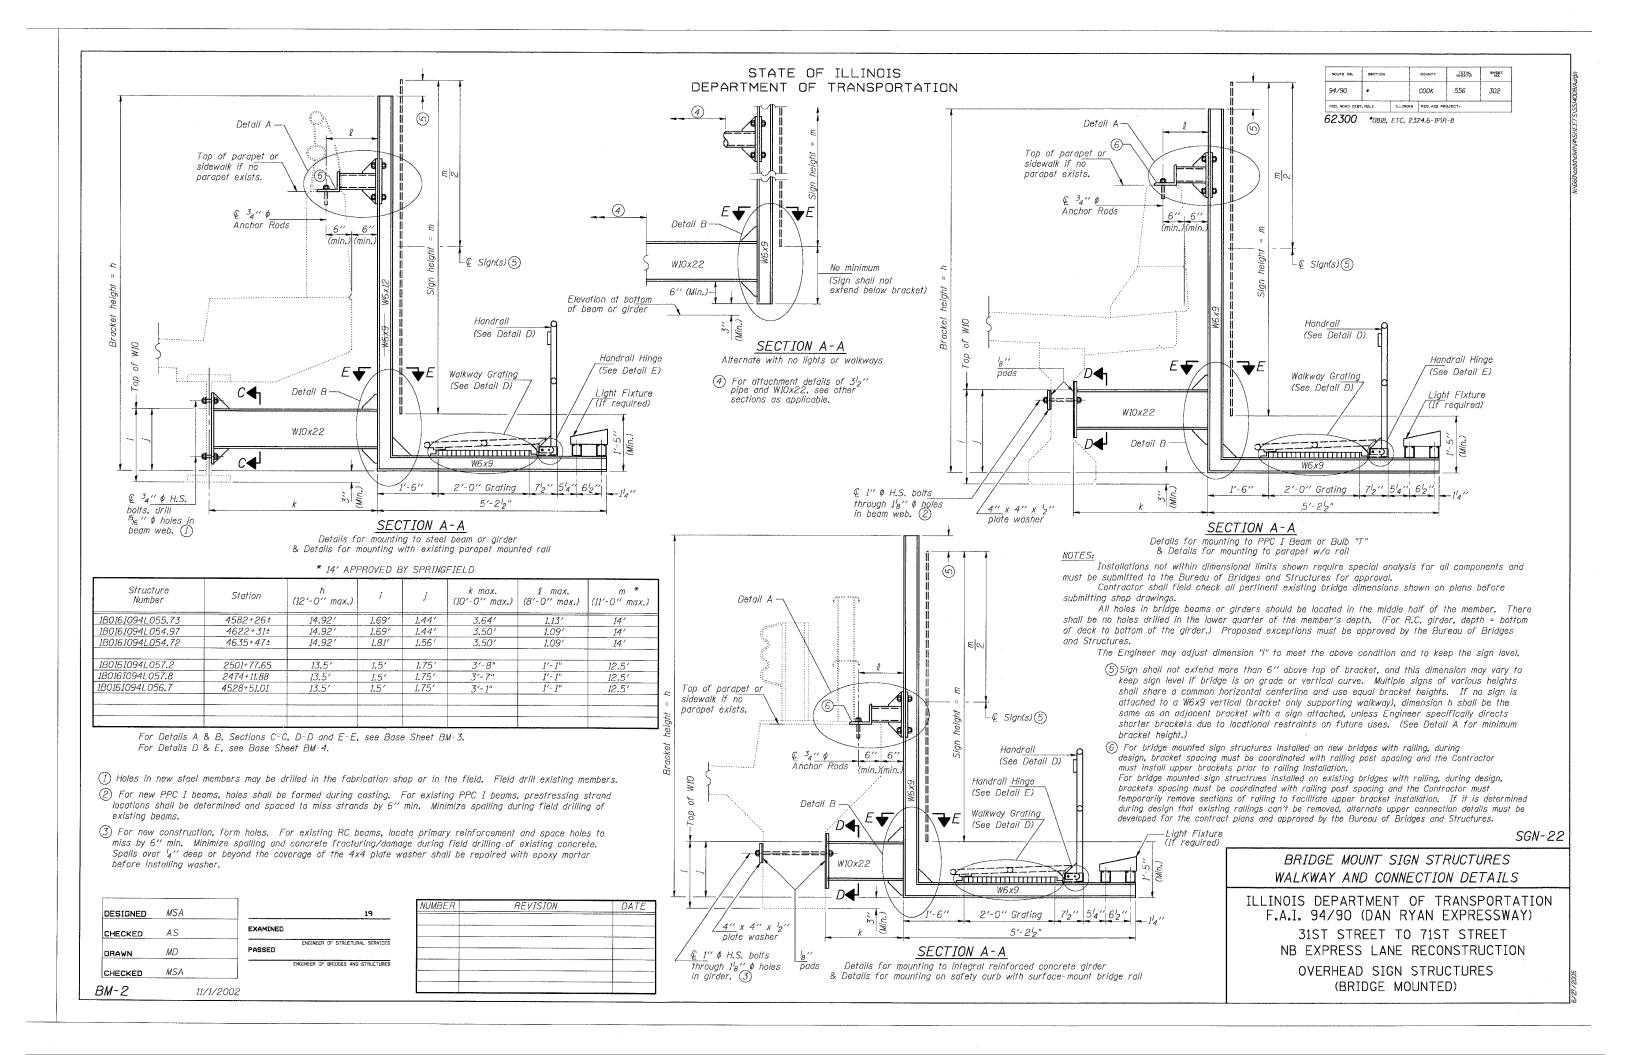

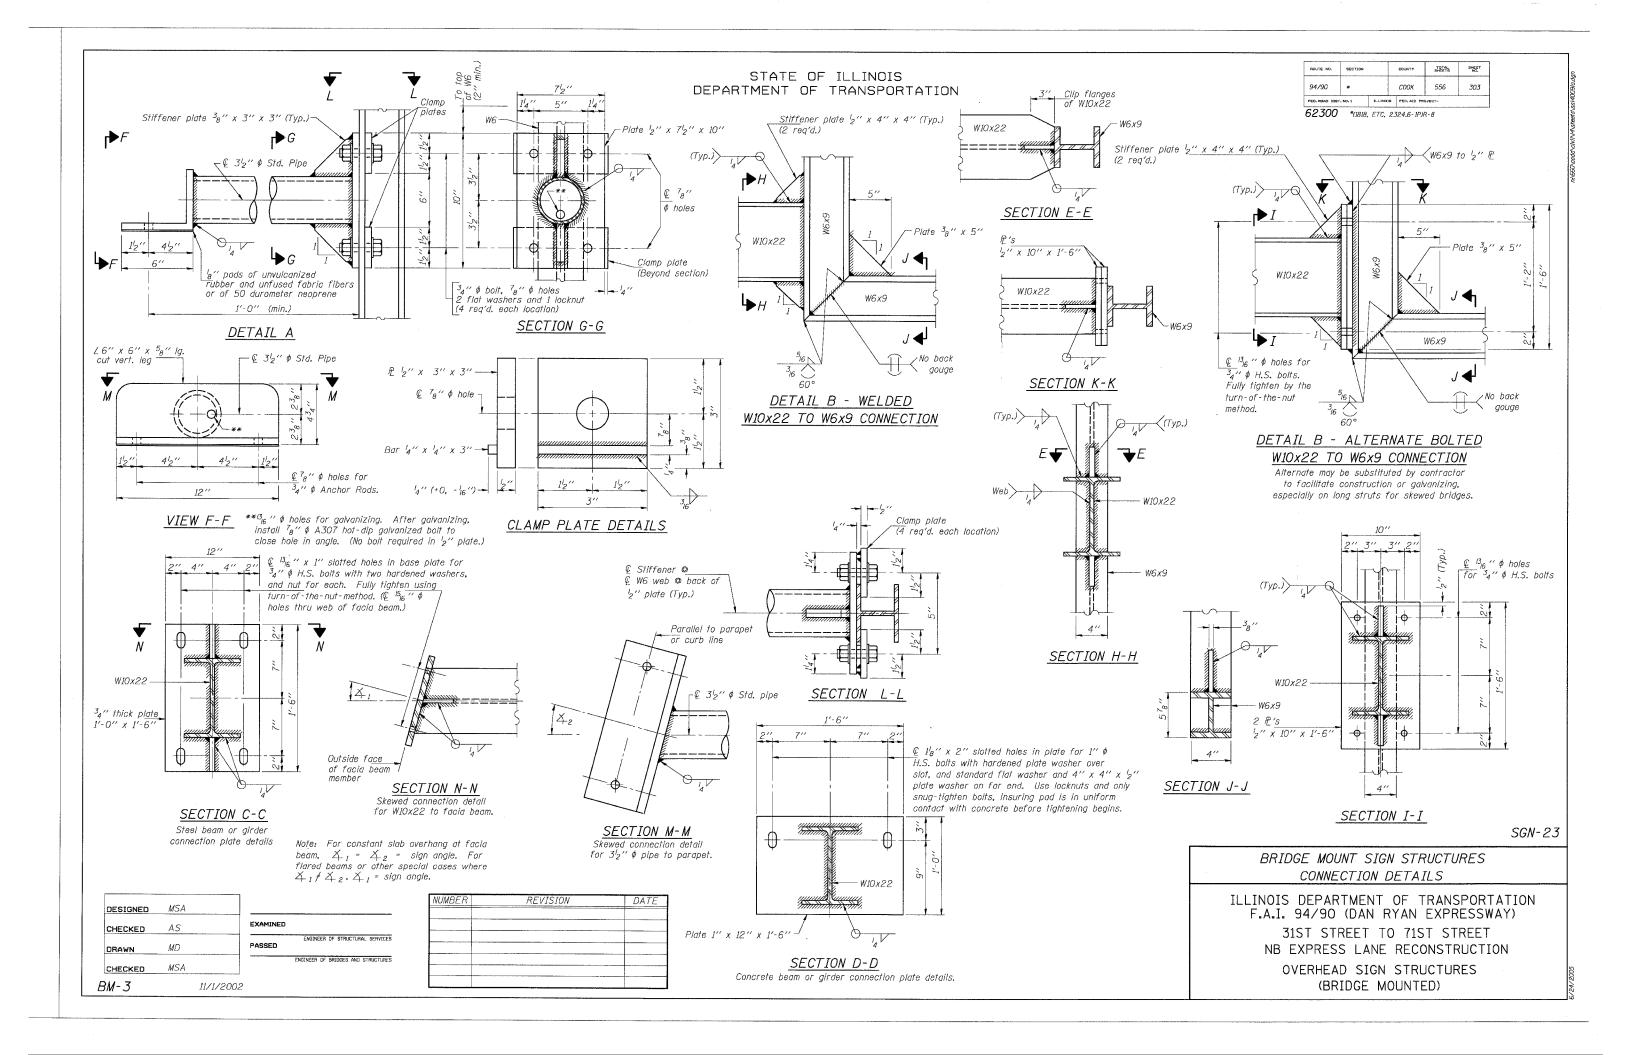

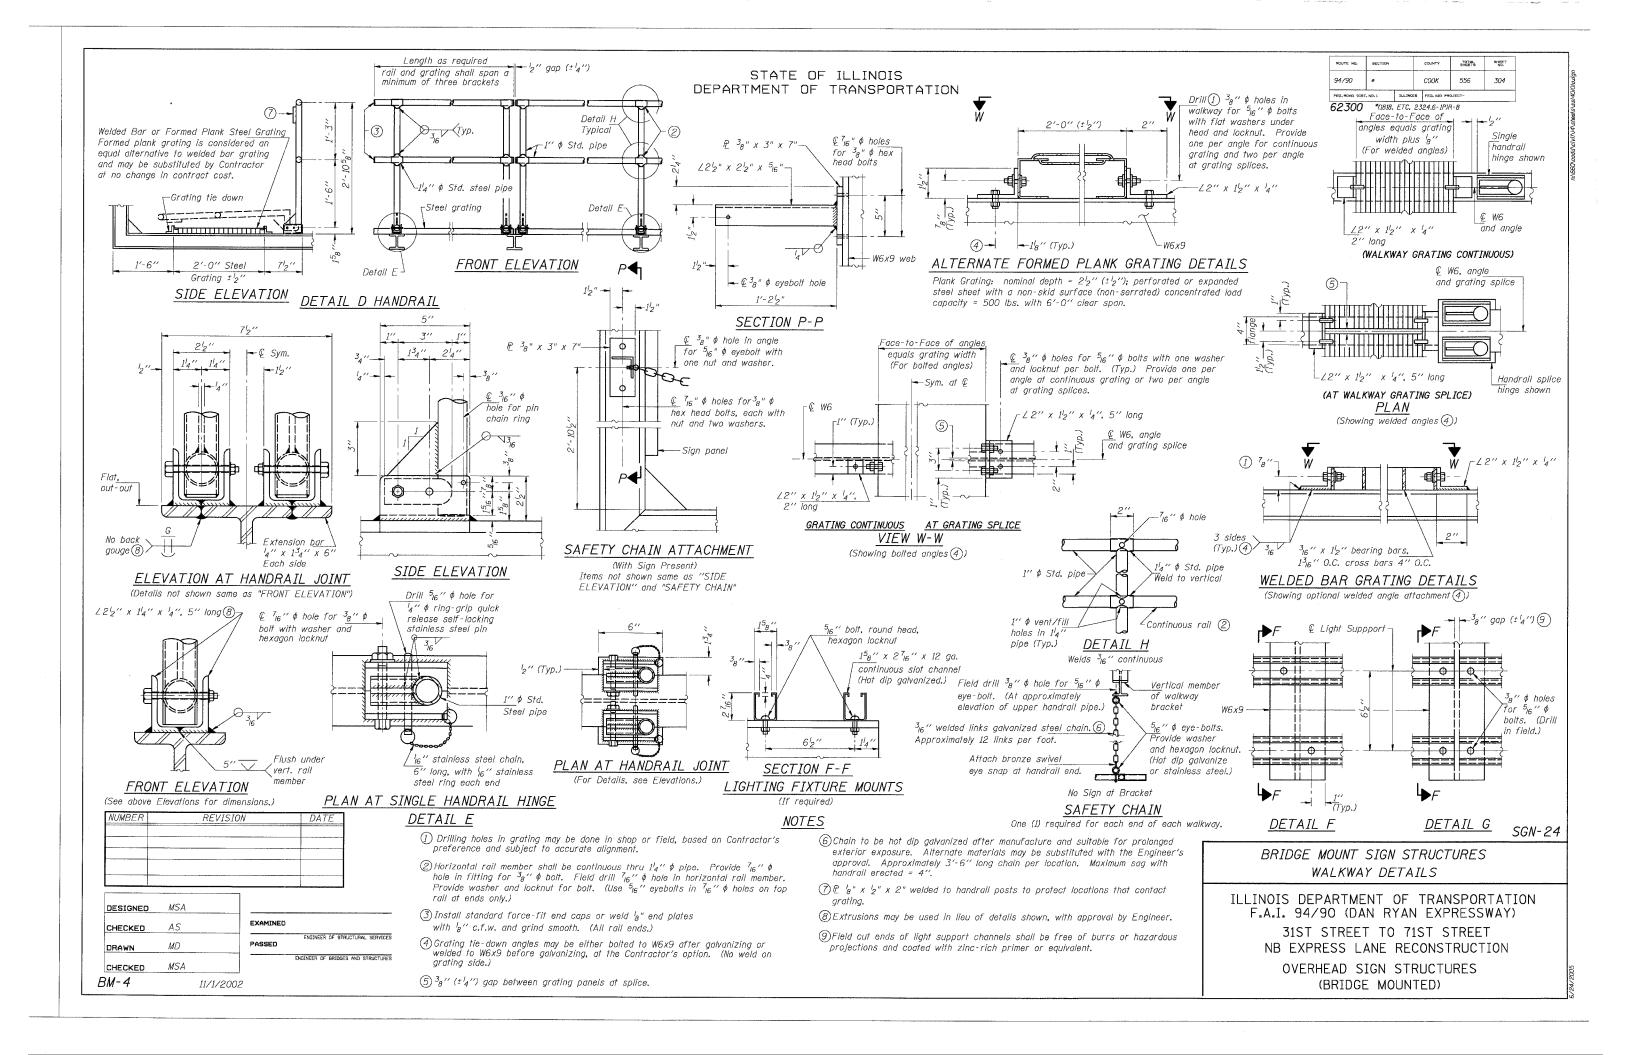

F.A.I. RTE.	SECTION	ı	COUNTY	TOTAL SHEETS	SHEET NO.
94/90	*		COOK	- 556	305
STA.	'	TO	STA.		
FED. RO.	AD DIST, NO.	ILLINO	S FED. AID	PROJECT	

62300 • (1818, ETC, 2324.6-1P)R-8

Illinois Depo	artment	IL BORING LO	0	Page	_1_ c	of <u>1</u>
Division of Highways AMERICAN GEOENGLYEERING, INC.	JIIOH 30	IL DONTING ED		Date	4/8	5/05_
ROUTE <u>F.A.I. (-90 / I-94</u> DESCI	RIPTION <u>Dan Ry</u>	<u>ch Expressway (D-91-419-81)</u>	· OGGE) BY	R.	۴
(1919.15A, ETC, SECTION 2122-921PT.1) R-3	LOCATION <u>Chica</u>	go, Illinsis				
COUNTY Cook DRILLING	LIGH CONTEM	ow Stem Auger HAMMER 1	YPE	Autor	<u>natic</u>	
Station Sign Structures	D 3 U M E L C O P 0 S I	Surface Water Elev. S-ream Bed Elev.	_ft D _ft E P	B L O	U C S	M 0 1
Station 2442+19.93	T W S Qu T	Groundwater Elev.: First Encounter <u>–6.4</u>	H H	W S	Qu	S
Offset 31.57ft (NBDR) Ground Surface Llev. 3.09 ft	ft)(/6")(tsf) (%)	Upon Completion AfterHrs	_ ft	(76")	tsf)	(%)
Aspha 1, 2" 2.92 Concrete, 12" 1.92		Hard / Dense Gray SILTY CLAY LOAM / SILTY	_			
Sub Bose, Gravel (FILL)	12	LOAM (continued)	_		5.9	10.0
	15	Medium Dense	-19.41	18	В	
	5	Gray SAND, trace silt and clay		11		
-1.91	8 -5 5		-21.91 -25	13 15		
Stiff to Hard Grcy SILIY CLAY LOAM —		Fard / Very Dense Gray				
SIL:1 CLAI LUAM	3 4 1,3 18,0	SILTY CLAY LOAV / SILTY LOAM		22 24	9.9	11.0
, store	9 8			26	S	
***************************************	_ 2		_	15		
10-Inch Schol Seam	7 4.9 16.0 10 8 B		-30	22 26	12.0 S	11.0
	_					
_	11 7.4 14.0		_			
Hard / Dense	11 B					
Gray - SILTY CLAY LOAM / SILTY	コ ₁₂ :			20		
LGAM —	12 6.2 13.0 -15 13 B		-31.91 -35	30	12.3 S	11.0
	10	End of Boring	3: - 3! - 35		:	
_	10 16 8.3 13.0		_			
19.	16 B,S					
	11 7.4 14.0 -20 12 3					

The Unconfined Compressive Strength (USS) Failure Mode is incicated by (8-Bulge, S-Shear, 2-Penetrometer) The SPT (N value) is the sum of the lost two blow values in each sampling zone (AASHTO T206) BBS, from 137 (Rev. 8-99)

ONE NORTH FRANKLIN CHICAGO, IL 60606 PHONE: (312) 251-3005 WEB: WWW.EKCORP.COM


F.A.I. 94/90 (DAN RYAN EXPRESSWAY)
31ST STREET TO 71ST STREET
NB EXPRESS LANE RECONSTRUCTION BORING LOG DRAWN BY: RLK DATE: 7/7/05 CHECKED BY: PJM


ILLINOIS DEPARTMENT OF TRANSPORTATION


F.A.I. SECTION COUNTY TOTAL SHEET NO. 94/90 • COOK 556 306

STA. TO STA. FED. ROAD DIST. NO. | ILLINOIS | FED. AID | PROJECT

62300 *(1818, ETC, 2324.6-1P)R-8

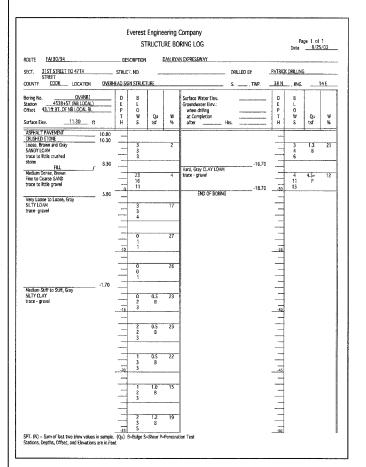

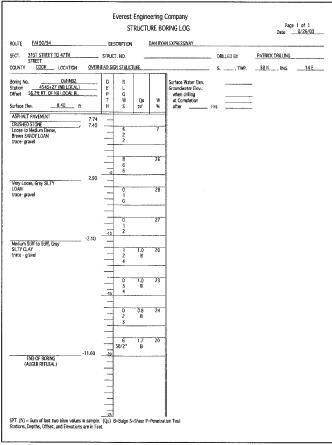

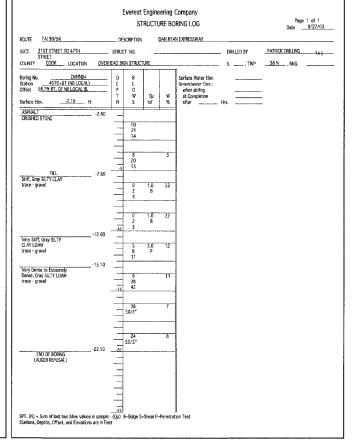

			ST	RUCTI	JRE BO	RING LOG			Pag Date	e 1 of 8/27	1 /03
ROLITE FAI 90/94		DE	SCRIPTION		DAN RYA	N EXPRESSWAY					
SECT. 31ST STREET TO 47TH STREET		STRUC	T. NO.				DRILLED BY	PATRIC	K DRILLING		
COUNTY COOK LOCATION	OVERH	AD S	GN STRUCT	URE			S, TWP.	39 N	, RNG.	1	4 E
Boring No. OV/HNB7 Station 4599±81 (NB LOCAL) Offset 58.2ft RT. OF NB LOCAL BL Surface Elev. 10.10 ft		D E P T H	B L O W S	Qu tsf	W %	Surface Water Elev. Groundwater Elev.: when drilling at Completion after Hrs	-0.9	D E P T H	B L O W S	Qu tsf	W %
ASPHALT CRUSHED STONE	9.68	_			J						
		=	18 20 23		3				0 1 3	0.4 B	25
			14 23 14		5	5		30	1 3 5	0.7 B	24
FILL Loose to Medium Dense, Gray SUTY LOAM	4.60		2 4 6		20			=			
			2 2 2 2		23				3 7 5	1.7	20
Very Soft to Stiff, Gray SILTY CLAY trace - gravel	-0.40	-10	1 1 1	0.4 B	25			-35	3	***********	
		-15	1 1 4	0.7 B	24	Hard, Gray SILTY CLAY LOAM trace - gravel	-27.90	-40	11 16 24	4.8 B	10
			0 0 1	0.1 B	26	END OF BORING					
		-20	0 0 1	0.1 B	ZŞ			-45			
		_	0 0 1	0.1 B	26			45			
		-25	0 1	0.3 B	25			-50			

<u>OVHNB1</u>

<u>OVHNB2</u>

OVHNB4

OVHNB7

BOWMAN, BARRETT & ASSOCIATES INC.
CONSULTING ENGINEERS
Chicago, Illinois
312 228 0100
www.bbandainc.com

REVISION		THE TNOTS DEPART	MENT OF TRANSPORTATION
NAME	DATE		
		F.A.I. 94/90 (D	AN RYAN EXPRESSWA
		31ST STREE	T TO 71ST STREET
		NB EXPRESS L	ANE RECONSTRUCTION
		OVERHEAD	SIGN STRUCTURES
		SOIL I	BORING LOGS
		SCALE: NTS	DRAWN BY: MTR
		DATE: 07/07/05	CHECKED BY. IDC

STATE OF ILLINOIS DEPARTMENT OF TRANSPORTATION


F.A.I. RTE.	SECTION		COUNTY	TOTAL SHEETS	SHEET NO.
90/94			COOK	556	307
STA.		TO	STA.		
FED. ROAD	DIST. NO. 1	ILLINOIS	FED. AID	PROJECT	•


62300

• (1818, ETC, 2324.6-1P)R-8

NOTES:

- 1. DYNAMIC MESSAGE SIGN WILL BE INSTALLED IN ANOTHER CONTRACT. COORDINATE WITH CONTRACT 62583 FOR LOCATION, TYPE, AND ORIENTATION OF HARDWARE AND CONDUIT.
- 2. THE FABRICATOR SHALL COORDINATE WITH THE MANUFACTURER OF THE DYNAMIC MESSAGE SIGN (DMS) TO DETERMINE THE ACTUAL SIZE, WEIGHT AND MOUNTING DETAILS OF THE DMS BEFORE ORDERING OR FABRICATING ANY MATERIALS FOR THE TRUSS OR WALKWAY/SIGN SUPPORTS.

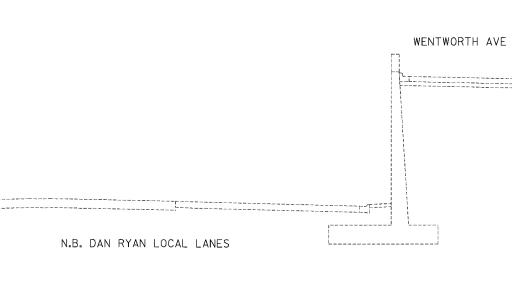

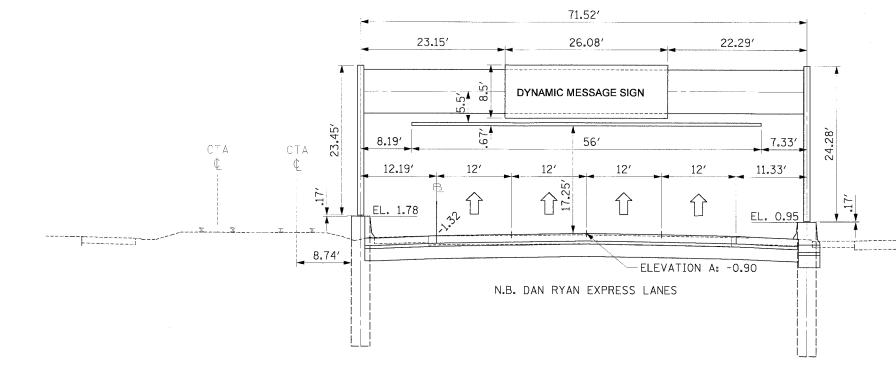

1S016I094L058.0 MOUNTING DETAIL PROPOSED OVERHEAD SIGN STRUCTURE FOR DYNAMIC MESSAGE SIGN STA. 2461+51.44/4461+50 N.B. I-90/94 LOOKING NORTH


ILLINOIS DEPARTMENT OF TRANSPORTATION F.A.I. 90/94 (DAN RYAN EXPRESSWAY) 31st STREET TO 71st STREET (NB Express Lanes)

> PROPOSED DYNAMIC MESSAGE SIGN INSTALLATION

SCALE: NONE

DRAWN BY: SWANG CHECKED BY: JAL

CTE | AECOM

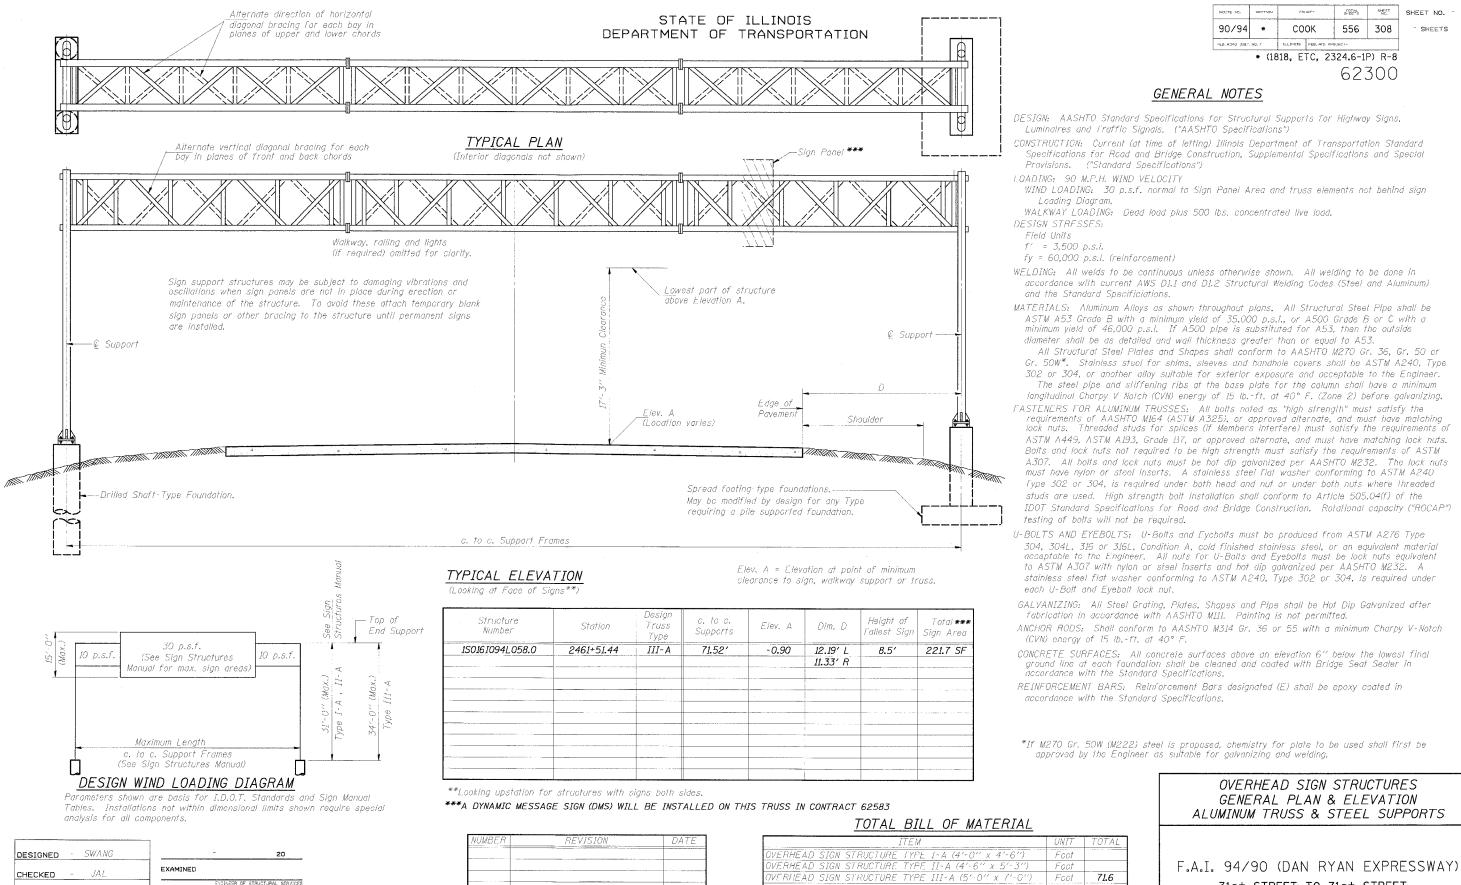

PASSED

11/1/2002

DRAWN

OS-A-1

ERHEAD SIGN WALKWAY TYPE A

RILLED SHAFT CONCRETE FOUNDATIONS


DNCRETE FOUNDATIONS

.l. 94/90 (DAN RYAN EXPRESSWA) 31st STREET TO 71st STREET (NB Express Lanes)

56

38.3

Foot

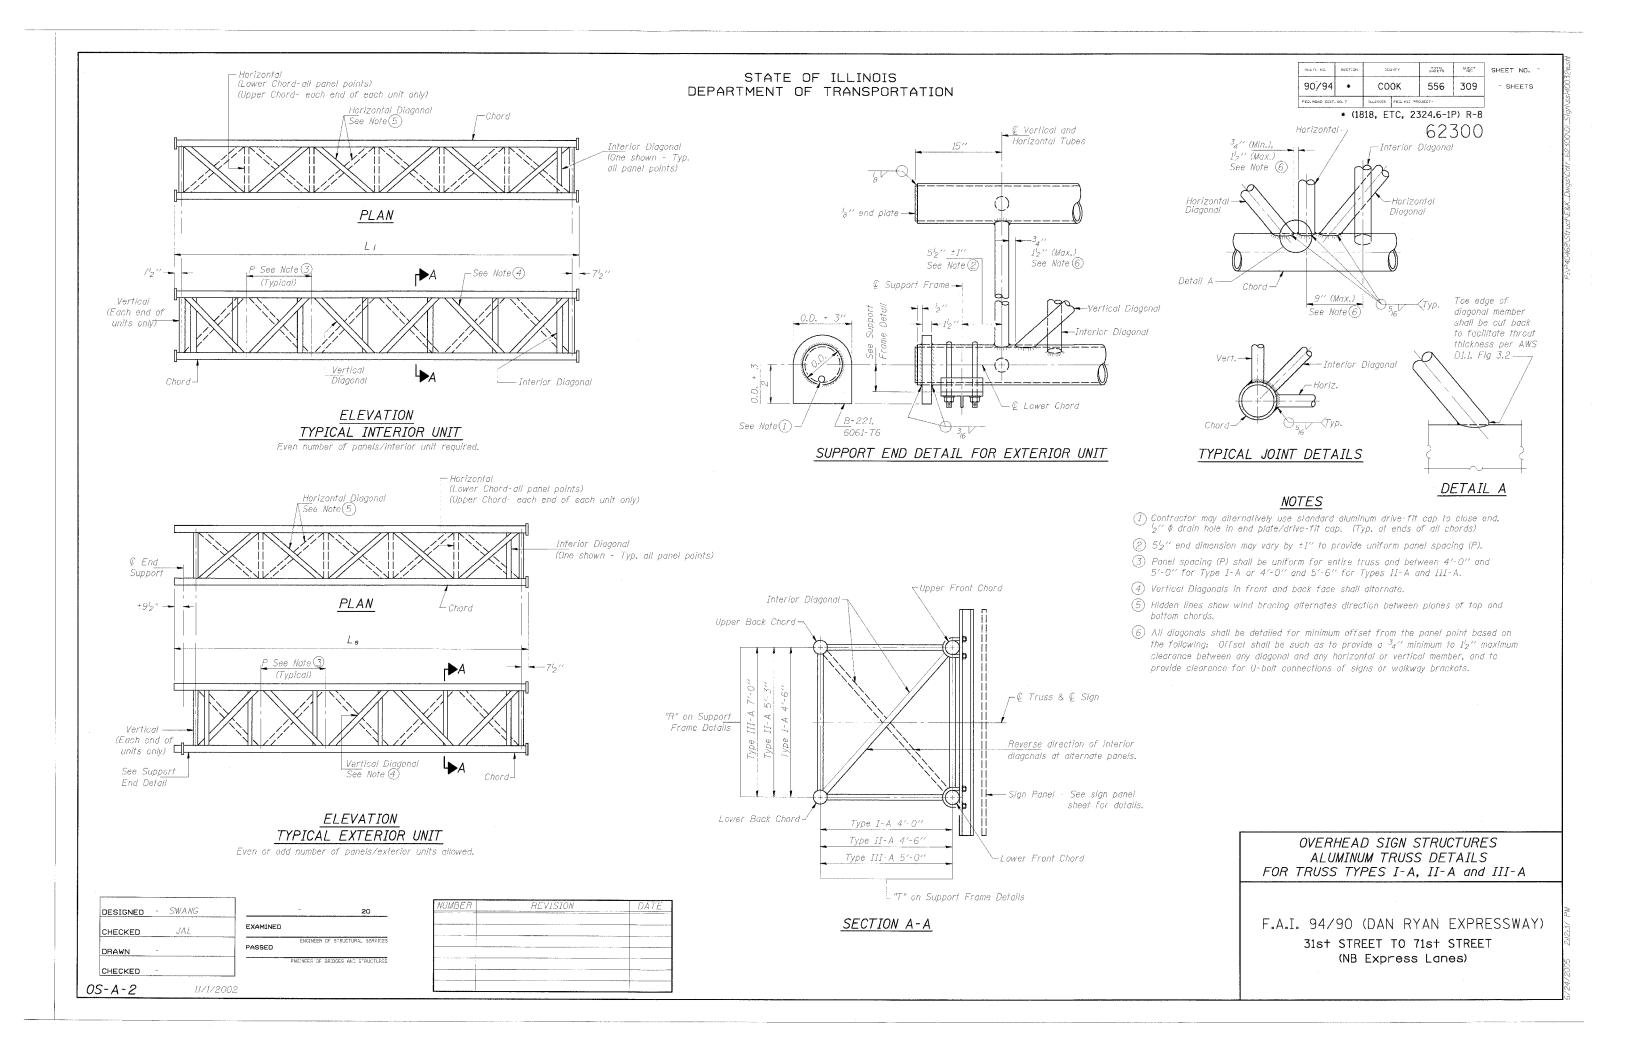


STATE OF ILLINOIS DEPARTMENT OF TRANSPORTATION

TRUSS UNIT TABLE

Structure Number	Station	Design		rior Units			Interio				& Lower		rizontals: Vertical,	Camber				Flange		
Nomber	STUTION	Truss Type	No. Panels per Unit	Unit Lgth.(L _e)	Panel Lgth.(P)	No. Req'd.	No. Panels per Unit	Unit Lgth.(L _i)	Panel Lgth.(P)	i	ord Wall	0.D.	1 Interior Diagonals Wall	at Midspan	Boll No./Splice	····	Weld W	Sizes W ₁	Α	
1S016I094L058.0	2461+51.44	III - A	7	36.58′	4.96′					7"	⁵ /6 "	314"	5/6"	1.8"	6	1"	716 "	5/6"	1112"	15"
				 	<u>:</u>						·						-			
																				<u> </u>
	:											111111111111111111111111111111111111111								
												-								
																		:		
								i				1								***************************************

2 units

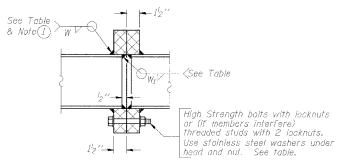

SECTION B-B


1 Splicing Flanges shall be attached to each truss unit with the truss shop assembled to camber shown. Truss units shall be in proper alignment and flange surfaces shall be shop bolled into full contact before welding. Sufficient external welds or tacks shall be made to secure flanges until remaining welds are made after disassembly. Adjacent flanges shall be "malch marked" to insure proper field assembly.


NUMBER	REVISION	DATE
	· A	

DESIGNED		SLW		-	20
CHECKED	-	RD	EXAMINED		
DRAWN	-		PASSED	ENGINÉES	OF STRUCTURAL SERVICES
CHECKED				ENGINEER OF	BRIDGES AND STRUCTURES

11/1/2002

0S4-A-2

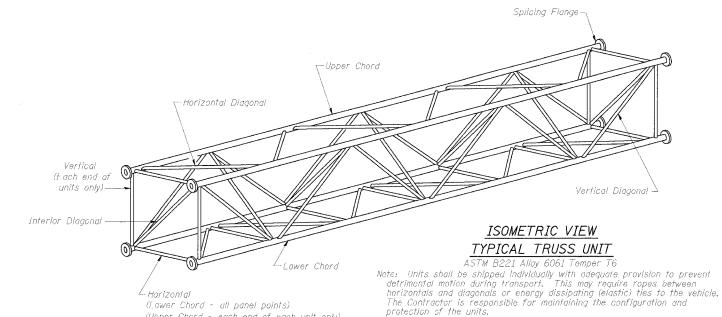


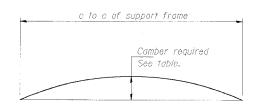

(Upper Chord - each end of each unit only)

CAMBER DIAGRAM

Camber curve shown is theoretical. Actual camber attained by slope changes at splices between units.

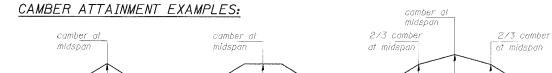


3 units

Camber shown is for fabrication only, measured with truss fully supported, (No-load condition)


NOUTE NO.	SECTION	cti	JNTY	512E%	SHEET NC.	SHE	
90/94 *		соок		556	310		
FEC. HOND DIST.	NG. 7	ILLING:8	FED-ACC PR	CURTOT			

SHEETS

* (1818, ETC, 2324.6-1P) R-8 62300

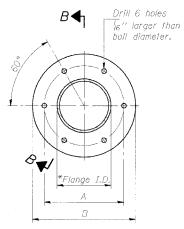

TRUSS TYPES I-A, II-A, & III-A

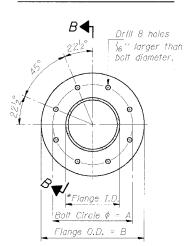


TRUSS TYPES II-A & III-A

SPLICING FLANGES

ASTM B221, Alloy 6061-T6 or ASTM B209, Alloy 6061-T651 *To fit O.D. of Chord with maximum gap of $\frac{1}{16}$ ".

OVERHEAD SIGN STRUCTURES ALUMINUM TRUSS DETAILS FOR TRUSS TYPES I-A, II-A and III-A

F.A.I. 94/90 (DAN RYAN EXPRESSWAY) 31st STREET TO 71st STREET (NB Express Lanes)

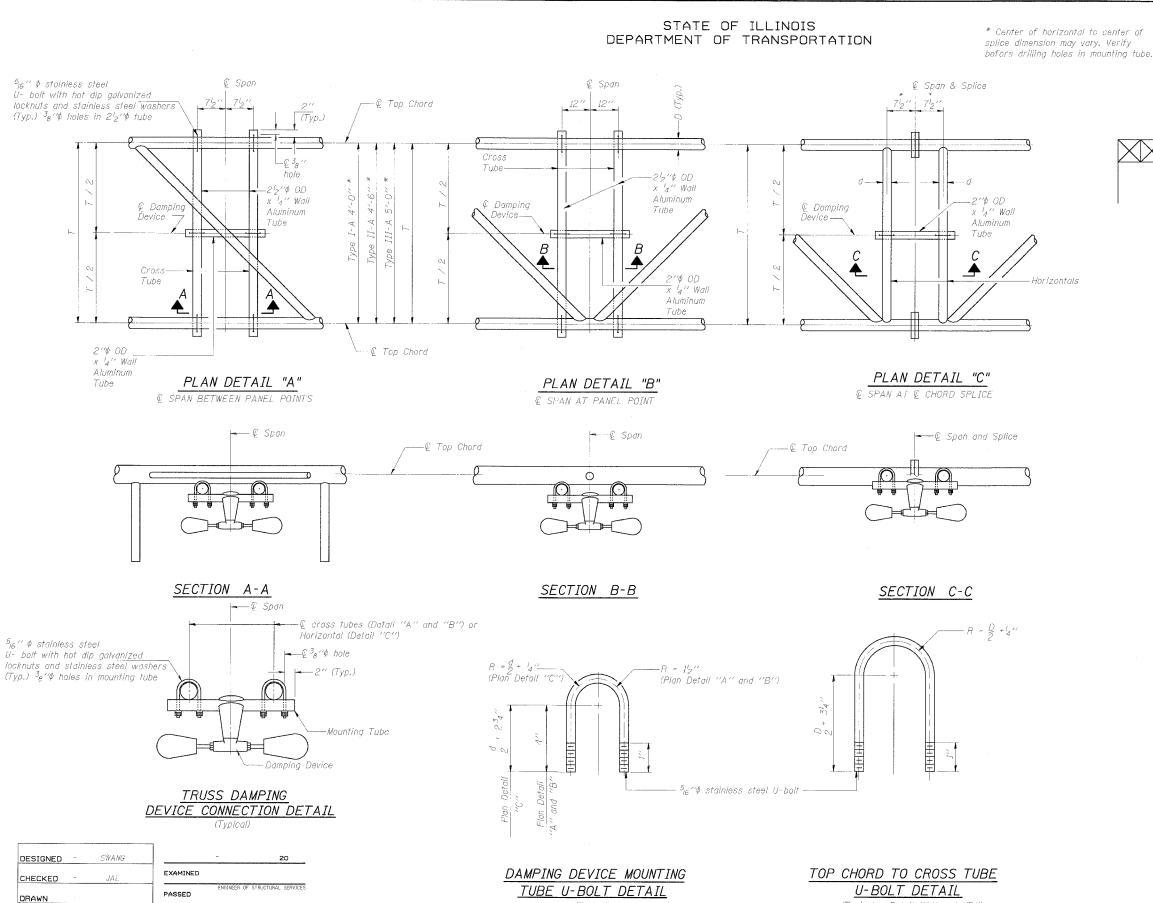

(Typical)

OS-A-D

11/1/2002

* (1818, ETC, 2324.6-1P) R-8

<u>← © Span</u> 62300

See Plan Detail A, B, C, for truss damping device

ELEVATION

Aluminum Overhe Sign Truss

NOTES

Damper: One damper per truss.
(31 lbs. Stockbridge-Type Aluminum)
Cosl included in "Overhead Sign Structure..."

Materials: Aluminum tubes shall be ASTM B221 alloy 6061 temper T6. Cost included in "Overhead Sign Structure..."


OVERHEAD SIGN STRUCTURE
DAMPING DEVICE

F.A.I. 94/90 (DAN RYAN EXPRESSWAY)

31st STREET TO 71st STREET

(NB Express Lanes)


(Typical - Detail "A" and "B")

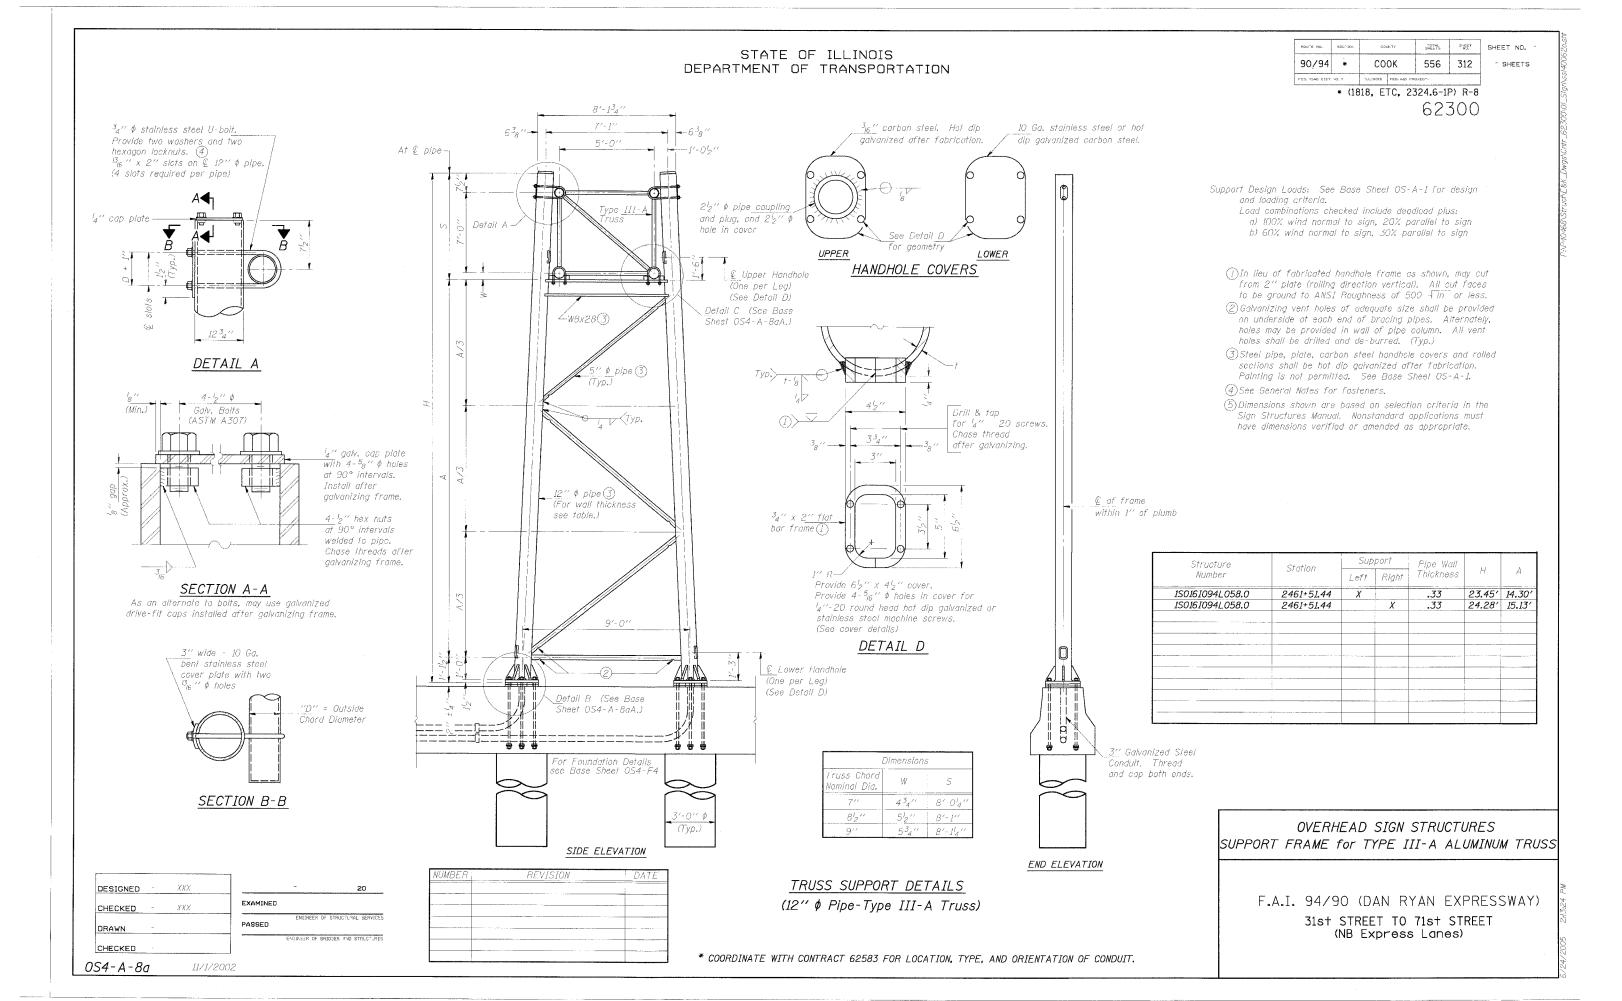

STATE OF ILLINOIS DEPARTMENT OF TRANSPORTATION


TOTAL SHEETS SYSCET NO. SHEET NO. 90/94 * COOK 556 313

* (1818, ETC, 2324.6-1P) R-8 62300

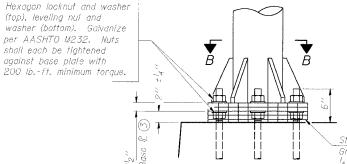


DETAIL B Ribs shall be cut to fit slope of pipe.

Stainless Stoel Standard Grade Wire Cloth, 3" wide, 14" maximum opening with a minimum wire diameter of AWG. No. 16 with a minimum 2" lap. Secure to base plate after erection with 3/2 stainless steel banding.

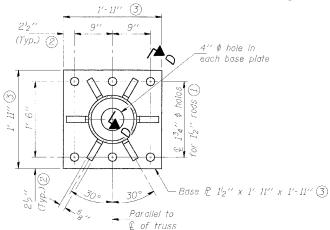

SECTION B-B

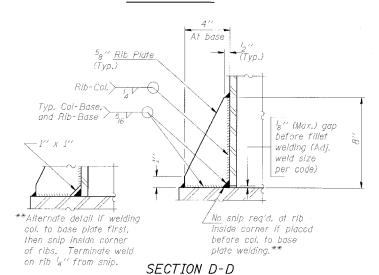

DESIGNED	-	SWANG
CHECKED	-	JAL
DRAWN		
CHECKED	_	
0S4-A-8a	Α	11/1/200

(top), leveling nul and

shall each be tightened against base plale with

	-	20
EXAMINED		
PASSED	ENGINEER	OF STRUCTURAL SERVICES
	ENGINEER OF :	BRIDGES AND STRUCTURES

NUMBER	REVISION	DAT
L		

-Ò-POSITIONING PLATE(S) $-\ell l'_2'' \not p rod (1)$ All Thread = NC (National Coarse)

(Typ.)

ANCHOR ROD DETAIL

lock to secure.

per rod. Deform thread


or use chemical thread

Anchor rods shall conform to AASHTO M314 Grade 36 or 55 and meet Charpy V-Notch (CVN) energy of 15 lb.-ft. at 40° F. Galvanize upper 12" per AASHTO M232. No welding shall be permitted on rods.

TYPE III-A TRUSS 12" # PIPE SUPPORT FRAME DETAILS

Notes: For Type III-A Truss spans greater than 150 ft, and up to 160 ft.:

- (1) 134" \$ rod, 2" \$ holes
- 2 2³4" edge distance
- 3 Base £ 1⁵8" x 1'-11¹2" x 1'-11¹2"

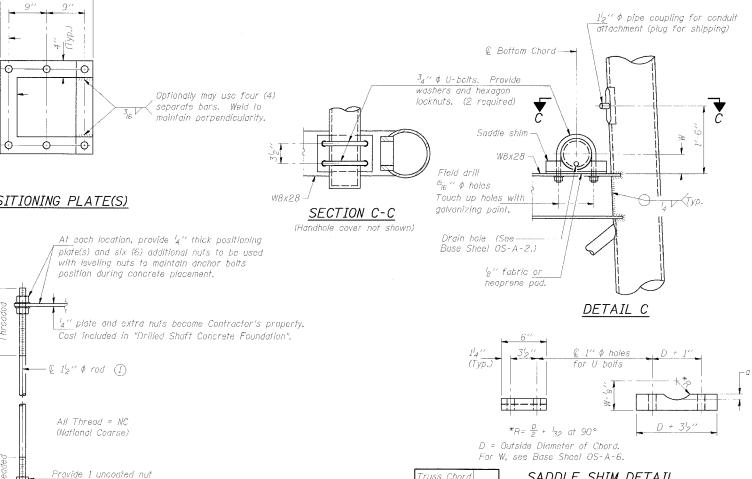


SADDLE SHIM DETAIL


ASTM B26 Alloy 356 F

ASTM B209 Alloy 6061-T651 (4 required per sign truss)

OVERHEAD SIGN STRUCTURES SUPPORT FRAME for TYPE III-A ALUMINUM TRUSS

> F.A.I. 94/90 (DAN RYAN EXPRESSWAY) 31st STREET TO 71st STREET (NB Express Lanes)

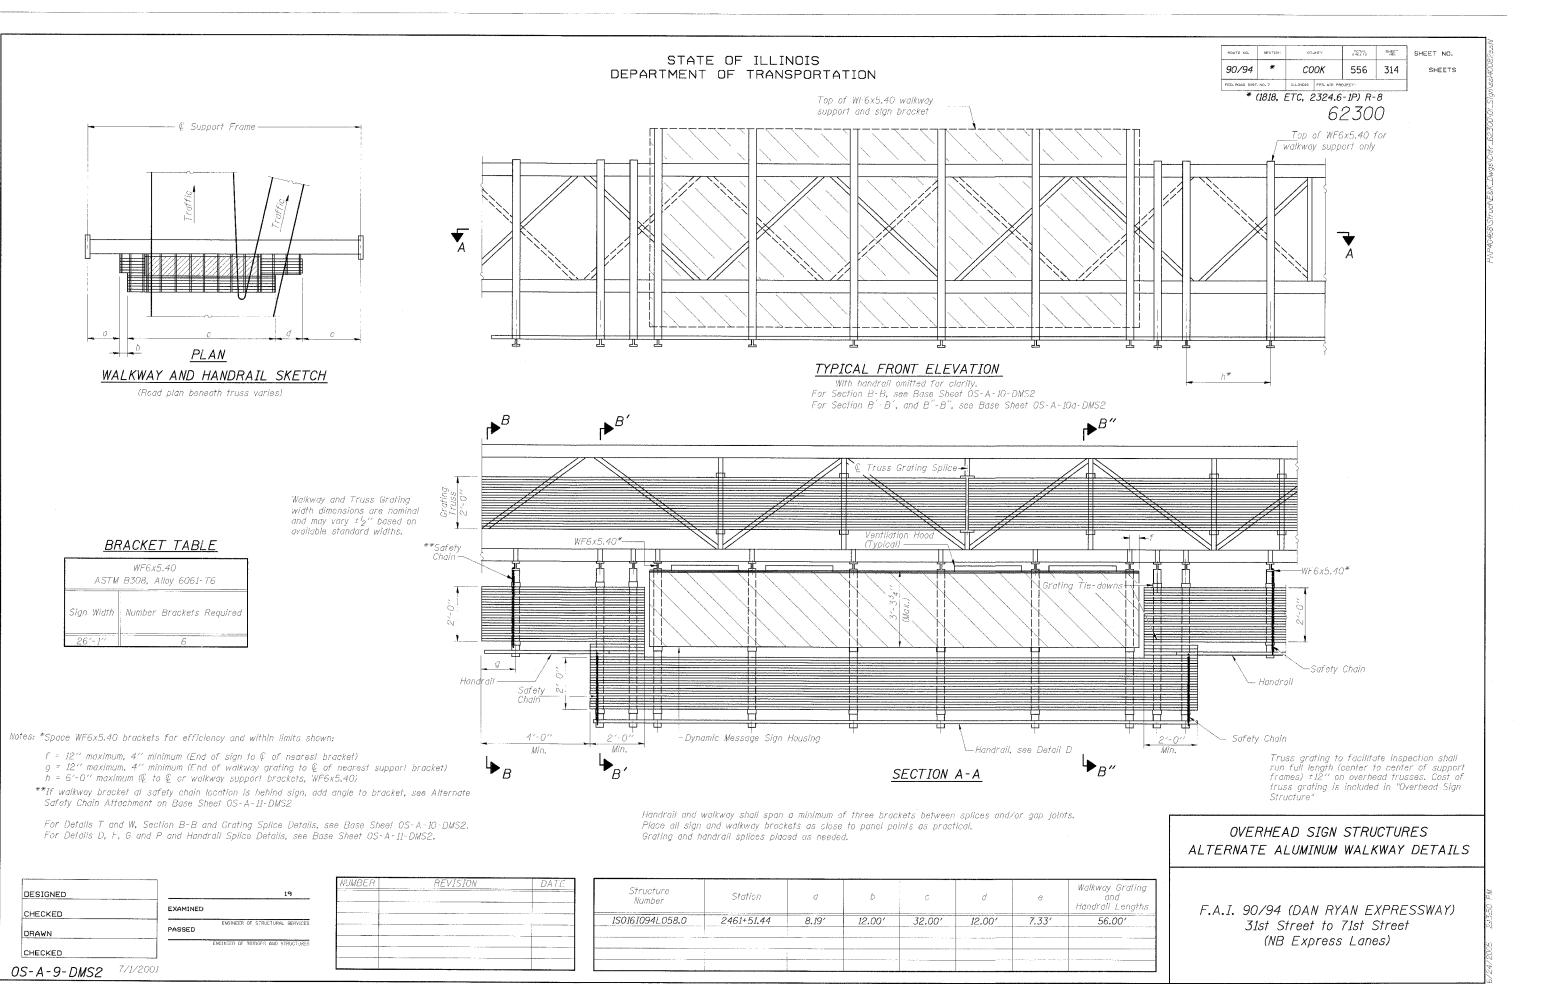


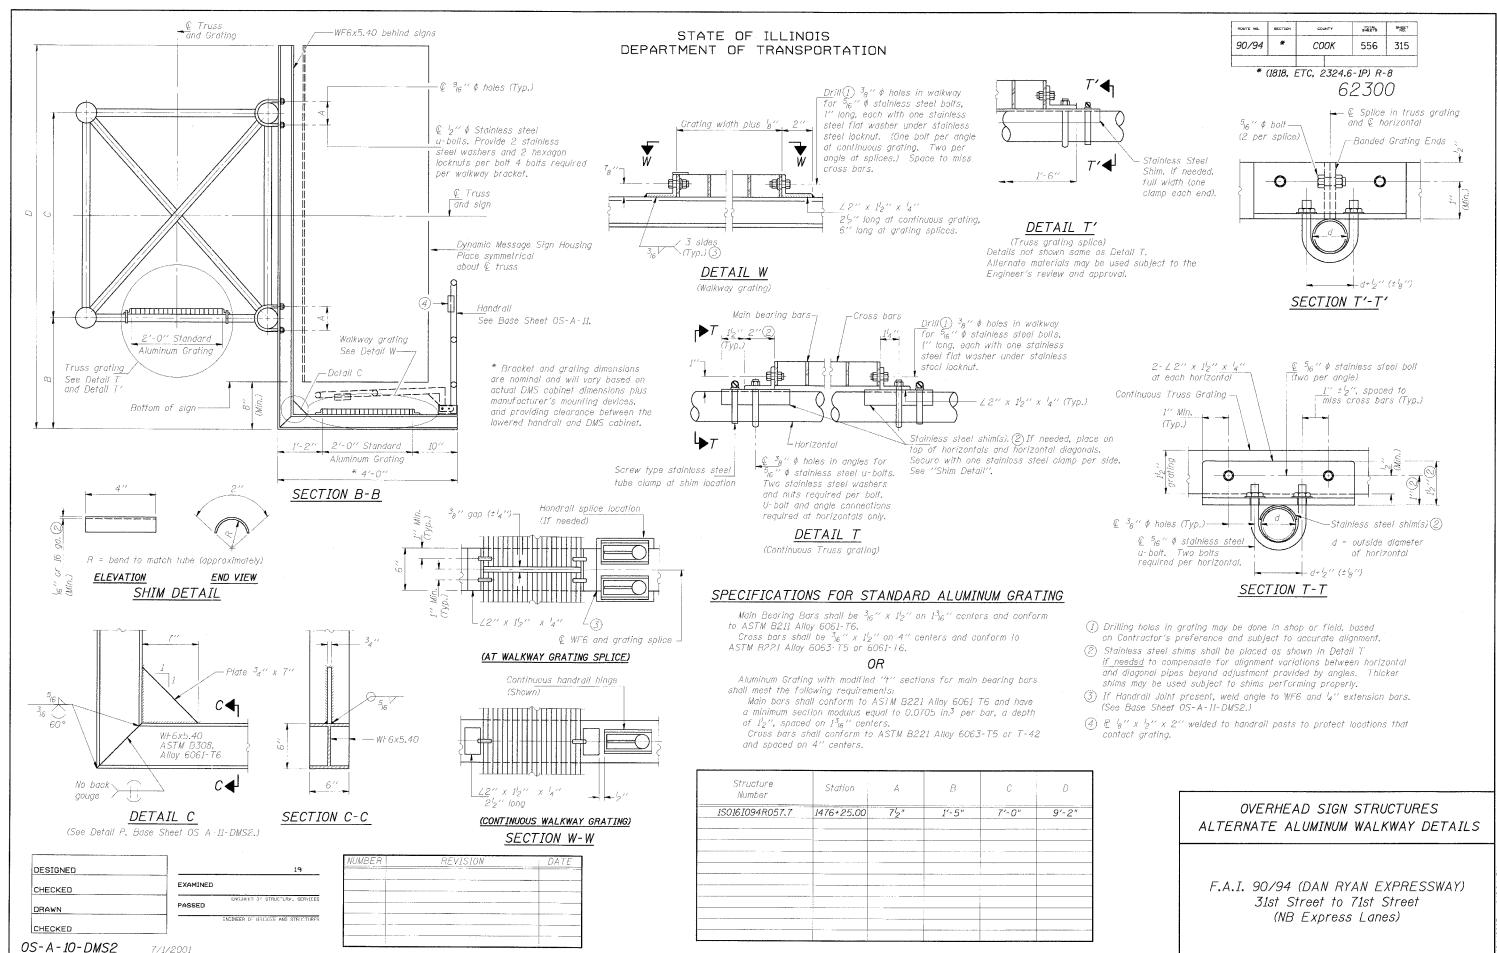


STATE OF ILLINOIS DEPARTMENT OF TRANSPORTATION

ROUTE NO.	9E01104	COLK-Y	SHEETS	SHEET
90/94	*	соок	556	316

* (1818, ETC, 2324.6-1P) R-8 62300

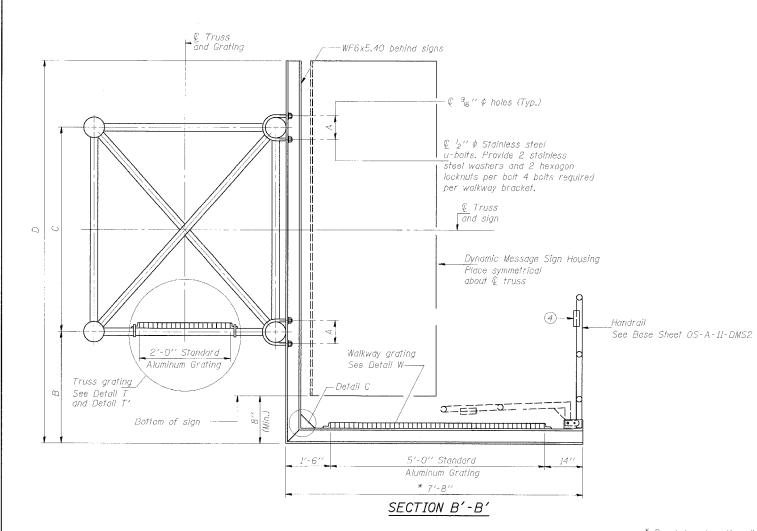

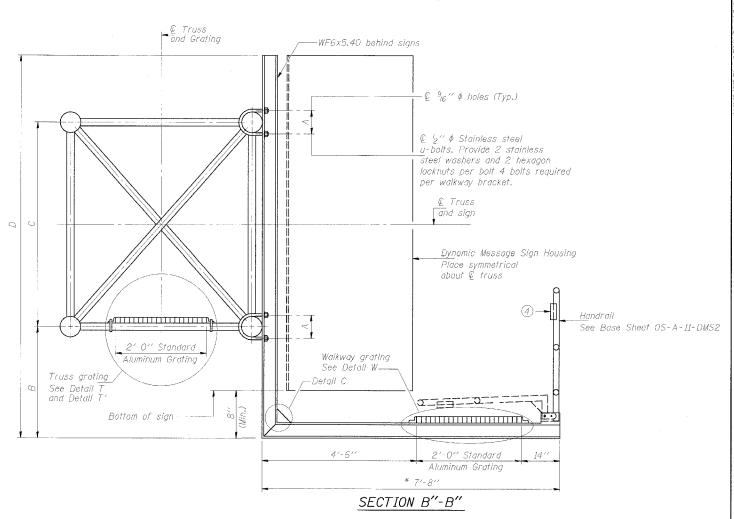

* Bracket and grating dimensions are nominal and will vary based on actual DMS cabinet dimensions plus manufacturer's mounting devices, and providing clearance between the lowered handrail and DMS cabinet.

Note:

For dimentions "A" to "D" and remaining details, see sheet OS-A-10-DMS2

OVERHEAD SIGN STRUCTURES
ALTERNATE ALUMINUM WALKWAY DETAILS

F.A.I. 90/94 (DAN RYAN EXPRESSWAY)
31st Street to 71st Street
(NB Express Lanes)

DESIGNED

CHECKED

EXAMINED

ENGINEER OF STRUCTURAL SERVICES


PASSED


ENGINEER OF BRIDGES AND STRUCTURES


CHECKED

OS-A-10a-DMS2 7/1/2001

NUMBER	REVISION	DATE

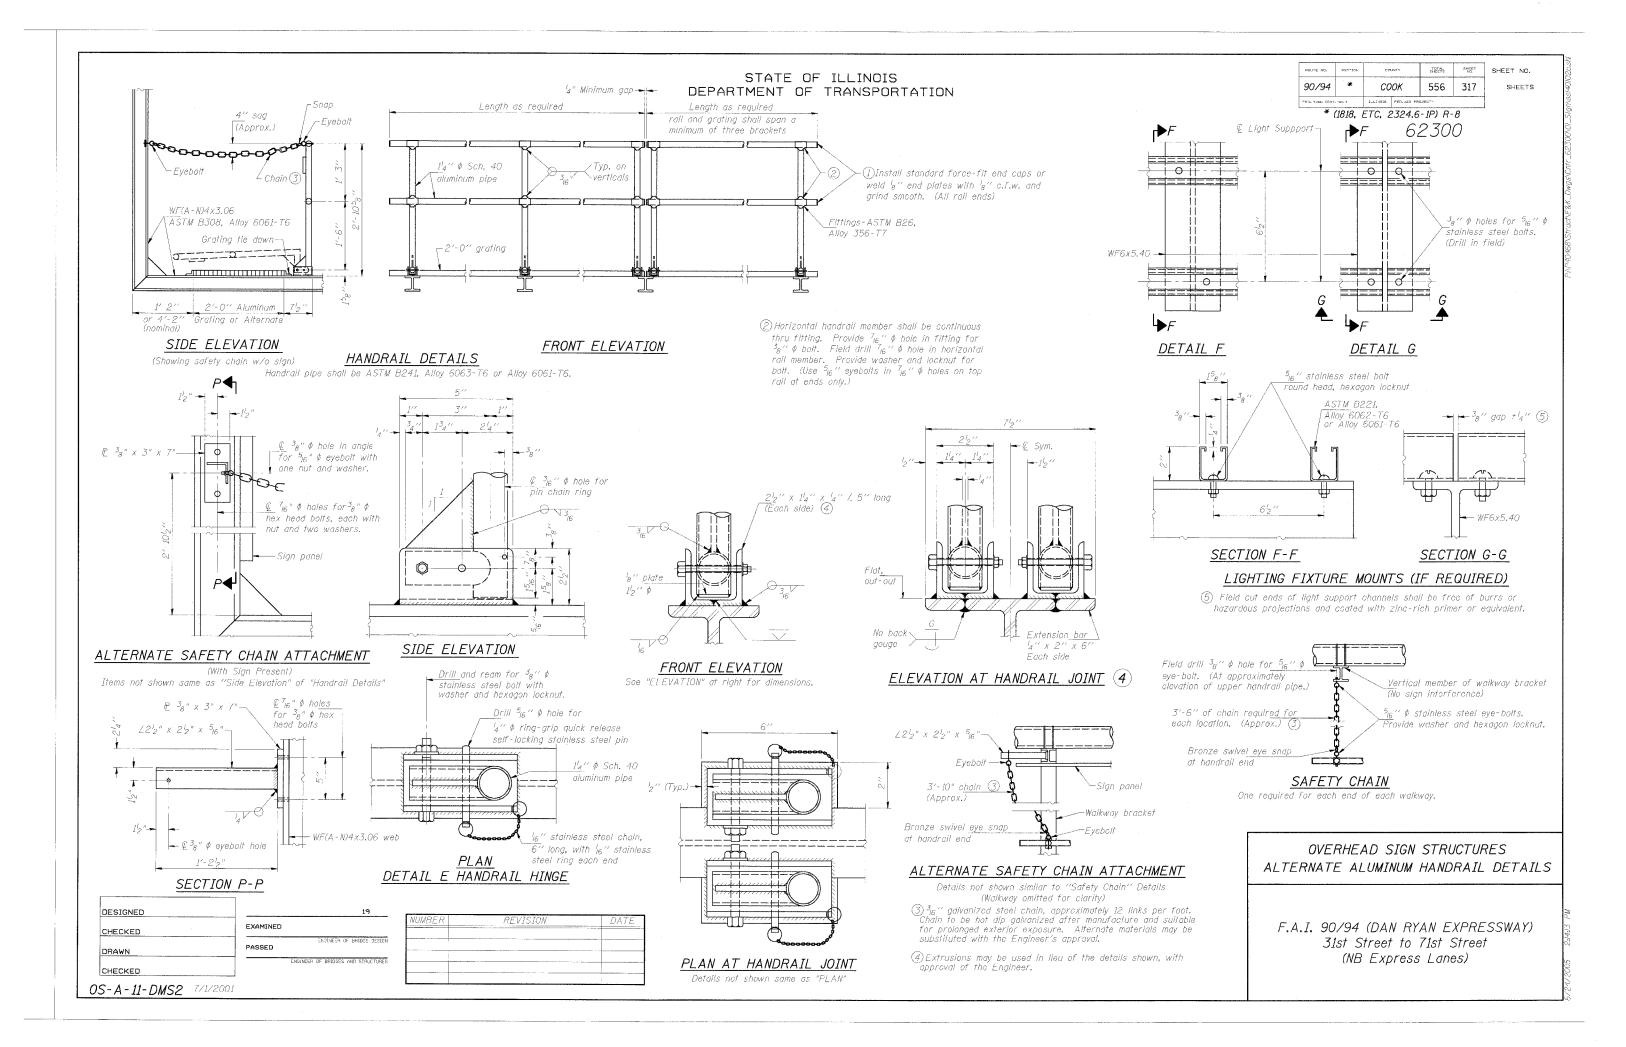

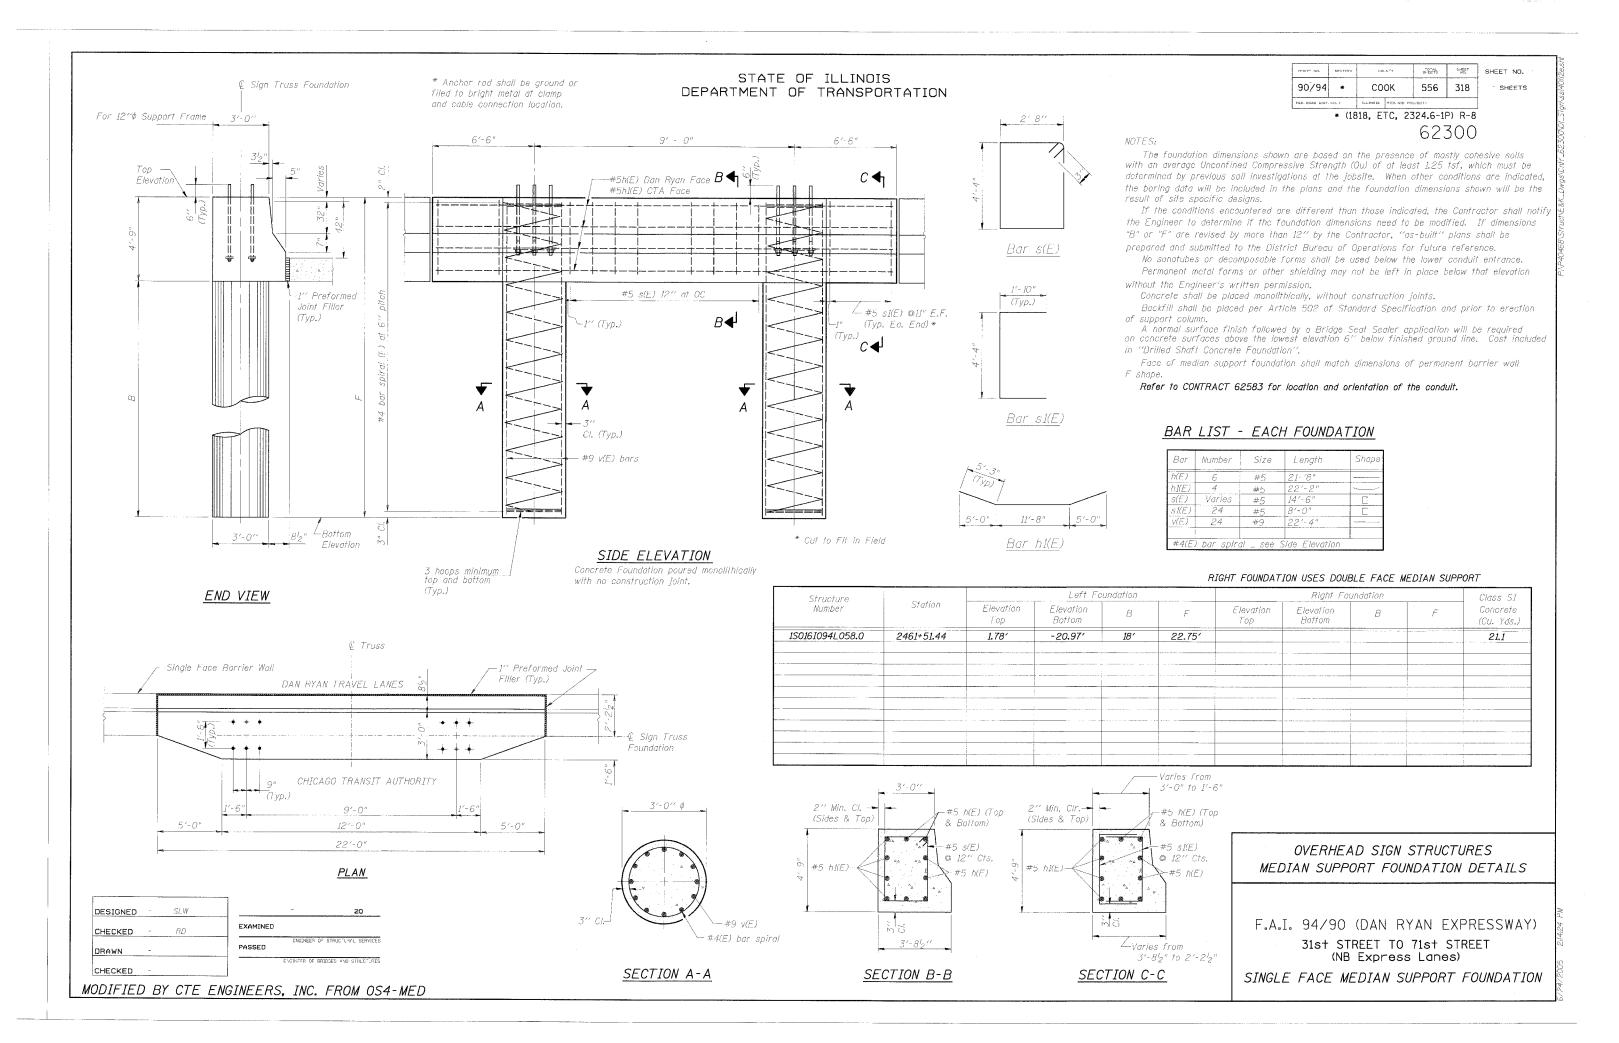

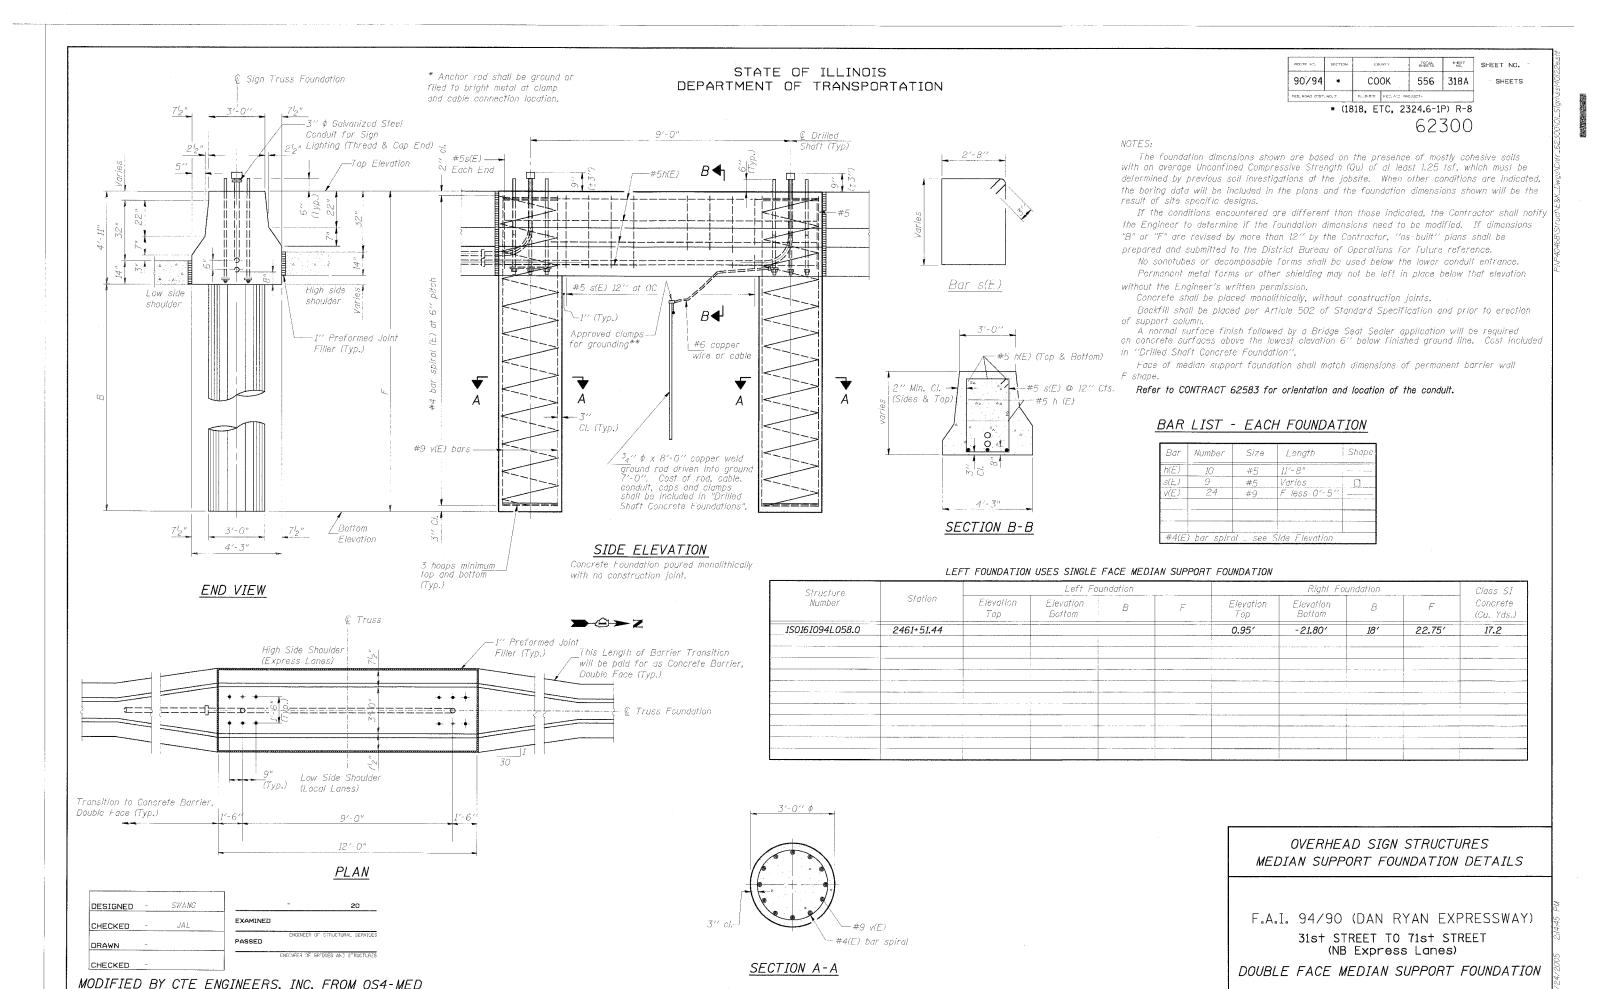

_		STATE OF ILLINOIS
Illino's Repartment Poge 1 of 1		DEPARTMENT OF TRANSPORTATION
of Transportation SOIL BORING LOG	III inois Department of Transportation SOIL BORING LOG	DOS CONTROL INCIDENT
Bivision of Highways Markitan disconstruction, onc. Dorte 4/7/05	Division of Biography Option of Biography Options of Biography	Date <u>8/26/03</u>
ROUTE F.A.J. 1-90 / 1-94 UESCRIPTION Don Ryon Expressway (7-91-419-01) LOGGED SY R.P.	ROUTE _F.A.1. 1-90 / 1-94 DESCRIPTIONDan Ryan -xpressway (D-91-419-01)	LOGGED BY A.P.
(1919.15A, ETC. SECTION2122_9212T.t).R-3	12021-922PT 1.2 &	W 1333 - 01333 Management
CCUNTY Cock DR.LLING METHOD Holiow Stem Auger HAMMER TYPE Automatic	CCUNTY Cook DRILLING MEYHOD HOLLOW Stem Auger HAMMER TYPE	Au:omatic
STRUCT: NO.	STRUCT, NO. D 3 U M Surface Woter E.ev. ft Storion Sign Trusses E C C Stream Bed Elev. ft	
P O S I SHOWLESS LIVE I P G S I	F J S I	P O S I
Staffon 2461-49-35 H S Qu T First Encounter Dry ft II S Qu T	Starion 2461+54-92 H S &u T First Encounter Dry ft	H S QU T
Ground Surface Elev1.29 -: (***) /6" (***) After Hrs ft (***) (***)	Ground Surface Elev2.07 ft TT (%) TST [7] After Hrs. ft	(ft (/6")(18f. (%)
Asphalt. 2" (=1.46" Very Stiff to Hard Caragraph, 8" -2.13 Gray	Aspholf: 5" -2.49 Hars / Very Bensc Gray	
Sub Base, Gravel IFILE) 8 SILTY CLAY LOAM (continued) 11 13 8.7 13.0	SUB-Base 4 SILTY CLAY LOAM / SILTY (FILL)	-2 :
-3.75 5 · · · · · · · · · · · · · · · ·	Very STIff to Hard 5 2.6 (5.6)	10 6.4 12.5 15 S
Very Straff Gray	CLAY	
C_AY 5 9 11 8.2 13.0	4 5 2.2 17.6	55 6.0 12.0
□ 5 B □ □ −26,29 −25 13 S □	- 6 B	-25 21 · S
- - - - - - - - -	-	
4 SILTY CLAY LOAN / SILTY 8 36 7.2 14.0	6 7 2.2 16.0	19:7.8 13.0
-6.79 6 B 50 B	9 B	28 S
Gray """		
3 450	6 4.4 16.0	30 ©50 9.5 10.0
		-30 - I S
_	ST DY CLAY COM	
4 5.7 16.0	11 7.6 12.0	-
11 B	-4.57 15 B · Hand / Very Dense	
	Gray SILTY CLAY LOAM / SILTY	
70 8:7 13:0	LCAM 25 7.5 11.0	28 Q50 9.0
<u>-15 12 8</u>	5 35 B31.0	77 -39 -
<u> </u>	18 5.6 13.0	-
112 B	18 B	-
7	15	
10 6.2 13. C	14 6.2 14.0 -20 29 5	
The Unconfined Compressive Strength (UCS) Editure Mode is Indicated by (8-Bulge, S-Shear, P-Penetromater) The SPT (N value) is the sum of the last two blow values in each sampling zone (AAS-NO 1986) 665, from 137 (Rgv. 88-99)	The Unconfined Compressive Strength (UCS) Eciture Mode is incloated by (3-Bulge, The SPT (3 value) is the sum of the lost two blow values in each sampling some (2	5-5nagr, P-Penetrometer) AksHTO T206) n 337 (Rev. 8-39)
bc3. 11 Oil 131 1/18% 0-931	DRS- TFOR	1 -01 (Maks 0.00)

F.A.I. RTE.	SECTION	COUNTY	TOTAL SHEETS	SHEET NO.
90/94	•	COOK	556	318B
STA.		TO STA.		
FED. R	DAD DIST. NO. 1 ILLIN	IOIS FED. AID	PROJECT	-

* (1818, ETC, 2324.6-1P)R-8

62300

REVISIONS NAME DA		ILLINOIS DEPARTMENT OF TRANSPORTATION F.A.I. 90/94 (DAN RYAN EXPRESSWAY)			
	31st STREE	T TO 71st STREET	(NB Express	Lanes)	
	SIG	SOIL BORING LO			
	SCALE: NONE		DRAWN BY:	JSS	
	DATE: JULY	7, 2005	CHECKED BY:	PJ0	

COUNTY TOTAL SHEET NO. F.A.I. SECTION 94/90 * ELECTRICAL SYMBOLS FOR PROPOSED WORK GENERAL ELECTRICAL CALLOUTS FED. ROAD DIST. NO. ILLINOIS FED. AID PROJECT LIGHT TOWER FOUNDATION NUMBER INSIDE HEXAGON INDICATES TOWER TYPE HANDHOLE LOCATION AS INDICATED TOWER INSTALLED BY OTHERS, UNDER A SEPARATE CONTRACT - NUMBER OF LUMINAIRES - CONTROLLER DESIGNATION - CIRCUIT DESIGNATION (RED PHASE) - CIRCUIT DESIGNATION (BLACK PHASE) - UNIT NUMBER LIGHTED SIGN STRUCTURE-TRUSS TYPE (N.I.C.) POLE MOUNTED ELECTRIC UTILITY TRANSFORMER(S) 62300 * (1818, ETC, 2324.6-1P)R-8 NUMBER OF LUMINAIRES TEMPORARY LIGHTED SIGN STRUCTURE-TRUSS TYPE, QUANTITY OF LUMINAIRES AS SHOWN ON SIGNING PLANS PAD MOUNTED ELECTRIC UTILITY TRANSFORMER CONTROLLER DESIGNATION SIGN STRUCTURE NUMBER (10) GROUND ROD TYPE 10 11 12 TOWER HEIGHT <u>□××××</u>6 LIGHTED SIGN STRUCTURE-BRIDGE MOUNT TYPE (N.I.C.) MAIN SERVICE FUSED DISCONNECT SWITCH (RATING AS INDICATED) \square CONTROLLER DESIGNATION DYNAMIC MESSAGE SIGN (N.I.C.) LIGHT POLE FOUNDATION POLE INSTALLED BY OTHERS UNDER A SEPARATE CONTRACT LIGHTING UNIT NUMBER D-Z EXISTING RACEWAY OR CONDUIT RUN AS INDICATED ON PLANS STA. 1700+00, 65RT FBS FLASHING BEACON SIGN (N.I.C.) PROPOSED IDOT CONTROLLER "U" STA, 1528+10, 160LT TEMPORARY LIGHTING UNIT INCLUDING 60 FOOT WOOD POLE (CLASS 4), 8'-0" MAST ARM WITH 400 WATT HPS LUMINAIRE -- CKT. C&D: 3#2, 1#4 GND, 1 1/4" UD $\overline{\mathbb{Q}}$ RACEWAY EMBEDDED IN STRUCTURE **○** CLOSED CIRCUIT TELEVISION CAMERA (N.I.C.) М RACEWAY OR DIRECT BURIAL CABLE UNDERGROUND WITHOUT ENCASEMENT MICROWAVE DETECTOR (N.I.C.) Н ELECTRIC HANDHOLE: TYPE AS INDICATED -4" RGC PUSHED, 60 LF TYPE E1: PC CONCRETE, 21.5"×21.5"×30" IDOT STANDARD 814001 DETECTOR LOOP 4" RGC TRENCHED, 60 LF RIGID GALVANIZED STEEL CONDUIT SLEEVE, TRENCHED OR PUSHED TYPE E2: PC CONCRETE-HEAVY DUTY, 22"x22"x30", IDOT STANDARD 814001 CONTROLLER CABINET FOUNDATION HANDHOLE NUMBER TYPE C1: COMMUNICATIONS VAULT UNDERGROUND REINFORCED CONCRETE ENCASED DUCTBANK, UNO. (NUMBER, TYPE, AND SIZE OF DUCTS AS SHOWN) CONTROLLER CABINET FOUNDATION: SURVEILLANCE - TYPE DESIGNATION • 0 TYPE S1: PC CONCRETE-HEAVY DUTY, 22"x22"x36" CONTROLLER CABINET FOUNDATION: SURVEILLANCE, TYPE 334 TYPE S2: PC CONCRETE-HEAVY DUTY SPECIAL, 30"x30"x36" RACEWAY OR CONDUIT IN TRENCH, TYPE AS INDICATED ON PLANS RAMP METER SIGNAL POLE/HEAD FOUNDATION \rightarrow JB, SS, 18"x18"x8" ATS J JUNCTION BOX: TYPE AND SIZE AS INDICATED ON PLANS RAMP METER FLASHER FOUNDATION AERIAL CABLE, TYPE AS INDICATED ON PLANS CONDUIT-SPARE P PULL BOX: TYPE AND SIZE AS INDICATED ON PLANS CONDUIT WITH CABLE TEMPORARY WOOD POLE, 50 FOOT LENGTH (10 FOOT BURIED, 40 FOOT INSTALLED HEIGHT) -O_T CONDUIT TURNED DOWN T TELEPHONE CONNECTION CONDUIT TURNED UP ~O_{HAR} HIGHWAY ADVISORY RADIO ANTENNA (N.I.C.) FIBER OPTIC COMMUNICATIONS HUT ELECTRIC UTILITY POLE LIGHTED SIGN STRUCTURE-CANTILEVER TYPE (NUMBER OF FLUORESCENT FIXTURES AS INDICATED WITH ASSOCIATED DISCONNECT SWITCH - TYP.) (N.I.C.) CCTV CAMERA POLE (N.I.C.) ELECTRICAL SYMBOLS FOR EXISTING CONDITIONS Q-0-Q EXISTING LIGHTING UNIT, TWIN LUMINAIRE (0) EXISTING CDOT ELECTRIC HANDHOLE/MANHOLE EXISTING RAMP METER FLASHER E---EXISTING LIGHTING UNIT EXISTING LIGHTED SIGN STRUCTURE-CANTILEVER TYPE EXISTING HIGHWAY ADVISORY RADIO ANTENNA -O-HAR (E)-0 EXISTING TEMPORARY LIGHTING UNIT EXISTING CCTV CAMERA POLE \circ_{E} EXISTING LIGHTED SIGN STRUCTURE-TRUSS TYPE <u>—</u> EXISTING CDOT LIGHTING UNIT EXISTING UTILITY SERVICE CONNECTION, POLE MOUNTED ΔE EXISTING LIGHTED SIGN STRUCTURE-BRIDGE MOUNT TYPE EXISTING UNDERPASS LUMINAIRE \square_{E} EXISTING UTILITY SERVICE CONNECTION, PAD MOUNTED EXISTING DYNAMIC MESSAGE SIGN H EXISTING ELECTRIC HANDHOLE FBS EXISTING FLASHING BEACON SIGN EXISTING CONCEALED CONDUIT IN STRUCTURE \square_{E} EXISTING JUNCTION BOX EXISTING CLOSED CIRCUIT TELEVISION CAMERA EXISTING EXPOSED CONDUIT EXISTING PULL BOX PE EXISTING MICROWAVE DETECTOR EXISTING RACEWAY OR DIRECT BURIED CABLE WITHOUT ENCASEMENT ET EXISTING TELEPHONE CONNECTION EXISTING DETECTOR LOOP EXISTING CONCEALED CONDUIT UNDERGROUND, TRENCHED OR PUSHED EXISTING FIBER OPTIC COMMUNICATIONS HUT \boxtimes_{E} EXISTING LIGHTING CONTROLLER, DUPLEX EXISTING ELECTRIC HANDHOLE/MANHOLE REVISIONS NAME EXISTING ELECTRIC CABLE IN CONDUIT ILLINOIS DEPARTMENT OF TRANSPORTATION \boxtimes_{E} EXISTING CONTROLLER CABINET F.A.I. 94/90 (DAN RYAN EXPRESSWAY) 31ST STREET TO 71ST STREET \bigcirc EXISTING RAMP METER SIGNAL POLE/HEAD NB EXPRESS LANE RECONSTRUCTION ELECTRICAL SYMBOLS *Edwards* AND Kelcey SCALE: NOT TO SCALE

COOK

DRAWN BY: CJM

556 319

A	AMPERES	ID	INNERDUCT	₩B	WESTBOUN
AC	ALTERNATING CURRENT	IDOT	ILLINOIS DEPARTMENT OF TRANSPORTATION	WM	WALL MOU
A/C	AERIAL CABLE	IN	INCHES	WP	WOOD POL
AFG	ABOVE FINISHED GRADE	J, JB	JUNCTION BOX	XFMR	TRANSFOR
ANT	ANTENNA	KVA	KILOVOLT-AMPERE		
AOBE	AS ORDERED BY THE ENGINEER	KW	KILOWATT		
ASPH ATS	ASPHALT ATTACHED TO STRUCTURE	LF	LINEAR FEET		
AVE	AVENUE	LP	LIGHT POLE		
BHD	BULKHEAD	L SUM	LUMP SUM		
BIT	BITUMINOUS	LT	LEFT		
BLK	BLOCK	М	METER		
BR	BRIDGE	MA	MAST ARM		
С	CONDUIT, CONDUCTOR	MD	MICROWAVE DETECTOR		
CAB	CABINET	MM	MULTI-MODE		
CBW	CONCRETE BLOCK WALL	MW	MESSENGER WIRE		
CC	COMMUNICATIONS CENTER	NB	NORTHBOUND		
CCTV	CLOSED CIRCUIT TELEVISION	NIC	NOT IN CONTRACT		
CDOT	CDOT-CHICAGO DEPARTMENT OF	NM	NONMETALLIC		
COLLED	TRANSPORTATION	NO NEC	NUMBER		
COMED	COMED	NTS	NOT TO SCALE		
CLF	CIRCUIT CHAIN LINK FENCE	OH	OVERHEAD PROPERTY LINE		
CNC	COILABLE NONMETALLIC CONDUIT	PL PH	PROPERTY LINE PHASE		
COMM	COMMUNICATIONS	PIN	PROJECT IDENTIFICATION NUMBER		
CONC	CONCRETE	PNL	PANEL		
CONST	CONSTRUCTION	PROP	PROPOSED		
CORR	CORRUGATED	PTZ	PAN-TILT-ZOOM		
CW	CONCRETE WALL	PEC	POLYETHYLENE CONDUIT		
¢.	CENTERLINE	PVC	POLYVINYL CHLORIDE		
DB	DIRECT BURIED	PVCC	POLYVINYL CHLORIDE COATED		
DC	DIRECT CURRENT	R	EXISTING UNIT TO BE REMOVED		
DF	DARK FIBER		(OWNER SALVAGED UNO)		
DIA	DIAMETER	RC	REINFORCED CONCRETE		
DMS	DYNAMIC MESSAGE SIGN	RD	ROAD		
DWG	DRAWING(S)	RGC	RIGID GALVANIZED STEEL CONDUIT		
E	EXISTING UNIT TO REMAIN	RM	RAMP METER		
EA	EACH	ROW	RIGHT OF WAY		
EB	EASTBOUND	RR	EXISTING UNIT TO BE REMOVED		
ECA	ELECTRIC CABLE ASSEMBLY	RT	AND REINSTALLED RIGHT		
EL	ELEVATION	RW	RETAINING WALL		
EM	EXISTING UNIT TO BE MCDIFIED (e.g. NEW LUMINAIRE, BALLAST,	SB	SOUTHBOUND		
	OR MAST ARM)	SH	SHEET		
ER	EXISTING RELOCATED UNIT	SM	SINGLE MODE		
ET	EXISTING TEMPORARY UNIT TO REMAIN OR MODIFIED	SS	STAINLESS STEEL		
ETP	EMERGENCY TRAFFIC PATROL	ST	STREET		
ETR	EXISTING TEMPORARY RELOCATED	STA	STATION		
	UNIT	STD	STANDARD		
EXCAV	EXCAVATION	STL	STEEL		
F, FT	FOOT, FEET	STRUCT	STRUCTURE		
FDN	FOUNDATION	SURF	SURFACE		
F0	FIBER OPTIC	SURV	SURVEILLANCE		
GM CND CDD	GROUND MOUNTED	SW	SIDEWALK		
GND, GRD	GROUND CHARD BATH	T	TEMPORARY		
GR GSC	GUARD RAIL GALVANIZED STEEL CONDUIT	TAN	TANGENT		
HAR	HIGHWAY ADVISORY RADIO	TC	TRAY CABLE		
HD	HEAVY DUTY	TEL	TELEPHONE		
HH	HANDHOLE	TS	TRAFFIC SIGNAL		
HPS	HIGH PRESSURE SODIUM	TSC	TRAFFIC SYSTEMS CENTER		
HYD	HYDRANT	TYP	TYPICAL		
I	INTERSTATE	UD	UNIT DUCT		
		UND	UNDERDRAIN		
		UNO V	UNLESS NOTED OTHERWISE VOLT		
dva	ONE NORTH FRANKLIN CHICAGO, IL 60606 PHONE: (312) 251-3000	¥	YOL!		

	F.A.I. RTE.	SECTIO	V	COUN	ΓΥ	TOTAL	SHEET NO.	1.5/1
ĺ	94/90	*		COO	(556	320	121
	STA.	~~~~	ТО	STA.			·	90/0
[FED. RO	AD DIST. NO.	ILLINOIS	FED.	AID	PROJECT		18

62300 * (1818, ETC, 2324.6-1P)R-8

EI-101

REVISIONS DATE	ILLINOIS DEPARTMENT OF TRANSPORTATION
10000	F.A.I. 94/90 (DAN RYAN EXPRESSWAY
	31ST STREET TO 71ST STREET NB EXPRESS LANE RECONSTRUCTION
	ELECTRICAL ABBREVIATIONS

SCALE: NOT TO SCALE DATE: 7/7/05

DRAWN BY: CJM CHECKED BY: WDS

COUNTY TOTAL SHEET NO.

COOK 556 321 F.A.I. SECTION 94/90 * STA. 1366+00 TO STA, 1376+00 FED. ROAD DIST. NO. ILLINOIS FED. AID PROJECT **→**②→ Z 62300 * (1818, ETC, 2324.6-1P)R-8 S. VINCENNES AV. S. LAFAYETTE AV. MATCH LINE STA. 1367+00 SEE SHEET EI-22 DAN RYAN EXPRESSWAY HH 2313, TYPE S1 STA 2371+87 - 2" GSC IN TRENCH - 3" PVC ENCASED AND AND THE PARTY THE PART HH 2308, TYPE S1 STA 16+85 (EXISTING BY OTHERS) S. STATE ST. -3" PVC ENCASED, EXISTING BY OTHERS -2" GSC PUSHED, EXISTING BY OTHERS NOTES:

1. SEE DRAWING EI-100 AND EI-101 FOR ELECTRICAL SYSTEMS AND ABBREVIATIONS.

2. UNLESS OTHERWISE STATED, ALL NOTED CABLE TO BE FURNISHED AND INSTALLED UNDER ANOTHER CONTRACT.

3. TRENCHED CONDUITS INSTALLED IN PARALLEL ARE TO BE INSTALLED IN COMMON TRENCH.

4. THIS SHEET ONLY DEPICTS INSTALLATION OF DETECTION/RAMP METER ELEMENTS. REFER TO SHEETS FOR OTHER SUBSYSTEMS FOR ADDITIONAL ELEMENTS IN THE AREA SHOWN.

5. DETECTOR LOOPS INSTALLED BY OTHERS.

6. REFER TO HANDHOLE DETAILS. SEE DRAWING DET-29 STA 17+00, EXISTING BY OTHERS ST. 70†h 6. REFER TO HANDHOLE DETAILS. SEE DRAWING DET-29 SCALE IN FEET EI-23 ILLINOIS DEPARTMENT OF TRANSPORTATION F.A.I. 94/90 (DAN RYAN EXPRESSWAY) 31ST STREET TO 71ST STREET
NB EXPRESS LANE RECONSTRUCTION ELECTRICAL INFRASTRUCTURE PLAN NORTHBOUND STA. 1367+00 TO 1376+00 AND KEICEU

ONE NORTH FRANKLIN CHICAGO, 31. GOBGE AND KEICEU


ONE NORTH FRANKLIN CHICAGO, 31. GOBGE AND KEICEU 251-309 FAX: (322 251-301) SCALE: 1"=50' DRAWN BY: CJH DATE: 7/7/05 CHECKED BY: MJL

→⊕→ Z

F.A.I. SECTION COUNTY TOTAL SHEE NO. COOK 556 322 94/90 * TO STA, 1388+00 FED. ROAD DIST. NO. ILLINOIS FED. AID PROJECT

62300 * (1818, ETC, 2324.6-1P)R-8

NO PROPOSED WORK ON THIS SHEET

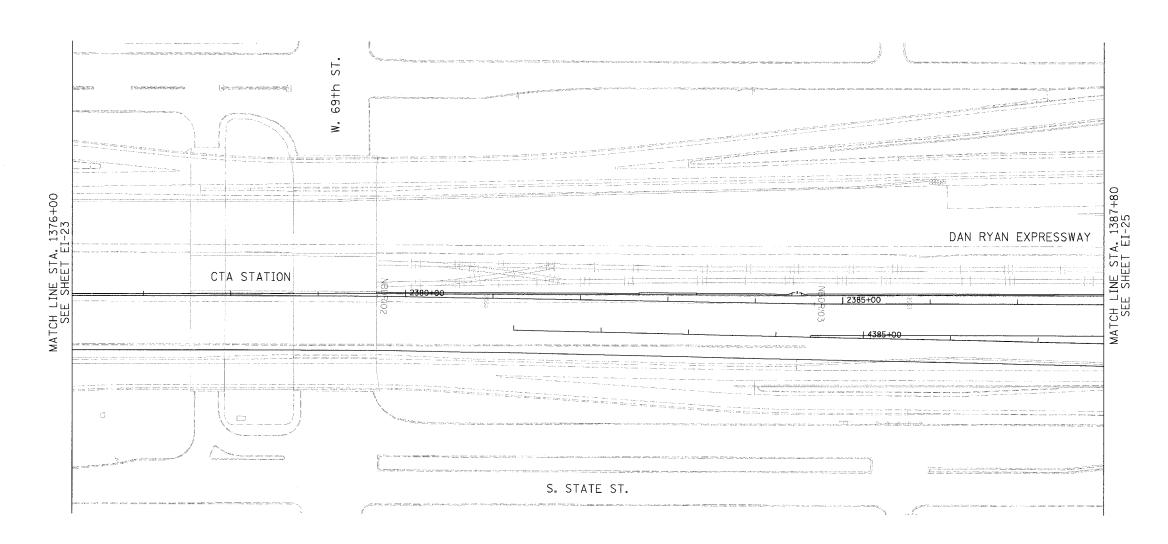

NOTES;

1. SEE DRAWING EI-100 AND EI-101 FOR ELECTRICAL SYSTEMS AND ABBREVIATIONS.

2. UNLESS OTHERWISE STATED, ALL NOTED CABLE TO BE FURNISHED AND INSTALLED UNDER ANOTHER CONTRACT.

3. TRENCHED CONDUITS INSTALLED IN PARALLEL ARE TO BE INSTALLED IN COMMON TRENCH.

4. THIS SHEET ONLY DEPICTS INSTALLATION OF DETECTION/RAMP METER ELEMENTS. REFER TO SHEETS FOR OTHER SUBSYSTEMS FOR ADDITIONAL ELEMENTS IN THE AREA SHOWN.

5. DETECTOR LOOPS INSTALLED BY OTHERS.

6. REFER TO HANDHOLE DETAILS. SEE DRAWING DET-29

AND KEICEU

ONE NORTH FRANKLIN CHICAGO, IL 60606

AND KEICEU

ONE NORTH FRANKLIN CHICAGO, IL 60606

FAX: G312 251-305


FEB: WWW.ECORP.COM

SCALE IN FEET

ILLINOIS DEPARTMENT OF TRANSPORTATION F.A.I. 94/90 (DAN RYAN EXPRESSWAY) 31ST STREET TO 71ST STREET NB EXPRESS LANE RECONSTRUCTION ELECTRICAL INFRASTRUCTURE PLAN NORTHBOUND STA. 1376+00 TO 1387+80

SCALE: 1"=50" DATE: 7/7/05 DRAWN BY: CJH

EI-24

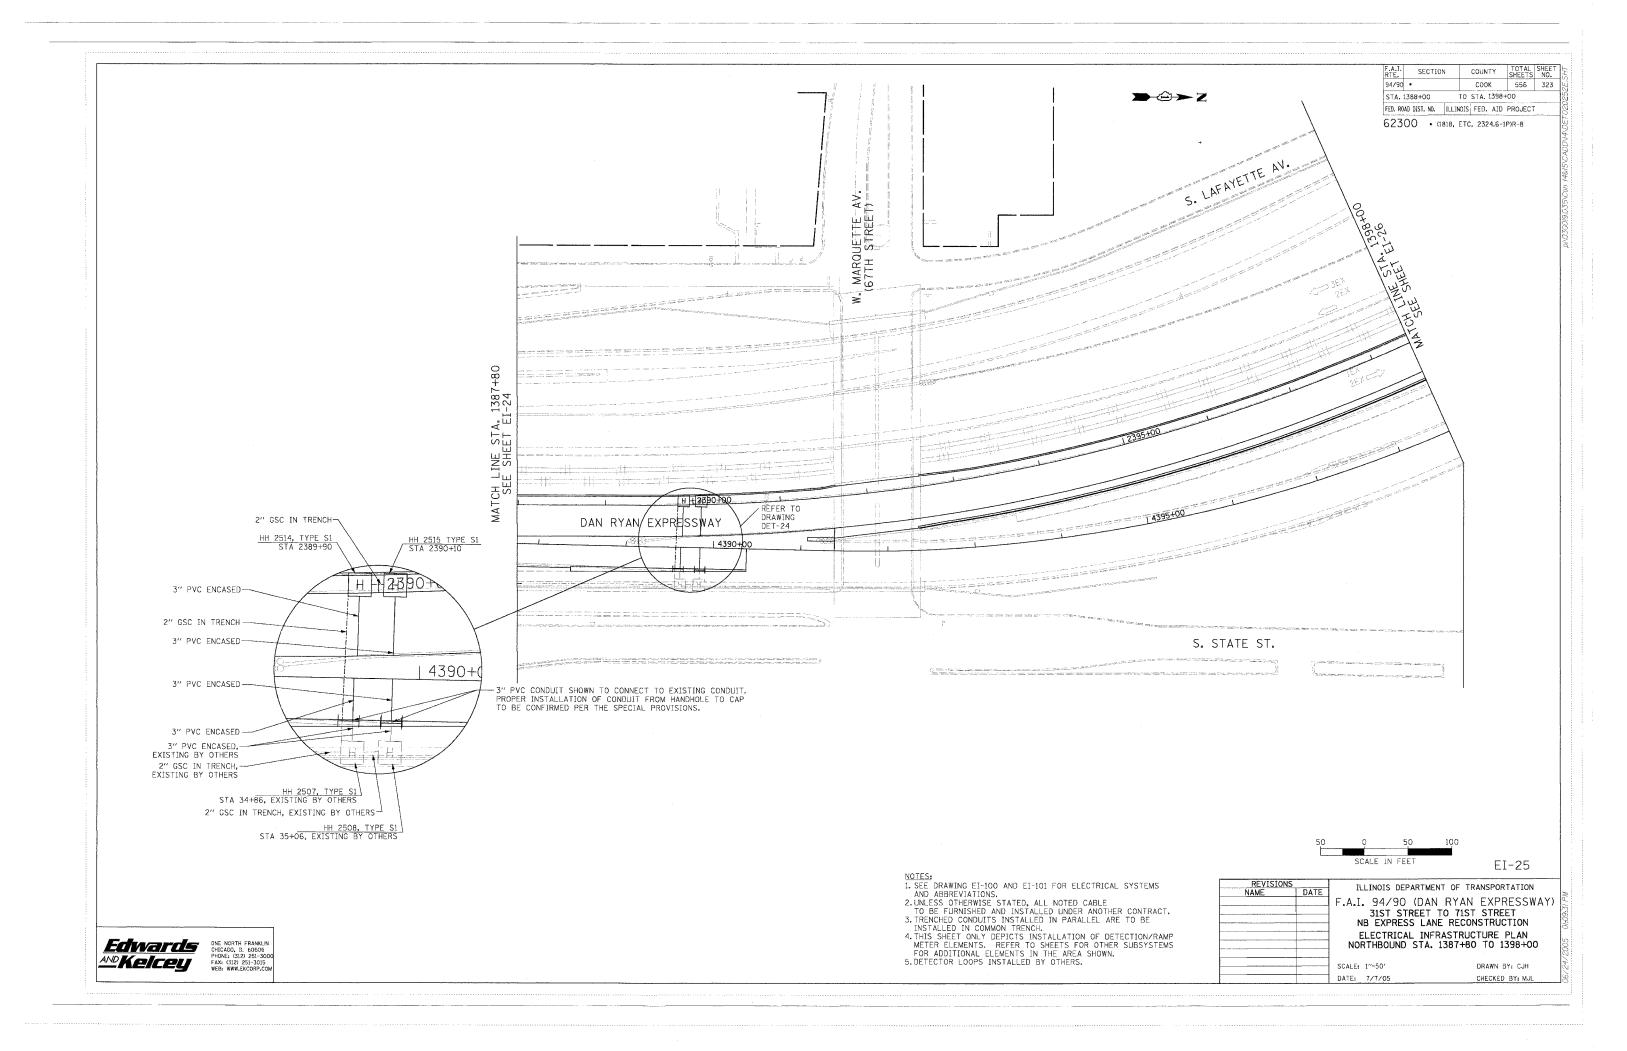

TOTAL SHEET SHEETS NO. 556 324 COOK 94/90 * STA. 1398+00 TO STA, 1406+00 FED. ROAD DIST. NO. ILLINOIS FED. AID PROJECT 62300 • (1818, ETC, 2324.6-1P)R-8 $\rightarrow \bigcirc \rightarrow Z$ NO PROPOSED WORK ON THIS SHEET DAN RYAN EXPRESSWAY NOTES:

1. SEE DRAWING EI-100 AND EI-101 FOR ELECTRICAL SYSTEMS AND ABBREVIATIONS.

2. UNLESS OTHERWISE STATED, ALL NOTED CABLE TO BE FURNISHED AND INSTALLED UNDER ANOTHER CONTRACT.

3. TRENCHED CONDUITS INSTALLED IN PARALLEL ARE TO BE INSTALLED IN COMMON TRENCH.

4. THIS SHEET ONLY DEPICTS INSTALLATION OF DETECTION/RAMP METER ELEMENTS. REFER TO SHEETS FOR OTHER SUBSYSTEMS FOR ADDITIONAL ELEMENTS IN THE AREA SHOWN.

5. DETECTOR LOOPS INSTALLED BY OTHERS.

6. REFER TO HANDHOLE DETAILS. SEE DRAWING DE-29. SCALE IN FEET EI-26 REVISIONS NAME ILLINOIS DEPARTMENT OF TRANSPORTATION F.A.I. 94/90 (DAN RYAN EXPRESSWAY)
31ST STREET TO 71ST STREET
NB EXPRESS LANE RECONSTRUCTION ELECTRICAL INFRASTRUCTURE PLAN NORTHBOUND STA 1398+00 TO 1406+00 Edivards

AND Kelcey

ONE NORTH FRANKLIN CHICAGO, II. GOSGO
FAX: (3)21 251-300
FAX: (3)21 251-300
FAX: (3)21 251-300
FAX: (3)21 251-301
FAX: (3)21 SCALE: 1"=50" DRAWN BY: CJH CHECKED BY: MJL

SECTION

COUNTY

F.A.I. RTE. 94/90 * COUNTY TOTAL SHEE COOK 556 325 STA. 1406+00 TO STA. 1416+00 **→** 🗢 Z FED. ROAD DIST. NO. ILLINOIS FED. AID PROJECT 62300 • (1818, ETC, 2324.6-1P)R-8 NOTES:

1. SEE DRAWING EI-100 AND EI-101 FOR ELECTRICAL SYSTEMS AND ABBREVIATIONS.

2. UNLESS OTHERWISE STATED, ALL NOTED CABLE TO BE FURNISHED AND INSTALLED UNDER ANOTHER CONTRACT.

3. TRENCHED CONDUITS INSTALLED IN PARALLEL ARE TO BE INSTALLED IN COMMON TRENCH.

4. THIS SHEET ONLY DEPICTS INSTALLATION OF DETECTION/RAMP METER ELEMENTS. REFER TO SHEETS FOR OTHER SUBSYSTEMS FOR ADDITIONAL ELEMENTS IN THE AREA SHOWN.

5. DETECTOR LOOPS INSTALLED BY OTHERS.

6. REFER TO HANDHOLE DETAILS. SEE DRAWING DT-29. ST 65+h - 3" PVC ENCASED S. WENTWORTH AVE. HH 2704, TYPE S1 STA 6071+58, EXISTING BY OTHERS _2"GSC PUSHED, EXISTING BY OTHERS _2" GSC PUSHED (SPARE), EXISTING BY OTHERS ELECTRIC SERVICE INSTALLATION - 30A, 120V, EXISTING BY OTHERS -2" GSC IN TRENCH, EXISTING BY OTHERS HH 2705, TYPE C1 STA 6071+58, BY OTHERS 3" GSC IN TRENCH, EXISTING BY OTHERS PROPOSED SURVEILLANCE CABINET 48
STA. 6071+50, 35 RT, BY OTHERS
-CONCRETE FOUNDATION, TYPE 1, EXISTING BY OTHERS 3" PVC ENCASED, EXISTING BY OTHERS-EI-27 SCALE IN FEET REVISIONS NAME ILLINOIS DEPARTMENT OF TRANSPORTATION F.A.I. 94/90 (DAN RYAN EXPRESSWAY) 31ST STREET TO 71ST STREET NB EXPRESS LANE RECONSTRUCTION CABINET, MODEL 334 EQUIPMENT, SYSTEM DETECTOR, EXISTING BY OTHERS ELECTRICAL INFRASTRUCTURE PLAN NORTHBOUND STA. 1406+00 TO 1416+00 EDIVATOS

ONE NORTH FRANKLIN CHICAGO, IL 60605

AND KEICEU

ONE NORTH FRANKLIN CHICAGO, IL 60605

FAX: (312) 251-3030

FEB: WWW_ECGOR-COM SCALE: 1"=50" DRAWN BY: CJH DATE: 7/7/05 CHECKED BY: MJL

COUNTY TOTAL SHEET NO. SECTION COOK 556 326 94/90 * STA. 1416+00 TO STA. 1426+00 FED. ROAD DIST. NO. ILLINOIS FED. AID PROJECT 62300 • (1818, ETC, 2324.6-1P)R-8 $\rightarrow \ominus \rightarrow Z$ ST. 641 `. S. YALE AV. NO PROPOSED WORK ON THIS SHEET DAN RYAN EXPRESSWAY CTA STATION 14425-600 S. WENTWORTH AV. Α, S Ō 63r ≥ NOTES:

1. SEE DRAWING EI-100 AND EI-101 FOR ELECTRICAL SYSTEMS AND ABBREVIATIONS.

2. UNLESS OTHERWISE STATED, ALL NOTED CABLE TO BE FURNISHED AND INSTALLED UNDER ANOTHER CONTRACT.

3. TRENCHED CONDUITS INSTALLED IN PARALLEL ARE TO BE INSTALLED IN COMMON TRENCH.

4. THIS SHEET ONLY DEPICTS INSTALLATION OF DETECTION/RAMP METER ELEMENTS. REFER TO SHEETS FOR OTHER SUBSYSTEMS FOR ADDITIONAL ELEMENTS IN THE AREA SHOWN.

5. DETECTOR LOOPS INSTALLED BY OTHERS.

6. REFER TO HANDHOLE DETAILS. SEE DRAWING DET-29. SCALE IN FEET EI-28 ILLINOIS DEPARTMENT OF TRANSPORTATION F.A.I. 94/90 (DAN RYAN EXPRESSWAY)
31ST STREET TO 71ST STREET
NB EXPRESS LANE RECONSTRUCTION ELECTRICAL INFRASTRUCTURE PLAN NORTHBOUND STA. 1416+00 TO 1426+00 Edivards

AND Kelcey

ONE NORTH FRANKLIN CHICAGO, IL 60606

FAX: (3312 251-3016

FAX: (3312 251-3016

FAX: (3312 251-3016

FAX: (3312 251-3016

FAX: WWW.EXCORP.COM SCALE: 1"=50" DRAWN BY: CJH CHECKED BY: MJL

F.A.I. SECTION COUNTY TOTAL SHEETS NO. 94/90 * COOK 556 327 STA, 1426+00 TO STA. 1436+00 $\rightarrow \ominus \rightarrow Z$ FED. ROAD DIST. NO. ILLINOIS FED. AID PROJECT 62300 * (1818, ETC, 2324.6-1P)R-8

SŢ. 61st 61s+ ¦≥° ≥. S. WELLS ST. THE TAX OF THE STATE OF THE STATE AND ADDRESS OF THE STATE OF THE STAT 00+ MATCH LINE STA, 1426 SEE SHEET EI-28 A. 1436 EI-30 P CH LINE STA SEE SHEET 12435+00 REFER TO DRAWING DT-24 DAN RYAN EXPRESSWAY -NOTE: PROVIDE 4' OF 2" GSC STUBOUT FOR FUTURE CONDUIT CONNECTION, CENTER OF STUBOUT ELEV. = -2.47 NOTES:

1. SEE DRAWING EI-100 AND EI-101 FOR ELECTRICAL SYSTEMS AND ABBREVIATIONS.

2. UNLESS OTHERWISE STATED, ALL NOTED CABLE TO BE FURNISHED AND INSTALLED UNDER ANOTHER CONTRACT.

3. TRENCHED CONDUITS INSTALLED IN PARALLEL ARE TO BE INSTALLED IN COMMON TRENCH.

4. THIS SHEET ONLY DEPICTS INSTALLATION OF DETECTION/RAMP METER ELEMENTS. REFER TO SHEETS FOR OTHER SUBSYSTEMS FOR ADDITIONAL ELEMENTS IN THE AREA SHOWN.

5. DETECTOR LOOPS INSTALLED BY OTHERS.

6. REFER TO HANDHOLE DETAILS. SEE DRAWING DT-29. S. WENTWORTH AV. (7) 4/C #18, BY OTHERS— 2" GSC IN TRENCH, BY OTHERS -3" PVC ENCASED HH 2913, TYPE S1 (SPECIAL) STA 2429+01 -2" GSC IN TRENCH HH 2911, TYPE S1 (SPECIAL) STA 2428+82 -3" PVC ENCASED, FUTURE WORK BY OTHERS SCALE IN FEET EI-29 HHH REVISIONS NAME 2" GSC IN TRENCH, FUTURE WORK BY OTHERS HH 2912, TYPE S1 STA 2429+01, FUTURE WORK BY OTHERS -2" GSC IN TRENCH, FUTURE WORK BY OTHERS

Edivards

AND Kelcey

ONE NORTH FRANKLIN CHICAGO, 11. 60606

FAX: (3312 251-3010

FAX: (3312 251-3015)

WEB: WWW.EKCORP.COM

HH 2910, TYPE S1 STA 2428+82, FUTURE WORK BY OTHERS

ILLINOIS DEPARTMENT OF TRANSPORTATION F.A.I. 94/90 (DAN RYAN EXPRESSWAY) 31ST STREET TO 71ST STREET NB EXPRESS LANE RECONSTRUCTION ELECTRICAL INFRASTRUCTURE PLAN NORTHBOUND STA 1426+00 TO 1436+00

SCALE: 1"=50"

DRAWN BY: CJH CHECKED BY: MJL

COUNTY TOTAL SHEET NO. COOK 556 328 SECTION STA, 1436+00 TO STA. 1446+50 FED. ROAD DIST. NO. ILLINOIS FED. AID PROJECT 62300 • (1818, ETC, 2324.6-1P)R-8

CTA GREEN LINE S. WELLS ST. DAN RYAN EXPRESSWAY MATCH LINE STA. SEE SHEET EI 1 4440+00 NOTE: PER OVERHEAD SIGN FOUNDATION PLANS,-PROVIDE 3" GSC STUBOUT FOR FUTURE CONNECTION S. WENTWORTH AV.

REVISIONS NAME DATE

ILLINOIS DEPARTMENT OF TRANSPORTATION F.A.I. 94/90 (DAN RYAN EXPRESSWAY)
31ST STREET TO 71ST STREET
NB EXPRESS LANE RECONSTRUCTION ELECTRICAL INFRASTRUCTURE PLAN SOUTHBOUND STA. 1436+00 TO 1446+50

SCALE: 1"=50" DATE: 7/7/05 CHECKED BY: MJL

EI-30

AND KEICEU

ONE NORTH FRANKLIN
CHICAGO, IL 60506
FAX: 0312/ 251-3015
FAX: 0312/ 251-3015

NOTES:
1. SEE DRAWING EI-100 AND EI-101 FOR ELECTRICAL SYSTEMS AND ABBREVIATIONS.
2. UNLESS OTHERWISE STATED, ALL NOTED CABLE TO BE FURNISHED AND INSTALLED UNDER ANOTHER CONTRACT.
3. TRENCHED CONDUITS INSTALLED IN PARALLEL ARE TO BE INSTALLED IN COMMON TRENCH.
4. THIS SHEET ONLY DEPICTS INSTALLATION OF DETECTION/RAMP METER ELEMENTS. REFER TO SHEETS FOR OTHER SUBSYSTEMS FOR ADDITIONAL ELEMENTS IN THE AREA SHOWN.
5. DETECTOR LOOPS INSTALLED BY OTHERS.
6. REFER TO HANDHOLE DETAILS. SEE DRAWING DT-29.

COUNTY TOTAL SHEE SHEETS NO. SECTION COOK 556 329 94/90 • STA. 1446+50 TO STA. 1458+50 FED. ROAD DIST. NO. ILLINOIS FED. AID PROJECT 62300 • (1818, ETC, 2324.6-1P)R-8 **→**②→ Z ST 59†h Š S. WELLS ST. INE STA. 1446 SHEET EI-30 DAN RYAN EXPRESSWAY NOTE: PROVIDE 2' OF 2" GSC STUBOUT-FOR FUTURE CONDUIT CONNECTION. CENTER OF STUBOUT ELEV. = -4.49 S. WENTWORTH AV. -2" GSC IN TRENCH, BY OTHERS 3" PVC ENCASED--3" GSC IN TRENCH, BY OTHERS 2" GSC IN TRENCH, BY OTHERS H HH 3114, TYPE C1 STA 2455+64, BY OTHERS — 2" GSC IN TRENCH, BY OTHERS F-3" GSC IN TRENCH, BY OTHERS NOTES:

1. SEE DRAWING EI-100 AND EI-101 FOR ELECTRICAL SYSTEMS AND ABBREVIATIONS.

2. UNLESS OTHERWISE STATED, ALL NOTED CABLE TO BE FURNISHED AND INSTALLED UNDER ANOTHER CONTRACT.

3. TRENCHED CONDUITS INSTALLED IN PARALLEL ARE TO BE INSTALLED IN COMMON TRENCH.

4. THIS SHEET ONLY DEPICTS INSTALLATION OF DETECTION/RAMP METER ELEMENTS. REFER TO SHEETS FOR OTHER SUBSYSTEMS FOR ADDITIONAL ELEMENTS IN THE AREA SHOWN.

5. DETECTOR LOOPS INSTALLED BY OTHERS.


6. REFER TO HANDHOLE DETAILS. SEE DRAWING DT-29. -3" GSC IN TRENCH, BY OTHERS 2" GSC IN TRENCH, FUTURE WORK BY OTHERS EI-31 Н 3" PVC ENCASED, FUTURE WORK BY OTHERS -REVISIONS NAME ILLINOIS DEPARTMENT OF TRANSPORTATION HH 3113, TYPE S1 STA 2454+96, BY OTHERS F.A.I. 94/90 (DAN RYAN EXPRESSWAY) 31ST STREET TO 71ST STREET NB EXPRESS LANE RECONSTRUCTION 2" GSC IN TRENCH, BY OTHERS-3" GSC IN TRENCH, BY OTHERS-ELECTRICAL INFRASTRUCTURE PLAN NORTHBOUND STA 1446+50 TO 1458+00 AND KEICEU


ONE NORTH FRANKLIN CHICAGO, IL 60606

FAX: 13212 251-3010

FAX: 13212 251-3010

FAX: WWW.EXCORP.COM CONCRETE FOUNDATION, TYPE 1, BY OTHERS-PROPOSED SURVEILLANCE CABINET 44 STA, 2455+65, 124RT SCALE: 1"=50' CABINET, MODEL 334 EQUIPMENT, DMS/SYSTEM DETECTOR, BY OTHERS DRAWN BY: CJH DATE: 7/7/05

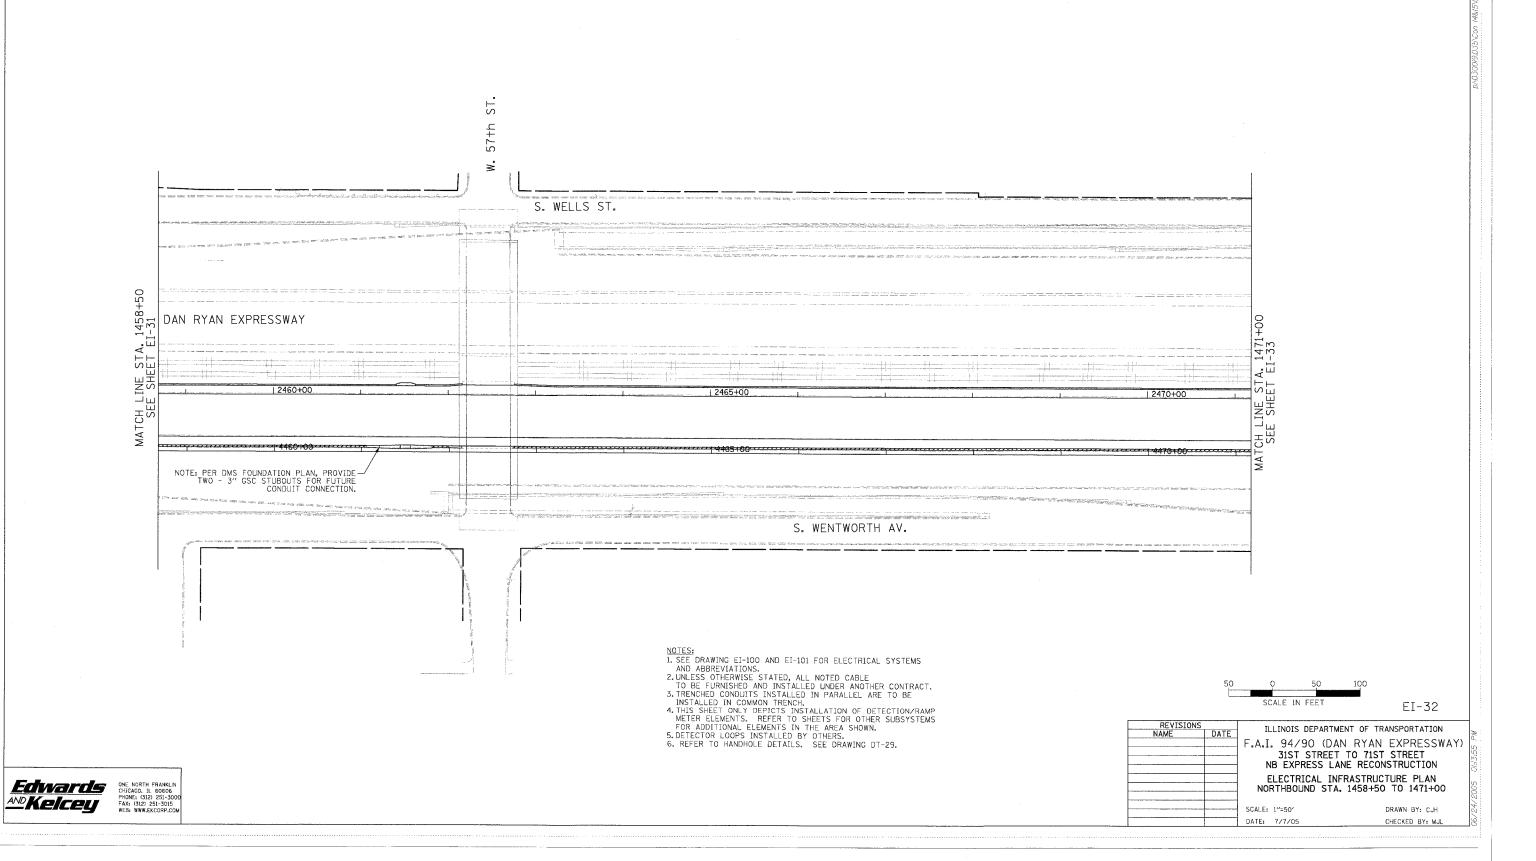


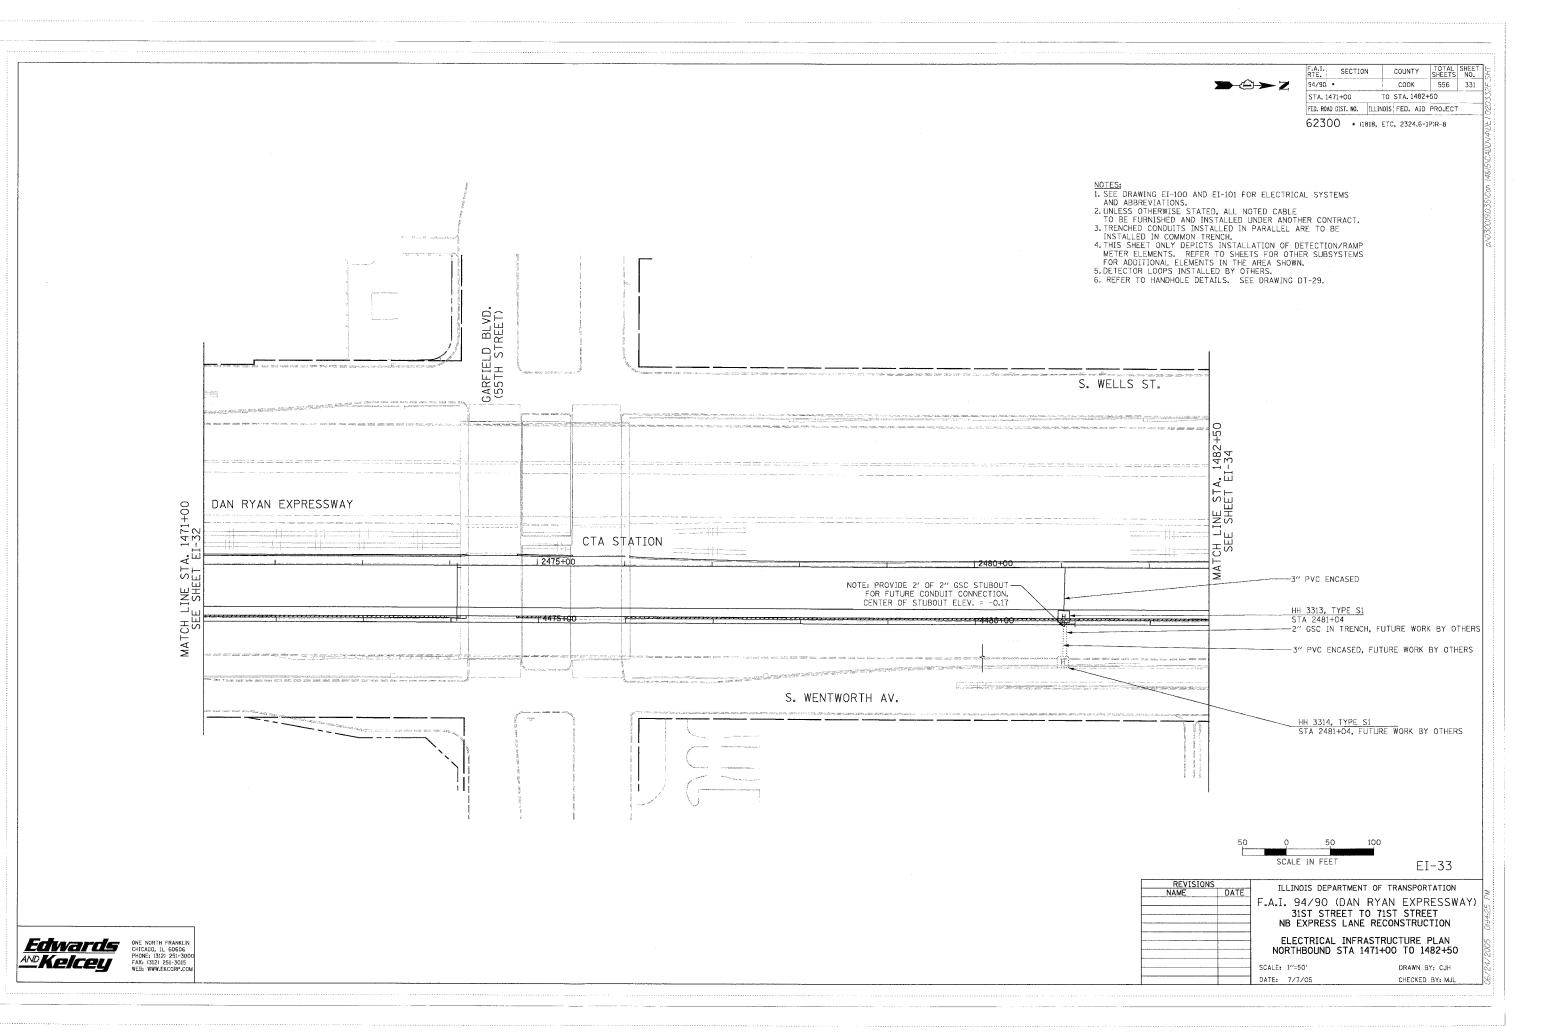

COUNTY TOTAL SHEET NO.

COOK 556 332 94/90 * STA. 1482+50 TO STA, 1494+50 FED. ROAD DIST. NO. ILLINOIS FED. AID PROJECT 62300 * (1818, ETC, 2324.6-1P)R-8 **→** 🗢 Z EI-34 ILLINOIS DEPARTMENT OF TRANSPORTATION F.A.I. 94/90 (DAN RYAN EXPRESSWAY)
31ST STREET TO 71ST STREET
NB EXPRESS LANE RECONSTRUCTION ELECTRICAL INFRASTRUCTURE PLAN NORTHBOUND STA 1482+50 TO 1495+50

NO PROPOSED WORK ON THIS SHEET

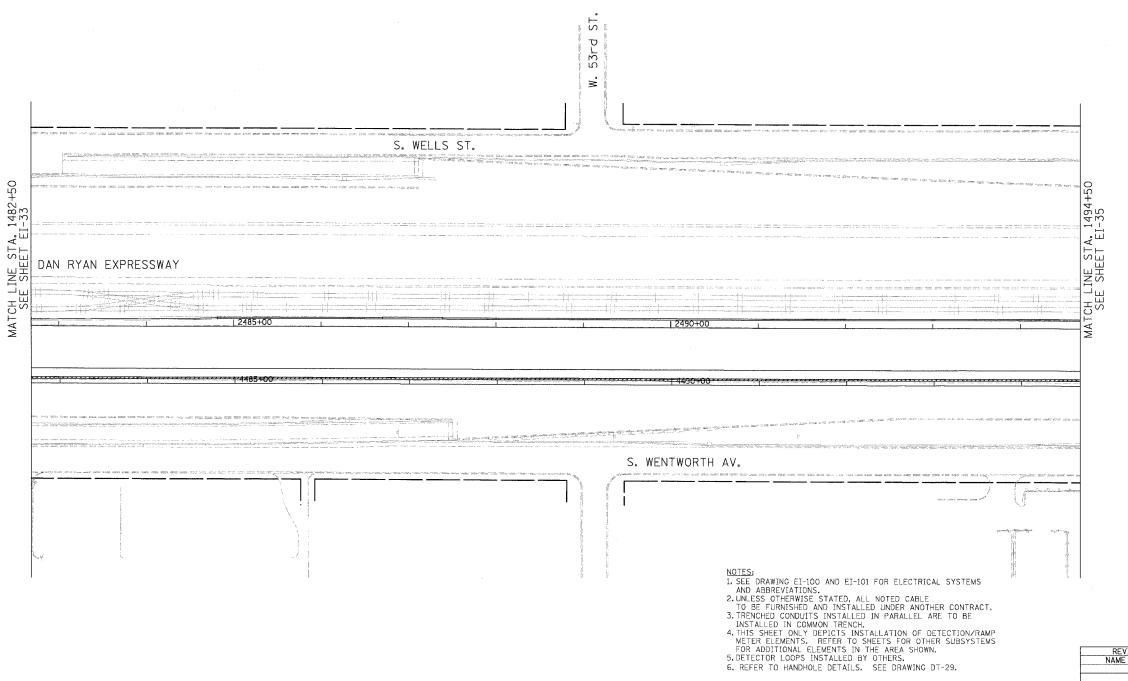

SCALE: 1"=50"

DRAWN BY: CJH CHECKED BY: MJL

AND KEICEU

ONE NORTH FRANKLIN CHICAGO, IL 60606

AND KEICEU

ONE NORTH FRANKLIN CHICAGO, IL 60606

FAX: 13212 251-3305

WES: WWW.ECGOR.COM

F.A.I. RTE. 94/90 • SECTION COUNTY TOTAL SHEET SHOOL SHEETS NO.

COOK 556 333 STA. 1494+50 TO STA, 1506+50 FED. ROAD DIST. NO. ILLINOIS FED. AID PROJECT 62300 • (1818, ETC, 2324.6-1P)R-8

 $\rightarrow \bigcirc \rightarrow Z$ NOTES:
1. SEE DRAWING EI-100 AND EI-101 FOR ELECTRICAL SYSTEMS AND ABBREVIATIONS.
2. UNLESS OTHERWISE STATED, ALL NOTED CABLE
TO BE FURNISHED AND INSTALLED UNDER ANOTHER CONTRACT.
3. TRENCHED CONDUITS INSTALLED IN PARALLEL ARE TO BE
INSTALLED IN COMMON TRENCH.
4. THIS SHEET ONLY DEPICTS INSTALLATION OF DETECTION/RAMP METER ELEMENTS. REFER TO SHEETS FOR OTHER SUBSYSTEMS FOR ADDITIONAL ELEMENTS IN THE AREA SHOWN.
5. DETECTOR LOOPS INSTALLED BY OTHERS.
6. REFER TO HANDHOLE DETAILS. SEE DRAWING DT-29. S ST. 6. REFER TO HANDHOLE DETAILS. SEE DRAWING DT-29. 51st 52nd ×. S. WELLS ST. INE STA, 1506-1 SHEET EI-36 DAN RYAN EXPRESSWAY CH LI SEE | 2495+00 -NOTE: PROVIDE 2' OF 2" GSC STUBOUT FOR FUTURE CONDUIT CONNECTION, CENTER OF STUBOUT ELEV. = -7.48 1400+00 S. WENTWORTH AV. -LOOP DETECTOR, BY OTHERS
NOTE: CONTRACTOR MUST COORDINATE
LOOP DETECTOR PLACEMENT WITH CONTRACT 62583 -LOOP DETECTOR, FUTURE WORK BY OTHERS --- (4) 4/C #18, FUTURE WORK BY OTHERS 3" CSC IN TRENCH, FUTURE WORK BY OTHERS HH 3508 TYPE S1 STA 2503+63 -(7) 4/C *18, FUTURE WORK BY OTHERS
3" GSC IN TRENCH, FUTURE WORK BY OTHERS
-2/C *1/O, 1/C *6 GND, FUTURE WORK BY OTHERS
3" GSC IN TRENCH, FUTURE WORK BY OTHERS SCALE IN FEET EI-35 2/C #1/0, 1/C #6 GND, BY OTHERS— 3" GSC CONCRETE ENCASED, BY OTHERS ILLINOIS DEPARTMENT OF TRANSPORTATION F.A.I. 94/90 (DAN RYAN EXPRESSWAY) 31ST STREET TO 71ST STREET
NB EXPRESS LANE RECONSTRUCTION HH 3509 TYPE S1, BY OTHERS STA 2503+63 ELECTRICAL INFRASTRUCTURE PLAN NORTHBOUND STA. 1494+50 TO 1506+50 AND KEICEU

ONE NORTH FRANKLIN CHICAGO, IL 60606
FAX: G12: 251-3015
FAX: G12: 251-3015 2/C #1/O, 1/C #6 GND, BY OTHERS-3" GSC IN TRENCH, BY OTHERS SCALE: 1"=50' DRAWN BY: CJH DATE: 7/7/05 CHECKED BY: MJL

94/90 * STA- 1506+50 TO STA. 1518+00 FEO. ROAD DIST. NO. ILLINOIS FED. AID PROJECT 62300 * (1818, ETC, 2324.6-1P)R-8 $\rightarrow \bigcirc \rightarrow Z$ CH LINE STA, 1518 SEE SHEET EI-37 ST DAN RYAN EXPRESSWAY S. WENTWORTH AV. HH 3606, TYPE S1 STA 8068+62, BY OTHERS -3" PVC IN TRENCH, BY OTHERS 3" PVC ENCASED-H -2" GSC IN TRENCH, BY OTHERS HH 3604, TYPE S1 STA 2512+00 NOTES:

1. SEE DRAWING EI-100 AND EI-101 FOR ELECTRICAL SYSTEMS AND ABBREVIATIONS.

2. UNLESS OTHERWISE STATED, ALL NOTED CABLE TO BE FURNISHED AND INSTALLED UNDER ANOTHER CONTRACT.

3. TRENCHED CONDUITS INSTALLED IN PARALLEL ARE TO BE INSTALLED IN COMMON TRENCH.

4. THIS SHEET ONLY DEPICTS INSTALLATION OF DETECTION/RAMP METER ELEMENTS. REFER TO SHEETS FOR OTHER SUBSYSTEMS FOR ADDITIONAL ELEMENTS IN THE AREA SHOWN.

5. DETECTOR LOOPS INSTALLED BY OTHERS.

6. REFER TO HANDHOLE DETAILS. SEE DRAWING DT-29. 2" GSC IN TRENCH, FUTURE WORK BY OTHERS--2" GSC IN TRENCH STUBOUT FOR FUTURE CONDUIT CONNECTION, CENTER OF STUBOUT ELEV. = 2.86 3" PVC IN TRENCH, FUTURE WORK BY OTHERS-SCALE IN FEET EI-36 REVISIONS NAME ILLINOIS DEPARTMENT OF TRANSPORTATION F.A.I. 94/90 (DAN RYAN EXPRESSWAY) 31ST STREET TO 71ST STREET
NB EXPRESS LANE RECONSTRUCTION ELECTRICAL INFRASTRUCTURE PLAN SOUTHBOUND STA 1506+50 TO 1518+00 AND KEICEU

ONE NORTH FRANKLIN CHICAGO, IL 60506

AND KEICEU


FAX: 3122 251-3015

FEB: WWW.EXCORP.COM HH 3605, TYPE S1 STA 2512+17, FUTURE WORK BY OTHERS SCALE: 1"=50" DRAWN BY: CJH

COUNTY TOTAL SHEETS NO. SECTION COOK 556 334

62300 * (1818, ETC, 2324.6-1P)R-8


NO PROPOSED WORK ON THIS SHEET

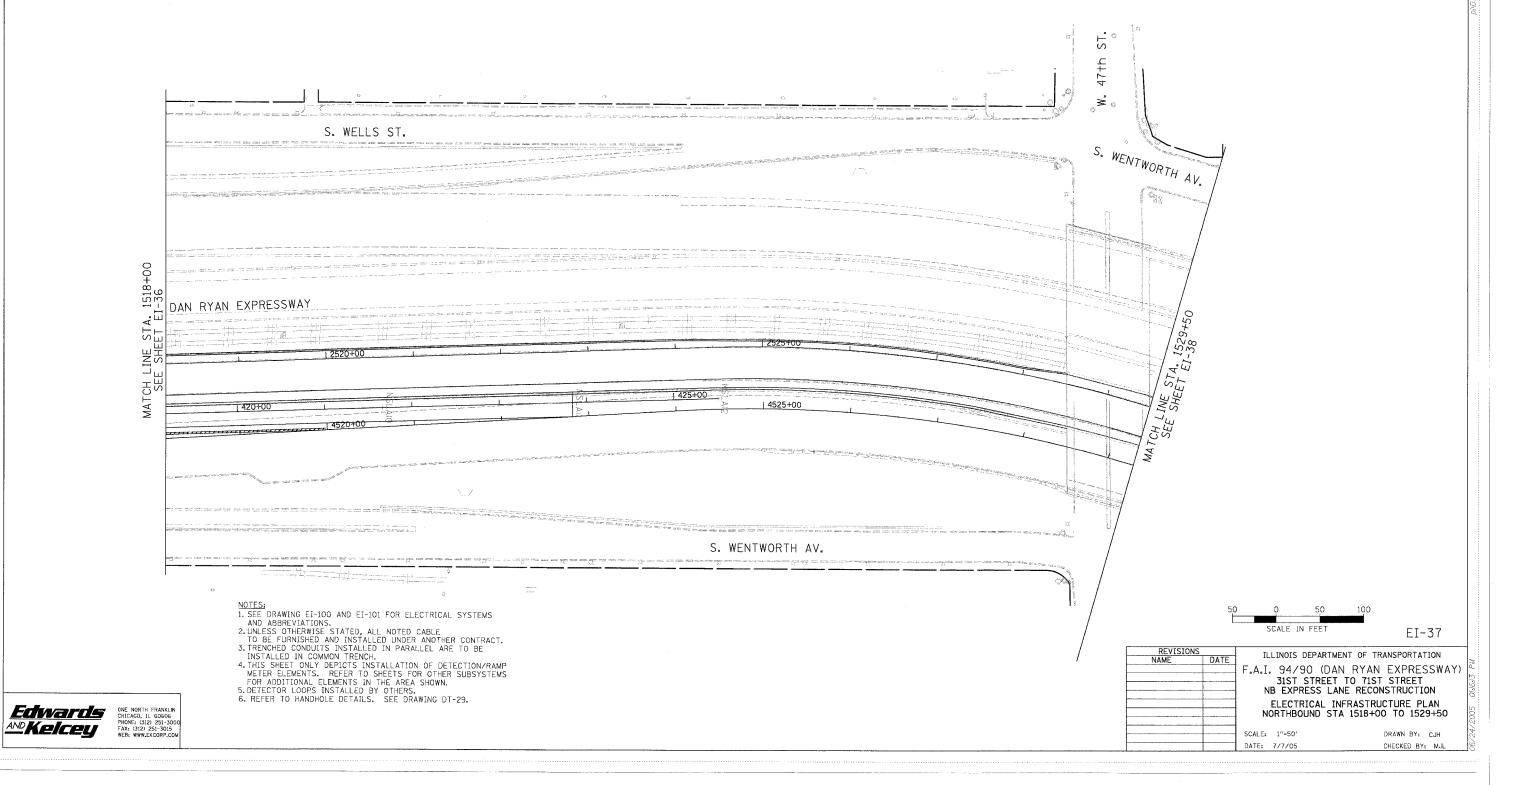

F.A.I.	SECTION		COUNTY	TOTAL SHEETS	SHEE.
94/90	•		COOK	556	336
STA.	1529+50	то	STA.	1536+00	
FFD. ROAD	DIST, NO.	TILI TNOTS	FED. ATC	PROJECT	



NO PROPOSED WORK ON THIS SHEET

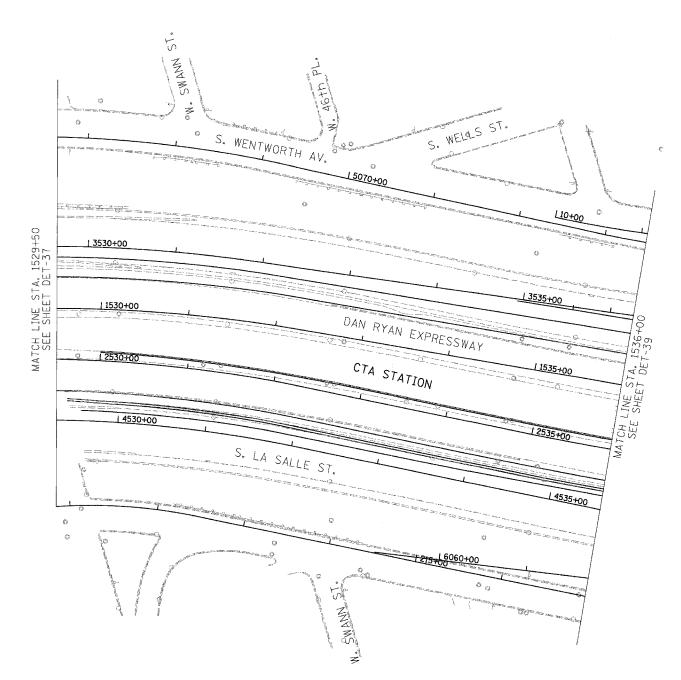

NOTES:

NOTES:

1. SEE DRAWING EI-100 AND EI-101 FOR ELECTRICAL SYSTEMS AND ABBREVIATIONS.


2. UNLESS OTHERWISE STATED, ALL NOTED CABLE TO BE FURNISHED AND INSTALLED UNDER ANOTHER CONTRACT.

3. TRENCHED CONDUITS INSTALLED IN PARALLEL ARE TO BE INSTALLED IN COMMON TRENCH.

4. THIS SHEET ONLY DEPICTS INSTALLATION OF DETECTION/RAMP METER ELEMENTS. REFER TO SHEETS FOR OTHER SUBSYSTEMS FOR ADDITIONAL ELEMENTS IN THE AREA SHOWN.

5. DETECTOR LOOPS INSTALLED BY OTHERS.


6. REFER TO HANDHOLE DETAILS. SEE DRAWING DT-29.

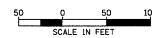

EI-38

REVISIONS NAME	DATE	ILLINOIS DEPARTMENT OF TE	RANSPORTATION
IVENUE.		F.A.I. 94/90 (DAN RYAN 31ST STREET TO 71: NB EXPRESS LANE REC	ST STREET
		ELECTRICAL INFRASTRU NORTHBOUND STA. 1529+50	
		SCALE: 1"=50"	DRAWN BY: TER
		DATE: 07/07/05	CHECKED BY: JDC


BOWMAN, BARRETT & ASSOCIATES INC.
CONSULTING ENGINEERS
Chicago, Illinois
312 228 0100
www.bbandainc.com

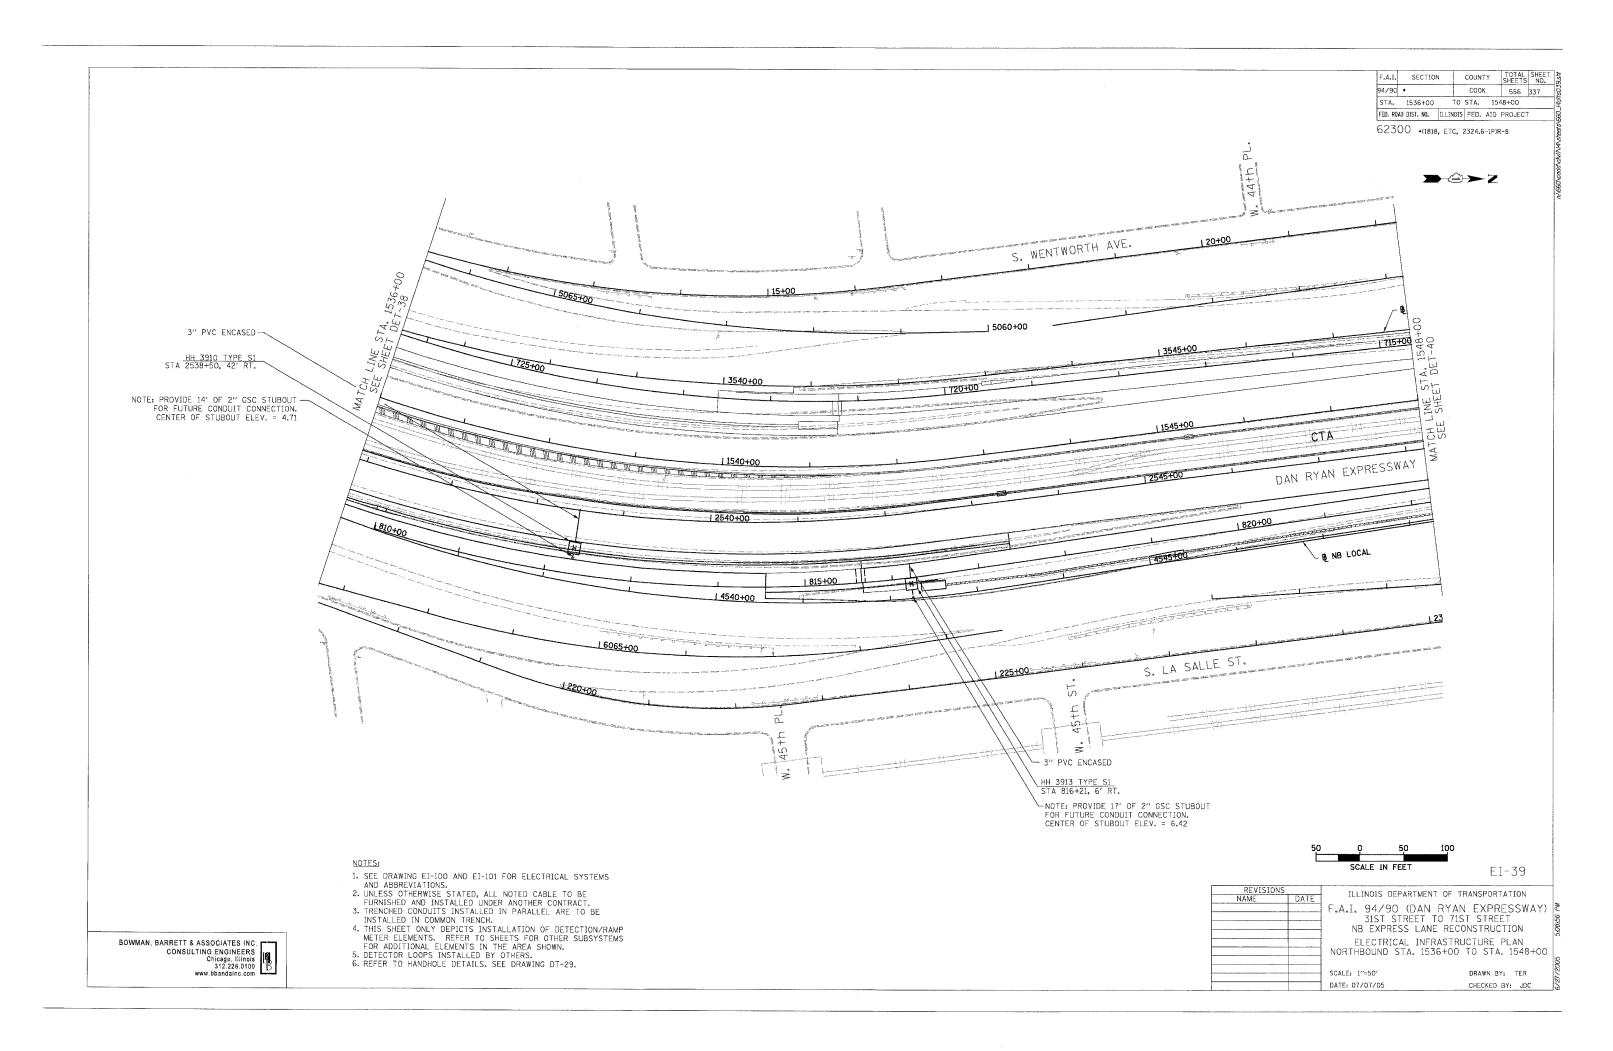

F.A.I.	SECTION	I	COUN.	TY	TOTAL	SHEET NO.
94/90	•		COO	K	556	338
STA.	1548+00	Т	O STA.	156	00+0	
FED. RO.	AD DIST. NO.	ILLING	IS FED.	AID	PROJECT	



NO PROPOSED WORK ON THIS SHEET

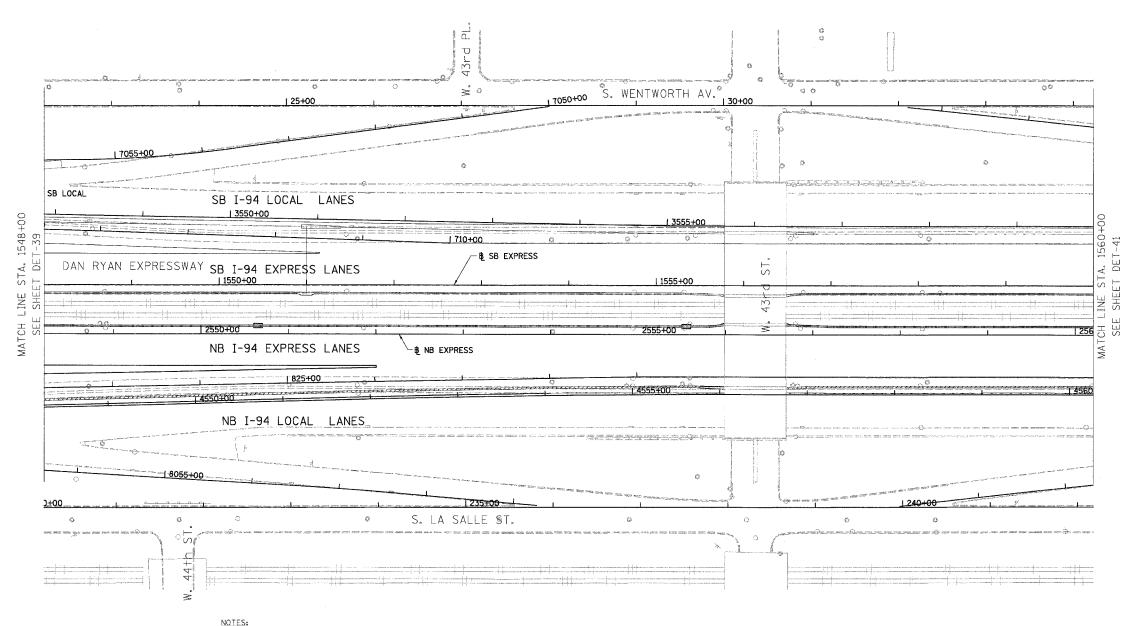

NOTES:

1. SEE DRAWING EI-100 AND EI-101 FOR ELECTRICAL SYSTEMS AND ABBREVIATIONS.

2. UNLESS OTHERWISE STATED, ALL NOTED CABLE TO BE FURNISHED AND INSTALLED UNDER ANOTHER CONTRACT.

3. TRENCHED CONDUITS INSTALLED IN PARALLEL ARE TO BE INSTALLED IN COMMON TRENCH.

4. THIS SHEET ONLY DEPICTS INSTALLATION OF DETECTION/RAMP METER ELEMENTS. REFER TO SHEETS FOR OTHER SUBSYSTEMS FOR ADDITIONAL ELEMENTS IN THE AREA SHOWN.

5. DETECTOR LOOPS INSTALLED BY OTHERS.

6. REFER TO HANDHOLE DETAILS. SEE DRAWING DT-29.

50	ọ		50	10
	SCALE	ΙN	FEET	

EI-40

REVISIONS		ILLINOIS DEPARTMENT OF TRANSPORTATION	l
NAME	DATE		L
		F.A.I. 94/90 (DAN RYAN EXPRESSWAY)	ã
		31ST STREET TO 71ST STREET	C
		NB EXPRESS LANE RECONSTRUCTION	0
		FLECTRICAL INFRACTRUCTURE DI AN	U
		ELECTRICAL INFRASTRUCTURE PLAN	
		NORTHBOUND STA. 1548+00 TO STA. 1560+00	l.
			100

SCALE: 1"=50' DATE: 07/07/05

DRAWN BY: TER CHECKED BY: JDC

BOWMAN, BARRETT & ASSOCIATES INC
CONSULTING ENGINEERS
Chicago, Illinois
312.228 0100
www.bbandainc.com

F.A.I. SECTION COUNTY TOTAL SHEETS NO. COOK 556 339 94/90 * STA. 1560+00 TO STA. 1572+00 FED. ROAD DIST. NO. ILLINOIS FED. AID PROJECT 62300 *(1818, ETC, 2324.6-1P)R-8 **→** S. WENTWORTH AV. 140+00 145+00 SB I-94 LOCAL LANES 3560+00 3" PVC ENCASED -1 3570+00 HH 4107 TYPE S1 B SB EXPRESS STA 2561+13, 54' RT. SB I-94 EXPRESS LANES NOTE: PROVIDE 12' OF 2" GSC STUBOUT -1560+00 1565+00 FOR FUTURE CONDUIT CONNECTION. CENTER OF STUBOUT ELEV. = -4.77 CTA DAN RYAN EXPRESSWAY NB I-94 EXPRESS LANES 4570+00 B NB LOCAL NB I-94 LOCAL LANES 16050+00 L8040+00 Manufacture Comments of the Co 1-6045+00---1 245+00 1250±00 S. LA SALLE ST. EI-41 NOTIES:

1. SEE DRAWING EI-100 AND EI-101 FOR ELECTRICAL SYSTEMS AND ABBREVIATIONS.

2. UNLESS OTHERWISE STATED, ALL NOTED CABLE TO BE FURNISHED AND INSTALLED UNDER ANOTHER CONTRACT.

3. TRENCHED CONDUITS INSTALLED IN PARALLEL ARE TO BE INSTALLED IN COMMON TRENCH.

4. THIS SHEET ONLY DEPICTS INSTALLATION OF DETECTION/RAMP METER ELEMENTS. REFER TO SHEETS FOR OTHER SUBSYSTEMS FOR ADDITIONAL ELEMENTS IN THE AREA SHOWN.

5. DETECTOR LOOPS INSTALLED BY OTHERS.


6. REFER TO HAMDHOLE DETAILS SEE DRAWING DI-29 ILLINOIS DEPARTMENT OF TRANSPORTATION F.A.I. 94/90 (DAN RYAN EXPRESSWAY)

31ST STREET TO 71ST STREET

NB EXPRESS LANE RECONSTRUCTION ELECTRICAL INFRASTRUCTURE PLAN NORTHBOUND STA. 1560+00 TO 1572+00 BOWMAN, BARRETT & ASSOCIATES INC.
CONSULTING ENGINEERS
Chicago, Illinois
312.228.0100
www.bbandainc.com 6. REFER TO HANDHOLE DETAILS. SEE DRAWING DT-29. CHECKED BY: JDC DATE: 07/07/05

F.A.I.	SECTIO	N	COUNTY	TOTAL	SHEET NO.	2.sh
94/90	*		COOK	556	340	å
STA.	1572+00	ТО	STA.	1584+00		14ci
FED. RO	AD DIST. NO.	ILLINOIS	FED. AID	PROJECT		099




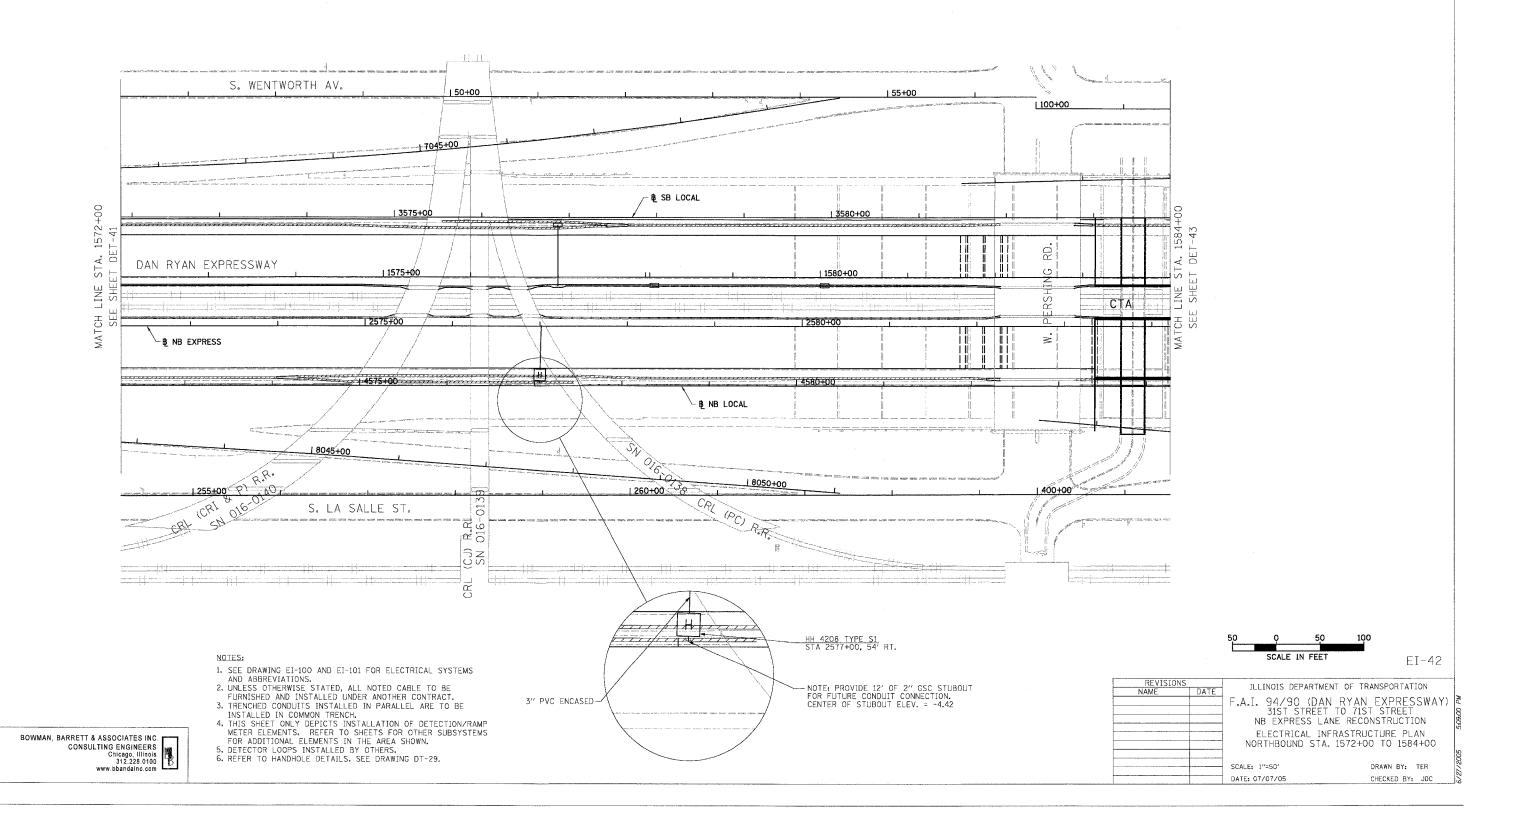

F.A.I.	SECTION	COUNTY	Y TOTAL SHEETS	SHEET NO.
94/90	*	COOK	556	341
STA.	1584+00	TO STA.	1596+00	
EED. RO	AD DIST. NO.	TILINOIS FED. 4	AID PROJECT	



NO PROPOSED WORK ON THIS SHEET

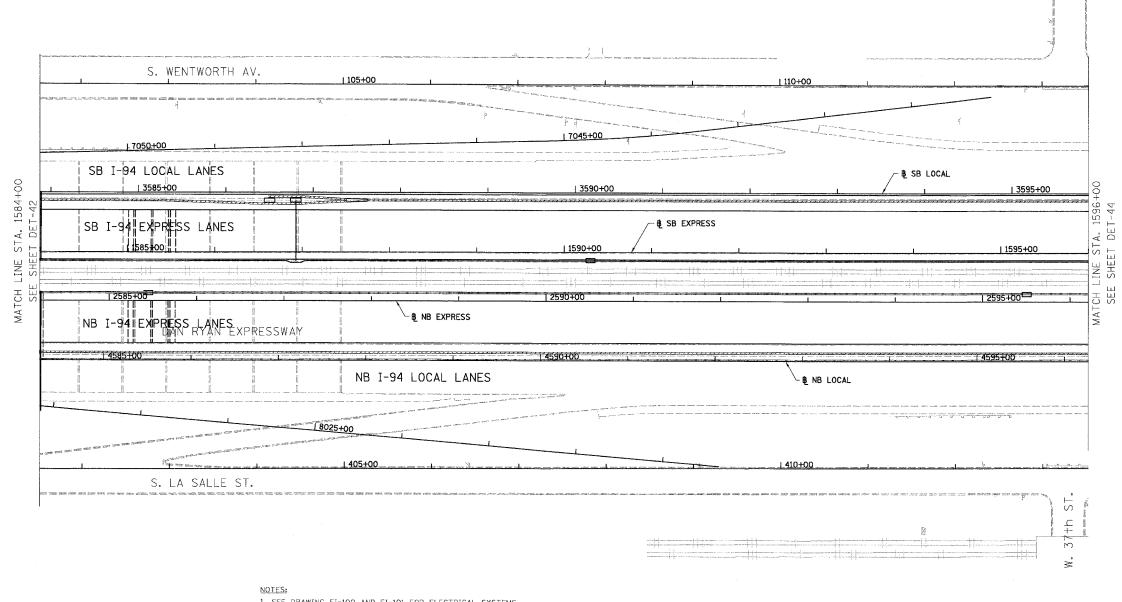

EI-43

REVISIONS	THINOIS DEPARTMENT OF TE	PANSPORTATION
NAME DATE		
	F.A.I. 94/90 (DAN RYAN	EXPRESSWAY)
	31ST STREET TO 71S	ST STREET
	NB EXPRESS LANE REC	EXPRESSWAY)
	FLECTRICAL INFRASTRU	
	NORTHBOUND STA, 1584+00	
		İş
	SCALE: 1"=50"	DRAWN BY: TER
	DATE: 07/07/05	CHECKED BY: JDC

NOTES:

1. SEE DRAWING EI-100 AND EI-101 FOR ELECTRICAL SYSTEMS AND ABBREVIATIONS.

2. UNLESS OTHERWISE STATED, ALL NOTED CABLE TO BE FURNISHED AND INSTALLED UNDER ANOTHER CONTRACT.

3. TRENCHED CONDUITS INSTALLED IN PARALLEL ARE TO BE INSTALLED IN COMMON TRENCH.

4. THIS SHEET ONLY DEPICTS INSTALLATION OF DETECTION/RAMBVC ENCASED METER ELEMENTS. REFER TO SHEETS FOR OTHER SUBSYSTEMS FOR ADDITIONAL ELEMENTS IN THE AREA SHOWN.

5. DETECTOR LOOPS INSTALLED BY OTHERS.

6. REFER TO HANDHOLE DETAILS. SEE DRAWING DT-29.

BOWMAN, BARRETT & ASSOCIATES INC.
CONSULTING ENGINEERS
Chicago, Illinois
312.228.0100
www.bbandainc.com

F.A.I.	SECT10	N	COUN	ΤΥ	TOTAL	SHEET NO.
94/90	*		COO	K	556	342
STA.	1596+00	T	O STA.	160	B+00	
FED. RO	AD DIST. NO.	TI I TNO	IS FED.	AID	PROJECT	


SCALE: 1"=50"

DATE: 07/07/05

DRAWN BY: TER

CHECKED BY: JDC



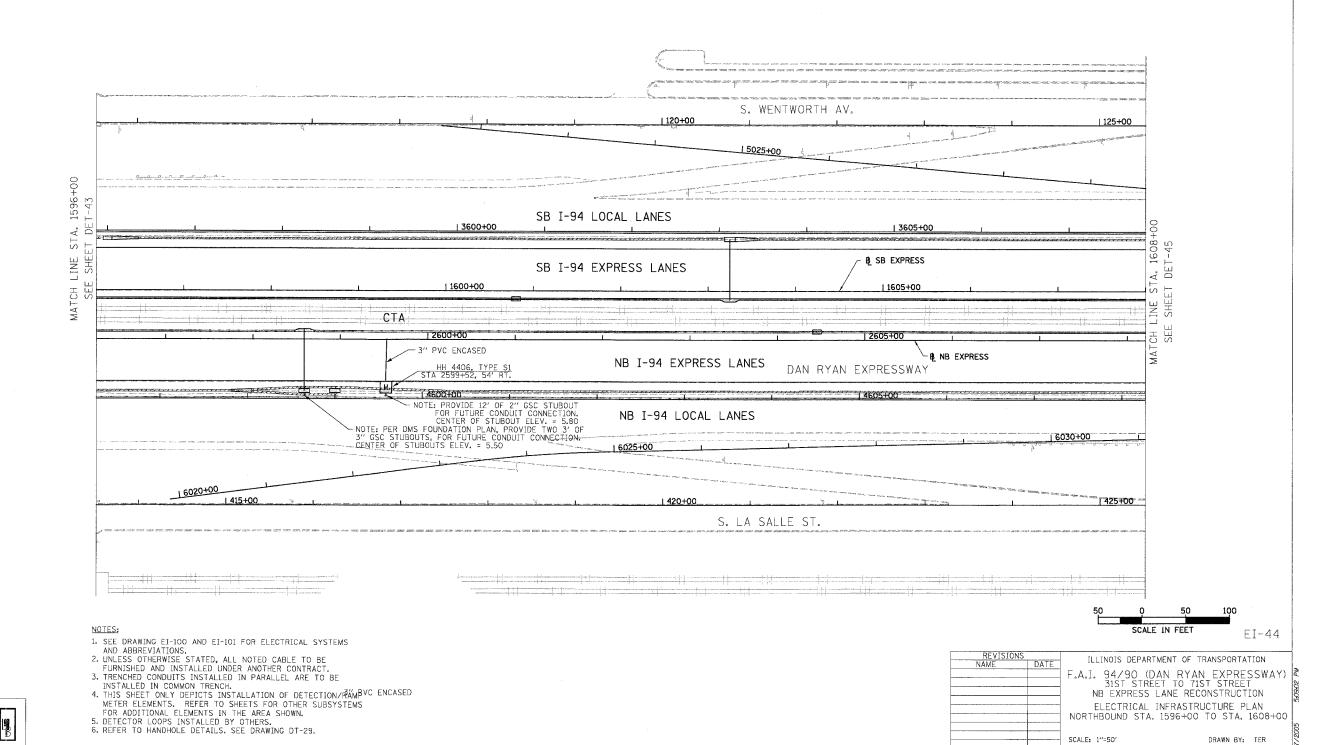

BOWMAN, BARRETT & ASSOCIATES INC.
CONSULTING ENGINEERS
Chicago, Illinois
312.228.0100
www.bbandainc.com

COUNTY TOTAL SHEE SHEETS NO. F.A.I. SECTION 94/90 * COOK 556 343 STA. 1608+00 TO STA. 1620+00 FED. ROAD DIST. NO. | ILLINOIS | FED. AID PROJECT

62300 *(1818, ETC, 2324.6-1P)R-8


SCALE: 1"=50"

DATE: 07/07/05

DRAWN BY: TER

CHECKED BY: JDC

NO PROPOSED WORK ON THIS SHEET

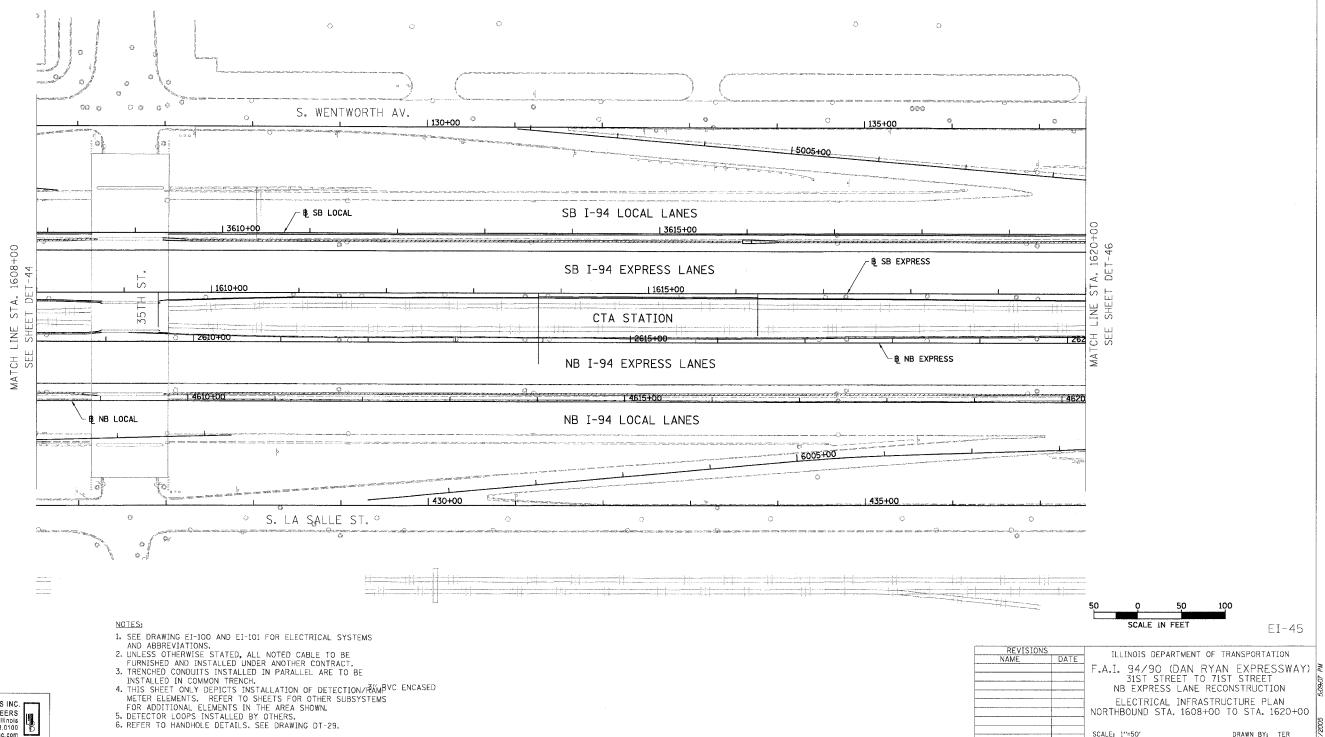

BOWMAN, BARRETT & ASSOCIATES INC.
CONSULTING ENGINEERS
Chicago, Illinois
312.228.0100
www.bbandainc.com

F.A.I. SECTION COUNTY TOTAL SHEETS NO. 94/90 * COOK 556 344 STA. 1620+00 TO STA. 1632+00 FED. ROAD DIST. NO. ILLINOIS FED. AID PROJECT 62300 *(1818, ETC, 2324.6~1P)R-8 $\rightarrow \bigcirc \rightarrow Z$ S. WENTWORTH AV. 145+00 17005+00 B SB LOCAL SB I-94 LOCAL LANES 3620+00 1 3625+00 13630+00 SB I-94 EXPRESS LANES STA. ET DE S J. 1620+00 11625+00 1630+00 END CTA -3" PVC ENCASED 2630+00 HH 4612 TYPE S1
STA. 2628+35, 54' RT.
NOTE: PROVIDE 12' OF 2" GSC STUBOUT FOR FUTURE CONDUIT CONNECTION CENTER OF STUBOUT ELEV. = -3.43 DAN RYAN EXPRESSWAY NB I-94 EXPRESS LANES NB I-94 LOCAL LANES B NB LOCAL 1440+00 S. LA SALLE ST. NOTES: EI-46 NOTES: 1

1. SEE DRAWING EI-100 AND EI-101 FOR ELECTRICAL SYSTEMS AND ABBREVIATIONS.

2. UNLESS OTHERWISE STATED, ALL NOTED CABLE TO BE FURNISHED AND INSTALLED UNDER ANOTHER CONTRACT.


3. TRENCHED CONDUITS INSTALLED IN PARALLEL ARE TO BE INSTALLED IN COMMON TRENCH.

4. THIS SHEET ONLY DEPICTS INSTALLATION OF DETECTION/RÁMBVC ENCASED METER ELEMENTS. REFER TO SHEETS FOR OTHER SUBSYSTEMS FOR ADDITIONAL ELEMENTS IN THE AREA SHOWN.


5. DETECTOR LOOPS INSTALLED BY OTHERS.

6. REFER TO HANDHOLE DETAILS. SEE DRAWING DT-29. ILLINOIS DEPARTMENT OF TRANSPORTATION F.A.I. 94/90 (DAN RYAN EXPRESSWAY) 31ST STREET TO 71ST STREET NB EXPRESS LANE RECONSTRUCTION ELECTRICAL INFRASTRUCTURE PLAN NORTHBOUND STA. 1620+00 TO STA. 1632+00 BOWMAN, BARRETT & ASSOCIATES INC.
CONSULTING ENGINEERS
Chicago, Illinois
312.228 0100
www.bbandainc.com SCALE IN FEET SCALE: 1"=50" DRAWN BY: TER DATE: 07/07/05 CHECKED BY: JDC

F.A.I. RTE.	SECTION	COUNTY	TOTAL SHEETS	SHEET NO.
94/90	*	COOK	556	345
STA.		TO STA.		
FED. RO	AD DIST, NO. ILLIN	DIS FED. AID	PROJECT	-

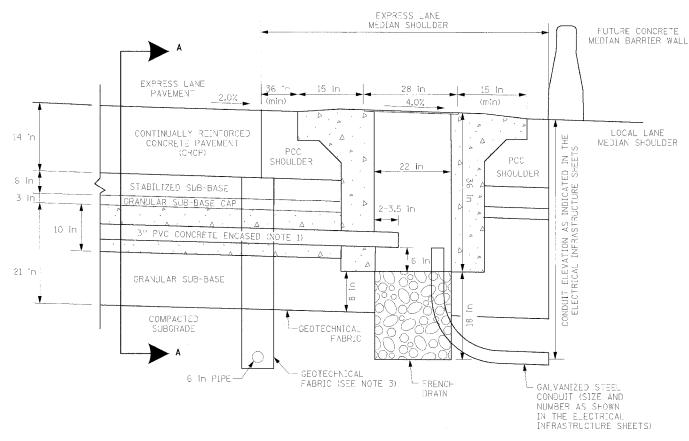

HEAVY DUTY HANDHOLE IN MAINLINE SHOULDER (TYPICAL)

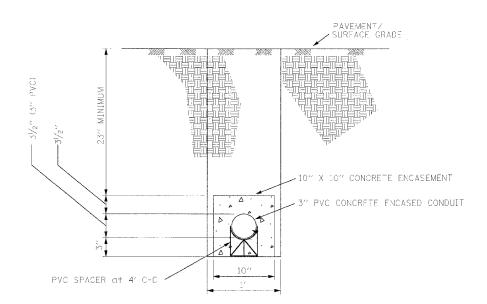

SECTION A-A

TYPICAL 3" PVC CONCRETE ENCASED CONDUIT UNDER PAVEMENT DETAIL

(FOR MICROLOOP INSTALLATION IN PROPOSED MAINLINE PAVEMENT)

NOTES

NOTES

1. 3" PVC CONCRETE ENCASED CONDUIT IS REQUIRED ONLY WHERE SHOWN ON THE PLAN DRAWINGS. WHEN INSTALLED, THE CONDUIT MUST MAINTAIN THE SAME ANGLE AS THE PAVEMENT THROUGHOUT ITS ENTIRE LENGTH,

2. FOR FANDHOIE DETAIL SEE SHEET DT-46,


3. WHEN INSTALLING CONDUIT NEAR OR THROUGH UNDERDRAIN GEOTECHNICAL FABRIC, THE CONTRACTOR SHALL MAINTAIN THE INTEGRITY AND UNIFORMITY OF THE UNDERDRAIN FABRIC THROUGH OVERLAP TO THE SATISFACTION OF THE ENGINEER.

DT-29

REVISIONS		TILINOIS DEPARTM	ENT OF TRANSPORTATION
NAME	DATE		
		F.A.I. 94/90 (DA	N RYAN EXPRESSWAY:
		31ST STREET	TO 71ST STREET
	+	NB EXPRESS LA	NE RECONSTRUCTION
		TYPICAL HANDHOLE	INSTALLATION DETAIL -
	_		INE SHOULDER
		MAINC	INE SHOOLDER
	-	SCALE: NTS	DRAWN BY: NB
		DATE: 7/7/05	CHECKED BY: CTC

Edwards


AND Kelcey

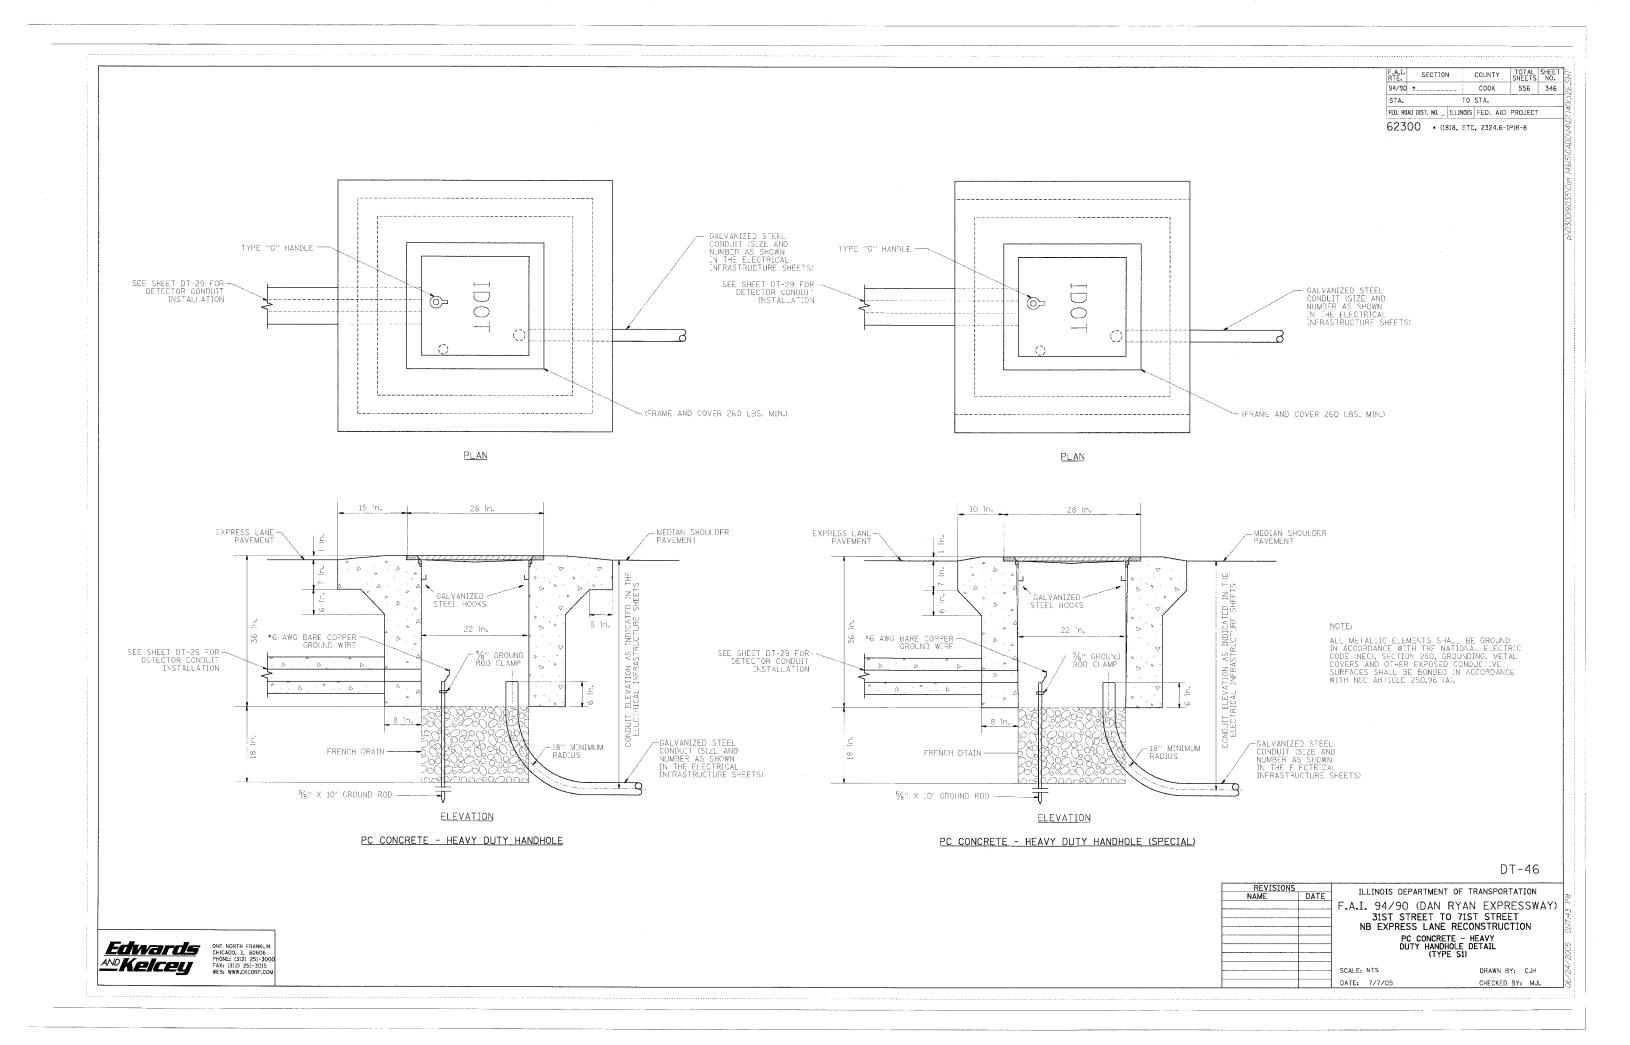ONE NORTH FRANKLIN
CHICAGO, IL 60606
PHONE: G1312 251-3000
FAX: G121


F.A.I. RTE.	SECTIO	N	COUNTY	TOTAL	SHEET NO.
94/90 🚣			COOK	556	347
STA.		ТО	STA,		
FFD. ROAD D	IST. NO.	THE TNOTS	FED. AT	PROJECT	

NOTES

- 2. CONDUIT END CAP TO BE PRESS FITTED (NO ADHESIVE), 1/6 IN. DRAINAGE HOLE TO BE DRILLED IN END CAP, HOLE TO BE POSITIONED AT ROTTOM.
- 3, CONDUIT TO EXTEND APPROXIMATELY 3 IN. INTO HANDHOLE.
- 4. FOR 3" PVC CONCRETE ENCASED IN TRENCH DETAIL, SEE SHEET DT-29. FOR HANDHOLE DETAIL, SEE SHEET DT-46.

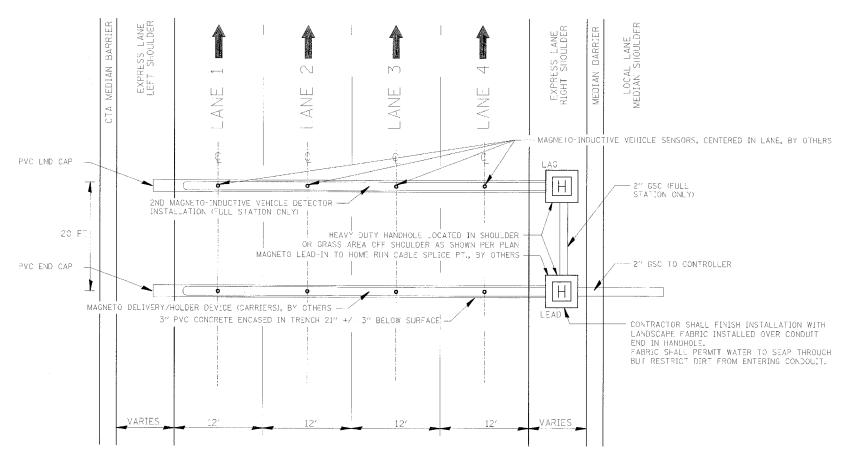

DAN RYAN TYPICAL 4 LANE CROSS SECTION WITH NON-INVASIVE MAGNETO-INDUCTIVE VEHICLE SENSOR (PROBE) INSTALLED IN ALL LANES

DT-24


REVISIONS NAME	DATE	F.A.I ,	LINOIS DEPARTMENT OF 1 . 94/90 (DAN RYAI 31ST STREET TO 71S BEXPRESS LANE RECC YPICAL MULTIPLE MAGI VEHICLE SENSOR (MICR STALLATION/SPEED ME	N EXPRESSWAY) IT STREET DINSTRUCTION NETO-INDUCTIVE DLOOP) - FULL
		SCALE:	NTS	DRAWN BY: NB
		DATE:	7/7/05	CHECKED BY: CTC

ECVATCS

ONE NORTH FRANKLIN
CHICAGO, IL 60606
PHONE: 03:12 251-3000
FAX: 03:12 251-3000
FAX: 03:12 251-3000
WBB: WWW.ECCORP.COM

| F.A.I. | SECTION | COUNTY | TOTAL SHEET | SH

62300 * (1818, ETC, 2324.6-1P)R-8

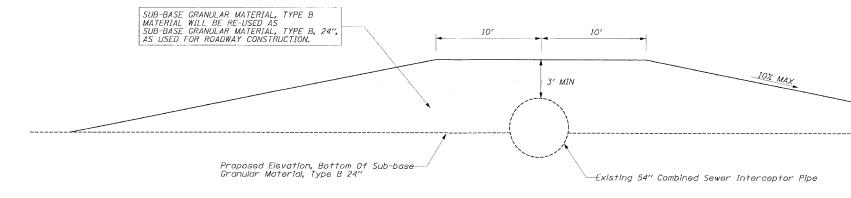

54" SEWER INTERCEPTOR (STA. 1385+44 SB, 2385+64 NB)
36" WATER MAIN (STA. 1533+28 SB, 2533+49 NB)
CONSTRUCTION PROTECTION

NOTES

1. Contractor will provide a minimum cover, as shown above at all times during construction and prior to the installation of the permanent Water Main/Sewer Protection Cap. Construction traffic shall not cross the water main/sewer pipe without protection in place.

2. CONTRACTOR IS RESPONSIBLE FOR THE INTEGRITY OF WATER MAIN/SEWER PIPE THROUGH THE DURATION OF THE PROJECT, AND WILL NOT BE PAID FOR ANY REPAIRS REQUIRED. AS DETERMINED BY THE ENGINEER, TO THE PIPE, DUE TO CONSTRUCTION ACTIVITIES.


CDT-


REVISIONS	ILLINOIS DEPARTMENT O	OF TRANSPORTATIO)N
NAME DATE			
	F.A.I. 94/90 (DAN R	YAN EXPRESS	SWAY)
	31ST STREET TO	71ST STREET	
	NB EXPRESS LANE R	ECONSTRUCTION	4
	CIVIL DE		
	CONSTRUCTION	PROTECTION	
	SCALE: NOT TO SCALE	DRAWN BY:	TAI
	DATE: 7/7/05	CHECKED BY:	DPB

Edvards


AND Kelcey


ONE. NORTH FRANKLIN
CHICAGO, IL. 60606
PHONE. (312) 251-3015
FAX: (312) 251-3015
FAX: (312) 251-3015

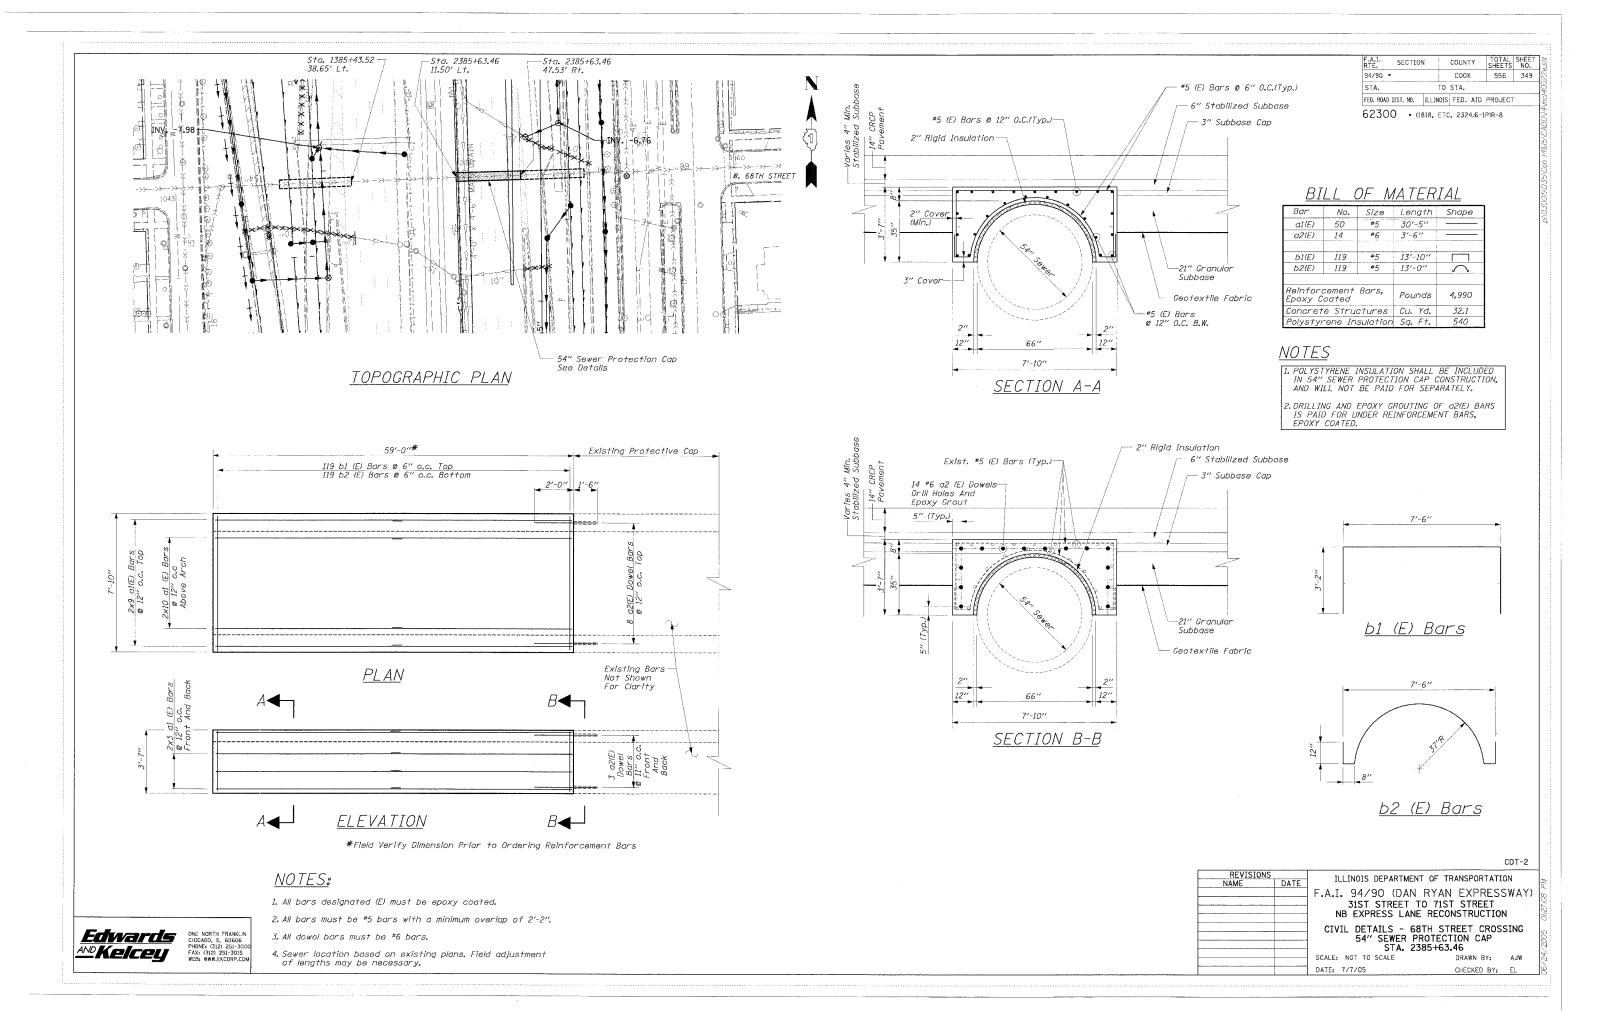

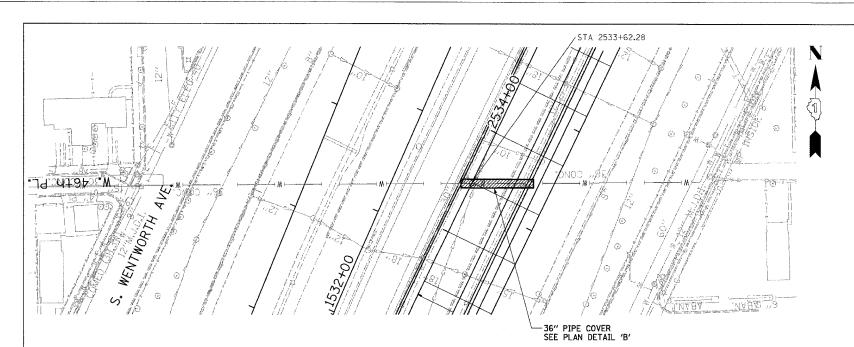

TOPOGRAPHIC PLAN

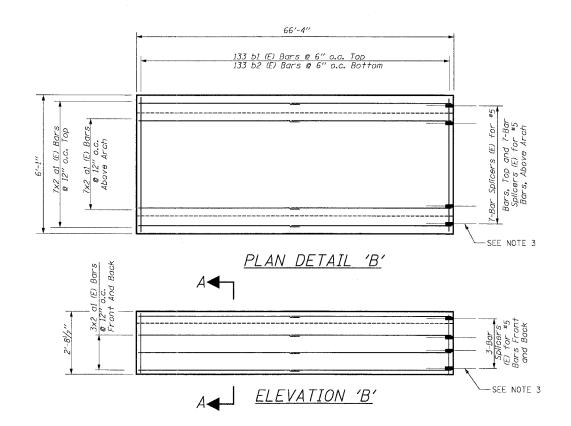

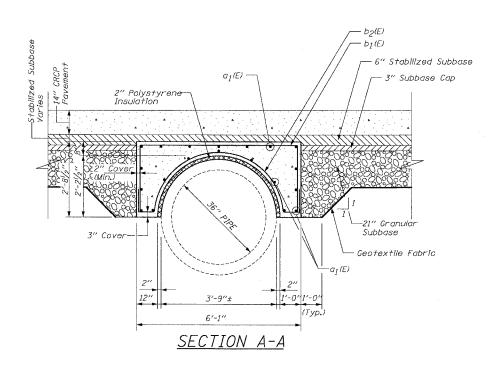


62300 *(1818, ETC, 2324.6-1P)R-8

BILL OF MATERIAL

Bar	No.	Size	Length	Shape
a1(E)	40	#5	34'-1''	
b1(E)	133	#5	10'-4"	
b2(E)	133	#5	10'-3"	\sim
Reinforcement Bars, Epoxy Coated			Pounds	4,280
Bar Splicers			Each	20
Concrete Structures			Cu. Yd.	24.4

NOTES:

- 1. THE 2" POLYSTYRENE INSULATION SHALL BE INCLUDED IN THE COST OF 36" WATER MAIN PROTECTION CAP CONSTRUCTION. THE ESTIMATED QUANTITY IS 426 SQ. FT.
- 2. ADDITIONAL GRANULAR SUB-BASE REQUIRED AS SHOWN IN SECTION A-A OR AS DIRECTED BY ENGINEER WILL BE INCLUDED IN THE COST OF SUB-BASE GRANULAR MATERIAL, TYPE B 24".
- 3. CONTRACTOR SHALL PROVIDE BAR SPLICERS AS SHOWN.
 INSTALL STAGE I PORTION AND PROVIDE STAGE II PORTION
 TO THE ENGINEER. PLUG THREADED COUPLER WITH PLASTIC
 NIPPLE OR H.S. BOLT FOR PROTECTION. COST INCLUDED
 WITH "BAR SPLICERS".

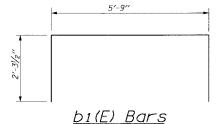

5'-9" 26|12¹R

<u>b2(E) Bars</u>

CDT-3


			CDT-3
REVISIONS		ILLINOIS DEPARTMENT OF TRANSP	ORTATION
NAME	DATE		
		F.A.I. 94/90 (DAN RYAN EX	PRESSWAY)
	+	31ST STREET TO 71ST	STREET
		NB EXPRESS LANE RECONS	TRUCTION
		CIVIL DETAILS - 46TH ST	CROSSING
		36" WATER MAIN PROTECT	
		SCALE: =NTS DRAW	N BY: EGH
		DATE: 07/07/05 CHECK	KED BY: CBB

BOWMAN, BARRETT & ASSOCIATES INC.
CONSULTING ENGINEERS
Chicago, Illinois
312.228.0100
www.bbandainc.com

NOTES:

1. All bars designated (E) must be epoxy coated.

2. All bars must be #5 bars with a minimum overlap of 2'-2".

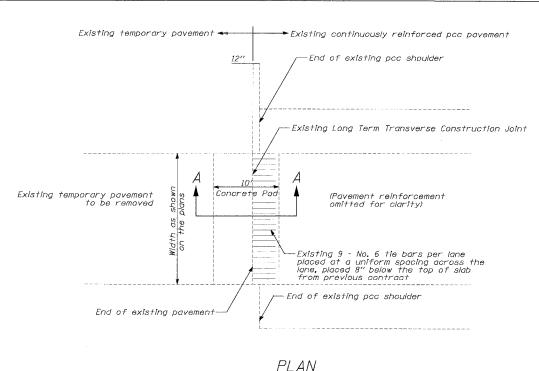

(EXISTING LONG TERM TRANSVERSE CONSTRUCTION JOINT)

Existing (tie bar with bar splicer)


Existing bar splicer (reinforcment)

Existing pavement reinforcment

Existing stablized subbase

Existing improved subgrade


Existing 7'-0" tie bar with bar splicer

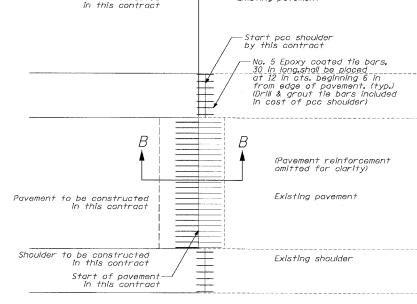


Existing pavement


Pavement to be constructed

PLAN (CONNECTION TO EXISTING LONG TERM TRANSVERSE CONSTRUCTION JOINT)

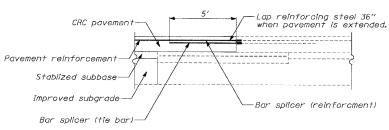

LONG TERM TRANSVERSE CONSTRUCTION JOINT SECTION B-B

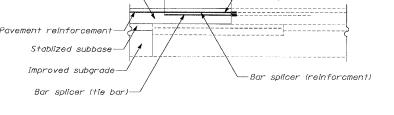


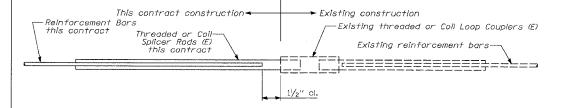

LONG TERM TRANSVERSE CONSTRUCTION JOINT

SECTION A-A

BAR SPLICER ASSEMBLY DETAIL

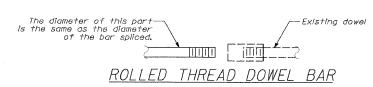

COUNTY TOTAL SHEE SHEETS NO. SECTION 94/90 * COOK 556 351 STA. TO STA. FED. ROAD DIST. NO. ILLINOIS FED. AID PROJECT

62300 • (1818, ETC, 2324.6-1P)R-8

NOTES

- 1. This detail shows connection of proposed CRC pavement to existing pavement at an existing long term transverse construction joint.
- 2. Bar splicer assemblies shall be of an IDOT approved type and shall develop in tension at least 125 percent of the yield strength of the lapped reinforcement bars.
- 3. Bar splicers shall be of the "coupler" type, and shall not have flanges.
- 4. Splicer rods shall be of minimum 60 ksi yield strength, threaded or coiled full length.
- 5. All reinforcement bars shall be lapped and tied to the splicer rods or dowel bars.
- Bar splicer assemblies shall be epoxy coated according to the requirements for reinforcement bars.
- 7. Other systems of similar design may be submitted to the Engineer for approval. Approval shall be based on certified test results from an approved testing laboratory that the proposed bar splicer assembly satisfies the following requirements:
 - A. Minimum Capacity (Tension in ksl) = $1.25 \times fy \times A(t)$
 - B. Minimum *Pull-out Strength (Tension in ksl) = 1.25 x fs (allow) x A(t)

fy = Yield strength of lapped reinforcement bars in ksi.
fs(allow) = Allowable tensile stress in lapped reinforcement bars in ksi (Service Load)
A(t) = Tensile stress area of lapped reinforcement bars (in²).
= 28 day concrete

BAR SPLICER	ASSEMBLIES	
	STRENGTH RE	EQUIREMENTS
Splicer Rod or Dowel Bar Length	Min. Capacity (kips) tension	Min. Pull-Out Strength (kips) tension
2'-0"	23.0	9.2
2'-7"	33.1	13.3
3'-5"	45.1	18.0
4'-6''	5 8. 9	23.6
5′-9′′	75.0	30.0
	Splicer Rod or Dowel Bar Length 2'-0" 2'-7" 3'-5" 4'-6"	Splicer Rod or Dowel Bar Length Min. Capacity (klps) tension 2'-0" 23.0 2'-7" 33.1 3'-5" 45.1 4'-6" 58.9

- 8. Bar splicer assemblies shall be according to Section 508 of the Standard Specifications, except as noted.
- Reinforcement shall not be paid for separately but included in the cost of CONTINUOUSLY REINFORCED PORTLAND CEMENT PAVEMENT, of the thickness specified.
- 10. Connection to long term transverse construction joint work includes the installation of the bar spiloers, payment for this work will be included in the cost of CONTINUOUSLY REINFORCED PORTLAND CEMENT CONCRETE PAYEMENT of the thickness specified. The bars to be drilled and grouted shall not be paid for separately but included in the cost of PORTLAND CEMENT CONCRETE SHOULDERS, of the thickness specified.

REVISIONS

DATE: 7/7/05

CDT-4 ILLINOIS DEPARTMENT OF TRANSPORTATION F.A.I. 94/90 (DAN RYAN EXPRESSWAY) 31ST STREET TO 71ST STREET
NB EXPRESS LANE RECONSTRUCTION CIVIL DETAILS CONNECTION TO EXISTING LONG TERM TRANSVERSE CONSTRUCTION JOINT SCALE: NONE (SHEET 1 OF 2) DRAWN BY: TAI

CHECKED BY: PJM

Edivaris

ONE NORTH FRANKLIN
CHICAGO, IL 60605


AND KEICEU


FAX: (3)22 251-305


WEB WWW.EKCORP.COM AND Kelcey


Existing temporary pavement-to be removed


Existing concrete pad-

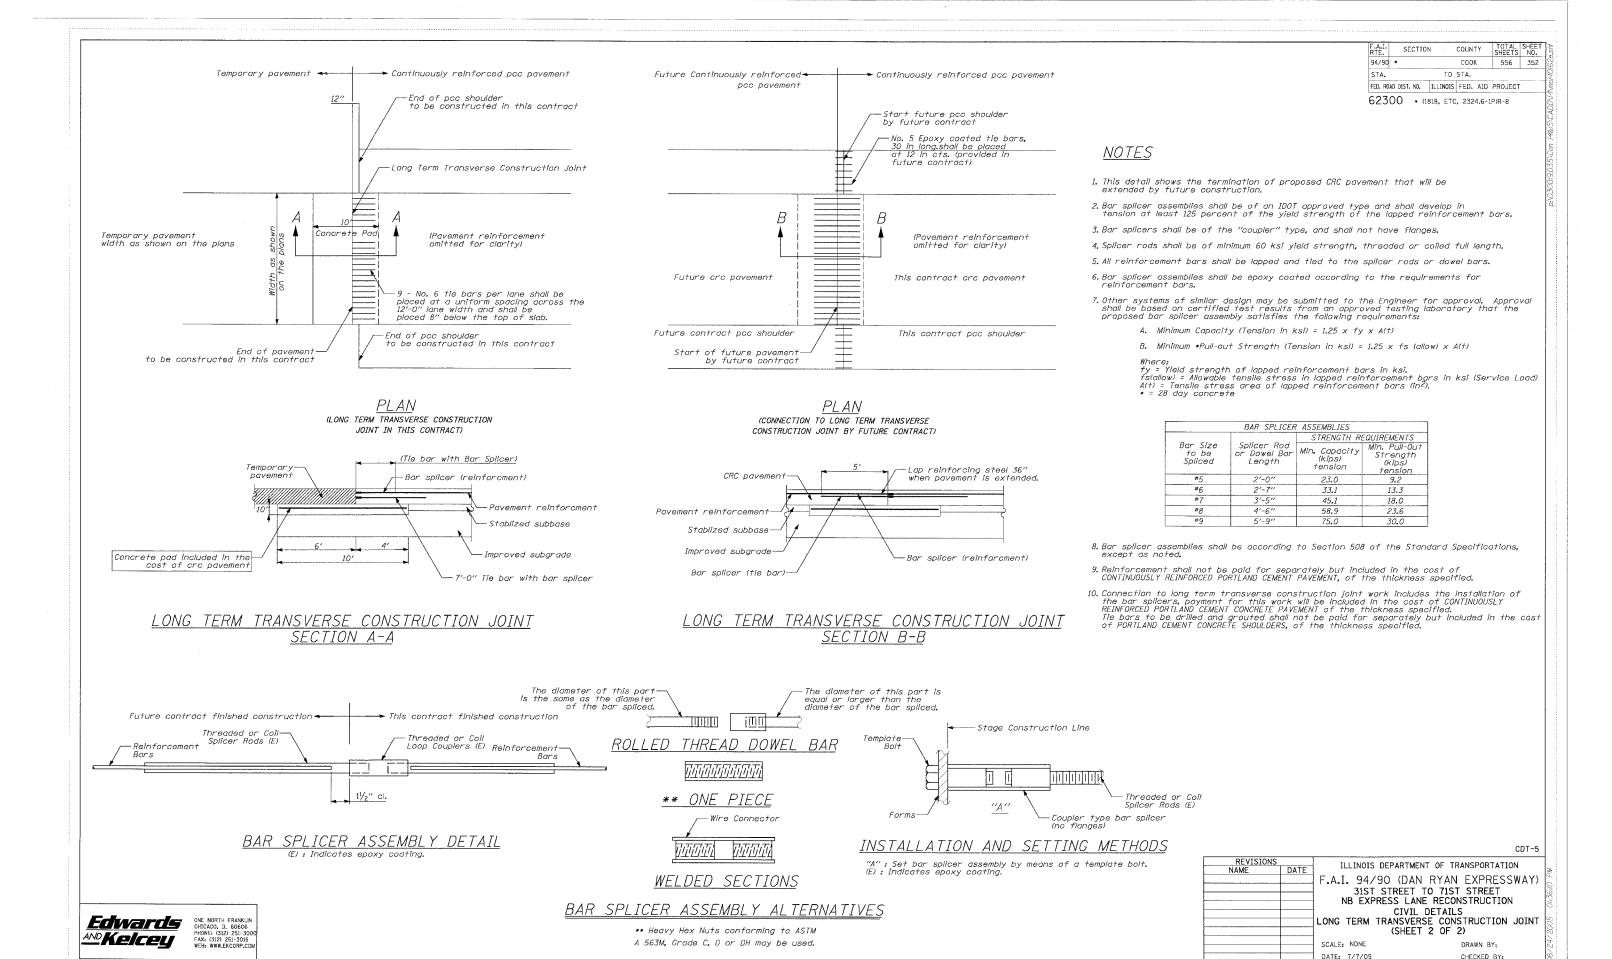


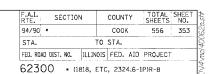

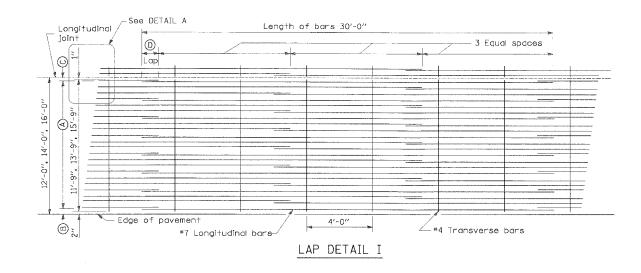

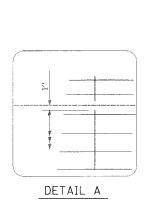

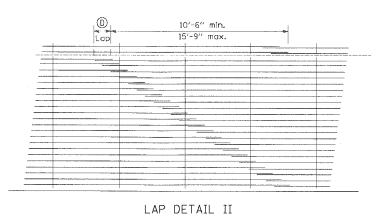

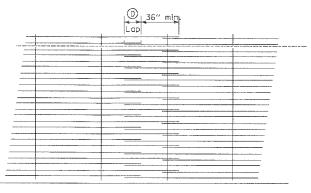

LAP DETAIL III

Pavement Width	Bar Size	Pavement Thickness	(Approx. Spacing)	B	0	0
12 feet	#7	14"	26 spaces (27 bars) @ 5 ¹ / ₄ "	31/2"	3′′	26"
14 feet	#7	14"	30 spaces (31 bars) @ 53/8"	31/2"	3''	26′′
16 feet	#7	14"	35 spaces (36 bars) @ 51/4"	31/2"	3′′	26′′

GENERAL NOTES

- 1. THE PAVEMENT REINFORCEMENT SHALL BE 4.5" FROM THE TOP OF PAVEMENT.
- 2. EXCEPT AS NOTED OR SHOWN, THE DIMENSIONS AND NOTES SPECIFIED FOR LAP DETAIL I ARE TYPICAL FOR LAP DETAIL II AND III.
- 3. THE (B) DIMENSION AND THE DISTANCE FROM THE END OF THE TRANSVERSE BAR TO THE EDGE OF PAVEMENT MAY BE INCREASED BY 1" FOR SLIP FORM PAVING.


CDT-6

REVISIONS NAME DATE	ILLINOIS DEPARTMENT	OF TRANSPORTATION
	F.A.I. 94/90 (DAN F	RYAN EXPRESSWAY)
	31ST STREET TO NB EXPRESS LANE	
	CIVIL DE EXTENDED LANE REI CONTINUOUSLY REINFO	NFORCEMENT FOR
	SCALE; NONE	DRAWN BY: TAI
	DATE: 7/7/05	CHECKED BY: DPB

Edivards

AND Keiceu


ONE NORTH FRANKLIN
CHICAGO, IL 60606
PHONE: (312) 251-3000
FAX: (312) 251-3000

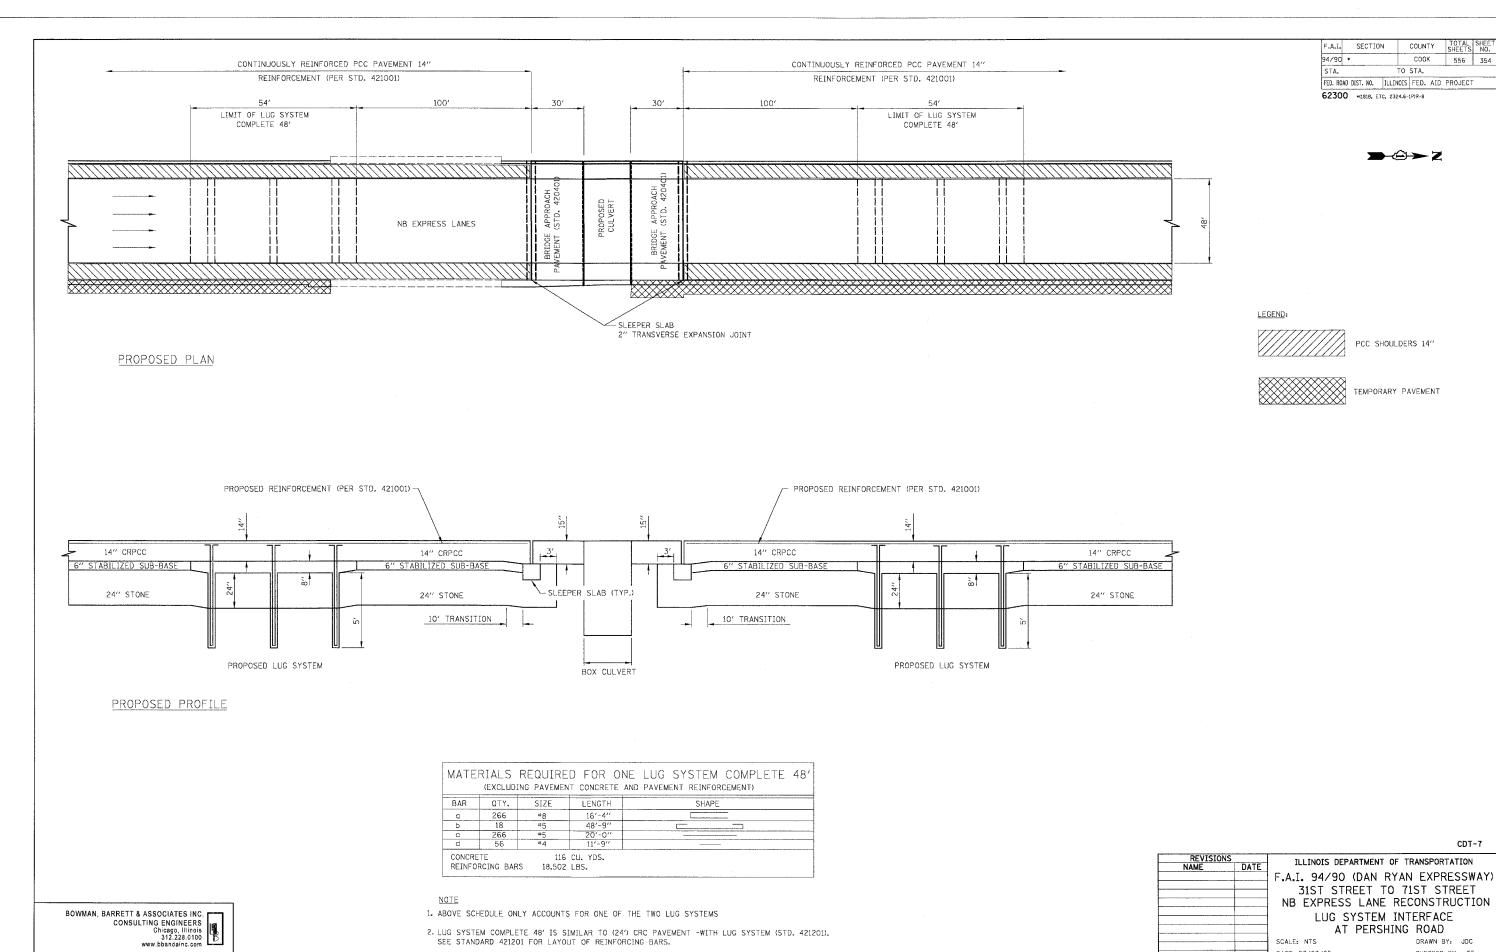


CHECKED BY: TF


DATE: 07/07/05


F.A.I. SECTION COUNTY TOTAL SHEE NO. COOK 556 355 94/90 * TO STA. FED. ROAD DIST. NO. ILLINOIS FED. AID PROJECT 62300 *(1818, ETC, 2324.6-1P)R-8 **→**②→ Z - EXISTING 2" PREFORMED EXPANSION JOINT EXISTING CRPCC PVT.*
(TOWARDS 31ST STREET AND BEYOND) EXISTING CRPCC PVT. (TOWARDS HIGH BRIDGE) NB EXPRESS LANES NB EXPRESS LANES TO FRANKLIN CONNECTOR EXISTING PLAN EXISTING PAVEMENT RELIEF **
JOINT, TYPE 5 (MODIFIED) EXISTING 4" STABILIZED SUB-BASE (BAM) EXISTING 4" BIT. OVERLAY -EXISTING 10" CRPCC EXISTING 8" CRPCC EXISTING LUG SYSTEM ** EXISTING 4" STABILIZED SUB-BASE (BAM)-EXISTING STONE 26" EXISTING 36" STONE EXISTING PROFILE CDT-8 • LUGS FROM ORIGINAL 1961 CONSTRUCTION WERE REMOVED DURING 1987 HIGH BRIDGE (31ST TO I-290) RECONSTRUCTION.
•• LUGS AND PAVEMENT RELIEF JOINTS FROM 1987 RECONSTRUCTION OF DAN RYAN HIGH BRIDGE AND APPROACH PAVEMENTS. ILLINOIS DEPARTMENT OF TRANSPORTATION F.A.I. 94/90 (DAN RYAN EXPRESSWAY) 31ST STREET TO 71ST STREET NB EXPRESS LANE RECONSTRUCTION BOWMAN, BARRETT & ASSOCIATES INC.
CONSULTING ENGINEERS
Chicago, (Illinois
312.228.0100
www.bbandainc.com LUG SYSTEM INTERFACE AT 31ST STREET SCALE: NTS DRAWN BY: RR SHEET 1 OF 2 DATE: 07/07/05 CHECKED BY: JDC

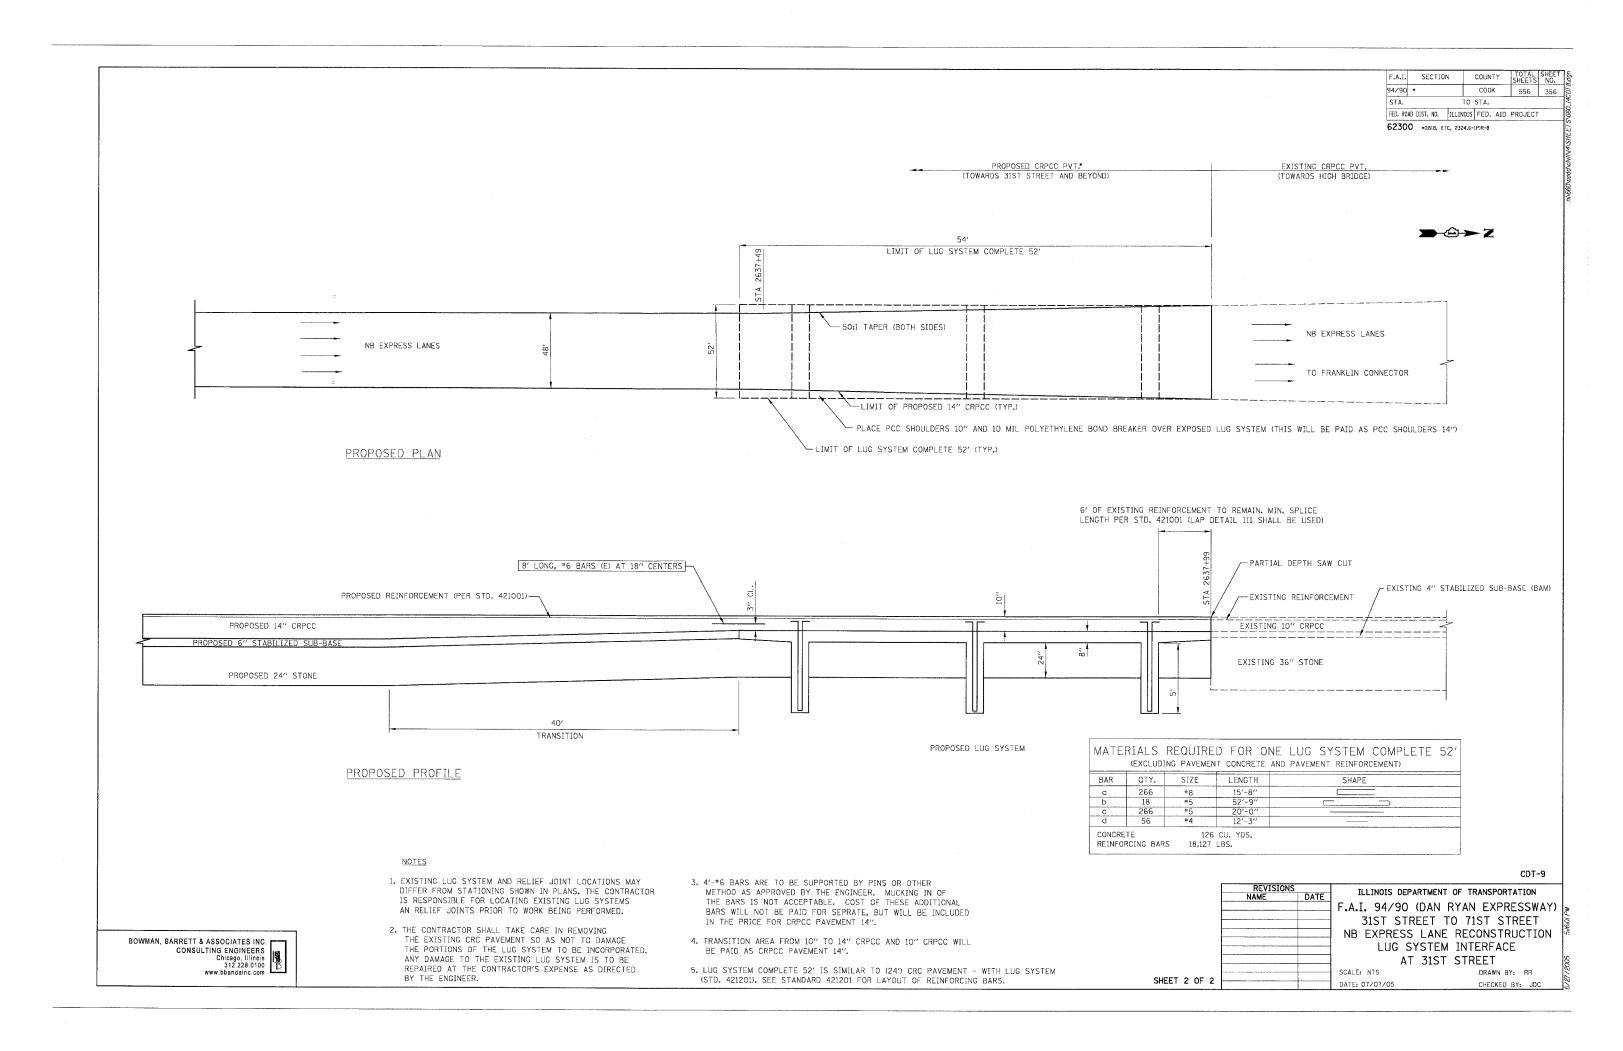

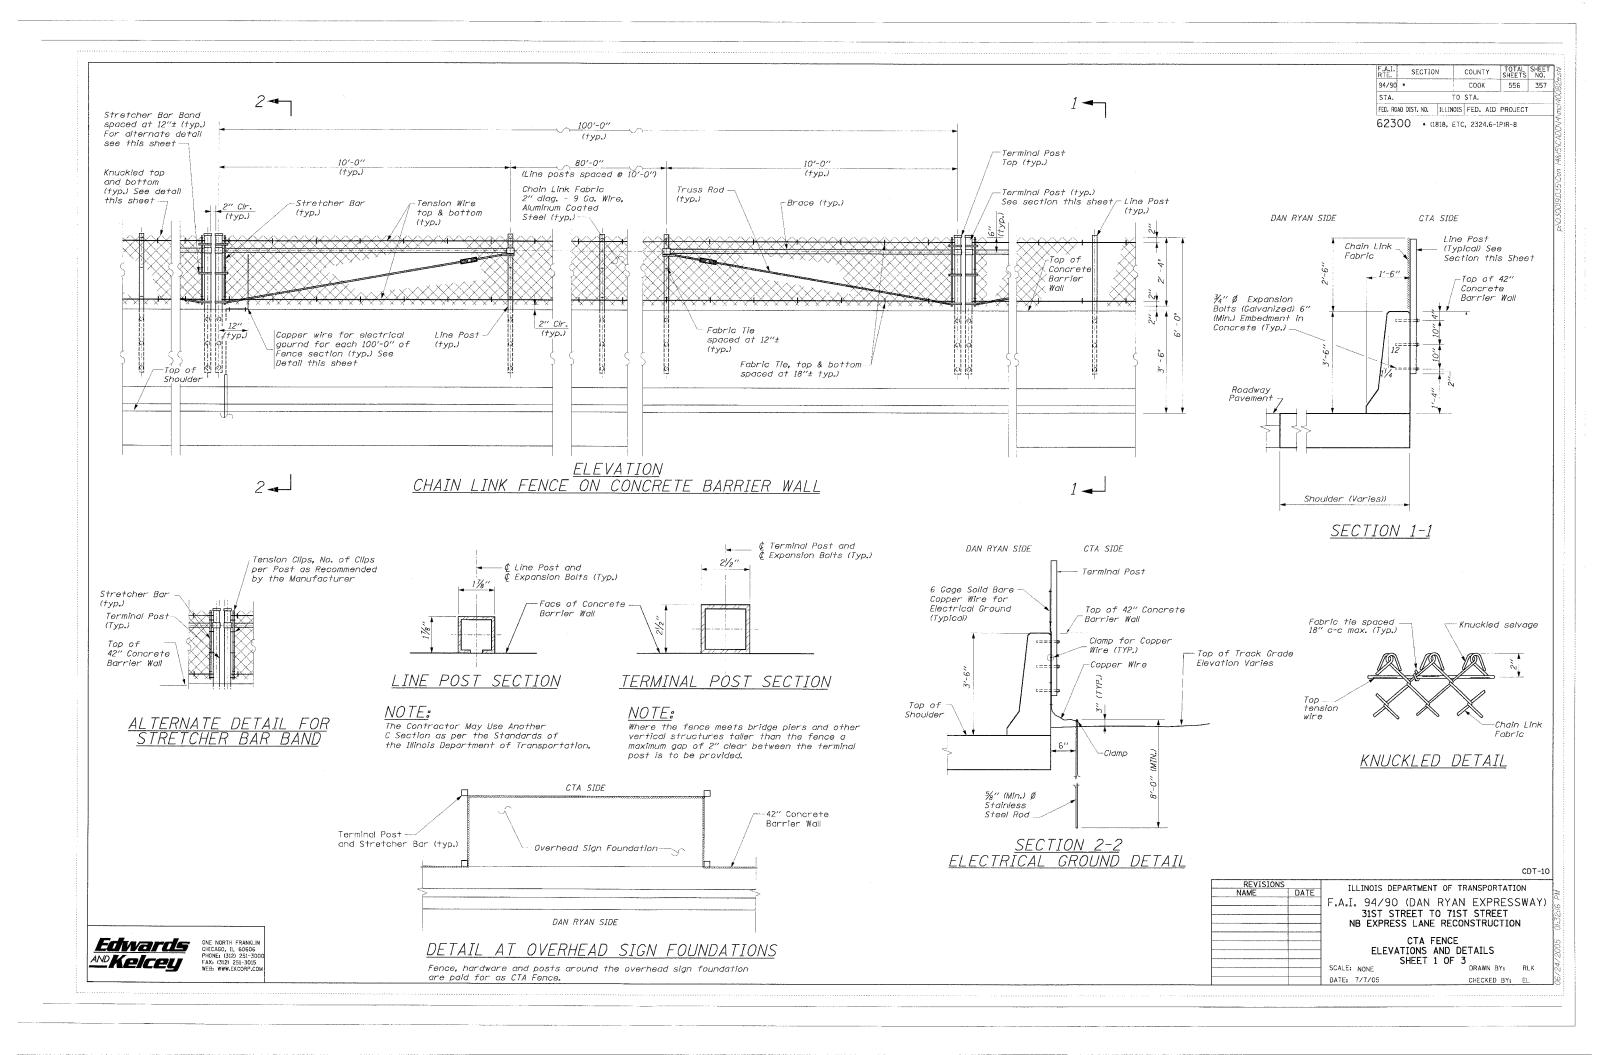





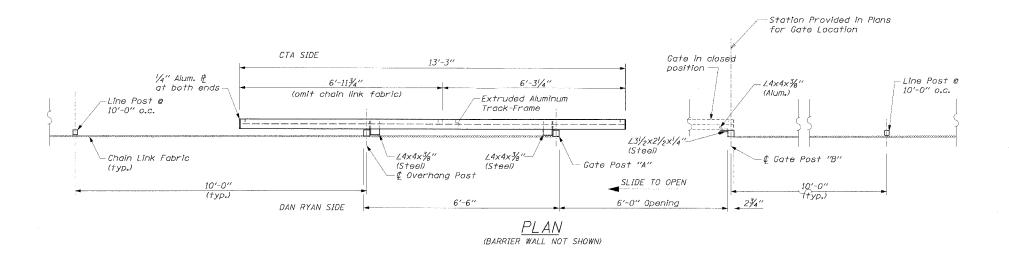

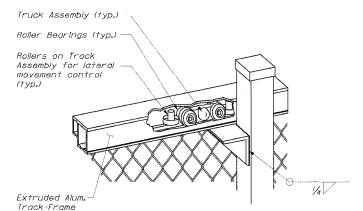

ROLLER BEARING TRUCK ASSEMBLY DETAIL

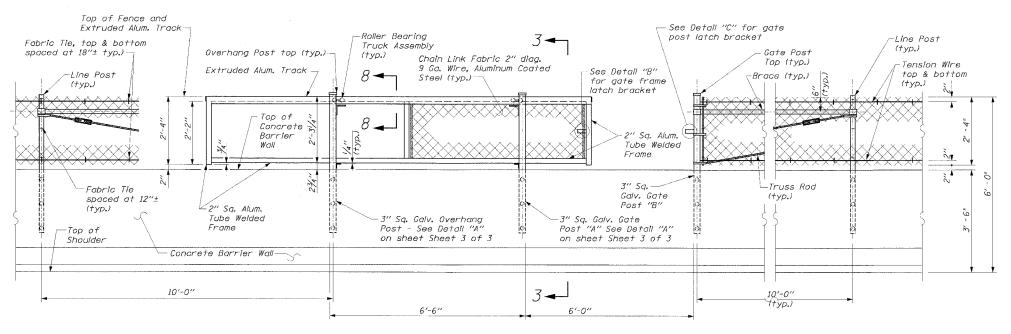

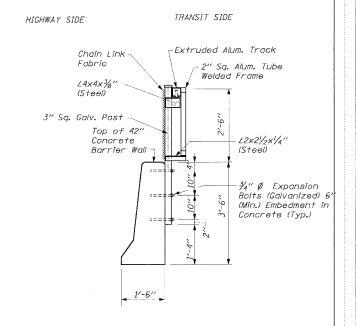

ELEVATION CHAIN LINK FENCE SLIDING GATE (FOOTING NOT SHOWN)

SECTION 3-3

NOTE: For Additional Details and Sections see Sheet 3 of 3

CDT-11

				CD 1 - 1
REVISIONS		ILLINOIS DEPARTMENT OF TRANSPO	RTATIO	N
NAME DATE				
		F.A.I. 94/90 (DAN RYAN EXP		₩AY.
		31ST STREET TO 71ST STRE	ET	
		NB EXPRESS LANE RECONSTRU	CTION	
		CTA FENCE		
		ELEVATIONS AND DETAIL	c	
		SHEET 2 OF 3	.3	
		SCALE: NONE DRAWN	BY:	RLK
		DATE: 7/7/05 CHECKE	n BV.	E1

Edivards


AND Kelcey


ONE NORTH FRANKLIN CHICAGO, IL 60606

FAX: (3)22 251-3030


FAS: (3)22 251-3030

FAS: (3)22 251-3030

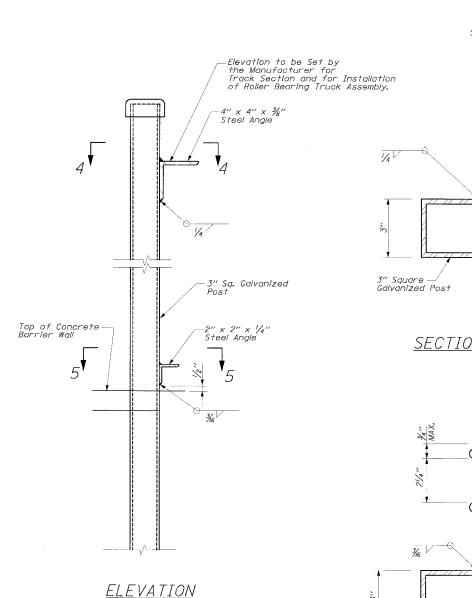

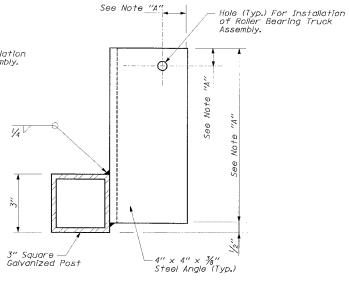

SECTION 4-4

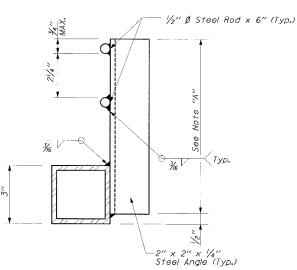



SECTION 5-5

DETAIL A

For Overhang Post - As Shown For Gate Post "A" - Opposite Hand

NOTE:
"A": The Manufacturer of the Sliding
Gate Shall Determine the Length of Angles
and Location of Hole for Installation of Roller
Bearing Truck Assembly.

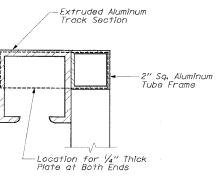


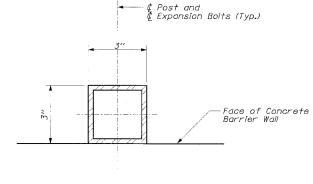


COUNTY TOTAL SHEETS NO. SECTION COOK 556 359 TO STA. STA. FED. ROAD DIST. NO. ILLINOIS FED. AID PROJECT

62300 • (1818, ETC, 2324.6-1P)R-8

GATE AND OVERHANG POST SECTION

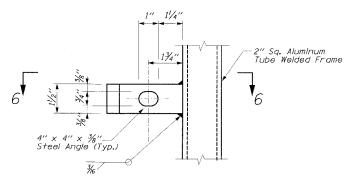




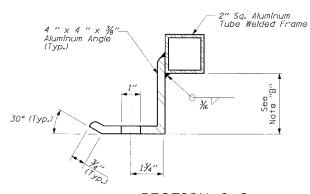


DETAIL B

NOTE:

"B": The Manufacturer of the Silding Gate Shall Set the Angle Based on the Size of the Track Frame

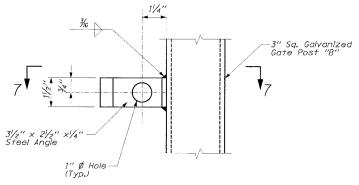

ELEVATION

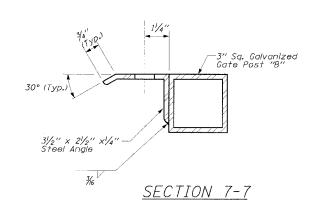

DETAIL C

CDT-12

ILLINOIS DEPARTMENT O	REVISIONS		
TELINOIS DELAKTIMENT O	DATE	NAME	
F.A.I. 94/90 (DAN R)			
31ST STREET TO			
NB EXPRESS LANE RI			
CTA FEI			
ELEVATIONS AN			
SHEET 3	-		
SCALE: NONE			

OF TRANSPORTATION YAN EXPRESSWAY) 71ST STREET
RECONSTRUCTION

ND DETAILS OF 3 DRAWN BY: RLK DATE: 7/7/05 CHECKED BY: EL

Edivaris

ONE NORTH FRANKLIN
CHICAGO, IL 60606

AND KEICEU

FAX: G312: 251-300

FAX: WWLEKCORP.COM


GENERAL NOTE:

The Slide Gates Shall be of the Cantilevered Type with NO Track


or Support Across the Opening.

SECTION 8-8


SECTION 6-6

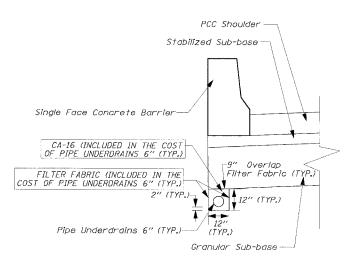


PIPE UNDERDRAINS 6" UNDER SINGLE FACE BARRIER WALL

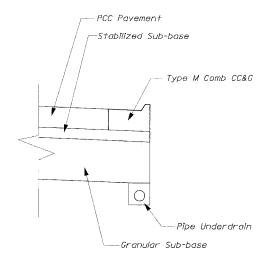


<u>PIPE UNDERDRAINS 6" - UNDER TYPE M</u> COMBINATION CONCRETE CURB & GUTTER

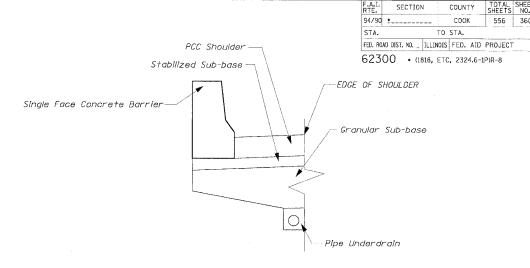

PIPE UNDERDRAINS 6" UNDER SHOULDER ADJACENT TO CTA

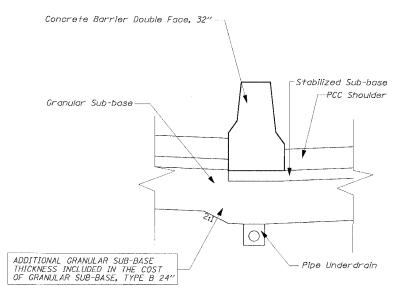


PIPE UNDERDRAINS 6" UNDER DOUBLE FACE BARRIER WALL

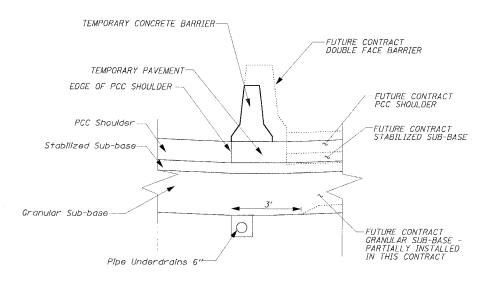

-- INDICATES FUTURE CONTRACT CONSTRUCTION

PIPE UNDERDRAINS 6" UNDER TEMPORARY CONCRETE BARRIER WALL SCENARIO A - FUTURE LOCAL LANES HIGHER THAN EXPRESS LANES

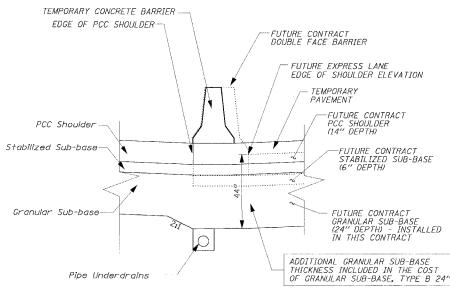

.....INDICATES FUTURE CONTRACT CONSTRUCTION

PIPE UNDERDRAINS 6" UNDER TEMPORARY CONCRETE BARRIER WALL SCENARIO B - FUTURE LOCAL LANES LOWER THAN EXPRESS LANES

Edwards


ONE NORTH FRANKLIN
CHICAGO, IL 60606

AND KEICEU

FAX: (312) 251-3015

FAX: (312) 251-3015

CDT-13 ILLINOIS DEPARTMENT OF TRANSPORTATION F.A.I. 94/90 (DAN RYAN EXPRESSWAY) 31ST STREET TO 71ST STREET
NB EXPRESS LANE RECONSTRUCTION CIVIL DETAILS PIPE UNDERDRAINS 6" SCALE: NONE DRAWN BY: TAI DATE: 7/7/05 CHECKED BY: PJM

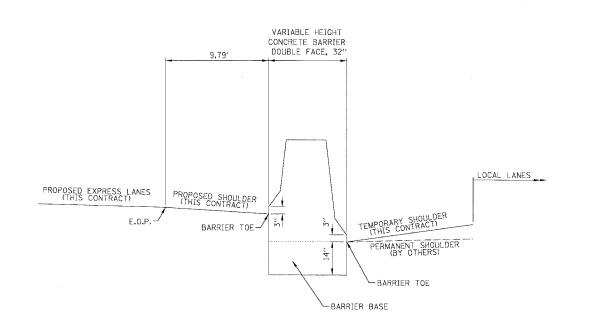

CONCRETE BARRIER DOUBLE FACE

EXPRESS LANE STATION	E.O.P. ELEV. OUTSIDE EXPRESS LANES	TOE OF BARRIER ELEV. ALONG EXPRESS LANES	TOE OF BARRIER ELEV. ALONG LOCAL LANES
2530+00	-4.83	-5.41	-4.54
2530+50	-4.32	-4.90	-3.93
2531+00	-3.81	-4.39	-3.17
2531+50	-3.30	-3.88	-2.31
2532+00	-2.42	-2.89	-1.65
2532+50	-1.46	-1,85	-0.96
2533+00	-0.49	-0.88	-0.19
2533+50	0.48	0.09	0.59
2534+00	1.45	1.06	1.35
2534+50	2.42	2.03	2.15
2535+00	3,39	3.00	2.93
2535+50	4.36	3.98	3.69
2536+00	5.33	5.08	4.38
2536+50	6.07	5.88	5,11
2537+00	6.57	6.37	5.77
2537+50	7.08	6.88	6.48
2538+00	7,59	7.39	7.17
2538+50	8.10	7.90	7.78
2539+00	8.61	8.41	8.29
2539+50	9.12	8,92	8,72
2540+00	9,62	9,42	9.05
2540+50	10.05	9,85	9.31
2541+00	10.41	10.21	9,46
2541+50	10.55	10.32	9.52
2542+00	10.49	10.18	9.64
2542+50	10.35	9.97	9.84
2543+00	10.15	9.75	9.77

F.A.I.	SECTIO	N.	COUNTY	TOTAL SHEETS	SHEET NO.
34/90	*		COOK	556	361
STA.		то	STA.		
FED. ROA	D DIST. NO.	ILLINOIS	FED. AID	PROJECT	-

	VARIES	OVERHEAD SIGN FOUNDATION	4	
PROPOSED EXPRESS LANES (THIS CONTRACT)	PROPOSED SHOULDER (THIS CONTRACT) FOUNDATION TOE	3"	TEMPORARY SHOULDER (THIS CONTRACT) PERMANENT SHOULDER (BY OTHERS) FOUNDATION TOE	LOCAL LANES

DOUBLE FACE OVERHEAD SIGN FOUNDATION

BOWMAN, BARRETT & ASSOCIATES INC.
CONSULTING ENGINEERS
Chicago, Illinois
312,228,0100
www.bbandainc.com


EXPRESS LANE	E.O.P. ELEV.	TOE OF FOUNDATION ELEV.	TOE OF FOUNDATION ELEV.	LOCAL LANE
STATION	OUTSIDE EXPRESS LANES	ALONG EXPRESS LANES	ALONG LOCAL LANES	STATION
2536+25,78	5.82	5.64	4.72	4535+94.62
2536+36,53	5.93	5.75	4.93	810+07.19
819+24.43	8.22	7.68	8.38	4545+30
819+34.43	8.16	7.62	8.26	4545+40
2570+88.71	-0.69	-1.05	-2.07	4570+95
2570+98.71	-0.53	-0.89	-1.90	4571+05
2598+52.69	11.71	11.36	10.77	4598+59
2598+64.69	11.63	11.28	10.69	4598+71
2598+87.69	11.48	11.13	10.53	4598+94
2598+99.69	11.40	11.05	10.45	4599+06

			02, 11
REVISIONS		ILLINOIS DEPARTMENT OF TRANSF	PORTATION
NAME	DATE		
		F.A.I. 94/90 (DAN RYAN EX	PRESSWAY)
		31ST STREET TO 71ST	STREET
		NB EXPRESS LANE RECONS	T I
		DOUBLE FACE BARR	IER
		ELEVATIONS	ķ
		SCALE: NTS DRAW	N BY: JDC

DATE: 07/07/05


CDT-14

CHECKED BY: RS

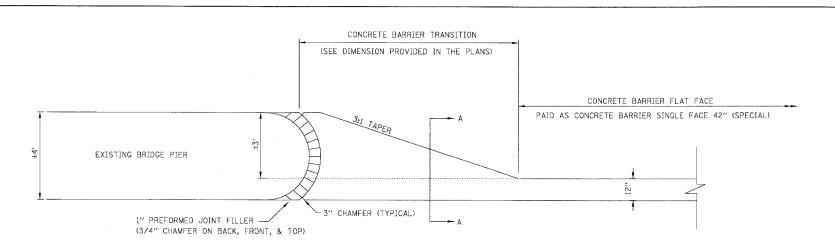

CONCRETE BARRIER FLAT FACE

STA. 2575+72.07 TO STA. 2576+21.44 STA. 2576+40.50 TO STA. 2576+78.37

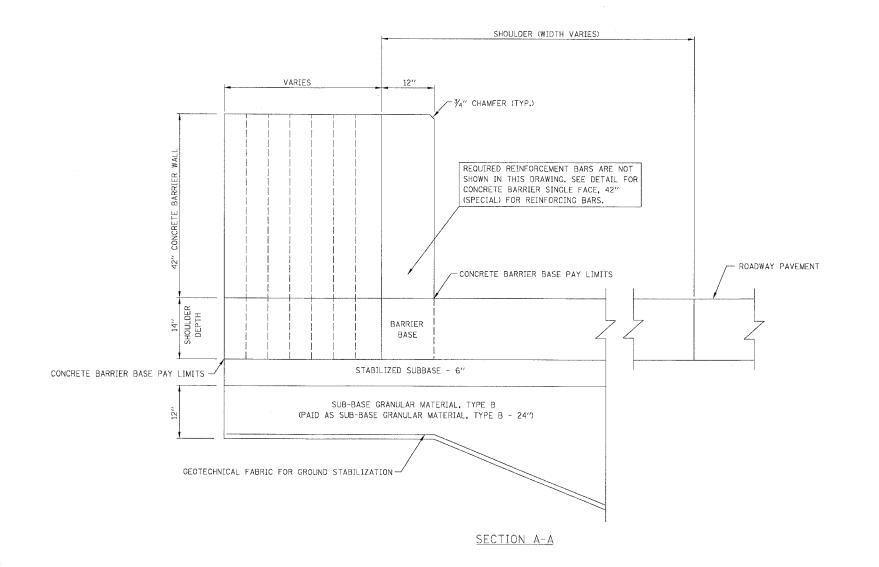

REVISIONS
NAME DATE
F.A.I. 94/90 (DAN RYAN EXPRESSWAY)
31ST STREET TO 71ST STREET
NB EXPRESS LANE RECONSTRUCTION
CONCRETE BARRIER FLAT FACE
SCALE: NTS DRAWN BY: JDC

CHECKED BY: RS

DATE: 07/07/05

F.A.I. SECTION

94/90 *

STA.

COUNTY TOTAL SHEE SHEETS NO.


TO STA.


FED. ROAD DIST. NO. ILLINOIS FED. AID PROJECT

62300 +(1818, ETC, 2324.6-1P)R-8

COOK 556 362

BOWMAN, BARRETT & ASSOCIATES INC.
CONSULTING ENGINEERS
Chicago, Illinois
312.22.8.0100
www.bbandainc.com

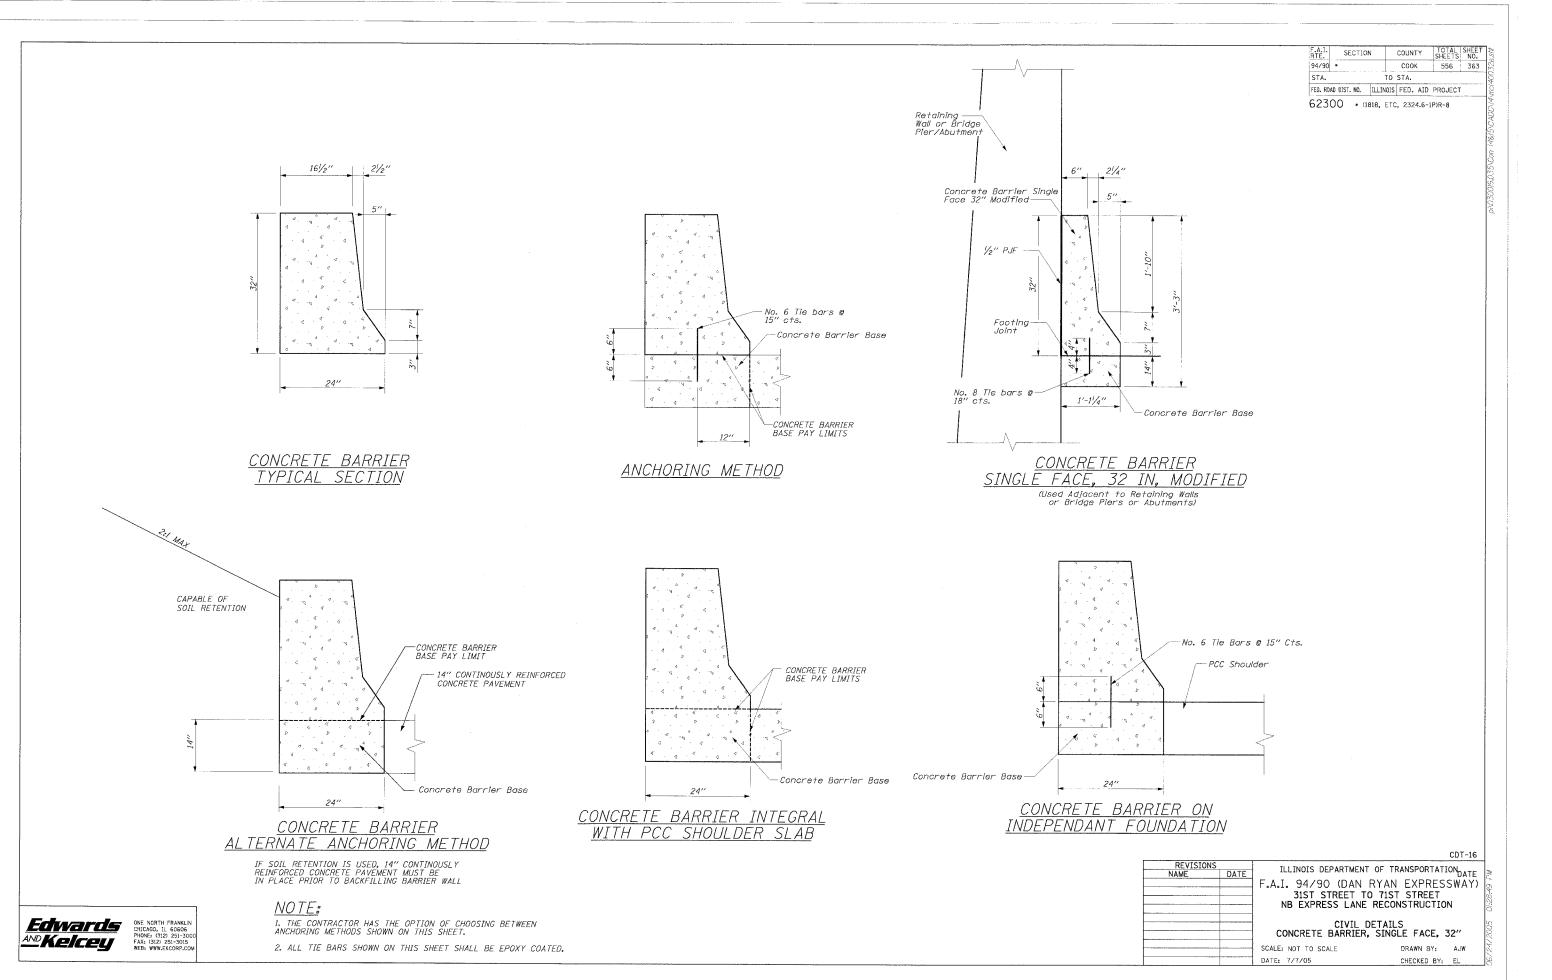

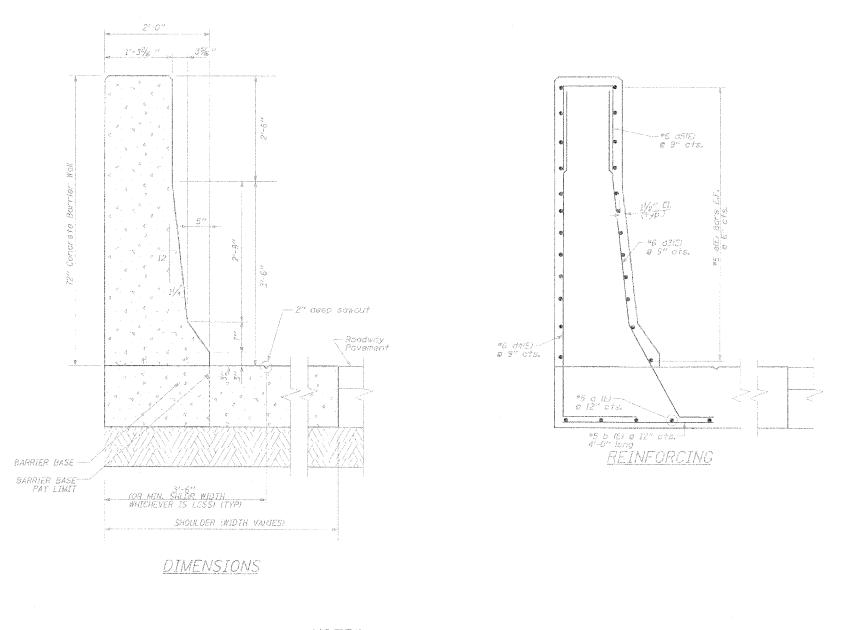

3" 1-3" a 3'-0"

<u>Bar d3(E)</u>

2'-0"

Bar d4(E)

F.A.I. RTE. 94/90 * COUNTY TOTAL SHEETS SECTION COOK STA. TO STA. FED. ROAD DIST. NO. ILLINOIS FED. AID PROJECT

62300 * (1818, ETC, 2324.6-1P)R-8

Bar d5(E)

Ly__12''

MIN LAP; *5 Bars - 2'-2" *6 Bars - 2'-7"

*Lap varies as necessary

CDT-17

ILLINOIS DEPARTMENT OF TRANSPORTATION F.A.I. 94/90 (DAN RYAN EXPRESSWAY)
31ST STREET TO 71ST STREET
NB EXPRESS LANE RECONSTRUCTION CONCRETE BARRIER SINGLE FACE, 72" (SPECIAL)

SCALE: NOT TO SCALE

DRAWN BY: AJW DATE: 7/7/05 CHECKED BY: EL

NOTES:


- 1. All reinforcing bars, i'e bars and dowel bars shall be seated in the find position prior to the concrete operations. The cost of these items is included in the cost of the barrier walk. Bars cannot be mucked into picce.
- 2. Maintain siope of face as shown on datalis.





AND KEICEU


ONE NORTH FRANKLIN CHICAGO, IL 60606
PHONE: (312) 251-3000
FAX: (312) 251-3000
WB: WWW.EXCORP.COM


STATE OF ILLINOIS DEPARTMENT OF TRANSPORTATION

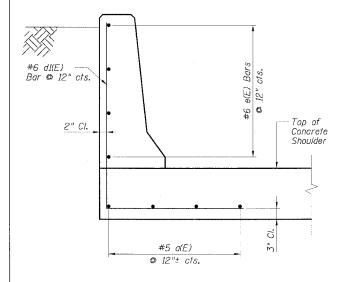


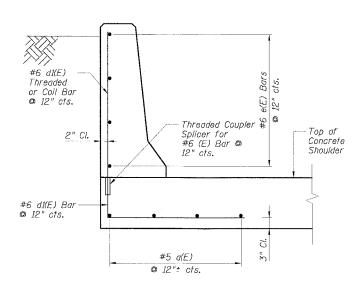

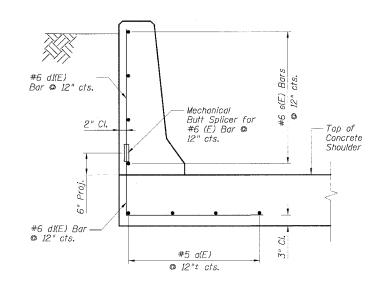


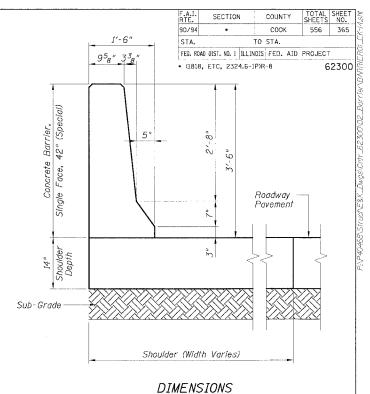

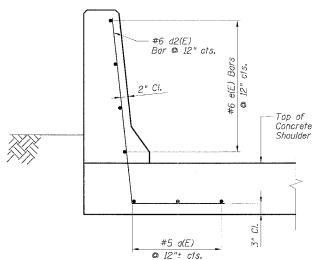

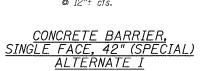


CONCRETE BARRIER, SINGLE FACE, 42" (SPECIAL) ALTERNATE II

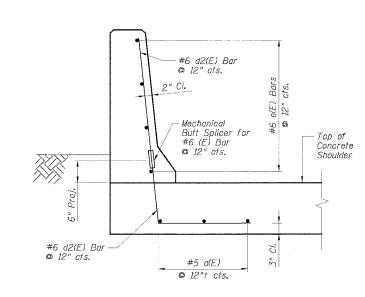


CONCRETE BARRIER, SINGLE FACE, 42" (SPECIAL) ALTERNATE III

NOTES:

- The cost of furnishing and placing reinforcing in concrete shoulders and barriers shall be included in the cost per foot for "Concrete Barrier, Single Face, 42" (Special).
- 2. Mechanical butt splicers shall be capable of developing a minimum of 125% of the yield strength of a #6 bar.

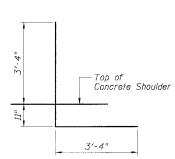

BAR d1(E)

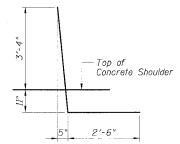

BAR d2(E)

REVISIONS	TI	ILLINOIS DEPARTMENT OF TRANSPOR				
NAME		A.I. 90/94 (DAN R				
		CONCRETE B	ARRIER			
		SINGLE FACE, 42	" (SPECIAL)			
		ALTERNA	TES			
	SCALE:	None	DRAWN BY:			
	DATE:	JULY 7, 2005	CHECKED BY:			

NOTES:

 The cost of furnishing and placing reinforcing in concrete shoulders and barriers shall be included in the cost per foot for "Concrete Barrier, Single Face, 42" (Special).

NOTES:


- 1. The cost of furnishing and placing reinforcing and threaded coupler splicer in concrete shoulders and barriers shall be included in the cost per foot for "Concrete Barrier, Single Face, 42" (Special).
- 2. Threaded coupler splicers shall be capable of developing a minimum of 125% of the yield strength of a #6 bar.

CTE AECOM


End Wickor Drive, Sultro 600, Choopy, Illinois 60801-5278
(2338-300 F 312-308.110) www.cfs.orgoni.com

COUNTY TOTAL SHEETS NO. SECTION соок 94/90 * 556 366 STA. TO STA. FED. ROAD DIST. NO. ILLINOIS FED. AID PROJECT


62300 * (1818, ETC, 2324.6-1P)R-8

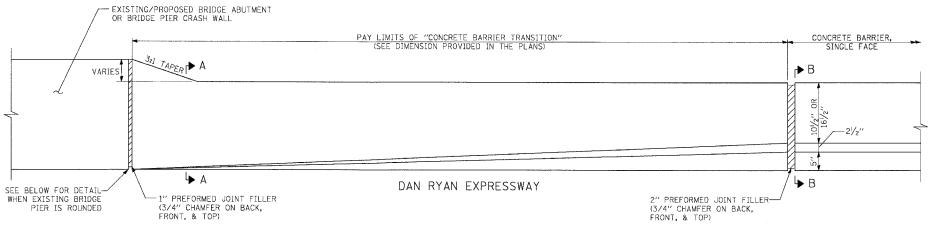


DETAIL OF "CONCRETE BARRIER TRANSITION" FOR SINGLE FACE BARRIER WALL

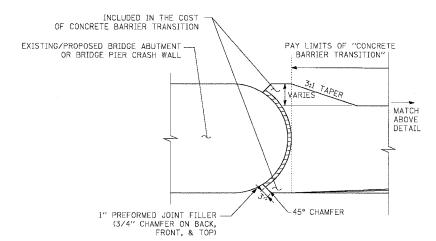

DETAIL OF "CONCRETE BARRIER TRANSITION" AT EXISTING ROUNDED PIER

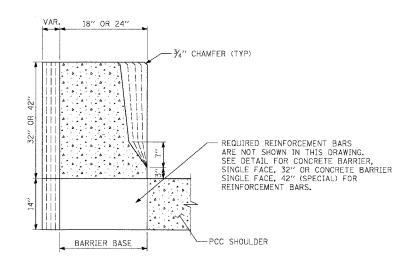

SECTION A-A CONCRETE BARRIER TRANSITION

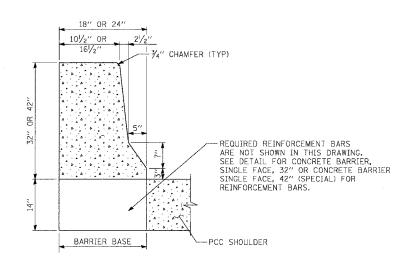

SECTION B-B CONCRETE BARRIER, SINGLE FACE & CONCRETE BARRIER BASE

NOTE: ALL TRANSITIONS PAID FOR AS CONCRETE BARRIER TRANSITION


CDT-19

REVISIONS	ILLINOIS DEPARTMEN	T OF TRANSPORTATION
NAME DA	F.A.I. 94/90 (DAN 31ST STREET T	RYAN EXPRESSWAY) O 71ST STREET RECONSTRUCTION
		RIER TRANSITION 1 OF 3)
	SCALE: NONE	DRAWN BY: TAI
'	DATE: 7/7/05	CHECKED BY: PJM


AND KEICEU


ONE NORTH FRANKLIN CHICAGO, IL 66666
FAX: (312) 251-3015
FAX: (312) 251-315

F.A.I. SECTION COUNTY TOTAL SHEE NO. COOK 556 367 94/90 * STA. FED. ROAD DIST, NO. | ILLINOIS | FED. AID PROJECT 62300 * (1818, ETC, 2324.6-1P)R-8

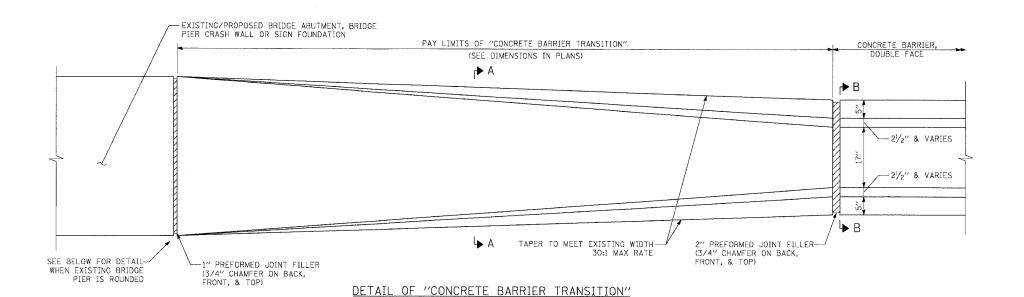

FOR DOUBLE FACE BARRIER WALL

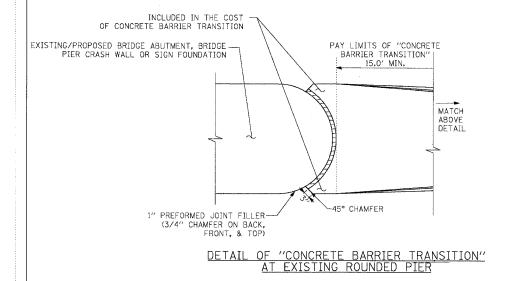

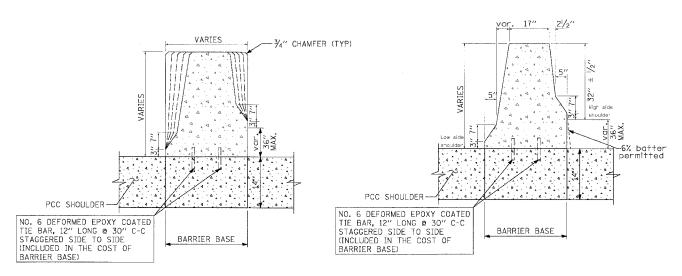

SECTION A-A CONCRETE BARRIER TRANSITION

SECTION B-B DOUBLE FACE BARRIER WALL NOTE: ALL TRANSITIONS PAID FOR AS CONCRETE BARRIER TRANSITION

AND KEICEU

ONE NORTH FRANKLIN CHICAGO, II. 60606

AND KEICEU

ONE NORTH FRANKLIN CHICAGO, II. 60606

FAX: (3)2 25-1-3015

WEB: WWW.EKCRP.COM


CDT-20 ILLINOIS DEPARTMENT OF TRANSPORTATION F.A.I. 94/90 (DAN RYAN EXPRESSWAY) 31ST STREET TO 71ST STREET NB EXPRESS LANE RECONSTRUCTION CONCRETE BARRIER TRANSITION (SHEET 2 OF 3) DRAWN BY: TAI

SCALE: NONE DATE: 7/7/05

CHECKED BY: PJM


COUNTY TOTAL SHEE SHEETS NO. F.A.I. SECTION COOK 94/90 * 556 368 STA. FED. ROAD DIST, NO. ILLINOIS FED. AID PROJECT

62300 • (1818, ETC, 2324.6-1P)R-8

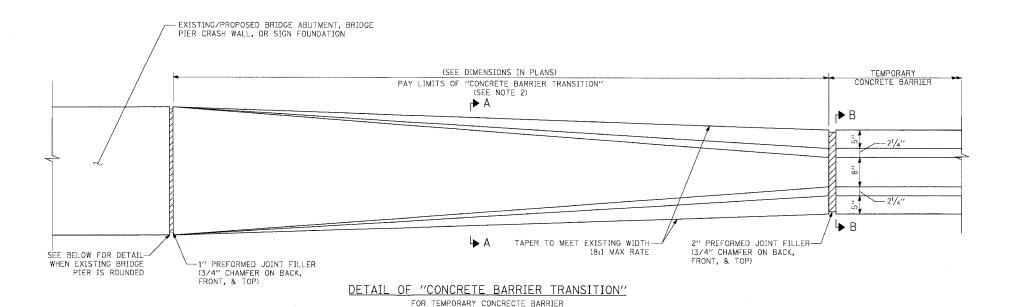

INCLUDED IN THE COST OF CONCRETE BARRIER TRANSITION PAY LIMITS OF "CONCRETE BARRIER TRANSITION" EXISTING/PROPOSED BRIDGE ABUTMENT, BRIDGE — PIER CRASH WALL, OR SIGN FOUNDATION MATCH ABOVE DETAIL 1" PREFORMED JOINT FILLER— (3/4" CHAMFER ON BACK, FRONT, & TOP) -45° CHAMEER

DETAIL OF "CONCRETE BARRIER TRANSITION" AT EXISTING ROUNDED PIER

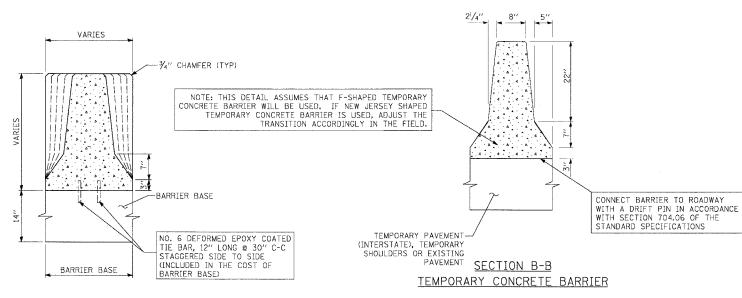

SECTION A-A CONCRETE BARRIER TRANSITION

NOTE:
1. ALL TRANSITIONS PAID FOR AS CONCRETE BARRIER TRANSITION.

2. LENGTHS PROVIDED IN THE PLANS ARE APPROXIMATE. THE CONTRACTOR MUST ADJUST THE LENGTH OF CONCRETE BARRIER TRANSITION AS NECESSARY TO MEET TEMPORARY CONCRETE BARRIER SEGMENTS USED.

			CD1-21		
REVISIONS NAME	DATE	ILLINOIS DEPARTMENT OF TRANSPORTATION F.A.I. 94/90 (DAN RYAN EXPRESSWAY 31ST STREET TO 71ST STREET NB EXPRESS LANE RECONSTRUCTION			
			BARRIER TRANSITION EET 3 OF 3)		
	+	SCALE: NONE	DRAWN BY: TAI		
	<u> </u>	DATE: 7/7/05	CHECKED BY: PJM		

Edivards

ONE NORTH FRANKLIN CHICAGO, IL 60606

AND KEICEU

ONE NORTH FRANKLIN CHICAGO, IL 60606

FAX: (3)21 251-3010

FAX: (3)21 251-3010

FAX: (3)21 251-3010

STATE OF ILLINOIS DEPARTMENT OF TRANSPORTATION

F.A.I. RTE.	SECTION	1	сопи.	ΤΥ	TOTAL SHEETS	SHEET NO.
90/94	*		COOK		556	369
STA.		TO	STA.			
FED. ROAD	DIST. NO. 1	ILLINOIS	FED.	AID	PROJECT	
· (1818,	ETC. 232	4.6-1P)R	-8		6	2300

CTA BARRIER WALL LOCATION AND MODIFICATION TABLE

STATION	NORTH BOUND							SOUTH BOUND						
		Soldier Piles Proposed T / Shou.		Proposed T / Shoulder At or	T / Shoulder At or Above Existing Proposed T / Shoulder Below Existing		Soldier Piles		Proposed T / Shoulder At or Above Existing		Proposed T / Shoulder Below Existing			
	Size	Length	Max. Spacing	Location	Modification	Location	Modification	Size	Length	Max. Spacing	Location	Modification	Location	Modification
35 th St.	W12x120	30′	5′-0"	Sta. 2611+51 to 2618+39	6" Facing			W12x120	30′	5′-0"	Sta. 1611+71 to 1618+59	6" Facing		
47 th St.	W12x106	20′	5'-0"			Sta. 2530+19 to 2537+02	1'-4 ^l 2" Facing	W12x72	20′	6′-6″	Sta. 1530+63 to 1537+46	6" Facing		
55 th St.	W12x106	20′	8'-0"			Sta. 2476+06 to 2481+81	1'-4 ¹ ₂ " Facing	W12×106	20′	8'-0"			Sta. 1475+89 to 1484+84	1'-4 ¹ 2" Facin
63 rd St.	W12x72	20′	8'-0"	Sta. 2422+99 to 2428+31	1			W12×106	20′	8'-0"			Sta. 1422+79 to 1426+92	1
69 th St.	W12x72	20′	8'-0"	Sta. 2372+94 to 2378+56	2			W12x106	20'	8'-0"	Sta. 1372+75 to 1374+50	1)	Sta. 1374+50 to 1378+53	1

- 1) Replace Exist. 32" Barrier with Single Face Barrier, 42" Special
- (2) Reface Existing CTA Barrier Wall with Vertical Facing

GENERAL NOTES:

- Utility locations shown on these plans may not be correct or complete. The contractor shall coordinate
 construction activities with the respective utilities of the city of chicago. Before starting any excavation,
 the contractor shall call "cuan" (chicago utility alert network) at 312-744-7000 for field locations of buried
 electric, telephone, and gas facilities (48 hour notification is required). Contact the department of water
 management permit section at (312) 747-7893 for water and sewer locations.
- 2. In locations where the main sewers, drainage structures, public, and private drain connections are disturbed or damaged during construction by the contractor, it will be the contractor's responsibility to restore and replace the damaged facilities at his/her own expense to the satisfaction of the department of water management. The sewer flows must be maintained at all times.
- 3. In locations where pilings/drilled shafts are being proposed in the vicinity of the existing sewer facilities, a licensed structural engineer should approve construction methods of support in order to maintain the structural integrity of the city's sewer system.
- 4. The Location of various items such as pavement, barrier walls and drainage structures built in contracts under construction during the preparation of these plans is based on the published contract plan drawings available during design. The contractor must field verify limits, locations and elevations of these previously constructed items.
- 5. The contractor shall use care in grading or excavating near any and all existing items which will not be removed.

 Any damage done to existing items by the contractor shall be repaired by the contractor at the contractor's own expense.
- 6. The contractor shall take all necessary safety precautions to protect and provide access to abutting CTA property, utilities and vehicular traffic.
- 7. It shall be the contractor's responsibility to ensure that no gap remains between proposed CTA fencing or where proposed CTA fencing terminates and existing CTA fence remains in place.
- 8. Hammer driving of piles will not be allowed. All piles must be vibrated into place.
- 9. Plan dimensions and details relating to existing structures have been taken from existing plans and are subject to nominal construction variations. It shall be the Contractor's responsibility to verify such dimensions and details in the field and make necessary approved adjustments prior to construction or ordering of materials. Such variations shall not be cause for additional compensation or a change in the scope of work. However the Contractor will be paid for the quantity actually furnished at the unit price for the work.
- 10. All construction joints shall be bonded.
- 11. All exposed concrete edges shall have a $^34''$ by 45° chamfer except where shown otherwise. Chamfer on vertical edges shall be continued a minimum of 1 foot below the finished ground line.
- 12. A protective coat shall be applied within the limits shown on the plans according to Section 503.19 of the Standard Specifications.
- 13. Reinforcement bars shall conform to the requirements of AASHTO M31 or M322 Grade 60.
- 14. Reinforcement bars designated "(E)" shall be epoxy coated.

15. For Existing Barrier Wall Modifications for Proposed T / Shoulder Below Existing, See Sheets R2 and R3

 For Existing Barrier Wall Modifications for Proposed T / Shoulder At or Above Existing, See Sheet R4 and R5.

17. For Existing Barrier Wall Modifications for 63rd St. Station (NB & SB), For 69th St. Station (SB) See Sheet B6.

18. For Existing Barrier Wall Modifications for 69rd St. Station (NB) See Sheet B7.

- For Refaced Barrier to Pier, Transition Details (Taper), Proposed T / Shoulder Below Existing. See Sheet BB.
- For Refaced Barrier to Pier, Transition Details (No Taper), Proposed T / Shoulder Below Existing, See Sheet B9.
- 21. For Refaced Barrier to Pier, Transition Details (Taper), Proposed T / Shoulder At or Above Existing, See Sheet B10.
- 22. For Refaced Barrier to Pier, Transition Details (No Taper), Proposed T / Shoulder At or Above Existing, See Sheet B11.
- 23. For New 42" Barrier to Vert. Refaced Barrier, Transition Details (Taper), Proposed T / Shoulder At or Above Existing, See Sheet B12.
- For Vert. Refaced Barrier to Pler, Transition Details (No Taper), Proposed T / Shoulder At or Above Existing, See Sheet BI3.
 For Refaced Barrier to New 42" Barrier, Transition Details, Proposed T / Shoulder
- Below Existing, See Sheet B14.
 26. For Refaced Barrier to New 42" Barrier Transition Details Proposed T / Shoulde
- 26. For Refaced Barrier to New 42" Barrier, Transition Details, Proposed T / Shoulder At or Above Existing, See Sheet B15.
- 27. For New 42" Barrier to Pier, Transition Details, Proposed T / Shoulder Below or Above Existing, See Sheet B16.
- 28. For Refaced Barrier to New Sign Structure, Transition Plan, Elevation and Details, Proposed T / Shoulder Below Existing, See Sheets B17 and B18.

DESIGN STRESSES:


 $f'c = 3,500 \ psi$ $fy = 60,000 \ psi \ (Reinf.)$


Sheet B1 of 16

CHECKED BY: RDP

REVISION	TI	INOIS DEPA	RTMENT OF 1	TRANSPORTA	TTON			
NAME	DATE	F.A.I. 90/94 (DAN RYAN EXPRESS)						
				IG BARRIER CTA STATIO				
		LO	CATION AN	D MODIFICA	TION TABL	.E		
		SCALE:	None		DRAWN BY:	KWT		

DATE: JULY 7, 2005

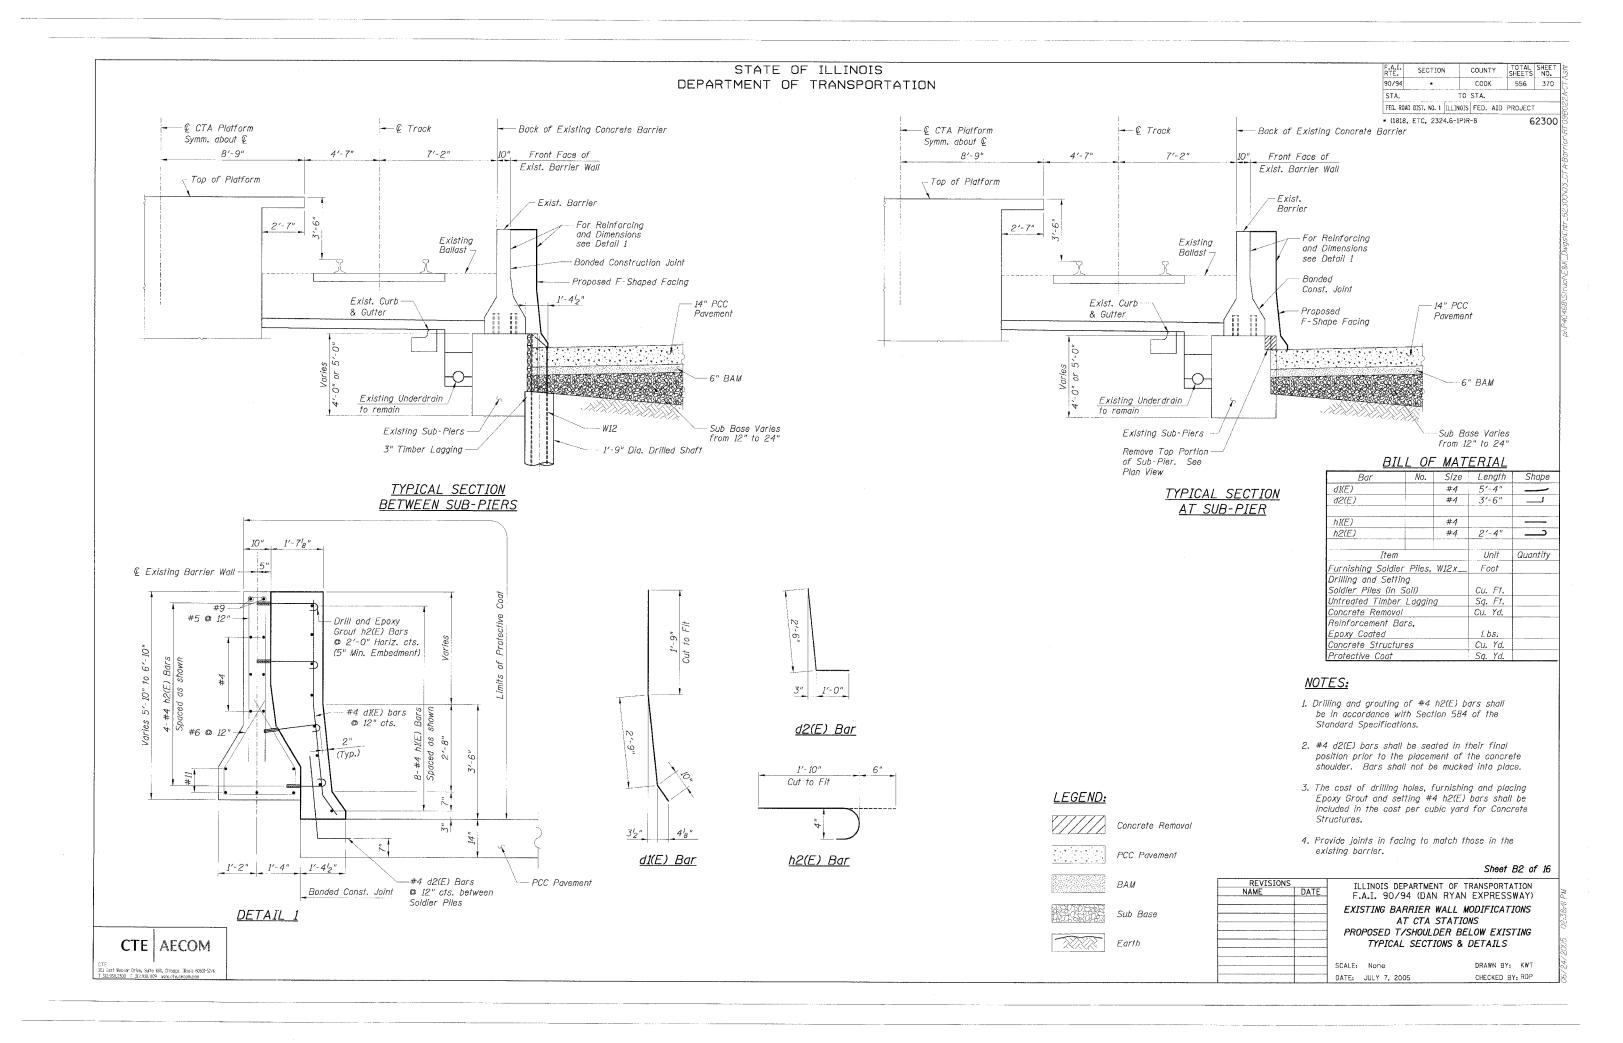

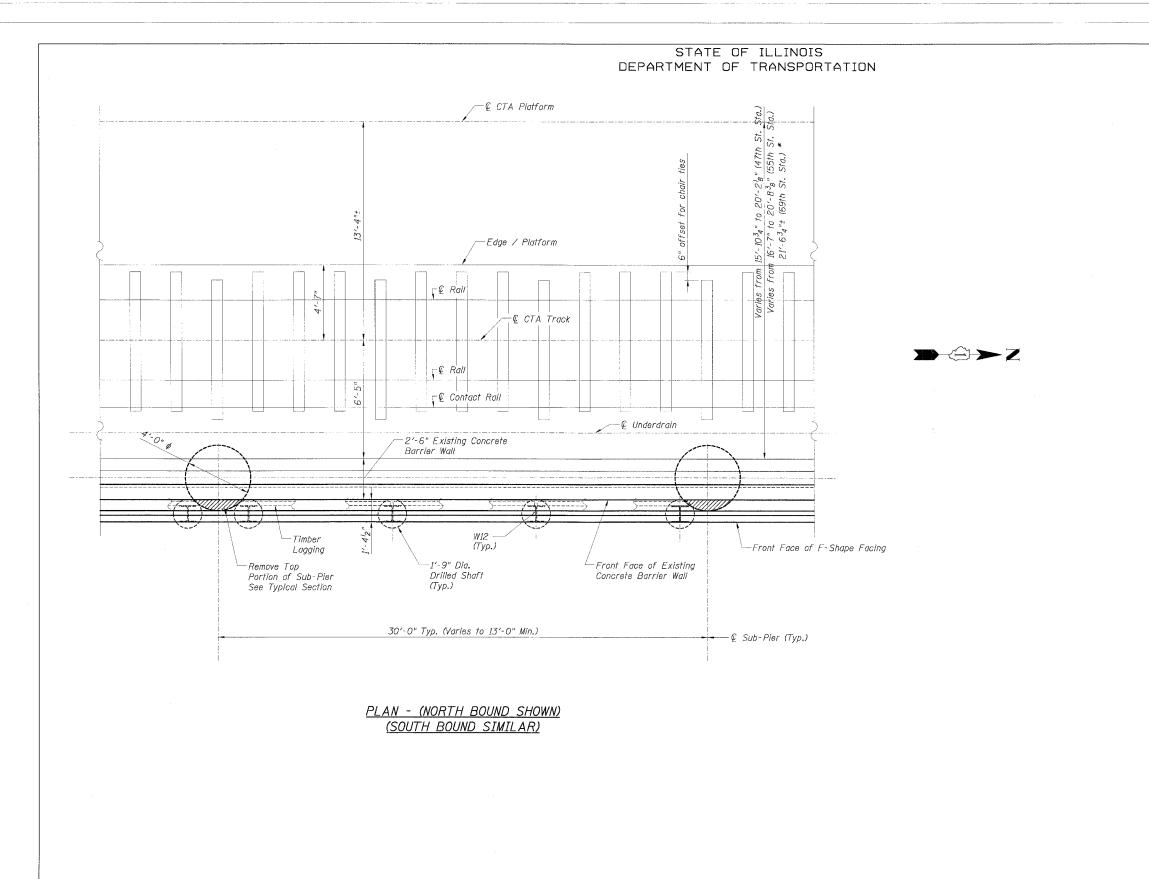

F.A.I. RTE.	SECTION		COUNTY	TOTAL	SHEE NO.
90/94			COOK	556	371
STA.		TO	STA.		


Sheet B3 of 16

REVISIONS	ILLINOIS DEPARTMENT OF TRANSPORTATION
NAME DATE	F.A.I. 90/94 (DAN RYAN EXPRESSWAY)
	EXISTING BARRIER WALL MODIFICATIONS
	AT CTA STATIONS
	PROPOSED T/SHOULDER BELOW EXISTING
	TYPICAL PLAN
	DOLLAR DE VIET


SCALE: None DATE: JULY 7, 2005 DRAWN BY: KWT CHECKED BY: RDP

CTE AECOM

CTE OD, CRICO CRICOGO, Illinois 60601-5210

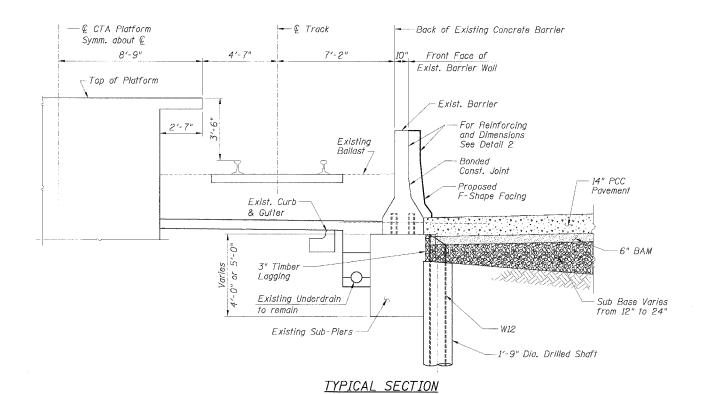



AT STATION PLATFORM

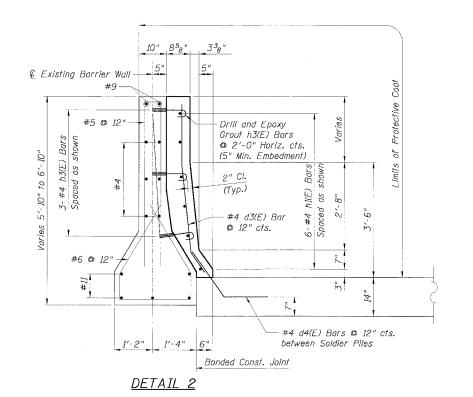

CTE | AECOM

CTL 303 East Wacker Srive, Suite 608, Chicago, Thinis 60601-5276 F 302-938,3300 F 312,938,1109 www.cts.eecom.com

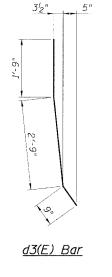

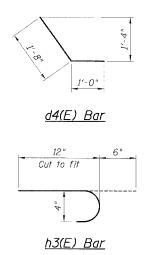

LEGEND: PCC Pavement

Sheet B4 of 16

Sub Base

Earth

BAM

		3/100/ 10/ 10
REVISIONS NAME DATE	ILLINOIS DEPARTMENT F.A.I. 90/94 (DAN E EXISTING BARRIER W AT CTA S PROPOSED T/SHOULDER TYPICAL SECTIO	RYAN EXPRESSWAY) VALL MODIFICATIONS TATIONS AT OR ABOVE EXISTING
	SCALE: None	DRAWN BY: KWT
	DATE: JULY 7, 2005	CHECKED BY: RDP

SECTION COUNTY COOK 556 372 STA. TO STA. FED. ROAD DIST. NO. 1 ILLINOIS FED. AID PROJECT

62300


RILL OF MATERIAL

* (1818, ETC, 2324.6-1P)R-8

Bar	No.	Size	Length	Shape
d3(E)		#4	5′-3"	
d4(E)		#4	2'-8"	
h1(E)		#4		
h3(E)		#4	1'-6"	>
Item	L		Unit	Quantity
Furnishing Soldier		W12x	Foot	
Drilling and Settin				
Soldier Piles (in S	ioil)		Cu. Ft.	
Untreated Timber	Laggin	9	Sq. Ft.	
Reinforcement Ba	rs.			1
Epoxy Coated			Lbs.	
Concrete Structur	es		Cu. Yd.	
			Sq. Yd.	

NOTES:

- 1. Drilling and grouting of #4 h3(E) bars shall be in accordance with Section 584 of the Standard Specifications.
- 2. #4 d4(E) bars shall be seated in their final position prior to the placement of the concrete shoulder. Bars shall not be mucked into place.
- 3. The cost of drilling holes, furnishing and placing Epoxy Grout and setting #4 h3(E) bars shall be included in the cost per cubic yard for Concrete Structures.
- 4. Provide joints in facing to match those in the existing barrier.

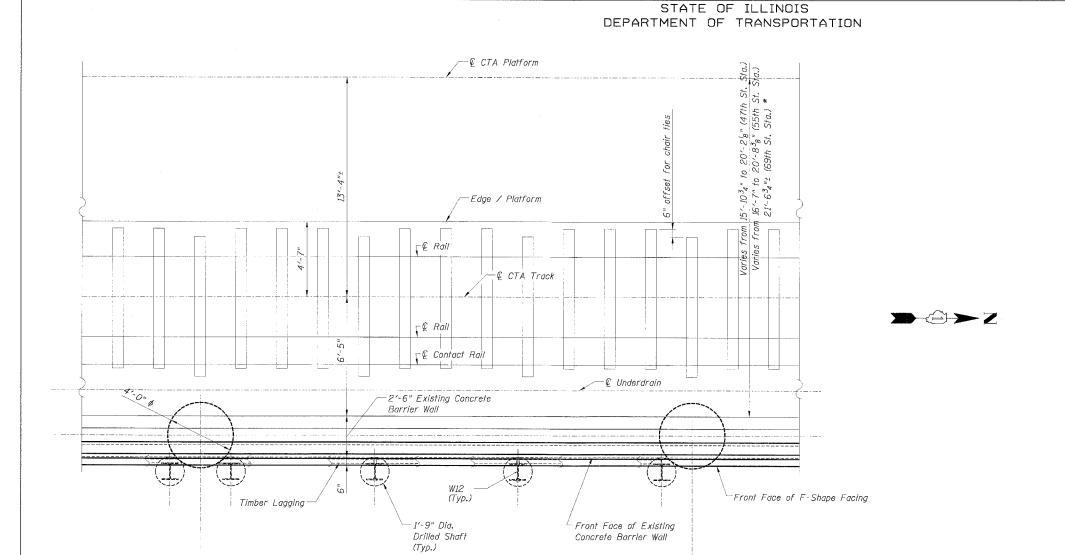

- € Sub-Pier (Typ.)

PLAN - (NORTH BOUND SHOWN) (SOUTH BOUND SIMILAR)

30'-0" Typ. (Varies to 13'-0" Min.)

Sheet B5 of 16

REVISIONS NAME	DATE		S DEPARTMENT C 90/94 (DAN RY		
		EXISTIN	IG BARRIER WA		IONS
		PROPOSED	T/SHOULDER A		XISTING
			TYPICAL	PLAN	
		SCALE: None	•	DRAWN BY:	KWT
		DATE. HUV	7 2005	CHECKED BY-	RUB

CTE | AECOM

RTE. SECTION COUNTY TOTAL SHEETS NO.


90/94 • COOK 556 373

TO STA. FED. ROAD DIST. NO. 1 ILLINOIS FED. AID PROJECT

STA.

* (1818, ETC, 2324.6-1P)R-8

62300

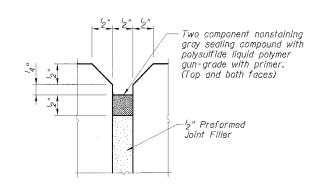

EXPANSION JOINT DETAIL

| F.A.I. | SECTION | COUNTY | TOTAL | SHEET | NO. | STA. | TO STA. | TO STA. | FED. ROAD DIST. NO. | I ILLINOIS | FED. AID | PROJECT | STA. |

* (1818, ETC, 2324.6-1P)R-8

62300

BIL	L OF	MAT	ERIAL
	No	Size	Lenath

<u> </u>		7917 1 7	<u></u>	
Bar	No.	Size	Length	Shape

Item			Unit	Quantity
Concrete Barrier	Remova	/	Foot	
Furnishing Soldler	Piles \	N12x	Foot	
Drilling and Settin	g			
Soldier Piles (in S	oil)		Cu. Ft.	
Untreated Timber	Lagging	7	Sq. Ft.	
Reinforcement Ba	rs,			
Epoxy Coated			Lbs.	
Concrete Structur	es		Cu. Yd.	
Protective Coat			Sq. Yd.	

NOTES:


- See "Concrete Barrier Single Face, 42" (Special)" for F-Shaped Barrier dimensions and reinforcing details.
- 2. Provide construction joints in the Type F Barrier on maximum of 30'-0" centers.
- 3. Provide ^l2" expansion joints in the Type F Barrier on maximum 90'-0" centers.
- The cost of furnishing and installing sealing compound shall be included in the cost per cubic yard for "Concrete Structures".

Sheet B6 of 16

REVISION NAME	DATE		TMENT OF TRANSPORTATION DAN RYAN EXPRESSWAY)
		EXISTING BARRI	ER WALL MODIFICATIONS
		AT C	TA STATIONS
		TYPICAL SE	CCTIONS & DETAILS
			. STATION (NB & SB)
		FOR 69th	ST. STATION (SB)
		CCALE. None	DOAWN DV. KWT

SCALE: None
DATE: JULY 7, 2005

CHECKED BY: RDP

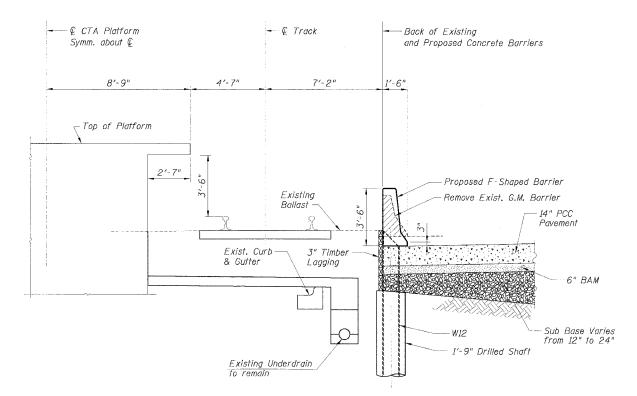

TYPICAL SECTION
AT 69TH ST. STATION (SB)
AT 63TH ST. STATION (NB)
AT 63TH ST. STATION (NB)

CTE AECOM

CTF
SIX East Wasker (Privs, Suite 800, Orloops, Illinois 66001-92/8

1.3 14(259.000) 1 37.338 [119] www.cfp.oncon.com

LEGEND:

Concrete Removal


PCC Pavement

BAN


Sub Bas

TO E

Earth

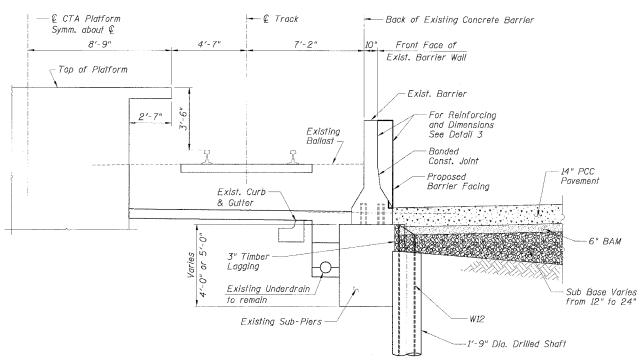


TYPICAL SECTION BETWEEN SUB-PIERS AT 69TH ST. STATION (NB)

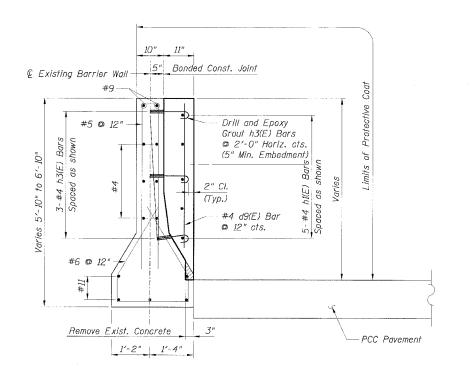

Cut to fit h3(E) Bar

DETAIL 3

CTE AECOM

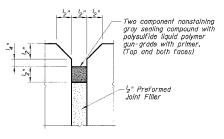

EXPANSION JOINT DETAIL

F.A.I. RTE.	SECTION	COUNTY	TOTAL	SHEET NO.
90/94		соок	556	375
STA.		TO STA,		
FED. ROAD	DIST. NO. 1 THEIR	INIS FED ATE	PROJECT	

62300

BILL OF MATERIAL

* (1818, ETC, 2324.6-1P)R-8

Bar	No.	Size	Length	Shape
d9(E)		#4	4'-4"	
h1(E)		#4		
h3(E)		#4	1'-6"	
7974 (PA 1974 In 1874				
Item			Unit	Quantity
Furnishing Soldier	Piles	W12x	Foot	
Drilling and Settin	g			
Soldler Piles (in S	Soil)		Cu. Ft.	
Untreated Timber	Laggin	ng	Sq. Ft.	
Concrete Removal			Cu. Yd.	
Reinforcement Ba	rs,			
Epoxy Coated			Lbs.	
Concrete Structur	es		Cu. Yd.	
Protective Coat			Sq. Yd.	

NOTES:

- 1. Drilling and grouting of #4 h3(E) bars shall be in accordance with Section 584 of the Standard Specifications.
- 2. The cost of drilling holes, furnishing and placing Epoxy Grout and setting #4 h3(E) bars shall be included in the cost per cubic yard for Concrete Structures.
- 3. Provide joints in facing to match those in the existing barrier.

LEGEND:

Concrete Removal

PCC Pavement



BAM



Sub Base

Earth .


REVISIONS


ILLINOIS DEPARTMENT OF TRANSPORTATION F.A.I. 90/94 (DAN RYAN EXPRESSWAY)


EXISTING BARRIER WALL MODIFICATIONS AT CTA STATIONS TYPICAL SECTIONS & DETAILS FOR 69th ST. STATION (NB)

SCALE: None DATE: JULY 7, 2005 DRAWN BY: KWT CHECKED BY: RDP

Sheet B7 of 16

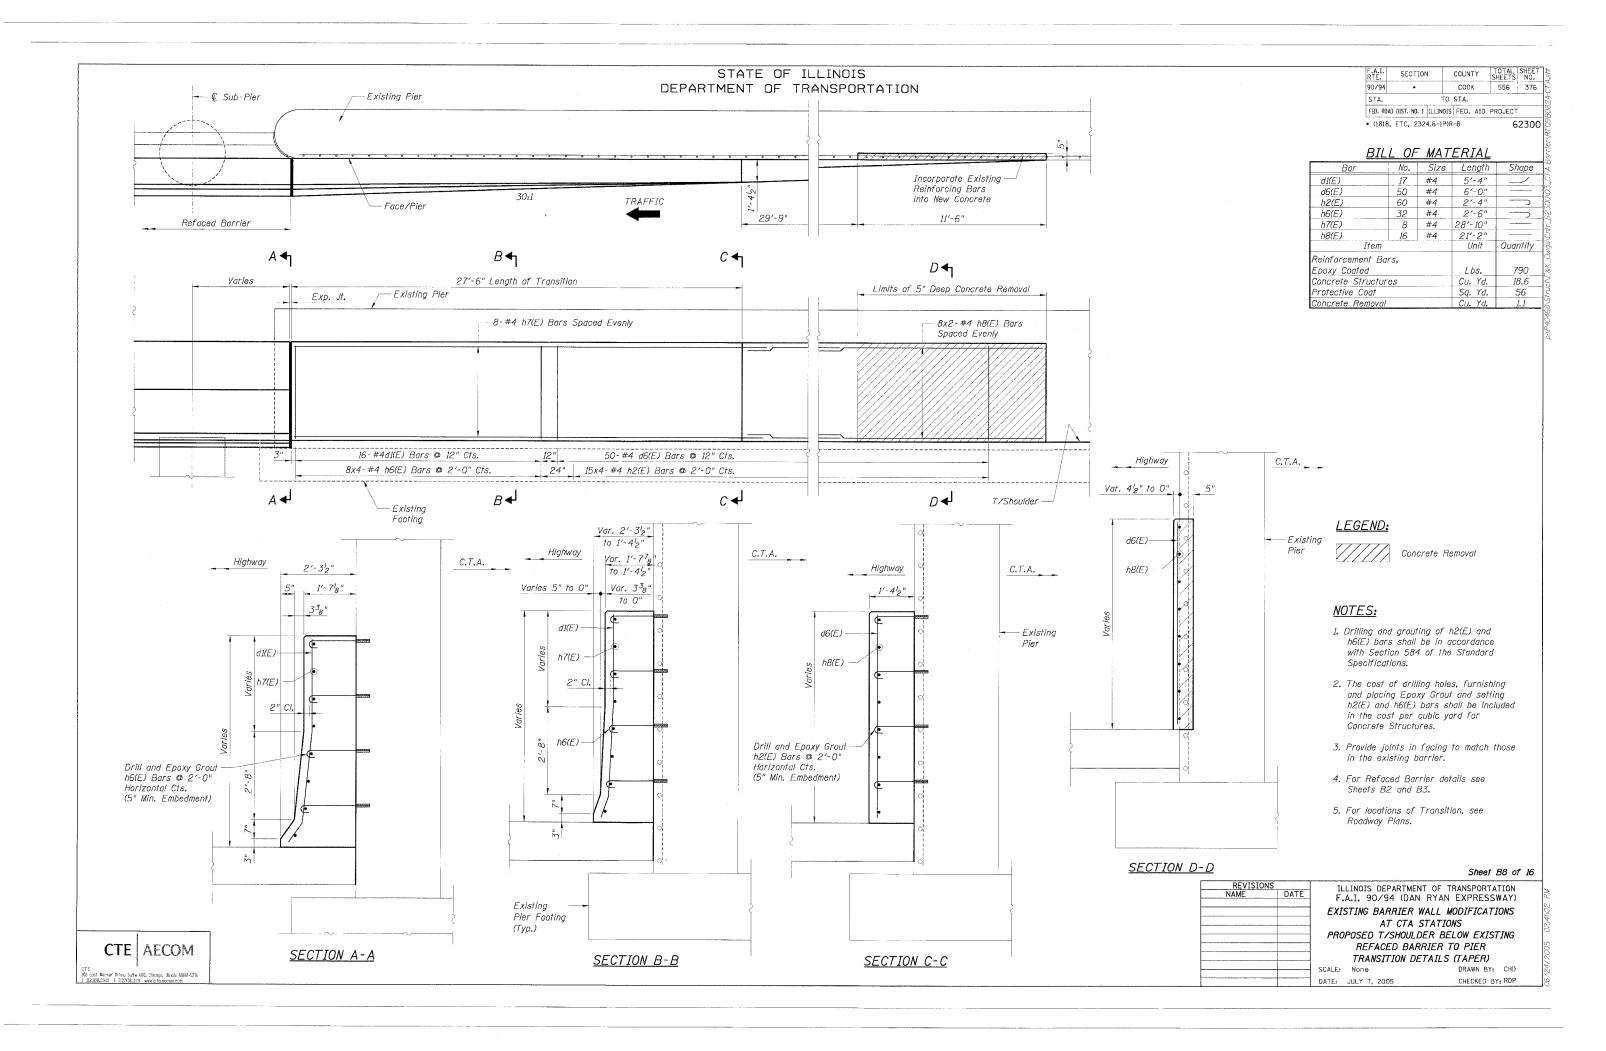

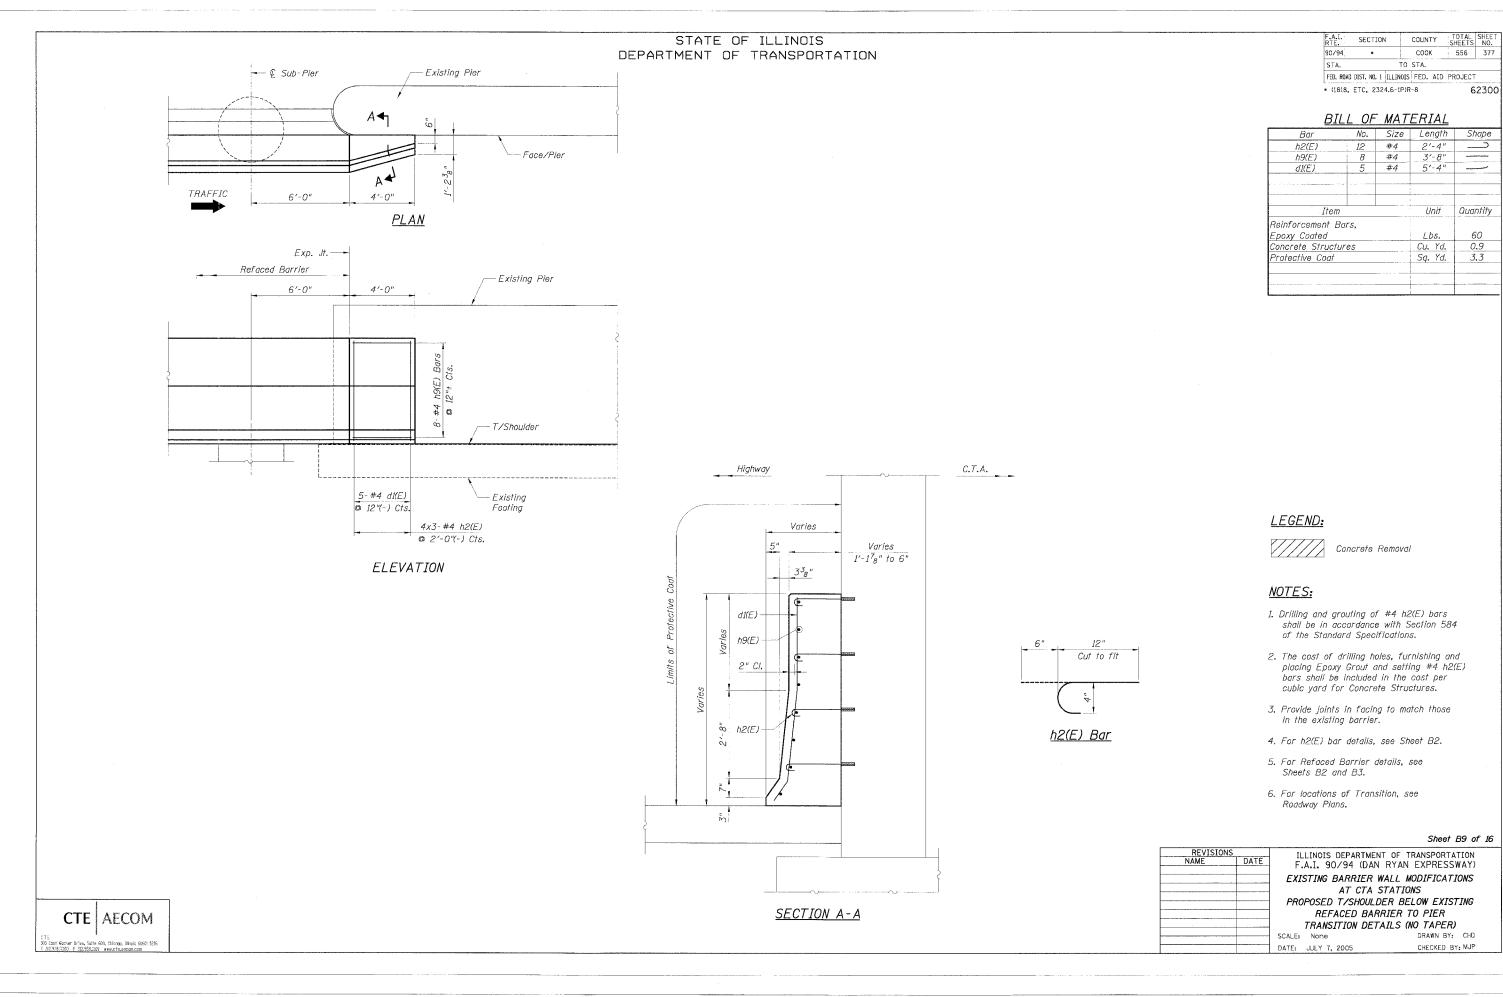

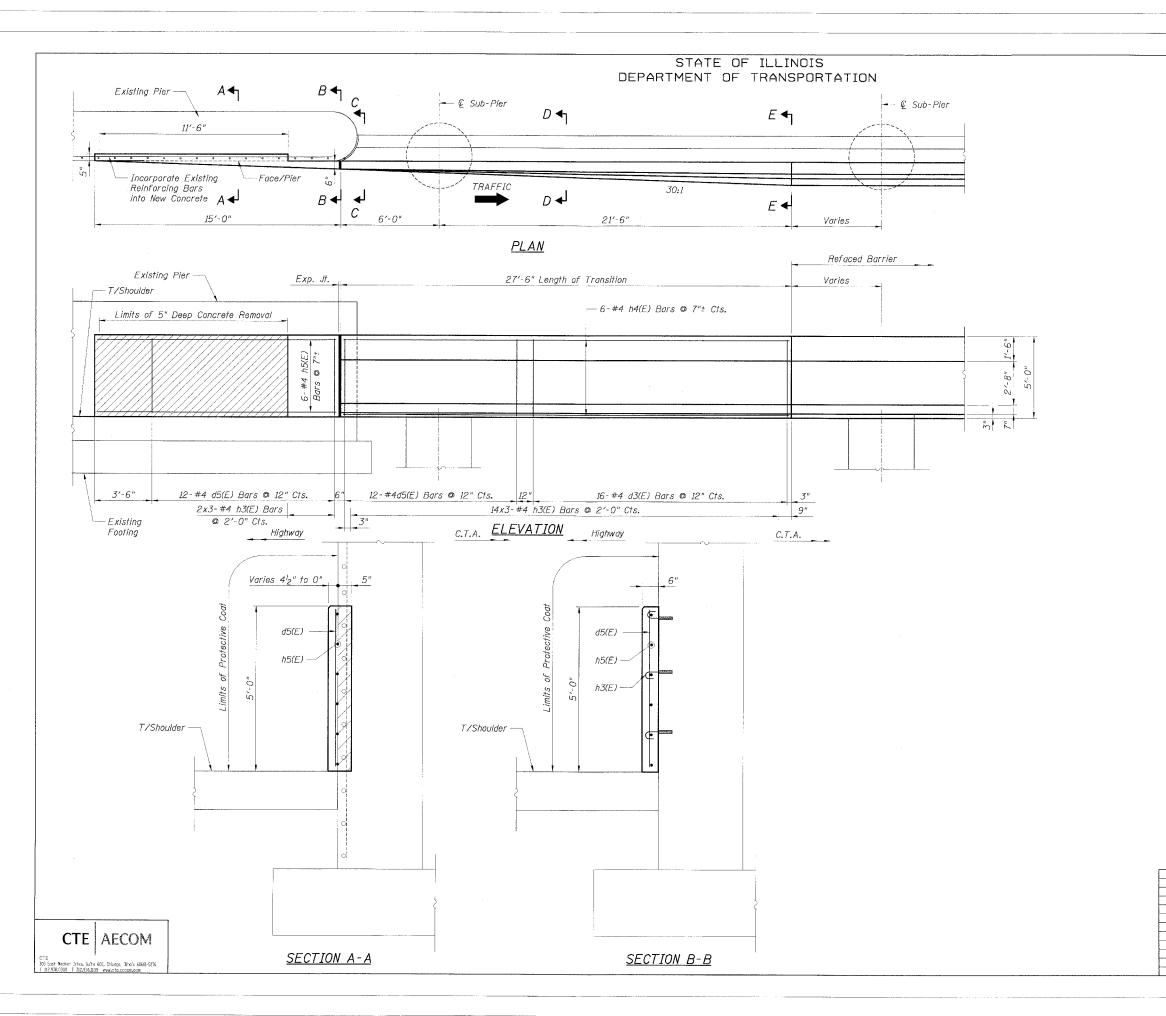

F.A.I. RTE.	SECTION	COUNTY	TOTAL SHEETS	SHEET NO.
90/94	*	COOK	556	378
STA.		TO STA.		
FED. ROAD	DIST. NO. 1 ILLIN	OIS FED. AID	PROJECT	-

* (1818, ETC, 2324.6-1P)R-8

62300

BILL OF MATERIAL FOR ONE TRANSITION

Bar	No.	Size	Length	Shape
d3(E)	16	#4	5'-3"	
d5(E)	24	#4	4'-8"	
h3(E)	48	#4	1'-6"	
h4(E)	6	#4	26'-8"	
h5(E)	6	#4	14'-8"	
<u>I</u> tem			Unit	Quantity
Reinforcement Ba	rs,			
Epoxy Coated			Lbs.	345
Concrete Structur	es		Cu. Yd.	4.6
Protective Coat			Sq. Yd.	22.5
Concrete Removal			Cu. Yd.	0.9

LEGEND:




NOTES:

- 1. Drilling and grouting of #4 h3(E) bars shall be in accordance with Section 584 of the Standard Specifications.
- 2. The cost of drilling holes, furnishing and placing Epoxy Grout and setting #4 h3(E) bars shall be included in the cost per cubic yard for Concrete Structures.
- 3. Provide joints in facing to match those in the existing barrier.
- 4. For Refaced Barrier details, see Sheets B4 and B5.
- 5. For Sections C-C, D-D and E-E see Sheet B11.
- 6. For d3(E) and h3(E) bar details, see Sheet B4.
- 7. For locations of Transition, see Roadway Plans.

Sheet B10 of 16

REVISIONS		LLINOIS DEPARTME	NT OF TR	ANSPORTAT	TON
NAME D.		.A.I. 90/94 (DA)			
	1				
	E.	XISTING BARRIEF	R WALL M	ODIFICATI	ONS
		AT CTA	STATIO	NS	
	PROP	OSED T/SHOULDE	R AT OR	ABOVE E.	XISTING
		REFACED BA	RRIER 7	O PIER	
		TRANSITION I	DETAILS	(TAPER)	
	SCALE:	None		DRAWN BY:	CHD
	DATE:	JULY 7, 2005		CHECKED BY:	MJP

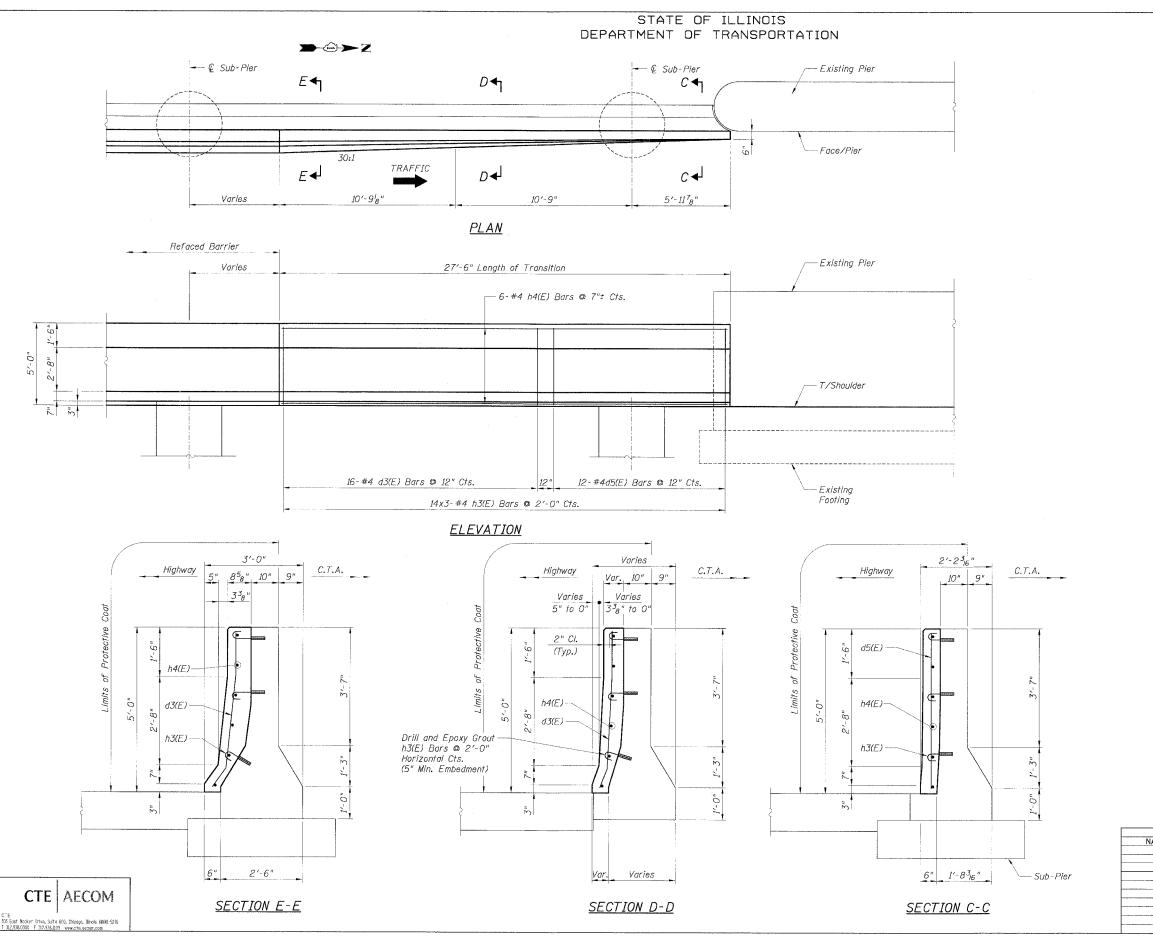

COUNTY TOTAL SHEET SHEETS NO. SECTION COOK 90/94 556 379 STA. TO STA. FED. ROAD DIST. NO. 1 ILLINOIS FED. AID PROJECT

* (1818, ETC, 2324.6-1P)R-8

BILL OF MATERIAL FOR ONE TRANSITION

Bar	No.	Size	Length	Shape
d3(E)	16	#4	5′-3"	
d5(E)	12	#4	4'-8"	
h3(E)	42	#4	1'-6"	
h4(E)	6	#4	26'-8"	
Item			Unit	Quantity
Reinforcement B	ars,			
Epoxy Coated			250	
Concrete Structu			3.0	
Protective Coat			19.6	
Concrete Remove	1/			
			:	

LEGEND:


Concrete Removal


NOTES:


- Drilling and grouting of #4 h3(E) bars shall be in accordance with Section 584 of the Standard Specifications.
- 2. The cost of drilling holes, furnishing and placing Epoxy Grout and setting #4 h3(E) bars shall be included in the cost per cubic yard for Concrete Structures.
- 3. Provide joints in facing to match those in the existing barrier.
- 4. For Refaced Barrier details, see Sheets B4 and B5.
- 5. For locations of Transition, see Roadway Plans.


Sheet B11 of 16


REVISIONS		TIL INOTS DE	PARTMENT OF TRANSPORTATION	d
NAME	DATE		94 (DAN RYAN EXPRESSWAY	
		EXISTING B	ARRIER WALL MODIFICATION	/S
			AT CTA STATIONS	
		PROPOSED T/S	HOULDER AT OR ABOVE EXIS	STING
		REFA	CED BARRIER TO PIER	
		TRANSI	TION DETAILS (NO TAPER)	
		SCALE: None	DRAWN BY: CH	D
		DATE: JULY 7, 20	005 CHECKED BY: RDI	Р

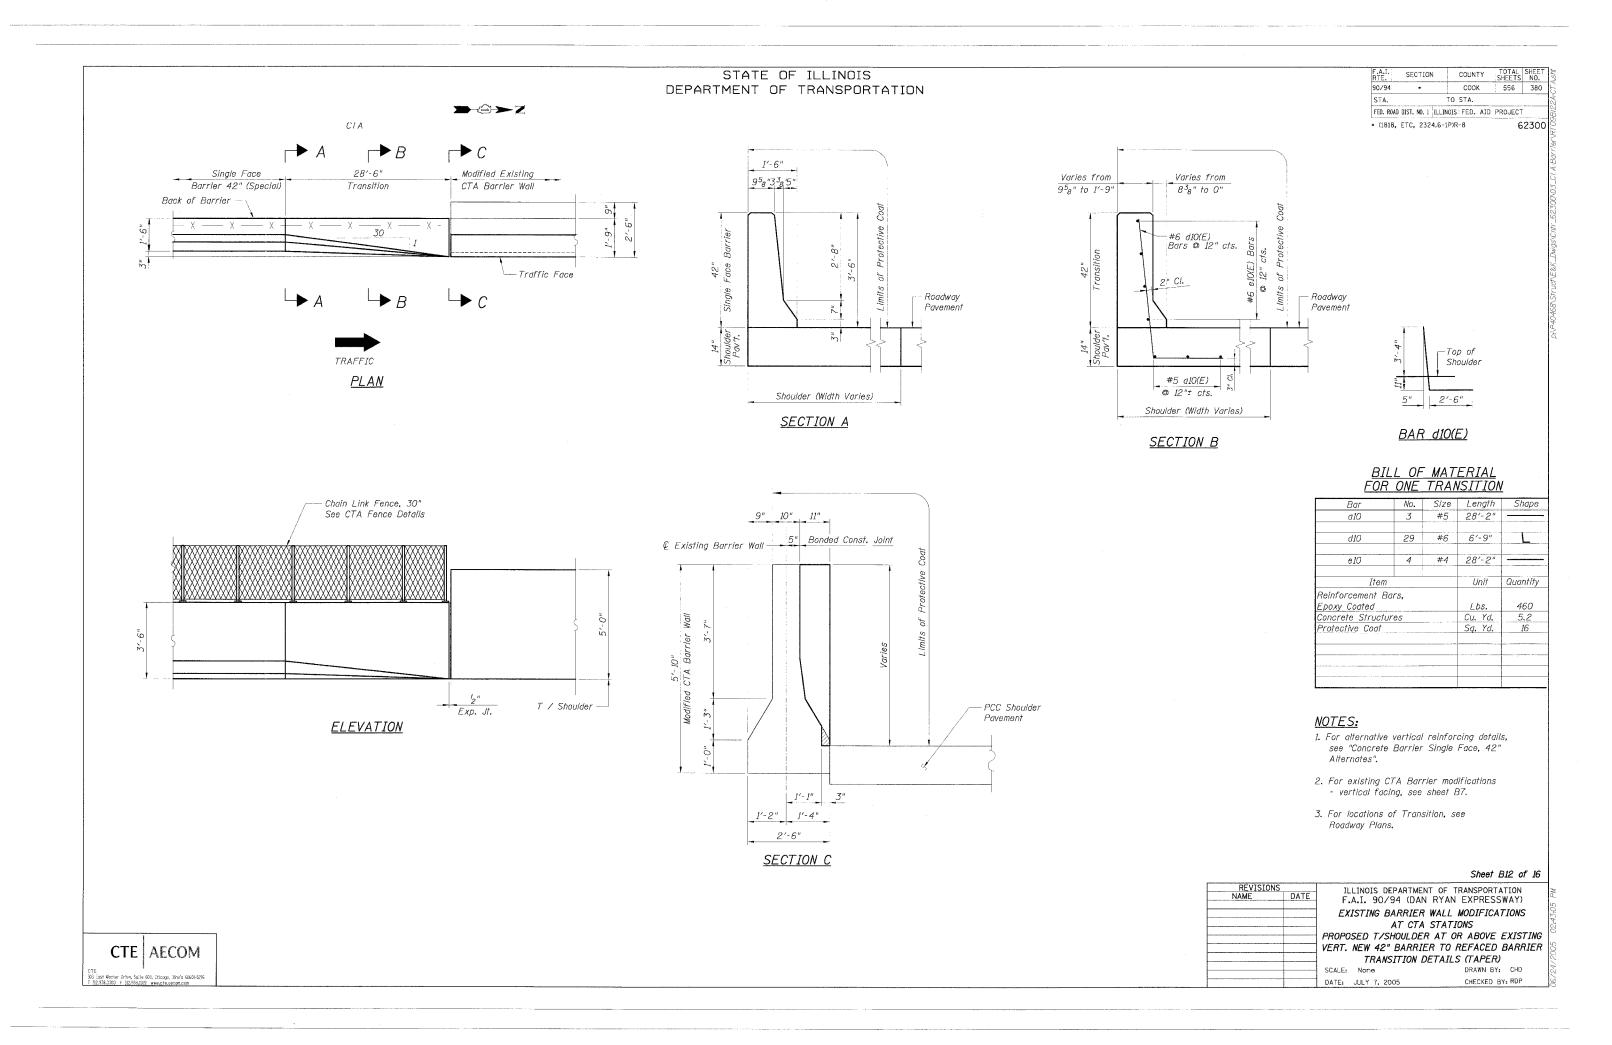


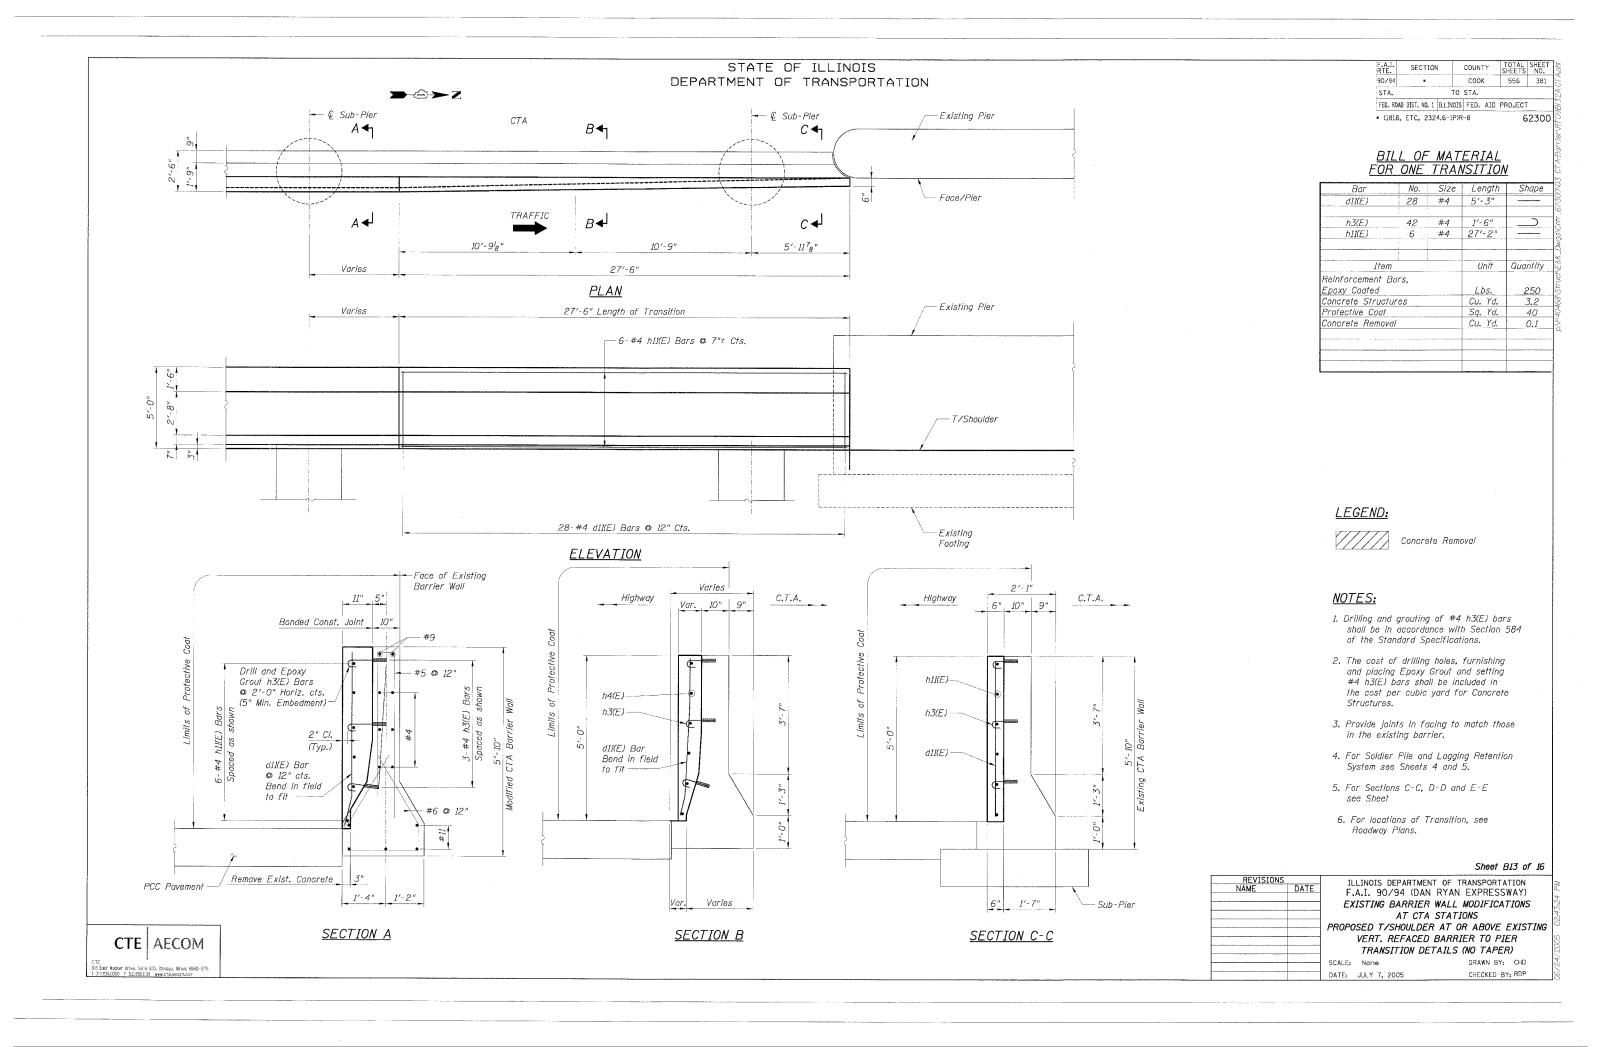

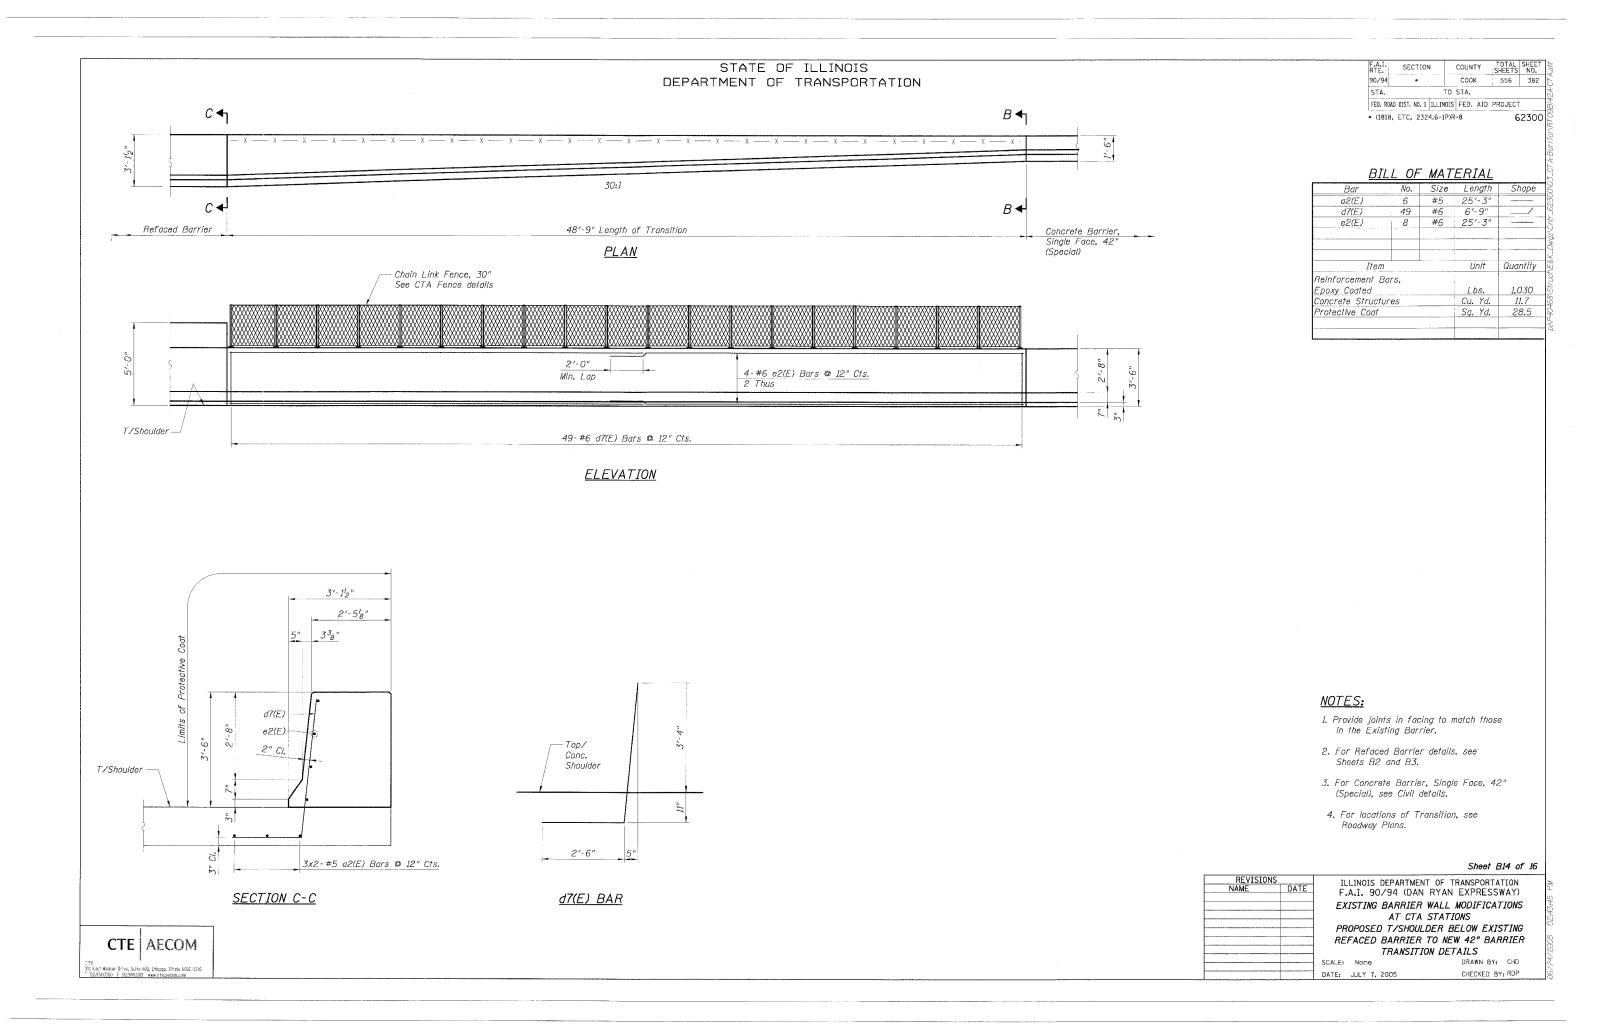

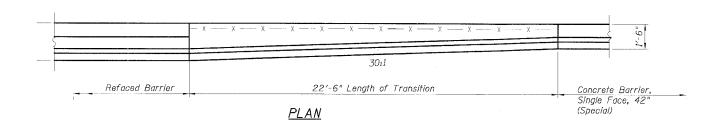

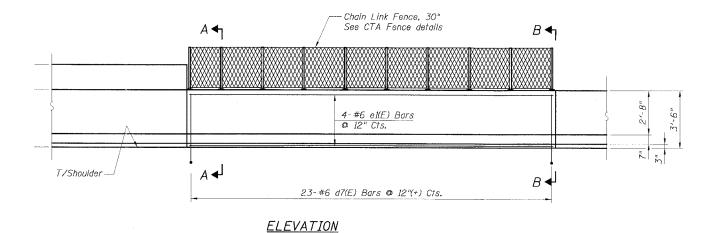

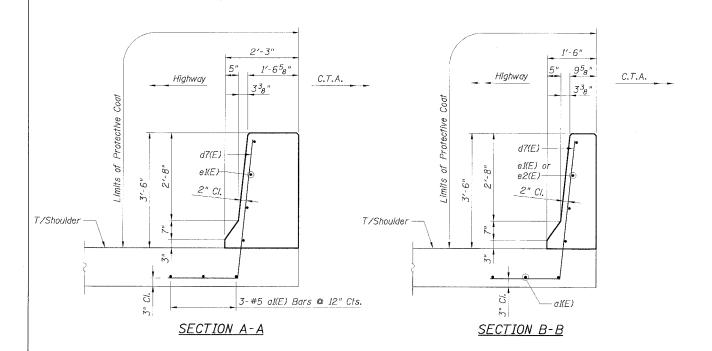

CTE | AECOM

East Rocker Prive, Suite 500, Chicago, Birous 6660) ±276.
2598.000 F 302.933.000 vevicite.genom.com

F.A.I. RTE.	SECTION	COUNTY	TOTAL	SHEET NO.
90/94	*	COOK	556	383
STA.		TO STA.		
FFD. ROAL	DIST. NO. 1 TILL	NOIS FED. AID	PROJECT	

* (1818, ETC, 2324.6-1P)R-8

62300

BILL OF MATERIAL


	No.	Size	Length	Shape
	3	#5	22'-2"	
	23	#6	6′-9"	
	4	#6	22'-2"	
Item			Unit	Quantity
nt Ba	rs.			
Epoxy Coated				470
Concrete Structures				4.2
Protective Coat			Są. Yd.	12.2
	d ructur	3 23 4 Item nt Bars, d ructures	3 #5 23 #6 4 #6 Item nt Bars, d	3 #5 22'-2" 23 #6 6'-9" 4 #6 22'-2" Item Unit not Bars, d Lbs. ructures Cu. Yd.


NOTES:


- 1. Provide joints in facing to match those in the Existing Barrier.
- 2. For d7(E) bar details, see Sheet B14.
- 3. For Refaced Barrier details, see Sheets B4 and B5.
- 4. For Concrete Barrier, Single Face, 42" (Special), see Civil details.
- 5. For locations of Transition, see Roadway Plans.

Sheet B15 of 16


	סו וט כום וספווכ		
REVISIONS NAME DATE	ILLINOIS DEPARTMENT OF TRANSPORTATION		
77777	F.A.I. 90/94 (DAN RYAN EXPRESSWAY)		
	EXISTING BARRIER WALL MODIFICATIONS		
	AT CTA STATIONS		
	PROPOSED T/SHOULDER AT OR ABOVE EXISTING		
	REFACED BARRIER TO NEW 42" BARRIER		
	TRANSITION DETAILS		
	SCALE: None DRAWN BY: CHD		
	DATE: JULY 7, 2005 CHECKED BY: RDP		

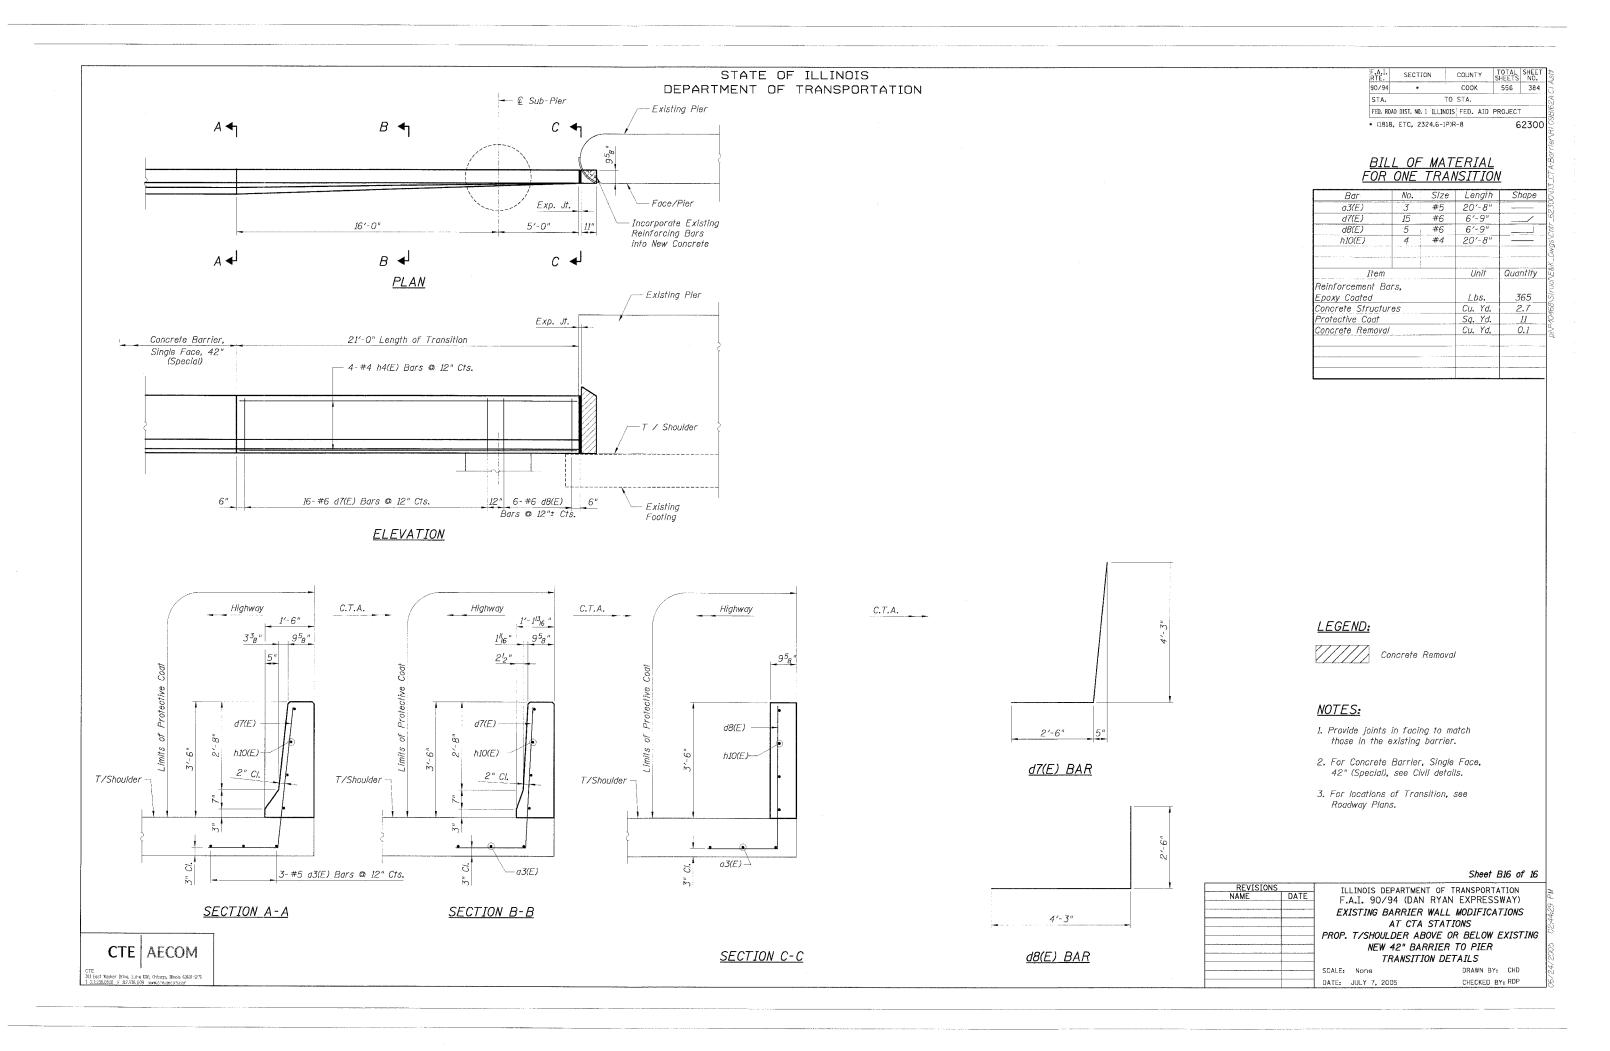

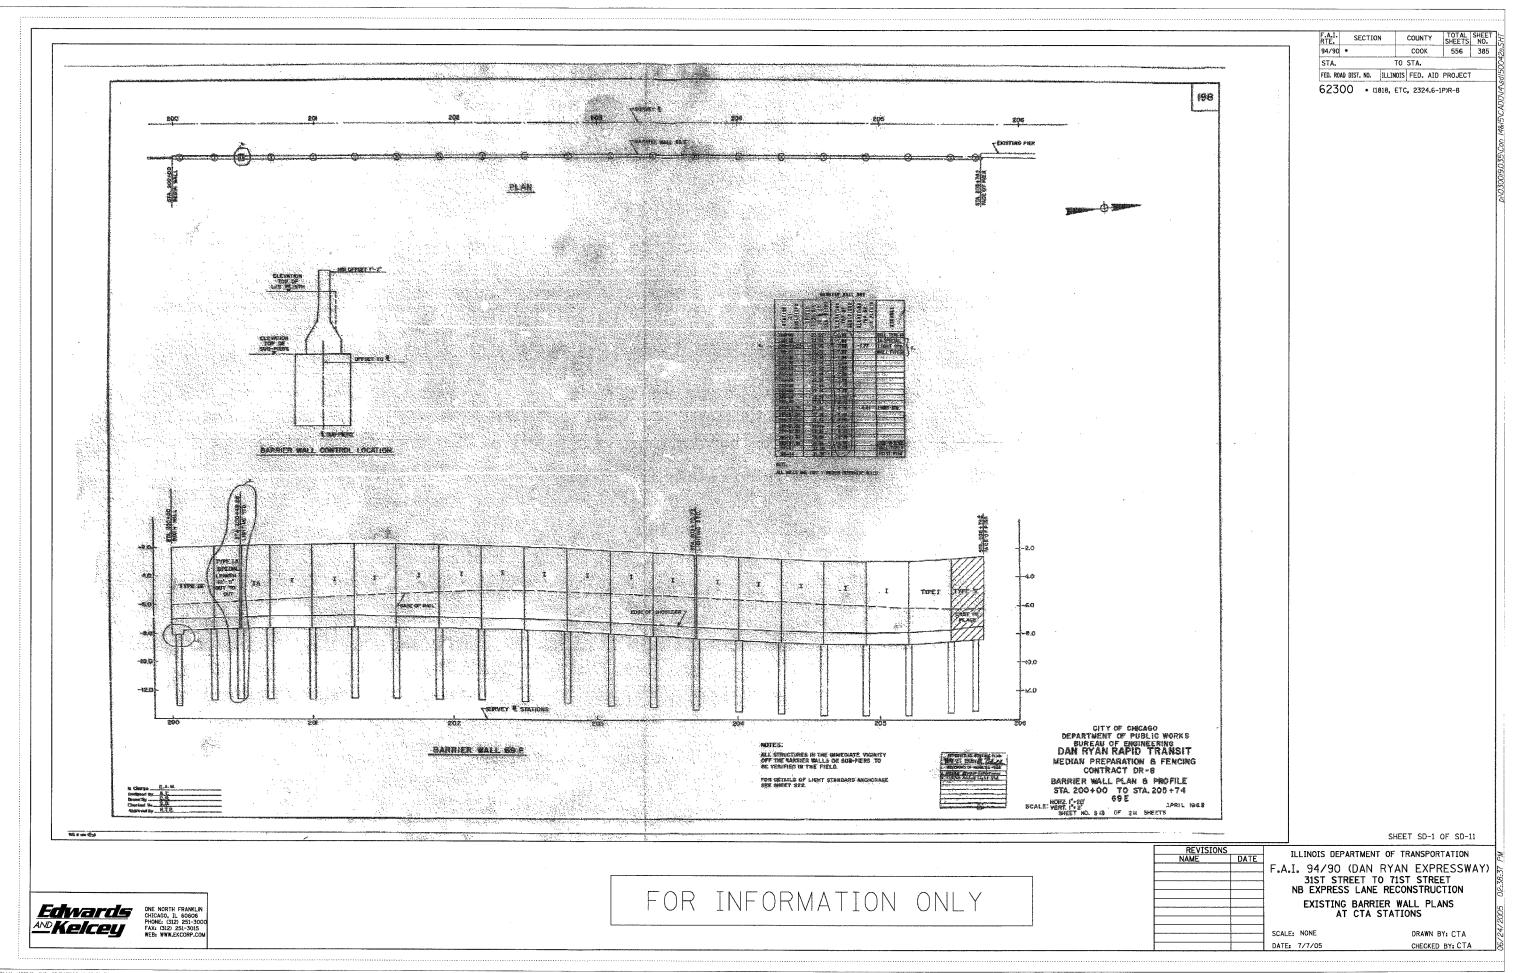

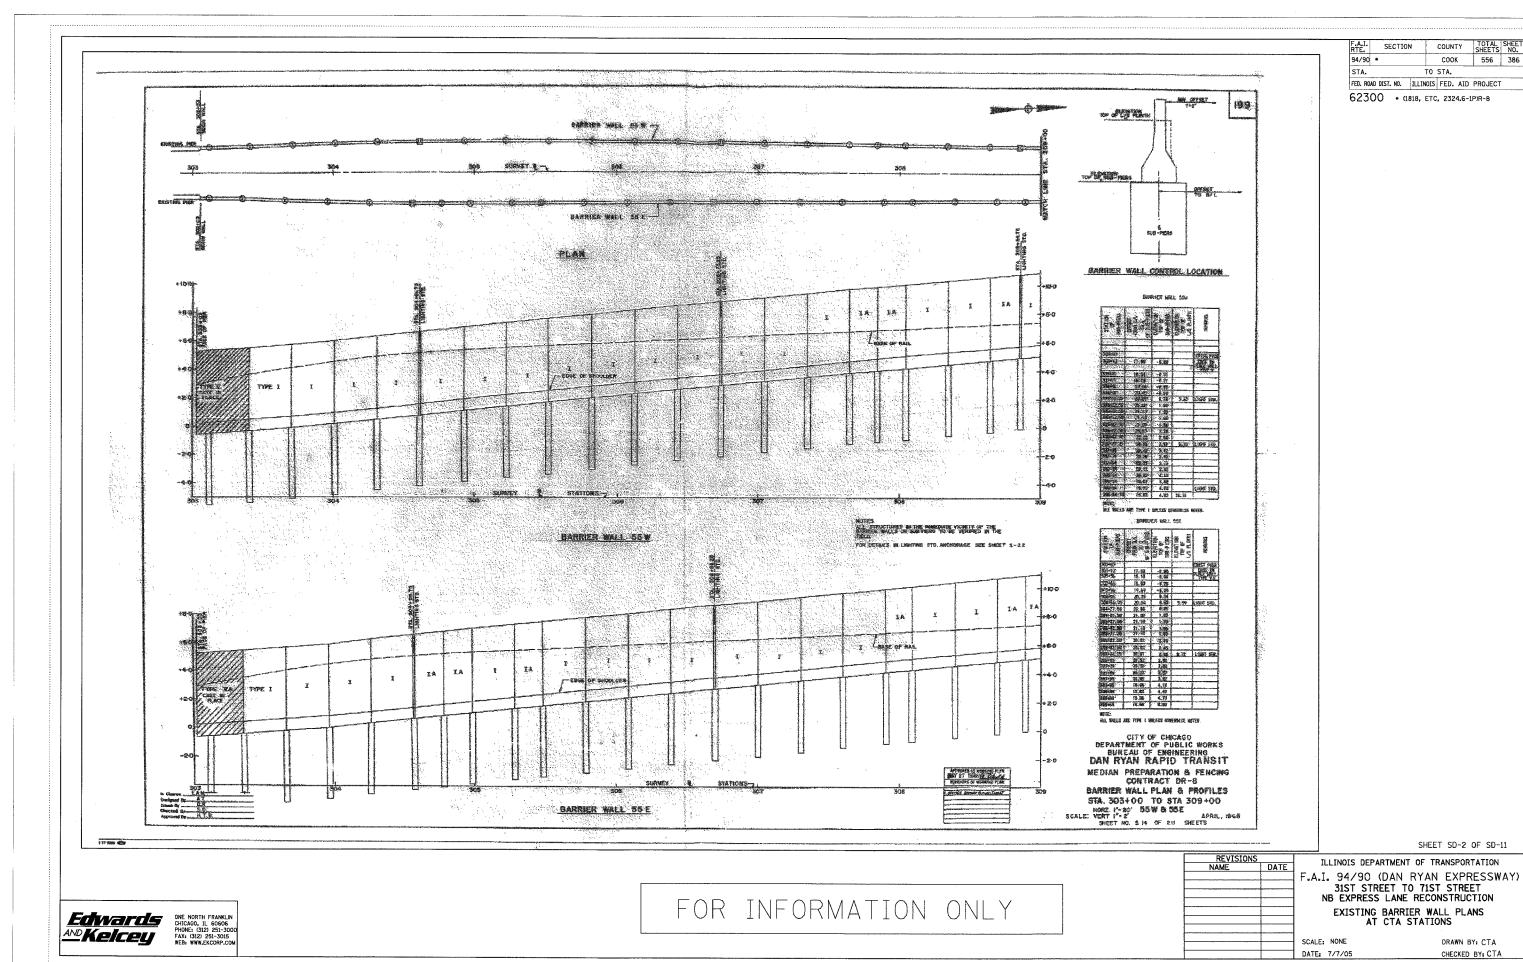

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F.A.I.	SECTION	COUNTY	TOTAL	SHEET	NO.
94/90	COOK	556	387		
STA.	TO STA.				
FED. ROAD DIST. NO.	ILLINOIS	FED. AID	PROJECT		

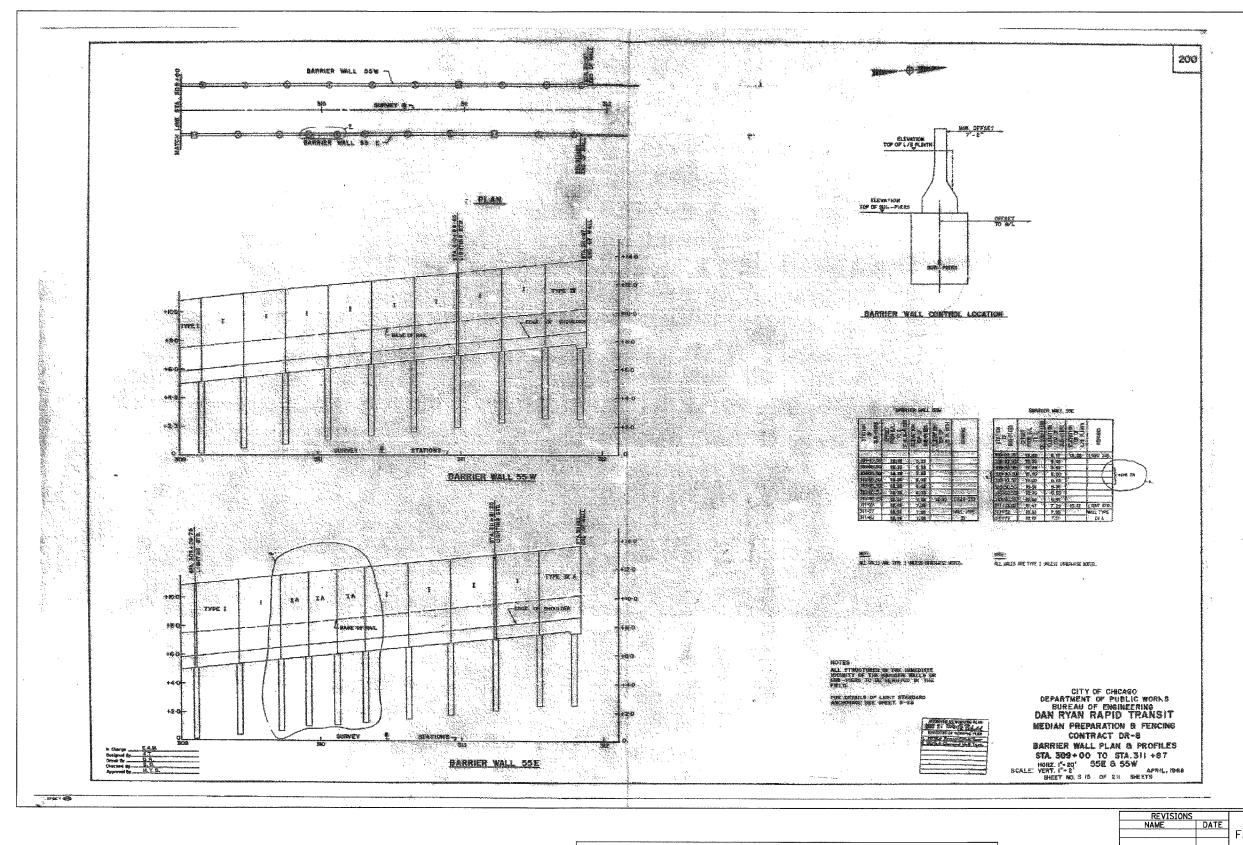62300 • (1818, ETC, 2324,6-1P)R-8

SHEET SD-3 OF SD-11

FOR INFORMATION ONLY

REVISIONS
NAME DATE
F.A

SCAL

ILLINOIS DEPARTMENT OF TRANSPORTATION
F.A.I. 94/90 (DAN RYAN EXPRESSWAY)
31ST STREET TO 71ST STREET
NB EXPRESS LANE RECONSTRUCTION
EXISTING BARRIER WALL PLANS
AT CTA STATIONS

SCALE: NONE DATE: 7/7/05 DRAWN BY: CTA CHECKED BY: CTA

Edivards


AND Kelcey

ONE NORTH FRANKLIN CHICAGO, IL 60606

FANS. (312) 251-3010

FANS. (312) 251-3015

WWW.EXCORP.COM

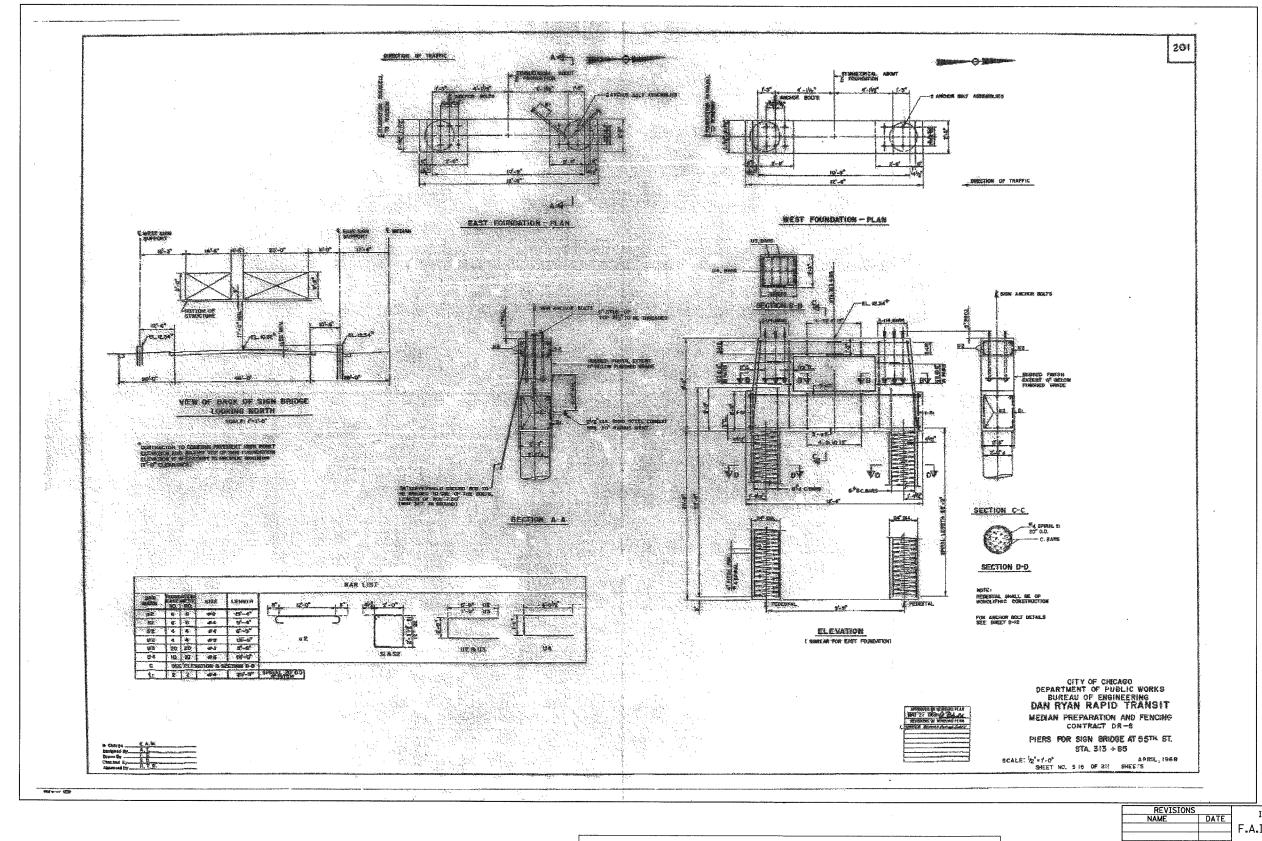

| F.A.I. | SECTION | COUNTY | SHEET | NO. | 1/2 | SHEET | NO. | 1/

62300 * (1818, ETC, 2324.6-1P)R-8

SHEET SD-4 OF SD-11


Edivarus


ONE NORTH FRANKLIN
CHICAGO, 11. 60606
PHONE: (312) 251-3005
WEB: WWW.EKCORP.COM


FOR INFORMATION ONLY


REVISIONS		ILLINOIS DEPARTMENT OF TRANSPORTATION				
ME	DATE	ILLENOIS BEFARTMENT OF TRANSFORTATION				
		F.A.I. 94/90 (DAN RYAN EXPRESSWAY)				
		31ST STREET TO 71ST STREET				
		NB EXPRESS LANE RECONSTRUCTION				
		EXISTING BARRIER WALL PLANS				
		AT CTA STATIONS				


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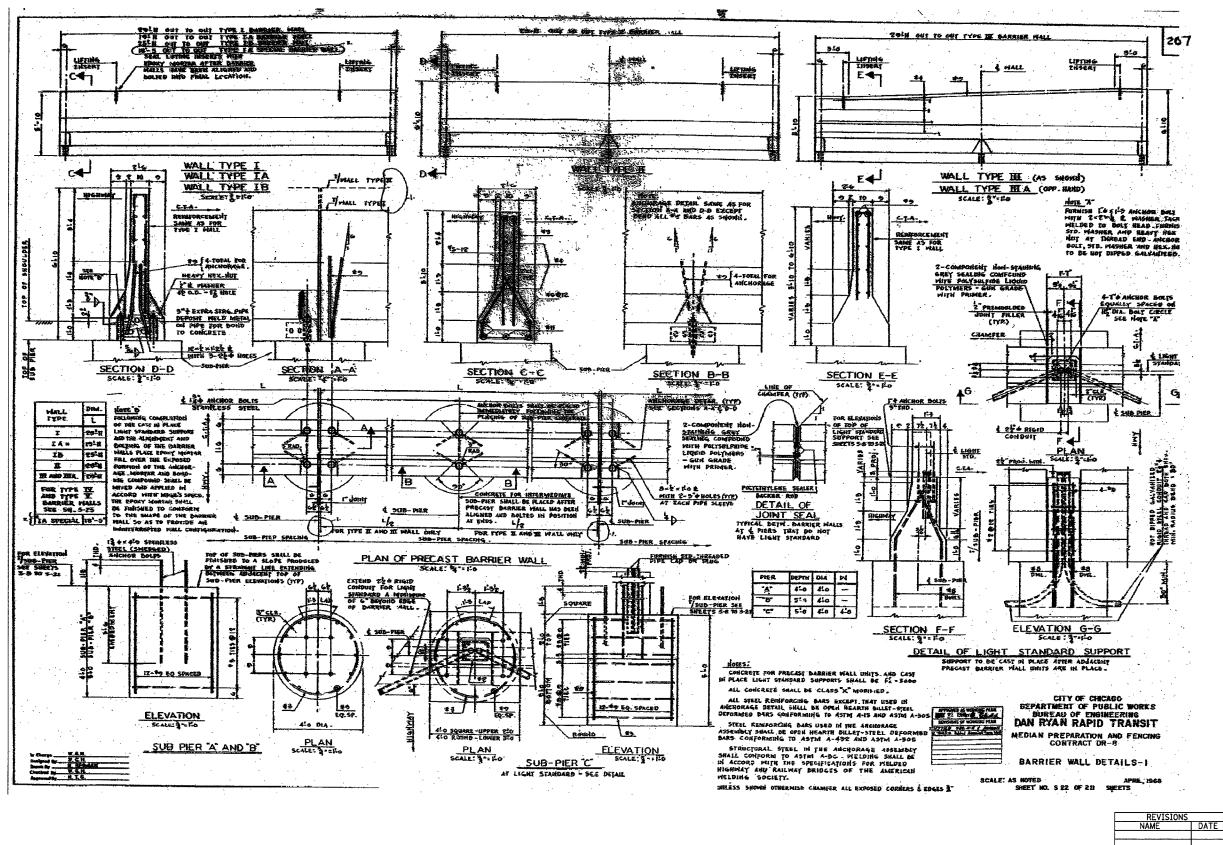


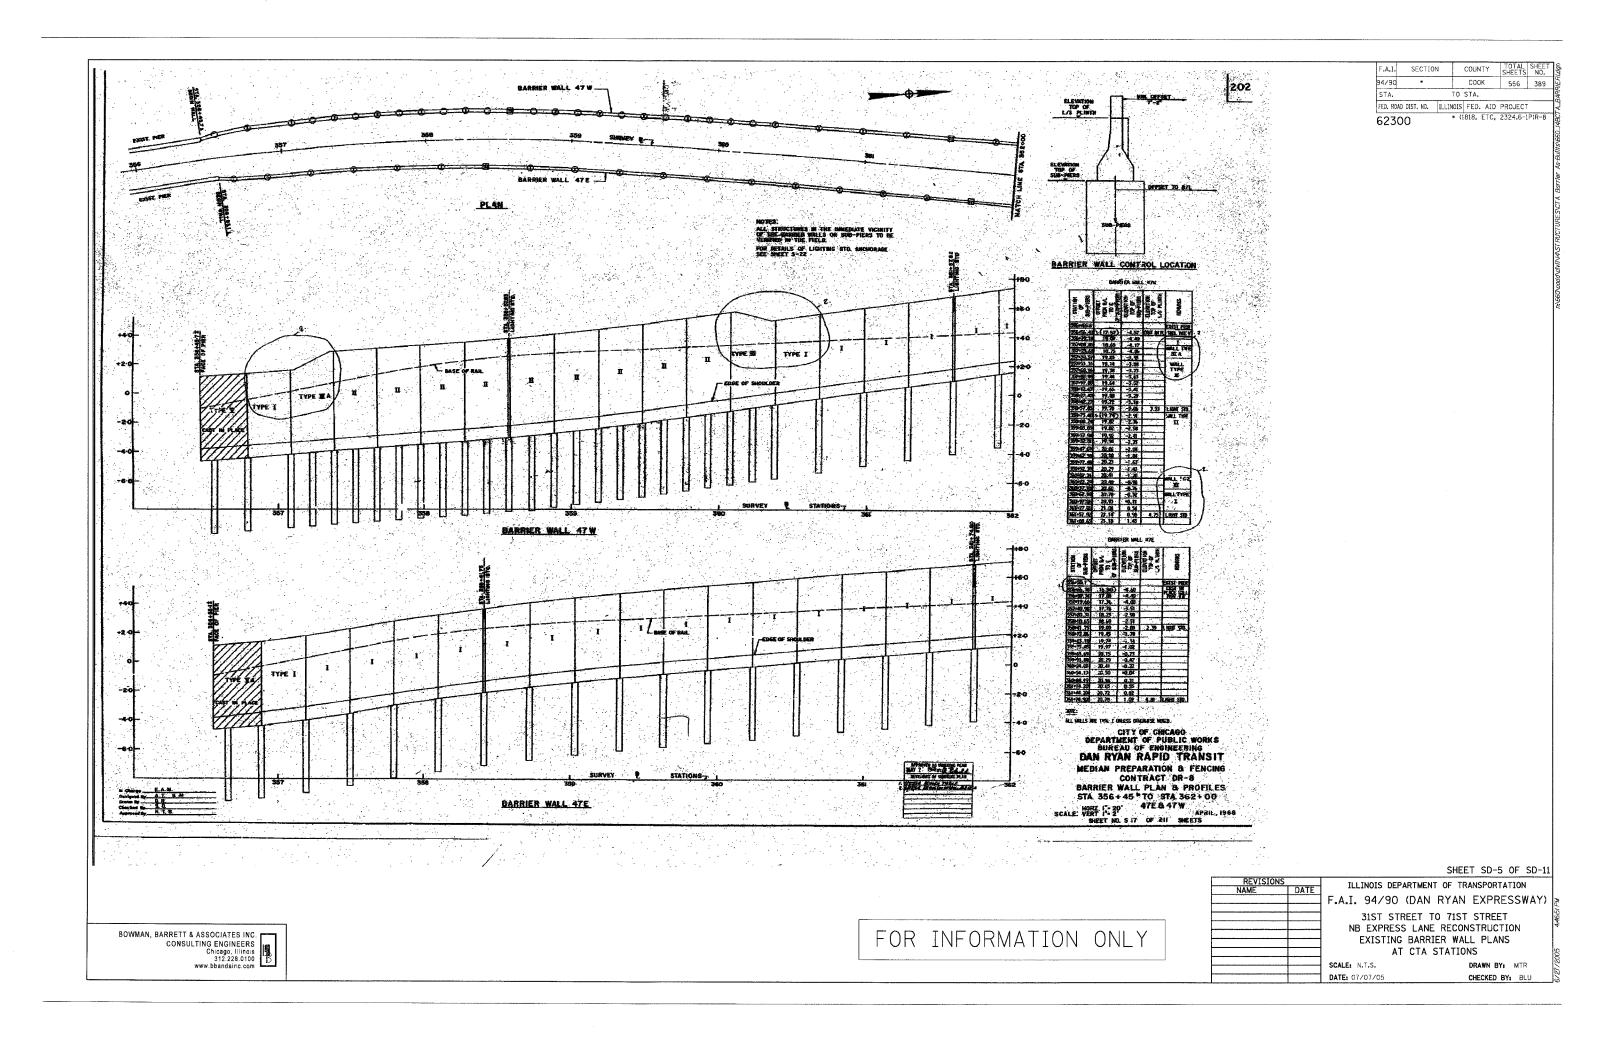

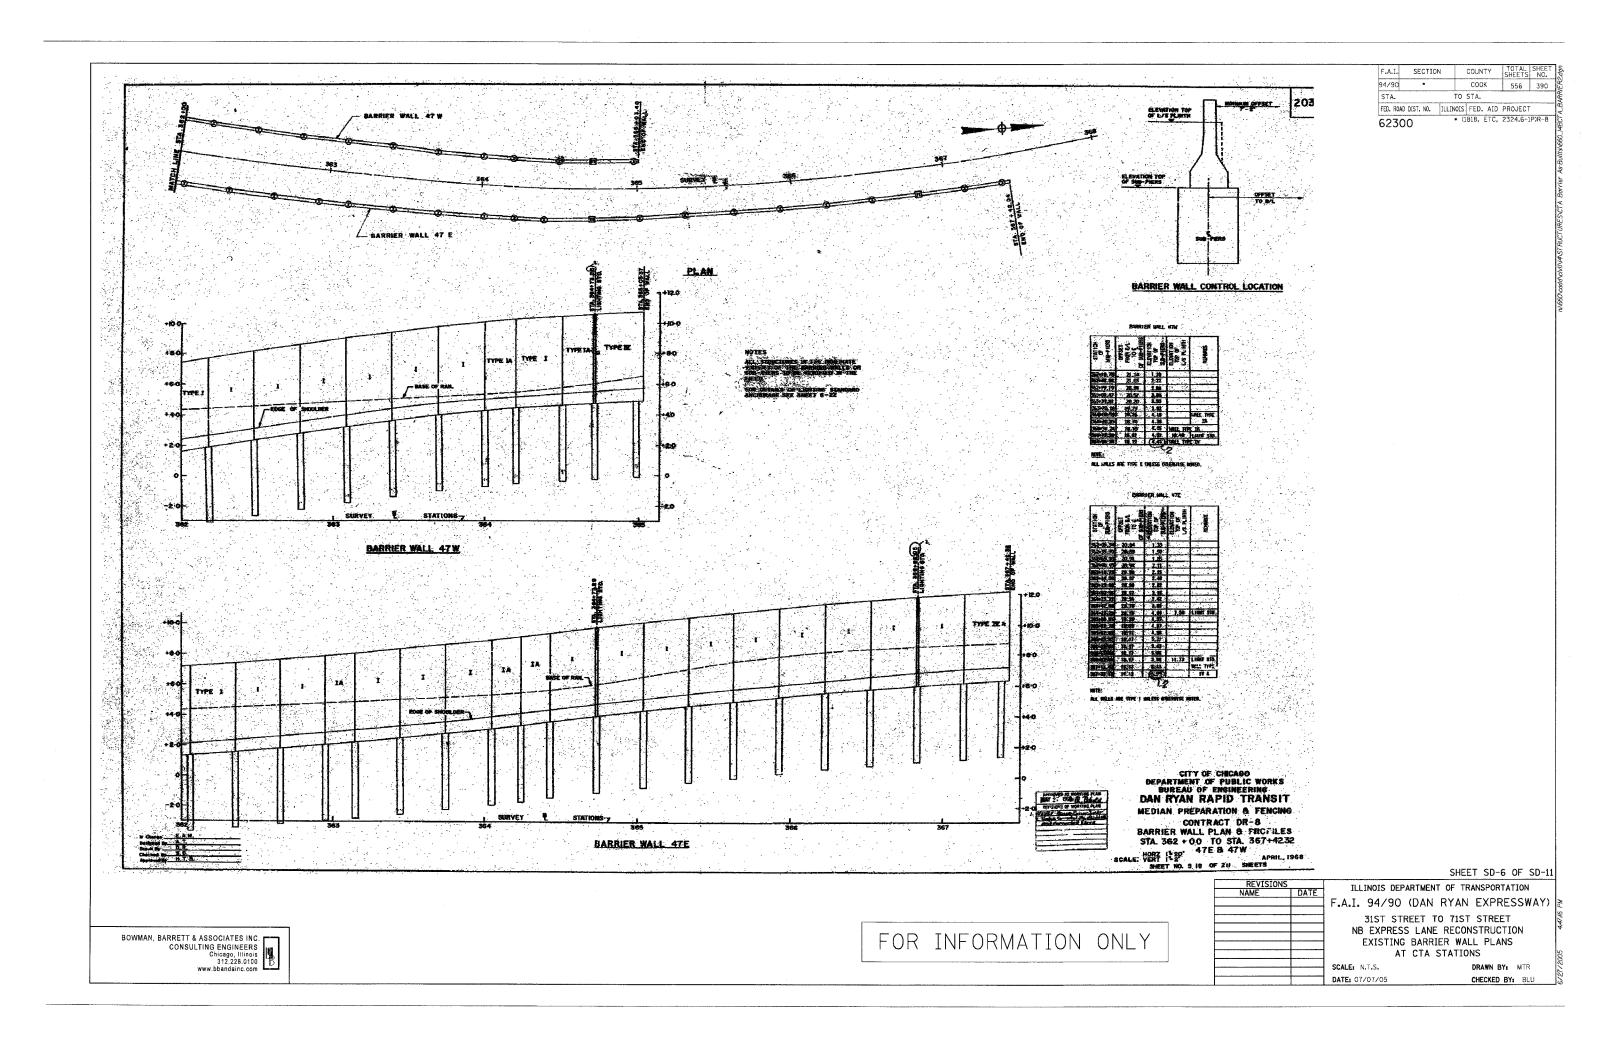

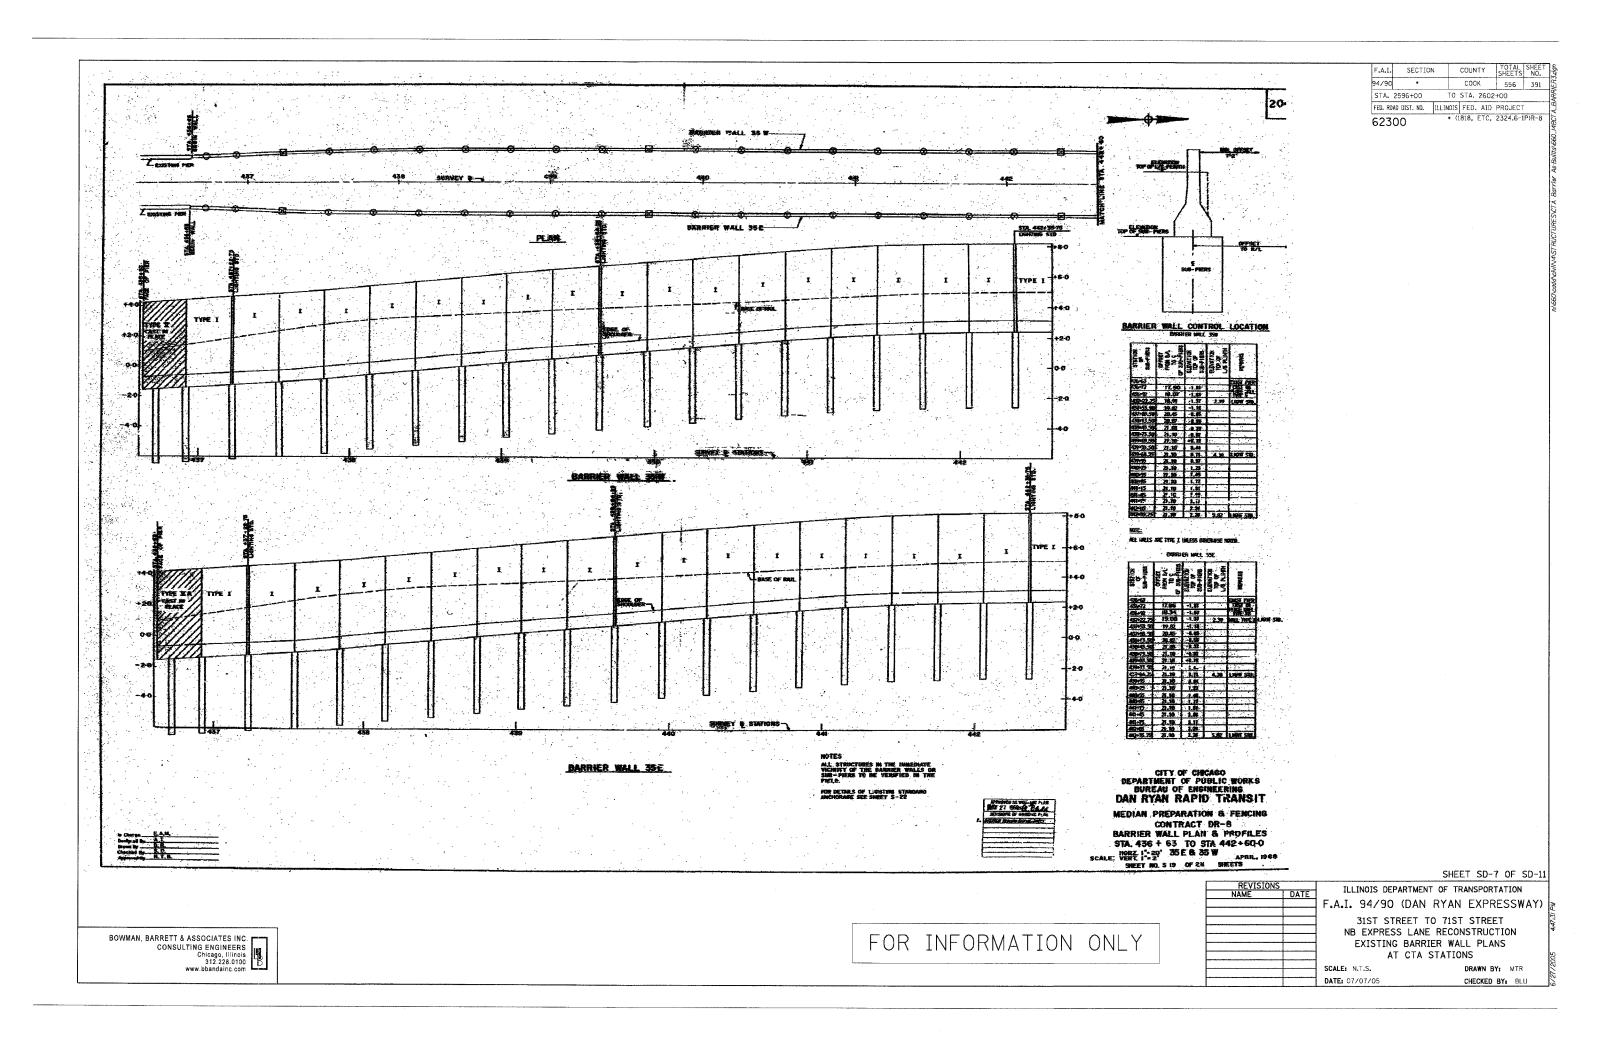

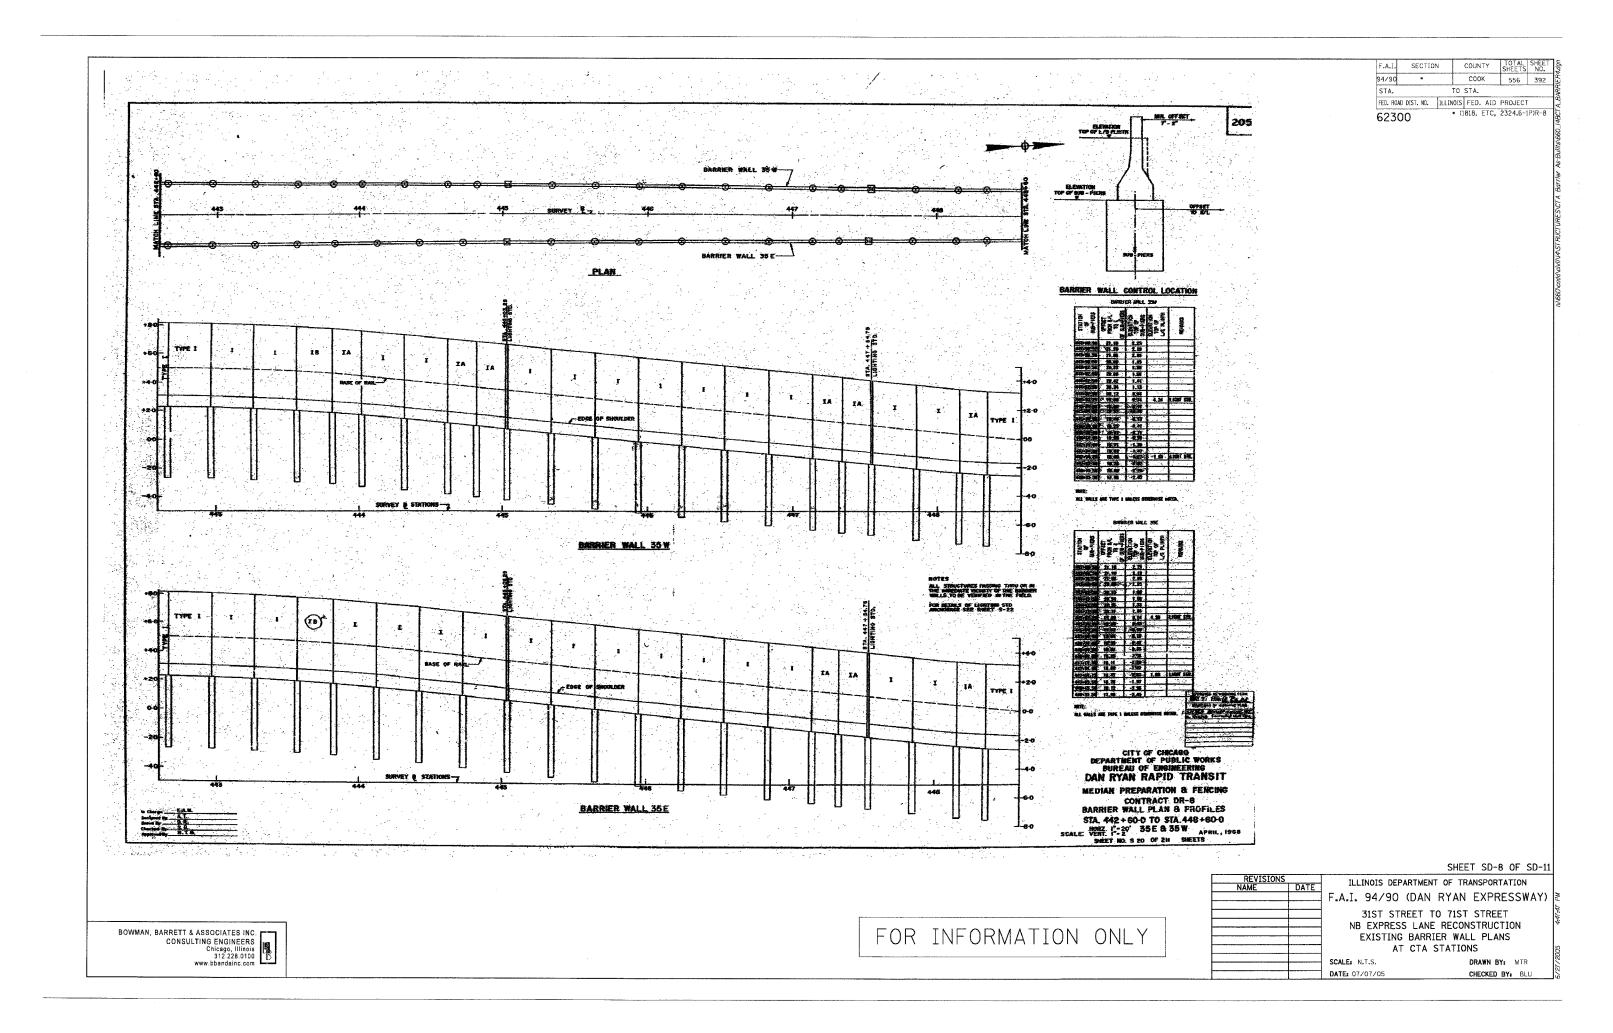

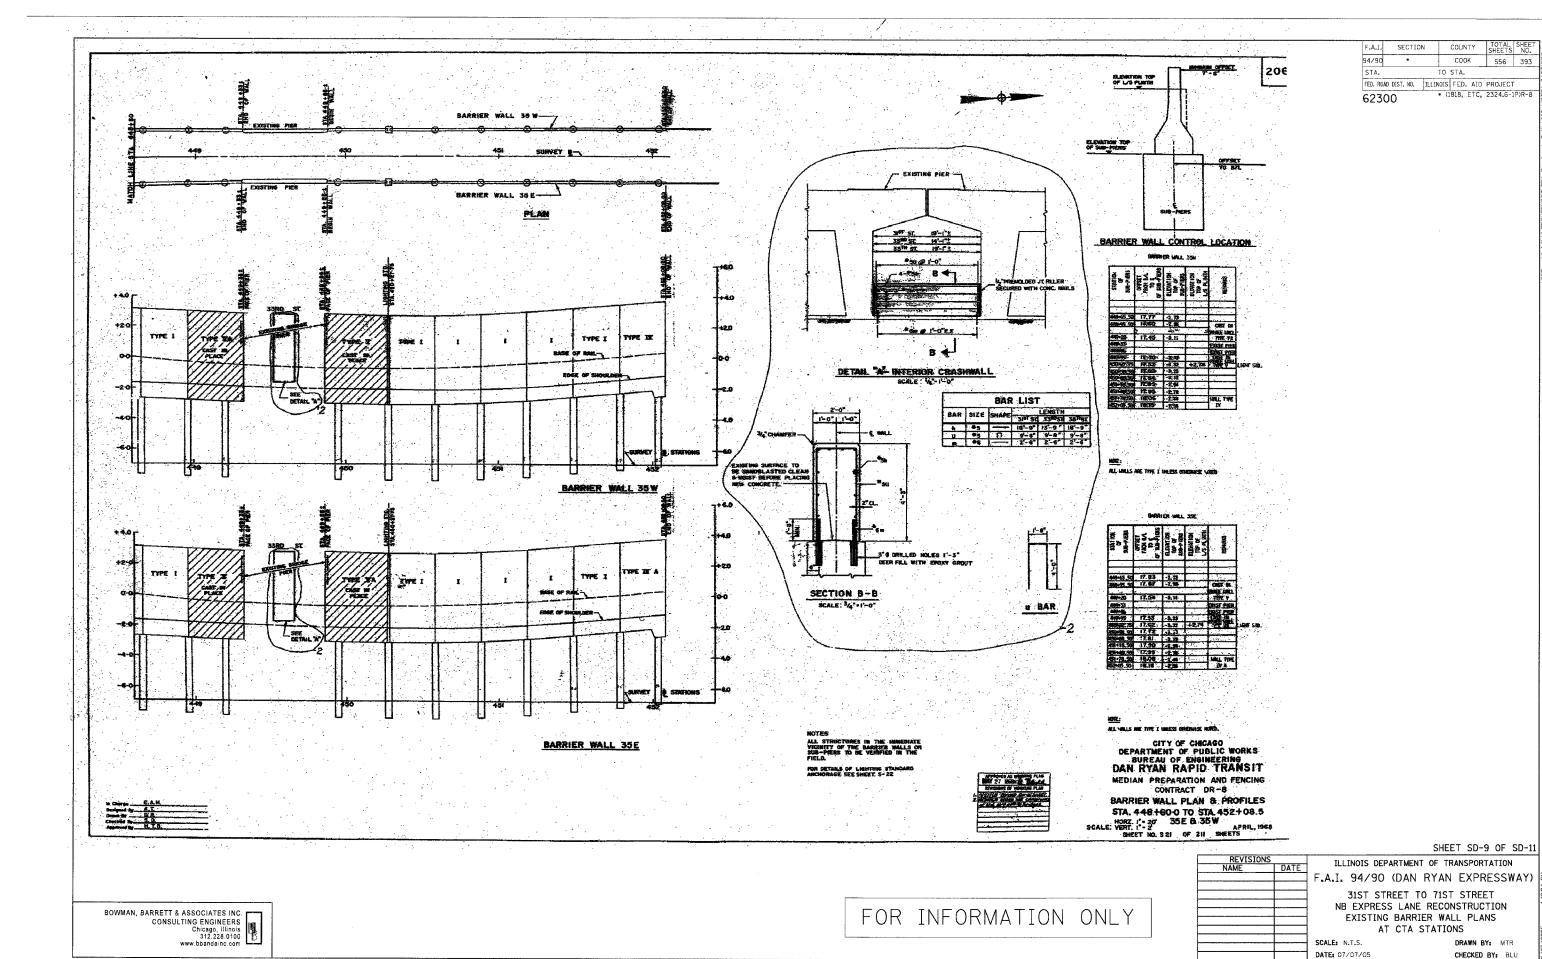

F.A.I. SECTION COUNTY SHEETS NO.

94/90 • COOK 556 394

STA. TO STA.

FED. ROAD DIST. NO. | ILLINOIS | FED. AID | PROJECT

62300 • (1818, ETC, 2324.6-1P)R-8

SHEET SD-10 OF SD-11

REVISIONS
NAME DATE

F.A.I. 94/90 (DAN RYAN EXPRESSWAY)

31ST STREET TO 71ST STREET

NB EXPRESS LANE RECONSTRUCTION

EXISTING BARRIER WALL PLANS


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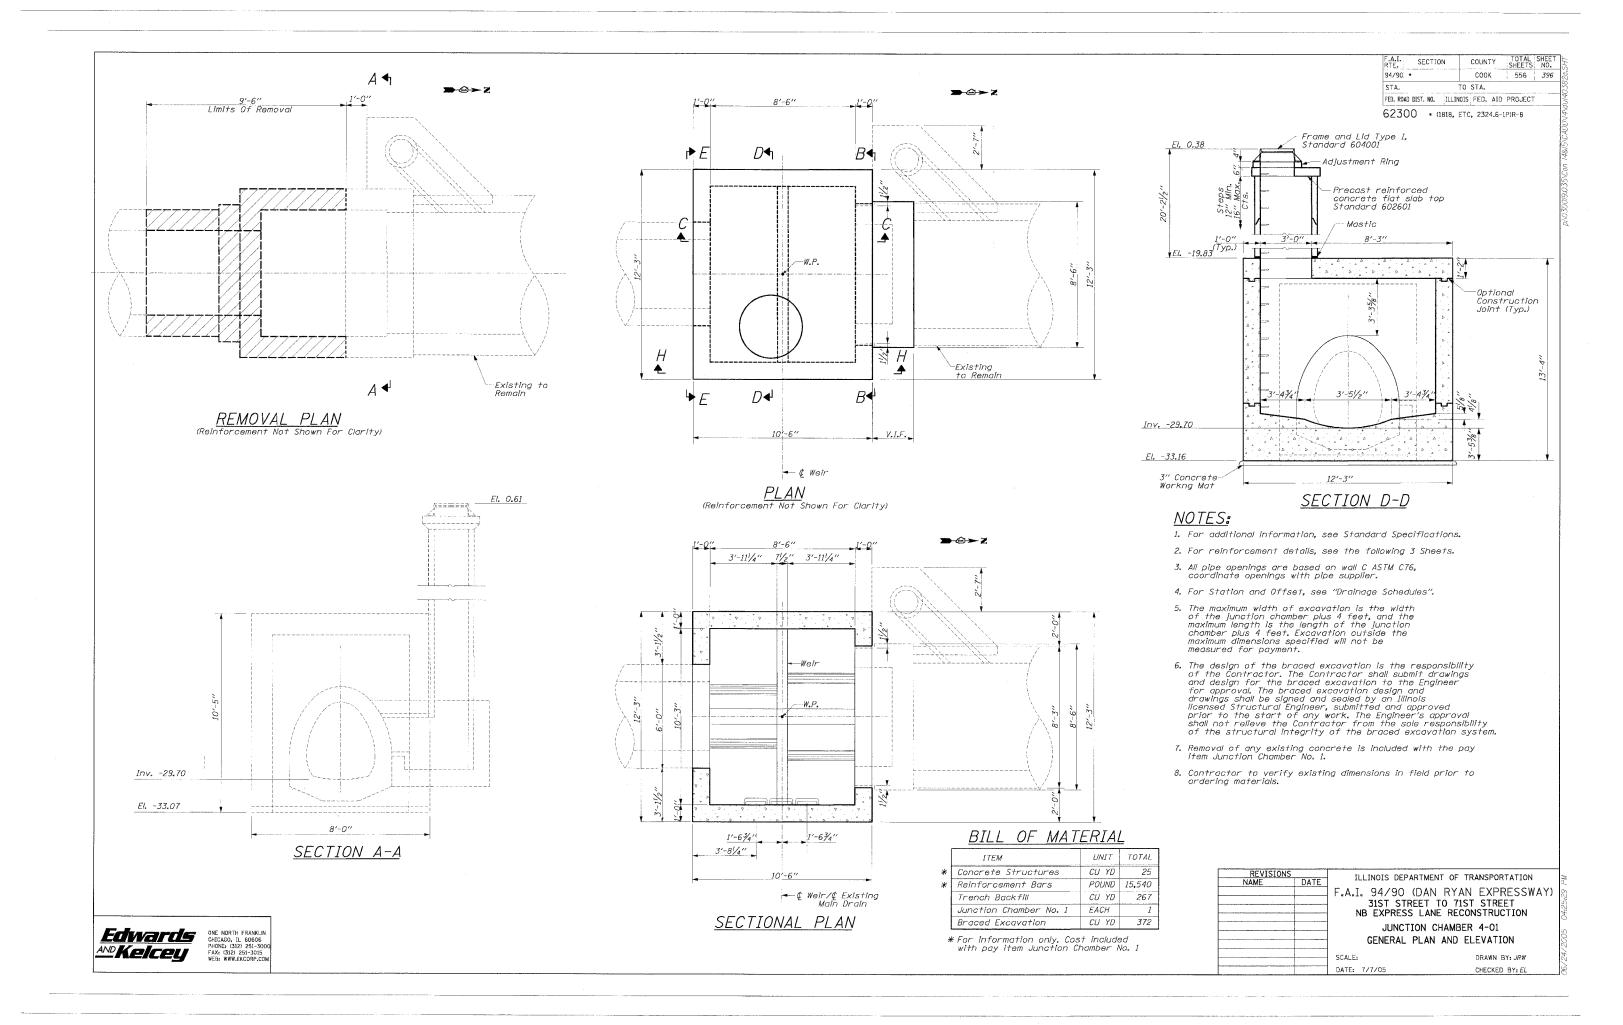
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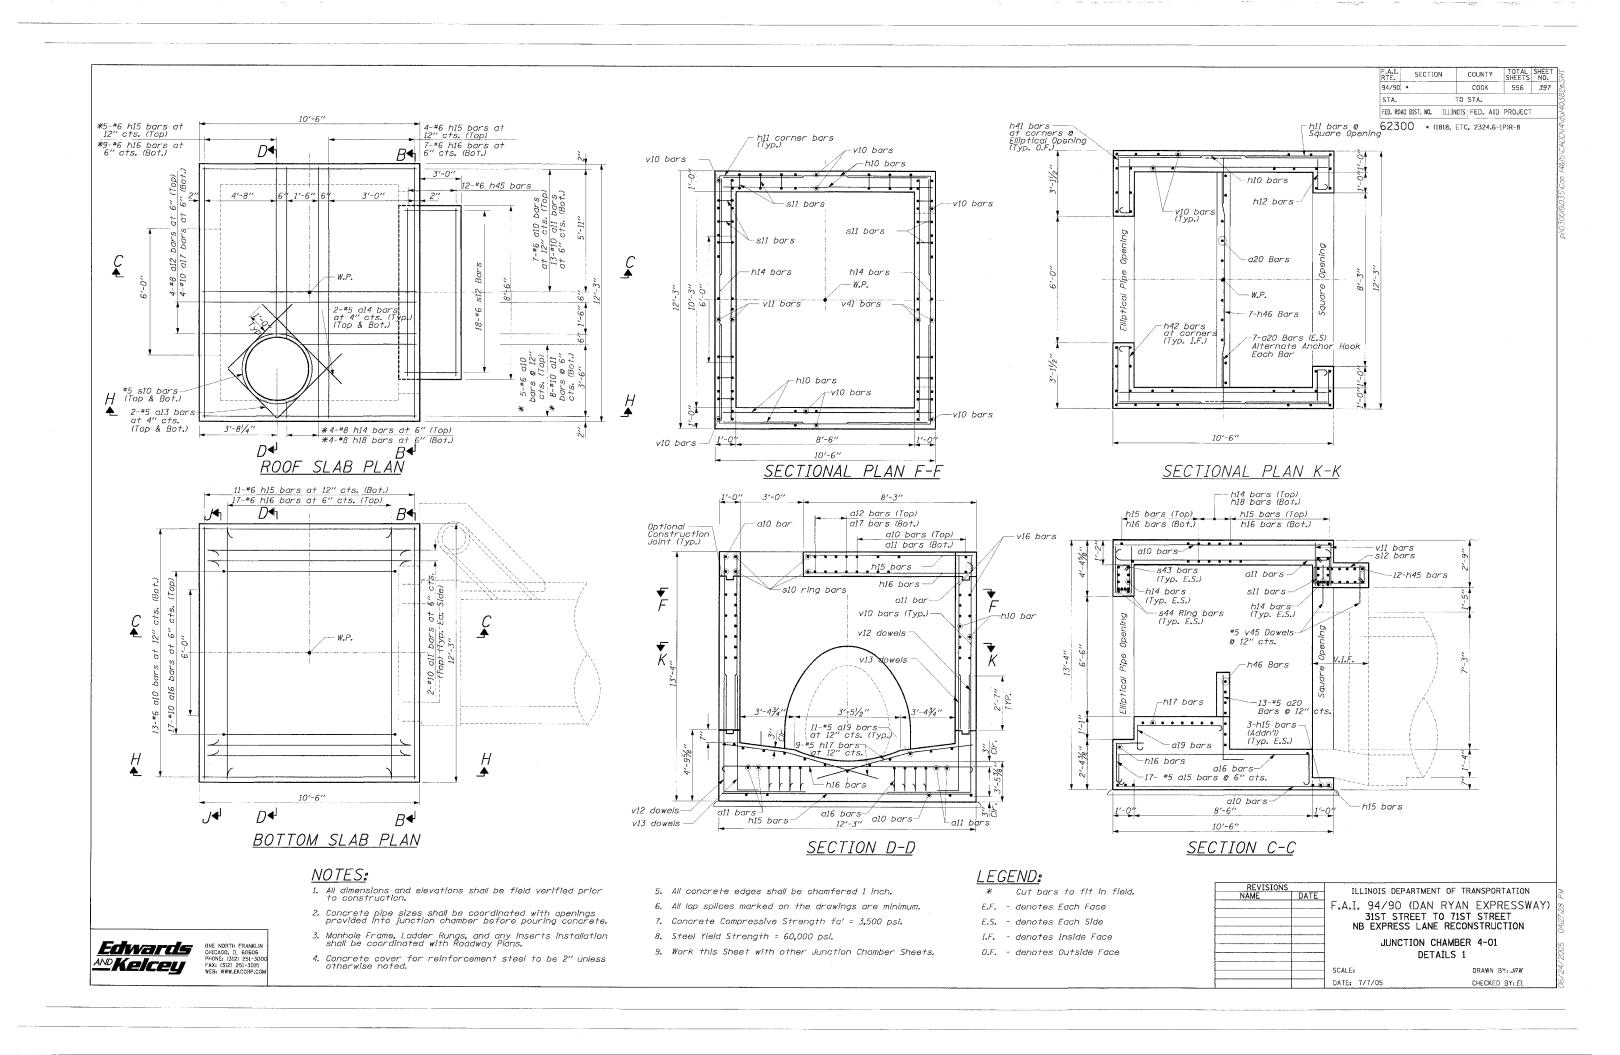
AT CTA STATIONS


FOR INFORMATION ONLY


BOWMAN, BARRETT & ASSOCIATES INC.
CONSULTING ENGINEERS
Chicago, Illinois
312.228.0100
www.bbandain.com





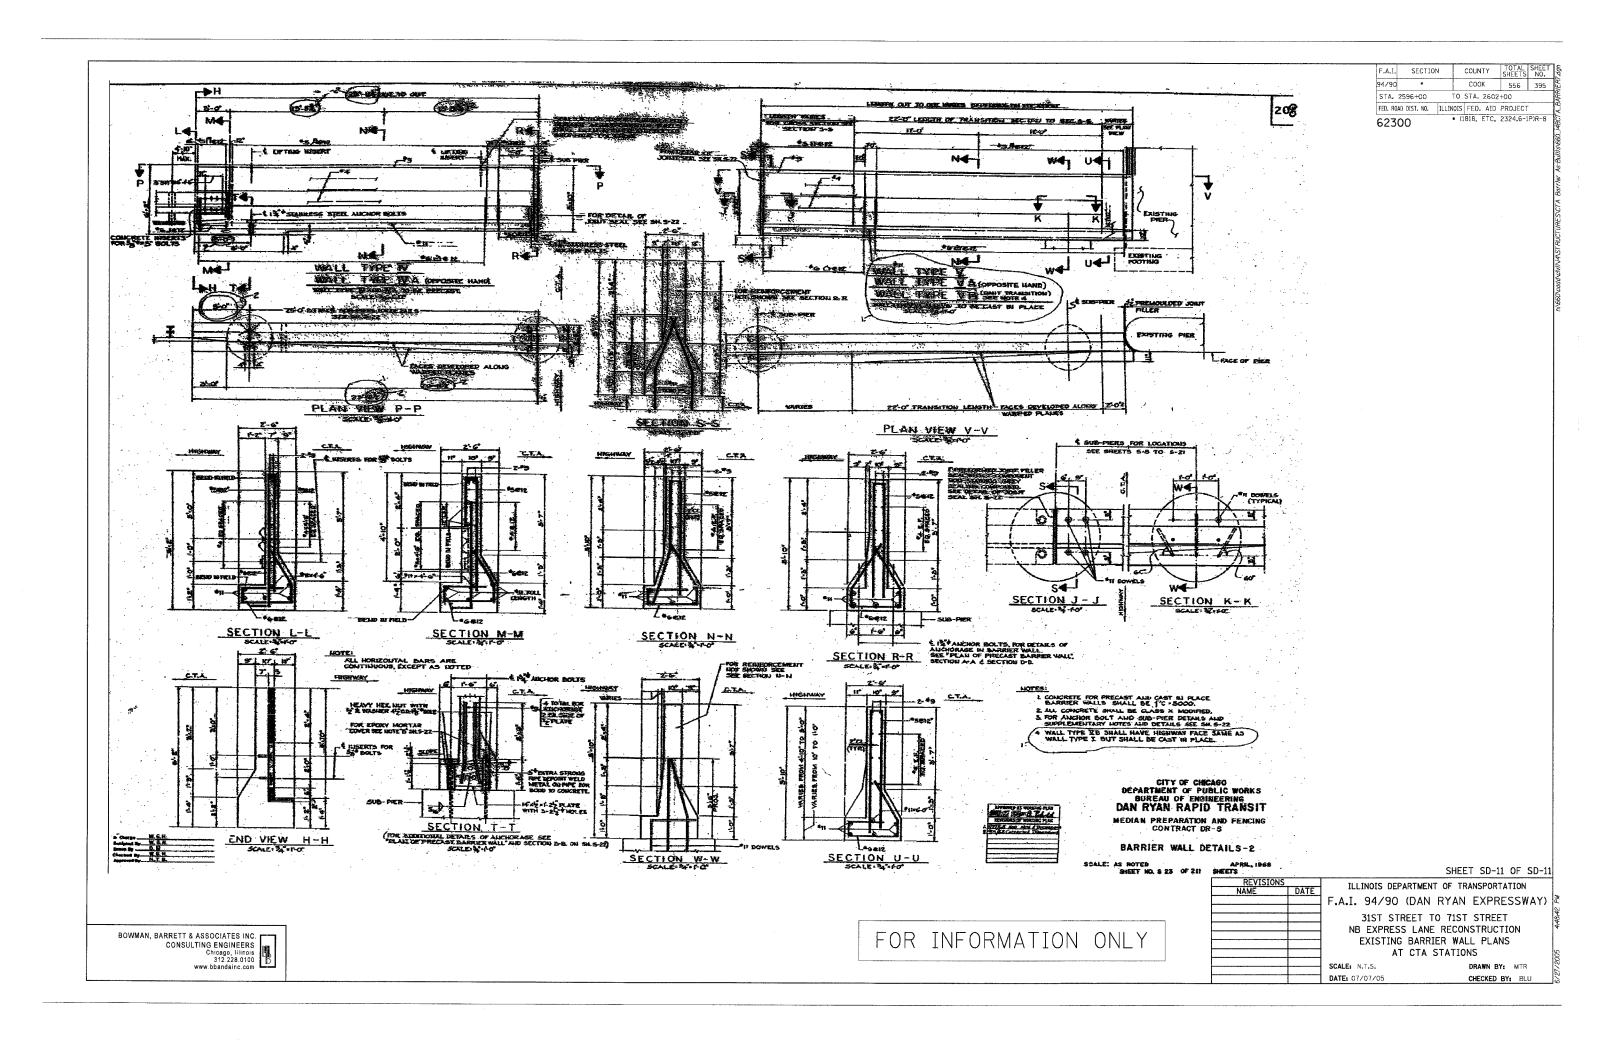

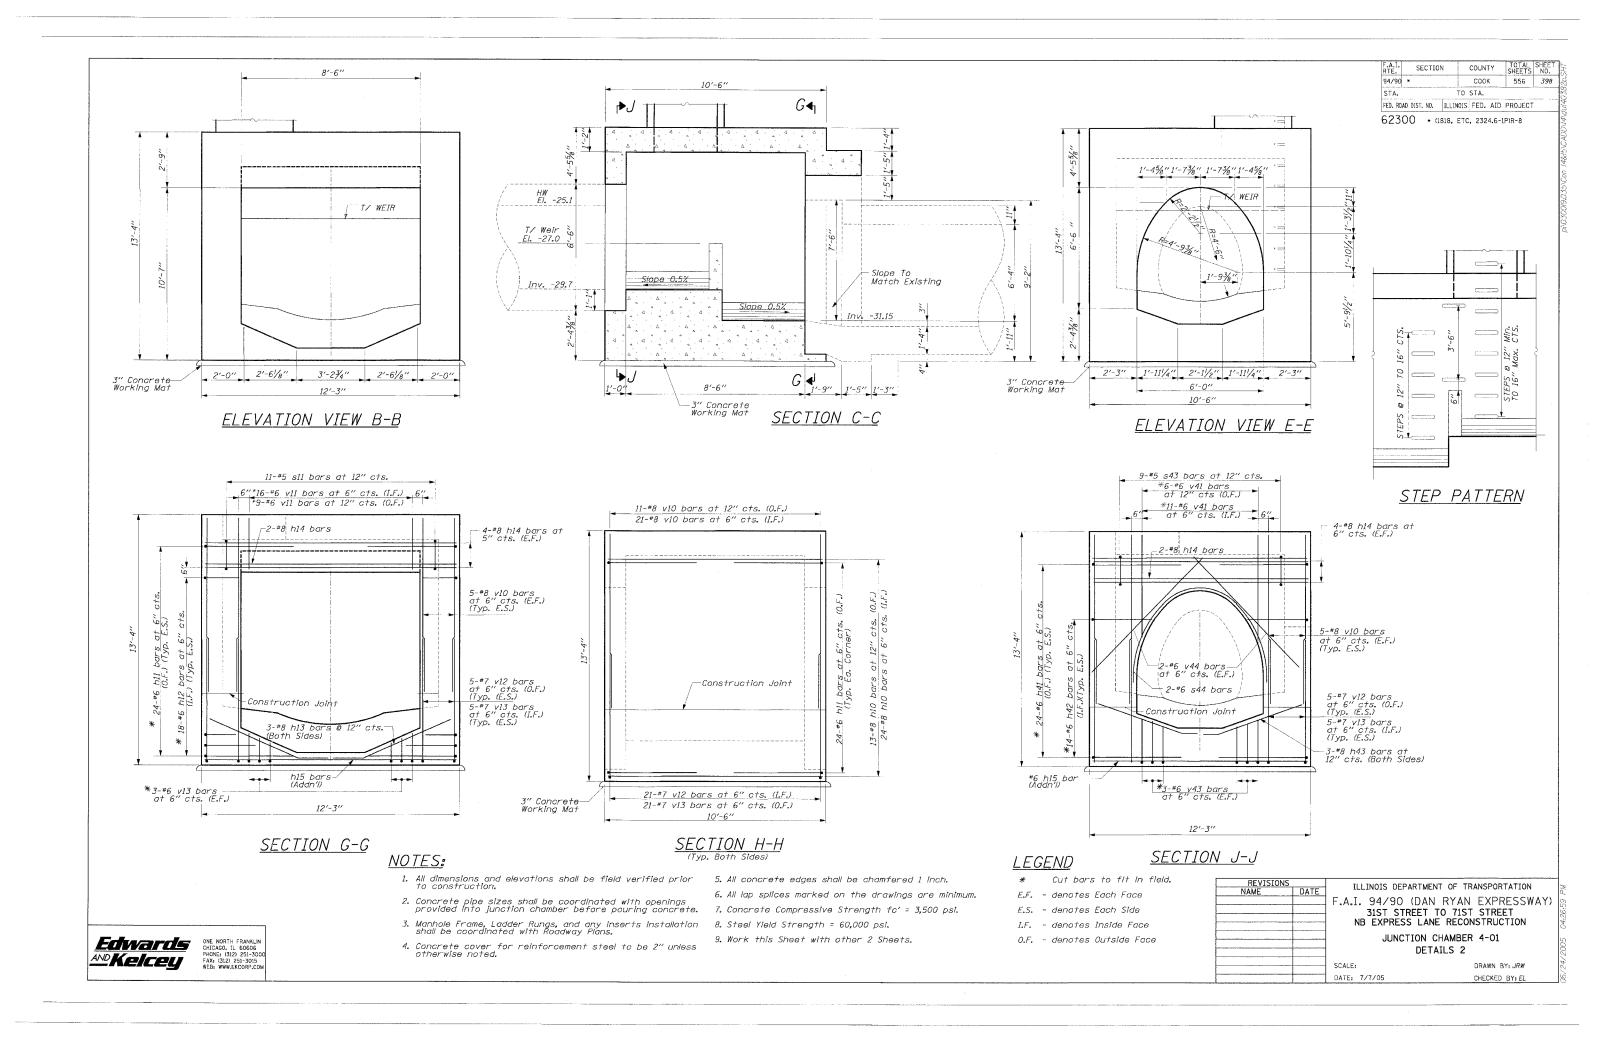

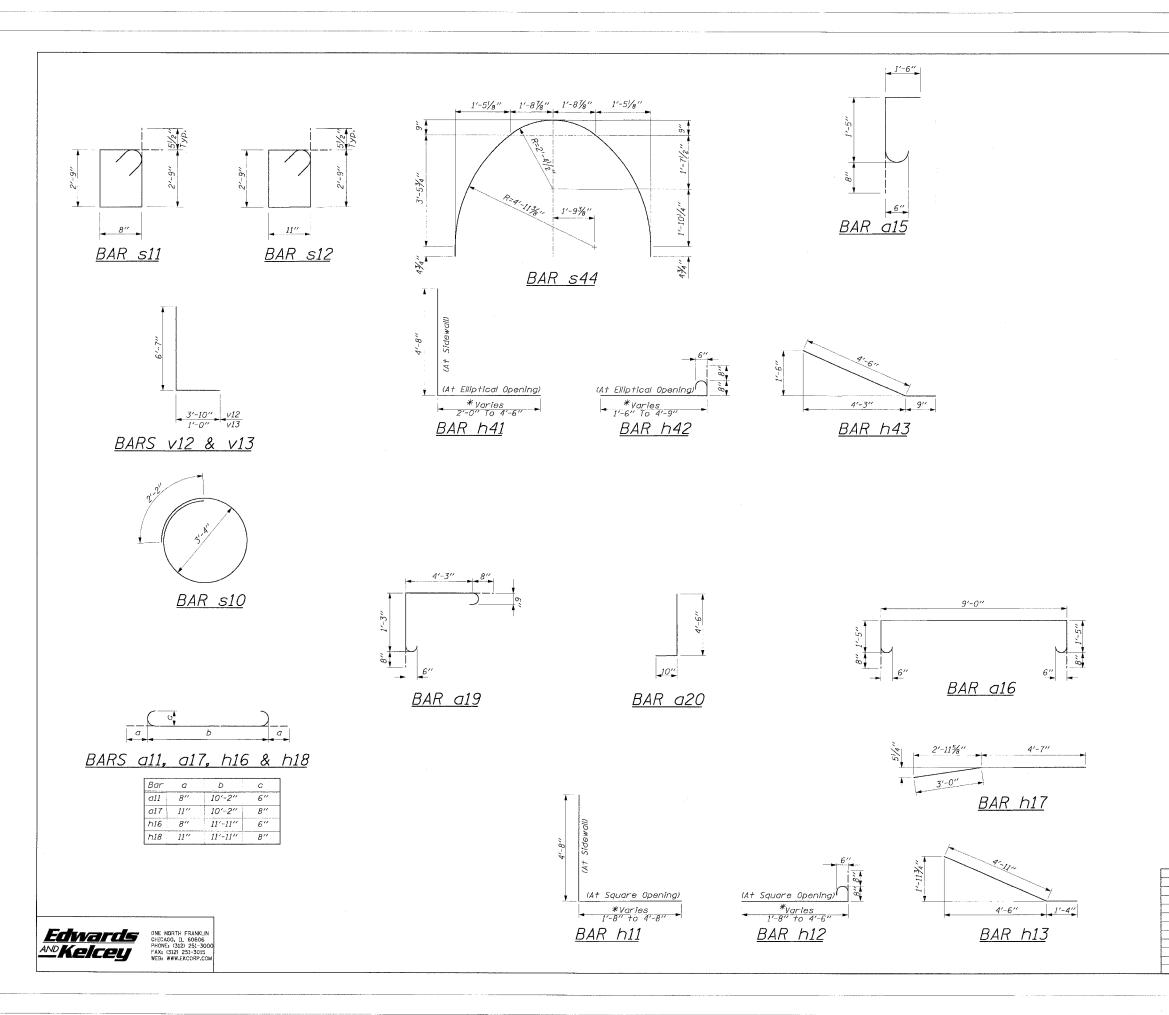

F.A.I. RTE. 94/90 * SECTION COUNTY TOTAL SHEE COOK 556 399 STA. TO STA.

FED. ROAD DIST. NO. ILLINOIS FED. AID PROJECT

62300 - (1818, ETC, 2324.6-1P)R-8

<u>BILL OF MATERIAL</u>

<u>JUNCTION CHAMBER 4-01</u>

	*			
Bar	No.	Size	Length	Shape
a10	25	#6	10'-2"	
a11	25	#10	11'-8''	ر ے
g12	4	#8	10'-2"	
a13	4	#5	5'-0"	
a14	4	#5	6'-0''	
a15	17	#5	3'-7"	
a16	17	#10	13'-2"	5 0
a17	4	#10	11'-6"	C 3
a19	11	#6	6'-10"	
		#5	5'-0"	5
a20	27		50	<u> </u>
h10	74	#8	10'-2''	
************************	48	#6	9'-4''	
h11	36	#6	9'-4''	<u> </u>
h12			6'-3''	
h13	6	#8		
h14	24	#8	11'-9''	
h15	. 24	#6	11'-9"	
h16	: 33	#6	13'-3''	ـــــــ
h17	18	#5	7'-7''	
h18	4	#8	13'-9''	
h41	48	#6	10'-2''	L
h42	28	#6	9'-2"	
h43	6	#8	5'-3''	· \
h45	12	#6	7'-11''	
h46	7	#5	9'-11''	
			,	
s10	2	#5	12'-8''	0
s11	11	#5	7'-10"	E
s12	18	#6	7'-4''	€
543	9	#5	8'-3''	E
s44	2	#6	12'-5"	\cap
v10	104	#8	8'-5"	
v11	. 25	#6	3'-0"	
v12	20	#7	10'-5"	
v13	20	#7	7'-7"	
V41	17	#6	7'-6"	
V44	4	#6	8'-6"	
v45	18	#5	2'-6"	
				i

A				
Reinforce	: ement	Bars	Lbs.	15,540
Concrete			Cu. Yd.	25
			٠	

NOTE:
Quantities included for information only. All quantities associated with the junction chamber are included with the pay item Junction Chamber No. 1 except for Braced Excavation and Trench Backfill which shall be paid for separately.

REVISIONS		ILLINOIS DEPARTMENT OF TRANSPORTATION
NAME	DATE	TELINOIS DEPARTMENT OF TRANSFORTATION
		F.A.I. 94/90 (DAN RYAN EXPRESSWAY)
		31ST STREET TO 71ST STREET
		NB EXPRESS LANE RECONSTRUCTION
		JUNCTION CHAMBER 4-01
		DETAIL 3

SCALE: DATE: 7/7/05

DRAWN BY: JRW CHECKED BY: EL

