

EXPIRES Nov. 30, 2006

EXPIRES November 30, 2005

SIGNED Cub w. Steffe July 7, 2005 EXPIRES NOVEMBER 30, 2005

FOR ALL OTHER BOWMANN, BARRETT SHEETS

JULY 7, 200\$ EXPIRES NOV. 30, 2006




EXPIRES NOVEMBER, 30, 2005 FOR ALL KAM ENGINEERING SHEETS

## PROJECT LOCATED IN THE CITY OF CHICAGO

DESIGN DESIGNATION DAN RYAN EXPRESSWAY 15,309 (35) ARTERIAL (PCC 30)

TRAFFIC VOLUMES AND SPEEDS DESIGN SPEED POSTED SPEED NB EXPRESS

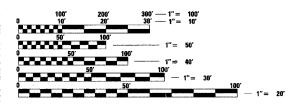

ENGINEERING SCALES, REDUCED SIZED PLANS WILL NOT CONFORM TO STANDARD SCALES. IN MAKING MEASUREMENTS ON REDUCED PLANS, THE ABOVE SCALES MAY BE USED.

FOR UTILITY LOCATION INFORMATION FOR EXCAVATION CALL CHICAGO UTILITY ALERT NETWORK (C.U.A.N.) 312-744-7000.

CONTRACT 62300

STATE OF ILLINOIS

**DEPARTMENT OF TRANSPORTATION** 

**DIVISION OF HIGHWAYS** 


# **PROPOSED HIGHWAY PLANS**

F.A.I. ROUTE 94/90 (DAN RYAN EXPRESSWAY) (I-94/90-NB)

31ST STREET TO 71ST STREET (NB EXPRESS LANES) ROADWAY RECONSTRUCTION

**SECTION** (1818, ETC, 2324.6–1P)R–8 PROJECT: IM-094-3(397)055 COOK COUNTY C-91-417-01



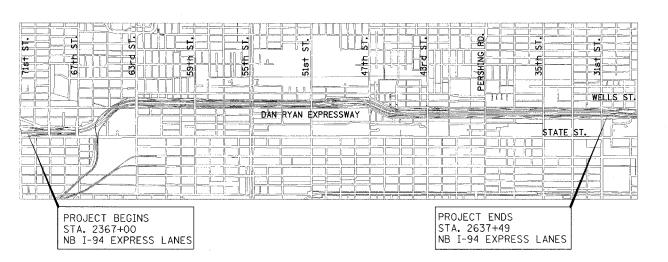

**LOCATION MAP** 

NET LENGTH OF IMPROVEMENT 27,050 ft. = 5.123 mi. GROSS LENGTH OF IMPROVEMENT 27,050 ft. = 5.123 mi.


Dan Ryan Contract 14

62300

COOK 

• (1818, ETC, 2324.6-1P)R-8 559



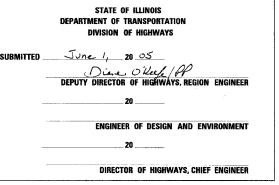



ONE NORTH FRANKLIN SUITE 500 CHICAGO, IL 60606



& ASSOCIATES SUITE 2650 130 E. RANDOLPH ST. CHICAGO, IL 60601

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RTE.	SECTION	COUNTY	SHEETS	SHEET NO.
94/90	*	соок	556	2
STA.		TO STA.		
FED. ROA	D DIST. NO ILLIN	OIS FED. AID	PROJECT	

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	CTA WALL AS-BUILT PLANS AT STATIONS
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	METRA AND CONRAIL BRIDGE SUBSTRUCTURE REPAIR
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<b>Edwards</b>	ONE NORTH FRAM CHICAGO, IL 606
<sup>AND</sup> Kelceu	PHONE: (312) 251 FAX: (312) 251-3
	WEB: WWW.EKCOR

REVISIO	NS	THE THINTS DEDARTME	ENT OF TRANSPORTATION
NAME	DATE	ILLINOIS DEFARTME	ENT OF TRANSPORTATION
		F.A.I. 94/90 (DAI	N RYAN EXPRESSWAY
		31ST STREET	TO 71ST STREET
		NB EXPRESS LA	NE RECONSTRUCTION
		THORN	AP 01.FFF6
		INDEX	OF SHEETS
		SCALE:	DRAWN BY: LPN
		DATE: 7/7/05	CHECKED BY: PJM

#### GENERAL NOTES

- 1. USE NO. 8 EPOXY-COATED TIE BARS CONFORMING TO ARTICLE 1006.10(B)(2) OF THE STANDARD SPECIFICATIONS FOR LONGITUDINAL CONSTRUCTION JOINT GROUTED-IN-PLACE TIE BAR AS SHOWN ON STATE STANDARD 420001 AND FOR TYING P.C.C. WIDENING TO EXISTING CONCRETE PAVEMENT AS SHOWN ON THE PLANS. THE TIE BARS WILL NOT BE PAID FOR SEPARATELY BUT SHALL BE INCLUDED IN THE COST OF THE PAVEMENT ITEMS BEING CONSTRUCTED.
- 2. UTILITY LOCATIONS SHOWN ON THESE PLANS MAY NOT BE CORRECT OR COMPLETE, THE CONTRACTOR SHALL COORDINATE CONSTRUCTION ACTIVITIES WITH THE RESPECTIVE UTILITY COMPANIES AND THE CITY OF CHICAGO, BEFORE STARTING ANY EXCAVATION, THE CONTRACTOR SHALL CALL THE CHICAGO UTILITY ALERT NETWORK AT (312) 744-7000 FOR FIELD LOCATIONS OF BURIED ELECTRICAL, TELEPHONE, CABLE, AND GAS FACILITIES (48 HOURS NOTIFICATION IS REQUIRED). CONTACT THE CHICAGO DEPARTMENT OF WATER MANAGEMENT PERMIT SECTION AT (312) 747-7893 FOR WATER AND SEWER LOCATIONS.
- 3. WHERE SECTION AND SUBSECTION MONUMENTS ARE ENCOUNTERED, THE ENGINEER SHALL BE NOTIFIED BEFORE SUCH MONUMENTS ARE REMOVED. THE CONTRACTOR SHALL PROTECT AND CAREFULLY PRESERVE ALL PROPERTY MARKS AND MONUMENTS. THE ENGINEER OR AN AUTHORIZED SURVEYOR AGENT WILL WITNESS OR OTHERWISE REFERENCE AND RESET MONUMENTS AS NECESSARY, ALL PROPERTY CORNERS EXCEPT THOSE WITHIN AREAS WHERE THE SCHEDULE, IF PROVIDED, SHOWS PLACEMENT OF RIGHT OF WAY MARKERS SHALL REMAIN LINITED THESE
- 4. THE CONTRACTOR SHALL NOT SET UP A YARD OR FIELD OFFICE ON I.D.O.T. PROPERTY WITHOUT WRITTEN PERMISSION FROM I.D.O.T.
- 5. THE CONTRACTOR SHALL TAKE ALL NECESSARY SAFETY PRECAUTIONS TO PROTECT AND PROVIDE ACCESS TO ABUTTING PROPERTY, UTILITIES, PEDESTRIANS, AND VEHICULAR TRAFFIC.
- 6. BARRICADES: THE CONTRACTOR SHALL PROVIDE AND INSTALL TWO WEIGHTED SAND BAGS ON EACH TYPE I OR TYPE II BARRICADE USED (ONE WEIGHTED BAG ACROSS EACH BOTTOM RAIL). ALL TYPE III BARRICADES SHALL REQUIRE A MINIMUM OF FOUR SAND BAGS PER BARRICADE.
- 7. WHEN ARTIFICIAL LIGHTING IS UTILIZED IN NIGHT OPERATIONS. THE CONTRACTOR SHALL EXERCISE THE UTMOST PRECAUTION IN PREVENTING ADVERSE VISIBILITY TO THE MOTORING PUBLIC AND THE ADJOINING COMMERCIAL AND RESIDENTIAL AREAS.
- 8. ALL ELEVATIONS IN THIS PLAN SET ARE IN THE CHICAGO CITY DATUM (CCD). THE FOLLOWING CONVERSION FACTOR IS USED FOR CONVERTING CCD TO NAVD 88: NAVD 88 ELEVATION = CCD + 579.19
- 9. THE CONTRACTOR SHALL USE CARE IN GRADING OR EXCAVATING NEAR ANY AND ALL EXISTING ITEMS THAT WILL NOT BE REMOVED. ANY DAMAGE DONE TO EXISTING ITEMS BY THE CONTRACTOR SHALL BE REPAIRED BY THE CONTRACTOR AT THE CONTRACTOR'S OWN EXPENSE.
- 10. THE CONTRACTOR SHALL MAINTAIN THE SURFACE DRAINAGE OF ALL ROADWAYS DURING CONSTRUCTION OF THIS PROJECT. WHEN EXISTING DRAINAGE FACILITIES ARE DISTURBED, THE CONTRACTOR SHALL PROVIDE AND MAINTAIN TEMPORARY OUTLETS AND CONNECTORS FOR ALL PRIVATE OR PUBLIC DRAINS, SEWERS, INLETS AND CATCH BASINS. THE CONTRACTOR SHALL PROVIDE FACILITIES TO TAKE IN ALL STORM WATER WHICH WILL BE RECEIVED BY THESE DRAINS AND SEWERS AND DISCHARGE THE SAME. THE CONTRACTOR SHALL PROVIDE AND MAINTAIN A TEMPORARY OUTLET, AND BE PREPARED AT ALL TIMES TO DISPOSE OF THE WATER RECEIVED FROM THESE TEMPORARY CONNECTIONS UNTIL INSTALLATION IS COMPLETE INCLUDING PAVEMENT. THIS WORK SHALL NOT BE PAID FOR DIRECTLY BUT SHALL BE CONSIDERED INCLUDED IN THE CONTRACT.
- 11. ON STATE STANDARD 483001, SUB-BASE GRANULAR MATERIAL, TYPE B 24", SHALL BE USED AS THE IMPROVED SUBGRADE. THE ADDITIONAL THICKNESS OF SUB-BASE GRANULAR MATERIAL UNDER THE SHOULDER SHALL BE INCLUDED IN THE COST PER SQUARE YARD OF "SUB-BASE GRANULAR MATERIAL, TYPE B 24"".
- 12. ALL STORM SEWER CONNECTIONS WITH PIPES 27 INCH DIAMETER AND SMALLER SHALL BE MADE WITH PRECAST "TEE" OR "WYE" PIPES. FOR PROPOSED STORM SEWER PIPES LARGER THAN 27 INCH DIAMETER, OPENINGS OF THE SPECIFIED DIAMETER SHALL BE MADE IN THE PIPE AT THE SAME TIME IT IS MANUFACTURED. PRECAST "TEE" OR "WYE" PIPE CONNECTIONS FOR THE PROPOSED STORM SEWER WILL NOT BE PAID FOR SEPARATELY BUT WILL BE INCLUDED IN THE COST FOR THE STORM SEWER.

14. THE	UNIT WEIGHT	USED FOR AL	L BITUMINOUS	SURFACE	MIXTURES	IS 112	LB/SQ YD/IN.

- 15. LOCATIONS OF ACCESS CONTROL FENCING AS SHOWN ON THE PLANS MAY BE ADJUSTED AS DIRECTED BY THE ENGINEER TO BETTER FIT FIELD CONDITIONS.
- 16. IT SHALL BE THE CONTRACTOR'S RESPONSIBILITY TO ENSURE THAT NO GAP REMAINS BETWEEN PROPOSED FENCING OR WHERE PROPOSED FENCING TERMINATES AND EXISTING FENCE REMAINS IN PLACE.
- 17. THE LOCATION OF VARIOUS ITEMS SUCH AS PAVEMENT, BARRIER WALLS, AND DRAINAGE STRUCTURES BUILT IN CONTRACTS UNDER CONSTRUCTION DURING THE PREPARATION OF THESE PLANS IS BASED ON THE PUBLISHED CONTRACT PLAN DRAWINGS AVAILABLE DURING DESIGN. THE CONTRACTOR MUST FIELD VERIFY LIMITS, LOCATIONS AND ELEVATIONS OF THESE PREVIOUSLY CONSTRUCTED ITEMS.
- 18. TEN FOOT TRANSITIONS SHALL BE USED TO MATCH PROPOSED CURB AND GUTTER AND MEDIAN ITEMS OF WORK TO EXISTING CURB AND GUTTERS AND MEDIANS IN THE FIELD, UNLESS OTHERWISE. SHOWN. THE TRANSITIONS SHALL BE PAID FOR AT THE CONTRACT UNIT PRICE FOR THE PROPOSED ITEMS OF WORK SPECIFIED.
- 19. TEMPORARY CONCRETE BARRIER THE BARRIER UNIT AT EACH END OF THE INSTALLATIONS SHALL BE SECURED TO THE PAVEMENT OR SHOULDER USING THREE ANCHORING PINS FOR F SHAPE OR THREE DOWEL BARS FOR NEW JERSEY SHAPE.
- 20. HAMMER DRIVING OF PILES WILL NOT BE ALLOWED. ALL PILES MUST BE VIBRATED INTO PLACE.
- 21. CRUSHING PLANT AND CONCRETE PLANT LOCATIONS REQUIRE CITY OF CHICAGO APPROVAL.

F.A.I. RTE.	SECTION	1	COUNTY	TOTAL	SHEET NO.
94/90	<b>*</b>		COOK	556	3
STA.		TO	STA.		
FED. ROA	D DIST. NO	ILLINOIS	FED. A	ID PROJECT	

#### LIST OF STANDARDS

62300 \* (1818, ETC, 2324.6-1P)R-8

000001-04	STANDARD SYMBOLS, ABBREVIATIONS, AND PATTERNS
280001 - <b>02</b>	TEMPORARY EROSION CONTROL SYSTEMS
420001- <b>06</b>	PAVEMENT JOINTS
420111 - <b>01</b>	PCC PAVEMENT ROUNDOUTS
420401 <i>-05</i>	BRIDGE APPROACH PAVEMENT
421001 <i>-01</i>	BAR REINFORCEMENT FOR CONTINUOUSLY REINFORCED PCC PAVEMENT
421201 <b>-04</b>	7.2M (24') CRC PAVEMENT (WITH LUG SYSTEM)
421206 - <b>04</b>	10.8M (36') CRC PAVEMENT (WITH LUG SYSTEM)
483001 <b>-02</b>	PCC SHOULDER
602001	CATCH BASIN, TYPE A
602101 <i>-01</i>	DRAINAGE STRUCTURES, TYPES 1, 2, & 3
602301	INLET, TYPE A
602401	MANHOLE, TYPE A
602406 <b>-0</b> 1	MANHOLE, TYPE A, 1800mm (72") DIAMETER
602601	PRECAST REINFORCED CONCRETE FLAT SLAB TOP
602701	CAST IRON STEPS
604001 - <i>0</i> 2	FRAME AND LID, TYPE 1
604071 - <i>0</i> 2	FRAME AND GRATE, TYPE 20
604076 <b>-<i>0</i>2</b>	FRAME AND GRATE, TYPE 21
604081 - <i>0</i> 2	FRAME AND GRATES, TYPE 22
630301 <i>- <b>03</b></i>	SHOULDER WIDENING FOR TYPE 1 (SPECIAL) GUARDRAIL TERMINALS
631031 - <i>0<b>5</b></i>	TRAFFIC BARRIER TERMINAL, TYPE 6
635006 <b>-<i>0</i>2</b>	REFLECTOR AND TERMINAL MARKER PLACEMENT
635011 <b>- 0/</b>	REFLECTOR MARKER AND MOUNTING DETAILS
637001 - <i>0</i> 2	CONCRETE BARRIER 815 MM (32 IN.) HEIGHT
664001 - <i>01</i>	CHAIN LINK FENCE
701101 - <i>01</i>	OFF-ROAD OPERATIONS, MULTILANE, LESS THAN 15' AWAY. FOR SPEEDS >= 45 MPH
701400 <b>-02</b>	APPROACH TO LANE CLOSURE, FREEWAY/EXPRESSWAY
701401 - <i>03</i>	LANE CLOSURE, FREEWAY/EXPRESSWAY

701411-03 LANE CLOSURE, MULTILANE AT ENTRANCE OR EXIT RAMP FOR SPEEDS >= 45 MPH TO 55 MPH

#### PROJECT COMMITMENTS

701402-05 LANE CLOSURE, FREEWAY/EXPRESSWAY, WITH BARRIER

APPLICATION OF TYPE A AND B POSTS

TWO LANE CLOSURE, FREEWAY/EXPRESSWAY

METAL POSTS (SIGNS, MARKERS AND DELINEATORS)

IDOT HAS MADE THE FOLLOWING COMMITMENTS FOR THIS PROJECT:

SIGN PANEL MOUNTING DETAILS

SIGN PANEL ERECTION DETAILS

702001-05 TRAFFIC CONTROL DEVICES

704001-02 TEMPORARY CONCRETE BARRIER

780001-01 TYPICAL PAVEMENT MARKINGS

701446

720001

729001

IDOT HAS COMMITTED TO ADDRESS CONSTRUCTION RELATED AIR QUALITY CONCERNS. THESE STRATEGIES INCLUDE REQUIRING DETAILED DUST CONTROL PLANS, REQUIRING THE USE OF CLEANER BURNING DIESEL FUELS ON CERTAIN DIESEL POWERED CONSTRUCTION EQUIPMENT AND/OR THE INSTALLATION OF EXHAUST EMISSION SCRUBBERS, AND THE REDUCTION OF CONSTRUCTION EQUIPMENT IDLING TIMES. THESE STRATEGIES ARE ADDRESSED IN SPECIAL PROVISIONS INCLUDED IN THIS CONTRACT AND DEVELOPED FOR THE DAN RYAN RECONSTRUCTION PROJECT.

IDOT HAS COMMITTED TO REDUCE TIRE-PAVEMENT HIGHWAY TRAFFIC NOISE FOR THE FINISHED PROJECT BY INCLUDING A SPECIAL PROVISION TO INCORPORATE VARIABLE WIDTH AND SKEWED "TINING" OF THE NEW CONCRETE PAVEMENT.

GEN-1

REVISIONS		THE THOTC DE	DADTHENT OF TO	ANCDODIAT	TON			
NAME	DATE		PARTMENT OF TR					
		F.A.I. 94/90			SWAY)			
			REET TO 71ST					
		NB EXPRESS LANE RECONSTRUCTION						
		GENERAL NO	OTES, LIST OF	STANDAR	RDS			
			COMMITMENTS	;				
		SCALE: NONE		DRAWN BY:	LPN			
		DATE: 7/7/05		CHECKED BY:	PJM			

Edwards \*\*\*\* Kelcey

BOWMAN, BARRETT & ASSOCIATES SUITE 2650 130 E. RANDOLPH ST CHICAGO, IL 60601

# Project Construction Schedule Dan Ryan Expressway

Note						2005						2006		***************************************		***************************************	1			2007		
100   100	ID	Task Name	Duration	Start	Finish		Dec Jan	Feb Mar	Apr Ma	y Jun	1	_	Sep	Oct	Nov	Dec	Jan	Feb			May Jur	1 0c+
March 1970 (Note And College	1	LOCAL LANE PAVEMENT PATCHING	52 days	Sat 10/1/05	Wed 11/30/05																	
Marche	2	SETUP AND MAINTAIN ALTERNATE ROUTE SIGNING	359 days	Mon 1/2/06	Wed 2/28/07														>>TRANS	FER TO	CONTRACT	62303
STATESTER COLUMN TOWERS NOT	3	PLACE INTERIM LOCAL LANE SIGNING	26 days	Mon 1/2/06	Tue 1/31/06		- Insurantial manages															
Month   March   Marc	4	REMOVE OVERHEAD LOCAL LANE SIGN TRUSSES	24 days	Wed 2/1/06	Tue 2/28/06																	
Color Transference Confession (Color Color Col	5	RESTRIPE / SHIFT LOCAL LANE TRAFFIC	13 days	Wed 3/1/06	Wed 3/15/06			5105														
MINITENSE AD PRESIDENCE WITH SAME NAME   1969   1	6	PLACE TEMPORARY CONCRETE BARRIER WALL	13 days	Wed 3/1/06	Wed 3/15/06																	
Department and Control Processes   12 control   12 cont	7	MAINTENANCE AND POSSESSION OF TEMPORARY CONCRETE BARRIER WALL	309 days	Wed 3/1/06	Wed 2/28/07						11719   1111 11110   1111								>>TRANS	FER TO	CONTRACT	62303
8 SENDER CONTRIBLATIONS ON TRIBUTES 27 289 1 10.37506	8	PAVEMENT AND APPURTENANCE REMOVAL	120 days	Wed 3/15/06	Tue 8/1/06																	
11   P.A.CERIMON OF CHAIN LAW FEMALE (# CEPTICAL)	9	REMOVE OVERHEAD EXPRESS LANE SIGN TRUSSES	27 days	Thu 3/16/06	Sat 4/15/06																	
11   P.A.CERIMON OF CHAIN LAW FEMALE (# CEPTICAL)	10	BARRIER WALL REMOVAL	105 days	Thu 3/16/06	Sat 7/15/06																	
19   10.00	11	PLACEMENT OF CHAIN LINK FENCE, 6' (SPECIAL)	27 days	Thu 3/16/06	Sat 4/15/06														.			
19   10.00	12	NB HIGH BRIDGE <roosevelt 31st="" to=""> REPAIRS (BY CONTRACT 62580)</roosevelt>	194 days	Thu 3/16/06	Fri 10/27/06			10														
SEX-MER ALLOCHORS	13	LIGHT POLE REMOVALS (BY CONTRACT 62583)	52 days	Thu 3/16/06	Mon 5/15/06			1521														
MAIN DAMA COMMERCINOSSEPMARS (WY CONTACT RESSO)   B days   Set 4156   Moi 81505   B defended	14	SEWER JACKING	62 days	Wed 3/22/06	Thu 6/1/06																	
SATILIZACIONEN   150 days	15	MAIN DRAIN CONNECTIONSREPAIRS (BY CONTRACT 62580)	80 days	Fri 3/31/06	Sat 7/1/06						9											
100	16	EARTH EXCAVATION	105 days	Sat 4/1/06	Tue 8/1/06																	
STA DARRIER RELIGIONAL	17	LIGHT POLE FOUNDATION REMOVALS	38 days	Sat 4/1/06	Mon 5/15/06																	
STA DARRIER RELIGIONAL	18	DRAINAGE INSTALLATIONS	144 days	Sat 4/1/06	Fri 9/15/06																	-
20 17 CTA BARRIER WALL HASTALLATION	19	CTA BARRIER REMOVAL	91 days	Sat 4/1/06	Sat 7/15/06							- Communication	4100000									+
100   100	20	72" CTA BARRIER WALL INSTALLATION	65 days	Sat 4/1/06	Thu 6/15/06							<b>†</b>										
PERSINNO BOX COLVERT REPAIRS  92 0 (99) Sale 415000 Mon 751000	21	SUB-BASE GRANULAR PLACEMENT	119 days	Sat 4/15/06	Thu 8/31/06											1						
22 LUS SYSTEM INSTALLATIONS 83 days Said 41500 The 81100 No. 7/3100 No. 7/310	22	PERSHING BOX CULVERT REPAIRS	92 days	Sat 4/15/06	Mon 7/31/06				10.00					1								
24   OVERNIEAD SIGN FOUNDATIONS   70 days   Mon 51/106   Mon 7/31/06	23	LUG SYSTEM INSTALLATIONS	93 days	Sat 4/15/06	Tue 8/1/06																	
26 PABRICATE OVERHEAD SIGN TRUSSES 106 days Mon 51/106 Thu 83/106   Th	24	OVERHEAD SIGN FOUNDATIONS	79 days	Mon 5/1/06	Mon 7/31/06				Hannet		elengerani	<b>3</b>										1
26 PIPE UNDERDRAN PLACEMENT 19 days Mon 51/06 Fi 9/15/06	25	FABRICATE OVERHEAD SIGN TRUSSES	106 days	Mon 5/1/06	Thu 8/31/06																	1
27 ELECTRICAL HANDHOLES AND CONDUITS  106 days  106 days  106 days  106 days  107 Mon 73/106  28 STABILIZED SUB-BASED  40 days  107 Mon 73/106  29 CRPCC 14" PAVEMENT  79 days  108 days	26	PIPE UNDERDRAIN PLACEMENT	119 days	Mon 5/1/06	Fri 9/15/06																	+
28 STABILIZED \$\text{STABILIZED \$\text{SUB-BASED}}\$  CRPCC 14" PAVEMENT  79 days  Fn 6/16/06  Fn 9/15/06  Fn 9/15/06  TEMP BARRIER WALL & LANE STRIPING (EXPRESS LANE)  86 days  Fn 7/706  Tue 9/106  Tue 9/106  Sat 10/14/06  31 WATER MAIN PROTECTION CAPS  32 INTERIM COMPLETION DATE - OPEN SINGLE EXPRESS LANE  O days  Tue 7/15/08  Tue 9/106  Sat 10/14/06  Sat 10/14/06  Sat 10/14/06  Tue 9/106  Sat 10/14/06  Sat 10/14/06  Tue 9/106  Sat 10/14/06  Tue 9/106  Sat 10/14/06  Sat 10/14/06  Tue 9/106  Sat 10/14/06  Tue 9/106  Sat 10/14/06  Sat 10/14/06  Tue 9/106  Sat 10/14/06  Tue 9/106  Sat 10/14/06  Sat	27	ELECTRICAL HANDHOLES AND CONDUITS	106 days	Mon 5/1/06	Thu 8/31/06		_															+
29 GRPC 14" AVEMENT 76 days Fri 6/15/06 Fri 9/15/06 Sat 9/30/06 Sat 9/30/06/06 Sat 9/30/06 Sat 9/30/06 Sat 9/30/06 Sat 9/30/06 Sat 9/30/06	28	STABILIZED SUB-BASED	40 days	Thu 6/15/06	Mon 7/31/06						1605066	6				1						+
30 TEMP BARRIER WALL & LANE STRIPING (EXPRESS LANE) 31 WATER MAIN PROTECTION CAPS 32 INTERIM COMPLETION DATE - OPEN SINGLE EXPRESS LANE 33 42° CTA BARRIER WALL AND FENCE 34 CONCRETE BARRIER TRANSITIONS 35 TEMPORARY PAVEMENT AND SHOULDERS 36 68 days 37 TUR 81/106 38 INSIDE PROPOSED SHOULDER PLACEMENT 39 PROPOSED SIGNING 49 days 49 d	29	CRPCC 14" PAVEMENT	79 days	Fri 6/16/06	Fri 9/15/06																	
31 WATER MAIN PROTECTION CAPS  22 days Fri 7/7/06 Tue 8/1/06  32 INTERIM COMPLETION DATE - OPEN SINGLE EXPRESS LANE  0 days Tue 7/15/06 Tue 7/15/06  33 42° CTA BARRIER WALL AND FENCE  65 days Tue 8/1/06 Sat 10/14/06  34 CONCRETE BARRIER TRANSITIONS  65 days Tue 8/1/06 Sat 10/14/06  35 TEMPORARY PAVEMENT AND SHOULDERS  65 days Tue 8/1/06 Sat 10/14/06  36 EXPRESS LANE OVERHEAD SIGN TRUSSES  65 days Tue 8/1/06 Sat 10/14/06  37 MAIN DRAIN CLEANING AND REPAIRS  65 days Tue 8/1/06 Sat 10/14/06  38 INSIDE PROPOSED SHOULDER PLACEMENT  52 days Wed 8/16/06 Sat 10/14/06  39 PROPOSED SIGNING  49 days Fri 9/1/06 Fri 10/27/06  41 DRAINAGE STRUCTURES TO BE CLEANED  49 days Fri 9/1/06 Fri 10/27/06  41 DRAINAGE STRUCTURES TO BE CLEANED  49 days Fri 9/1/06 Fri 10/27/06  41 DRAINAGE STRUCTURES TO BE CLEANED  49 days Fri 9/1/06 Fri 10/27/06  40 EXPRESS LANE PAVEMENT MARKINGS  49 days Fri 9/1/06 Fri 10/27/06	30	TEMP BARRIER WALL & LANE STRIPING (EXPRESS LANE)	86 days	Fri 6/23/06	Sat 9/30/06					i										-		
32   INTERIM COMPLETION DATE - OPEN SINGLE EXPRESS LANE   0 days   Tue 7/15/06   Tue 7/15/06   Tue 7/15/06   Sat 10/14/06	31	WATER MAIN PROTECTION CAPS	22 days	Fri 7/7/06	Tue 8/1/06																	
34 CONCRETE BARRIER TRANSITIONS 65 days Tue 8/1/06 Sat 10/14/06 9 35 TEMPORARY PAVEMENT AND SHOULDERS 65 days Tue 8/1/06 Sat 10/14/06 9 36 EXPRESS LANE OVERHEAD SIGN TRUSSES 65 days Tue 8/1/06 Sat 10/14/06 9 37 MAIN DRAIN CLEANING AND REPAIRS 65 days Tue 8/1/06 Sat 10/14/06 9 38 INSIDE PROPOSED SHOULDER PLACEMENT 52 days Wed 8/16/06 Sat 10/14/06 9 39 PROPOSED SIGNING 49 days Fri 9/1/06 Fri 10/27/06 9 40 ATTENUATOR INSTALLATIONS 49 days Fri 9/1/06 Fri 10/27/06 9 41 DRAINAGE STRUCTURES TO BE CLEANED 49 days Fri 9/1/06 Fri 10/27/06 9 42 EXPRESS LANE PAVEMENT MARKINGS 49 days Fri 9/1/06 Fri 10/27/06 9 40 EXPRESS LANE PAVEMENT MARKINGS 49 days Fri 9/1/06 Fri 10/27/06 9 40 EXPRESS LANE PAVEMENT MARKINGS 49 days Fri 9/1/06 Fri 10/27/06 9 41 EXPRESS LANE PAVEMENT MARKINGS 49 days Fri 9/1/06 Fri 10/27/06 9 42 EXPRESS LANE PAVEMENT MARKINGS 49 days Fri 9/1/06 Fri 10/27/06 9 43 EXPRESS LANE PAVEMENT MARKINGS 49 days Fri 9/1/06 Fri 10/27/06 9 44 EXPRESS LANE PAVEMENT MARKINGS 49 days Fri 9/1/06 Fri 10/27/06 9 45 EXPRESS LANE PAVEMENT MARKINGS 49 days Fri 9/1/06 Fri 10/27/06 9 46 EXPRESS LANE PAVEMENT MARKINGS 49 days Fri 9/1/06 Fri 10/27/06 9 47 EXPRESS LANE PAVEMENT MARKINGS 49 days Fri 9/1/06 Fri 10/27/06 9 48 EXPRESS LANE PAVEMENT MARKINGS 49 days Fri 9/1/06 Fri 10/27/06 9 49 days Fri 9/1/06 Fri 10/27/06 9 40 EXPRESS LANE PAVEMENT MARKINGS 49 days Fri 9/1/06 Fri 10/27/06 9 40 EXPRESS LANE PAVEMENT MARKINGS 49 days Fri 9/1/06 Fri 10/27/06 9 40 EXPRESS LANE PAVEMENT MARKINGS 49 days Fri 9/1/06 Fri 10/27/06 9 41 EXPRESS LANE PAVEMENT MARKINGS 49 days Fri 9/1/06 Fri 10/27/06 9 41 EXPRESS LANE PAVEMENT MARKINGS 49 days Fri 9/1/06 Fri 10/27/06 9 41 EXPRESS LANE PAVEMENT MARKINGS 49 days Fri 9/1/06 Fri 10/27/06 9 41 EXPRESS LANE PAVEMENT MARKINGS 49 days Fri 9/1/06 Fri 10/27/06 9 41 EXPRESS LANE PAVEMENT MARKINGS 49 days Fri 9/1/06 Fri 10/27/06 9 41 EXPRESS LANE PAVEMENT MARKINGS 49 days Fri 9/1/06 Fri 10/27/06 9 41 EXPRESS LANE PAVEMENT MARKINGS 49 days Fri 9/1/06 PAVEMENT MARKINGS 49 days Fri 9/1/06 PAVEMENT MARKINGS 49 days	32	INTERIM COMPLETION DATE - OPEN SINGLE EXPRESS LANE	0 days	Tue 7/15/06	Tue 7/15/06						1		/15									
34 CONCRETE BARRIER TRANSITIONS 65 days Tue 8/1/06 Sat 10/14/06	33	42" CTA BARRIER WALL AND FENCE	65 days	Tue 8/1/06	Sat 10/14/06						1											
36 EXPRESS LANE OVERHEAD SIGN TRUSSES 65 days Tue 8/1/06 Sat 10/14/06	34	CONCRETE BARRIER TRANSITIONS	65 days	Tue 8/1/06	Sat 10/14/06								armenment.									+
37 MAIN DRAIN CLEANING AND REPAIRS 65 days Tue 8/1/06 Sat 10/14/06  38 INSIDE PROPOSED SHOULDER PLACEMENT 52 days Wed 8/16/06 Sat 10/14/06  39 PROPOSED SIGNING 49 days Fri 9/1/06 Fri 10/27/06  40 ATTENUATOR INSTALLATIONS 49 days Fri 9/1/06 Fri 10/27/06  41 DRAINAGE STRUCTURES TO BE CLEANED 49 days Fri 9/1/06 Fri 10/27/06  42 EXPRESS LANE PAVEMENT MARKINGS 49 days Fri 9/1/06 Fri 10/27/06	35	TEMPORARY PAVEMENT AND SHOULDERS	65 days	Tue 8/1/06	Sat 10/14/06						1											
37 MAIN DRAIN CLEANING AND REPAIRS 65 days Tue 8/1/06 Sat 10/14/06	36	EXPRESS LANE OVERHEAD SIGN TRUSSES	65 days	Tue 8/1/06	Sat 10/14/06																	1
39         PROPOSED SIGNING         49 days         Fri 9/1/06         Fri 10/27/06         Image: Fri 10/27/06 <td< th=""><th>37</th><th>MAIN DRAIN CLEANING AND REPAIRS</th><th>65 days</th><th>Tue 8/1/06</th><th>Sat 10/14/06</th><th></th><th></th><th></th><th></th><th></th><th>1</th><th></th><th></th><th></th><th></th><th></th><th></th><th></th><th></th><th></th><th></th><th></th></td<>	37	MAIN DRAIN CLEANING AND REPAIRS	65 days	Tue 8/1/06	Sat 10/14/06						1											
39         PROPOSED SIGNING         49 days         Fri 9/1/06         Fri 10/27/06         Image: Fri 10/27/06 <td< th=""><th>38</th><th>INSIDE PROPOSED SHOULDER PLACEMENT</th><th>52 days</th><th>Wed 8/16/06</th><th>Sat 10/14/06</th><th></th><th></th><th></th><th></th><th></th><th>1</th><th></th><th></th><th></th><th></th><th></th><th></th><th></th><th></th><th></th><th></th><th>1</th></td<>	38	INSIDE PROPOSED SHOULDER PLACEMENT	52 days	Wed 8/16/06	Sat 10/14/06						1											1
40 ATTENUATOR INSTALLATIONS 49 days Fri 9/1/06 Fri 10/27/06	39	PROPOSED SIGNING	49 days	Fri 9/1/06	Fri 10/27/06						1		WATER O									
41     DRAINAGE STRUCTURES TO BE CLEANED     49 days     Fri 9/1/06     Fri 10/27/06     Image: Fri 9/1/06 in 10/27/06 in 10	40	ATTENUATOR INSTALLATIONS	49 days	Fri 9/1/06	Fri 10/27/06					1	1											1
42 EXPRESS LANE PAVEMENT MARKINGS 49 days Fri 9/1/06 Fri 10/27/06	41	DRAINAGE STRUCTURES TO BE CLEANED	49 days	Fri 9/1/06	Fri 10/27/06						1	1										
43 INTERIM COMPLETION DATE - MEET CONTRACT 6/20/4 STAGING 0 days Fri 9/4/06 Fri 9/4/06	42	EXPRESS LANE PAVEMENT MARKINGS	49 days	Fri 9/1/06	Fri 10/27/06						1	1	David Salari									
	43	INTERIM COMPLETION DATE - MEET CONTRACT 62304 STAGING	0 days	Fri 9/1/06	Fri 9/1/06							•	9/1									

F.A.I. SE	CTION	COUN	TY	TOTAL SHEETS	SHEET NO.
94/90 *		C00	K	556	4
STA.		TO STA.			
FED. ROAD DIST.	NO. ILLIN	OIS FED.	AID	PROJECT	

62300 •(1818, ETC, 2324.6-1P)R-9

REVISIONS
NAME
DATE

F.A.I. 94/90 (DAN RYAN EXPRESSWAY)

31ST STREET TO 71ST STREET

NB EXPRESS LANE RECONSTRUCTION

SUGGESTED CONSTRUCTION SCHEDULE

SCALE: 1"=NONE

DRAWN BY: RZ

CHECKED BY: JDC

BOWMAN, BARRETT & ASSOCIATES INC.
CONSULTING ENGINEERS
Clicago, Illinois
312.228.0100
www.bbandainc.com

45

RELOCATE / REMOVE TEMPORARY CONCRETE BARRIER WALL

RESTRIPE / SHIFT LOCAL LANE TRAFFIC

TASK:	MILESTONE:	<b>•</b>

23 days

11 days

Mon 10/2/06

Mon 10/2/06

Fri 10/27/06

Fri 10/27/06

				90%	90% FEDERAL / 10% STATE				
			URBAN TOTAL	ROADWAY	SIGNING	SURVEILLANCE	SN 016-2625	SN 016-0142 SN 016-1148	
CODE NO.	ITEM DESCRIPTION	UNIT	QUANTITY		Y002-1C	Y032-1F	X928-2A	SFTY-2A	
20200100	EARTH EXCAVATION	CU YD	217,181	217,181					
20800150	TRENCH BACKFILL	CU YD	37,065	37,065					
21001000	GEOTECHNICAL FABRIC FOR GROUND STABILIZATION	SQ YD	219,063	219,063					
21101615	TOPSOIL FURNISH AND PLACE, 4"	SQ YD	2,139	2,139					
21101630	TOPSOIL FURNISH AND PLACE, 8"	SQ YD	3,208	3,208					
21101815	COMPOST FURNISH AND PLACE, 4"	SQ YD	3,208	3,208					
21301052	EXPLORATION TRENCH 52" DEPTH	FOOT	540	540					
25000210	SEEDING, CLASS 2A	ACRE	1	1					
25000400	NITROGEN FERTILIZER NUTRIENT	POUND	99	99					
25000500	PHOSPHORUS FERTILIZER NUTRIENT	POUND	99	99					
25000600	POTASSIUM FERTILIZER NUTRIENT	POUND	99	99					
25100115	MULCH, METHOD 2	ACRE	1	1					
25100630	EROSION CONTROL BLANKET	SQ YD	5,347	5,347					
28000250	TEMPORARY EROSION CONTROL SEEDING	POUND	110	110					
28000400	PERIMETER EROSION BARRIER	FOOT	1,744	1,744					
28000510	INLET FILTERS	EACH	209	209					
31101860	SUB-BASE GRANULAR MATERIAL, TYPE B 24"	SQ YD	225,099	225,099					
42001165	BRIDGE APPROACH PAVEMENT	SQ YD	456				456		
42001300	PROTECTIVE COAT	SQ YD	227,431	227,431					
42100380	CONTINUOUSLY REINFORCED PORTLAND CEMENT CONCRETE 14"	SQ YD	148,867	148,867					
42101448	LUG SYSTEM COMPLETE 48'	EACH	2	2					
42101452	LUG SYSTEM COMPLETE 52'	EACH	1	1					
44000013	BITUMINOUS SURFACE REMOVAL, 5"	SQ YD	143				143		
44000030	BITUMINOUS SURFACE REMOVAL (VARIABLE DEPTH)	SQ YD	82				82		
44000100	PAVEMENT REMOVAL	SQ YD	151,914	151,914					
44000500	COMBINATION CURB AND GUTTER REMOVAL	FOOT	8,832	8,832					
44000700	APPROACH SLAB REMOVAL	SQ YD	219				219		
44001980	CONCRETE BARRIER REMOVAL	FOOT	21,318	21,318				,	
44004250	PAVED SHOULDER REMOVAL	SQ YD	63,649	63,649					
44201474	CLASS (C PATCHES, TYPE I	SQ YD	25	25					
44201476	CLASS PATCHES, TYPE II	SQ YD	60	60					
44201478	CLASS PATCHES, TYPE III	SQ YD	50	50					
44213200	SAW CUTS	FOOT	100	100					
							<u> </u>		
48202400	BITUMINOUS SHOULDERS SUPERPAVE 6"	SQ YD	36	36					
50300225	CONCRETE STRUCTURES	CU YD	57	57					
50300255	CONCRETE SUPERSTRUCTURE	CU YD	1,316	1,204			112		

F.A.I. RTE.	SECTION	COUNTY	TOTAL SHEETS	SHEET NO.	15
94/90	<b>*</b>	COOK	556	5	18
STA.		TO STA.			S

FED. ROAD DIST. NO. \_ ILLINOIS FED. AID PROJECT
62300 \* (1818, ETC, 2324.6-1P)R-8

SOQ-1

REVISIONS		TILINOTS DEPARTME	NT OF TRANSPORTATION
NAME	DATE	ILLINOIS DEI ARTIME	IN OF TISANSFORTATION
		F.A.I. 94/90 (DAI	N RYAN EXPRESSWAY)
			TO 71ST STREET
		NB EXPRESS LA	NE RECONSTRUCTION
		CURRAN	OF OUTBUTTIES
***************************************		SUMMARY	OF QUANTITIES
		SCALE: NONE	DRAWN BY: TAI
		DATE: 7/7/05	CHECKED BY: PJM

\* SPECIALITY ITEM



			URBAN	90%	. FEDERAL	/ 10% ST	ATE	
			TOTAL	ROADWAY	SIGNING	SURVEILLANCE	SN 016-2625	SN 016-0142 SN 016-1148
CODE NO.	ITEM DESCRIPTION	UNIT	QUANTITY	J000-2A	Y002-1C			SFTY-2A
50300260	BRIDGE DECK GROOVING	SQ YD	212				212	
50300300	PROTECTIVE COAT	SQ YD	2,903	2,506			257	140
50301245	FORMED CONCRETE REPAIR (DEPTH EQUAL TO OR LESS THAN 5")	SQ FT	1,219					1,219
50301250	FORMED CONCRETE REPAIR (DEPTH GREATER THAN 5")	SQ FT	44					44
50800205	REINFORCEMENT BARS, EPOXY COATED	POUND	80,795	59,345			21,540	
550A0050	STORM SEWERS, CLASS A, TYPE 1 12"	FOOT	4,598	4,598				
550A0070	STORM SEWERS, CLASS A, TYPE 1 15"	FOOT	1,054	1,054				
550A0090	STORM SEWERS, CLASS A, TYPE 1 18"	FOOT	68	68				
550A0110	STORM SEWERS, CLASS A, TYPE 1 21"	FOOT	133	133				
550A0340	STORM SEWERS, CLASS A, TYPE 2 12"	FOOT	4,692	4,692				
550A0360	STORM SEWERS, CLASS A, TYPE 2 15"	FOOT	1,032	1,032				
550A0380	STORM SEWERS, CLASS A, TYPE 2 18"	FOOT	2,078	2,078				
550A0400	STORM SEWERS, CLASS A, TYPE 2 21"	FOOT	2,352	2,352				
550A0410	STORM SEWERS, CLASS A, TYPE 2 24"	FOOT	1,669	1,669				
550A0420	STORM SEWERS, CLASS A, TYPE 2 27"	FOOT	1,748	1,748				
550A0430	STORM SEWERS, CLASS A, TYPE 2 30"	FOOT	2,543	2,543				
550A0440	STORM SEWERS, CLASS A, TYPE 2 33"	FOOT	623	623				
550A0450	STORM SEWERS, CLASS A, TYPE 2 36"	FOOT	2,378	2,378				
550A0470	STORM SEWERS, CLASS A, TYPE 2 42"	FOOT	827	827				
550A0480	STORM SEWERS, CLASS A, TYPE 2 48"	FOOT	53	53				
550A0640	STORM SEWERS, CLASS A, TYPE 3 12"	FOOT	8	8				
550A0700	STORM SEWERS, CLASS A, TYPE 3 21"	FOOT	314	314				
550A0710	STORM SEWERS, CLASS A, TYPE 3 24"	FOOT	151	151				
550A0720	STORM SEWERS, CLASS A, TYPE 3 27"	FOOT	66	66				
550A0730	STORM SEWERS, CLASS A, TYPE 3 30"	FOOT	749	749				
550A0750	STORM SEWERS, CLASS A, TYPE 3 36"	FOOT	612	612				
550A0770	STORM SEWERS, CLASS A, TYPE 3 42"	FOOT	50	50				
550B0030	STORM SEWERS, CLASS B, TYPE 1 8"	FOOT	2	2				
550B0040	STORM SEWERS, CLASS B, TYPE 1 10"	FOOT	55	55				
550B0050	STORM SEWERS, CLASS B, TYPE 1 12"	FOOT	374	374				
550B0070	STORM SEWERS, CLASS B, TYPE 1 15"	FOOT	21	21				
55100300	STORM SEWER REMOVAL 8"	FOOT	576	576				
55100400	STORM SEWER REMOVAL 10"	FOOT	6,548	6,548				
55100500	STORM SEWER REMOVAL 12"	FOOT	5,062	5,062				
55100700	STORM SEWER REMOVAL 15"	FOOT	4,309	4,309				
55100900	STORM SEWER REMOVAL 18"	FOOT	4,490	4,490				
33100300	STOUM SENEN NEWOVAL 10	1001	1 7,730	7,430		<del>                                     </del>	<u> </u>	<del> </del>

F.A.I. RTE.	SECTION	COUNTY	TOTAL SHEETS	SHEET NO.
94/90	*	COOK	556	6
STA.		TO STA.		
FED. RO	AD DIST. NO ILLI	NOIS FED. AID	PROJECT	
623	00 * (1818,	ETC, 2324.6-1	P)R-8	

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REVISIONS	THE THOTE DEPARTM	ENT OF TRANSPORTATION
NAME DA	TE TELLINOIS DEI AIKIM	ENT OF TRANSPORTATION
	F.A.I. 94/90 (DA	N RYAN EXPRESSWAY)
	31ST STREET	TO 71ST STREET
		NE RECONSTRUCTION
	ND EXINESS EA	THE THEODISTITUOTION
	SUMMARY	OF QUANTITIES
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	COLLE NONE	00.000.000.744
	SCALE: NONE	DRAWN BY: TAI
	DATE: 7/7/05	CHECKED BY: PJM

\* SPECIALITY ITEM



				90%	: FEDERAL	/ 10% ST	ATE	
			<i>URBAN</i> TOTAL	ROADWAY	SIGNING	SURVEILLANCE	SN 016-2625	SN 016-0142 SN 016-1148
	ITEM DESCRIPTION	UNIT	QUANTITY	J000-2A		Y032-1F	X928-2A	
55101100	STORM SEWER REMOVAL 21"	FOOT	495	495				
55101200	STORM SEWER REMOVAL 24"	FOOT	4,776	4,776				
55101300	STORM SEWER REMOVAL 27"	FOOT	200	200				
55101400	STORM SEWER REMOVAL 30"	FOOT	1,712	1,712				
55101600	STORM SEWER REMOVAL 36"	FOOT	504	504				-
55101800	STORM SEWER REMOVAL 42"	~ F00T	62	62				
552A1300	STORM SEWERS JACKED IN PLACE, CLASS A 36"	FOOT	600	600				
552A1500	STORM SEWERS JACKED IN PLACE, CLASS A 42"	FOOT	71	71				
59000100	EPOXY CRACK SEALING	FOOT	275					275
60107700	PIPE UNDERDRAINS 6"	FOOT	49,366	49,366			·	
60108200	PIPE UNDERDRAINS 6" (SPECIAL)	FOOT	722	722			'	
60109000	PIPE UNDERDRAINS, PERFORATED CORRUGATED STEEL PIPE 12"	FOOT	310	310				
60200105	CATCH BASINS, TYPE A, 4'-DIAMETER, TYPE 1 FRAME, OPEN LID	EACH	25	25				
60201310	CATCH BASINS, TYPE A, 4'-DIAMETER, TYPE 20 FRAME AND GRATE	EACH	273	273				
60203805	CATCH BASINS, TYPE A, 5'-DIAMETER, TYPE 1 FRAME, OPEN LID	EACH	4	4				
60218400	MANHOLES, TYPE A, 4'-DIAMETER, TYPE 1 FRAME, CLOSED LID	EACH	54	54				
60221100	MANHOLES, TYPE A, 5'-DIAMETER, TYPE 1 FRAME, CLOSED LID							
		EACH	141	141				
60223700	MANHOLES, TYPE A, 6'-DIAMETER, TYPE 1 FRAME, OPEN LID	EACH	1	1				
60226730	MANHOLES, DROP TYPE, 6'-DIAMETER, TYPE 1 FRAME, CLOSED LID	EACH	1	1				
60240324	INLETS, TYPE B, TYPE 20 FRAME AND GRATE	EACH	28	28				
X6020166	DRAINAGE STRUCTURES, TYPE 1 SPECIAL WITH TWO TYPE 20 FRAMES AND GRATES	EACH	62	62				
X6020167	DRAINAGE STRUCTURES, TYPE 2 SPECIAL WITH TWO TYPE 22 FRAMES AND GRATES	EACH	2	2				
60250400	CATCH BASINS TO BE ADJUSTED WITH NEW TYPE 1 FRAME, OPEN LID	EACH	54	54				
60255700	MANHOLES TO BE ADJUSTED WITH NEW TYPE 1 FRAME, OPEN LID	EACH	98	98				
60260300	INLETS TO BE ADJUSTED WITH NEW TYPE 1 FRAME, OPEN LID	EACH	39	39				
60500040	REMOVING MANHOLES	EACH	210	210				
60500050	REMOVING CATCH BASINS	EACH	265	265				
60500060	REMOVING INLETS	EACH	47	47				
60500105	FILLING MANHOLES	EACH	32	32				
60500205	FILLING CATCH BASINS	EACH	31	31				
60618324	CONCRETE MEDIAN SURFACE, 6 INCH (SPECIAL)	SQ FT	3,997	3,997				
63100085	TRAFFIC BARRIER TERMINAL, TYPE 6	EACH	1	1		,		
63100167	TRAFFIC BARRIER TERMINAL, TYPE 1 SPECIAL (TANGENT)	EACH	1	1				
63700805	CONCRETE BARRIER TRANSITION	FOOT	972	972				
66400560	CHAIN LINK FENCE, 6' (SPECIAL)	FOOT	25,093	25,093				
67000600	ENGINEER'S FIELD LABORATORY	CAL MO	10	10				
67100100	MOBILIZATION	L SUM	1	1		,		
0.100100		L SUM	1	1				

▲ INDICATES PAY CODE TYPE SFTY-3N

62300 \* (1818, ETC, 2324.6-1P)R-8

		S0Q-3
REVISIONS		ILLINOIS DEPARTMENT OF TRANSPORTATION
NAME	DATE	ILLINOIS DEPARTMENT OF TRANSPORTATION
		F.A.I. 94/90 (DAN RYAN EXPRESSWAY)
		31ST STREET TO 71ST STREET
		NB EXPRESS LANE RECONSTRUCTION
· · · · · · · · · · · · · · · · · · ·		
		SUMMARY OF QUANTITIES
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Edwards ONE NORTH FRANKLIN CHICAGO, IL 60606 PHONE: (312) 251-3005 FAX: (312) 251-3015 WEB: WWW.EKCORP.COM

\* SPECIALITY ITEM

DRAWN BY: TAI DATE: 7/7/05 CHECKED BY: PJM

					90%	FEDERAL	/ 10% ST	ATE	
				URBAN TOTAL	ROADWAY	SIGNING	SURVEILLANCE	SN 016-2625	SN 016-0142 SN 016-1148
	CODE NO.		UNIT	QUANTITY	J000-2A	Y002-1C	Y032-1F	X928-2A	SFTY-2A
	70300240	TEMPORARY PAVEMENT MARKING - LINE 6"	FOOT	31,465	31,465				
•	70300510	PAVEMENT MARKING TAPE, TYPE III - LETTERS AND SYMBOLS	SQ FT	218	218				
•	70300520	PAVEMENT MARKING TAPE, TYPE III 4"	FOOT	113,394	113,394				
	70300530	PAVEMENT MARKING TAPE, TYPE III 5"	FOOT	15,638	15,638				
	70300550	PAVEMENT MARKING TAPE, TYPE III 8"	FOOT	15,925	15,925				
	70300560	PAVEMENT MARKING TAPE, TYPE III 12"	F00T	3,774	3,774				
	70301000	WORK ZONE PAVEMENT MARKING REMOVAL	SQ FT	64,198	64,198				
	70400100	TEMPORARY CONCRETE BARRIER	F00T	25,315	25,315				
	70400200	RELOCATE TEMPORARY CONCRETE BARRIER	FOOT	24,312	24,312	***************************************			
*	72000100	SIGN PANEL - TYPE 1	SQ FT	12		12			
*	72000200	SIGN PANEL - TYPE 2	SQ FT	96		96			
*	72000300	SIGN PANEL - TYPE 3	SQ FT	4,186		4,186			
*	72100100	SIGN PANEL OVERLAY	SQ FT	2		2			
*	72400320	REMOVE SIGN PANEL - TYPE 2	SQ FT	72		72			
*	72400330	REMOVE SIGN PANEL - TYPE 3	SQ FT	591		591			
*	72400720	RELOCATE SIGN PANEL - TYPE 2	SQ FT	12		12			
*	72400730	RELOCATE SIGN PANEL - TYPE 3	SQ FT	488		488			
· ©	72700100	STRUCTURAL STEEL SIGN SUPPORT - BREAKAWAY	POUND	1,890		1,890			
*	72800100	TELESCOPING STEEL SIGN SUPPORT	FOOT	88		88			
*	73000100	WOOD SIGN SUPPORT	FOOT	17		17			
	73300 00	OVERHEAD SIGN STRUCTURE - SPAN, TYPE I-A (4'-0'' x 4'-6")	FOOT	72		72.0			
*	73300300	OVERHEAD SIGN STRUCTURE - SPAN, TYPE III-A (5'-0" X 7'-0")	FOOT	142		142			
	73304000	OVERHEAD SIGN STRUCTURE - BRIDGE MOUNTED	FOOT	332		332			
		OVERHEAD SIGN STRUCTURE WALKWAY				403			
	73305000		FT	403					
	73400100	CONCRETE FOUNDATIONS	CU YD	7		7			
*	73400200	DRILLED SHAFT CONCRETE FOUNDATIONS	CU YD	179		179			
*	73600100	REMOVE OVERHEAD SIGN STRUCTURE - SPAN	EACH	6		6			
*	73602000	REMOVE OVERHEAD SIGN STRUCTURE - BRIDGE MOUNTED	EACH	7		7			
*	73700300	REMOVE CONCRETE FOUNDATION - OVERHEAD	EACH	14		14			
*	78005100	EPOXY PAVEMENT MARKING - LETTERS AND SYMBOLS	SQ FT	327	327				
*	78005110	EPOXY PAVEMENT MARKING - LINE 4"	F00T	100,671	100,671				
*	78005120	EPOXY PAVEMENT MARKING - LINE 5"	FOOT	26,758	26,758				
*	78005140	EPOXY PAVEMENT MARKING - LINE 8"	F00T	21,714	21,714				
*	78005150	EPOXY PAVEMENT MARKING - LINE 12"	F00T	5,824	5,824				
ļ	78200100	MONODIRECTIONAL PRISMATIC BARRIER REFLECTOR	EACH	1,643	1,643				
*	78200530	BARRIER WALL MARKERS, TYPE C	EACH	414	414				
*	78201000	TERMINAL MARKER, DIRECT APPLIED	EACH	1	1				
7 L	78300100	PAVEMENT MARKING REMOVAL	SQ FT	26,297	26,297				
N 000	81000600	CONDUIT IN TRENCH, 2" DIA., GALVANIZED STEEL	FOOT	299			299		
ом *	* SPECIALI	TY ITEM							

 F.A.I. SECTION	COUNTY	TOTAL	SHEET NO.
94/90 *	COOK	556	8
	TO STA.	-	
FED. ROAD DIST. NO ILLIN	NOIS FED. AID	PROJECT	-

62300 \* (1818, ETC, 2324.6-1P)R-8

S0Q-4

REVISIONS AMF	DATE	ILLINOIS DEPARTMENT OF TRANSPORTATION
		F.A.I. 94/90 (DAN RYAN EXPRESSWAY
		31ST STREET TO 71ST STREET NB EXPRESS LANE RECONSTRUCTION
		IND EXPRESS LANE RECONSTRUCTION
		SUMMARY OF QUANTITIES

SCALE: NONE

DRAWN BY: TAI CHECKED BY: PJM

Edvards

AND Kelcey

ONE NORTH FRANKLIN CHICAGO, IL 60606
PHONE: (312) 251-3005
WEB: WWW.EKCORP.COM

					90%	: FEDERAL	/ 10% ST	ATE	
				URBAN TOTAL	ROADWAY	SIGNING	SURVEILLANCE	SN 016-2625	SN 016-0142 SN 016-1148
CODE		ITEM DESCRIPTION	UNIT	QUANTITY	J000-2A	Y002-1C	Y032-1F	X928-2A	
* 81400		HEAVY-DUTY HANDHOLE	EACH	13			13		
* 81400		HEAVY-DUTY HANDHOLE (SPECIAL)	EACH	2			2		
* 81500	0200	TRENCH AND BACKFILL FOR ELECTRICAL WORK	F00T	305			305		
★ 8420	0800	POLE FOUNDATION, REMOVED	EACH	130	130				
K1003	3660	MOWING CYCLE	EACH	6	6				
X032	0870	BRACED EXCAVATION	CU YD	6,621	6,621				
X032	2256	TEMPORARY INFORMATION SIGNING	SQ FT	625	625				
X032	3221	PLUG AND ABANDON EXISTING PIPE	CU YD	251	251				
□ X032	3426	SEDIMENT CONTROL, DRAINAGE STRUCTURE INLET FILTER CLEANING	EACH	209	209				
X032	3988	TEMPORARY SOIL RETENTION SYSTEM	SQ FT	52,802	52,802				
X032	4112	BARRIER BASE	FOOT	27,958	27,958				
X032-	4431	TEMPORARY SOIL RETENTION SYSTEM (TO REMAIN IN PLACE)	SQ FT	763	763				
X032-	4697	SOIL STABILIZERS	POUND	65,508	65,508				
X032-	4698	APPLYING DUST SUPPRESSION AGENT	UNIT	110	110				
X4210	0400	LUG SYSTEM REMOVAL	EACH	3	3				
X4834	4090	PORTLAND CEMENT CONCRETE SHOULDERS 14"	SQ YD	52,802	52,802				
X606	3401	COMBINATION CONCRETE CURB AND GUTTER, TYPE M-4.12	FOOT	248	248				
X606	3600	COMBINATION CONCRETE CURB AND GUTTER, TYPE M-4.24	FOOT	951	951				
X6370	0910	CONCRETE BARRIER, SINGLE FACE 32" HEIGHT	FOOT	1,742	1,742				
X6370	0925	CONCRETE BARRIER SINGLE FACE 42" (SPECIAL)	FOOT	21,414	21,414				
X6370	0930	CONCRETE BARRIER, DOUBLE FACE, 32"	FOOT	2,715	2,715				
X6700	0410	ENGINEER'S FIELD OFFICE TYPE A (SPECIAL)	CAL MO	15	15				
X7011		TRAFFIC CONTROL AND PROTECTION (EXPRESSWAYS)	L SUM	1	1				
X7013		TRAFFIC CONTROL SURVEILLANCE, EXPRESSWAYS	CAL DA	303	303				
X7015		CHANGEABLE MESSAGE SIGN	CAL MO	59	59				
X7040		FURNISH TEMPORARY CONCRETE BARRIER	FOOT	17,081	17,081				
* X7330		OVERHEAD SIGN STRUCTURE WALKWAY, TYPE A			17,001	***			
XX00:		STABILIZED SUB-BASE, 6"	FOOT	100	017.000	100			
XXOO		PAVEMENT REINFORCEMENT 14"	SQ YD	213,296	213,296				
		VIDEO TAPING OF SEWERS	SQ YD	148,867	148,867				
* XX00			FOOT	1,191	1,191				
Z000:	•	BAR SPLICERS	EACH	257				2 <b>5</b> 7	
Z0013		CONSTRUCTION LAYOUT	L SUM	1	1				
Z0018		DRAINAGE STRUCTURES TO BE CLEANED	EACH	50	50				
▲ Z0029		IMPACT ATTENUATOR REMOVAL	EACH	6	6				
△ Z0030		IMPACT ATTENUATORS (SEVERE USE, NARROW), TEST LEVEL 3	EACH	3	3				
<u>∠ Z0030</u>		IMPACT ATTENUATORS (SEVERE USE, WIDE), TEST LEVEL 3	EACH	1	1				
▲ Z0030		IMPACT ATTENUATORS, (NON-REDIRECTIVE), TEST LEVEL 3	EACH	1	1				
Z0030	0250	IMPACT ATTENUATORS, TEMPORARY (NON-REDIRECTIVE), TEST LEVEL 3	EACH	6	6				
Z0040	0530	PIPE UNDERDRAIN REMOVAL	FOOT	290	290				
м	DESTALI	TV ITEM				L		1	

62300 \* (1818, ETC, 2324.6-1P)R-8

▲ INDICATES PAY CODE TYPE SFTY-3N

DRAWN BY: TAI

CHECKED BY: PJM

		500-5
REVISIONS	DATE	ILLINOIS DEPARTMENT OF TRANSPORTATION
INAME	DATE	F.A.I. 94/90 (DAN RYAN EXPRESSWAY)
		31ST STREET TO 71ST STREET
		NB EXPRESS LANE RECONSTRUCTION
		SUMMARY OF QUANTITIES
		SOMINANT OF QUANTITIES

AND KEICEU

ONE NORTH FRANKLIN CHICAGO, IL 60606 PHONE: 3122 251-3000 FAX: 3122 251-3015 WEB: WWW.EKCORP.COM

\* SPECIALITY ITEM

I NON - PARTICIPATING

				90% FEDERAL / 10% STATE				
			URBAN TOTAL	ROADWAY	SIGNING	SURVEILLANCE	SN 016-2625	SN 016-0142 SN 016-1148
	ITEM DESCRIPTION	UNIT	QUANTITY	J000-2A		Y032-1F		
Z0048665	RAILROAD PROTECTIVE LIABILITY INSURANCE	L SUM	1	0.8				0.2
<b>⊙</b> <del>Z0076600</del>		HOUR						
* X7360 100	REMOVE OVERHEAD SIGN STRUCTURE - CANTILEVER (VMS)	EACH	1	1				
* X8100042	CONDUIT ENCASED, CONCRETE, 3" DIA., PVC	FOOT	766			766		
* X0325080	VIDEO TAPING OF MWRD CULVERT	FOOT	245				245	
X4810100	TEMPORARY SHOULDERS	SQ YD	8,545	8,545				
X032508\	CONCRETE SLAB HYDRO-DEMOLITION	SQ YD	237				237	
X6370927	CONCRETE BARRIER SINGLE FACE 72" (SPECIAL)	FOOT	271	271				
X0325082	CTA BARRIER REMOVAL	FOOT	21,781	21,781		,		
X0325083	CTA FENCE	FOOT	21/335	21,248			87	
X0325089	CTA GATES	EACH	23	23				
X0325085	TEMPORARY PAVEMENT (INTERSTATE)	SQ. YD	9,394	9,394				
X7011008	TRAFFIC CONTROL AND PROTECTION OR ALTERNAE ROUTE SIGNING	CAL MO	10	10				
X0325086	TEMPORARY CTA BALLAST RETENTION	L SUM	1				1	
· X0315087	VIDEO TAPING OF MAIN DRAIN	FOOT	43,620	32,960			10,660	
* X0321027	DRILLING GROUT HOLES	FOOT	60	60.				
· X3540580	PORTLAND CEMENT IN GROUT	CU FT	50	50				
· X0325088	PLACEMENT OF CEMENT GROUT	CU FT	150	150				ļ
* X0325089	CONNECTION TO GROUT HOLE	EACH	4	4				
60248000	JUNCTION CHAMBER NO. 1	EACH	1	1				
60248100	JUNCTION CHAMBER NO. 2	EACH	1	1				
X0325090	MAINDRAIN DROP MANHOLE NO. 1	EACH	1	1				<u></u>
X0325091	MAINDRAIN DROP MANHOLE NO. 2	EACH	1	1				ļ
X0325092	MAINDRAIN DROP MANHOLE NO. 3	EACH	1	1				
X0325093	MAINDRAIN DROP MANHOLE NO. 4	EACH	1	1				
	MAINDRAIN DROP MANHOLE NO. 5	EACH	1	1				
60248200	JUNCTIONCHAMBER NO. 3	EACH	1	1				
60248300	JUNCTIONCHAMBER NO. 4	EACH	1	1				
60248400	JUNCTIONCHAMBER NO. 5	EACH	1	1				
60248500	JUNCTIONCHAMBER NO. 6	EACH	1	1				
60248600	JUNCTIONCHAMBER NO. 7	EACH	1	1				
60248610	JUNCTIONCHAMBER NO. 8	EACH	1	1				
60248620	JUNCTIONCHAMBER NO. 9	EACH	1	1				
60248630	JUNCTIONCHAMBER NO. 10	EACH	1	1		,		
* X0325095		FOOT	32,900	32,900				
* 66900200	NON-SPECIAL WASTE DISPOSAL	CU YD	804	804				
* 66900450	SPECIAL WASTE PLANS AND REPORT	L SUM	1	1				
± 66900530	SOIL DISPOSAL ANALYSIS	EACH	1	1		*		
66402900	CHAIN LINK GATE, 6' X 6' SINGLE	EACH	23	23				
		LAUN	23	23				
* SPECIAL	ITY ITEM							

F.A.I. RTE.	SECTION	COUNTY	TOTAL	SHEET NO.							
94/90	*	COOK	556	10							
STA.	STA. TO STA.										
FED. R	FED. ROAD DIST. NO ILLINOIS FED. AID PROJECT										
623	62300 * (1818, ETC, 2324.6-1P)R-8										

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REVISIONS		ILLINOIS DEPARTMENT OF TRANSPORTATION	٦
NAME	DATE	ILLINOIS DEFARIMENT OF TRANSPORTATION	ŀ
		F.A.I. 94/90 (DAN RYAN EXPRESSWAY)	
		31ST STREET TO 71ST STREET	1
		NB EXPRESS LANE RECONSTRUCTION	
			ı
		SUMMARY OF QUANTITIES	ŀ

SCALE: NONE

DRAWN BY: TAI

AND KEICEU

ONE NORTH FRANKLIN CHICACO, IL 60606

AND KEICEU

FAX: (312) 251-3010

FEE WWW.EXCOPP.COM

				90% FEDERAL / 10% STATE					
			<i>URBAN</i> TOTAL	ROADWAY	SIGNING	SURVEILLANCE	SN 016-2625	SN 016-0142	
CODE NO.	ITEM DESCRIPTION	UNIT	QUANTITY				X928-2A		
Z0018800	DRAINAGE SYSTEM	L SUM	1	1					
	UNTREATED TIMBER LAGGING	SQ FT	14,027	14,027					
X0324455	DRILLING AND SETTING SOLDIER PILES (IN SOIL)	CU YD	35,885	35,885					
	FURNISHING SOLDIER PILES W 12X72	FOOT	3,040	3,040					
	FURNISHING SOLDIER PILES W 12X106	FOOT	4,980	4,980					
	FURNISHING SOLDIER PILES W 12X120			4,170					
X5120907		FOOT	4,170						
	DRILL AND GROUT DOWEL BARS	EACH	5,818	5,818					
50200100	STRUCTURE EXCAVATION	CU YD	1,123	1,123					
60200805	CATCH BASINS, TYPE A, 4'-DIAMETER, TYPE 8 GRATE	EACH	1	1					
60248640	JUNCTIONCHAMBER NO. 11	EACH	1	1					
60248650	JUNCTIONCHAMBER NO. 12	EACH	1	1					
60248660	JUNCTIONCHAMBER NO. 13	EACH	1	1					
81000800	CONDUIT IN TRENCH, 3" DIA., GALVANIZED STEEL	FOOT	6			6			
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								<u> </u>	
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								<u></u>	
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* SPECIAL	TTV TTEM	<del></del>			<del></del>	·			

F.A.I. RTE.	SECTION	ı	COUNT	Y	TOTAL SHEETS	SHEET NO.
94/90	<b>*</b>		COOK		556	11
STA.		TO	STA.			
FED. RO	AD DIST. NO	ILLINOIS	FED.	AID	PROJECT	
623	00 * (18	318, ETC	. 2324	l.6-1F	P)R-8	

S0Q-7

REVISIONS		ILLINOIS DEPARTMENT OF TRANSPORTATION
NAME	DATE	ILLINOIS DEFARTMENT OF TRANSPORTATION
		F.A.I. 94/90 (DAN RYAN EXPRESSWAY)
* -		31ST STREET TO 71ST STREET
		NB EXPRESS LANE RECONSTRUCTION
		SUMMARY OF QUANTITIES

SCALE: NONE DATE: 7/7/05 DRAWN BY: TAI CHECKED BY: PJM

Edwards

AND Kelcey


ONE NORTH FRANCLIN CHICAGO, IL 66666

FAX (32) 281-3015

FAX (32) 281-3015


WHILEGORP.COM


\* SPECIALITY ITEM

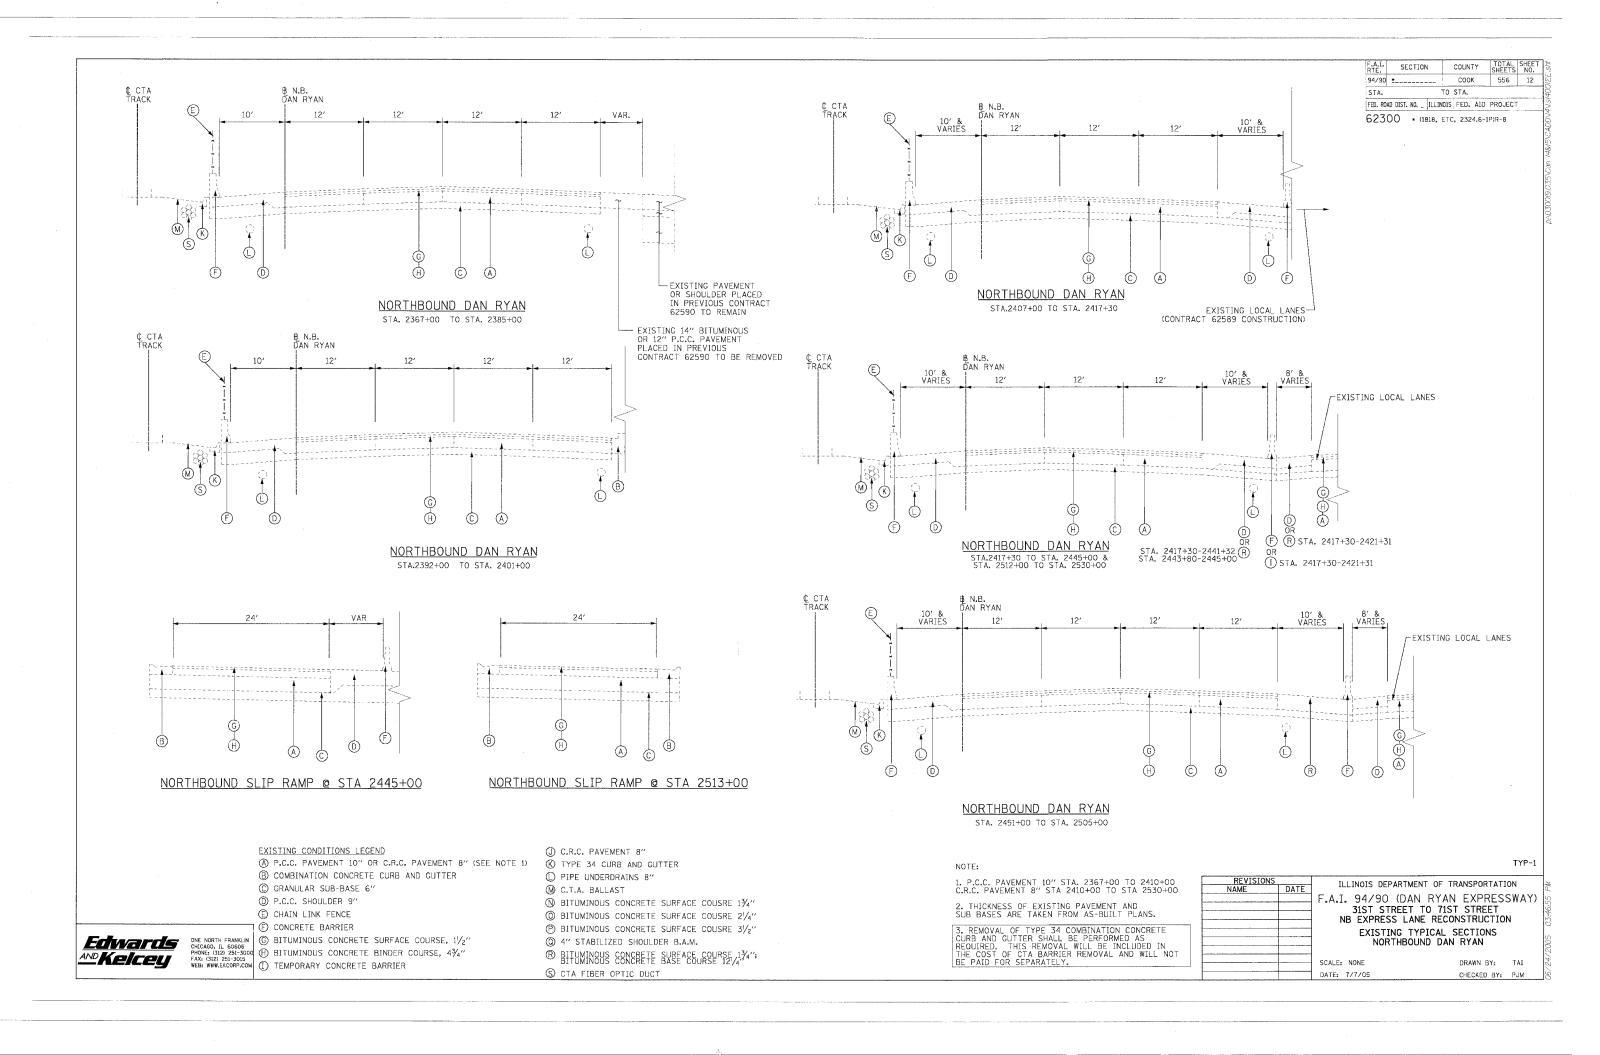




62300 •(1818, ETC, 2324.6-1P)R-8

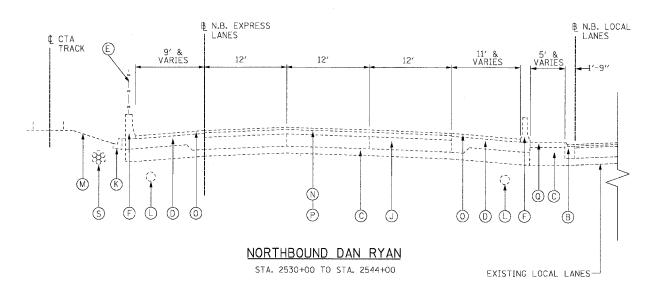

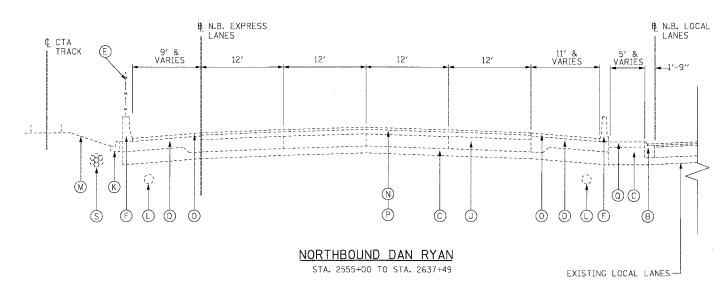

(AREA OF SLIP RAMP GORES FROM STA. 2544+00 TO STA. 2555+00 IS SIMILAR TO THE ABOVE SECTIONS)

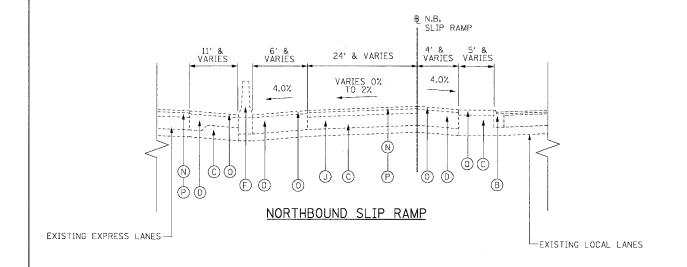

#### EXISTING CONDITIONS LEGEND

- A P.C.C. PAVEMENT 10"
- (B) COMBINATION CONCRETE CURB AND GUTTER
- © CRANULAR SUB-BASE 6" (VARIES 18"-42" FROM STA. 2582+21 TO STA. 2637+55 SEE SCHEDULE ON THIS SHEET- AND AT SHOULDERS)
- D P.C.C. SHOULDER 9"
- © CHAIN LINK FENCE
- © CONCRETE BARRIER
- © BITUMINOUS CONCRETE SURFACE COURSE, 11/2"
- ⊕ BITUMINOUS CONCRETE BINDER COURSE, 4¾"
- ① TEMPORARY CONCRETE BARRIER
- (J) C.R.C. PAVEMENT 8"
- (K) TYPE 34 CURB AND GUTTER
- □ PIPE UNDERDRAINS 8 "
- (M) C.T.A. BALLAST
- N BITUMINOUS CONCRETE SURFACE COURSE, 13/4"
- P BITUMINOUS CONCRETE BINDER COURSE, 31/2"
- ② 4" STABILIZED SHOULDER B.A.M.
- ® BITUMINOUS CONCRETE SURFACE COURSE 1¾"
  BITUMINOUS CONCRETE BASE COURSE 121/4"
- S C.T.A. FIBER OPTIC DUCT

EXISTING VARYING DEPTH SUB-B	ASE GRANULAR MATERIAL
STATION	DEPTH
2582+21 - 2586+54	18"
2586+54 - 2587+54	18" - 36"
2587+54 - 2605+69	36"
2605+69 - 2607+84	36" - 18"
2607+84 - 2608+79	18"
2608+79 - 2611+84	24'' - 42''
2611+84 - 2618+84	42"
2618+84 - 2622+84	42'' - 18''
2622+84 - 2627+34	18'' - 42''
2627+34 - 2631+64	42''
2631+64 - 2636+34	42" - 18"
2636+34 - 2637+55	18" - 26"


TYP-02

#### NOTES

- 1. THICKNESS OF EXISTING PAVEMENT AND SUB BASES ARE TAKEN FROM AS-BUILT PLANS.
- 2. SUPERELEVATED SECTIONS ARE SIMILAR TO TANGENT SECTIONS.
- 3. REMOVAL OF TYPE 34 COMBINATION CONCRETE CURB AND GUTTER SHALL BE PERFORMED AS REQUIRED. THIS REMOVAL WILL BE INCLUDED IN THE COST OF CTA BARRIER REMOVAL AND WILL NOT BE PAID FOR SEPARATELY.

|--|


REVISIONS
NAME
DATE
F.A.I. 94/90 (DAN RYAN EXPRESSWAY)
31ST STREET TO 71ST STREET
NB EXPRESS LANE RECONSTRUCTION
EXISTING TYPICAL SECTIONS
NORTHBOUND DAN RYAN
SCALE: NTS
DATE: 07/07/05
CHECKED BY: JDC

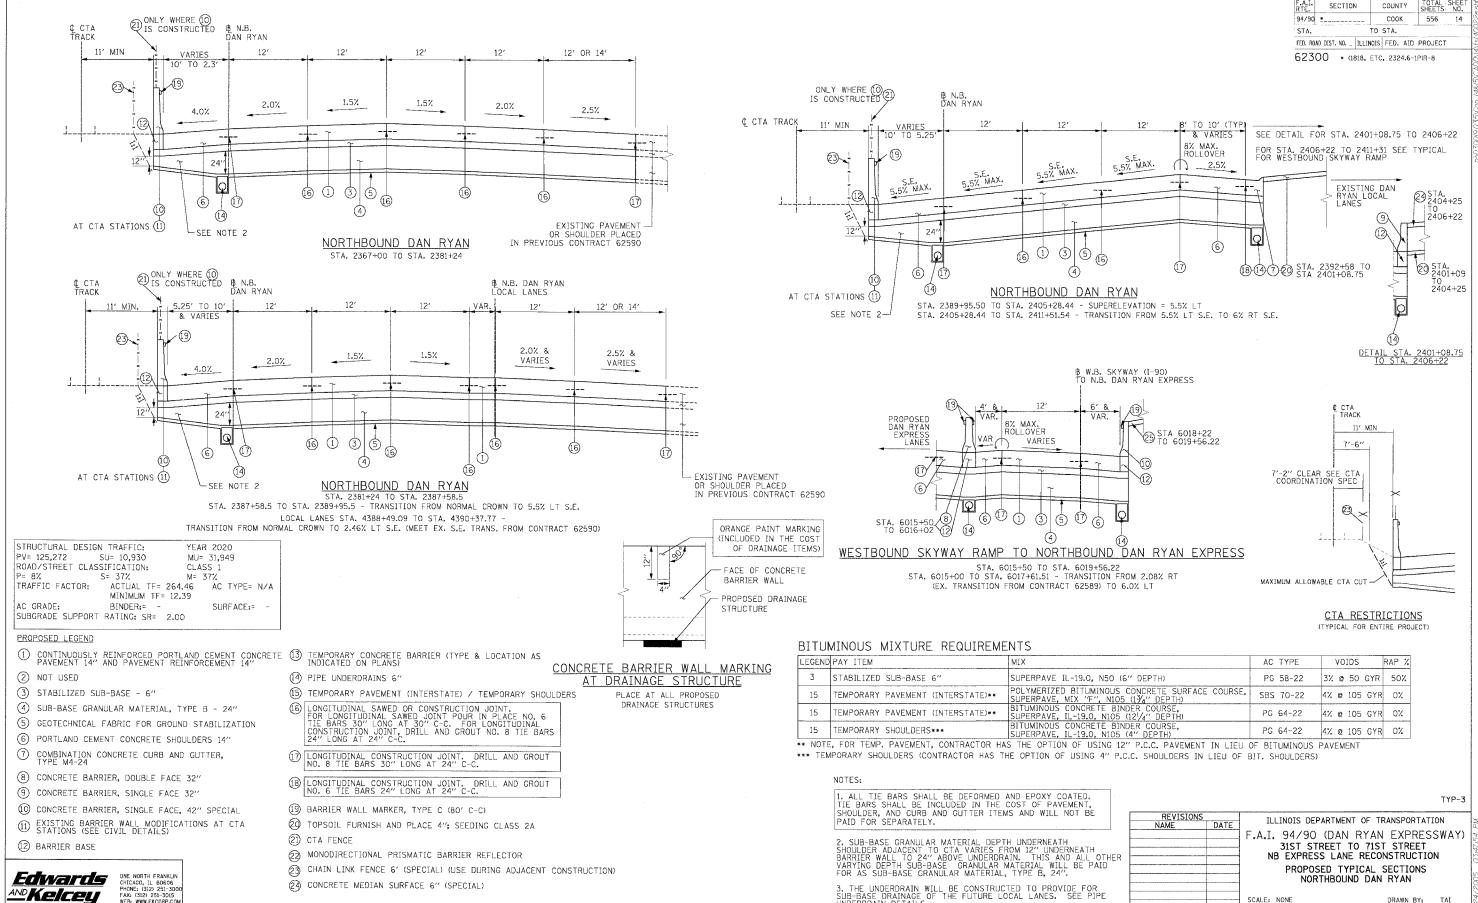

DRAWN BY: TAI

CHECKED BY:

DATE: 7/7/05

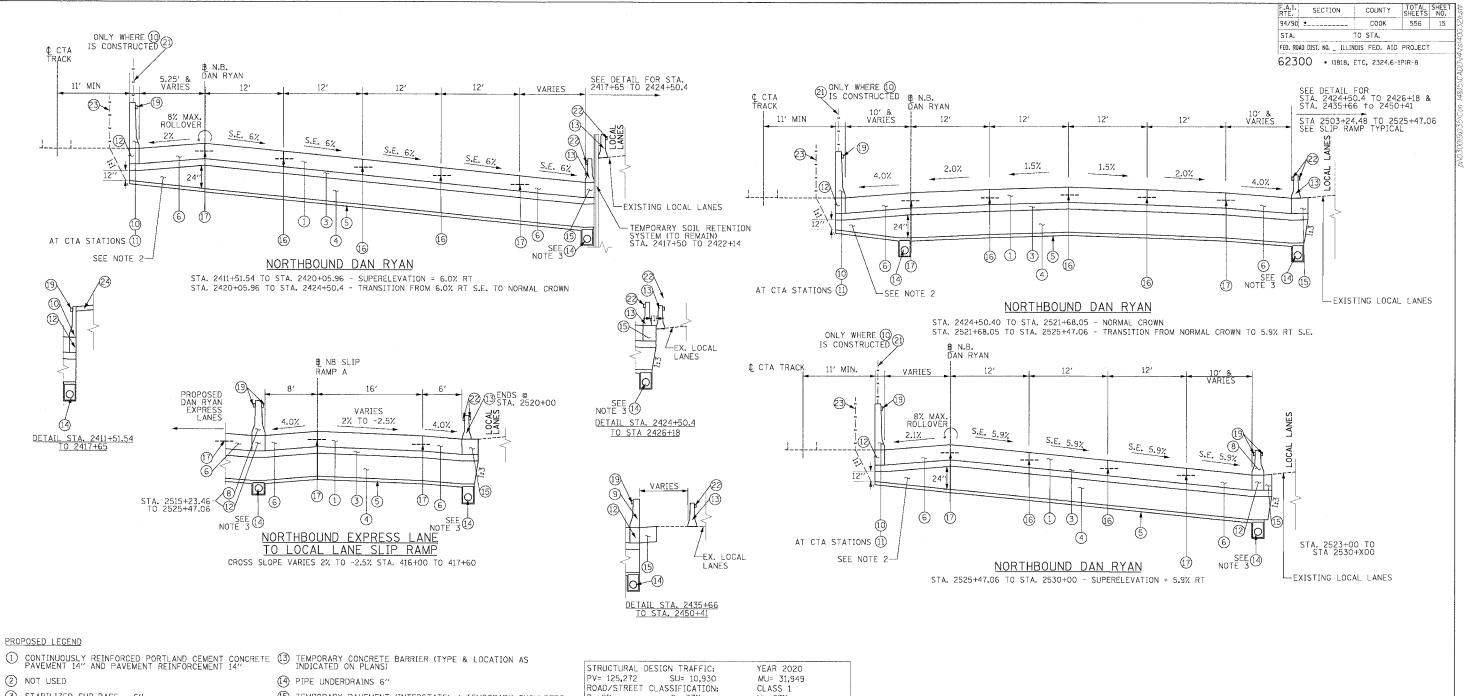

- 3 STABILIZED SUB-BASE 6"
- (4) SUB-BASE GRANULAR MATERIAL, TYPE B 24"
- (5) GEOTECHNICAL FABRIC FOR GROUND STABILIZATION
- 6 PORTLAND CEMENT CONCRETE SHOULDERS 14"
- 7 COMBINATION CONCRETE CURB AND GUTTER, TYPE M4-24
- (8) CONCRETE BARRIER, DOUBLE FACE 32"
- ONCRETE BARRIER, SINGLE FACE 32"
- 10 CONCRETE BARRIER, SINGLE FACE, 42" SPECIAL
- ① EXISTING BARRIER WALL MODIFICATIONS AT CTA

ONE NORTH FRANKLIN CHICAGO, IL 60606 PHONE: (312) 251-300: FAX: (312) 251-3015 WEB: WWW.EKCORP.COM

12 BARRIER BASE

Edvards AND Kelcey

- (15) TEMPORARY PAVEMENT (INTERSTATE) / TEMPORARY SHOULDERS
- (16) LONGITUDINAL SAWED OR CONSTRUCTION JOINT. FOR LONGITUDINAL SAWED JOINT POUR IN PLACE NO. 6 TIE BARS 30" LONG AT 30" C-C. FOR LONGITUDINAL CONSTRUCTION JOINT, DRILL AND GROUT NO. 8 TIE BARS 24" LONG AT 24" C-C.
- (1) LONGITUDINAL CONSTRUCTION JOINT. DRILL AND GROUT NO. 8 TIE BARS 30" LONG AT 24" C-C.
- (18) LONGITUDINAL CONSTRUCTION JOINT. DRILL AND GROUT NO. 6 TIE BARS 24" LONG AT 24" C-C.
- 19 BARRIER WALL MARKER, TYPE C (80' C-C)
- TOPSOIL FURNISH AND PLACE 4"; SEEDING CLASS 2A
- MONODIRECTIONAL PRISMATIC BARRIER REFLECTOR
- (3) CHAIN LINK FENCE 6' (SPECIAL) (USE DURING ADJACENT CONSTRUCTION)
- (2) CONCRETE MEDIAN SURFACE 6" (SPECIAL)

P= 8% S= 37% M= 37% TRAFFIC FACTOR: ACTUAL TF= 264.46 AC TYPE= N/A MINIMUM TF= 12.39 AC GRADE: BINDER:= SURFACE:= SUBGRADE SUPPORT RATING: SR= 2.00

#### NOTES:

1. ALL TIE BARS SHALL BE DEFORMED AND EPOXY COATED. TIE BARS SHALL BE INCLUDED IN THE COST OF PAVEMENT, SHOULDER, AND CURB AND GUTTER ITEMS AND WILL NOT BE PAID FOR SEPARATELY.


2. SUB-BASE GRANULAR MATERIAL DEPTH UNDERNEATH SHOULDER ADJACENT TO CTA VARIES FROM 12" UNDERNEATH BARRIER WALL TO 24" ABOVE UNDERDRAIN. THIS AND ALL OTHER VARYING DEPTH SUB-BASE GRANULAR MATERIAL WILL BE PAID FOR AS SUB-BASE GRANULAR MATERIAL, TYPE B, 24".


3, THE UNDERDRAIN WILL BE CONSTRUCTED TO PROVIDE FOR SUB-BASE DRAINAGE OF THE FUTURE LOCAL LANES. SEE PIPE UNDERDRAIN DETAILS.


ILLINOIS DEPARTMENT OF TRANSPORTATION F.A.I. 94/90 (DAN RYAN EXPRESSWAY) 31ST STREET TO 71ST STREET NB EXPRESS LANE RECONSTRUCTION PROPOSED TYPICAL SECTIONS NORTHBOUND DAN RYAN


SCALE: NONE DATE: 7/7/05

DRAWN BY: TAT CHECKED BY: PJ

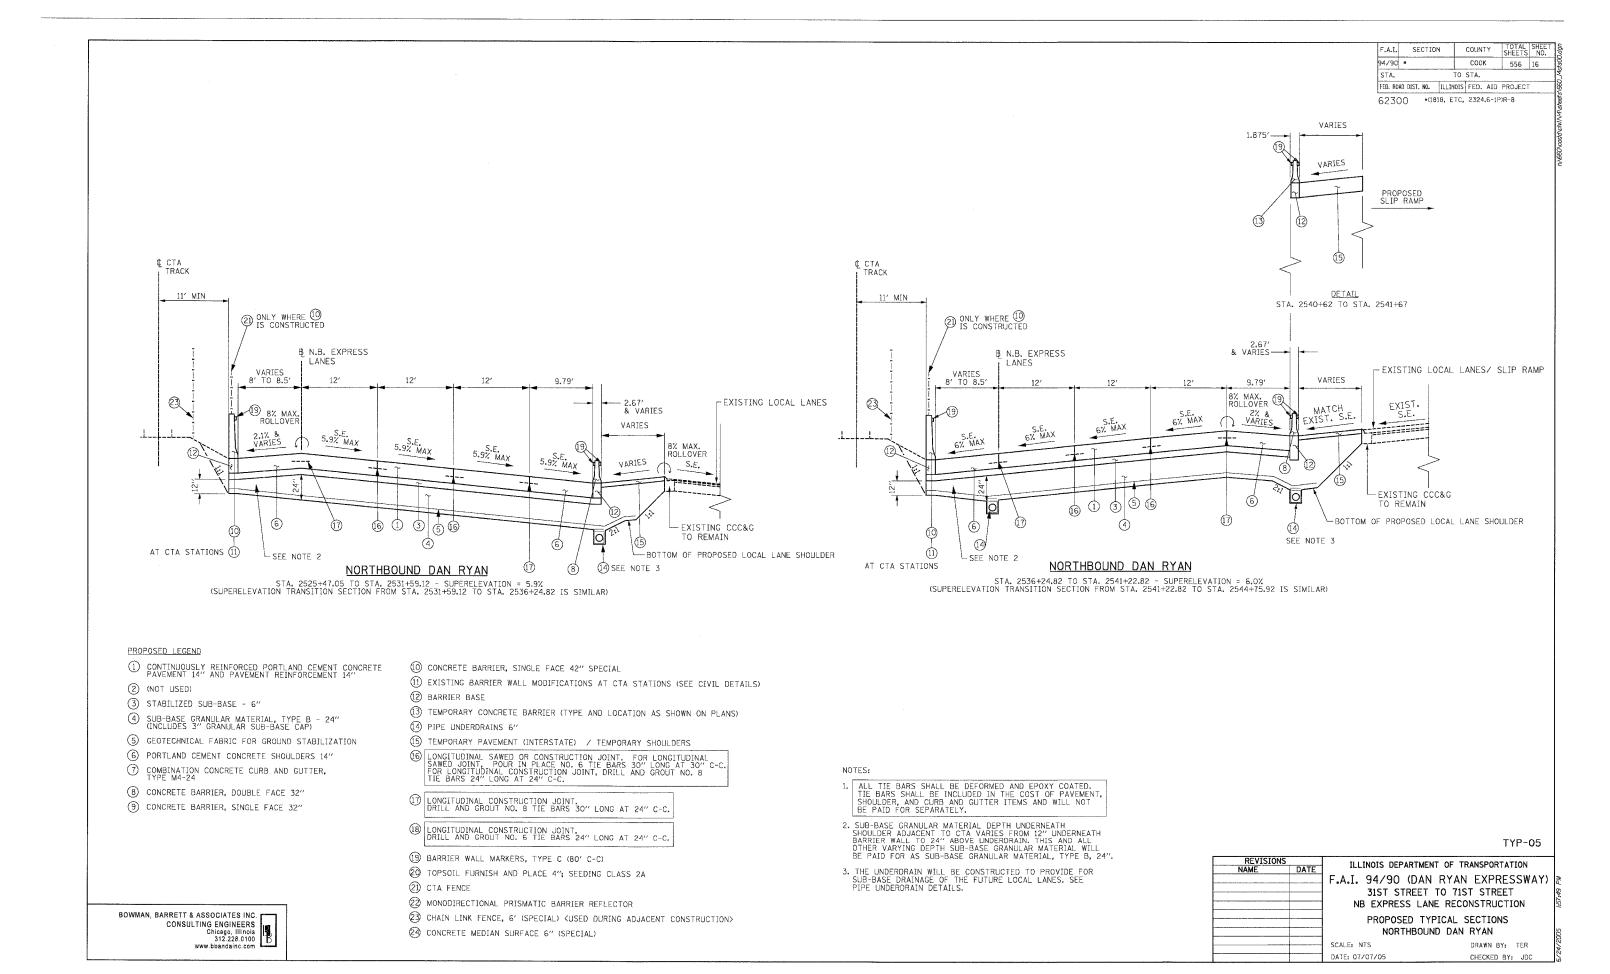

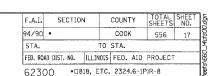

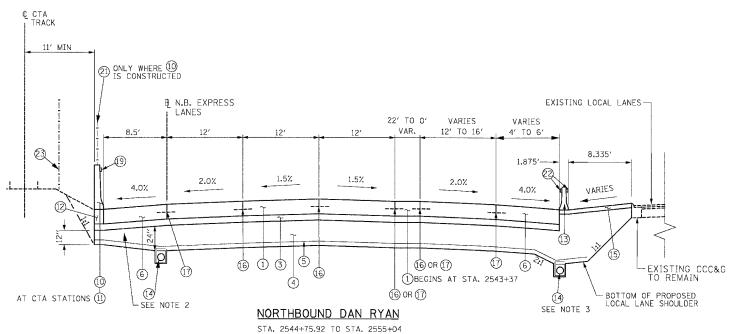

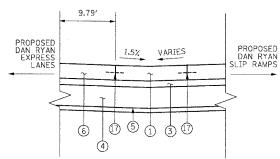



### NORTHBOUND SLIP RAMP GORES

#### PROPOSED LEGEND

- 1 CONTINUOUSLY REINFORCED PORTLAND CEMENT CONCRETE PAVEMENT 14" AND PAVEMENT REINFORCEMENT 14"
- (2) (NOT USED)
- 3 STABILIZED SUB-BASE 6"
- 4 SUB-BASE GRANULAR MATERIAL, TYPE B 2
- (5) GEOTECHNICAL FABRIC FOR GROUND STABILIZATION
- 6 PORTLAND CEMENT CONCRETE SHOULDERS 14"
- 7 COMBINATION CONCRETE CURB AND GUTTER, TYPE M4-24
- (8) CONCRETE BARRIER, DOUBLE FACE 32"
- (9) CONCRETE BARRIER, SINGLE FACE 32"

- 10 CONCRETE BARRIER, SINGLE FACE 42" SPECIAL
- (1) EXISTING BARRIER WALL MODIFICATIONS AT CTA STATIONS (SEE CIVIL DETAILS)
- 12) BARRIER BASE
- (3) TEMPORARY CONCRETE BARRIER (TYPE AND LOCATION AS SHOWN ON PLANS)
- (14) PIPE UNDERDRAINS 6"
- (15) TEMPORARY PAVEMENT (INTERSTATE) / TEMPORARY SHOULDERS
- (6) LONGITUDINAL SAWED OR CONSTRUCTION JOINT. FOR LONGITUDINAL SAWED JOINT, POUR IN PLACE NO. 6 TIE BARS 30" LONG AT 30" C-C. FOR LONGITUDINAL CONSTRUCTION JOINT, DRILL AND GROUT NO. 8 TIE BARS 24" LONG AT 24" C-C.
- [] LONGITUDINAL CONSTRUCTION JOINT. DRILL AND GROUT NO. 8 TIE BARS 30" LONG AT 24" C-C.
- (19) BARRIER WALL MARKERS, TYPE C (80' C-C)
- TOPSOIL FURNISH AND PLACE 4"; SEEDING CLASS 2A
- ②1) CTA FENCE
- 2 MONODIRECTIONAL PRISMATIC BARRIER REFLECTOR
- (3) CHAIN LINK FENCE, 6' (SPECIAL) (USED DURING ADJACENT CONSTRUCTION)
- 23 CONCRETE MEDIAN SURFACE 6" (SPECIAL)

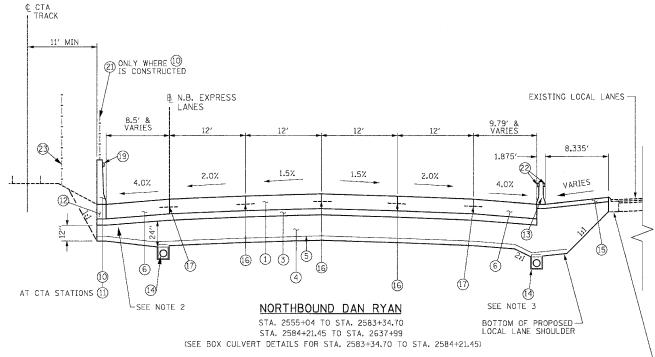

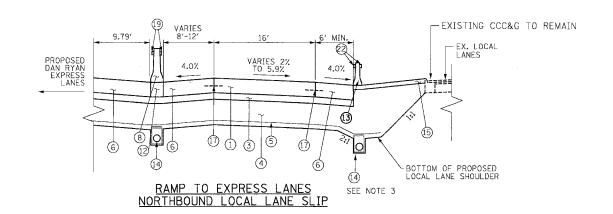

#### NOTES:

- 1. ALL TIE BARS SHALL BE DEFORMED AND EPOXY COATED.
  TIE BARS SHALL BE INCLUDED IN THE COST OF PAVEMENT,
  SHOULDER, AND CURB AND GUTTER ITEMS AND WILL NOT
  BE PAID FOR SEPARATELY.
- 2. SUB-BASE GRANULAR MATERIAL DEPTH UNDERNEATH SHOULDER ADJACENT TO CTA VARIES FROM 12" UNDERNEATH BARRIER WALL TO 24" ABOVE UNDERDRAIN. THIS AND ALL OTHER VARYING DEPTH SUB-BASE GRANULAR MATERIAL WILL BE PAID FOR AS SUB-BASE GRANULAR MATERIAL, TYPE B, 24".
- 3. THE UNDERDRAIN WILL BE CONSTRUCTED TO PROVIDE FOR SUB-BASE DRAINAGE OF THE FUTURE LOCAL LANES, SEE PIPE UNDERDRAIN DETAILS.

TYP-06

EXISTING CCC&G -

TO REMAIN

REVISIONS NAME DATE	ILLINOIS DEPARTMENT OF	TRANSPORTATION
HAME DATE	F.A.I. 94/90 (DAN RYA	N EXPRESSWAY)
	31ST STREET TO 71 NB EXPRESS LANE REC	
	PROPOSED TYPICAL NORTHBOUND DAM	
	SCALE: NTS	N RYAN  DRAWN BY: TER  CHECKED BY: JDC
	DATE: 07/07/05	CHECKED BY: JDC

BOWMAN, BARRETT & ASSOCIATES INC.
CONSULTING ENGINEERS
Chicago, Illinois
312.228.0100
www.bbandainc.com

F.A.I. RTE.	SECTION		COUNT	ſΥ	TOTAL	SHEET NO.
94/90 *		COOF	(	556	18	
STA.		TO	STA.			
EED BOAD DE	TILT ON TE	NOTS	EED	ATD	PROJECT	

62300 \* (1818, ETC, 2324.6-1P)R-8

## PAVEMENT, SHOULDERS, AND MEDIANS

STATION	TO STATION	CONT REINF PCC PVT 14 (SQ YD)	PAVT REINF 14 (SQ YD)	PCC SHOULDERS 14 (SQ YD)	TEMP PAVEMENT (SQ YD)	TEMP SHOULDERS (SQ YD)	STAB SUB- BASE 6 (SQ YD)	SUB GRAN MAT B 24 (SQ YD)	GEOTECH FAB F/GR STAB (SQ YD)	CONC MEDIAN SURF 6 SP (SQ YD)	PROTECTIVE COAT (SQ YD)	BIT SHLD SUPER 6 (SQ YD)
2367+00	2382+00	11,345	11,345	1,123	545		12,657	12,657	12,657		12,519	
2382+00	2397+00	9,650	9,650	2,161	693		12,164	12,164	12,164		11,811	36
2397+00	2412+00	6,735	6,735	2,890			10,154	10,154	10,154	1810	9,625	
2412+00	2427+00	8,000	8,000	1,605	178		10,112	10,112	10,112	2187	9,783	
2427+00	2442+00	8,000	8,000	2,938	500		11,799	11,799	11,799		11,438	
2442+00	2457+00	8,000	8,000	3,383	420	557	12,222	12,222	12,222		11,803	
2457+00	2472+00	8,000	8,000	3,348	413		12,014	12,014	12,014		11,761	
2472+00	2487+00	8,000	8,000	3,145	531		11,805	11,805	11,805		11,676	
2487+00	2502+00	8,067	8,067	3,104	660		12,098	12,098	12,098		11,831	
2502+00	2517+00	9,660	9,660	3,631	1,953		15,532	15,532	15,532		15,244	
2517+00	2530+00	6,232	6,232	3,184	1,407		11,373	11,373	11,373		10,823	
2530+00	2542+00	4862	4862	2515	326	1034	7529	9201	7903		7377	70.000
2542+00	2554+00	7959	7959	3140		1228	11365	12878	11823		11099	
2554+00	2566+00	6412	6412	2471		1054	9149	10215	9682		8883	
2566+00	2578+00	6400	6400	2471	426	591	9137	10317	9897		8871	
2578+00	2590+00	5937	5937	2264	414	659	8449	9676	9316		8201	
2590+00	2602+00	6400	6400	2440		1167	9108	10288	9881		8840	
2602+00	2614+00	6400	6400	2302	409	655	8856	9990	9563		8702	
2614+00	2626+00	6400	6400	2147	518	590	8568	9701	9221		8547	
2626+00	2637+49	6407	6407	2542		1011	9215	10348	9848		8949	
ТОТ	TAL	146,867	146,867	52,802	9,394	8,545	213,296	225,099	219,063	3,997	207,782	36

### PAVEMENT & SHOULDER REMOVAL

STATION	TO STATION	PAVEMENT REM (SQ YD)	PAVED SHLD REMOVAL (SQ YD)	APPROAC SLAB RE (SQ YD)
2367+00	2382+00	9,398	1,500	
2382+00	2397+00	11,262	1,951	
2397+00	2412+00	8,007	3,107	
2412+00	2427+00	6,999	3,039	
2427+00	2442+00	7,618	3,367	
2442+00	2457+00	9,110	3,524	
2457+00	2472+00	8,083	3,333	
2472+00	2487+00	8,094	3,127	
2487+00	2502+00	8,100	3,333	
2502+00	2517+00	10,036	4,352	
2517+00	2530+00	6,900	4,117	
2530+00	2542+00	6094	3044	
2542+00	2554+00	7774	3982	
2554+00	2566+00	6406	3060	
2566+00	2578+00	6400	3147	
2578+00	2590+00	6038	3071	
2590+00	2602+00	6400	3167	219
2602+00	2614+00	6400	3110	
2614+00	2626+00	6400	3027	
2626+00	2637+49	6395	3291	
то	TAL	151,914	63,648	219

ECIVATES

ONE NORTH FRANKLIN
CHICACO, 11. 60606
PHONE: (312) 251-3001
WEB: WWW.EKCORP.COM

REVISIONS NAME	DATE	ILLINOIS DEPARTMENT OF TRANSPORTATION			
		F.A.I. 94/90 (DAN RYAN EXPRESSWAY) 31ST STREET TO 71ST STREET			
		NB EXPRESS LANE RECONSTRUCTION			
		ROADWAY SCHEDULE			

SCALE: NONE DATE: 7/7/05 DRAWN BY: TAI CHECKED BY: PJM

F.A.I. RTE.	SECTION	COUN	ΤΥ	TOTAL SHEETS	SHEET NO.
94/90 *		000	<	556	19
STA.		TO STA.	-	A	
FED ROAD DE	ST NO TILE	NOIS FED	ΔTD	PROJECT	

62300 • (1818, ETC, 2324.6-1P)R-8

## CONCRETE BARRIER WALL, COMBINATION CONCRETE CURB AND GUTTER, & CTA FENCE

STATION	TO STATION	CONC BAR 1F 32HT (FOOT)	CONC BAR 1F 42HT SPL (F00T)	CTA FENCE (FOOT)	CONC BAR 1F 72HT SPL (FOOT)	CONC BAR 2F 32HT (FOOT)	CONC BAR TRANS (FOOT)	BARRIER BASE (FOOT)	BARRIER WALL MARKERS (EACH)	COMB CC&G TM4.24 (FOOT)	CTA GATE (EACH)	PROTECTIVE COAT (SQ YD)
2367+00	2382+00		811	826			15	826	10		1	679
2382+00	2397+00		1297	1338	66		39	1402	18	442	1	1,251
2397+00	2412+00	413	1600	1418		80	60	2153	28	509	2	1,834
2412+00	2427+00		1720	1376			110	1830	23		2	1,570
2427+00	2442+00	500	1500	1467				2000	25		1	1,563
2442+00	2457+00	829	1371	1423			- 40	2240	28	1 1100	2	1,707
2457+00	2472+00		1411	1441			60	1471	19		1	1,209
2472+00	2487+00		527	572	30		91	693	9	****	1	586
2487+00	2502+00		1426	1438	39		68	1533	19		1	1,282
2502+00	2517+00		1398	1413		177	15	1590	22		1	1,307
2517+00	2530+00		1134	1149		1171	45	2350	44		1	1,932
2530+00	2542+00		162	162		1150	40	1352	45			978
2542+00	2554+00		1125	1100	75	137	28	1365	19		2	732
2554+00	2566+00		1076	1096			102	1177	15		2	538
2566+00	2578+00		993	1066			128	1121	15	MP (MP) . MODELS A. (-)		496
2578+00	2590+00		1000	1104		1111/1/2017	45	1045	15		1	500
2590+00	2602+00		1200	1188		- Secretary - 1	24	1224	15		1	600
2602+00	2614+00		680	683			31	711	15		1	340
2614+00	2626+00		93	81			15	108	15		1	47
2626+00	2637+49		890	907	61		52	1002	15		1	495
TO:	TAL	1,742	21,414	21,248	271	2,715	972	27,958	414	951	23	19,648

## CONCRETE BARRIER & COMBINATION CONCRETE CURB AND GUTTER REMOVAL

STATION	TO STATION	CONC BARRIER REMOV (FOOT)	CTA BARRIER REMOV (FOOT)	COMB CURB GUTTER REM (FOOT)
2367+00	2382+00		907	720
2382+00	2397+00		1393	593
2397+00	2412+00	30	1418	880
2412+00	2427+00	1019	1418	478
2427+00	2442+00	1500	1500	68
2442+00	2457+00	1,526	1422	604
2457+00	2472+00	1441	1441	
2472+00	2487+00	1376	501	
2487+00	2502+00	1467	1478	
2502+00	2517+00	1474	1413	1185
2517+00	2530+00	1200	1150	1250
2530+00	2542+00	1200	162	1045
2542+00	2554+00	1250	1200	2008
2554+00	2566+00	1126	1117	
2566+00	2578+00	1051	1060	
2578+00	2590+00	1102	1114	
2590+00	2602+00	1200	1200	
2602+00	2614+00	1112	694	
2614+00	2626+00	1132	93	
2626+00	2637+49	1111	1100	
ТО	TAL	21,318	21,780	8,832

AND KEICEL ONE NORTH FRANKLIN CHICAGO, IL 66666
AND KEICEL FAX: (3)22 521-3016
FAX: (3)22 521-3016
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ILLINOIS DEPARTMENT OF TRANSPORTATION F.A.I. 94/90 (DAN RYAN EXPRESSWAY)
31ST STREET TO 71ST STREET
NB EXPRESS LANE RECONSTRUCTION ROADWAY

SCHEDULE

SCALE: NONE DATE: 7/7/05 DRAWN BY: TAI

CHECKED BY: PJM

 F.A.I. RTE.	SECTION COUNTY					SHEET NO.
94/90	<b>9</b>		COOK		556	20
STA.		TO	STA.			
FED. RO	AD DIST. NO.	ILLINOIS	FED.	AID	PROJECT	

62300 \* (1818, ETC, 2324.6-1P)R-8

## TERMINAL SECTIONS AND IMPACT ATTENUATORS

STATION	TO STATION	IMP ATTEN SU NAR TL3 (EACH)	IMP ATTEN SU WID TL3 (EACH)	IMPACT ATTEN NRD TL3 (EACH)	IMP ATTEN TEMP NRD TL3 (EACH)	IMPACT ATTENUATOR REM (EACH)	TR BAR TRM T1 SPL TAN (EACH)	TRAF BAR TERM T6 (EACH)
2367+00	2382+00				4	2		
2382+00	2397+00		1				1	1
2397+00	2412+00							
2412+00	2427+00	1						
2427+00	2442+00			1	1			1000
2442+00	2457+00					1		
2457+00	2472+00							
2472+00	2487+00				1			
2487+00	2502+00							
2502+00	2517+00	1						
2517+00	2530+00					1		
2530+00	2542+00			1				
2542+00	2554+00	1				1		
2554+00	2566+00					31000		
2566+00	2578+00							
2578+00	2590+00							
2590+00	2602+00							
2602+00	2614+00							
2614+00	2626+00			-				
2626+00	2637+99					· · · · · · · · · · · · · · · · · · ·		
SK	YWAY					1		
TO	TAL	3	1	1	6	6	1	1

### TEMPORARY CONCRETE BARRIER

STATION	TO STATION	EXISTING TEMP. BARRIER ON SITE (FT)	TEMP. BARRIER FOR STAGE 1 & 3 (FT)	ADDITIONAL TEMP BARRIER FOR STAGE 2 (FT)	TEMP. BARRIER FOR FINAL CONDITION (FT)	CONC BARRIER	TEMP CONC BARRIER (FOOT)	REL TEMP CONC BARRIER (FOOT)
2367+00	2382+00		1850				1850	3524
2382+00	2397+00	1211	1790				1790	3205
2397+00	2412+00	751	948				948	
2412+00	2427+00	497	1500		1536		-36 *	394
2427+00	2442+00		1500	. 1000	1500	577	1000	577
2442+00	2457+00		. 1500	1500	1500	1500	1500	1500
2457+00	2472+00		1500	1500	1350	1350	1650	1350
2472+00	2487+00		1500	1500	1365	1365	1635	1365
2487+00	2502+00		1500	1500	1435	1435	1565	1435
2502+00	2517+00		1500	1300	1425	1425	1375	1425
2517+00	2530+00		1275		300	300	975	300
2530+00	2542+00		1225			605	620	
2542+00	2554+00		1120	1063	1104	1120	1063	1104
2554+00	2566+00		1270	1200	1059	1190	1280	1059
2566+00	2578+00		1210	1200	1393	750	1660	1393
2578+00	2590+00		1220	1200	1099	1110	1310	1099
2590+00	2602+00		1200	1200	1275	1200	1200	1275
2602+00	2614+00		1200	1200	1107	1100	1300	1107
2614+00	2626+00		1200	1200	1112	1120	1280	1112
2626+00	2637+99		1160	1250	1106	1060	1350	1106
SK	YWAY	142						
TO	TAL					17,065	25,315	24,312

• NOTE: A NEGATIVE NUMBER MEANS THAT MORE TEMPORARY CONCRETE BARRIER IS REQUIRED FOR THE FINAL CONDITION THAN DURING TRAFFIC STAGINGING.

AND KEICEU

ONE NORTH FRANKLIN CHICAGO, IL 60606 PHONE: (312) 251-3006 FAX: (312) 251-3015 WEB: WWW.EKCORP.COM

REVISIONS		ILLINOIS DEPARTMENT OF TRANSPORTATION				
NAME [	)ATE	ILLINOIS DEFARTMENT OF TRANSPORTATION				
		] F.A.I. 94/90 (DAN RYAN EXPRESSWA				
		31ST STREET TO 71ST STREET				
		NB EXPRESS LANE RECONSTRUCTION				
		ab Em Ness Em				
		ROADWAY				
		COUEDINE				

SCALE: NONE

DRAWN BY: TAI CHECKED BY: PJM

### TEMPORARY SOIL RETENTION SYSTEM

	EMPORARY SOIL TENTION SYSTEM (SQ FT)
2372+00.00 2373+00.00	85
2373+00.00 2374+00.00	185
2374+00.00 2375+00.00	300
2413+00.00 2414+00.00	10
2414+00.00 2415+00.00	80
2415+00.00 2416+00.00	195
2416+00.00 2417+00.00	290
2417+00.00 2418+00.00	260
2418+00.00 2419+00.00	135
2419+00.00 2420+00.00	40
2432+00.00 2433+00.00	25
2433+00.00 2434+00.00	25
2450+00.00 2451+00.00	1.0
2451+00.00 2452+00.00	55
2452+00.00 2453+00.00	50
2453+00.00 2454+00.00	5
2461+00.00 2462+00.00	5
2462+00.00 2463+00.00	50
2463+00.00 2464+00.00	45
2464+00.00 2465+00.00	5
2465+00.00 2466+00.00	10
2466+00.00 2467+00.00	25
2467+00.00 2468+00.00	70
2468+00.00 2469+00.00	75
2469+00.00 2470+00.00	55
2470+00.00 2471+00.00	50
2471+00.00 2472+00.00	50
2472+00.00 2473+00.00	50
2473+00.00 2474+00.00	80
2474+00.00 2475+00.00	130
2483+00.00 2484+00.00	360
2484+00.00 2485+00.00	205
2485+00.00 2486+00.00	95
2486+00.00 2487+00.00	55
2487+00.00 2488+00.00	45
2488+00.00 2489+00.00	55
2489+00.00 2490+00.00	50
2490+00.00 2491+00.00	35
2491+00.00 2492+00.00	40
2492+00.00 2493+00.00	20
2493+00.00 2494+00.00	30
	45
2494+00.00 2495+00.00	
2495+00.00 2495+00.00	15
	15 0
2495+00.00 2496+00.00	
2495+00.00 2496+00.00 2496+00.00 2497+00.00	0

	STATION T	O STATION	TEMPORARY SOIL RETENTION SYSTEM (SQ FT)
	2500+00.00	2501+00.00	30
	2501+00.00	2502+00.00	25
	2502+00.00	2503+00.00	20
	2506+00.00	2507+00.00	5
	2507+00.00	2508+00.00	5
	2521+00.00	2522+00.00	5
	2522+00.00	2523+00.00	5
	2523+00.00	2524+00,00	25
	2524+00,00	2525+00.00	30
	2525+00.00	2526+00.00	55
	2526+00.00	2527+00.00	85
	2527+00.00	2528+00.00	80
	2537+00.00	2538+00.00	343
	2619+00.00	2620+00.00	235
	2620+00,00	2621+00.00	241
	2621+00.00	2622+00.00	234
Ī	2622+00.00	2623+00.00	362
	2623+00.00	2624+00.00	263
Ī	2624+00.00	2625+00.00	321
	2625+00.00	2626+00.00	292
		SUBTOTAL	
	FROM DRAIN	NAGE STRUCT.	
ľ		TOTAL	56,269

NOTE: ADDITIONAL LOCATIONS AND QUANTITIES OF TEMPORARY SOIL RETENTION SYSTEM WILL BE REQUIRED TO SUPPORT AND PROTECT EXISTING SURFACE AND UNDERGROUND FACILITIES WITHIN THE CTA OPERATING AREA. THESE FACILITIES MAY INCLUDE BUT ARE NOT LIMITED TO POWER DISTRIBUTION CABLES, TRAIN CONTROL SIGNALS, TRAIN CONTROL SIGNAL CABINETS, AND COMMUNICATION SERVICE LINES. EXACT LOCATIONS OF THESE FACILITIES ARE NOT KNOWN.

AND KEICEU

ONE NORTH FRANKLIN CHICAGO, IL 60606

AND KEICEU

WEST WAYLE CORPT. COM

WEST WAYLE CRORP. COM

WEST WAYLE CROPP. COM

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ONE NORTH FRANKLIN

CHICAGO. IL 60606

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CHICAGO. IL 60606

FAX: 1312 / 251-3016

WEST WAYLE CROPP. COM

ONE WAYLE CR

	FU	LE FOUNDA
STATION	OFFSET	LIGHTING FND REM (EACH)
2368+64.5	12.9 LT	1
2372+15.3	11.4 LT	1
2373+45.8	6.6 LT	1
2376+66.9	3.9 LT	1
2380+22.8	5.9 LT	1
2382+15,4	8.5 LT	1
2383+83,7	11.4 LT	1
2385+15.6	12.5 LT	1
2386+39.9	12.3 LT	1
2387+65.6	12.2 LT	1
2389+9.5	12.2 LT	1
2390+90.8	13.1 LT	11
2393+52.8	13.2 LT	1
2395+53.5	13.1 LT	1
2397+48.5	13.1 LT	1
2399+56.4	11.7 LT	1
2401+60.4	11.9 LT	1
2403+36.4	10.9 LT	1
2405+11,4	8.8 LT	1
2406+75,1	7.7 LT	1 1
2410+29.5	52.1 RT	1
2412+16.1	52.1 RT	1
2413+64.8	52.4 RT 52.6 RT	1
2415+88.9 2419+67.8	51.9 RT	1 1
2417+76.3	51.8 RT	1
2421+57.4	54.1 RT	1
2423+57,8	54.5 RT	1
2425+58.9	53.5 RT	1
2427+67.4	52.1 RT	1
2429+80.3	51.4 RT	1
2431+81.4	50.2 RT	1 .
2433+87.6	49.1 RT	1
2435+93.3	48.1 RT	1
2437+99.8	46.8 RT	1
2440+08.6	43.1 RT	1
2442+07.0	37.8 RT	1
2444+23,4	33.0 RT	1
2446+37.8	72.8 RT	1
2448+29.7	65.0 RT	1
2450+20.4	64.1 RT	1
2452+15.6	60.0 RT	1 1
2454+05,2	59.3 RT	1
2455+94.9	59.2 RT 59.3 RT	1
2457+83.5 2459+66.1	59.2 RT	1
2459+66.1	59.3 RT	1
2463+54.3	59.5 RT	1
2465+46.3	59.7 RT	1
2467+41.7	59.6 RT	1
2469+44.4	59.7 RT	1
2471+42.5	59.8 RT	1
2473+47.8	59.8 RT	1
2476+72.8	60.0 RT	1
2478+69.4	60.0 RT	1
2480+71.8	59.9 RT	1
2482+79.7	60.1 RT	1
2484+81.5	60.0 RT	1
2486+86.9	60.2 RT	1
2488+92,7	60.3 RT	1
2490+98.0	60.4 RT	1
2493+03.6	60.5 RT	1
2495+07.7	60.5 RT 60.6 RT	1
2497+12.9	60.7 RT	1
2499+18.6 2501+22.7	60.0 RT	1
2503+31.9	60.0 RT	1
2505+36.4	62.0 RT	1
2507+36.6	70.5 RT	1
2509+45.3	80.5 RT	1
2511+49.8	86.6 RT	1
2513+58.5	47.9 RT	1
2515+68.2	47.8 RT	1
2517+72.6	47.7 RT	1
2519+68.3	47.8 RT	1
2521+81.8	47.7 RT	1
2523+81.8	48.0 RT	11
2525+88.8	49.5 RT	1
2527+89.8	48.9 RT	1

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_	$\cup$ $\sqsubseteq$	С	г	UUI	$^{\prime\prime}$	.   1	UIV.	KENIU	V E D

		LIGHTING
}	\$	FND REA
STATION	OFFSET	(EACH)
2530+44.3	RT	1
2532+48.7	RT	1
2534+51.4	RT	1
2536+61.0	RT	1
2538+69.2	RT	1
2540+80.5	RT	1
2542+94.3	RT	1
2544+90.9	RT	1
2546+95.4	RT	1
2548+98.8	RT	1
2551+05.6	RT	1
2553+05.3	RT	1
2555+16.9	RT	1
2557+24.5	RT	1
2559+30.7	R⊺	1
2561+27.3	RT	1
2563+29.3	RT	1
2565+30.5	RT	1
2567+36.7	RT	1
2569+62.4	RT	1
2571+68.6	RT	1
2573+53.4	RT	1
2575+73.0	RT	1
2577+80.2	RT	1
2579+73.4	RT	1
2581+58.5	RT	1
2584+23.6	RT	1
2586+18.0	RT	1
2588+18.3	RT	1
2590+17.0	RT	1
2592+20.2	RT	1
2594+15.8	RT	1
2596+03.4	RT	1
2598+12.4	RT	1
2600+12.4	RT	1
2602+15.6	RT	1
2604+16.6	RT	1
2606+16.1	RT	1
2608+08.0	RT	1
2610+37.7	ŔT	1
2612+62.9	RT	1
2614+88.3	RT	1
2617+07.1	RT	1
2619+26.3	RT	1
2621+44.7	RT	1
2623+61.1	RT	1
2625+80.9	RT	1
2628+15.9	RT	1
2630+21.6	RT	1
2632+42.5	RT	1
2634+73.5	RT	1
TOTAL		130

F.A.I. RTE.	SECT10N	i	COUNTY	TOTAL SHEETS	SHEET NO.
94/90	*		COOK	556	21
STA.		TO	STA.		
EED BOA	n ntst nn	THE TWOTE	EED ATO	PPO ICCT	

62300 • (1818, ETC, 2324.6-1P)R-8

ELECTRICAL ITEMS

STATION	TO STATION	CON T 2 GALVS (FOOT)	CON T 3 GALVS (FOOT)	CON ENC C 3 PVC (FOOT)	HD HANDHOLE (EACH)	HD HANDHOLE SPL (EACH)	TR & BKFIL   ELECT WK (FOOT)
1367+00	1376+00	68		68	1		68
1376+00	1387+80						
1387+80	1398+00	93		136	2		93
1398+00	1406+00						
1406+00	1416+00						
1416+00	1426+00						
1426+00	1436+00	18		96		2	18
1436+00	1446+50						
1446+50	1458+50	2		2	1		2
1458+50	1471+00						
1471+00	1482+50	2		54	1		2
1482+50	1495+50						
1495+50	1506+50	2			1		2
1506+50	1518+00	35		70	1		35
1518+00	1529+50						
1529+50	1536+00						
1536+00	1548+00	31		64	2		31
1548+00	1560+00			1 1 700 0000 1000			
1560+00	1572+00	12		54	1		12
1572+00	1584+00	12		54	1		12
1584+00	1596+00						
1596+00	1608+00	12	6	54	1		18
1608+00	1620+00						
1620+00	1632+00	12		54	1		12
TO:	TAL	299	6	766	13	2	305

REVISIONS		ILLINOIS DEPARTMENT OF TRANSPORTATION
NAME	DATE	ILLINOIS DEPARTMENT OF TRANSFORTATION
		F.A.I. 94/90 (DAN RYAN EXPRESSWAY
		31ST STREET TO 71ST STREET
		NB EXPRESS LANE RECONSTRUCTION
		ROADWAY

SCALE: NONE DATE: 7/7/05

SCHEDULE DRAWN BY: TAI CHECKED BY: PJM

STATION	ТО	STATION	EARTH EXCAVATION (CU YD)
2367+00		2368+00	787.6
2368+00		2369+00	763.7
2369+00		2370+00	769.6
2370+00		2371+00	778.0
2371+00	$\top$	2372+00	771,1
2372+00		2373+00	749.1
2373+00	T	2374+00	735.7
2374+00		2375+00	749.8
2375+00	+	2376+00	776.9
2376+00	-	2377+00	775.4
2377+00		2378+00	772.0
2378+00		2379+00	780.0
2379+00		2380+00	779.6
2380+00			
	-	2381+00	800.9
2381+00	-	2382+00	845.6
2382+00	+	2383+00	872.2
2383+00	+	2384+00	858.5
2384+00	+	2385+00	845.0
2385+00		2386+00	868.0
2386+00	-	2387+00	950.4
2387+00		2388+00	1074.6
2388+00		2389+00	1260.4
2389+00		2390+00	1379.8
2390+00		2391+00	1313.1
2391+00		2392+00	1247.8
2392+00		2393+00	1252.2
2393+00		2394+00	1279.4
2394+00		2395+00	1277.0
2395+00		2396+00	1277.0
2396+00		2397+00	1264.8
2397+00		2398+00	1306.1
2398+00		2399+00	1450.4
2399+00		2400+00	1528.0
2400+00		2401+00	1434.1
2401+00		2402+00	1146.3
2402+00		2403+00	883.7
2403+00		2404+00	765.4
2404+00		2405+00	475.2
2405+00		2406+00	266.5
2406+00		2407+00	267.4
2407+00		2408+00	356.9
2408+00		2409+00	472.8
2409+00		2410+00	509.4
2410+00	+	2411+00	517.0
2411+00	+	2412+00	620.4
2412+00	+	2413+00	790.7
2413+00		2414+00	867.4
2414+00	+	2415+00	866.1
2415+00	+	2416+00	875.7
2416+00	+	2417+00	894.3
2417+00	+	2418+00	919.3
2418+00	+	2419+00	933.3
2419+00	-	2420+00	927.0
			1 52,10
2420+00		2421+00	843.3

			· · · · · · · · · · · · · · · · · · ·	****	
STATION	TO STATION	EARTH EXCAVATION (CU YD)	STATION	TO STATION	EARTH EXCAVATION (CU YD)
2422+00	2423+00	563.3	2477+00	2478+00	760.9
2423+00	2424+00	512.2	2478+00	2479+00	761.7
2424+00	2425+00	515.6	2479+00	2480+00	763.3
2425+00	2426+00	549.3	2480+00	2481+00	765.9
2426+00	2427+00	591.9	2481+00	2482+00	770.7
2427+00	2428+00	633,7	2482+00	2483+00	780,6
2428+00	2429+00	680.4	2483+00	2484+00	784.1
2429+00	2430+00	698.0	2484+00	2485+00	806.1
2430+00	2431+00	717.2	2485+00	2486+00	841.7
2431+00	2432+00	717.8	2486+00	2487+00	871.5
2432+00	2433+00	712.8	2487+00	2488+00	878.7
2433+00	2434+00	731.5	2488+00	2489+00	842.4
2434+00	2435+00	769.4	2489+00	2490+00	842.4
2435+00	2436+00	808.5	2490+00	2491+00	794.3
2436+00	2437+00	816.5	2491+00	2492+00	757.2
2437+00	2438+00	797.4	2492+00	2493+00	751.1
2438+00	2439+00	734.3	2493+00	2494+00	
2439+00	2440+00	697.4	2494+00	2495+00	764.4
2440+00	2441+00	725.0	2495+00	2496+00	·
2441+00	2442+00	790.2	2496+00	2497+00	771.9
2442+00	2443+00	877.4	2497+00	2498+00	815.0
2443+00	2444+00	916.3	2498+00	2499+00	
2444+00	2445+00	900.2	2499+00	2500+00	827.6
2445+00	2446+00		2500+00	2501+00	830.0
2446+00	2447+00	889.4	2501+00	2502+00	830.4
2447+00	2448+00	885.9	2502+00	2502+00	808.3
2448+00	2449+00	846.5 795.2	2503+00	2504+00	805.4
2449+00	2450+00		2504+00	2505+00	809,8
2450+00	2451+00	751.5	2505+00	2506+00	811.1
2451+00	2452+00	727.2	2506+00	2507+00	853.7
2452+00	2453+00	757.2	2507+00	2508+00	895.6
2453+00	2454+00	785.6 786.3	2508+00	2509+00	899.6
2454+00	2455+00	796.1	2509+00	2510+00	908.0
2455+00	2456+00	794.4	2510+00	2511+00	938.7
2456+00	2457+00	792.2	2510+00	2512+00	951.3 970.4
2457+00	2458+00			2513+00	
2458+00	2459+00	778.1 759.4	2512+00 2513+00	2514+00	1002.6
2459+00	2460+00	724.8	2514+00	2515+00	1045.6
2460+00	2461+00	700.2	2515+00	2516+00	1102.6
2461+00	2462+00	708.0	2516+00	2517+00	
2462+00	2463+00	717.2	2517+00	2518+00	1139.1
2463+00	2464+00	744.4	<u> </u>		1127.2
2464+00	2465+00		2518+00	2519+00 2520+00	1097.2
2465+00	2466+00	756.3	2519+00 2520+00		1113.0
2466+00		765.6		2521+00	1108.0
2467+00	2467+00	780.4	2521+00	2522+00	1099.4
	2468+00	785.4	2522+00	2523+00	1056.3
2468+00 2469+00	2469+00	788.3	2523+00	2524+00	893.5
	2470+00	789.8	2524+00	2525+00	780.0
2470+00 2471+00	2471+00 2472+00	795.7	2525+00	2526+00	831.5
		787.6	2526+00	2527+00	858.3
2472+00	2473+00	767.8	2527+00	2528+00	822.2
2473+00	2474+00	795.4	2528+00	2529+00	740.4
2474+00	2475+00	803,9	2529+00	2530+00	697.8
2475+00	2476+00	781,5			
2476+00	2477+00	773.7			

STATION T	O STATION	EARTH EXCAVATION (CU YD)
2530+00.00	2531+00,00	616.2
2531+00.00	2532+00.00	720.5
2532+00.00	2533+00.00	730.9
2533+00.00	2534+00.00	709.5
2534+00.00	2535+00.00	676.1
2535+00.00	2536+00,00	672.8
2536+00.00	2537+00.00	704.3
2537+00.00	2538+00.00	767.5
2538+00.00	2539+00.00	780.3
2539+00.00	2540+00.00	774.8
2540+00.00	2541+00.00	709.9
2541+00.00	2542+00.00	937.9
2542+00.00	2543+00.00	906.1
2543+00.00	2544+00.00	1083.0
2544+00.00	2545+00.00	1060,3
2545+00.00	2546+00.00	1020.1
2546+00.00	2547+00.00	988.6
2547+00.00	2548+00.00	930.3
2548+00.00	2549+00.00	896.3
2549+00.00	2550+00.00	869.2
2550+00.00	2551+00.00	843.2
2551+00.00	2552+00.00	826,1
2552+00.00	2553+00.00	799.0
2553+00.00	2554+00.00	787.5
2554+00.00	2555+00.00	811.7
2555+00.00	2556+00.00	776,1
2556+00.00	2557+00.00	727.8
2557+00.00	2558+00.00	745.6
2558+00.00	2559+00.00	716.0
2559+00.00	2560+00.00	742.9
2560+00.00	2561+00.00	741.5
2561+00.00	2562+00.00	774.5
2562+00.00	2563+00.00	795.3
2563+00.00	2564+00.00	812.6
2564+00.00	2565+00.00	806.3
2565+00.00	2566+00.00	778.8
2566+00,00	2567+00.00	810.3
2567+00.00	2568+00.00	794.7
2568+00.00	2569+00.00	810.5
2569+00.00	2570+00.00	818.5
2570+00.00	2571+00.00	841.1
2571+00.00	2572+00.00	770.4
2572+00.00	2573+00.00	722.4
2573+00.00	2574+00.00	686.0
2574+00.00	2575+00.00	653.8
2575+00.00	2576+00.00	614.6
2576+00.00	2577+00.00	654.2
2577+00.00	2578+00.00	611.7
2578+00.00	2579+00.00	681.2
2579+00.00	2580+00.00	696.1
2580+00.00	2581+00.00	713.7
2581+00.00	2582+00.00	620.7
2582+00.00	2583+00.00	623.7
2583+00.00	2584+00.00	696.7

STATION T	O STATION	EARTH EXCAVATION (CU YD)	
2585+00.00	2586+00.00	725.1	
2586+00.00	2587+00.00	723.8	
2587+00.00	2588+00.00	720.4	
2588+00.00	2589+00.00	699.4	S.
2589+00.00	2590+00.00	697.3	
2590+00.00	2591+00.00	675.9	26:
2591+00.00	2592+00.00	668.9	263
2592+00.00	2593+00.00	670.5	263
2593+00.00	2594+00.00	660.4	26
2594+00.00	2595+00.00	648.3	26.
2595+00.00	2596+00.00	668.7	26
2596+00.00	2597+00.00	693.4	
2597+00.00	2598+00.00	683.3	

2598+00.00 2599+00.00

2600+00.00 2601+00.00

2601+00.00 2602+00.00 2602+00.00 2603+00.00

2600+00.00

2604+00.00

2605+00.00

2606+00.00

2607+00.00

2608+00.00

2609+00.00

2610+00.00

2611+00.00

2612+00.00

2614+00.00

2615+00.00

2616+00.00

2617+00.00

2618+00.00

2621+00.00

2622+00.00

2627+00.00

2628+00.00

678.8

680.7

697.7

701.2

728.0

737.6

747.8

667.2

692.7

649.9

691.7

735.6

738.1

703.9

669.6

685.7

730.0

759.6

728.7

751.2

710.1

736.0

764.8

2599+00.00

2603+00.00

2604+00.00

2605+00.00

2606+00.00

2607+00.00

2608+00.00

2609+00.00

2610+00.00

2611+00.00

2613+00.00

2614+00.00

2615+00,00

2616+00.00

2617+00.00

2619+00.00 2620+00.00

2621+00.00

2626+00.00

2627+00.00

2612+00.00 2613+00.00

2618+00.00 2619+00.00

2622+00.00 2623+00.00

2623+00.00 2624+00.00

2624+00.00 2625+00.00 2625+00.00 2626+00.00

2628+00.00 2629+00.00

2629+00.00 2630+00.00 2630+00.00 2631+00.00

2631+00.00 2632+00.00

F.A.I. RTE.	SECTION	COUNTY	TOTAL SHEETS	SHEET NO.
94/90	*	COOK	556	22
STA.		TO STA.		
FED. ROA	AD DIST. NO. ILLIN	OIS FED. AID	PROJECT	

STATION T	EARTH EXCAVATION (CU YD)	
2632+00.00	2633+00.00	797.5
2633+00.00	2634+00.00	779.9
2634+00.00	2635+00.00	786.1
2635+00.00	2636+00.00	825.5
2636+00.00	2637+00.00	775.3
2637+00.00	2637+99.00	733.3
	IATOT	217.181

ILLINOIS DEPARTMENT OF TRANSPORTATION F.A.I. 94/90 (DAN RYAN EXPRESSWAY)
31ST STREET TO 71ST STREET
NB EXPRESS LANE RECONSTRUCTION EARTHWORK

> SCALE: NONE DATE: 7/7/05

DRAWN BY: TAI CHECKED BY: PJM

EGVATOS

AND KEICEU

ONE NORTH FRANKLIN CHICAGO, IL 66566
PHORE (312) 261-3015
FAX. (3)22 251-3015
WEB: WWW.LKCOPP.COM

SCHEDULE

					·····				
		T	1	WORKZONE	ļ		1	T	
SHEET				1					WORKZONE
	LINE DECODIOTION	CTATION	TO 67177011	PAVEMENT	SHEET				PAVEMENT
NUMBER	LINE DESCRIPTION	STATION	TO STATION	MARKING REMOVAL	NUMBER	LINE DESCRIPTION	STATION	TO STATION	MARKING REMOVAL
				(SQ FT)					(SQ FT)
STAGE IA					MOT 0				0.00
MOT-4					MOT-9	4// COLTD (V)			
4"	4" SOLID (Y)	2352+00	2367+00	1500	4′′	4" SOLID (Y)	4381+76	4387+27	551
4"	6'S - 2'D (W)	2359+50	2362+53	76	4''	4" SOLID (W)	4381+76	4387+27	551
4"	4" SOLID (W)	2354+35	2367+00	1265	5′′	5" 30'S - 10'D	4381+76	4387+27	138
4"	4" SOLID (Y)	2367+00	2382+00	1500	STAGE I				
4"	4" SOLID (W)	2367+00	2372+14	514	MOT-4				
4"	4" SOLID (Y)		t		4"	4" SOLID (Y)	4400+96	4412+42	1146
		2367+52	2374+60	708	4"	4" SOLID (W)	4400+96	4412+42	
4"	4" SOLID (W)	2367+52	2382+00	1448	MOT-10		4400+36	7712172	1146
5"	5" 30'S - 10'D	2364+04	2367+00	74	l F				
5"	5" 30'S - 10'D	2367+00	2382+00	375	4''	4" SOLID (Y)	4412+42	4426+98	1456
12"	12" SOLID (W)	2354+35	2359+50	313	4''	4" SOLID (W)	4412+42	4414+24	182
12"	12" SOLID (W)	2364+04	2367+52	202	4′′	4" SOLID (W)	4414+24	4426+98	1274
MOT-5					4''	6'S - 2'D (W)	4416+78	4426+98	255
	4" SOLID (Y)	4701   70	4707.07		4"	6'S - 2'D (W)	4426+98	4430+00	76
4"		4381+76	4397+07	1531	4"	4" SOLID (Y)	4426+98	4441+96	1498
4"	4" SOLID (W)	4381+76	4389+83	807	4"	4" SOLID (W)	4426+98	4432+84	586
4''	4" SOLID (Y)	4384+24	4389+83	559				1	I I
4"	4" SOLID (W)	4384+24	4397+07	1283	4"	4" SOLID (W)	4432+84	4440+60	776
4''	4" SOLID (Y)	4397+07	4400+96	389	4′′	4" SOLID (W)	4440+60	4441+96	136
4"	4" SOLID (W)	4397+07	4400+96	389	4''	6'S - 2'D (W)	4434+89	4438+07	80
5"	5" 30'S - 10'D	4381+76	4397+07	383	5"	5" 30'S - 10'D	4412+42	4426+98	364
5"	5" 30'S - 10'D	4390+95	4397+07		5′′	5" 30'S - 10'D	4412+42	4426+98	364
5"	5" 30'S - 10'D	4397+07	1	153	5′′	5" 30'S - 10'D	4426+98	4441+96	375
1		ł	4412+42	384	5"	5" 30'S - 10'D	4426+98	4441+96	375
5"	5" 30'S - 10'D	4397+07	4412+42	384	8"	8" SOLID (W)	4414+24	4416+78	254
12"	12" SOLID (W)	4389+83	4390+95	13	8"	8" SOLID (W)			254
STAGE IB						1	4414+24	4416+78	
MOT-6					8"	8" SOLID (W)	4432+84	4434+89	205
4"	4" SOLID (Y)	2356+78	2367+00	1022	8''	8" SOLID (W)	4432+84	4434+89	205
4′′	4" SOLID (W)	2354+35	2367+00	1265	8"	8" SOLID (W)	4438+07	4440+60	253
4''	4" SOLID (Y)	2354+35	2356+78	243	8′′	8" SOLID (W)	4438+07	4440+60	253
4"	6'S - 2'D (W)	2360+22	2363+22	75	12"	12" SOLID (W)	4414+24	4416+78	59
4"	4" SOLID (Y)	2367+00	2382+00	1500	12"	12" SOLID (W)	4432+84	4434+89	94
4"	4" SOLID (W)	2374+71	1		12"	12" SOLID (W)	4438+07	4440+60	205
4"	4" SOLID (W)		2382+00	729	MOT-11	IL SOLID (III)	1730101	1 1110100	
		2367+00	2374+37	737	4"	4" SOLID (Y)	4441+96	4457:00	1504
5"	5" 30'S - 10'D	2356+78	2367+00	256	4"			4457+00	1504
5"	5" 30'S - 10'D	2356+78	2367+00	256		4" SOLID (W)	4441+96	4457+00	1504
5"	5" 30'S - 10'D	2367+00	2382+00	375	4''	6'S - 2'D (W)	4455+57	4457+00	36
5"	5" 30'S - 10'D	2367+00	2370+28	82	4''	4" SOLID (Y)	4457+00	4471+99	1499
8′′	8" SOLID (W)	2356+78	2360+22	344	4''	6'S - 2'D (W)	4457+00	4458+85	46
8"	8" SOLID (W)	2356+78	2360+22	344	4"	4" SOLID (W)	4457+00	4461+99	499
8"	8" SOLID (W)	2370+28	2374+71		4"	4" SOLID (W)	4461+99	4471+99	1000
8"	8" SOLID (W)			443	5"	5" 30'S - 10'D	4441+96	4457+00	376
_	12" SOLID (W)	2370+28	2374+71	443	5"	5" 30'S - 10'D	4441+96		
12"		2356+78	2360+22	137				4457+00	376
12"	12" SOLID (W)	2370+28	2374+71	125	5"	5" 30'S - 10'D	4457+00	4471+99	375
MOT-7					5"	5" 30'S - 10'D	4457+00	4471+99	375
4"	4" SOLID (Y)	4381+76	4391+37	961	8"	8" SOLID (W)	4458+85	4461+99	314
4"	4" SOLID (W)	4381+76	4389+83	807	8"	8" SOLID (W)	4458+85	4461+99	314
4"	4" SOLID (W)	4384+63	4391+37	674	12"	12" SOLID (W)	4458+85	4461+99	100
4"	4" SOLID (Y)			(	MOT-12				
5"		4384+63	4389+83	520	4"	4" SOLID (Y)	4471+99	4486+99	1500
1	5" 30'S - 10'D	4381+76	4391+37	240	4''	4" SOLID (W)	4471+99	4486+99	1
5"	5" 30'S - 10'D	4390+99	4391+37	10	4"	4" SOLID (Y)			1500
8"	8" SOLID (W)	4389+83	4390+99	116	4"	4" SOLID (W)	4486+99	4502+00	1501
8"	8" SOLID (W)	4389+83	4390+99	116	4"		4486+99	4487+50	51
12"	12" SOLID (W)	4389+83	4390+99	9		6'S - 2'D (W)	4488+99	4492+60	90
STAGE IC					4"	4" SOLID (W)	4487+50	4502+00	1450
MOT-8					5"	5" 30'S - 10'D	4471+99	4486+99	375
4"	4" SOLID (Y)	2367+00	2382+00	1500	5′′	5" 30'S - 10'D	4471+99	4486+99	375
4"	4" SOLID (W)	2367+00	2374+76	776	5′′	5" 30'S - 10'D	4486+99	4502+00	375
4"	4" SOLID (W)	2374+60	2382+00	740	5"	5" 30'S - 10'D	4486+99	4502+00	
1	5" 30'S - 10'D	2367+00		375	8′′	8" SOLID (W)		4488+99	375
5"			2382+00		8"	8" SOLID (W)	4487+50		149
5"	5" 30'S - 10'D	2367+00	2368+71	43	12"	12" SOLID (W)	4487+50	4488+99	149
8"	8" SOLID (W)	2368+71	2374+60	589	"-	TO SOUTH (M)	4487+50	4488+99	22
8"	8" SOLID (W)	2368+71	2374+76	605			· · · · · · · · · · · · · · · · · · ·		
12"	12" SOLID (W)	2368+71	2374+76	707					
		L	L						

				r	
					WORKZONE
	SHEET				PAVEMENT
1	NUMBER	LINE DESCRIPTION	STATION	TO STATION	MARKING REMOVAL
			***************************************		(SQ FT)
1	MOT-13 4"	4" SOLID (Y)	4502+00	4517+01	1501
	4′′	4" SOLID (W)	4502+00	4514+05	1501
	4"	6'S - 2'D (W)	4506+05	4510+02	99
	4"	4" SOLID (W)	4514+05	4517+01	296
1	4"	4" SOLID (Y)	4517+01	4529+76	1275
	4"	4" SOLID (W)	4517+01	4529+76	1275
	5"	5" 30'S - 10'D	4502+00	4517+01	375
-	5"	5" 30'S - 10'D	4502+00	4517+01	375
1	5"	5" 30'S - 10'D	4517+01	4529+76	319
	5"	5" 30'S - 10'D	4517+01	4529+76	319
	8′′	8" SOLID (W)	4510+02	4514+05	403
	8′′	8" SOLID (W)	4510+02	4514+05	403
	12"	12" SOLID (W)	4510+02	4514+05	102
1	MOT-14				
	4''	SOLID (W)	4540+70.00	4542+31.00	54
	4"	6'S ~ 2'D (W)	4543+00.00	4547+05,00	34
	4"	SOLID (W)	4550+00.00	4554+05.00	135
	4"	SOLID (Y)	4529+80,00	4554+05.00	808
	5"	30'S - 10'D (W)	4529+80.00	4554+05.00	505
	8"	© GORES	4542+31.00	4543+00.00	92
	8"	© GORES	4547+06.00	4550+00,00	196
	12"	© GORE (DIAGONAL)	4542+31.00	4543+00.00	20
	MOT-15				
1	4"	SOLID (W)	4554+05.00	4564+00.00	332
ı	4"	SOLID (W)	4565+51.00	4569+83.00	144
	4"	SOLID (W)	4573+88.00	4578+05.00	139
	4''	SOLID (Y)	4554+05.00	4578+05.00	800
	4"	6'S - 2'D (W)	4565+15.00	4571+25.00	51
	5"	30'S - 10'D (W)	4554+05.00	4578+05.00	500
-	8"	@ GORES	4564+00.00	4565+15.00	77
l	8"	@ GORES	4571+25,00	4573+88.00	175
	MOT-16				
	4"	SOLID (W)	4578+05.00	4582+66.00	154
	4"	SOLID (W)	4586+40.00	4601+00.00	487
	4"	SOLID (Y)	4578+05.00	4602+05.00	800
	4'' 5''	6'S - 2'D (W)	4582+66.00	4584+51.00	15
Ì	8"	30'S - 10'D (W) @ GORES	4578+05.00 4584+51.00	4602+05.00 4586+40.00	500 126
	8"	© GORES	4601+00.00	4602+05.00	70
		e cours	4601700.00	4802+03.00	
	MOT-17				
	4''	SOLID (W)	4610+50.00	4616+86,00	212
	4''	SOLID (W)	4621+67.00	4624+32.00	88
-	4"	SOLID (Y)	4602+05.00	4626+05.00	800
	4''	6'S - 2'D (W)	4604+50.00	4610+50.00	50
	4"	6'S - 2'D (W)	4620+17.00	4624+59.00	37
	5"	30'S - 10'D (W)	4602+05.00	4626+05.00	250
	5"	30'S - 10'D (W)	4602+05.00	4621+66.00	204
	8"	@ GORES	4602+05.00	4604+50.00	163
	8''	@ GORES	4616+86.00	4620+17.00	221
	8"	@ GORES	4624+59.00	4626+05.00	97
	8"	6'S - 2'D (W)	4621+66.00	4626+05.00	73
	LET/SYM	LEFT TURN ONLY	4621+80.00		36
	LET/SYM	LEFT TURN ONLY	4626+80.00		36
-					
	MOT-18	COLID (MI)	4000100.00	4630 180 00	0.7
	4"	SOLID (W)	4626+90.00	4629+80.00	97
╛	5"	SOLID (Y) 30'S - 10'D (W)	4626+05.00 4625+05.00	4629+80.00 4629+80.00	125 49
	8"	@ GORES	4626+05.00	4626+90.00	57
	, ~	@ 0011LJ	105010000	1050130100	JI
	8"	6'S - 2'D (W)	4626+05.00	4629+80.00	63

F.A.I. RTE.	SECTIO	ON	COUNT	Υ	TOTAL SHEETS	SHEET NO.
94/90	*		COOF	(	556	23
STA.		TO	STA.			
FED RO	AD DIST. NO.	ILLINOIS	FED.	AID	PROJECT	

				WORK ZONE PAVEMENT
SHEET				MARKING REMOVAL
NUMBER	LINE DESCRIPTION	STATION	TO STATION	(SQ FT)
TAGE II				
MOT-19 4"	4" SOLID (Y)	4408 100	4440.00	1400
4"	1	4428+00	4442+00	
	6'S - 2'D (W)	4428+00	4432+00	100
4"	4" SOLID (W)	4436+98	4442+00	
8"	8" SOLID (W)	4432+00	4436+98	498
8"	8" SOLID (W)	4432+00	4436+98	498
12''	12" SOLID (W)	4432+00	4436+98	153
12"	@ SHLDR. (DIAGONAL)	4436+98	4442+00	122
MOT-20				
4′′	4" SOLID (Y)	2442+00	2457+00	1500
4′′	4" SOLID (W)	2442+00	2457+00	1500
4''	4" SOLID (Y)	2457+00	2472+00	1500
4′′	4" SOLID (W)	2457+00	2472+00	1500
12"	@ SHLDR. (DIAGONAL)	2442+00	2472+00	122
MOT-21				
4′′	4" SOLID (Y)	2472+00	2487+00	1500
4''	4" SOLID (W)	2472+00	2487+00	1500
4''	4" SOLID (Y)	2487+00	2502+00	1500
4''	4" SOLID (W)	2487+00	2502+00	1500
4"	4" SOLID (Y)	2502+00	2517+00	1500
4"	4" SOLID (W)	2502+00	2517+00	1500
4"	4" SOLID (Y)	2517+00	2530+00	1300
4"	4" SOLID (W)	2517+00	2520+00	300
4"	6'S - 2'D (W)	4523+76	4528+00	106
12"	@ SHLDR. (DIAGONAL)	2472+00	2502+00	151
MOT-22	a onesia astroorate	2112100	2502.00	
8"	8" SOLID (W)	4520+00	4523+76	376
8"	8" SOLID (W)	4520+00	4523+76	376
8"	12'S - 3'D (W)	4528+00	4530+00	50
12"	12" SOLID (W)	4520+00	4523+76	122
12"	@ SHLDR, (DIAGONAL)	2502+00	2530+00	96
		2302+00	2330+00	
STAGE II MOT-23				
_ET/SYM	LEFT TURN ONLY	4531+50.00		36
.ET/SYM	LEFT TURN ONLY	4534+80.00		36
1''	SOLID (W)	4541+99.00	4626+05.00	2,802
1''	SOLID (Y)	4541+99.00	4626+05.00	2,802
3''	12'S - 3'D (W)	4529+80.00	4534+70.00	65
3′′	@ GORES X 2	4534+70.00	4541+99.00	972
3′′	SOLID (W)	4529+80.00	454199	813
√0T-24				
_ET/SYM	LEFT TURN ONLY	4639+00.00		36
4′′	SOLID (W)	4541+99.00	4642+29.00	3,343
	I	45 44 100 00	4040.00.00	7 7 4 7
4′′	SOLID (Y)	4541+99.00	4642+29.00	3,343

REVISIONS		ILLINOIS DEPARTMENT OF TRANSPORTATION
NAME	DATE	ILLINOIS DEPARTMENT OF TRANSFORTATION
		F.A.I. 94/90 (DAN RYAN EXPRESSWAY)
		31ST STREET TO 71ST STREET
		NB EXPRESS LANE RECONSTRUCTION
		NB EXTRESS EARE RECORDINGSTRUCTION
		l .

MAINTENANCE OF TRAFFIC SCHEDULE

SCALE: NONE DATE: 7/7/05 DRAWN BY: ATD CHECKED BY: TAI

Edivards
ONE NORTH FRANKLIN
CHICAGO, IL. 60606
PHONE: G122 251-3005
WEB: WWW.EKCORP.COM

				PAVEMENT
SHEET				MARKING
NUMBER	LINE DESCRIPTION	STATION	TO STATION	REMOVAL
				(SQ FT)
PMK-1	30'S - 10'D (W)	2367+00	2382+00	156
	30'S - 10'D (W)	2367+00	2382+00	156
	SOLID (Y)	2367+00	2382+00	500
PMK-2	SOLID (Y)	2382+00	2393+67	389
	30'S - 10'D (W)	2382+00	2393+67	97
	30'S - 10'D (W)	2382+00	2393+67	97
	@ GORES	4384+25	4391+37	475
	@ GORES	4384+25	4391+37	475
	30'S - 10'D (W)	4385+88	4397+07	117
	SOLID (W)	4385+88	4397+07	373
	SOLID (Y)	4391+37	4397+07	190
	6'S - 2'D (W)	4391+37	4401+02	80
	SOLID (Y)	4397+07 4397+07	4412+42	512
	SOLID (W) 30'S - 10'D (W)	4397+07	4412+42	512
PMK-3	SOLID (W)	4412+25	4412+42 4426+98	160
LMIV-2	SOLID (W)	4412+42	4414+25	491
	SOLID (Y)	4412+42	4426+98	61
	30'S - 10'D (W)	4412+42	4426+98	485
	@ GORES	4414+25	4417+50	152 217
	© GORES	4414+25	4417+50	217
	30'S - 10'D (W)	4417+50	4426+98	99
	SOLID (W)	4426+98	4432+84	195
	30'S - 10'D (W)	4426+98	4437+32	86
	SOLID (Y)	4426+98	4441+96	499
	30'S - 10'D (W)	4426+98	4441+96	156
		4432+83	4434+87	136
	@ GORES	4432+83	4434+87	136
	6'S - 2'D (W)	4434+87	4436+38	13
	@ GORES	4436+38	4443+93	503
	@ GORES	4436+38	4443+93	503
	@ GORES	4437+32	4442+80	365
	@ GORES	4437+32	4442+80	365
PMK-4	SOLID (Y)	4442+80	4457+00	473
	SOLID (W)	4443+93	4457+00	436
	30'S - 10'D (W)	4441+96	4457+00	157
	6'S - 2'D (W)	4453+83	4457+00	26
	SOLID (W) @ GORES	4457+00	4461+99	166
	© GORES	4457+00	4461+99	333
	SOLID (Y)	4457+00	4461+99	333
	30'S - 10'D (W)	4457+00 4457+00	4471+99	500
	SOLID (W)	4457+00	4471+99	156
PMK-5	SOLID (Y)	4471+99	4471+99	333
FMK-5	SOLID (W)	4471+99	4486+99 4486+99	500
	30'S - 10'D (W)	4471+99	4486+99	500
	SOLID (W)	4486+99	4487+49	156 17
	SOLID (Y)	4486+99	4502+00	500
	30'S - 10'D (W)	4486+99	4502+00	156
	@ GORES	4487+49	4492+04	303
	@ GORES	4487+49	4492+04	303
	SOLID (W)	4487+49	4502+00	484
	C/C	4400+04	4494+21	18
	6'S - 2'D (W)	4492+04	1134121	10
			1131121	10
PMK-6	SOLID (W)	4502+00	4511+67	322
PMK-6	SOLID (W) SOLID (Y)	4502+00 4502+00	4511+67 4515+15	
PMK-6	SOLID (W) SOLID (Y) 30'S - 10'D (W)	4502+00 4502+00 4502+00	4511+67 4515+15 4517+01	322 438 156
PMK-6	SOLID (W) SOLID (Y) 30'S - 10'D (W) 6'S - 2'D (W)	4502+00 4502+00 4502+00 4504+13	4511+67 4515+15 4517+01 4507+28	322 438 156 26
PMK-6	SOLID (W)  SOLID (Y)  30'S - 10'D (W)  6'S - 2'D (W)  © GORES	4502+00 4502+00 4502+00 4504+13 4507+28	4511+67 4515+15 4517+01 4507+28 4514+06	322 438 156 26 452
PMK-6	SOLID (W)  SOLID (Y)  30'S - 10'D (W)  6'S - 2'D (W)  © GORES  © GORES	4502+00 4502+00 4502+00 4504+13 4507+28 4507+28	4511+67 4515+15 4517+01 4507+28 4514+06 4514+06	322 438 156 26 452 452
PMK-6	SOLID (W)  SOLID (Y)  30'S - 10'D (W)  6'S - 2'D (W)  @ GORES  @ GORES  SOLID (W)	4502+00 4502+00 4502+00 4502+00 4504+13 4507+28 4507+28 4514+06	4511+67 4515+15 4517+01 4507+28 4514+06 4514+06 4517+01	322 438 156 26 452 452 98
PMK-6	SOLID (W) SOLID (Y) 30'S - 10'D (W) 6'S - 2'D (W) @ GORES @ GORES SOLID (W) @ GORES	4502+00 4502+00 4502+00 4504+13 4507+28 4507+28 4514+06 4515+15	4511+67 4515+15 4517+01 4507+28 4514+06 4514+06 4517+01 4517+55	322 438 156 26 452 452 98 160
PMK-6	SOLID (W)  SOLID (Y)  30'S - 10'D (W)  6'S - 2'D (W)  © GORES  © GORES  SOLID (W)  © GORES  © GORES	4502+00 4502+00 4502+00 4504+13 4507+28 4507+28 4514+06 4515+15 4515+15	4511+67 4515+15 4517+01 4507+28 4514+06 4514+06 4517+01 4517+55 4517+55	322 438 156 26 452 452 98 160
PMK~6	SOLID (W) SOLID (Y) 30'S - 10'D (W) 6'S - 2'D (W) © GORES GORES SOLID (W) © GORES GORES SOLID (W) SOURCES SOLID (Y)	4502+00 4502+00 4502+00 4504+13 4507+28 4507+28 4514+06 4515+15 4515+15	4511+67 4515+15 4517+01 4507+28 4514+06 4514+06 4517+01 4517+55 4517+55 4529+76	322 438 156 26 452 452 98 160 160 487
PMK-6	SOLID (W)  SOLID (Y)  30'S - 10'D (W)  6'S - 2'D (W)  © GORES  © GORES  SOLID (W)  © GORES  © GORES  SOLID (Y)  SOLID (W)	4502+00 4502+00 4502+00 4504+13 4507+28 4507+28 4514+06 4515+15 4515+15 4515+15	4511+67 4515+15 4517+01 4507+28 4514+06 4514+06 4517+01 4517+55 4517+55 4529+76	322 438 156 26 452 452 98 160 160 487 425
PMK-6	SOLID (W)  SOLID (Y)  30'S - 10'D (W)  6'S - 2'D (W)  © GORES  © GORES  © GORES  © GORES  © GORES  SOLID (Y)  SOLID (Y)  SOLID (W)  30'S - 10'D (W)	4502+00 4502+00 4502+00 4504+13 4507+28 4507+28 4514+06 4515+15 4515+15 4515+15 4517+00 4517+01	4511+67 4515+15 4517+01 4507+28 4514+06 4514+06 4517+01 4517+55 4517+55 4529+76 4529+76	322 438 156 26 452 452 98 160 160 487 425
PMK-6	SOLID (W)  SOLID (Y)  30'S - 10'D (W)  6'S - 2'D (W)  © GORES  © GORES  SOLID (W)  © GORES  © GORES  SOLID (Y)  SOLID (W)	4502+00 4502+00 4502+00 4504+13 4507+28 4507+28 4514+06 4515+15 4515+15 4515+15	4511+67 4515+15 4517+01 4507+28 4514+06 4514+06 4517+01 4517+55 4517+55 4529+76	322 438 156 26 452 452 98 160 160 487 425

				WORK ZONE
SHEET				PAVEMENT
	I THE DECOMESTION	CTATION	TO STATION	
NUMBER	LINE DESCRIPTION	STATION	TO STATION	MARKING REMOVAL
				(SQ FT)
STAGE I				
MOT-14				
4"	SOLID (W)	4540+70.00	4542+31.00	54
4"	6'S - 2'D (W)	4543+00.00	4547+05.00	34
4''	SOLID (W)	4550+00.00	4554+05.00	135
4"	SOLID (Y)			1
		4529+80,00	4554+05.00	808
5"	30'S - 10'D (W)	4529+80.00	4554+05.00	505
8"	@ GORES	4542+31.00	4543+00.00	92
8''	@ GORES	4547+06.00	4550+00.00	196
12''	@ GORE (DIAGONAL)	4542+31.00	4543+00.00	20
MOT-15				
4''	SOLID (W)	4554+05,00	4564+00.00	332
	t		1	!
4''	SOLID (W)	4565+51.00	4569+83.00	144
4′′	SOLID (W)	4573+88.00	4578+05.00	139
4''	SOLID (Y)	4554+05.00	4578+05.00	800
4''	6'S - 2'D (W)	4565+15.00	4571+25.00	51
5′′	30'S - 10'D (W)	4554+05.00	4578+05.00	500
8''	@ GORES	4564+00.00	4565+15.00	77
		1		
8''	@ GORES	4571+25.00	4573+88.00	175
MOT-16				
4''	SOLID (W)	4578+05.00	4582+66.00	154
4''	SOLID (W)	4586+40.00	4601+00.00	487
4''	SOLID (Y)	4578+05.00	4602+05.00	800
4''	6'S - 2'D (W)	4582+66.00	4584+51.00	15
5″	30'S - 10'D (W)	į.		1
		4578+05.00	4602+05.00	500
8''	@ GORES	4584+51.00	4586+40.00	126
8′′	@ GORES	4601+00.00	4602+05.00	70
MOT-17				
4''	SOLID (W)	4610+50.00	4616+86.00	212
4''	SOLID (W)	4621+67.00	4624+32.00	88
4''	SOLID (Y)	4602+05.00	4626+05.00	800
4"	6'S - 2'D (W)			
		4604+50.00	4610+50.00	50
4''	6'S - 2'D (W)	4620+17.00	4624+59.00	37
5′′	30'S - 10'D (W)	4602+05.00	4626+05.00	250
5′′	30'S - 10'D (W)	4602+05.00	4621+66.00	204
8′′	@ GORES	4602+05.00	4604+50.00	163
8''	@ GORES	4616+86.00	4620+17.00	221
8′′	@ GORES	4624+59.00	4626+05.00	97
8′′	6'S - 2'D (W)	4621+66.00	4626+05.00	73
-			4626703,00	
LET/SYM	LEFT TURN ONLY	4621+80.00		36
LET/SYM	LEFT TURN ONLY	4626+80.00		36
MOT-18				
4′′	SOLID (W)	4626+90.00	4629+80.00	97
4''	SOLID (Y)	4626+05.00	4629+80,00	125
5′′	30'S - 10'D (W)	4625+05.00	4629+80.00	49
8′′	@ GORES	4626+05.00	4626+90.00	57
8′′	6'S - 2'D (W)	4626+05.00	4629+80.00	63
STAGE II				
MOT-23				}
LET/SYM	LEFT TURN ONLY	4531+50.00		36
LET/SYM	LEFT TURN ONLY	4534+80.00		36
4"	SOLID (W)	4541+99.00	4626+05.00	2,802
4"				
	SOLID (Y)	4541+99.00	4626+05.00	2,802
8′′	12'S - 3'D (W)	4529+80.00	4534+70.00	65
8′′	© GORES X 2	4534+70.00	4541+99.00	972
8′′	SOLID (W)	4529+80.00	454199	813
MOT-24				
LET/SYM	LEFT TURN ONLY	4639+00.00		36
4"	SOLID (W)	4541+99.00	4642+29.00	3,343
4"				
	SOLID (Y)	4541+99.00	4642+29.00	3,343
12"	@ SHLDR DIAG.	4541+99.00	4637+65.00	270
			TOTAL	26,297

F.A.I. SECTIO	N	COUNTY	TOTAL	SHEET NO.
94/90; *		COOK	556	24
STA.		TO STA.		
FED. ROAD DIST. NO.	ILLIN	OIS FED. AID	PROJECT	
62300 • a	818,	ETC, 2324.6-1	P)R-8	

		· · · · · · · · · · · · · · · · · · ·		
SHEET NUMBER	LINE DESCRIPTION	STATION	TO STATION	WORKZONE PAVEMENT MARKING REMOVAL CONT'D (SQ FT)
MOT-25		.,		
4''	4" SOLID (Y)	2364+20	2367+00	280
4′′	4" SOLID (W)	2364+20	2367+00	280
4′′	6'S - 2'D (W)	2364+20	2367+00	70
4′′	4" SOLID (Y)	2367+00	2382+00	1500
4"	4" SOLID (W)	2367+00	2374+60	760
4''	4" SOLID (W)	2372+75	2382+00	925
4"	4" SOLID (Y)	2372+75	2374+60	185
5′′	5" 30'S - 10'D	2364+20	2367+00	70
5′′	5" 30'S - 10'D	2364+20	2367+00	70
5"	5" 30'S - 10'D	2367+00	2382+00	375
5"	5" 30'S - 10'D	2367+00	2382+00	375
8′′	8" SOLID (W)	2367+00	2372+75	575
8"	8" SOLID (W)	2367+00	2372+75	575
12"	12" SOLID (W)	2367+00	2372+75	457
MOT-26				
4′′	4" SOLID (Y)	2382+00	2392+67	1067
4''	4" SOLID (W)	2382+00	2392+67	1067
4''	4" SOLID (Y)	4384+63	4391+37	674
4"	4" SOLID (W)	4384+63	4391+37	674
5"	5" 30'S - 10'D	2382+00	2392+67	267
5″	5" 30'S - 10'D	2382+00	2392+67	267
			TOTAL	64,198

ONE NORTH FRANKLIN CHICAGO, IL 60606 PHONE: G122 251-3006 WB; WWW.EKCORP.COM

ILLINOIS DEPARTMENT OF TRANSPORTATION F.A.I. 94/90 (DAN RYAN EXPRESSWAY)
31ST STREET TO 71ST STREET
NB EXPRESS LANE RECONSTRUCTION MAINTENANCE OF TRAFFIC SCHEDULE

SCALE: NONE DATE: 7/7/05

REVISIONS NAME

DRAWN BY: ATD CHECKED BY: TAI

F.A.I. SECTIO	A COMM	ΤY	TOTAL SHEETS	SHEET NO.
94/90 *	C00	K	556	25
STA.	TO STA.			
FED. ROAD DIST. NO.	ILLINOIS FED.	AID	PROJECT	

62300	_	/1010	ETC	2324.6-	1000-0

SHEET NUMBER	LINE DESCRIPTION	STATION	TO STATION	TEMPORARY PAVEMENT MARKING-LINE 6" (FOOT)
STAGE IA MOT-4	SOLID (Y) AT BARRIER WALL	2367+52 2367+52	2374+60 2382+00	708 1448
MOT-5	SOLID (Y) AT BARRIER WALL	4381+76 4382+15	4384+75 4391+39	299 924
STAGE IB MOT-6	SOLID (Y) AT BARRIER WALL	2365+00 2367+00	2367+00 2382+00	200 1500
MOT-7	SOLID (Y) AT BARRIER WALL	4381+76 4384+24	4390+99 4387+25	923 301
STAGE IC MOT-8	SOLID (Y) AT BARRIER WALL	2367+00	2374+76	776
MOT-9	SOLID (Y) AT BARRIER WALL	4382+08	4387+27	519
STAGE I MOT-10	SOLID (Y) AT BARRIER WALL	4417+50 4426+98	4426+98 4441+96	948 1498
MOT-11	SOLID (Y) AT BARRIER WALL	4441+96 4457+00	4457+00 4471+99	1504 1499
MOT-12	SOLID (Y) AT BARRIER WALL	4471+99 4486+99	4486+99 4502+00	1500 1501
MOT-13	SOLID (Y) AT BARRIER WALL	4502+00 4517+01	4517+01 4529+76	1501 1275
MOT-14	SOLID (Y) AT BARRIER WALL	4529+80.00	4554+05.00	2,425
M0⊤-15	SOLID (Y) AT BARRIER WALL	4554+05.00	4578+05.00	2,400
MOT-16	SOLID (Y) AT BARRIER WALL	4578+05.00	4602+05.00	2,400
MOT-17	SOLID (Y) AT BARRIER WALL	4602+05.00	4626+05.00	2,400
MOT-18	SOLID (Y) AT BARRIER WALL	4626+05.00	4637+60.00	1,155
MOT-25	SOLID (Y) AT BARRIER WALL	2373+00	2382+00	900
MOT-26	SOLID (Y) AT BARRIER WALL	4381+76	4391+37	961
			TOTAL.	31,465

SHEET   NUMBER   LINE DESCRIPTION   STATION   TO STATION   TYPE III 8"   (F00T)   STATION   TO STATION   TYPE III 8"   (F00T)   STATION   STATION   TYPE III 8"   (F00T)   STATION   STATION   STATION   TYPE III 8"   (F00T)   STATION					
MOT-4 2504-5 2354-35 2359-50 515 2364-04 2367+52 348 2364-04 2367+52 348 3489-83 4390+95 112 3489-83 4390+95 112 3564-78 2366-78 2360+22 344 3489-83 4390+95 112 3564-78 2360+22 344 3489-83 4390+95 112 3564-78 2360+22 344 3489-83 4390+99 116 3564-78 2370+28 2374+71 443 2370+28 2374+71 443 3489-83 4390+99 116 3576-78 2368+71 2374+76 605 3489-83 4390+99 116 3576-78 2368+71 2374+76 605 3658-78 2368+71 2374+76 605 3658-78 2368+71 2374+76 605 3658-78 2368-71 2374+76 605 3658-78 2368-71 2374+76 605 3658-78 2368-71 2374+76 605 3658-78 2368-71 2374+76 605 3658-78 2368-71 2374+76 605 3658-78 2368-71 2374+76 605 3658-78 2368-71 2374+76 605 3658-78 2368-71 2374+76 605 3658-78 2368-71 2374+76 605 3658-78 2368-71 2374+76 605 3658-78 2368-71 2374+76 605 3658-78 2368-71 2374+76 605 3658-78 2368-71 2374+76 605 3658-78 2368-71 2374+76 605 3658-78 2368-71 2374+76 605 3658-78 2368-71 2374+76 605 3658-78 2368-71 2374+76 605 3658-78 2368-71 2374+76 605 3658-78 2368-71 2374+76 605 3658-78 2374-76 605 3658-78 2368-79 368-78 2374-78 2568-78 2374-78 2568-78 2568-78 2568-7		LINE DESCRIPTION	STATION	TO STATION	MARKING , TYPE III 8"
MOT-5		@ GORES	2354+35 2364+04	2359+50 2367+52	515 348
STAGE IB   REGORES   2356-78   2360-42   344   443   443   мот-5	@ GORES	4389+83	4390+95 4390+95	112
MOT-1		@ GORES	2356+78 2370+28	2360+22 2374+71	344 443
STACE IC MOT-8         @ GORES         2368+71 2374+76 605         589 2374+76 605           STAGE I MOT-10         4414+24 4416+78 254 4414+78 4416+78 254 4432+84 4434+89 205 4432+84 4434+89 205 4438+07 4440+60 253 4438+07 4440+60 253 4438+07 4440+60 253 4438+07 4440+60 253 4458+85 4461+99 314 4458+85 4461+99 314 4458+85 4461+99 314 4458+85 4461+99 314 4487+50 4488+99 149 314 4487+50 4488+99 149 314 4487+50 4488+99 149 314 4458+85 4461+99 314 4458+85 4461+99 314 4450+02 4514+05 403 4510+02 4514+05 403 4510+02 4514+05 403 4510+02 4514+05 403 4510+02 4514+05 403 4510+02 4514+05 403 4510+02 4514+05 403 4510+02 4514+05 403 4510+02 4514+05 575 575 4510+02 4512+06 4510+02 4512+06 4510+06 4510+06 4510+	MOT-7				
STAGE I         4414+24         4416+78         254           MOT-10         e GORES         4432+84         4434+89         205           MOT-10         e GORES         4432+84         4434+89         205           MOT-11         e GORES         4438+07         4440+60         253           MOT-11         e GORES         4458+85         4461+99         314           MOT-12         e GORES         4487+50         4488+99         149           MOT-13         e GORES         4510+02         4514+05         403           MOT-25         e GORES         2367+00         2372+75         575           MOT-25         e GORES         2367+00         2372+75         575           MOT-19         e GORES         4432+00         4436+98         498           MOT-19         e GORES         4432+00         4436+98         498           MOT-22         e GORES         4520+00         4523+76         376           MOT-14         e GORES         4547+06.00         4523+76         376           MOT-16         e GORES         4547+06.00         4565+15.00         115           e GORES         4564+00.00         4565+15.00         165			2368+71	2374+60	589
MOT-11		@ GORES	4414+24 4432+84 4432+84 4438+07 4438+07	4416+78 4434+89 4434+89 4440+60	254 205 205 253
MOT-12	MOT-11	@ GORES	4458+85		
MOT-15	MOT-12	@ GORES	4487+50		
MOT-25         © GORES         2367+00         2372+75         575           MOT-19         © GORES         4432+00         4436+98         498           MOT-22         © GORES         4520+00         4523+76         376           MOT-22         © GORES         4520+00         4523+76         376           MOT-14         © GORES         4528+00         4530+00         50           STAGE I         MOT-14         © GORES         4547+06.00         4550+00.00         294           MOT-15         © GORES         4564+00.00         4550+00.00         294           MOT-16         © GORES         4564+00.00         4565+15.00         115           © GORES         4571+25.00         4573+88.00         263           MOT-16         © GORES         4584+51.00         4586+40.00         189           © GORES         4601+00.00         4602+05.00         105           MOT-17         © GORES         4602+05.00         4604+50.00         245           © GORES         4616+86.00         4620+17.00         331           MOT-18         © GORES         4624+59.00         4626+05.00         10           STAGE II         © GORES         4626+05.00		@ GORES			
MOT-19         © GORES         4432+00 4436+98 498 4520+00 4523+76 376 376 4520+00 4523+76 376 376 4520+00 4523+76 376 4520+00 4523+76 376 4528+00 4530+00 50           STAGE I         MOT-14         © GORES         4542+31.00 4530+00.00 294 4530+00.00 294 4573+86.00 263 4571+25.00 4573+88.00 263 4571+25.00 4573+88.00 263 4571+25.00 4573+88.00 263 4571+25.00 4586+40.00 189 6076 4602+05.00 105 4602+05.00 4602+05.00 245 4602+05.00 4602+05.00 245 4602+05.00 4602+05.00 245 4602+05.00 4602+05.00 105 4602+05.00 4602+05.00 110 57AGE II         © GORES 462+05.00 4626+05.00 110 4626+05.00 110 57AGE II         © GORES 4626+05.00 4626+05.00 4626+05.00 4626+05.00 4626+05.00 4626+05.00 4626+05.00 4626+05.00 4626+05.00 4626+05.00 4626+05.00 4626+05.00 4626+05.00 4626+05.00 4626+05.00 4626+05.00 4626+05.00 4626+05.00 4626+05.00 4626+05.00 4			2367+00		
MOT-22         № GORES         4520+00 4523+76 4530+00         376 4528+00         376 4530+00         50           STAGE I         MOT-14         № GORES         4542+31.00 4543+00.00         138 450+00.00         294 450+00.00         294 4550+00.00         294 4550+00.00         294 4565+15.00         115 4550+15.00         115 4550+15.00         115 4550+15.00         115 4550+15.00         115 4550+15.00         115 4550+15.00         115 4550+15.00         126 450+15.00         126 450+15.00         126 450	MOT-19	@ GORES	4432+00	4436+98	498
MOT-14         e GORES         4542+31.00         4543+00.00         138           e GORES         4547+06.00         4550+00.00         294           MOT-15         e GORES         4564+00.00         4565+15.00         115           e GORES         4571+25.00         4573+88.00         263           MOT-16         e GORES         4584+51.00         4586+40.00         189           e GORES         4601+00.00         4602+05.00         105           MOT-17         e GORES         4602+05.00         4604+50.00         245           e GORES         4616+86.00         4620+17.00         331           MOT-18         e GORES         4624+59.00         4626+05.00         116           STAGE II         e GORES         4626+05.00         4626+05.00         10           STAGE II         e GORES         4626+05.00         4626+05.00         75           12'S - 3'D (W)         4626+05.00         4529+80.00         75           12'S - 3'D (W)         4529+80.00         4541+99.00         1,458           SOLID (W)         4529+80.00         4541+99.00         1,219	MOT-22	@ GORES	4520+00	4523+76	376
© CORES         4547+06.00         4550+00.00         294           MOT-15         © CORES         4564+00.00         4565+15.00         115           © CORES         4571+25.00         4573+88.00         263           MOT-16         © CORES         4584+51.00         4586+40.00         189           © CORES         4601+00.00         4602+05.00         105           MOT-17         © CORES         4602+05.00         4604+50.00         245           © CORES         4616+86.00         4620+17.00         331           MOT-18         © CORES         4624+99.00         4626+05.00         116           STAGE II         © CORES         4626+05.00         4626+05.00         85           MOT-23         12'S - 3'D (W)         4626+05.00         4629+80.00         75           12'S - 3'D (W)         4529+80.00         4534+70.00         98           © GORES X 2         4534+70.00         4541+99.00         1,458           SOLID (W)         4529+80.00         4541+99.00         1,219	STAGE I				
MOT-15              ■ GORES             ■ GORES             ■ 4564+00.00             ■ 4565+15.00             ■ 115             ■ GORES             ■ 4571+25.00             ■ 4573+88.00             ■ 263             ■ MOT-16             ■ GORES             ■ 4584+51.00             ■ 4586+40.00             ■ 189             ■ 60RES             ■ 4601+00.00             ■ 4602+05.00             ■ 105             ■ 60RES             ■ 4602+05.00             ■ 4602+05.00             ■ 4602+05.00             ■ 4602+05.00             ■ 4620+17.00             ■ 331             ■ MOT-18             ■ GORES             ■ 4624+59.00             ■ 4626+05.00             ■ 4626+05.00             ■ 116             ■ 60RES             ■ 4624+69.00             ■ 4626+05.00             ■ 4626+05.00             ■ 4626+05.00             ■ 4626+05.00             ■ 4626+05.00             ■ 4628+80.00             ■ 75             ■ 75	MOT-14			1	
© GORES         4571+25.00         4573+88.00         263           MOT-16         © GORES         4584+51.00         4586+40.00         189           © GORES         4601+00.00         4602+05.00         105           MOT-17         © GORES         4602+05.00         4604+50.00         245           © GORES         4616+86.00         4620+17.00         331           MOT-18         © GORES         4624+59.00         4626+05.00         146           6'S - 2'D (W)         4621+66.00         4626+05.00         110           STAGE II         © GORES         4626+05.00         4626+90.00         85           MOT-23         12'S - 3'D (W)         4626+05.00         4629+80.00         75           12'S - 3'D (W)         4529+80.00         4534+70.00         98           © GORES X 2         4534+70.00         4541+99.00         1,458           SOLID (W)         4529+80.00         4541+99.00         1,219	MOT-15				
MOT-16         © CORES         4584+51.00         4586+40.00         189           © GORES         4601+00.00         4602+05.00         105           MOT-17         © CORES         4602+05.00         4604+50.00         245           © GORES         4616+86.00         4620+17.00         331           MOT-18         © CORES         4624+59.00         4626+05.00         146           6'S - 2'D (W)         4621+66.00         4626+05.00         10           STAGE II         © GORES         4626+05.00         4626+90.00         85           MOT-23         12'S - 3'D (W)         4626+05.00         4629+80.00         75           12'S - 3'D (W)         4529+80.00         4534+70.00         98           © GORES X 2         4534+70.00         4541+99.00         1,458           SOLID (W)         4529+80.00         4541+99.00         1,219					
MOT-17         e GORES         4602+05.00         4604+50.00         245           e GORES         4616+86.00         4620+17.00         331           MOT-18         e GORES         4624+59.00         4626+05.00         146           6'S - 2'D (W)         4621+66.00         4626+05.00         110           STAGE II         e GORES         4626+05.00         4626+90.00         85           MOT-23         12'S - 3'D (W)         4626+05.00         4629+80.00         75           12'S - 3'D (W)         4529+80.00         4534+70.00         98           e GORES X 2         4534+70.00         4541+99.00         1,458           SOLID (W)         4529+80.00         4541+99.00         1,219	MOT-16	@ GORES			
© GORES     4616+86.00     4620+17.00     331       MOT-18     © GORES     4624+59.00     4626+05.00     146       6'S - 2'D (W)     4621+66.00     4626+05.00     110       STAGE II     © GORES     4626+05.00     4626+90.00     85       MOT-23     12'S - 3'D (W)     4626+05.00     4629+80.00     75       12'S - 3'D (W)     4529+80.00     4534+70.00     98       © GORES X 2     4534+70.00     4541+99.00     1,458       SOLID (W)     4529+80.00     451+99.00     1,219		@ GORES	4601+00.00	4602+05.00	105
MOT-18 & CORES 4624+59.00 4626+05.00 146 6'S - 2'D (W) 4621+66.00 4626+05.00 110  STAGE II & GORES 4626+05.00 4626+90.00 85  MOT-23 12'S - 3'D (W) 4626+05.00 4629+80.00 75 12'S - 3'D (W) 4529+80.00 4534+70.00 98  & GORES X 2 4534+70.00 4541+99.00 1,458  SOLID (W) 4529+80.00 4541+99.00 1,219	MOT-17	@ GORES	4602+05.00	4604+50.00	245
6'S - 2'D (W) 4621+66.00 4626+05.00 110  STAGE II © GORES 4626+05.00 4626+90.00 85  MOT-23 12'S - 3'D (W) 4626+05.00 4629+80.00 75  12'S - 3'D (W) 4529+80.00 4534+70.00 98  © GORES X 2 4534+70.00 4541+99.00 1,458  SOLID (W) 4529+80.00 4541+99.00 1,219				4620+17.00	331
STAGE II     @ GORES     4626+05.00     4626+90.00     85       MOT-23     12'S - 3'D (W)     4626+05.00     4629+80.00     75       12'S - 3'D (W)     4529+80.00     4534+70.00     98       @ GORES X 2     4534+70.00     4541+99.00     1,458       SOLID (W)     4529+80.00     4541+99.00     1,219	MOT-18	@ GORES	4624+59.00	4626+05.00	146
MOT-23 12'S - 3'D (W) 4626+05.00 4629+80.00 75 12'S - 3'D (W) 4529+80.00 4534+70.00 98 @ GORES X 2 4534+70.00 4541+99.00 1,458 SOLID (W) 4529+80.00 4541+99.00 1,219					
12'S - 3'D (W) 4529+80.00 4534+70.00 98 @ GORES X 2 4534+70.00 4541+99.00 1,458 SOLID (W) 4529+80.00 4541+99.00 1,219					
© GORES X 2 4534+70.00 4541+99.00 1,458 SOLID (W) 4529+80.00 4541+99.00 1,219	MOT-23				
SOLID (W) 4529+80.00 4541+99.00 1,219				1	
				1	
TOTAL 15.925		SOLID (W)	4529+80.00		
				FOTAL	15.925

SHEET NUMBER	LINE DESCRIPTION	STATION	TO STATION	MARKING, TYPE III 5" (FOOT)
STAGE IA MOT-4	30'S - 10'D (W)	2364+04 2367+00	2367+00 2382+00	74 375
MOT-5	30'S - 10'D (W)	4381+76 4390+95 4397+07 4397+07	4397+07 4397+07 4412+42 4412+42	383 153 384 384
STAGE IB		2356+78	2367+00	256
мот-6	30'S - 10'D (W)	2356+78 2367+00 2367+00	2367+00 2382+00 2370+28	256 375 82
MOT-7	30'S - 10'D (W)	4381+76 4390+99	4391+37 4391+37	240 10
STAGE IC MOT-8	30'S - 10'D (W)	2367+00 2367+00	2382+00 2368+71	375 43
MOT-9	30'S - 10'D (W)	4381+76	4387+27	138
STAGE I	*** ***********************************	4412+42	4426+98	364
MOT-10	30'S - 10'D (W)	4412+42 4426+98	4426+98 4441+96	364
l		4426+98	4441+96	375 375
		4441+96	4457+00	376
MOT-11	30'S - 10'D (W)	4441+96 4457+00 4457+00	4457+00 4471+99 4471+99	376 375
MOT-12	30'S - 10'D (W)	4471+99 4471+99 4486+99 4486+99	4486+99 4486+99 4502+00 4502+00	375 375 375 375 375 375
MOT-13	30'S - 10'D (W)	4502+00 4502+00 4517+01 4517+01	4517+01 4517+01 4529+76 4529+76	375 375 319 319
MOT-14	30'S - 10'D (W)	4529+80.00	4554+05.00	1,213
MOT-15	30'S - 10'D (W)	4554+05.00	4578+05.00	1,200
MOT-16	30'S - 10'D (W)	4578+05.00	4602+05,00	1,200
MOT-17	30'S - 10'D (W)	4602+05.00	4626+05.00	600
	30'S - 10'D (W)	4602+05.00	4621+66.00	490
MOT-18	30'S - 10'D (W)	4625+05.00	4629+80.00	119
STAGE III MOT-25	30'S - 10'D (W)	2364+20 2364+20 2367+00 2367+00	2367+00 2367+00 2382+00 2382+00	7( 7( 375 375
MOT-26	30'S - 10'D (W)	2382+00 2382+00	2392+67 2392+67	26 26
			TOTAL	15,638

SHEET NUMBER	LINE DESCRIPTION	STATION	TO STATION	PAVEMENT MARKING TAPE, TYPE III -LETTERS & SYMBOLS (SQ FT)
STAGE I	LEFT TURN ONLY	2517+00	2530+00	36
MOT-13	LEFT TURN ONLY	2517+00	2530+00	36
MOT-17	LEFT TURN ONLY	4621+80.00		36
	LEFT TURN ONLY	4626+80.00		36
STAGE II				
MOT-23	LEFT TURN ONLY	4531+50.00		36
	LEFT TURN ONLY	4534+80.00		36
MOT-24	LEFT TURN ONLY	4639+00.00		36
			TOTAL	218

REVISIONS		ILLINOIS DEPARTMENT OF TRANSPORTATION				
NAME	DATE	ILLINUIS DEPARTMENT OF TRANSPORTATION				
		F.A.I. 94/90 (DAN RYAN EXPRESSWAY)				
		31ST STREET TO 71ST STREET				
		NB EXPRESS LANE RECONSTRUCTION				
		MAINTENANCE OF TRAFFIC				

ONE NORTH FRANKLIN CHICAGO, 1L 60606 PHONE: (312) 251-3005 WEB: WWW.EXCORP.COM

SCALE: NONE DATE: 7/7/05

CHECKED BY: TAI

SCHEDULE DRAWN BY: ATD

F.A.I. S	ECTION	COUNTY	TOTAL SHEET SHEETS NO.
94/90 *		COOK	556 26
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FED. ROAD DIS	r. NO. ILLINOIS	FED. AID	PROJECT

62300	*	(1818,	ETC,	2324.6-1P)R-
02300		(TOTO)	L I C;	202 110 II ///

				PAVEMENT
EET				MARKING .
	INE DESCRIPTION	CTATION	TO CTATION	
MBER	LINE DESCRIPTION	STATION	TO STATION	TYPE III 4"
		The second secon		(F00T)
AGE IA	SOLID (Y)	2352+00	2367+00	1500
	6'S - 2'D (W)	2359+50	2362+53	76
T-4	SOLID (W)	2354+35	2367+00	1265
	SOLID (Y)	2367+00	2382+00	1500
	SOLID (W) SOLID (Y)	2367+00	2372+14	514
	SOLID (W)	2367+52 2367+52	2374+60	708
0T-5	SOLID (Y)	4381+76	2382+00 4397+07	1448 1531
J 1 J	SOLID (W)	4381+76	4389+83	807
	SOLID (Y)	4384+24	4389+83	559
	SOLID (W)	4384+24	4397+07	1283
	SOLID (Y)	4397+07	4400+96	389
	SOLID (W)	4397+07	4400+96	389
AGE IB	SOLID (Y)	2356+78	2367+00	1022
OT-6	SOLID (W)	2354+35	2367+00	1265
	SOLID (Y)	2354+35	2356+78	243
	6'S - 2'D (W) SOLID (Y)	2360+22 2367+00	2363+22	75
	SOLID (W)	2374+71	2382+00 2382+00	1500 729
	SOLID (W)	2367+00	2374+37	737
OT-7	SOLID (Y)	4381+76	4391+37	961
	SOLID (W)	4381+76	4389+83	807
	SOLID (W)	4384+63	4391+37	674
	SOLID (Y)	4384+63	4389+83	520
AGE IC	SOLID (Y)	2367+00	2382+00	1500
10T-8	SOLID (W)	2367+00	2374+76	776
	SOLID (W)	2374+60	2382+00	740
10T-9	SOLID (Y) SOLID (W)	4381+76	4387+27	551
		4381+76	4387+27	551
FAGE I	SOLID (Y) SOLID (W)	4400+96	4412+42 4412+42	1146
10T-4 10T-10	SOLID (Y)	4400+96 4412+42	4426+98	1146 1456
101-10	SOLID (W)	4412+42	4414+24	182
	SOLID (W)	4414+24	4426+98	1274
	6'S - 2'D (W)	4416+78	4426+98	255
	6'S - 2'D (W)	4426+98	4430+00	76
	SOLID (Y)	4426+98	4441+96	1498
	SOLID (W)	4426+98	4432+84	586
	SOLID (W)	4432+84	4440+60	776
	SOLID (W) 6'S - 2'D (W)	4440+60	4441+96	136
IOT-11	6'S - 2'D (W) SOLID (Y)	4434+89 4441+96	4438+07 4457+00	80 1504
01-11	SOLID (W)	4441+96 4441+96	4457+00 4457+00	1504
	6'S - 2'D (W)	4455+57	4457+00	36
	SOLID (Y)	4457+00	4471+99	1499
	6'S - 2'D (W)	4457+00	4458+85	46
	SOLID (W)	4457+00	4461+99	499
	SOLID (W)	4461+99	4471+99	1000
OT-12	SOLID (Y)	4471+99	4486+99	1500
	SOLID (W)	4471+99	4486+99	1500
		4486+99	4502+00	1501
	SOLID (W) 6'S - 2'D (W)	4486+99 4488+99	4487+50 4492+60	51 90
	SOLID (W)	4488+99 4487+50	4502+00	1450
IOT-13	SOLID (Y)	4502+00	4517+01	1501
01 13	SOLID (W)	4502+00	4514+05	1205
	6'S - 2'D (W)	4506+05	4510+02	99
	SOLID (W)	4514+05	4517+01	296
	SOLID (Y)	4517+01	4529+76	1275
	SOLID (W)	4517+01	4529+76	1275

SHEET NUMBER	LINE DESCRIPTION	STATION	TO STATION	PAVEMENT MARKING TYPE III 4" (FOOT)
STAGE II MOT-25	SOLID (Y) SOLID (W) 6'S - 2'D (W) SOLID (Y) SOLID (W) SOLID (W)	2364+20 2364+20 2364+20 2367+00 2367+00 2372+75	2367+00 2367+00 2367+00 2382+00 2374+60 2382+00	280 280 70 1500 760 925
MOT-26	SOLID (Y) SOLID (Y) SOLID (W) SOLID (Y) SOLID (W)	2372+75 2382+00 2382+00 4384+63 4384+63	2374+60 2392+67 2392+67 4391+37 4391+37	185 1067 1067 674 674
MOT-19	SOLID (Y) 6'S - 2'D (W) SOLID (W)	4428+00 4428+00 4436+98	4442+00 4432+00 4442+00	1400 100 502
MOT-20	SOLID (Y) SOLID (W) SOLID (Y) SOLID (W)	2442+00 2442+00 2457+00 2457+00	2457+00 2457+00 2472+00 2472+00	1500 1500 1500 1500
MOT-21	SOLID (Y) SOLID (W) SOLID (W) SOLID (W) SOLID (W) SOLID (W) SOLID (W) SOLID (Y) SOLID (Y) SOLID (W) 6'S - 2'D (W)	2472+00 2472+00 2487+00 2487+00 2502+00 2502+00 2517+00 4523+76	2487+00 2487+00 2502+00 2502+00 2517+00 2517+00 2530+00 2520+00 4528+00	1500 1500 1500 1500 1500 1500 1300 300 106
STAGE I	SOLID (W)	4540+70.00	4542+31.00	161
MOT-14	6'S - 2'D (W)	4543+00.00	4547+06.00	102
	SOLID (W)	4550+00.00	4554+05.00	405
	SOLID (Y)	4529+80.00	4554+05.00	2,425
MOT-15	SOLID (W)	4554+05.00	4564+00.00	995
	SOLID (W)	4565+51.00	4569+83.00	432
	SOLID (W)	4573+88.00	4578+05.00	417
	SOLID (Y)	4554+05.00	4578+05.00	2,400
	6'S - 2'D (W)	4565+15.00	4571+25.00	153
MOT-16	SOLID (W)	4578+05.00	4582+66.00	461
	SOLID (W)	4586+40.00	4601+00.00	1,460
	SOLID (Y)	4578+05.00	4602+05.00	2,400
	6'S - 2'D (W)	4582+66.00	4584+51.00	46
M0T-17	SOLID (W)	4610+50,00	4616+86.00	636
	SOLID (W)	4621+67.00	4624+32,00	265
	SOLID (Y)	4602+05.00	4626+05.00	2,400
	6'S - 2'D (W)	4604+50.00	4610+50.00	150
MOT 10	6'S - 2'D (W)	4620+17.00	4624+59.00	111
MOT-18	SOLID (W)	4626+90.00	4629+80.00	290
CTACE II	SOLID (Y)	4626+05.00	4629+80.00	375
STAGE II	SOLID (W)	4541+99.00	4626+05.00	8,406
MOT-23	SOLID (Y)	4541+99.00	4626+05.00	8,406
MOT-24	SOLID (W)	4626+05.00	4642+29.00	1,624
·····	SOLID (Y)	4626+05.00	4642+29.00	1,624
			TOTAL	113,394

SHEET NUMBER	LINE DESCRIPTION	STATION	TO STATION	PAVEMENT MARKING , TYPE III 12" (FOOT)
STAGE IA MOT-4	⊚ GORE (DIAGONAL)	2354+35 2364+04	2359+50 2367+52	313 202
MOT-5	@ GORE (DIAGONAL)	4389+83	4390+95	13
STAGE IB MOT-6 MOT-7	© GORE (DIAGONAL)	2356+78 2370+28 4389+83	2360+22 2374+71 4390+99	137 125 9
STAGE IC MOT-8	@ GORE (DIAGONAL)	2368+71	2374+76	707
STAGE I MOT-10	@ GORE (DIAGONAL)	4414+24 4432+84 4438+07	4416+78 4434+89 4440+60	59 94 205
MOT-11	@ GORE (DIAGONAL)	4458+85	4461+99	100
MOT-12	@ GORE (DIAGONAL)	4487+50	4488+99	22
MOT-13	© GORE (DIAGONAL)	4510+02	4514+05	102
MOT-14	© GORE (DIAGONAL)	4542+31.00	4543+00.00	20
	SHLDR DIAG.	4541+99.00	4637+65.00	541
STAGE II MOT-19 MOT-20	© GORE (DIAGONAL) © SHLDR. (DIAGONAL) © SHLDR. (DIAGONAL)	4432+00 4436+98 2442+00	4436+98 4442+00 2472+00	153 27 122
MOT-21	© SHLDR. (DIAGONAL)	2472+00	2502+00	151
MOT-22	@ GORE (DIAGONAL) @ SHLDR. (DIAGONAL)	4520+00 2502+00	4523+76 2530+00	122 96
MOT-25	@ GORE (DIAGONAL)	2367+00	2372+75	457
			TOTAL	3,774

ECVIPCE

ONE NORTH FRANKLIN
CHICAGO, IL 60606
PHONE: G122 251-3000
PHONE: HZ 6122 251-3015
WEB: WWW.EXCORP.COM

ILLINOIS DEPARTMENT OF TRANSPORTATION F.A.I. 94/90 (DAN RYAN EXPRESSWAY) 31ST STREET TO 71ST STREET NB EXPRESS LANE RECONSTRUCTION MAINTENANCE OF TRAFFIC SCHEDULE

> SCALE: NONE DATE: 7/7/05

DRAWN BY: ATD

CHECKED BY: TAI

	LINE DESCRIPTION	STATION	TO STATION	MARKING - LINE 4"	NUMBER	LINE DESCRIPTION	STATION	TO STATION	PAVEMEN MARKING - LINE 4
			**********	(FOOT)					(F00
PMK-1					PMK-6				
	SOLID (Y)	2367+00	2382+00	1500	(CONT'D)	6'S - 2'D (W)	4504+28	4507+28	7
	SOLID (W)	2367+00	2374+91	791		SOLID (Y)	2517+00	2530+00	130
	6'S - 2'D (W)	2367+00	2368+62	41		SOLID (W)	2517+00	2530+00	130
	SOLID (W)	2375+80	2382+00	620		SOLID (Y)	4517+01	4529+76	127
PMK-2						SOLID (W)	4517+01	4529+76	127
	SOLID (Y)	2382+00	2397+00	1500	PMK-7				
	SOLID (W)	2391+59	2397+00	541		EVENECE II			
1	SOLID (W)	4381+76	4384+25	249		EXPRESS &	0570.00.00	05.47.70.00	
	SOLID (Y)	4391+38	4397+07	569		SOLID (W)	2530+00.00	2543+78.00	1,37
1	SOLID (W)	4384+25	4397+07	1282		SOLID (Y)	2530+00,00	2554+00.00	2,40
İ	6'S - 2'D (W)	4391+37	4401+02	241		SB SLIP RAMP B	0045.50.00		
l	SOLID (Y)	2397+00	2412+00	1500		SOLID (W)	0815+50.00	0828+00.00	1,25
	SOLID (W)	2397+00	2408+02	1102		SOLID (Y)	0810+00.00	0818+80.00	88
l	SOLID (Y)	2407+22	2408+02	80		LOCAL B			
l	SOLID (W)	2407+22	2412+00	478		SOLID (W)	4540+70.00	4542+90.00	22
	SOLID (Y)	4397+07	4412+42	1535		SOLID (W)	4550+68.60	4554+05.00	33
	SOLID (W)	4397+07	4412+42	1535		SOLID (Y)	4529+80.00	4536+00.00	62
PMK-3						SOLID (Y)	4542+57.00	4554+05.00	1,14
l	SOLID (Y)	2412+00	2427+00	1500		6'S - 2'D (W)	4543+52.70	4546+55.00	
1	SOLID (W)	2412+00	2427+00	1500	PMK-8				
I	SOLID (Y)	4412+42	4426+98	1456	I WIN G				
l	SOLID (W)	4412+42	4414+25	183		EXPRESS B			
l	SOLID (W)	4414+25	4426+98	1273		SOLID (W)	2554+00.00	2578+00.00	2,40
l	6'S - 2'D (W)	4419+78	4426+98	180		SOLID (Y)	2554+00.00	2578+00.00	2,40
l	6'S - 2'D (W)	4426+98	4429+09	53		LOCAL B			
l	SOLID (Y)	2427+00	2442+00	1500		SOLID (W)	4554+05,00	4564+00.00	9
l	SOLID (W)	2427+00	2442+00	1500		SOLID (W)	4573+88.00	4578+05.00	4
l	SOLID (Y)	4426+98	4441+96	1498		SOLID (Y)	4554+05.00	4578+05.00	2,40
l	SOLID (W)	4426+98	4432+84	586		6'S - 2'D (W)	4565+81.90	4570+97.20	12
l	SOLID (W)	4432+84	4440+61	777	PMK-9				
l	SOLID (W)	4440+61	4441+96	135	FWIN-3				
ı	6'S - 2'D (W)	4434+62	4437+52	73		EXPRESS B			
PMK-4						SOLID (W)	2578+00.00	2602+00.00	2,40
l	SOLID (Y)	2442+00	2457+00	1500		SOLID (Y)	2578+00.00	2602+00.00	2,40
l	SOLID (W)	2442+00	2457+00	1500		LOCAL B			
l	SOLID (Y)	4441+96	4457+00	1504		SOLID (W)	4578+05,00	4582+78.00	4
l	SOLID (W)	4441+96	4457+00	1504		SOLID (W)	4586+40.00	4601+00.00	1,46
l	6'S - 2'D (W)	4453+83	4457+00	79		SOLID (Y)	4578+05.00	4602+05.00	2,40
l	SOLID (Y)	2457+00	2472+00	1500		6'S - 2'D (W)	4582+43.50	4584+34.30	
l	SOLID (W)	2457+00	2472+00	1500	PMK-10				
l	SOLID (Y)	4457+00	4471+99	1499	PMK-10				
l	SOLID (W)	4457+00	4461+99	499		EXPRESS &			
l	SOLID (W)	4461+99	4471+99	1000		SOLID (W)	2602+00.00	2626+00.00	2,40
PMK-5						SOLID (Y)	2602+00.00	2626+00.00	2,40
	SOLID (Y)	2472+00	2487+00	1500		LOCAL B			
	SOLID (W)	2472+00	2487+00	1500		SOLID (W)	4611+54.30	4616+86.00	53
	SOLID (Y)	4471+99	4486+99	1500		SOLID (Y)	4602+05.00	4626+05.00	2,40
1	SOLID (W)	4471+99	4486+99	1500		6'S - 2'D (W)	4605+29.30	4611+54.30	15
	SOLID (Y)	2487+00	2502+00	1500		6'S - 2'D (W)	4620+70.00	4624+40.60	,
	SOLID (W)	2487+00	2502+00	1500	DIAN 44		·····		
	SOLID (Y)	4486+99	4502+00	1501	PMK-11				
	SOLID (W)	4486+99	4487+49	50		EXPRESS B			
	SOLID (W)	4487+49	4502+00	1451		SOLID (W)	2626+00.00	2637+50.00	1,15
	6'S - 2'D (W)	4491+10	4494+21	78		SOLID (Y)	2626+00.00	2637+50.00	1,15
/K-6	-0 -0 111/	1131110	1131121	10		LOCAL &			1
11N-0	COLID (V)	2500100	0E17100	1500		SOLID (W)	4626+90.70	4629+80.00	28
	SOLID (Y)	2502+00	2517+00	1500		SOLID (Y)	4626+05.00	4629+80.00	3
	SOLID (W)	4502+00	4516+33	1433	Diam'r				
	SOLID (Y)	2515+23	2517+00	177	PMK-12	601 10 00	5007	6006	
	SOLID (W)	2515+23	2517+00	177		SOLID (Y)	5997+48	6006+31	88
	SOLID (Y)	4502+00	4516+33	1433		SOLID (W)	5997+48	6006+40	89
,	SOLID (W)	4502+00	4514+06	1206	-	SOLID (W)	6004+70	6006+31	1
l l	SOLID (W)	4514+06	4517+01	295		SOLID (Y)	6004+70	6006+40	1

SHEET NUMBER	LINE DESCRIPTION	STATION	TO STATION	EPOXY PAVEMENT MARKING - LINE 5"
	1			(FOOT)
PMK-1				
	30'S - 10'D (W)	2367+00	2382+00	375
	30'S - 10'D (W)	2367+00	2382+00	375
	30'S - 10'D (W)	2375+80	2382+00	155
	30'S - 10'D (W)	2367+00	2381+24	356
PMK-2				
	30'S - 10'D (W)	2382+00	2397+00	375
	30'S - 10'D (W)	2382+00	2397+00	375
	30'S - 10'D (W)	4381+76	4397+07	383
	30'S - 10'D (W)	2397+00	2412+00	375
	30'S - 10'D (W)	2397+00	2412+00	375
	30'S - 10'D (W)	2411+32	2412+00	17
5. W 3	30'S - 10'D (W)	4397+07	4412+42	384
PMK-3	70/C 10/D (W)	0440100	0.407.400	
	30'S - 10'D (W)	2412+00	2427+00	375
	30'S - 10'D (W) 30'S - 10'D (W)	2412+00 2412+00	2427+00 2427+00	375 375
	30'S - 10'D (W)	4412+42	4426+98	364
	30'S - 10'D (W)	4417+50	4419+78	57
	30'S - 10'D (W)	2427+00	2442+00	375
	30'S - 10'D (W)	2427+00	2442+00	375
	30'S - 10'D (W)	2427+00	2442+00	375
	30'S - 10'D (W)	4426+98	4441+96	375
PMK-4				
	30'S - 10'D (W)	2442+00	2457+00	375
	30'S - 10'D (W)	2442+00	2457+00	375
	30'S - 10'D (W)	2442+00	2457+00	375
	30'S - 10'D (W)	4441+96	4457+00	376
	30'S - 10'D (W)	2457+00	2472+00	375
	30'S - 10'D (W)	2457+00	2472+00	375
	30'S - 10'D (W)	2457+00	2472+00	375
	30'S - 10'D (W)	4457+00	4471+99	375
PMK-5				
	30'S - 10'D (W)	2472+00	2487+00	375
	30'S - 10'D (W)	2472+00	2487+00	375
	30'S - 10'D (W)	2472+00	2482+11	253
	30'S - 10'D (W)	4471+99	4486+99	375
	30'S - 10'D (W)	2487+00	2502+00	375
	30'S ~ 10'D (W)	2487+00	2502+00	375
	30'S - 10'D (W)	4486+99	4502+00	375
PMK-6				
	30'S - 10'D (W)	2502+00	2517+00	375
	30'S - 10'D (W)	2502+00	2517+00	375
	30'S - 10'D (W)	4502+00	4517+01	375

2517+00 2530+00

2530+00

4529+76

4529+76

4527+14

2517+00

4517+01

4524+56

4524+56

30'S - 10'D (W)

325

325 319

130

65

F.A.1. SECTIO	N	COUNT	Y	TOTAL	SHEET NO.
94/90 *		COOK		556	27
STA.	TO	STA.		- 1	
FED. ROAD DIST. NO.	TELTNOIS	FED.	AID	PROJECT	

62300 • (1818, ETC, 2324.6-1P)R-8

SHEET NUMBER	LINE DESCRIPTION	STATION	TO STATION	EPOXY PAVEMENT MARKING - LINE 5" (FOOT)
PMK-7				Committee Commit
	EXPRESS &			
	30'S - 10'D (W) 30'S - 10'D (W)	2530+00.00 2553+00.00	2554+00.00 2554+00.00	1,200
	LOCAL BL	2000 100100	2501100100	
	30'S - 10'D (W)	4529+80.00	4554+05.00	1,213
PMK-8	***************************************	1-7-14		
	EXPRESS B			4 500
	30'S - 10'D (W) LOCAL B	2554+00,00	2578+00.00	1,800
	30'S - 10'D (W)	4554+05.00	4578+05.00	1,200
PMK-9				
	EXPRESS &			
	30'S - 10'D (W)	2578+00.00	2602+00.00	1,800
	LOCAL ₽ 30'S - 10'D (₩)	4578+05.00	4602+05.00	1,200
PMK-10				
LMIKTO	EXPRESS B			
	30'S - 10'D (W)	2602+00.00	2626+00.00	1,800
	LOCAL B 30'S - 10'D (W)	4602+05.00	4621+60.00	978
	30'S - 10'D (W)	4621+60.00	4626+05.00	111
PMK-11				
	EXPRESS B			
	30'S - 10'D (W)	2626+00.00	2637+50.00	863
	LOCAL B 30'S - 10'D (W)	4626+05.00	4629+80.00	94
PMK-I2				
	30'S ~ 10'D (W)	5997+48	6001+20	93
1			TOTAL	26,758
	I	L	L	

ILLINOIS DEPARTMENT OF TRANSPORTATION F.A.I. 94/90 (DAN RYAN EXPRESSWAY)
31ST STREET TO 71ST STREET
NB EXPRESS LANE RECONSTRUCTION

PAVEMENT MARKING SCHEDULE

SCALE: NONE DATE: 7/7/05

DRAWN BY: ATD CHECKED BY: TAI

SHEET				EPOXY PAVEMENT
NUMBER	LINE DESCRIPTION	STATION	TO STATION	MARKING - LINE 12" (FOOT)
PMK-1				
	SOLID (W) @ GORE Solid (W)	2368+62 2367+00	2375+80 2382+00	540 <b>.</b> 50
PMK-2	JOLID (W)	2301100	2302100	17,30
	SOLID (W) © GORE SOLID (W) © GORE	2381+24	2391+59 4391+37	325.50 237.25
	SOLID (W) @ GORE	4384+25 2408+02	2411+32	92.25
	SOLID (W)	2382+00	2412+00	221.00
PMK-3	SOLID (W) @ GORE	4414+25	4417+50	110,50
	SOLID (W) @ GORE	4432+84	4434+62	108.25
	SOLID (W) @ GORE	4437+52	4440+48	305.00
PMK-4	SOLID (W)	2412+00	2442+00	151.00
	SOLID (W) @ GORE	4457+00	4461+99	272.75
PMK-5	SOLID (W) @ SHOULDER	2442+00	2472+00	198.50
I WIK 3	SOLID (W) @ GORE	4487+49	4491+10	136.25
	SOLID (W) @ SHOULDER	2472+00	2502+00	224.00
PMK-6	I2" GORE TAPE	2502+09	25 5+23	701.25
	SOLID (W) @ GORE	4507+28	4514+06	336.75
	SOLID (W) @ GORE	4516+33	4524+56	553.50
D. W. 7	SOLID (W)	2502+00	2530+00	197.25
PMK-7	EXPRESS B			
	SOLID (W) @ GORE	2543+78.00	2553+02.00	400
	LOCAL B SOLID (W) @ GORE	4530 183 00	4542+57,00	333
	SOLID (W) @ GORE	4536+87.00 4546+55.00	4550+69.00	55
PMK-8	LOCAL B			
	SOLID (W) @ GORE	4564+00.00	4565+81.90	15
	SOLID (W) @ GORE	4570+97.20	4573+88.30	27
PMK-9				
	LOCAL B			
	SOLID (W) @ GORE SOLID (W) @ GORE	4584+34.30 4601+00.00	4586+40.00 4602+05.00	22
PMK-10	LOCAL B			
	LOCAL 원 SOLID (W) @ GORE	4602+05.00	4605+29.30	27
	SOLID (W) @ GORE	4616+86.00	4620+70.00	36
	SOLID (W) @ GORE	4624+40.60	4626+05,00	18
PMK-12				
	SOLID (W) @ GORE SOLID (W)	2502+09 5997+48	2515+23 6006+31	107.25 18.50
		3331170		
			TOTAL	5,824

T WIRC D				
	SOLID (W)	4414+25	4417+50	325
	SOLID (W)	4414+25	4417+50	325
	SOLID (W)	4432+84	4434+62	178
	SOLID (W)	4432+84	4434+62	178
	SOLID (W)	4437+52	4440+61	309
	SOLID (W)	4437+52	4440+61	296
PMK-4	***************************************			
	SOLID (W)	4457+00	4461+99	499
	SOLID (W)	4457+00	4461+99	499
PMK-5				
	12'S - 3'D (W)	2482+11	2487+00	489
	12'S - 3'D (W)	2487+00	2502+00	1500
	SOLID (W)	4487+49	4491+10	361
	SOLID (W)	4487+49	4491+10	361
PMK-6				
	12'S - 3'D (W)	2502+00	2502+09	9
	SOLID (W)	2502+09	2515+23	1314
	SOLID (W)	2502+09	2515+23	1314
	SOLID (W)	4507+28	4514±06	678
	SOLID (W)	4507+28	4514+06	678
	SOLID (W)	4516+33	4524+56	823
	SOLID (W)	4516+33	4524+56	823
	12'S - 3'D (W)	4527+14	4529+76	262
				EPOXY PAVEMEN
SHEET				MARKING - LETTERS
NUMBER	LINE DESCRIPTION	STATION	TO STATION	AND SYMBOLS
				(SQ FT
PMK-5	10.5 Managara at 1.55 / West			
I WILL S	LEFT TURN ONLY	2472+00	2487+00	36.
	LEFT TURN ONLY	2487+00	2502+00	36
	LEFT TURN ONLY	2487+00	2502+00	36
	LEFT TURN ONLY	2487+00	2502+00	36
PMK-6	ELI I IBINA ONE I	2101100	2302100	30
1 11111	LEFT TURN ONLY	2502+00	2517+00	36
	LEFT TURN ONLY	2517+00	2530+00	36
	EET FORM ONE	2311.00	2330.00	30.
PMK-7	Į.	1		
	LEFT TURN ONLY	4534+00.00		36
DIAK 10	LEFT TURN ONLY	4534+00.00		30
PMK-10				
PMK-10	LEFT TURN ONLY	4534+00.00 4622+00.00		36

4626+80.00

TOTAL

327

EPOXY PAVEMENT

(F00T)

598

718

76 76

959 962 712

712

330

330

MARKING - LINE 8"

SHEET

PMK-1

PMK-2

PMK-3

NUMBER LINE DESCRIPTION

SOLID (W)

LEFT TURN ONLY

STATION

2368+62

2368+62

2381+24

2381+24

2382+00

4381+76

4384+25

4384+25

2408+02

2408+02

TO STATION

2374+60

2375+80

2382+00

2382+00

2391+59

4391+38

4391+37

4391+37

2411+32

2411+32

CUEET				EPOXY
SHEET NUMBER	LINE DESCRIPTION	STATION	TO STATION	PAVEMENT MARKING - LINE 8"
NUMBER	EINE DESCRIPTION	STATION	TO STATION	(FOOT)
		**************************************		(1001)
PMK-7				
	EXPRESS B			
	© GORE (TIMES 2)	2543+78.00	2553+02.00	1,848
	LOCAL B			
	@ GORE (TIMES 2)	4536+87.00	4542+57.00	1,140
	SOLID (W)	4533+86.00	4536+87.00	301
	SOLID (W)	4542+90.00	4543+53.00	63
	SOLID (W)	4546+55,00	4550+69.00	414
	12'S - 3'D (W)	4529+80.00	4533+86.00	81
PMK-8				
	LOCAL BL			
	SOLID (W)	4564+00.00	4565+81.90	249
	SOLID (W)	4570+97.20	4573+88.30	319
PMK-9				
I IWIT 3	LOCAL B			
	SOLID (W)	4584+34.30	4586+40.00	206
		4601+00.00	4602+05.00	105
		-		
PMK~10	Looks th			
	LOCAL B	4600105.00	4005 100 70	404
	@ GORE @ GORE	4602+05.00 4616+86.00	4605+29.30 4620+70.00	404
	@ GORE	4624+40.60	4626+05.00	183
	12'S - 3'D (W)	4621+60.00	4626+05.00	89
PMK-11				
	LOCAL BE			
	@ GORE	4626+05.00	4626+90.70	86
	12'S - 3'D (W)	4626+05.00	4629+80.00	75
PMK-12				
	SOLID (W)	6001+20	6004+70	350
	SOLID (W)	6001+20	6004+70	350
	***************************************		TOTAL	04 74 4
			I O A A L	21,714

F.A.I. RTE.	SECTION	ı	COUNT	Υ	TOTAL SHEETS	SHEE'
94/90	*		COOK	,	556	28
STA.		TO	STA.			
FED. ROA	ND DIST. NO.	ILLINOIS	FED.	AID	PROJECT	
6230	0C • (18	18, ETC	, 232	4.6-1	P)R-8	

REVISIONS	ζ,	THINOIS DEPARTMENT OF TRANSPORTATION
NAME	DATE	ILLINOIS DEPARTMENT OF TRANSFORTATION
		F.A.I. 94/90 (DAN RYAN EXPRESSWAY
		31ST STREET TO 71ST STREET
		NB EXPRESS LANE RECONSTRUCTION
		DAVENENT MARKING

PAVEMENT MARKING SCHEDULE

SCALE: NONE DATE: 7/7/05 DRAWN BY: ATD CHECKED BY: TAI

Edivards

AND KEICEY

ONE NORTH FRANKLIN
CHICACO, IL 60606
PHONE: 3122 251-3000
FAX: 3121 251-3015
WEB: WHW.EKCORP.COM

F.A.I. RTE.	SECTION		COUNT		TOTAL SHEETS	SHEET NO,
94/90	•		COOK		556	29
STA.		TO	STA.			
FED ROAD	DEST NO	THITMOTS	EED	AID	PROJECT	

62300 + (1818, ETC, 2324.6-1P)R-8

	SIGN NO	D. ES	2-03 ES	2-04	PS2-01	PS2-02	ES3-03	1S016I094L058.	4 ES4-02	ES4-03	1B016I094L057.8	1B016I094L057.2	ES5-02	ES6-02	ES6-03	ES6-04	1 PS6-0	1 PS6-02	1B016I094L056.7	ES6-06	TS3-01	TS4-01 T	TS4-01
PAY ITEM								0 2442+20			2474+11.88	2501+77.65							4828+57.81		2365+00		
	ROUTE					i										1	1		1020101101		2303100	+	
SIZE (HEIGH	T × LENGHT	7) 2'-	6"×15 2"	-6"X26	′ 4′X4′	4'X4	ВМ	(12'-6"×18")X2	SPAN	4'X4'	12'-6"×30"; 12'-6"	<16' 12'-6"x30'; 12'-6"x16	' SPAN	SPAN	4'×4'	4'×4'	4'×4'	4'×4'	12'-6"×30'; 12'-6"X18	,	12'-6"×18'-0"	,	
SIGN PANEL - TYPE 1	SQ FT 12						_			1											12 0 /120 0		
SIGN PANEL - TYPE 2	SQ FT 96				16	16						***************************************					16	16					
SIGN PANEL - TYPE 3	SQ FT 418	86						463			575	575							681.3				
SIGN PANEL OVERLAY	SQ FT 2															1			•	1			
REMOVE SIGN PANEL - TYPE 2	SQ FT 72									16					16	16							
REMOVE SIGN PANEL - TYPE 3	SQ FT 59	1 37.	5 69	5						:	1												
RELOCATE SIGN PANEL - TYPE 2	SQ FT 12																			1			
RELOCATE SIGN PANEL - TYPE 3	SQ FT 48	8													1	1							
STRUCTURAL STEEL SIGN SUPPORT - BREAKAWAY	POUND 189	90										***************************************			1								
TELESCOPING STEEL SIGN SUPPORT	F00T 88				12	12									1		12	12					
WOOD SIGN SUPPORT	F00T 17																						
OVERHEAD SIGN STRUCTURE - SPAN, TYPE 1-A (4'-0" X 4'-6")	F00T 72				1			72															
OVERHEAD SIGN STRUCTURE - SPAN, TYPE III-A (5'-0" X 7'-0")	F00T 142	2																					
OVERHEAD SIGN STRUCTURE - BRIDGE MOUNTED	F00T 33	2						:			56	56							56				
OVERHEAD SIGN STRUCTURE WALKWAY	F00T 40	3									56	56	1						56				
DRILLED SHAFT CONCRETE FOUNDATIONS	CU YD 179	9					i	17.5															
REMOVE OVERHEAD SIGN STRUCTURE - SPAN	EACH 6								1				1	1									
REMOVE OVERHEAD SIGN STRUCTURE - BRIDGE MOUNT	EACH 7						1													1	1		
REMOVE CONCRETE FOUNDATION - OVERHEAD	EACH 14								2				2	2							1		
OVERHEAD SIGN STRUCTURE WALKWAY, TYPE A	F00T 100	0						44	T							1					1		!
REMOVE OVERHEAD SIGN STRUCTURE - CANTILEVER (VMS)	EACH 1															1							
TEMPORARY INFORMATION SIGNING	SQ FT 62	5														1					225	65 3	37.5

	SIGN NO.	TS3-02	TS3-03	DMS
PAY ITEM	STATION		2362+50	2356+90
	ROUTE			
SIZE (HEIGH	IT × LENGHT)	(6'X7'-6")X3	(6'X5'-6")X2	
SIGN PANEL - TYPE 1	SQ FT			
SIGN PANEL - TYPE 2	SQ FT			
SIGN PANEL - TYPE 3	SQ FT			
SIGN PANEL OVERLAY	SQ FT		!	
REMOVE SIGN PANEL - TYPE 2	SQ FT			
REMOVE SIGN PANEL - TYPE 3	SQ FT			
RELOCATE SIGN PANEL - TYPE 2	SQ FT			
RELOCATE SIGN PANEL - TYPE 3	SQ FT			
STRUCTURAL STEEL SIGN SUPPORT - BREAKAWAY	POUND			
TELESCOPING STEEL SIGN SUPPORT	FOOT			
WOOD SIGN SUPPORT	FOOT			1
OVERHEAD SIGN STRUCTURE - SPAN, TYPE 1-A (4'-0" X 4'-6")	FOOT			
OVERHEAD SIGN STRUCTURE - SPAN, TYPE III-A (5'-0" X 7'-0")	FOOT			
OVERHEAD SIGN STRUCTURE - BRIDGE MOUNTED	FOOT			
OVERHEAD SIGN STRUCTURE WALKWAY	FOOT			
DRILLED SHAFT CONCRETE FOUNDATIONS	CU YD	:		
REMOVE OVERHEAD SIGN STRUCTURE ~ SPAN	EACH			
REMOVE OVERHEAD SIGN STRUCTURE - BRIDGE MOUNT	EACH			
REMOVE CONCRETE FOUNDATION - OVERHEAD	EACH			1
OVERHEAD SIGN STRUCTURE WALKWAY, TYPE A	FOOT		ļ	
REMOVE OVERHEAD SIGN STRUCTURE - CANTILEVER (VMS)	EACH		:	
TEMPORARY INFORMATION SIGNING	SQ FT	135	78	1

NOTE: DYNAMIC MESSAGE SIGN AT STA. 2461+51.44 IS NOT SHOWN IN THIS SCHEDULE.



REVISIONS NAME DATE	ILLINOIS DEPARTME	NT OF TRANSPORTATION
		N RYAN EXPRESSWAY) TO 71ST STREET
		NE RECONSTRUCTION
	S.	IGNING
	SC	HEDULE
	SCALE: NONE	DRAWN BY: TAI
	DATE: 7/7/05	CHECKED BY: GG

	SIGN NO.	1S016I094 L056.60	TS17-01	ES17-01	W12-1	W4-3	TS17-03	1S016I094 L056.43	ES17-02 ES17-03	TS17-02	TS18-01	TS18-02	1S016I094 L055.94	ES18-01	TS18-03	ES19-02	1B016I094 L055.73	ES19-04	PS09-02	1S016I094 L055.41	ES20-0
	STATION	4536+00	4540+00	4540+17	4542+40	4542+90	4544+00	4545+35	4545+43	4545+50	4555+00	4569+50	4571+00	4571+02	4571+00	4582+26	4582+26	4597+12	4598+65	4599+00	4608+15
PAY ITEM	ROUTE	I-94	I-94	I-94	I-94	I-94	I-94	I-94	I-94	I-94	I-94	I-94	I-94	I-94	I-94	I-94	I-94	I-94	1-94	I-94	I-94
	SIZE (HEIGHT×LENGTH)		8′×15′		4'×4'	4'x4'	4′×3′		8'×15' 8'×11' 4'×3'	8'×11'	8'×10'	8′×10′	7′×10′	8'x10' 8'x10' 8'x15'	8′×15′	9'-6''×26' 12'-6''×19'-6''	14'×23' 14'×17'~6'	,	20'-1"x8'-6" DYNAMIC MESSAGE SIGN		4'x3'
	UNIT																				
SIGN PANEL - TYPE 1	SQ FT																				
SIGN PANEL - TYPE 2	SQ FT				16	16								***************************************							
SIGN PANEL - TYPE 3	SQ FT																567				
SIGN PANEL OVERLAY	SQ FT										2										
REMOVE SIGN PANEL - TYPE 2	SQ FT								12												12
REMOVE SIGN PANEL - TYPE 3	SQ FT								208					280							
RELOCATE SIGN PANEL - TYPE 2	SQ FT						12														
RELOCATE SIGN PANEL - TYPE 3	SQ FT		120.0							88	80	80			120						
STRUCTURAL STEEL SIGN SUPPORT-BREAKAWAY	POUND		450.0							450	270	270			450						
TELESCOPING STEEL SIGN SUPPORT	FOOT				12	12															
WOOD SIGN SUPPORT	FOOT						17												***************************************		
OVERHEAD SIGN STRUCTURE - SPAN, TYPE III-A (5'-0" X 7'-0")	FOOT																		69.8		
OVERHEAD SIGN STRUCTURE - BRIDGE MOUNTED	FOOT									/· · ·····							56				
CONCRETE FOUNDATIONS	CU YD		1.4							1.4	1.4	1.4			1.4						
DRILLED SHAFT CONCRETE FOUNDATIONS	CU YD	22.4						19.8					20.4						26.1	34.0	
REMOVE OVERHEAD SIGN STRUCTURE - SPAN	EACH			1					1	***************************************				1							
REMOVE OVERHEAD SIGN STRUCTURE - BRIDGE MOUNTED	EACH															1		1			
REMOVE CONCRETE FOUNDATION - OVERHEAD	EACH			2				l	2					2			1	1		† <del>-</del>	1
OVERHEAD SIGN STRUCTURE WALKWAY	FOOT																56	1	56		
REMOVE OVERHEAD SIGN STRUCTURE - CANTILEVER (VMS)	EACH																	1			1
TEMPORARY INFORMATION SIGNING	SQ FT								1		************							†			1

F.A.I. RTE.	SECTION	COUNTY	TOTAL SHEETS	SHEET NO.
94/90 *		COOK	556	30
STA.	-	TO STA.		
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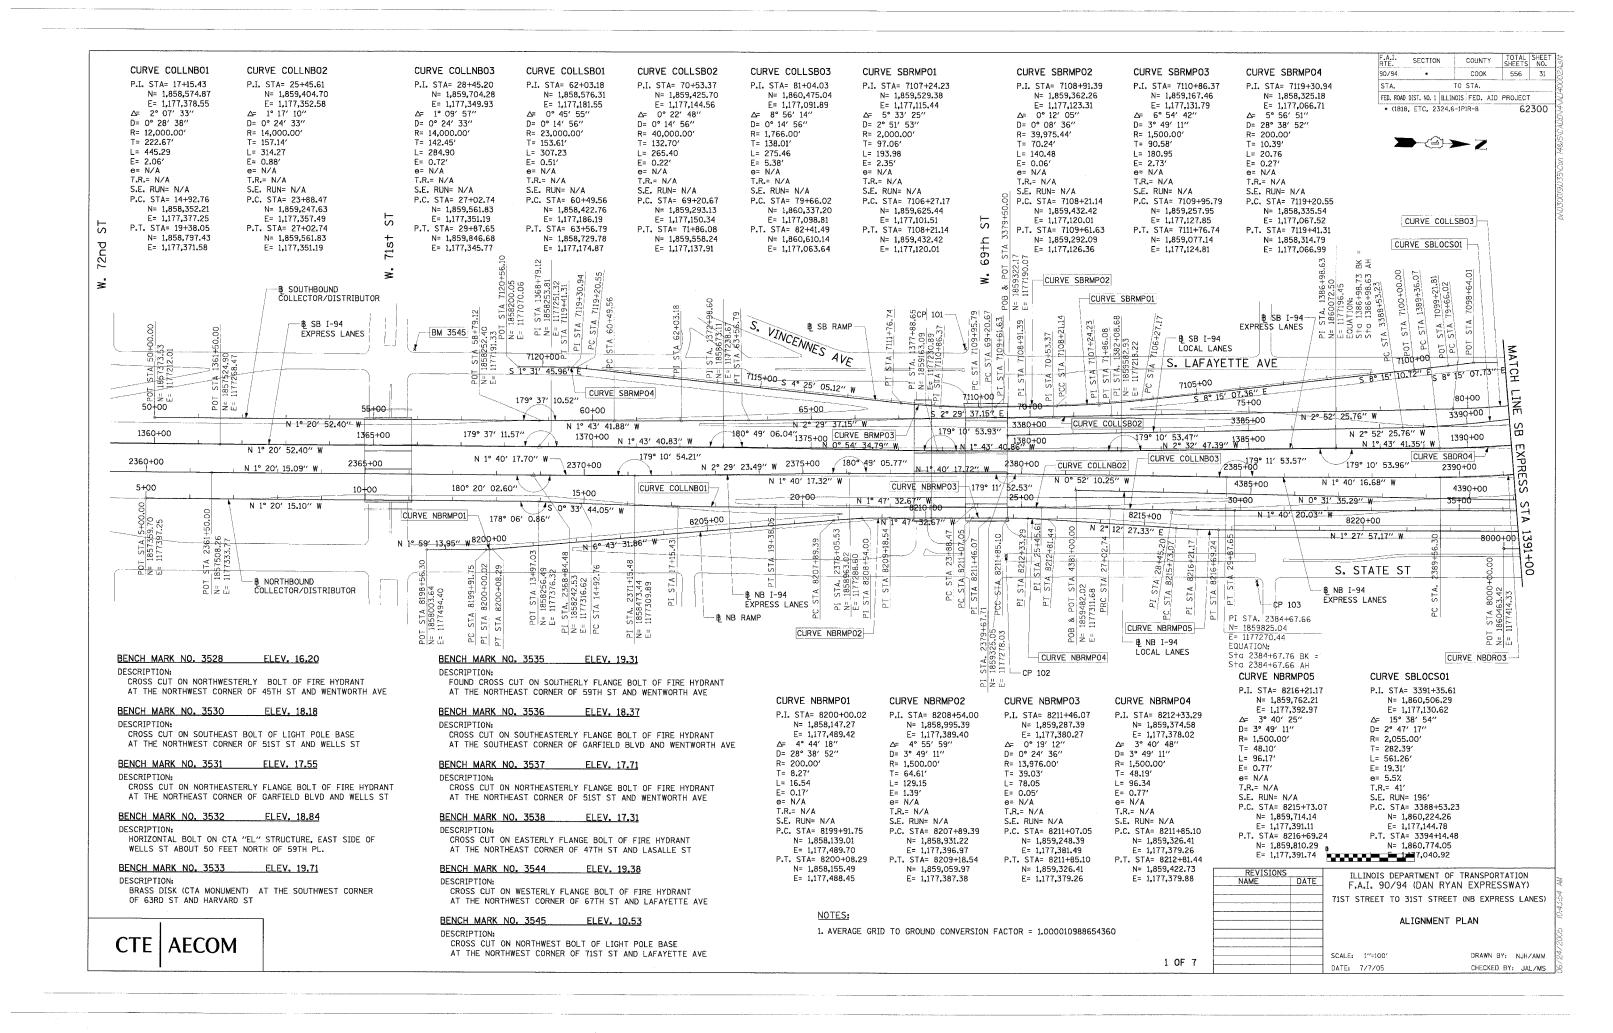
PAY ITEM	SIGN NO.  STATION  ROUTE  SIZE (HEIGHT×LENGTH)	ES20-03 4622+25 I-94 10'-6''x26' 13'x16'	180161094 L054.97 4622+31 I-94 14'x23' 14'x17'-6"	ES21-01 4635+47 I-94 13'x26' 13'x19'-6''	1B016I094 L054.72 4635+47 I-94 14'x23' 14'x17'-6"	VARIOUS I-94 3'x1'	TEMPORARY INFORMATION SIGN 4515+00 I-94 7' X 10'	TEMPORARY INFORMATION SIGN 4519+00 I-94 7' X 10'	3530+\$\$28+55 4.5' X46X 7.5' 4.5' X 6'	TEMPORARY INFORMATION SIGN 4528+50 I-94 6' X 8'-6"
	UNIT									
SIGN PANEL - TYPE 1	SQ FT					12				
SIGN PANEL - TYPE 2	SQ FT									
SIGN PANEL - TYPE 3	SQ FT		567		567		70	70		51
SIGN PANEL OVERLAY	SQ FT									
REMOVE SIGN PANEL - TYPE 2	SQ FT									
REMOVE SIGN PANEL - TYPE 3	SQ FT									
RELOCATE SIGN PANEL - TYPE 2	SQ FT	***************************************								
RELOCATE SIGN PANEL - TYPE 3	SQ FT									
STRUCTURAL STEEL SIGN SUPPORT-BREAKAWAY	POUND									
TELESCOPING STEEL SIGN SUPPORT	FOOT					16				
WOOD SIGN SUPPORT	FOOT									
OVERHEAD SIGN STRUCTURE - SPAN, TYPE III-A (5'-0" X 7'-0")										
OVERHEAD SIGN STRUCTURE - BRIDGE MOUNTED	FOOT		52		56					
CONCRETE FOUNDATIONS	CU YD									
DRILLED SHAFT CONCRETE FOUNDATIONS	CU YD									
REMOVE OVERHEAD SIGN STRUCTURE - SPAN	EACH									
REMOVE OVERHEAD SIGN STRUCTURE - BRIDGE MOUNTED	EACH	1	1	1	1					
REMOVE CONCRETE FOUNDATION - OVERHEAD	EACH									
OVERHEAD SIGN STRUCTURE WALKWAY	FOOT		52		56					
REMOVE OVERHEAD SIGN STRUCTURE - CANTILEVER (VMS)	EACH									
TEMPORARY INFORMATION SIGNING	SQ FT								54 30	


ILLINOIS DEPARTMENT OF TRANSPORTATION F.A.I. 94/90 (DAN RYAN EXPRESSWAY) 31ST STREET TO 71ST STREET NB EXPRESS LANE RECONSTRUCTION


SIGNING SCHEDULE


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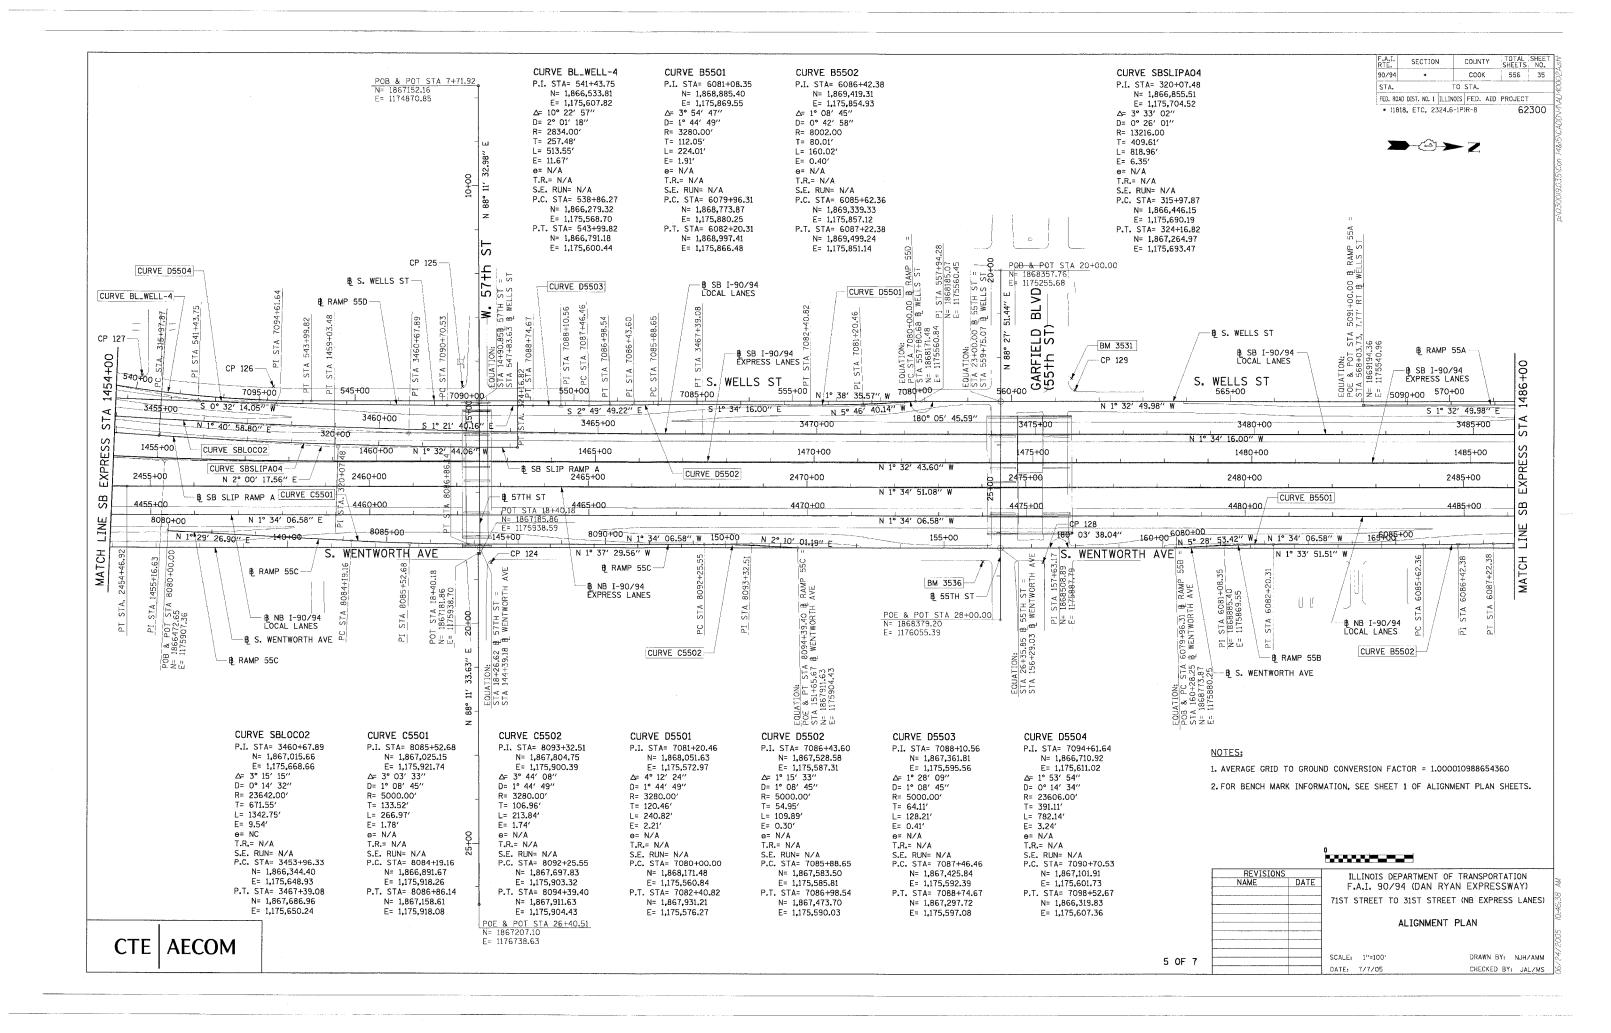
Edivards
ONE NORTH FRANKLIN
OHICAGO, IL 60606
PHONE: (312) 251-3005
WEB: WWW.EKCORP.COM







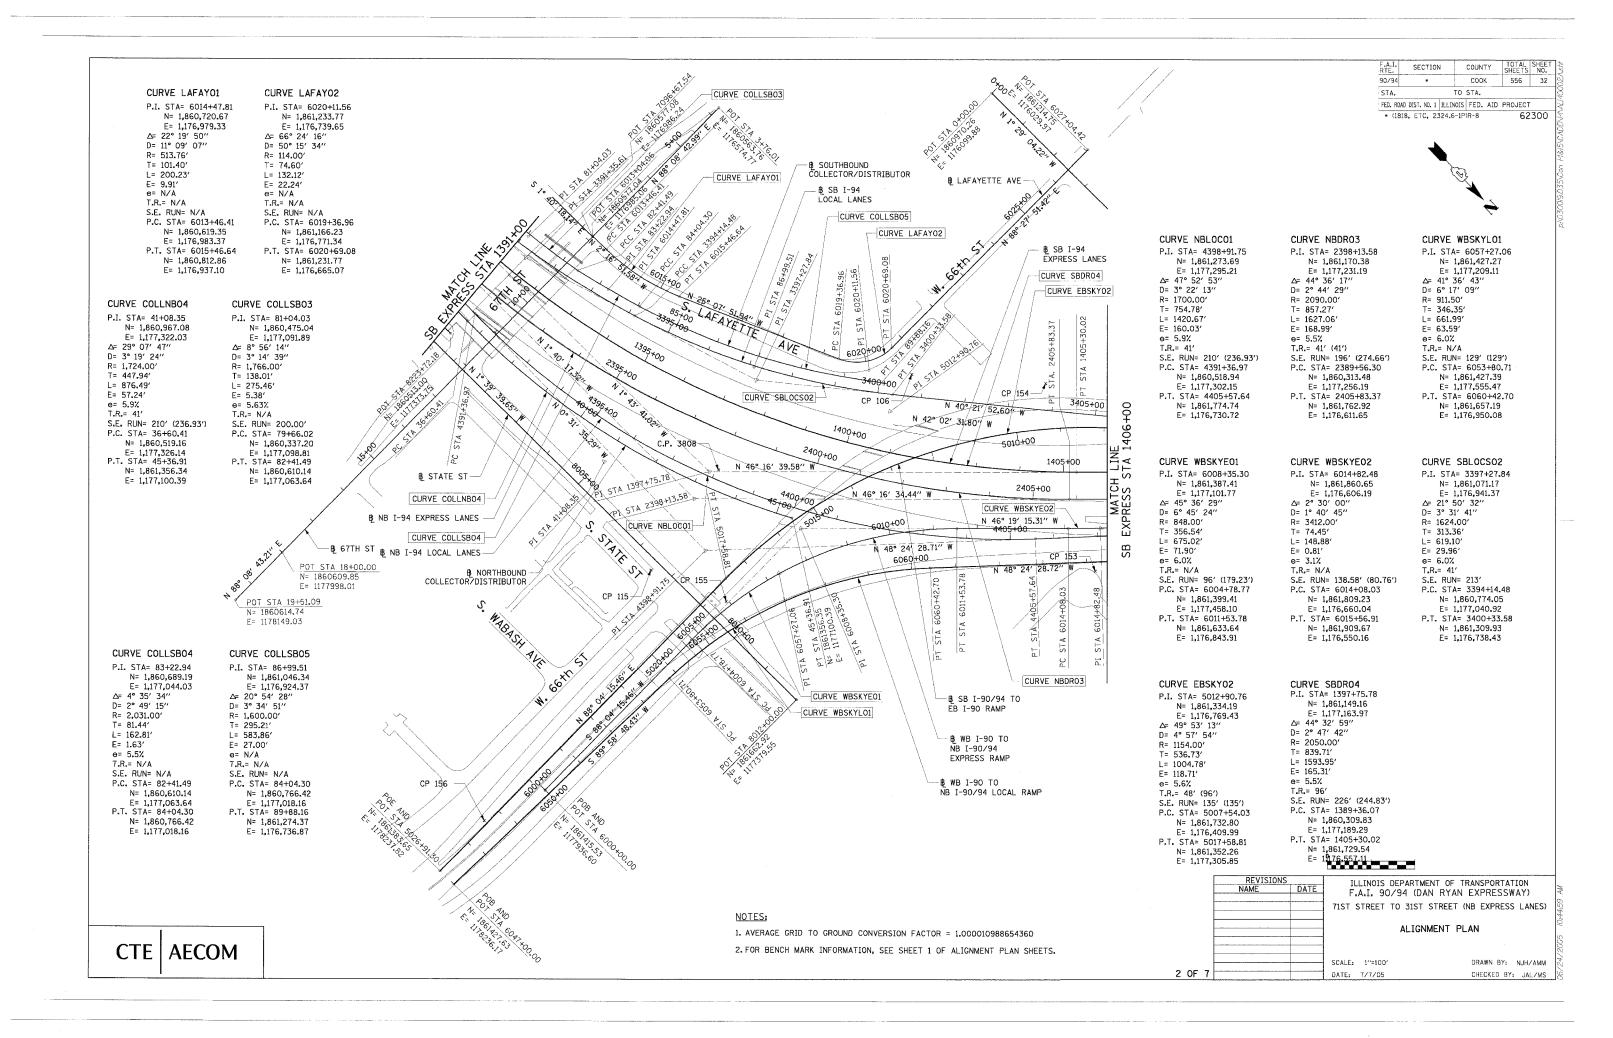


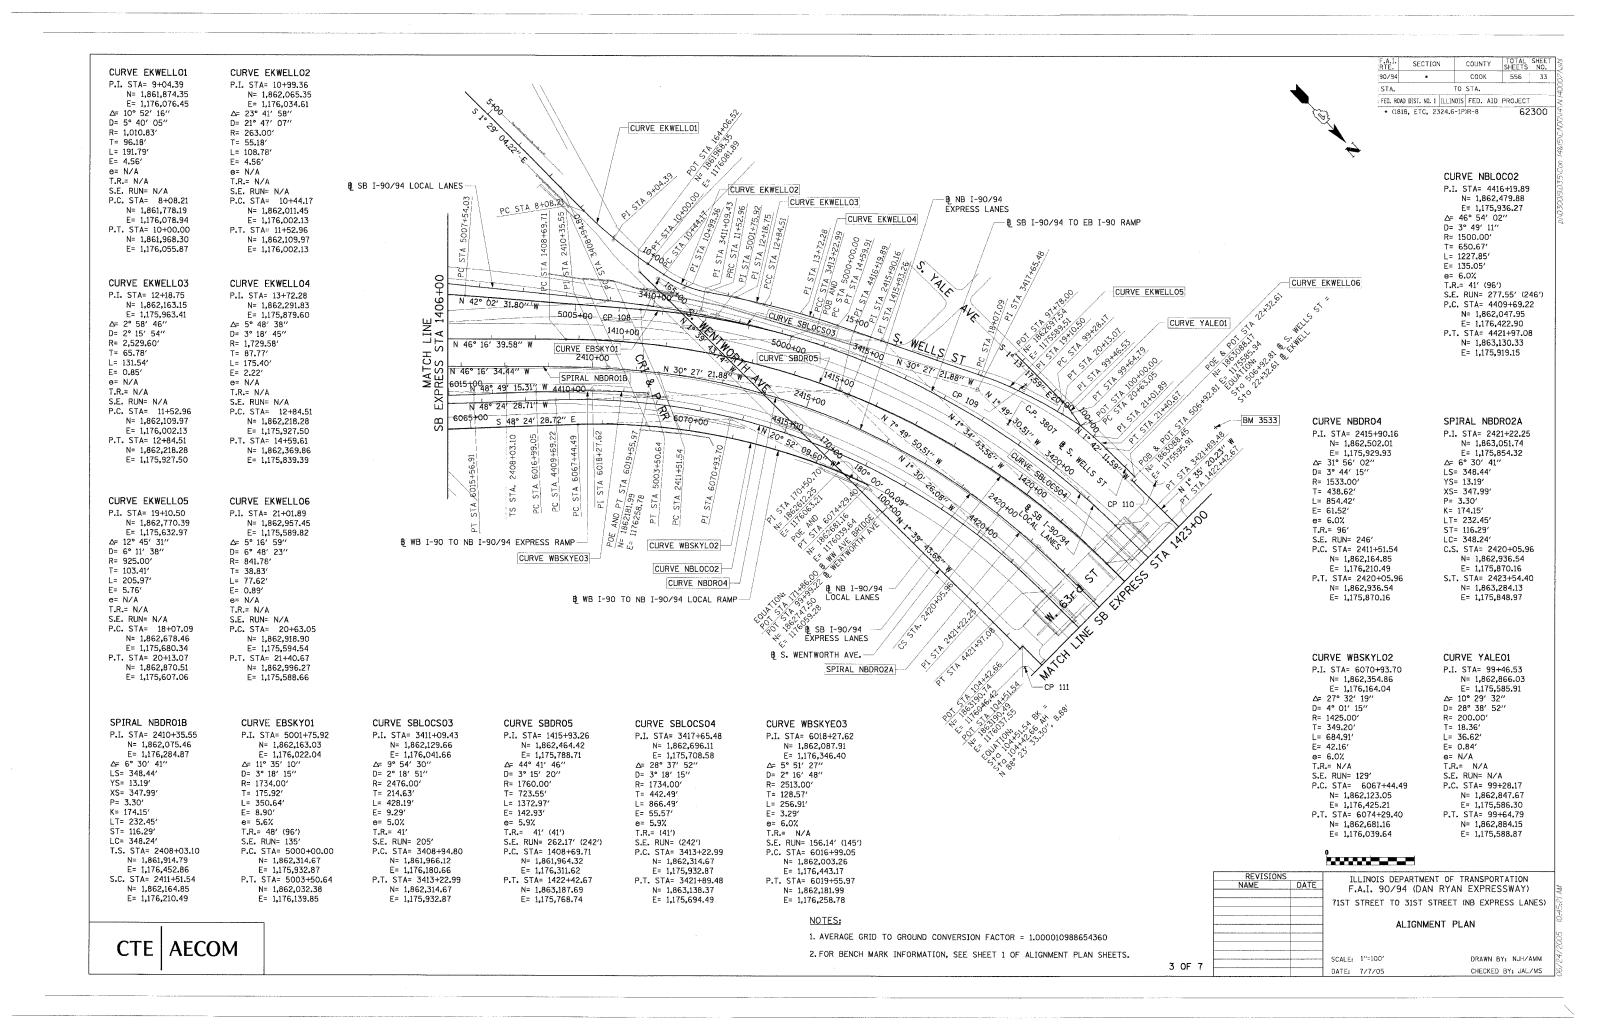


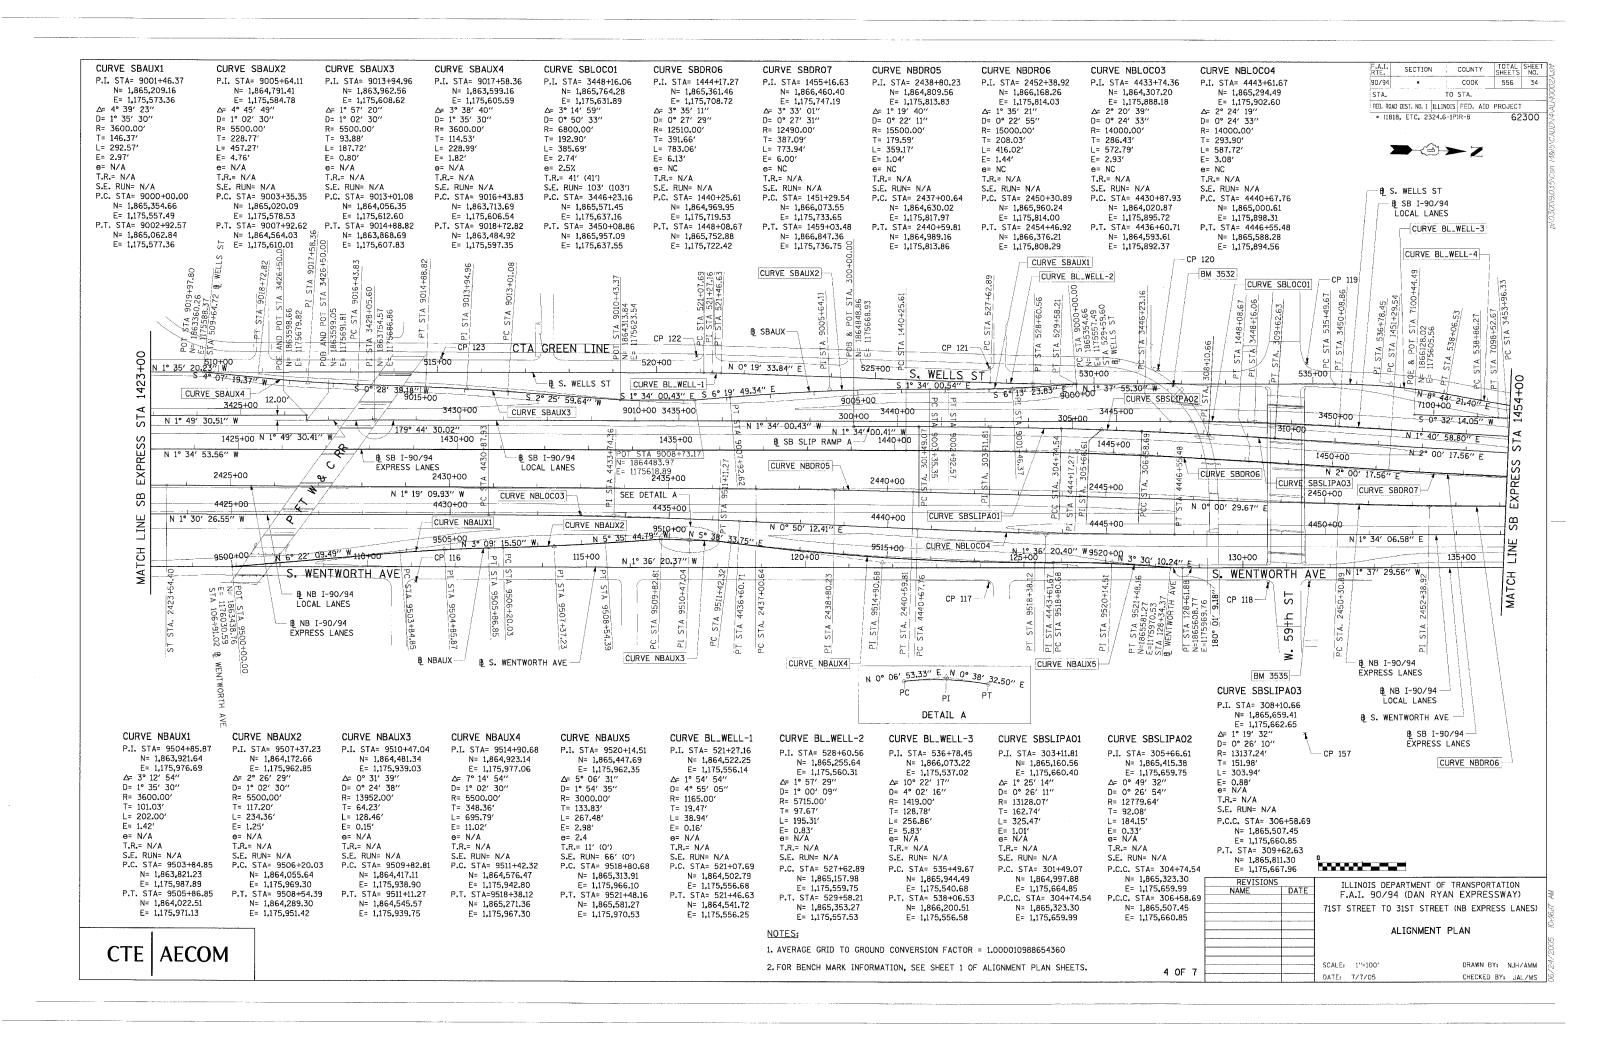


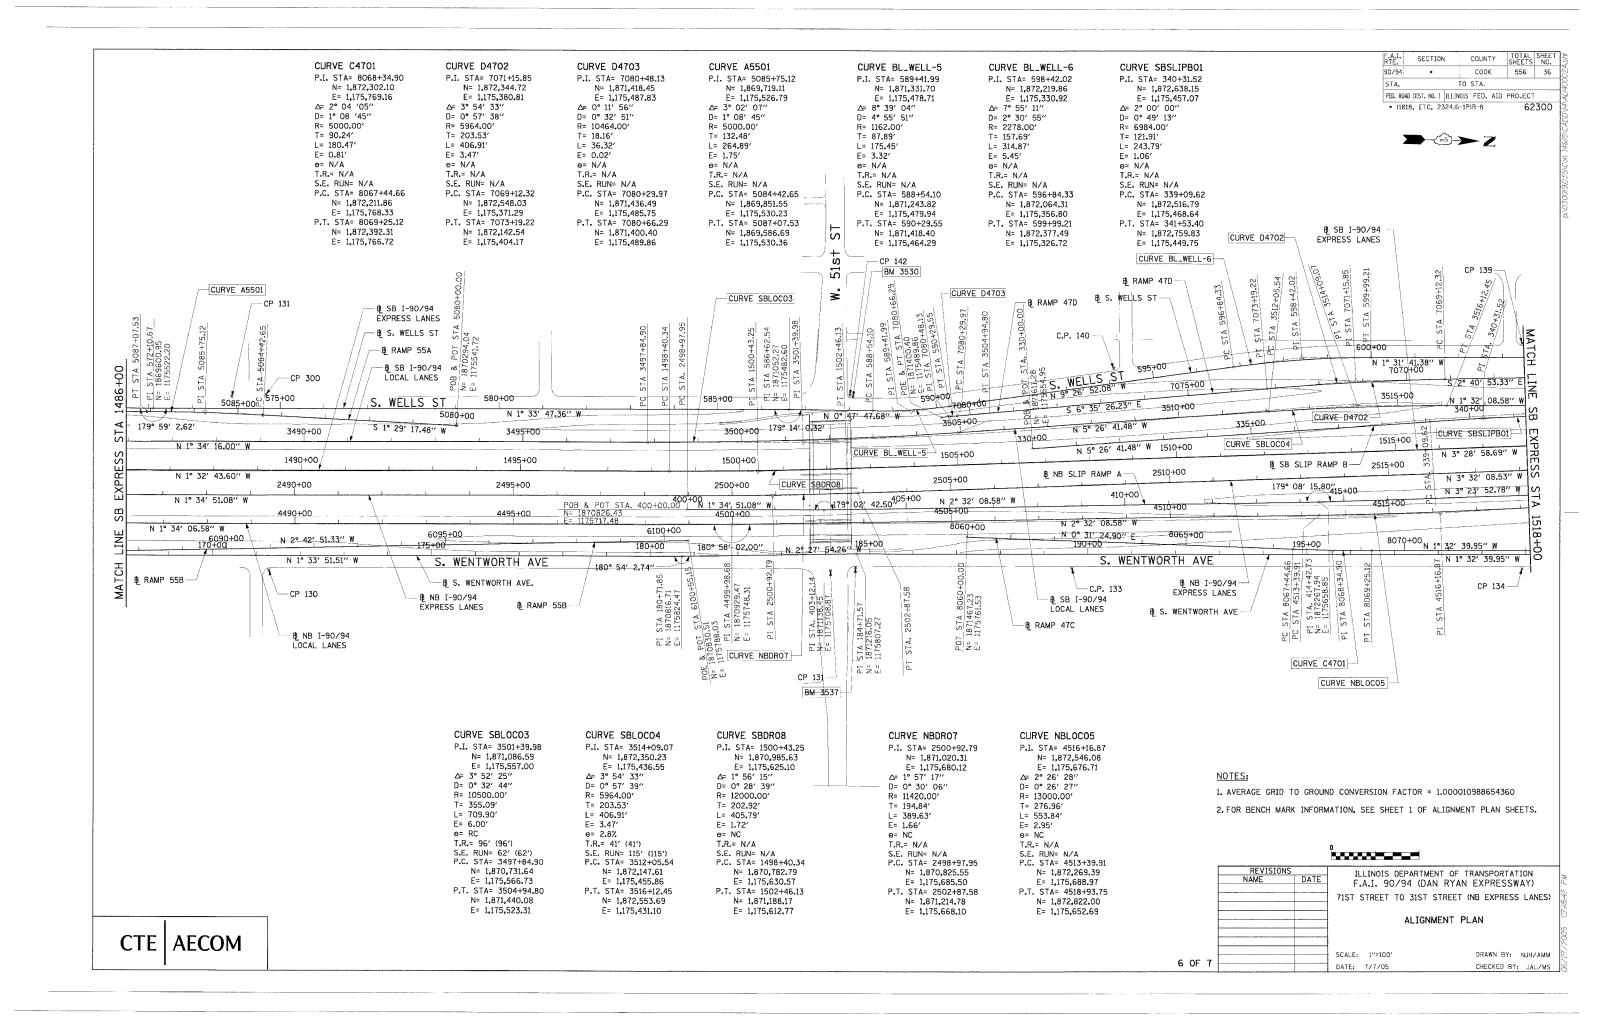


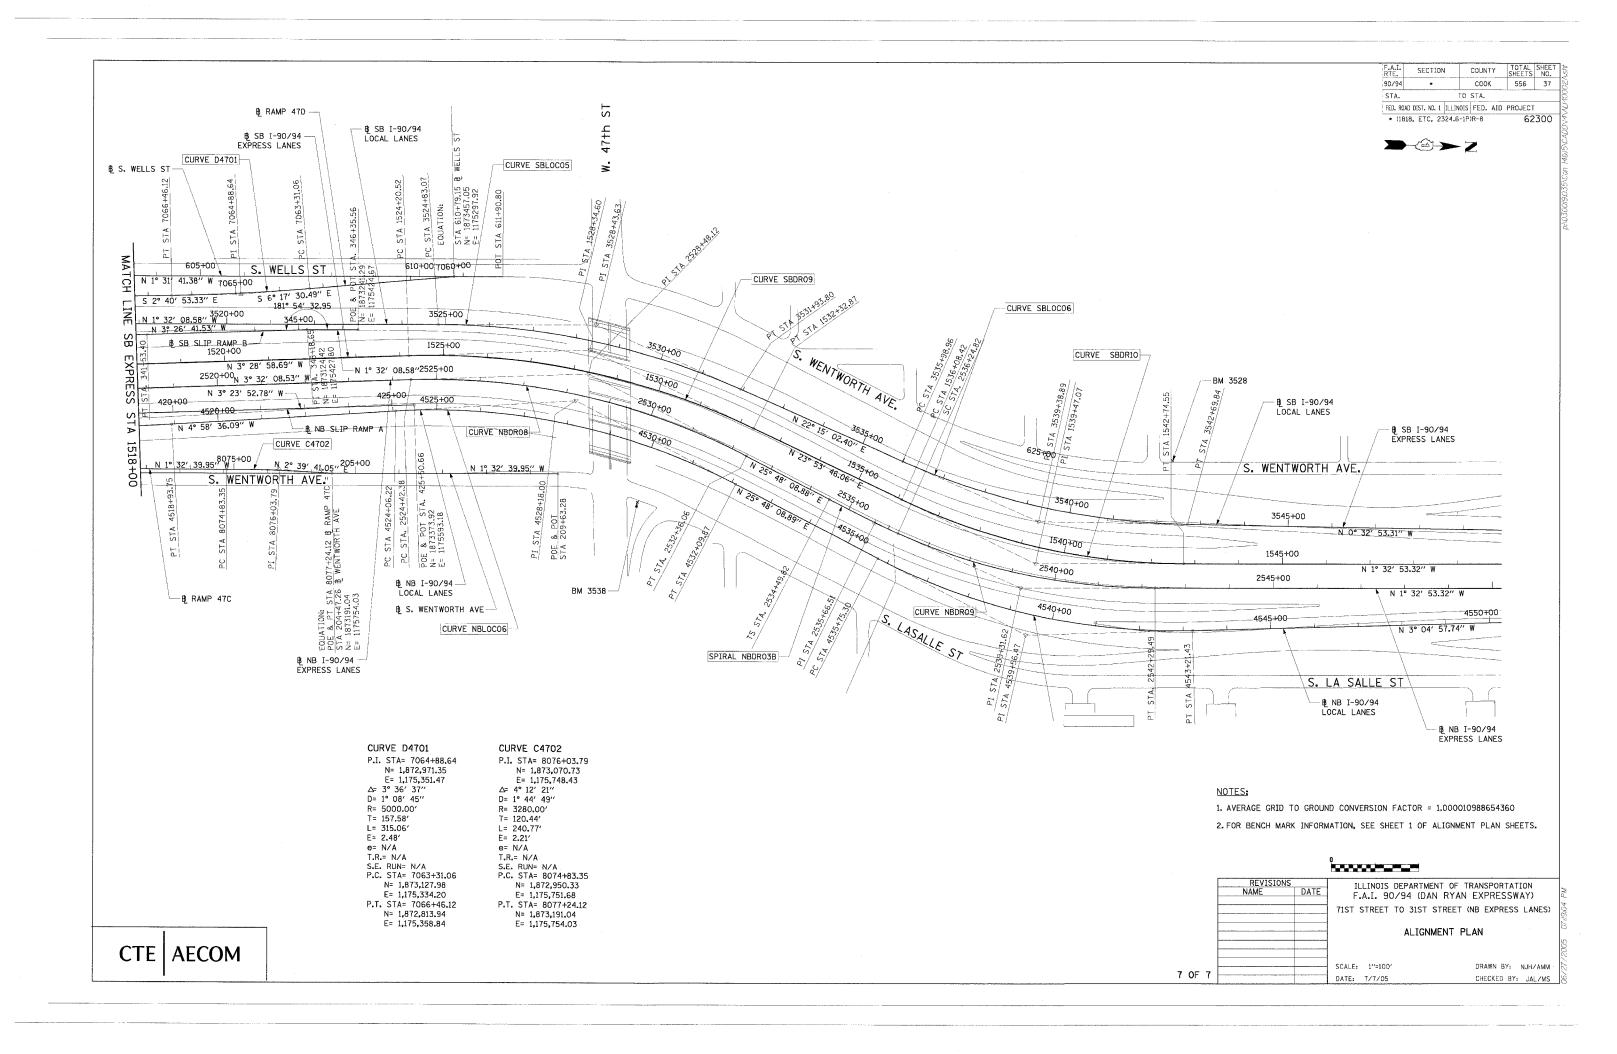

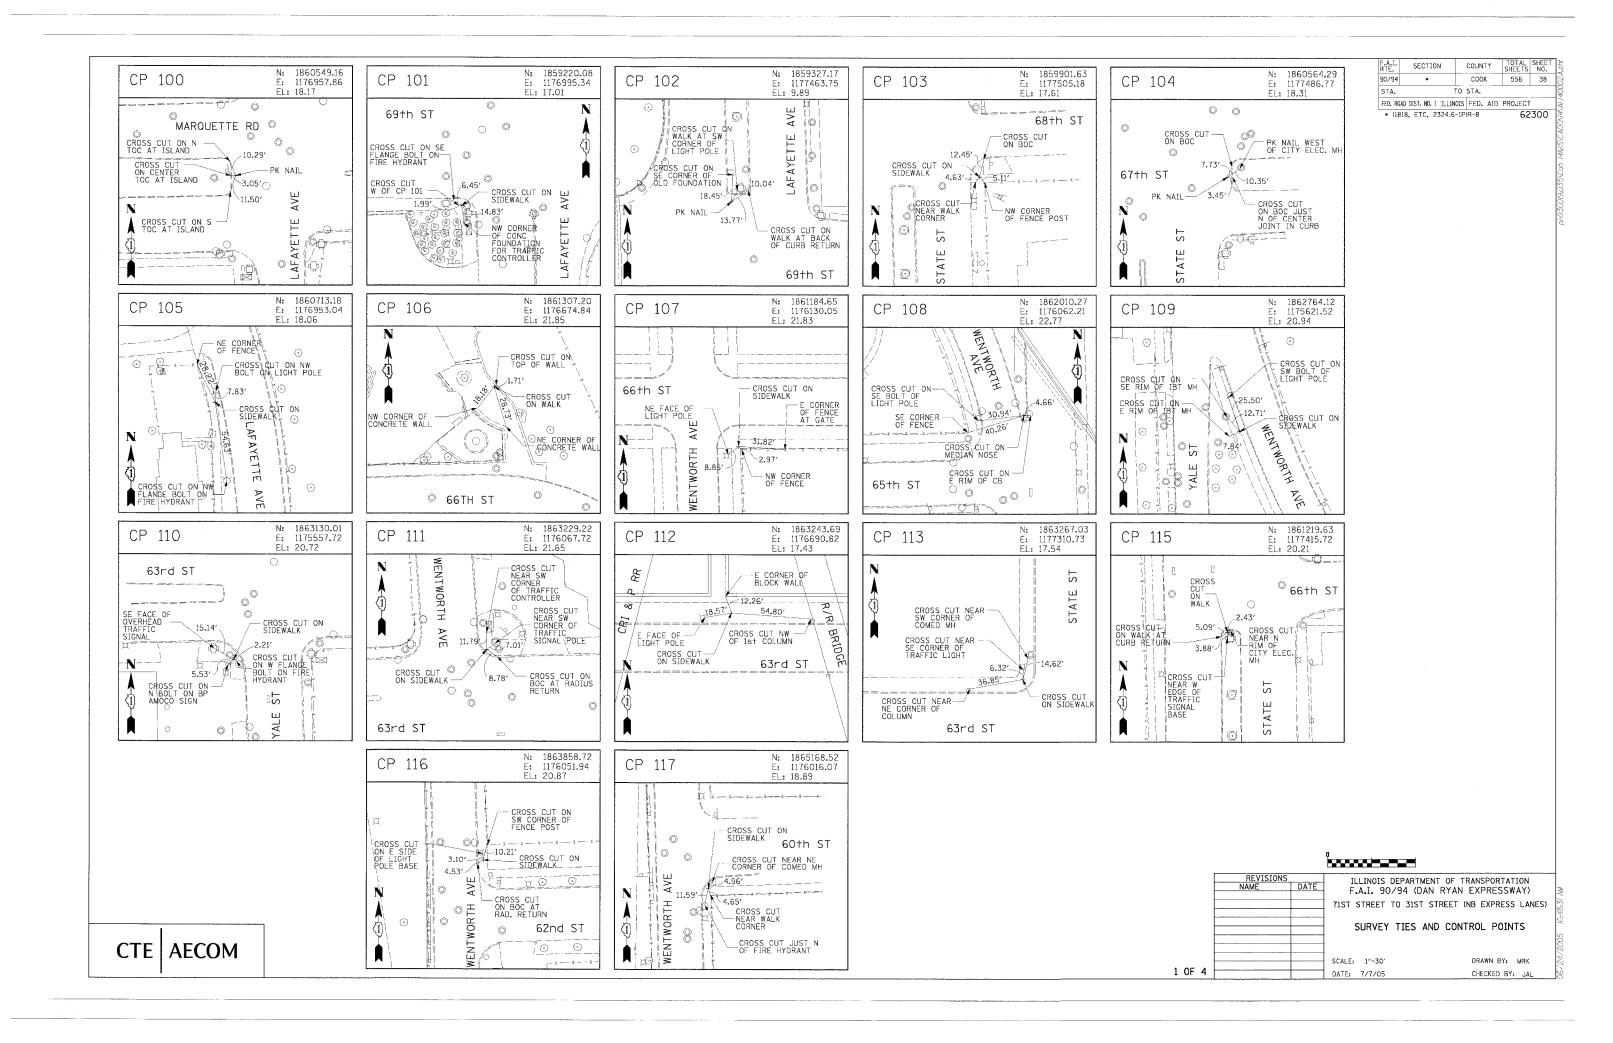

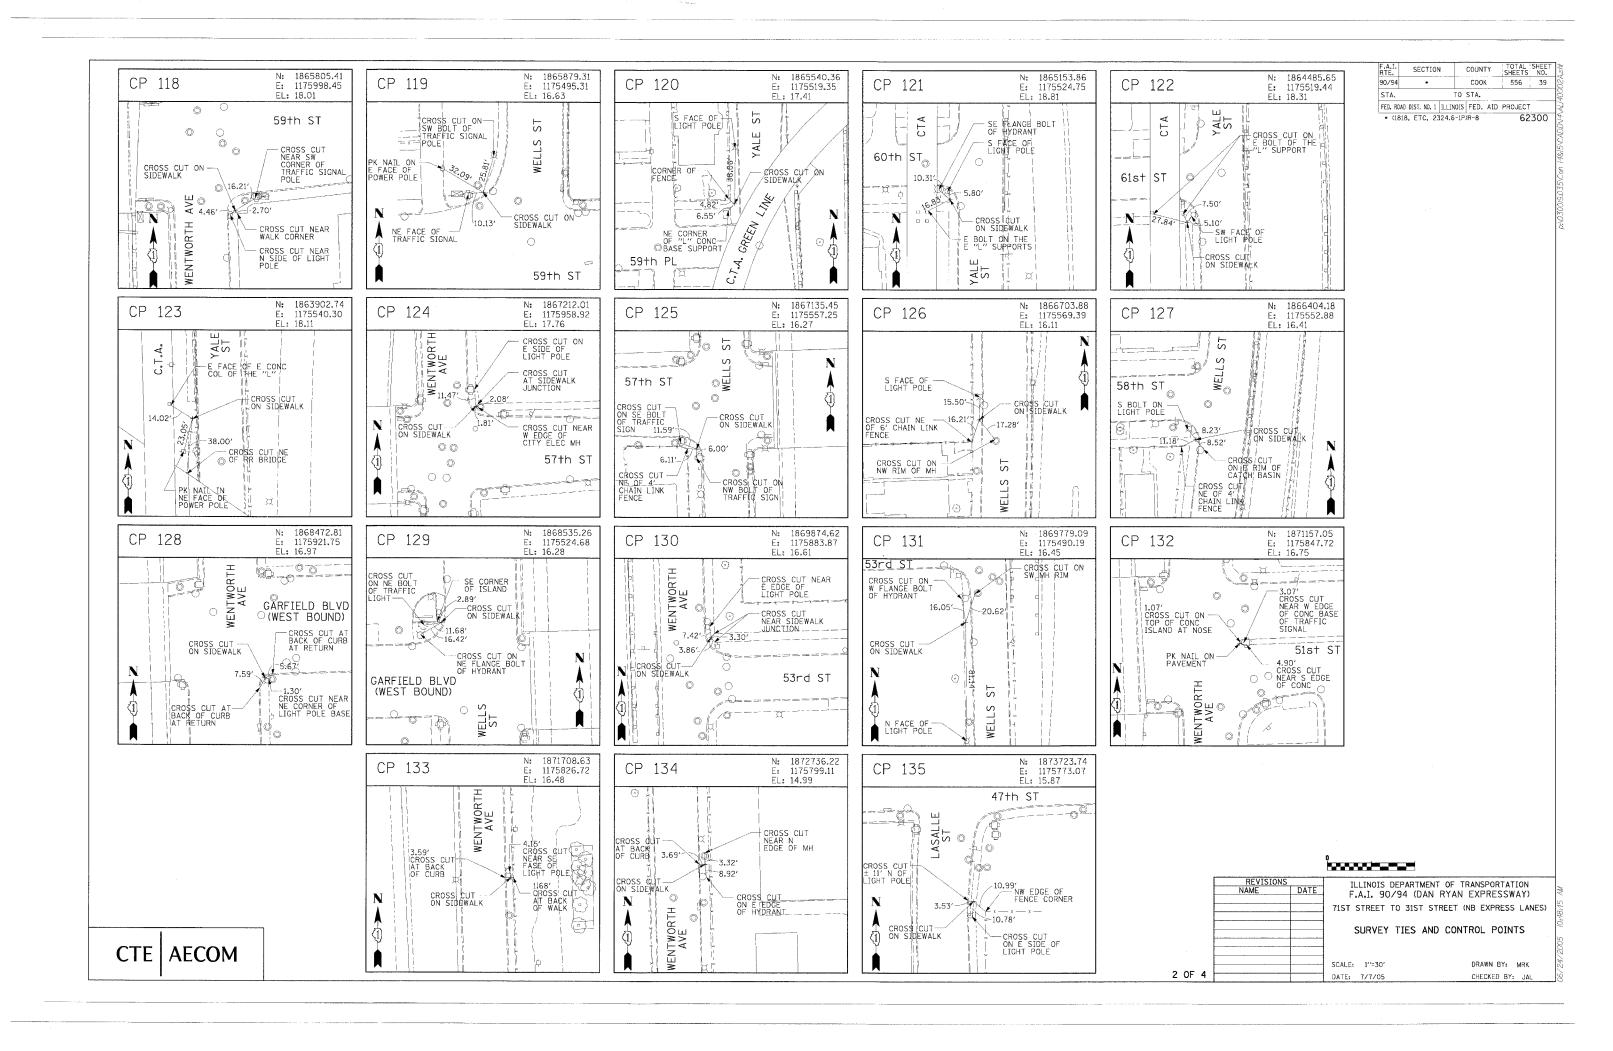

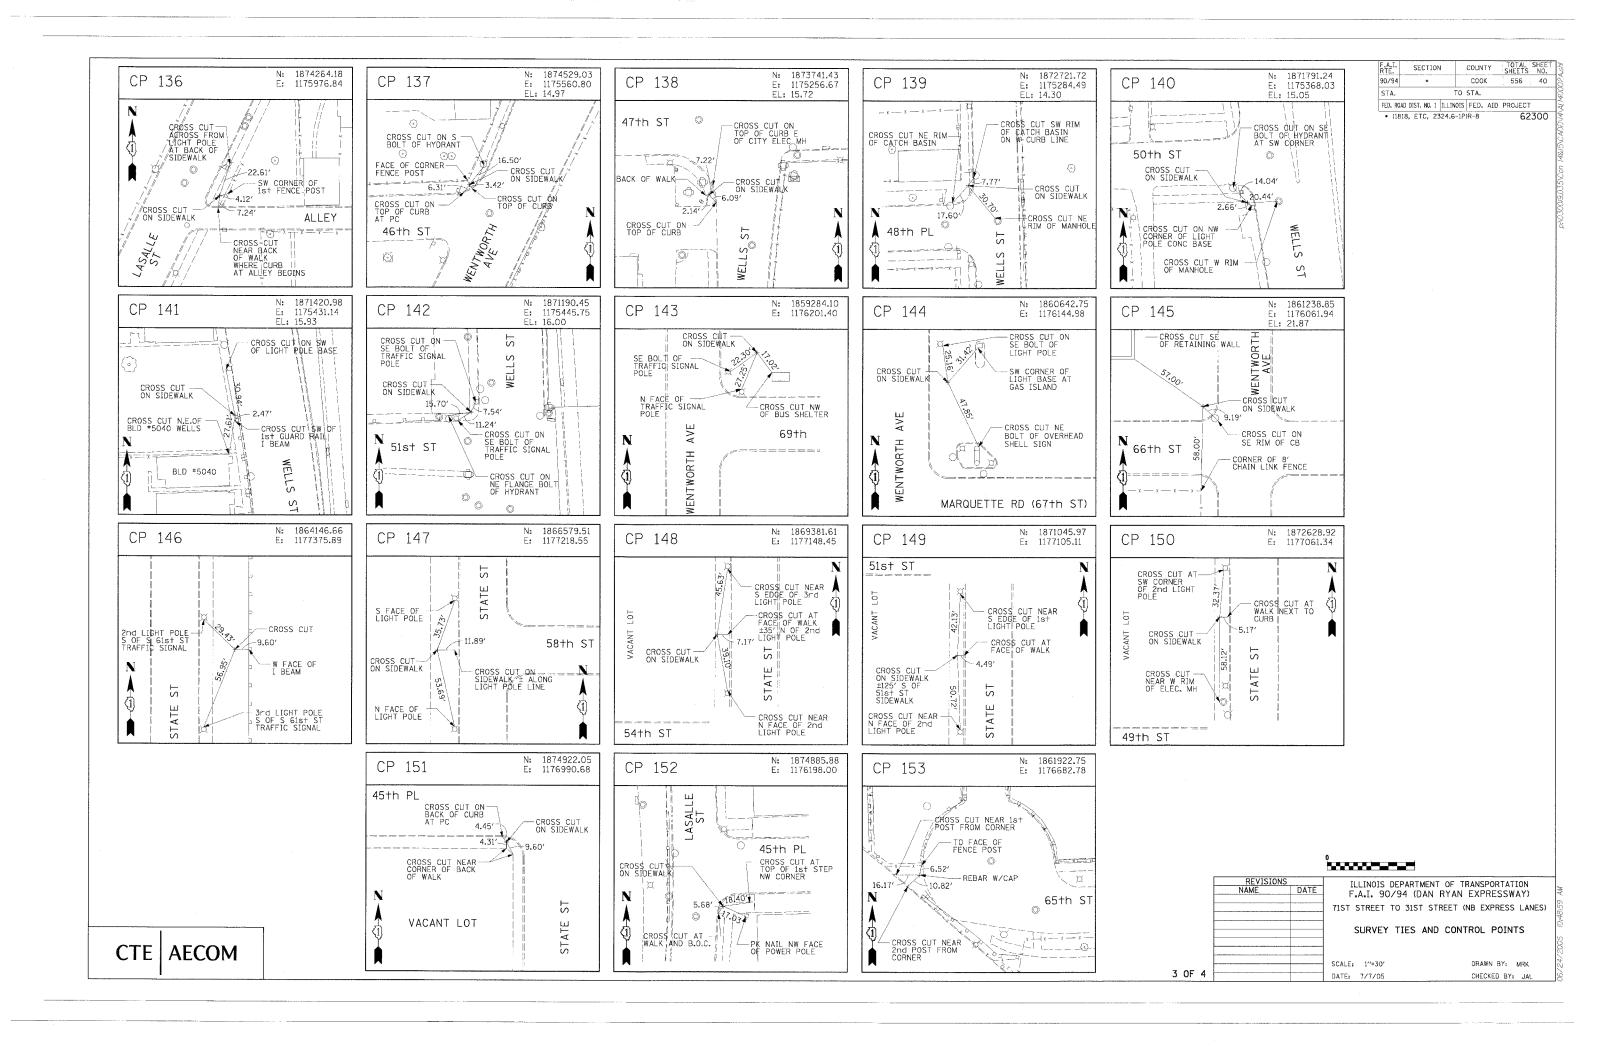

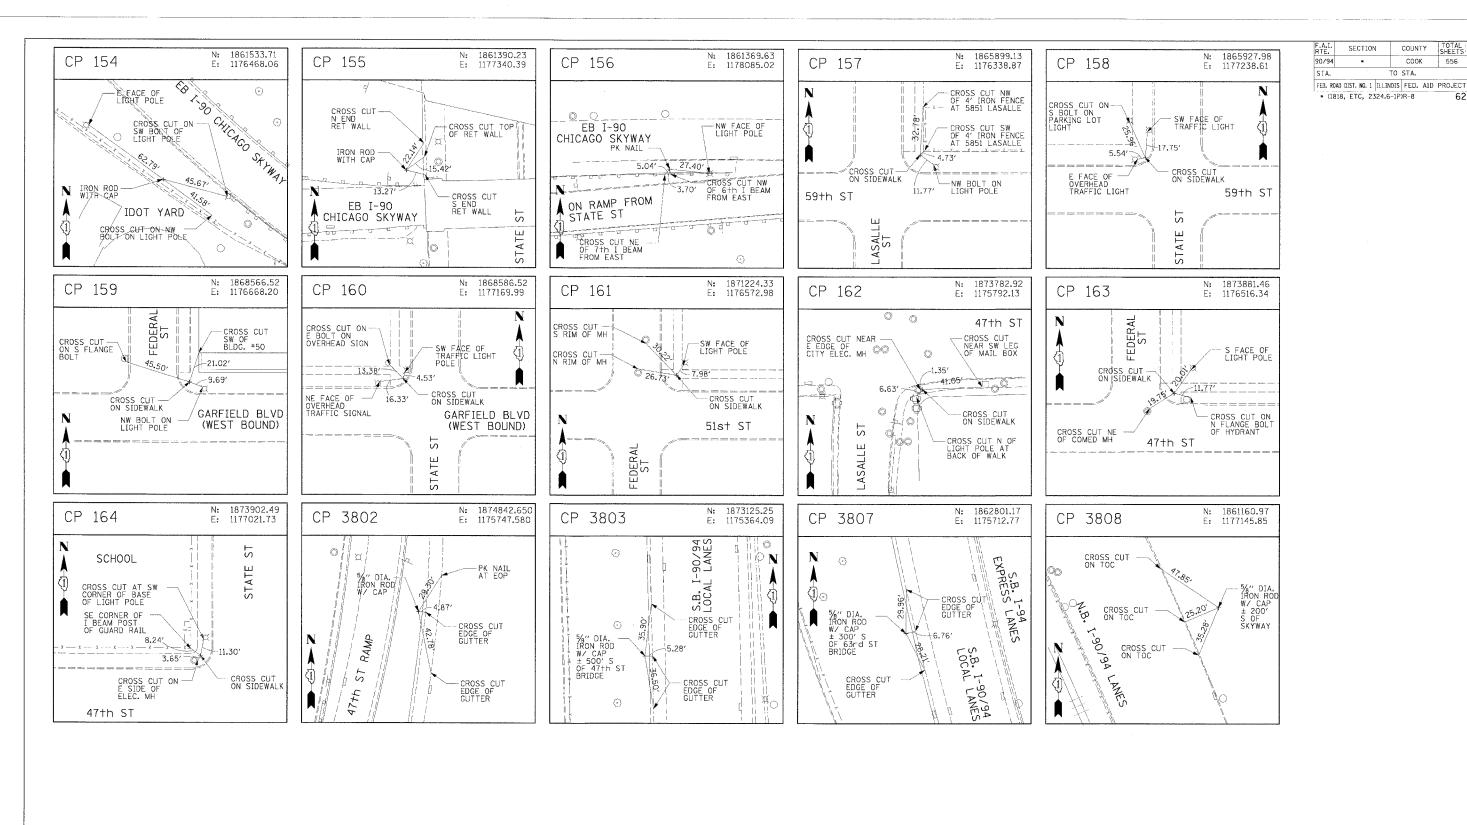

SCALE: 1"=30"

DATE: 7/7/05

ILLINOIS DEPARTMENT OF TRANSPORTATION F.A.I. 90/94 (DAN RYAN EXPRESSWAY) 71ST STREET TO 31ST STREET (NB EXPRESS LANES) SURVEY TIES AND CONTROL POINTS

4 OF 4


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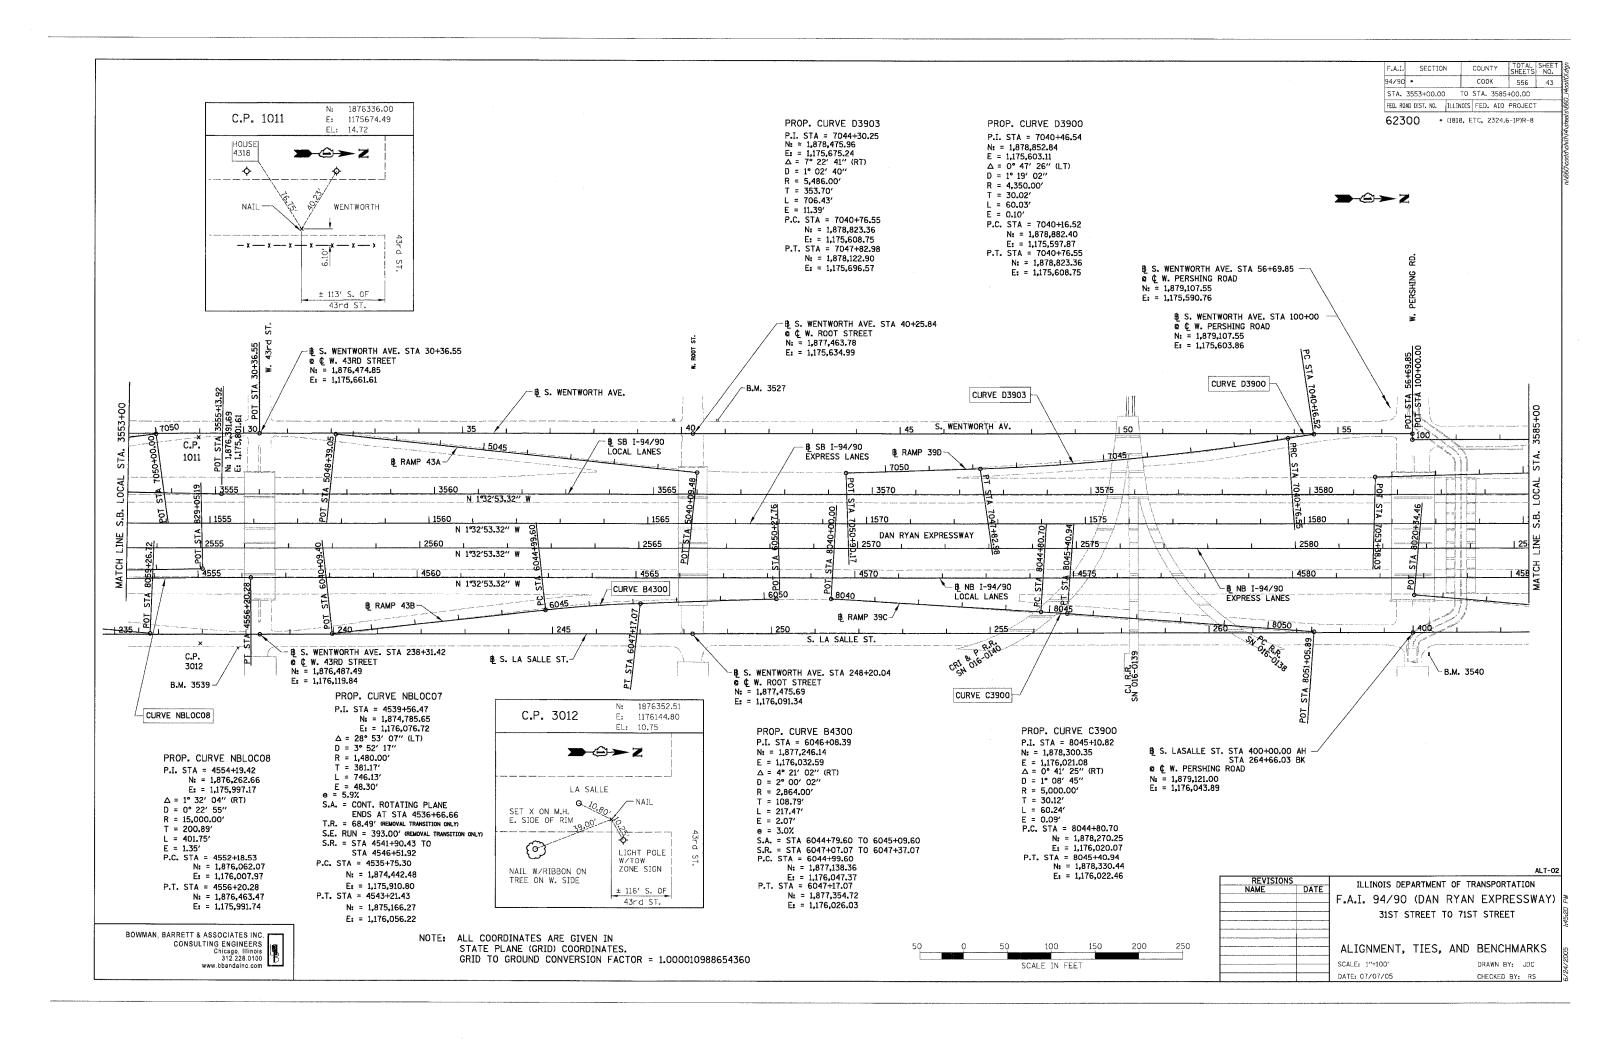
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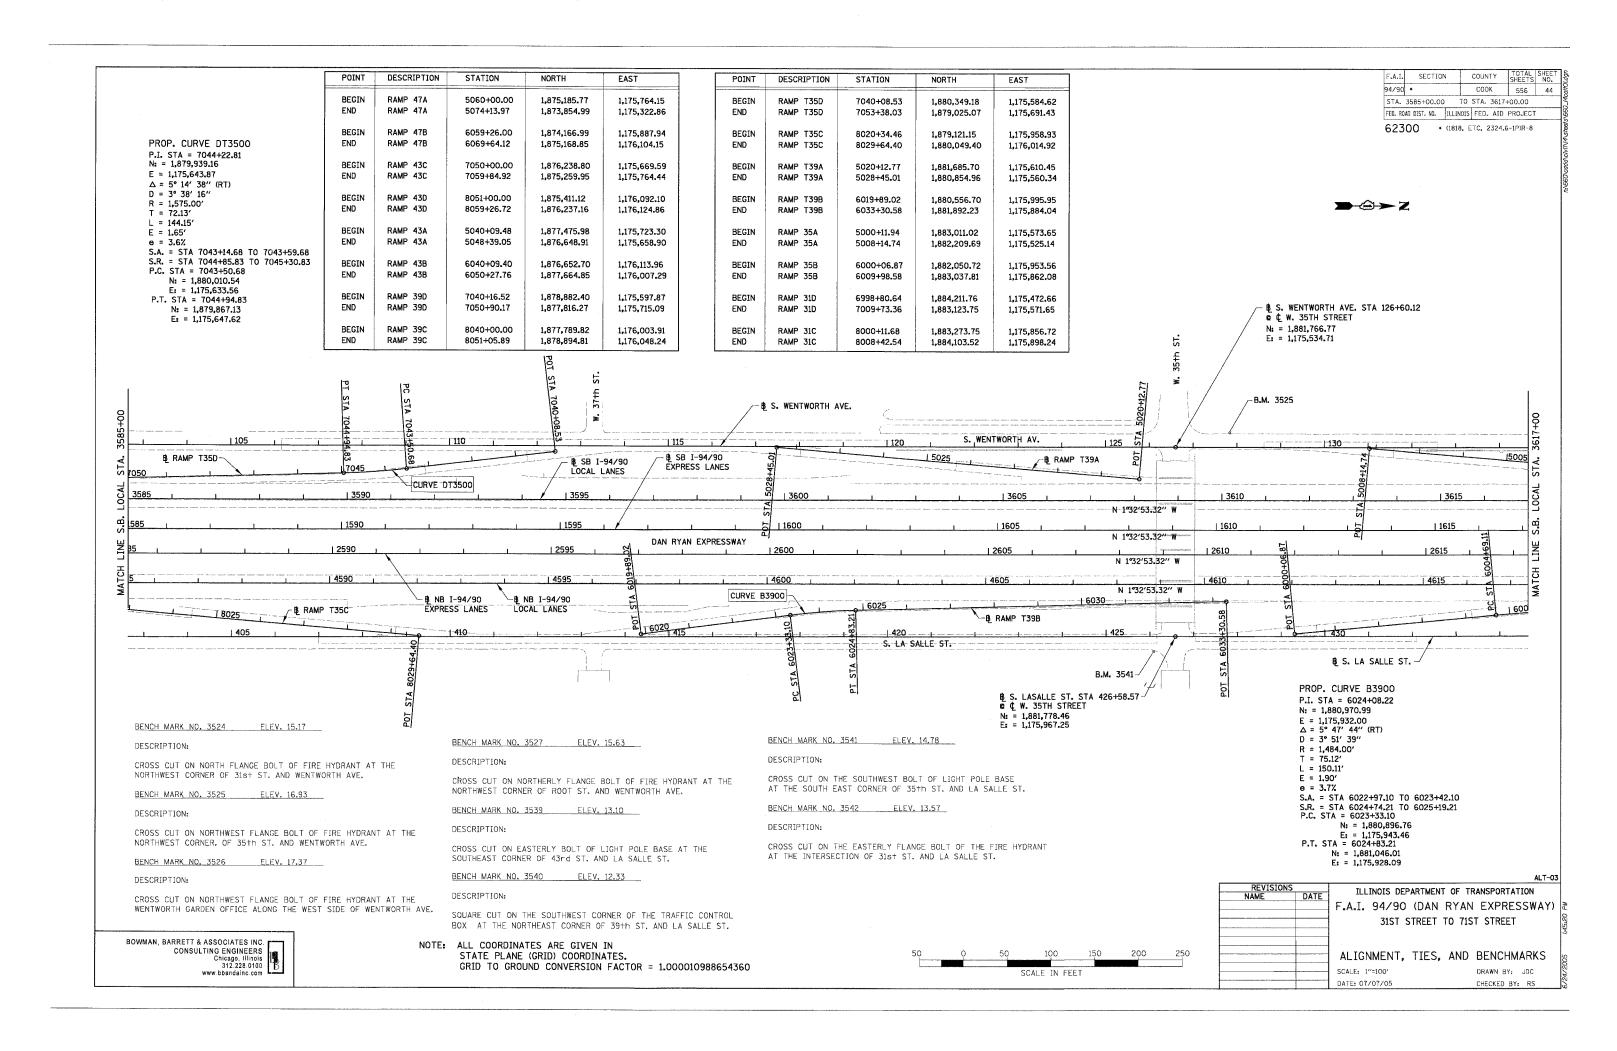
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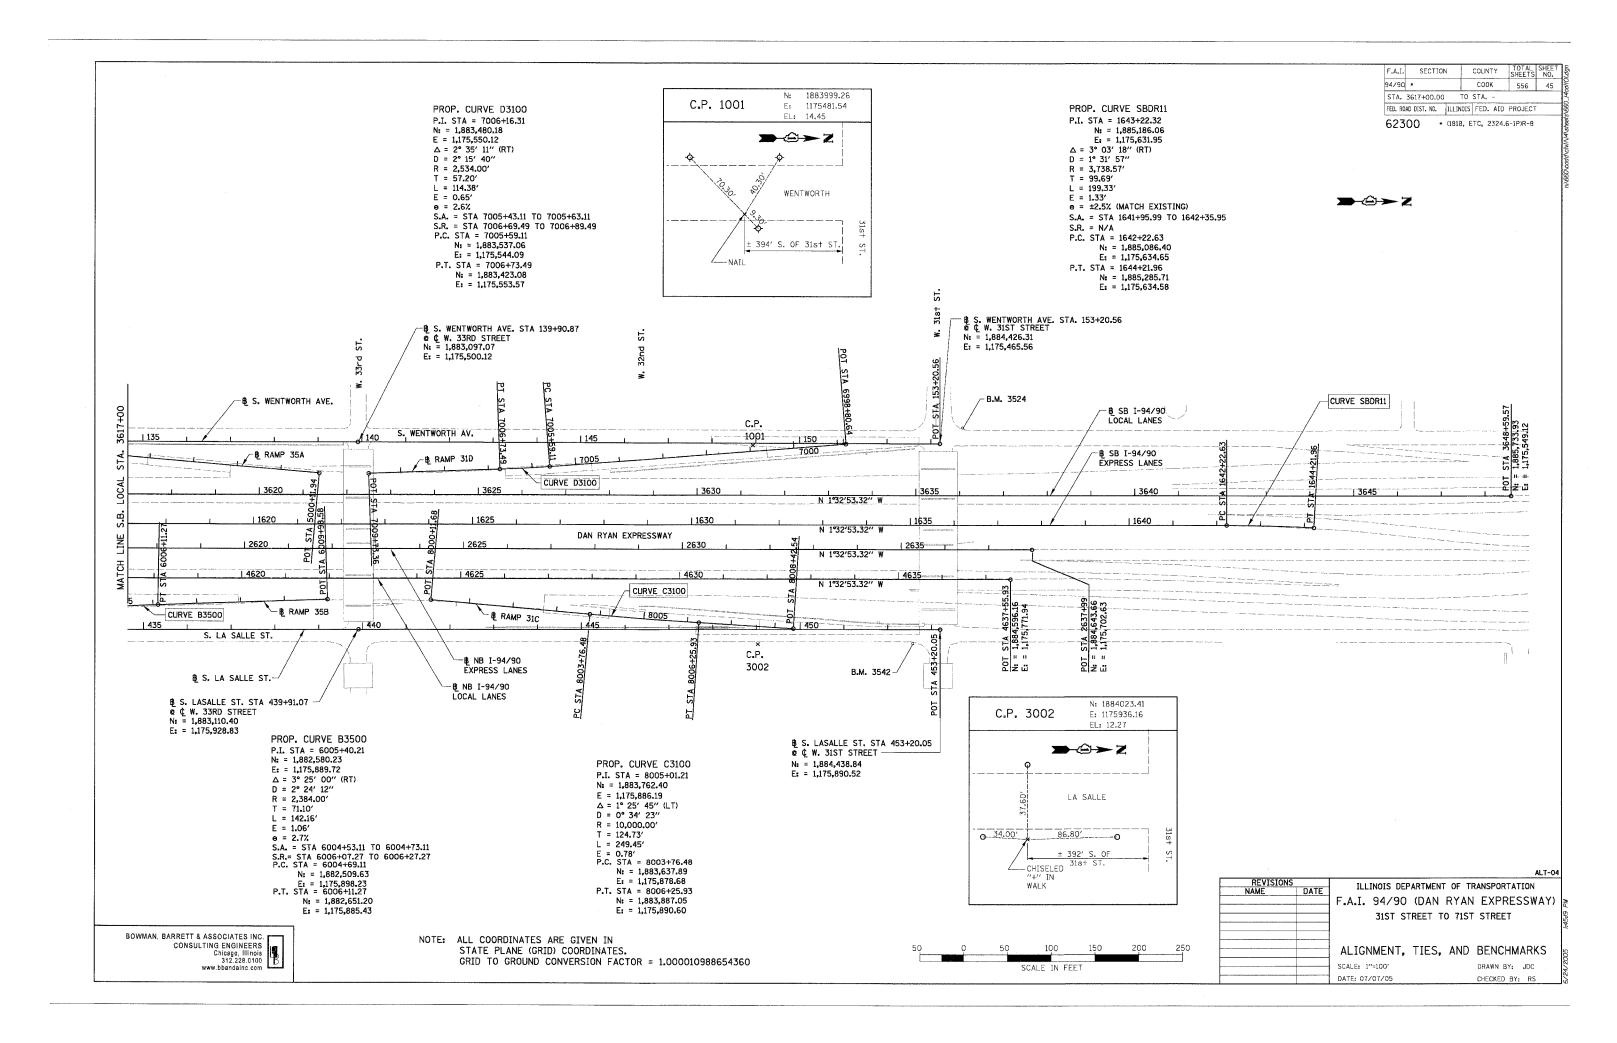
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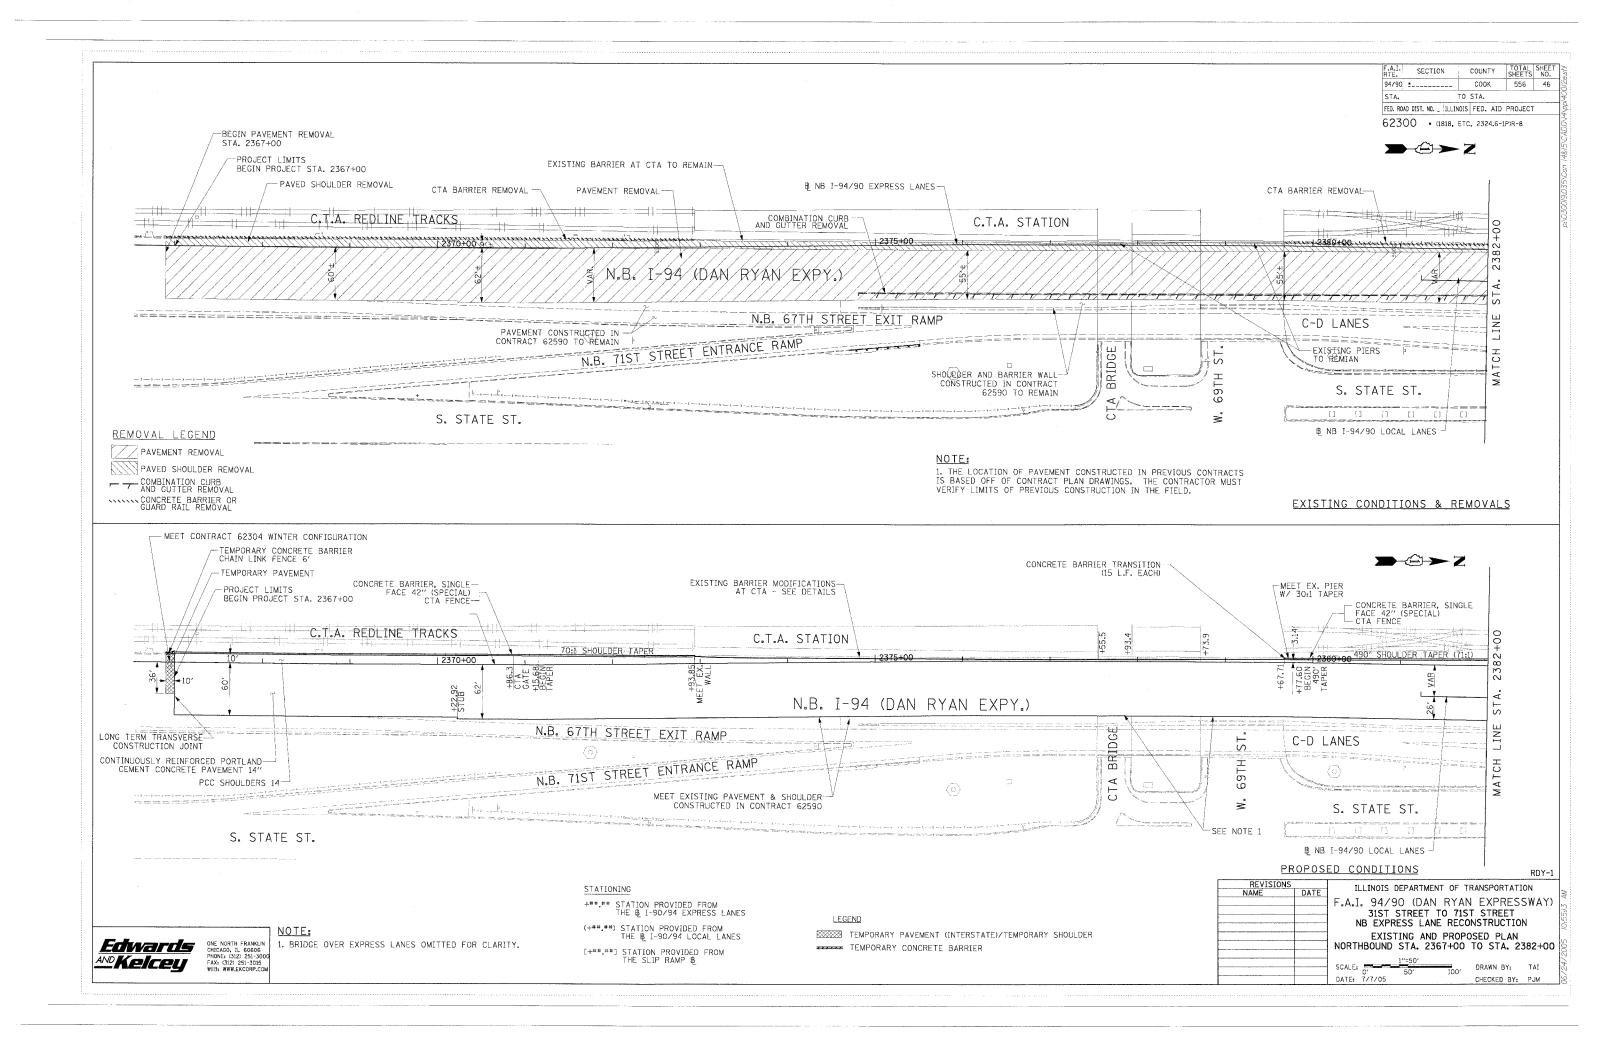
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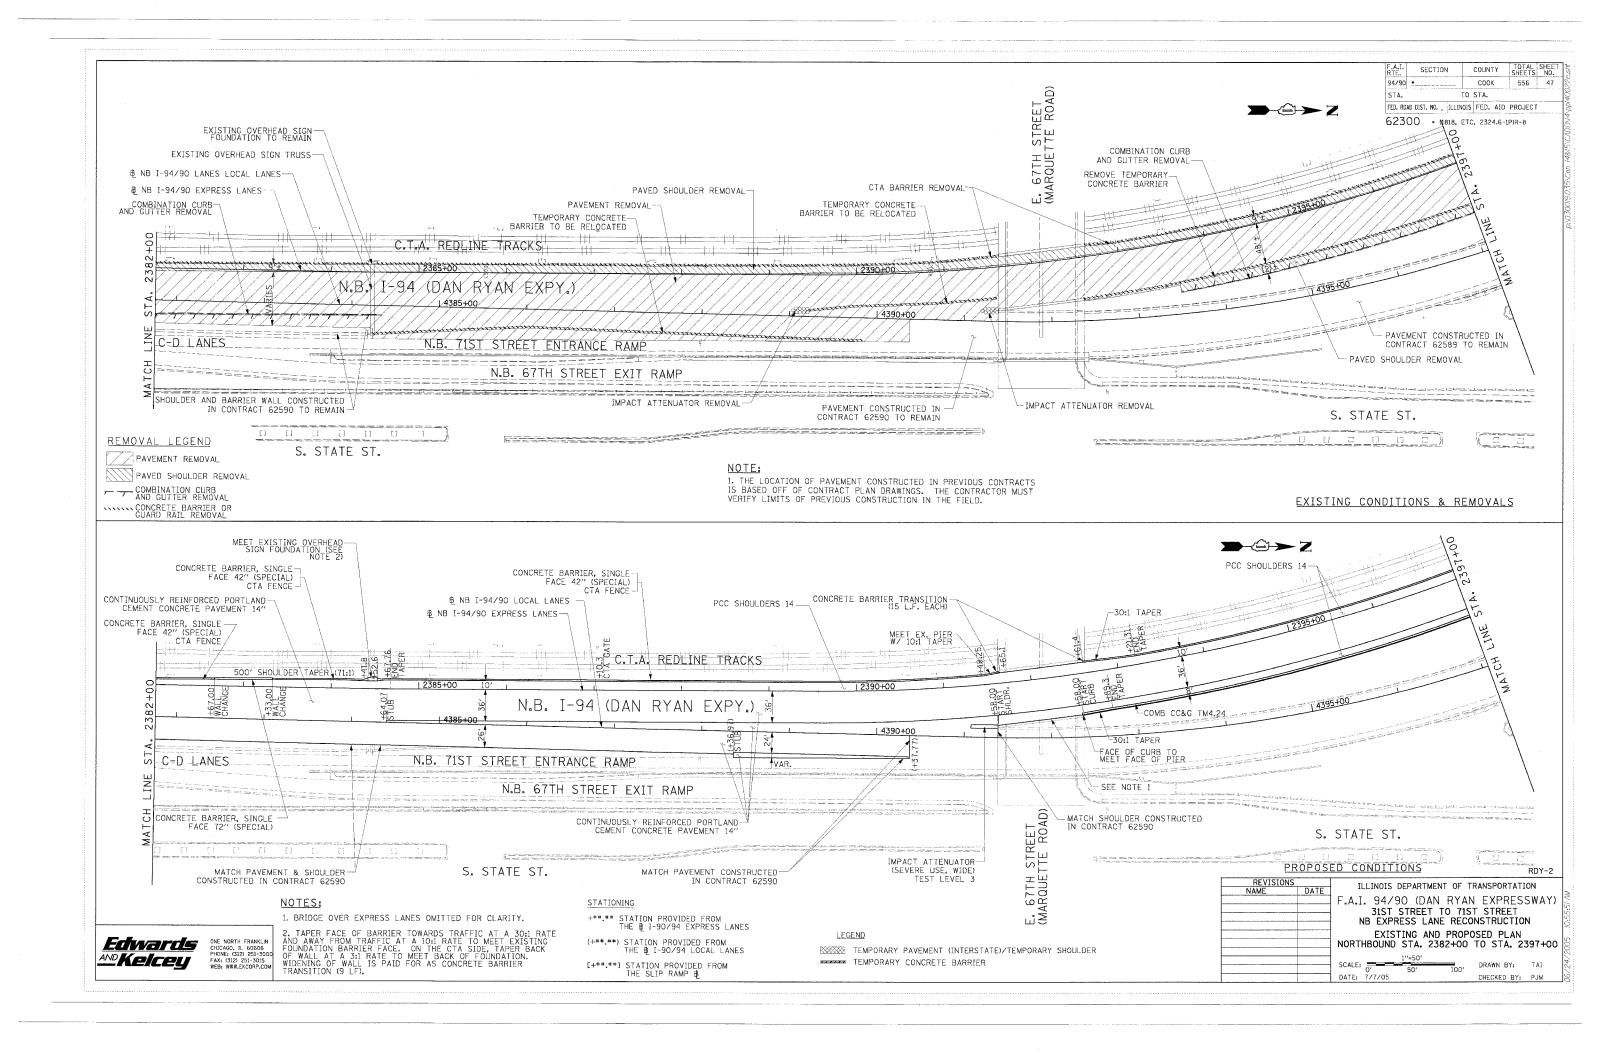














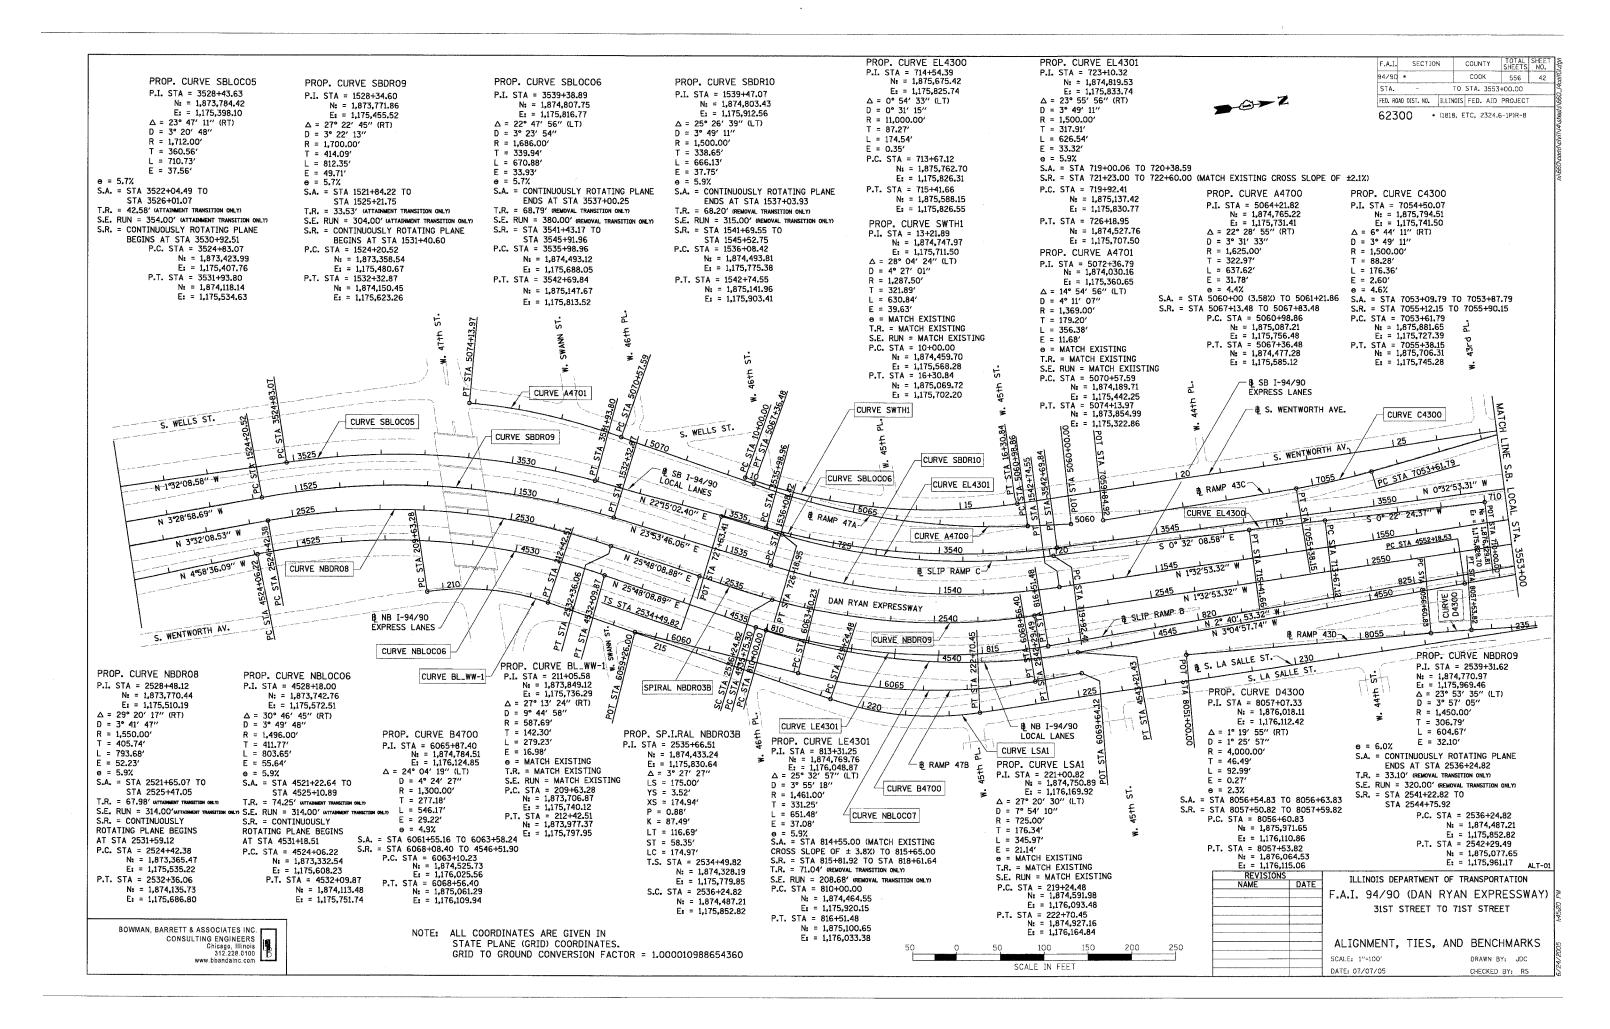


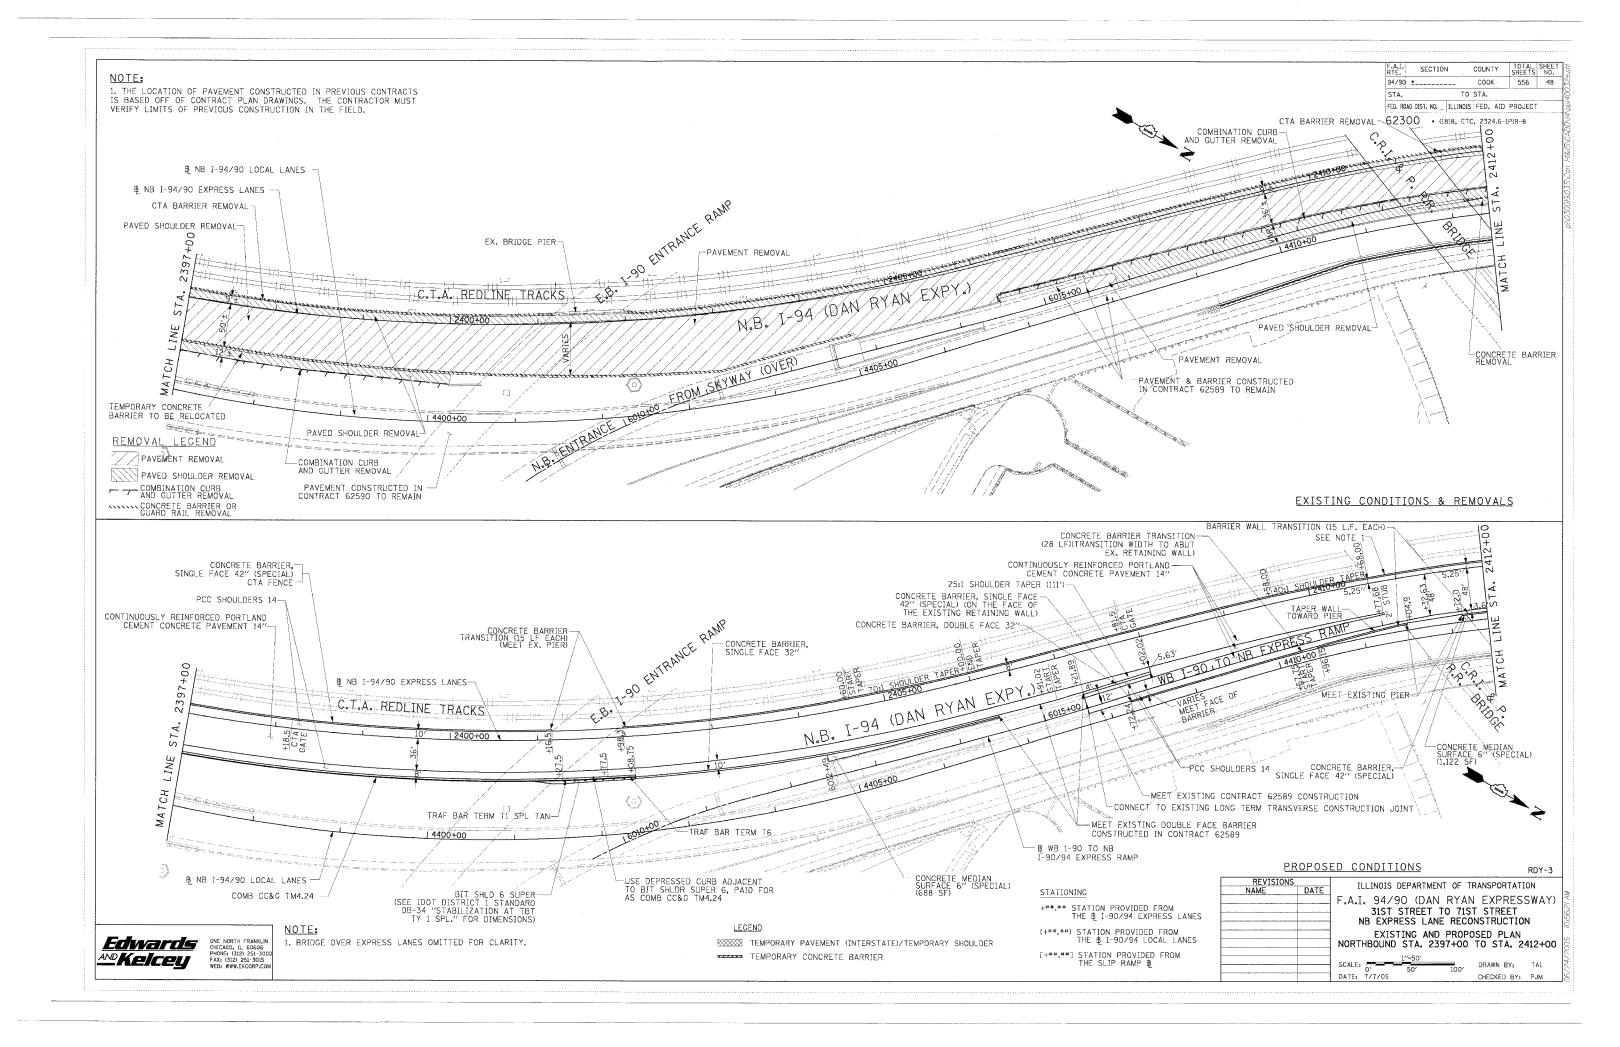


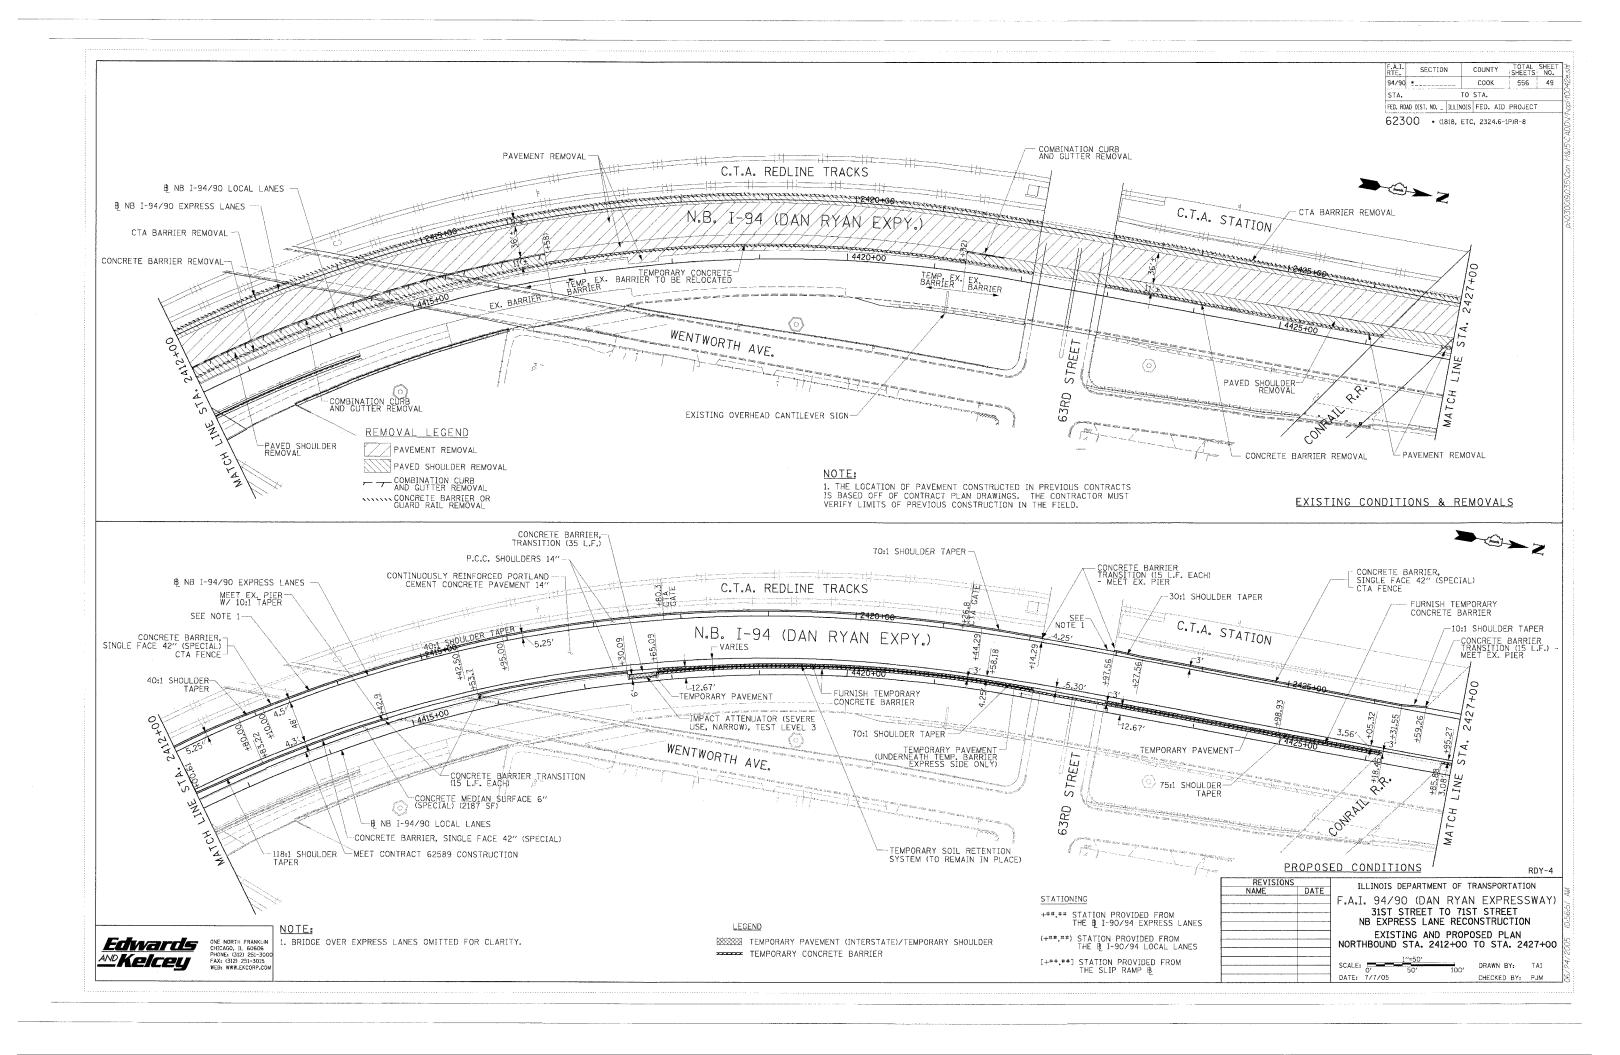


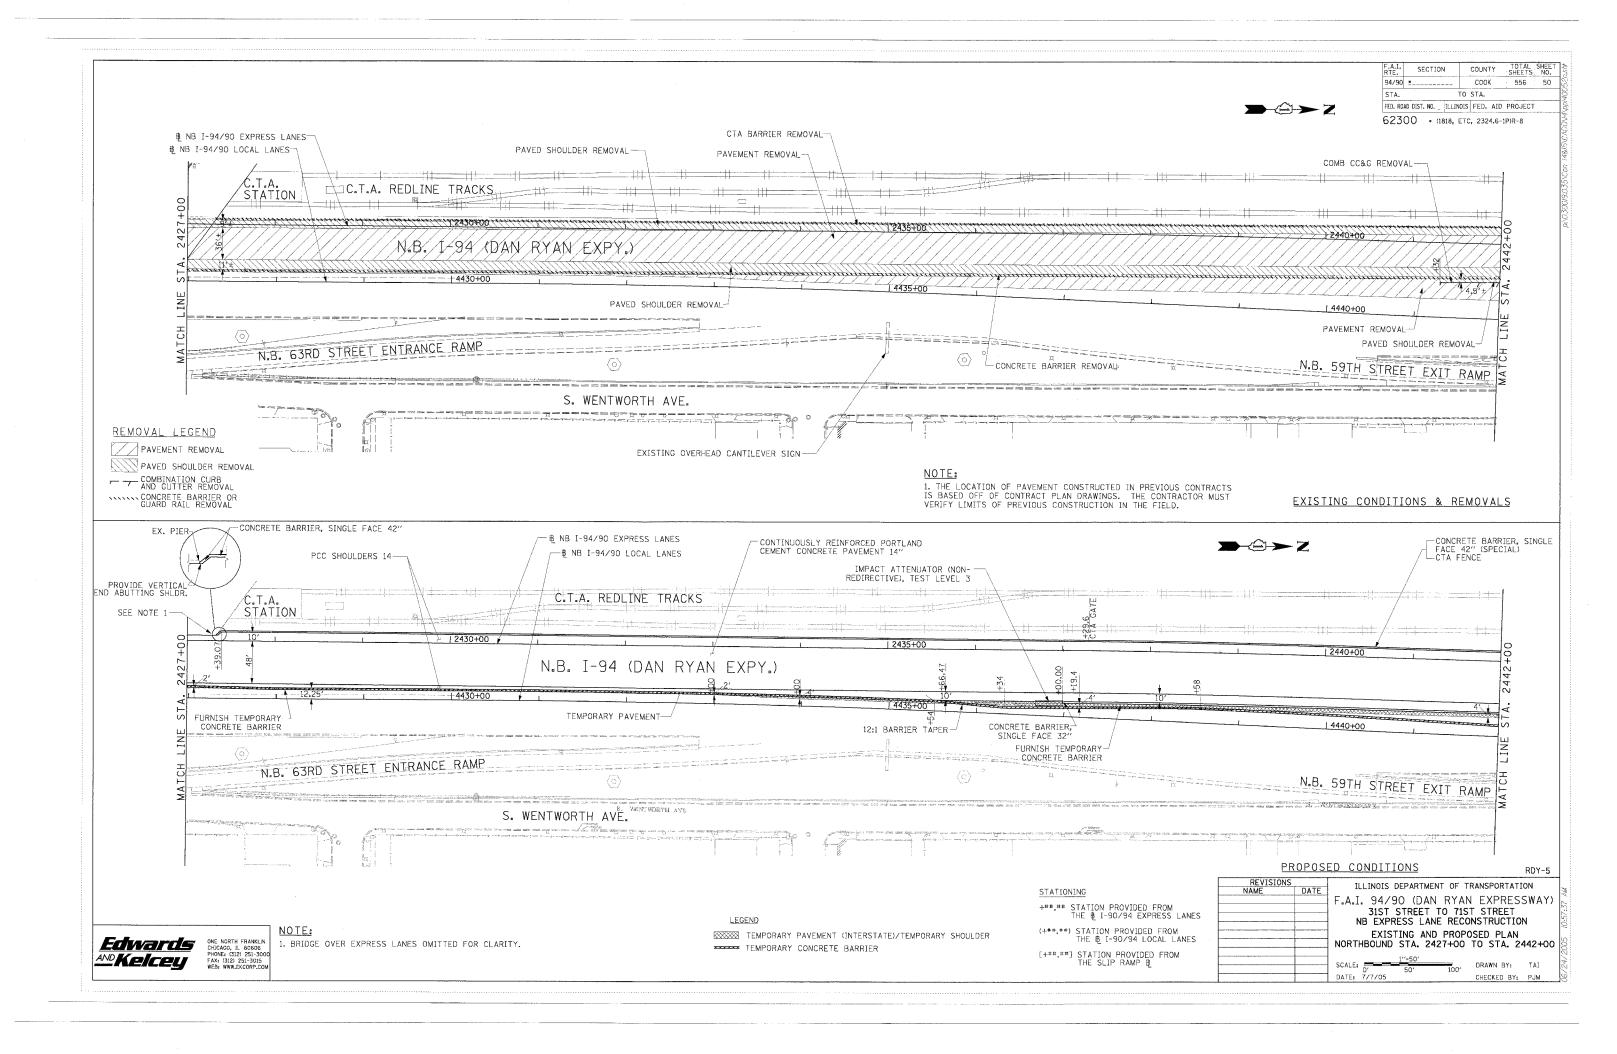


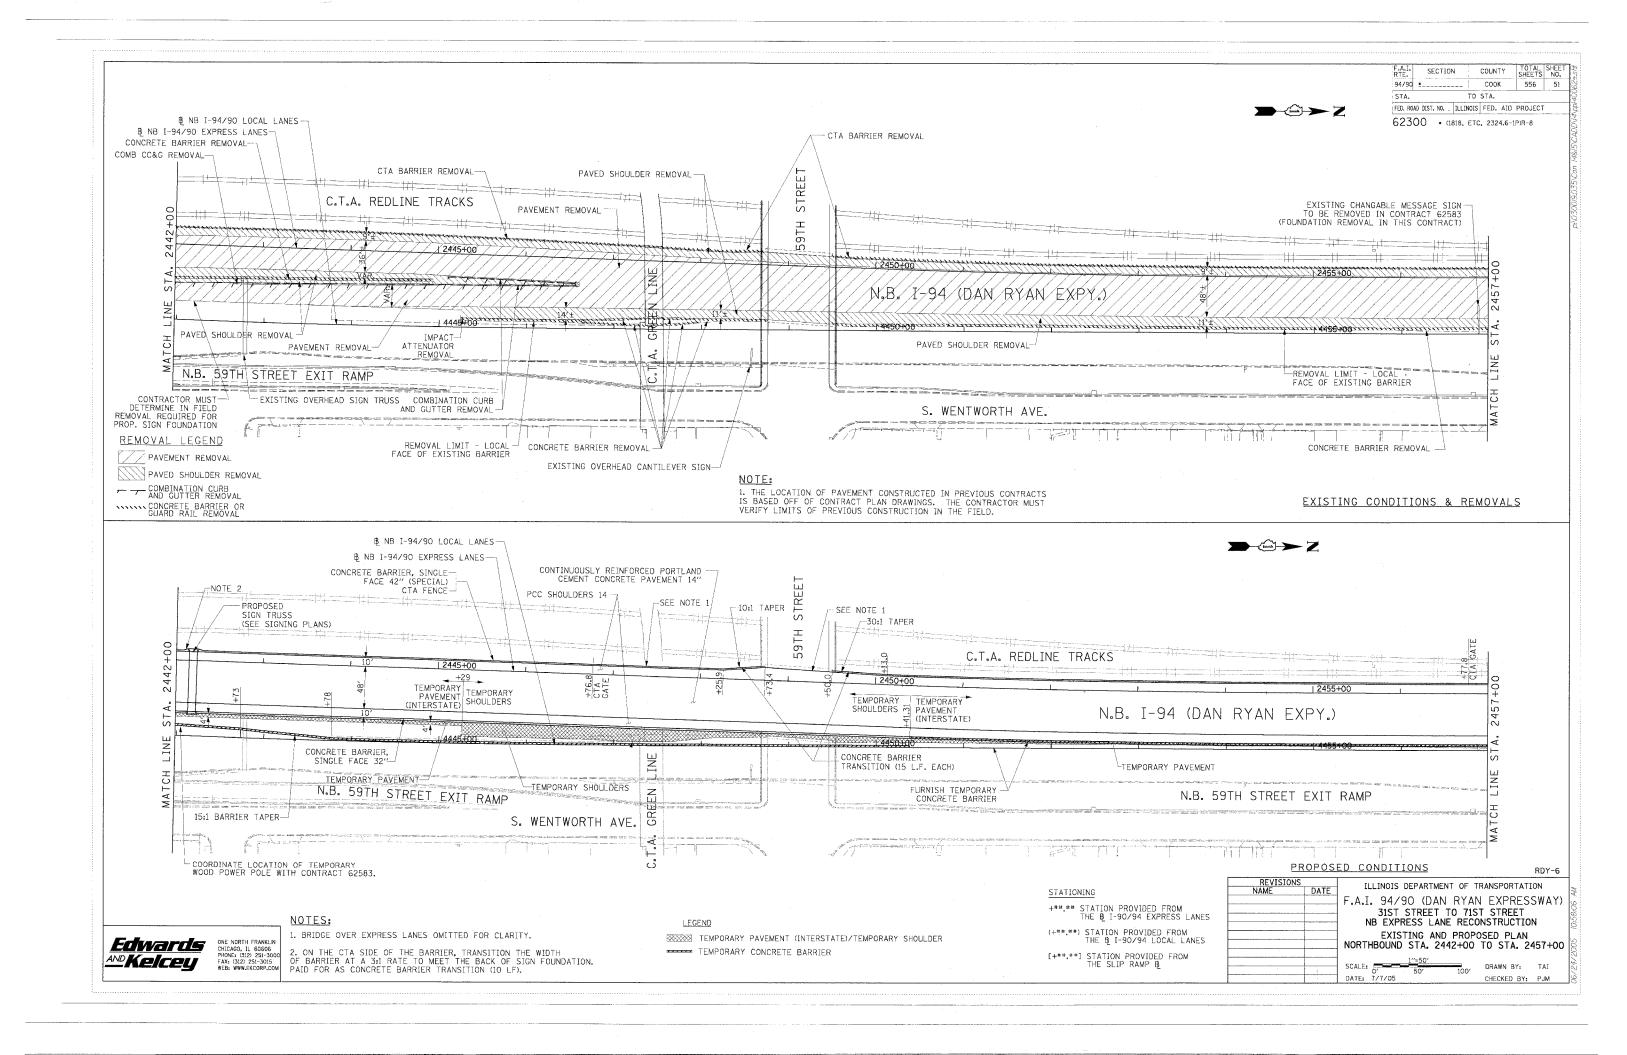


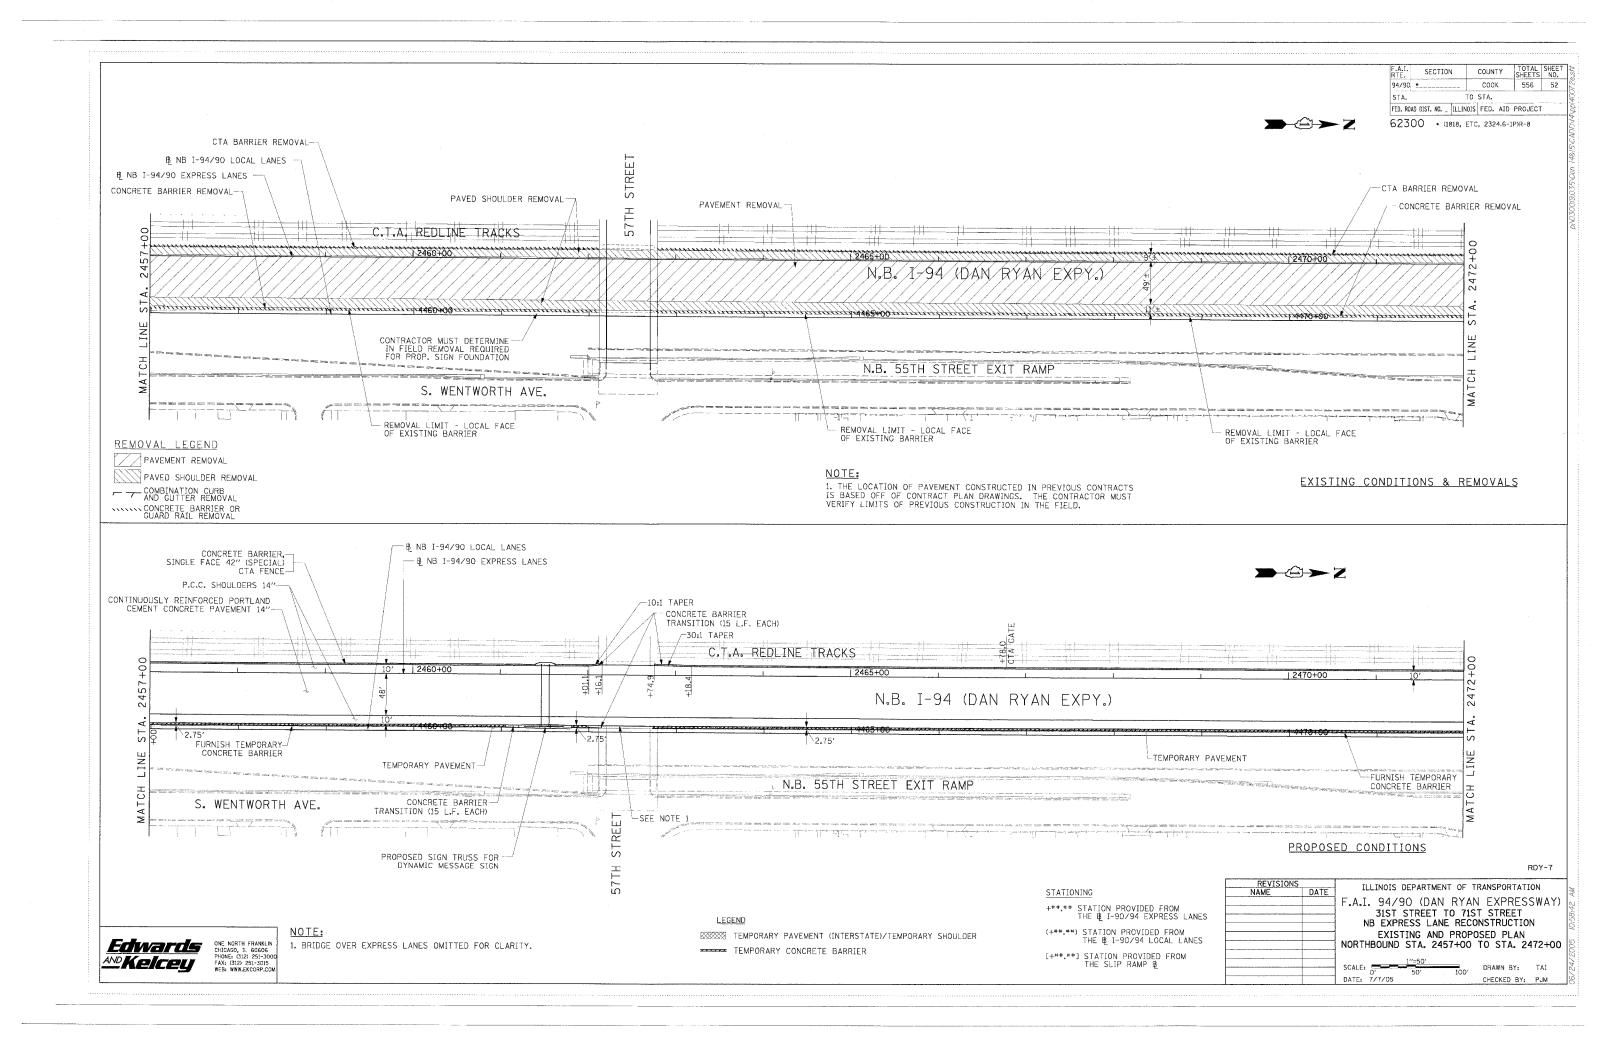


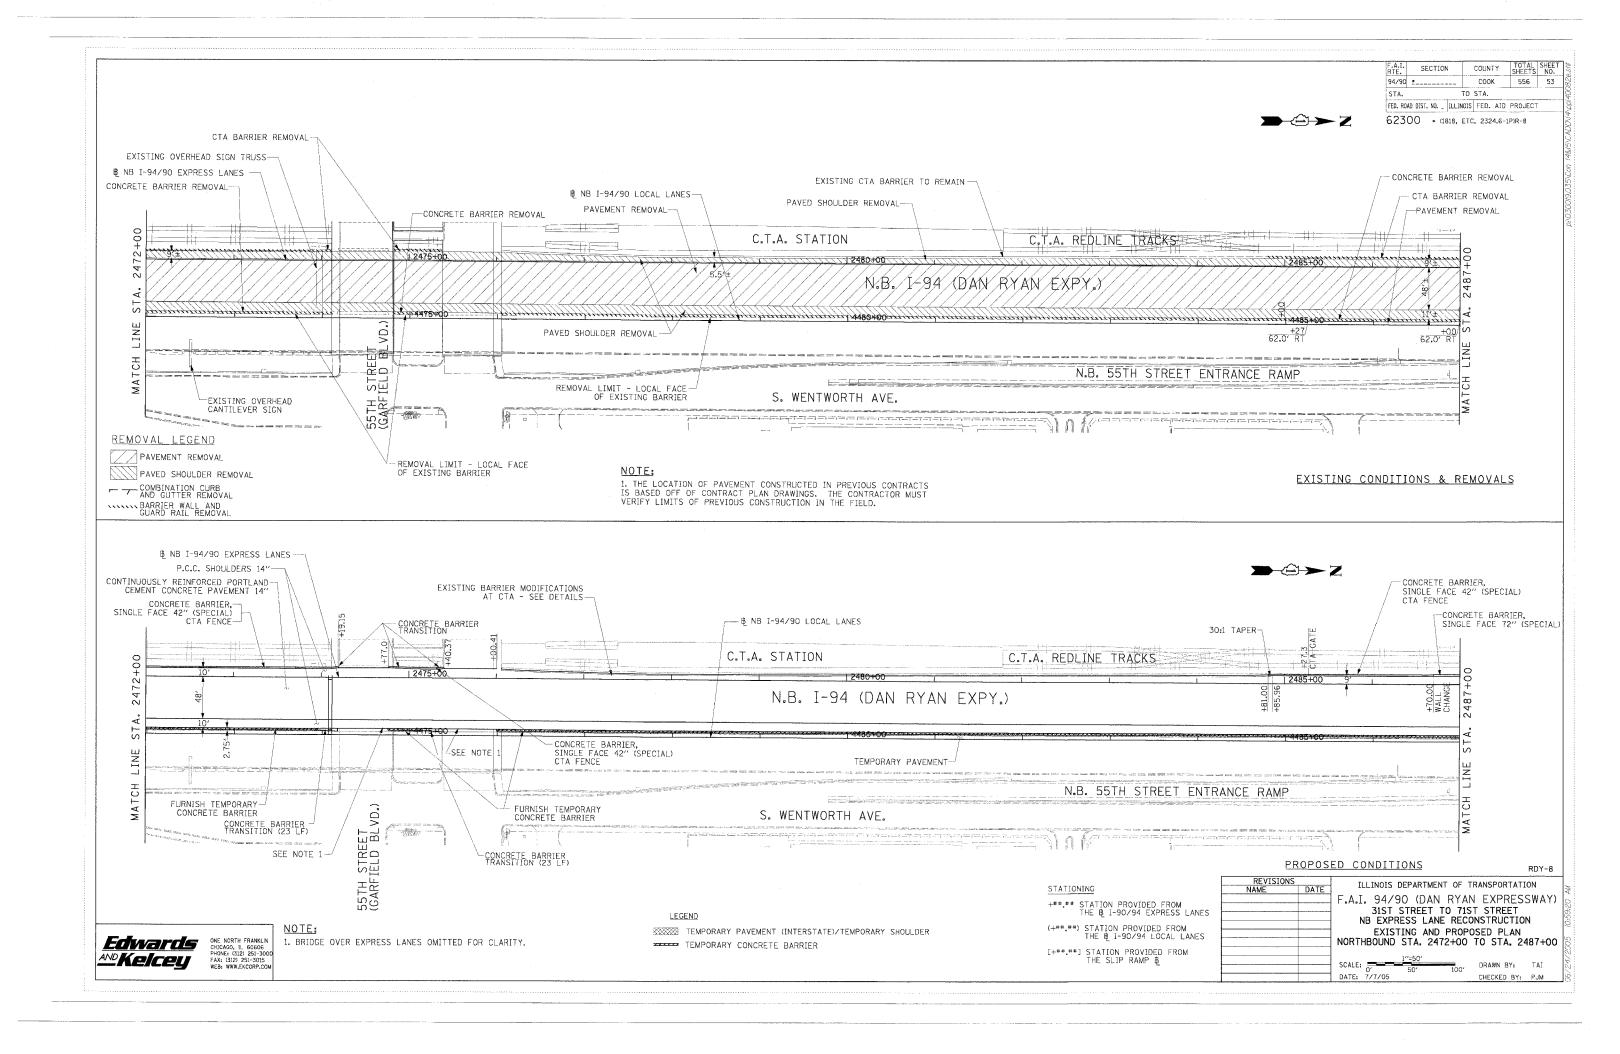


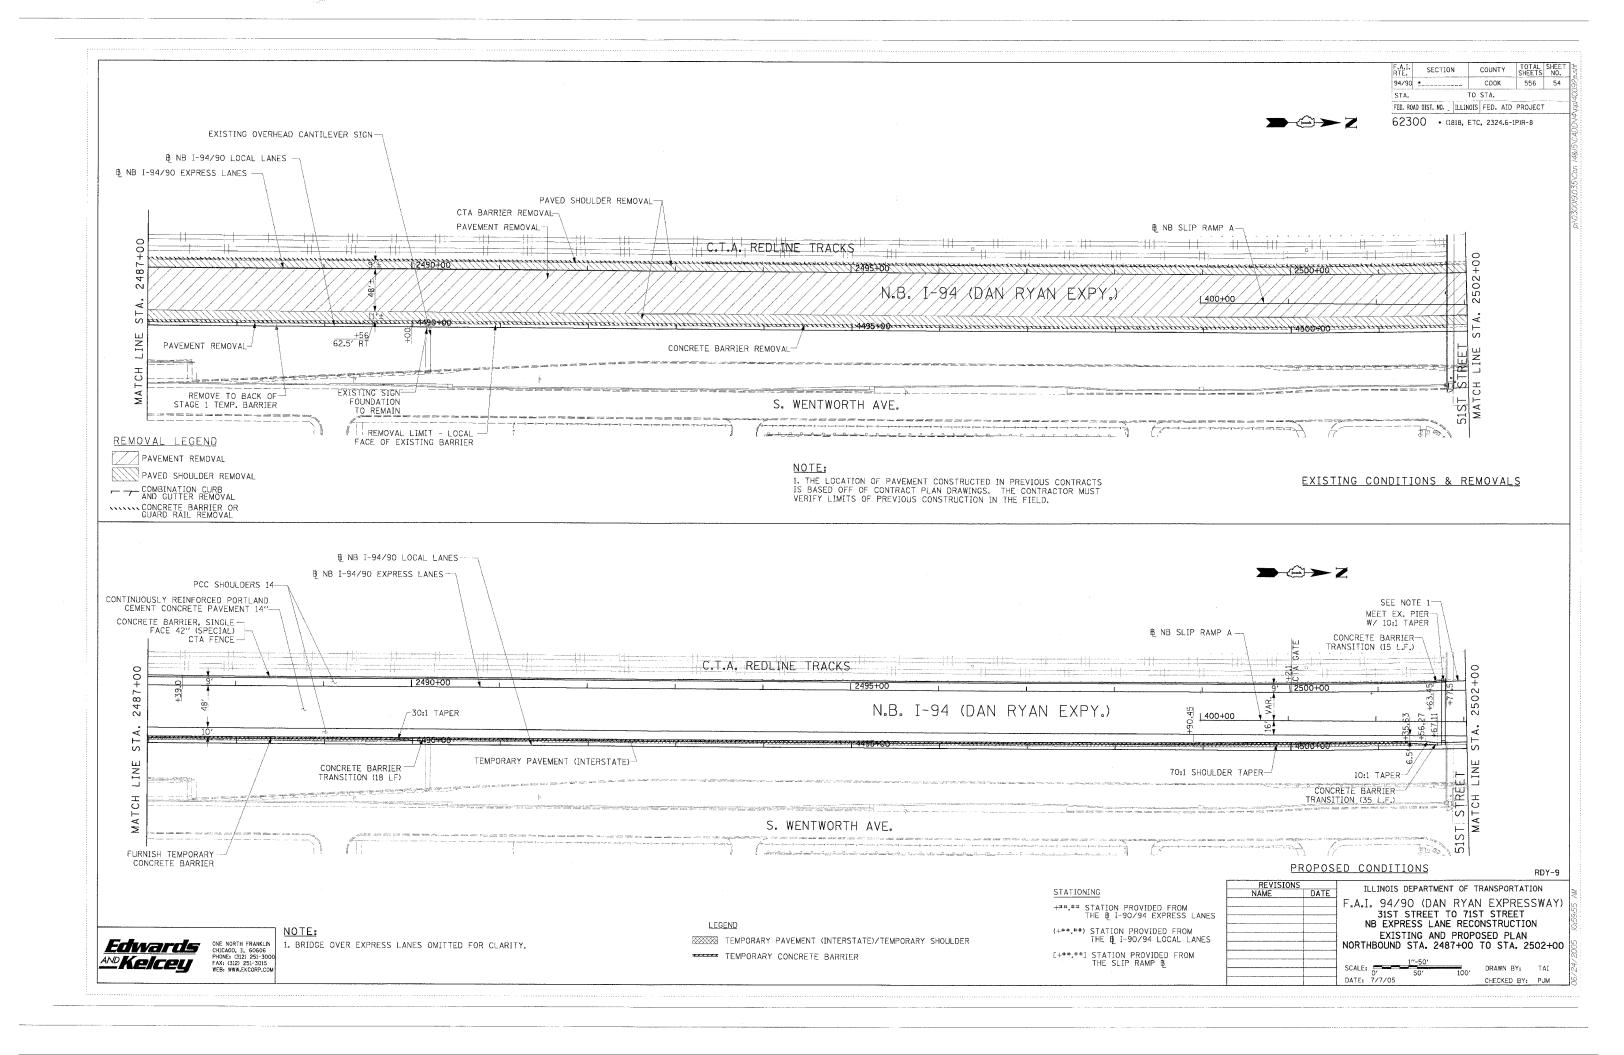


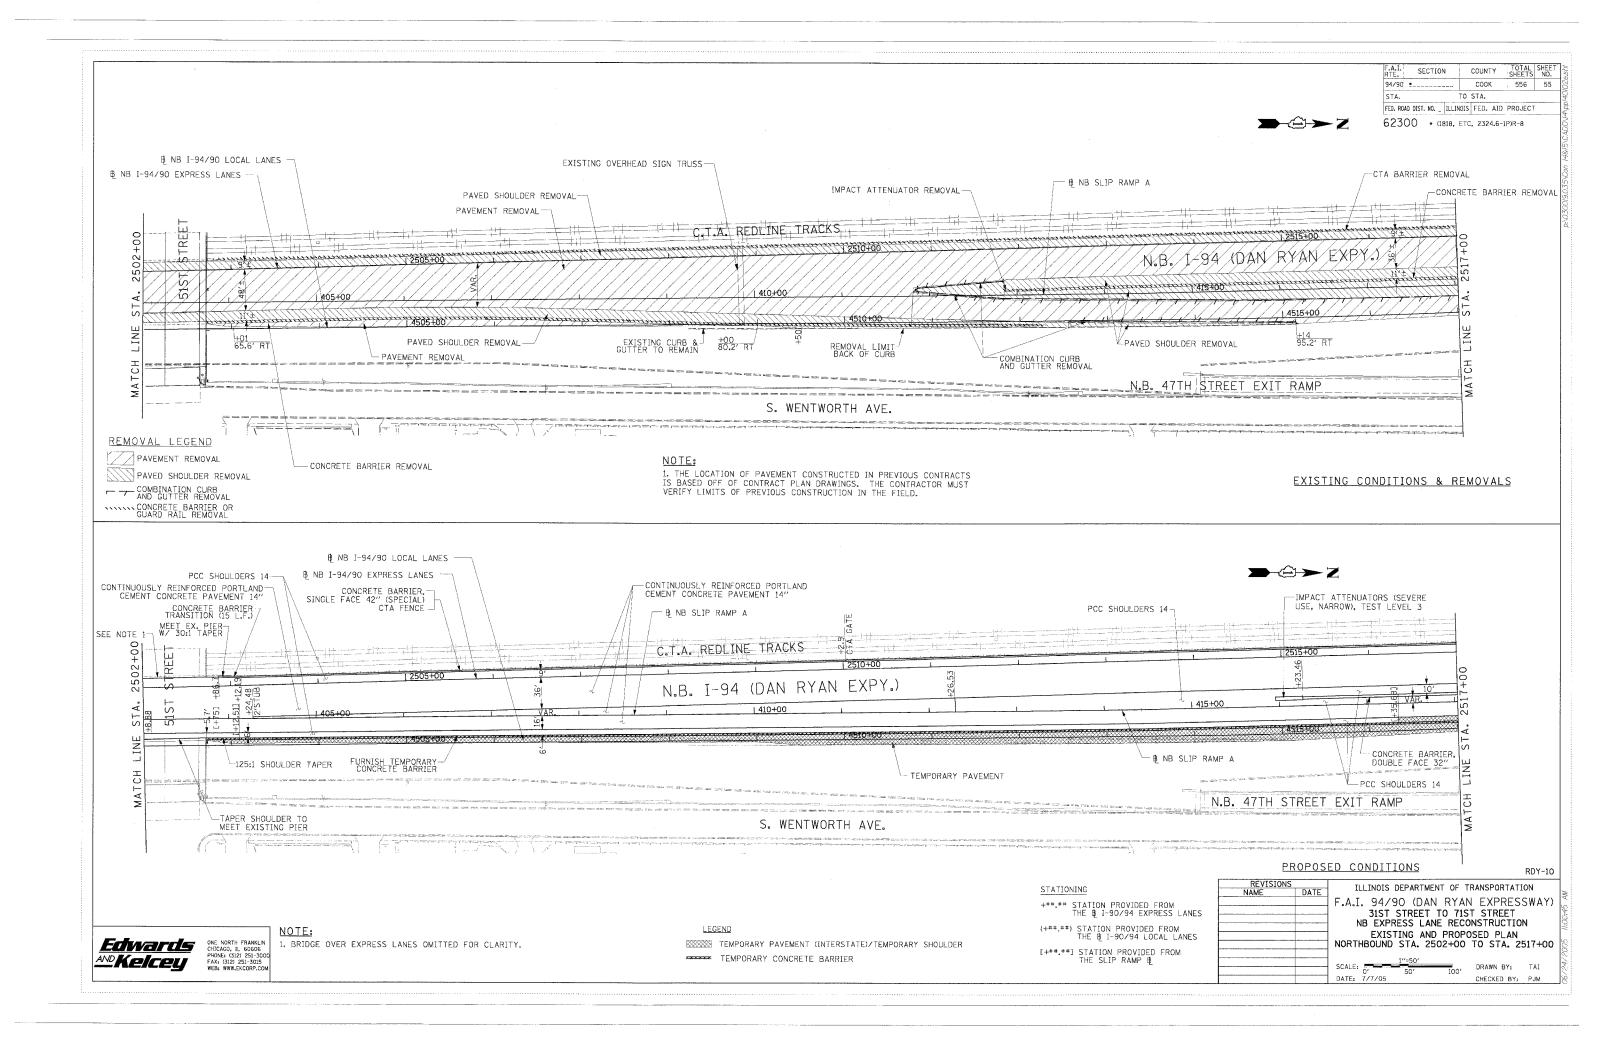


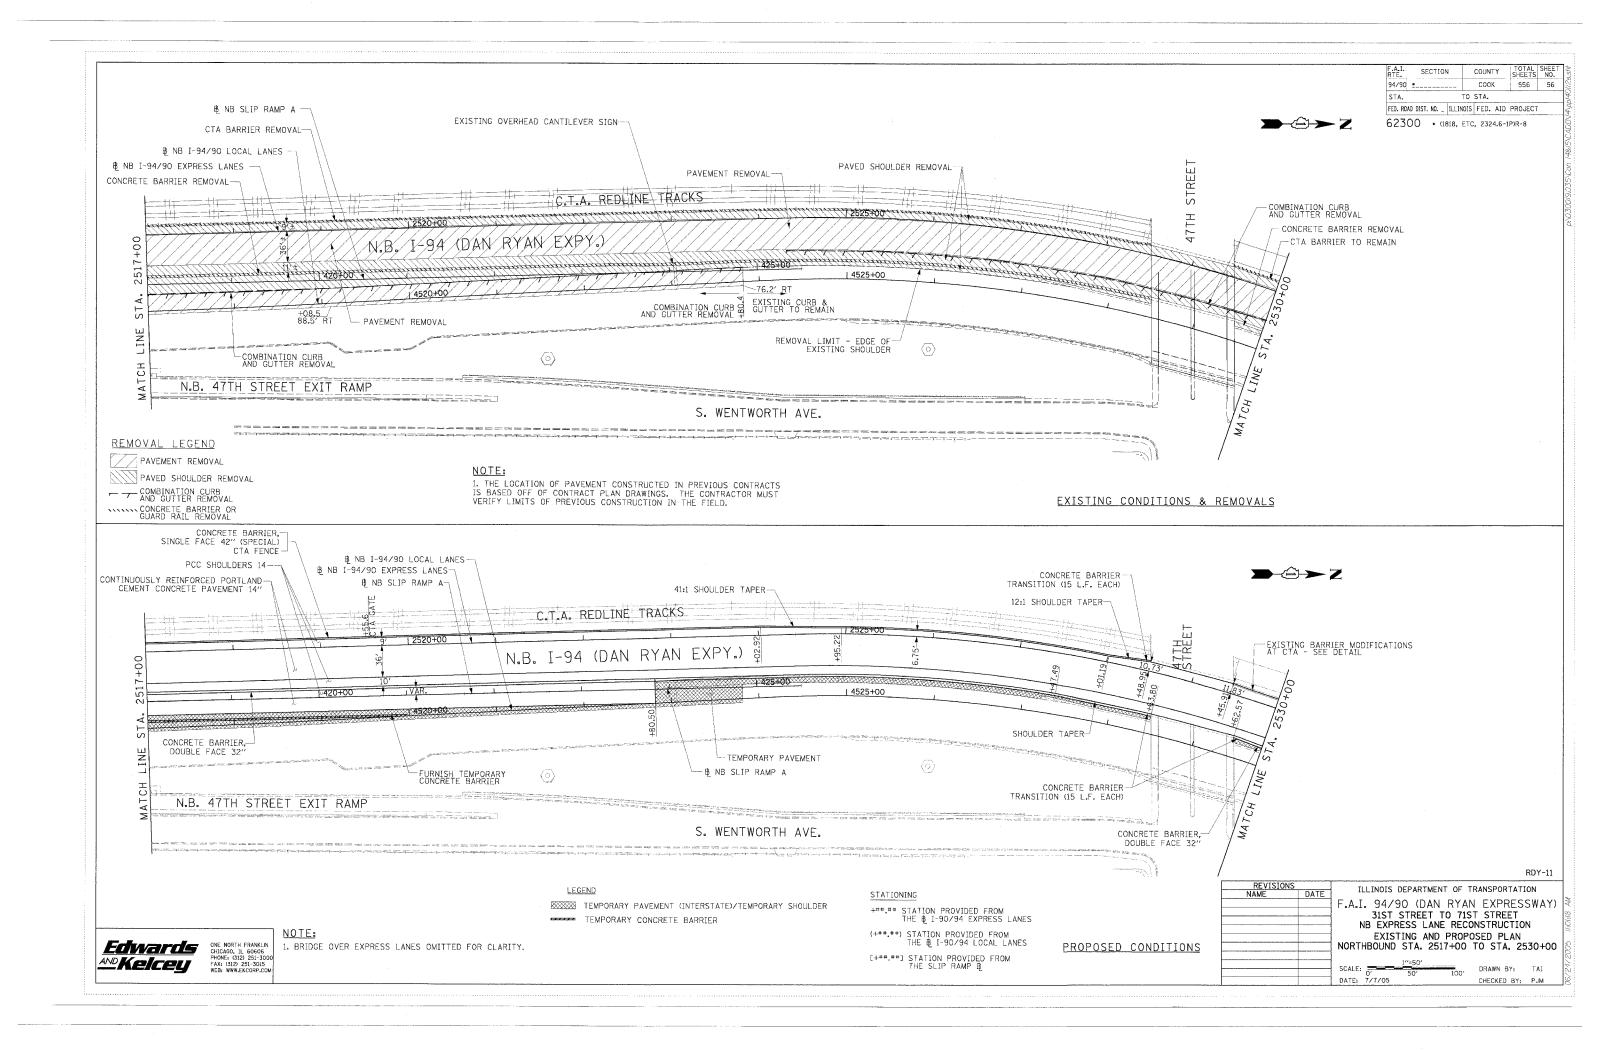


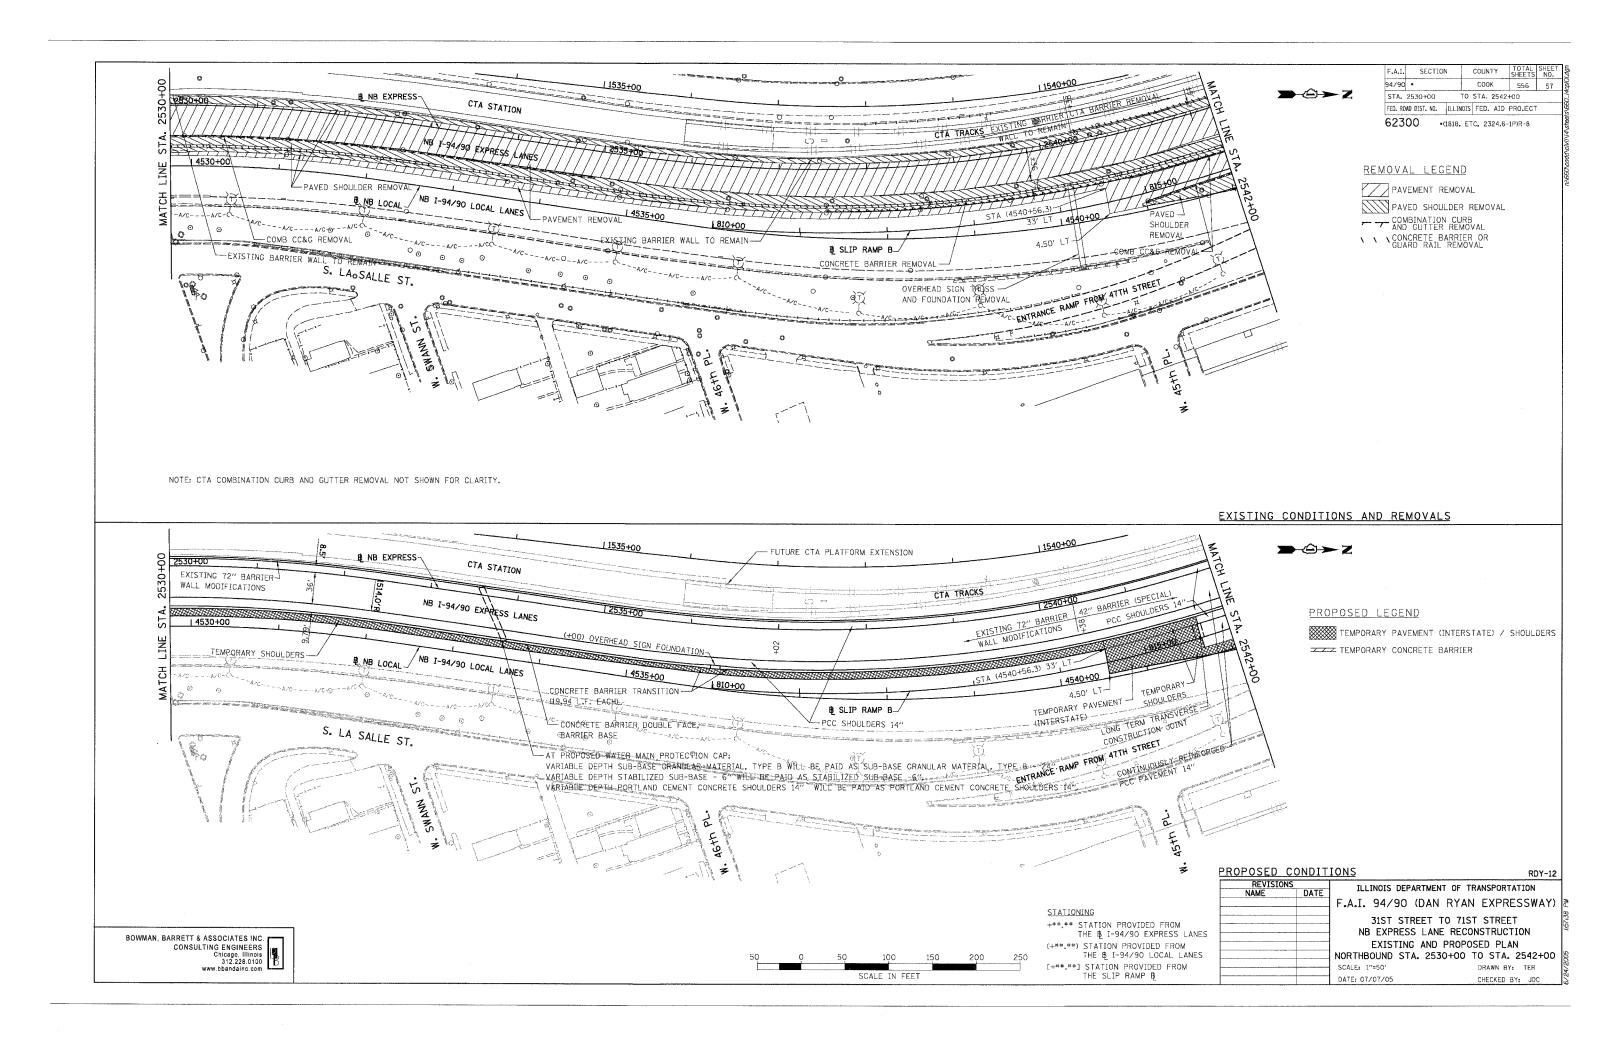


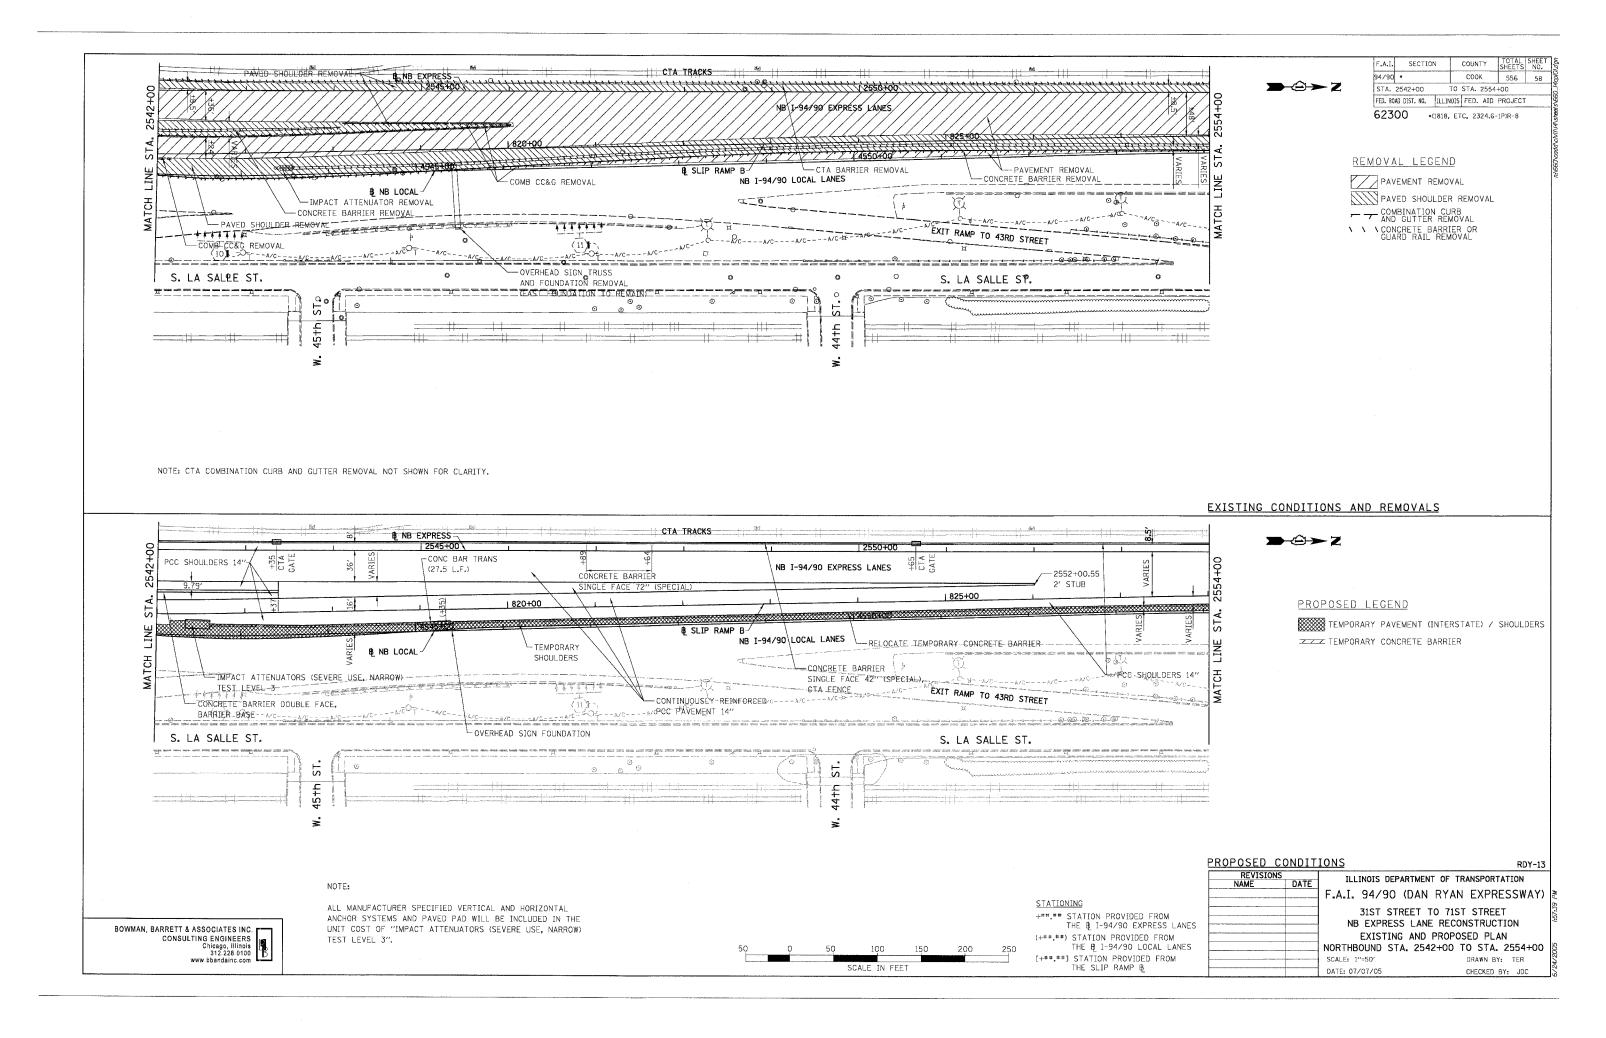


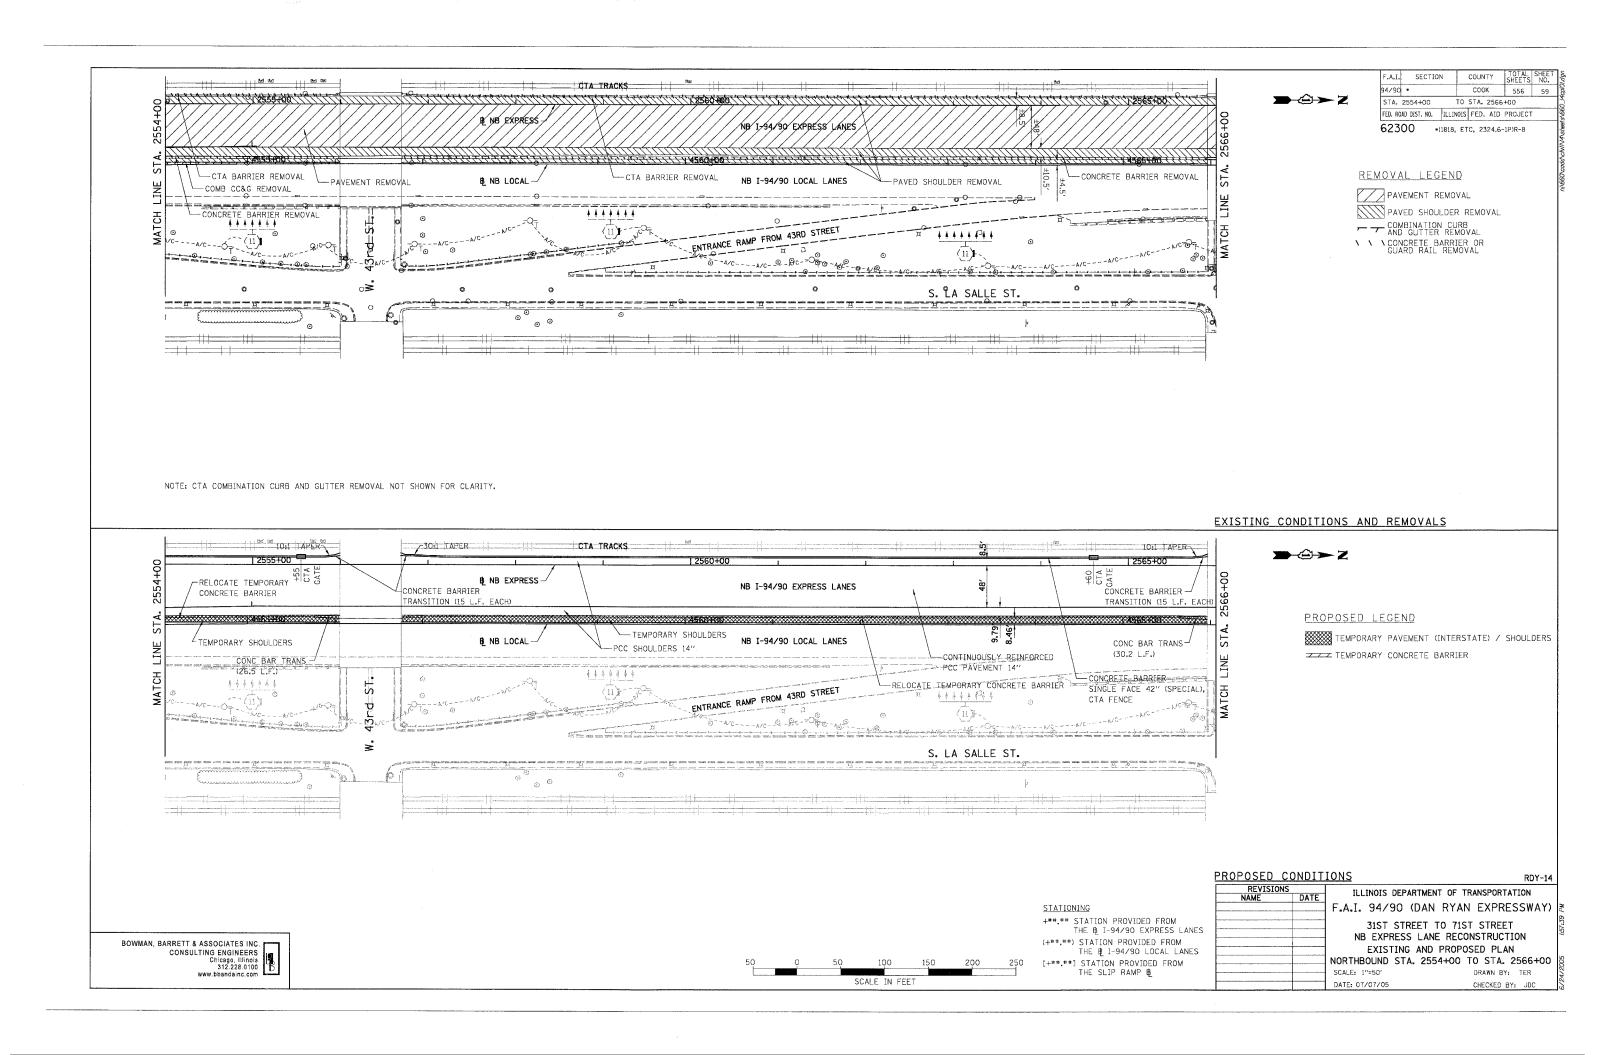


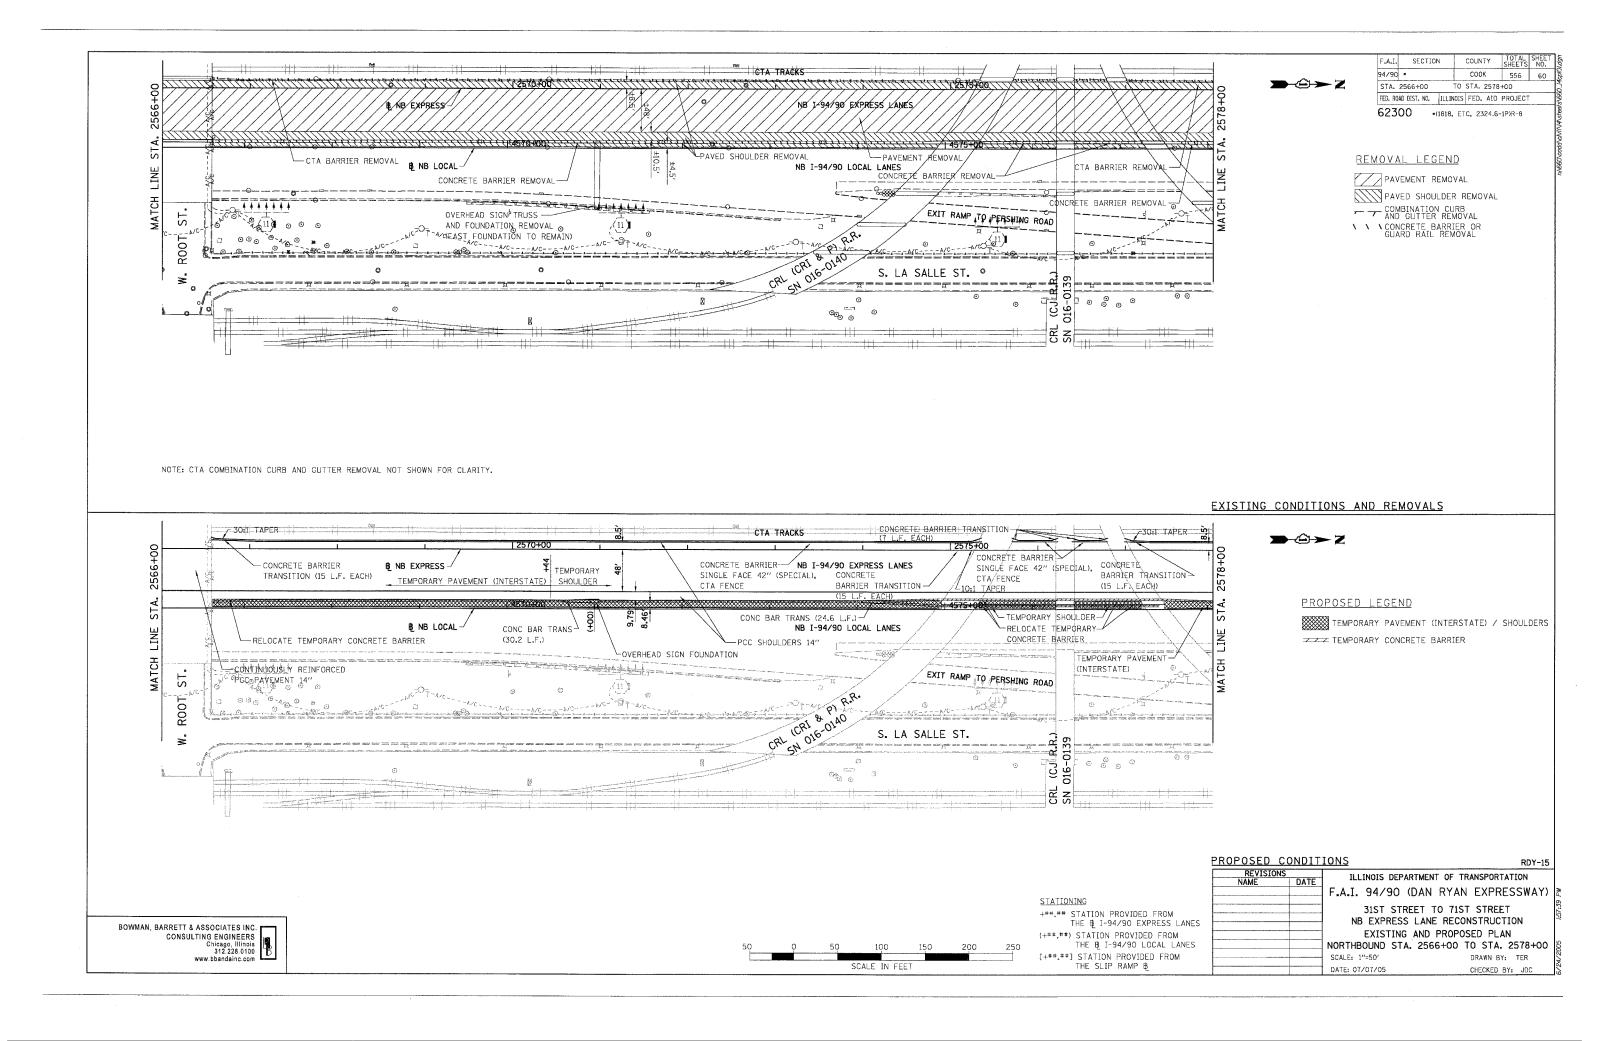


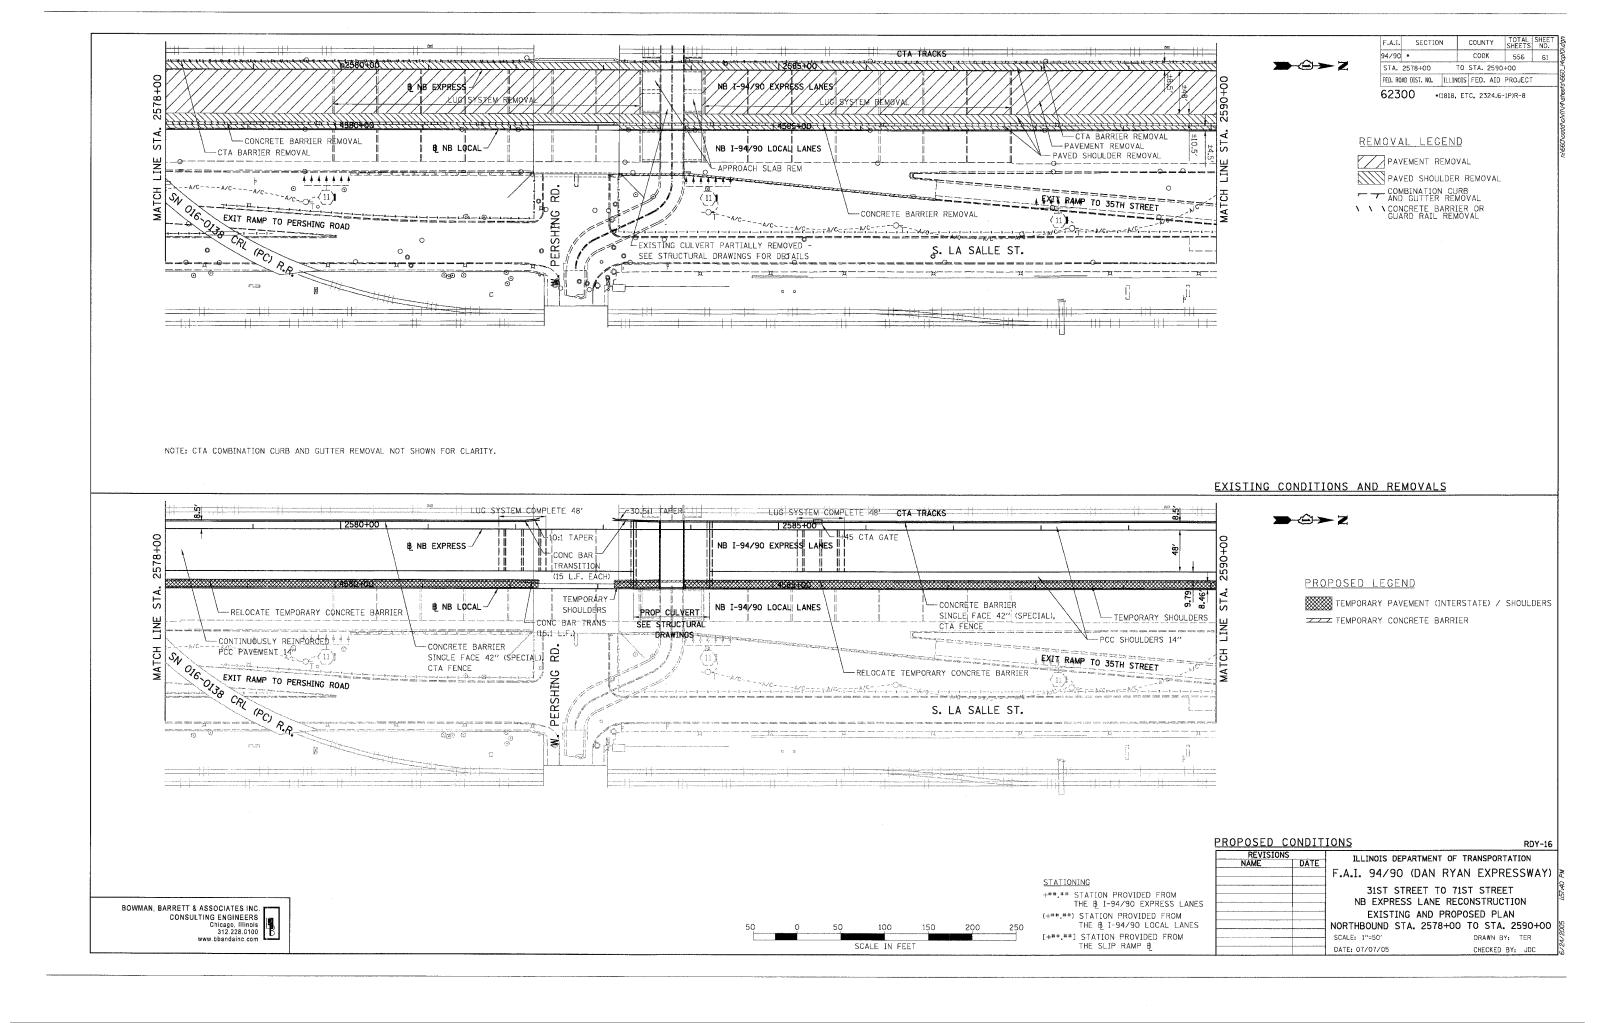


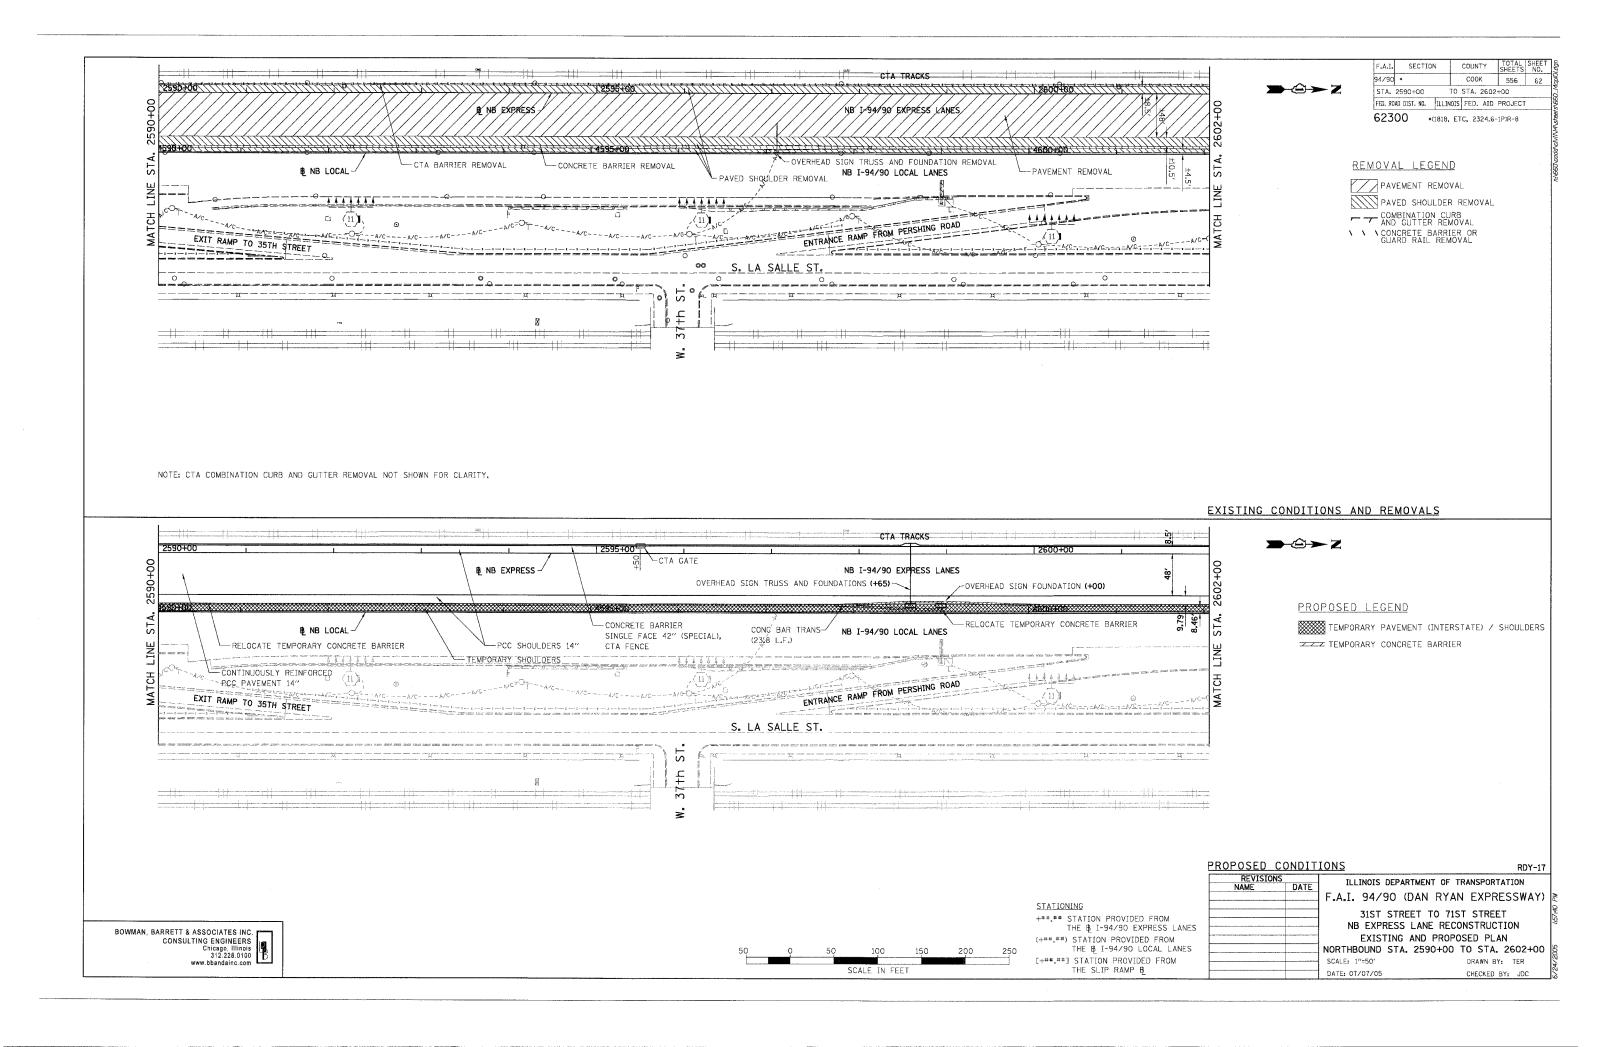


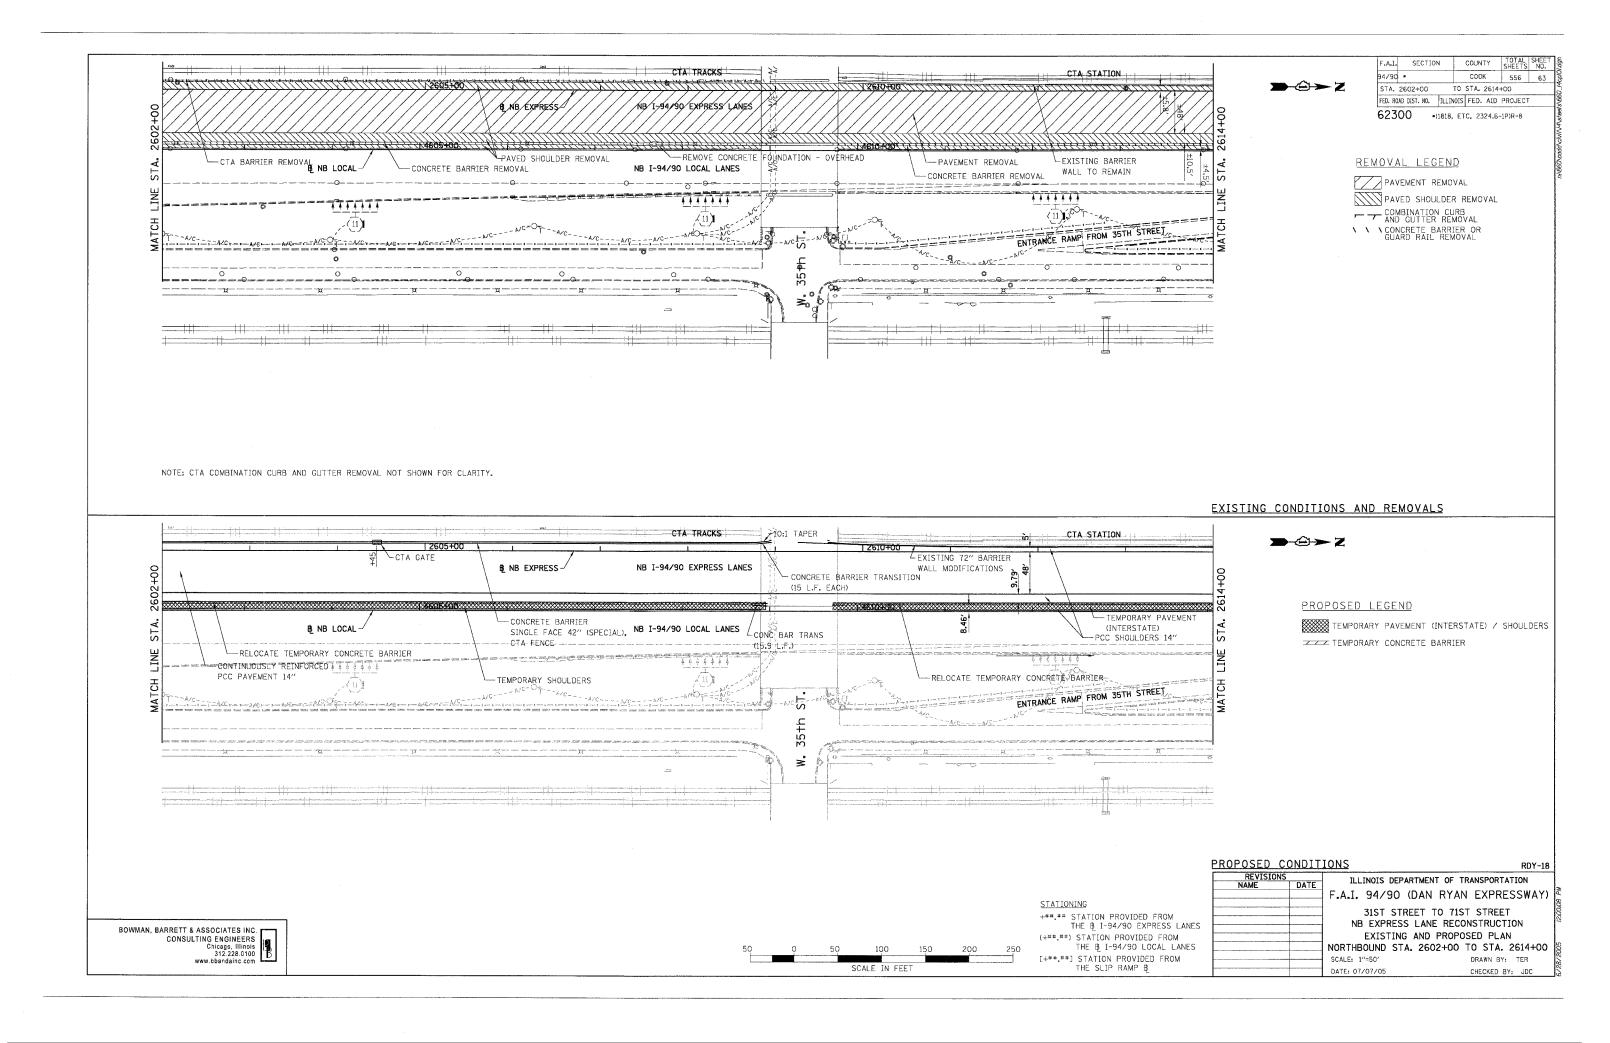


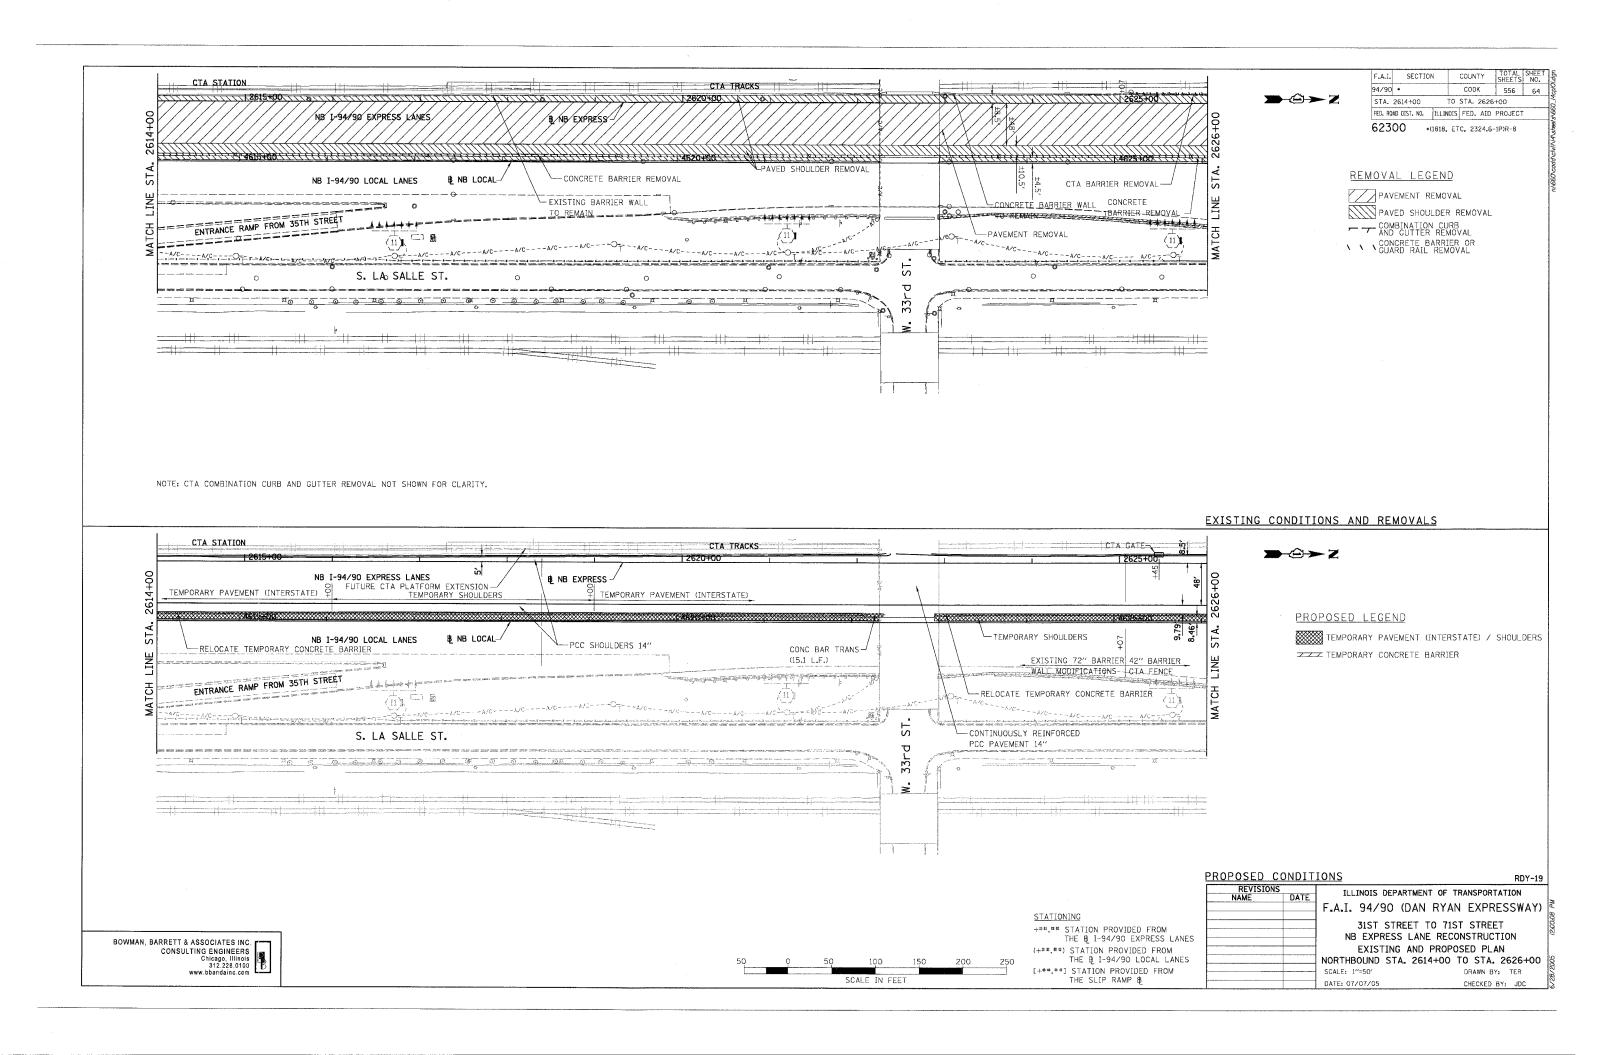


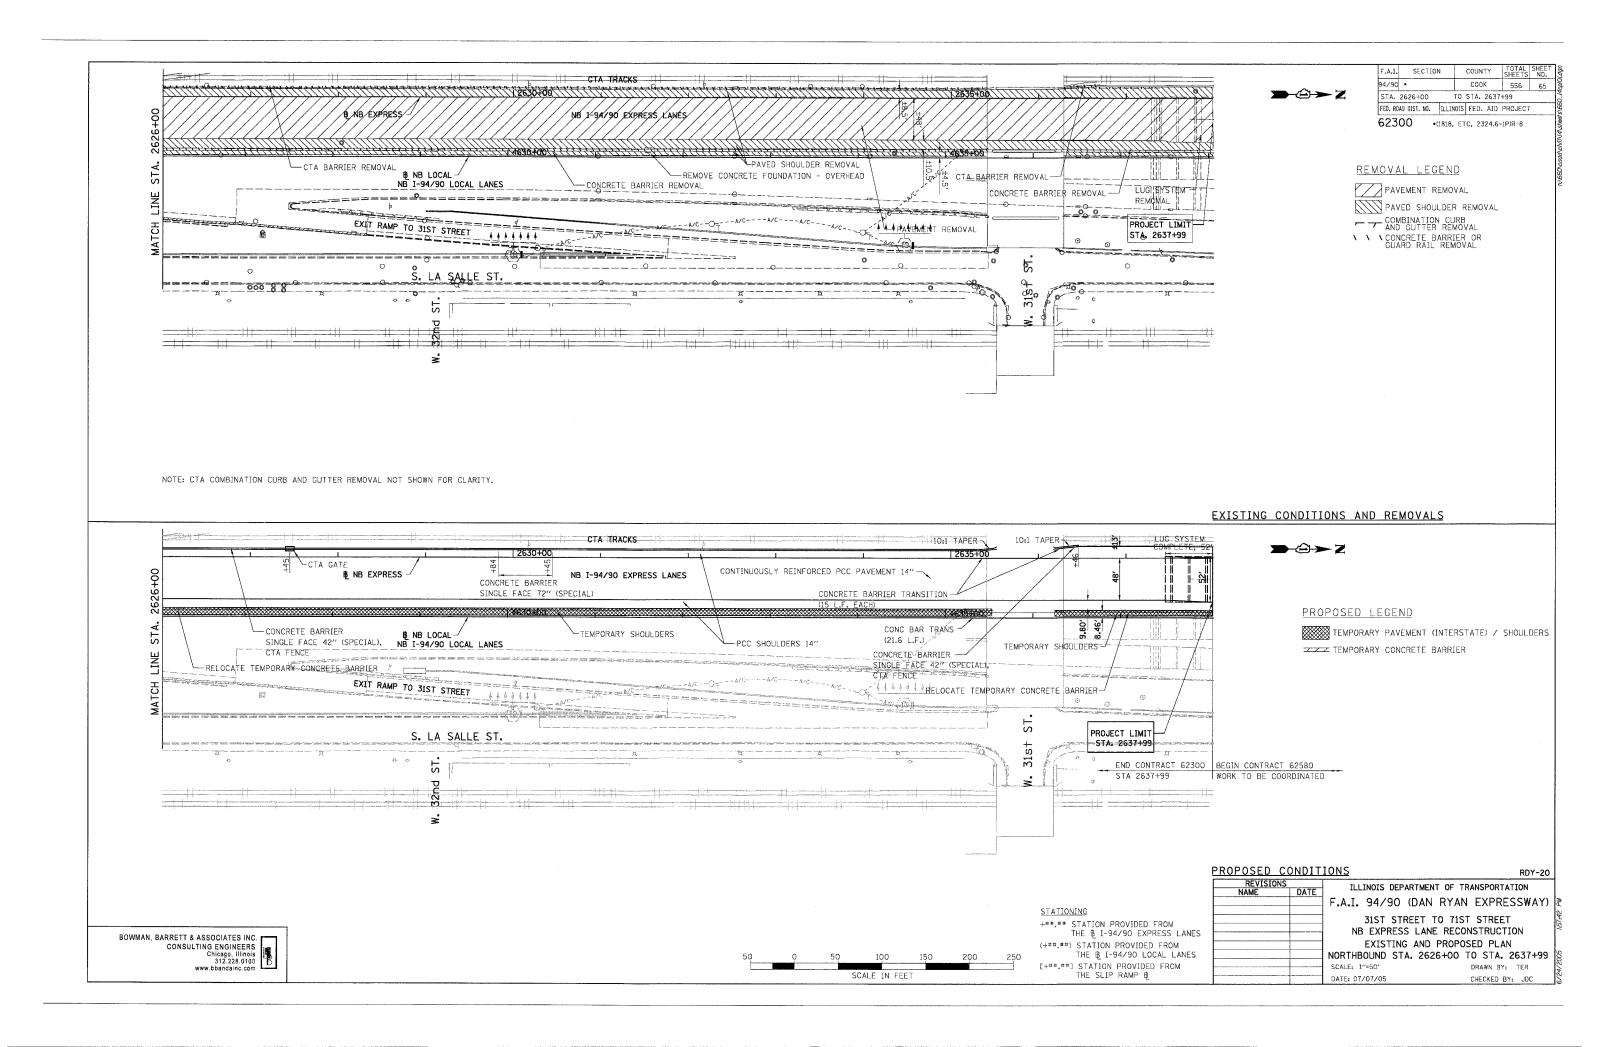


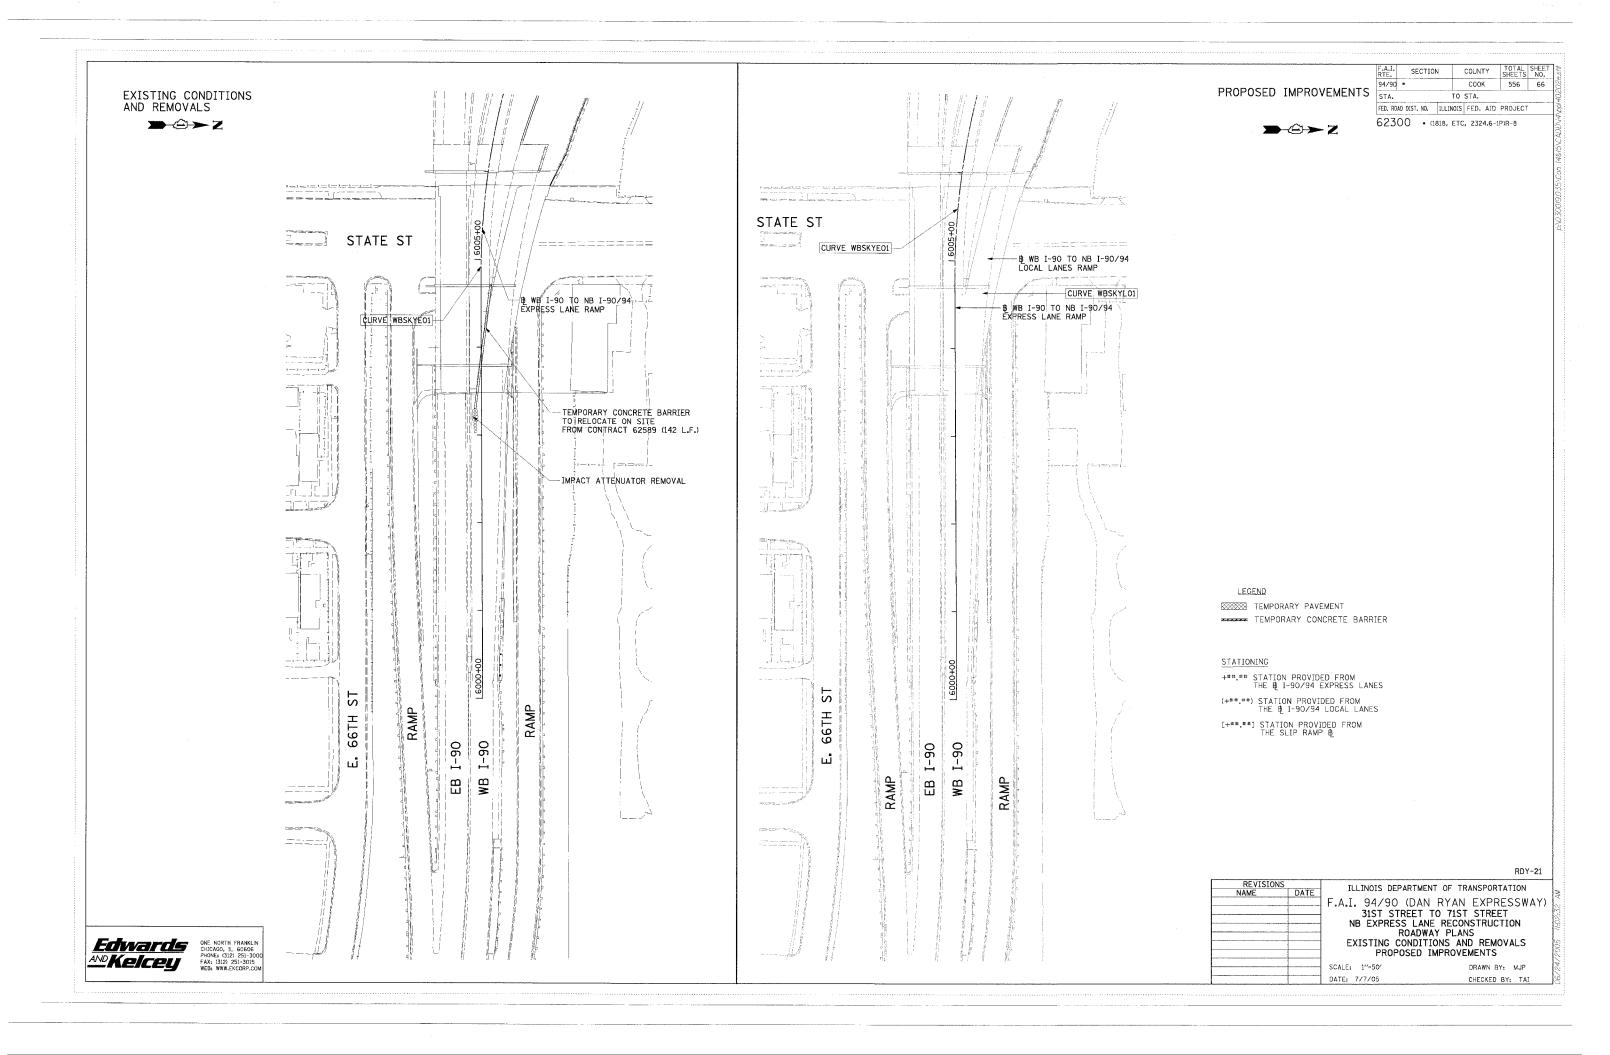


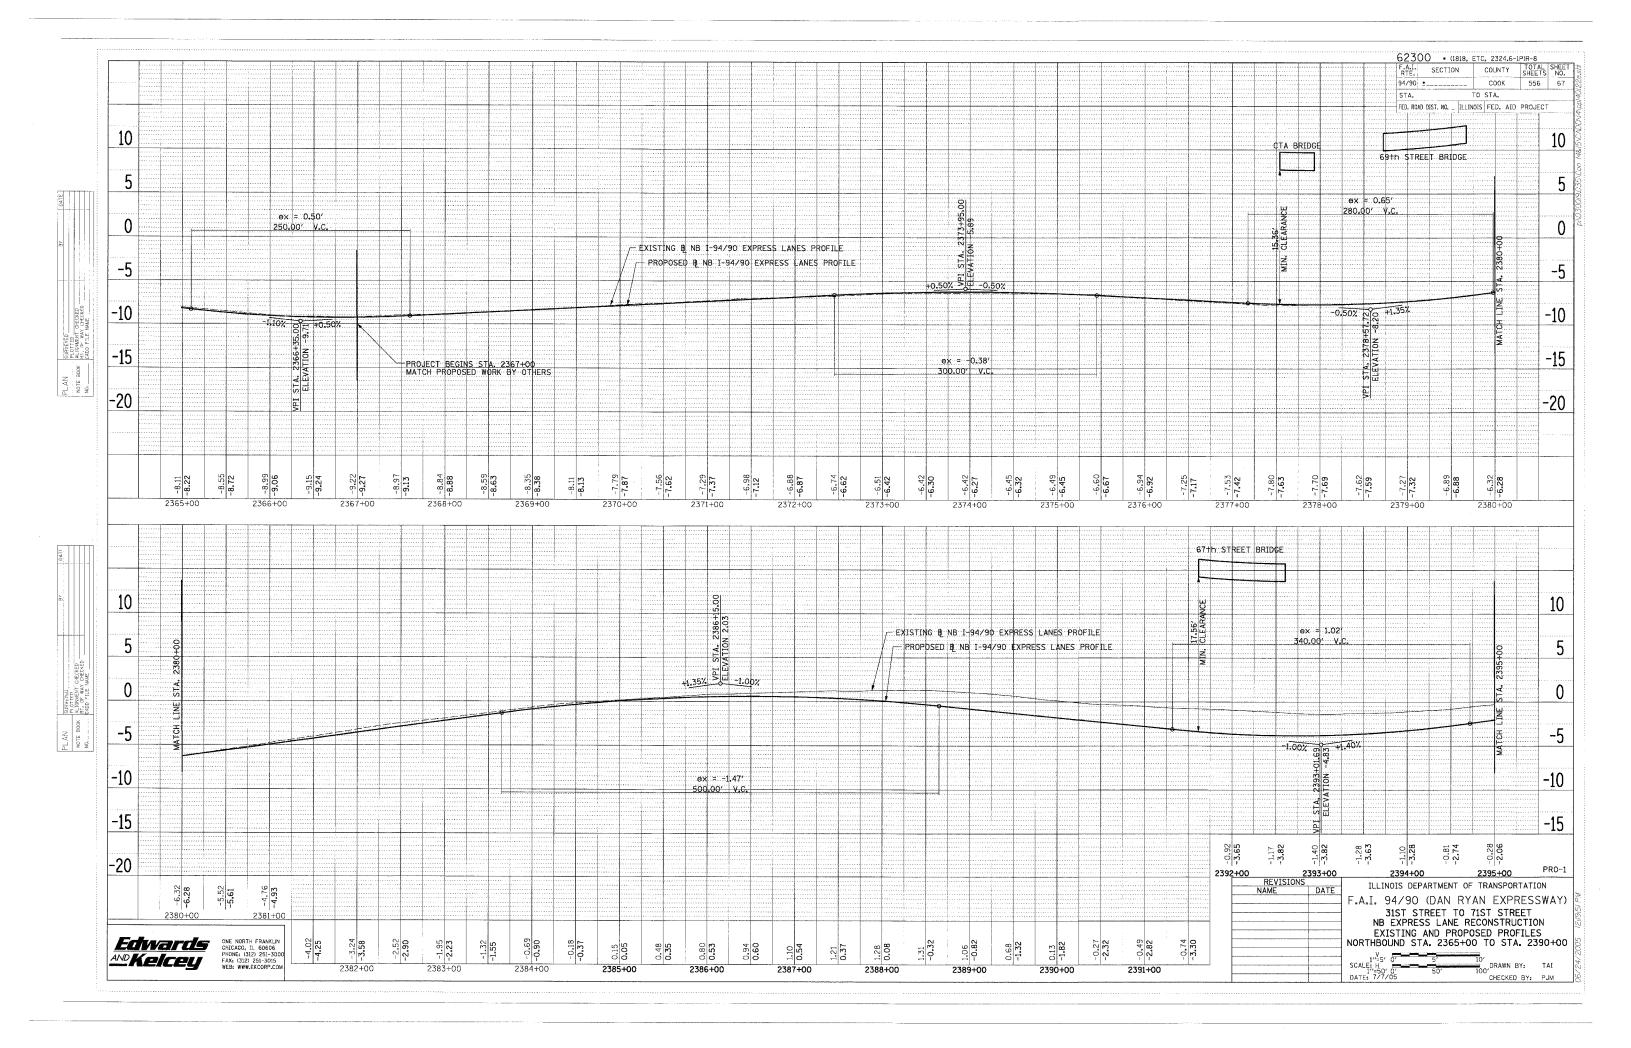


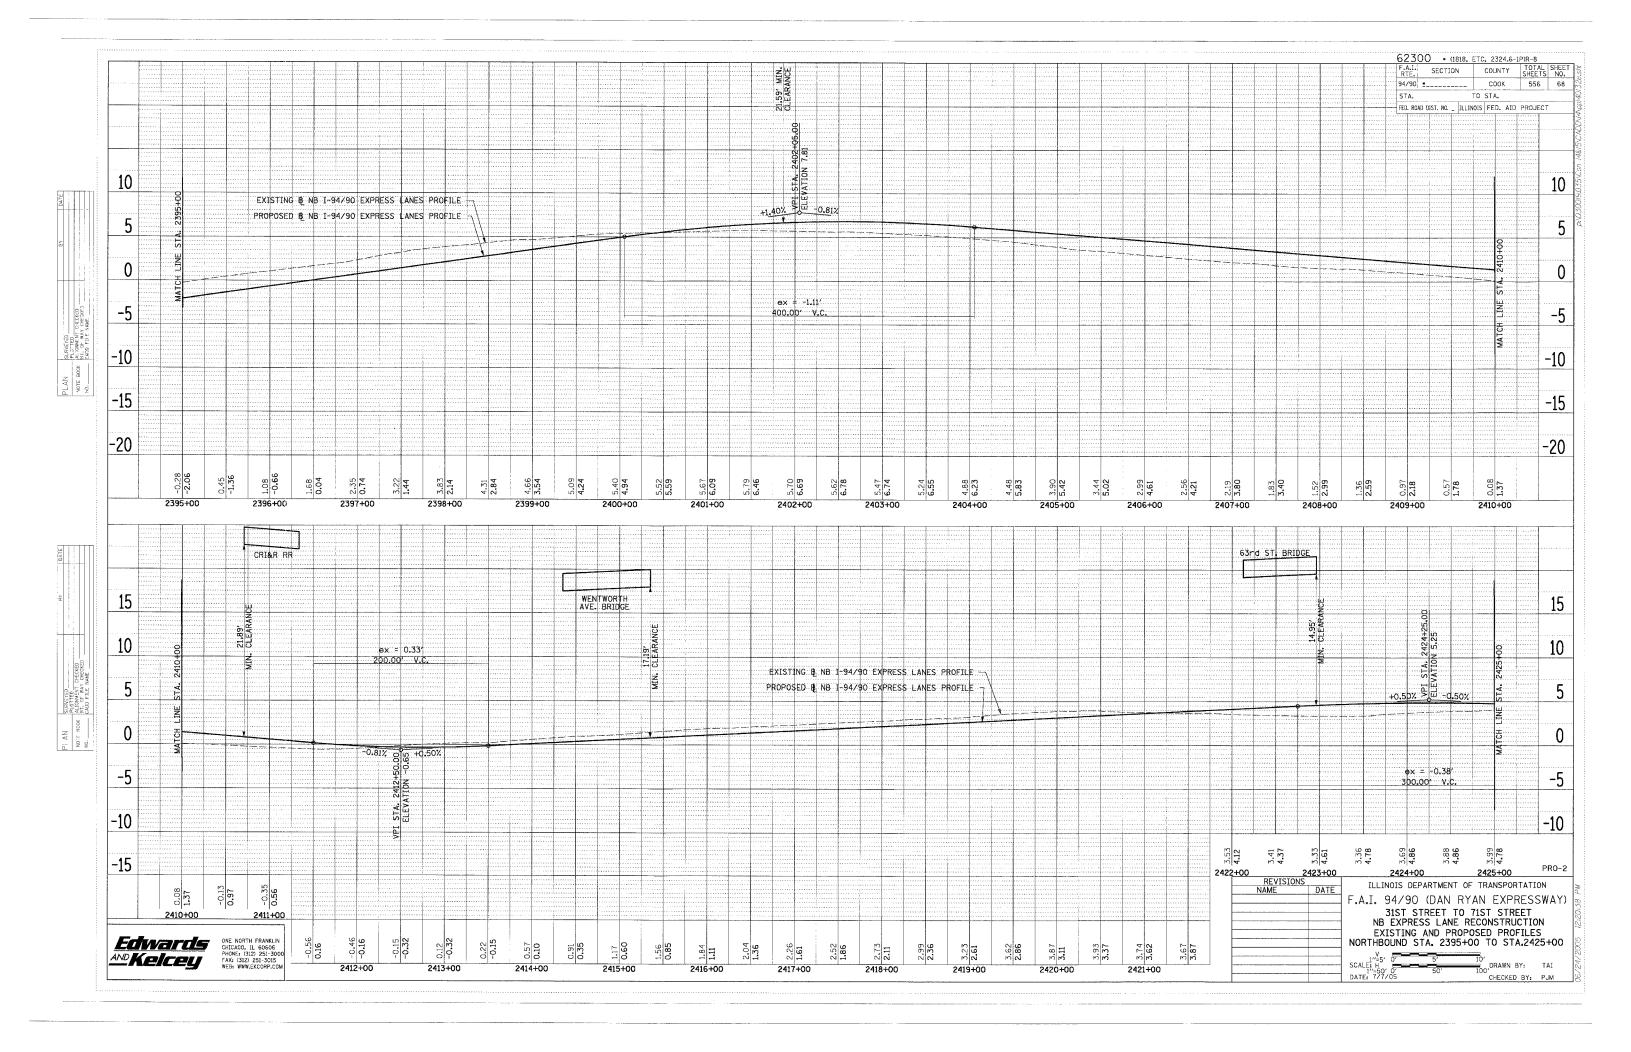


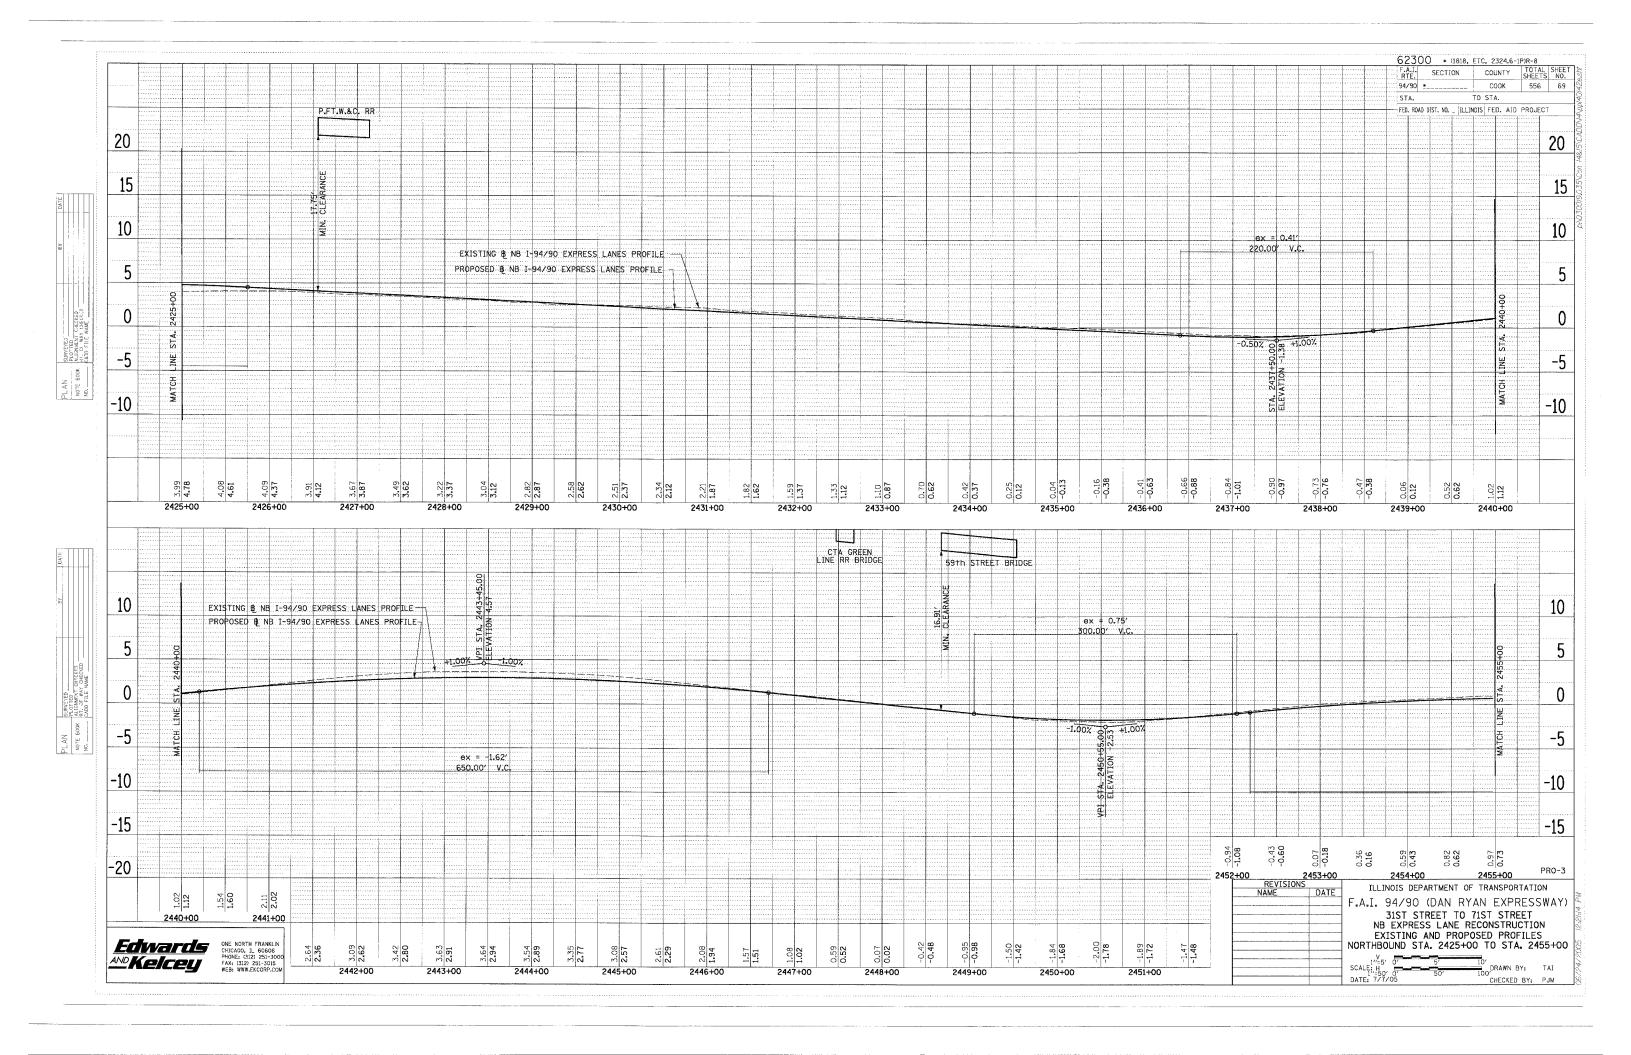


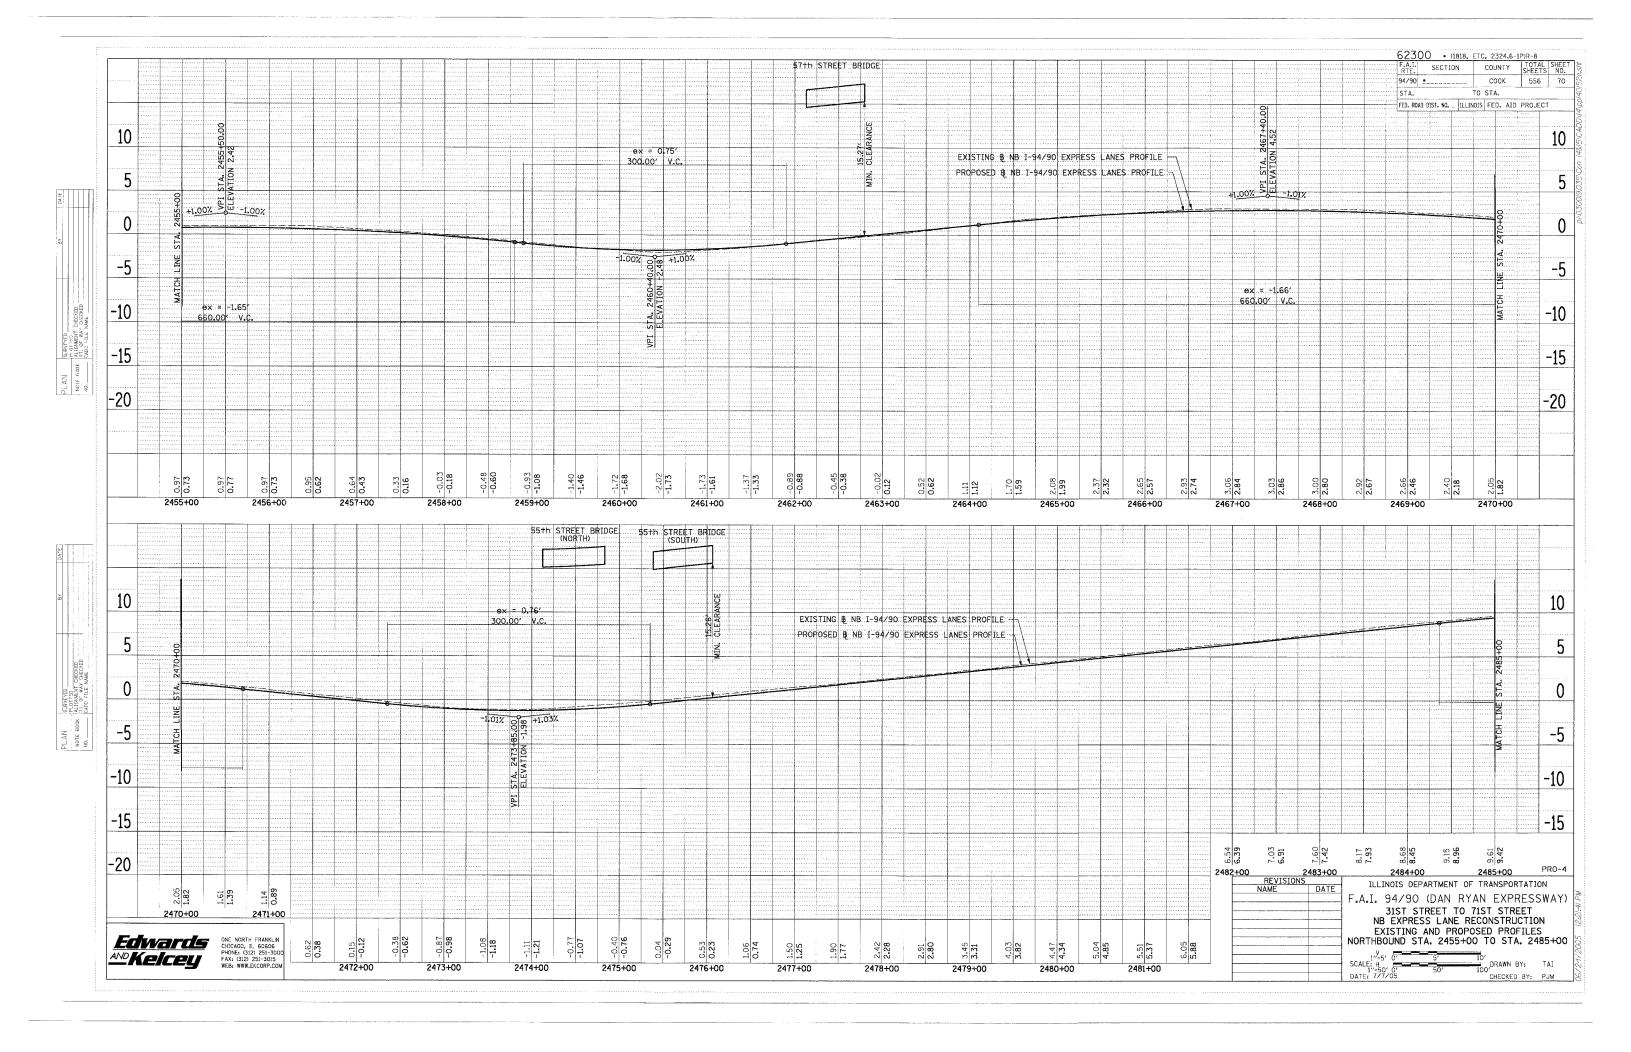


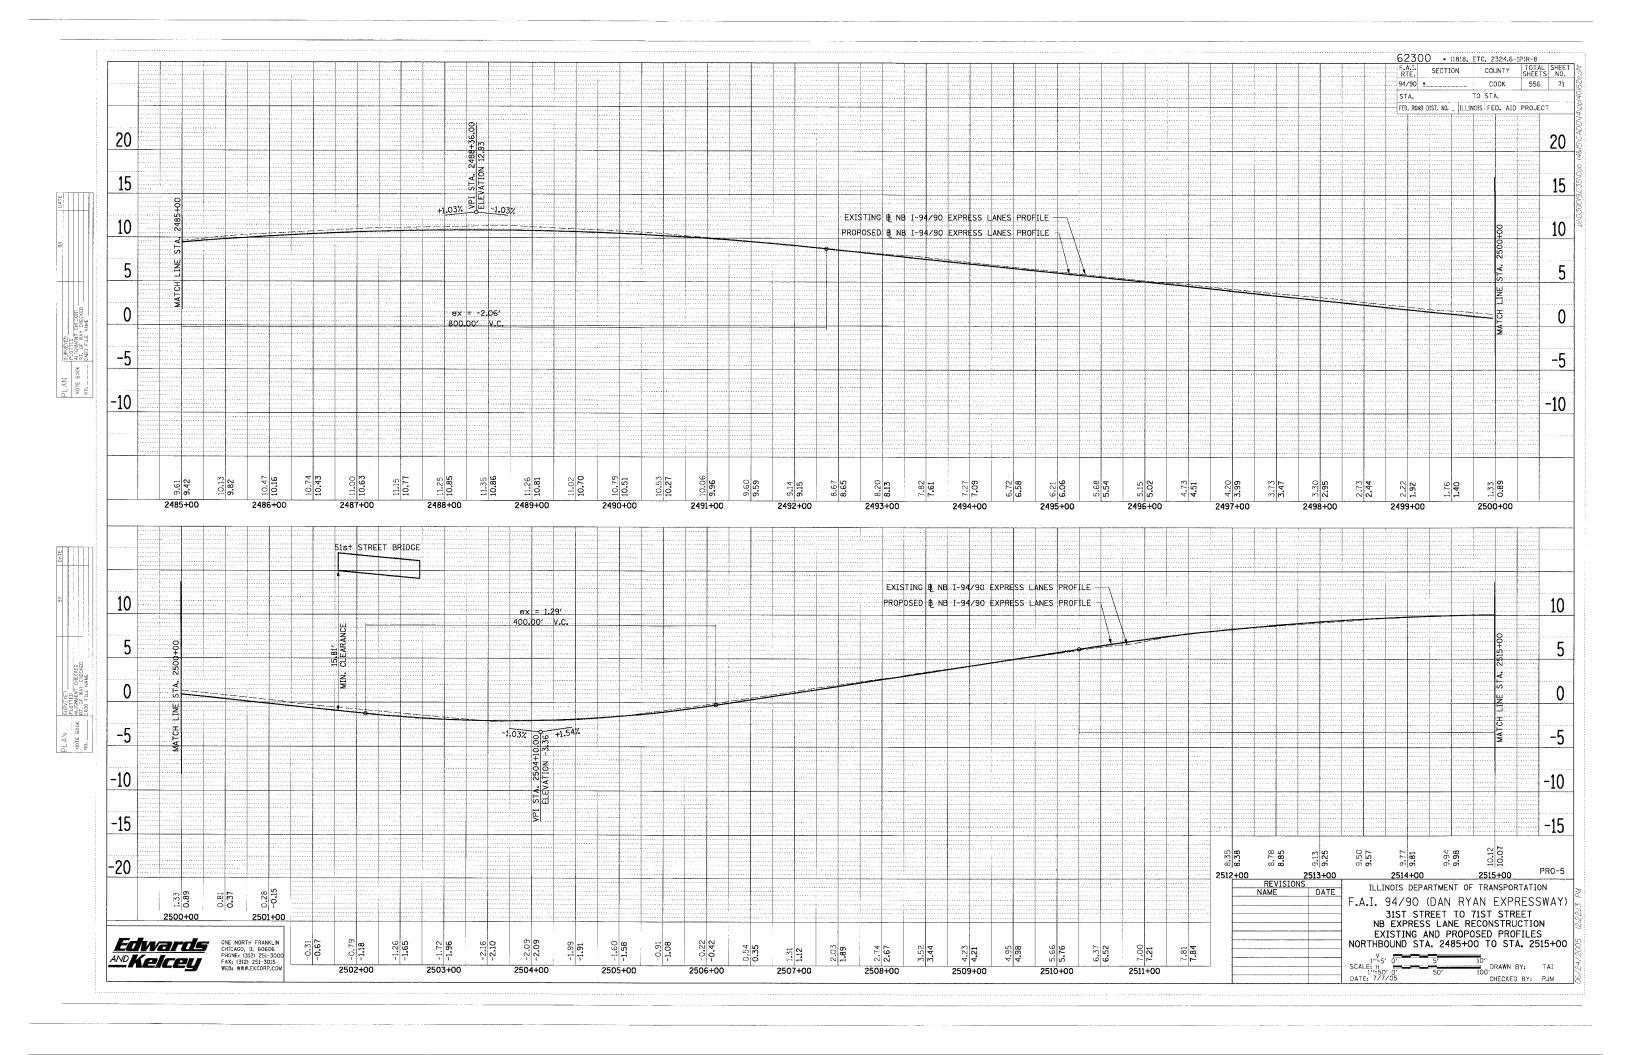


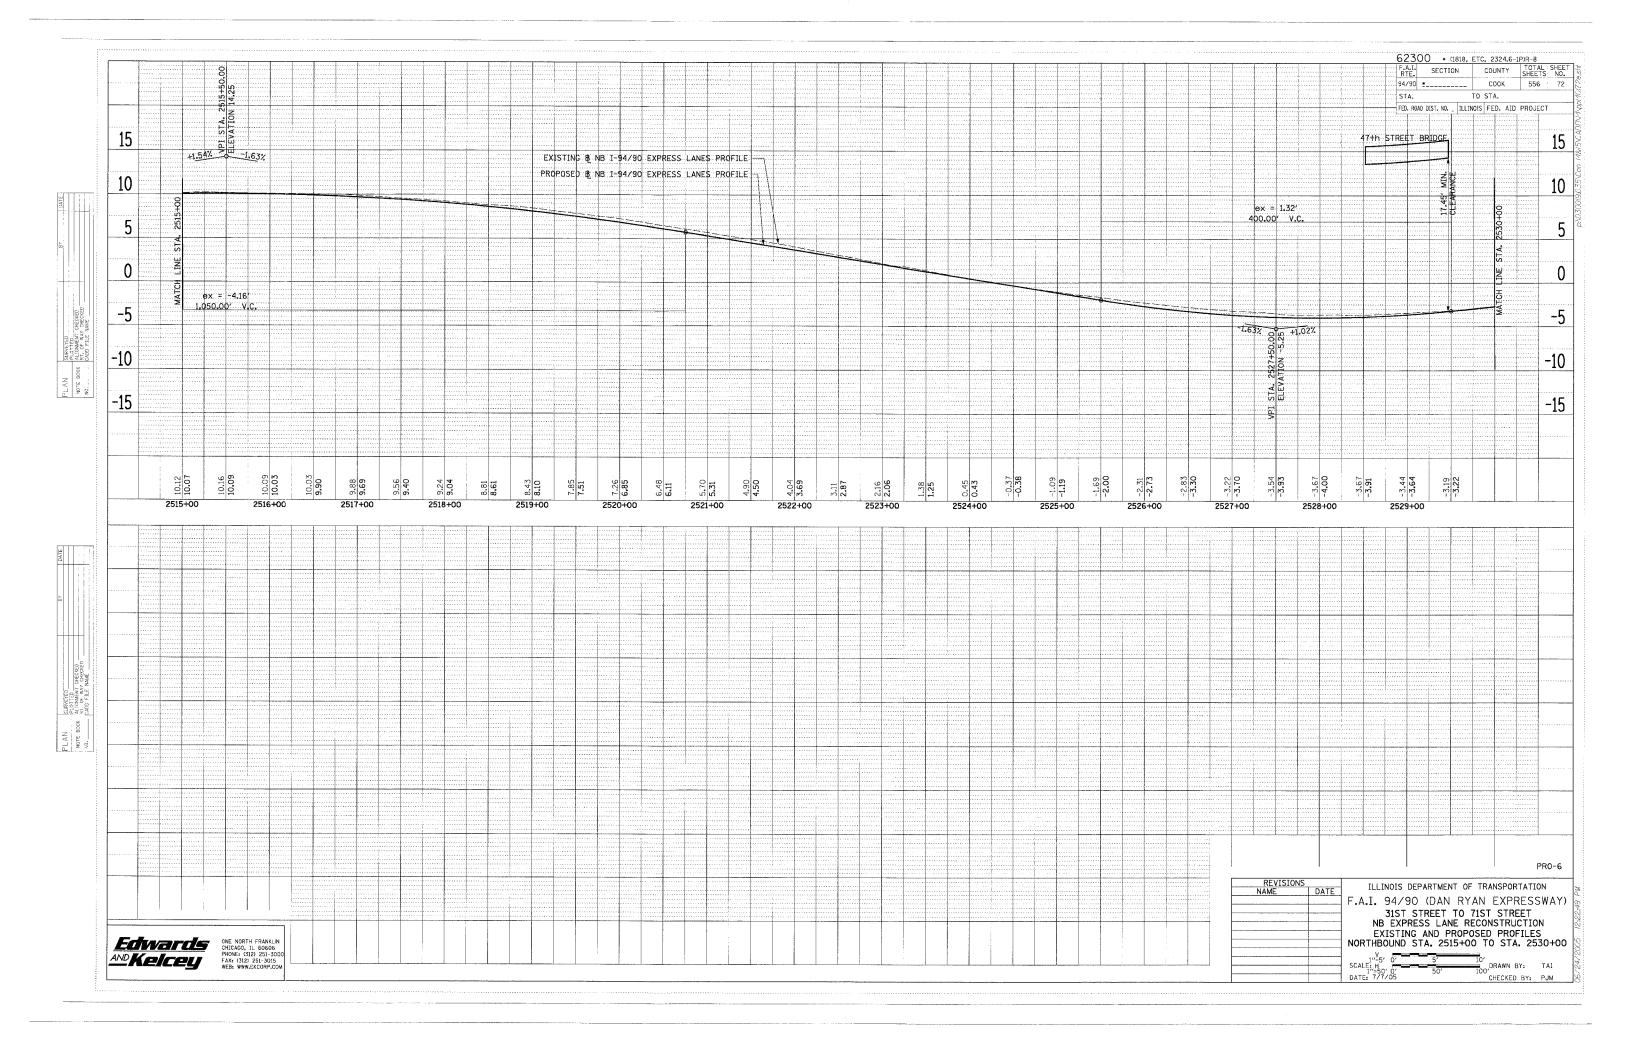


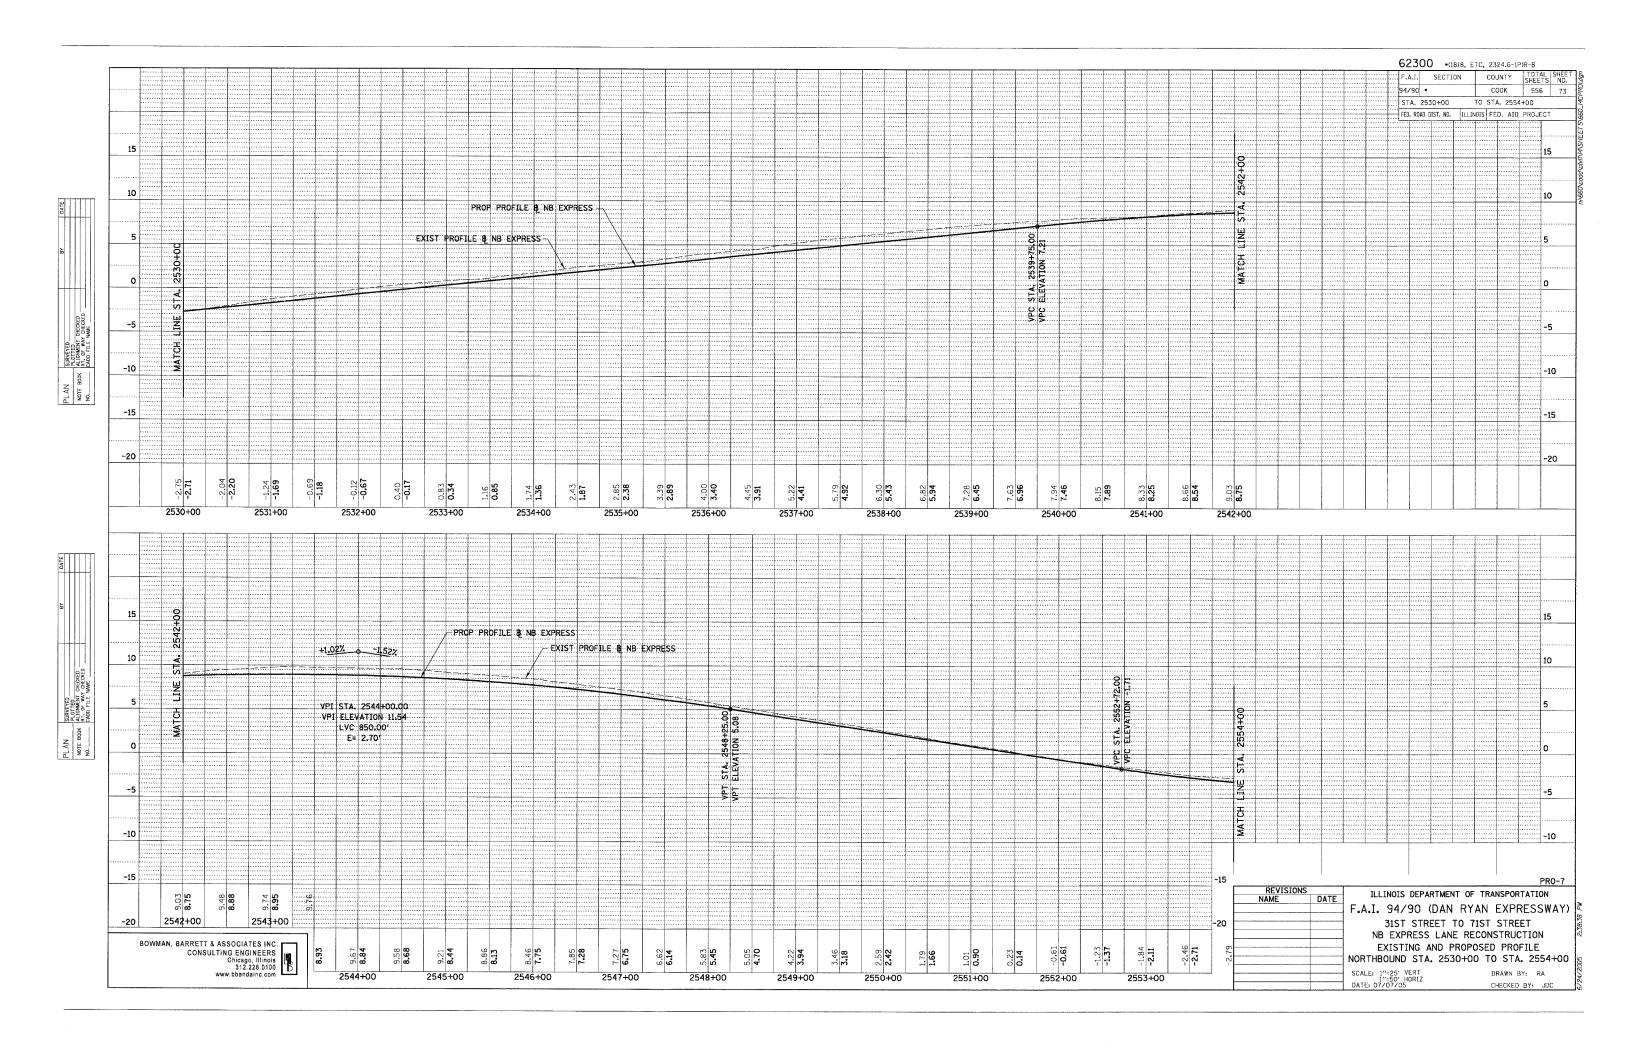


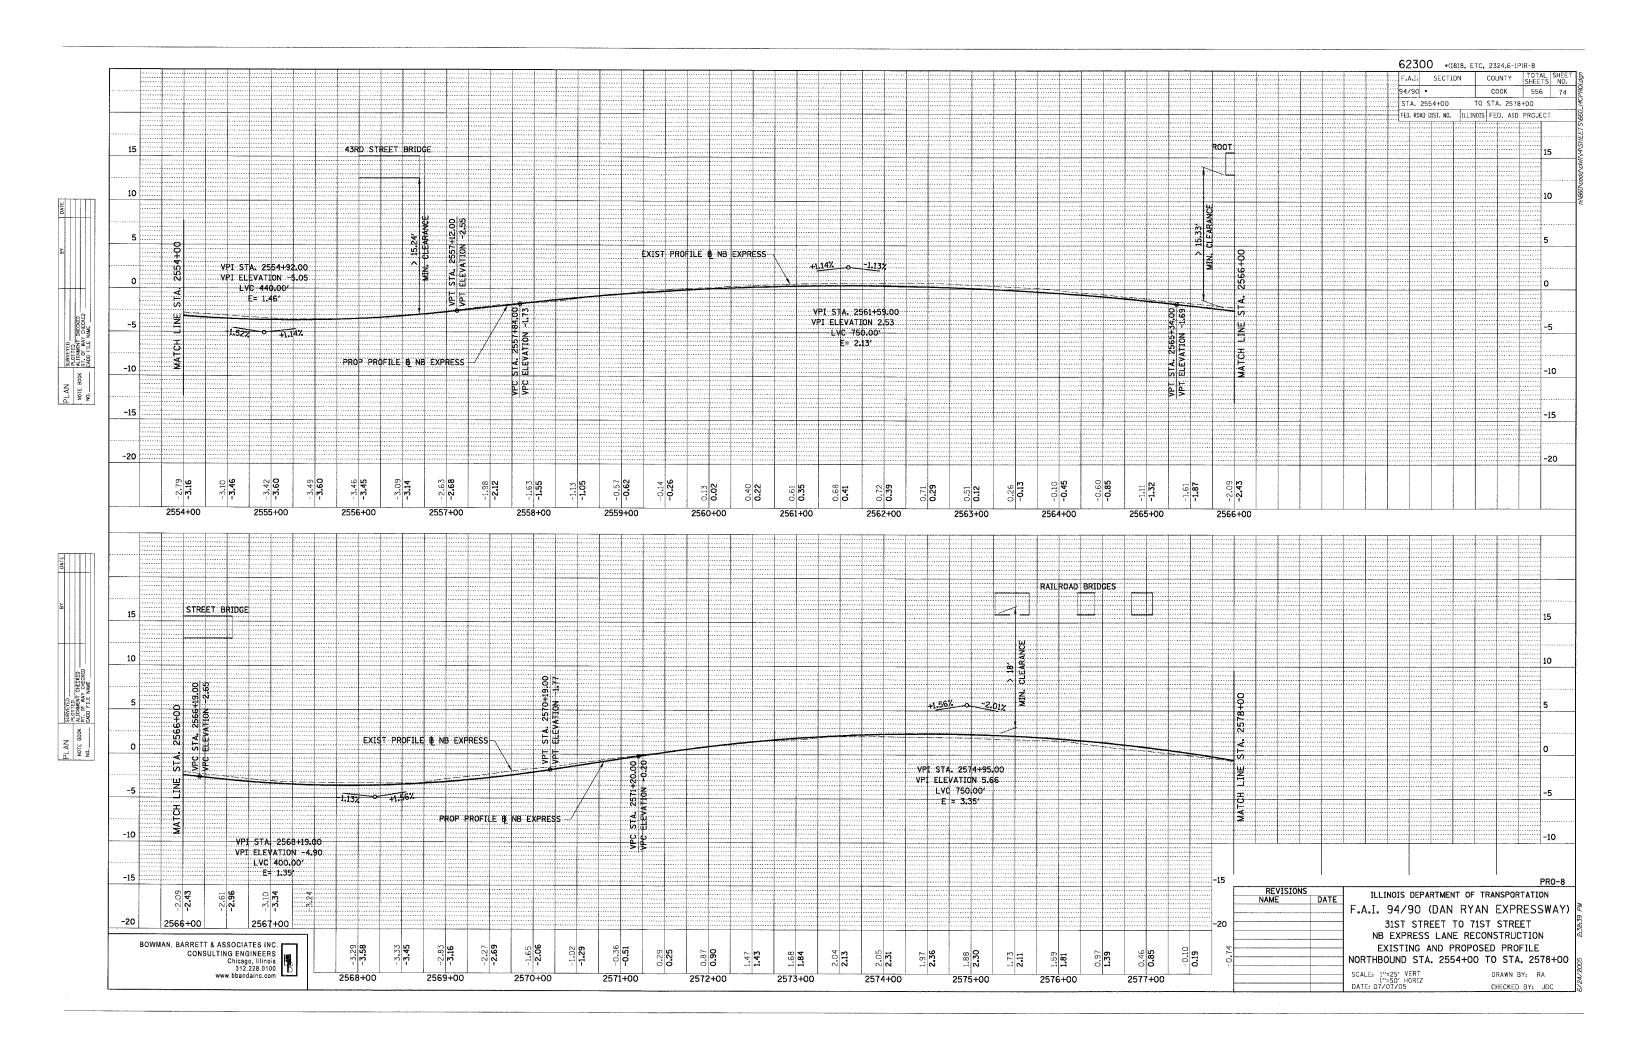


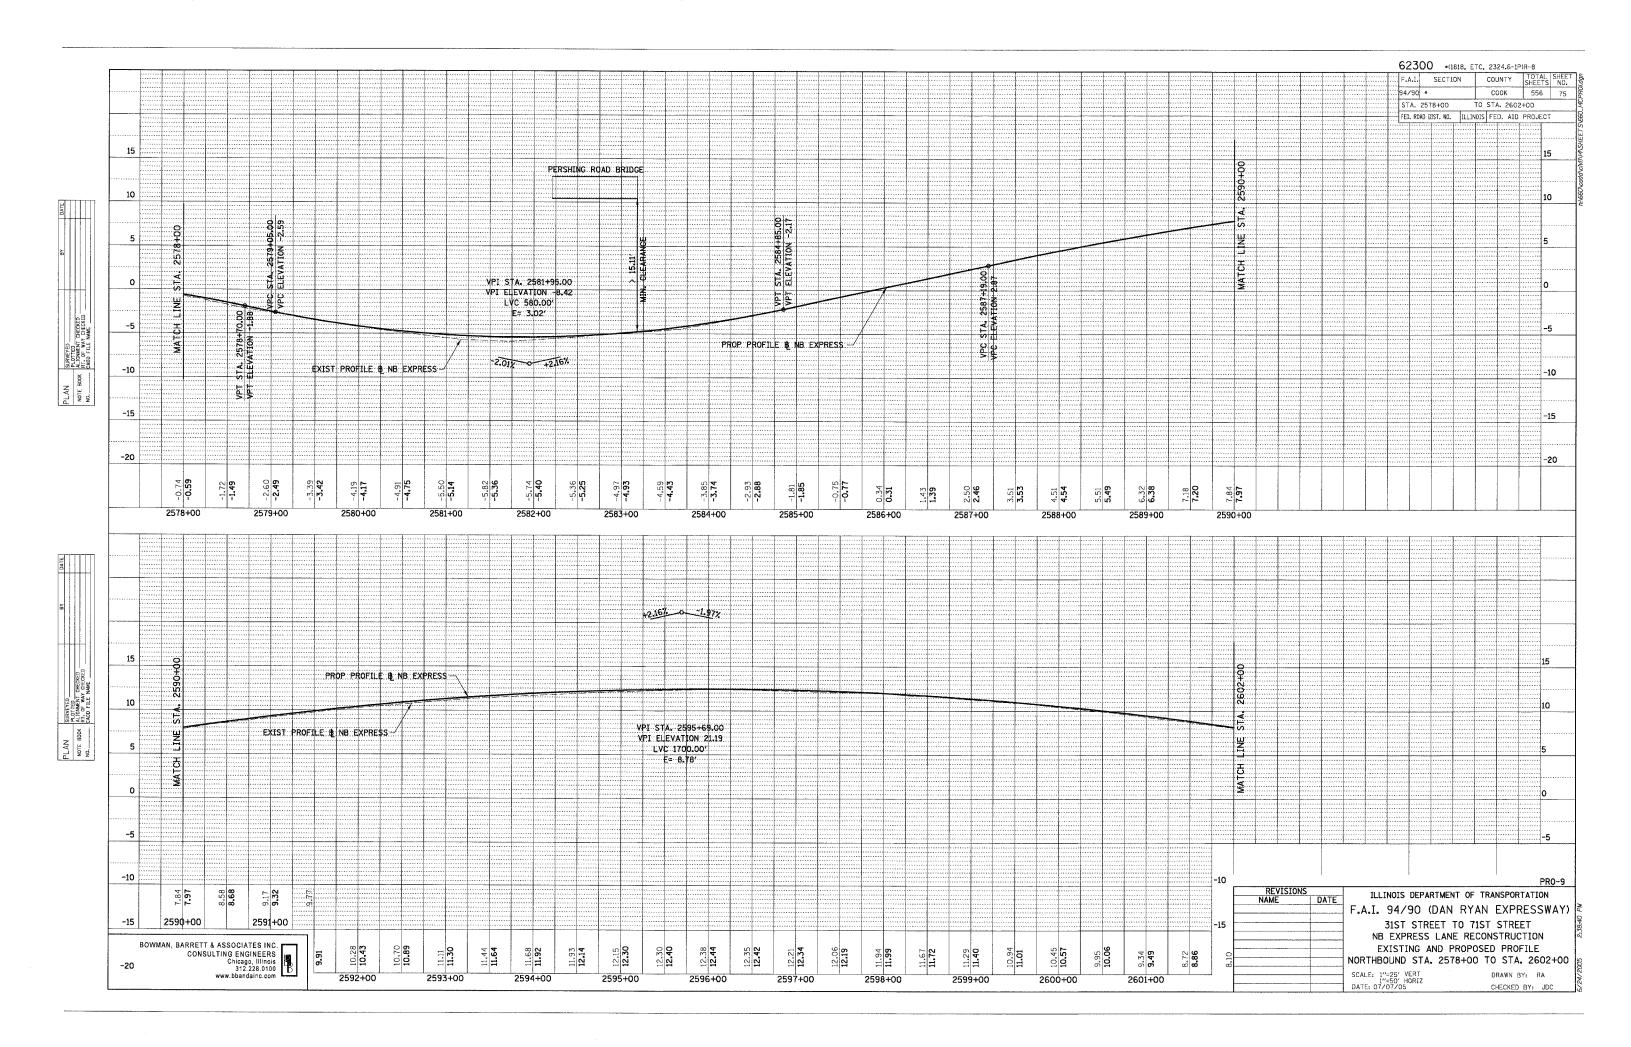


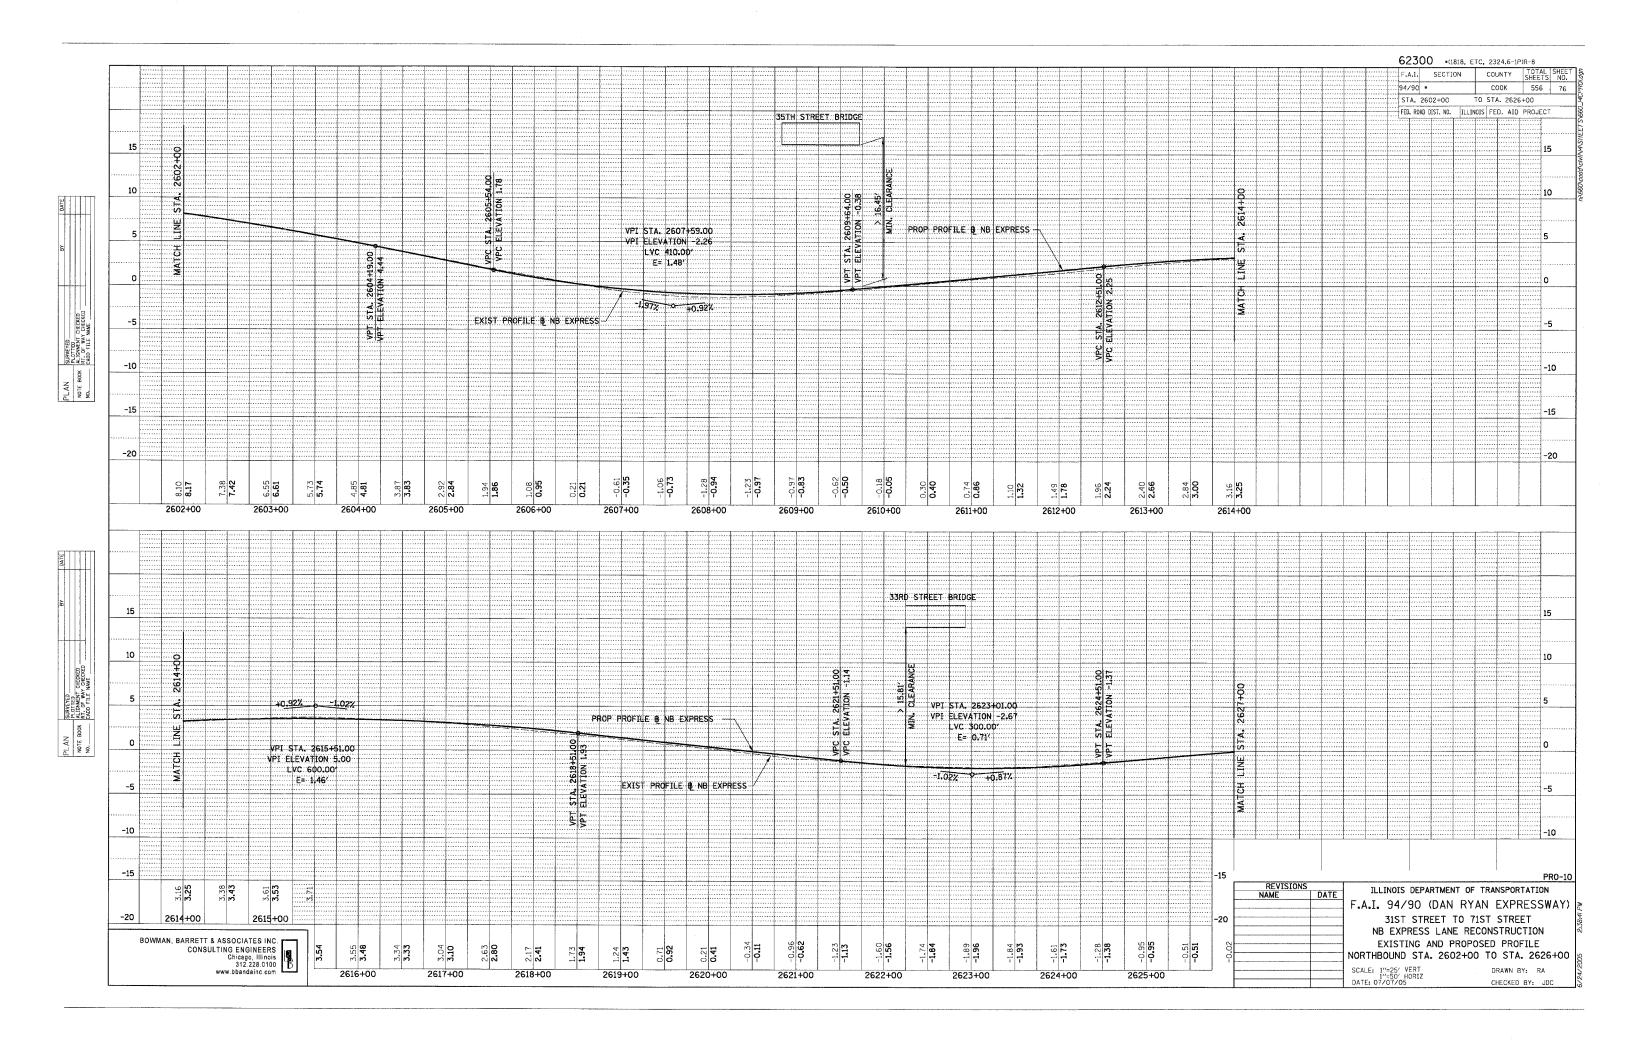

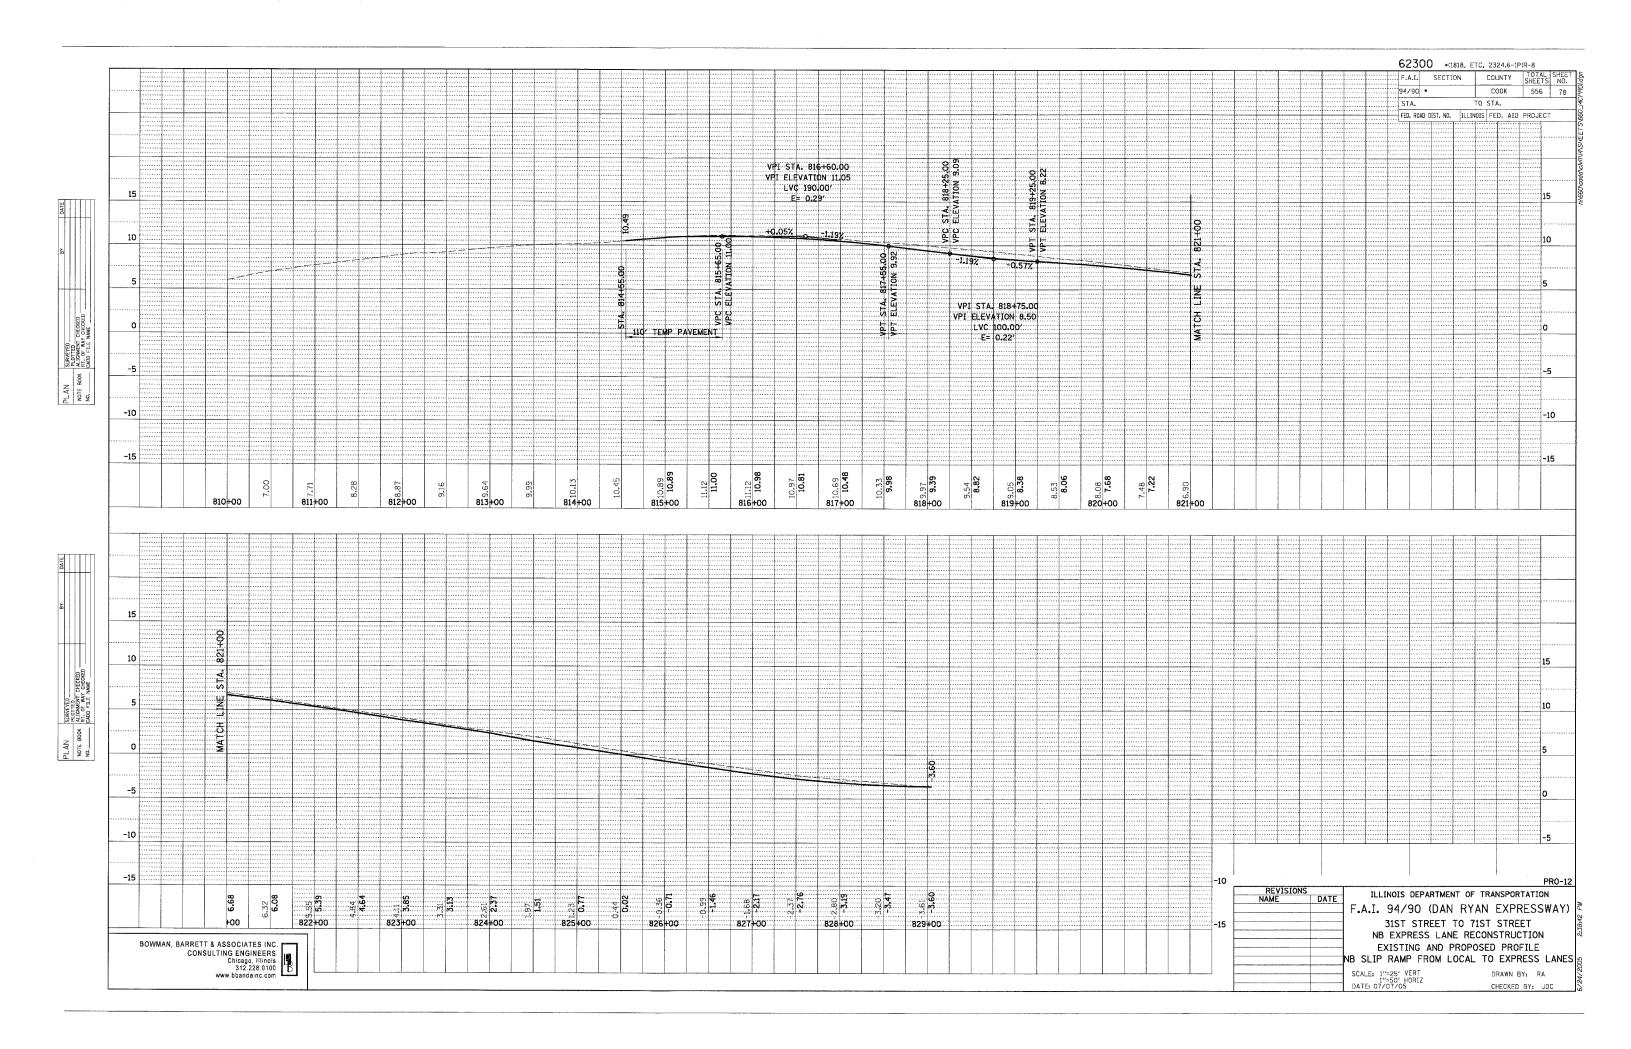

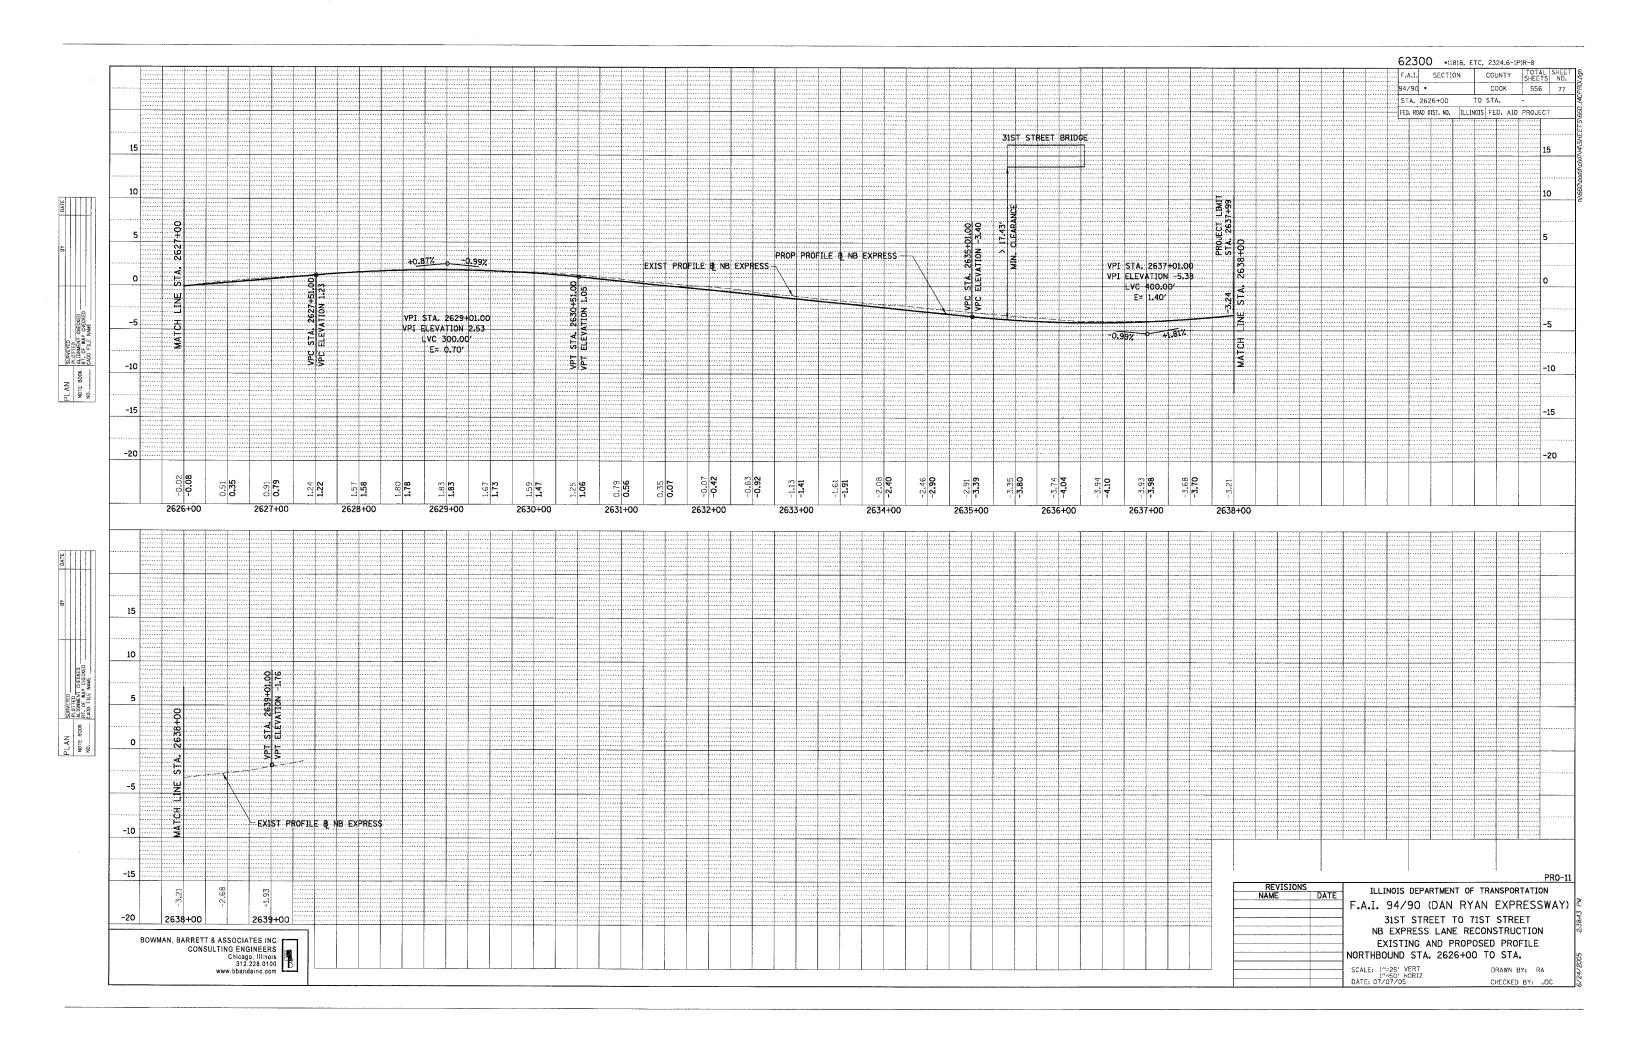

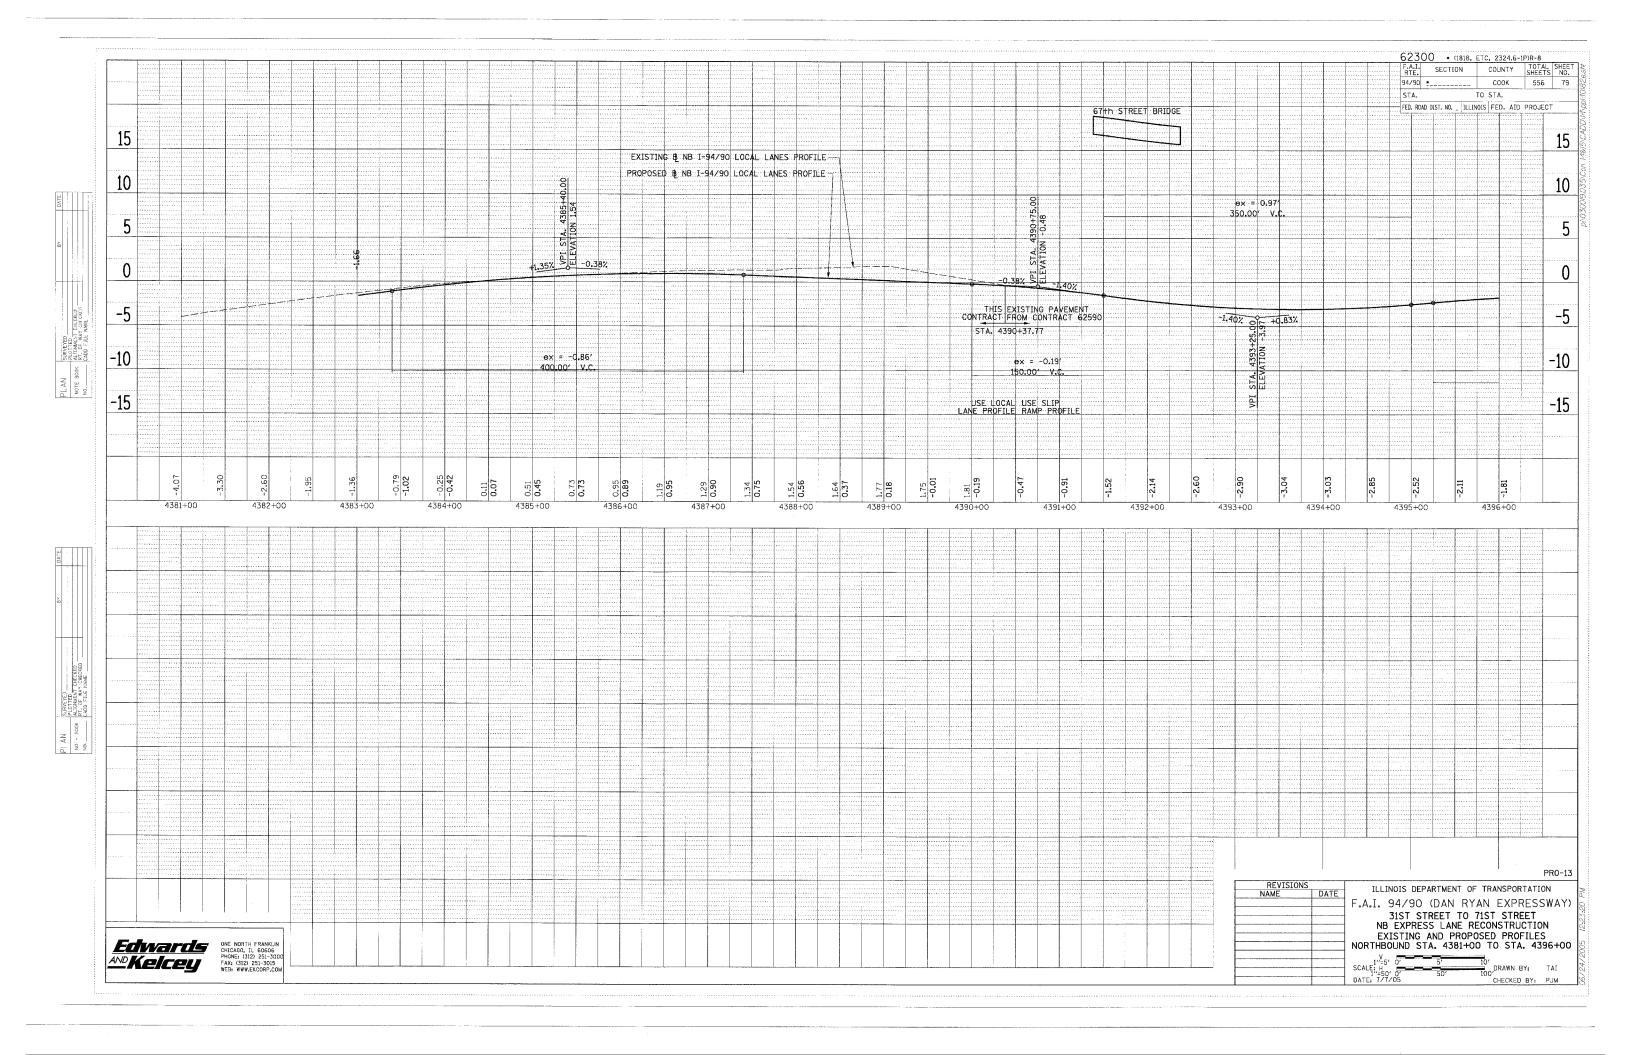

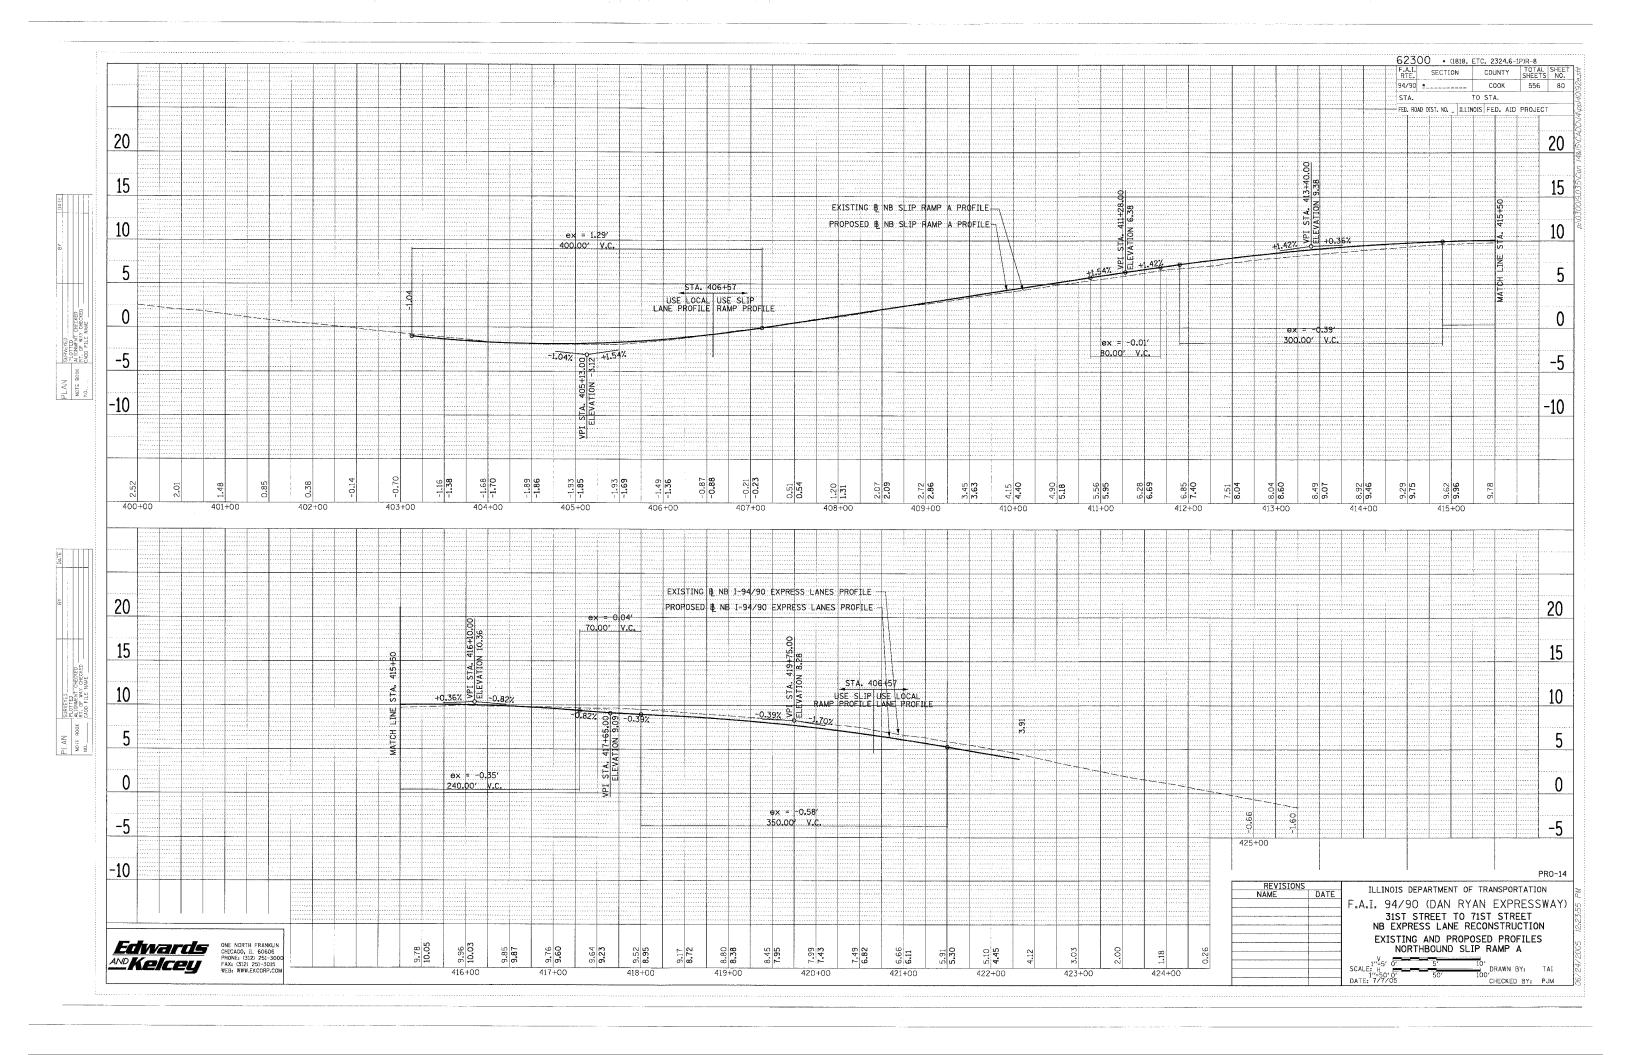

# MAINTENANCE OF TRAFFIC GENERAL NOTES

- 1. THE CONTRACTOR MUST COORDINATE ALL LANE CLOSURES WITH THE ENGINEER.
- 2. SEE SPECIAL PROVISIONS FOR PROTECTION AND COORDINATION REQUIRED WITH THE CHICAGO TRANSIT AUTHORITY.
- 3. ALL TRAFFIC CONTROL DEVICES AND SIGNAGE REQUIRED ON THE DAN RYAN EXPRESSWAY AND RAMPS IN ACCORDANCE WITH APPLICABLE IDOT DISTRICT 1 STANDARDS, IDOT HIGHWAY STANDARDS, AND THIS CONTRACT DRAWINGS IS INCLUDED IN THE COST OF TRAFFIC CONTROL AND PROTECTION (EXPRESSWAYS), AND WILL NOT BE PAID FOR SEPARATELY.
- 4. ALL EXISTING DRAINAGE STRUCTURE LIDS AND GRATES SHALL BE SECURED TO THE SATISFACTION OF THE ENGINEER AT LOCATIONS WHERE TRAFFIC IS LOCATED ON THE SHOULDERS. SECURING OF THE LIDS AND GRATES WILL NOT BE PAID FOR SEPARATELY AND IS INCLUDED IN THE CONTRACT UNIT PRICE FOR TRAFFIC CONTROL AND PROTECTION. SATISFACTION OF THE ENGINEER.
- 5. CONTRACTOR MUST COORDINATE WORK WITH IDOT CONTRACTS 62592, 62593, AND 62302.
- 6. TRAFFIC CONTROL FOR THE DAN RYAN LOCAL LANES, EXPRESS LANES, AND ALL RAMPS AS DETAILED HEREIN WILL BE PAID FOR AT THE CONTRACT LUMP SUM PRICE FOR TRAFFIC CONTROL AND PROTECTION (EXPRESSWAY),
- 7. LANE CLOSURES, RAMP CLOSURES, SIGNING, PAVEMENT MARKING AND BARRICADE PLACEMENT SHALL BE IN ACCORDANCE WITH THE INCLUDED IDOT STANDARD DRAWINGS AND IDOT DISTRICT 1 STANDARD DETAILS. CLOSURES MUST BE COORDINATED WITH THE ENGINEER.
- 8. ANY RAISED REFLECTIVE PAVEMENT MARKERS THAT CONFLICT WITH THE TEMPORARY TRAFFIC LANES SHALL HAVE THE REFLECTIVE LENSES REMOVED, AS DIRECTED BY THE ENGINEER, AND REPLACED AT THE END OF THE PROJECT. THE COST OF REMOVAL AND REPLACEMENT OF THE RAISED REFLECTIVE PAVEMENT MARKER LENSES IS INCLUDED IN THE CONTRACT UNIT PRICE FOR TRAFFIC CONTROL AND PROTECTION (EXPRESSWAYS).
- EXISTING PAVEMENT MARKINGS THAT CONFLICT WITH TEMPORARY PAVEMENT MARKINGS SHALL BE REMOVED, AS DIRECTED BY THE ENGINEER. THE REMOVAL WILL BE MEASURED IN SQUARE FEET AND PAID FOR AS PAVEMENT MARKING REMOVAL.
- 10. ALL DRUMS, VERTICAL PANELS, AND BARRICADES IMMEDIATELY ADJACENT TO THE EDGE OF TRAVELED WAY SHALL BE EQUIPPED WITH STEADY BURN MONO-DIRECTIONAL LIGHTS. CONES WILL NOT BE ALLOWED, UNLESS NOTED. ALL DRUM SPACINGS SHALL BE 100' CENTER TO CENTER, UNLESS OTHERWISE SPECIFIED.
- 11. ANY EXISTING SIGNS DENOTED WITHIN THE PLAN SET THAT DO NOT APPLY TO THE REVISED TRAFFIC PATTERNS SHALL BE REMOVED OR COVERED, AS DIRECTED BY THE ENGINEER. THE COVERING OR REMOVAL OF GROUND MOUNTED SIGNS WILL NOT BE MEASURED FOR PAYMENT BUT IS CONSIDERED INCLUDED IN THE CONTRACT UNIT PRICE FOR TRAFFIC CONTROL AND PROTECTION (EXPRESSWAYS) / (SPECIAL).
- 12. MONODIRECTIONAL PRISMATIC BARRIER REFLECTORS SHALL BE PLACED ON ALL TEMPORARY CONCRETE BARRIER WALL AS INDICATED IN THE SPECIAL PROVISIONS.
- 13. FOR THE TEMPORARY CONCRETE BARRIER ON THE DAN RYAN EXPRESSWAY LANES, THE BASE OF THE SIDE FACING TRAFFIC SHALL BE MARKED WITH A 6" LINE. THESE MARKINGS WILL BE MEASURED IN LINEAR FEET AND PAID FOR AS TEMPORARY PAVEMENT MARKING, LINE 6". WHEN THE BARRIER IS RELOCATED, THE LINE AND MONO-DIRECTIONAL PRISMATIC BARRIER REFLECTORS SHALL BE MAINTAINED.
- 14. AT LOCATIONS WHERE A HAZARD EXISTS WITHIN 4.0 FEET OF THE TEMPORARY CONCRETE BARRIER, THE BARRIER SHALL BE ANCHORED TO THE PAVEMENT. ANCHORING OF THE TEMPORARY CONCRETE BARRIER WILL NOT BE MEASURED FOR PAYMENT BUT IS INCLUDED IN THE CONTRACT UNIT PRICE FOR TEMPORARY CONCRETE BARRIER AND RELOCATE TEMPORARY CONCRETE BARRIER.
- 15. ADVANCE SIGNING AND WORK LIMIT SIGNING MUST CONFORM TO IDOT HIGHWAY STANDARDS 701400 AND 701600. SIGNS THAT INCORRECTLY IDENTIFY A WORK ZONE OR END CONSTRUCTION SHALL BE REMOVED. CONSTRUCTION WORK, TRAFFIC CONTROL, AND ADVANCE SIGNING MUST BE COORDINATED WITH ADJACENT DAN RYAN CONSTRUCTION CONTRACTS.
- 16. ADVANCED SIGNING PER IDOT DISTRICT 1 DETAIL TC-22 AND/OR CHANGABLE MESSAGE SIGNS SHALL BE USED IN ADVANCE OF ROAD WORK IN BOTH NORTHBOUND AND SOUTHBOUND DIRECTIONS, ON BOTH THE FRONTAGE ROADS AND EXPRESSWAY LANES (4 SIGNS TOTAL). THESE SIGNS WILL BE PAID FOR AT THE CONTRACT UNIT PRICE FOR TEMPORARY INFORMATION SIGNING OR CHANGABLE MESSAGE SIGN.
- 17. FOR ACCESS CONTROL, THE CONTRACTOR IS REQUIRED TO PLACE CHAIN LINK FENCE 6' (SPECIAL), 7'-2" CLEAR FROM THE CENTERLINE OF CTA TRACK, PRIOR TO REMOVING EXISTING CTA CHAIN LINK FENCE AND BARRIER WALL. THE CONTRACTOR MUST ALSO PLACE CHAIN LINK GATES, 6' X 6' SINGLE AT ALL LOCATIONS WHERE THERE ARE EXISTING CTA FENCE GATES, THE CHAIN LINK FENCE 6' (SPECIAL) MUST REMAIN IN PLACE UNTIL THE NEW PERMANENT CTA FENCE IS COMPLETED.
- 18. THE CONTRACTOR HAS THE OPTION TO USE EPOXY PAVEMENT MARKINGS IN LIEU OF PAVEMENT MARKING TAPE, TYPE III, WITH THE CONSENT OF THE ENGINEER. IF THE CONTRACTOR USES EPOXY PAVEMENT MARKING, THE COST OF REMOVAL IS INCLUDED IN THE INITIAL COST OF THE ITEM.
- 19. THE CONTRACTOR IS RESPONSIBLE FOR COORDINATING AND PROVIDING ACCESS POINTS TO THE WORK ZONE, ACCESS POINTS MUST BE APPROVED BY THE ENGINEER PRIOR TO INSTALLATION. ANY SIGNING OR ADDITIONAL TRAFFIC CONTROL DEVICES REQUIRED TO PROVIDE CONTRACTOR ACCESS TO THE WORK ZONE IS INCLUDED IN THE COST OF TRAFFIC CONTROL AND PROTECTION (EXPRESSWAYS) AND WILL NOT BE PAID FOR SEPARATELY.
- 20. THE CONTRACTOR MUST COVER OVERHEAD SIGNS FOR THE EXPRESS LANES AT 76TH AND 71ST STREETS. COVERING THESE SIGNS IS INCLUDED IN THE COST OF TRAFFIC CONTROL AND PROTECTION.



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STAGING OVERVIEW:	62300	1010 570 0701 6 1010	_

62300 \* (1818, ETC, 2324.6-1P)R-8

SECTION

94/90 .

COUNTY TOTAL SHEETS

556

COOK

PRESTAGE

THE PRESTAGE WILL OCCUR DURING DATES AS INDICATED ON THE SUGGESTED CONSTRUCTION SCHEDULE. WORK DURING THIS STAGE WILL INCLUDE ALL WORK THAT IS REQUIRED TO PLACE TRAFFIC IN STAGE 1 AND STAGE 1A, INCLUDING BUT NOT LIMITED TO PATCHING, SIGNING, PAVEMENT MARKING, TEMPORARY PAVEMENT AND TEMPORARY CONCRETE BARRIER. ALL PRESTAGE WORK WILL BE PERFORMED UNDER TEMPORARY LANE CLOSURES DURING HOURS AS APPROVED BY THE ENGINEER. ALL LANE CLOSURES MUST BE IN ACCORDANCE WITH APPLICABLE IDOT HIGHWAY STANDARDS. THE COST OF ALL LANE CLOSURES IS INCLUDED IN THE COST OF TRAFFIC CONTROL AND PROTECTION (EXPRESSWAYS) AND WILL NOT BE PAID FOR SEPARATELY.

### STAGE 1

STAGE 1 ADDRESSES THE STAGING OF TRAFFIC ON THE LOCAL LANES BETWEEN STATION 4400+96 AND THE NORTH PROJECT LIMITS. DURING THIS STAGE, 3 - 11' LANES ARE PLACED ON THE LOCAL LANES, THE EXPRESS LANES ARE CLOSED BETWEEN STATION 2391+00 AND 2644+21 WHILE ALL PAVEMENT, BARRIER WALL, AND SIGNING IS CONSTRUCTED IN THIS REGION. THE STAGE 1 WORK BETWEEN STATION 2367+00 AND 2391+00 WILL BE CONSTRUCTED IN 3 SUBSTAGES. AT THE COMPLETION OF STAGE 1, ALL CONTRACT WORK MUST BE COMPLETED, EXCEPT THE PERMANENT TIE-IN OF THE LOCAL LANES AT THE SOUTH THEIR SOUTH TERMINATION, WHICH WILL BE COMPLETED IN STAGE 2 PRIOR TO CONTRACT COMPLETION.

#### STAGE 1A

STAGE 1A INVOLVES PLACING 2 TRAFFIC LANES ON THE INSIDE OF EXISTING EXPRESSWAY PAVEMENT AND 1 LANE ON THE 67TH STREET - 71ST STREET C-D SYSTEM WHILE THE INSIDE 2 LANES AND SOUTHERN PORTIONS OF THE CENTER LANE IN THIS SECTION ARE CONSTRUCTED.

## STAGE 1B

STAGE 1B INVOLVES PLACING 2 LANES OF TRAFFIC ON THE OUTSIDE EXPRESSWAY LANES OR TEMPORARY PAVEMENT CONSTRUCTED IN STAGE 1A. 1 LANE OF TRAFFIC WILL REMAIN ON THE 67TH STREET - 71ST STREET C-D SYSTEM. DURING THIS STAGE, THE INSIDE 3 LANES WILL BE CONSTRUCTED.

### STAGE 1C

STAGE 1C INVOLVES PLACING TRAFFIC BACK ON THE INSIDE 2 LANES OF THE EXPRESSWAY IN ORDER TO MEET CONTRACT 62304 CONSTRUCTION. ONE LANE OF TRAFFIC WILL REMAIN ON THE 67TH - 71ST STREET C-D SYSTEM. THE SOUTHERN PORTION OF THE OUTSIDE LANES CAN BE CONSTRUCTED IN THIS STAGE.

### STAGE 2

OPEN A LANE OF TRAFFIC ON THE EXPRESS LANES IN ACCORDANCE WITH DATES SET FORTH IN THE SPECIAL PROVISIONS.

## STAGE 3

THIS STAGE INVOLVES CONSTRUCTING THE PERMANENT TIE IN BETWEEN THE EXPRESS AND LOCAL LANES AT THE SOUTH LIMITS OF THE DAN RYAN LOCAL LANES AND COMPLETION OF THE GORE. THIS STAGE MUST OCCUR AFTER THE EXPRESS LANES HAVE BEEN COMPLETED. DURING THIS STAGE, THE NORTHBOUND ACCESS TO THE LOCAL LANES CAN ONLY BE ACHIEVED THROUGH THE COLLECTOR DISTRIBUTOR SYSTEM.

### CHANGABLE MESSAGE SIGNS

THE CONTRACTOR IS RESPONSIBLE FOR COORDINATING THE PLACEMENT AND MESSAGES FOR ALL PORTABLE CHANGABLE MESSAGE SIGNS. PROVIDED BELOW FOR INFORMATION ONLY ARE ANTICIPATED LOCATIONS AND DURATIONS AT EACH LOCATION FOR PORTABLE CHANGABLE MESSAGE SIGNS:


LOCATION	CMS BOARDS (EACH)	TOTAL DURATION (CAL MO)
WB CHICAGO SKYWAY (I-90) AT STONY ISLAND	1	4
WB DAN RYAN (I-94) AT 95TH STREET	1	9
WB DAN RYAN (I-94) AT 75TH STREET	1	9
WB DAN RYAN (I-94) AT 71ST STREET	1	9
WB DAN RYAN (I-94/90) AT 51ST STREET	1	9
WB DAN RYAN (I-94/90) AT 31ST STREET	1	9
NB STEVENSON (I-55) AT ASHLAND AVE.	1	4
SB STEVENSON (I-55) AT MICHIGAN AVE.	1	4
NB STAGE 2 CONSTRUCTION	1	4
	TOTAL	59

MOT-1

REVISIONS	THE THOUS DEPA	ARTMENT OF TRAN	SPORTATION
NAME DA	TE   TEETHOIS DELA	TOTAL	51 01(1A1101)
	F.A.I. 94/90	(DAN RYAN E	XPRESSWAY
	— 31ST STR	EET TO 71ST S	TREET
	NB EXPRESS	LANE RECONS	TRUCTION
		NANCE OF TRAF	FIC
	GI	ENERAL NOTES	
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SCALE: DRAWN!

DATE: 7/7/05 CHECKED

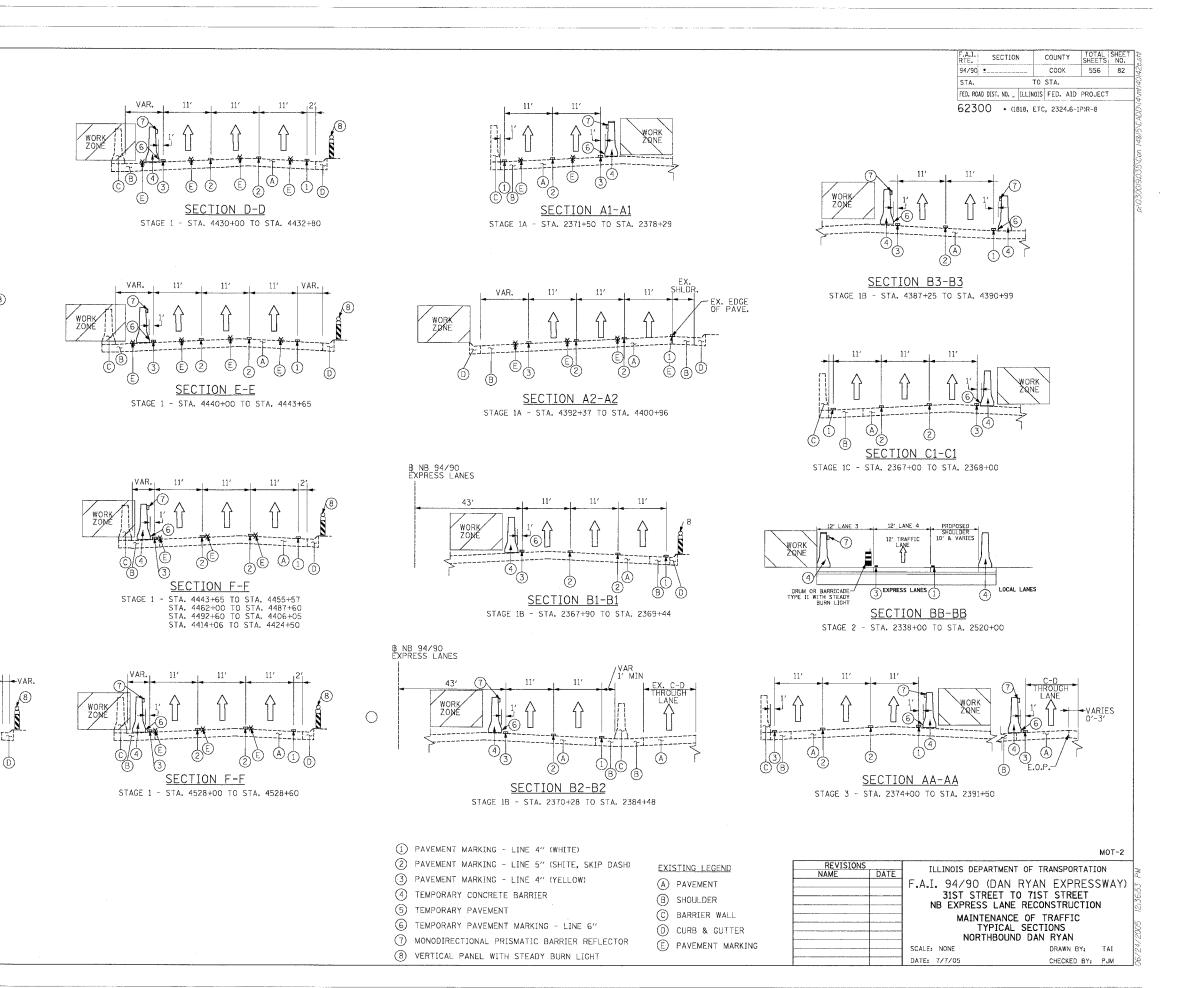

ONE NORTH FRANKLIN CHICAGO, IL 60606 PHONE. (312) 251-3000 FAX: (312) 251-3000 WEG: WHW.EKCORP.COM

B NB 94/90 LOCAL LANES

SECTION A-A

SECTION B-B

B NB 94/90 LOCAL LANES

SECTION C-C

STAGE 1 - STA. 4416+00 TO STA. 4426+22

STAGE 1 - STA. 4406+80 TO STA. 4415+00

STAGE 1 - STA. 4402+60 TO STA. 4405+60

