	INDEX OF SHEETS
SHEET NUMBE	R SHEET TITLE
1	TITLE
3	INDEX OF HIGHWAY AND DISTRICT STANDARDS, STANDARD DETAILS
4	GENERAL NOTES GENERAL NOTES
5	LEGEND
6	TYPICAL SECTIONS
7	TYPICAL SECTIONS
8	TYPICAL SECTIONS
9	TYPICAL SECTIONS
10	TYPICAL SECTIONS
11	TYPICAL SECTIONS
12	SUMMARY OF QUANTITIES
13	SCHEDULE OF QUANTITIES
14	SCHEDULE OF QUANTITIES ALIGNMENT AND BENCHMARK LOCATIONS
16	REMOVAL PLAN STA 182+50 TO 188+82
17	REMOVAL PLAN STA 188+82 TO 195+10
18	COMANCHE AVE STA 182+00 TO 185+00
19	COMANCHE AVE STA 185+00 TO 188+00
20	COMANCHE AVE STA 188+00 TO 190+85
21	COMANCHE AVE STA 190+85 TO 193+00
22	COMANCHE AVE STA 193+00 TO 196+00
23	GRADING PLAN STA 182+00 TO 185+00
24	GRADING PLAN STA 185+00 TO 188+00
25	GRADING PLAN STA 188+00 TO 190+85
26	GRADING PLAN STA 190+85 TO 193+00
27	GRADING PLAN STA 193+00 TO 196+00
29	UTILITY PLAN STA 182+00 TO 185+00 UTILITY PLAN STA 185+00 TO 188+00
30	UTILITY PLAN STA 185+00 TO 188+00 UTILITY PLAN STA 188+00 TO 190+85
31	UTILITY PLAN STA 190+85 TO 193+00
32	UTILITY PLAN STA 193+00 TO 195+00
33	NORTH PARKING LOT
34	SOUTH PARKING LOT
35	NORTH SECTION STAIRS
36	SOUTH SECTION STAIRS
37	OVERALL NORTH TRAFFIC CONTROL PLANS - STAGE 1
38	NORTH TRAFFIC CONTROL PLANS STA 181+00 TO 187+00 - STAGE
39	NORTH TRAFFIC CONTROL PLANS STA 187+00 TO 193+00 - STAGE
40	NORTH TRAFFIC CONTROL PLANS STA 193+00 TO 196+00 - STAGE
42	OVERALL SOUTH TRAFFIC CONTROL PLANS - STAGE 2 SOUTH TRAFFIC CONTROL PLANS STA 181+00 TO 187+00 - STAGE 2
43	SOUTH TRAFFIC CONTROL PLANS STA 187+00 TO 193+00 - STAGE 2
44	COLITY TRAFFIC CONTROL DIANG STA 107 00 TO 100 TO STACE 2
45	LANDSCAPE PLAN STA 182+00 TO 185+00 TO 196+00 - STAGE 2
46	LANDSCAPE PLAN STA 185+00 TO 188+00
47	LANDSCAPE PLAN STA 188+00 TO 190+85
48	LANDSCAPE PLAN STA 190+85 TO 193+00
49	LANDSCAPE PLAN STA 193+00 TO 196+00
50	LANDSCAPE PLAN - NORTH PARKING LOT
51	LANDSCAPE NOTES, DETAILS & PLANT LIST
52	LANDSCAPE DETAILS
53 54	IRRIGATION PLAN STA 188+00 TO 190+85
	IRRIGATION PLAN STA 190+85 TO 193+00 IRRIGATION PLAN STA 193+00 TO 196+00
	LIGHTING COMANCHE AVE STA 181+00 TO 184+00
	LIGHTING COMANCHE AVE STA 181+00 TO 187+00
	LIGHTING COMANCHE AVE STA 187+00 TO 190+00
	LIGHTING COMANCHE AVE STA 190+00 TO 193+00
	LIGHTING COMANCHE AVE STA 193+00 TO 196+00
	LIGHTING PARKING LOTS COMANCHE AVE 194+00
	ELECTRICAL DETAILS
63	ELECTRICAL SCHEDULES AND DETAILS
	ELECTRICAL DETAILS
	CROSS SECTIONS
	CROSS SECTIONS
	STANDARD DETAILS
	STANDARD DETAILS
	DISTRICT 3 STANDARD DETAILS
	DISTRICT 3 STANDARD DETAILS DISTRICT 3 STANDARD DETAILS
71	DISTRICT O STANDARD DETAILS


STATE OF ILLINOIS
DEPARTMENT OF TRANSPORTATION PLANS FOR PROPOSED

SHABBONA DOWNTOWN STREETSCAPE

VILLAGE OF SHABBONA

ILLINOIS TRANSPORTATION ENHANCEMENT PROGRAM

FAP ROUTE 573 (US 30) SHABBONA ROAD TO ILLINI STREET SECTION 23-00019-01-LS PROJECT U4SL(231) DEKALB COUNTY C-93-028-24

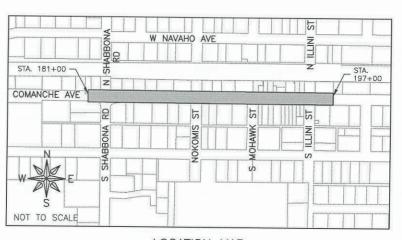


LOCATION MAP FAP ROUTE 573 / COMANCHE AVE (MINOR ARTERIAL) TOWNSHIP 38 NORTH, RANGE 3 EAST 2021 ADT = 4276LENGTH OF PROJECT = 0.26 MILES NET LENGTH OF PROJECT = 0.26 MILES

ENGINEERING & ENVIRONMENTAL

ILLINOIS

IOWA

WISCONSIN

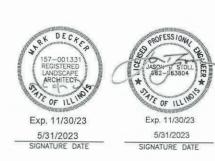




HORIZONTAL	20	0	20	40	60	FEET
VERTICAL	5	0	5	10	15	FEET

PLAN & PROFILE

HORIZONTAL	10	0	10	20	30	FEE
VERTICAL	5	0	5	10	15	FEE

CROSS SECTIONS

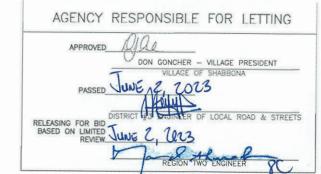



_	IN	٨
	111	H

ORIGINA	L SET FOR PROJECT: 19-366	DATE CREATED: 05/17/2023
	REVISION	IS
REV. NO.	DESCRIPTION	N DATE

a\c30\19\19-366\Pions\19-366\Pions\49, TITLE CONTRACT # 87841

ILLINOIS PROFESSIONAL DESIGN FIRM NUMBER: 184003525 PRINTED BY AUTHORITY OF STATE OF ILLINOIS

HIGHWAY STANDARDS

280001-07 TEMPORARY EROSION CONTROL SYSTEMS

424026-03 ENTRANCE/ALLEY PEDESTRIAN CROSSINGS

442201-03 CLASS C AND D PATCHES

602306-03 INLET-TYPE B

602401-07 PRECAST MANHOLE TYPE A 4' (1.22M) DIAMETER

602402-03 PRECAST MANHOLE TYPE A 5' (1.52M) DIAMETER

604001-05 FRAME AND LIDS TYPE 1

604006-05 FRAME AND GRATE TYPE 3

604036-03 GRATE TYPE 8

606001-08 CONCRETE CURB TYPE B AND COMBINATION CURB AND GUTTER

640001-01 SIGHT SCREEN CHAIN LINK FENCE

701006-05 OFF-ROAD OPERATIONS, 2L, 2W, 15' (4.5M) TO 24" (600 MM) FROM PAVEMENT EDGE

701201-05 LANE CLOSURE, 2L, 2W, DAY ONLY, FOR SPEEDS ≥ 45MPH

701301-04 LANE CLOSURE, 2L, 2W, SHORT TIME OPERATIONS

701501-06 LANE CLOSURE, 2L, 2W, UNDIVIDED

701801-06 SIDEWALK, CORNER OR CROSSWALK CLOSURE

701901-08 TRAFFIC CONTROL DEVICES

720001-01 SIGN PANEL MOUNTING DETAILS

720006-04 SIGN PANEL ERECTION DETAILS

720011-01 METAL POSTS FOR SIGNS, MARKERS & DELINEATORS

729001-01 APPLICATIONS OF TYPES A & B METAL POSTS (FOR SIGNS & MARKERS)

780001-05 TYPICAL PAVEMENT MARKINGS

836001-04 LIGHT POLE FOUNDATION

DISTRICT 3 STANDARDS (SEE SHEETS 69 THRU 71 FOR DETAILS)

406-8 HMA DETAIL AT BUTT JOINTS

423-1 PCC URBAN ENTRANCES

424-32 DETAIL OF CONCRETE STEPS

509-1 PIPE HANDRAIL FOR STEPS

602-2 INLET ADJUST

606-9 CURB AND GUTTER REPLACEMENT AT INLET

703-1 SHORT TERM PAVEMENT MARKINGS

780-22 TYPICAL PARKING SPACING

STANDARD DETAILS

7" CONCRETE PAVEMENT SECTION (PAY CODE 42300300, SHEET 67)

SIDEWALK DETAIL (PAY CODE 42400200, SHEET 67)

PEDESTRIAN RAILING DETAIL (PAY CODE 50900805, SHEET 68)

TRENCH DRAIN SECTION (SHEET 67)

90 DEGREE PARKING STRIPE DETAIL (SHEET 67)

FEHR GRAHAM

ENGINEERING & ENVIRONMENTAL

ILLINOIS IOWA WISCONSIN WNER/DEVELOPER:
VILLAGE OF SHABBONA
206 S. BLACKHAWK ST
SHABBONA, IL 60550

PROJECT AND LOCATION:
SHABBONA DOWNTOWN
STREETSCAPE
SHABBONA, IL

DRAWN BY: JMV
APPROVED BY: BS
DATE: 05/17/2023
SCALE: AS NOTED

REVISIONS		
REV. NO.	DESCRIPTION	DATE
	·	

INDEX OF HIGHWAY AND DISTRICT STANDARDS, STANDARD DETAILS

SET TYPE: FINAL

SHEET NUMBER: 2 of 71

JOB NUMBER:

19-366

CONTRACT NO. 87841 SECTION NO. 23-00019-01-LS

GENERAL NOTES

- THIS PROJECT SHALL BE CONSTRUCTED IN ACCORDANCE WITH THE MUNICIPAL CODE, VILLAGE OF SHABBONA, ILLINOIS, CURRENT EDITION, THE ILLINOIS DEPARTMENT OF TRANSPORTATION'S "STANDARD SPECIFICATIONS FOR ROAD AND BRIDGE CONSTRUCTION", "ADOPTED JANUARY 1, 2022, "SUPPLEMENTAL SPECIFICATIONS AND RECURRING SPECIAL PROVISIONS," CURRENT EDITION, SPECIAL PROVISIONS AND THE "STANDARD SPECIFICATIONS FOR WATER AND SEWER MAIN CONSTRUCTION ILLINOIS", CURRENT EDITION. SIGN CONSTRUCTION AND PAVEMENT MARKINGS SHALL CONFORM TO THE REQUIREMENTS OF THE "MANUAL ON UNIFORM TRAFFIC CONTROL DEVICES". CURRENT EDITION.
- 2. AS PART OF THE BIDDING PROCEDURE, THE CONTRACTOR SHALL VERIFY THAT THE QUANTITIES FOR PAY ITEMS, AS PRESENTED IN THESE PLAN DOCUMENTS, ARE SUBSTANTIALLY CORRECT. IF DISCREPANCIES ARE DETECTED, THE CONTRACTOR SHALL NOTIFY THE ENGINEER OF THE DISCREPANCY PRIOR TO THE BID DATE.
- 3. GENERAL SAFETY PROVISION: TO PROVIDE DRIVERS WITH SAFE TRAVEL CONDITIONS DURING THE CONSTRUCTION PROJECT, GENERAL SAFELY PROVISION: 10 PROVIDE DRIVERS WITH SAFE TRAVEL CONDITIONS DURING THE CONSTRUCTION PROJECT, AND TO PROVIDE SAFE WORKING CONDITIONS FOR ALL EMPLOYEES, THE RULES, REGULATIONS, AND CONDITIONS STATED BELOW WILL PREVAIL FOR THE DURATION OF THIS CONTRACT. ANY EMPLOYEE OF THE CONTRACTOR OR HIS SUBCONTRACTORS WHO REFUSES TO COMPLY WITH THESE GENERAL SAFETY PROVISIONS SHALL BE REMOVED FROM THE JOB SITE IN ACCORDANCE WITH STATE AND LOCAL REQUIREMENTS. THE CONTRACTOR AND ANY SUBCONTRACTORS RETAINED BY HIM SHALL COMPLY WITH THE STATE AND FEDERAL REQUIREMENTS OF THE OCCUPATIONAL SAFETY AND HEALTH ACT OF 1970 (OSHA), JULY 1, 1987 AS IT RELATES TO CONTRACTOR'S OPERATIONS.
- 4. THE CONTRACTOR SHALL COMPLY WITH ALL STATE REGULATIONS REGARDING AIR, WATER, AND NOISE POLLUTION. THE CONTRACTOR WILL NOT BE ALLOWED TO BUILD FIRES ON THE SITE.
- 5. THE SCALE SHOWN ON THE DRAWINGS APPLIES ONLY TO THE FULL SIZE PLANS NOT THE REDUCED SIZE PLANS.
- 6. IT SHALL BE THE CONTRACTOR'S RESPONSIBILITY TO MAINTAIN DRAINAGE FLOWS AT ALL TIMES DURING THE PERFORMANCE OF THE WORK. METHODS USED BY THE CONTRACTOR SHALL BE SUBJECT TO THE APPROVAL OF THE ENGINEER. COST OF MAINTAINING DRAINAGE FLOWS SHALL BE INCIDENTAL TO THE CONTRACT.
- 7. WHERE SECTION OR SUBSECTION MONUMENTS ARE ENCOUNTERED. THE ENGINEER SHALL BE NOTIFIED BEFORE SUCH MONUMENTS ARE REMOVED OR DISTURBED. THE CONTRACTOR SHALL PROTECT AND CAREFULLY PRESERVE ALL PROPERTY MARKERS, MONUMENTS AND RICHT-OF-WAY PINS UNTIL THE OWNER, AND AUTHORIZED SURVEYOR, OR AGENT HAS WITNESSED OR OTHERWISE REFERENCED THEIR LOCATION. THE CONTRACTOR SHALL BE RESPONSIBLE FOR HAVING AN AUTHORIZED SURVEYOR RE-ESTABLISH ANY SECTION OR SUBSECTION MONUMENTS DESTROYED BY HIS OPERATIONS. REPLACEMENT OF MONUMENTS WILL BE DETERMINED BY THE ENGINEER.
- 8. AT THE END OF EACH DAY, THE CONTRACTOR SHALL SECURE THE CONSTRUCTION WORK ZONE FROM POTENTIAL INTRUDERS.
- 9. THE CONTRACTOR SHALL FIELD VERIFY THE ELEVATIONS OF THE BENCHMARKS PRIOR TO COMMENCING WORK. THE CONTRACTOR SHALL ALSO FIELD VERIFY LOCATION, ELEVATION AND SIZE OF EXISTING UTILITIES, AND VERIFY PAVEMENT ELEVATIONS WHERE MATCHING INTO EXISTING WORK. THE CONTRACTOR SHALL FIELD VERIFY HORIZONTAL CONTROL BY REFERENCING SHOWN COORDINATES TO KNOWN PROPERTY LINES. NOTIFY ENGINEER OF DISCREPANCIES IN EITHER VERTICAL
- 10. THE CONTRACTOR SHALL CONTACT THE ENGINEER OF ANY ERRORS OR DISCREPANCIES WHICH MAY BE SUSPECTED IN LINES AND GRADES, AND SHALL NOT PROCEED WITH THE WORK UNTIL ALL LINES AND GRADES WHICH ARE BELIEVED TO BE IN ERROR HAVE BEEN VERIFIED OR CORRECTED BY THE ENGINEER OR HIS REPRESENTATIVE.
- 11. THE ENGINEER AND OWNER ARE NOT RESPONSIBLE FOR THE CONSTRUCTION MEANS, METHODS, TECHNIQUES, SEQUENCE OR PROCEDURES, TIME OF PERFORMANCE, PROGRAMS OR ANY SAFETY PRECAUTIONS USED BY THE CONTRACTOR. THE CONTRACTOR IS SOLELY RESPONSIBLE FOR EXECUTION OF THEIR WORK IN ACCORDANCE WITH THE CONTRACT DOCUMENTS
- 12. ALL EXCESS EARTH EXCAVATION, EXCESS MATERIALS, OR OTHER REMOVED ITEMS SHALL BE HAULED OFF-SITE AT THE CONTRACTOR'S EXPENSE, UNLESS OTHERWISE APPROVED BY THE OWNER.
- 13. ALL ROADWAY REMOVAL ITEMS SHALL CONFORM TO THE ILLINOIS DEPARTMENT OF TRANSPORTATION'S "STANDARD ALL ROADWAY REMOVAL HEMS SHALL CONFORM TO THE ILLINOIS DEPARTMENT OF TRANSPORTATION'S STANDARD SPECIFICATIONS FOR ROAD AND BRIDGE CONSTRUCTION IN ILLINOIS", CURRENT EDITION. ALL JOINTS BETWEEN THE PORTION REMOVED AND THAT LEFT IN PLACE SHALL BE SAWED TO SUCH A DEPTH THAT A CLEAN, NEAT EDGE WILL RESULT WITH NO SPALLING TO THE REMAINING PORTION. THE COST OF SAWING SHALL BE CONSIDERED INCIDENTAL TO THE CONTRACT. ADDITIONAL SAWING OR RE-SAWING MAY BE REQUIRED AS DIRECTED BY THE ENGINEER WITH NO ADDITIONAL COMPENSATION BEING ALLOWED. THE COST OF SAWCUTTING THE EXISTING PAVEMENT SHALL NOT BE PAID FOR SEPARATELY, BUT SHALL BE CONSIDERED INCIDENTAL TO THE CONTRACT.
- 14. THE CONTRACTOR IS REQUIRED TO STAY WITHIN THE NOTED PROPERTY BOUNDARIES RIGHT-OF-WAY AND EASEMENTS AS SHOWN IN THE PLANS. ANY ADDITIONAL EASEMENTS SHALL BE SECURED BY THE CONTRACTOR AT NO EXTRA COST
- 15. ANY AREAS DAMAGED OR DISTURBED DURING THE PROJECT AS A DIRECT OR INDIRECT RESULT OF CONTRACTOR OPERATIONS, SHALL BE RESTORED TO A CONDITION EQUAL TO OR BETTER THAN THE ORIGINAL CONDITION. THE COST OF SAID RESTORATION OR REPAIR SHALL BE BORNE TOTALLY BY THE CONTRACTOR, WITH NO EXTRA COMPENSATION BEING AWARDED UNDER THIS CONTRACT. THE RESPONSIBILITY FOR THE REPAIR OR REPLACEMENT OF ANY UTILITY, STRUCTURE, LANDSCAPING, ETC., DAMAGED OR DESTROYED BY THE CONTRACTOR DURING MOBILIZATION OR CONSTRUCTION SHALL BE BORNE SOLELY BY THE CONTRACTOR, WITH NO EXPENSE BEING CHARGED TO THE ENGINEER OR OWNER. PRIOR TO ACCEPTANCE OF THIS REPAIR OR REPLACEMENT, THE CONTRACTOR SHALL PRESENT THE OWNER WITH A "SIGNOFF LETTER", SIGNED BY A RESPONSIBLE OFFICIAL OF THE OWNER OF THE DAMAGED UTILITY STATING THAT THE REPAIR OR REPLACEMENT IS ACCEPTABLE.
- 16. ALL SAW CUTS NOT SPECIFIED IN THE PLANS THAT ARE REQUIRED BY THE CONSTRUCTION OF THIS PROJECT SHALL BE CONSIDERED INCIDENTAL

EROSION CONTROL NOTES

- 1. UNLESS OTHERWISE SPECIFIED, ALL EROSION AND SEDIMENT CONTROL MEASURES AND THEIR MAINTENANCE, CLEARING AND REMOVAL SHALL BE CONSIDERED INCIDENTAL TO CONSTRUCTION.
- 2. THIS WORK SHALL CONFORM TO THE APPLICABLE STANDARDS FROM THE ILLINOIS URBAN MANUAL, THE ILLINOIS DEPARTMENT OF TRANSPORTATION STANDARD SPECIFICATION, CURRENT EDITION, THE PROJECT SPECIFICATIONS, AND THE APPROPRIATE
- 3. A NOTICE OF INTENT (NOI) AND A STORM WATER POLLUTION PREVENTION PLAN (SWPPP) WILL BE COMPLETED AND SUBMITTED TO THE ILLINOIS EPA BY THE OWNER PRIOR TO CONSTRUCTION.
- 4. THE SWPPP SHALL BE CONSIDERED PART OF THE CONTRACT DOCUMENTS AND WILL BE AVAILABLE FOR REVIEW DURING THE
- 5. A COPY OF THE SWPPP WILL BE PROVIDED TO THE SUCCESSFUL BIDDER. THE CONTRACTOR SHALL MAINTAIN ONE COPY OF THE SWPPP AT THE CONSTRUCTION SITE AT ALL TIMES DURING WORKING HOURS FROM THE DATE OF PROJECT INITIATION TO THE DATE OF FINAL STABILIZATION.
- 6. THE CONTRACTOR SHALL LEGIBLY MARK ANY CHANGES OR REVISIONS IMPLEMENTED TO THE SWPPP. AT COMPLETION OF THE PROJECT, THE CONTRACTOR SHALL DELIVER THE SWPPP (INCLUDING ALL REVISIONS, RECORDS, AND INSPECTION
- 7. THE GENERAL CONTRACTOR AND ANY SUBCONTRACTOR RESPONSIBLE FOR SEDIMENT AND EROSION CONTROL MEASURES OR CONSTRUCTION ACTIVITIES THAT DISTURB SITE SOIL WILL BE REQUIRED TO CERTIFY THE SWPPP BEFORE A NOTICE TO
- 8. A COPY OF THE LETTER OF NOTIFICATION OF COVERAGE, AND THE GENERAL NPDES PERMIT NO. ILR10 MUST BE POSTED IN A PROMINENT PLACE FOR PUBLIC VIEWING AT THE CONSTRUCTION SITE BY THE GENERAL CONTRACTOR.
- 9. THE CONTRACTOR SHALL IMPLEMENT THE EROSION AND SEDIMENT CONTROL MEASURES AS INDICATED ON THESE EROSION CONTROL PLANS AND IN THE SWPPP BEFORE CONSTRUCTION BEGINS.
- 10. THE CONTROLS SHALL BE INSTALLED AS DETAILED AND WHERE INDICATED ON THE EROSION CONTROL PLAN SHEETS AND AS DIRECTED BY THE INSPECTOR
- 11. SITE ACTIVITIES SHOULD ENSURE THAT EXISTING VEGETATION IS PRESERVED WHERE PRACTICABLE.
- 12. EXCEPT AS PROVIDED IN THE SWPPP, DISTURBED PORTIONS OF THE SITE SHALL BE STABILIZED (TEMPORARILY OR PERMANENTLY SEEDED, MULCHED, SODDED OR PAVED) AS SOON AS PRACTICABLE, BUT IN NO CASE MORE THAN CALENDAR DAYS AFTER THE CONSTRUCTION ACTIVITY IN THAT PORTION OF THE SITE HAS TEMPORARILY OR PERMANENTLY
- 13. UNTIL SUCH TIME AS THE PROJECT SITE REACHES FINAL STABILIZATION AND A NOTICE OF TERMINATION IS FILED BY THE OWNER, THE CONTRACTOR SHALL BE RESPONSIBLE TO ADJUST, REPAIR, OR REPLACE, ALL VEGETATION, EROSION CONTROLS, SEDIMENT CONTROLS, AND ANY OTHER PROTECTIVE MEASURES AS REQUIRED IN ORDER TO MAINTAIN THEIR INTENDED FUNCTION IN A GOOD AND EFFECTIVE OPERATING CONDITION.
- 14. EXCEPT FOR FLOWS FROM FIRE FIGHTING ACTIVITIES. SOURCES OF NON-STORM WATER EXPECTED DURING THE CONSTRUCTION PROCESS THAT MAY BE COMBINED WITH STORM WATER DISCHARGES ARE IDENTIFIED IN THE SWPPP. THESE DISCHARGES SHALL BE DIRECTED AWAY FROM UNPROTECTED, BARE, OR OTHERWISE UNSTABILIZED SOIL, AND APPROPRIATE POLLUTION PREVENTION MEASURES SHALL BE IMPLEMENTED SO THAT THESE DISCHARGES DO NOT CAUSE EROSION OR DEGRADE THE QUALITY OF RUNOFF FROM THE CONSTRUCTION SITE.
- 15. REGULAR INSPECTIONS WILL BE MADE AS REQUIRED UNDER THE GENERAL NPDES PERMIT NO. ILR10 AND SPECIFIED IN THE SWPPP. A QUALIFIED INSPECTOR WILL BE PROVIDED BY THE OWNER. BASED ON THE RESULTS OF THE INSPECTIONS, POLLUTION PREVENTION MEASURES SHALL BE REVISED AS APPROPRIATE AS SOON AS PRACTICABLE AFTER EACH INSPECTION. SUCH REVISIONS SHALL BE IMPLEMENTED WITHIN 7 CALENDAR DAYS FOLLOWING EACH INSPECTION.
- 16. THE INSPECTOR SHALL HAVE AUTHORIZATION TO DETERMINE THE ADEQUACY OF THE CONTRACTOR'S EROSION CONTROL EFFORTS. THE OWNER OR THE INSPECTOR SHALL HAVE FULL AUTHORITY OVER THE GENERAL CONTRACTOR AND ANY SUBCONTRACTOR TO CAUSE POLLUTANT CONTROL MEASURES TO BE REPAIRED, MODIFIED, MAINTAINED, SUPPLEMENTED, OR WHATEVER ELSE IS NECESSARY IN ORDER TO ACHIEVE EFFECTIVE POLLUTANT CONTROL OR TO SUSPEND OR LIMIT THE CONTRACTORS OPERATIONS PENDING ADEQUATE PERFORMANCE.
- 17. PERIMETER EROSION BARRIER TO BE CONSTRUCTED OF SILT FENCE UNLESS NOTED OTHERWISE.
- 18. INLET PROTECTION SHALL BE A DANDY BAG, DANDY SACK, ROCSOC, OR APPROVED EQUAL.
- 19. EROSION CONTROL BLANKET SHALL BE OF NORTH AMERICAN GREEN DS75 OR APPROVED EQUAL
- 20. A TEMPORARY CONCRETE WASHOUT FACILITY SHALL BE CONSTRUCTED AT A LOCATION APPROVED BY THE ENGINEER. WASHOUT FACILITY SHALL BE UTILIZED FOR ALL APPLICABLE OPERATIONS.
- 21. AT THE COMPLETION OF THE PROJECT, ALL TEMPORARY EROSION CONTROL ITEMS SHALL BE REMOVED FROM THE SITE, AND BECOME THE PROPERTY OF THE CONTRACTOR. CONTRACTOR MUST STABILIZE ANY AREA DISTURBED BY THE REMOVAL OF EROSION CONTROL ITEMS.
- 22. CONTRACTOR SHALL CLEAN ANY DEBRIS TRACKED OFFSITE DAILY.

ENGINEERING & ENVIRONMENTAL

ILLINOIS IOWA

WISCONSIN

VILLAGE OF SHABBONA 206 S. BLACKHAWK ST SHABBONA, IL 60550

OWNER/DEVELOPER

PROJECT AND LOCATION

SHABBONA DOWNTOWN STREETSCAPE SHABBONA, IL

DRAWN BY: JMV APPROVED BY: BS DATE: 05/17/2023 SCALE: AS NOTED

REVISIONS DESCRIPTION DATE

GENERAL NOTES SET TYPE: FINAL

JOB NUMBER 19-366 SHEET NUMBER

3 of 71

ILLINOIS DESIGN FIRM NO. 184-00352 PLOT DATE: 6/19/23 © 2023 FEHR GRAHAM CONTRACT NO. 87841 SECTION NO. 23-00019-01-LS

STORM SEWER

- 1. ALL EXISTING MANHOLE CONNECTIONS MUST BE CORE-DRILLED, UNLESS A PRE-CORED HOLE, SUITABLY LOCATED, EXISTS IN THE MANHOLE.
- 2. CONTRACTOR SHALL FIELD VERIFY ALL EXISTING STORM SEWER ELEVATIONS THAT PROJECT CONNECTS TO.

MATERIAL AND COMPACTION TESTING

1. A GEOTECHNICAL REPRESENTATIVE WILL BE PROVIDED AND PAID FOR BY THE OWNER FOR ANY REQUIRED TESTING. THE CONTRACTOR IS RESPONSIBLE TO FOLLOW AND MEET GUIDELINES SET BY THE GEOTECHNICAL REPRESENTATIVE.

UTILITIES

- 1. UTILITIES SHOWN ON THE PLANS ARE FOR ILLUSTRATIVE PURPOSES ONLY AND NO GUARANTEE OF THEIR ACCURACY IS MADE OR INFERRED. THE LOCATION OF EXISTING UTILITIES AS SHOWN ON THE DRAWINGS REPRESENT DATA RECEIVED FROM VARIOUS SOURCES. IT IS NOT GUARANTEED TO BE CORRECT OR ALL—INCUSIVE. THE CONTRACTOR SHALL CONDUCT HIS OWN INVESTIGATION INTO THE LOCATION, SIZE, DEPTH AND NATURE OF ANY AND ALL EXISTING UTILITIES THAT MAY INTERFERE WITH THE WORK UNDER THIS CONTRACT. ANY EXISTING UTILITIES THAT ARE TO REMAIN IN SERVICE SHALL BE FULLY PROTECTED BY THE CONTRACTOR AND ANY DAMAGE CAUSED BY THE CONSTRUCTION OPERATIONS SHALL BE IMMEDIATELY REPAIRED OR REPLACED TO THE SATISFACTION OF THE ENGINEER OR THE OWNER. THE CONTRACTOR SHALL BE RESPONSIBLE FOR CONTACTING ANY AND ALL UTILITY COMPANIES REGARDING ADJUSTMENTS NECESSARY. THIS WORK SHALL BE AT THE CONTRACTOR'S EXPENSE AND CONSIDERED INCIDENTAL TO THE PROJECT COST. THE CONTRACTOR SHALL BE RESPONSIBLE FOR THE PROTECTION OF ALL UNDERGROUND, OVERHEAD, OR SUFFACE UTILITIES EVEN THOUGH THEY MAY NOT BE SHOWN ON THE PLANS. ANY UTILITY THAT IS DAMAGED DURING CONSTRUCTION SHALL BE REPAIRED TO THE SATISFACTION OF THE ENGINEER OR THE OWNER OR REPLACED. THIS WORK SHALL BE AT THE CONTRACTOR'S EXPENSE.
- 2. THE CONTRACTOR MUST VERIFY AND LOCATE ALL EXISTING UTILITIES ON OR ADJACENT TO THE SITE. PRIOR TO BEGINNING CONSTRUCTION ACTIVITIES, CONTACT J.U.L.I.E. AT 1-800-892-0123 (OR 811) FOR EXACT FIELD LOCATION OF UTILITIES. DAMAGE, AND THE COST THEREOF, TO ANY AND ALL UTILITIES SHALL BE THE SOLE RESPONSIBILITY OF THE CONTRACTOR. ANY AND ALL EXISTING UTILITIES SHOWN HEREON ARE APPROXIMATE. THE ENGINEER AND SURVEYOR ASSUMES NO RESPONSIBILITY FOR THE LOCATION OF THE EXISTING UTILITIES SHOWN HEREON.
- IF THERE ARE ANY UTILITIES WHICH ARE NOT MEMBERS OF THE J.U.L.I.E. SYSTEM, THE CONTRACTOR SHALL BE SOLELY RESPONSIBLE FOR DETERMINING THIS AND REQUESTING SAID UTILITIES TO FIELD VERIFY AND MARK PERTINENT UTILITY LOCATIONS.
- 4. THE UTILITY LOCATIONS, DEPTHS, ETC. SHOWN ON THESE PLANS ARE APPROXIMATE ONLY, AND SHALL BE VERIFIED BY THE CONTRACTOR WITH ALL AFFECTED UTILITY COMPANIES PRIOR TO INITIATING CONSTRUCTION OPERATIONS; THE ENGINEER AND OWNER ASSUME NO RESPONSIBILITY FOR THE ADEQUACY, SUFFICIENCY OR EXACTNESS OF THESE UTILITY REPRESENTATIONS.
- 5. THE CONTRACTOR SHALL CONTACT THE NECESSARY UTILITY COMPANIES FOR ANY UTILITY RELOCATIONS. THE CONTRACTOR SHALL PAY FOR ALL COSTS ASSOCIATED WITH RELOCATION OF UTILITIES ON OR ADJACENT TO THE SUBJECT PROPERTY OR WITHIN THE ROAD RIGHT-OF-WAY.
- 6. TRENCH BACKFILL SHALL BE FILL MATERIAL TYPE A (GRAVEL OR CA6 CRUSHED STONE.) OR TYPE C (SAND FA-1 OR SAND FA-2) IN ACCORDANCE WITH AASHTO T27 GUIDELINES AND "STANDARD SPECIFICATIONS FOR WATER & SEWER CONSTRUCTION IN ILLINOIS", 8TH EDITION. COST SHALL BE INCLUDED IN UNIT PRICE OF PIPE.
- 7. ABANDONED UNDERGROUND UTILITIES THAT CONFLICT WITH CONSTRUCTION OR HAVE THE POTENTIAL FOR CREATING FUTURE PROBLEMS SHALL BE DISPOSED OF OUTSIDE THE LIMITS OF THE PROJECT AT AN APPROVED LOCATION OBTAINED BY THE CONTRACTOR, ACCORDING TO THE "STANDARD SPECIFICATIONS FOR WATER & SENER CONSTRUCTION IN ILLINOIS", CURRENT EDITION, AND AS DIRECTED BY THE ENGINEER. THIS WORK WILL NOT BE PAID FOR SEPARATELY, BUT SHALL BE CONSIDERED INCIDENTAL TO EARTH EXCAVATION AND NO ADDITIONAL COMPENSATION WILL BE ALLOWED.
- 8. ANY AND ALL FIELD TILES AND OR STORM SEWERS DAMAGED OR ENCOUNTERED DURING THE CONSTRUCTION ACTIVITIES SHALL BE REPAIRED, REPLACED AND/OR CONNECTED IMMEDIATELY BY THE CONTRACTOR. COST FOR SAID REPAIRS, REPLACEMENT, AND/OR CONNECTION SHALL BE THE SOLE RESPONSIBILITY OF THE CONTRACTOR.

UTILITIES

UTILITY TYPE	COMMON NAME
WATER & SEWER	VILLAGE OF SHABBONA
ELECTRIC	COMED
TELEPHONE	FRONTIER/DEKALB FIBER OPTIC
GAS	NICOR GAS
CABLE	MEDIACOM/DEKALB FIBER OPTIC

(CONTRACTOR TO BE RESPONSIBLE FOR ANY ADJUSTMENTS TO BE MADE.)

TRAFFIC CONTROL

- 1. THE CONTRACTOR SHALL PROVIDE, INSTALL AND MAINTAIN ALL TRAFFIC CONTROL ITEMS NECESSARY FOR THE CONSTRUCTION OF ITEMS WITH IN THE ROAD RIGHT-OF-WAY. ALL WORK PERFORMED SHALL HAVE TRAFFIC CONTROL IN ACCORDANCE WITH THE "MANUAL ON UNIFORM TRAFFIC CONTROL DEVICES" AND OF THE ILLINOIS DEPARTMENT OF TRANSPORTATION'S "STANDARD SPECIFICATIONS FOR ROAD AND BRIDGE CONSTRUCTION IN ILLINOIS" CURRENT EDITION
- 2. ALL TRAFFIC CONTROL DEVICES USED FOR THE MAINTENANCE OF TRAFFIC SHALL BE REFLECTORIZED PRIOR TO INSTALLATION AND CLEANED AS NECESSARY THROUGHOUT THE DURATION OF THE CONTRACT. ALL SIGNS SHALL BE FURNISHED, INSTALLED AND MAINTAINED BY THE CONTRACTOR. PAYMENT SHALL BE CONSIDERED INCIDENTAL TO THE PROJECT.
- 3. TRAFFIC CONDITIONS, ACCIDENTS, AND OTHER UNFORESEEN CONDITIONS MAY REQUIRE THE ENGINEER TO MODIFY THE LOCATION OF THE TRAFFIC CONTROL DEVICES. THE CONTRACTOR SHALL MAKE THE NECESSARY ADJUSTMENTS AS DIRECTED BY THE ENGINEER WITHOUT DELAY. THE CONTRACTOR SHALL RESPOND WITHIN 30 MINUTES FROM THE TIME OF NOTIFICATION BY THE ENGINEER TO ANY REQUEST MADE BY THE ENGINEER FOR CORRECTION, IMPROVEMENT OR MODIFICATION BY THE MAINTENANCE OF TRAFFIC CONTROL DEVICES. DURING CONSTRUCTION OPERATIONS, THE CONTRACTOR SHALL TAKE NECESSARY PRECAUTIONS TO PROTECT ADJACENT TRAFFIC LANES OPEN TO TRAFFIC FROM DEBRIS BEING BLOWN OR OTHERWISE REMOVED FROM THE CONSTRUCTION AREAS. THE CONTRACTOR SHALL ALSO BE RESPONSIBLE FOR KEEPING DEBRIS OFF THE ADJACENT TRAVELED LANE SURFACE. COST INCIDENTAL TO THE PROJECT.
- 4. THE CONTRACTOR SHALL SUBMIT MAINTENANCE OF TRAFFIC AND STAGING OF CONSTRUCTION PLANS FOR APPROVAL BY THE ENGINEER PRIOR TO COMMENCING WORK.
- THE CONTRACTOR SHALL PERFORM THE WORK UNDER STAGE CONSTRUCTION IN THE EVENT THAT THE CONTRACTOR WILL NEED TO CLOSE PUBLIC ROADS, CONTRACTOR SHALL SUBMIT PROPOSED DETOUR ROUTE AND ASSOCIATED SIGNAGE TO THE ENGINEER PRIOR TO COMMENCING WORK.
- 6. TRAFFIC CONTROL DEVICES, STREET NAME SIGNS, AND PAVEMENT MARKINGS SHALL BE INSTALLED IN ACCORDANCE WITH VILLAGE OF SHABBONA ORDINANCES AND THE "MANUAL ON UNIFORM TRAFFIC CONTROL DEVICES". LOCATIONS OF SIGNS AND MARKINGS SHALL BE SPECIFIED BY THE PLANS, AND/OR AS DIRECTED BY THE ENGINEER.
- 7. PROVIDE TO THE ENGINEER AND THE OWNER THE NAME AND PHONE NUMBER OF INDIVIDUALS RESPONSIBLE FOR MAINTAINING TRAFFIC CONTROL MEASURES DURING CONSTRUCTION. THIS INDIVIDUAL SHALL BE AVAILABLE TO CORRECT TRAFFIC CONTROL PROBLEMS 24 HOURS PER DAY.
- 8. THE CONTRACTOR SHALL NOTIFY THE POST OFFICE, POLICE DEPARTMENT, FIRE DEPARTMENT, 911 DISPATCH CENTER, ILLINOIS DEPARTMENT OF TRANSPORTATION, STATE POLICE, APPROPRIATE SCHOOL DISTRICT AND THE LOCAL AGENCY A MINIMUM OF 5 DAYS PRIOR TO CLOSING ANY PORTION OF THE STREET OR ALLEY.

SUBGRADES, SUBBASES, AND BASE COURSES

- 1. THE CONTRACTOR WILL BE REQUIRED TO SUBSTANTIATE BASE COURSE THICKNESSES AND FINISH PAVEMENT THICKNESSES. THE ENGINEER SHALL INSPECT BASE COURSE COREOUT PRIOR TO PLACING BASE COURSE TO ENSURE REQUIRED BASE COURSE DEPTH IS PRESENT. IN ADDITION, THE ENGINEER AND/OR THE CITY ENGINEER SHALL WITHESS THE PLACEMENT OF BITUMINOUS BINDER AND SURFACE COURSE. CORE DRILLING MAY BE REQUIRED TO DEMONSTRATE THAT BASE COURSE AND PAVEMENT THICKNESSES CONFORM TO THE SPECIFICATIONS. PRIOR TO PLACING BASE COURSE MATERIAL, THE CONTRACTOR SHALL TEST ROLL THE SUBGRADE, IN THE PRESENCE OF THE ENGINEER OR HIS AGENT TO DEMONSTRATE THAT SAID SUBGRADE IS READY FOR BASE. PRIOR TO PLACEMENT OF THE BITUMINOUS SURFACE, THE SAME VERIFICATION PROCEDURE SHALL BE PERFORMED ON THE BASE COURSE MATERIAL. THE CONTRACTOR SHALL NOTIFY THE ENGINEER AT LEAST 48 HOURS PRIOR TO PERFORMING ANY OF THE REQUIRED TESTS SO THAT A REPRESENTATIVE MAY BE PRESENT.
- 2. PRIOR TO ANY EMBANKMENT OR ROAD BASE BEING PLACED, SHOULD IT BE DETERMINED BY THE ENGINEER THAT THE SUBGRADE MATERIAL IS UNSUITABLE ON WHICH TO CONSTRUCT THE ROADWAY STRUCTURE, THE CONTRACTOR SHALL BE RESPONSIBLE FOR REMOVING THE UNSUITABLE MATERIAL TO THE SATISFACTION OF THE ENGINEER AND REPLACING SAME WITH STABILIZING SUBBASE CONSISTING OF SUBBASE GRANULAR MATERIAL, TYPE B IN ACCORDANCE WITH THE ILLINOIS DEPARTMENT OF TRANSPORTATION'S "STANDARD SPECIFICATIONS FOR ROAD AND BRIDGE CONSTRUCTION IN ILLINOIS", CLUPPENT EDITION.

EXCAVATION/EARTHWORK

- THE CONTRACTOR SHALL USE CARE IN GRADING OR EXCAVATION NEAR ANY AND ALL EXISTING ITEMS WHICH ARE NOT INDICATED TO BE REMOVED. ANY DAMAGE DONE TO EXISTING ITEMS BY THE CONTRACTOR'S OPERATIONS SHALL BE REPAIRED AT NO ADDITIONAL EXPENSE TO THE OWNER.
- 2. PRIOR TO STARTING EARTHWORK OR UTILITY TRENCHING, THE CONTRACTOR SHALL STRIP THE SITE OF TOPSOIL TO A DEPTH OF 4" AND TO THE LIMITS APPROVED BY THE ENGINEER. THIS MATERIAL SHALL BE STOCKPILED IN A REMOTE LOCATION OF THE SITE (APPROVED BY THE ENGINEER) UNTIL THE PLAN IMPROVEMENTS ARE COMPLETED AND THE EXCESS MATERIAL SPREAD AS DIRECTED. IT SHALL THEN BE THE RESPONSIBILITY OF THE CONTRACTOR TO SPREAD THIS TOPSOIL MATERIAL IN AREAS OF THE SITE, OVER AREAS WHERE EXCESS EXCAVATED MATERIAL, SAND, GRAVEL HAS BEEN SPREAD OR IN OTHER AREAS AS DESIGNATED BY THE ENGINEER. THE MATERIAL SHALL THEN BE COMPACTED TO A MINIMAL DEPTH OF 4" AND FINE GRADED IN A MANNER ACCEPTABLE TO THE ENGINEER. THIS WORK SHALL BE IN ACCORDANCE WITH THE ILLINOIS DEPARTMENT OF TRANSPORTATION'S "STANDARD SPECIFICATIONS FOR ROAD AND BRIDGE CONSTRUCTION IN ILLINOIS", CURPENT FOILION.
- 3. CLEAN CONSTRUCTION OR DEMOLITION DEBRIS (CCDD) REQUIREMENTS—"THE CONTRACTOR IS RESPONSIBLE FOR THE ASSESSMENT AND PROPER DISPOSAL OF ALL EXCESS SOIL AND SUBSURFACE MATERIALS THAT ARE NOT ABLE TO BE RE—USED ON THE PROJECT SITE AS SUITABLE CLEAN FILL. CONTRACTOR RESPONSIBILITY'S SHALL INCLUDE ALL REQUIRED SOIL SAMPLING, LABORATORY ANALYSIS, DISPOSAL PROFILING FEES, TRANSPORTATION, AND DISPOSAL TIPPING FEES AND SUIRCHARGES"
- 4. ROCK IS NOT ANTICIPATED TO BE ENCOUNTERED.
- 5. ALL EXCAVATIONS FOR STRUCTURES AND PIPE SHALL BE KEPT DEWATERED DURING CONSTRUCTION UNTIL BACKFILL IS IN PLACE. DURING DEWATERING OPERATIONS, WATER SHALL BE PUMPED INTO SEDIMENT BASINS OR SILT TRAPS. (COST INCIDENTAL)
- 6. EARTH EXCAVATION SHALL CONFORM TO SECTION 202 OF THE ILLINOIS DEPARTMENT OF TRANSPORTATION'S "STANDARD SPECIFICATIONS FOR ROAD AND BRIDGE CONSTRUCTION IN ILLINOIS", CURRENT EDITION. THIS WORK SHALL INCLUDE THE EXCAVATION OF ALL MATERIALS TO DESIGN SUBGRADE ELEVATIONS INDICATED IN THE PLANS.
- 7. SHEETING AND SHORING SHALL BE CONSIDERED INCIDENTAL TO CONTRACT IF REQUIRED
- 8. WHENEVER THE CONTRACTOR WORKS NEAR EXISTING FACILITIES WITHIN THE LIMITS OF THE IMPROVEMENTS DURING TRENCHING OPERATIONS, HE WILL BE REQUIRED TO HAND TRENCH IN THAT AREA IN ORDER NOT TO DAMAGE THESE FACILITIES. PUSH HOLES AND SEARCH HOLES THAT ARE DUG BY THE CONTRACTOR SHALL BE BACKFILLED BY TAMPING THE EXCAVATED MATERIAL BACK IN PLACE TO KEEP SETTLEMENT TO A MINIMUM. NO ADDITIONAL COMPENSATION WILL BE ALLOWED.
- 9. EMBANKMENT WORK SHALL CONSIST OF THE CONSTRUCTION OF EMBANKMENTS BY DEPOSITING, PLACING AND COMPACTING EARTH, STONE, GRAVEL OR OTHER MATERIALS OF ACCEPTABLE QUALITY ABOVE THE NATURAL GROUND OR OTHER SURFACE IN ACCORDANCE WITH THE ILLINOIS DEPARTMENT OF TRANSPORTATION'S "STANDARD SPECIFICATIONS FOR ROAD AND BRIDGE CONSTRUCTION IN ILLINOIS", CURRENT EDITION.
- 10. IF SUFFICIENT TOPSOIL IS NOT PRESENT, THE CONTRACTOR SHALL SPREAD FURNISHED TOPSOIL SO AS TO MEET THE REQUIREMENTS OF THE CONTRACT. FURNISHED TOPSOIL SHALL ONLY BE USED WITH APPROVAL BY THE ENGINEER. THIS FURNISHED TOPSOIL SHALL BE PAID FOR AS FURNISHED TOPSOIL IN PLACE, DEPTH SPECIFIED.
- 11. IN PROPOSED FILL AREAS FOR PAVEMENT AND EMBANKMENT, TOPSOIL AND TURF SHALL BE SCARIFIED AND REMOVED PRIOR TO CONSTRUCTING THE EMBANKMENT.

FEHR GRAHAM

FNGINFFRING & FNVIRONMENTAL

ILLINOIS DESIGN FIRM NO. 184-00352

ILLINOIS IOWA

WISCONSIN

VILLAGE OF SHABBONA 206 S. BLACKHAWK ST SHABBONA, IL 60550

OWNER/DEVELOPER

SHABBONA DOWNTOWN STREETSCAPE SHABBONA, IL

CONTRACT NO. 87841

PROJECT AND LOCATION

DRAWN BY: JMV
APPROVED BY: BS
DATE: 05/17/2023
SCALE: AS NOTED

REVISIONS
REV. NO. DESCRIPTION DATE

DRAWING:
GENERAL NOTES

SET TYPE: FINAL
SIZE TYPE: FINAL
SIZE TYPE AND THE PROPERTY 10 - 165 Press days. NOTES 2


JOB NUMBER:

19-366

SHEET NUMBER:

4 of 71

PLOT DATE: 6/19/23 © 2023 FEHR GRAHAM

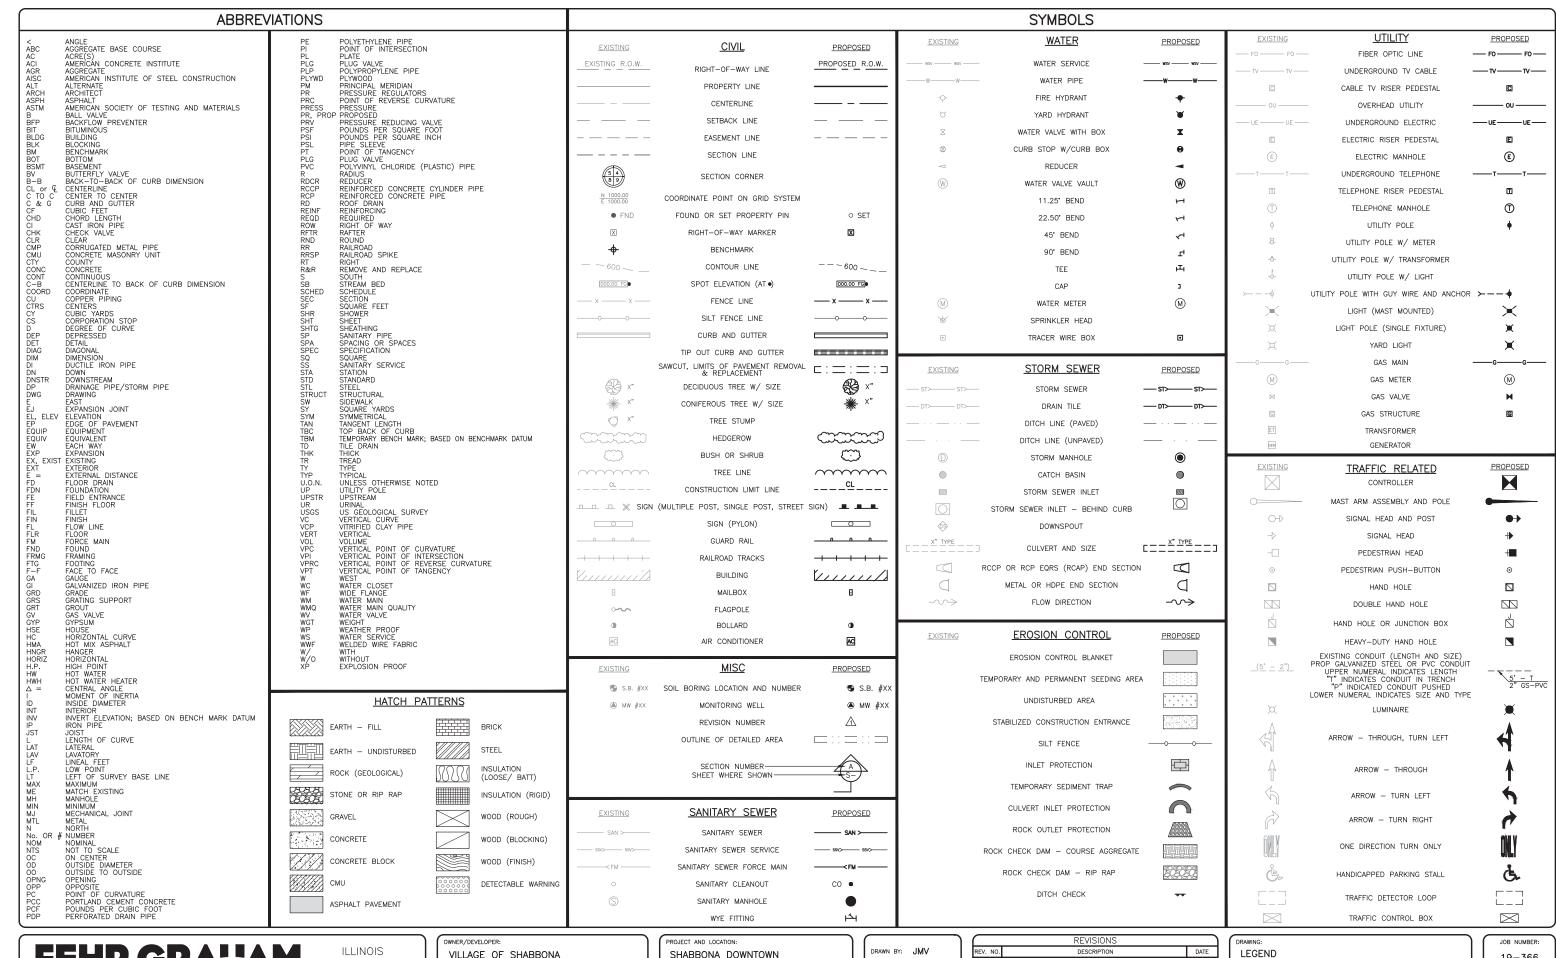

FEHR GRAHA

ENGINEERING & ENVIRONMENTAL

IOWA

WISCONSIN

VILLAGE OF SHABBONA 206 S. BLACKHAWK ST SHABBONA, IL 60550


SHABBONA DOWNTOWN STREETSCAPE SHABBONA, IL


APPROVED BY: BS DATE: 05/17/2023 SCALE: AS NOTED

$\overline{}$	REVISIONS		
REV. NO.	REV. NO. DESCRIPTION		
\subset			

SET TYPE: FINAL


19-366 SHEET NUMBER: 5 of 71

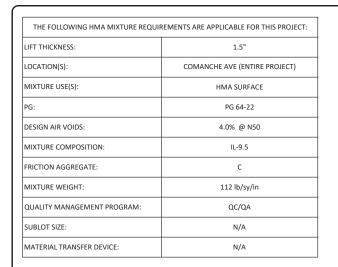

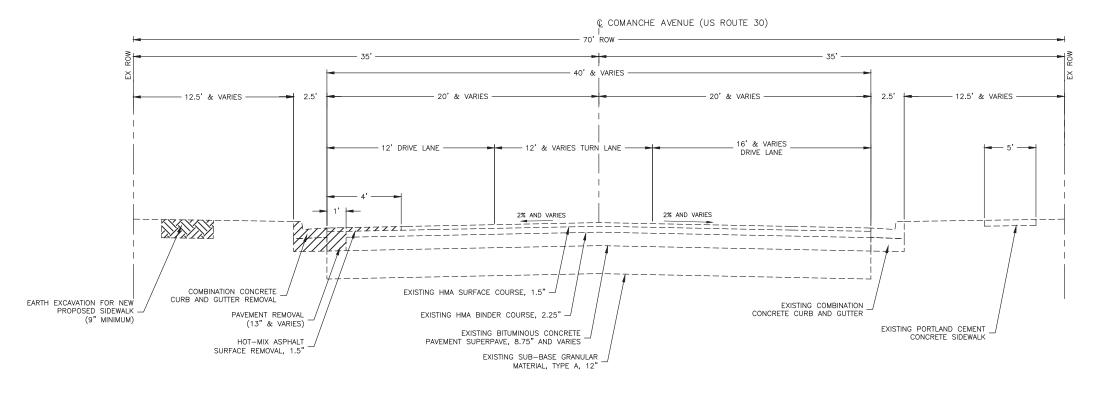

EXISTING TYPICAL SECTION (NOT TO SCALE) STA 182+58 TO 186+74

LIFT THICKNESS:	1.5"
LOCATION(S):	COMANCHE AVE (ENTIRE PROJECT)
MIXTURE USE(S):	HMA SURFACE
PG:	PG 64-22
DESIGN AIR VOIDS:	4.0% @ N50
MIXTURE COMPOSITION:	IL-9.5
FRICTION AGGREGATE:	С
MIXTURE WEIGHT:	112 lb/sy/in
QUALITY MANAGEMENT PROGRAM:	QC/QA
SUBLOT SIZE:	N/A
MATERIAL TRANSFER DEVICE:	N/A

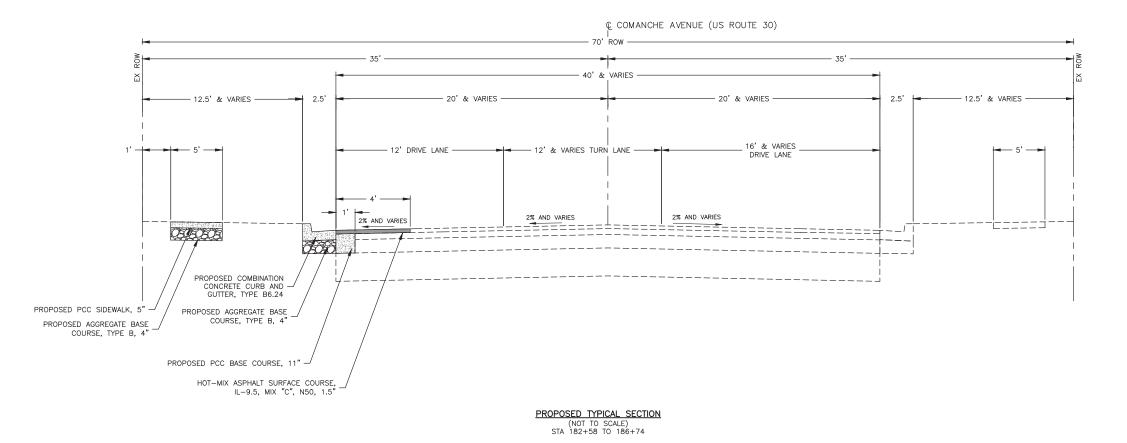

FEHR GRAHAM

ILLINOIS IOWA WISCONSIN owner/developer:
VILLAGE OF SHABBONA
206 S. BLACKHAWK ST
SHABBONA, IL 60550

PROJECT AND LOCATION:
SHABBONA DOWNTOWN
STREETSCAPE
SHABBONA, IL

DRAWN BY: JMV
APPROVED BY: BS
DATE: 05/17/2023
SCALE: AS NOTED

REVISIONS
REV. NO. DESCRIPTION DATE

DRAWING:
TYPICAL SECTIONS

SET TYPE: FINAL


JOB NUMBER:
19-366

SHEET NUMBER:
6 of 71

ENGINEERING & ENVIRONMENTAL ILLINOIS DESIGN FIRM NO. 184-003525

PLOT DATE: 6/19/23 © 2023 FEHR GRAHAM

THE FOLLOWING HMA MIXTURE REQUIREMENTS ARE APPLICABLE FOR THIS PROJECT:			
LIFT THICKNESS:	1.5"		
LOCATION(S):	COMANCHE AVE (ENTIRE PROJECT)		
MIXTURE USE(S):	HMA SURFACE		
PG:	PG 64-22		
DESIGN AIR VOIDS:	4.0% @ N50		
MIXTURE COMPOSITION:	IL-9.5		
FRICTION AGGREGATE:	С		
MIXTURE WEIGHT:	112 lb/sy/in		
QUALITY MANAGEMENT PROGRAM:	QC/QA		
SUBLOT SIZE:	N/A		
MATERIAL TRANSFER DEVICE:	N/A		

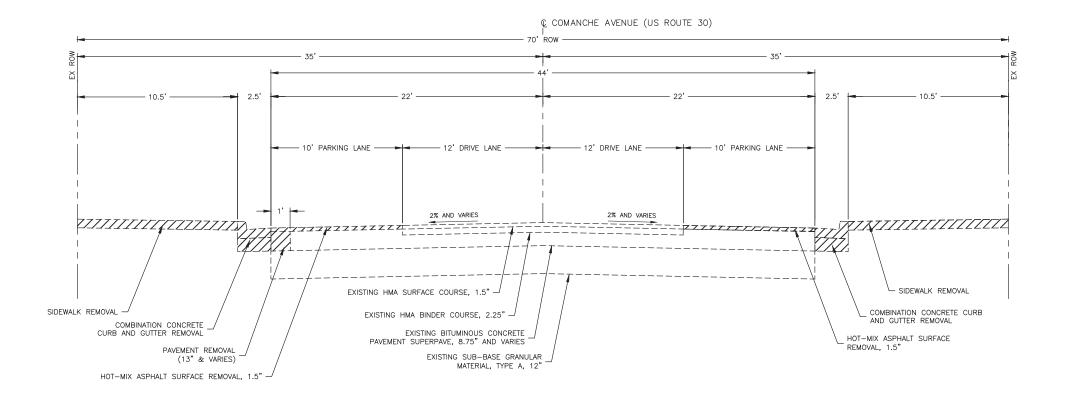

EXISTING TYPICAL SECTION (NOT TO SCALE) STA 188+45 TO 189+20

THE FOLLOWING HMA MIXTURE REQUIREMENTS ARE APPLICABLE FOR THIS PROJECT: LIFT THICKNESS: LOCATION(S): COMANCHE AVE (ENTIRE PROJECT) MIXTURE USE(S): HMA SURFACE PG 64-22 4.0% @ N50 DESIGN AIR VOIDS: MIXTURE COMPOSITION: IL-9.5 FRICTION AGGREGATE: C 112 lb/sy/in MIXTURE WEIGHT: QUALITY MANAGEMENT PROGRAM: QC/QA SUBLOT SIZE: MATERIAL TRANSFER DEVICE: N/A

© COMANCHE AVENUE (US ROUTE 30) — 12' DRIVE LANE — — 10' PARKING LANE —— — 12' DRIVE LANE ——— 10' PARKING LANE -222/22222222 2% AND VARIES 2% AND VARIES 2% AND VARIES 2% AND VARIES PROPOSED HMA SURFACE COURSE, IL-9.5, MIX "C", N50, 1.5" PROPOSED HMA SURFACE COURSE, IL-9.5, MIX "C", N50, 1.5" PROPOSED PCC SIDEWALK, 5 PROPOSED PCC SIDEWALK, 5" PROPOSED PCC BASE COURSE, 11" PROPOSED AGGREGATE BASE PROPOSED AGGREGATE BASE COURSE, TYPE B, 4" PROPOSED AGGREGATE BASE COURSE, TYPE B, 4" COURSE, TYPE B, 4" PROPOSED STAMPED CONCRETE PORTLAND CEMENT CONCRETE SIDEWALK, 5" PROPOSED COMBINATION CONCRETE CURB AND GUTTER, TYPE B6.24 PROPOSED COMBINATION CONCRETE CURB AND GUTTER, TYPE B6.24 PROPOSED AGGREGATE BASE COURSE, TYPE B, 4" PROPOSED STAMPED CONCRETE PORTLAND CEMENT CONCRETE SIDEWALK, 5" PROPOSED TYPICAL SECTION (NOT TO SCALE) STA 188+45 TO 189+20

FEHR GRAHAM

ILLINOIS IOWA WISCONSIN VILLAGE OF SHABBONA 206 S. BLACKHAWK ST SHABBONA, IL 60550 PROJECT AND LOCATION:
SHABBONA DOWNTOWN
STREETSCAPE
SHABBONA, IL

DRAWN BY: JMV
APPROVED BY: BS
DATE: 05/17/2023
SCALE: AS NOTED

REVISIONS
REV. NO. DESCRIPTION DATE

DRAWING:
TYPICAL SECTIONS

SET TYPE: FINAL
6\(C30\)19\19-366\(Plans\).19-366 Plans.dwg, TYP, SECT. 2


JOB NUMBER:
19-366

SHEET NUMBER:
7 of 71

ENGINEERING & ENVIRONMENTAL ILLINOIS DESIGN FIRM NO. 184-003525


PLOT DATE: 6/19/23 © 2023 FEHR GRAHAM

THE FOLLOWING HMA MIXTURE REQUIREMENTS ARE APPLICABLE FOR THIS PROJECT:		
LIFT THICKNESS:	1.5"	
LOCATION(S):	COMANCHE AVE (ENTIRE PROJECT)	
MIXTURE USE(S):	HMA SURFACE	
PG:	PG 64-22	
DESIGN AIR VOIDS:	4.0% @ N50	
MIXTURE COMPOSITION:	IL-9.5	
FRICTION AGGREGATE:	С	
MIXTURE WEIGHT:	112 lb/sy/in	
QUALITY MANAGEMENT PROGRAM:	QC/QA	
SUBLOT SIZE:	N/A	
MATERIAL TRANSFER DEVICE:	N/A	

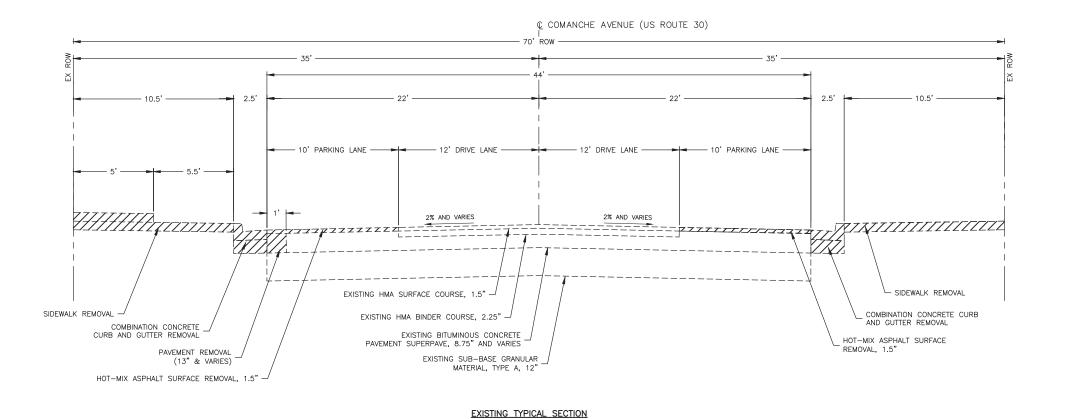

(NOT TO SCALE) STA 189+20 TO 190+45

THE FOLLOWING HMA MIXTURE REQUIREMENTS ARE APPLICABLE FOR THIS PROJECT:		
LIFT THICKNESS:	1.5"	
LOCATION(S):	COMANCHE AVE (ENTIRE PROJECT)	
MIXTURE USE(S):	HMA SURFACE	
PG:	PG 64-22	
DESIGN AIR VOIDS:	4.0% @ N50	
MIXTURE COMPOSITION:	IL-9.5	
FRICTION AGGREGATE:	С	
MIXTURE WEIGHT:	112 lb/sy/in	
QUALITY MANAGEMENT PROGRAM:	QC/QA	
SUBLOT SIZE:	N/A	
MATERIAL TRANSFER DEVICE:	N/A	

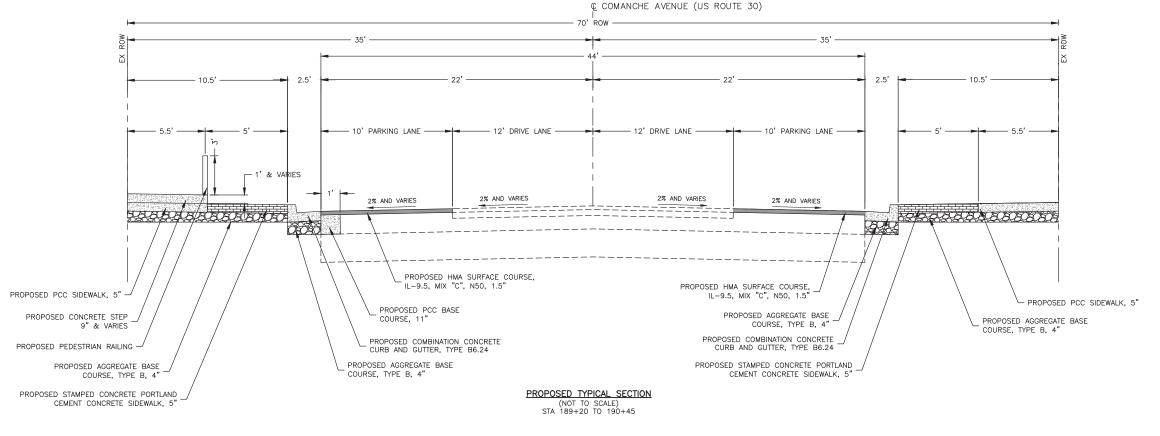

FEHR GRAHAM

ENGINEERING & ENVIRONMENTAL

ILLINOIS DESIGN FIRM NO. 184-003525

ILLINOIS IOWA WISCONSIN OWNER/DEVELOPER:
VILLAGE OF SHABBONA
206 S. BLACKHAWK ST
SHABBONA, IL 60550

PROJECT AND LOCATION:
SHABBONA DOWNTOWN
STREETSCAPE
SHABBONA, IL

DRAWN BY: JMV
APPROVED BY: BS
DATE: 05/17/2023
SCALE: AS NOTED

REVISIONS
REV. NO. DESCRIPTION DATE

DRAWING:
TYPICAL SECTIONS

SET TYPE: FINAL

JOB NUMBER:

19-366


SHEET NUMBER:


8 of 71

PLOT DATE: 6/19/23 © 2023 FEHR GRAHAM


CONTRACT NO. 87841

CONTRACT NO. 87841

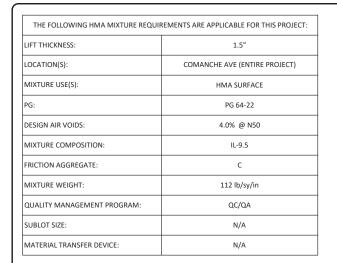

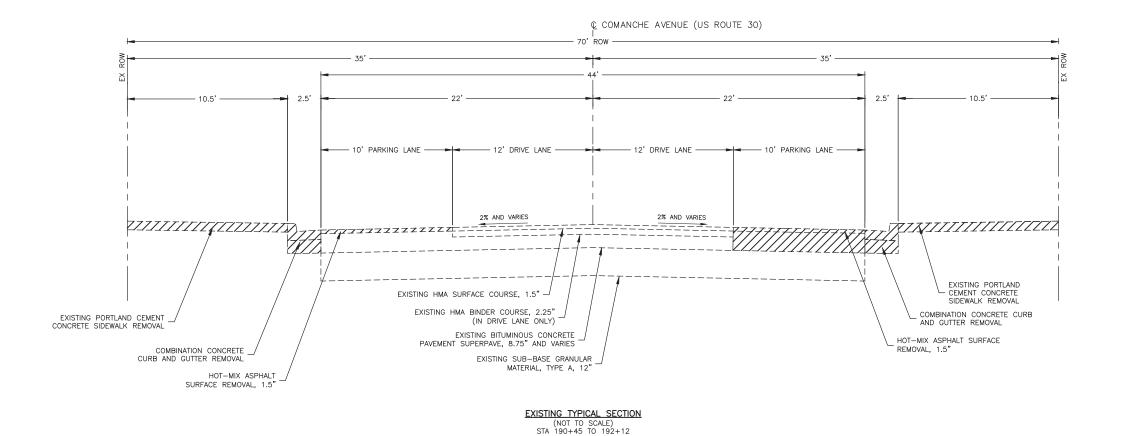

THE FOLLOWING HMA MIXTURE REQUIREMENTS ARE APPLICABLE FOR THIS PROJECT:			
LIFT THICKNESS:	1.5"		
LOCATION(S):	COMANCHE AVE (ENTIRE PROJECT)		
MIXTURE USE(S):	HMA SURFACE		
PG:	PG 64-22		
DESIGN AIR VOIDS:	4.0% @ N50		
MIXTURE COMPOSITION:	IL-9.5		
FRICTION AGGREGATE:	С		
MIXTURE WEIGHT:	112 lb/sy/in		
QUALITY MANAGEMENT PROGRAM:	QC/QA		
SUBLOT SIZE:	N/A		
MATERIAL TRANSFER DEVICE:	N/A		

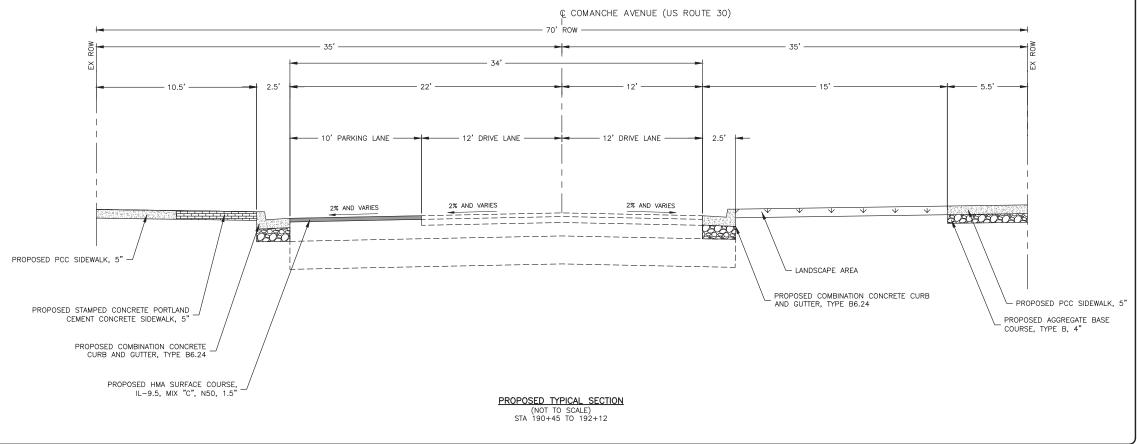



ILLINOIS IOWA WISCONSIN owner/developer:
VILLAGE OF SHABBONA
206 S. BLACKHAWK ST
SHABBONA, IL 60550

PROJECT AND LOCATION:
SHABBONA DOWNTOWN
STREETSCAPE
SHABBONA, IL

DRAWN BY: JMV
APPROVED BY: BS
DATE: 05/17/2023
SCALE: AS NOTED

REVISIONS
REV. NO. DESCRIPTION DATE

DRAWING:
TYPICAL SECTIONS


SET TYPE: FINAL
c:\C20\19\19-366\Plons.19-366 Plons.dwg, TYP. SECT. 4


JOB NUMBER:

19-366

SHEET NUMBER:


9 of 71

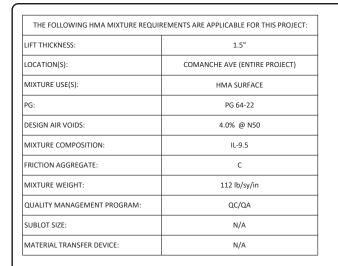

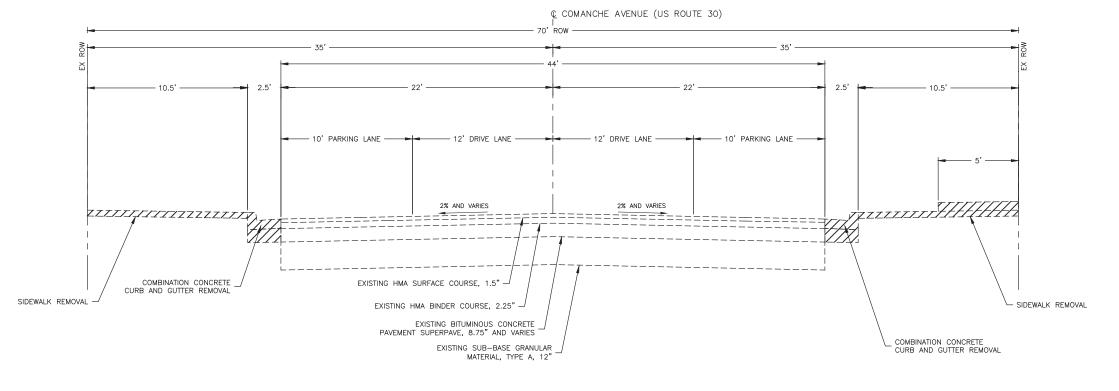

EXISTING TYPICAL SECTION
(NOT TO SCALE)
STA 192+12 TO 195+10

LIFT THICKNESS:	1.5"
LOCATION(S):	COMANCHE AVE (ENTIRE PROJECT)
MIXTURE USE(S):	HMA SURFACE
PG:	PG 64-22
DESIGN AIR VOIDS:	4.0% @ N50
MIXTURE COMPOSITION:	IL-9.5
FRICTION AGGREGATE:	С
MIXTURE WEIGHT:	112 lb/sy/in
QUALITY MANAGEMENT PROGRAM:	QC/QA
SUBLOT SIZE:	N/A
MATERIAL TRANSFER DEVICE:	N/A

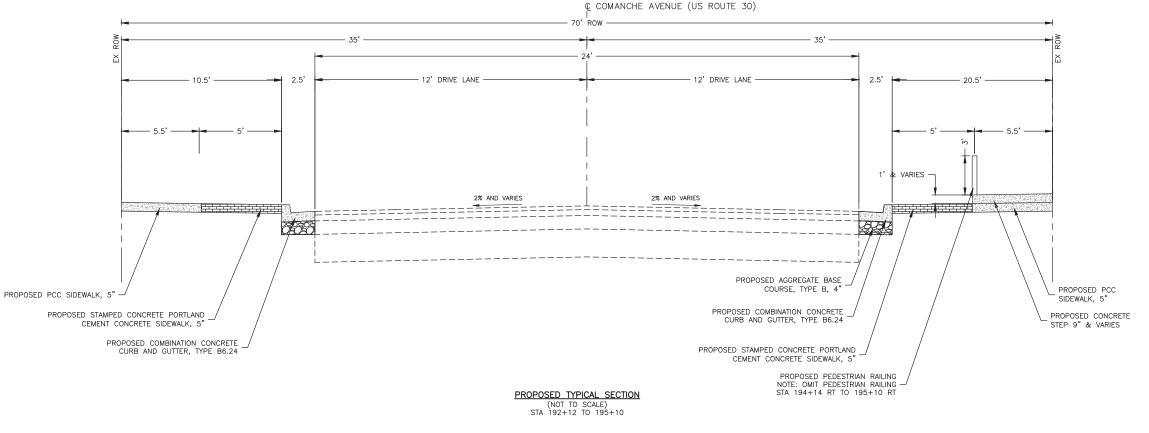



ILLINOIS IOWA WISCONSIN VILLAGE OF SHABBONA 206 S. BLACKHAWK ST SHABBONA, IL 60550 PROJECT AND LOCATION:
SHABBONA DOWNTOWN
STREETSCAPE
SHABBONA, IL

DRAWN BY: JMV
APPROVED BY: BS
DATE: 05/17/2023
SCALE: AS NOTED

REVISIONS
REV. NO. DESCRIPTION DATE

DRAWING:
TYPICAL SECTIONS


SET TYPE: FINAL


JOB NUMBER:

19-366

SHEET NUMBER:


10 of 71

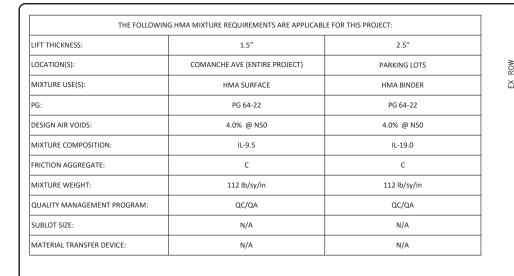

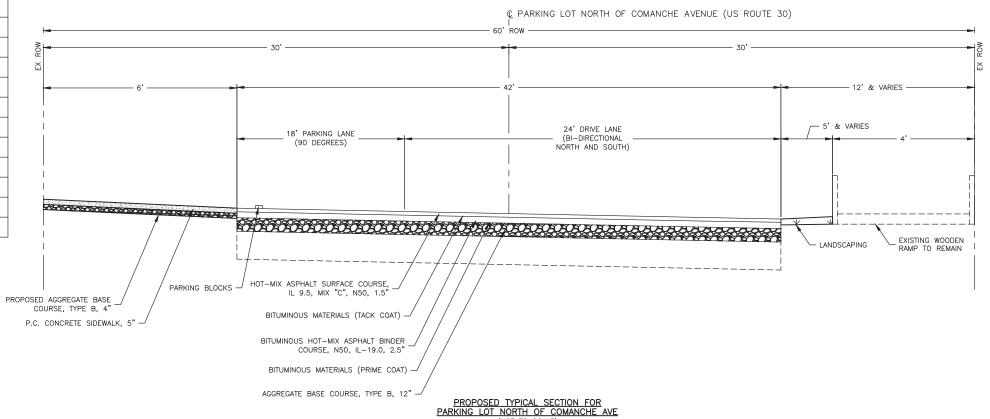

(NOT TO SCALE)

THE FOLLOWING HMA MIXTURE REQUIREMENTS ARE APPLICABLE FOR THIS PROJECT:		
LIFT THICKNESS: 1.5"		2.5"
LOCATION(S):	COMANCHE AVE (ENTIRE PROJECT)	PARKING LOTS
MIXTURE USE(S):	HMA SURFACE	HMA BINDER
PG:	PG 64-22	PG 64-22
DESIGN AIR VOIDS:	4.0% @ N50	4.0% @ N50
MIXTURE COMPOSITION:	IL-9.5	IL-19.0
FRICTION AGGREGATE:	С	С
MIXTURE WEIGHT:	112 lb/sy/in	112 lb/sy/in
QUALITY MANAGEMENT PROGRAM:	QC/QA	QC/QA
SUBLOT SIZE:	N/A	N/A
MATERIAL TRANSFER DEVICE:	N/A	N/A

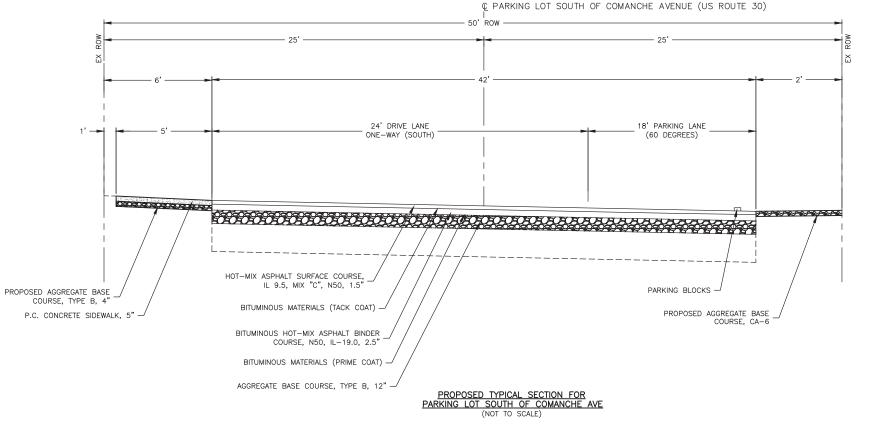



ILLINOIS IOWA WISCONSIN VILLAGE OF SHABBONA 206 S. BLACKHAWK ST SHABBONA, IL 60550 PROJECT AND LOCATION:
SHABBONA DOWNTOWN
STREETSCAPE
SHABBONA, IL

DRAWN BY: JMV
APPROVED BY: BS
DATE: 05/17/2023
SCALE: AS NOTED

REVISIONS
REV. NO. DESCRIPTION DATE

DRAWING:
TYPICAL SECTIONS

SET TYPE: FINAL

JOB NUMBER:

19-366

SHEET NUMBER:

11 of **71**

		SHABBONA DOWNTOWN STREETSCAPES -	SUMMARY OF C	UANTITIES - 2	3-00019-01-LS		
SPECIALTY ITEM	ITEM#	PAY ITEMS	UNIT	TOTAL QUANTITY	ITEP FUNDS - CONSTRUCTION CODE 0028 (80% FEDERAL / 20% LOCAL)	LOCAL SHARE FUNDS (100% LOCAL)	ITEP FUNDS LIGHTING - CONSTRUCTION CODE 0028 (50% FEDERAL / 50% LOCAL)
*	20100110	TREE REMOVAL (6 TO 15 UNITS DIAMETER)	UNIT	18	18	0	0
	20200100	EARTH EXCAVATION	CU YD	428	28	400	0
*	25200110	SODDING, SALT TOLERANT	SQ YD	151	151	0	0
	28000500	INLET AND PIPE PROTECTION	EACH	11	11	0	0
	35101600	AGGREGATE BASE COURSE, TYPE B 4"	SQ YD	2125	2033	92	0
	35102400	AGGREGATE BASE COURSE, TYPE B 12"	SQ YD	938	0	938	0
	35300600	PORTLAND CEMENT CONCRETE BASE COURSE 11"	SQ YD	95	95	0	0
	40603080	HOT-MIX ASPHALT BINDER COURSE, IL-19.0, N50	TON	135	0	135	0
	40604050	HOT-MIX ASPHALT SURFACE COURSE, IL-9.5, MIX "C", N50	TON	158	75	83	0
	40800025	BITUMINOUS MATERIALS (PRIME COAT)	POUND	2015	0	2015	0
	40800029	BITUMINOUS MATERIALS (TACK COAT)	POUND	793	388	405	0
	42300300	PORTLAND CEMENT CONCRETE DRIVEWAY PAVEMENT, 7 INCH	SQ YD	519	507	12	0
	42400200	PORTLAND CEMENT CONCRETE SIDEWALK 5 INCH	SQ FT	8403	7128	1275	0
	42400800	DETECTABLE WARNINGS	SQ FT	40	40	0	0
	44000100	PAVEMENT REMOVAL	SQ YD	1719	437	1282	0
	44000155	HOT-MIX ASPHALT SURFACE REMOVAL, 1 1/2"	SQ YD	810	810	0	0
	44000200	DRIVEWAY PAVEMENT REMOVAL	SQ YD	498	498	0	0
	44000500	COMBINATION CURB AND GUTTER REMOVAL	FOOT	1430	1430	0	0
	44000600	SIDEWALK REMOVAL	SQ FT	10721	10721	0	0
	44213200	SAW CUTS	FOOT	1430	1430	0	0
*	50900805	PEDESTRIAN RAILING	FOOT	250	250	0	0
	55100500	STORM SEWER REMOVAL 12"	FOOT	10	10	0	0
	55101200	STORM SEWER REMOVAL, 24"	FOOT	15	15	0	0
	60219000	MANHOLES, TYPE A, 4'-DIAMETER, TYPE 8 GRATE	EACH	1	1	0	0
	60221100	MANHOLES, TYPE A, 5'-DIAMETER, TYPE 1 FRAME, CLOSED LID	EACH	1	1	0	0
	60221700	MANHOLES, TYPE A, 5'-DIAMETER, TYPE 8 GRATE	EACH	1	1	0	0
	60240220	INLETS, TYPE B, TYPE 3 FRAME AND GRATE	EACH	4	4	0	0
	60255500	MANHOLES TO BE ADJUSTED	EACH	1	1	0	0
	60260100	INLETS TO BE ADJUSTED	EACH	5	5	0	0
	60266600	VALVE BOXES TO BE ADJUSTED	EACH	10	10	0	0
	60500060	REMOVING INLETS	EACH	2	2	0	0
	60605000	COMBINATION CONCRETE CURB AND GUTTER, TYPE B-6.24	FOOT	1527	1527	0	0
*	64000110	SIGHT SCREEN (CHAIN LINK FENCE) 6'	FOOT	45	0	45	0
*	66400305	CHAIN LINK FENCE, 6'	FOOT	30	0	30	0
*	66407600	CHAIN LINK GATES, 6' X 12' DOUBLE	EACH	1	0	1	0
*	66900200	NON-SPECIAL WASTE DISPOSAL	CU YD	114	114	0	0
*	66901001	REGULATED SUBSTANCES PRE-CONSTRUCTION PLAN	L SUM	1	1	0	0
*	66901003	REGULATED SUBSTANCES FINAL CONSTRUCTION REPORT	L SUM	1	1	0	0
*	66901006	REGULATED SUBSTANCES MONITORING	CAL DAY	9	9	0	0
*	66900530	SOIL DISPOSAL ANALYSIS	EACH	10	10	0	0
	67100100	MOBILIZATION	L SUM	1	1	0	0
	70107004	PAVEMENT MARKING BLACKOUT TAPE, 4"	FOOT	1805	1805	0	0
	70107008	PAVEMENT MARKING BLACKOUT TAPE, 8"	FOOT	160	160	0	0
	70307120	TEMPORARY PAVEMENT MARKING - LINE 4" - TYPE IV TAPE	FOOT	9800	9800	0	0
*	78000100	THERMOPLASTIC PAVEMENT MARKING - LETTERS AND SYMBOLS	SQ FT	40	0	40	0
*	78000200	THERMOPLASTIC PAVEMENT MARKING - LINE 4"	FOOT	820	294	526	0
*	78000600	THERMOPLASTIC PAVEMENT MARKING - LINE 12"	FOOT	275	275	0	0
*	81028720	UNDERGROUND CONDUIT, COILABLE NONMETALLIC CONDUIT, 1" DIA.	FOOT	70	0	0	70
*	81028730	UNDERGROUND CONDUIT, COILABLE NONMETALLIC CONDUIT, 1 1/4" DIA.	FOOT	2500	0	0	2500
*	81702420	ELECTRIC CABLE IN CONDUIT, 600V (XLP-TYPE USE) 3-1/C NO. 8	FOOT	4804	0	0	4804
*	81702450	ELECTRIC CABLE IN CONDUIT, 600V (XLP-TYPE USE) 3-1/C NO. 10	FOOT	1000	0	0	1000

	SHABBONA DOWNTOWN STREETSCAPES - SUMMARY OF QUANTITIES - 23-00019-01-LS						
SPECIALTY ITEM	ITEM #	PAY ITEMS	UNIT	TOTAL QUANTITY	ITEP FUNDS - CONSTRUCTION CODE 0028 (80% FEDERAL / 20% LOCAL)	LOCAL SHARE FUNDS (100% LOCAL)	ITEP FUNDS LIGHTING - CONSTRUCTION CODE 0028 (50% FEDERAL / 50% LOCAL)
*	83600200	LIGHT POLE FOUNDATION, 24" DIAMETER	FOOT	111	0	0	111
*	84200600	REMOVAL OF LIGHTING UNIT, NO SALVAGE	EACH	13	0	0	13
*	A2000086	TREE, ACER X FREEMANII ARMSTRONG (ARMSTRONG FREEMAN MAPLE), 2-1/2" CALIPER, BALLED AND BURLAPPED	EACH	4	4	0	0
*	A2003021	TREE, CELTIS OCCIDENTALIS JFS-KSU1 (PRAIRIE SENTINEL HACKBERRY), 2-1/2" CALIPER, BALLED AND BURLAPPED	EACH	2	2	0	0
*	A2006519	TREE, ULMUS TRIUMPH MORTON GLOSSY (HYBRID ELM), 2-1/2" CALIPER, BALLED AND BURLAPPED	EACH	7	7	0	0
*	C2000660	SHRUB, ARONIA MELANOCARPA MORTON (IROQUOIS BEAUTY BLACK CHOKEBERRY), 2-6" HEIGHT, BALLED AND BURLAPPED	EACH	5	5	0	0
*	C2002437	SHRUB, DIERVILLA G2X88544 (KODIAK ORANGE BUSH HONEYSUCKLE), CONTAINER GROWN, 3-GALLON	EACH	27	27	0	0
*	C2005228	SHRUB, POTENTILLA FRUTICOSA KIPINPA, (HAPPY FACE PINK PARADISE CINQUEFOIL), CONTAINER GROWN, 18" HEIGHT, 3-GALLON	EACH	10	10	0	0
*	C20058G5	SHRUB, RHUS AROMATICA GRO-LOW (GRO-LOW FRAGRANT SUMAC), 5-GALLON	EACH	3	3	0	0
*	C20132G3	SHRUB, WEIGELA MINUET (MINUET OLD FASHIONED WEIGELA), 3-GALLON CONTAINER	EACH	4	4	0	0
*	C2015302	SHRUB, JUNIPERUS CHINENSIS KALLAY'S COMPACTA, (KALLAY COMPACT JUNIPER), 5-GALLON	EACH	6	6	0	0
*	C2C06402	SHRUB, ROSA AMBER ROSE (AMBER ROSE FLOWER CARPET ROSE) 24" HEIGHT, CONTAINER	EACH	4	4	0	0
*	K0012990	PERENNIAL PLANTS, ORNAMENTAL TYPE, GALLON POT	UNIT	10.76	10.76	0	0
*	K0012993	PERENNIAL PLANTS, ORNAMENTAL TYPE, 3-GALLON POT	UNIT	0.29	0.29	0	0
*	K1001988	IRRIGATION SYSTEM SPECIAL	L SUM	1	1	0	0
*	X0322330	HANDICAP SIGN	EACH	2	0	2	0
	X0323378	CONCRETE PARKING BLOCKS	EACH	18	0	18	0
	X0326671	CONCRETE SURFACE COLOR TREATMENT	SQ FT	1670	1670	0	0
*	X0326696	SIGN AND POST	EACH	7	2	5	0
	X0326806	WASHOUT BASIN	L SUM	1	1	0	0
*	X0325379	DIRECTIONAL BORING	FOOT	2460	0	0	2460
	X0327301	RELOCATE EXISTING MAILBOX	EACH	1	1	0	0
	X0327997	TRASH RECEPTACLES	EACH	12	12	0	0
*	X1400210	LIGHT POLE, SPECIAL, 12'	EACH	6	0	6	0
*	X1400449	MODIFY EXISTING CABINET EQUIPMENT AND APPURTENANCES	EACH	2	0	0	2
	X1700067	STAMPED COLORED PORTLAND CEMENT CONCRETE SIDEWALK, 5 INCH	SQ FT	4367	4367	0	0
	X5510010	STORM SEWER CONNECTION	EACH	14	14	0	0
	X6010302	TRENCH DRAIN	FOOT	106	106	0	0
	X7010216	TRAFFIC CONTROL AND PROTECTION, (SPECIAL)	L SUM	1	1	0	0
*	X7240500	RELOCATE EXISTING SIGNS	EACH	3	3	0	0
*	X8300001	LIGHT POLE, SPECIAL	EACH	18	0	0	18
*	X8130110	JUNCTION BOX (SPECIAL)	EACH	4	0	0	4
*	XX008268	DECORATIVE GATEWAY ELEMENT	EACH	1	0	1	0
*	XX008811	GATE, SPECIAL	EACH	1	1	0	0
*	XX009591	LANDSCAPING PLANTER	EACH	14	14	0	0
	Z0012450	CONCRETE STEPS	CU YD	4	4	0	0
	Z0012455	CONCRETE STEP REMOVAL	EACH	2	2	0	0
	Z0013798	CONSTRUCTION LAYOUT	L SUM	1	1	0	0
	Z0003850	BENCHES	EACH	16	0	16	0
	Z0003855	BICYCLE RACKS	EACH	9	9	0	0
	Z0007126	HANDRAIL REMOVAL	FOOT	85	85	0	0



ILLINOIS IOWA WISCONSIN OWNER/DEVELOPER: VILLAGE OF SHABBONA

PROJECT AND LOCATION: SHABBONA DOWNTOWN 206 S. BLACKHAWK ST STREETSCAPE SHABBONA, IL 60550 SHABBONA, IL

DRAWN BY: JMV APPROVED BY: BS
DATE: 05/17/2023
SCALE: AS NOTED

	R E VISIONS	
REV. NO.	DESCRIPTION	DATE

SUMMARY OF QUANTITIES SET T(PE: FINAL av.\c30\19\19\-366\Plans.dwg, SOQ

JOB NUMBER: 19-366

12 of 71

0100110 - TREE REMOVAL (6 To 184+45 LT	6
104143 [1	
190+50 LT	6
193+20 LT	6
TOTA	L 18
0200100 - EARTH EXCAVATION	
182+63 - 186+68 LT	28
104.00.17	142
194+00 LT	143
194+00 RT	257
TOTA	L 428
5200110 - SODDING, SALT TOL	ERANT (SQ YD)
PROJECT	151
8000500 - INLET AND PIPE PRO	
182+73 LT	1
105.22.17	1
185+20 LT	1
188+70 RT	1
100170101	1
188+85 LT	1
189+81 RT	1
190+31 RT	1
190+77 LT	1
100 : 77 PT	1
190+77 RT	1
192+30 LT	1
192+30 RT	1
194+74 LT	1
TOTA	L 11
5101600 - AGGREGATE BASE C	OLIDSE TYPE B 4" (SO YD)
182+50 - 187+00 LT	237
188+50 - 191+00 LT	450
188+50 - 191+00 RT	335
191+00 - 195+00 LT	583
191+00 - 195+00 RT	520
TOTA	L 2125
5102400 - AGGREGATE BASE C	OURSE, TYPE B 12" (SO YD)
194+00 LT	320
254.00 L1	320
194+00 RT	618

PROJECT	95
TROJECT	
TOTAL	95
603080 - HOT-MIX ASPHALT BIN 19.0, N50 (TON)	DER COUR
194+00 LT	48
194+00 RT	87
TOTAL	135
604050 - HOT-MIX ASPHALT SUF BURSE, IL-9.5, MIX "C", N50 (TON	
194+00 LT	30
104.00.57	
194+00 RT	53
188+50 - 195+10 LT	46
188+50 - 195+10 RT	29
TOTAL	158
800025 - BITUMINOUS MATERIA	IIS (DRIME
AT) (POUND)	
194+00 LT	720
194+00 RT	1295
TOTAL	2015
B00029 - BITUMINOUS MATERIA AT) (POUND)	ALS (TACK
194+00 LT	145
194+00 RT	260
188+50 - 195+10 LT	237
188+50 - 195+10 RT	151
TOTAL	793
 300300 - PORTLAND CEMENT CO IVEWAY PAVEMENT, 7 INCH (SC	
182+90 - 184+15 LT	90
185+40 - 186+60 LT	104
189+50 - 191+25 LT	81
189+75 - 190+75 RT	116
194+15 LT	58
134.12 El	36
194+15 RT	58
194+00 LT	12
TOTAL	519

DEWALK 5 INCH (SQ FT)	
182+50 - 186+80 LT	1472
188+50 - 191+00 LT	1670
188+50 - 191+00 RT	835
191+00 - 195+00 LT	1835
191+00 - 195+00 RT	1316
194+00 LT	585
194+10 RT	690
TOTAL	8403
42400800 - DETECTABLE WARNIN	GS (SO FT)
194+15 LT	10
194+15 RT	10
194+40 LT	10
194+40 RT	10
TOTAL	40
AAOOO1OO DAVEMENT DEMOVAL	(SO VD)
44000100 - PAVEMENT REMOVAL 182+50 - 186-90 LT	87
188+60 - 191+00 LT	111
188+50 - 189+60 RT	78
192+10 - 194+00 LT	76
192+10 - 194+00 RT	85
194+80 LT	482
194+80 RT	800
TOTAL	1719
44000200 - DRIVEWAY PAVEMEN YD)	T REMOVAL (SC
182+80 - 184+10 LT	134
185+50 - 186+80 LT	160
189+50 - 191+25 LT	55
189+70 - 190+60 RT	94
194+20 LT	55
TOTAL	498

REMOVAL (FOOT)	
182+50 - 184+10 LT	160
185+10 - 186+80 LT	145
188+50 - 191+30 LT	290
188+50 - 191+30 RT	275
	2/3
192+15 - 195+25 LT	285
192+15 - 195+25 RT	275
TOTAL	1430
44000600 - SIDEWALK REMOVA	(SQ FT)
188+50 - 191+50 LT	2406
188+50 - 191+50 RT	1487
191+50 - 195+00 LT	3863
191+50 - 195+00 RT	2965
TOTAL	10721
44213200 - SAW CUTS (FOOT)	
182+50 - 184+10 LT	160
185+10 - 186+80 LT	145
188+50 - 191+50 LT	270
188+30 - 191+30 RT	270
192+10 - 195+15 LT	295
192+10 - 195+15 RT	290
TOTAL	1430
FOOODOOF DEDECTRIAN BALLING	(FOOT)
50900805 - PEDESTRIAN RAILING 189+20 - 190+40 LT	100
192+30 - 194+00 RT	150
TOTAL	250
55100500 - STORM SEWER REM (FOOT)	OVAL 12"
190+80 LT	10
TOTAL	. 10
55101200 - STORM SEWER REMO	OVAL 24"
PROJECT	15
60219000 - MANHOLES, TYPE A, TYPE 8 GRATE (EACH)	
189+70 RT	1
60221100 - MANHOLES, TYPE A, TYPE 1 FRAME, CLOSED LID (EAC	
194+70 RT	1
60221700 - MANHOLES, TYPE A, TYPE 8 GRATE (EACH)	5' DIAMETER
	5' DIAMETER

60260100 - INLETS, TYPE B, TYPE	3 FRAME AND GRATE (EACH)
189+75 RT	1
190+30 RT	1
190+75 LT	1
190+75 RT	1
TOTAL	4
60255500 - MANHOLES TO BE AD	JUSTED (EACH)
182+60 LT	1
60260100 - INLETS TO BE ADJUST	ED (EACH)
	Γ
188+90 LT	1
188+80 RT	1
192+30 LT	1
192+25 RT	1
152 - 25 1(1	
194+60 LT	1
TOTAL	5
60266600 - VALVE BOXES TO BE A	ADJUSTED (EACH)
189+30 LT	1
190+90 LT	1
192+00 LT	3
192+95 RT	1
193+50 LT	1
	-
194+40 RT	1
404.65.17	
194+65 LT	1
194+80 RT	1
TOTAL	10
60500060 - REMOVING INLETS (E	L ACH)
190+70 LT	1
190+70 RT	1
TOTAL	2
	CRETE CURB AND GUTTER, TYPE B-6.24 (FOOT)
182+75 - 184+20 LT	160
185+30 - 186+90 LT	145
188+50 - 191+40 LT	305
100±E0 101±40 DT	245
188+50 - 191+40 RT	315
192+10 - 195+15 LT	300
192+10 - 195+15 RT	302
TOTAL	1527
TOTAL	102.

194+20 LT	45
	-
66400305 - CHAIN LINK FENCE, 6'	(FOOT)
194+20 LT	30
66407600 - CHAIN LINK GATES, 6'	X 12' DOUBLE (EACH)
194+20 LT	1
67100100 - MOBILIZATION (L SUN	/I)
PROJECT	1
70107004 - PAVEMENT MARKING	BLACKOUT TAPE, 4" (FOOT)
182+50 - 187+50	1640
188+50 - 191+50	75
191+50 - 195+00	90
TOTAL	1805
70107008 - PAVEMENT MARKING	BLACKOUT TAPE, 8" (FOOT)
182+50 - 184+90	160
70207420	CALL MAD DVING LINE AT TYPE IV TARE (FOOT)
	ENT MARKING - LINE 4" - TYPE IV TAPE (FOOT)
182+75 - 188+00	4200
188+00 - 192+00	3200
100.00 131.00	3233
192+00 - 195+00	2400
TOTAL	9800
	EMENT MARKING - LETTERS AND SYMBOLS (SQ FT)
194+00 LT	11
194+50 RT	29
134±30 K1	73
TOTAL	40
101112	
78000200 - THERMOPLASTIC PAV	EMENT MARKING - LINE 4" (FOOT)
188+50 - 191+50 LT / RT	160
192+10 - 195+10 LT / RT	134
194+00 LT	114
104±50 PT	412
194+50 RT	412
TOTAL	820
TOTAL	020

FEHR GRAHAM

ENGINEERING & ENVIRONMENTAL
ILLINOIS DESIGN FIRM NO. 184-003525

ILLINOIS IOWA WISCONSIN VILLAGE OF SHABBONA 206 S. BLACKHAWK ST SHABBONA, IL 60550 PROJECT AND LOCATION:
SHABBONA DOWNTOWN
STREETSCAPE
SHABBONA, IL

DRAWN BY: JMV
APPROVED BY: BS
DATE: 05/17/2023
SCALE: AS NOTED

	REVISIONS	
REV. NO.	DESCRIPTION	DATE

DRAWING:
SCHEDULE OF QUANTITIES

SET TYPE: FINAL

JOB NUMBER:
19-366

SHEET NUMBER:
13 of 71

PROJECT	275
PROJECT	2/3
81028720 - UNDERGROUND COI NONMETALLIC CONDUIT, 1" DIA	NDUIT, COILABI
PROJECT	70
81028730 - UNDERGROUND COI	
NONMETALLIC CONDUIT, 1 1/4"	
181+50 - 187+60 LT	680
181+50 - 187+60 RT	640
187+60 - 191+80 LT	550
191+80 - 195+25 LT	330
194+50 - 195+75 RT	120
194+10 LT	60
194+50 RT	120
TOTAI	_ 2500
81702420 - ELECTRIC CABLE IN C (XLP-TYPE USE) 3-1/C NO. 8 (FO	
PROJECT	4804
81702450 - ELECTRIC CABLE IN C	ONDLIIT 600V
(XLP-TYPE USE) 3-1/C NO. 10 (FC	
PROJECT	1000
83600200 - LIGHT POLE FOUNDA	ATION, 24"
DIAMETER (FOOT)	
83600200 - LIGHT POLE FOUNDA DIAMETER (FOOT) PROJECT	111
PROJECT PROVAL OF LIGHTI	111
DIAMETER (FOOT) PROJECT	111
PROJECT 84200600 - REMOVAL OF LIGHTI SALVAGE (EACH)	111 NG UNIT, NO
PROJECT 84200600 - REMOVAL OF LIGHTI SALVAGE (EACH)	111 NG UNIT, NO
PROJECT 84200600 - REMOVAL OF LIGHTI SALVAGE (EACH) 182+85 LT	111 NG UNIT, NO
PROJECT 84200600 - REMOVAL OF LIGHTI SALVAGE (EACH) 182+85 LT 184+85 LT	111 NG UNIT, NO 1
PROJECT 84200600 - REMOVAL OF LIGHTI SALVAGE (EACH) 182+85 LT 184+85 LT	111 NG UNIT, NO 1
DIAMETER (FOOT) PROJECT 84200600 - REMOVAL OF LIGHTI SALVAGE (EACH) 182+85 LT 184+85 LT 186+78 LT	111 NG UNIT, NO 1 1 1
DIAMETER (FOOT) PROJECT 84200600 - REMOVAL OF LIGHTI SALVAGE (EACH) 182+85 LT 184+85 LT 186+78 LT 188+45 RT	111 NG UNIT, NO 1 1 1 1
DIAMETER (FOOT) PROJECT 84200600 - REMOVAL OF LIGHTI SALVAGE (EACH) 182+85 LT 184+85 LT 186+78 LT 188+45 RT	111 NG UNIT, NO 1 1 1 1
DIAMETER (FOOT) PROJECT 84200600 - REMOVAL OF LIGHTI SALVAGE (EACH) 182+85 LT 184+85 LT 186+78 LT 188+45 RT 188+47 LT 190+35 LT	111 NG UNIT, NO 1 1 1 1 1
DIAMETER (FOOT) PROJECT 84200600 - REMOVAL OF LIGHTI SALVAGE (EACH) 182+85 LT 184+85 LT 186+78 LT 188+45 RT 188+47 LT	111 NG UNIT, NO 1 1 1 1 1 1 1
DIAMETER (FOOT) PROJECT 84200600 - REMOVAL OF LIGHTI SALVAGE (EACH) 182+85 LT 184+85 LT 186+78 LT 188+45 RT 188+47 LT 190+35 LT	111 NG UNIT, NO 1 1 1 1 1 1 1
DIAMETER (FOOT) PROJECT 84200600 - REMOVAL OF LIGHTI SALVAGE (EACH) 182+85 LT 184+85 LT 186+78 LT 188+45 RT 188+47 LT 190+35 LT 190+65 RT	111 NG UNIT, NO 1 1 1 1 1 1 1 1 1 1 1 1 1 1 1 1 1 1
DIAMETER (FOOT) PROJECT 84200600 - REMOVAL OF LIGHTI SALVAGE (EACH) 182+85 LT 184+85 LT 186+78 LT 188+45 RT 188+47 LT 190+35 LT	111 NG UNIT, NO 1 1 1 1 1 1 1 1 1
DIAMETER (FOOT) PROJECT 84200600 - REMOVAL OF LIGHTI SALVAGE (EACH) 182+85 LT 184+85 LT 186+78 LT 188+45 RT 188+47 LT 190+35 LT 190+65 RT	111 NG UNIT, NO 1 1 1 1 1 1 1 1 1 1 1 1 1 1 1 1 1 1
DIAMETER (FOOT) PROJECT 84200600 - REMOVAL OF LIGHTI SALVAGE (EACH) 182+85 LT 184+85 LT 186+78 LT 188+45 RT 189+35 LT 190+35 LT 190+65 RT 192+20 LT 192+20 RT	111 NG UNIT, NO 1 1 1 1 1 1 1 1 1 1 1 1 1
DIAMETER (FOOT) PROJECT 84200600 - REMOVAL OF LIGHTI SALVAGE (EACH) 182+85 LT 184+85 LT 186+78 LT 188+45 RT 188+47 LT 190+35 LT 190+65 RT 192+20 LT	111 NG UNIT, NO 1 1 1 1 1 1 1 1 1 1 1 1 1 1 1 1 1 1
DIAMETER (FOOT) PROJECT 84200600 - REMOVAL OF LIGHTI SALVAGE (EACH) 182+85 LT 184+85 LT 186+78 LT 188+45 RT 189+35 LT 190+35 LT 190+65 RT 192+20 LT 192+20 RT	111 NG UNIT, NO 1 1 1 1 1 1 1 1 1 1 1 1 1
DIAMETER (FOOT) PROJECT 84200600 - REMOVAL OF LIGHTI SALVAGE (EACH) 182+85 LT 184+85 LT 186+78 LT 188+45 RT 188+47 LT 190+35 LT 190+65 RT 192+20 LT 192+20 RT 193+95 LT	111 NG UNIT, NO 1 1 1 1 1 1 1 1 1 1 1 1 1

	PER, BALLED AND BURLAPPED (EACH)
PROJECT	4
•	DENTALIS JFS-KSU1 (PRAIRIE SENTINEL BALLED AND BURLAPPED (EACH)
PROJECT	2
A2006519 - TREE,ULMUS TRUII 2-1/2" CALIPER, BALLED AND B	MPH MORTON GLOSSY (HYBRID ELM), URLAPPED (EACH)
PROJECT	7
	ELANOCARPA MORTON (IROQUOIS BEAUT' GHT, BALLED AND BURLAPPED (EACH)
PROJECT	5
C2002437 - SHRUB, DIERVILLA HONEYSUCKLE), CONTAINER GI	 G2X88544 (KODIAK ORANGE BUSH ROWN, 3-GALLON (EACH)
PROJECT	27
	A FRUTICOSA KIPINPA, (HAPPY FACE PINK AINER GROWN, 18" HEIGHT, 3-GALLON
PROJECT	10
C20058G5 - SHRUB, RHUS ARO SUMAC), 5-GALLON (EACH)	MATICA GRO-LOW (GRO-LOW FRAGRANT
PROJECT	3
C20132G3 - SHRUB, WEIGELA N WEIGELA), 3-GALLON CONTAIN PROJECT	MINUET (MINUET OLD FASHIONED JER (EACH) 4
	CHINENSIS KALLAY'S COMPACTA, (KALLAY
PROJECT	6 6
C2C06402 - SHRUB, ROSA AMB ROSE) 24" HEIGHT, CONTAINER	ER ROSE (AMBER ROSE FLOWER CARPET
PROJECT	4
KOO12000 DEDENING DIANTE	CONTRACTOR TYPE CALLON BOT (UNIT)
KUU1299U - PERENNIAL PLANTS	5, ORNAMENTAL TYPE, GALLON POT (UNIT) 10.76
PROJECT	
	s, ORNAMENTAL TYPE, 3-GALLON POT
K0012993 - PERENNIAL PLANTS (UNIT)	, ORNAMENTAL TYPE, 3-GALLON POT
K0012993 - PERENNIAL PLANTS	
K0012993 - PERENNIAL PLANTS (UNIT) PROJECT K1001988 - IRRIGATION SYSTER	0.29 M SPECIAL (L SUM)
K0012993 - PERENNIAL PLANTS (UNIT) PROJECT	o, ORNAMENTAL TYPE, 3-GALLON POT
K0012993 - PERENNIAL PLANTS (UNIT) PROJECT K1001988 - IRRIGATION SYSTER	0.29 M SPECIAL (L SUM)
K0012993 - PERENNIAL PLANTS (UNIT) PROJECT K1001988 - IRRIGATION SYSTEM PROJECT	0.29 M SPECIAL (L SUM)
K0012993 - PERENNIAL PLANTS (UNIT) PROJECT K1001988 - IRRIGATION SYSTEM PROJECT X0322330 - HANDICAP SIGN (EA	0.29 M SPECIAL (L SUM) 1 ACH)
K0012993 - PERENNIAL PLANTS (UNIT) PROJECT K1001988 - IRRIGATION SYSTER PROJECT X0322330 - HANDICAP SIGN (E.	0.29 M SPECIAL (L SUM) 1 ACH)

X0323378 - CONCRETE PARKING E	BLOCKS (EACH)
194+00 LT	7
104.FF DT	44
194+55 RT	11
TOTAL	18
X0326671 - CONCRETE SURFACE C	
191+10 LT - 192+30 LT / RT	1670
X0326696 - SIGN AND POST (EACH	H)
190+05 LT	1
190+50 LT	1
104.1F.LT	1
194+15 LT	1
194+15 RT	1
194+40 LT	1
404.5017	4
194+50 LT	1
194+50 RT	1
TOTAL	7
VO226906 WASHOUT BASIN (FA	CH)
X0326806 - WASHOUT BASIN (EA	1
ritoler	1
X0325379 - DIRECTIONAL BORING	(FOOT)
PROJECT	2460
VO227204 DELOCATE EVICTINO A	AAU DOY (FACU)
180+20 LT	1
160+20 L1	1
X0327997 - TRASH RECEPTACLES ((EACH)
188+50 LT,RT	2
190+50 LT	1
191+50 RT	1
151150	
191+75 LT	1
191+75 LT 192+15 LT	1
192+15 LT	1
192+15 LT	1
192+15 LT 192+90 LT,RT	2
192+15 LT 192+90 LT,RT	2
192+15 LT 192+90 LT,RT 193+85 LT,RT 194+95 LT,RT	2 2 2
192+15 LT 192+90 LT,RT 193+85 LT,RT	2
192+15 LT 192+90 LT,RT 193+85 LT,RT 194+95 LT,RT	2 2 2 12
192+15 LT 192+90 LT,RT 193+85 LT,RT 194+95 LT,RT TOTAL	2 2 2 12
192+15 LT 192+90 LT,RT 193+85 LT,RT 194+95 LT,RT TOTAL X1400210 - LIGHT POLE, SPECIAL, 194+00 LT	1 2 2 2 2 12 12' (EACH) 2
192+15 LT 192+90 LT,RT 193+85 LT,RT 194+95 LT,RT TOTAL X1400210 - LIGHT POLE, SPECIAL,	2 2 2 2 12 12' (EACH)

188+45 LT	1
192+35 LT	1
TOTAL	2
X1700067 STAMPED COLORED PORTL SIDEWALK, 5 INCH (SQ FT)	AND CEMENT CONCR
188+50 - 191+00 LT	1005
188+50 - 191+00 RT	415
191+00 - 195+00 LT	1193
191+00 - 195+00 RT	1754
TOTAL	4367
X0327301 - STORM SEWER CONNECTI	
189+70 RT	2
190+25 RT	2
190+30 RT	1
190+80 RT	5
	-
190+80 LT	1
194+50 RT	3
154150 KI	3
TOTAL	14
X6010302 - TRENCH DRAIN (FOOT)	
189+50 LT	17
189+90 LT	17
190+80 LT	18
191+20 LT	27
194+00 LT	27
134100 E1	21
TOTAL	106
X7010216 - TRAFFIC CONTROL AND PI SUM)	ROTECTION, SPECIAL (
PROJECT	1
VZZAGEGO DELOCATE EVICTINIC CICI	C (FACU)
X7240500 - RELOCATE EXISTING SIGN:	1 (EACH)
183+62 LT	1
188+70 LT	1
194+35 RT	1

X8300001		
	- LIGHT POLE, SPECIAL	(EACH)
	181+50 RT	1
	101.50 Ki	-
	181+50 LT	1
	101.00 1.	
	182+50 RT	1
	102-50 111	
	182+65 LT	1
		_
	182+65 RT	1
		_
	183+80 RT	1
		_
	185+10 LT	1
	186+50 RT	1
	187+75 LT	1
	188+45 RT	1
	189+60 LT	1
		_
	190+60 RT	1
		_
	191+50 LT	1
	151.50 2.	
	192+10 RT	1
	132-10 111	
	193+10 LT	1
	155.10 [1	
	193+90 RT	1
	155.50 Ki	
	195+10 LT	1
	155.10 [1	
	195+85 RT	1
		_
	TOTAL	18
X8130110	- JUNCTION BOX (SPEC	IAL) (FACH)
		, ()
	187+60 RT	1
	187+60 RT	
	191+90 LT	
		1
		1
	191+90 LT	1
	191+90 LT	1
	191+90 LT 194+10 LT	1 1 1
	191+90 LT 194+10 LT	1 1 1
	191+90 LT 194+10 LT 195+00 RT	1 1 1
XX008268	191+90 LT 194+10 LT 195+00 RT	1 1 1 4
XX008268	191+90 LT 194+10 LT 195+00 RT TOTAL - DECORATIVE GATEW	1 1 1 4
XX008268	191+90 LT 194+10 LT 195+00 RT	1 1 1 1 4 AY ELEMENT (EACH)
	191+90 LT 194+10 LT 195+00 RT TOTAL - DECORATIVE GATEW	1 1 1 1 4 4 AY ELEMENT (EACH)
	191+90 LT 194+10 LT 195+00 RT TOTAL - DECORATIVE GATEW 191+60 LT	1 1 1 1 4 4 AY ELEMENT (EACH)
	191+90 LT 194+10 LT 195+00 RT TOTAL - DECORATIVE GATEW 191+60 LT - GATE, SPECIAL (EACH-	1 1 1 1 4 4 AY ELEMENT (EACH) 1
XX008811	191+90 LT 194+10 LT 195+00 RT TOTAL - DECORATIVE GATEW 191+60 LT - GATE, SPECIAL (EACH-	1 1 1 1 4 AY ELEMENT (EACH) 1
XX008811	191+90 LT 194+10 LT 195+00 RT TOTAL - DECORATIVE GATEW 191+60 LT - GATE, SPECIAL (EACH 194+90 LT - LANDSCAPING PLAN	1 1 1 1 1 1 1 1 1 1 1 1 1 1 1 1 1 1 1
XX008811	191+90 LT 194+10 LT 195+00 RT TOTAL - DECORATIVE GATEW 191+60 LT - GATE, SPECIAL (EACH- 194+90 LT	1 1 1 1 4 AY ELEMENT (EACH) 1
XX008811 XX009591	191+90 LT 194+10 LT 195+00 RT TOTAL - DECORATIVE GATEW 191+60 LT - GATE, SPECIAL (EACH 194+90 LT - LANDSCAPING PLAN' PROJECT	1 1 1 4 AY ELEMENT (EACH) 1 1 1 1 1 1 1 1 1 1 1 1 1 1 1 1 1 1 1
XX008811 XX009591	191+90 LT 194+10 LT 195+00 RT TOTAL - DECORATIVE GATEW 191+60 LT - GATE, SPECIAL (EACH 194+90 LT - LANDSCAPING PLAN PROJECT - CONCRETE STEPS (CU	1 1 1 1 4 AY ELEMENT (EACH) 1 1 1 1 1 1 1 1 1 1 1 1 1 1 1 1 1 1 1
XX008811 XX009591	191+90 LT 194+10 LT 195+00 RT TOTAL - DECORATIVE GATEW 191+60 LT - GATE, SPECIAL (EACH 194+90 LT - LANDSCAPING PLAN' PROJECT	1 1 1 4 AY ELEMENT (EACH) 1 1 1 1 1 1 1 1 1 1 1 1 1 1 1 1 1 1 1
XX008811 XX009591 Z0012450	191+90 LT 194+10 LT 195+00 RT TOTAL - DECORATIVE GATEW 191+60 LT - GATE, SPECIAL (EACH 194+90 LT - LANDSCAPING PLAN' PROJECT - CONCRETE STEPS (CU	1 1 1 4 AY ELEMENT (EACH) 1 1 1 1 1 1 1 1 1 1 1 1 1 1 1 1 1 1 1
XX008811 XX009591 Z0012450	191+90 LT 194+10 LT 195+00 RT TOTAL - DECORATIVE GATEW 191+60 LT - GATE, SPECIAL (EACH 194+90 LT - LANDSCAPING PLAN' PROJECT - CONCRETE STEPS (CU PROJECT	1 1 1 1 4 AY ELEMENT (EACH) 1 1 1 1 VD) 4 OVAL (EACH)
XX008811 XX009591 Z0012450	191+90 LT 194+10 LT 195+00 RT TOTAL - DECORATIVE GATEW 191+60 LT - GATE, SPECIAL (EACH 194+90 LT - LANDSCAPING PLAN' PROJECT - CONCRETE STEPS (CU	1 1 1 4 AY ELEMENT (EACH) 1 1 1 1 1 1 1 1 1 1 1 1 1 1 1 1 1 1 1

Z0003850 - BENCHES (EACH)	
188+80 RT	1
189+20 LT	1
189+25 RT	1
203125111	-
190+50 LT	1
191+50 LT	1
191+60 LT	1
191+80 LT	1
192+00 LT	1
192+50 RT	1
105 :-	
195+55 LT	1
192+90 RT	1
402.05.17	
192+95 LT	1
193+60 LT	1
193+60 RT	1
133100 KI	1
194+75 LT	1
194+75 RT	1
PROJECT	16
Z0003855 - BICYCLE RACKS (EACH))
188+50 LT	1
188+50 RT	2
191+40 LT	3
194+00 LT	2
194+50 RT	1
PROJECT	9
Z0007126 - HANDRAIL REMOVAL	(FOOT)
189+30 LT	35
190+20 LT	30
150.2011	30
195+00	20
TOTAL	85
IOTAL	1 33



ENGINEERING & ENVIRONMENTAL
ILLINOIS DESIGN FIRM NO. 184-003525

ILLINOIS IOWA WISCONSIN OWNER/DEVELOPER:
VILLAGE OF SHABBONA
206 S. BLACKHAWK ST
SHABBONA, IL 60550

PROJECT AND LOCATION:
SHABBONA DOWNTOWN
STREETSCAPE
SHABBONA, IL

CONTRACT NO. 87841

DRAWN BY: JMV
APPROVED BY: BS
DATE: 05/17/2023
SCALE: AS NOTED

	REVISIONS	
REV. NO.	DESCRIPTION	DATE
\Box		


PROJECT

DRAWING:
SCHEDULE OF QUANTITIES

SET TYPE: FINAL
G\(CD\(1)=\forall \)
GOOD (19\\(1)=\forall \)
G

JOB NUMBER: 19-366

SHEET NUMBER: 14 of 71

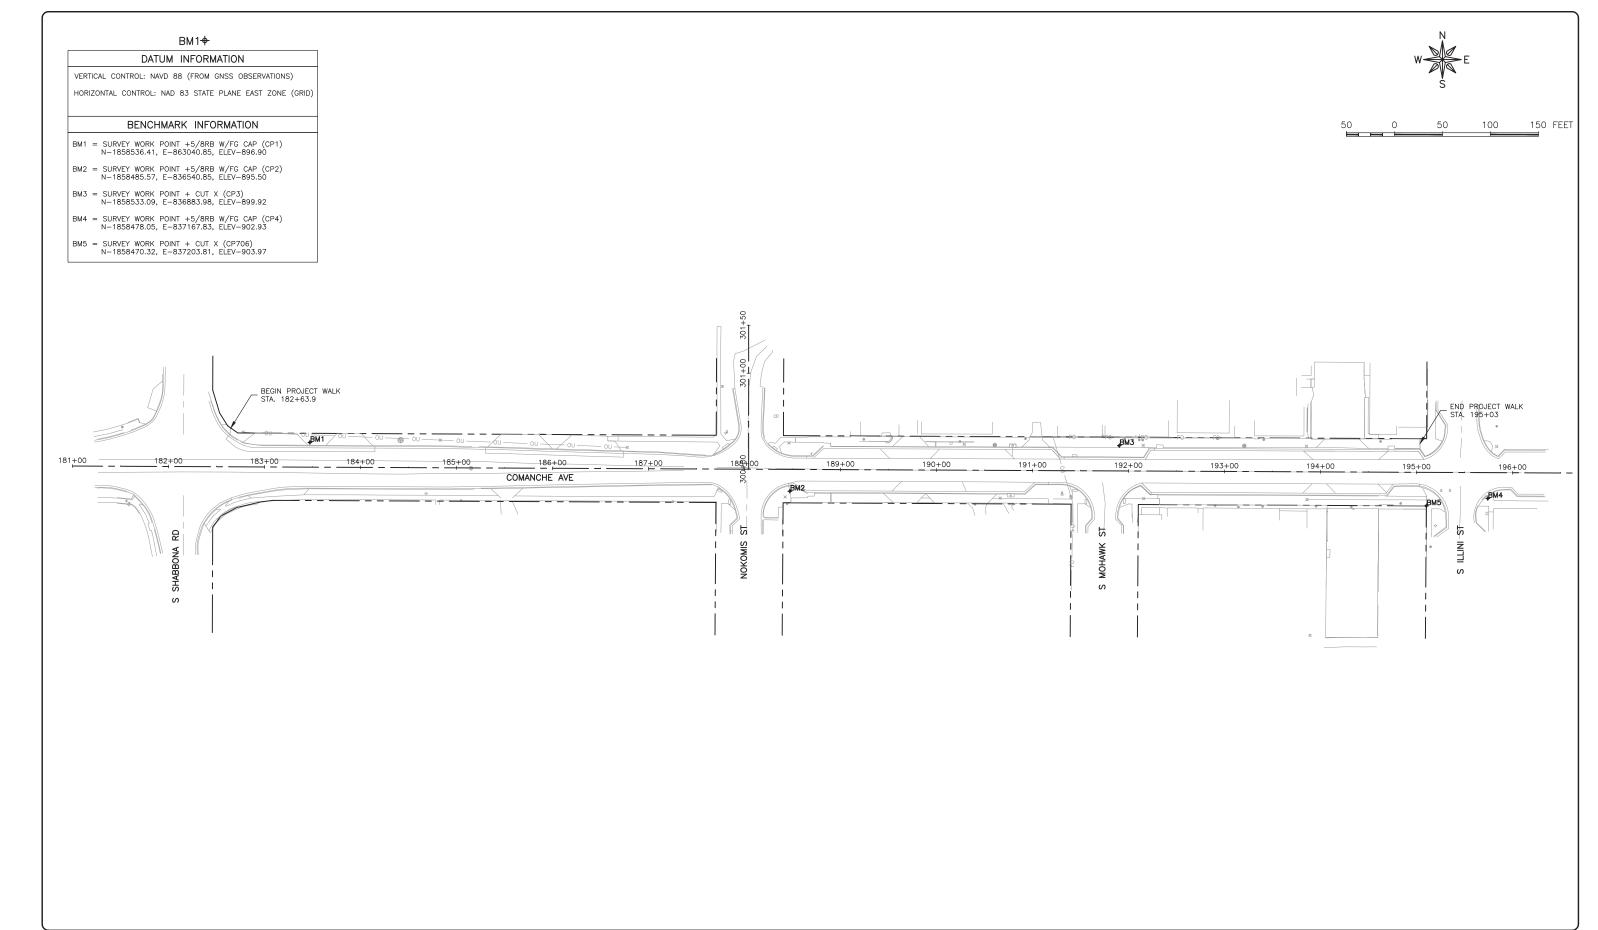



ILLINOIS IOWA WISCONSIN OWNER/DEVELOPER:

VILLAGE OF SHABBONA
206 S. BLACKHAWK ST
SHABBONA, IL 60550

PROJECT AND LOCATION:
SHABBONA DOWNTOWN
STREETSCAPE
SHABBONA, IL

DRAWN BY: JMV
APPROVED BY: BS
DATE: 05/17/2023
SCALE: AS NOTED

REVISIONS
REV. NO. DESCRIPTION DATE

DRAWING: ALIGNMENT AND BENCHMARK LOCATIONS


JOB NUMBER:

19-366

SHEET NUMBER:

15 of 71

SET TYPE: FINAL G:\C30\19\19-366\19-366 Design.dwg, AUGN-BENCH

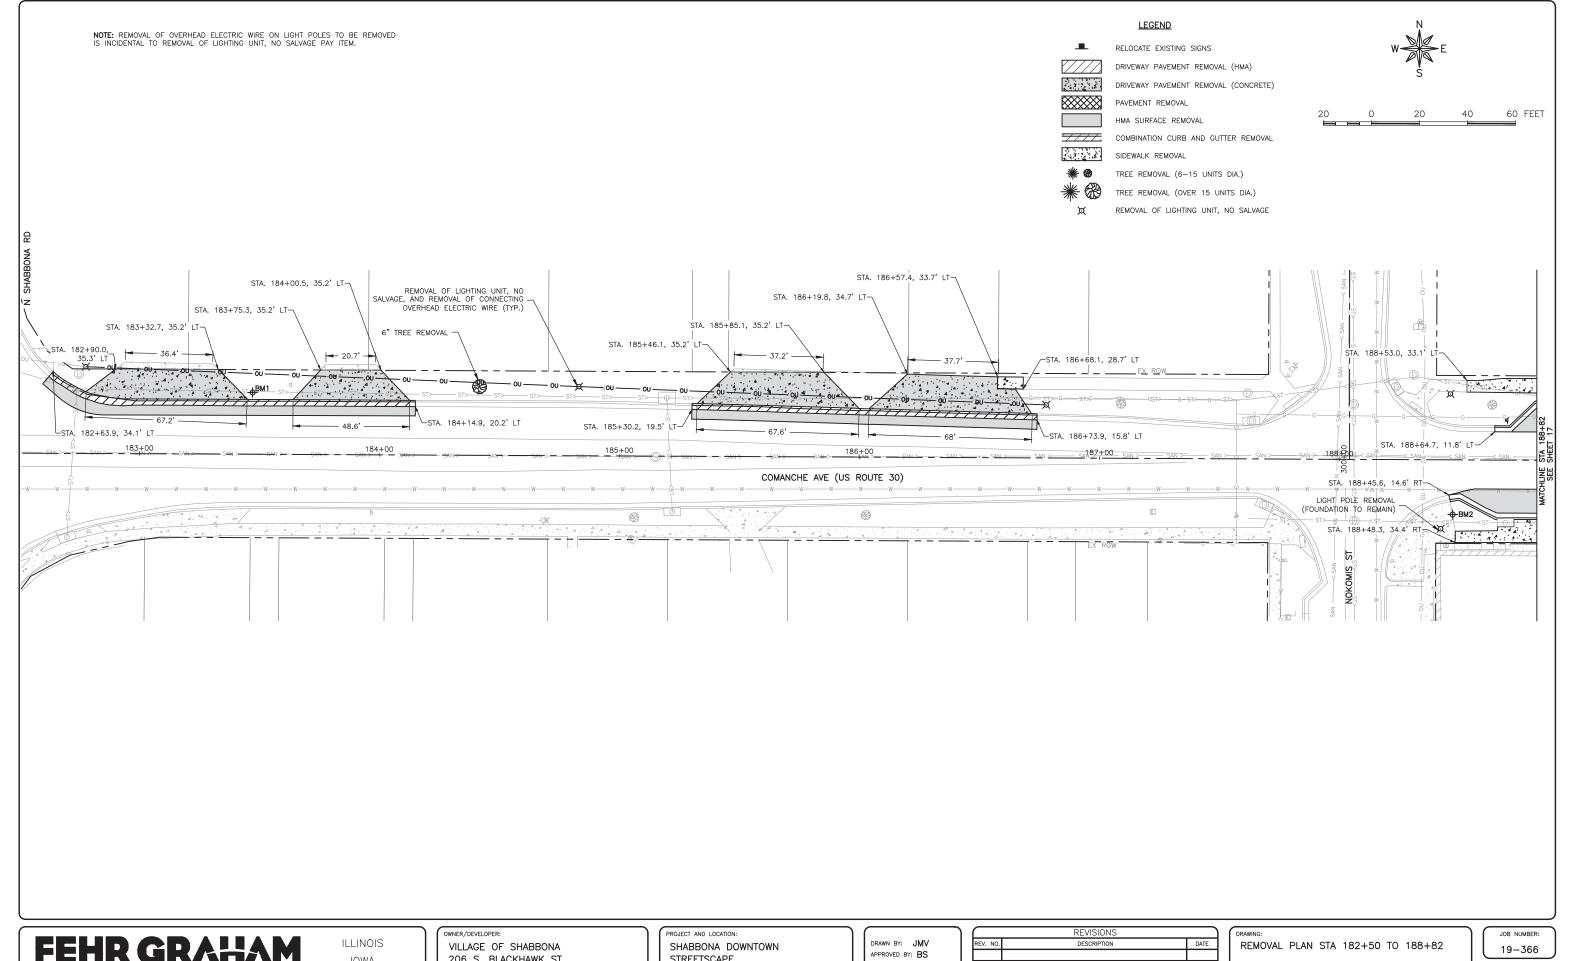

ENGINEERING & ENVIRONMENTAL ILLINOIS DESIGN FIRM NO. 184-003525 PLOT DATE: 6/19/23 © 2023 FEHR GRAHAM

IOWA WISCONSIN 206 S. BLACKHAWK ST SHABBONA, IL 60550

STREETSCAPE SHABBONA, IL


DATE: 05/17/2023 SCALE: AS NOTED

REVISIONS		
REV. NO.	DESCRIPTION	DATE

SET TYPE: FINAL

SHEET NUMBER:

16 of 71

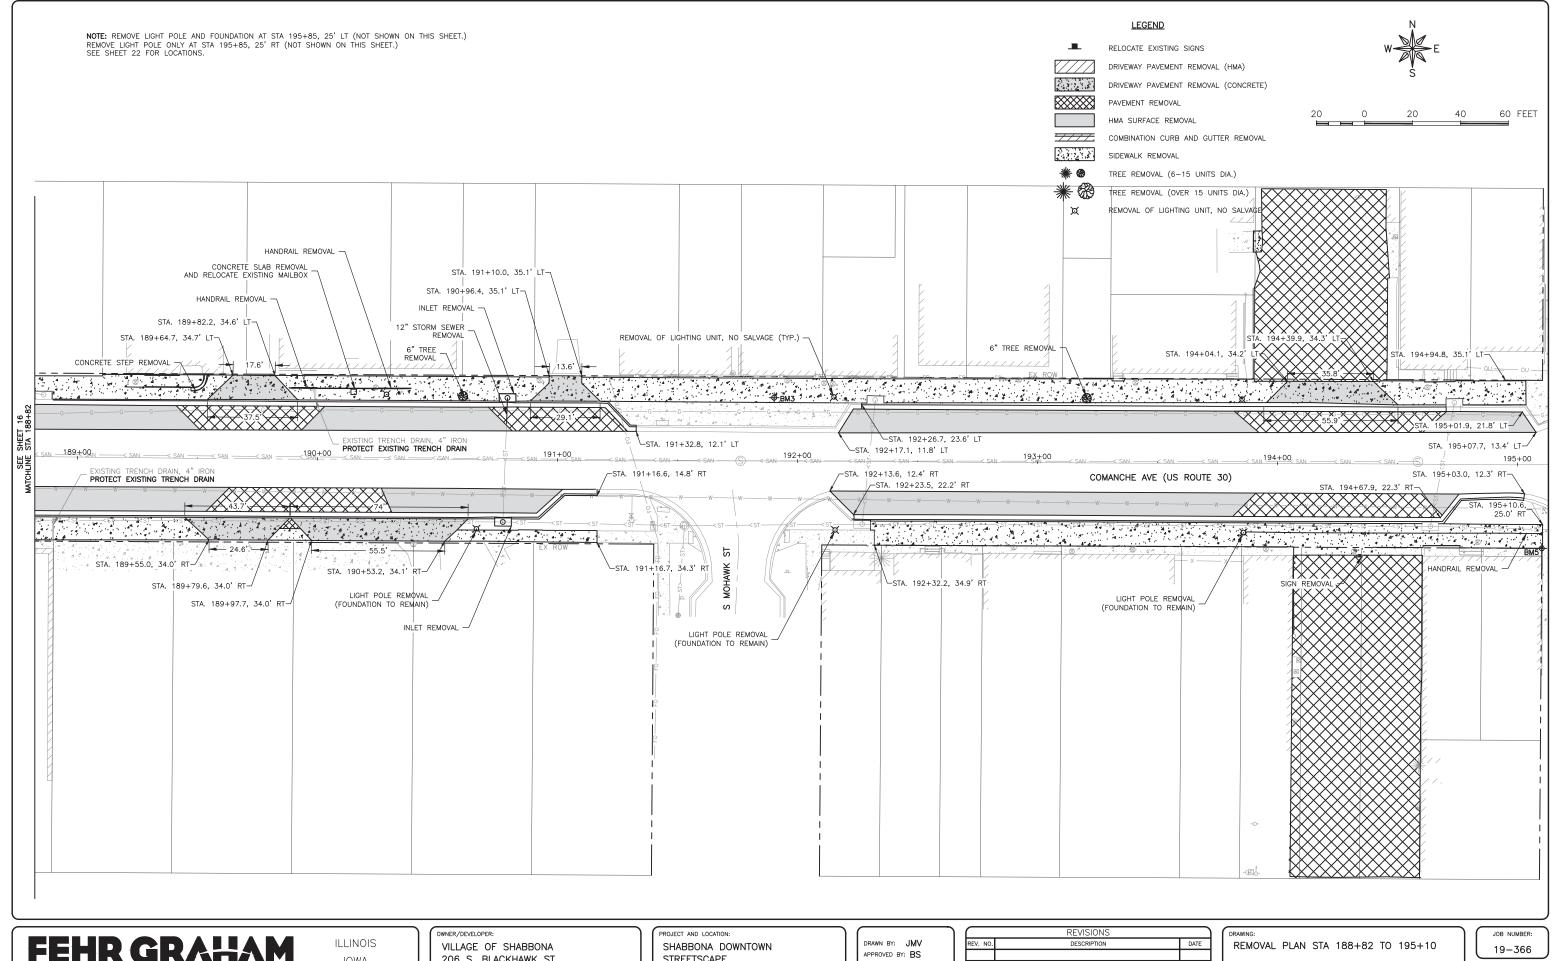

IOWA

WISCONSIN

206 S. BLACKHAWK ST SHABBONA, IL 60550

STREETSCAPE SHABBONA, IL

CONTRACT NO. 87841


DATE: 05/17/2023 SCALE: AS NOTED


REVISIONS		
REV. NO.	DESCRIPTION	DATE

SET TYPE: FINAL

SHEET NUMBER: **17** of **71**

ENGINEERING & ENVIRONMENTAL ILLINOIS DESIGN FIRM NO. 184-003525 PLOT DATE: 6/19/23 © 2023 FEHR GRAHAM

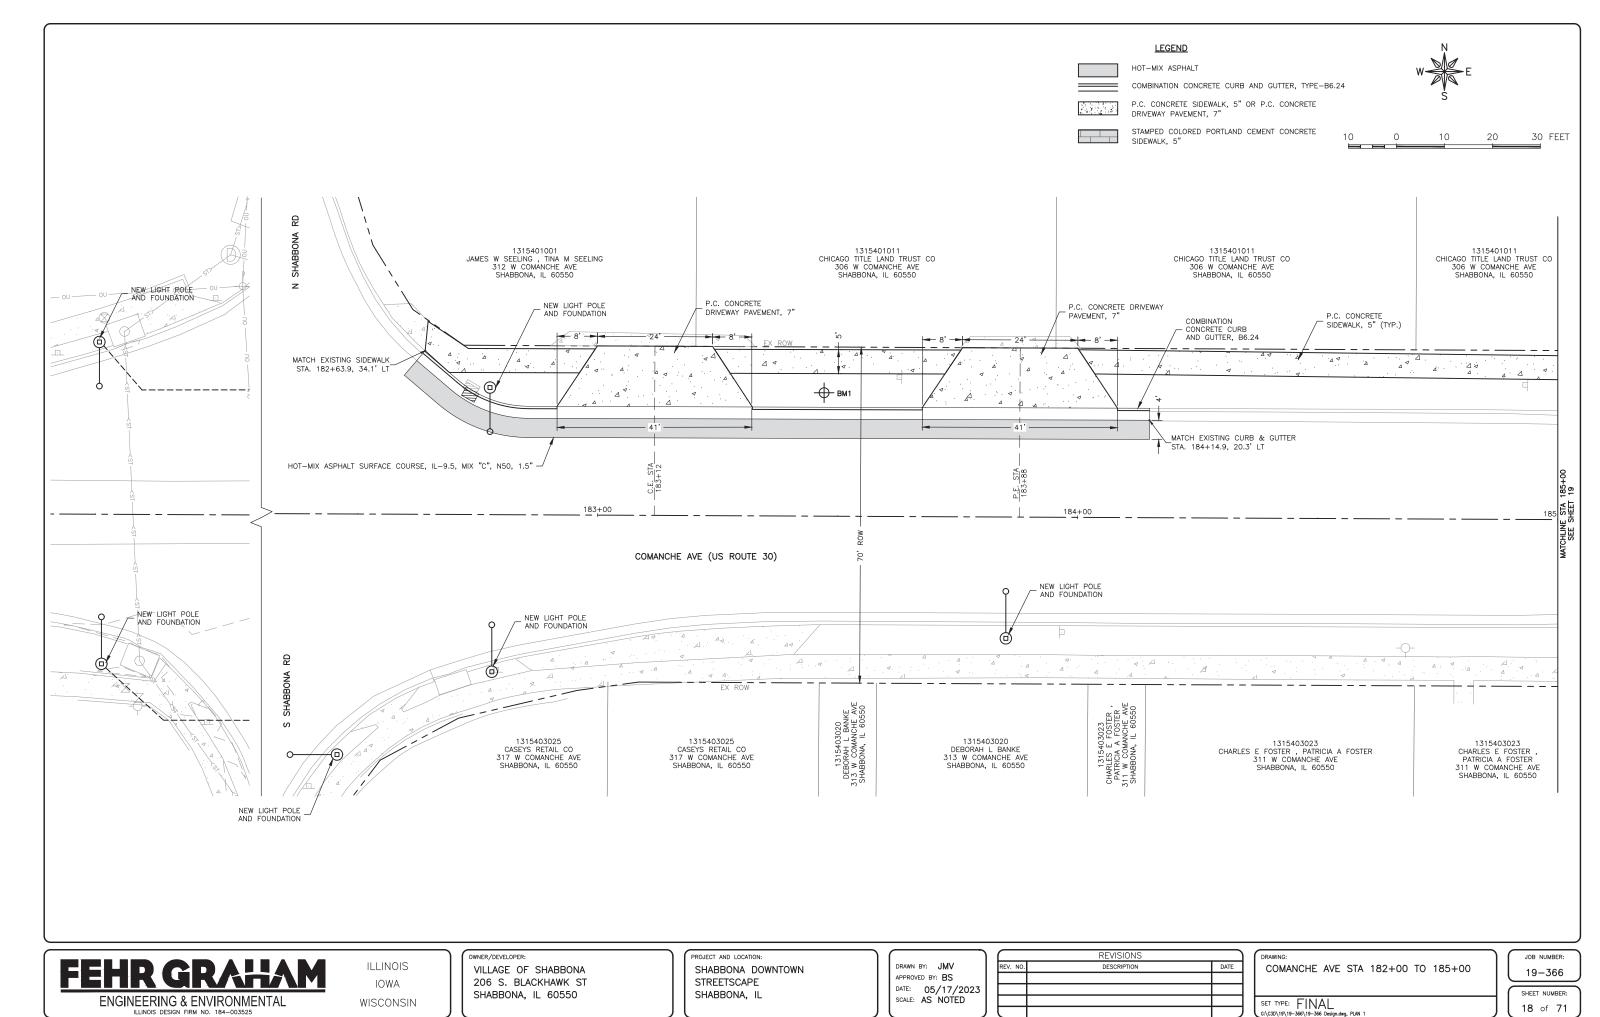

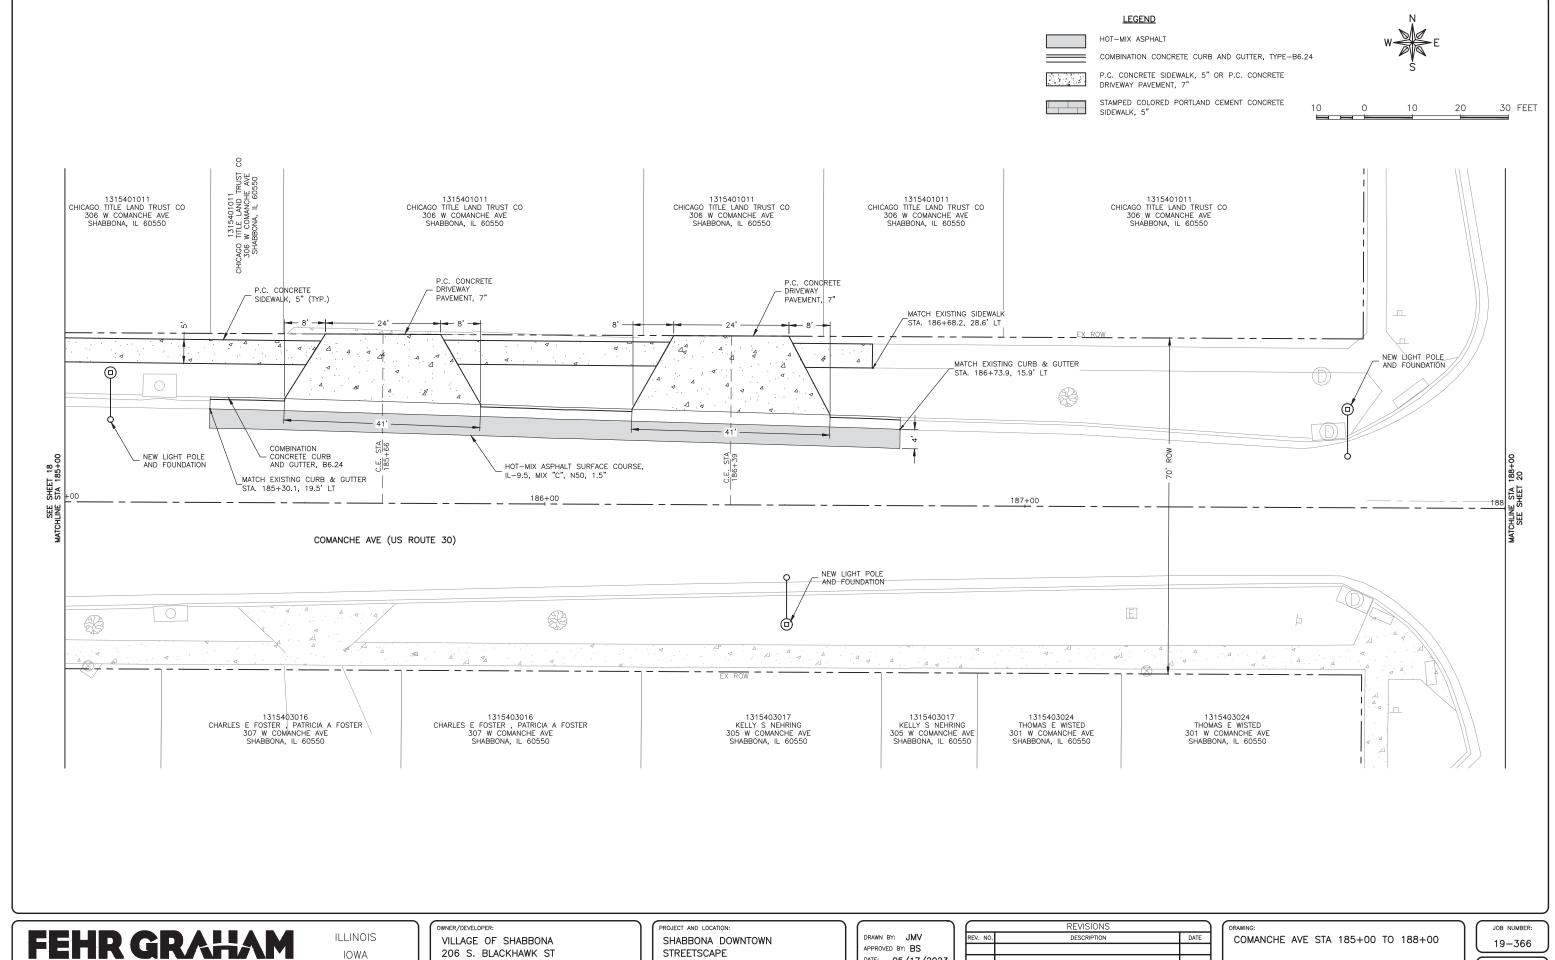

ENGINEERING & ENVIRONMENTAL ILLINOIS DESIGN FIRM NO. 184-003525 PLOT DATE: 6/19/23 © 2023 FEHR GRAHAM

WISCONSIN

206 S. BLACKHAWK ST SHABBONA, IL 60550

STREETSCAPE SHABBONA, IL


APPROVED BY: BS DATE: 05/17/2023 SCALE: AS NOTED

REVISIONS		
REV. NO.	DESCRIPTION	DATE

SET TYPE: FINAL

SHEET NUMBER:

19 of **71**

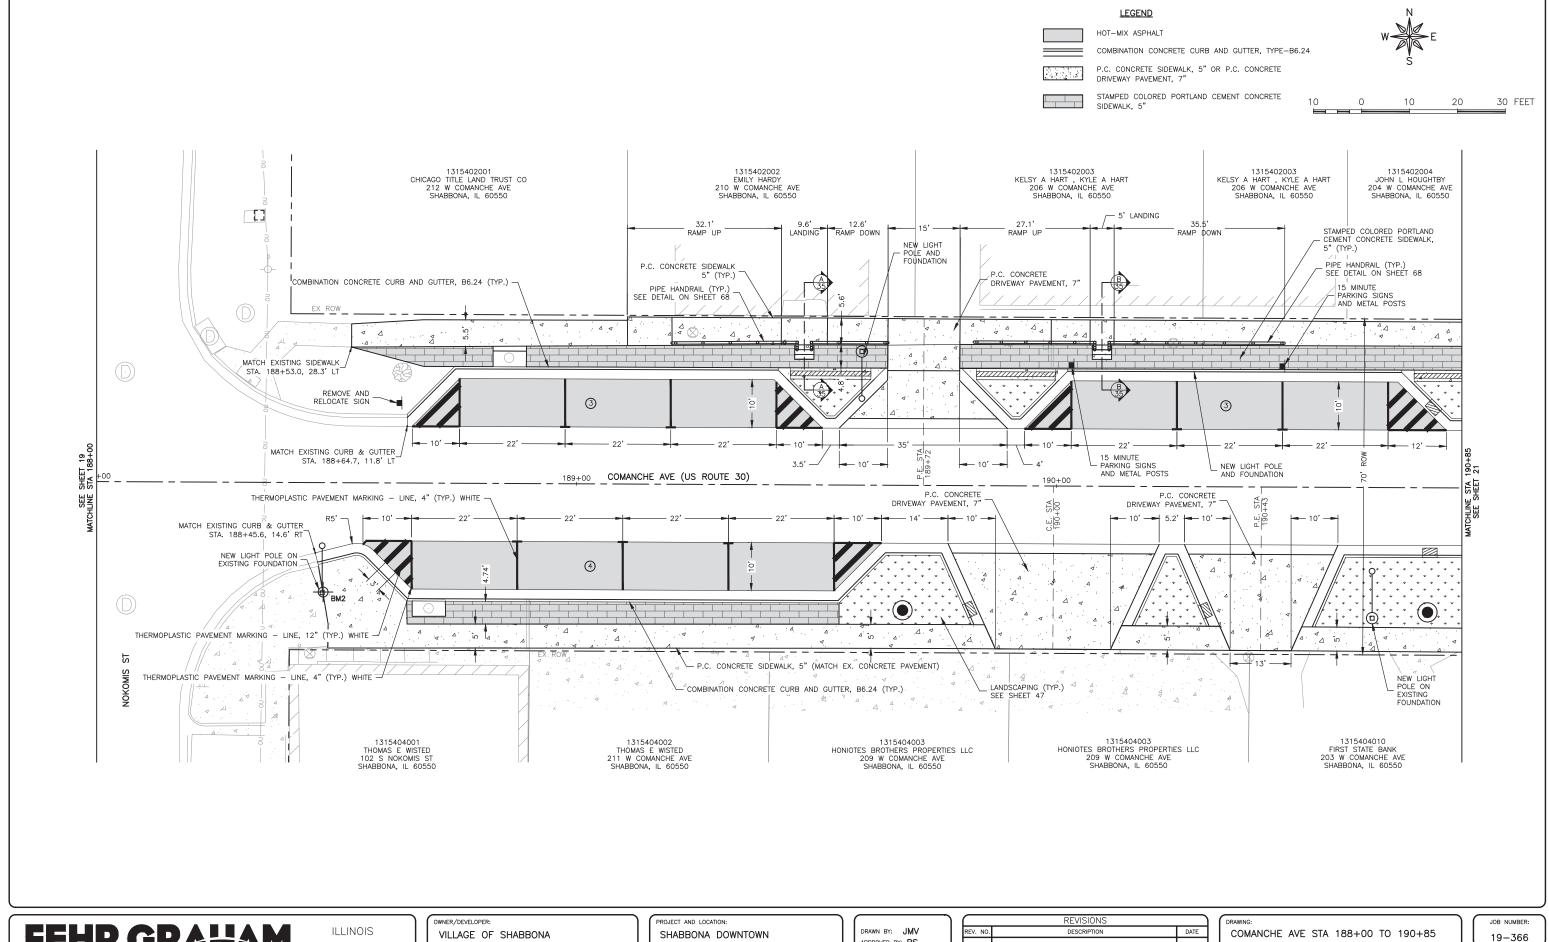

ENGINEERING & ENVIRONMENTAL ILLINOIS DESIGN FIRM NO. 184-003525

ILLINOIS IOWA WISCONSIN

VILLAGE OF SHABBONA 206 S. BLACKHAWK ST SHABBONA, IL 60550

SHABBONA DOWNTOWN STREETSCAPE SHABBONA, IL


DRAWN BY: JMV APPROVED BY: BS DATE: 05/17/2023 SCALE: AS NOTED

	REVISIONS	
REV. NO.	DESCRIPTION	DATE

COMANCHE AVE STA 188+00 TO 190+85

SET TYPE: FINAL

SHEET NUMBER: 20 of 71

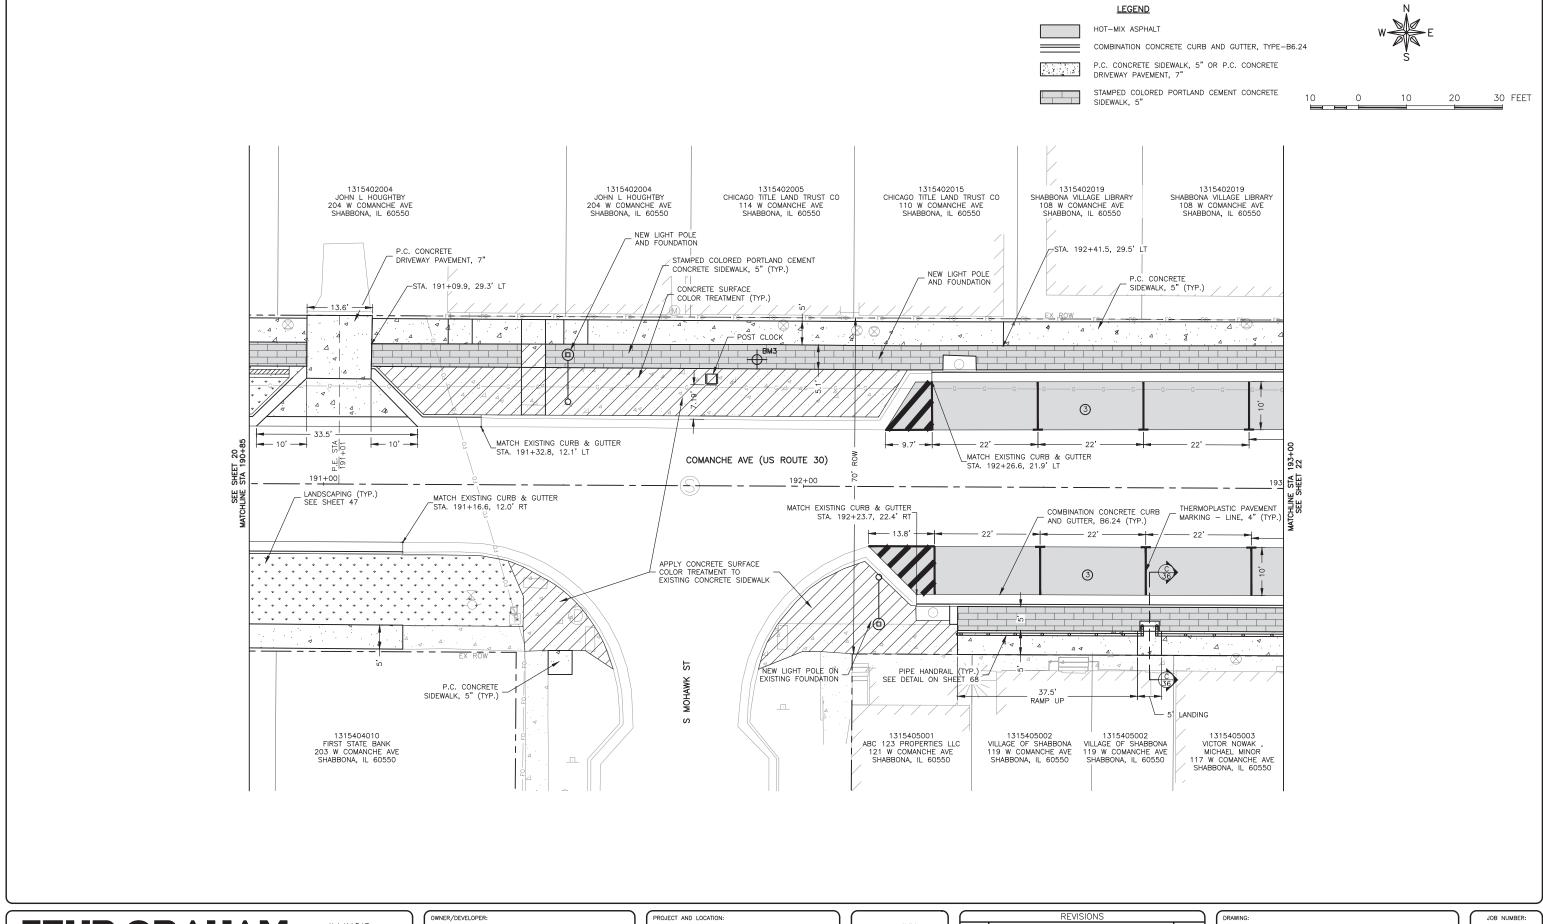

FEHR GRAHAM

ENGINEERING & ENVIRONMENTAL
ILLINOIS DESIGN FIRM NO. 184-003525

ILLINOIS IOWA WISCONSIN VILLAGE OF SHABBONA 206 S. BLACKHAWK ST SHABBONA, IL 60550 SHABBONA DOWNTOWN STREETSCAPE SHABBONA, IL DRAWN BY: JMV
APPROVED BY: BS
DATE: 05/17/2023
SCALE: AS NOTED

	REVISIONS	
REV. NO.	DESCRIPTION	DATE


COMANCHE AVE STA 190+85 TO 193+00

SET TYPE: FINAL

JOB NUMBER:
19-366

SHEET NUMBER:

21 of 71

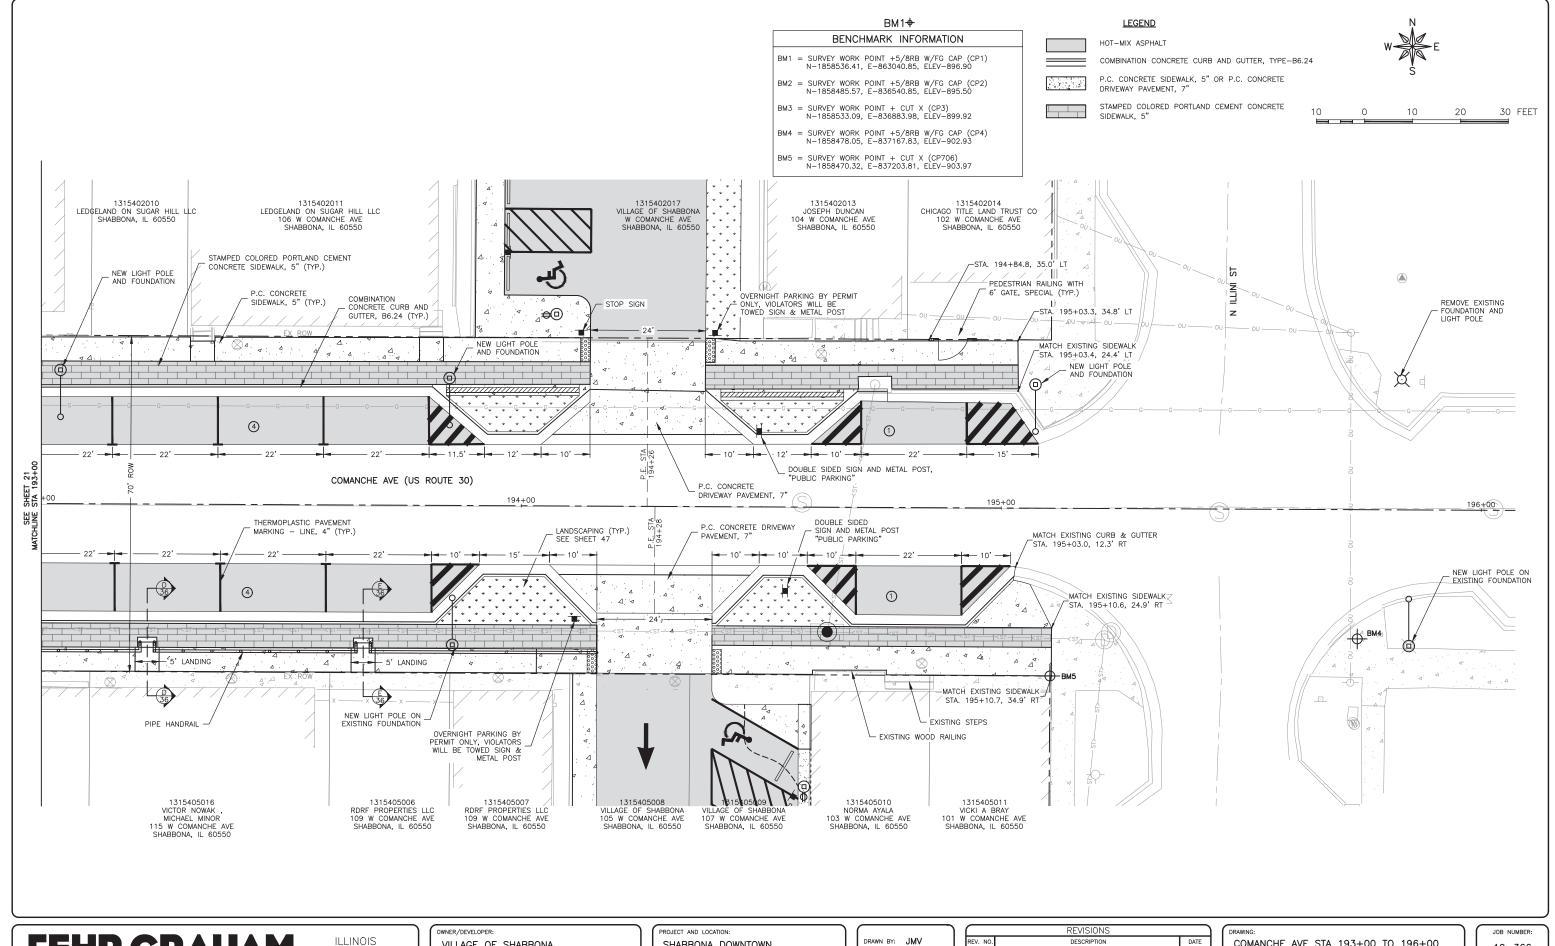

ENGINEERING & ENVIRONMENTAL ILLINOIS DESIGN FIRM NO. 184-003525 PLOT DATE: 6/19/23 © 2023 FEHR GRAHAM

IOWA

WISCONSIN

VILLAGE OF SHABBONA 206 S. BLACKHAWK ST SHABBONA, IL 60550

SHABBONA DOWNTOWN STREETSCAPE SHABBONA, IL

CONTRACT NO. 87841


DRAWN BY: JMV APPROVED BY: BS DATE: 05/17/2023 SCALE: AS NOTED

	REVISIONS	
REV. NO.	DESCRIPTION	DATE

COMANCHE AVE STA 193+00 TO 196+00

SET TYPE: FINAL

19-366 SHEET NUMBER: 22 of 71

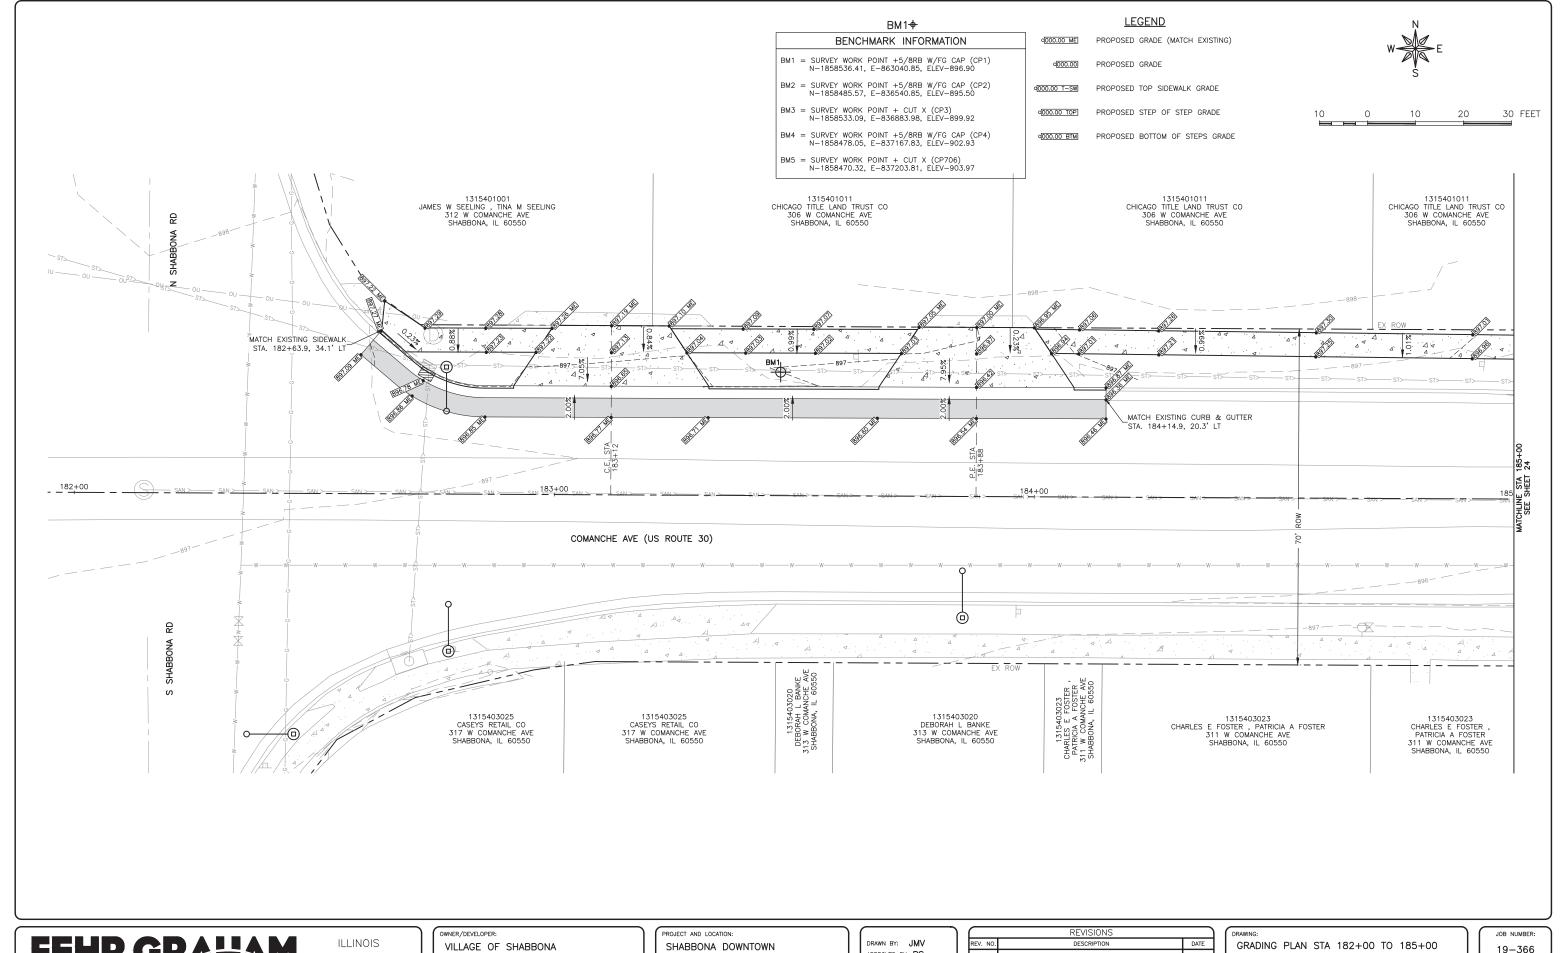

ENGINEERING & ENVIRONMENTAL ILLINOIS DESIGN FIRM NO. 184-003525


IOWA WISCONSIN 206 S. BLACKHAWK ST SHABBONA, IL 60550

STREETSCAPE SHABBONA, IL

APPROVED BY: BS DATE: 05/17/2023 SCALE: AS NOTED

SET TYPE: FINAL

19-366 SHEET NUMBER: 23 of 71

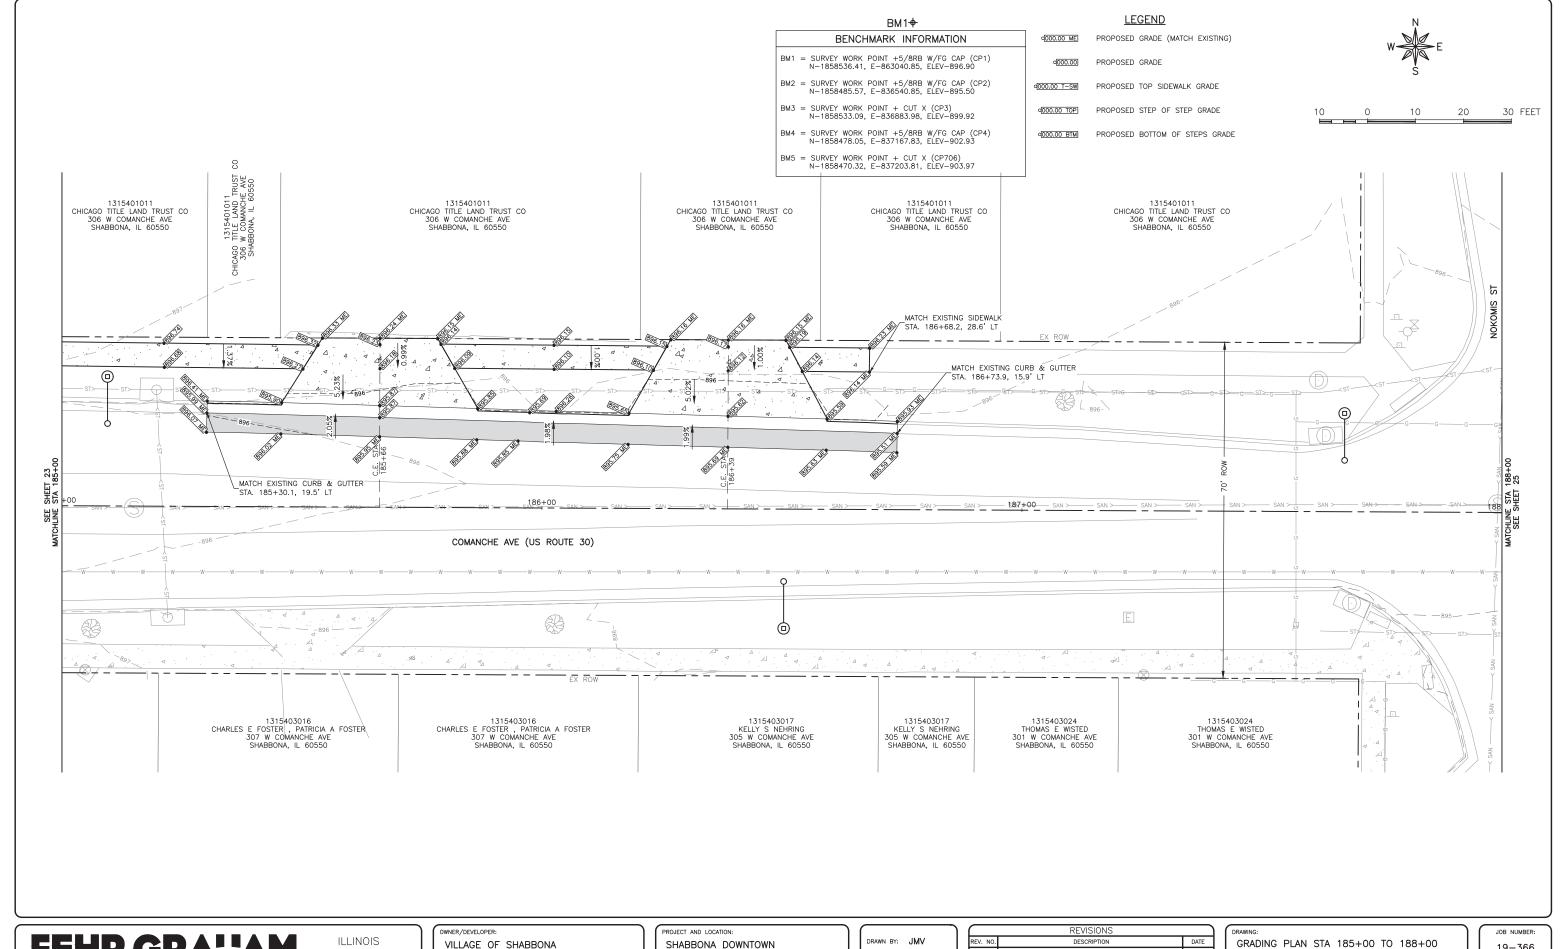

ENGINEERING & ENVIRONMENTAL
ILLINOIS DESIGN FIRM NO. 184-003525

ILLINOIS IOWA WISCONSIN WNER/DEVELOPER:
VILLAGE OF SHABBONA
206 S. BLACKHAWK ST
SHABBONA, IL 60550

PROJECT AND LOCATION:
SHABBONA DOWNTOWN
STREETSCAPE
SHABBONA, IL

DRAWN BY: JMV
APPROVED BY: BS
DATE: 05/17/2023
SCALE: AS NOTED

	REVISIONS	
REV. NO.	DESCRIPTION	DATE


DRAWING:
GRADING PLAN STA 185+00 TO 188+00
SET TYPE: FINAL

19-366

SHEET NUMBER:
24 of 71

PLOT DATE: 6/19/23 © 2023 FEHR GRAHAM

CONTRACT NO. 87841

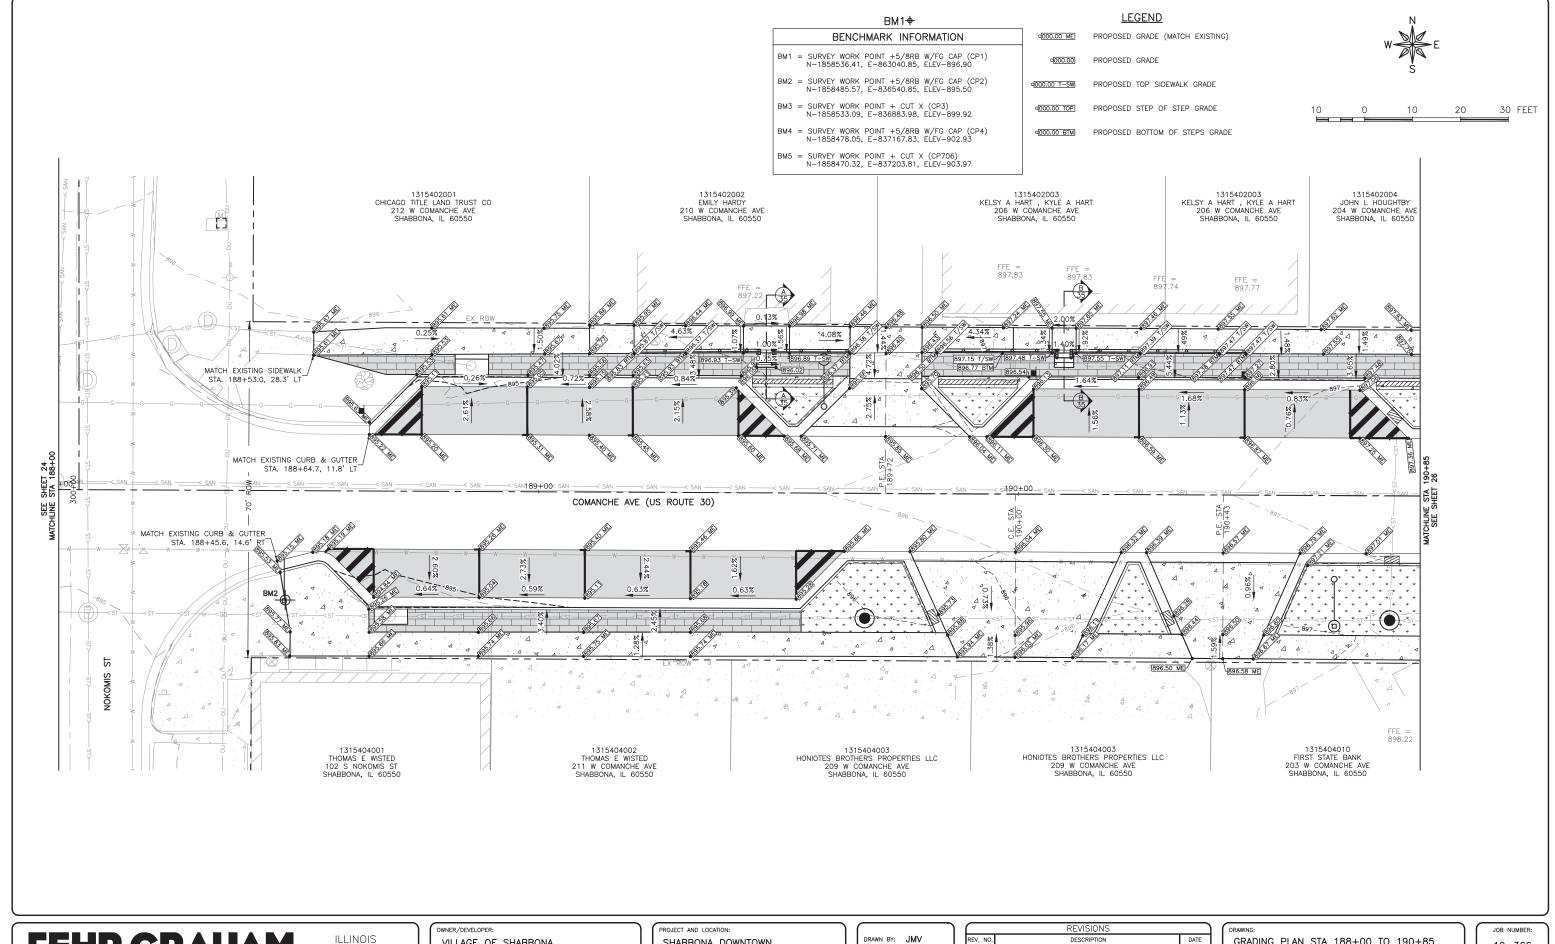

ENGINEERING & ENVIRONMENTAL

ILLINOIS DESIGN FIRM NO. 184-003525

PLOT DATE: 6/19/23 © 2023 FEHR GRAHAM

IOWA WISCONSIN

VILLAGE OF SHABBONA 206 S. BLACKHAWK ST SHABBONA, IL 60550 SHABBONA DOWNTOWN STREETSCAPE SHABBONA, IL

CONTRACT NO. 87841


DRAWN BY: JMV
APPROVED BY: BS
DATE: 05/17/2023
SCALE: AS NOTED


	REVISIONS	
REV. NO.	DESCRIPTION	DATE
\Box		

DRAWING: GRADING PLAN STA 188+00 TO 190+85

SET TYPE: FINAL c:\C3\(19\)19-366(19-366 besign.dwg, GRADING 3 19-366 SHEET NUMBER:

25 of 71

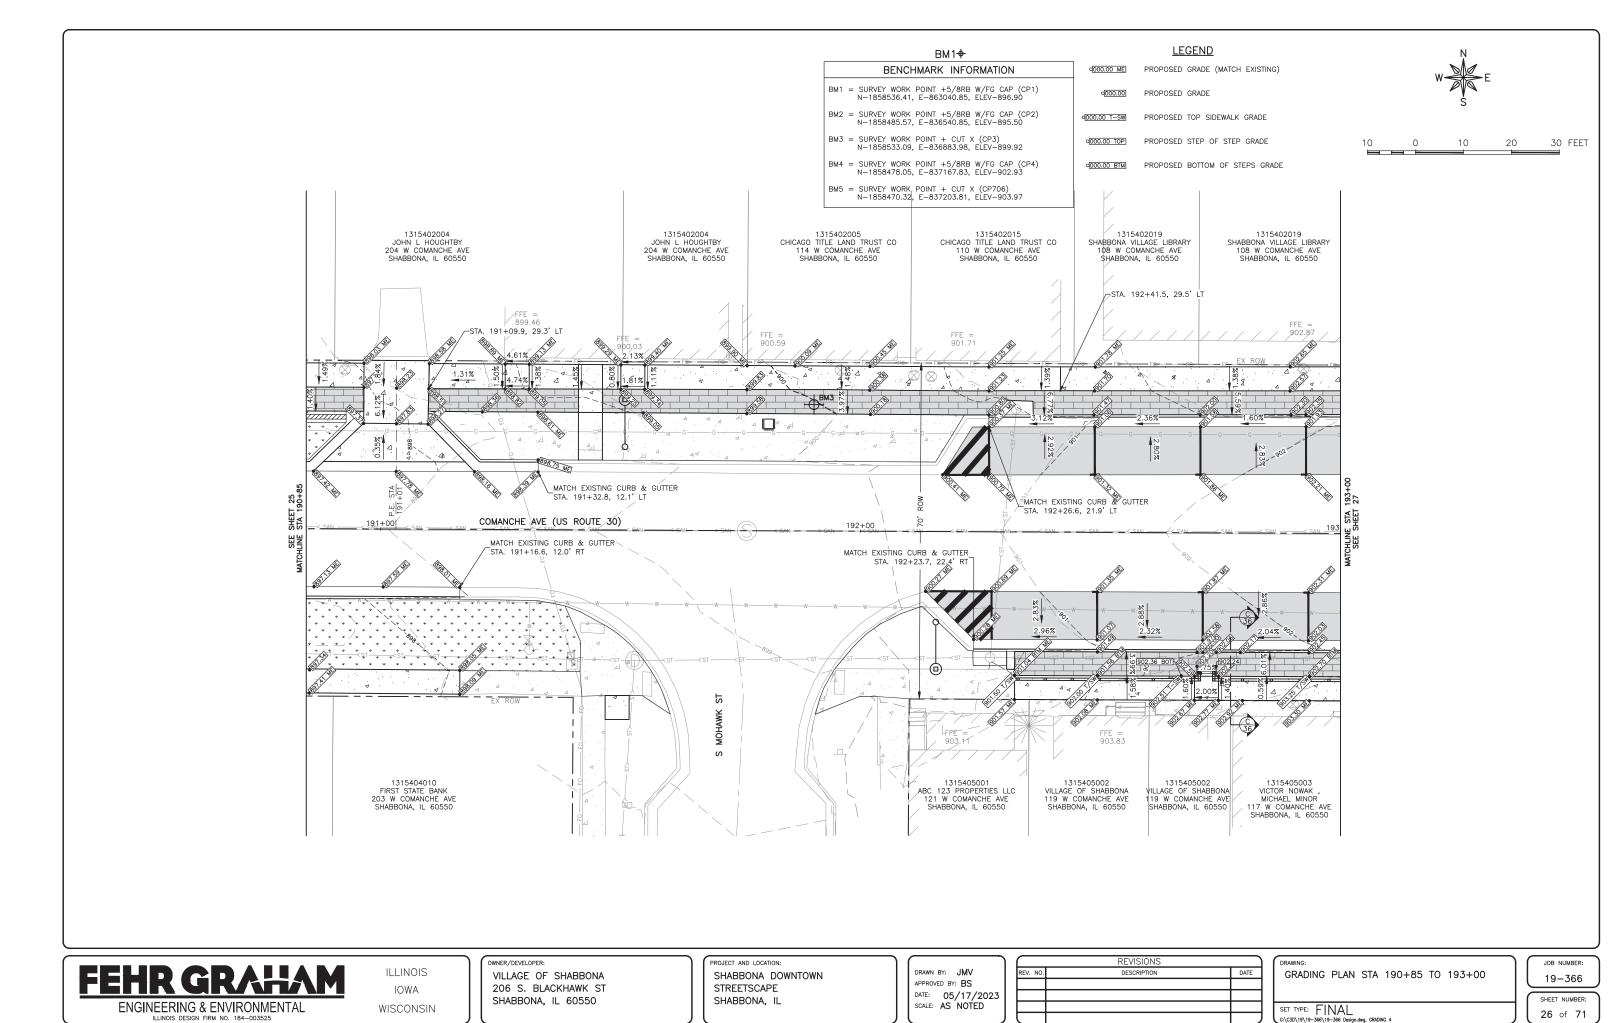

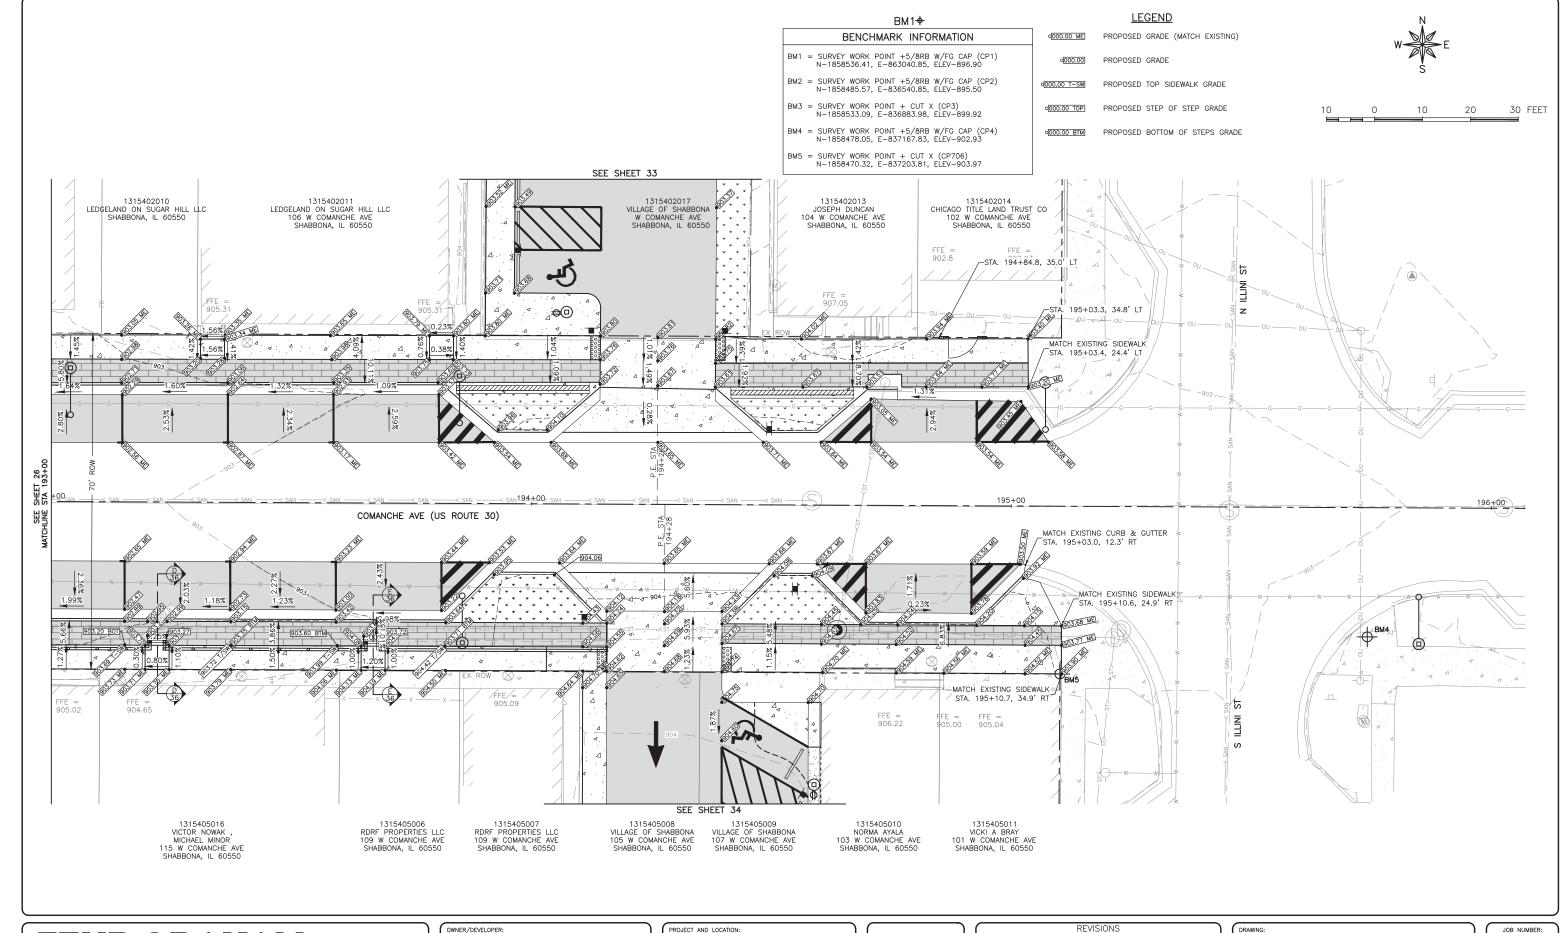

FEHR GRAHAM

ILLINOIS IOWA

WISCONSIN

VILLAGE OF SHABBONA 206 S. BLACKHAWK ST SHABBONA, IL 60550 SHABBONA DOWNTOWN STREETSCAPE SHABBONA, IL

DRAWN BY: JMV
APPROVED BY: BS
DATE: 05/17/2023
SCALE: AS NOTED

	REVISIONS	
REV. NO.	DESCRIPTION	DATE

DRAWING: GRADING PLAN STA 193+00 TO 196+00


SET TYPE: FINAL


19-366

SHEET NUMBER:
27 of 71

ENGINEERING & ENVIRONMENTAL ILLINOIS DESIGN FIRM NO. 184-003525

PLOT DATE: 6/19/23 © 2023 FEHR GRAHAM

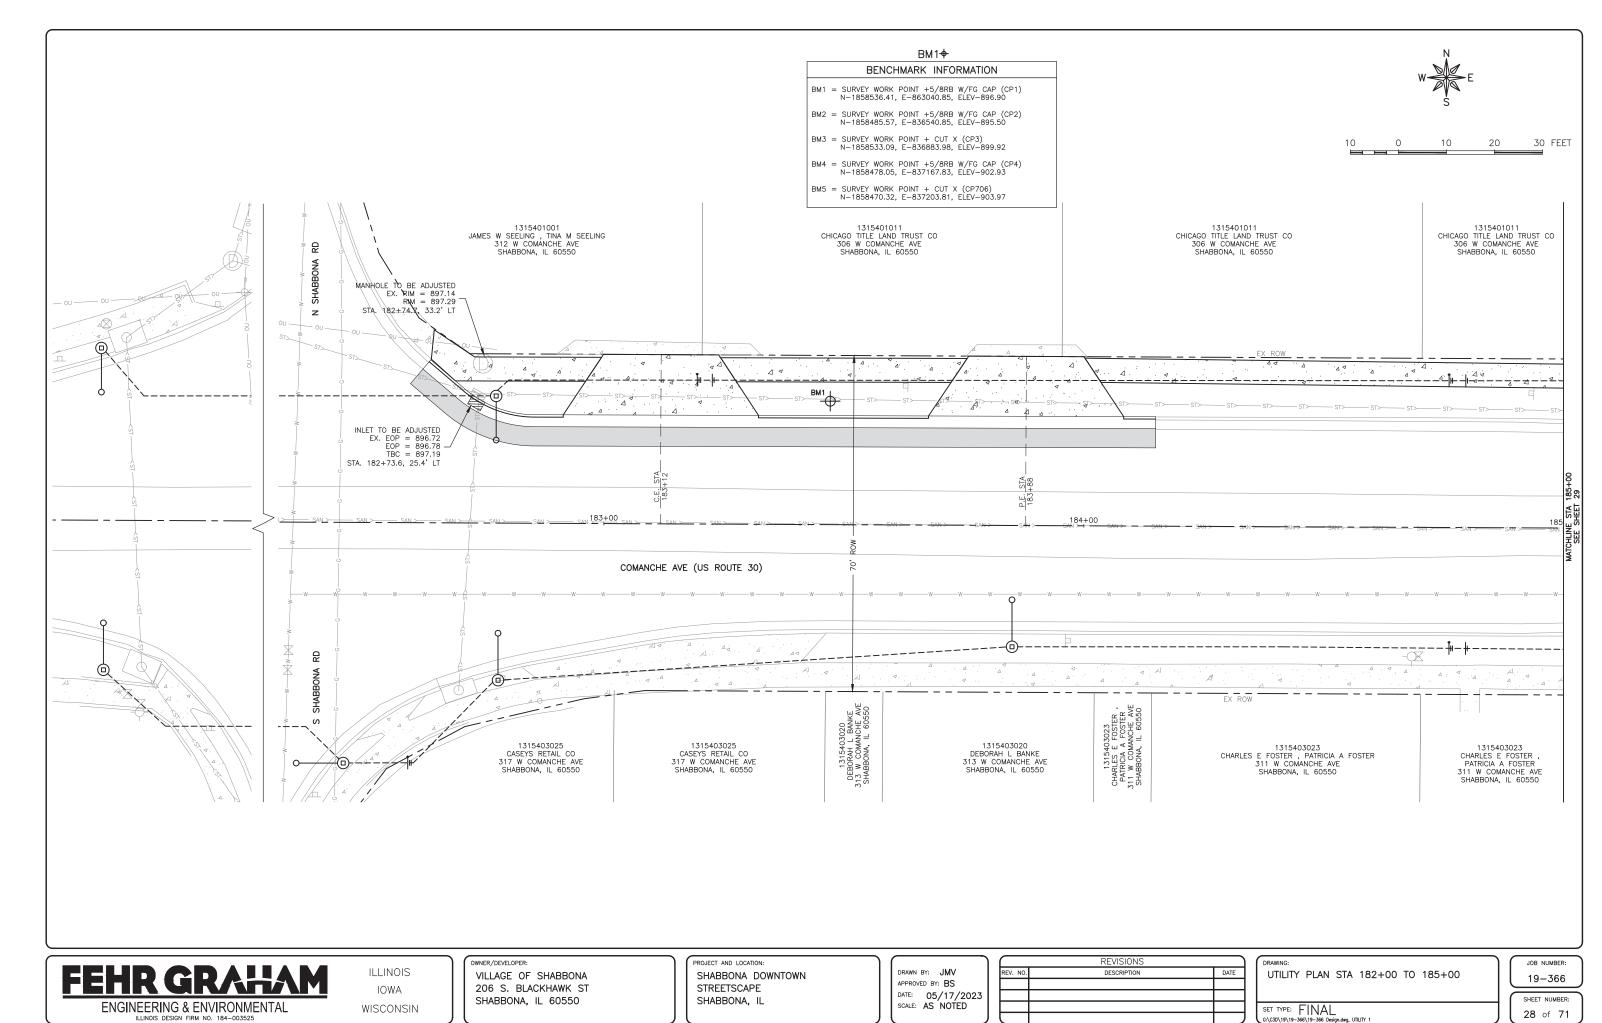

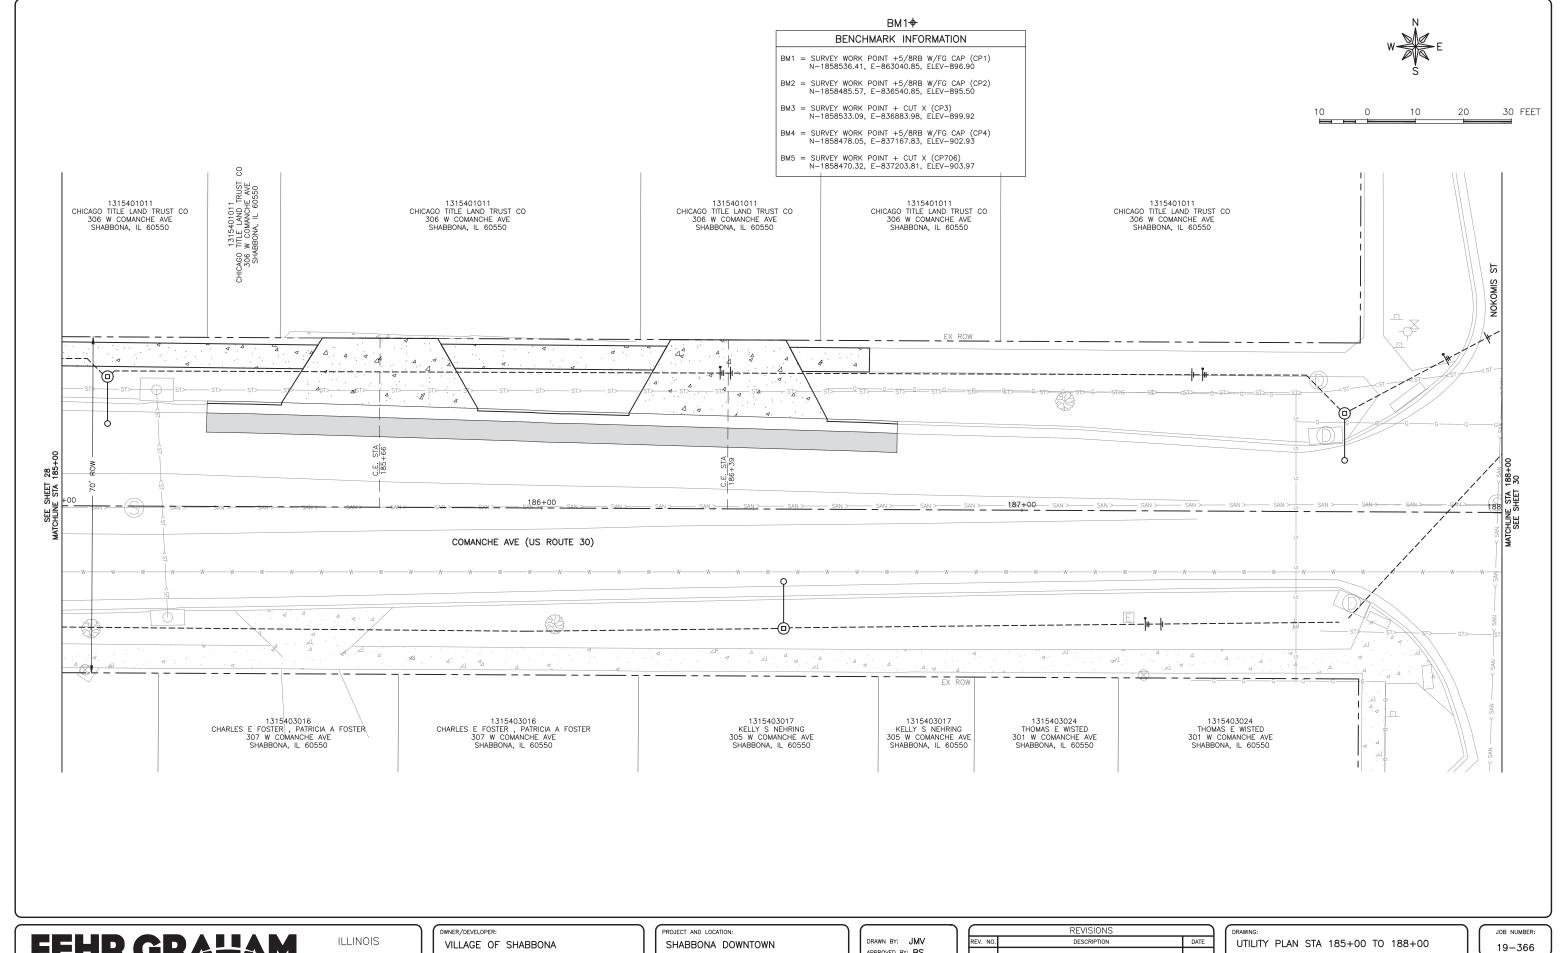

ENGINEERING & ENVIRONMENTAL ILLINOIS DESIGN FIRM NO. 184-003525

IOWA WISCONSIN 206 S. BLACKHAWK ST SHABBONA, IL 60550

STREETSCAPE SHABBONA, IL


APPROVED BY: BS DATE: 05/17/2023 SCALE: AS NOTED

SET TYPE: FINAL

SHEET NUMBER: 29 of 71

PLOT DATE: 6/19/23 © 2023 FEHR GRAHAM

SECTION NO. 23-00019-01-LS CONTRACT NO. 87841

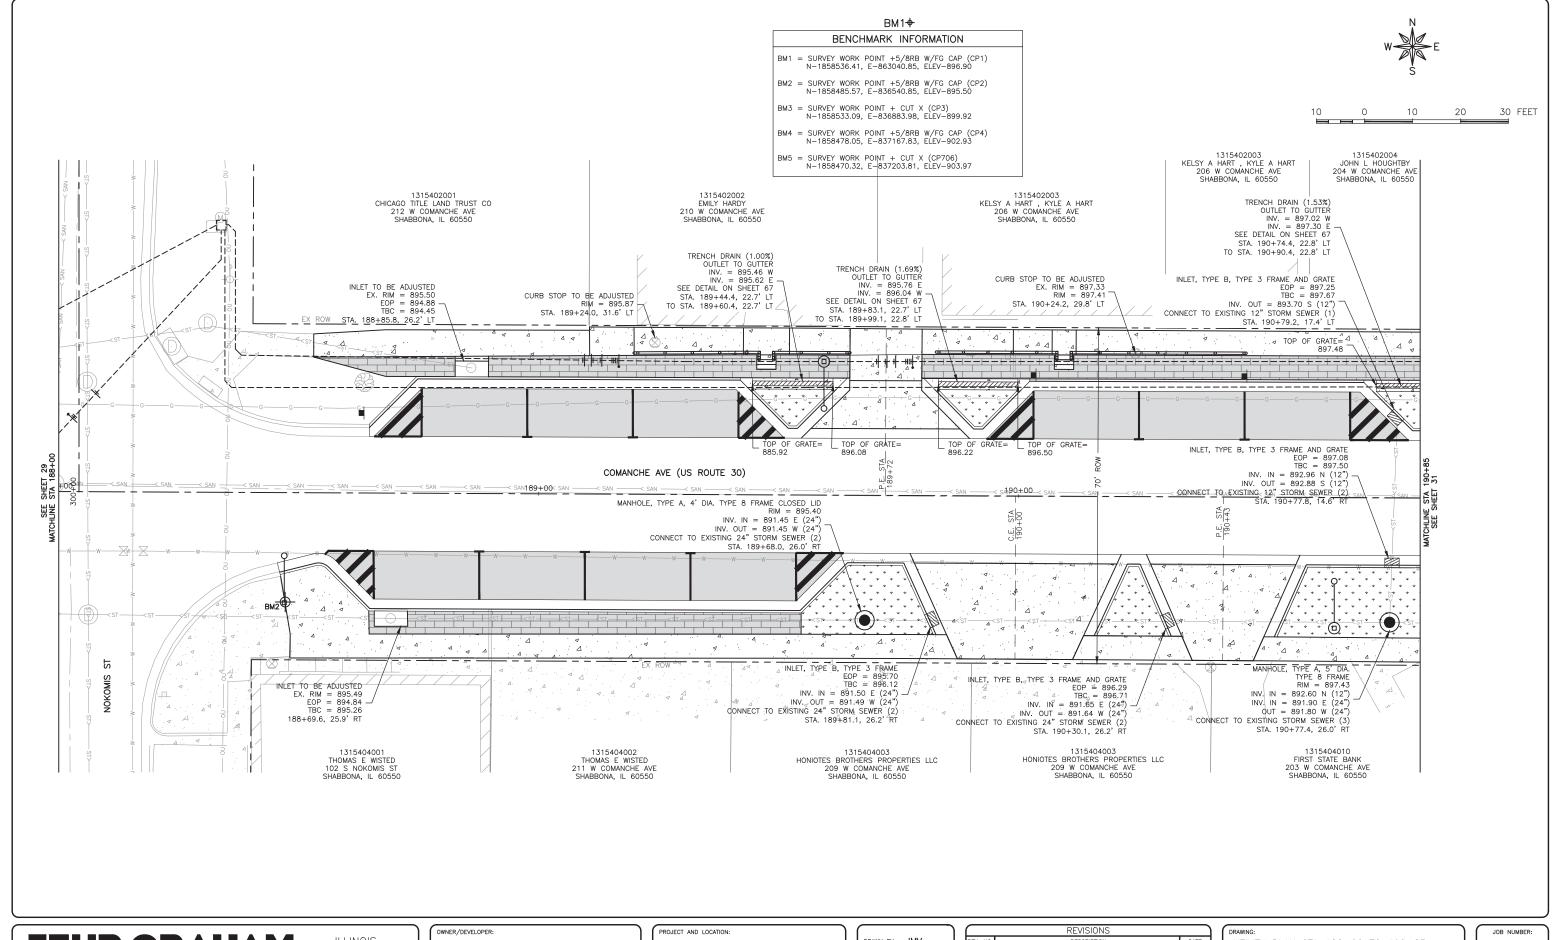

FEHR GRAHAM

ENGINEERING & ENVIRONMENTAL

ILLINOIS IOWA WISCONSIN VILLAGE OF SHABBONA 206 S. BLACKHAWK ST SHABBONA, IL 60550 SHABBONA DOWNTOWN STREETSCAPE SHABBONA, IL DRAWN BY: JMV
APPROVED BY: BS
DATE: 05/17/2023
SCALE: AS NOTED

REVISIONS
REV. NO. DESCRIPTION DATE

S
G

DRAWING:
UTILITY PLAN STA 188+00 TO 190+85
SET TYPE: FINAL


JOB NUMBER:

19-366

SHEET NUMBER:

30 of 71

ILLINOIS DESIGN FIRM NO. 184–003525 PLOT DATE: 6/19/23 © 2023 FEHR GRAHAM

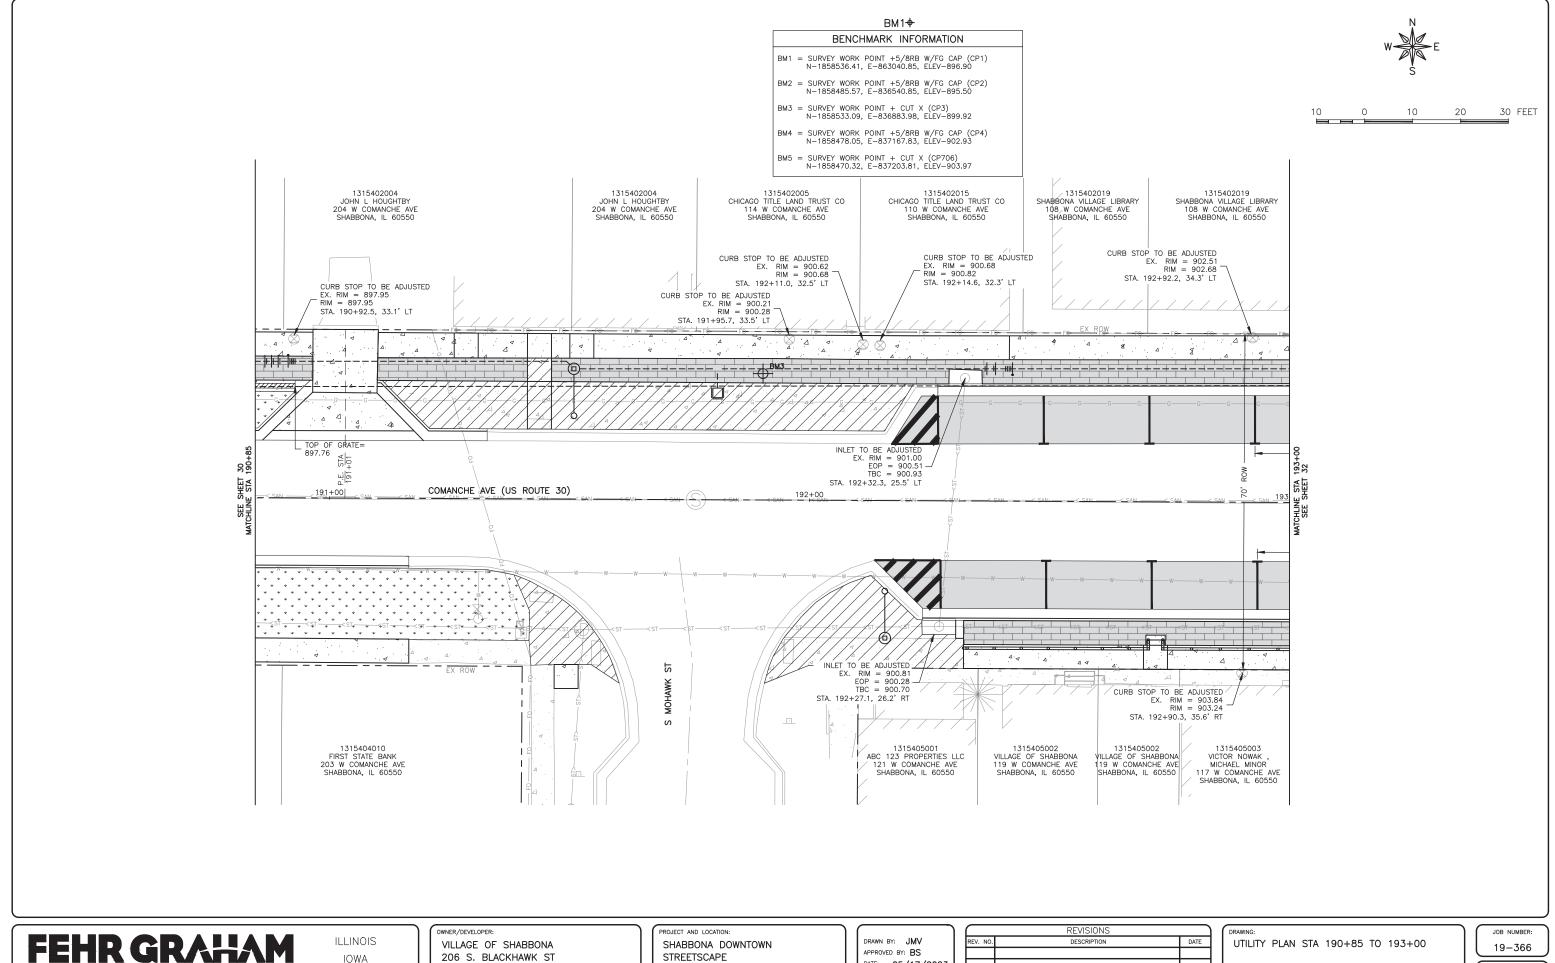

ENGINEERING & ENVIRONMENTAL ILLINOIS DESIGN FIRM NO. 184-003525 PLOT DATE: 6/19/23 © 2023 FEHR GRAHAM

IOWA WISCONSIN

206 S. BLACKHAWK ST SHABBONA, IL 60550

STREETSCAPE SHABBONA, IL

CONTRACT NO. 87841


APPROVED BY: BS DATE: 05/17/2023 SCALE: AS NOTED

	REVISIONS	
REV. NO.	DESCRIPTION	DATE

SET TYPE: FINAL

SHEET NUMBER:

31 of **71**

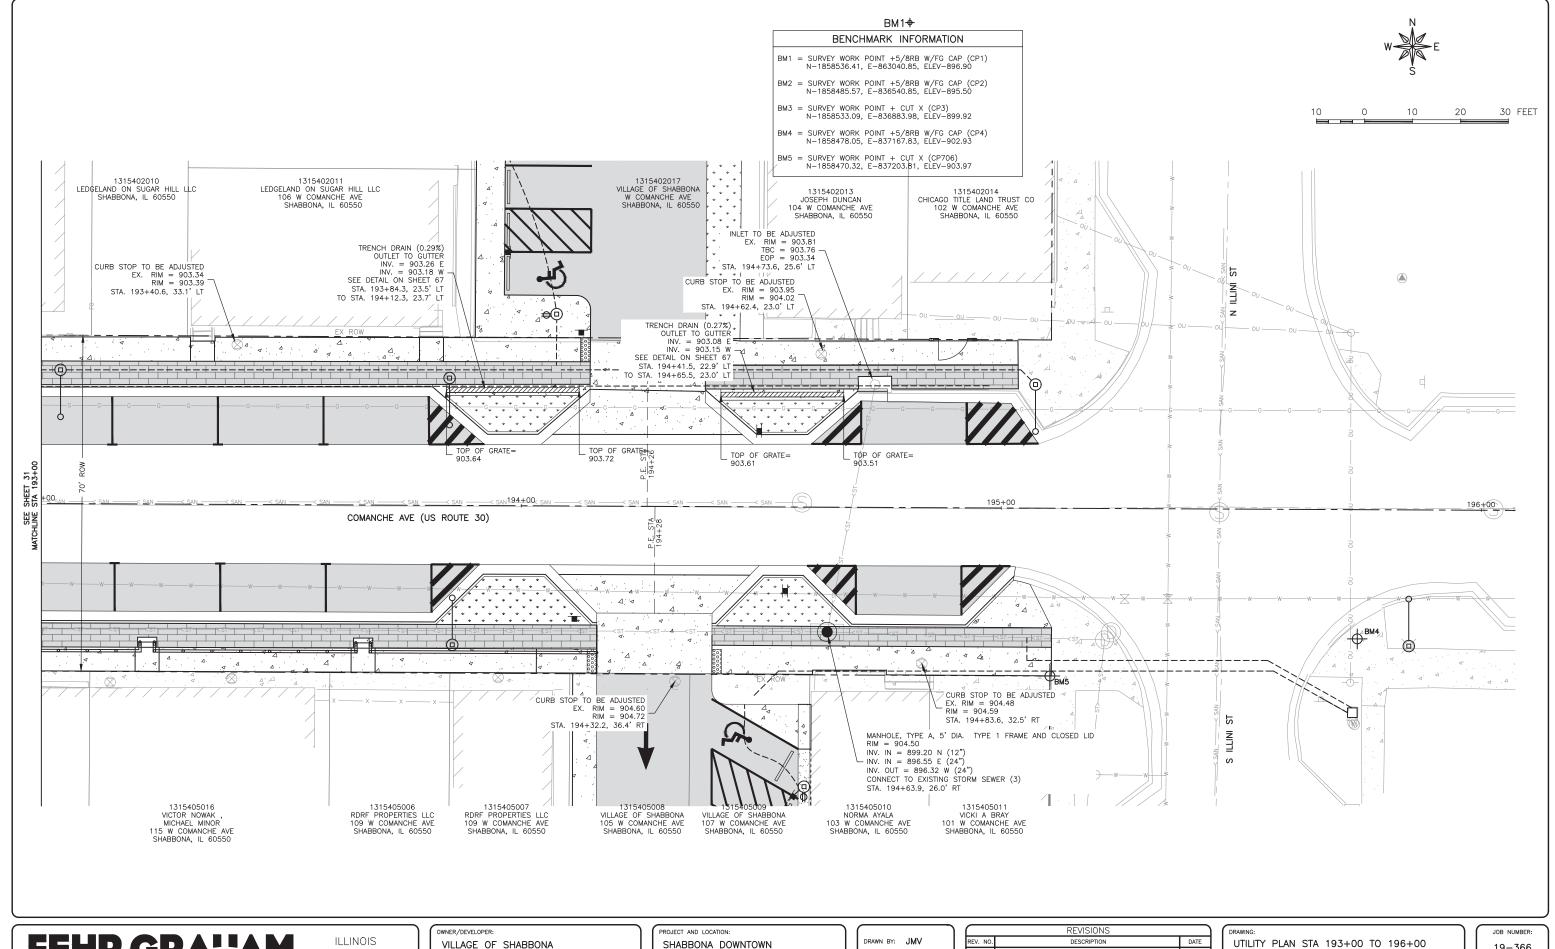

ENGINEERING & ENVIRONMENTAL ILLINOIS DESIGN FIRM NO. 184-003525 PLOT DATE: 6/19/23 © 2023 FEHR GRAHAM

IOWA

WISCONSIN

206 S. BLACKHAWK ST SHABBONA, IL 60550

SHABBONA DOWNTOWN STREETSCAPE SHABBONA, IL


DRAWN BY: JMV APPROVED BY: BS DATE: 05/17/2023 SCALE: AS NOTED

	REVISIONS	
REV. NO.	DESCRIPTION	DATE


UTILITY PLAN STA 193+00 TO 196+00

SET TYPE: FINAL

19-366 SHEET NUMBER: 32 of 71

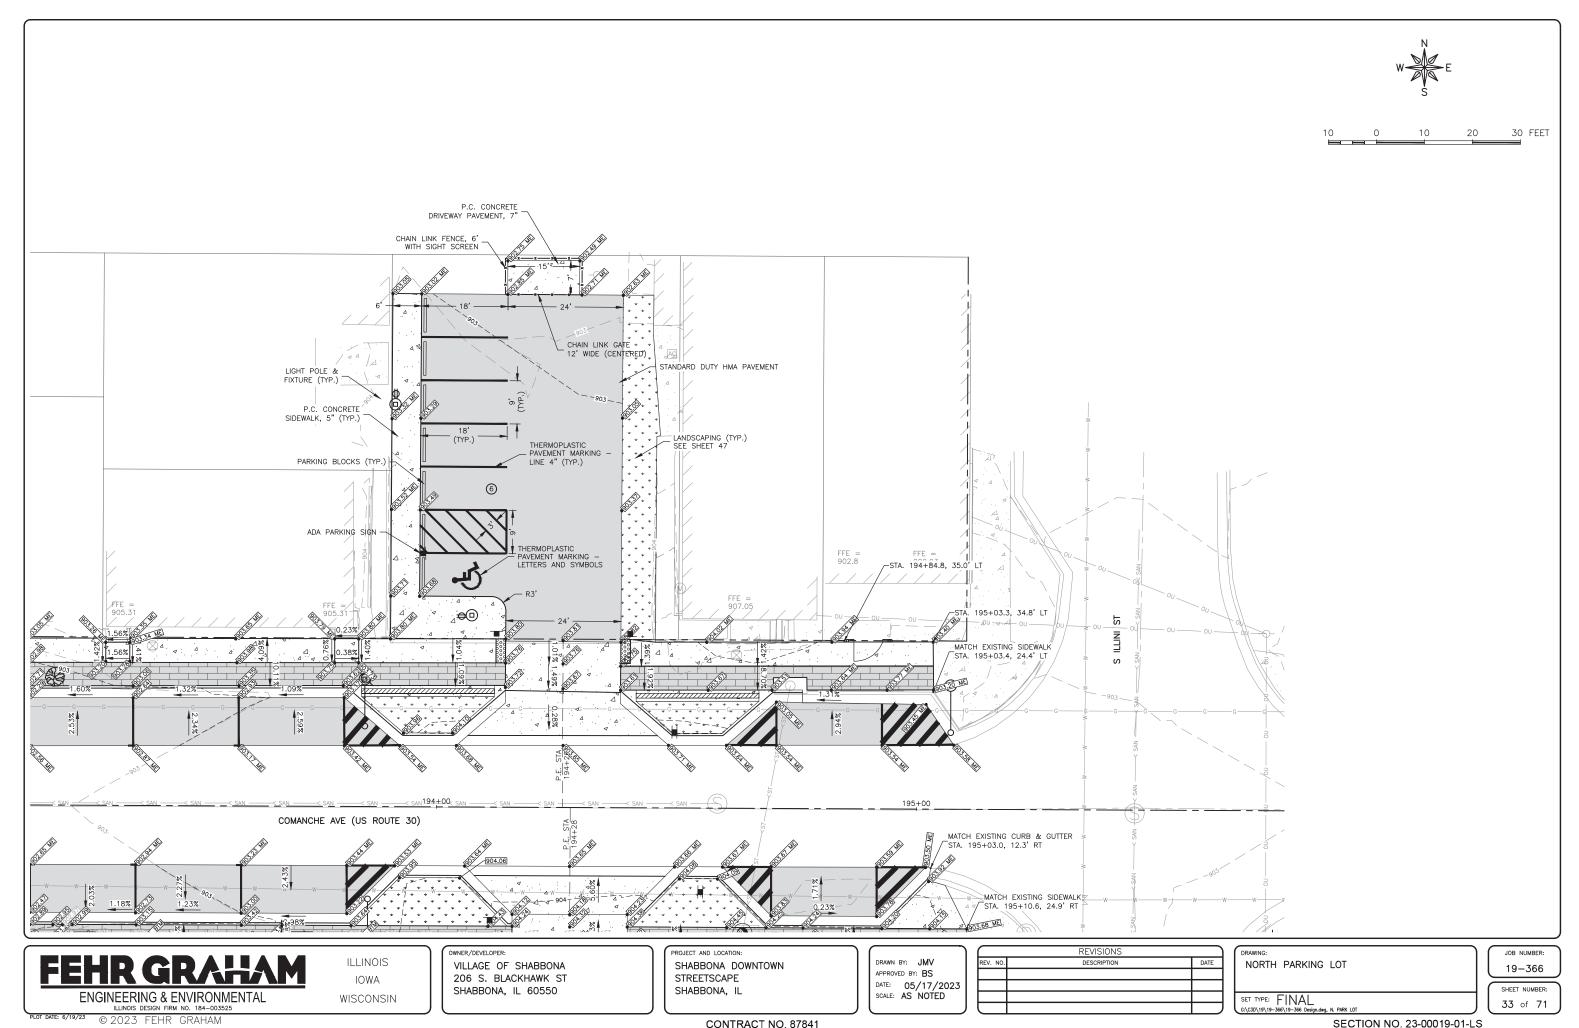

CONTRACT NO. 87841

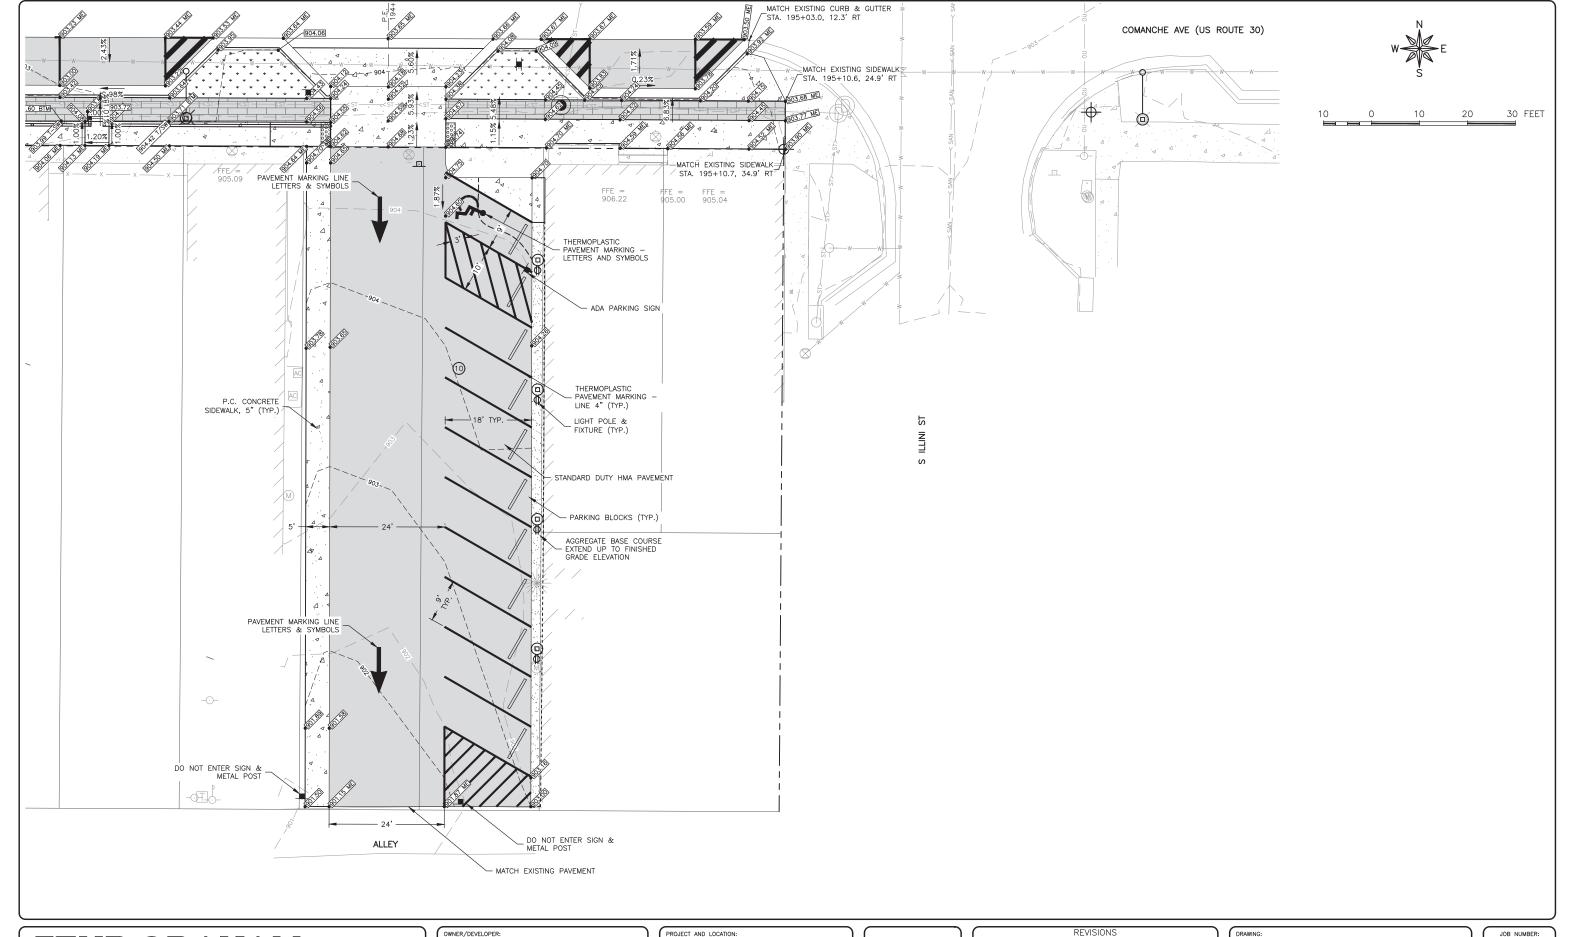

FEHR GRAHAM

ILLINOIS IOWA WISCONSIN owner/developer:
VILLAGE OF SHABBONA
206 S. BLACKHAWK ST
SHABBONA, IL 60550

PROJECT AND LOCATION:

SHABBONA DOWNTOWN

STREETSCAPE

SHABBONA, IL

DRAWN BY: JMV
APPROVED BY: BS
DATE: 05/17/2023
SCALE: AS NOTED


	REVISIONS	
REV. NO.	DESCRIPTION	DATE
	_	

DRAWING:
SOUTH PARKING LOT
SET TYPE: FINAL

JOB NUMBER:
19-366

SHEET NUMBER:
34 of 71



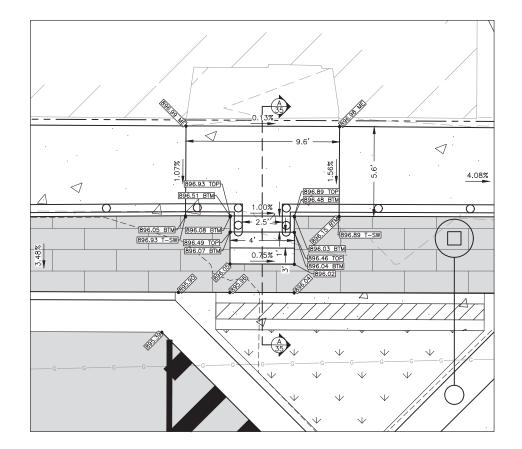

3 0 3 6 9 FEET

LEGEND


4000.00 ME PROPOSED GRADE (MATCH EXISTING)

9000.00 PROPOSED GRADE


0000.00 T-SW PROPOSED TOP SIDEWALK GRADE

PROPOSED STEP OF STEP GRADE

000.00 BTM PROPOSED BOTTOM OF STEPS GRADE

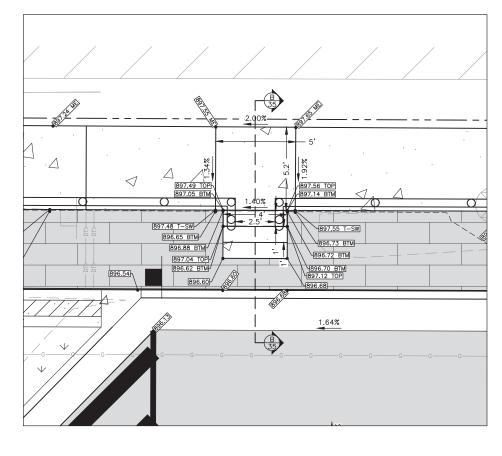


DETAIL B SCALE: 1"=3"

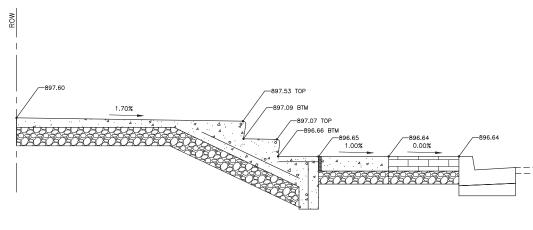

SECTION B N.T.S.

COMANCHE AVENUE STAIRS STA: 190+10

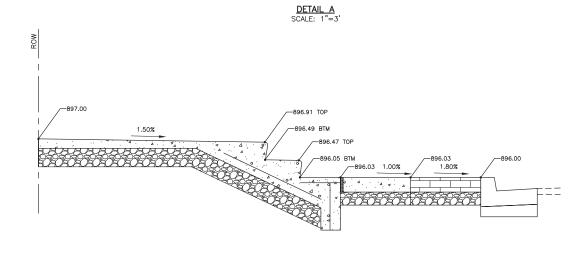

SECTION A N.T.S.

COMANCHE AVENUE STAIRS STA: 189+50

FEHR GRAHAM

ILLINOIS IOWA WISCONSIN OWNER/DEVELOPER:
VILLAGE OF SHABBONA
206 S. BLACKHAWK ST
SHABBONA, IL 60550

PROJECT AND LOCATION:

SHABBONA DOWNTOWN

STREETSCAPE

SHABBONA, IL

DRAWN BY: JMV
APPROVED BY: BS
DATE: 05/17/2023
SCALE: AS NOTED


$\overline{}$	REVISIONS	
REV. NO.	DESCRIPTION	DATE

DRAWING:
NORTH SECTION STAIRS

SET TYPE: FINAL


JOB NUMBER:
19-366

SHEET NUMBER:
35 of 71

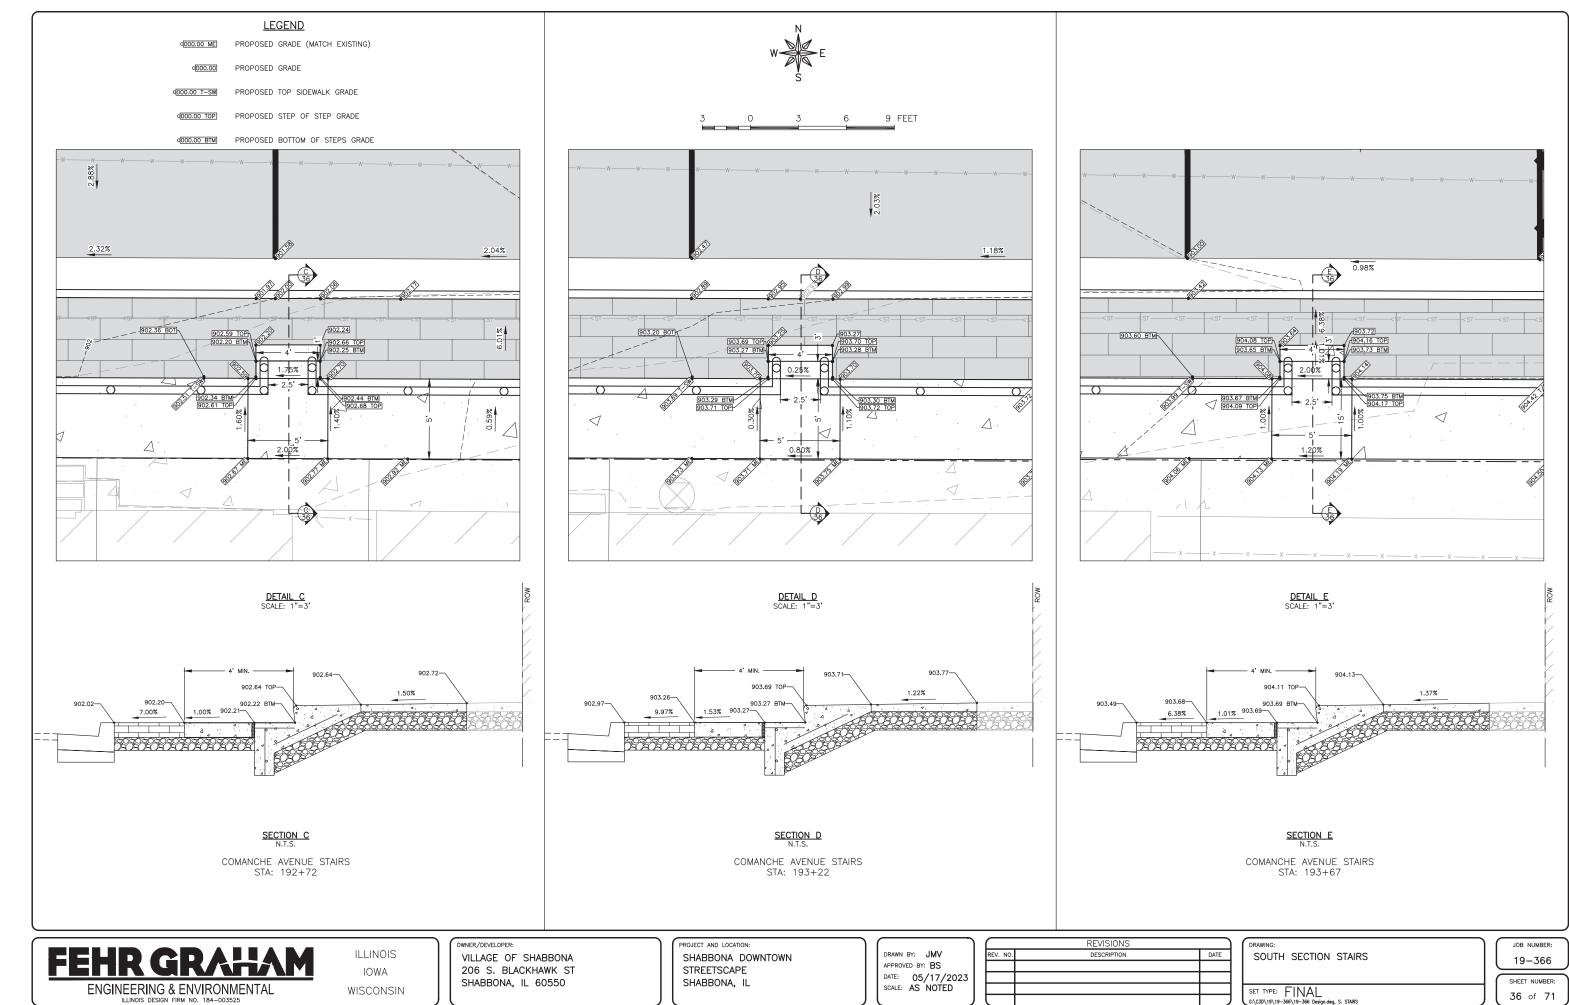

PLOT DATE: 6/19/23 © 2023 FEHR GRAHAM

CONTRACT NO. 87841

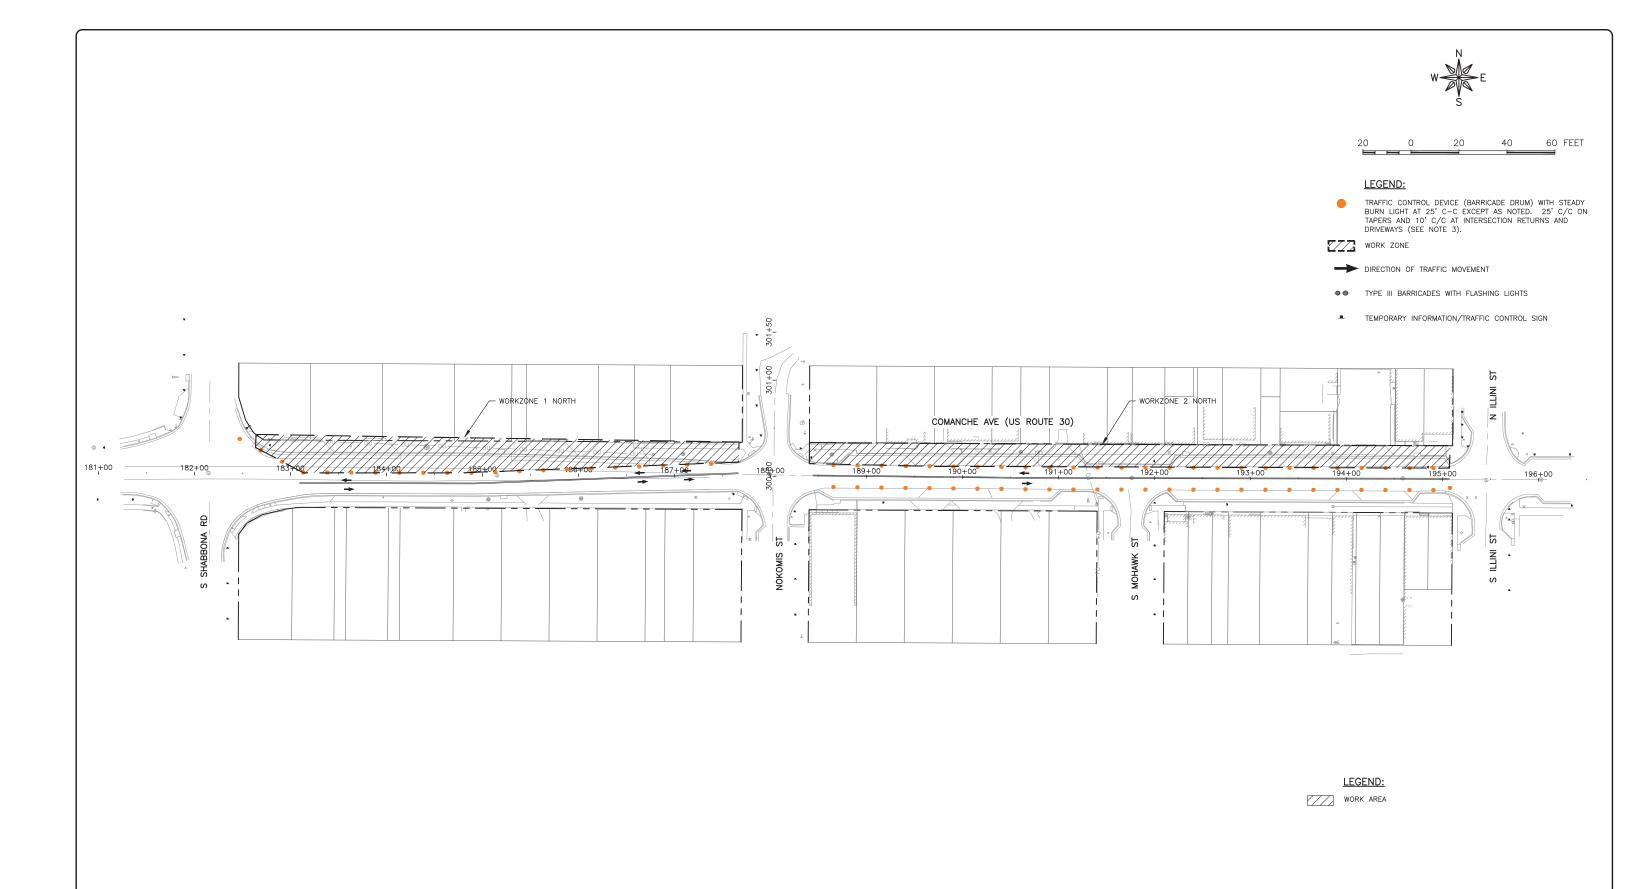

ILLINOIS IOWA WISCONSIN owner/developer:
VILLAGE OF SHABBONA
206 S. BLACKHAWK ST
SHABBONA, IL 60550

PROJECT AND LOCATION:

SHABBONA DOWNTOWN

STREETSCAPE

SHABBONA, IL

DRAWN BY: JMV
APPROVED BY: BS
DATE: 05/17/2023
SCALE: AS NOTED

REVISIONS				
REV. NO.	DESCRIPTION	DATE		

OVERALL NORTH TRAFFIC CONTROL PLANS


- STAGE 1

19-366

SHEET NUMBER:
37 of 71

JOB NUMBER:

SET TYPE: FINAL 6\C30\19\19-366\Plans\19-366 Traffic Plans.dag, N-T.C. OVERALL SECTION NO. 23-00019-01-LS

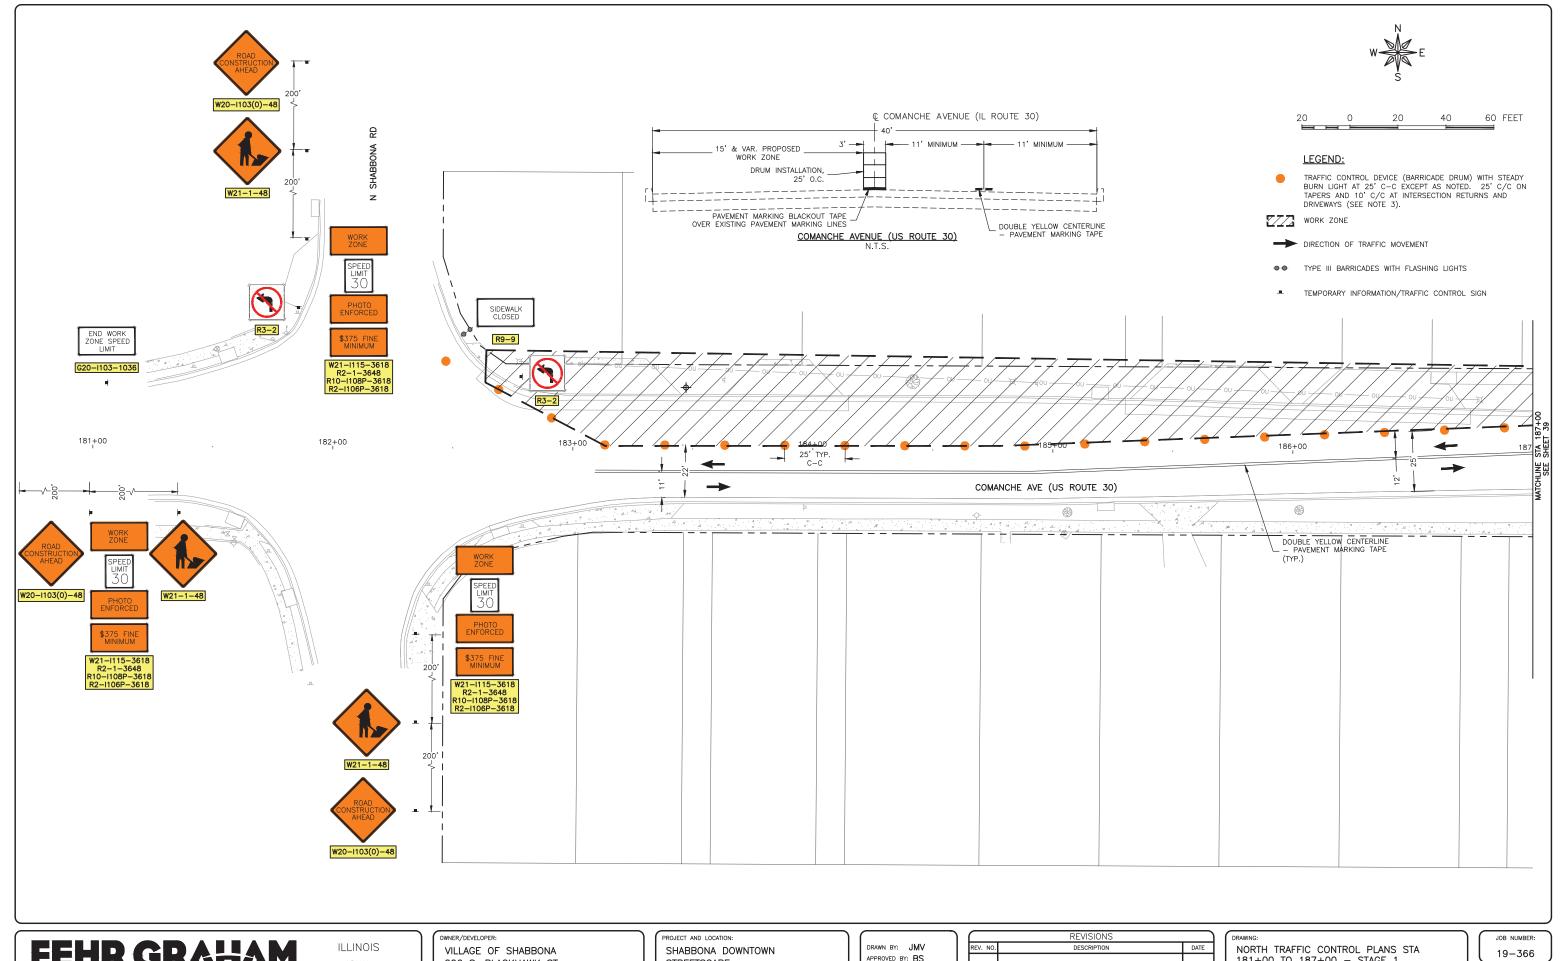

PLOT DATE: 6/19/23 © 2023 FEHR GRAHAM

IOWA WISCONSIN

206 S. BLACKHAWK ST SHABBONA, IL 60550

STREETSCAPE SHABBONA, IL


APPROVED BY: BS DATE: 05/17/2023 SCALE: AS NOTED

REVISIONS			
REV. NO.	DESCRIPTION	DATE	
	•		

181+00 TO 187+00 - STAGE 1

SHEET NUMBER: 38 of 71

SECTION NO. 23-00019-01-LS CONTRACT NO. 87841

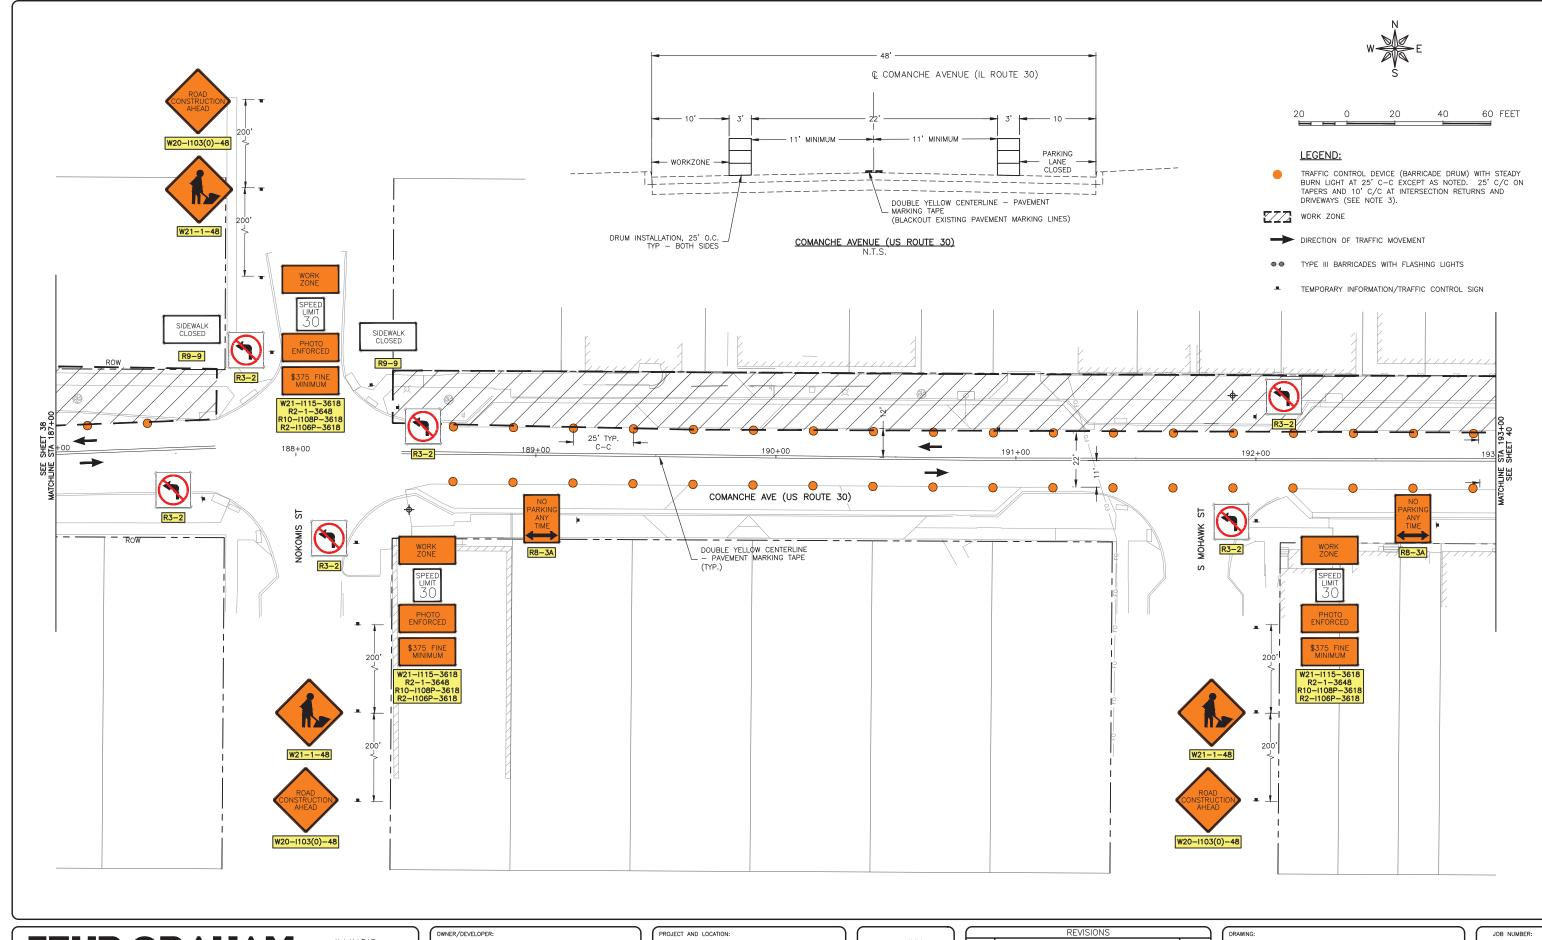

FEHR GRALIAM

ENGINEERING & ENVIRONMENTAL

ILLINOIS DESIGN FIRM NO. 184-003525

ILLINOIS IOWA WISCONSIN owner/developer:
VILLAGE OF SHABBONA
206 S. BLACKHAWK ST
SHABBONA, IL 60550

PROJECT AND LOCATION:
SHABBONA DOWNTOWN
STREETSCAPE
SHABBONA, IL

DRAWN BY: JMV
APPROVED BY: BS
DATE: 05/17/2023
SCALE: AS NOTED

	REVISIONS			
REV. NO.	DESCRIPTION	DATE		

DRAWING:
NORTH TRAFFIC CONTROL PLANS STA
187+00 TO 193+00 - STAGE 1


CONTROL PLANS STA

3+00 - STAGE 1

19-366

SHEET NUMBER:

39 of 71

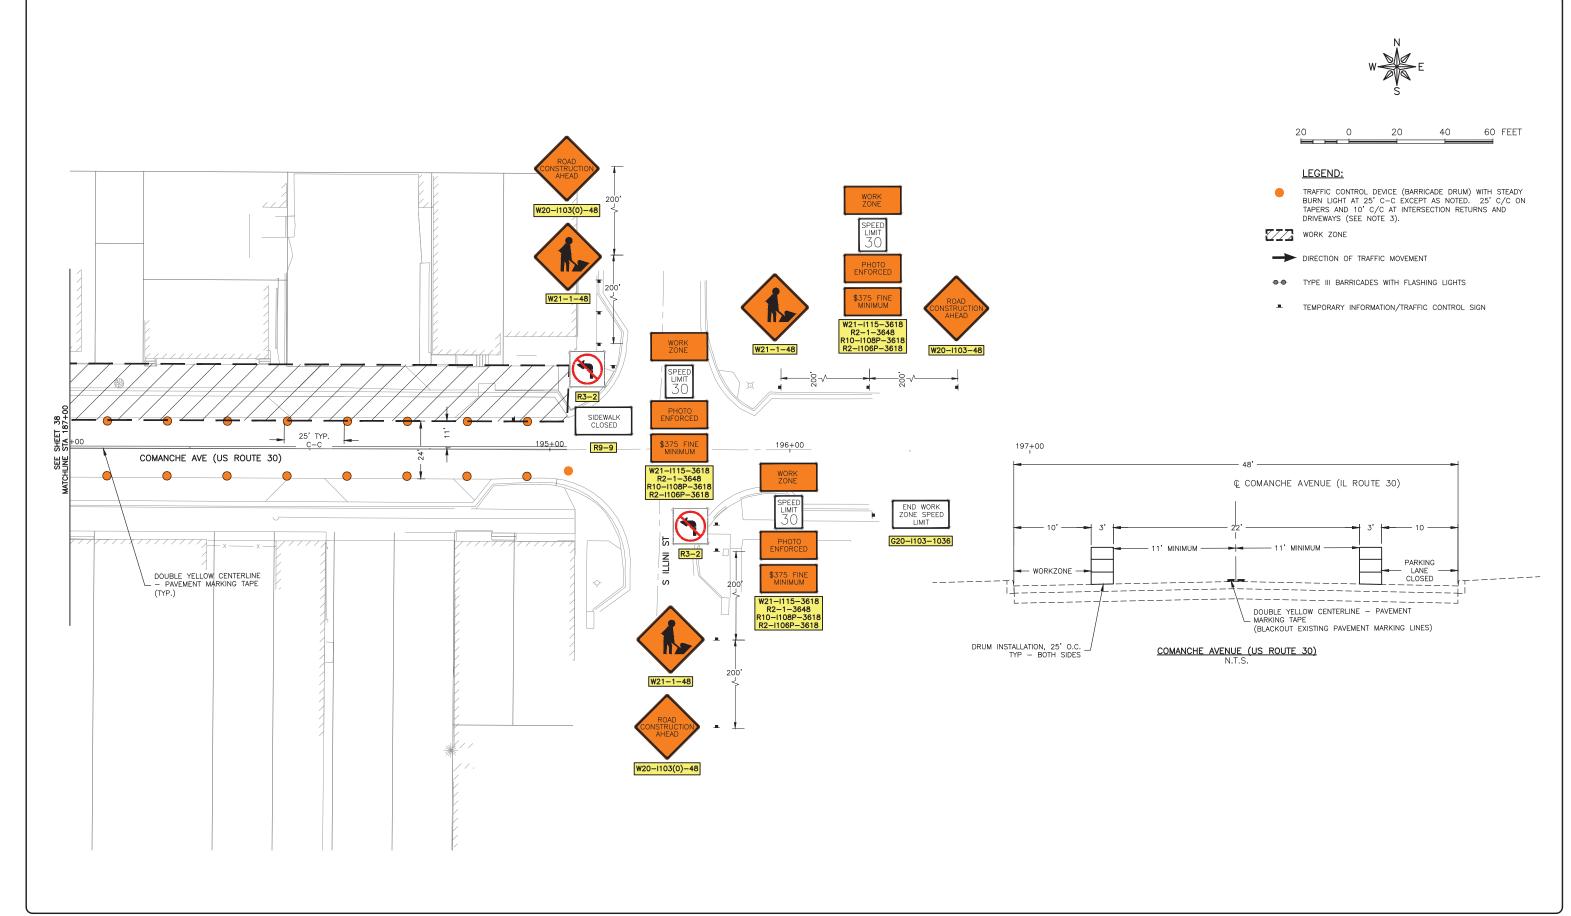

ILLINOIS IOWA WISCONSIN VILLAGE OF SHABBONA 206 S. BLACKHAWK ST SHABBONA, IL 60550 PROJECT AND LOCATION:
SHABBONA DOWNTOWN
STREETSCAPE
SHABBONA, IL

CONTRACT NO. 87841

DRAWN BY: JMV
APPROVED BY: BS
DATE: 05/17/2023
SCALE: AS NOTED

REVISIONS			
REV. NO.	DESCRIPTION	DATE	

DRAWING:

NORTH TRAFFIC CONTROL PLANS STA

193+00 TO 196+00 - STAGE 1

STOU - STAGE I

SHEET NUMBER: 40 of 71


19-366

ENGINEERING & ENVIRONMENTAL

ILLINOIS DESIGN FIRM NO. 184-003525

PLOT DATE: 6/19/23 © 2023 FEHR GRAHAM



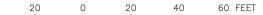


LEGEND:

TRAFFIC CONTROL DEVICE (BARRICADE DRUM) WITH STEADY BURN LIGHT AT 25' C-C EXCEPT AS NOTED. 25' C/C ON TAPERS AND 10' C/C AT INTERSECTION RETURNS AND DRIVEWAYS (SEE NOTE 3).

WORK ZONE

DIRECTION OF TRAFFIC MOVEMENT

•• TYPE III BARRICADES WITH FLASHING LIGHTS

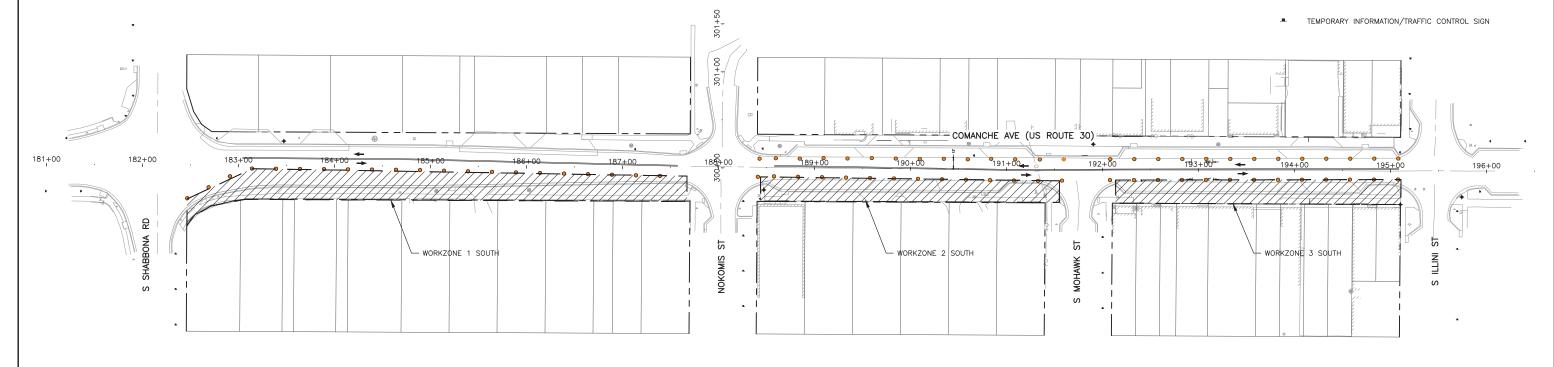

FEHR GRAHAM

ILLINOIS IOWA WISCONSIN owner/developer:
VILLAGE OF SHABBONA
206 S. BLACKHAWK ST
SHABBONA, IL 60550

PROJECT AND LOCATION:
SHABBONA DOWNTOWN
STREETSCAPE
SHABBONA, IL

DRAWN BY: JMV
APPROVED BY: BS
DATE: 05/17/2023
SCALE: AS NOTED

	REVISIONS	
REV. NO.	DESCRIPTION	DATE

DRAWING:

OVERALL SOUTH TRAFFIC CONTROL PLANS

- STAGE 2

SET TYPE: FINAL
G:\C3D\19\19-366\Plans\19-366 Traffic Plans.dwg, S-T.C. OVERALL


JOB NUMBER:

19-366

SHEET NUMBER:


41 of **71**

D\19\19-366\Plans\19-366 Traffic Plans.dwg, S-T.C. OVERALL

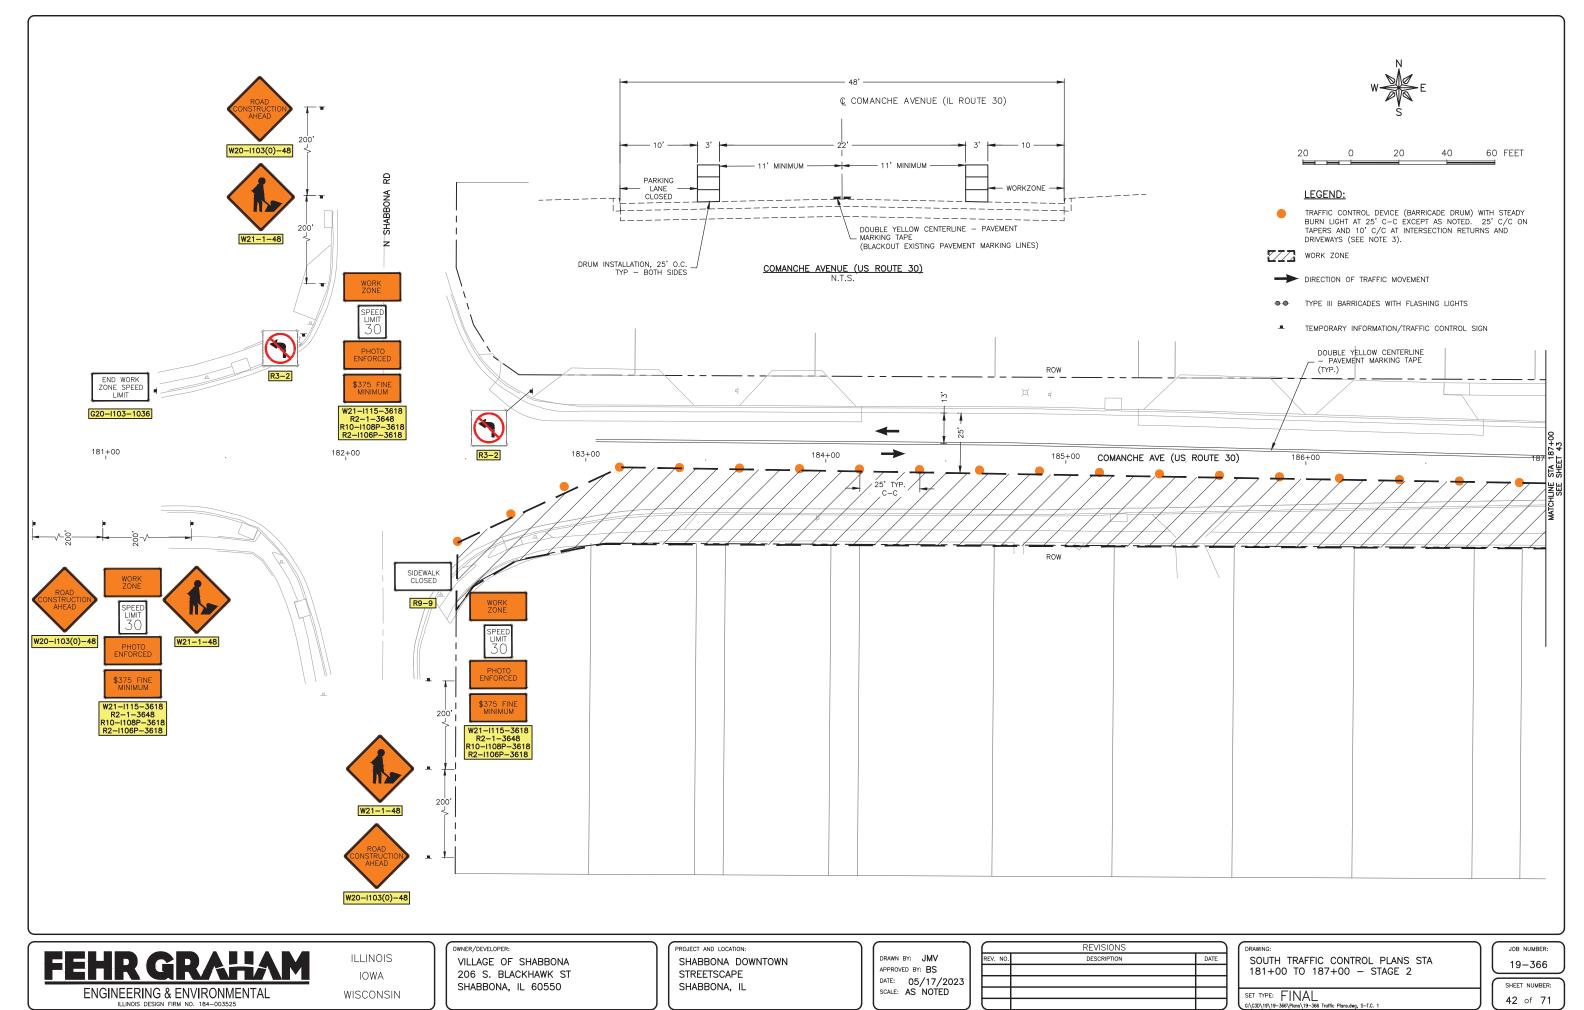

PLOT DATE: 6/19/23 © 2023 FEHR GRAHAM

CONTRACT NO. 87841

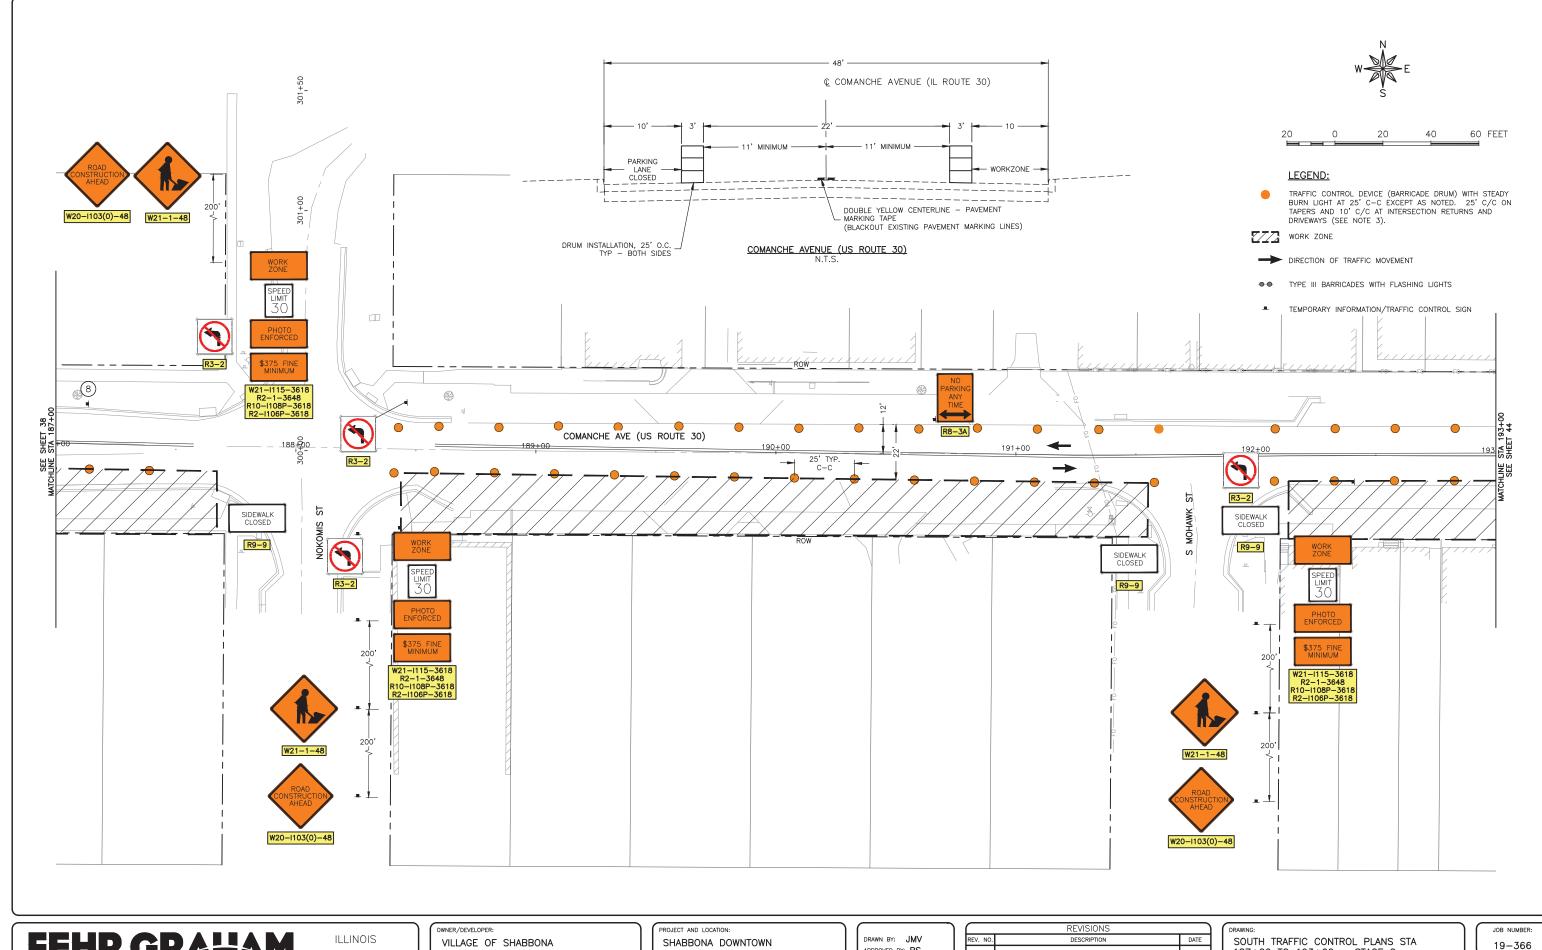

ILLINOIS IOWA WISCONSIN

VILLAGE OF SHABBONA 206 S. BLACKHAWK ST SHABBONA, IL 60550


SHABBONA DOWNTOWN STREETSCAPE SHABBONA, IL

DRAWN BY: JMV APPROVED BY: BS DATE: 05/17/2023 SCALE: AS NOTED

REVISIONS			
REV. NO.	DESCRIPTION	DATE	

SOUTH TRAFFIC CONTROL PLANS STA 187+00 TO 193+00 - STAGE 2

SHEET NUMBER: SET TYPE: FINAL **43** of **71**

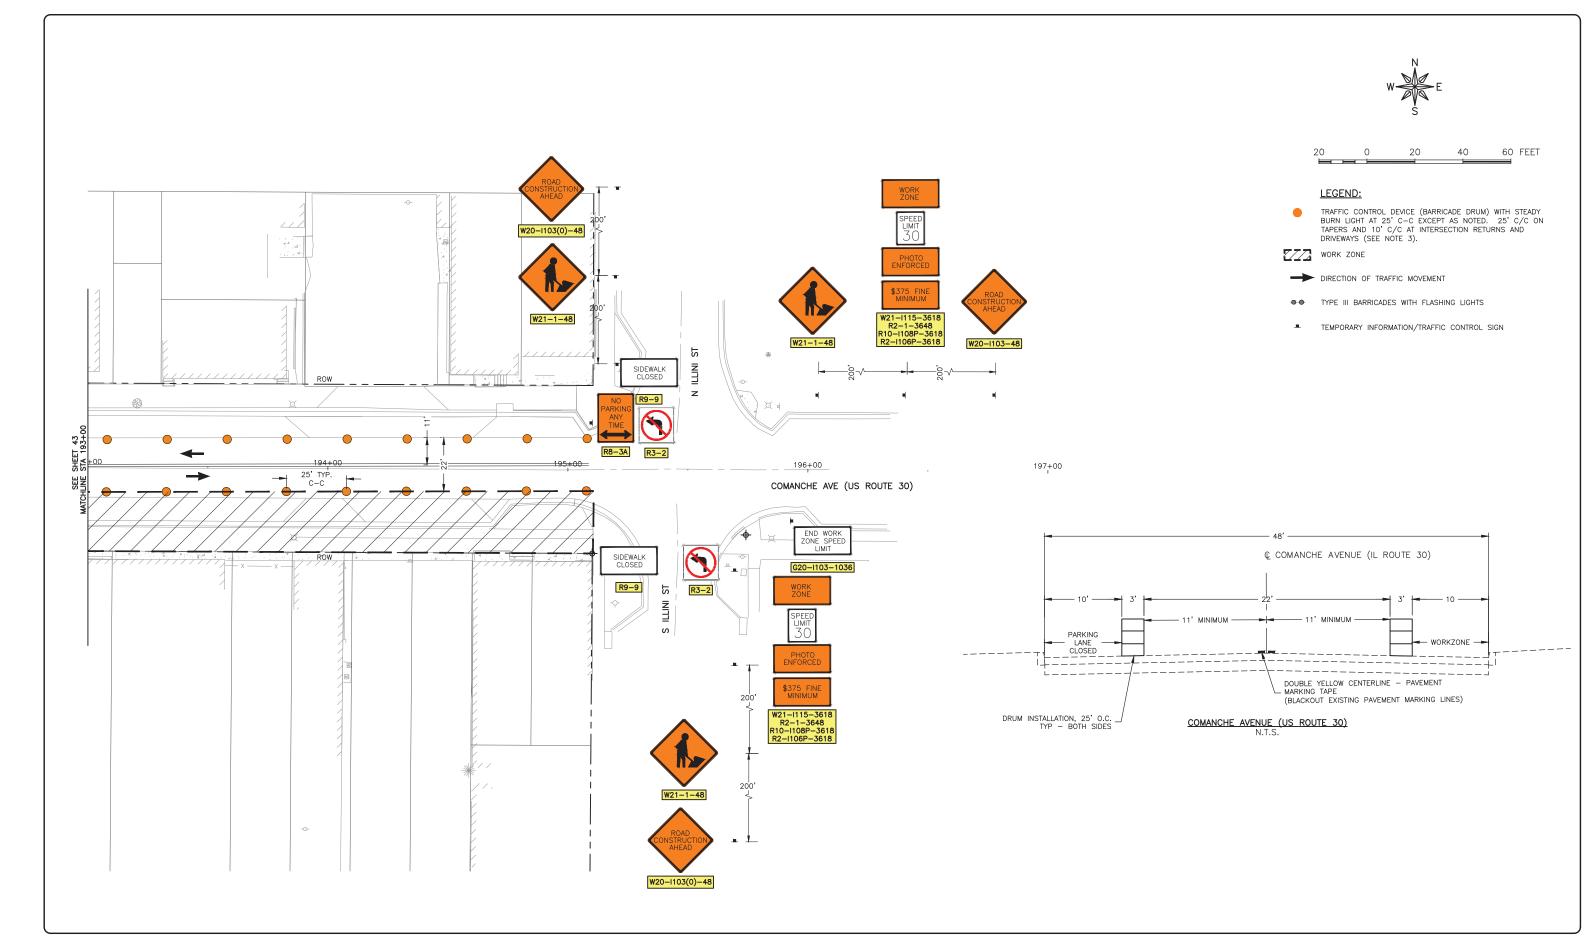



ILLINOIS IOWA WISCONSIN VILLAGE OF SHABBONA 206 S. BLACKHAWK ST SHABBONA, IL 60550 PROJECT AND LOCATION:

SHABBONA DOWNTOWN

STREETSCAPE

SHABBONA, IL

CONTRACT NO. 87841

DRAWN BY: JMV
APPROVED BY: BS
DATE: 05/17/2023
SCALE: AS NOTED

REVISIONS		
REV. NO.	DESCRIPTION	DATE


DRAWING:
SOUTH TRAFFIC CONTROL PLANS STA
193+00 TO 196+00 - STAGE 2

SET TYPE: FINAL

SHEET NUMBER: 44 of 71

19-366

PLOT DATE: 6/19/23 © 2023 FEHR GRAHAM

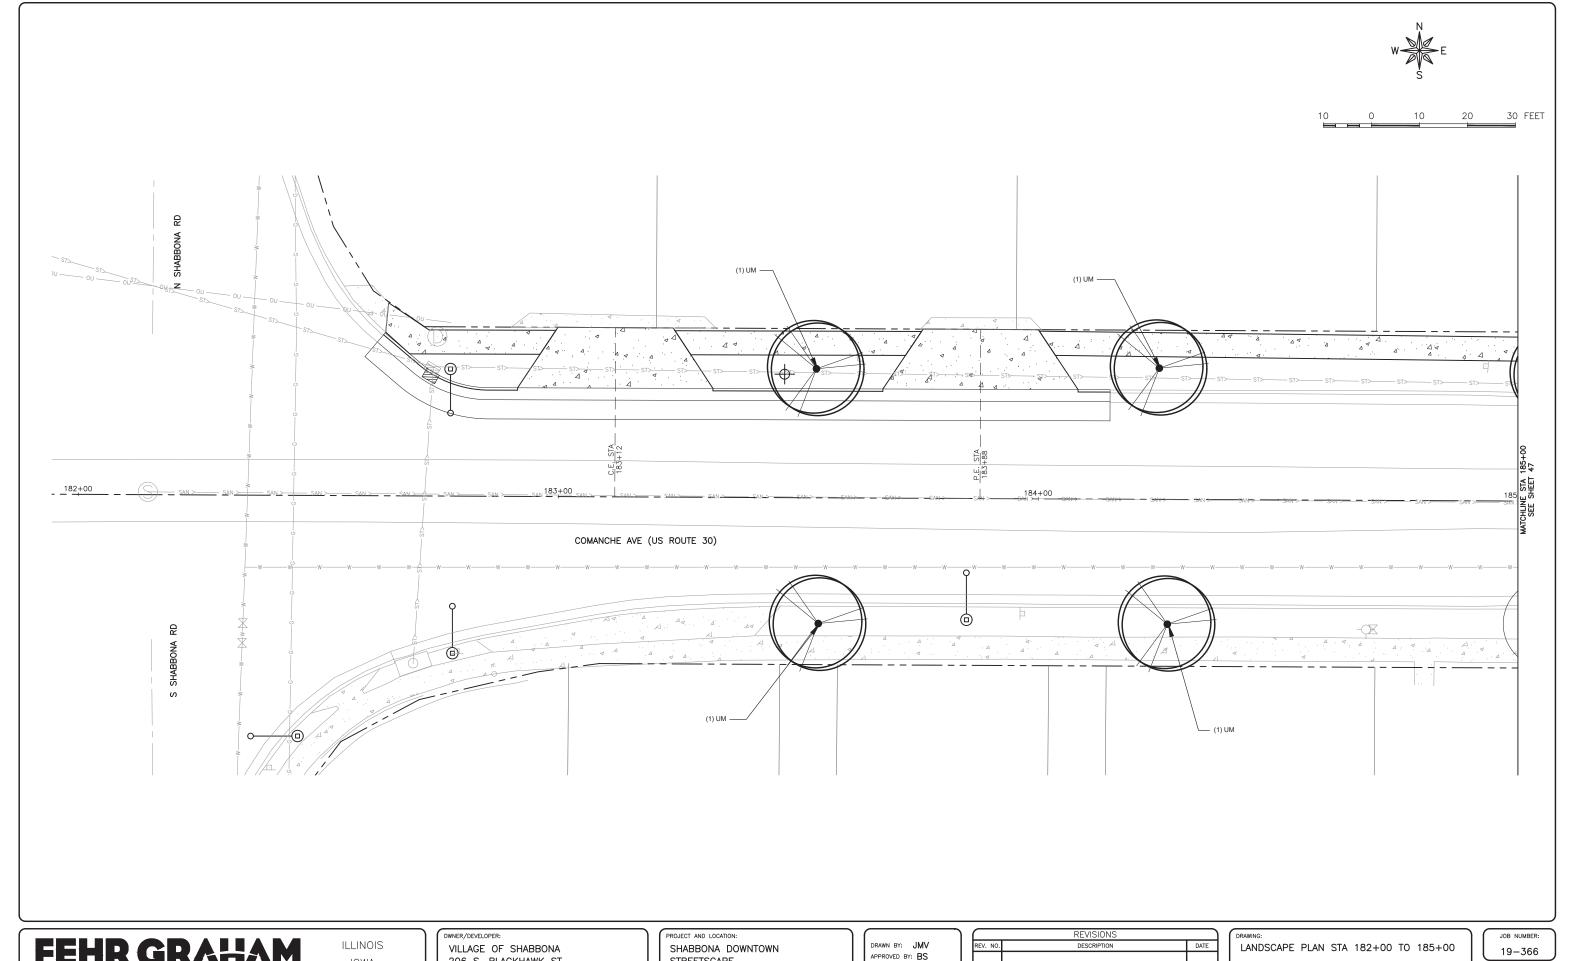

IOWA WISCONSIN VILLAGE OF SHABBONA 206 S. BLACKHAWK ST SHABBONA, IL 60550

STREETSCAPE SHABBONA, IL APPROVED BY: BS
DATE: 05/17/2023
SCALE: AS NOTED


REVISIONS		
REV. NO.	DESCRIPTION	DATE

SET TYPE: FINAL G:\C3D\19\19-366\Landscape\19-3

45 of **71**

PLOT DATE: 6/19/23 © 2023 FEHR GRAHAM

CONTRACT NO. 87841

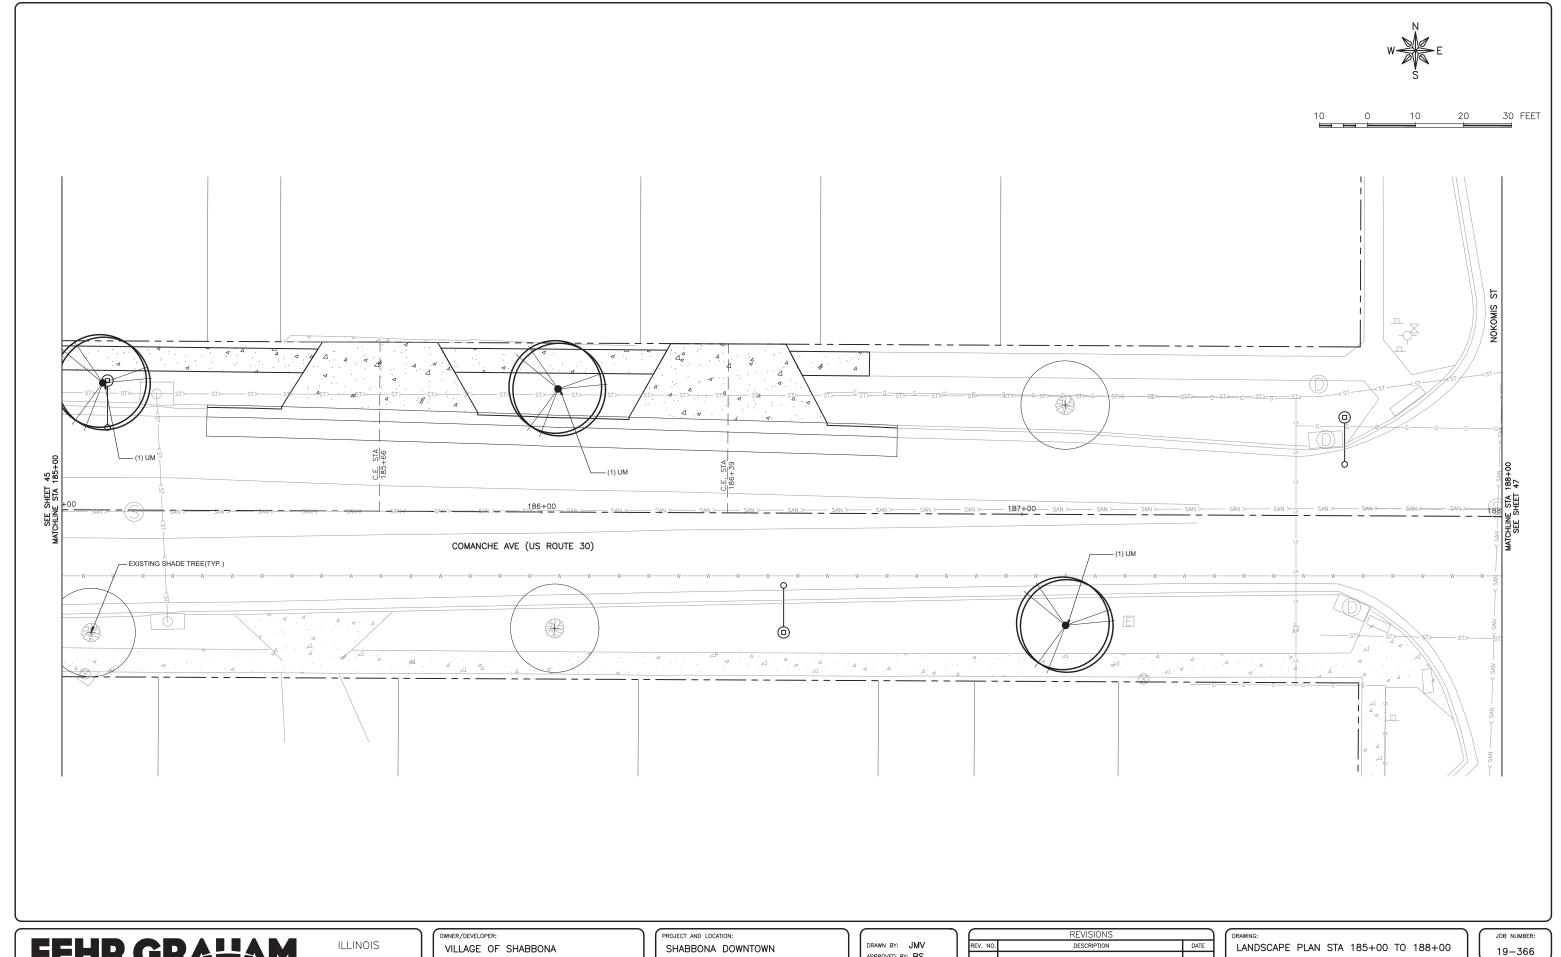

IOWA WISCONSIN VILLAGE OF SHABBONA 206 S. BLACKHAWK ST SHABBONA, IL 60550

SHABBONA DOWNTOWN STREETSCAPE SHABBONA, IL

CONTRACT NO. 87841


APPROVED BY: BS DATE: 05/17/2023 SCALE: AS NOTED

REVISIONS		
REV. NO.	DESCRIPTION	DATE

SET TYPE: FINAL 6:\C30\19\19-366\Landscape\19-36

46 of **71**

PLOT DATE: 6/19/23 © 2023 FEHR GRAHAM

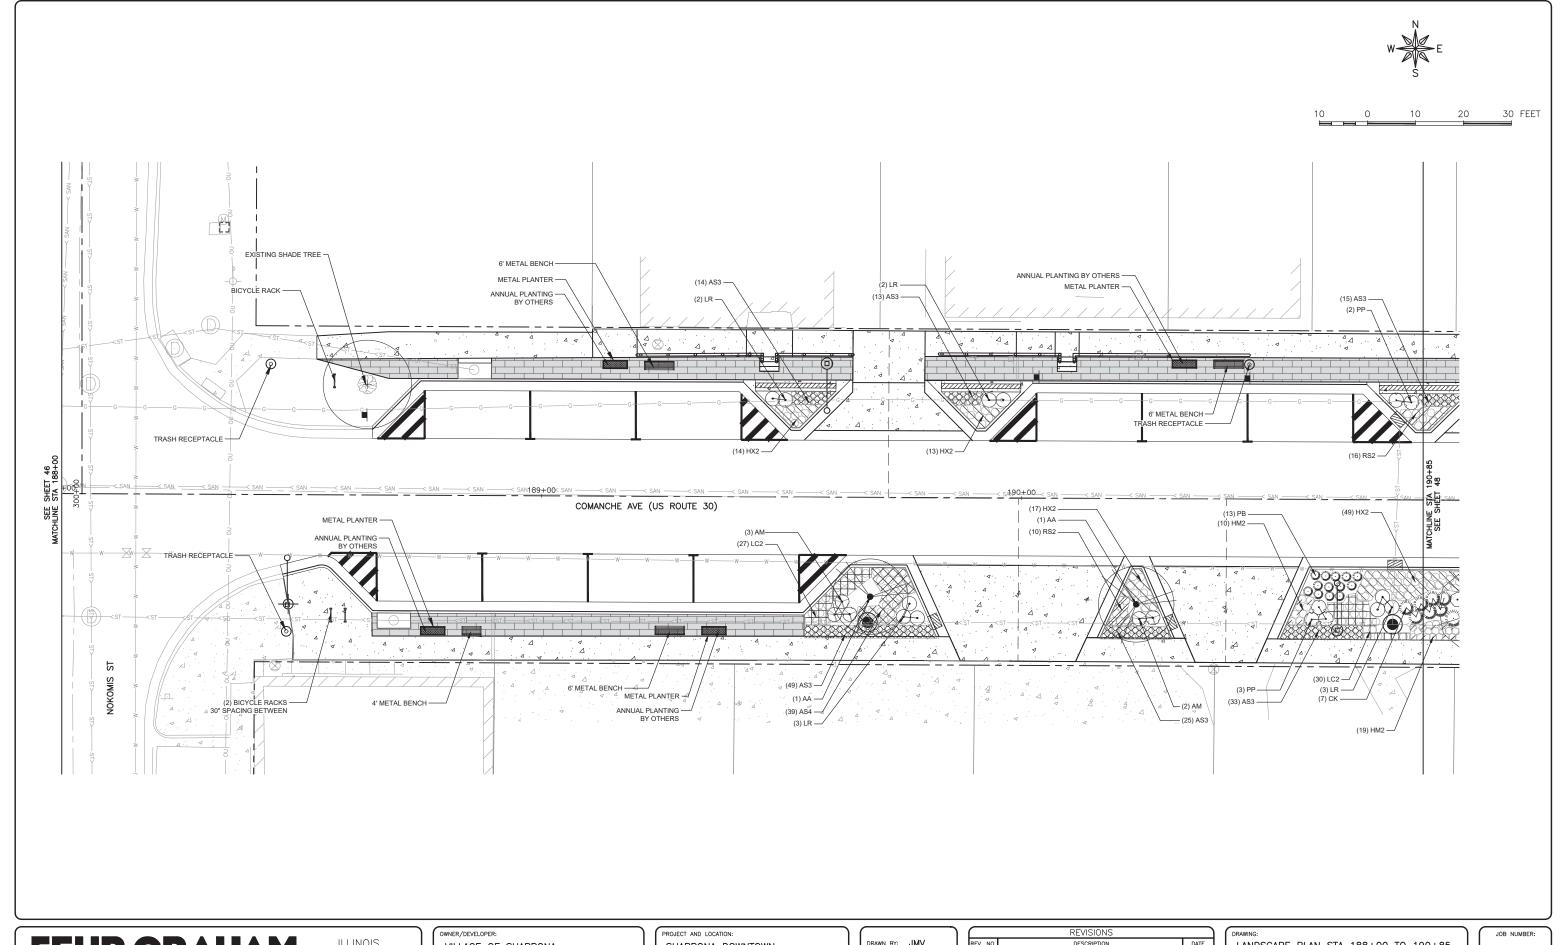

ILLINOIS IOWA WISCONSIN VILLAGE OF SHABBONA 206 S. BLACKHAWK ST SHABBONA, IL 60550 SHABBONA DOWNTOWN STREETSCAPE SHABBONA, IL DRAWN BY: JMV
APPROVED BY: BS
DATE: 05/17/2023
SCALE: AS NOTED

REVISIONS		
REV. NO.	DESCRIPTION	DATE


DRAWING: LANDSCAPE PLAN STA 188+00 TO 190+85


19-366

SHEET NUMBER:
47 of 71

SECTION NO. 23-00019-01-LS

SET TYPE: FINAL

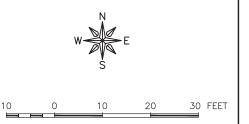

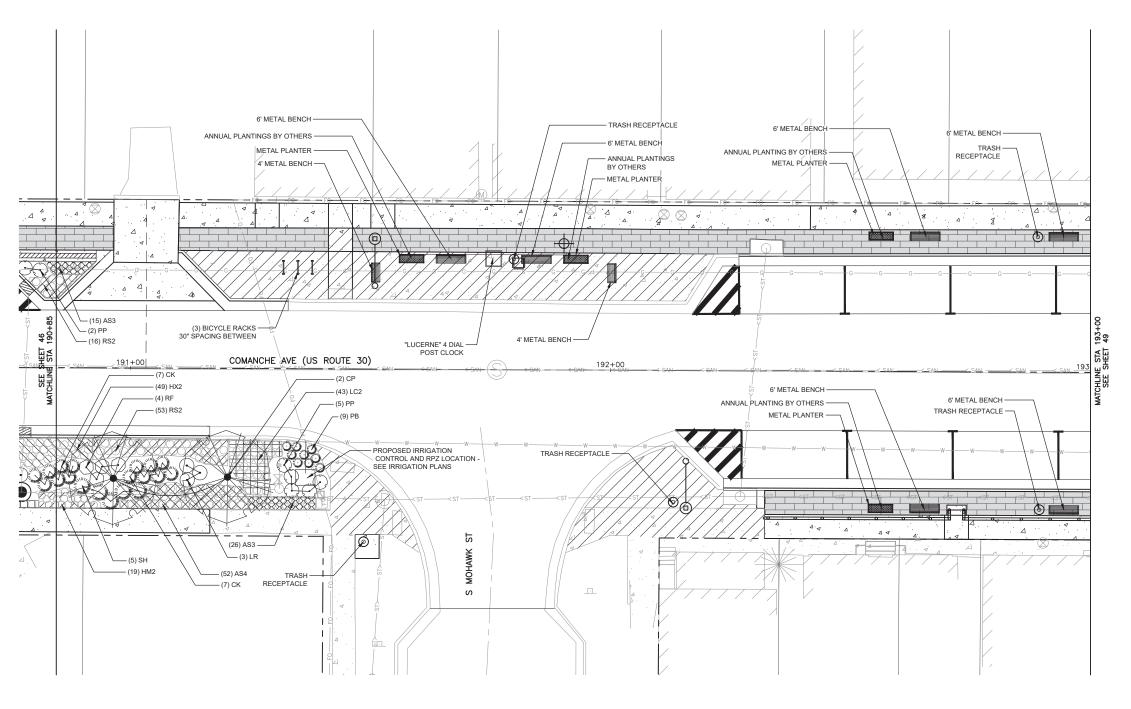

ILLINOIS IOWA WISCONSIN owner/developer:
VILLAGE OF SHABBONA
206 S. BLACKHAWK ST
SHABBONA, IL 60550

PROJECT AND LOCATION:
SHABBONA DOWNTOWN
STREETSCAPE
SHABBONA, IL

DRAWN BY: JMV
APPROVED BY: BS
DATE: 05/17/2023
SCALE: AS NOTED

	REVISIONS	
REV. NO.	DESCRIPTION	DATE

DRAWING: LANDSCAPE PLAN STA 190+85 TO 193+00

SET TYPE: FINAL


SHEET NUMBER: 48 of 71

19-366

ENGINEERING & ENVIRONMENTAL ILLINOIS DESIGN FIRM NO. 184-003525

PLOT DATE: 6/19/23 © 2023 FEHR GRAHAM

CONTRACT NO. 87841

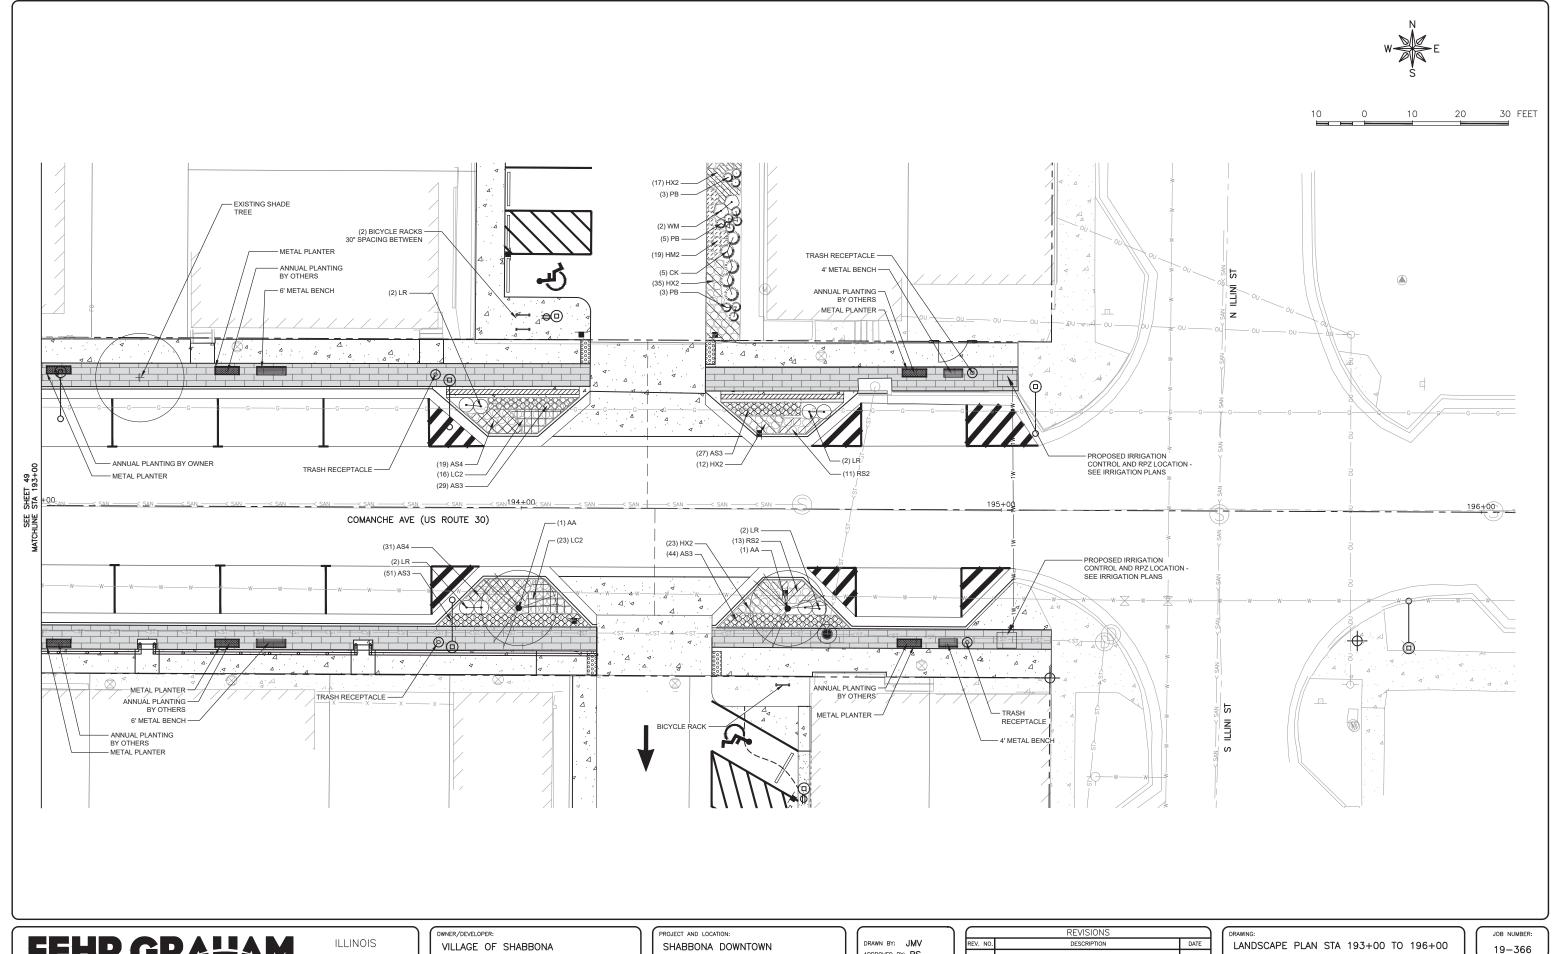


IOWA WISCONSIN 206 S. BLACKHAWK ST SHABBONA, IL 60550

STREETSCAPE SHABBONA, IL

APPROVED BY: BS DATE: 05/17/2023 SCALE: AS NOTED

	REVISIONS		DRAWING:
REV. NO.	DESCRIPTION	DATE	LANDSCAPE PL
			SET TYPE: FINAL
			G:\C3D\19\19-366\Landscape\19-

49 of **71**

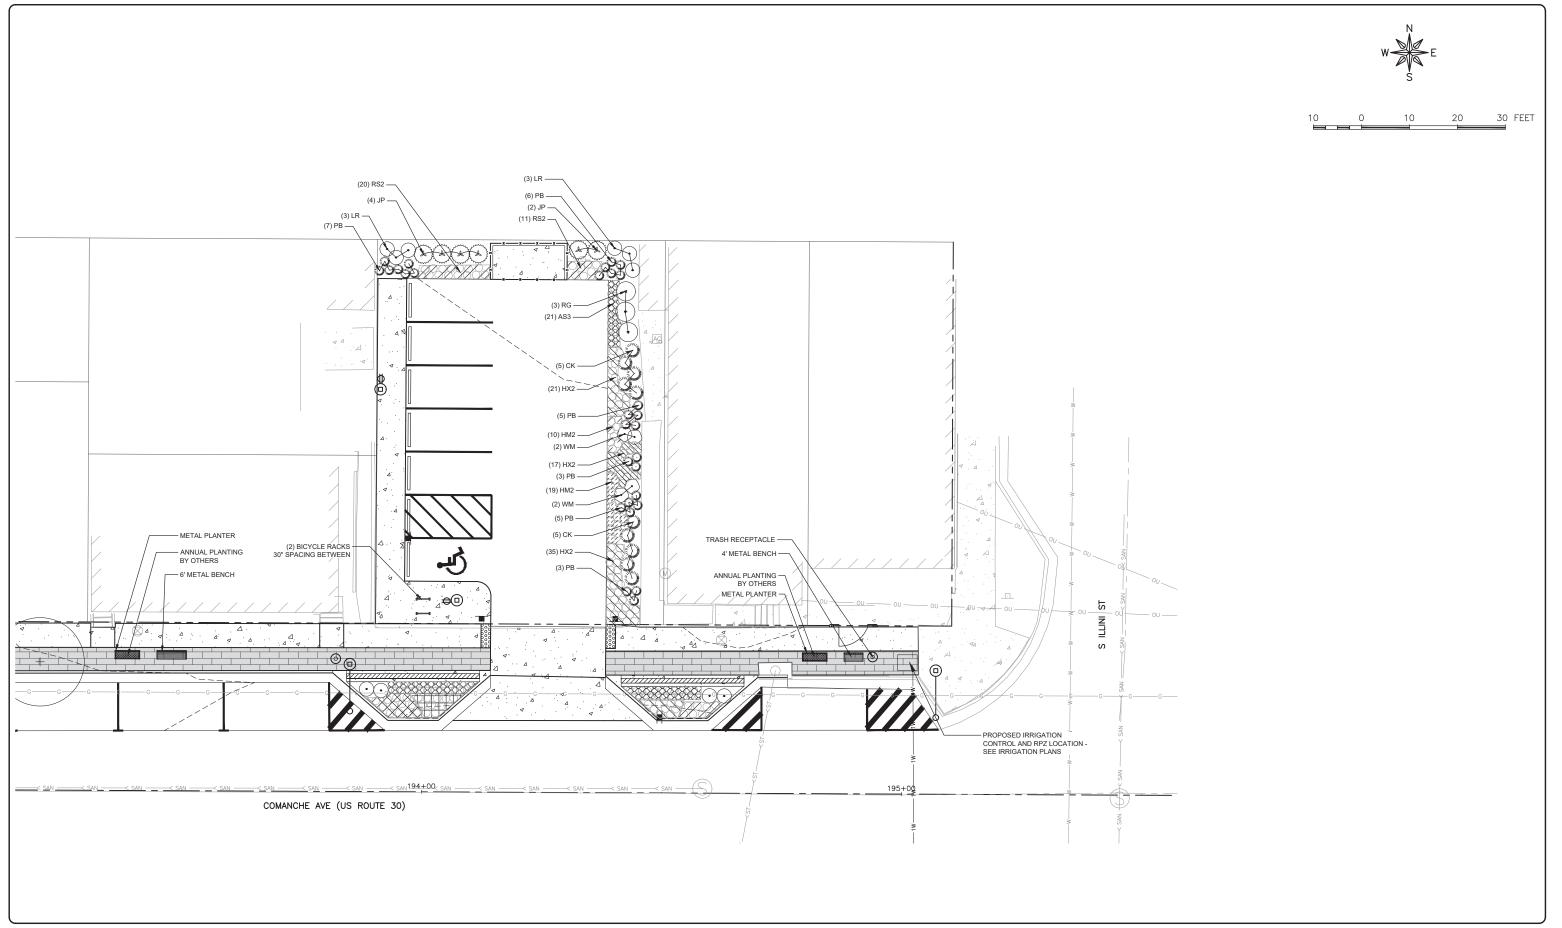

ILLINOIS IOWA WISCONSIN VILLAGE OF SHABBONA 206 S. BLACKHAWK ST SHABBONA, IL 60550 PROJECT AND LOCATION:
SHABBONA DOWNTOWN
STREETSCAPE
SHABBONA, IL

DRAWN BY: JMV
APPROVED BY: BS
DATE: 05/17/2023
SCALE: AS NOTED

	REVISIONS	
REV. NO.	DESCRIPTION	DATE

| DRAWING: | LANDSCAPE PLAN - NORTH PARKING LOT

SET TYPE: FINAL a:\C30/19/19-366\Landscape/19-366 Landscape.dwg, N. PARKING LOT

19-366

SHEET NUMBER:
50 of 71

LANDSCAPE NOTES:

- 1. CONTRACTOR SHALL VISIT SITE, INSPECT EXISTING CONDITIONS AND REVIEW PROPOSED WORK, IN CASE OF DISCREPANCY BETWEEN PLAN AND QUANTITY LISTS, PLAN SHALL GOVERN QUANTITIES.
- 2. CONTRACTOR SHALL VERIFY LOCATIONS OF ALL ON-SITE UTILITIES PRIOR TO BEGINNING CONTRACTION STALL VERIFIE LOCATIONS OF ALL OFF-SITE OFF-STRUCTION ON HIS/HER PHASE OF WORK. ELECTRIC, GAS, TELEPHONE, AND CABLE TELEVISION MAY BE LOCATED BY CALLING 811 NATIONWIDE TO REQUEST A LINE LOCATE, ANY DAMAGE TO UTILITIES OR INTERRUPTION OF SERVICES SHALL BE THE RESPONSIBILITY OF THE CONTRACTOR. CONTRACTOR TO COORDINATE ALL RELATED ACTIVITIES WITH OTHER TRADES ON JOB AND SHALL REPORT ANY UNACCEPTABLE JOB CONDITIONS TO OWNER'S REPRESENTATIVE PRIOR TO COMMENCING WORK.
- 3. CONTRACTOR RESPONSIBLE FOR APPLICATION AND COST OF ALL NECESSARY PERMITS AND CODE VERIFICATIONS. SUBMIT COPIES OF ALL DOCUMENTS TO OWNER AND LANDSCAPE ARCHITECT.
- 4. ALL SHRUB BEDS AND TREES SHALL BE MULCHED WITH A 3" DEPTH CONTINUOUS LAYER OF DARK BROWN SHREDDED HARDWOOD BARK MULCH. ALL GROUND COVER AND PERENNIAL BEDS SHALL BE MULCHED WITH A 1" DEPTH LAYER OF MULCH. ALL DECIDUOUS TREES SHALL BE MULCHED WITH A 3' DIAMETER CIRCLE OF 3" DEPTH MULCH. ALL EVERGREEN TREES SHALL BE MULCHED TO THE DRIP LINE.
- 5. PERENNIAL AND GROUND COVER BEDS SHALL BE AMENDED WITH A 2" LAYER OF MUSHROOM COMPOST, TILLED TO A DEPTH OF 6", RAKED SMOOTH, FERTILIZED WITH COMMERCIAL 10-6-4 FERTILIZER AT A RATE OF 25 LBS. PER 1,000 S.F., PLANTED, COVERED WITH 1" LAYER OF DARK BROWN SHREDDED HARDWOOD BARK MULCH AND WATERED.
- 6. FDGE ALL SHRUB BEDS THAT ABUT LAWN AREAS WITH RYERSON 1/8" X 4" GREEN STEEL EDGING OR APPROVED EQUAL. INSTALL PER MANUFACTURER'S SPECIFICATIONS. HEAT BEND ALL CORNERS. SAW CUT 1/2 DEPTH AND HEAT BEND ALL VERTICAL CURVES. INSTALL STAKES, CORNERS AND JOINTS ACCORDING TO MANUFACTURER'S RECOMMENDATIONS.
- 7. THE TOPSOIL CONDITION FOR THIS PROJECT SITE IS AS FOLLOWS:

CONTRACTOR TO SUPPLY, PLACE AND FINISH GRADE TOPSOIL AT SPECIFIED DEPTHS IN PLANTING AND LAWN AREAS. PLANTING AREAS: 10 INCHES, LAWN AREAS: 6 INCHES.

FOR CORRECTING MINOR IRREGULARITIES ON-SITE WILL BE SUPPLIED AND PLACED BY


- GUARANTEE OF PLANTS FOR ONE (1) YEAR SHALL BEGIN AFTER ACCEPTANCE BY LANDSCAPE ARCHITECT AND/OR OWNER. THE OWNER SHALL ASSUME MAINTENANCE RESPONSIBILITIES OF ALL PLANT MATERIAL, INCLUDING WATERING, CULTIVATING, WEEDING, MULCHING AND SPRAYING AS NECESSARY TO KEEP PLANTS FREE OF INSECTS AND IN A HEALTHY, VIGOROUS CONDITION. THE CONTRACTOR SHALL GUARANTEE ALL PLANTS TO BE IN A HEALTHT, VIGOROUS CONDITION. FOR A PERIOD OF ONE (1) YEAR FOLLOWING ACCEPTANCE. CONTRACTOR SHALL REPLACE WITHOUT COST TO OWNER, ANY DEAD OR UNACCEPTABLE PLANTS, AS DETERMINED BY LANDSCAPE ARCHITECT DURING AND AT THE END OF THE GUARANTEE PERIOD.
- 9. SOD TO BE WELL ESTABLISHED MINERAL TYPE GROWTH. NO PEAT SOD WILL BE ALLOWED. SOD

GRASSES SHALL CONSIST OF THE FOLLOWING BLUEGRASS TYPES: 55% BARRONS, 15% MAJESTIC, 15% ADELPHI, 15% GLADE. SOD PIECES ARE TO FIT TIGHTLY TOGETHER SO THAT NO JOINTS ARE VISIBLE, ALTERNATE AND STAGGER COURSES AND TAMP OR ROLL FIRMLY, ALL SODDED LAWN AREAS SHALL BE FERTILIZED AT FIRST CUTTING WITH 15-40-5 ANALYSIS FERTILIZER, A RATE OF 6 LBS. PER 1,000 S.F. ACCEPTANCE AND GUARANTEE SHALL APPLY TO ALL SOD


- 10. ACCEPTANCE OF GRADING AND SOD SHALL BE BY LANDSCAPE ARCHITECT AND OWNER. THE CONTRACTOR SHALL ASSUME MAINTENANCE RESPONSIBILITIES FOR A MINIMUM OF THIRTY (30) DAYS OR UNTIL SECOND CUTTING, WHICHEVER IS LONGER. MAINTENANCE SHALL INCLUDE WATERING, WEEDING, REPLACEMENT OF WASH-OFFS AND ANY OTHER OPERATIONS NECESSARY TO KEEP LAWN IN A THRIVING CONDITION. UPON FINAL ACCEPTANCE BY LANDSCAPE ARCHITECT AND/OR OWNER, THE OWNER SHALL ASSUME ALL MAINTENANCE RESPONSIBILITIES.
- 11. SEEDED LAWN TO BE A COMBINATION OF BLUEGRASS, PERENNIAL RYE AND RED FESCUE WITH THE FOLLOWING ANALYSIS BY WEIGHT: 30% RUGBY KENTUCKY BLUEGRASS, 20% PARK KENTUCKY BLUEGRASS, 20% CREEPING RED FESCUE, 20% SCALDIS HARD FESCUE, 10% PERENNIAL RYEGRASS. SEED TO BE APPLIED AT A RATE OF 4 LBS. PER 1,000 S.F. ALL SEEDED LAWN AREAS SHALL BE FERTILIZED AT INSTALLATION WITH 0-26-26 ANALYSIS, AT A RATE OF 6 LBS. PER 1,000 S.F. SECOND APPLICATION OF 15-40-5 TO BE APPLIED AT RATE OF 6 LBS. PER 1,000 S.F. AFTER FIRST CUTTING. ACCEPTANCE AND GUARANTEE NOTES SHALL APPLY TO ALL SEFERD ARFAS. APPLY TO ALL SEEDED AREAS.
- 12. ACCEPTANCE OF GRADING AND SEEDING SHALL BE BY LANDSCAPE ARCHITECT AND OWNER. THE CONTRACTOR SHALL ASSUME MAINTENANCE RESPONSIBILITIES FOR A MINIMUM OF SIXTY (60) DAYS OR UNTIL SECOND CUTTING, WHICHEVER IS LONGER. MAINTENANCE SHALL INCLUDE WATERING, WEEDING, RESEEDING AND OTHER OPERATIONS NECESSARY TO KEEP LAWN IN A THRIVING CONDITION. UPON FINAL ACCEPTANCE BY LANDSCAPE ARCHITECT AND/OR OWNER, OWNER SHALL ASSUME ALL MAINTENANCE RESPONSIBILITIES. AFTER LAWN AREAS HAVE GERMINATED, AREAS WHICH FAIL TO SHOW A UNIFORM STAND OF GRASS FOR ANY REASON WHATSOEVER SHALL BE RESEEDED REPEATEDLY UNTIL ALL AREAS ARE COVERED WITH A SATISFACTORY STAND OF GRASS. MINIMUM ACCEPTANCE OF SEEDED LAWN AREAS MAY INCLUDE SCATTERED BARE SPOTS, NONE OF WHICH ARE LARGER THAN 1 SQUARE FOOT AND WHEN COMBINED DO NOT EXCEED 2% OF TOTAL SEEDED LAWN AREA.
- 13. IRRIGATION TO BE PROVIDED FOR AREAS INDICATED ON IRRIGATION PLANS. CONTTRACTOR TO PROVIDE SHOP DRAWINGS OF LINES, CONNECTIONS, ZONES, HEADS, AND OTHER COMPONENTS FOR APPROVAL BY ENGINEER PRIOR TO INSTALLATION. IRRIGATION FOR FREESTANDING METAL PLANTERS SHALL BE PROVIDED WITH REMOVEABLE CONNECTION TO IRRIGATION SYSTEM IN FLUSH-MOUNTED SIDEWALK CONNECTION. WATER LINE CONNECTIONS, ABOVE GROUND RPZ, AND CONTROLLER LOCATIONS HOWN ON PLANS ARE PROVIDED FOR REFERENCE. FINAL LOCATIONS AND CONNECTIONS TO BE PREPARED BY CONTRACTOR AND SUBMITTED TO ENGINEER FOR APPROVAL

PLANT LIST:

Code	Botanical	Common	Size	Container	Spacing	Quantity
DECIDUOUS TREES						
AA	Acer x freemanii 'Armstrong'	Armstrong Freeman Maple	2.5" Cal.	B&B		4
СР	Celtis occidentalis 'JFS-KSU1'	Prairie Sentinel® Hackberry	2.5" Cal.	B&B		2
UM	Ulmus x `Morton Glossy`	Triumph™ Elm	2.5" Cal.	B&B		7
DECIDUOUS SHRUE	3S					
AM	Aronia melanocarpa `Morton`	Iroquois Beauty™ Black Chokeberry	2.5` Ht.	B&B		5
LR	Diervilla x 'G2X88544'	Kodiak® Orange Diervilla	#3			27
PP	Potentilla fruticosa `Kupinpa`	Happy Face® Pink Paradise Bush Cinquefoil	#3			10
RG	Rhus aromatica 'Gro-Low'	Gro-Low Fragrant Sumac	#5			3
RF	Rosa x `NOA97400A`	Flower Carpet® Amber Rose	#3			4
WM	Weigela florida 'Minuet'	Minuet Weigela	#3			4
EVERGREEN SHRUE	35					
JP	Juniperus chinensis 'Kallays Compact'	Kallay Compact Pfitzer Juniper	#5			6
GRASSES / SEDGES						
CK	Calamagrostis x acutiflora 'Karl Foerster'	Karl Foerster Feather Reed Grass	#3			24
РВ	Pennisetum alopecuroides 'Burgundy Bunny'	Burgundy Bunny Dwarf Fountain Grass	#1			51
SH	Sporobolus heterolepis	Prairie Dropseed	#3			5
PERENNIALS						
AS3	Allium x 'MGsmmpkb13'	Summer Peek-A-Boo® Ornamental Onion	#1		15" o.c.	347
AS4	Anemone sylvestris	Snowdrop Anemone	#1		18" o.c.	141
HX2	Hemerocallis x 'VER00112'	EveryDaylily® Cream Daylily	#1		18" o.c.	201
HM2	Heuchera x 'Midnight Rose'	Midnight Rose Coral Bells	#1		18" o.c.	58
LC2	Liriope spicata	Creeping Lilyturf	#1		18" o.c.	139
RS2	Rudbeckia fulgida 'Little Goldstar'	Little Goldstar Coneflower	#1		18" o.c.	134

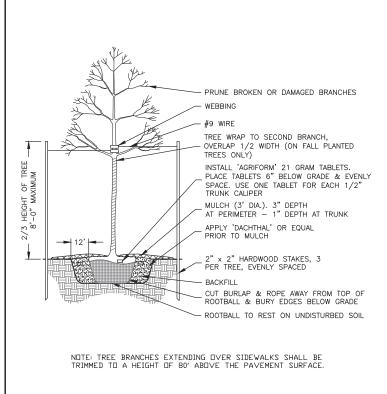

TREE PLANTING

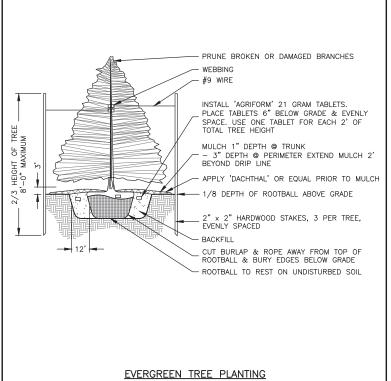

SET ORIGINAL GROUNDLINE OF ROOTBALL AT FINISH GRADE FOR CONTAINERIZED MATERIAL SLASH -4-5, 1" DEEP CUTS THE LENGTH OF FOR B&B REMOVE TOP 1/3 OF BURLAP AND NYLON ROPE PLANTING SOIL MIX: 4 PARTS TOPSOIL 1 PART PEAT MOSS 1 PART ROTTED MANURE FINISH GRADE EXIST. SUBSOIL INSTALL 'AGRIFORM' 21 GRAM TABLETS 6" BELOW GRADE, 1 TABLETS PER 12" HEIGHT OR SPREAD.

SHRUB PLANTING N.T.S.

- MULCH FERTILIZE WITH COMMERCIAL 10-6-4 FERTILIZER AT A RATE OF 25 LBS. PER 1000 S.F. 6" TILLED DEPTH-ALL BEDS AMENDED WITH 2" LAYER MUSHROOM COMPOST FINISH GRADE, TYPICAL EXISTING SUBSOIL

FEHR GRAH/

ENGINEERING & ENVIRONMENTAL

ILLINOIS IOWA

WISCONSIN

VILLAGE OF SHABBONA 206 S. BLACKHAWK ST SHABBONA, IL 60550

PROJECT AND LOCATIO

SHABBONA DOWNTOWN STREETSCAPE SHABBONA, IL

REVISIONS DRAWN BY: JMV DESCRIPTION APPROVED BY: BS DATE: 05/17/2023 SCALE: AS NOTED


LANDSCAPE NOTES, DETAILS & PLANT LIST SET TYPE: FINAL


DATE


PERENNIAL/GROUNDCOVER PLANTING METAL EDGE N.T.S.

JOB NUMBER 19-366 SHEET NUMBER **51** of **71**

PLOT DATE: 6/19/23 © 2023 FEHR GRAHAM

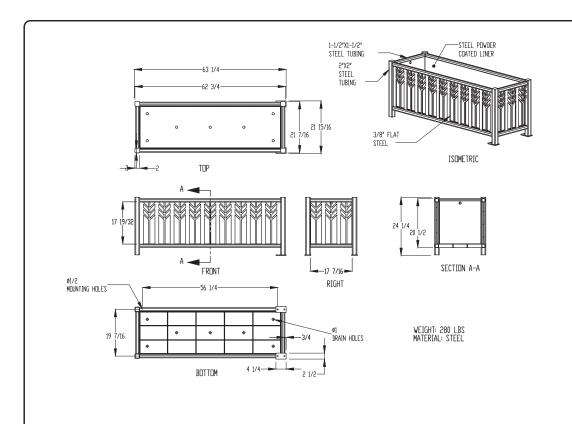

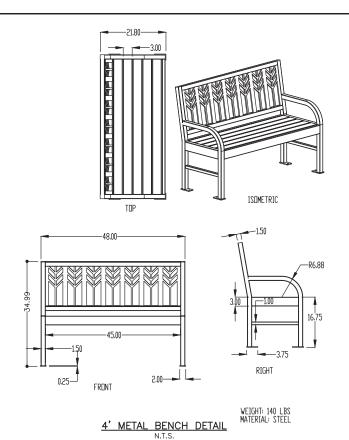

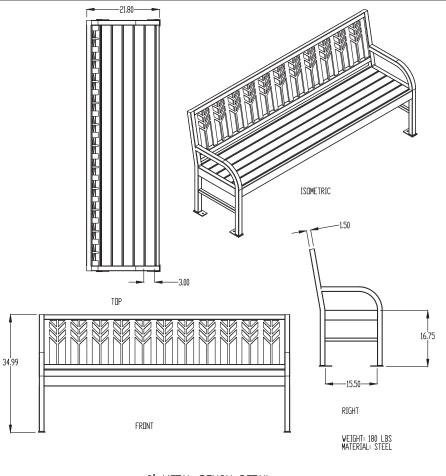


- DRIP IRRIGATION BY CONTRACTOR - ANNUAL PLANTINGS BY OTHERS 18" DEPTH PLANTER MIX - DRAINAGE BOARD, COVER WITH FILTER FABRIC, WRAP TOP 6" OVER BACK SIDE OF DRAINAGE BO - DRAIN HOLES

6' METAL BENCH DETAIL N.T.S.

IN GROUND REMOVABLE CONNECTION TO IRRIGATION TO BE PROVIDED BY CONTRACTOR

RAISED METAL PLANTER DETAIL N.T.S.

RAISED METAL PLANTER DETAIL N.T.S.

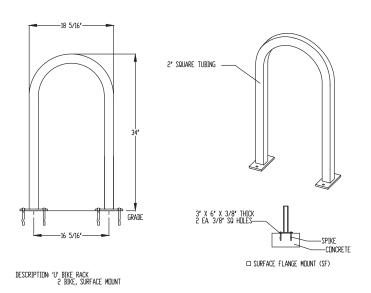

NULLS!

INSTALL BIKE RACKS ACCORDING TO MANUFACTURER'S SPECIFICATIONS.
CONSULTANT TO SELECT COLOR (FINISH), SEE MANUFACTURER'S SPECIFICATIONS.
SEE SITE PLAN FOR LOCATION OR CONSULT DIVINER.

IOWA

BICYCLE RACK DETAIL N.T.S.



WASTE RECEPTACLE DETAIL N.T.S.

ILLINOIS ENGINEERING & ENVIRONMENTAL ILLINOIS DESIGN FIRM NO. 184-003525 WISCONSIN

VILLAGE OF SHABBONA 206 S. BLACKHAWK ST SHABBONA, IL 60550

PROJECT AND LOCATION: SHABBONA DOWNTOWN STREETSCAPE SHABBONA, IL

DRAWN BY: JMV APPROVED BY: BS DATE: 05/17/2023 SCALE: AS NOTED


	REVISIONS	
REV. NO.	DESCRIPTION	DATE
	<u> </u>	

LANDSCAPE DETAILS SET TYPE: FINAL

JOB NUMBER:

19-366

52 of 71

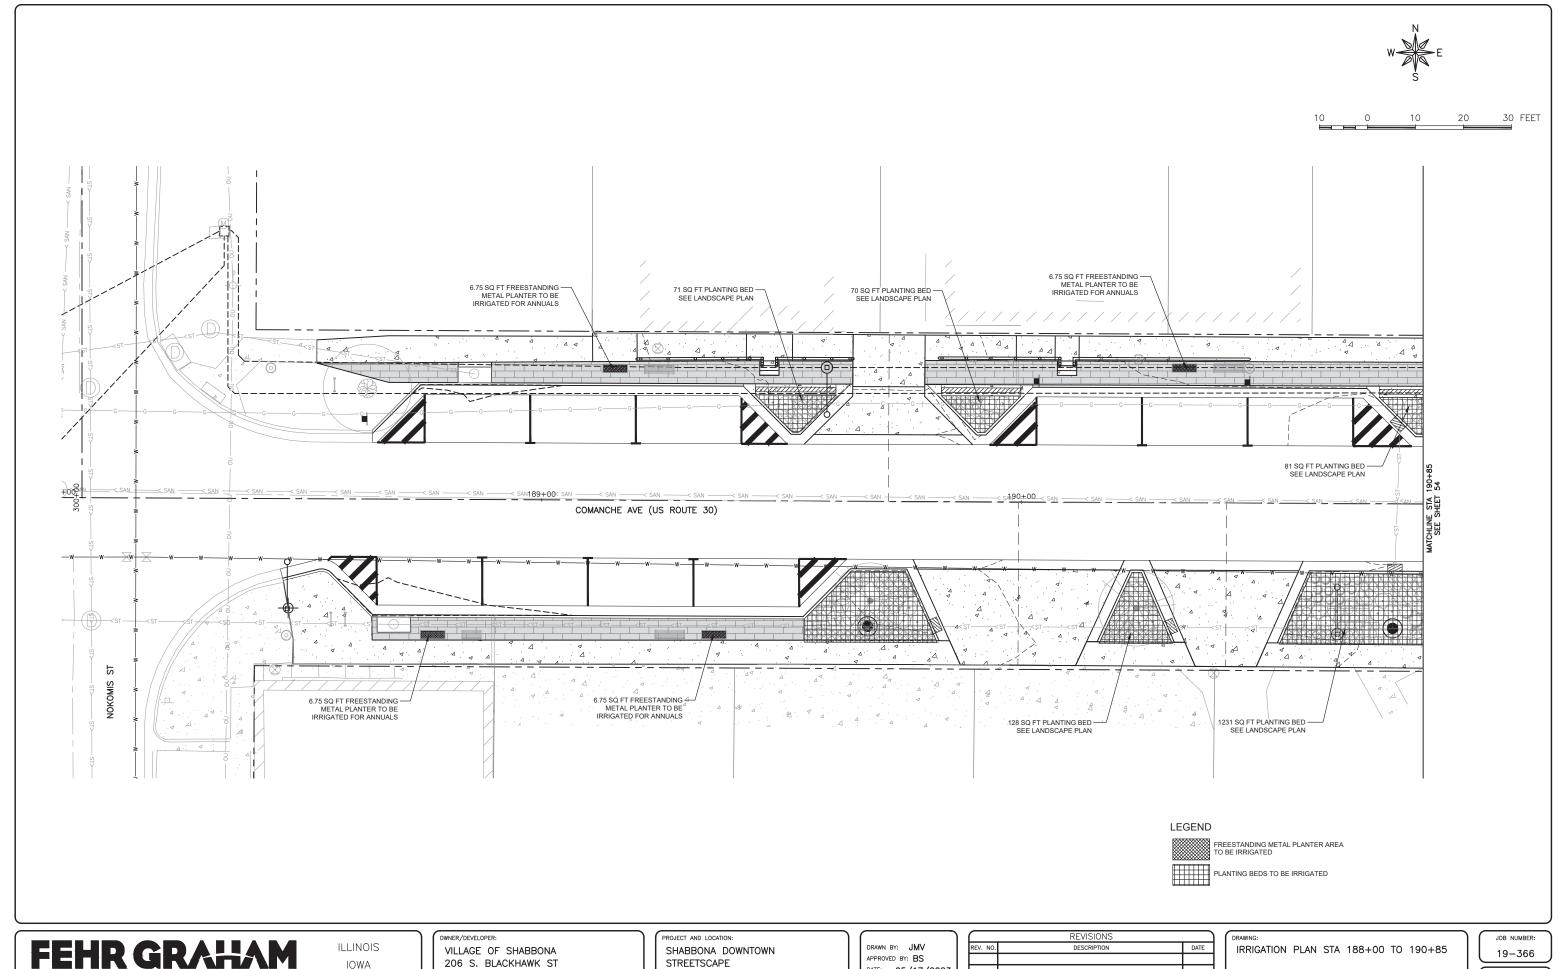

IOWA WISCONSIN SHABBONA, IL 60550


SHABBONA, IL


DATE: 05/17/2023 SCALE: AS NOTED

	REVISIONS	
REV. NO.	DESCRIPTION	DATE
	•	

SET TYPE: FINAL

53 of 71

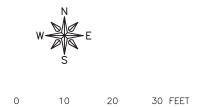

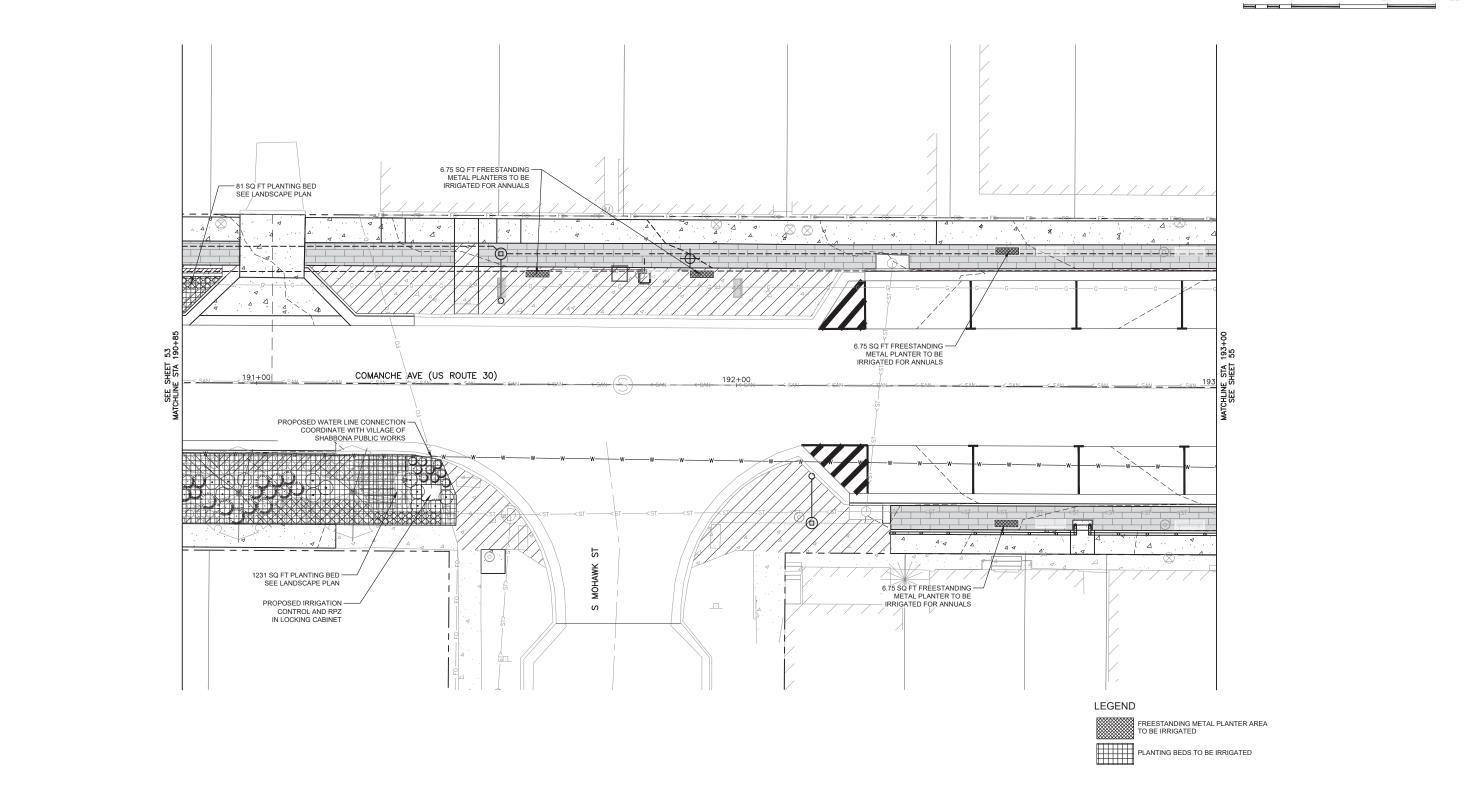

ILLINOIS IOWA WISCONSIN VILLAGE OF SHABBONA 206 S. BLACKHAWK ST SHABBONA, IL 60550 PROJECT AND LOCATION:
SHABBONA DOWNTOWN
STREETSCAPE
SHABBONA, IL

DRAWN BY: JMV
APPROVED BY: BS
DATE: 05/17/2023
SCALE: AS NOTED

	REVISIONS	
REV. NO.	DESCRIPTION	DATE


DRAWING: IRRIGATION PLAN STA 190+85 TO 193+00

SET TYPE: FINAL

JOB NUMBER:
19-366


SHEET NUMBER:

66 Landscope.dwg, IRRIGATION 2 54 of 71

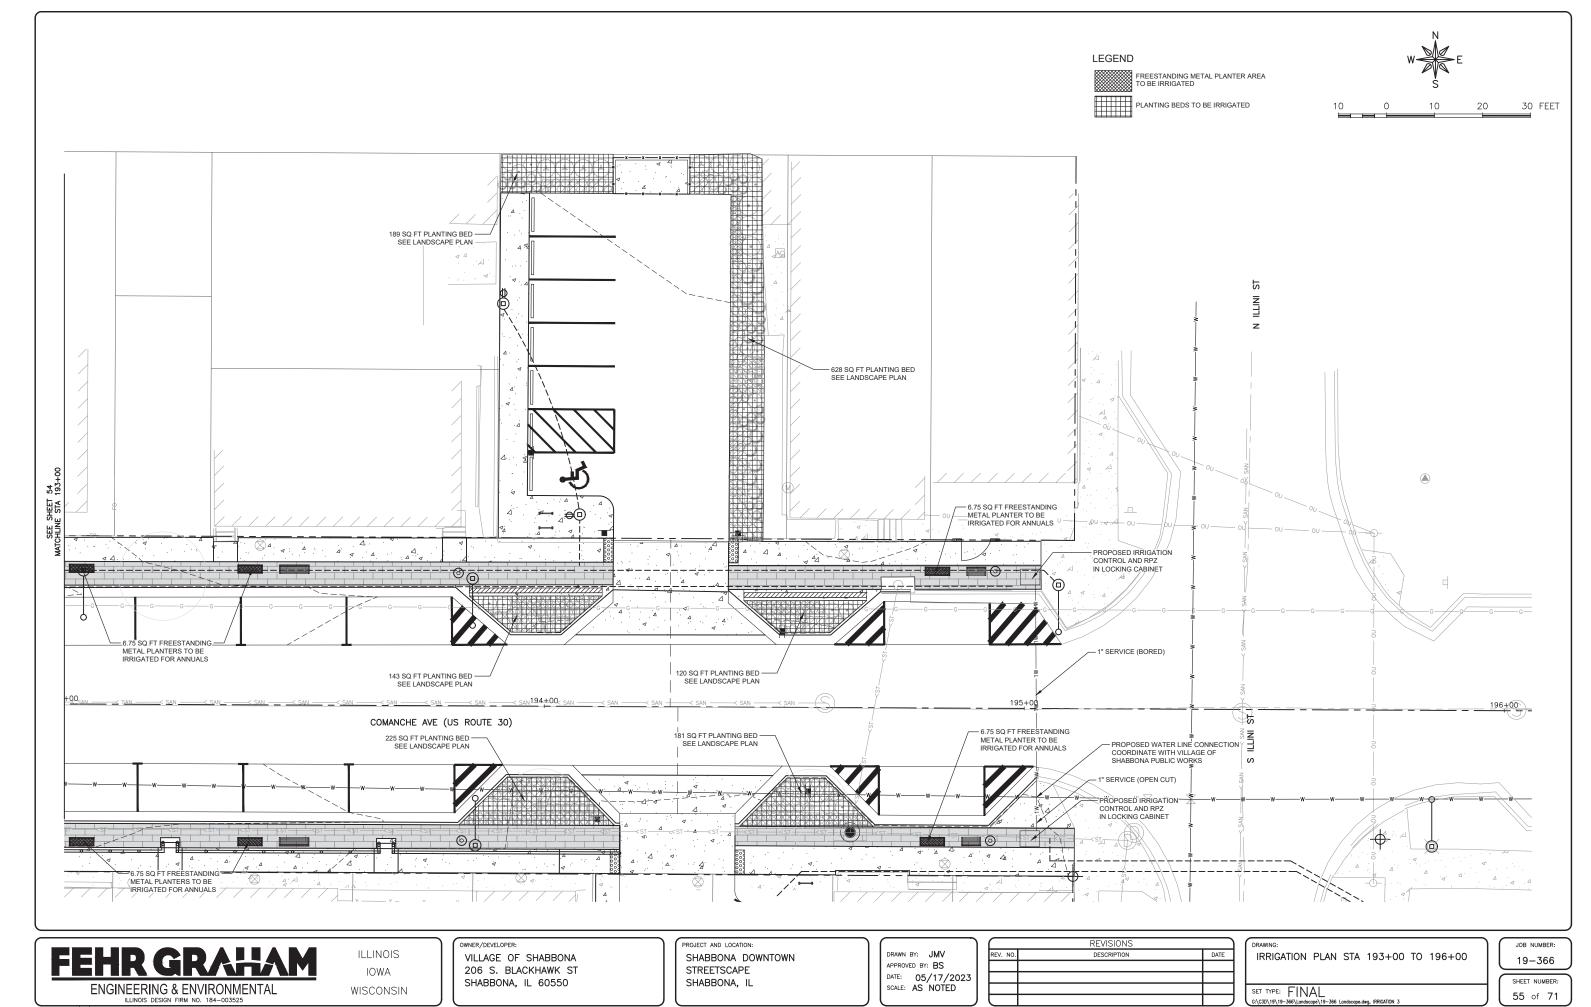

PLOT DATE: 6/19/23 © 2023 FEHR GRAHAM

CONTRACT NO. 87841

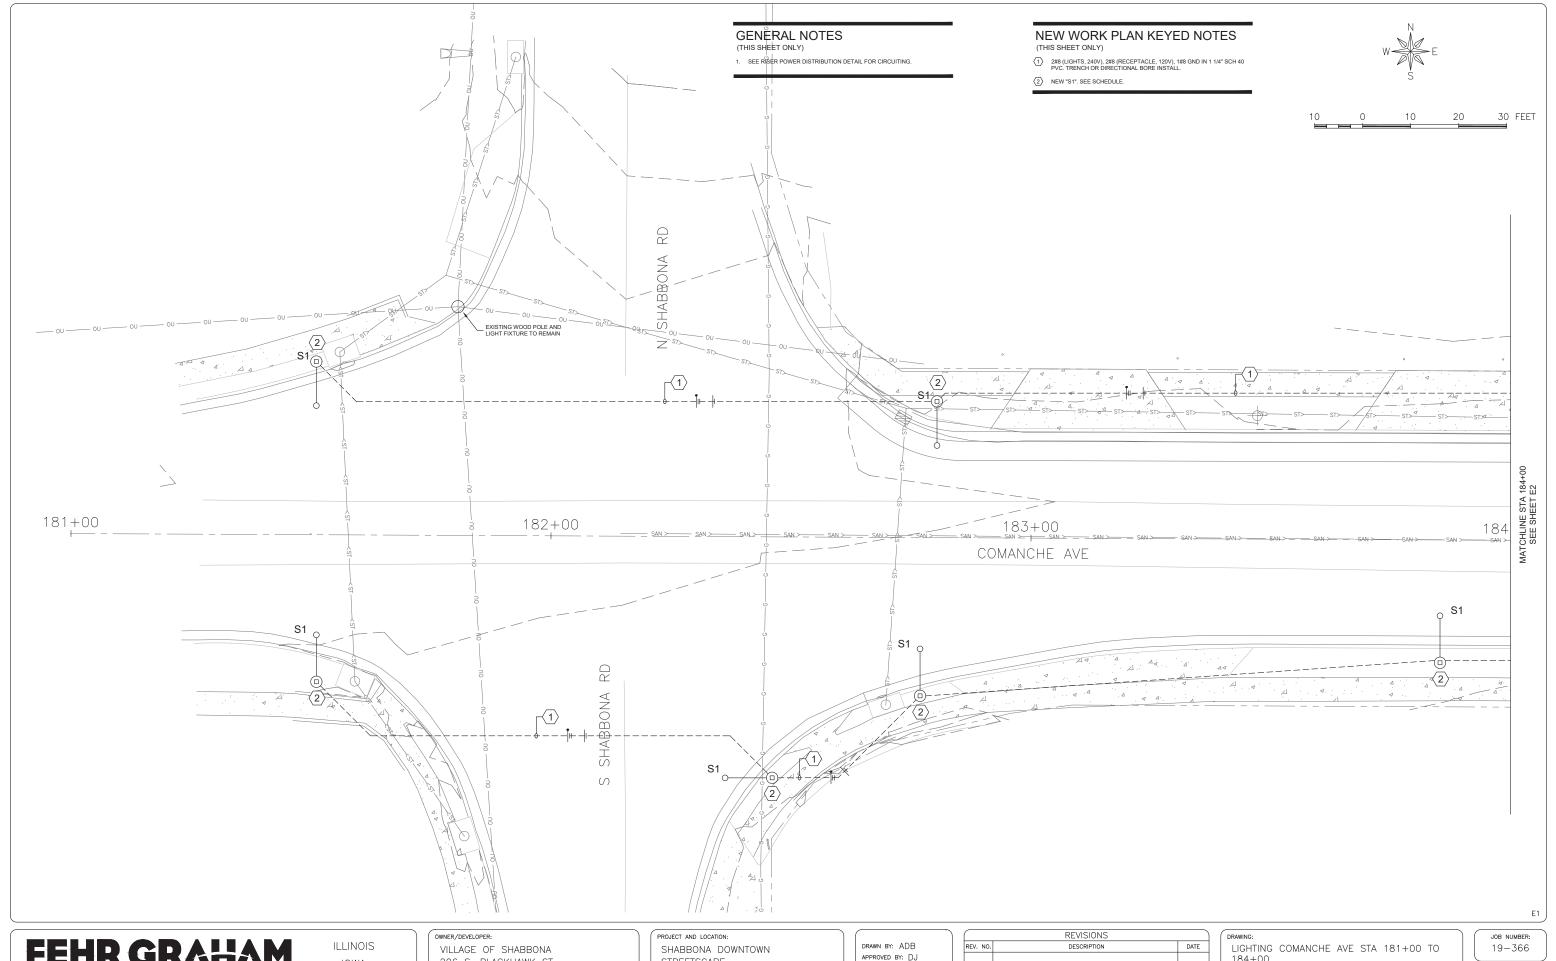

IOWA WISCONSIN 206 S. BLACKHAWK ST SHABBONA, IL 60550

STREETSCAPE SHABBONA, IL


APPROVED BY: DJ DATE: 05/17/23 SCALE: AS NOTED

	REVISIONS	
REV. NO	DESCRIPTION	DATE

LIGHTING COMANCHE AVE STA 181+00 TO 184+00 SET TYPE: FINAL

SHEET NUMBER:

56 of 71

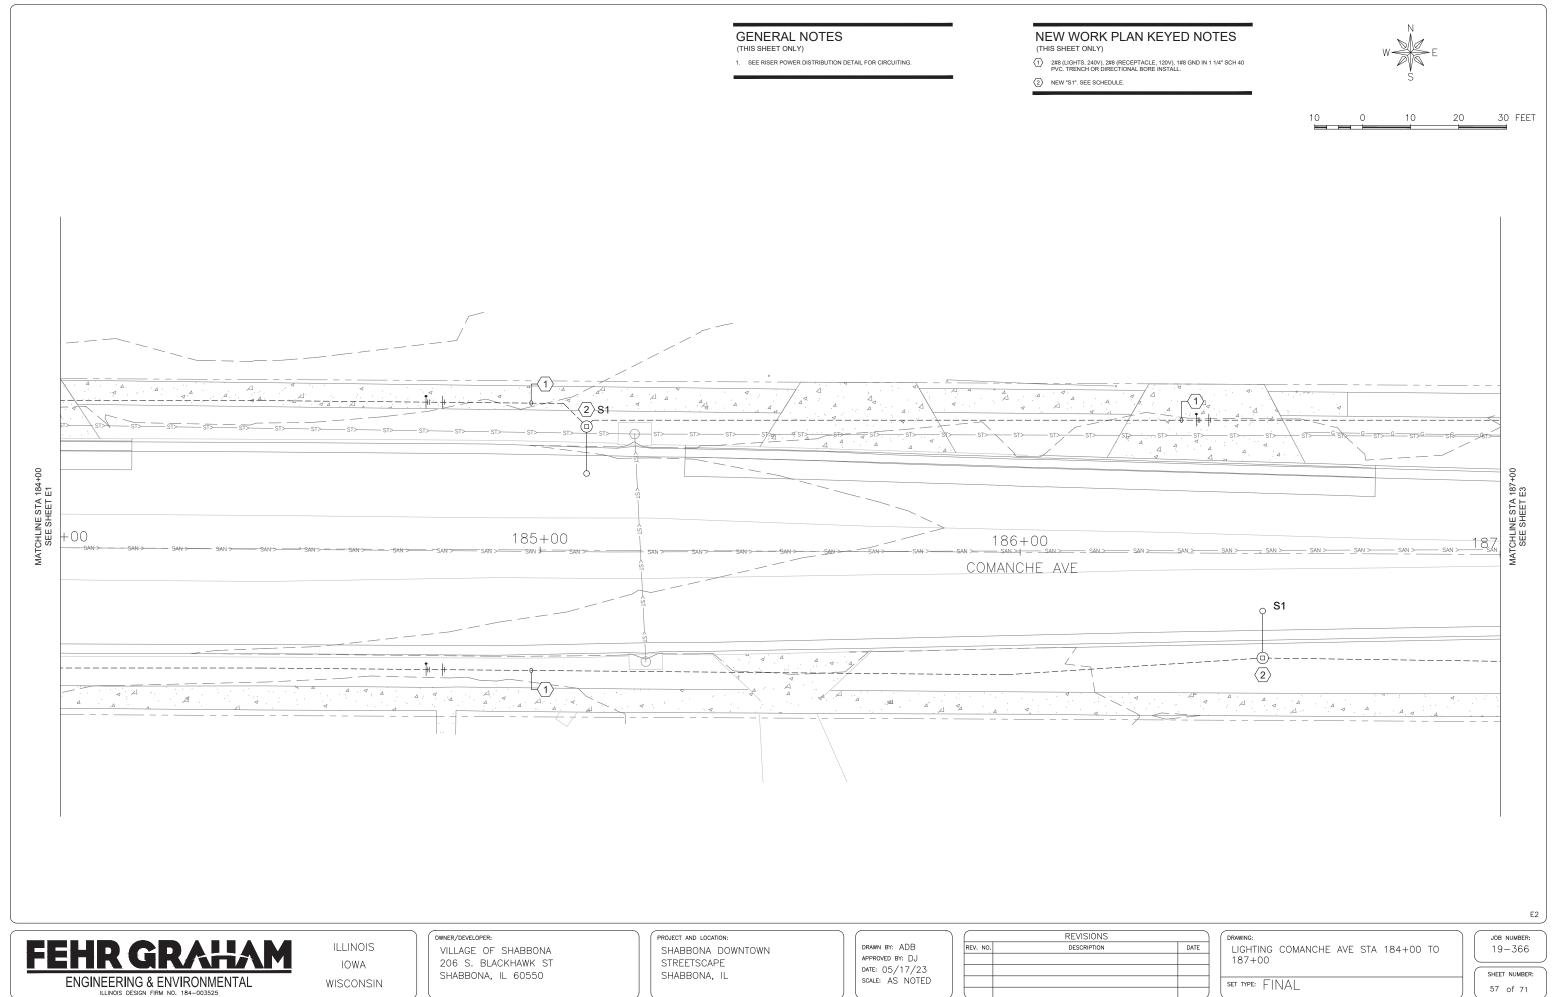

GENERAL NOTES

(THIS SHEET ONLY)

1. SEE RISER POWER DISTRIBUTION DETAIL FOR CIRCUITING.

DEMOLITION PLAN KEYED NOTES

REMOVE POLE, CONCRETE BASE AND CONDUCTORS/CONDUITS AT THIS LOCATION.

(2) REMOVE EXISTING POLE AND FIXTURE ASSEMBLY FROM THIS LOCATION. CONCRETE BASE AND CONDUCTORS SHALL REMAIN FOR REUSE.

NEW WORK PLAN KEYED NOTES (THIS SHEET ONLY)

(1) 2#8 (LIGHTS, 240V), 2#8 (RECEPTACLE, 120V), 1#8 GND IN 1 1/4* SCH 40 PVC. TRENCH OR DIRECTIONAL BORE INSTALL.

2 NEW HANDHOLE FLUSH IN SIDEWALK. 18'x12x12 MINIMUM.

(3) NEW 'S2 ON EXISTING CONCRETE POLE BASE. RECONNECT EXISTING CONDUCTORS FOR CONTINUED SERVICE TO LED LUMINAIRE AND RECEPTACLE. SEE SCHEDULE.

(4) 4#8 (LIGHTS), 4#8 (RECEPTACLES), 2#10 (CLOCK), 1#10 GND IN 1 1/4" SCHEDULE 40 PVC.


 PROVIDE UPGRADE OF EXISTING POWER DISTRIBUTION IN EXISTING PEDESTAL. (SEE DETAIL).

6 NEW "S1". SEE SCHEDULE.

7 2#8 (IRRIGATION), 1#10 GROUND IN 1 1/4" SCHEDULE 40 PVC. (TRENCH OR DIRECTIONAL BORE).



0 10 20 30 FEET

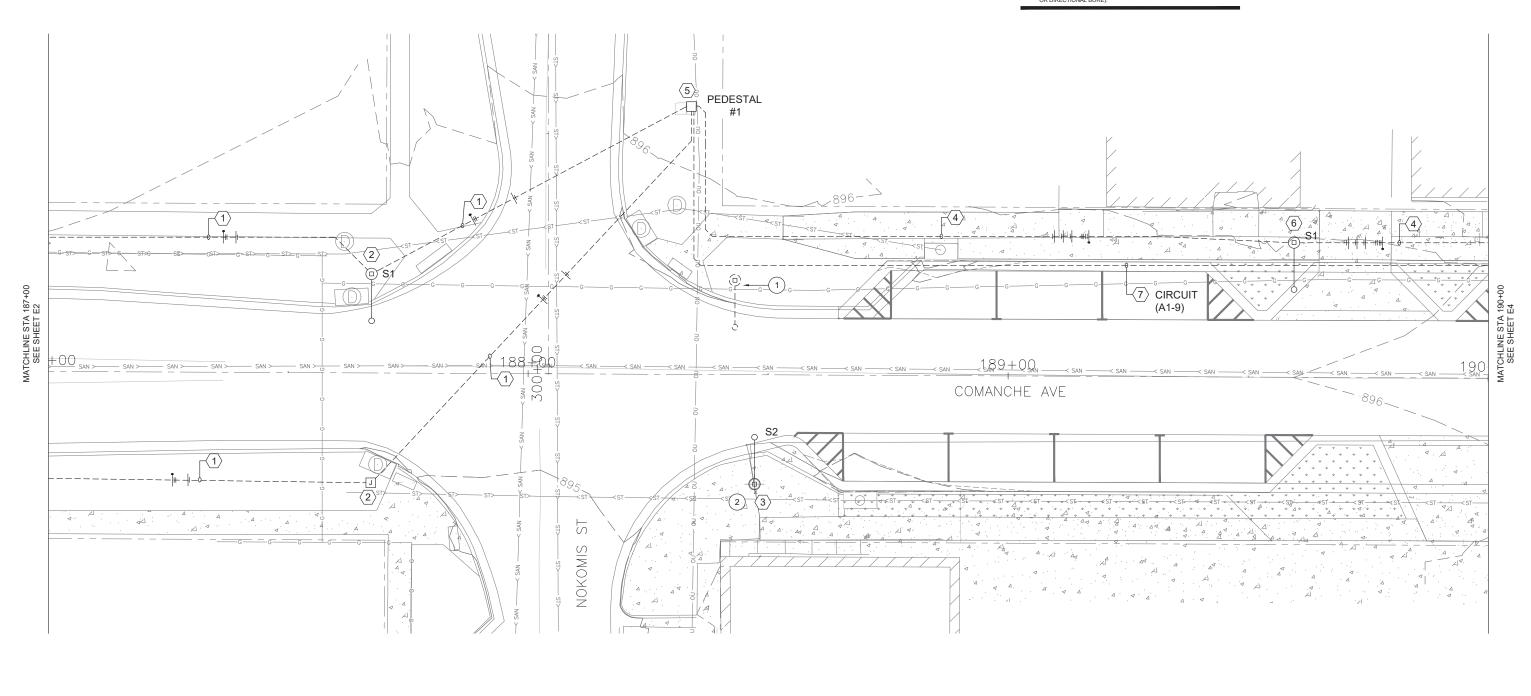



ILLINOIS IOWA WISCONSIN OWNER/DEVELOPER:

VILLAGE OF SHABBONA
206 S. BLACKHAWK ST
SHABBONA, IL 60550

PROJECT AND LOCATION:

SHABBONA DOWNTOWN

STREETSCAPE

SHABBONA, IL


DRAWN BY: ADB
APPROVED BY: DJ
DATE: 05/17/23
SCALE: AS NOTED

	REVISIONS		DRAWING:
REV. NO.	DESCRIPTION	DATE	LIGHTING COMA
			190+00
			SET TYPE: FINAL

DRAWING:
LIGHTING COMANCHE AVE STA 187+00 TO 190+00

JOB NUMBER: 19-366

SHEET NUMBER: 58 of 71

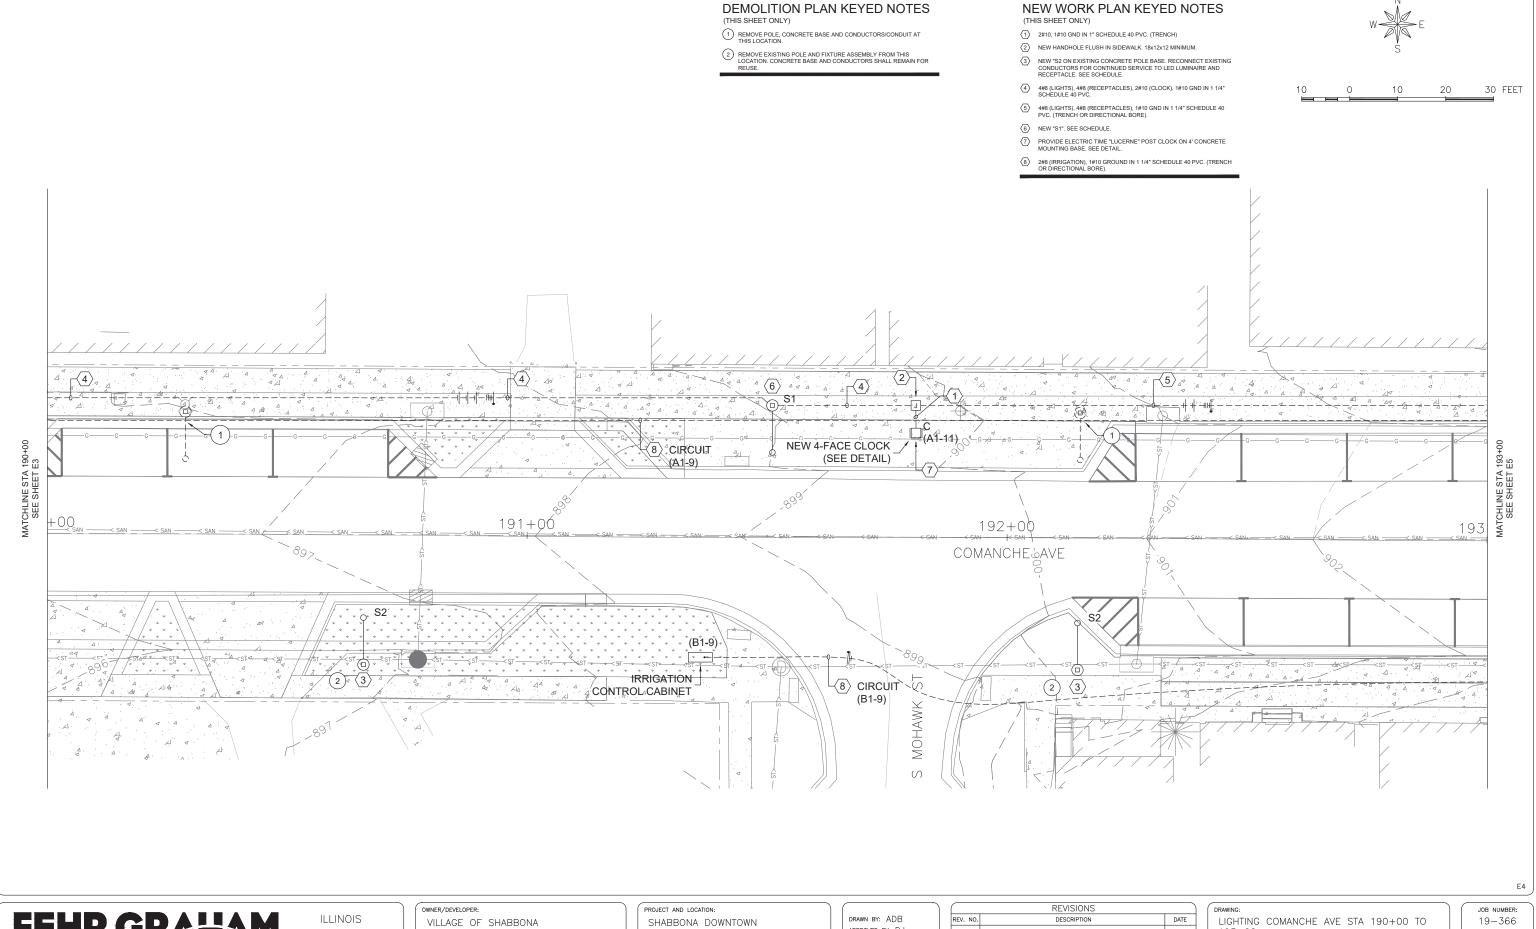

PLOT DATE: 6/16/23 © 2023 FEHR GRAHAM

ENGINEERING & ENVIRONMENTAL

IOWA

WISCONSIN

206 S. BLACKHAWK ST SHABBONA, IL 60550

STREETSCAPE SHABBONA, IL


APPROVED BY: DJ DATE: 05/17/23 SCALE: AS NOTED

	REVISIONS	
REV. NO.	DESCRIPTION	DATE

LIGHTING COMANCHE AVE STA 190+00 TO 193+00

SET TYPE: FINAL

SHEET NUMBER:

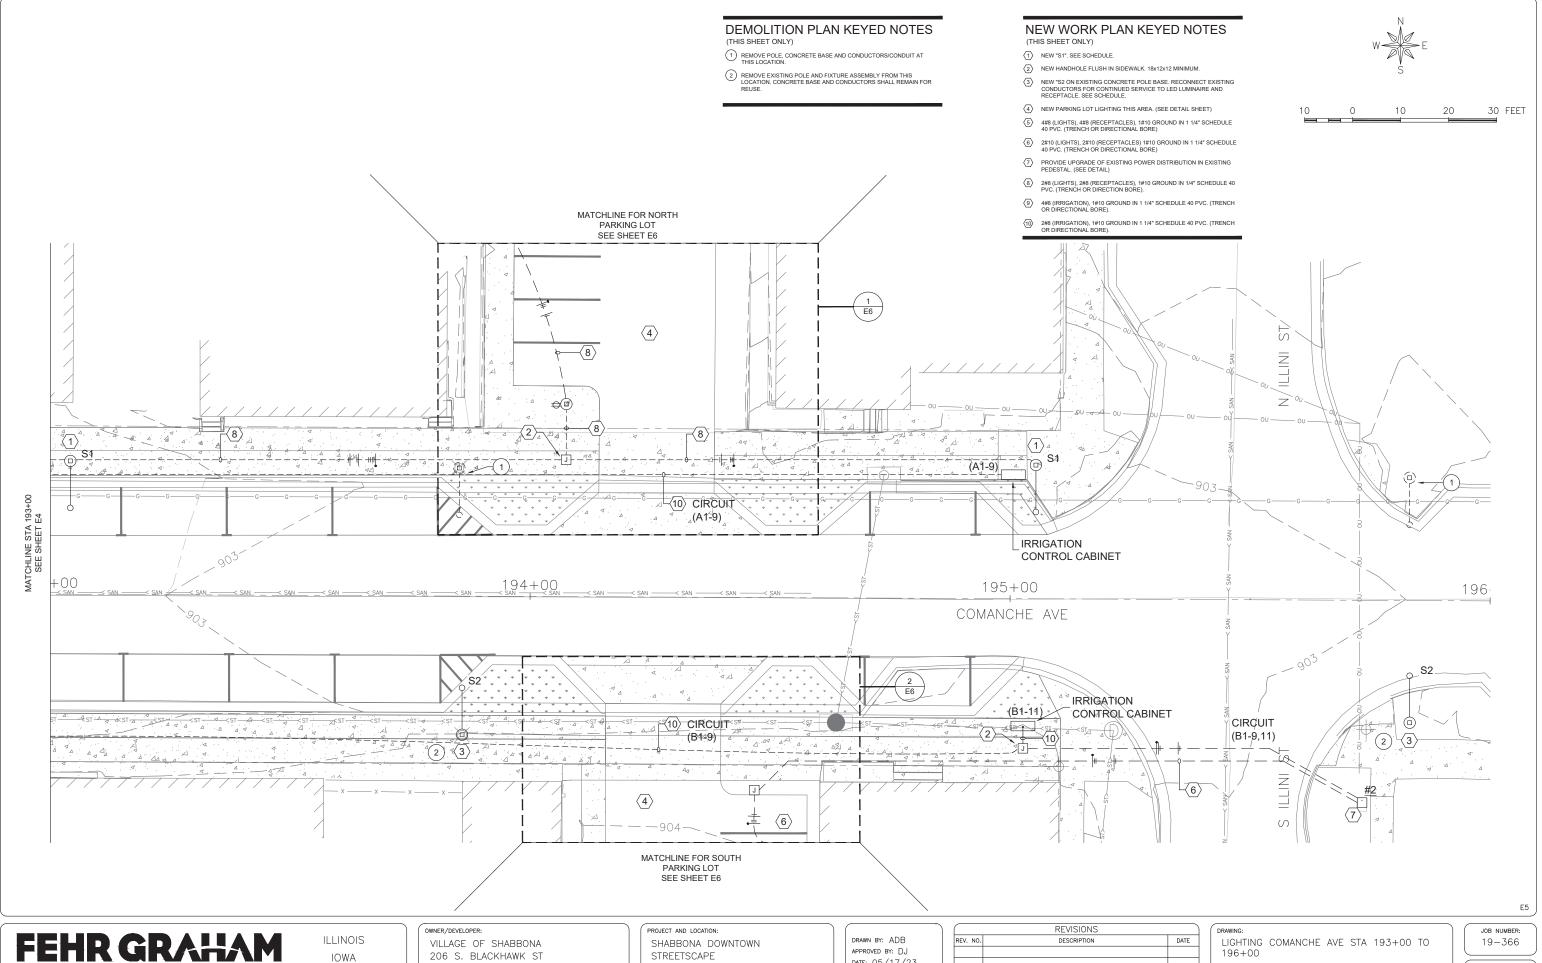

IOWA WISCONSIN 206 S. BLACKHAWK ST SHABBONA, IL 60550

STREETSCAPE SHABBONA, IL

DATE: 05/17/23 SCALE: AS NOTED

)	١		REVISIONS	
		REV. NO.	DESCRIPTION	DATE
į)			


LIGHTING COMANCHE AVE STA 193+00 TO 196+00


SET TYPE: FINAL

SHEET NUMBER: 60 of 71

NEW WORK PLAN KEYED NOTES (THIS SHEET ONLY)

- 2#10 (LIGHTS), 2#10 (RECEPTACLES) 1#10 GROUND IN 1 1/4" SCHEDULE 40 PVC. (TRENCH OR DIRECTIONAL BORE).
- 2 18"x12"x12" IN-GRADE JUNCTION BOX. INSTALL FLUSH WITH.
- (3) 2#8 (LIGHTS), 2#8 (RECEPTACLES) 1#10 GROUND IN 1 1/4" SCHEDULE 40 PVC. (TRENCH OR DIRECTIONAL BORE).

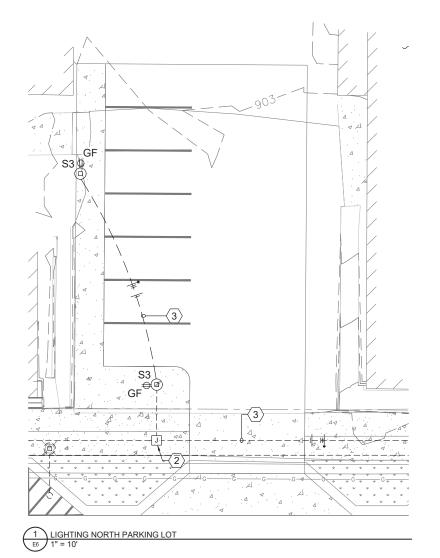

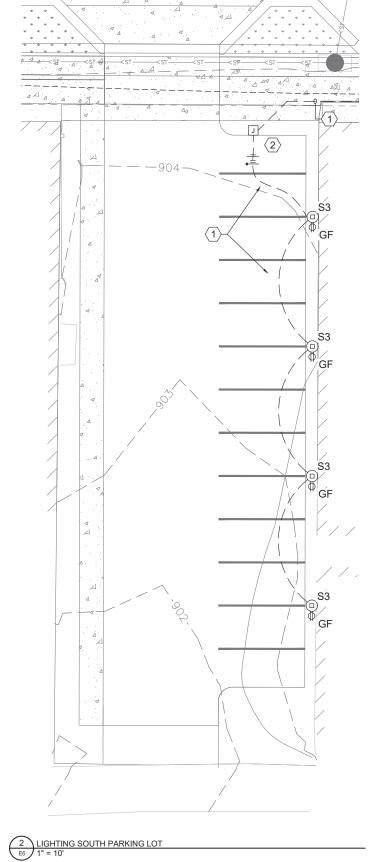



FEHR GRAHAM

ILLINOIS IOWA WISCONSIN OWNER/DEVELOPER:

VILLAGE OF SHABBONA 206 S. BLACKHAWK ST SHABBONA, IL 60550 PROJECT AND LOCATION:
SHABBONA DOWNTOWN
STREETSCAPE
SHABBONA, IL

DRAWN BY: ADB
APPROVED BY: DJ
DATE: 05/17/23
SCALE: AS NOTED


	REVISIONS	
REV. NO.	DESCRIPTION	DATE

DRAWING:
LIGHTING PARKING LOTS COMANCHE AVE
194+00


194+00
SET TYPE: FINAL

JOB NUMBER: 19-366


SHEET NUMBER: 61 of 71

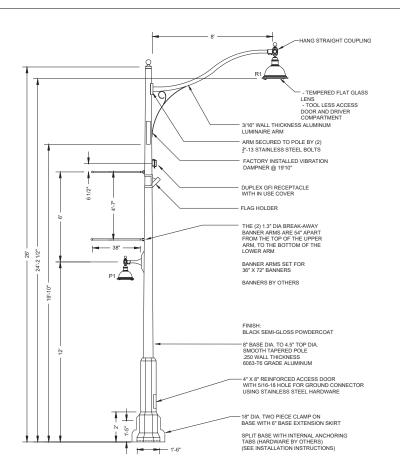


1 S1 LIGHT POLE DETAIL-NEW UNIT-NEW CONCRETE BASE NTS

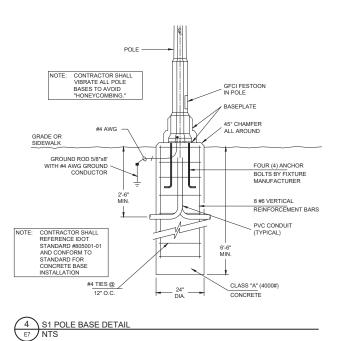

2 S2 LIGHT POLE DETAIL-NEW UNIT-REUSE CONCRETE BASE BT NTS

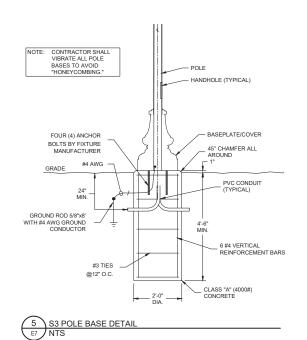

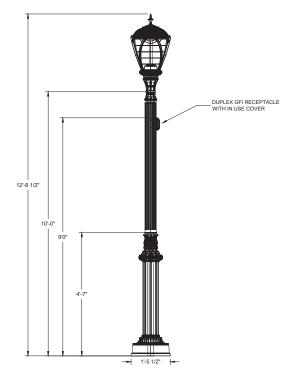

3 S3 LIGHT POLE DETAIL E7 NTS

FEHR GRAHAM

ENGINEERING & ENVIRONMENTAL

ILLINOIS IOWA WISCONSIN OWNER/DEVELOPER:

VILLAGE OF

VILLAGE OF SHABBONA 206 S. BLACKHAWK ST SHABBONA, IL 60550 PROJECT AND LOCATION:

SHABBONA DOWNTOWN

STREETSCAPE

SHABBONA, IL

DRAWN BY: ADB
APPROVED BY: DJ
DATE: 05/17/23
SCALE: AS NOTED

REVISIONS				
REV. NO.	DESCRIPTION	DATE		

DRAWING:
ELECTRICAL DETAILS


SET TYPE: FINAL


JOB NUMBER: 19-366

SHEET NUMBER: 62 of 71

PLOT DATE: 6/16/23 © 2023 FEHR GRAHAM

CONTRACT NO. 87841 SECTION NO. 23-00019-01-LS

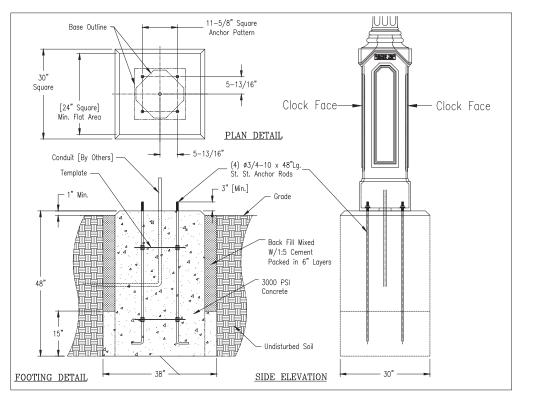

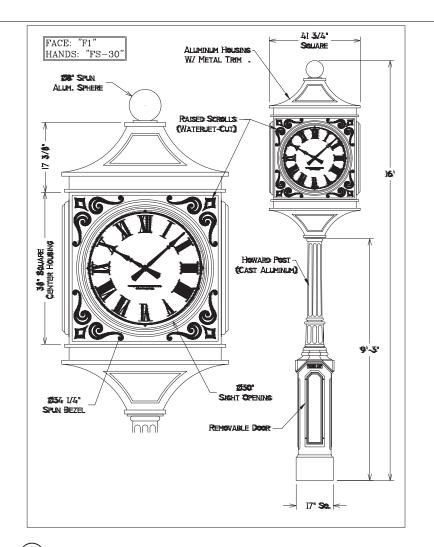

NOTE: POST CLOCK (4-SIDED) UNIT:

IMPRINT "SHABBONA" ABOVE FACE (EACH SIDE). IMPRINT "1872" BELOW FACE (EACH SIDE).

ACCEPTABLE MANUFACTURERS :

- A. ELECTRIC TIME COMPANY
 PH: 1-508-359-4396
 WWW.ELECTRICTIME.COM
- B. THE VERDIN COMPANY
 PH: 1-800-543-0488
 WWW.VERDIN.COM
- C. NATIONAL TIME AND SIGNAL CORP. PH: 1-801-290-8308 WWW.NATSCO.NET

1 LARGE POST CLOCK FOUNDATION DETAILS
E8 NTS

2 ELEVATION DETAILS 4 DIAL POST CLOCK NTS

Label	Catalog Number	Description	Lamp	Voltage	Mount	Watts	Accessories	Notes
S1	STERNBERG: VIA-153/1162/IRLED-HS-HB. FG-68RC4573R-F-MDL03/CASW 2426ART-6" EXTREC4/BDBA/ GF-HUCA/D/BK	OMEGA SERIES, LED DECORATIVE ARM MOUNTED FULL CUTOFF AREA LIGHT ON ROUND TAPPERED ALUMINUM BLACK 26 FT. POLE, GFC10 AT 18 FT., FLAG HOLDER, DUAL BANNER ARMS, TYPE 3 DISTRIBUTION, BLACK.	LED 13400 LUMEN UPPER 6700 LUMEN LOWER	240	POLE TOP 26 FT., 8 FT. ARM	148	-	
S2	STERNBERG: #1A-1531/152/RLED-HS-HB- FG-6ARC4573R-F-MDL03/CAS8/ 2425ART-6" EXT/BCC4/BDBA/ GF-IUC/VD/BK	OMEGA SERIES, LED DECOPATIVE ARM MOUNTED FULL CUTOFF AREA LIGHT ON ROUND TAPPERED ALUMINUM. BLACK 26 FT. POLE. GPC1 AT 18 FT, FLAG HOLDER DUAL BANNER ARMS, TYPE 3 DISTRIBUTION, BLACK.	LED 13400 LUMEN UPPER 6700 LUMEN LOWER	240	POLE TOP 26 FT., 8 FT. ARM	148	•	S2 REUSE EXISTING POLE BASE.
S3	STERNBERG: #PT-1190ALED-SP-16L30T3-MDL014- AVS910FPS-188/GFI-LPIUC/BKT	LED POST TOP 'ACORN TYPE' LIGHTING FIXTURE. 4000K COLOR TEMPERATURE, BLACK, POLYCARBONATE LENS, TYPE 3 DISTRIBUTION. 10' DECORATIVE ALUMINUM POLE, GFCI FESTOON	LED 5200 LUMEN	240	POLE TOP 10 FT.	61	-	

Label	Catalog Number	Description	Lamp	Voltage	Mount	Watts	Accessories	Notes
\$1/\$2	KING (STRESS CRETE GROUP): # K828K729-P4-III-100-SSL-8000-240-4K-8K-8K-9K-9K-9K-9K-9K-9K-9K-9K-9K-9K-9K-9K-9K	LED DECORATIVE ARM MOUNTED FULL CUTTOFF AREA LIGHT ON ROUND TAPPERED ALUMINUM BLACK 26 FF. POLE GEOLOATS BLACK 26 FF. DUAL BANNER ARMS, TYPE 3 DISTRIBUTION, BLACK.	LED 13400 LUMEN UPPER 6700 LUMEN LOWER	240	POLE TOP 26 FT., 8 FT. ARM	148	-	S2 REUSE EXISTING POLE BASE.
	LUMEC (SIGNIFY): # DMS50-90W80LED4K-G3- LESF-VOLT-DMS-SMA-BKTK WITH/ YR8-1-RF-BKTX, ATR85V-26.0-BA-GFII-BKTX + DECORATIVE BASE COVER							
	SPRING CITY ELECTRICAL: # ALMBCC-LE080EVXX2-40- CRS-GSIG-LACLEFAH-CU WITH #FARRENC-15-96- BASE: WBHNC-20-CU BASE: WBHNC-20-CU RASE: 40-GFWI-GFCL-2FP-4BP- WH-CU ARM: SBNUBT-1S-1.00-25.00- FOZ-CU							

Label	Catalog Number	Description	Lamp	Voltage	Mount	Watts	Accessories	Notes
S3	KING (STRESS CRETE GROUP) # K136R-P4-PR-III-60-SSL-1030- 249-K164-K8-SSL-105- WITH FE-A-10-5.25-CW- 140-3030-GFI-BK (KSBS2 BASE)	LED POST TOP "ACORN TYPE" LIGHTING FIXTURE, 4000K COLOR TEMPERATURE, BLACK, POLYCARBONATE LENS, TYPE 3 DISTRIBUTION, 10' DECORATIVE ALUMINUM POLE, GFCI FESTOON	LED 5200 LUMEN	240	POLE TOP 10 FT.,	61	-	
	SENTRY LIGHTING: # SCP-NB(LED)+LEV29B- 1.05A-840-KH73-BK WITH/ SAL-B-4B-10-BK-GFI							
	LUMEC (SIGNIFY): # MPTR-59W32LED4K-G3-LE3- VOLT-DMG-BKTK WITH/ AM6F-10-GFII-BKTK							
	SPRING CITY ELECTRICAL: # AMMCL-LE60-EVX-40-CR3- YKSF- FCP-CU WITH/ IPSM/DS-18-10.25- TN2.88-2.50-CU							

FEHR GRAHAM

ENGINEERING & ENVIRONMENTAL

ILLINOIS IOWA WISCONSIN OWNER/DEVELOPER:

VILLAGE OF SHABBONA
206 S. BLACKHAWK ST
SHABBONA, IL 60550

PROJECT AND LOCATION:
SHABBONA DOWNTOWN
STREETSCAPE
SHABBONA, IL

DRAWN BY: ADB
APPROVED BY: DJ
DATE: 05/17/23
SCALE: AS NOTED


	REVISIONS	
REV. NO.	DESCRIPTION	DATE


DRAWING:
ELECTRICAL SCHEDULES AND DETAILS


SET TYPE: FINAL


JOB NUMBER: 19-366


SHEET NUMBER: 63 of 71

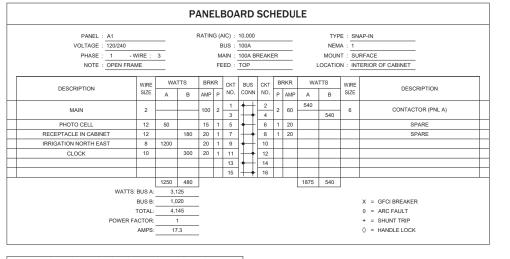


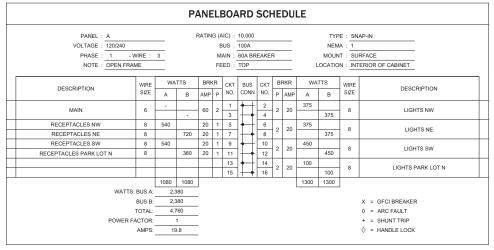

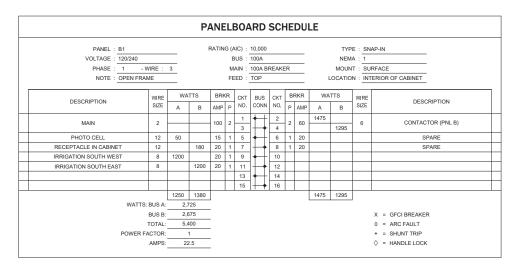

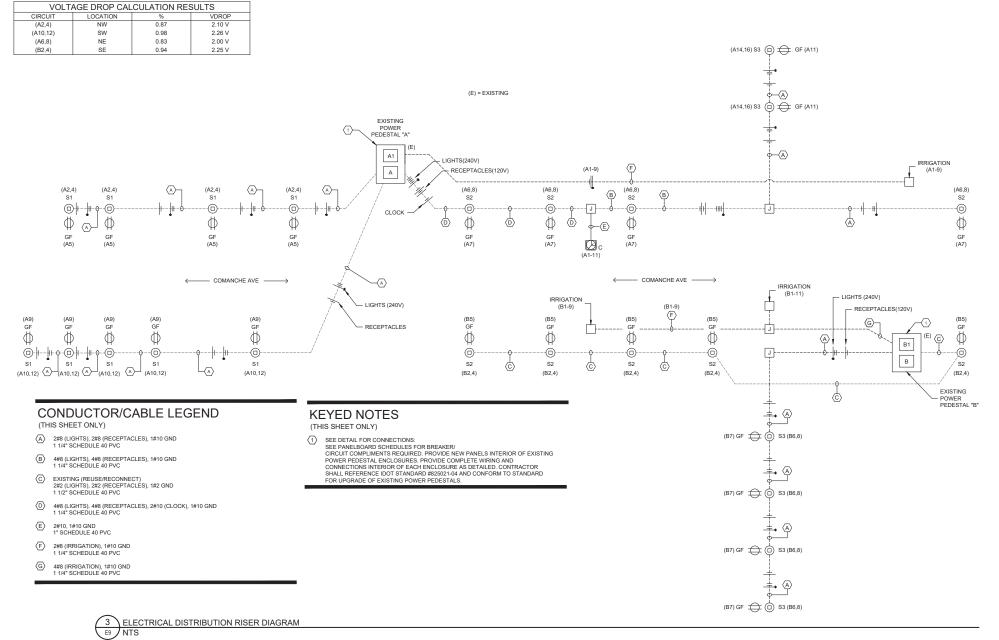

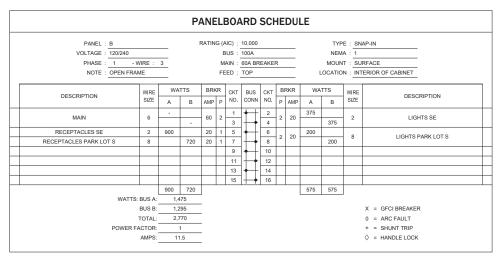

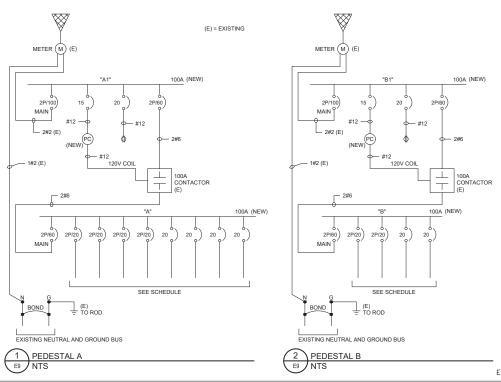



ILLINOIS DESIGN FIRM NO. 184-003525

ILLINOIS IOWA

WISCONSIN

OWNER/DEVELOPER:

VILLAGE OF SHABBONA
206 S. BLACKHAWK ST
SHABBONA, IL 60550


PROJECT AND LOCATION:

SHABBONA DOWNTOWN

STREETSCAPE

SHABBONA, IL


DRAWN BY: ADB
APPROVED BY: DJ
DATE: 05/17/23
SCALE: AS NOTED

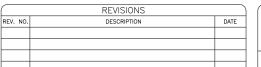

DRAWING:
ELECTRICAL DETAILS

JOB NUMBER:
19-366

SHEET NUMBER:
64 of 71

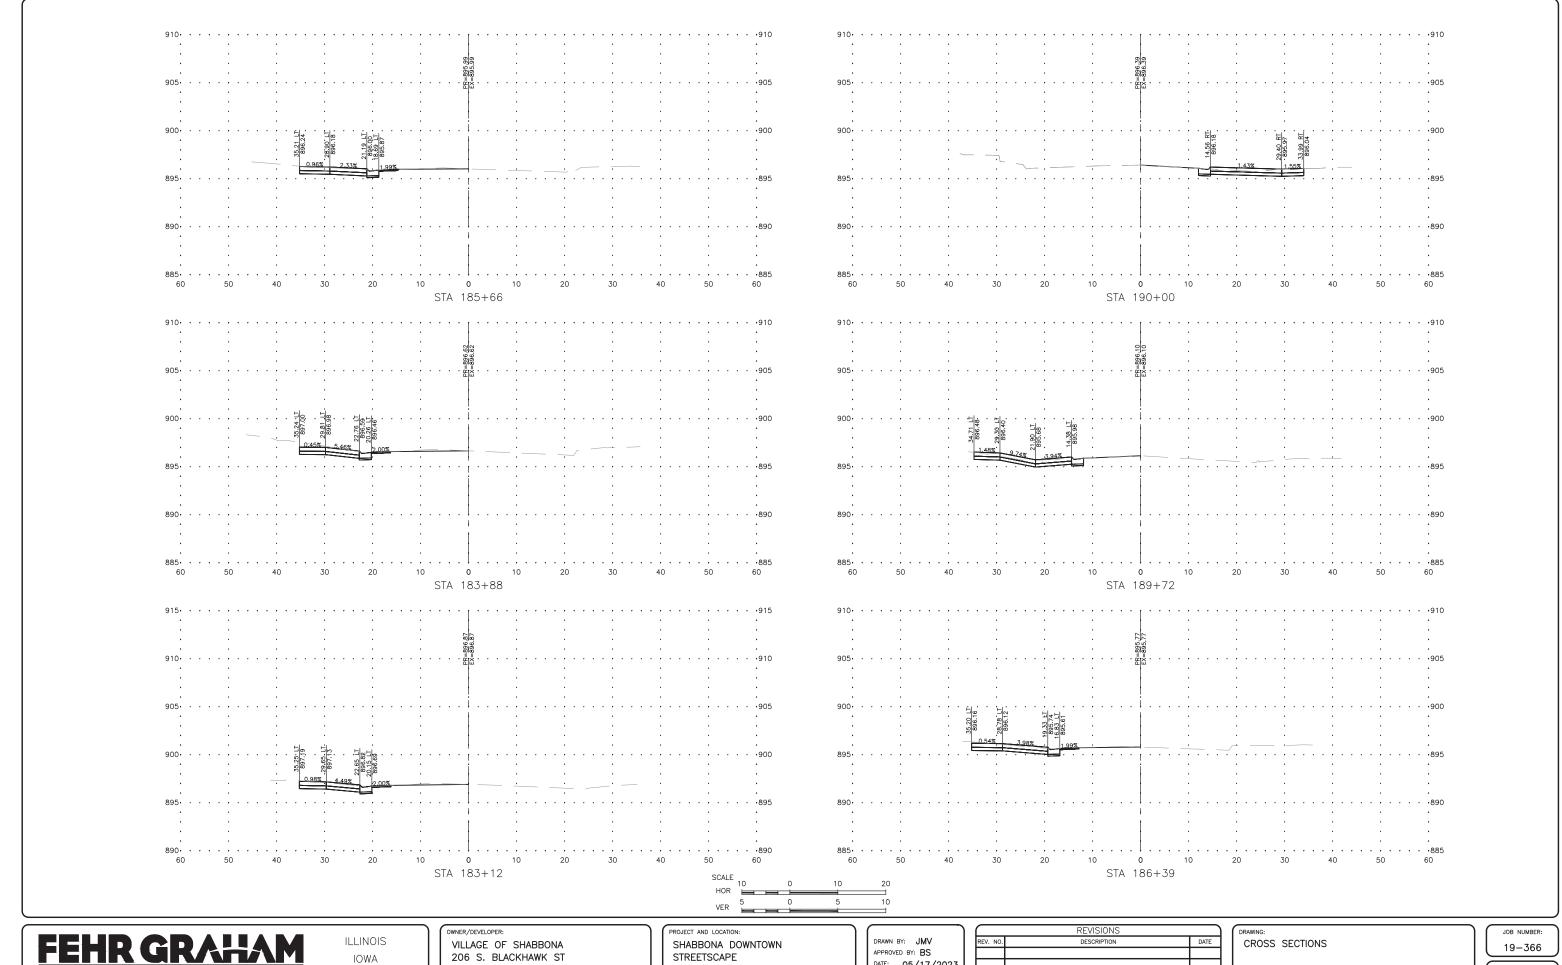

WISCONSIN

SHABBONA, IL 60550

SHABBONA, IL


APPROVED BY: BS
DATE: 05/17/2023
SCALE: AS NOTED

	REVISIONS	
REV. NO.	DESCRIPTION	DATE

SET TYPE: FINAL 6:\C30\19\19-366\19-366 Corrido


65 of 71

PLOT DATE: 6/19/23 © 2023 FEHR GRAHAM CONTRACT NO. 87841 SECTION NO. 23-00019-01-LS

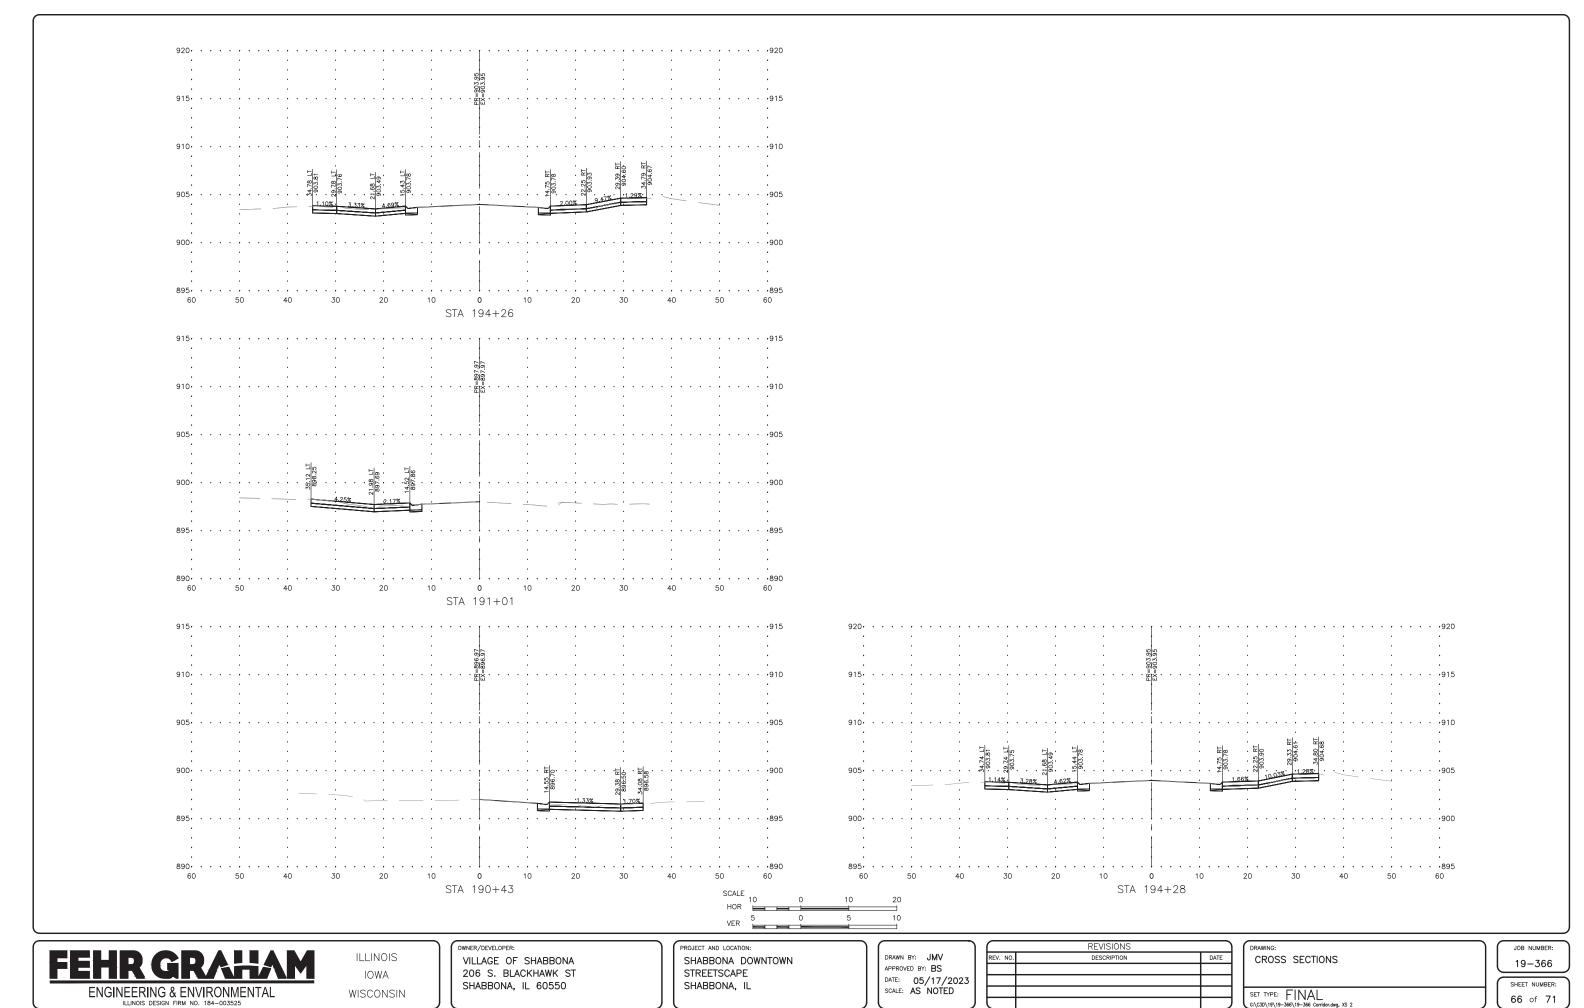


PLOT DATE: 6/19/23 © 2023 FEHR GRAHAM

CONTRACT NO. 87841

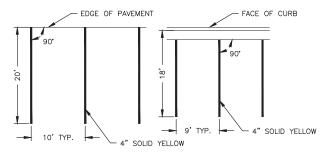

90 DEGREE STANDARD STALLS

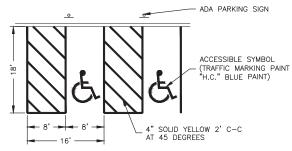


90 DEGREE ADA ACCESSIBLE STALLS

NOTE: THE ADA PARKING SIGN AND PAINTED SYMBOL SHALL BE IN CONFORMANCE WITH THE STATE OF ILLINOIS ACCESSIBILITY CODES.


PARKING SPACES AND ACCESS AISLES SHALL HAVE SURFACE SLOPES NOT EXCEEDING 1:50 (2%) IN ALL DIRECTIONS.

90 DEGREE PARKING STRIPE DETAILS

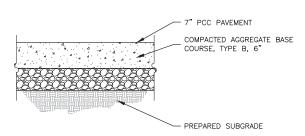

NOTE: SUBBASE SHALL BE PROOF ROLLED PRIOR TO PAVING. SHOULD SOFT SOILS BE ENCOUNTERED, ADDITIONAL 6" TO 12" BASE REPAIR MAY BE REQUIRED. ALL ADDITIONAL BASE REPAIR SHALL BE APPROVED BY ENGINEER PRIOR TO ANY AND ALL EXCAVATION. ADDITIONAL BASE REPAIR WILL BE PAID BY CUBIC YARDS FOR REMOVAL OF UNSUITABLE SOILS AND REPLACEMENT OR COMPACTED ACCORPORATE MARCH AS DATE OF MARCH BY AND ASSET OF THE MEDICAL PROMISED. AGGREGATE BASE AS PART OF BASE BID ALLOWANCE.

7" CONCRETE DRIVEWAY PAVEMENT SECTION

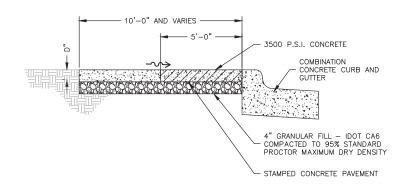

SIDEWALK ABUTTING CURB

NOTE: WALK CONSTRUCTED OF 3500 PSI CONCRETE WITH 5 - 8% AIR ENTERTAINMENT, 3/4" MAX. AGGREGATE SIZE TO A MINIMUM THICKNESS OF 4" WITH 6 x 6 - 10/10 W.W.M. CONTINUOUS. WALK TO BE FINISHED WITH A FLOAT, STEEL TROWEL AND BARN BROOM FINISH WITH 4" TOOLED JOINTS AND EDGES. FORMED JOINTS TO BE FINISHED WITH A TOOL HAVING A 1/4" RADIUS.

INSTALL 1/2" WIDE EXPANSION JOINTS WITH BITUMINOUS JOINT FILLER AT 30'-0" O.C. (EXTEND FULL DEPTH OF WALK).


SCORE TOOLED JOINTS (1/2 D DEEP) AT 5'-0" O.C. UNLESS OTHERWISE NOTED.

INSTALL 1/2" WIDE BITUMINOUS ISOLATION JOINT WHERE SIDEWALK ABUTS A CURB, CONCRETE DRIVEWAY, STRUCTURE OR AT AN ADJACENT CURB JOINT (EXTEND FULL DEPTH OF WALK).

DEPTH D = 5" MIN. EXCEPT AT CURB RAMPS WHERE D = 6" MIN. OR AT DRIVEWAYS WHERE D = 7" MIN.

SIDEWALK RAMPS AT DRIVES TO BE CONSTRUCTED ACCORDING TO IDOT STANDARD No. 424001.

SIDEWALK DETAIL

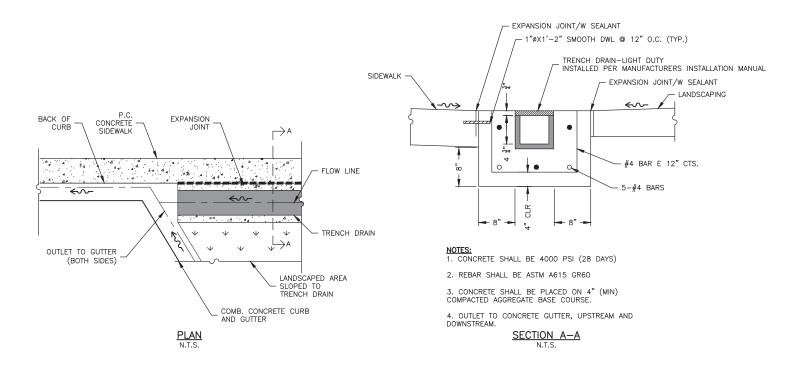

TRENCH DRAIN DETAIL N.T.S.



ENGINEERING & ENVIRONMENTAL WISCONSIN ILLINOIS DESIGN FIRM NO. 184-003525

ILLINOIS IOWA

OWNER/DEVELOPER VILLAGE OF SHABBONA 206 S. BLACKHAWK ST SHABBONA, IL 60550

PROJECT AND LOCATION SHABBONA DOWNTOWN STREETSCAPE SHABBONA, IL

DRAWN BY: JMV APPROVED BY: BS DATE: 05/17/2023 SCALE: AS NOTED

REVISIONS DESCRIPTION

STANDARD DETAILS SET TYPE: FINAL


SECTION NO. 23-00019-01-LS

JOB NUMBER

19-366

SHEET NUMBER:

67 of 71

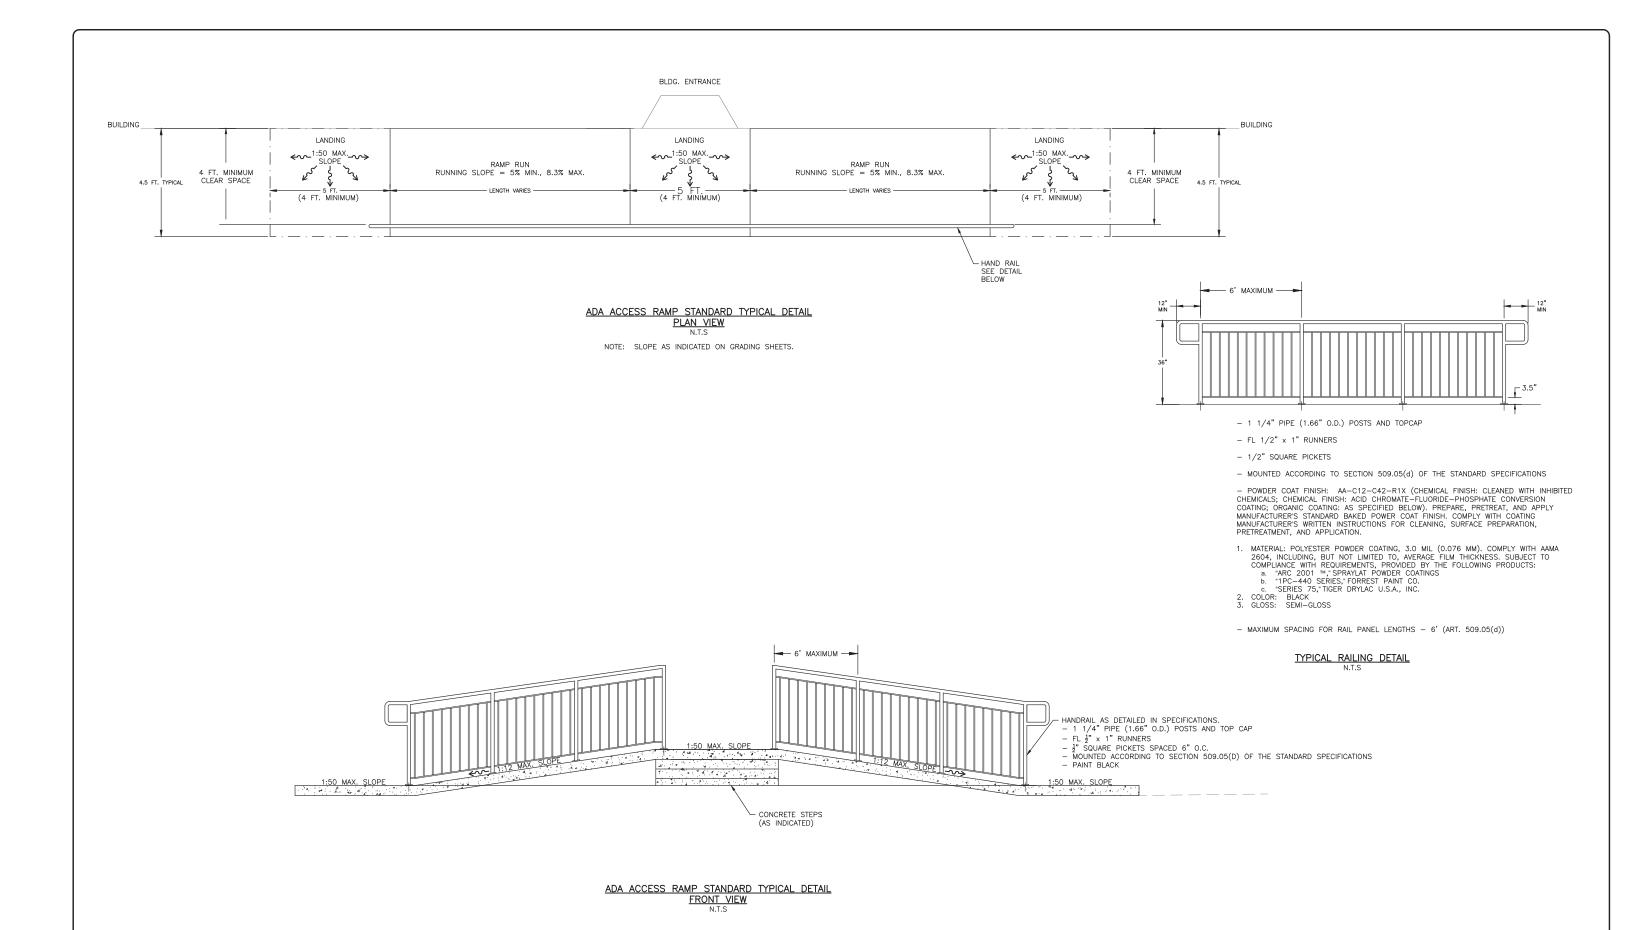

ILLINOIS IOWA WISCONSIN OWNER/DEVELOPER:
VILLAGE OF SHABBONA
206 S. BLACKHAWK ST
SHABBONA, IL 60550

PROJECT AND LOCATION:
SHABBONA DOWNTOWN
STREETSCAPE
SHABBONA, IL

CONTRACT NO. 87841

DRAWN BY: JMV
APPROVED BY: BS
DATE: 05/17/2023
SCALE: AS NOTED

$\overline{}$	REVISIONS	
REV. NO.	DESCRIPTION	DATE
\Box		

DRAWING:
STANDARD DETAILS

SET TYPE: FINAL

JOB NUMBER:

19-366


SHEET NUMBER:

68 of 71

ENGINEERING & ENVIRONMENTAL

ILLINOIS DESIGN FIRM NO. 184-003525


PLOT DATE: 6/19/23 © 2023 FEHR GRAHAM

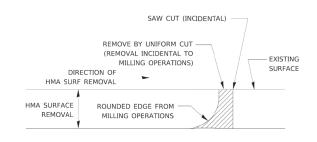

WHEN MILLING OPERATIONS PRODUCE A ROUNDED EDGE, THEN A SAW CUT SHALL BE USED TO MANUFACTURE A PERPENDICULAR EDGE AS SHOWN IN THE DETAIL. THE ENGINEER SHALL BE THE SOLE JUDGE CONCERNING THE USE OF THIS DETAIL

HMA DETAIL AT BUTT JOINTS

406-8

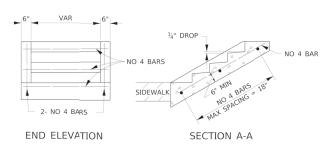

NO 4 BAR PLAN

TABLE OF TREADS & RISERS


SLOPE	TREAD	RISER
1:2	12"	6"
1:3	15"	5"
1:4	17"	41/4"

WHERE SLOPES FALL BETWEEN THOSE SHOWN IN THE TABLE ABOVE, THE STAIR RAIL SHOULD FIT THE SLOPE AND THE TREAD IN INCHES x THE RISER IN INCHES SHOULD BE BETWEEN 72 AND 78.

FOR A 1:4 SLOPE USE y = RISER HEIGHT 4y = 275 ". SOLVING y²= 75", y= 4.3" (USE 4½" FOR CONVENIENCE.) TREAD WOULD THEN BE $4\frac{1}{4}$ " x 4 = 17"

COST OF REINFORCEMENT BARS SHALL BE PAID FOR AT THE CONTRACT UNIT PRICE PER LBS REINFORCEMENT BARS.

CLASS SI CONCRETE SHALL BE USED THROUGHTOUT, WHICH SHALL BE PAID FOR AT THE CONTRACT UNIT PRICE PER CUBIC YARD FOR CLASS SI CONCRETE STEPS.

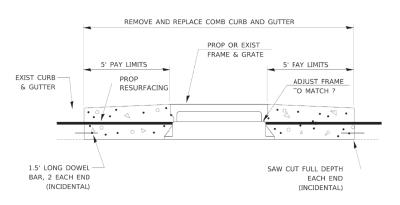


INLET ADJUST

602-2

DETAIL OF CONCRETE STEPS

424-32

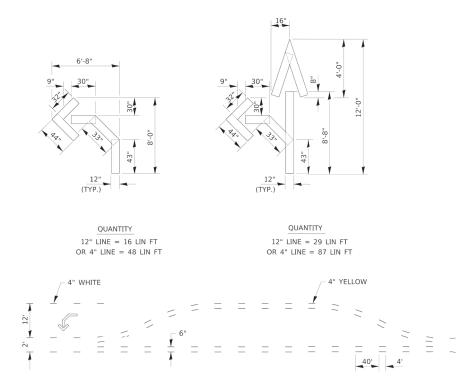

SHORT-TERM PAVEMENT MARKING FOR MEDIANS AND ARROWS

703-1

CONCRETE CURB AND GUTTER SHALL BE CONSTRUCTED IN ACCORDANCE WITH SECTION 606 OF THE STANDARD SPECIFICATIONS, SUPPLEMENTAL SPECIFICATIONS, STANDARD 606001 AND THIS DRAWING.

CLASS SI CONCRETE SHALL BE USED THROUGHOUT. A HOLE $1\frac{1}{2}$ " IN DIA AND 9" DEEP SHALL BE DRILLED IN THE EXISTING CONCRETE CURB AS SHOWN. A $1\frac{1}{4}$ " x 18" SMOOTH DOWEL BAR SHALL BE GROUTED IN THE HOLE LONGITUDINALLY.

JOINTS OF A TYPE SIMILAR TO THAT IN THE UNDERLYING PAVEMENT (EXPANSION OR CONTRACTION) SHALL BE INSTALLED IN THE CONCRETE CURB IN ALIGNMENT WITH THE JOINTS IN THE PAVEMENT.

INLETS ARE NOT TO BE INCLUDED IN THE MEASUREMENT FOR CURB AND GUTTER REPLACEMENT.


THE PROPOSED CONFIGURATION OF THE CURB AND GUTTER SHALL MATCH THAT REMOVED.

THE CONCRETE REQUIRED BETWEEN THE EDGE OF PAVEMENT AND FRAME AND GRATE SHALL BE CONSIDERED INCIDENTAL TO THE CURB AND GUTTER

THE LOCATION OF THE DOWEL BAR SHALL BE DETERMINED BY THE ENGINEER.

THE COST OF ALL MATERIALS AND LABOR REQUIRED TO INSTALL THE JOINTS AND BARS IN THE CURBS SHALL BE INCLUDED IN THE CONTRACT UNIT PRICE PER FOOT FOR COMBINATION CURB AND GUTTER

ALL EXISTING TIE BARS IN EDGE OF PAVEMENT SLAB THRU REPLACEMENT AREA SHALL BE CUT OFF.

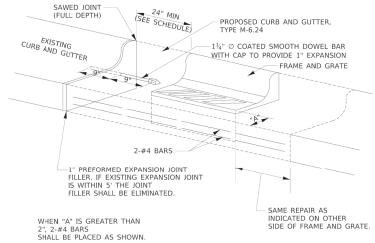

DETAILS FOR CURB & GUTTER

606-9

REPLACEMENT AT INLET

ENGINEERING & ENVIRONMENTAL

ILLINOIS IOWA WISCONSIN VILLAGE OF SHABBONA 206 S. BLACKHAWK ST SHABBONA, IL 60550


PROJECT AND LOCATION SHABBONA DOWNTOWN STREETSCAPE SHABBONA, IL

DRAWN BY: JMV APPROVED BY: BS DATE: 05/17/2023 SCALE: AS NOTED

REVISIONS

DISTRICT 3 STANDARD DETAILS SET TYPE: FINAL


JOB NUMBER 19-366 SHEET NUMBER: 69 of 71

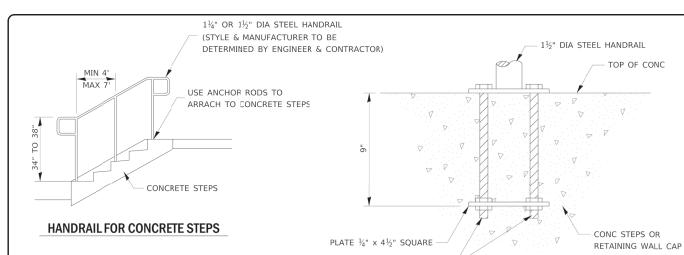

34" DIA GALV STEEL ANCHOR ROD THREADED AT BOTH ENDS WITH HEAVY HEX NUT WASHER & TWO HEX NUTS

ANCHOR ROD DETAIL

(INCLUDED IN THE COST OF HAND OR SAFETY RAIL)

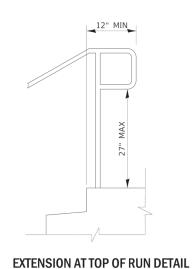

EXTENSION AT BOTTOM OF RUN DETAIL

NOTES:

STAIRWAYS SHALL HAVE CONTINUOUS HANDRAILS BOTH SIDES OF ALL STAIRS.

THE INSIDE HANDRAIL ON SWITCHBACK OR DOGLEG STAIRS SHALL ALWAY BE CONTINUOUS.

GRIPPING SURFACES SHALL BE UNINTERRUPTED BY NEWEL POSTS, OTHER CONSTRUCTION ELEMENTS, OR OBSTRUCTIONS.

ENDS OF HANDRAIL SHALL BE EITHER ROUNDED OR RETURNED SMOOTHLY TO FLOOR, WALL, OR POST.

HAND & SAFETY RAILS SHALL NOT ROTATE WITHIN THEIR FITTINGS.

THE CLEAR SPACES BETWEEN HANDRAILS AND ANY WALL SHALL BE 1½".

HANDRAIL SHALL CONFORM TO SECTION 509 WITH THE EXCEPTION THAT ALL PIPE AND CONNECTIONS SHALL BE WELDED GALVANIZED OR ALUMINUM ACCORDING TO ARTICLE 1006.27, 1006.30, OR 1006.34.

THE DIAMETER OF THE GRIPPING SURFACE OF THE HANDRAIL SHALL BE 11/4" TO 11/2".

THIS WORK SHALL BE PAID FOR AT THE CONTRACT UNIT PRICE PER FOOT FOR PIPE HANDRAIL.


1" x 11/4" SLOTTED HOLE FOR 3/4" DIA GALV STEEL ANCHOR ROD (SEE DETAIL) 1/4" GALV STEEL BASE PLATE POST 1½" DIA GALV EXTRA STRONG STEEL PIPE

POST CASE PLATE DETAIL


(INCLUDED IN THE COST OF HAND OR SAFETY RAIL)


PIPE HANDRAILS FOR STEPS

509-1

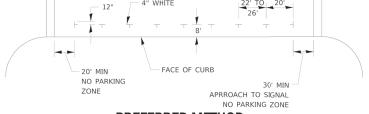

PREFERRED METHOD

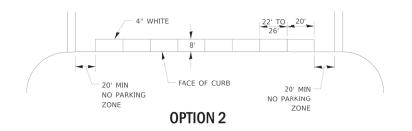

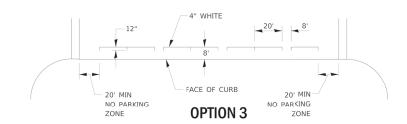

TYPICAL PARKING SPACING

780-22

ILLINOIS IOWA WISCONSIN

VILLAGE OF SHABBONA 206 S. BLACKHAWK ST SHABBONA, IL 60550

SHABBONA DOWNTOWN STREETSCAPE SHABBONA, IL


APPROVED BY: BS DATE: 05/17/2023 SCALE: AS NOTED

REVISIONS

DISTRICT 3 STANDARD DETAILS

JOB NUMBER 19-366 SHEET NUMBER: 70 of 71

ENGINEERING & ENVIRONMENTAL ILLINOIS DESIGN FIRM NO. 184-003525 PLOT DATE: 6/19/23 © 2023 FEHR GRAHAM SECTION NO. 23-00019-01-LS CONTRACT NO. 87841

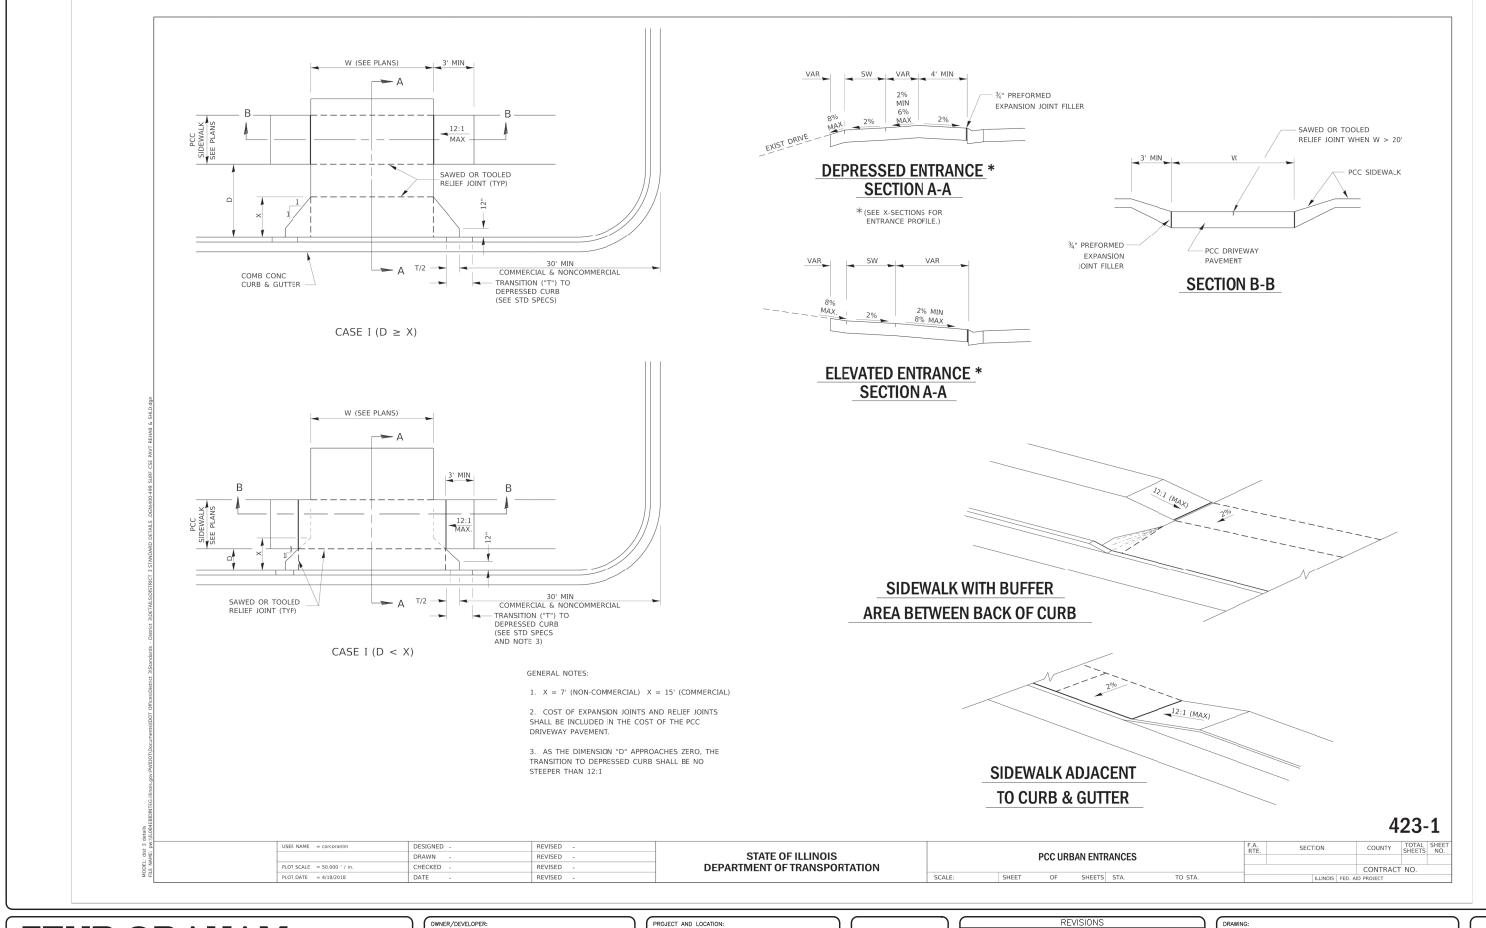

ILLINOIS IOWA WISCONSIN VILLAGE OF SHABBONA 206 S. BLACKHAWK ST SHABBONA, IL 60550 PROJECT AND LOCATION:

SHABBONA DOWNTOWN

STREETSCAPE

SHABBONA, IL

DRAWN BY: JMV
APPROVED BY: BS
DATE: 05/17/2023
SCALE: AS NOTED

	REVISIONS	
REV. NO.	DESCRIPTION	DATE

DRAWING:
DISTRICT 3 STANDARD DETAILS

SET TYPE: FINAL

JOB NUMBER:
19-366

SHEET NUMBER:
71 of 71