STATE OF ILLINOIS

DEPARTMENT OF TRANSPORTATION

FOR INDEX OF SHEETS, SEE SHEET NO. 2

TRAFFIC DATA
U.S. ROUTE 45:
2021 ADT = 18,100

0

0

0

DESIGN CLASSIFICATION:
OTHER PRINCIPAL ARTERIAL

SPEED LIMIT = 45 MPH

PROPOSED HIGHWAY PLANS

FAP 330: US ROUTE 45 (DES PLAINES RIVER RD)
AT MCDONALD CREEK (N OF ENCLAVE DR)
SECTION: FAP 0330 22 BJ3
PROJECT: NHPP-JG1Z(895)
BRIDGE DECK OVERLAY, BRIDGE JOINT

REPLACEMENT AND REPAIR
COOK COUNTY

U.S. ROUTE 45
S.N. 016–2418

C-91–282–22

EUCLID AVE

KENSINGTON RD

KENSINGTON RD

COOK
COUNTY
FOREST
PRESERVE

RAND RD

CENTRAL RD

CENTRAL RD

CENTRAL RD

COOK
COUNTY
FOREST
PRESERVE

RAND RD

CENTRAL RD

LOCATION MAP

GROSS LENGTH = 105.5 FT. = 0.02 MILE

NET LENGTH = 105.5 FT. = 0.02 MILE

OSZ-04884
REGISTERED
PROFESSIONAL
PROFESSIONAL
FINENCIA OF

Signed: POVID

Date: 04/18/2023

License Expires: 11/30/2023

D-91-229-22

FAP 0330 22 BJ3


COOK

UNOIS CONTRACT NO 62T05

23






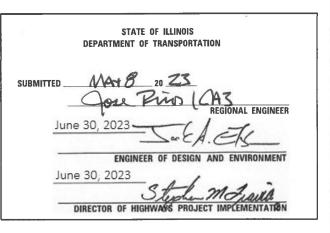

PRINTED BY THE AUTHORITY OF THE STATE OF ILLINOIS

THE PROJECT IS LOCATED IN UNINCORPORATED MOUNT PROSPECT

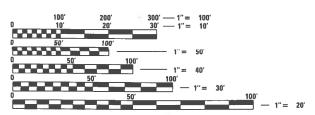

FULL SIZE PLANS HAVE BEEN PREPARED USING STANDARD ENGINEERING SCALES. REDUCED SIZED PLANS WILL NOT CONFORM TO STANDARD SCALES. IN MAKING MEASUREMENTS ON REDUCED PLANS, THE ABOVE SCALES MAY BE USED.

J.U.L.I.E.
JOINT UTILITY LOCATION INFORMATION FOR EXCAVATORS
1–800–892–0123
OR 811

PROJECT ENGINEER: LUKASZ POCIECHA (847) 705–4255
PROJECT MANAGER: FAWAD AQUEEL (847) 705–4211

CONTRACT NO. 62T05

INDEX OF SHEETS

- COVER SHEET
- INDEX, HIGHWAY STANDARDS, GENERAL NOTES
- 3-4 SUMMARY OF QUANTITIES
- ALIGNMENT, TIES, AND BENCHMARKS
- 6**-**9 STAGING PLANS
- 10 PAVEMENT MARKING & LANDSCAPING PLANS
- 11-17 STRUCTURAL PLANS
- 18-23 DISTRICT DETAILS

DISTRICT ONE DETAILS

- BD-33 HMA TAPER AT EDGE OF PCC PAVEMENT
- TC-10 TRAFFIC CONTROL & PROTECTION FOR SIDEROADS, INTERSECTIONS & DRIVEWAYS
- TC-11 RAISED REFLECTIVE PAVEMENT MARKERS (SNOW-PLOW RESISTANT)
- TC-13 DISTRICT ONE TYPICAL PAVEMENT MARKINGS
- TC-22 ARTERIAL ROAD INFORMATION SIGN
- TC-26 DRIVEWAY ENTRANCE SIGNING

HIGHWAY STANDARDS

000001-08	STANDARD	SYMBOLS.	ABBREVIATIONS	AND PATTERNS

001006 DECIMAL OF AN INCH AND OF A FOOT	
---	--

- 280001-07 TEMPORARY EROSION CONTROL SYSTEMS
- 701301-04 LANE CLOSURE, 2L, 2W, SHORT TIME OPERATIONS
- LANE CLOSURE, 2L, 2W MOVING OPERATIONS- DAY ONLY 701311-03
- 701426-09 LANE CLOSURE, MULTILANE, INTERMITTENT OR MOVING OPER., SPD >= 45 MPH
- LANE CLOSURE, MULTILANE, INTERMITTENT OR MOVING OPER., SPD <= 40 MPH
- URBAN HALF-RD CLOSURE, MULTILANE, 2W W/ MOUNTABLE MEDIAN
- SIDEWALK, CORNER OR CROSSWALK CLOSURE 701801-06
- TRAFFIC CONTROL DEVICES 701901-08
- 704001**-**08 TEMPORARY CONCRETE BARRIER
- 780001-05 TYPICAL PAVEMENT MARKINGS
- 781001-04 TYPICAL APPLICATIONS RAISED REFLECTIVE PAVEMENT MARKERS 782006-01 GUARDRAIL AND BARRIER WALL REFLECTOR MOUNTING DETAILS

HOT-MIX ASPHALT MIXTURE REQUIREMENTS CHART

MIXTURE TYPE	AIR VOIDS @ N DES	QMP			
HMA OVERLAY					
HMA SURFACE COURSE, IL-9.5, MIX "D" N70	4% @ 70 GYR.	QC/QA			
QMP DESIGNATION: QUALITY CONTROL/QUALITY ASSURANCE (QC/QA)					

- 1. THE UNIT WEIGHT USED TO CALCULATE ALL HOT-MIX ASPHALT SURFACE MIXTURE QUANTITIES IS 112 LB/SQ YD/IN.
- 2. THE AC TYPE FOR POLYMERIZED HMA MIXES SHALL BE SBS/SBR PG 76-22 AND FOR NON-POLYMERIZED HMA THE AC TYPE SHALL BE PG 64-22 UNLESS MODIFIED BY RECLAIMED MATERIALS SPECIFICATIONS.

GENERAL NOTES

- 1. BEFORE STARTING ANY EXCAVATION, THE CONTRACTOR SHALL CALL "J.U.L.I.E." AT (800) 892-0123 OR 811 FOR FIELD LOCATIONS OF BURIED ELECTRIC, TELEPHONE AND GAS UTILITIES. 48 HOURS NOTIFICATION IS REQUIRED.
- 2. THE CONTRACTOR SHALL COORDINATE CONSTRUCTION ACTIVITIES WITH UTILITY COMPANIES AND WITH LOCAL EMERGENCY SERVICES AND THE VILLAGE OF CRESTWOOD
- 3. THE CONTRACTOR WILL NOT BE ALLOWED TO SET UP A YARD OR FIELD OFFICE ON STATE OR VILLAGE PROPERTY WITHOUT WRITTEN PERMISSION FROM THE DEPARTMENT
- 4. THE RESIDENT ENGINEER SHALL CONTACT AREA TRAFFIC FIELD ENGINEER FADI SULTAN AT FADI.SULTAN@ILLINOIS.GOV A MINIMUM OF TWO WEEKS PRIOR TO PLACEMENT OF PERMANENT PAVEMENT MARKINGS.
- 5. THE CONTRACTOR SHALL COORDINATE CONSTRUCTION ACTIVITIES WITH AFFECTED UTILITY COMPANIES AND THE VILLAGE OF MOUNT PROSPECT.
- 6. DO NOT SCALE PLANS FOR CONSTRUCTION DIMENSIONS.
- 7. THE CONTRACTOR SHALL TAKE CARE IN REMOVING OR EXCAVATING NEAR ALL EXISTING ITEMS WHICH WILL REMAIN. ANY DAMAGE DONE TO EXISTING ITEMS BY THE CONTRACTOR SHALL BE REPAIRED AT THE CONTRACTOR'S EXPENSE.
- 8. DURING CONSTRUCTION OPERATIONS, IF ANY LOOSE MATERIAL IS DEPOSITED IN THE FLOWLINE OF DRAINAGE STRUCTURES SUCH THAT THE NATURAL FLOW OF WATER IS OBSTRUCTED, THE MATIERAL SHALL BE REMOVED AT THE CLOSE OF EACH WORKDAY, THIS WORK WILL NOT BE PAID SEPARATELY BUT SHALL BE INCLUDED IN THE COST OF THE
- 9. THE CONTRACTOR SHALL OBTAIN ALL NECESSARY PERMITS, AS REQUIRED, PRIOR TO COMMENCING WITH CONSTRUCTION. ANY COST ASSOCIATED WITH OBTAINING THESE PERMITS SHALL BE CONSIDERED INCLUDED IN THE CONTRACT UNIT PRICE FOR THE ITEMS
- 10. POLLUTION CONTROL: THE CONTRACTOR SHALL BE REQUIRED TO COMPLY WITH STATE REGULATIONS REGARDING AIR, WATER, AND NOISE POLLUTION. THIS WORK WILL NOT BE PAID FOR SEPARATELY BUT SHALL BE CONSIDERED INCLUDED IN THE COST OF THE
- 11. THE COST OF SAW CUTTING, (FULL DEPTH) SHALL BE INCLUDED IN THE UNIT PRICES FOR THE VARIOUS REMOVAL PAY ITEMS.
- 12. 10 FOOT TRANSITIONS SHALL BE USED TO MATCH PROPOSED CURB & GUTTER AND MEDIANS TO THE EXISTING CURB & GUTTER AND MEDIANS IN THE FIELD UNLESS OTHERWISE SHOWN. THE TRANSITION SHALL BE CONSIDERED INCLUDED IN THE COST OF THE ITEM(S) OF WORK.
- 13. TREES (3) INCHES OR GREATER IN DIAMETER AT BREAST HEIGHT WILL NOT BE CLEARED BETWEEN APRIL 1 AND OCTOBER 31.
- 14. ANY DAMAGE TO EXISTING PAVEMENT MARKINGS OR RAISED REFLECTIVE PAVEMENT MARKERS OUTSIDE THE REMOVAL LIMITS SHOWN ON THE PLANS SHALL BE REPLACED AT NO ADDITIONAL COST TO THE DEPARTMENT.
- 15. BEFORE BEGINNING ANY WORK, THE CONTRACTOR SHALL RETAIN AND RECORD FOR FUTURE REFERENCE ALL EXISTING PAVEMENT MARKING LINES (AND RAISED REFLECTIVE PAVEMENT MARKERS) IN ORDER THAT THESE LOCATIONS CAN BE RE-ESTABLISHED FOR STRIPING AT THE COMPLETION OF THIS CONTRACT. EXACT LOCATIONS OF ALL PAVEMENT MARKINGS SHALL BE AS SHOWN ON THE PLANS OR AS DIRECTED BY THE ENGINEER.

BLA, Inc.

USER NAME = WTeng	DESIGNED - WT	REVISED
	DRAWN	REVISED
PLOT SCALE = 20.0000 / in.	CHECKED - J <u>PO</u>	REVISED
PLOT DATE = 5/8/2023	DATE - 05/04/2023	REVISED -

STATE OF ILLINOIS **DEPARTMENT OF TRANSPORTATION**

U.S. 45 OVER MCDONALD CREEK	F.A. <u>P</u> RTE.	SECTION	
NDEX, STANDARDS AND GENERAL NOTES	330	FAP 0330 22 BJ3	
VDEX, OTANDANDO AND GENERAL NOTES			

				CONSTRUC	CTION CODE
			URBAN	80% FED 20% STATE	80% FED 20% STATE
	***			ROADWAY	BRIDGE
CODE			TOTAL	0005	0047
NO.	ITEM	UNIT	QUANTITY		S.N. 016-2418
28000510	INLET FILTERS	EACH	1	1	
40600290	BITUMINOUS MATERIALS (TACK COAT)	POUND	104		104
40604062	HOT-MIX ASPHALT SURFACE COURSE, IL-9.5, MIX "D", N70	TON	26	26	
50300260	BRIDGE DECK GROOVING	SQ YD	364		364
50300300	PROTECTIVE COAT	SQ YD	486		486
67100100	MOBILIZATION	L SUM	1	1	
70107025	CHANGEABLE MESSAGE SIGN	CAL DA	100	100	
70300150	SHORT TERM PAVEMENT MARKING REMOVAL	SQ FT	1941	1941	
			2		
70307120	TEMPORARY PAVEMENT MARKING - LINE 4" - TYPE IV TAPE	FOOT	5703	5703	
70307160	TEMPORARY PAVEMENT MARKING - LINE 12" - TYPE IV TAPE	FOOT	40	40	
70400100	TEMPORARY CONCRETE BARRIER	FOOT	325	325	
70400200	RELOCATE TEMPORARY CONCRETE BARRIER	FOOT	325	325	
70600255	IMPACT ATTENUATORS, TEMPORARY (FULLY REDIRECTIVE, NARROW), TEST LEVEL 2	EACH	2	2	
4					
70600322	IMPACT ATTENUATORS, RELOCATE (FULLY REDIRECTIVE, NARROW), TEST LEVEL 2	EACH	2	2	

				CONSTRUCTION CODE		
				URBAN	80% FED 20% STATE	80% FED 20% STATE
Γ			Ï		ROADWAY	BRIDGE
l	CODE			TOTAL	0005	0047
	NO.	ITEM	UNIT	QUANTITY		S.N. 016-2418
l						
	78000200	THERMOPLASTIC PAVEMENT MARKING - LINE 4"	FOOT	1954	1954	
	78004635	PREFORMED PLASTIC PAVEMENT MARKING, TYPE D - STANDARD - LINE 7"	FOOT	20	20	
	78009004	MODIFIED URETHANE PAVEMENT MARKING - LINE 4"	FOOT	132	132	
100	78011040	GROOVING FOR RECESSED PAVEMENT MARKING 8"	FOOT	20	20	
	78100100	RAISED REFLECTIVE PAVEMENT MARKER	EACH	4	4	
	70400300	PERI ACTUAL DELL'ECTOR	FAGU	0.5	0.5	Î
	78100300	REPLACEMENT REFLECTOR	EACH	86	86	
	78300200	RAISED REFLECTIVE PAVEMENT MARKER REMOVAL	EACH	14		14
	78300202	PAVEMENT MARKING REMOVAL - WATER BLASTING	SQ FT	702	702	
	X0326766	CLEAN & RESEAL RELIEF JOINT	FOOT	104		104
	X6700407	ENGINEER'S FIELD OFFICE, TYPE A (D1)	CAL MO	6	6	
	X7010216	TRAFFIC CONTROL AND PROTECTION, (SPECIAL)	L SUM	1	1	
	Z0001700	APPROACH SLAB REPAIR (FULL DEPTH)	SQ YD	14		14
	Z0001800	APPROACH SLAB REPAIR (PARTIAL DEPTH)	SQ YD	18		18
1	Z0006014	BRIDGE DECK LATEX CONCRETE OVERLAY, 2 1/2 INCHES	SQ YD	379		379



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PLOT DATE = 5/8/2023	DATE 05/04/2023	REVISED =

STATE OF ILLINOIS
DEPARTMENT OF TRANSPORTATION

SCALE:

U.S. 45 OVER MCDONALD CREEK					F.A.P RTE.	SECTION	COUNTY TOTAL SHEET SHEETS NO.					
		CHI	лил	RV	OF OU	MITITIFS		330	FAP 0330 22 BJ3	COOK	23	3
	SUMMARY OF QUANTITIES							41 00	CONTRACT	NO. 62	2T05	
SHEET 1 OF 2 SHEETS STA. TO STA.						ILLINOIS FED. AI	D PROJECT					

CONSTRUCTION CODE

				CONSTRUC	CTION CODE
				80% FED	80% FED
			URBAN	20% STATE	20% STATE
				ROADWAY	BRIDGE
CODE	ITEM	LINIT	TOTAL	0005	0047 S.N. 016-2418
NO.	ITEM	UNIT	QUANTITY		S.N. 016-2418
Z0012130	BRIDGE DECK SCARIFICATION 3/4"	SQ YD	379		379
Z0012754	STRUCTURAL REPAIR OF CONCRETE (DEPTH EQUAL TO OR LESS THAN 5 INCHES)	SQ FT	142		142
Z0012800	CONCRETE PAVEMENT SCARIFICATION	SQ YD	232		232
Z0013798	CONSTRUCTION LAYOUT	L SUM	1	1	
20013798	CONSTRUCTION LATOUT	L 30M	1	1	
Z0015550	DEBRIS REMOVAL	CU YD	10		10
Z0016002	DECK SLAB REPAIR (FULL DEPTH, TYPE II)	SQ YD	21		21
Z0030850	TEMPORARY INFORMATION SIGNING	SQ FT	89	89	
Z0064800	SELECTIVE CLEARING	UNIT	1.5	1.5	
20064800	SELECTIVE CLEARING	UNIT	1.5	1.5	
Z0073510	TEMPORARY TRAFFIC SIGNAL TIMING	EACH	1	1	
Z0076600	TRAINEES	HOUR			
Z0076604	TRAINEES TRAINING PROGRAM GRADUATE	HOUR			

* SPECIALTY ITEM




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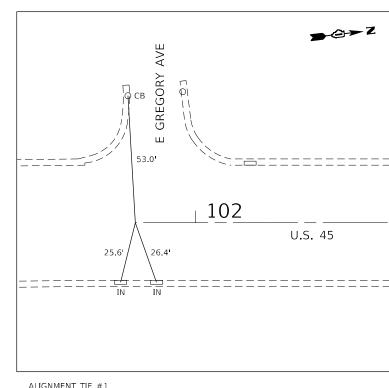
STATE OF ILLINOIS **DEPARTMENT OF TRANSPORTATION**

SCALE:


U.S. 45 OVER MCDONALD CREEK	F.A.P RTE	SECTION	COUNTY	TOTAL SHEETS	SHEET NO.
SUMMARY OF QUANTITIES	330	FAP 0330 22 BJ3	COOK	23	4
JOININALL OF GOARTIFIED			CONTRACT	NO. 62	T05
SHEET 2 OF 2 SHEETS STA. TO STA.		TILLIMOIS FED AT	D DROIFCT		

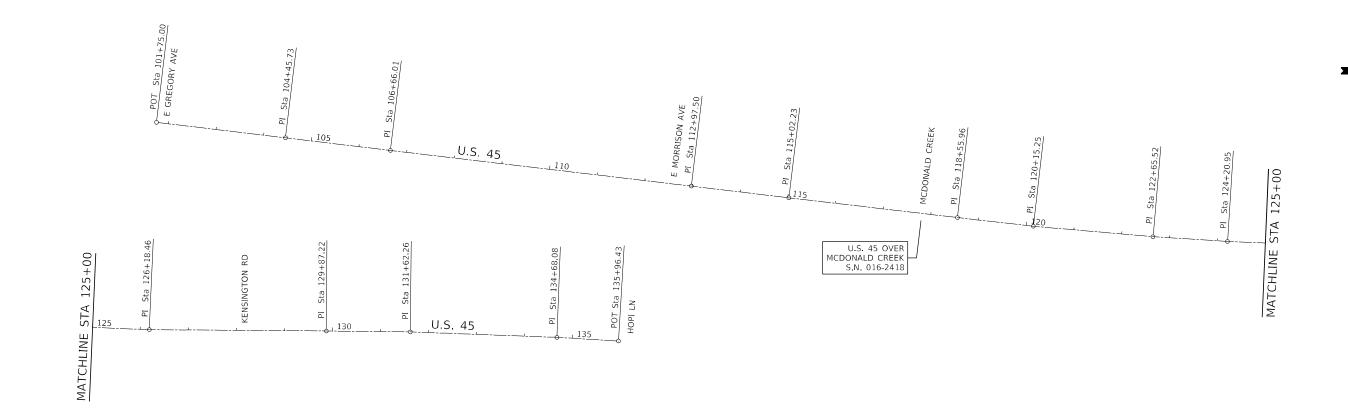

COC	DRDINATE DA	ATA - EXISTING L	J.S. 45
STATION	ELEMENT	NORTHING	EASTING
101+75.00	POT	1,969,594.01	1,103,620.67
104+45.73	PI	1,969,862.97	1,103,651.55
106+66.01	PI	1,970,081.78	1,103,676.96
112+97.50	PI	1,970,709.25	1,103,748.08
115+02.23	PI	1,970,912.63	1,103,771.50
118+55.96	PI	1,971,264.16	1,103,810.98
120+15.25	PI	1,971,422.51	1,103,828.24
122+65.52	PI	1,971,671.93	1,103,848.78
124+20.95	PI	1,971,827.10	1,103,857.92
126+18.46	PI	1,972,024.46	1,103,865.33
129+87.22	ΡĪ	1,972,393.23	1,103,866.23
131+62.26	PI	1,972,568.26	1,103,867.25
134+68.08	PI	1,972,873.93	1,103,877.14
135+96.43	POT	1,973,002.08	1,103,884.15



ALIGNMENT TIE #1 U.S. 45 STA. 101+75.00 N: 1,969,594.01 E: 1,103,620.67

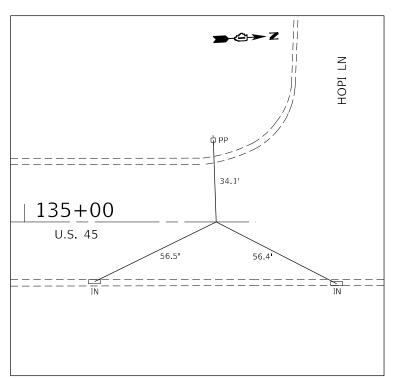

ALIGNMENT TIE #2 U.S. 45 STA. 135+78.00 N: 1,972,983.36 E: 1,103,883.13

BL	BLA, Inc. ITASCA, ILLINOIS
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USER NAME = WTeng	DESIGNED - WT	REVISED -
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PLOT SCALE = 200.0000 / in.	CHECKED - JPO	REVISED -
PLOT DATE = 4/17/2023	DATE - 04/14/2023	REVISED -

STATE OF ILLINOIS	
DEPARTMENT OF TRANSPORTATION	

	U.S. 45 OVER MCDONALD CREEK ALIGNMENT AND TIES						F.A RT		SEC.	TION		COUNTY	TOTAL SHEETS	SHEET NO.	
							33	30	FAP 033	0 22 BJ3	3	соок	23	5	
			ALIUN	IIVIL	IVI AIVI) IILU							CONTRACT	NO. 6	2T05
	SCALE: 1" = 100'	SHEET 1	OF	1	SHEETS	STA.	TO STA.				ILLINOIS	FED. AI	ID PROJECT		

MAINTENANCE OF TRAFFIC GENERAL NOTES

- 1. CHANGEABLE MESSAGE SIGNS SHALL BE INSTALLED TWO WEEKS PRIOR TO ALL TRAFFIC STAGE CHANGES ON EACH APPROACH OF THE AFFECTED ROADWAY TO WARN MOTORISTS OF THE UPCOMING EVENTS. THE SIGN MESSAGES SHALL BE REVISED TWO WEEKS THEREAFTER WITH MESSAGES WARNING TRAFFIC OF POTENTIAL TRAFFIC DELAYS, QUEUING AND/OR WITH MESSAGES NOTIFYING TRAFFIC TO USE ALTERNATE ROUTES. THE SIGN LOCATIONS AND MESSAGES SHALL BE DETERMINED BY THE ENGINEER
- 2. THE CONTRACTOR SHALL CONTACT THE DISTRICT ONE TRAFFIC CONTROL SUPERVISOR AT KALPANA.KANNAN-HOSADURGA@ILLINOIS.GOV A MINIMUM OF 72 HOURS IN ADVANCE OF BEGINNING ANY WORK.
- 3. NO WORK SHALL COMMENCE UNTIL TRAFFIC CONTROL REQUIREMENTS ARE MET.
- 4. BEFORE BEGINNING ANY WORK, THE CONTRACTOR SHALL RETAIN AND RECORD FOR FUTURE REFERENCE ALL EXISTING PAVEMENT MARKING LINES (AND RAISED REFLECTIVE PAVEMENT MARKERS) IN ORDER THAT THESE LOCATIONS CAN BE RE-ESTABLISHED FOR STRIPING AT THE COMPLETION OF THIS CONTRACT. EXACT LOCATIONS OF ALL PAVEMENT MARKINGS SHALL BE AS SHOWN ON THE PLANS OR AS DIRECTED BY THE ENGINEER.
- 5. RAISED REFLECTIVE PAVEMENT MARKER REMOVAL ON U.S. 45 SHALL INCLUDE ONLY THE REMOVAL OF THE REFLECTIVE ELEMENTS, EXCEPT AT BRIDGE S.N. 016-2418 WHERE THE REFLECTIVE ELEMENTS AND BASE CASTINGS SHALL BOTH BE REMOVED PRIOR TO SCARIFICATION, PER ARTICLE 783.03(b).
- 6. THE CONTRACTOR WILL GIVE THE ENGINEER AT LEAST 10 DAYS NOTICE PRIOR TO ANY TRAFFIC STAGING CHANGES.
- 7. ARROW BOARDS SHALL HAVE SOLAR POWER CAPABILITY.
- 8. THE CONTRACTOR SHALL PROVIDE AT LEAST 48 HOURS PRIOR NOTICE TO THE RESIDENT ENGINEER, LOCAL EMERGENCY SERVICES, SCHOOLS, AND POST OFFICE PRIOR TO IMPLEMENTING LANE CLOSURES OR MAJOR TRAFFIC CONTROL CHANGES.
- 9. ADVANCE WIDTH RESTRICTION SIGNS SHALL REMAIN IN PLACE UNTIL THE COMPLETION OF M.O.T. STAGE 2.

GENERAL SEQUENCE OF CONSTRUCTION

STAGE 1

SHIFT TRAFFIC TO WEST HALF OF U.S. 45 AS SHOWN IN STAGE 1 PLANS TO MAINTAIN ONE LANE OF TRAFFIC IN EACH DIRECTION. PERFORM DECK SCARIFICATION AND OVERLAY ON EAST HALF OF BRIDGE S.N. 016-2418.


STAGE

SHIFT TRAFFIC TO EAST HALF OF U.S. 45 AS SHOWN IN STAGE 2 PLANS TO MAINTAIN ONE LANE OF TRAFFIC IN EACH DIRECTION. PERFORM DECK SCARIFICATION AND OVERLAY ON WEST HALF OF BRIDGE S.N. 016-2418.

ADVANCE WIDTH RESTRICTION SIGNING MAP

NOT TO SCALE



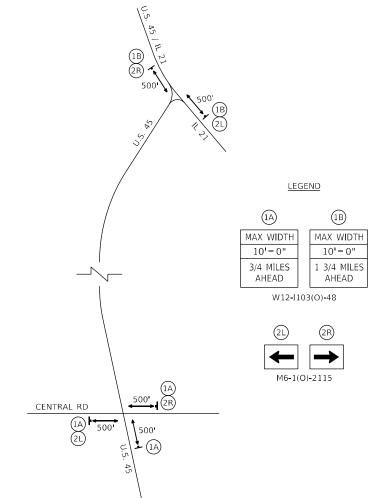





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PLOT DATE = 4/17/2023	DATE - 04/14/2023	REVISED -

STATE OF ILLINOIS
DEPARTMENT OF TRANSPORTATION


MAINTEN		15 OVER TRAFFIC				SEQUENCIN	G
SCALE: N.T.S.	SHEET 1	OF 4	SHEETS	STA.	N/A	TO STA.	N/A

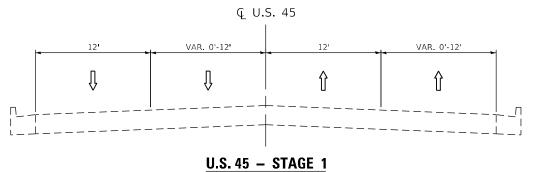


STA 109+39 TO 116+51

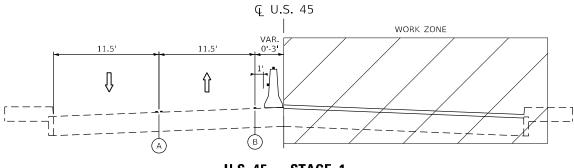


U.S. 45 - STAGE 1
STA 116+51 TO 119+01

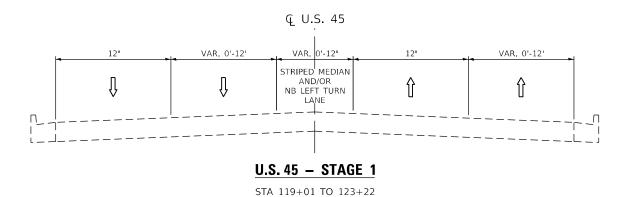

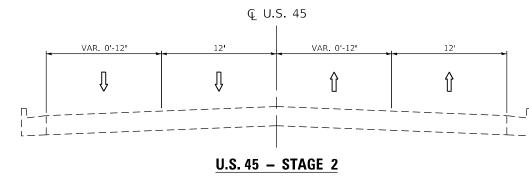


STA 107+19 TO 115+51

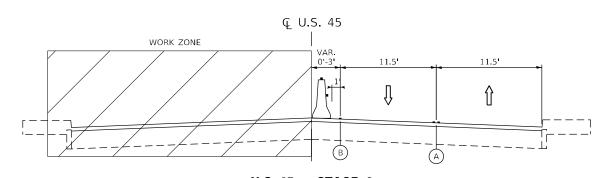

<u>U.S. 45 – STAGE 2</u>

STA 116+51 TO 119+01

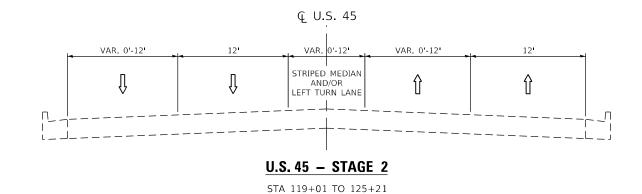

LEGEND

* TEMP. CONC. BARRIER W/ TY. C BI-DIRECTIONAL CRYSTAL REFLECTORS (PER STDS. 704001 & 782006)

WORK ZONE

A 4" DOUBLE YELLOW @ 11" C-C TYPE IV TAPE

B 4" SOLID WHITE TYPE IV TAPE

*TYPE C REFLECTORS SHALL BE CONSIDERED INCLUDED IN THE COST OF TEMP. CONC. BARRIER.


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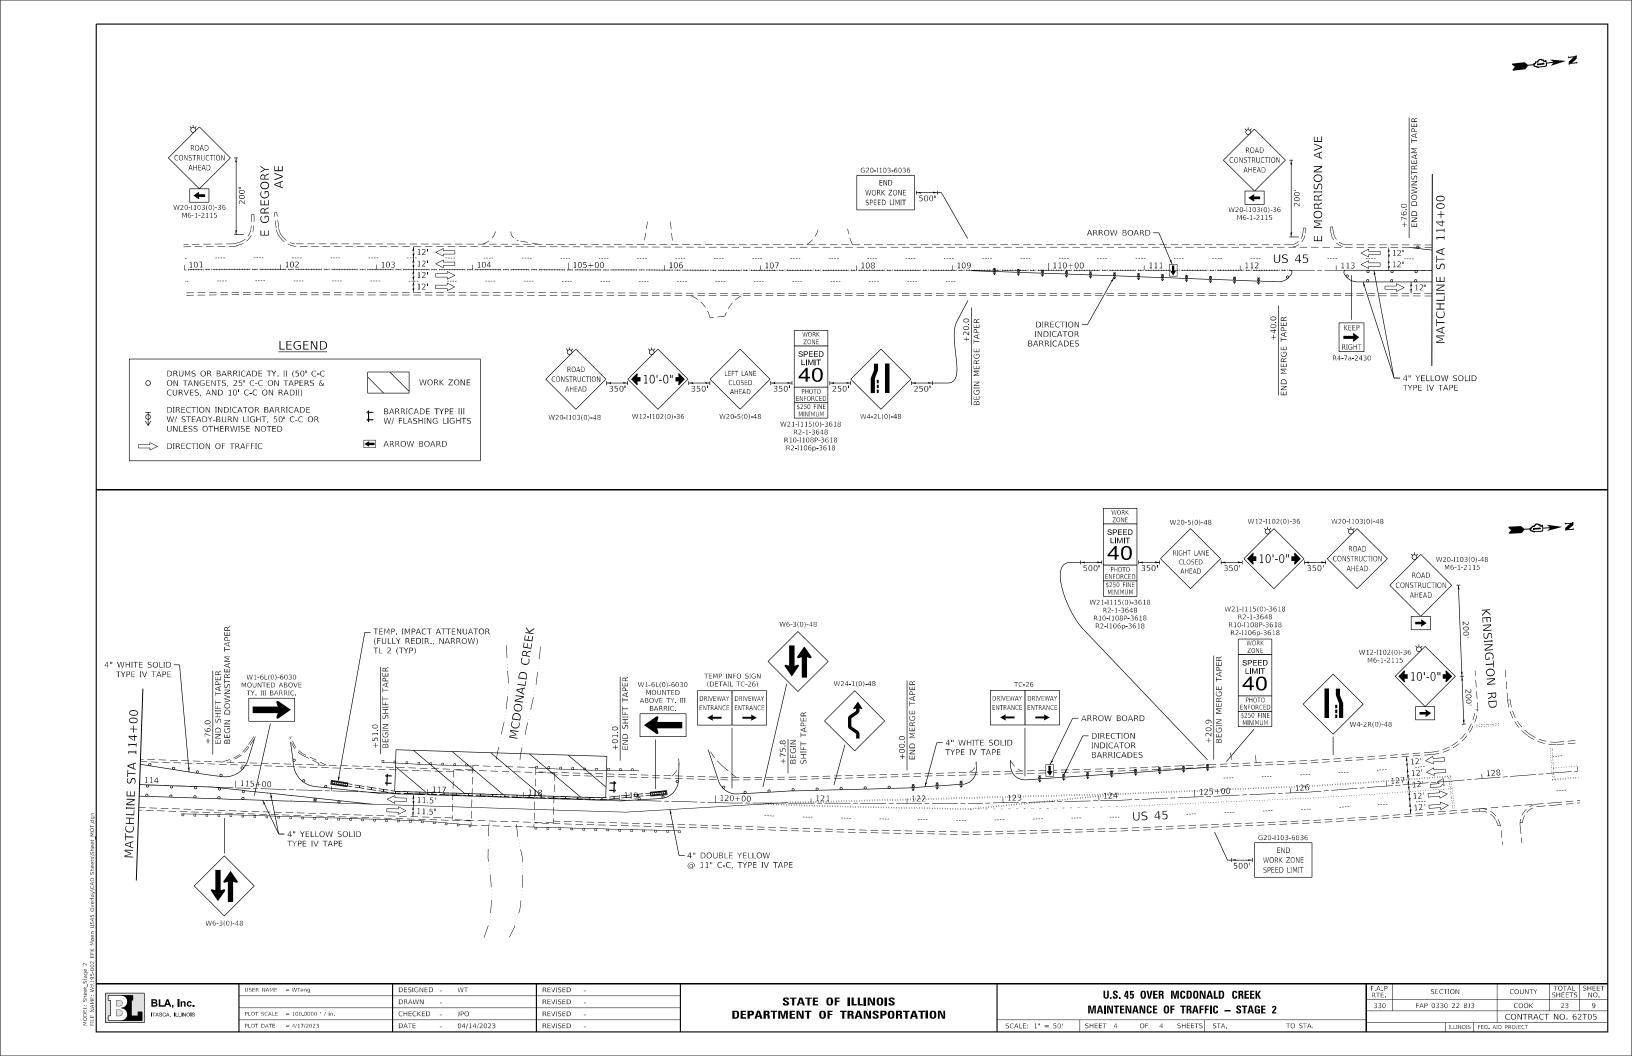



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PLOT DATE = 4/17/2023	DATE - 04/14/2023	REVISED -

STATE OF ILLINOIS
DEPARTMENT OF TRANSPORTATION

U.S. 45 OVER MCDONALD CREEK	F.A.P RTE	SECTION	COUNTY	TOTAL SHEETS	SHEET NO.
MAINTENANCE OF TRAFFIC TYPICAL SECTIONS	330	FAP 0330 22 BJ3	COOK	23	7
MAINTENANCE OF THAITIO THEORE SECTIONS			CONTRAC	NO. 62	2T05
SHEET 2 OF 4 SHEETS STA. TO STA.		ILLINOIS FED. A	D PROJECT		



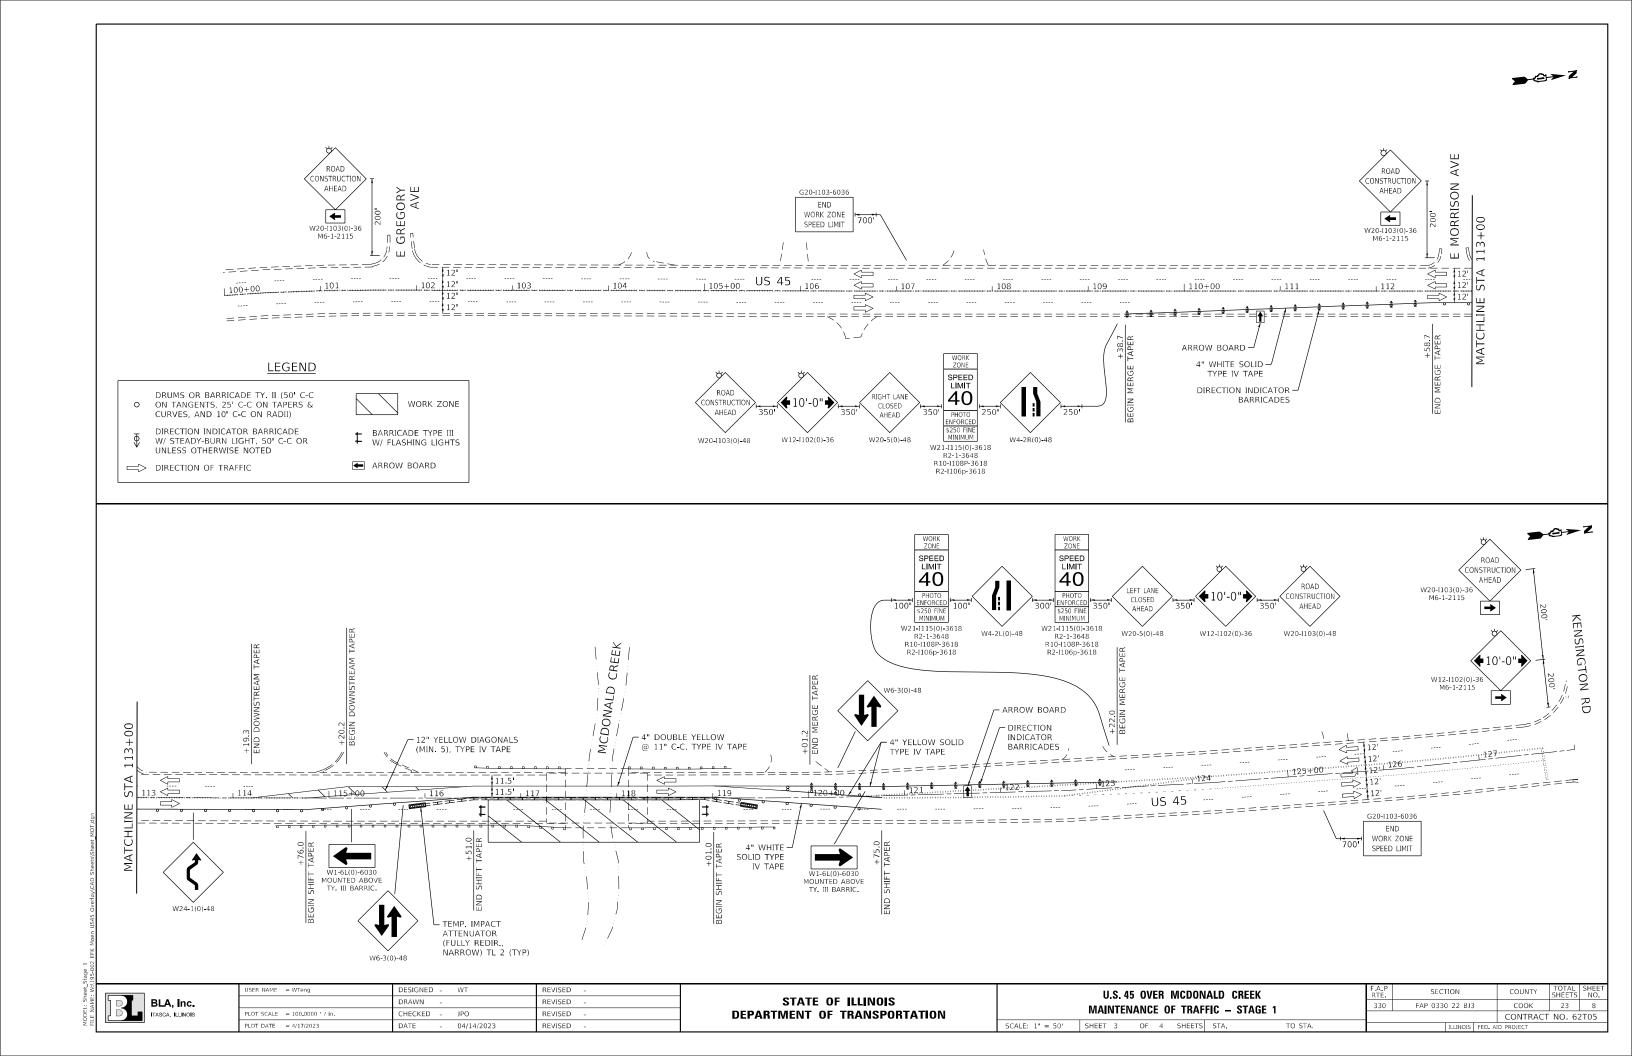

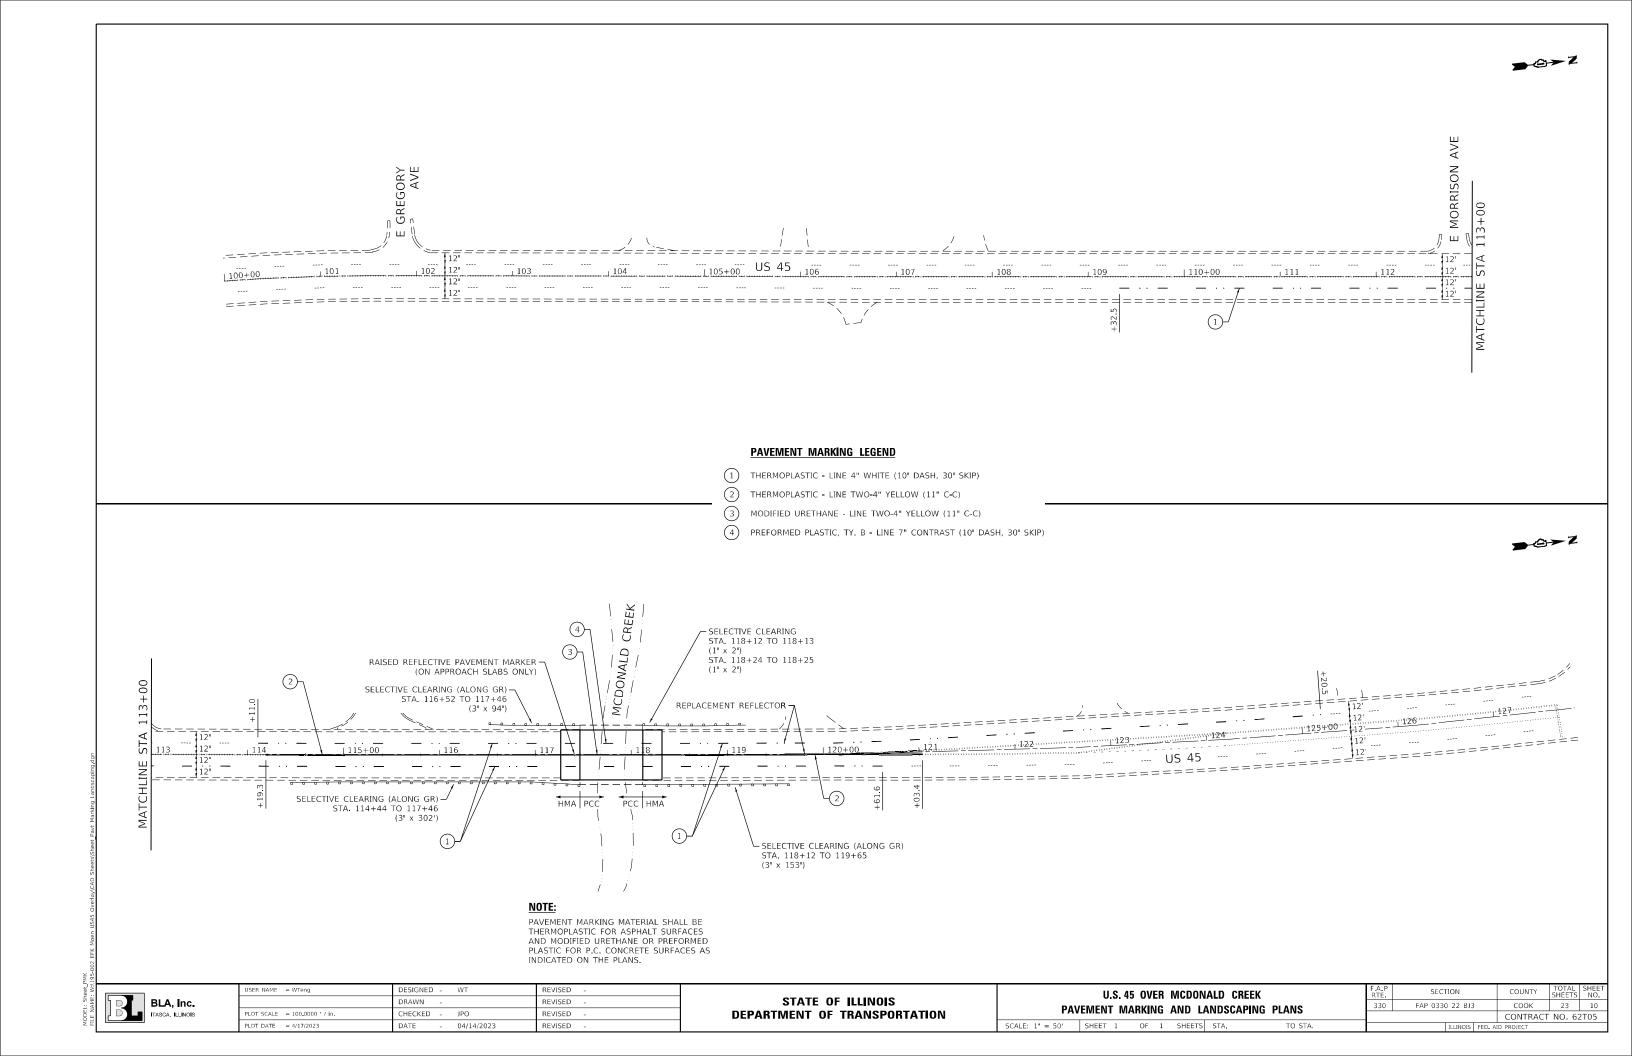

Existing Structure: S.N 016-2418 was built in 1984 as a slab bridge. The structure has a back-to-back abutment length of 66'-6" and the width is 64'-0" out to out deck. The superstructure consists of a 1'-2" thick reinforced concrete slab.


Traffic to be maintained utilizing stage construction.

LOADING HS20-44


Original Construction Allow 25 psf for FWS

DESIGN SPECIFICATIONS

1977 AASHTO Standard Specifications for Highway, Bridges & Interim Specifications for 1980 (New Construction) 2002 AASHTO Standard Specifications for Highway Bridges, 17th Edition

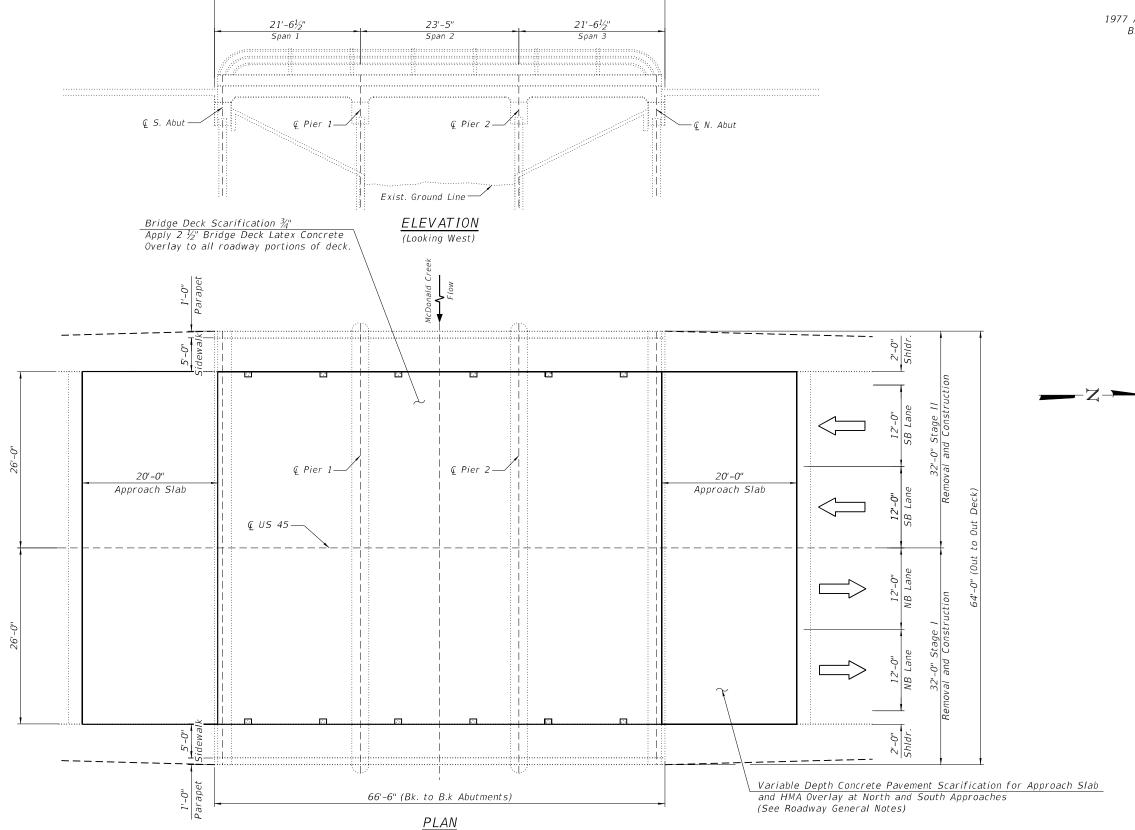

66'-6" (Bk. to B.k Abutments)

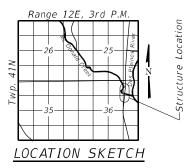



DATE SIGNED: 1-16-2023 EXP. DATE: 11-30-2024

GENERAL PLAN & ELEVATION

U.S RT. 45 OVER
MCDONALD CREEK
F.A.P. ROUTE 330
SEC. 0330 022 BJ3
COOK COUNTY
STATION 256+46.50
S.N 016-2418

COOK 23 11

CONTRACT NO. 62T05

BLA, Inc.

USER NAME = esotelo	DESIGNED - ES	REVISED -
	CHECKED - KN	REVISED -
PLOT SCALE =	DRAWN - ES	REVISED -
PLOT DATE = 6/19/2023	CHECKED - KN	REVISED -

GENERAL NOTES


- 1. Plan dimensions and details relative to existing plans are subject to nominal construction variations. The Contractor shall field verify existing dimensions and details affecting new construction and make necessary approved adjustments prior to construction or ordering of materials. Such variations shall not be cause for additional compensation for a change in scope of the work; however, the Contractor will be paid for the quantity actually furnished based on the unit price bid for the work.
- 2. Areas of deck repairs are estimated. Actual type, location and dimensions are to be determined by the Engineer during construction and documented on as-built plans.
- 3. Existing Reinforcement bars extending into the removal area shall be cleaned, straightened and incorporated into the new construction. Any reinforcement bars that are damaged within concrete removal area shall be replaced with an approved bar splicer or anchorage system. Cost included with concrete removal.
- 4. See Special Provisions "Deck Slab Repair" for additional requirements pertaining to deck slab repair.

INDEX OF SHEETS


- 1. General Plan & Elevation
- 2. General Data
- 3. Stage Construction Details
- 4. Bridge Deck and Approach Slabs Overlay and Repairs
- 5. Parapet Repair Details
- 6. Pier 2 Repair Details
- 7. North Abutment Repair Details

SCOPE OF WORK

- 1. Scarify $\frac{3}{4}$ " from the bridge slab and variable depth from approach slabs.
- 2. Full and partial depth repairs to bridge slab and approach slabs.
- 3. Apply $2\frac{1}{2}$ " Bridge Deck Latex Concrete Overlay on bridge slab and variable depth Hot-Mix Asphalt (HMA) Overlay on approach slabs.
- 4. Bridge Deck Grooving.
- 5. Apply Protective Coat to the top and inside faces of parapets, top and inside faces of sidewalks, and top of Latex Overlay.
- 6. Concrete Repair of West and East Parapet, North Abutment, and Pier 2.

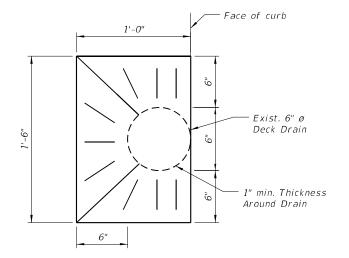

DECK DRAIN TOP PLAN

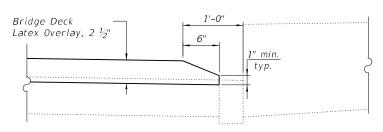

SECTION AT DECK DRAIN

TOTAL BILL OF MATERIAL


TOTAL BILL OF THAT	711712	
ITEM	UNIT	TOTAL
Bituminous Materials (Tack Coat)	Pound.	104
Bridge Deck Grooving	Sq. Yd.	364
Protective Coat	Sq. Yd.	486
Clean & Reseal Relief Joint	Foot	104
Approach Slab Repair (Full Depth)	Sq. Yd.	14
Approach Slab Repair (Partial Depth)	Sq. Yd.	18
Bridge Deck Latex Concrete Overlay, 2 ½ Inches	Sq. Yd.	379
Bridge Deck Scarification ¾"	Sq. Yd.	379
Structural Repair of Concrete (Depth Equal To or Less Than 5 Inches)	Sq. Ft.	142
Concrete Pavement Scarification	Sq. Yd.	232
Debris Removal	Cu. Yd.	10
Deck Slab Repair (Full Depth, Type II)	Sq. Yd.	21




USER NAME = esotelo	DESIGNED - ES	REVISED -
	CHECKED - KN	REVISED -
PLOT SCALE =	DRAWN - ES	REVISED -
PLOT DATE = 6/19/2023	CHECKED - KN	REVISED -

GENERAL DATA Structure No. 016–2418
SHEET NO. 2 OF 7 SHEETS

A.P TE.	SECTION		COUNTY	TOTAL SHEETS	SHE
30	0330 022 BJ3		COOK	23	1
			CONTRACT	NO. 62	2T05
	ILLINOIS	FED. A	D PROJECT		

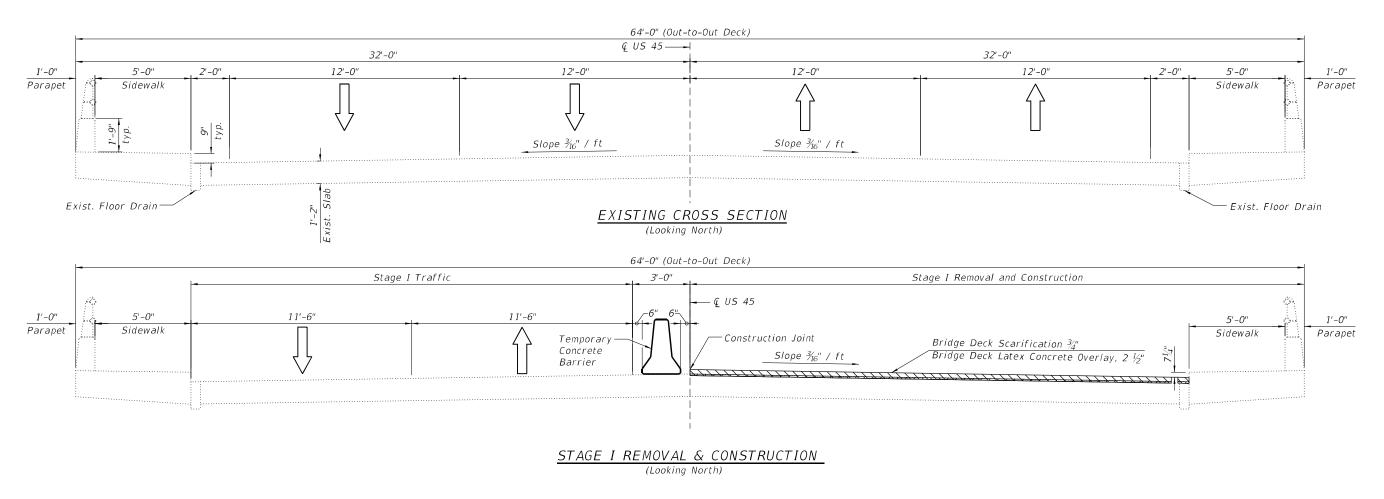

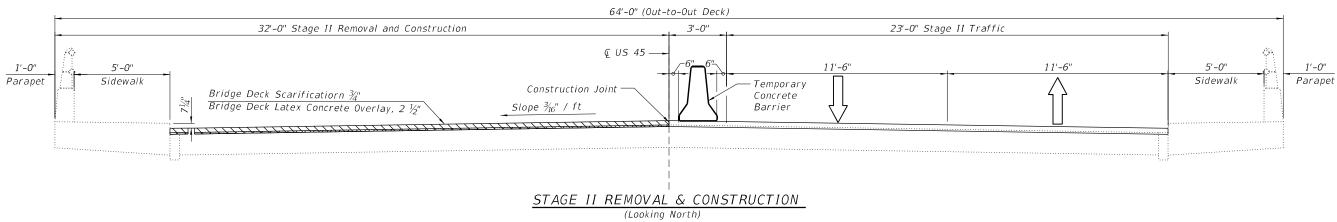

LEGEND

Bridge Deck Scarification 3/4"



Bridge Deck Latex Concrete Overlay 2 $\frac{1}{2}$ "


BILL OF MATERIAL


ITEM	UNIT	QUANTITY
Bridge Deck Scarification ¾"	Sq. Yd.	379
Bridge Deck Latex Concrete Overlay, 2 ½ Inches	Sq. Yd.	379


BL	BLA.	Inc.
	DLA,	mc.

	USER NAME = esotelo	DESIGNED - ES	REVISED -
		CHECKED - KN	REVISED -
	PLOT SCALE =	DRAWN - ES	REVISED -
•	PLOT DATE = 6/19/2023	CHECKED - KN	REVISED -

STAGE CONSTRUCTION DETAILS	F.A.P RTE.	SEC
STRUCTURE NO. 016-2418	330	0330
0111001011E 140, 010 2410		
SHEET NO. 3 OF 7 SHEETS		

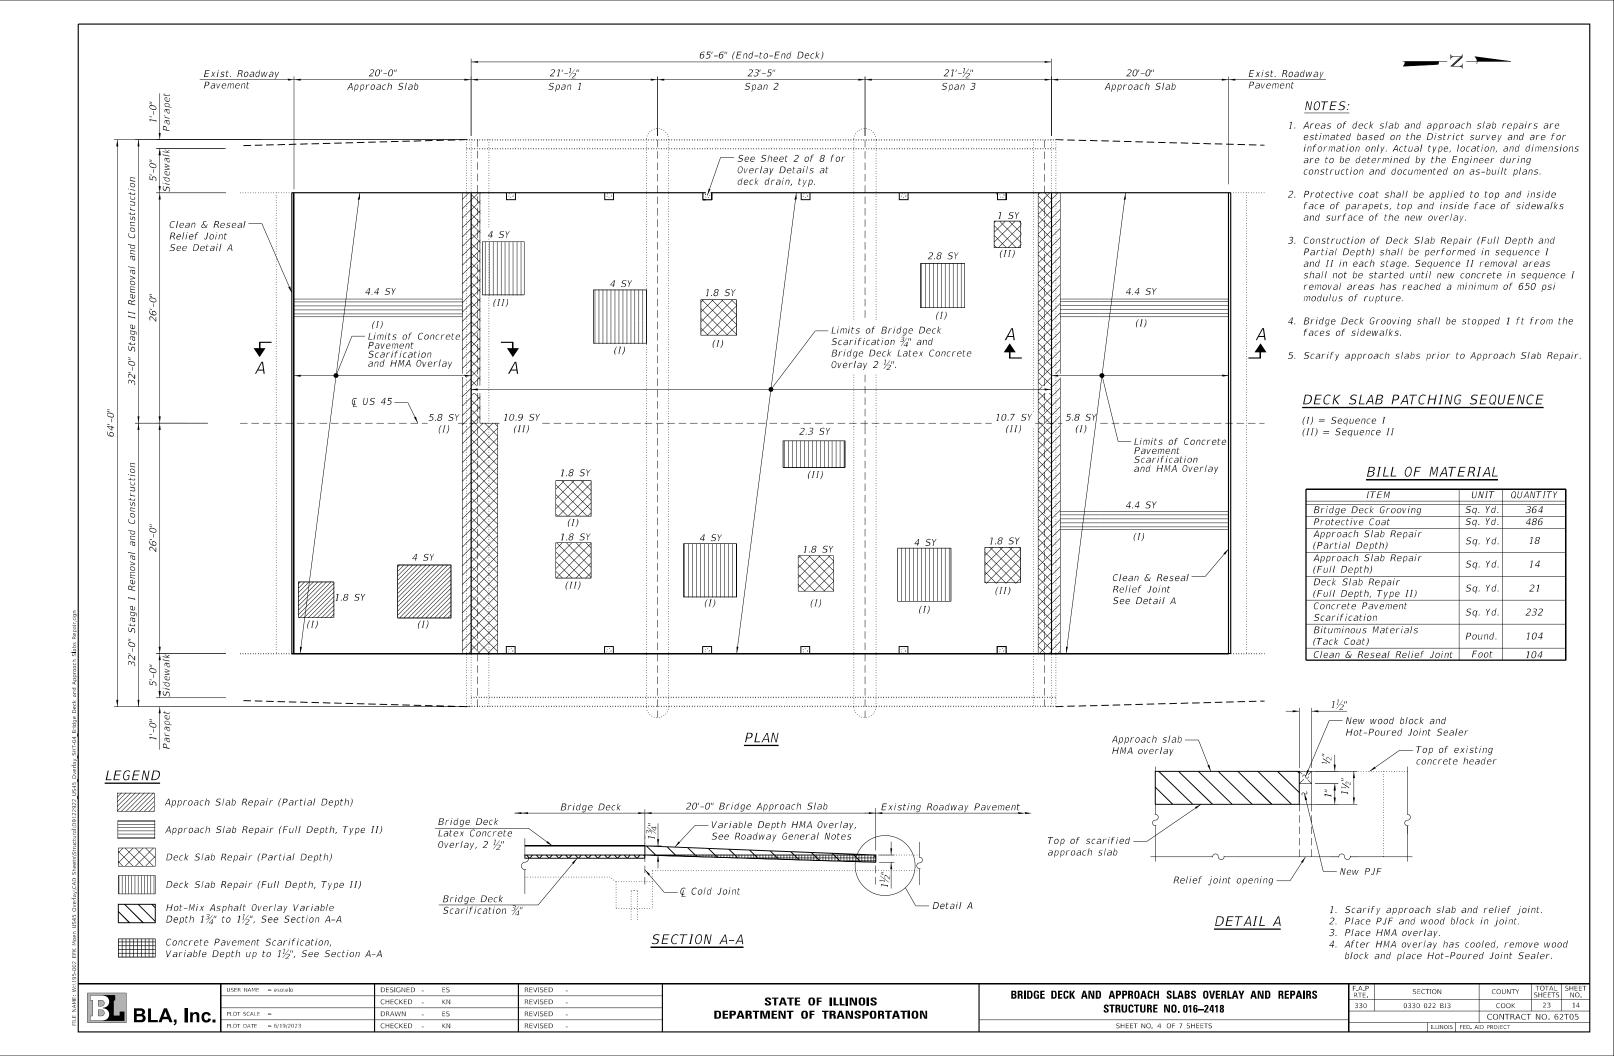

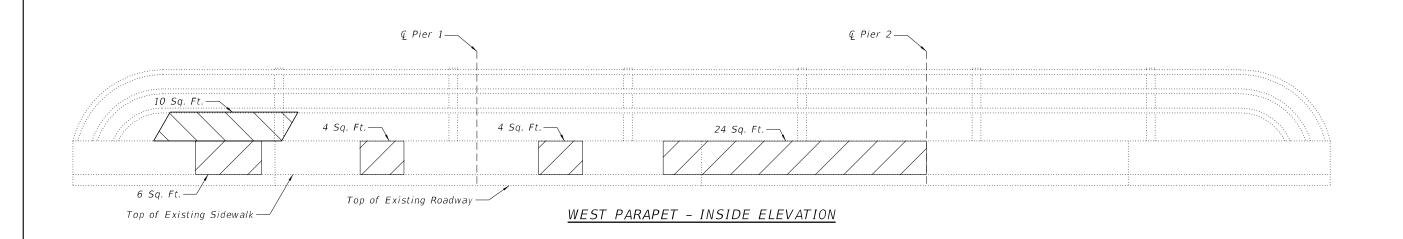

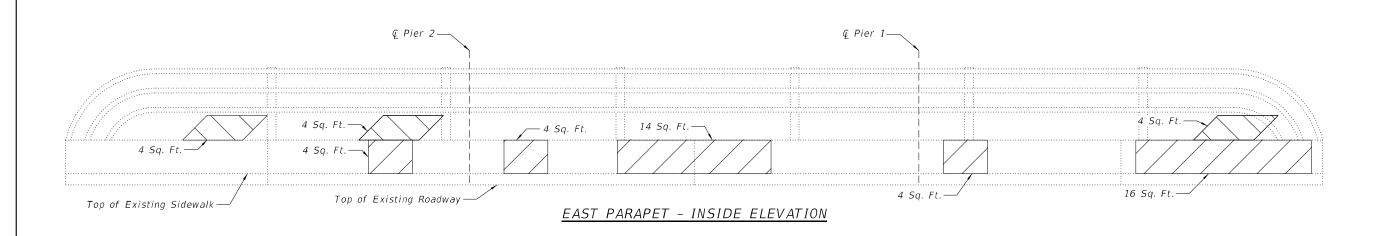

<u>LEGEND</u>



Structural Repair of Concrete - Traffic Face (Depth Equal to or Less Than 5 Inches)



Structural Repair of Concrete - Back Face (Depth Equal to or Less Than 5 Inches)

BILL OF MATERIAL


ITEM	UNIT	QUANTITY
Structural Repair of Concrete (Depth Equal To or Less Than 5 Inches)	Sq. Ft.	102




USER NAME = esotelo	DESIGNED - ES	REVISED -
	CHECKED - KN	REVISED -
PLOT SCALE =	DRAWN - ES	REVISED -
PLOT DATE = 4/12/2023	CHECKED - KN	REVISED -

STATE OF ILLINOIS
DEPARTMENT OF TRANSPORTATION

PARAPET REPAIR DETAILS STRUCTURE NO. 016–2418	F.A.P RTE.	SECTION		COUNTY	TOTAL SHEETS	SHEET NO.	
	330	0330 022 BJ3			COOK	23	15
3111001011L 140, 010-2410					CONTRACT	NO. 62	2T05
SHEET NO. 5 OF 7 SHEETS			ILLINOIS	FED. AI	D PROJECT		

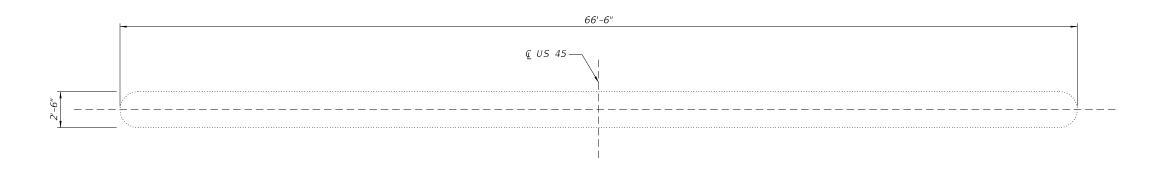

<u>PIER 2 - PLAN</u>

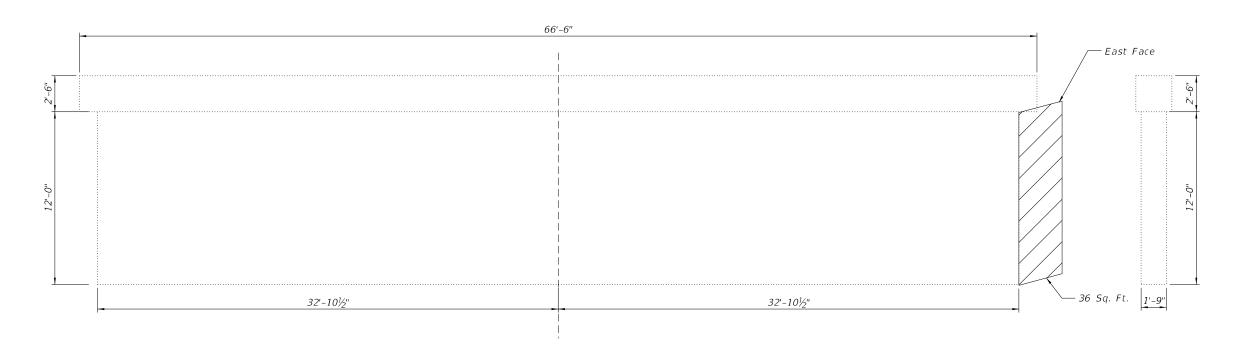

PIER 2 - ELEVATION (Looking North)

<u>LEGEND</u>



Structural Repair of Concrete (Depth Equal to or Less Than 5 Inches)

BILL OF MATERIAL


ITEM	UNIT	QUANTIT'
Structural Repair of Concrete (Depth Equal To or Less Than 5 Inches)	Sq. Ft.	36

USER NAME = esotelo	DESIGNED - ES	REVISED -
	CHECKED - KN	REVISED -
PLOT SCALE =	DRAWN - ES	REVISED -
PLOT DATE = 4/12/2023	CHECKED - KN	REVISED -

STATE OF ILLINOIS	
DEPARTMENT OF TRANSPORTATION	

PIER 2 REPAIR DETAILS		SEC
STRUCTURE NO. 016-2418	330	0330
CHICOTOLIC NOTOLIC ETTO		
SHEET NO. 6 OF 7 SHEETS		

P E			COUNTY	TOTAL SHEETS	SHEET NO.
0	0330 022 BJ3		COOK	23	16
·		CONTRACT	NO. 62	2T05	
	ILLINOIS	FED. A	D PROJECT		

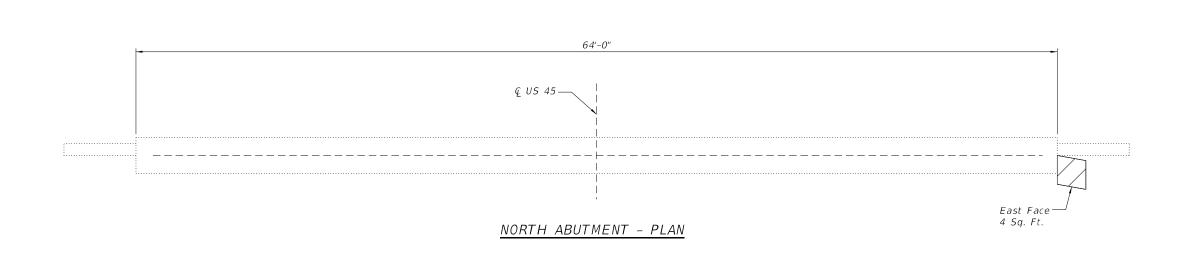

BILL OF MATERIAL

	ITEM	UNIT	QUANTITY
(1	Structural Repair of Concrete Depth Equal To or Less Than 5 Inches)	Sq. Ft.	4

<u>LEGEND</u>



Structural Repair of Concrete (Depth Equal to or Less Than 5 Inches)


BLA,	Inc.

USER NAME = esotelo	DESIGNED - ES	REVISED -
	CHECKED - KN	REVISED -
PLOT SCALE =	DRAWN - ES	REVISED -
PLOT DATE = 4/12/2023	CHECKED - KN	REVISED -

STATE OF ILLINOIS		
DEPARTMENT	0F	TRANSPORTATION

NORTH ABUTMENT REPAIR DETAILS				
STRUCTURE NO. 016-2418				
SHEET NO. 7 OF 7 SHEETS				

A.P SECTION			COUNTY	TOTAL SHEETS	SHE
330	330 0330 022 BJ3		СООК	23	17
		CONTRACT	NO. 62	2T05	
	ILLINOIS	FED A	ID PROJECT		

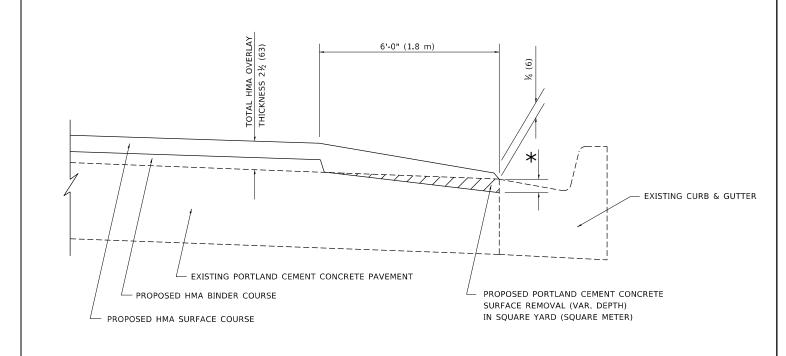

HMA TAPER AT EDGE OF PCC PAVEMENT


HMA SURFACE COURSE		HMA BINDER COURSE	
MIX	THICKNESS	THICKNESS	* MILLING AT GUTTER FLAG
D	1½ (38)	1 (25)	1¼ (33)
E OR SMA 9.5	1¾ (44)	¾ (19)	1½ (38)

ALL DIMENSIONS ARE IN INCHES (MILLIMETERS) UNLESS OTHERWISE SHOWN.

USER NAME = Shawn.Ley	DESIGNED	-	R. SHAH	REVISED	-	E. GOMEZ 12-21-00
	DRAWN	-	JIS	REVISED	-	R. BORO 01-01-07
PLOT SCALE = 50.0000 / in.	CHECKED	-	A. ABBAS	REVISED	-	JP CHANG 07-08-16
PLOT DATE = 1/23/2023	DATE	-	09-10-94	REVISED	-	K. SMITH 11-18-22

STATE OF ILLINOIS		
DEPARTMENT OF	TRANSPORTATION	

HMA TAPER AT							F.A. RTE	SEC	TON		COUNTY	TOT
	EDGE OF P.C.C. PAVEMENT						330	FAP 0330 22 BJ3		СООК		
							В	D400-06	BD-33	3	CONTRAC	T NO.
	SCALE: NONE	SHEET 1	OF 1	SHEETS	STA.	TO STA.			ILLINOIS	FED. A	ID PROJECT	

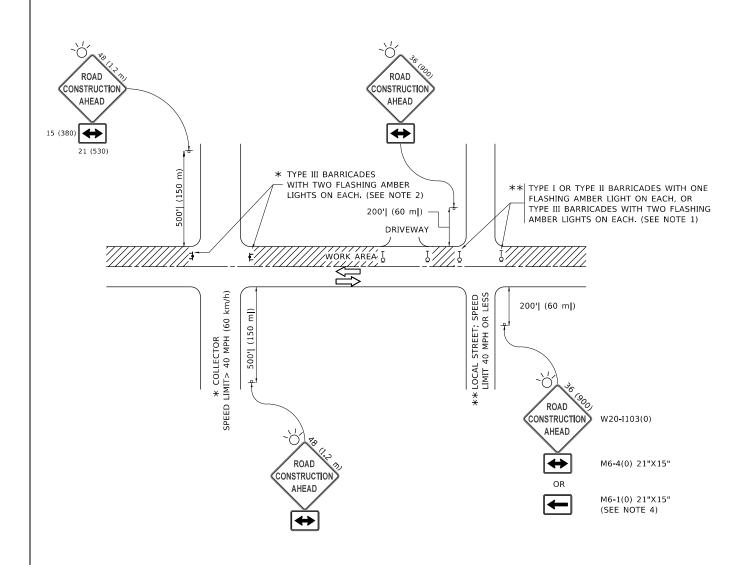

NOTES:

- 1. SIDE ROAD WITH A SPEED LIMIT OF 40 MPH (60 km/h) OR LESS AS SHOWN ON THE DRAWING AND AS DIRECTED BY THE ENGINEER:
- a) ONE "ROAD CONSTRUCTION AHEAD" SIGN 36 x 36 (900x900) WITH A FLASHER MOUNTED ON IT APPROXIMATELY 200' (60 m) IN ADVANCE OF THE MAIN ROUTE.
- b) THE CLOSED PORTION OF THE MAIN ROUTE SHALL BE PROTECTED BY BLOCKING WITH TYPE I, TYPE II OR TYPE III BARRICADES, 1/3 OF THE CROSS SECTION OF THE CLOSED PORTION.
- SIDE ROAD WITH A SPEED LIMIT GREATER THAN 40 MPH (60 km/h) AS SHOWN ON THE DRAWING AND AS DIRECTED BY THE ENGINEER:
- a) ONE "ROAD CONSTRUCTION AHEAD" SIGN 48 x 48 (1.2 m x 1.2 m) WITH A FLASHER MOUNTED ON IT APPROXIMATELY 500' (150 m) IN ADVANCE OF THE MAIN ROUTE.
- THE CLOSED PORTION OF THE MAIN ROUTE SHALL BE PROTECTED BY
 b) BLOCKING WITH TYPE III BARRICADES, 1/2 OF THE CROSS SECTION
 OF THE CLOSED PORTION.
- 3. CONES MAY BE SUBSTITUTED FOR BARRICADES OR DRUMS AT HALF THE SPACING DURING DAY OPERATIONS. CONES SHALL BE A MINIMUM OF 28 (710)
- WHEN THE SIDE ROAD LIES BETWEEN THE BEGINNING OF THE MAINLINE
 4. SIGNING AND THE WORK ZONE, A SINGLE HEADED ARROW (M6-1) SHALL
 BE USED IN LIEU OF THE DOUBLE HEADED ARROW (M6-4).

SCALE: NONE


- 5. WHEN WORK IS BEING PERFORMED ON A SIDE ROAD OR DRIVEWAY, FOLLOW THE APPLICABLE STANDARD(S). THE DIRECTIONAL ARROW (M6-1 OR M6-4) SHALL BE COVERED OR REMOVED WHEN NO LONGER CONSISTENT WITH THE TRAFFIC CONTROL SET-UP.
- 6. ADVANCE WARNING SIGNS ARE TO BE OMITTED ON DRIVEWAYS UNLESS OTHERWISE SPECIFIED IN THE PLANS OR BY THE ENGINEER
- 7. THE TRAFFIC CONTROL AND PROTECTION FOR SIDE ROADS, INTERSECTIONS, AND DRIVEWAYS SHALL BE INCLUDED IN THE COST OF SPECIFIED TRAFFIC CONTROL STANDARDS OR ITEMS.


All dimensions are in inches (millimeters) unless otherwise shown.

USER NAME = footemj	DESIGNED - L.H.A.	REVISED - A. HOUSEH 10-15-9		
	DRAWN -	REVISED	- T. RAMMACHER 01-06-00	
PLOT SCALE = 50.0000 / in.	CHECKED -	REVISED	- A. SCHUETZE 07-01-13	
PLOT DATE = 3/4/2019	DATE - 06-89	REVISED	_ A. SCHUETZE 09-15-16	


STATE OF	ILLINOIS
DEPARTMENT OF	TRANSPORTATION

	TRAFFIC CONTROL AND PROTECTION FOR								SE	
:1	IDE ROADS, INTERSECTIONS, AND DRIVEWAYS							330		
IDE NOADS, INTENSECTIONS, AND DRIVEWATS							TC-1			
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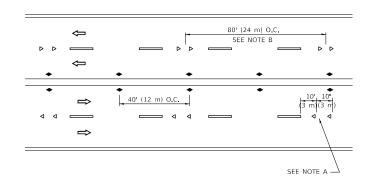


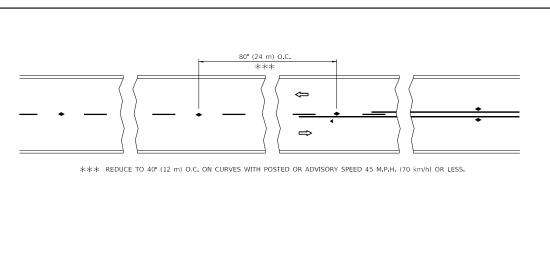


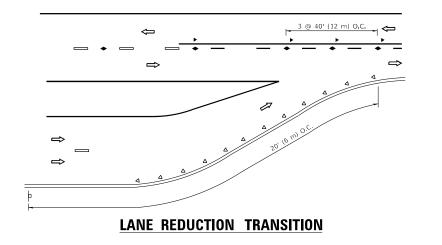SEE FIGURE 3B-14 MUTCD

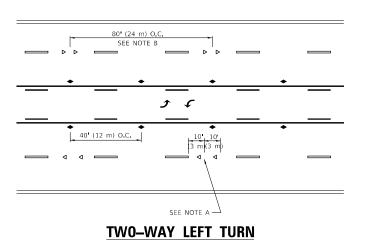


TWO-LANE/TWO-WAY




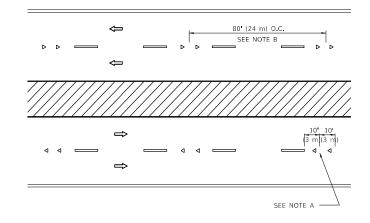

MULTI-LANE/UNDIVIDED



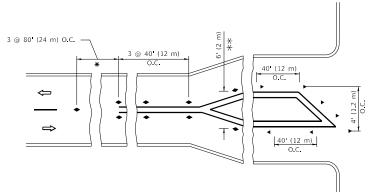

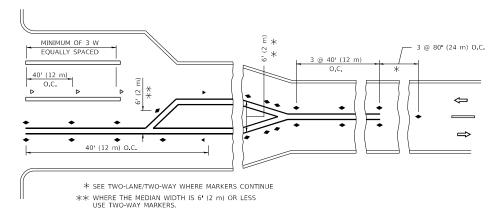

TURN LANES

GENERAL NOTES

- MARKERS USED WITH DASHED LINES SHALL BE CENTERED IN THE GAP BETWEEN SEGMENTS.
- 2. MARKERS USED ADJACENT TO SOLID LINES SHALL BE OFFSET 2 TO 3 (50 TO 75) TOWARD TRAFFIC AS SHOWN.
- MARKERS THROUGH TANGENTS LESS THAN 500' (150 m) IN LENGTH BETWEEN CURVES SHALL BE INSTALLED AT THE LESSER OF THE TWO CURVE SPACINGS.
- 4. MARKERS ARE TO BE USED ADJACENT TO BOTH SOLID WHITE LINES IN DUAL LEFT TURN LANES

LANE MARKER NOTES

- A. USE DOUBLE LANE LINE MARKERS SPACED AS SHOWN.
- B. REDUCE TO 40' (12 m) O.C. ON CURVES WHERE ADVISORY SPEEDS ARE 10 M.P.H (20 km/h) LOWER THAN POSTED SPEEDS.

DESIGN NOTES

- 1. DOUBLE LANE LINE MARKERS SHALL BE USED UNLESS SPECIFIED OTHERWISE.
- 2. EXCEPT AS SHOWN ON THE LANE REDUCTION TRANSITION AND FREEWAY EXIT RAMP DETAIL, MARKERS ARE NOT TO BE SPECIFIED ON RIGHT EDGE LINES.
- 3. THE EXACT MARKER LIMITS, SPACING, AND COLOR SHALL BE INCLUDED IN THE PLANS WHEN STANDARD SPECIFICATIONS ARE NOT BEING USED.
- MARKERS SHOULD NOT BE USED ALONGSIDE CURBS EXCEPT FOR EXTREMELY SHORT SECTIONS OF CURBS WHERE NOT MORE THAN TWO MARKERS WOULD BE INVOLVED.

All dimensions are in inches (millimeters) unless otherwise shown.

STATE OF ILLINOIS
DEPARTMENT OF TRANSPORTATION

TYPICAL APPLICATIONS
RAISED REFLECTIVE PAVEMENT MARKERS (SNOW-PLOW RESISTANT)

SCALE: NONE SHEET 1 OF 1 SHEETS STA. TO STA.

SYMBOLS

ONE-WAY AMBER MARKER

TWO-WAY AMBER MARKER

ONE-WAY CRYSTAL MARKER (W/O)

YELLOW STRIPE


■ WHITE STRIPE


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- III

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TYPE OF MARKING WIDTH OF LINE PATTERN SPACING / REMARKS COLOR CENTERLINE ON 2 LANE PAVEMENT SKIP-DASH YELLOW 10' (3 m) LINE WITH 30' (9 m) SPACE SOLID YELLOW 11 (280) C-C NO PASSING ZONE LINES: FOR ONE DIRECTION FOR BOTH DIRECTIONS YELLOW YELLOW **4 (100)** 2 @ 4 (100) OMIT SKIP-DASH CENTERLINE BETWEEN LANE LINES SKIP-DASH 10' (3 m) LINE WITH 30' (9 m) SPACE 4 (100) 5 (125) ON FREEWAYS SKIP-DASH DOTTED LINES (EXTENSIONS OF CENTER, LANE OR TURN LANE MARKINGS) SAME AS LINE BEING EXTENDED SKIP-DASH SAME AS LINE BEING EXTENDED 2 (600) LINE WITH 6 (1.8 m) SPACE EDGE LINES SOLID OUTLINE MEDIANS IN YELLOW 4 (100) YELLOW-LEFT WHITE-RIGHT 6 (150) LINE; FULL SIZE LETTERS & SYMBOLS (8' (2.4m) TURN LANE MARKINGS SOLID SEE TYPICAL TURN LANE MARKING DETAIL 10' (3 m) LINE WITH 30' (9 m) SPACE FOR SKIP-DASH; 5½ (140) C-C BETWEEN SOLID LINE AND SKIP-DASH LINE SEE TYPICAL TWO-WAY LEFT TURN MARKING DETAIL TWO WAY LEFT TURN MARKING 2 @ 4 (100) EACH DIRECTION YELLOW 8' (2.4m) LEFT ARROW 2 @ 6 (150) 12 (300) @ 45° 12 (300) @ 90° CROSSWALK LINES (PEDESTRIAN) A. DIAGONALS (BIKE & EOUESTRIAN) NOT LESS THAN 6 (1.8 m) APART . LONGITUDINAL BARS (SCHOOL) SOLID WHITE ' (600) APART SEE TYPICAL CROSSWALK MARKING DETAILS. PLACE 4 (1.2 m) IN ADVANCE OF AND PARALLEL TO CROSSWALK, IF PRESENT, OTHERWISE, PLACE AT DESIRED STOPPING POINT, PARALLEL TO CROSSROAD CENTERLINE, WHERE POSCELS IS STOP LINES 24 (600) SOLID WHITE PAINTED MEDIANS SOLID 11 (280) C-C FOR THE DOUBLE LINE SEE TYPICAL PAINTED MEDIAN MARKING. 2 @ 4 (100) WITH 12 (300) DIAGONALS YELLOW: TWO WAY TRAFFIC WHITE: ONE WAY TRAFFIC @ 45° NO DIAGONALS USED FOR 4' (1.2 m) WIDE MEDIANS DIAGONALS: 15' (4.5 m) C-C (LESS THAN 30MPH (50 km/h)) 20' (6 m) C-C 30MPH (50 km/h) TO 45MPH (70 km/h)) 30' (9 m) C-C (OVER 45MPH (70 km/h)) 24 (600) TRANSVERSE LINES; "RR" IS 6' (1.8 m) LETTERS; 16 (400) LINE FOR "X" RAILROAD CROSSING SOLID WHITE SEE STATE STANDARD 780001 AREA OF: "R"=3.6 SQ. FT. (0.33 m FEACH "X"=54.0 SQ. FT. (5.0 m)2 50' (15 m) C-C (LESS THAN 30MPH (50 km/h)) 75' (25 m) C-C (30 MPH (50 km/h) TO 45MPH (70 km/h)) 150' (45 m) C-C (OVER 45MPH (70 km/h)) SHOULDER DIAGONALS (REQUIRED FOR 12 (300) @ 45° SOLID WHITE - RIGHT YELLOW - LEFT SHOULDERS > 8') U TURN ARROW SEE DETAIL SOLID WHITE 2 ARROW COMBINATION SOLID 30.4 SF

FOR FURTHER DETAILS ON PAVEMENT MARKING REFER TO STANDARD SPECIFICATIONS FOR ROAD AND BRIDGE CONSTRUCTION AND STATE STANDARD 780001.

SCALE: NONE

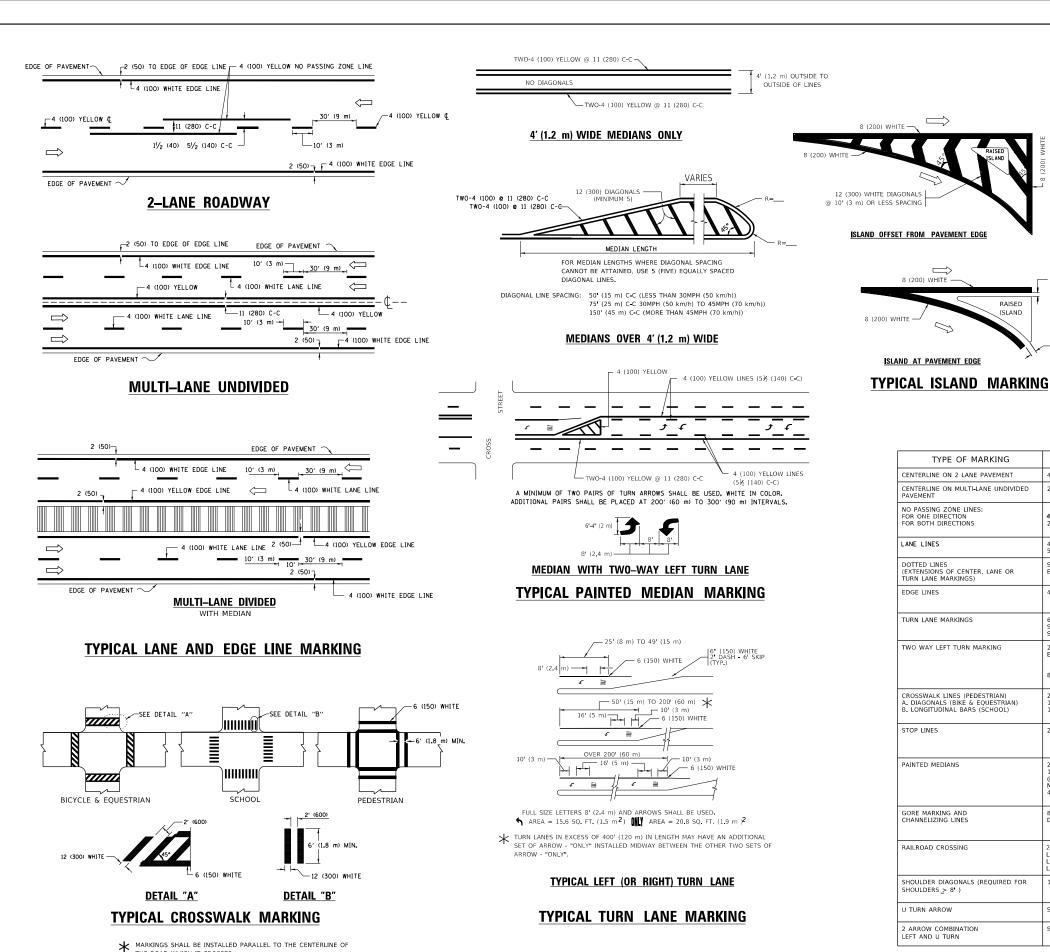RAISED

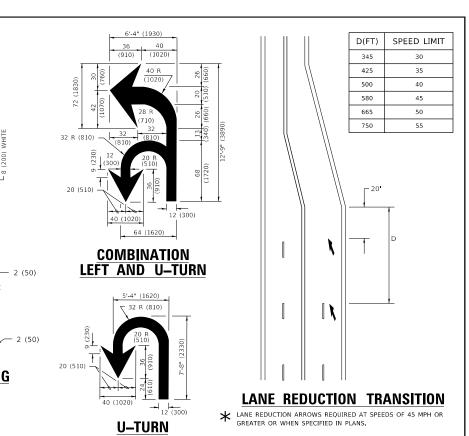
ISLAND

JSER NAME = footem DESIGNED -EVERS C. JUCIUS 09-09-09 DRAWN REVISED C. JUCIUS 07-01-13 HECKED REVISED C. JUCIUS 12-21-15 DATE

THE ROAD WHICH IT CROSSES

STATE OF ILLINOIS **DEPARTMENT OF TRANSPORTATION**

SECTION DISTRICT ONE FAP 0330 22 BJ3 COOK 23 21 TYPICAL PAVEMENT MARKINGS TC-13 CONTRACT NO. 62T05 OF 2 SHEETS STA TO STA. SHEET 1

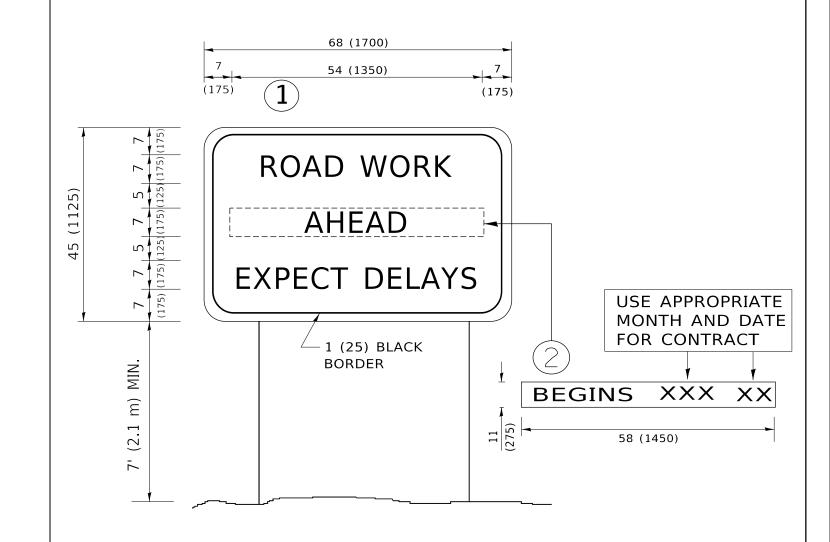


NOTES:

- 1. USE BLACK LETTERING ON ORANGE BACKGROUND.
- 2. ERECT SIGNS IN ADVANCE OF THE LOCATION FOR THE "ROAD CONSTRUCTION AHEAD" SIGN AT LOCATIONS AS DIRECTED BY THE ENGINEER.
- 3. ERECT SIGN 1 WITH INSTALLED PANEL 2 ONE WEEK PRIOR TO THE START OF CONSTRUCTION.
- 4. REMOVE PANEL(2)SOON AFTER THE START OF CONSTRUCTION.
- 5. SEE SPECIAL PROVISION FOR "TEMPORARY INFORMATION SIGNING" FOR ADDITIONAL INFORMATION.
- 6. ONE SIGN ASSEMBLY EQUALS 25.70 SQ. FT. (2.3 SQ. M.)
- 7. SHALL BE PAID FOR AS TEMPORARY INFORMATION SIGNING.

ALL DIMENSIONS ARE IN INCHES (MILLIMETERS) UNLESS OTHERWISE SHOWN.

USER NAME = footemj	DESIGNED -	REVISED - R. MIRS 09-15-97		ARTERIAL ROAD INFORMATION SIGN			F.A. RTF	SECTION	COUNTY	TOTAL	SHEET	
	DRAWN -	REVISED - R. MIRS 12-11-97	STATE OF ILLINOIS 9 DEPARTMENT OF TRANSPORTATION				330	FAP 0330 22 BJ3	COOK	23	22	
PLOT SCALE = 50.0000 ' / in.	CHECKED -	REVISED -T. RAMMACHER 02-02-99						TC-22	CONTRAC	.T NO. €	2T05	
PLOT DATE = 3/4/2019	DATE -	REVISED - C. JUCIUS 01-31-07		SCALE: NONE	SHEET 1 OF 1 SHEETS	STA.	TO STA.		ILLINOIS FED. AI	D PROJECT		

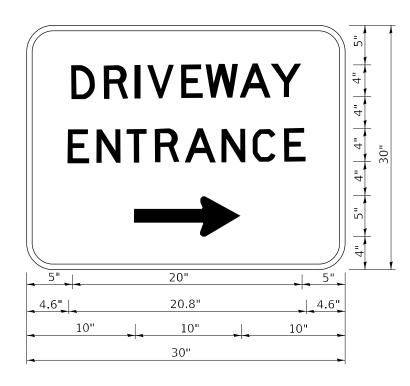

3.0" RADIUS, 0.5" BORDER, WHITE ON GREEN; REFLECTORIZED "DRIVEWAY" D; "ENTRANCE" D; STANDARD ARROW CUSTOM 12.0" x 5.0"

NOTES:

- 1. HALF OF THE SIGNS WILL REQUIRE A LEFT HAND FACING ARROW.
- 2. TWO SIGNS SHALL BE USED AT EACH COMMERCIAL ENTRANCE PLACED BACK-TO-BACK: ONE WITH A RIGHT HAND ARROW (SHOWN) SHALL BE PLACED ON THE NEAR RIGHT SIDE THE DRIVEWAY AND ONE WITH A LEFT HAND ARROW SHALL BE PLACED ON THE FAR LEFT SIDE OF THE DRIVEWAY.
- 3. SIGNS TO BE PAID FOR AS ITEM "TEMPORARY INFORMATION SIGNING".

USER NAME = leysa	DESIGNED -	REVISED	-	C. JUCIUS 02-15-07
	DRAWN -	REVISED	-	
PLOT SCALE = 50.0000 / in.	CHECKED -	REVISED	-	
PLOT DATE = 8/6/2021	DATE -	REVISED	-	

STATE OF ILLINOIS DEPARTMENT OF TRANSPORTATION