
# STATE OF ILLINOIS DEPARTMENT OF TRANSPORTATION

### 

D-91-225-22


THIS IMPROVEMENT IS LOCATED IN CITY OF WOODSTOCK

FOR INDEX OF SHEETS, SEE SHEET NO. 2

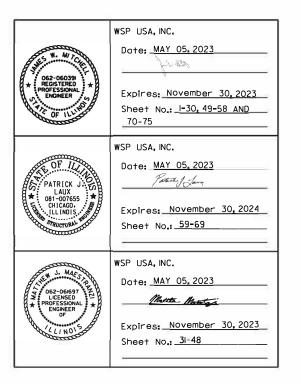

FUNCTIONAL CLASSIFICATION
OTHER PRINCIPAL ARTERIAL
2019 ADT = 5400

POSTED SPEED = 55 DESIGN SPEED = 60

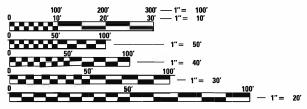

FULL SIZE PLANS HAVE BEEN PREPARED USING STANDARD ENGINEERING SCALES. REDUCED SIZED PLANS WILL NOT CONFORM TO STANDARD SCALES. IN MAKING MEASUREMENTS ON REDUCED PLANS, THE ABOVE SCALES MAY BE USED.

J.U.L.I.E.
JOINT UTILITY LOCATION INFORMATION FOR EXCAVATION
1-800-892-0123
OR 811


PROJECT ENGINEER: DANIEL WILGREEN, PE (847) 705–4240
PROJECT MANAGER: FAWAD AQUEEL, PE

CONTRACT NO. 62T01

# PROPOSED HIGHWAY PLANS

F.A.P. ROUTE 326 IL 47
AT NIPPERSINK CREEK
SECTION FAP 0326 22 BJ
PROJECT: NHPP-44PP(722)
BRIDGE JOINT REPLACE/REPAIR, BRIDGE DECK
OVERLAY
MCHENRY COUNTY


C-91-278-22

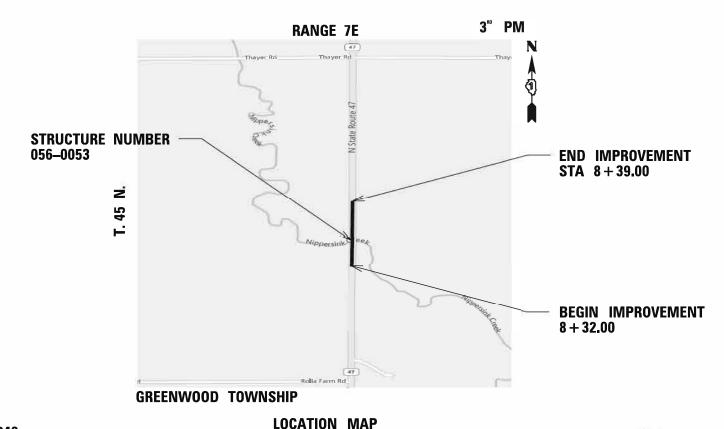


NOT TO SCALE

GROSS LENGTH = 457.00 FT. = 0.087 MILE

NET LENGTH = 457.00 FT. = 0.087 MILE

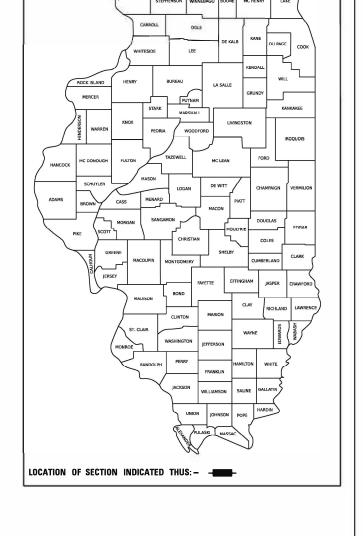

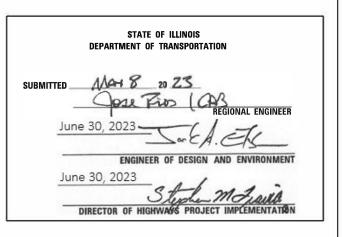

PRINTED BY THE AUTHORITY OF THE STATE OF ILLINOIS

CHICAGO, IL 60602

### **INDEX OF SHEETS**

COVER SHEET

1

## **HIGHWAY STANDARDS**

STANDARD SYMBOLS, ABBREVIATIONS AND PATTERNS

2	INDEX OF SHEETS, STANDARDS AND COMMITMENTS	001001-02	AREAS OF REINFORCEMENT BARS
3-7	SUMMARY OF QUANTITIES	001006	DECIMAL OF AN INCH AND OF A FOOT
8-10	TYPICAL SECTIONS	631033-09	TRAFFIC BARRIER TERMINAL, TYPE 6B
11-13	SCHEDULE OF QUANTITIES	701001-02	OFF-ROAD OPERATIONS, 2L, 2W, MORE THAN 15' (4.5M) AWAY
14	ALIGNMENTS, TIES AND BENCHMARKS	701006-05	OFF-ROAD OPERATIONS, 2L, 2W, 15' (4.5M) TO 24' (600MM) FROM PAVEMENT EDGE
15-27	MAINTENANCE OF TRAFFIC	701011-04	OFF-ROAD MOVING OPERATIONS, 2L, 2W, DAYS ONLY
28-30	PAVEMENT MARKING PLANS	701201-05	LANE CLOSURE, 2L, 2W, DAY ONLY, FOR SPEED >= 45MPH
31-40	TEMPORARY SIGNAL PLANS	701206-05	LANE CLOSURE, 2L, 2W, NIGHT ONLY, FOR SPEED >= 45MPH
41-48	TEMPORARY LIGHTING PLAN	701301-04	LANE CLOSURE, 2L, 2W, SHORT TIME OPERATIONS
49-51	REMOVAL PLANS	701311-03	LANE CLOSURE, 2L, 2W MOVING OPERATIONS - DAY ONLY
52-54	ROADWAY PLANS	701901-08	TRAFFIC CONTROL DEVICES
55	ROADWAY PROFILE	704001-08	TEMPORARY CONCRETE BARRIER
56-58	EROSION CONTROL	782006-01	GUARDRAIL AND BARRIER WALL REFLECTOR MOUNTING DETAILS
59-69	STRUCTURAL PLANS	BD-01	DRIVEWAY DETAILS - DISTANCE BETWEEN R.O.W AND FACE OF CURB & EDGE OF SHOULDER >=15' (4.5m
70-75	CONSTRUCTION DETAILS	BD-32	BUTT JOINT AND HMA TAPER DETAILS
		BE-800	TEMPORARY LIGHT POLE
		BE-801	TEMPORARY AERIAL CABLE INSTALLATION
		BE-805	TEMPORARY LIGHTENING AND TRAFFIC SIGNALS FOR SINGLE LANE STAGING
		TC-10	TRAFFIC CONTROL AND PROTECTION FOR SIDE ROADS, INTERSECTIONS, AND DRIVEWAYS
		TC-11	RAJSED REFLECTIVE PAVEMENT MARKERS (SNOW PLOW RESISTANT)
		TC-13	DISTRICT ONE TYPICAL PAVEMENT MARKINGS
		TC-22	ARTERIAL ROAD INFORMATION SIGN
		TC-26	DRIVEWAY ENTRANCE SIGNING
		TS-05	STANDARD TRAFFIC SIGNAL DESIGN DETAILS

000001-08

## **GENERAL NOTES**

- 1. ANY PAVEMENT MARKINGS AND RAISED REFLECTIVE PAVEMENT MARKERS OBLITERATED BY MILLING AND RESURFACING OPERATIONS ON SIDE STREETS AND ENTRANCES SHALL BE REPLACED AND PAID FOR IN KIND.
- 2. ALL DAMAGE TO EXISTING PAVEMENT MARKINGS OR RAISED REFLECTIVE PAVEMENT MARKERS OUTSIDE THE REMOVAL LINE SHOWN ON THE PLANS SHALL BE REPLACED AT NO ADDITIONAL COST TO THE DEPARTMENT.
- 3. BEFORE BEGINNING ANY WORK, THE CONTRACTOR SHALL RETAIN AND RECORD FOR FUTURE REFERENCE, ALL EXISTING PAVEMENT MARKING LINES (AND RAISED REFLECTIVE PAVEMENT MARKERS) IN ORDER THAT THESE LOCATIONS CAN BE RE-ESTABLISHED FOR STRIPING. EXACT LOCATIONS OF ALL PAVEMENT MARKINGS SHALL BE AS DIRECTED BY THE ENGINEER.
- 4. THE CONTRACTOR SHALL CONTACT THE DISTRICT ONE ARTERIAL TRAFFIC CONTROL SUPERVISOR AT KALPANA.KANNAN-HOSADURGA@ILLINOIS.GOV, AND MCHENRY COUNTY, PUBLIC WORKS (815) 363-2186.
- 5. AT LEAST TWO WEEKS PRIOR TO PLACEMENT OF PERMANENT PAVEMENT MARKINGS THE RESIDENT ENGINEER SHALL CONTACT WALTER CZARNY, ARTERIAL TRAFFIC ENGINEER, VIA EMAIL AT WALTER.CZARNY@ILLINOIS.GOV
- 6. THE THICKNESS OF THE HMA MIXTURE SHOWN ON THE PLANS IS THE NOMINAL THICKNESS.

  DEVIATIONS FROM THE NOMINAL THICKNESS WILL BE PERMITTED WHEN SUCH DEVIATIONS OCCUR

  DUE TO IRREGULARITIES IN THE EXISTING SURFACE OR BASE ON WHICH THE HMA MIXTURE IS PLACED.
- 7. THE CONTRACTOR SHALL BE RESPONSIBLE FOR THE NOTIFICATION OF ALL EMERGENCY SERVICES, SCHOOL DISTRICTS, I.D.O.T.'S COMMUNICATIONS CENTER, SPRINGFIELD TRUCK PERMIT SECTION AND OTHER AGENCIES AFFECTED BY THE CLOSURE. THE CONTRACTOR SHALL ALSO BE RESPONSIBLE FOR POSTING SIGNS THAT WILL INDICATE THE DATES THE CLOSURE WILL BE IN PLACE.
- 8. DO NOT SCALE PLANS FOR CONSTRUCTION DIMENSIONS.
- 9. WHEN THE MILLED PAVEMENT IS OPEN TO TRAFFIC THE MAXIMUM GRADE DIFFERENTIAL BETWEEN PASSES OF THE MILLING MACHINE SHALL NOT EXCEED 1 1/2 INCHES (40 mm) WHERE THE SPEED LIMIT IS 40 MPH (80 km/h) OR LESS AND 1 INCH (25 mm) WHERE THE SPEED LIMIT IS GREATER THAN 40 MPH (80 km/h). WITH WRITTEN APPROVAL OF THE ENGINEER, A MAXIMUM GRADE DIFFERENTIAL OF 3 INCHES (75 mm) MAY BE ALLOWED IF THE EDGE OF THE MILLING IS SLOPED A MINIMUM 1:3 (V:H) OR A NOTCHED LONGITUDINAL WEDGE IS USED.
- 10. BUTT JOINTS WILL BE INSTALLED AT THE ENDS OF ALL RESURFACING (WHERE RESURFACING MEETS EXISTING PAVEMENT) ACCORDING TO THE "BUTT JOINT AND HOT-MIX ASPHALT TAPER DETAILS" SHEET INCLUDED IN THE PLANS, UNLESS OTHERWISE SPECIFIED.
- 11. OVERNIGHT LANE CLOSURES SHALL NOT BE ALLOWED FOR REHABILITATION PROJECTS INVOLVING DAYTIME MILLING AND RESURFACING OPERATIONS AND CLASS D PATCHING UNLESS OTHER CONDITIONS WARRANT EXTENDED LANE CLOSURES AS DETERMINED AND APPROVED IN WRITING BY THE ENGINEER OR AS PROVIDED FOR IN THE CONTRACT SPECIFICATIONS.
- 12. FOR WORK OUTSIDE THE LIMITS OF BRIDGE APPROACH PAVEMENT, ALL REFERENCES IN THE HIGHWAY STANDARDS AND STANDARD SPECIFICATIONS FOR REINFORCEMENT, DOWEL BARS AND TIE BARS IN PAVEMENT, SHOULDERS, CURB, GUTTER, COMBINATION CURB AND GUTTER AND MEDIAN, AND CHAIR SUPPORTS FOR CRC PAVEMENT, SHALL BE EPOXY COATED, UNLESS NOTED ON THE PLAN.
- THE CONTRACTOR WILL NOT BE REIMBURSED FOR ANY CHARGES, FEES, OR COSTS TO SECURE NECESSARY PERMITS. ANY COSTS INCURRED SHALL BE INCLUDED IN THE COST OF OTHER ITEMS OF THE CONTRACT.

	USER NAME = USHA669697	DESIGNED -	REVISED -
EET		DRAWN -	REVISED -
	PLOT SCALE = 40.000 / in.	CHECKED -	REVISED -
	PLOT DATE = 5/12/2023	DATE -	REVISED -

SCALE:

F.A.P RTE	SECTION	COUNTY	TOTAL SHEETS	SHEE NO.	
0326	FAP 032622 BJ	FAP 032622 BJ		75	2
			CONTRACT	NO. 6	2T01
	ILLINOIS	FED AL	D PROJECT		

DEPA

					CONSTRUCTION CODE
SPECIALTY ITEM	CODE NO.	ITEM	UNIT	TOTAL QUANTITY	STRUCTURE 056-0053  FEDERAL =80%  STATE=20%  0059  URBAN
	20200100	EARTH EXCAVATION	CU YD	81	81
	28000400	PERIMETER EROSION BARRIER	FOOT	714	714
	31101200	SUBBASE GRANULAR MATERIAL, TYPE B 4"	SQ YD	244	244
	35501308	HOT-MIX ASPHALT BASE COURSE, 6"	SQ YD	20	20
	40600290	BITUMINOUS MATERIALS (TACK COAT)	POUND	109	109
	40600982	HOT-MIX ASPHALT SURFACE REMOVAL - BUTT JOINT	SQ YD	348	348
	40603085	HOT-MIX ASPHALT BINDER COURSE, IL-19.0, N70	TON	86	86
	40604060	HOT-MIX ASPHALT SURFACE COURSE, IL-9.5, MIX "D", N50	TON	3	3
	40004000	HOT-WIX ASPRACE GOOKSE, IL-9.5, WIX D , NSO	TON	3	•
	40604062	HOT-MIX ASPHALT SURFACE COURSE, IL-9.5, MIX "D", N70	TON	102	102
	44000100	PAVEMENT REMOVAL	SQ YD	38	38
	44000156	HOT-MIX ASPHALT SURFACE REMOVAL, 1 3/4"	SQ YD	64	64
	44000200	DRIVEWAY PAVEMENT REMOVAL	SQ YD	19	19
	50102400	CONCRETE REMOVAL	CU YD	4.6	4.6
	50300255	CONCRETE SUPERSTRUCTURE	CU YD	5.6	5.6

3				
FILE WAME, L.V.	11	5	)	WSP US 30 N. LA SUITE 4 CHICAC TEL: (3° FAX: (3°

	USER NAME = USHA669697	DESIGNED -	REVISED -
REET		DRAWN -	REVISED -
0	PLOT SCALE = 40.000 / in.	CHECKED -	REVISED -
4	PLOT DATE = 5/12/2023	DATE -	REVISED -

SCALE:

						SECTION		COUNTY	TOTAL SHEETS	SHEE NO.
SUMMARY OF QUANTITIES					0326	26 FAP 032622 BJ		McHENRY	75	3
								CONTRACT	NO. 62	2T01
SHEET	OF	SHEETS	STA.	TO STA.		ILLINOIS	FED. AIC	PROJECT		

					CONSTRUCTION CODE
SPECIALTY ITEM	CODE NO.	ITEM	UNIT	TOTAL QUANTITY	STRUCTURE 056-0053  FEDERAL =80%  STATE=20%  0059  URBAN
	50300300	PROTECTIVE COAT	SQ YD	495	495
	50800205	REINFORCEMENT BARS, EPOXY COATED	POUND	770	770
	50800515	BAR SPLICERS	EACH	8	
					-
	52000110	PREFORMED JOINT SEAL STRIP SEAL	FOOT	84	84
	63100089	TRAFFIC BARRIER TERMINAL, TYPE 6B	EACH	1	1
	63200310	GUARDRAIL REMOVAL	FOOT	38	38
Y	66900200	NON-SPECIAL WASTE DISPOSAL	CU YD	81	81
Y	66900530	SOIL DISPOSAL ANALYSIS	EACH	2	2
Y	66901001	REGULATED SUBSTANCES PRE-CONSTRUCTION PLAN	L SUM	1	1
Υ	66901003	REGULATED SUBSTANCES FINAL CONSTRUCTION REPORT	L SUM	1	1
	00004000	DECULATED CURCTANOES MONITORING	OAL DA	_	
Υ	66901006	REGULATED SUBSTANCES MONITORING	CAL DA	5	5
	67000400	ENGINEER'S FIELD OFFICE, TYPE A	CAL MO	12	12
	07/00/	MODILIZATION	1 01111		
	67100100	MOBILIZATION	L SUM	1	1
	70103815	TRAFFIC CONTROL SURVEILLANCE	CAL DA	15	15

STATE OF ILLINOIS
DEPARTMENT OF TRANSPORTATION

SCALE:

 SUMMARY
 OF QUANTITIES
 FAP 032622 B

 SHEET
 OF SHEETS
 STA.
 TO STA.
 ILLINO

					CONSTRUCTION CODE STRUCTURE 056-0053
SPECIALTY	CODE NO.	ITEM	UNIT	TOTAL QUANTITY	FEDERAL =80% STATE=20%
ITEM					0059 URBAN
	70107025	CHANGEABLE MESSAGE SIGN	CAL DA	84	84
	70300150	SHORT TERM PAVEMENT MARKING REMOVAL	ORT TERM PAVEMENT MARKING REMOVAL SQ FT 2468		2468
	70307120	TEMPORARY PAVEMENT MARKING - LINE 4" - TYPE IV TAPE	FOOT	5846	5846
	70307210	TEMPORARY PAVEMENT MARKING - LINE 24"- TYPE IV TAPE	FOOT	48	48
	70400100	TEMPORARY CONCRETE BARRIER	FOOT	375	375
	70400200	RELOCATE TEMPORARY CONCRETE BARRIER	FOOT	325	325
	70600260	IMPACT ATTENUATORS, TEMPORARY (FULLY REDIRECTIVE, NARROW), TEST LEVEL 3	EACH	2	2
	70600332	IMPACT ATTENUATORS, RELOCATE (FULLY REDIRECTIVE, NARROW), TEST LEVEL 3	EACH	2	2
Y	78000200	THERMOPLASTIC PAVEMENT MARKING - LINE 4"	FOOT	1336	1336
Y	78000600	THERMOPLASTIC PAVEMENT MARKING - LINE 12"	FOOT	104	104
Y					
	78009004	MODIFIED URETHANE PAVEMENT MARKING - LINE 4"	FOOT	214	214
Y					
	78009012	MODIFIED URETHANE PAVEMENT MARKING - LINE 12"	FOOT	46	46
Y	78100100	RAISED REFLECTIVE PAVEMENT MARKER	EACH	9	9
Y	78100300	REPLACEMENT REFLECTOR	EACH	5	5

:\7762			
ILE NAME: L:\7	115	)	WSP USA Inc. 30 N. LASALLE S SUITE 4200 CHICAGO, IL 606 TEL: (312) 782-8: FAX: (312) 782-11

	USER NAME = USHA669697	DESIGNED -	REVISED -
STREET		DRAWN -	REVISED -
602 150	PLOT SCALE = 40.000 / in.	CHECKED -	REVISED -
684	PLOT DATE = 5/12/2023	DATE -	REVISED -

STATE	OF ILLINOIS	
DEPARTMENT	OF TRANSPORTATION	V

SCALE:

SUMMARY OF QUANTITIES						SECT			COUNTY  McHENRY	TOTAL SHEETS 75	SHEET NO. 5
SHEET	OF	SHEETS	STA.	TO STA.			ILLINOIS	FED. AIC	CONTRACT PROJECT	NO. 62	2T01
										REV-	-SEP

					CONSTRUCTION CODE
SPECIALTY ITEM	CODE NO.	ITEM	UNIT	TOTAL QUANTITY	STRUCTURE 056-0053  FEDERAL =80%  STATE=20%  0059  URBAN
Υ	78200011	BARRIER WALL REFLECTORS, TYPE C	EACH	6	6
	78300200	RAISED REFLECTIVE PAVEMENT MARKER REMOVAL	EACH	10	10
	78300202	PAVEMENT MARKING REMOVAL - WATER BLASTING	SQ FT	551	551
Y	89000100	TEMPORARY TRAFFIC SIGNAL INSTALLATION	EACH	1	1
	Z0001800	APPROACH SLAB REPAIR (PARTIAL DEPTH)	SQ YD	27	27
	Z0006016	BRIDGE DECK LATEX CONCRETE OVERLAY, 2 3/4 INCHES	SQ YD	390	390
	Z0012130	BRIDGE DECK SCARIFICATION 3/4"	SQ YD	390	390
	Z0012755	STRUCTURAL REPAIR OF CONCRETE (DEPTH GREATER THAN 5 INCHES)	SQ FT	13	13
	Z0016001	DECK SLAB REPAIR (FULL DEPTH, TYPE I)	SQ YD	1	1
	Z0029090	DIAMOND GRINDING (BRIDGE SECTION)	SQ YD	406	406
	70000050	THE PARTY WEST WATER VICTOR OF THE PARTY WATER VICTOR OF THE VIC			
	Z0030850	TEMPORARY INFORMATION SIGNING	SQ FT	72	72
	Z0043800	PRECAST PRESTRESSED CONCRETE I-BEAM REPAIR	SQ FT	27	27
Y	Z0073510	TEMPORARY TRAFFIC SIGNAL TIMING	EACH	1	1
	V0205740	ACDVI IO COATINO	60.7/2		
	X0325748	ACRYLIC COATING	SQ YD	11	11

L S / I

STATE OF ILLINOIS DEPARTMENT OF TRANSPORTATION

SCALE:

SUMMARY OF QUANTITIES

SHEET OF SHEETS STA. TO STA.

	1	T	1		CONSTRUCTION CODE STRUCTURE 056-0053				
					FEDERAL =80%				
SPECIALTY ITEM	CODE NO.	ITEM	UNIT	TOTAL QUANTITY	STATE=20%				
11 - 11					0059				
					URBAN				
	X0325749	FIBER WRAP	SQ FT	99	99				
	X0326276	TEMPORARY LIGHTING FOR SINGLE LANE STAGING	L SUM	1	1				
	X5060700	LEANING AND PAINTING BEARINGS		14	14				
	X4021000	TEMPORARY ACCESS (PRIVATE ENTRANCE)	EACH	1	1				
	X5030250	BRIDGE DECK GROOVING (LONGITUDINAL)	SQ YD	234	234				
5	Z0076600	TRAINEES	HOURS	500	500				
	X7010216	TRAFFIC CONTROL AND PROTECTION, (SPECIAL)	L SUM	1	1				
5	Z0076604	TRAINEES -TRAINING PROGRAM GRADUATE	HOURS	500	500				

Ø 0042 COUNTY TOTAL SHEET NO.

McHENRY 75 7 CONTRACT NO. 62T01

F.A.P RTE. 0326

TO STA.


**SUMMARY OF QUANTITIES** 

SHEET OF SHEETS STA.

SECTION

FAP 032622 BJ

SCALE:

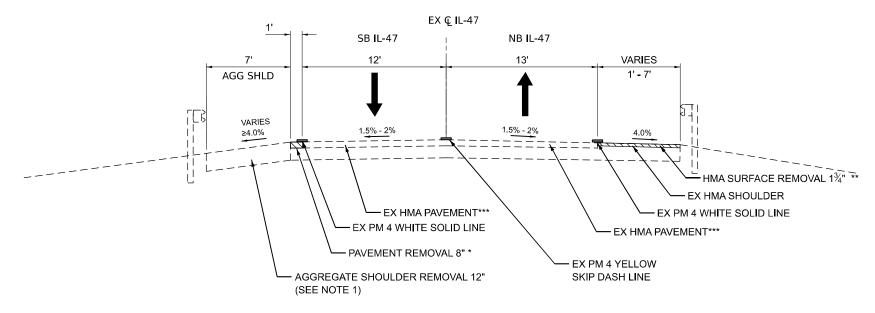

# EXISTING IL-47 ROAD TYPICAL SECTION

STA 3+81.77 TO 6+10.94 STA 6+99.72 TO 8+38.54

\* 1' WIDE: STA 4+22.00 TO 5+97.28 & STA 7+13.39 TO 8+70.00

\*\* 8' WIDE: STA 5+59.41 TO 5+97.09


\*\* 7' WIDE: STA 7+13.34 TO 7+50.91

\*\*\* EX CONCRETE PAVEMENT STA 5+59.56 TO 6+10.94 & STA 6+99.72 TO 7+51.01

#### IOTES:

- 1) AGGREGATE SHOULDER REMOVAL 12" SHALL BE PAID FOR AS EARTH EXCAVATION.
- 2) EXISTING AGGREGATE SHOULDER SLOPE VARIES AND IS STEEPER THAN 4% IN MOST LOCATIONS DUE TO EROSION OF THE SHOULDER. DEPTH OF EXCAVATION SHALL BE DETERMINED IN THE FIELD BASED ON EXISTING CONDITIONS. CONTRACTORS SHALL EXCAVATE THE MINIMUM AMOUNT OF MATERIAL REQUIRED TO INSTALL THE PROPOSED PAVED SHOULDER SECTION.

USER NAME = USHA669697	DESIGNED -	REVISED -	STATE OF ILLINOIS  TYPICAL SECTION  FA.  ATTE				F.A.IL	SECTION	COUNTY	TOTAL	SHEET
	DRAWN -	REVISED -					47	FAP 032622 BJ	McHENRY	75	8
PLOT SCALE = 8.000 / in.	CHECKED -	REVISED -	DEPARTMENT OF TRANSPORTATION						CONTRAC	TNO. 6	52T01
PLOT DATE = 5/3/2023	DATE 05/05/2023	REVISED -		SCALE: 1/4" = 1'	SHEET 1 OF 2 SHEETS ST	A. TO STA.		ILLINOIS FED. A	ID PROJECT		

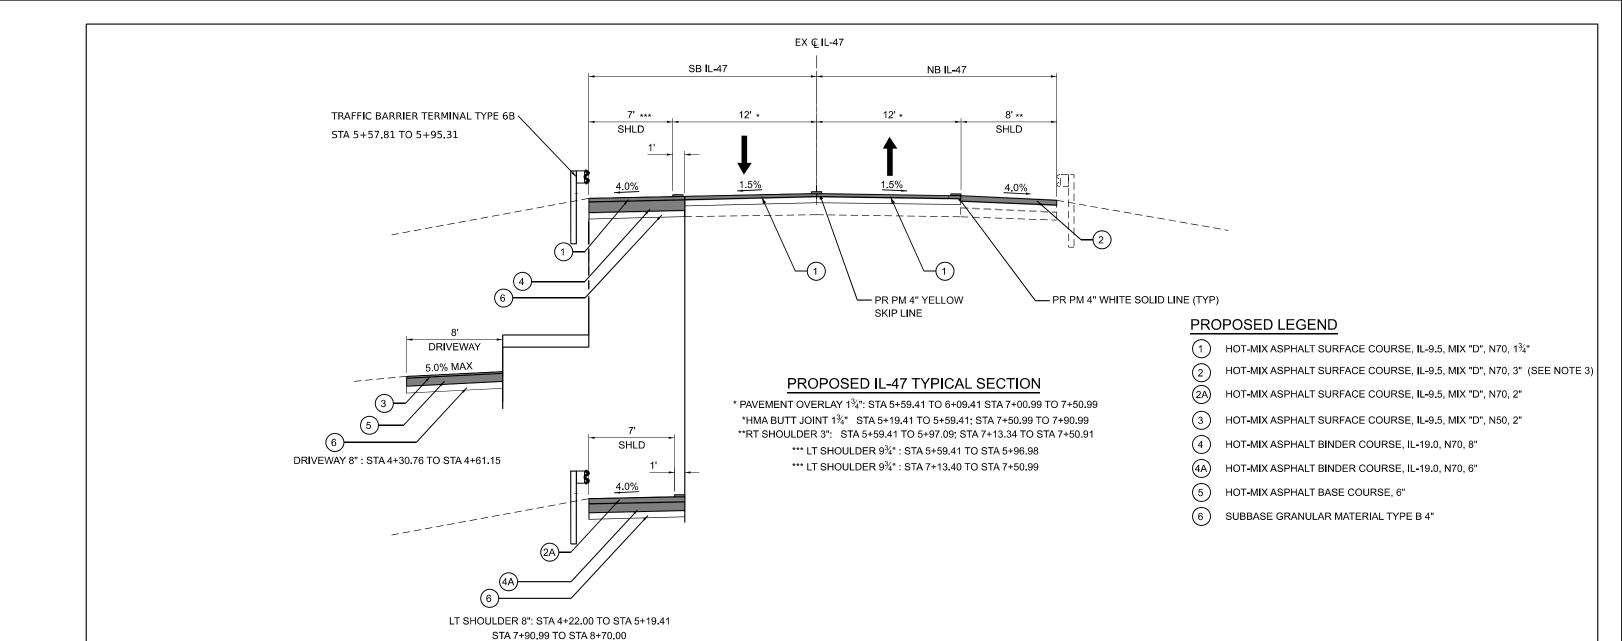


	HOT-MIX ASPHALT MIXTURE REQUIREMENTS								
	MIXTURE TYPE	AIR VOIDS N <sub>DES</sub>	QMP						
PAVEMENT OVERLAY 1¾"	HOT-MIX ASPHALT SURFACE COURSE, IL-9.5, MIX "D", N70, 1¾"	4% @ 70 Gyr.	QC/QA						
RT SHOULDER 3"	HOT-MIX ASPHALT SURFACE COURSE, IL-9.5, MIX "D", N70, 3"	4% @ 70 Gyr.							
LT SHOULDER 9¾"	HOT-MIX ASPHALT SURFACE COURSE, IL-9.5, MIX "D", N70, 1¾"	4% @ 70 Gyr.	QC/QA						
1. 6.1.6.61.51.4	HOT-MIX ASPHALT BINDER COURSE, IL-19.0, N70, 8"	4% @ 70 Gyr.	QC/QA						
LT SHOULDER 8"	HOT-MIX ASPHALT SURFACE COURSE, IL-9.5, MIX "D", N70, 2"	4% @ 70 Gyr.	QC/QA						
	HOT-MIX ASPHALT BINDER COURSE, IL-19.0, N70, 6"	4% @ 70 Gyr.	QC/QA						
DDIVEWAY OIL	HOT-MIX ASPHALT SURFACE COURSE, IL-9.5, MIX "D", N50, 2"	4% @ 50 Gyr.	QC/QA						
DRIVEWAY 8"	HOT-MIX ASPHALT BASE COURSE, 6" (HMA BINDER IL-19.0)	4% @ 50 Gyr.	QC/QA						
QMP DESIGNATION: QUALITY CONTROL/QUALITY ASSURANCE (QC/QA); QUALITY CONTROL FOR PERFORMANCE (QCP)									

# **NOTES**

- 1. THE UNIT WEIGHT USED TO CALCULATE ALL HOT-MIX ASPHALT SURFACE MIXTURE QUANTITIES IS 112 LBS/SQ YD/IN.
- 2. THE AC TYPE FOR NON-POLYMERIZED SHALL BE "PG 64-22" UNLESS MODIFIED BY RECLAIMED MATERIALS SPECIFICATIONS.
- 3. HOT-MIX ASPHALT SURFACE COURSE, IL-9.5, MIX "D", N70, 3" SHALL BE CONSTRUCTED IN TWO 1.5 INCH LIFTS.

USER NAME = WangS	DESIGNED -	REVISED -		TYPICAL SECTION		F.A. IL RTF	SECTION	COUNTY TOTAL SHEET
	DRAWN -	REVISED -	STATE OF ILLINOIS			47	FAP 032622 BI	McHENRY 75 9
PLOT SCALE = 8.000 '/in.	CHECKED -	REVISED -	DEPARTMENT OF TRANSPORTATION					CONTRACT NO. 62T01
PLOT DATE = 5/10/2023	DATE -	REVISED -		SCALE: 1/4" = 1' SHEET 2 OF 2 SHEETS STA.	TO STA.	ILLINOIS FED. AID PROJECT		

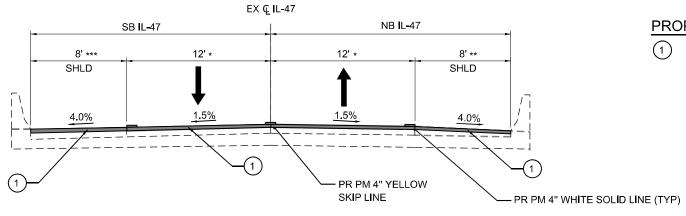

# PROPOSED LEGEND

) HOT-MIX ASPHALT SURFACE COURSE, IL-9.5, MIX "D", N70, 1¾"

PROPOSED IL-47 TYPICAL SECTION

\*\* RT PAVEMENT OVERLAY 1¾": STA 5+97.09 TO 6+09.41; STA 7+00.99 TO STA 7+13.34

\*\*\* LT PAVEMENT OVERALY  $1\frac{3}{4}$ ": STA 5+96.98 TO 6+09.41; STA 7+00.99 TO STA 7+13.40

STATE OF ILLINOIS DEPARTMENT OF TRANSPORTATION

\CAD\!Sheets\MOT\D162T01-sht- PR SECTION.-TYP01 .dgn

31101200	SUBBASE GRANULAR I							
LOCATION	STATION	STATION	SQ FT	SQ YD				
EX CL IL 47 SB OUTSIDE SHOULDER	4+22.00	5+19.41	777	87				
EX CL IL 47 SB OUTSIDE SHOULDER	5+59.41	5+96.98	300	34				
EX CL IL 47 SB OUTSIDE SHOULDER	7+13.40	7+50.99	300	34				
EX CL IL 47 SB OUTSIDE SHOULDER	7+90.99	8+70.00	629	70				
EX CL IL 47 NB DRIVEWAY	4+30.76	4+61.15	170	19				
TOTAL	TOTAL							

35501308	HOT-MIX ASPHALT BAS	SE COURSE, 6"					
LOCATION	STATION	STATION	SIDE (LT/RT)	SYD			
EX CL IL 47 SB DRIVEWAY	4+30.76	4+61.15	LT	20			
TOTAL							

40603085	HOT-MIX ASPHALT BINI	DER COURSE, IL-19.0	, N70			
					UNIT WEIGHT	
LOCATION	STATION	STATION	SQ YD	DEPTH (INCH)	(LBS/SYD/IN)	VOLUME (TON)
EX CL IL 47 SB OUTSIDE SHOULDER	4+22.00	5+19.41	87	6	112	30
EX CL IL 47 SB OUTSIDE SHOULDER	5+59.41	5+96.98	34	8	112	16
EX CL IL 47 SB OUTSIDE SHOULDER	7+13.40	7+50.99	34	8	112	16
EX CL IL 47 SB OUTSIDE SHOULDER	7+90.99	8+70.00	70	6	112	24
					TOTAL	86

40604062	HOT-MIX ASPHALT SU	RFACE COURSE, IL-9.5	5, MIX "D", N70			
					UNIT WEIGHT	
LOCATION	STATION	STATION	SQ YD	DEPTH (INCH)	(LBS/SYD/IN)	VOLUME (TON)
EX CL IL 47	5+19.41	5+59.41	174	1 1/2	112	15
EX CL IL 47	7+50.99	7+90.99	174	1 1/2	112	15
EX CL IL 47	5+59.41	6+09.41	128	1 3/4	112	13
EX CL IL 47	7+00.99	7+50.99	128	1 3/4	112	13
EX CL IL 47 LT	5+96.98	6+09.41	13	1 3/4	112	2
EX CL IL 47 RT	5+97.09	6+09.41	11	1 3/4	112	2
EX CL IL 47 LT	7+00.99	7+13.40	12	1 3/4	112	2
EX CL IL 47 RT	7+00.99	7+13.34	12	1 3/4	112	2
EX CL IL 47 SB OUTSIDE SHOULDER	4+22.00	5+19.41	87	2	112	10
EX CL IL 47 SB OUTSIDE SHOULDER	5+59.41	5+96.98	34	1 3/4	112	4
EX CL IL 47 SB OUTSIDE SHOULDER	7+13.40	7+50.99	34	1 3/4	112	4
EX CL IL 47 SB OUTSIDE SHOULDER	7+90.99	8+70.00	70	2	112	8
EX CL IL 47 NB OUTSIDE SHOULDER	5+59.41	5+97.09	34	3	112	6
EX CL IL 47 NB OUTSIDE SHOULDER	7+13.34	7+50.99	34	3	112	6
	•				TOTAL	102

40600982 HOT-MIX ASPHALT SURFACE REMOVAL - BUTT JOINT					
LOCATION	STATION	STATION	SQ FT	SQ YD	
EX CL IL 47	5+19.41	5+59.41	1560	174	
EX CL IL 47	7+50.99	7+90.99	1560	174	
_	·	-	TOTAL	348	

40604060 HOT-MIX ASPHALT SURFACE COURSE, IL-9.5, MIX "D", N50								
LOCATION	STATION	STATION	SIDE (LT/RT)	DEPTH (INCH)	VOLUME (TON)			
EX CL IL 47 SB DRIVEWAY	4+30.76	4+61.15	LT	2	3			
TOTAL								

44000100	PAVEMENT REMOV	PAVEMENT REMOVAL						
LOCATION	STATION	STATION	SQ FT	SQ YD				
EX SB	4+22.00	5+97.28	175.28	20				
EX SB	7+13.39	8+70.00	156.61	18				
			TOTAL	38				

44000156	HOT-MIX ASPHALT	DT-MIX ASPHALT SURFACE REMOVAL, 1 3/4"					
LOCATION	STATION	STATION	WIDTH	SQ FT	SQ YD		
NB IL47	5+59.41	5+97.09	8	302	34		
NB IL47	7+13.34	7+50.91	7	263	30		
				TOTAL	64		

44000200	DRIVEWAY PAVEM	IENT REMOVAL		
LOCATION	STATION	STATION	SQ FT	SQ YD
EX CL IL 47 SB DRIVEWAY	4+30.76	4+61.15	170	19
		-	TOTAL	19

	WSP USA Inc.	
11711	30 N, LASALLE STREET SUITE 4200	
	CHICAGO, IL 60602 TEL: (312) 782-8150	
•	FAX: (312) 782-1684	Г

	USER NAME = USHA669697	DESIGNED -	REVISED -
REET		DRAWN -	REVISED -
,	PLOT SCALE = 40.000 / in.	CHECKED -	REVISED -
1	PLOT DATE = 5/5/2023	DATE 05/05/2023	REVISED -

	SCHEDILLE OF CHANTITIES					F.A.P RTE	SEC	TION		COUNTY	TOTAL SHEETS	SHEET NO.	
						0326	FAP 03	2622 BJ		McHENRY	75	10	
											CONTRACT	NO. 6	2T01
	SCALE:	SHEET	OF	SHEETS	STA.	TO STA.			ILLINOIS	FED. Al	D PROJECT		

70400200 RELOCATE TEMPORARY CONCRETE BARRIER									
LOCA	ATION	STATION	STATION	LT/CL/RT	FOOT				
	STAGE 2								
				_					
	=	-	-	-	-				
IL 47_NB	-	4+92.12	8+16.34	LT LT	325				

78009004	MODIFIED URETHANE	PAVEMENT MARKING	i - LINE 4"		
LOCATION	STATION	STATION	LT/CL/RT	DESCRIPTION	FOOT
IL 47_SB DECK	6+09.41	7+00.99	LT	SOLID WHITE	92
IL 47_NB DECK	6+09.41	7+00.99	RT	SOLID WHITE	92
IL 47 DECK	6+09.41	7+00.99	CL	SKIP YELLOW	30
				TOTAL	214

78000600	THERMOPLASTIC PAV	EMENT MARKING - LIN	NE 12"		
LOCATION	STATION	STATION	LT/CL/RT	DESCRIPTION	FOOT
IL 47_SB	3+81.77	6+09.41	LT	SOLID WHITE 45 DEG	46
IL 47_SB	7+00.99	8+70.00	LT	SOLID WHITE 45 DEG	35
IL 47_NB	5+39.41	6+09.41	RT	SOLID WHITE 45 DEG	12
IL 47_NB	7+00.99	7+70.91	RT	SOLID WHITE 45 DEG	12
			•	TOTAL	104

78009012 MODIFIED URETHANE PAVEMENT MARKING - LINE 12"				<u> </u>	
LOCATION	STATION	STATION	LT/CL/RT	DESCRIPTION	FOOT
IL 47_SB	6+09.41	7+00.99	LT	SOLID WHITE 45 DEG	23
IL 47_NB	6+09.41	7+00.99	LT	SOLID WHITE 45 DEG	23
				TOTAL	46

78300202		PAVEMENT MARI	KING REMOVAL - WAT	ER BLASTING	
LOCATION	STATION	STATION	LT/CL/RT	WIDTH (INCH)	SQ FT
		PRE STAGE			
IL 47	3+30.00	10+00.00	LT	4	224
IL 47	4+22.00	8+38.54	RT	4	139
IL 47		2+63.48	CL	4	84
IL 47	2+63.48	10+00.00	CL	4	62
IL 47	10+00.00	-	CL	4	42
				TOTAL	551

i		WSP USA Inc.	ι
	<b>///////</b>	30 N. LASALLE STREET SUITE 4200	
		CHICAGO, IL 60602 TEL: (312) 782-8150	F
		FAX; (312) 782-1684	-

	USER NAME = USHA669697	DESIGNED -	REVISED -
EET		DRAWN -	REVISED -
	PLOT SCALE = 40.000 / in.	CHECKED -	REVISED -
	PLOT DATE = 6/21/2023	DATE -	REVISED -

						F.A.P RTE	SECTION		COUNTY	TOTAL SHEETS	
	SCF	IEDULE	OF QU	JANTITIES		0326	FAP 032622 BJ		McHENRY	75	12
									CONTRACT	NO. 62	2T01
SCALE:	SHEET	OF	SHEETS	STA.	TO STA.		ILLINOIS	FED. A	D PROJECT		

70400200 RELOCATE TEMPORARY CONCRETE BARRIER						
LOCATION	STATION	STATION	LT/CL/RT	FOOT		
	STA	AGE 2				
-	-	-	-	-		
II 47 ND	4,02.42	8+16.34	ΙT	325		
IL 47_NB	4+92.12	0+16.34	LI	323		

78008210	POLYUREA PAVEMENT	MARKING TYPE I - L	INE 4"		
LOCATION	STATION	STATION	LT/CL/RT	DESCRIPTION	FOOT
IL 47_SB DECK	6+09.41	7+00.99	LT	SOLID WHITE	92
IL 47_NB DECK	6+09.41	7+00.99	RT	SOLID WHITE	92
IL 47 DECK	6+09.41	7+00.99	CL	SKIP YELLOW	30
		•		TOTAL	214

78000600	THERMOPLASTIC PAVI	EMENT MARKING - LIN	NE 12"		
LOCATION	STATION	STATION	LT/CL/RT	DESCRIPTION	FOOT
IL 47_SB	3+81.77	6+09.41	LT	SOLID WHITE 45 DEG	46
IL 47_SB	7+00.99	8+70.00	LT	SOLID WHITE 45 DEG	35
IL 47_NB	5+39.41	6+09.41	RT	SOLID WHITE 45 DEG	12
IL 47_NB	7+00.99	7+70.91	RT	SOLID WHITE 45 DEG	12
				TOTAL	104

78008250	POLYUREA PAVEMENT	MARKING TYPE I - LI	NE 12"		
LOCATION	STATION	STATION	LT/CL/RT	DESCRIPTION	FOOT
IL 47_SB	6+09.41	7+00.99	LT	SOLID WHITE 45 DEG	23
IL 47_NB	6+09.41	7+00.99	LT	SOLID WHITE 45 DEG	23
				TOTAL	46


78300202		PAVEMENT MAR	KING REMOVAL - WAT	ER BLASTING	
LOCATION	STATION	STATION	LT/CL/RT	WIDTH (INCH)	SQ FT
		PRE STAGE			
IL 47	3+30.00	10+00.00	LT	4	224
IL 47	4+22.00	8+38.54	RT	4	139
IL 47		2+63.48	CL	4	84
IL 47	2+63.48	10+00.00	CL	4	62
IL 47	10+00.00	-	CL	4	42
				TOTAL	551

5		
ì	WSP USA Inc.	U
i	30 N. LASALLE STREET SUITE 4200	
	CHICAGO, IL 60602 TEL: (312) 782-8150	Р
	FAX: (312) 782-1684	Р

	USER NAME = USHA669697	DESIGNED -	REVISED -
EET		DRAWN -	REVISED -
	PLOT SCALE = 40.000 / in.	CHECKED -	REVISED -
	PLOT DATE = 5/5/2023	DATE 05/05/2023	REVISED -

						F.A.P RTE.	SEC.	TION		COUNTY	TOTAL SHEETS	SHEET NO.
	SCI	HEDULE	OF QU	JANTITIE	:8	0326	FAP 03:	2622 BJ		McHENRY	75	13
						_				CONTRACT	NO. 6	2T01
SCALE:	SHEET	OF	SHEETS	STA.	TO STA.			ILLINOIS	FED. AI	D PROJECT		

ALINGMENT COORDINATES - IL 47					
IL 47	STATION	N	Е		
POT	0+00.00	2090656.100	2091981.875		
POT	13+25.79	955934,242	955941,406		

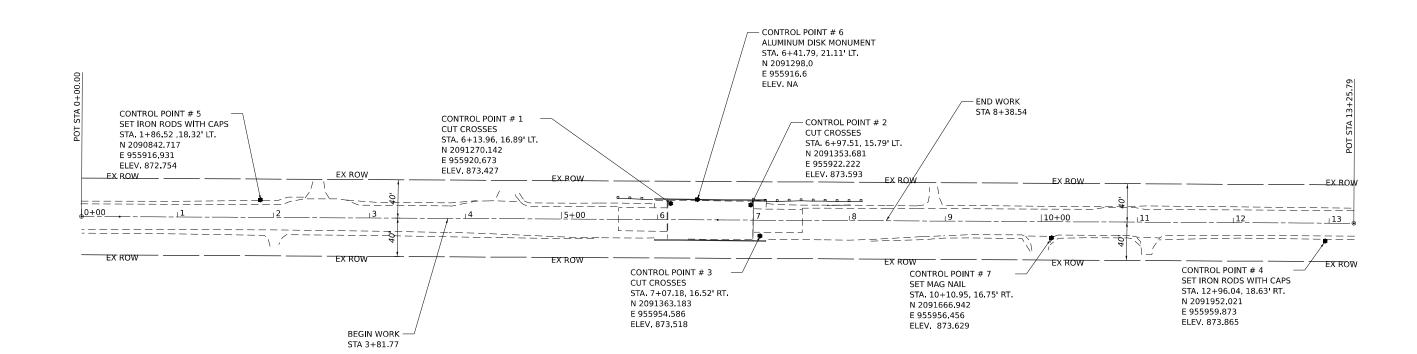

USER NAME = USHA669697	DESIGNED -	REVISED -
	DRAWN -	REVISED -
PLOT SCALE = 100.000 / in.	CHECKED -	REVISED -
PLOT DATE = 5/3/2023	DATE 05/05/2023	REVISED -

STATE OF ILLINOIS	
DEPARTMENT OF TRANSPORTATION	N

							21/0	F.A. RTE		TION		COUNTY	TOTAL SHEETS	SHEET NO.
l	AL	INGMENI	, 11	ES	AND	BENCHMA	KKS	47	FAP 03	32622 BJ		McHENRY	75	14
L												CONTRACT	NO. 62	2T01
	SCALE: 1" = 50'	SHEET 1	OF	1	SHEETS	STA.	TO STA.			ILLINOIS	FED. AID	PROJECT		

## MAINTENANCE OF TRAFFIC GENERAL NOTES

- TRAFFIC CONTROL AND PROTECTION SHALL BE PERFORMED IN ACCORDANCE WITH THE TRAFFIC CONTROL PLAN, TRAFFIC SIGNAL PLANS, THESE NOTES, APPLICABLE SPECIAL PROVISIONS, AND SECTION 701 OF THE STANDARD SPECIFICATION AS AMENDED BY THE SPECIAL PROVISION FOR WORK ZONE TRAFFIC CONTROL (CHECK SHEET LRS 3).
- THE TYPE III BARRICADES ARE TO BE PLACED IN ACCORDANCE WITH STANDARD 701901 UNLESS AUTHORIZED BY THE ENGINEER TO USE AN ALTERNATE ARRANGEMENT.
- 3. EXISTING TRAFFIC CONTROL SIGNS AND DEVICES MAY BE REMOVED BY THE MCHENRY COUNTY DIVISION OF TRANSPORTATION AFTER THE TRAFFIC CONTROL REQUIREMENTS ARE MET OR AS AUTHORIZED BY THE ENGINEER; ANY SIGNS OR DEVICES LEFT IN PLACE AT THIS TIME ARE TO BE RELOCATED, MAINTAINED AND PROTECTED FROM DAMAGE BY THE CONTRACTOR AND ANY DAMAGED OR LOST SIGNS WILL BE REPLACED BY THE CONTRACTOR AT NO ADDITIONAL COST TO THE CONTRACT.
- BARRICADES THAT MUST BE PLACED IN EXCAVATED AREAS SHALL HAVE LEG
   EXTENSIONS INSTALLED SUCH THAT THE TOP OF THE BARRICADE IS IN COMPLIANCE
   WITH THE HEIGHT REQUIREMENTS OF STANDARD 701901.
- 5. TYPE I OR TYPE II BARRICADES WITH TWO-WAY FLASHING LIGHTS SHALL BE REQUIRED AT ALL OPEN TRENCHES, EXCAVATIONS, OPEN OR EXPOSED SEWER STRUCTURES, TRANSVERSE PAVEMENT JOINTS, MATERIALS OR EQUIPMENT WITHIN THE RIGHT-OF-WAY (NUMBER AND SPACING DEPENDS ON THE CONDITIONS); AND AT LOCATIONS DESIGNATED BY THE ENGINEER OR LOCAL LAW ENFORCEMENT AGENCIES.
- WHERE REQUIRED, TRAFFIC SIGNS SHALL BE RELOCATED FOR EACH STAGE OF CONSTRUCTION. RELOCATION IS INCLUDED IN THE COST OF THE CONTRACT.
- PRIOR TO THE START OF CONSTRUCTION, REQUIRED TRAFFIC CONTROL DEVICES SHALL BE IN PLACE.
- 8. THE CONTRACTOR SHALL CONTACT THE IDOT TRAFFIC SUPERVISOR AT KALPANA.KANNAN-HOSADURGA@ILLINOIS.GOV 72 HOURS IN ADVANCE OF BEGINNING WORK.
- 9. THE FOLLOWING TRAFFIC CONTROL STANDARDS ARE THE MINIMUM REQUIREMENTS FOR THE TRAFFIC CONTROL FOR THIS PROJECT:
- 10. DROP-OFFS ADJACENT TO THE TRAVEL LANE SHALL BE KEPT TO A MINIMUM. PROTECTION OF THE DROP-OFF SHALL BE ACCORDING TO THE IDOT BUREAU OF SAFETY PROGRAMS AND ENGINEERING, SAFETY ENGINEERING POLICY MEMORANDUM 4-21. DROP-OFFS GREATER THAN OR EQUAL TO 12" WILL NOT BE ALLOWED AT LOCATIONS WHERE THE DROP-OFF IS LOCATED WITHIN 8 FT OF THE EDGE OF THE TRAVEL LANE. THE CONTRACTOR SHALL BE RESPONSIBLE FOR ENSURING THAT THE DROP-OFF AREAS MEET THE OFFSET, HEIGHT, AND DURATION REQUIREMENTS TO USE BARRICADES AT THE END OF EACH WORKDAY. THIS MAY REQUIRE THE CONTRACTOR TO REPLACE OR PLACE SUFFICIENT MATERIAL IN THE EXCAVATION TO REDUCE THE DROP-OFF TO BE COMPLIANT WITH THE REQUIREMENTS FOR USE OF BARRICADES. NO ADDITIONAL COMPENSATION SHALL BE ALLOWED TO COMPLY WITH THIS REQUIREMENT.

# SUGGESTED CONSTRUCTION SEQUENCING

#### CONSTRUCTION STAGING

#### PRE-STAGE

- INSTALL TRAFFIC CONTROL DEVICES AND TEMPORARY PAVEMENT MARKINGS, UTILIZE HIGHWAY STANDARDS 701201, 701301, 701311 AS WELL AS DISTRICT STANDARDS TC-10 AND TC-13 TO CLOSE THE SB SHOULDER AND PARTIAL LANE DURING THE ALLOWABLE LANE CLOSURE HOURS.
- MAINTAIN (2) 12' TRAVEL LANES. SHIFT TRAFFIC TO EAST, USING THE NB SHOULDER, NB LANE, AND PARTIAL SB LANE AS SHOWN IN THE PRE STAGE MOT PLANS.
- CONSTRUCT HMA PAVEMENT ALONG SB SHOULDERS AND HMA DRIVEWAY AS CALLED OUT ON PLANS.

#### STAGE '

- INSTALL TRAFFIC CONTROL DEVICES AND TEMPORARY PAVEMENT MARKINGS, UTILIZE HIGHWAY STANDARDS 701201, 701301, 701311 & 7031321 AS WELL AS DISTRICT STANDARDS TC-10, TC-13 AND AS SHOWN IN THE STAGE 1 MOT PLANS.
- CLOSE NB SHOULDER AND NB LANE AS SHOWN IN THE STAGE 1 MOT PLANS, UTILIZING TEMPORARY TRAFFIC SIGNALS TO DIRECT (1) 16' LANE ON THE SB LANE AND SB SHOULDER.
- PERFORM BRIDGE DECK SCARIFICATION, DECK LATEX CONCRETE OVERLAY, AND DIAMOND GRINDING ON NB BRIDGE DECK AND HMA OVERLAY ON BRIDGE APPROACHES. CONSTRUCT HMA OVERLAY ON NB SHOULDERS AS CALLED OUT ON PLANS.

#### STAGE 2


- INSTALL TRAFFIC CONTROL DEVICES AND TEMPORARY PAVEMENT MARKINGS, UTILIZE HIGHWAY STANDARDS 701201, 701301, 701311 & 7031321 AS WELL AS DISTRICT STANDARDS TC-10, TC-13 AND AS SHOWN IN THE STAGE 2 MOT PLANS.
- CLOSE SB SHOULDER AND SB LANE AS SHOWN IN THE STAGE 2 MOT PLANS, UTILIZING TEMPORARY TRAFFIC SIGNALS TO DIRECT (1) 16' LANE ON THE NB LANE AND NB SHOULDER.
- PERFORM BRIDGE DECK SCARIFICATION, DECK LATEX CONCRETE OVERLAY, AND DIAMOND GRINDING ON SB BRIDGE DECK AND HMA OVERLAY ON BRIDGE APPROACHES. CONSTRUCT HMA OVERLAY ON SB SHOULDERS.

USER NAME = WangS	DESIGNED -	REVISED -	
	DRAWN -	REVISED -	
PLOT SCALE = 2.000 / in.	CHECKED -	REVISED -	
PLOT DATE = 5/5/2023	DATE 05/05/2023	REVISED -	

STATE OI	F ILLINOIS
<b>DEPARTMENT OF</b>	TRANSPORTATION

SCALE: NONE


MAINTENANCE OF TRAFFIC						F.A.IL RTE.	SECTION		COUNTY	TOTAL SHEETS	SHEET NO.
GENERAL NOTES					47	FAP 032622 BJ		McHENRY	75	15	
GENERAL NOTES								CONTRACT	NO. 62	2T01	
SHEET	1	OF · 1	SHEETS	STA.	TO STA.		ILLINOIS	FED. AI	D PROJECT		

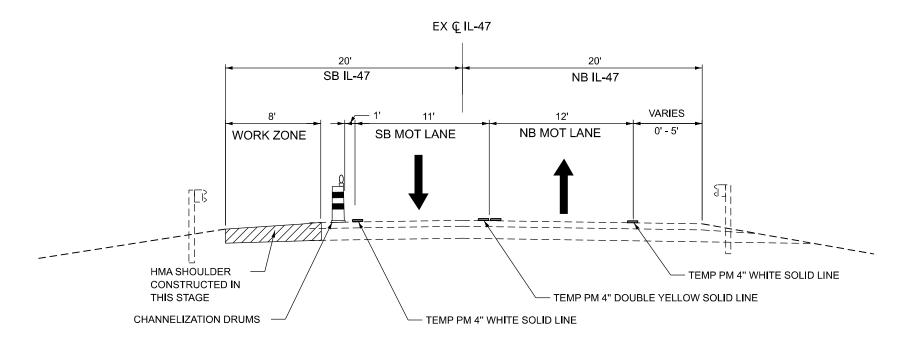

# PRESTAGE IL-47 ROAD TYPICAL SECTION

STA 4+22.00 TO 5+96.78 STA 7+13.24 TO 8+38.56




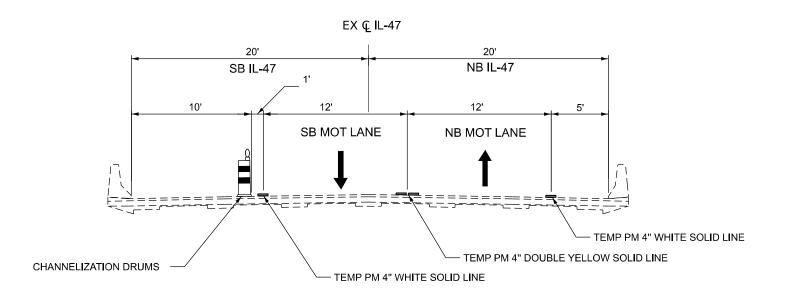

# PRE-STAGE NIPPERSINK BRIDGE TYPICAL SECTION

STA 6+10.94 TO 6+99.72


USER NAME = WangS	DESIGNED -	REVISED -		MAINTENANCE OF TRAFFIC	F.A.IL RTF	SECTION	COUNTY TOTAL SHEET SHEETS NO.
	DRAWN -	REVISED -	STATE OF ILLINOIS		47	FAP 032622 BI	McHENRY 75 16
PLOT SCALE = 8.000 / in.	CHECKED -	REVISED -	DEPARTMENT OF TRANSPORTATION	TYPICAL SECTIONS			CONTRACT NO. 62T01
PLOT DATE = 5/5/2023	DATE 05/05/2023	REVISED -		SCALE: $1/4'' = 1'$ SHEET 1 OF 5 SHEETS STA. TO STA.		ILLINOIS FED. AI	ID PROJECT

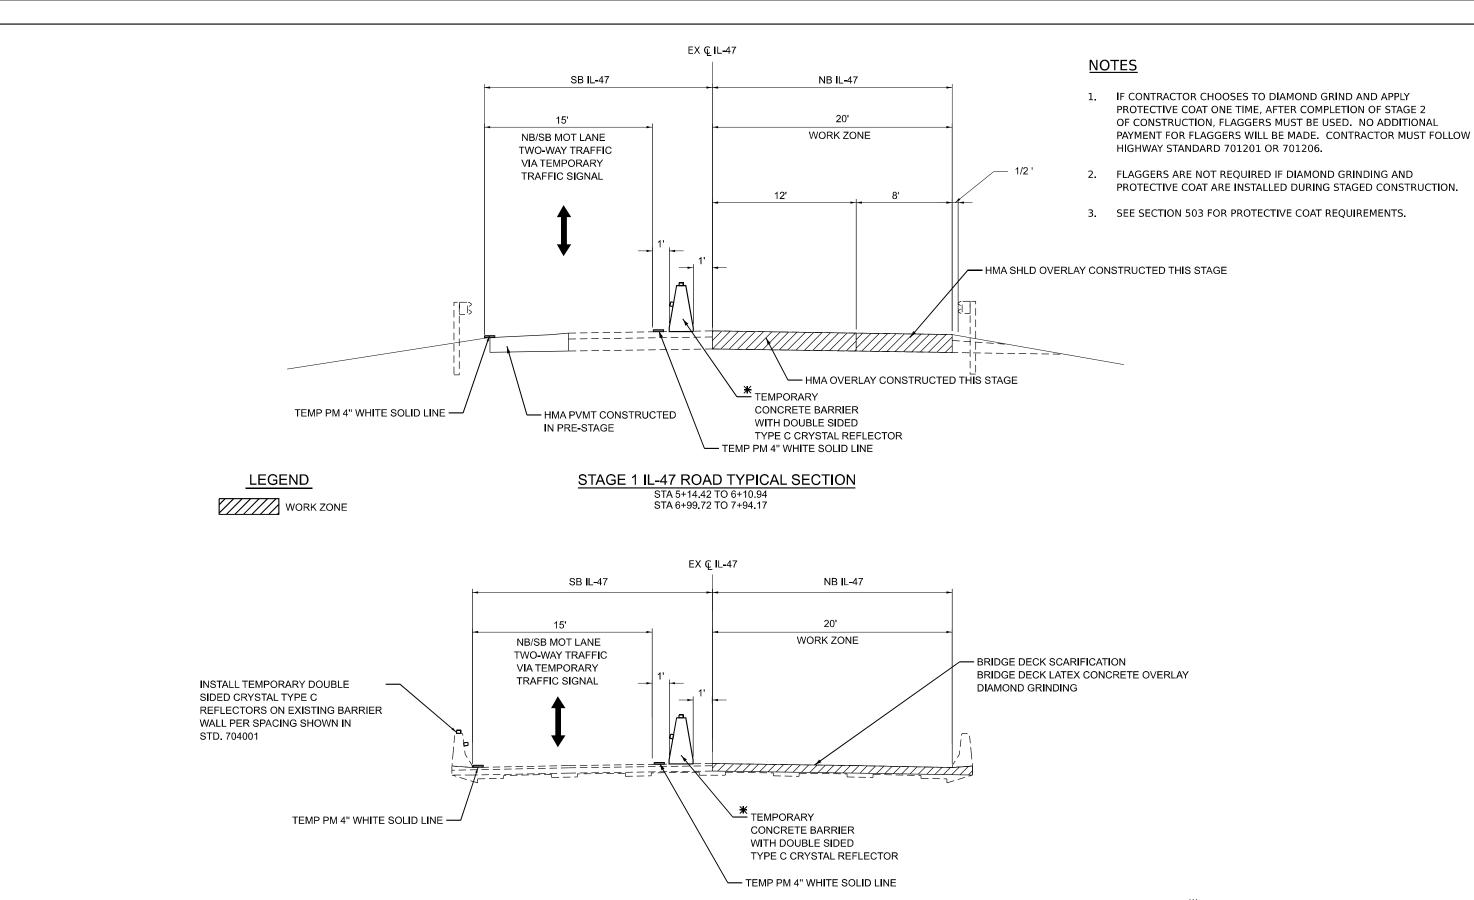

STAGE 1 IL-47 OVER NIPPERSINK CREEK TYPICAL SECTION

\* TYPE C REFLECTORS INSTALLED ON TEMPORARY CONCRETE BARRIER SHALL BE CONSIDERED INCLUDED IN THE COST OF TEMPORARY CONCRETE BARRIER

USER NAME = wangs	DESIGNED -	REVISED -		MAINTENANCE OF TRAFFIC	RTF	SECTION	COUNTY	SHEETS	NO.
	DRAWN -	REVISED -	STATE OF ILLINOIS		47	FAP 032622 BI	MCHENRY	75	17
PLOT SCALE = 8.000 / in	CHECKED -	REVISED -	DEPARTMENT OF TRANSPORTATION	TYPICAL SECTIONS			CONTRAC	T NO. 62	T01
PLOT DATE = 5/5/2023	DATE 05/05/2023	REVISED -		SCALE: 1/4" = 1' SHEET 2 OF 5 SHEETS STA. TO STA.		ILLINOIS FED. A	.ID PROJECT		

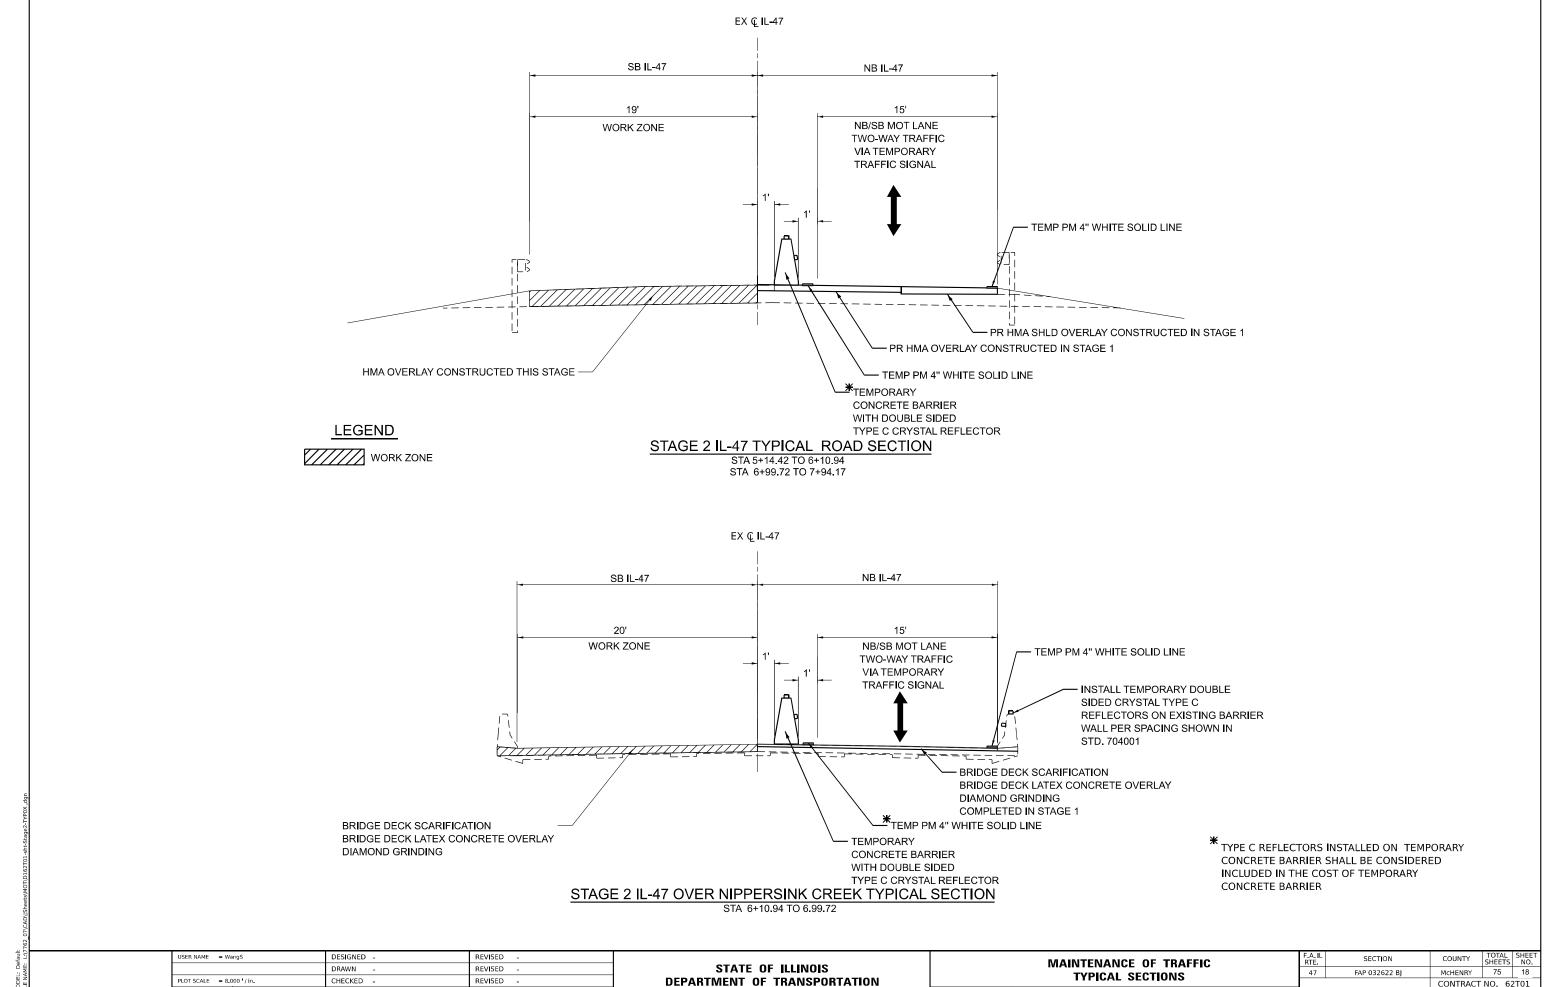

SCALE: 1/4'' = 1' SHEET 3 OF 5 SHEETS STA.


TO STA.

CONTRACT NO. 62T01

PLOT DATE = 5/5/2023


DATE 05/05/2023


REVISED -

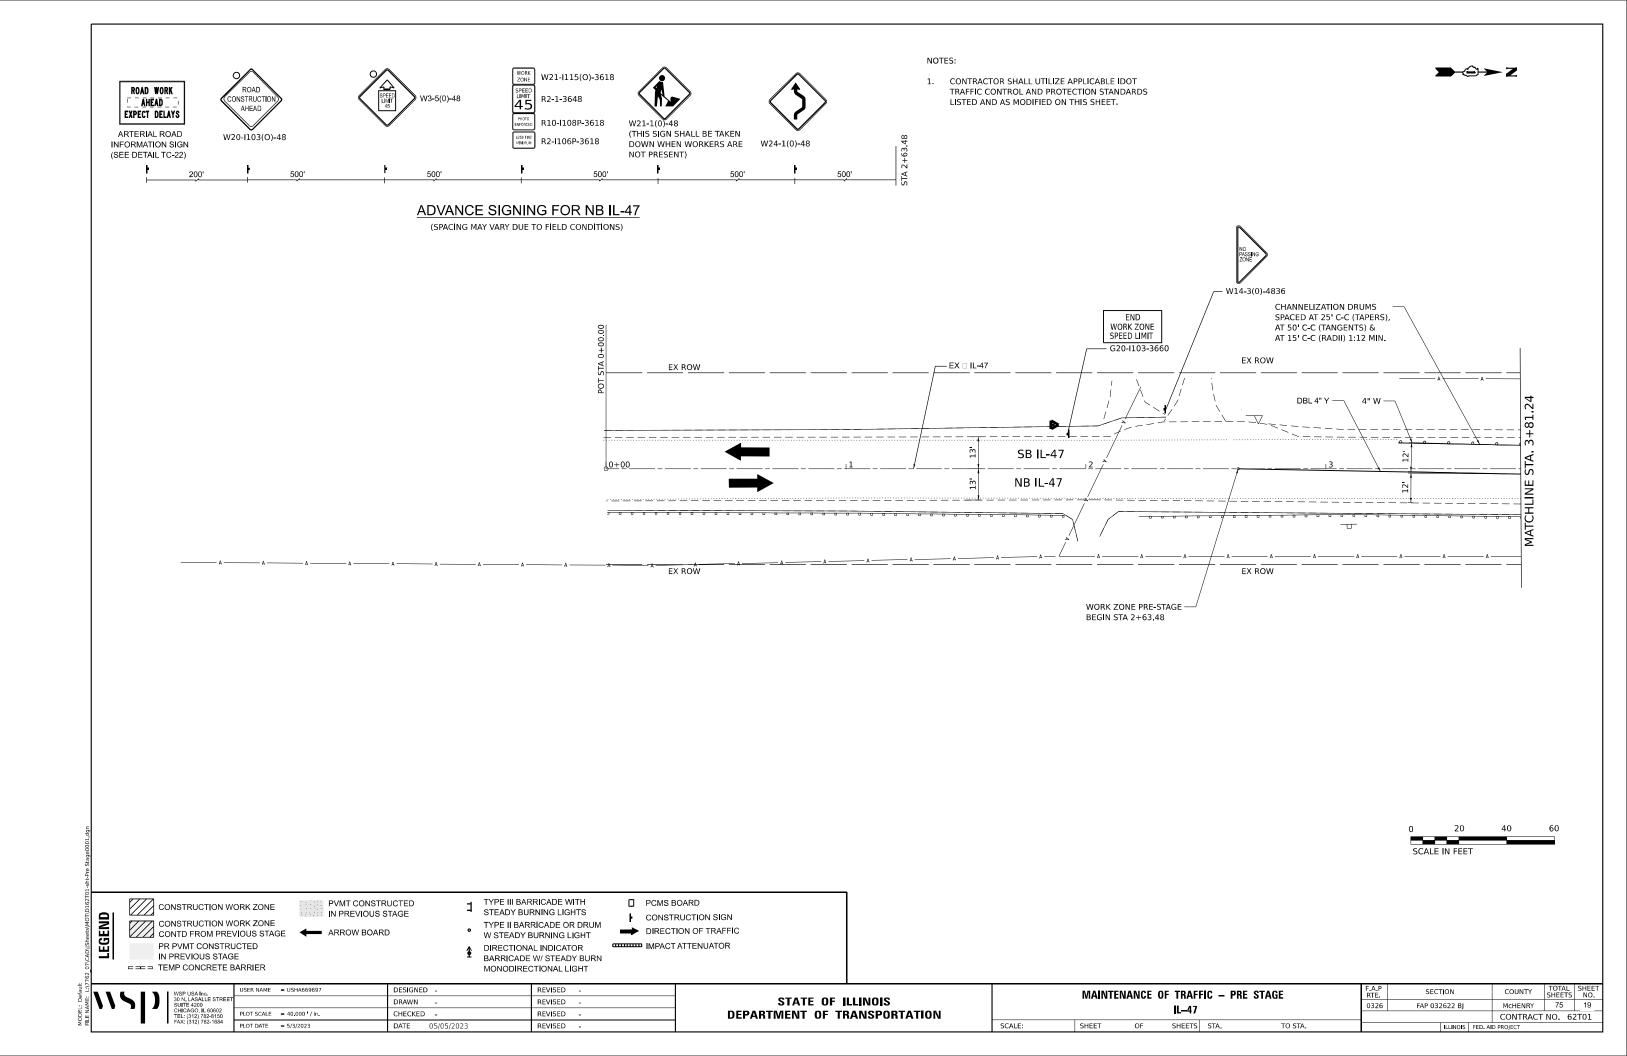

**→**Û→Z

CONTRACTOR SHALL UTILIZE APPLICABLE IDOT
 TRAFFIC CONTROL AND PROTECTION STANDARDS
 LISTED AND AS MODIFIED ON THIS SHEET.

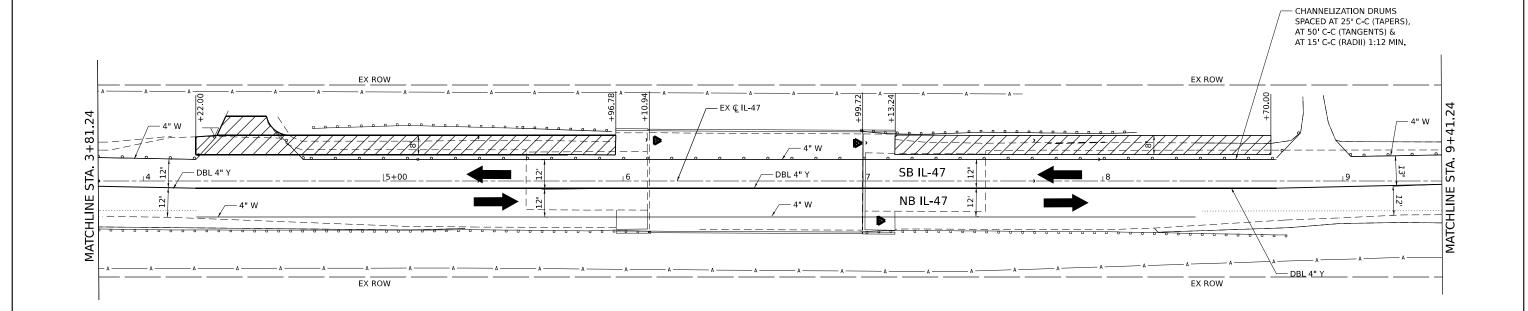

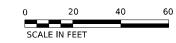



CONSTRUCTION WORK ZONE CONSTRUCTION WORK ZONE
CONTD FROM PREVIOUS STAGE

ARROW BOARD PR PVMT CONSTRUCTED IN PREVIOUS STAGE

TEMP CONCRETE BARRIER

PVMT CONSTRUCTED IN PREVIOUS STAGE

TYPE III BARRICADE WITH STEADY BURNING LIGHTS TYPE II BARRICADE OR DRUM

MONODIRECTIONAL LIGHT

☐ PCMS BOARD CONSTRUCTION SIGN W STEADY BURNING LIGHT DIRECTIONAL INDICATOR BARRICADE W/ STEADY BURN

■ DIRECTION OF TRAFFIC IMPACT ATTENUATOR

115	)	WSP USA Inc. 30 N. LASALLE STREET SUITE 4200 CHICAGO, IL 60602 TEL: (312) 782-8150 FAX: (312) 782-1684

	USER NAME = USHA669697	DESIGNED -	REVISED -
STREET		DRAWN -	REVISED -
602 3150	PLOT SCALE = 40.000 / in.	CHECKED -	REVISED -
1684	PLOT DATE = 5/3/2023	DATE 05/05/2023	REVISED -

STATE	0F	ILLINOIS
DEPARTMENT (	DF 1	<b>TRANSPORTATION</b>

	MAINTE	NANCE	DF TRAFI IL–47	IC – PR	E STAGE	F.A.P RTE. 0326	SECTION FAP 032622 BJ	COUNTY  McHENRY  CONTRACT	TOTAL SHEETS 75	SHEET NO. 20 2T01
SCALE:	SHEET	OF	SHEETS	STA.	TO STA.		ILLINOIS	FED. AID PROJECT		

WORK ZONE SPEED LIMIT 45 W21-I115(O)-3618 ROAD WORK R2-1-3648 AHEAD CONSTRUCTION AHEAD EXPECT DELAYS R10-I108P-3618 ARTERIAL ROAD (THIS SIGN SHALL BE TAKEN R2-I106P-3618 W20-I103(O)-48 INFORMATION SIGN 10+00 DOWN WHEN WORKERS ARE NOT PRESENT) (SEE DETAIL TC-22) 500' 500' 500' 500'


#### NOTES:

1. CONTRACTOR SHALL UTILIZE APPLICABLE IDOT TRAFFIC CONTROL AND PROTECTION STANDARDS LISTED AND AS MODIFIED ON THIS SHEET.

# ADVANCE SIGNING FOR SB IL-47

(SPACING MAY VARY DUE TO FIELD CONDITIONS)

SCALE:

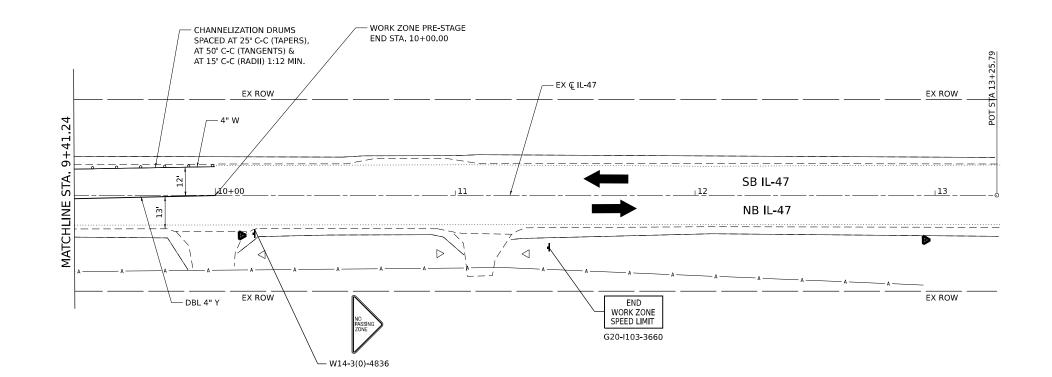





CONSTRUCTION WORK ZONE CONSTRUCTION WORK ZONE CONSTRUCTION WORK ZONE
CONTD FROM PREVIOUS STAGE

ARROW BOARD PR PVMT CONSTRUCTED IN PREVIOUS STAGE

TEMP CONCRETE BARRIER

PVMT CONSTRUCTED IN PREVIOUS STAGE

- TYPE III BARRICADE WITH STEADY BURNING LIGHTS
- TYPE II BARRICADE OR DRUM W STEADY BURNING LIGHT DIRECTIONAL INDICATOR BARRICADE W/ STEADY BURN MONODIRECTIONAL LIGHT

REVISED -

☐ PCMS BOARD CONSTRUCTION SIGN ■ DIRECTION OF TRAFFIC


IMPACT ATTENUATOR

STATE 0	F ILLINOIS
DEPARTMENT OF	TRANSPORTATION


	MAINTEN	ANCE (	OF TRAFF	IC – P	F.A.P RTE	SECTION	COUNTY	COUNTY TOTAL SHEETS		
IL <b>–</b> 47							FAP 032622 BJ	McHENRY	75	21
			L					CONTRACT	NO. 62	2T01
	SHEET	OF	SHEETS	STA.	TO STA.		ILLINOIS FED.	AID PROJECT		


DRAWN REVISED -CHECKED -REVISED PLOT DATE = 5/3/2023 DATE 05/05/2023 REVISED -

DESIGNED -

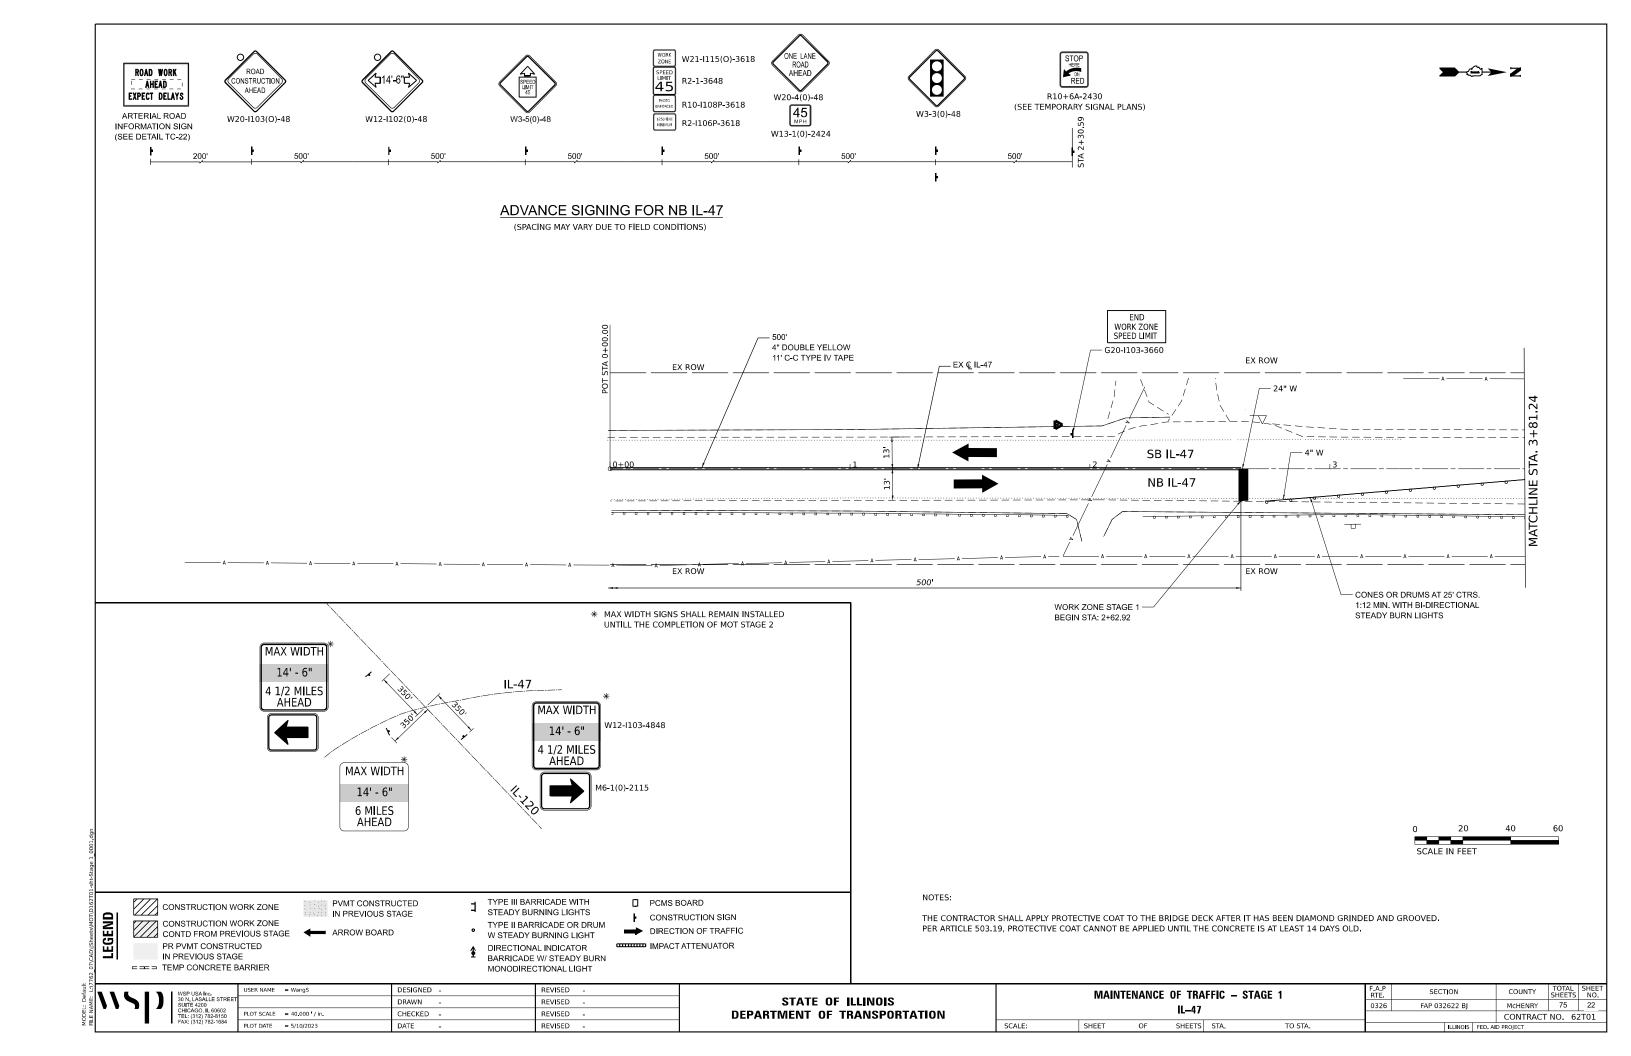



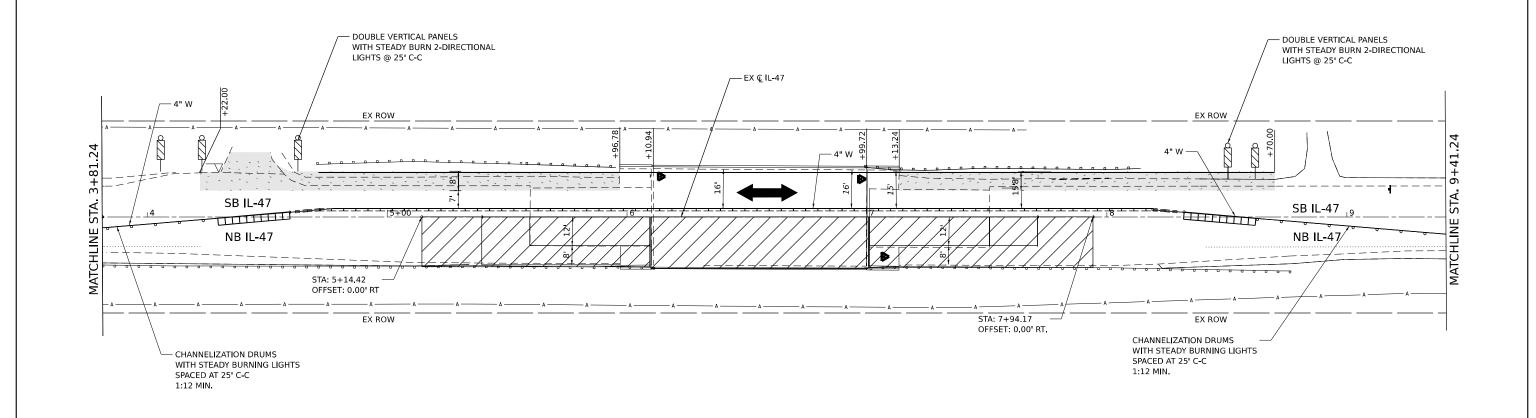

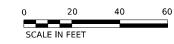



CONSTRUCTION WORK ZONE CONSTRUCTION WORK ZONE CONSTRUCTION WORK ZONE CONTD FROM PREVIOUS STAGE PR PVMT CONSTRUCTED IN PREVIOUS STAGE ¬

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TEMP CONCRETE BARRIER

PVMT CONSTRUCTED IN PREVIOUS STAGE

TYPE III BARRICADE WITH STEADY BURNING LIGHTS

TYPE II BARRICADE OR DRUM W STEADY BURNING LIGHT DIRECTIONAL INDICATOR BARRICADE W/ STEADY BURN

MONODIRECTIONAL LIGHT

PCMS BOARD

CONSTRUCTION SIGN ■ DIRECTION OF TRAFFIC IMPACT ATTENUATOR

SCALE:

THE CONTRACTOR SHALL APPLY PROTECTIVE COAT TO THE BRIDGE DECK AFTER IT HAS BEEN DIAMOND GRINDED AND GROOVED. PER ARTICLE 503.19, PROTECTIVE COAT CANNOT BE APPLIED UNTIL THE CONCRETE IS AT LEAST 14 DAYS OLD.


DESIGNED -REVISED -DRAWN REVISED -CHECKED -REVISED -REVISED -DATE

STATE OF ILLINOIS **DEPARTMENT OF TRANSPORTATION** 

MAIN'	TENANCE	OF TRA	FFIC -	STAGE 1	F.A RTI	E.			
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		1147							
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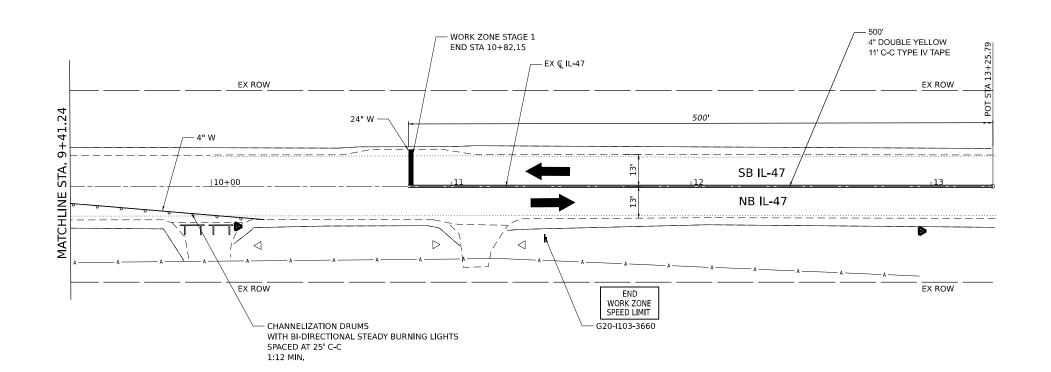
COUNTY TOTAL SHEET NO.

MCHENRY 75 23 SECTION FAP 032622 BJ CONTRACT NO. 62T01

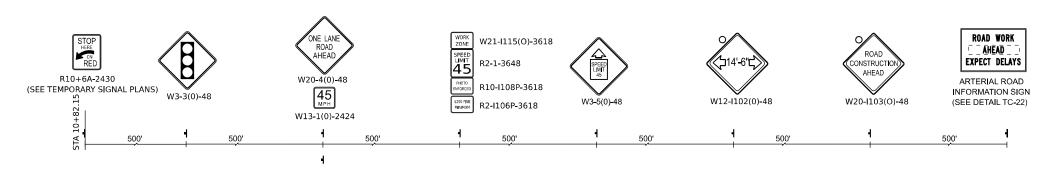

# ADVANCE SIGNING FOR NB IL-47

(SPACING MAY VARY DUE TO FIELD CONDITIONS)




☐ PCMS BOARD

CONSTRUCTION SIGN


**■** DIRECTION OF TRAFFIC


IMPACT ATTENUATOR

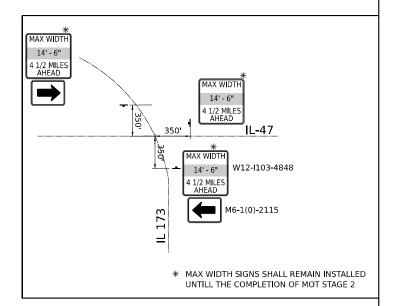


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- TYPE III BARRICADE WITH STEADY BURNING LIGHTS
- TYPE II BARRICADE OR DRUM W STEADY BURNING LIGHT DIRECTIONAL INDICATOR BARRICADE W/ STEADY BURN

MONODIRECTIONAL LIGHT

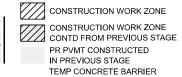SCALE:

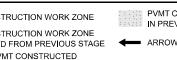THE CONTRACTOR SHALL APPLY PROTECTIVE COAT TO THE BRIDGE DECK AFTER IT HAS BEEN DIAMOND GRINDED AND GROOVED. PER ARTICLE 503.19, PROTECTIVE COAT CANNOT BE APPLIED UNTIL THE CONCRETE IS AT LEAST 14 DAYS OLD.

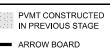	USER NAME = WangS	DESIGNED -	REVISED -	
STREET		DRAWN -	REVISED -	
602 150	PLOT SCALE = 40.000 / in.	CHECKED -	REVISED -	
684	PLOT DATE = 5/10/2023	DATE -	REVISED -	


STATE OF ILLINOIS **DEPARTMENT OF TRANSPORTATION** 

	MAINT	ENANCE	OF TRA	FFIC –	STAGE 1	F.A.P RTE.	SECTION	COUNTY	TOTAL SHEETS	SHEET NO.	
IL <b>–</b> 47						0326	FAP 032622 BJ		McHENRY	75	24
	IL-4/								CONTRACT	NO. 6	2T01
	SHEET	OF	SHEETS	STA	TO CTA		II I INOIC	EED A	D DDOLLCT		

W21-I115(O)-3618 ROAD WORK R2-1-3648 EXPECT DELAYS R10+6A-2430 W20-4(0)-48 R10-I108P-3618 (SEE TEMPORARY SIGNAL PLANS) 45 MPH ARTERIAL ROAD W20-I103(O)-48 W12-I102(0)-48 R2-I106P-3618 INFORMATION SIGN W13-1(0)-2424 (SEE DETAIL TC-22)

# ADVANCE SIGNING FOR NB IL-47

(SPACING MAY VARY DUE TO FIELD CONDITIONS)

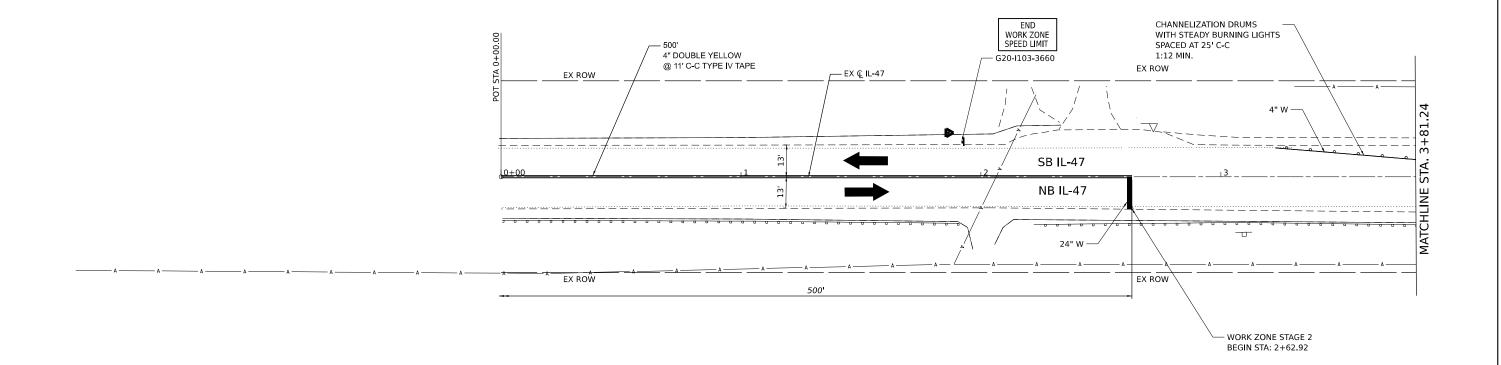





CONSTRUCTION WORK ZONE CONSTRUCTION WORK ZONE CONSTRUCTION WORK ZONE CONTD FROM PREVIOUS STAGE PR PVMT CONSTRUCTED IN PREVIOUS STAGE ¬

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TEMP CONCRETE BARRIER

PVMT CONSTRUCTED IN PREVIOUS STAGE

TYPE III BARRICADE WITH STEADY BURNING LIGHTS

TYPE II BARRICADE OR DRUM W STEADY BURNING LIGHT DIRECTIONAL INDICATOR BARRICADE W/ STEADY BURN

MONODIRECTIONAL LIGHT

REVISED -

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☐ PCMS BOARD CONSTRUCTION SIGN ■ DIRECTION OF TRAFFIC

IMPACT ATTENUATOR

SCALE:

THE CONTRACTOR SHALL APPLY PROTECTIVE COAT TO THE BRIDGE DECK AFTER IT HAS BEEN DIAMOND GRINDED AND GROOVED. PER ARTICLE 503.19, PROTECTIVE COAT CANNOT BE APPLIED UNTIL THE CONCRETE IS AT LEAST 14 DAYS OLD.




DESIGNED -DRAWN CHECKED -PLOT DATE = 5/10/2023 DATE

STATE OF ILLINOIS **DEPARTMENT OF TRANSPORTATION** 

SECTION MAINTENANCE OF TRAFFIC - STAGE 2 COUNTY COUNTY SHEETS NO.

McHENRY 75 25 FAP 032622 BJ 0326 IL-47 CONTRACT NO. 62T01 SHEET SHEETS STA. TO STA.



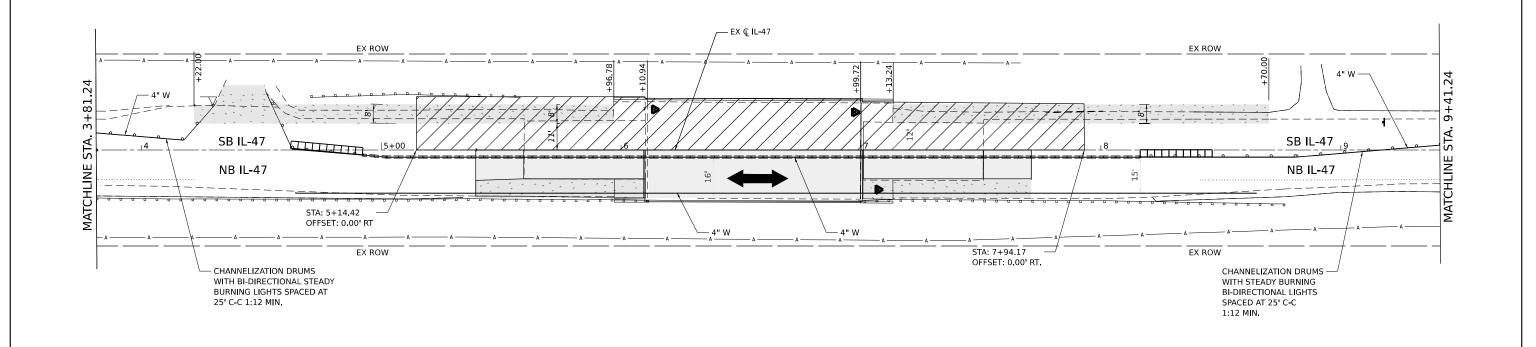





CONSTRUCTION WORK ZONE CONSTRUCTION WORK ZONE
CONTD FROM PREVIOUS STAGE PR PVMT CONSTRUCTED IN PREVIOUS STAGE □== TEMP CONCRETE BARRIER

PVMT CONSTRUCTED IN PREVIOUS STAGE

TYPE III BARRICADE WITH STEADY BURNING LIGHTS TYPE II BARRICADE OR DRUM

W STEADY BURNING LIGHT DIRECTIONAL INDICATOR BARRICADE W/ STEADY BURN

MONODIRECTIONAL LIGHT

REVISED -

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PCMS BOARD CONSTRUCTION SIGN ■ DIRECTION OF TRAFFIC IMPACT ATTENUATOR

THE CONTRACTOR SHALL APPLY PROTECTIVE COAT TO THE BRIDGE DECK AFTER IT HAS BEEN DIAMOND GRINDED AND GROOVED. PER ARTICLE 503.19, PROTECTIVE COAT CANNOT BE APPLIED UNTIL THE CONCRETE IS AT LEAST 14 DAYS OLD.

11	5	)	WSP USA Inc. 30 N. LASALLE STRE SUITE 4200 CHICAGO, IL 60602 TEL: (312) 782-8150 FAX: (312) 782-1684


USER NAME = WangS DESIGNED -DRAWN CHECKED -PLOT DATE = 5/10/2023 DATE

STATE OF ILLINOIS **DEPARTMENT OF TRANSPORTATION** 

	MAINTEN	IANCE	OF TRAFI	F.A.P RTE	SEC	TION		COUNTY	TOTAL SHEETS	SHEE NO.			
IL <b>–</b> 47								0326 FAP 032622 BJ		McHENRY	75	26	
			JL-4/								CONTRACT	NO. 62	2T01
CALE:	SHEET	OF	SHEETS	STA.	TO STA.				ILLINOIS	FED. AIC	PROJECT		

# ADVANCE SIGNING FOR NB IL-47

(SPACING MAY VARY DUE TO FIELD CONDITIONS)

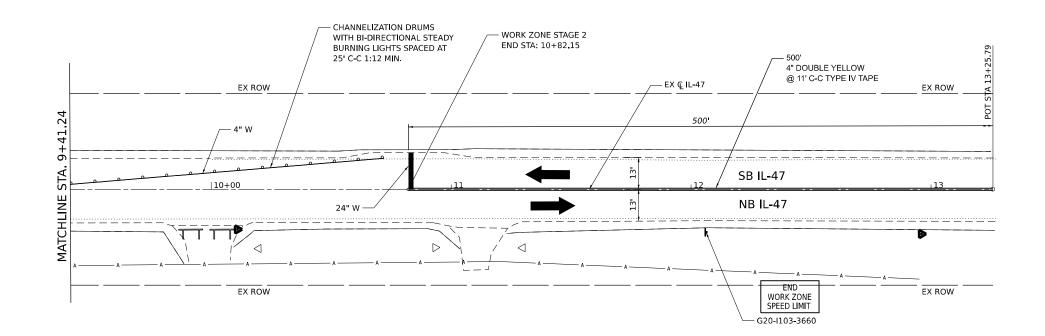

40 20 SCALE IN FEET



CONSTRUCTION WORK ZONE CONSTRUCTION WORK ZONE CONSTRUCTION WORK ZONE
CONTD FROM PREVIOUS STAGE PR PVMT CONSTRUCTED IN PREVIOUS STAGE TEMP CONCRETE BARRIER

PVMT CONSTRUCTED IN PREVIOUS STAGE

TYPE III BARRICADE WITH STEADY BURNING LIGHTS TYPE II BARRICADE OR DRUM

MONODIRECTIONAL LIGHT

W STEADY BURNING LIGHT IMPACT ATTENUATOR DIRECTIONAL INDICATOR BARRICADE W/ STEADY BURN

☐ PCMS BOARD CONSTRUCTION SIGN **■** DIRECTION OF TRAFFIC


SCALE:

THE CONTRACTOR SHALL APPLY PROTECTIVE COAT TO THE BRIDGE DECK AFTER IT HAS BEEN DIAMOND GRINDED AND GROOVED. PER ARTICLE 503.19, PROTECTIVE COAT CANNOT BE APPLIED UNTIL THE CONCRETE IS AT LEAST 14 DAYS OLD.

DESIGNED -REVISED -DRAWN REVISED -CHECKED -REVISED -PLOT DATE = 5/10/2023 REVISED -DATE

STATE OF ILLINOIS **DEPARTMENT OF TRANSPORTATION** 

SECTION MAINTENANCE OF TRAFFIC - STAGE 2 COUNTY McHENRY 75 27 0326 FAP 032622 BJ IL-47 CONTRACT NO. 62T01 SHEET SHEETS STA. TO STA.

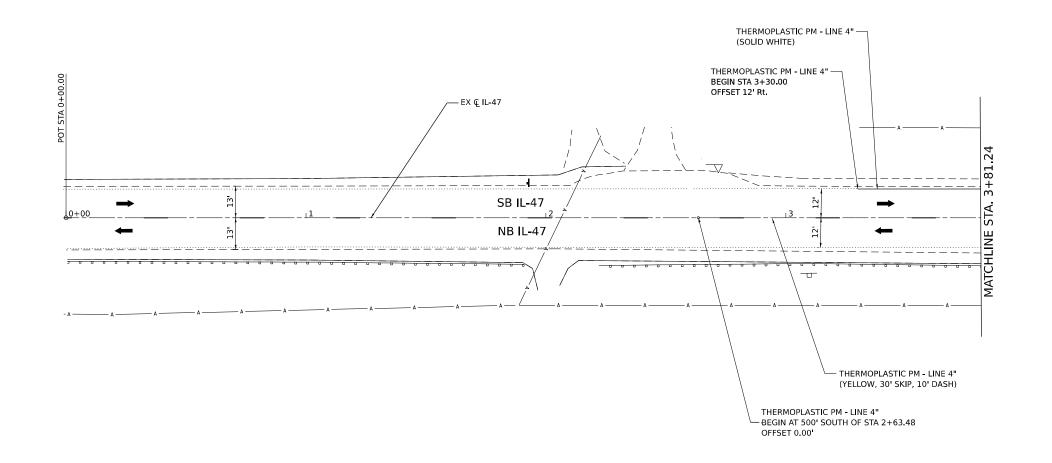


WSP USA Inc.	U
30 N, LASALLE STREET SUITE 4200	
CHICAGO, IL 60602 TEL: (312) 782-8150	P
FAX: (312) 782-1684	P

	USER NAME = USHA669697	DESIGNED -	REVISED -
ΕT		DRAWN -	REVISED -
	PLOT SCALE = 40.000 / in.	CHECKED -	REVISED -
	PLOT DATE = 5/3/2023	DATE 05/05/2023	REVISED -

STATI	E OI	F ILLINOIS
DEPARTMENT	0F	TRANSPORTATION

		AVE	VIE	NT MA	F.A.P RTE	F.A.P RTE SECTION					
IL 47							0326	0326 FAP 032622 BJ			McHE
											CONT
	SHEET 1	OF	3	SHEETS	STA.	TO STA.			ILLINOIS	FED. AI	D PROJECT

DUNTY SHEETS NO.
HENRY 75 28
NTRACT NO. 62T01 SCALE: N.T.S

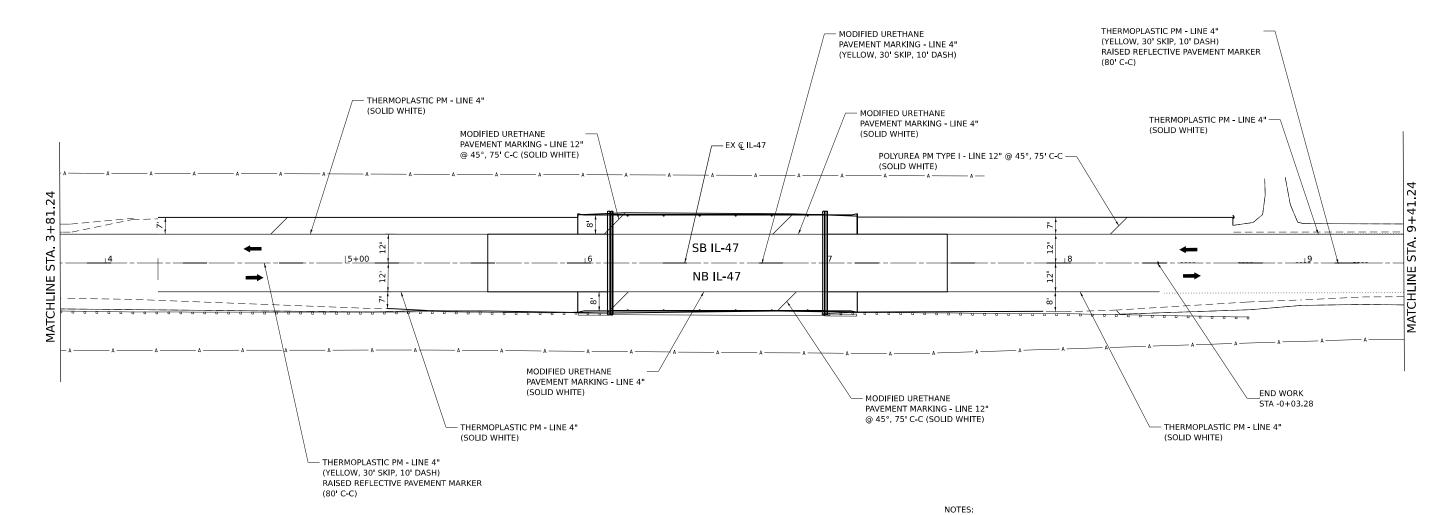

1. NO RAISED REFLECTIVE PAVEMENT MARKER ON BRIDGE DECK 2. PAVEMENT MARKING ON CONCRETE WILL BE MODIFIED URETHANE AND HMA WILL BE THERMOPLASTIC

	USER NAME = USHA669697	DESIGNED -	REVISED -
REET		DRAWN -	REVISED -
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4	PLOT DATE = 6/21/2023	DATE -	REVISED -


STATE OF	ILLINOIS
DEPARTMENT OF	TRANSPORTATION

SCALE: N.T.S

	PAVEMENT MARKING						F.A.P SECTION				
IL 47						0326	FAP 03:	2622 BJ			
		,									
HEET 2	OF	3	SHEETS	STA.	TO STA.			ILLINOIS	FED A	ä	

COUNTY TOTAL SHEET NO.

McHENRY 75 29 CONTRACT NO. 62T01

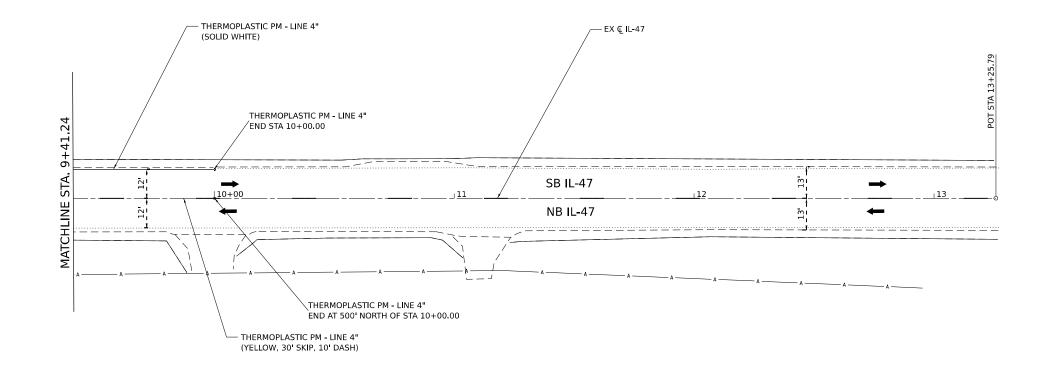

WSP USA1 30 N, LASS 00 CHE 4.20 FEL: (312) FAX: (312)

	USER NAME = USHA669697	DESIGNED -	REVISED -
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	PLOT DATE = 5/3/2023	DATE 05/05/2023	REVISED -

STATI	E OI	F ILLINOIS
DEPARTMENT	0F	TRANSPORTATION

								F.A.F RTE.		SECTION	COUNTY	TOTAL SHEETS	SHEET NO.
	IL 47						032	6	FAP 032622 BJ	McHENRY	75	30	
										CONTRACT	NO. 6	2T01	
	SCALE: N.T.S	SHEET 3	OF	3 SH	HEETS	STA.	TO STA.		ILLINOIS FED. AID PROJECT				

# TRAFFIC SIGNAL LEGEND


(NOT TO SCALE)

CONTROLLER CABINET  COMMUNICATION CABINET  MASTER CONTROLLER  MASTER MASTER CONTROLLER  UNINTERRUPTABLE POWER SUPPLY	ECC EMC	CC	HANDHOLE -SQUARE					
MASTER CONTROLLER	ЕМС	CC	-ROUND			SIGNAL HEAD -(P) PROGRAMMABLE SIGNAL HEAD	R Y Y	R R Y
MASTER MASTER CONTROLLER			HEAVY DUTY HANDHOLE		<b>-</b>			G G 4Y 4Y 4G
		MC	-SQUARE -ROUND	⊞ ®	⊞ ⊕		<b>₹</b>	<b>4</b> G <b>4</b> G <b>P</b>
UNINTERRUPTABLE POWER SUPPLY	ЕММС	ммс	DOUBLE HANDHOLE			SIGNAL HEAD WITH BACKPLATE		RRR
	4	Ø	JUNCTION BOX		•	-(P) PROGRAMMABLE SIGNAL HEAD -(RB) RETROREFLECTIVE BACKPLATE		
SERVICE INSTALLATION -(P) POLE MOUNTED	P	- <b>■</b> -P	RAILROAD CANTILEVER MAST ARM	$X \circ \overline{X} = X \circ X$	X <del>QX X</del>			G G G G G G G G G G G G G G G G G G G
SERVICE INSTALLATION	G GM	C CM	RAILROAD FLASHING SIGNAL	<del>X0</del> X	<b>X⊕X</b>		P RB	P RB
-(G) GROUND MOUNTED -(GM) GROUND MOUNTED METERED	$\boxtimes^{G} \boxtimes^{GM}$	<b>⊠</b> <sup>G</sup> <b>⊠</b> <sup>GM</sup>	RAILROAD CROSSING GATE  RAILROAD CROSSBUCK	<del>202</del> >	<b>¥•</b> ⊁-	PEDESTRIAN SIGNAL HEAD	<b>①</b>	<b>P</b>
TELEPHONE CONNECTION	EΤ	Т				AT RAILROAD INTERSECTIONS		
STEEL MAST ARM ASSEMBLY AND POLE	O	•——	RAILROAD CONTROLLER CABINET  UNDERGROUND CONDUIT (UC),		▶∢	PEDESTRIAN SIGNAL HEAD WITH COUNTDOWN TIMER	<b>(</b>	<b>₽</b> C <b>★</b> D
ALUMINUM MAST ARM ASSEMBLY AND POLE			GALVANIZED STEEL			ILLUMINATED SIGN		
STEEL COMBINATION MAST ARM ASSEMBLY AND POLE WITH LUMINAIRE	<del>-</del>	•*	TEMPORARY SPAN WIRE, TETHER WIRE, AND CABLE			"NO LEFT TURN"/"NO RIGHT TURN"		
SIGNAL POST (BM) BARREL MOUNTED - TEMPORARY	0	● • BM	SYSTEM ITEM INTERSECTION ITEM	S I	SP IP	NUMBER OF CONDUCTORS, ELECTRIC CABLE NO. 14, UNLESS NOTED OTHERWISE. ALL DETECTOR LOOP CABLE TO BE SHIELDED		
WOOD POLE	$\otimes$	•	REMOVE ITEM		R	GROUND CABLE IN CONDUIT,	<b>—————</b>	<u> </u>
GUY WIRE	>-	>-	RELOCATE ITEM		RL	NO. 6 SOLID COPPER (GREEN)  ELECTRIC CABLE IN CONDUIT, TRACER		
SIGNAL HEAD	→	-	ABANDON ITEM		А	NO. 14 1/C	1	
SIGNAL HEAD WITH BACKPLATE	+->	+-	CONTROLLER CABINET AND FOUNDATION TO BE REMOVED		RCF	COAXIAL CABLE	<u>—</u> c—	<u> </u>
SIGNAL HEAD OPTICALLY PROGRAMMED		→ P + → P	MAST ARM POLE AND		DME	VENDOR CABLE	(v)	_(v)
FLASHER INSTALLATION (FS) SOLAR POWERED	od> F od> FS	•► FS	FOUNDATION TO BE REMOVED		RMF	COPPER INTERCONNECT CABLE,	<u></u>	<del></del>
	⊕⊳ <sup>F</sup> ⊕⊳ <sup>FS</sup>	<b>₽</b> ► <b>P</b> ► FS	SIGNAL POST AND FOUNDATION TO BE REMOVED		RPF	NO. 18, 3 PAIR TWISTED, SHIELDED	6#18	0#18)
PEDESTRIAN SIGNAL HEAD	-0	-1	DETECTOR LOOP, TYPE I			FIBER OPTIC CABLE -NO. 62.5/125, MM12F	—	—(12F)—
PEDESTRIAN PUSH BUTTON (APS) ACCESSIBLE PEDESTRIAN PUSH BUTTON	⊚ ⊗ APS		PREFORMED DETECTOR LOOP	P P	PP	-NO. 62.5/125, MM12F SM12F -NO. 62.5/125, MM12F SM24F	24F)	24F
RADAR DETECTION SENSOR	R	R	SAMPLING (SYSTEM) DETECTOR	s s	SS			—(36F)—
VIDEO DETECTION CAMERA	[V]	<b>V</b> ■	INTERSECTION AND SAMPLING (SYSTEM) DETECTOR	IS (IS)	IS (IS)			
RADAR/VIDEO DETECTION ZONE			QUEUE AND SAMPLING (SYSTEM) DETECTOR	os os	QS (QS)	GROUND ROD -(C) CONTROLLER -(M) MAST ARM	C M P S	$\stackrel{\underline{+}^{C}}{\downarrow} \stackrel{\underline{+}^{M}}{\downarrow} \stackrel{\underline{+}^{P}}{\downarrow} \stackrel{\underline{+}^{S}}{\downarrow}$
PAN, TILT, ZOOM (PTZ) CAMERA	PTZ]	PTZ	WIRELESS DETECTOR SENSOR	<u> </u>	<b>©</b>	-(P) POST -(S) SERVICE		
MERGENCY VEHICLE LIGHT DETECTOR	$\bowtie$	-	WIRELESS ACCESS POINT		-			
CONFIMATION BEACON	<b>⊶</b> (]							
WIRELESS INTERCONNECT	<b>⊶<del>।   </del></b>	• <del>••   </del>						
	ERR	RR						

# TRAFFIC SIGNAL MAST ARM AND SIGNAL POST


MAST ARM MOUNTED SIGNALS IN EXISTING, PROPOSED OR FUTURE SIDEWALK/BICYCLE PATH AREA. INTERSECTION SHOWN WITH PEDESTRIAN SIGNALS AND

PEDESTRIAN PUSHBUTTON DETECTORS.

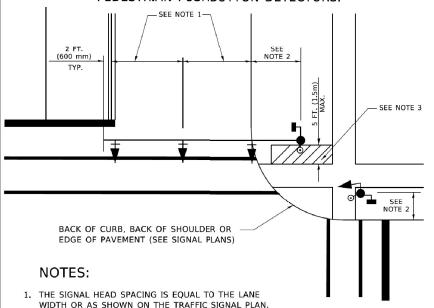


- 2. REFER TO THE TRAFFIC SIGNAL EQUIPMENT OFFSET TABLE.
- PROVIDE A LEVEL ALL-WEATHER SURFACE (CONCRETE SIDEWALK, ASPHALT BICYCLE PATH SURFACE OR MATCHING MATERIAL TO THE ADJACENT SURFACE) UP TO THE MAST ARM SHAFT OR THE SIGNAL POST.
- THE FACE OF THE PEDESTRIAN PUSHBUTTON SHALL BE PARALLEL TO THE CROSSWALK TO BE USED.
- 5. THE LOCATIONS AND INSTALLATION OF PEDESTRIAN SIGNAL HEADS AND PEDESTRIAN PUSHBUTTONS SHALL MEET THE REQUIREMENTS OF THE MUTCD AND INFORMATION FOUND IN THE "AMERICANS WITH DISABILITIES ACT ACCESSIBILITY GUIDELINES FOR BUILDINGS AND FACILITIES."

# PEDESTRIAN SIGNAL POST AND PEDESTRIAN PUSH BUTTON POST

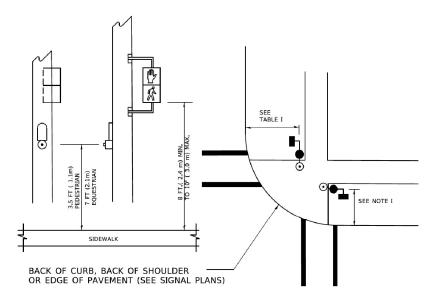

## NOTES:

- 1. REFER TO THE TRAFFIC SIGNAL EQUIPMENT OFFSET TABLE.
- PROVIDE A LEVEL ALL-WEATHER SURFACE (CONCRETE SIDEWALK, ASPHALT BICYCLE PATH SURFACE OR MATCHING MATERIAL TO THE ADJACENT SURFACE) UP TO THE PEDESTRIAN SIGNAL POST OR THE PEDESTRIAN PUSH BUTTON POST.
- THE FACE OF THE PEDESTRIAN PUSHBUTTON SHALL BE PARALLEL TO THE CROSSWALK TO BE USED.
- 4. THE LOCATIONS AND INSTALLATION OF PEDESTRIAN SIGNAL HEADS AND PEDESTRIAN PUSHBUTTONS SHALL MEET THE REQUIREMENTS OF THE MUTCD AND INFORMATION FOUND IN THE "AMERICANS WITH DISABILITIES ACT ACCESSIBILITY GUIDELINES FOR

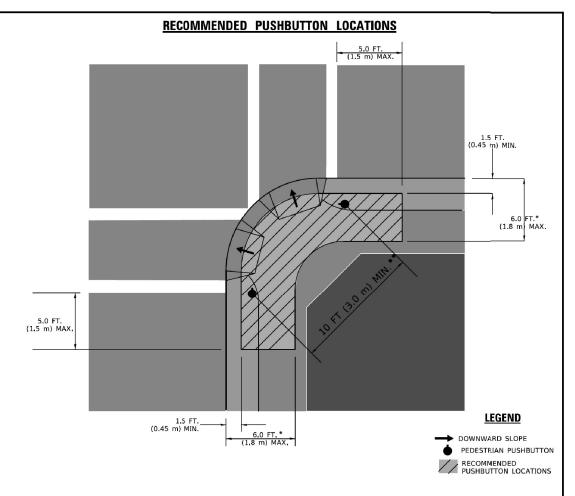

- \* WHERE THERE ARE CONSTRAINTS THAT MAKE IT IMPRACTICAL TO PLACE THE PEDESTRIAN PUSHBUTTON BETWEEN 1.5 FT (0.45 m) AND 6 FT (1.8 m) FROM THE EDGE OF THE CURB, SHOULDER, OR PAVEMENT, IT SHOULD NOT BE FURTHER THAN 10 FT (3 iii) FROM THE EDGE OF CURB, SHOULDER, OR PAVEMENT.
- \*\* WHERE THERE ARE CONSTRAINTS ON A PARTICULAR CORNER THAT MAKE IT IMPRACTICAL TO PROVIDE THE 10 FT (3 m) SEPERATION BETWEEN THE TWO PEDESTRIAN PUSHBUTTONS, THE PUSHBUTTONS MAY BE PLACED CLOSER TOGETHER OR ON THE SAME POLE.

## NOTES:

- PEDESTRIAN SIGNAL HEADS SHALL BE MOUNTED WITH THE BOTTOM OF THE SIGNAL HOUSING INCLUDING BRACKETS NOT LESS THAN 8 FT (2.4 m) OR MORE THAN 10 FT (3 m) ABOVE SIDEWALK LEVEL, AND SHALL BE POSITIONED AND ADJUSTED TO PROVIDE MAXIMUM VISIBILITY AT THE BEGINNING OF THE CONTROLLED CROSSWALK.
- THE BOTTOM OF THE SIGNAL HOUSING (INCLUDING BRACKETS) OF A VEHICULAR SIGNAL FACE THAT IS NOT LOCATED OVER A HIGHWAY SHALL BE AT LEAST 8 FT (2.4 m) BUT NOT MORE THAN 19 FT (5.8 m) ABOVE THE SIDEWALK OR, IF THERE IS NO SIDEWALK, ABOVE THE PAVEMENT GRADE AT THE CENTER OF THE ROADWAY.
- 3. THE BOTTOM OF THE SIGNAL HOUSING AND ANY RELATED ATTACHMENTS TO A SIGNAL FACE LOCATED OVER ANY PORTION OF A HIGHWAY SHALL BE ACCORDING TO CURRENT STATE STANDARDS 877001, 877002, 877006, 877011 AND 877012 WITH A MINIMUM OF 16 FT (5.0 m) AND A MAXIMUM OF 18 FT. (5.5 m) FROM THE HIGHEST POINT OF PAVEMENT.
- 4. THE BOTTOM OF THE TEMPORARY SPAN WIRE MOUNTED SIGNAL HOUSING AND ANY RELATED ATTACHMENTS TO A SIGNAL FACE LOCATED OVER ANY PORTION OF A HIGHWAY SHALL BE ACCORDING TO CURRENT STATE STANDARD 880001 WITH A MINIMUM OF 17 FT (5.18 m) FROM THE HIGHEST POINT OF PAVEMENT.
- THE TOP OF THE SIGNAL HOUSING OF A SIGNAL FACE LOCATED OVER ANY PORTION OF A HIGHWAY SHALL NOT BE MORE THAN 25.6 FT (7.8 m) ABOVE THE PAVEMENT.

#### TRAFFIC SIGNAL EQUIPMENT OFFSET

TRAFFIC SIGNAL EQUIPMENT	COMBINATION CONCRETE CURB AND GUTTER (MINIMUM DISTANCE FROM BACK OF CURB TO CENTERLINE OF FOUNDATION)	SHOULDER/NON-CURBED AREA (MINIMUM DISTANCE FROM EDGE OF PAVEMENT TO CENTERLINE OF FOUNDATION)						
TRAFFIC SIGNAL MAST ARM POLE	6 FT (1.8m)	SHOULDER WIDTH + 2 FT (0.6m), MINIMUM 10 FT (3.0m)						
TRAFFIC SIGNAL POST	4 FT (1.2m)	SHOULDER WIDTH + 2 FT (0.6m), MINIMUM 10 FT (3.0m)						
PEDESTRIAN SIGNAL POST	4 FT (1.2m)	SHOULDER WIDTH + 2 FT (0.6m), MINIMUM 10 FT (3.0m)						
PEDESTRIAN PUSHBUTTON POST	4 FT (1.2m)	SHOULDER WIDTH + 2 FT (0.6m), MINIMUM 10 FT (3.0m)						
TEMPORARY WOOD POLE	6 FT (1.8m)	SHOULDER WIDTH + 2 FT (0.6m), MINIMUM 10 FT (3.0m)						
CONTROLLER CABINET	6 FT (1.8m) MINIMUM DISTANCE SEE NOTE 2	SHOULDER WIDTH + 6 FT (1.8m), MINIMUM 16 FT (4.9m) SEE NOTE 3.						
SERVICE INSTALLATION, GROUND MOUNT	6 FT (1.8m) MINIMUM DISTANCE SEE NOTE 2	SHOULDER WIDTH + 6 FT (1.8m), MINIMUM 16 FT (4.9m) SEE NOTE 3.						


#### NOTES:


- 1. CONTACT THE "AREA TRAFFIC SIGNAL MAINTENANCE AND OPERATIONS ENGINEER" FOR ASSISTANCE IN LOCATING THE TRAFFIC SIGNAL EQUIPMENT WHEN THERE ARE CONFLICTS WITH DITCHES OR THE MINIMUM OFFSET DISTANCES CANNOT BE MET.
- 2. MINIMUM DISTANCE FROM THE BACK OF CURB TO THE ROADWAY SIDE OF THE FOUNDATION.
- 3. MINIMUM DISTANCE FROM THE EDGE OF PAVEMENT TOTHE ROADWAY SIDE OF THE FOUNDATION.
- 4. ANY CHANGES TO THE OFFSETS OF THE FOUNDATIONS, FROM THE MINIMUM DISTANCES LISTED IN THE "TRAFFIC SIGNAL EQUIPMENT OFFSET" CHART AND THE TRAFFIC SIGNAL INSTALLATION PLAN, COULD EFFECT THE PLACEMENT OF THE SIGNAL HEADS, PEDESTRIAN SIGNAL HEADS AND THE PEDESTRIAN PUSHBUTTONS. THE SIGNAL HEAD PLACEMENT ON THE MAST ARMS SHALL REMAIN AS PER THE TRAFFIC SIGNAL INSTALLATION PLAN AND THE "TRAFFIC SIGNAL MAST ARM AND SIGNAL POST" DETAIL ABOVE. THE PROPOSED MAST ARM LENGTHS MAY NEED TO BE REVISED TO MEET THE ABOVE REQUIREMENTS. THE PEDESTRIAN SIGNAL HEADS AND PEDESTRIAN PUSHBUTTONS MUST MEET THE REQUIREMENTS UNDER THE DETAILS ON THIS SHEET.


SCALE: NONE

USER NAME = footemj	DESIGNED -	REVISED -
	DRAWN -	REVISED -
PLOT SCALE = 50.0000 ' / in.	CHECKED -	REVISED -
PLOT DATE = 3/4/2019	DATE -	REVISED -


STATE OF ILLINOIS
DEPARTMENT OF TRANSPORTATION

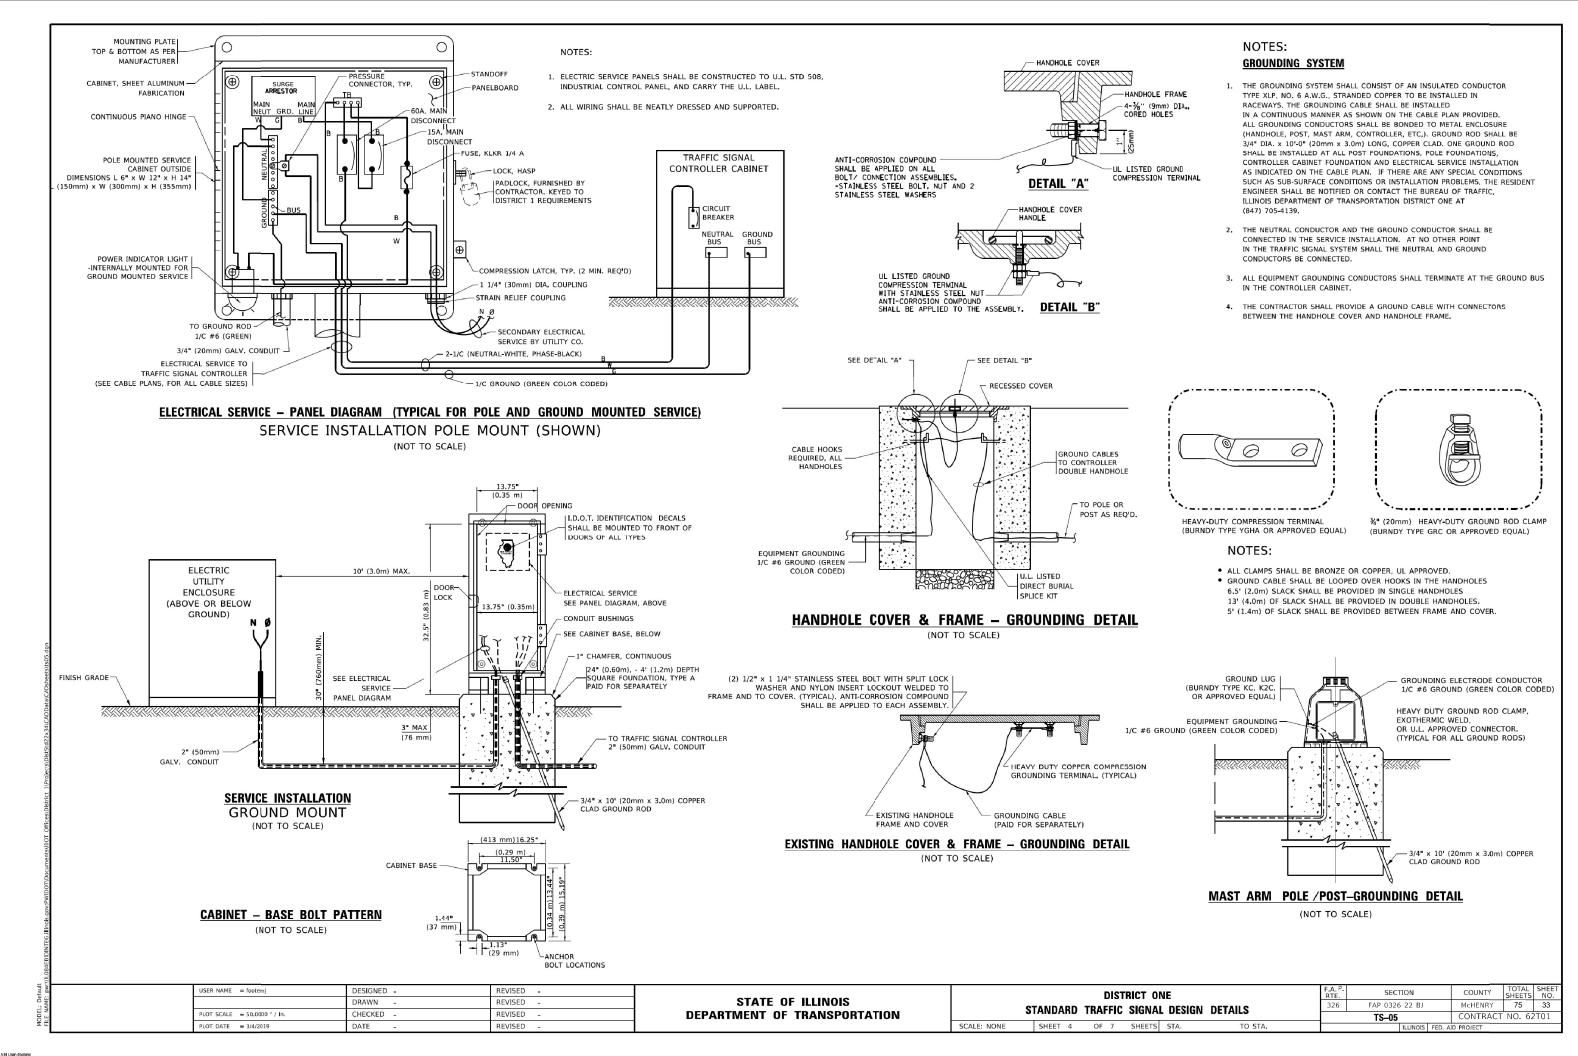

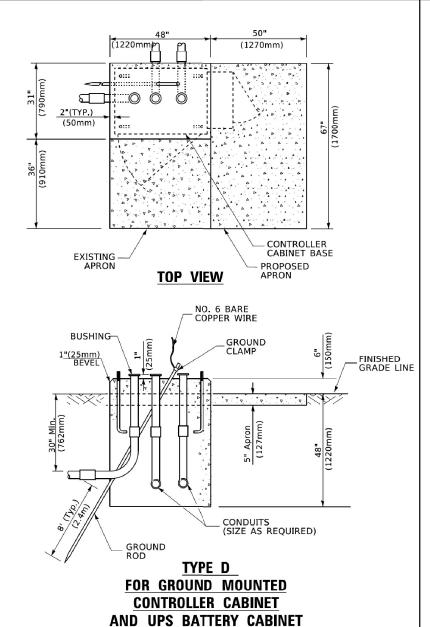

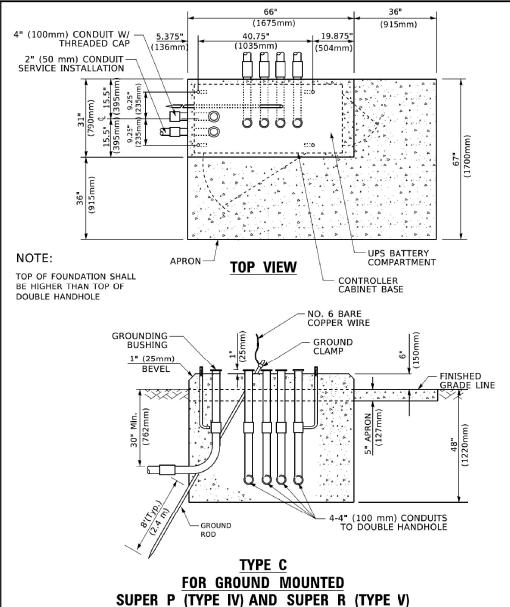

**CONTROLLER CABINETS** 

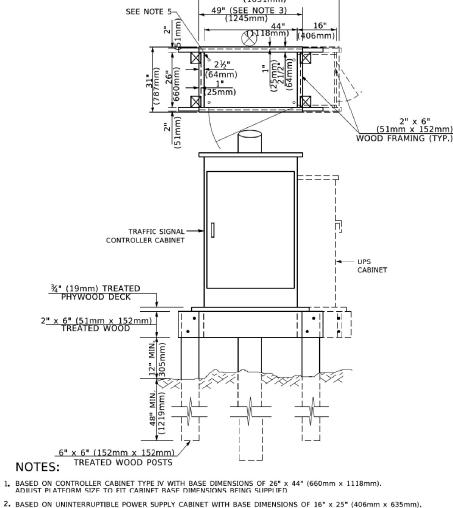

65" (SEE NOTE 4) (1651mm)

- BASED ON UNINTERRUPTIBLE POWER SUPPLY CABINET WITH BASE DIMENSIONS OF 16" x 25" (406mm x 635mm), ADJUST PLATFORM SIZE TO FIT CABINET BASE DIMENSIONS BEING SUPPLIED.
- $\mathbf{3}_{\bullet}$  PLATFORM SIZE FOR CONTROLLER CABINET TYPE IV.
- 4. PLATFORM SIZE FOR CONTROLLER CABINET TYPE IV AND UNINTERRUPTIBLE POWER SUPPLY CABINET
- 5. DRILLED HOLES THROUGH THE PLATFORM BASE TO MATCH THE CONTROLLER CABINET BOLT TEMPLATE. FASTEN THE CONTROLLER CABINET TO THE PLATFORM WITH CARRIAGE BOLTS, WASHERS AND NUTS.
- 6. FASTEN ALL SUPPORT WOOD FRAMING TO THE WOOD POSTS WITH 2 LAG SCREWS FOR EACH CONNECTION..

# **TEMPORARY SIGNAL CONTROLLER** WOOD SUPPORT PLATFORM

CABLE SLACK LENGTH	FEET	METER
HANDHOLE	6.5	2.0
DOUBLE HANDHOLE	13.0	4.0
SIGNAL POST	2.0	0.6
MAST ARM	2.0	0.6
CONTROLLER CABINET	1.5	0.5
FIBER OPTIC AT CABINET	13.0	4.0
ELECTRIC SERVICE AT (CABINET OR SERVICE LOCATION)	1.5	0.5
GROUND CABLE (SIGNAL POST, MAST ARM, CABINET)	1.5	0.5
GROUND CABLE (BETWEEN FRAME AND COVER)	5.0	1.6

VERTICAL CABLE LENGTH	FEET	METER
MAST ARM POLE ( MAST ARM MOUNTED SIGNAL HEAD)		
(L = MAST ARM LENGTH - DISTANCE TO SIGNAL HEAD FROM END OF ARM)	20.0+L	6.0+L
BRACKET MOUNTED (MAST ARM POLE OR SIGNAL POLE)	13.0	4.0
PEDESTRIAN PUSH BUTTON	6.0	2.0
SERVICE INSTALLATION POLE MOUNT TO SERVICE DROP	13.5	4.1
SERVICE INSTALLATION POLE MOUNT TO GROUND	13.5	4.1
SERVICE INSTALLATION GROUND MOUNT	6.0	2.0
FOUNDATION (SIGNAL POST, MAST ARM POLE, CONTROLLER CABINET, SERVICE-GROUND MOUNT)	3.0	1.0
·		

## **VERTICAL CABLE LENGTH**

**CABLE SLACK** 

FOUNDATION	DEPTH
TYPE A - Signal Post	4'-0" (1.2m)
TYPE C - CONTROLLER W/ UPS	4'-0" (1.2m)
TYPE D - CONTROLLER	4'-0" (1.2m)
SERVICE INSTALLATION, GROUND MOUNT, TYPE A - SQUARE	4'-0" (1.2m)


### **DEPTH OF FOUNDATION**

Mast Arm Length	<ol> <li>Foundation Depth</li> </ol>	Foundation Diameter	Spiral Diameter	Quantity of Rebars	Size of Rebars
Less than 30′ (9.1 m)	10'-0" (3.0 m)	30" (750mm)	24" (600mm)	8	6(19)
Greater than or equal to	13'-6" (4.1 m)	30" (750mm)	24" (600mm)	8	6(19)
30' (9.1 m) and less than 40' (12.2 m)	11'-0" (3.4 m)	36" (900mm)	30" (750mm)	12	7(22)
Greater than or equal to 40' (12.2 m) and less than 50' (15.2 m)	13'-0" (4 <sub>•</sub> 0 m)	36" (900mm)	30" (750mm)	12	7(22)
Greater than or equal to 50' (15.2 m) and up to 55' (16.8 m)	15'-0'' (4 <b>.</b> 6 m)	36" (900mm)	30'' (750mm)	12	7(22)
Greater than or equal to 56' (16.8 m) and less than 65' (19.8 m)	21'-0" (6.4 m)	42" (1060mm)	36" (900mm)	16	8(25)
Greater than or equal to 65' (19.8 m) and up to 75' (22.9 m)	25'-0'' (7 <b>.</b> 6 m)	42'' (1060mm)	36" (900mm)	16	8(25)

- 1. These foundation depths are for sites which have cohesive soils (clayey silt, sandy clay, etc.) along the length of the shaft, with an average Unconfined Compressive Strength (Ou) > 1.0 tsf (100 kpa). This strength shall be verified by boring data prior to construction or with testing by the Engineer during foundation drilling. The Bureau of Bridges & structures should be contacted for a revised design if other conditions are encountered.
- 2. Combination mast arm assemblies under 55 feet (16.8 m) shall use 36" (900 mm) diameter foundations.
- 3. Combination mast arm assemblies under 56 feet (16,8 m) through 75 feet (22,9 m) shall use 42" (1060 mm) diameter foundations
- 4. For most arm assemblies with dual arms refer to state standard 878001...

# DEPTH OF MAST ARM FOUNDATIONS, TYPE E

USER NAME = footemj	DESIGNED -	REVISED -		DISTRICT ONE		SECTION	COUNTY TOTAL SHEETS	SHEET
	DRAWN -	REVISED -	STATE OF ILLINOIS		326	FAP 0326 22 BJ	McHENRY 75	34
PLOT SCALE = 50,0000 ' / in.	CHECKED -	REVISED -	DEPARTMENT OF TRANSPORTATION STANDARD TRAFFIC SIGNAL DESIGN DETAILS			TS-05	CONTRACT NO. 62	T01
PLOT DATE = 3/4/2019	DATE -	REVISED -		SCALE: NONE SHEET 5 OF 7 SHEETS STA. TO STA.		ILLINOIS FED	. AID PROJECT	

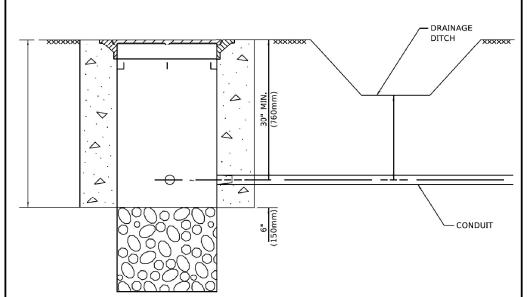


#### NOTES:

- 1. CONDUIT DEPTH SHALL BE A MINIMUM OF 30" (760mm) BELOW THE BOTTOM OF THE DRAINAGE DITCH OR ANY SLOPING GROUND
- 2. THE MINIMUM CONDUIT DEPTH APPLIES TO ALL CONDUIT PLACED UNDER ROADWAY PAVEMENT, MULTI-USE PATHS, SIDEWALKS AND SOIL SURFACES.
- 3. THE MINIMUM CONDUIT DEPTH APPLIES TO ALL HANDHOLES, HEAVY DUTY HANDHOLES AND DOUBLE HANDHOLES.

USER NAME = footem

LOT SCALE = 50.0000 ' / in.

# HANDHOLE WITH MINIMUM CONDUIT DEPTH

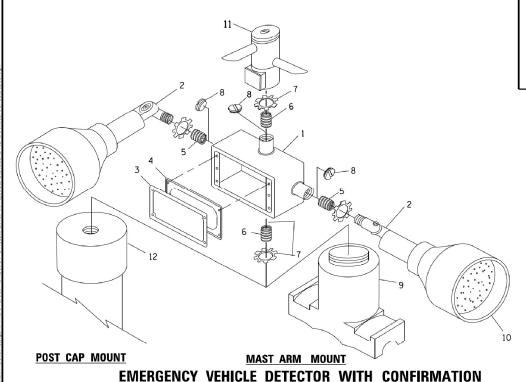

**BEACON MOUNTING DETAIL** 

DESIGNED -

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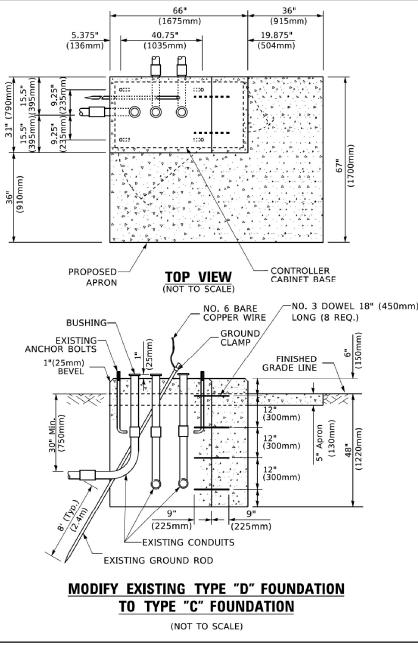
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DATE

REVISED -


REVISED

REVISED



# IDENTIFICATION OUTLET BOX- GALV. 21 CU.IN. (0.000344 CU-M) LAMP HOLDER AND COVER 3 OUTLET BOX COVER 4 RUBBER COVER GASKET 5 REDUCING BUSHING 6 ¾"(19 mm) CLOSE NIPPLE 7 ¾"(19 mm) LOCKNUT 8 ¾"(19 mm) HOLE PLUG 9 SADDLE BRACKET - GALV. 10 6 WATT PAR 38 LED FLOOD LAMP 11 DETECTOR UNIT 12 POST CAP [18 FT. (5.4 m) POST MIN.]


- 1. ALL ELECTRICAL ITEMS, EXCEPT ITEMS #2 AND #11 SHALL BE ALUMINUM OR
- 2. ITEM #1- OZ/GEDNEY FSX-1-50 OR EQUIVALENT ITEM #2- MULBERRY CON-O-SHADE LAMP SHIELD OR EQUIVALENT ITEM #9- "BAND-IT" SADDLE BRACKET OR EQUIVALENT
- 3. WHEN POST MOUNTING IS SPECIFIED. ITEM #9 SHALL NOT BE REQUIRED. THE DETECTION UNIT SHALL BE MOUNTED DIRECTLY ON TOP OF THE CAP BY DRILLING AND TAPPING A 3/4 "(19 mm) HOLE WITH PIPE THREADS. THE POST CAP SHALL EITHER BE SCREWED TO THE TOP OF THE POST OR A MINIMUM OF 3 TIGHTENING SCREWS SHALL BE REQUIRED ON EACH CAP.

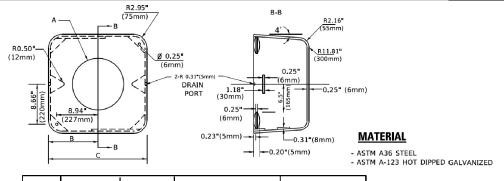


Α	В	С	HEIGHT	WEIGHT		
VARIES	9.5"(241mm)	19"(483mm)	7" (178mm) - 12" (300mm)	53 lbs (24kg)		
VARIES	10.75"(273mm)	21.5"(546mm)	7" (178mm) - 12" (300mm)	68 lbs (31 kg)		
VARIES	13.0"(330mm)	26"(660mm)	7" (178mm) - 12" (300mm)	81 lbs (37 kg)		
VARIES	18.5"(470mm)	37 <b>"</b> (940mm)	7" (178mm) - 12" (300mm)	126 lbs (57 kg)		

## SHROUD

- . DIMENSION "A" IS EQUAL TO THE DIAMETER OF THE MAST ARM POLE AT THE TOP OF THE SHROUD. THE SHROUD SHALL BE TIGHT TO THE MAST ARM POLE.
- 2. THE SUPPLIER SHALL VERIFIED THE ABOVE DIMENSIONS BASED ON MAST ARM REQUIREMENTS.
- 3. THE HEIGHT OF THE SHROUD SHALL COVER THE ANCHOR BOLTS, NUTS AND MAST ARM POLE BASE.

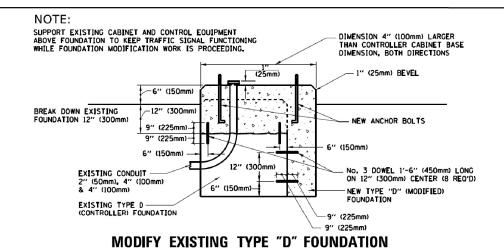

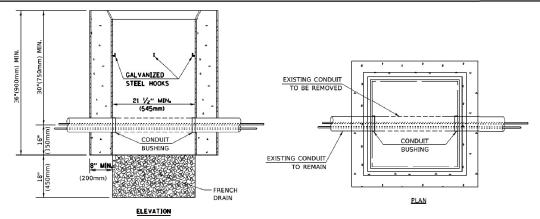


- 1. HANDHOLE CONSTRUCTED PER STATE STANDARD 814001.
- 2. REMOVAL OF THE EXISTING CONDUIT FROM THE HANDHOLE AND THE INSTALLATION OF THE CONDUIT BUSHINGS SHALL BE INCLUDED WITH THE COST OF THE HANDHOLE.

# HANDHOLE TO INTERCEPT EXISTING CONDUIT

SHEETS NO. DISTRICT ONE FAP 0326 22 BJ McHENRY STANDARD TRAFFIC SIGNAL DESIGN DETAILS CONTRACT NO. 62T01 TS-05 SHEET 6 OF 7 SHEETS STA.


STATE OF ILLINOIS **DEPARTMENT OF TRANSPORTATION** 

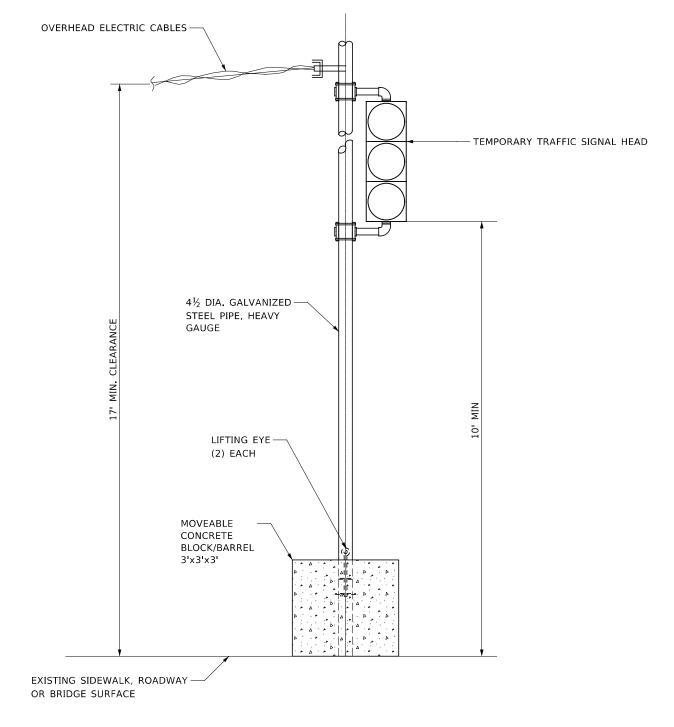

# TEMPORARY SIGNAL POST - BARREL MOUNTED

NOT TO SCALE

NOTE: THIS WORK WILL BE INCLUDED IN THE COST FOR TEMPORARY TRAFFIC SIGNAL INSTALLATION.

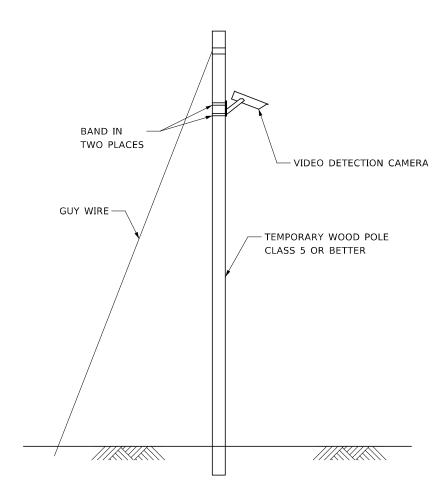

# TEMPORARY VIDEO DETECTION MOUNTING DETAIL NOT TO SCALE


NOTE: THIS WORK WILL BE INCLUDED IN THE COST FOR TEMPORARY TRAFFIC SIGNAL INSTALLATION.

USER NAME = USMM706094	DESIGNED - PAS	REVISED -
	DRAWN - PAS	REVISED -
PLOT SCALE = 1:2	CHECKED - MJM	REVISED -
PLOT DATE = 5/11/2023	DATE - 05/05/2023	REVISED -

STATE OF ILLINOIS **DEPARTMENT OF TRANSPORTATION** 

TEMPORARY TRAFFIC SIGNAL DETAILS									
IL-47 OVER NIPPERSINK CREEK – STRUCTURE NO. 056-0053								326	FAP
IL-47 OVER WITTENSTAN CHEEK - STROCTORE WG. 030-0033									
SCALE: AS SHOWN	SHEET	1	OF	1	SHEETS	STA.	TO STA.		

F.A.P. RTE	SECTION		COUNTY	TOTAL SHEETS	SHEE NO.
326	FAP 0326 22 BJ		McHENRY	75	36
		CONTRACT	NO. 62	2T01	
	ILLINOIS	FED. A	ID PROJECT		

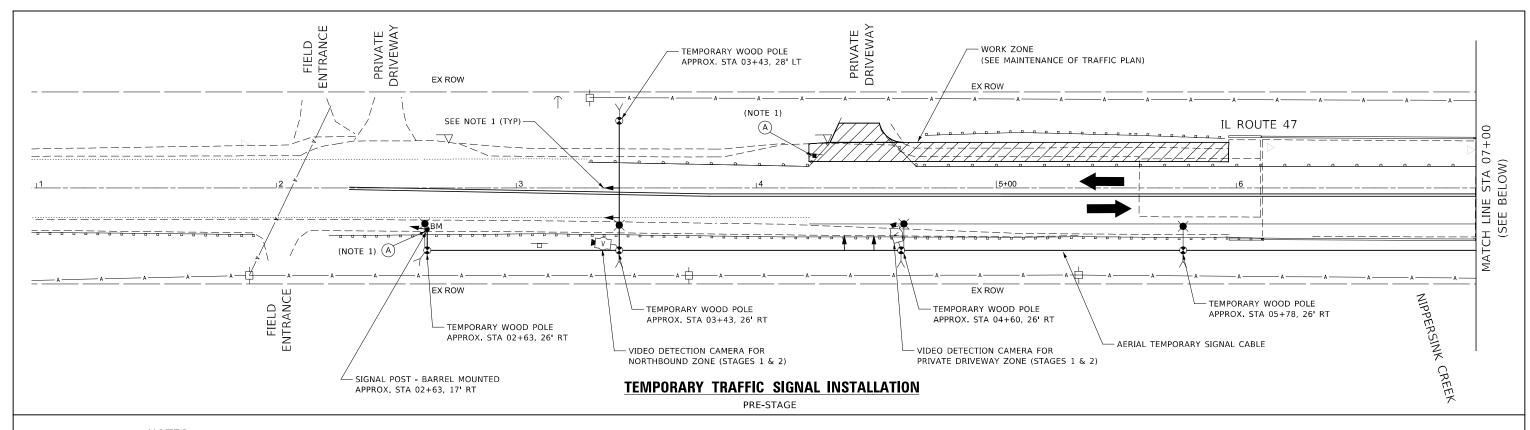

**STOP** HERE ON **RED** 

R10-6aL 24" x 30" 3 REQUIRED

- DURING PRE-STAGE, THE CONTRACTOR SHALL BAG ALL TEMPORARY TRAFFIC SIGNAL HEADS. THE TEMPORARY TRAFFIC SIGNAL SHALL
  REMAIN OUT OF SERVICE DURING PRE-STAGE. THE TEMPORARY TRAFFIC SIGNAL TURN-ON, TEMPORARY STOP BAR PAVEMENT MARKING
  INSTALLATION, AND TEMPORARY SIGNAGE MUST BE COORDINATED TO COINCIDE AT THE SAME TIME WITHIN THE SAME CALENDAR DAY.
- 2. THE CONTRACTOR SHALL PROVIDE ENOUGH CABLE SLACK TO RELOCATE THE TEMPORARY BARREL/BLOCK MOUNTED SIGNAL POSTS TO THE SATISFACTION OF THE ENGINEER.
- 3. THE EXACT LOCATION OF ALL SUBSURFACE UTILITIES IN THE VICINITY OF THE PROPOSED WOOD POLES SHALL BE FIELD VERIFIED BY THE CONTRACTOR BEFORE THE INSTALLATION OF ANY COMPONENTS OF THE TEMPORARY TRAFFIC SIGNAL SYSTEM. THE CONTRACTOR SHALL USE EXTREME CAUTION TO AVOID THE OVERHEAD POWER LINES. THIS WORK WILL NOT BE PAID FOR SEPARATELY AND SHALL BE CONSIDERED INCLUDED IN THE CONTRACT UNIT COST FOR TEMPORARY TRAFFIC SIGNAL INSTALLATION.

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REVISED

DRAWN


HECKED - MJM

- PAS

4. RESTORATION OF THE TEMPORARY LIGHTING AND TRAFFIC SIGNAL WORK AREA SHALL BE CONSIDERED INCLUDED IN THE CONTRACT UNIT COST FOR TEMPORARY LIGHTING FOR SINGLE LANE STAGING AND TEMPORARY TRAFFIC SIGNAL INSTALLATION. ALL DAMAGE TO MOWED LAWNS SHALL BE REPLACED WITH AN APPROVED SOD, AND ALL DAMAGE TO UNMOWED FIELDS SHALL BE SEEDED IN ACCORDANCE WITH STANDARD SPECIFICATIONS 252 AND 250 RESPECTIVELY.

IL-47 OVER NIPPERSINK CREEK - STRUCTURE NO. 056-0053

SCALE: AS SHOWN SHEET 1 OF 1 SHEETS STA.

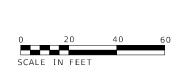


326

FAP 0326 22 BJ


McHENRY

CONTRACT NO. 62T01

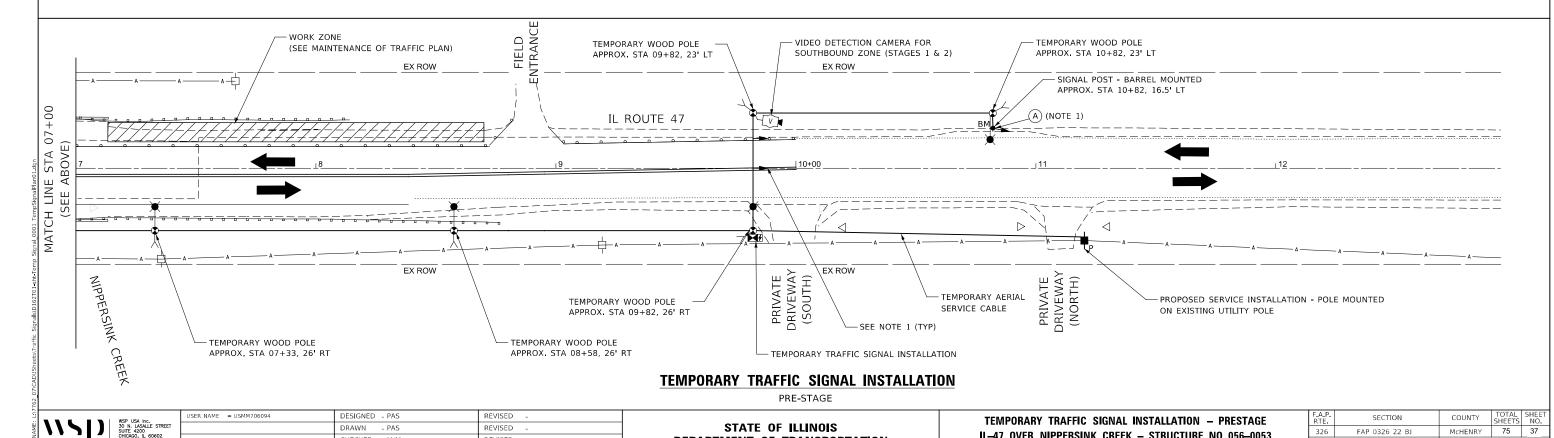

STATE OF ILLINOIS

**DEPARTMENT OF TRANSPORTATION** 

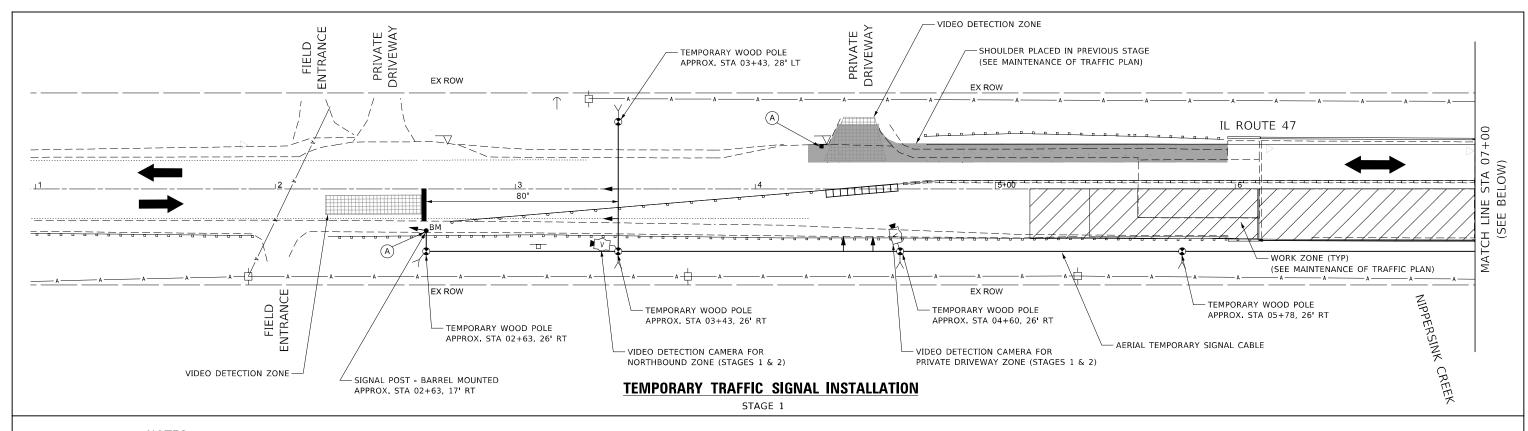

#### NOTES:

JSER NAME = USMM706094

DESIGNED - PAS

HECKED - MJM

- PAS

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> R10-6aL 24" x 30" 3 REQUIRED


- 1. THE CONTRACTOR SHALL PROVIDE ENOUGH CABLE SLACK TO RELOCATE THE TEMPORARY BARREL/BLOCK MOUNTED SIGNAL POSTS TO THE SATISFACTION OF THE ENGINEER.
- 2. THE EXACT LOCATION OF ALL SUBSURFACE UTILITIES IN THE VICINITY OF THE PROPOSED WOOD POLES SHALL BE FIELD VERIFIED BY THE CONTRACTOR BEFORE THE INSTALLATION OF ANY COMPONENTS OF THE TEMPORARY TRAFFIC SIGNAL SYSTEM. THE CONTRACTOR SHALL USE EXTREME CAUTION TO AVOID THE OVERHEAD POWER LINES. THIS WORK WILL NOT BE PAID FOR SEPARATELY AND SHALL BE CONSIDERED INCLUDED IN THE CONTRACT UNIT COST FOR TEMPORARY TRAFFIC SIGNAL INSTALLATION.

REVISED

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REVISED

3. RESTORATION OF THE TEMPORARY LIGHTING AND TRAFFIC SIGNAL WORK AREA SHALL BE CONSIDERED INCLUDED IN THE CONTRACT UNIT COST FOR TEMPORARY LIGHTING FOR SINGLE LANE STAGING AND TEMPORARY TRAFFIC SIGNAL INSTALLATION. ALL DAMAGE TO MOWED LAWNS SHALL BE REPLACED WITH AN APPROVED SOD, AND ALL DAMAGE TO UNMOWED FIELDS SHALL BE SEEDED IN ACCORDANCE WITH STANDARD SPECIFICATIONS 252 AND 250 RESPECTIVELY.

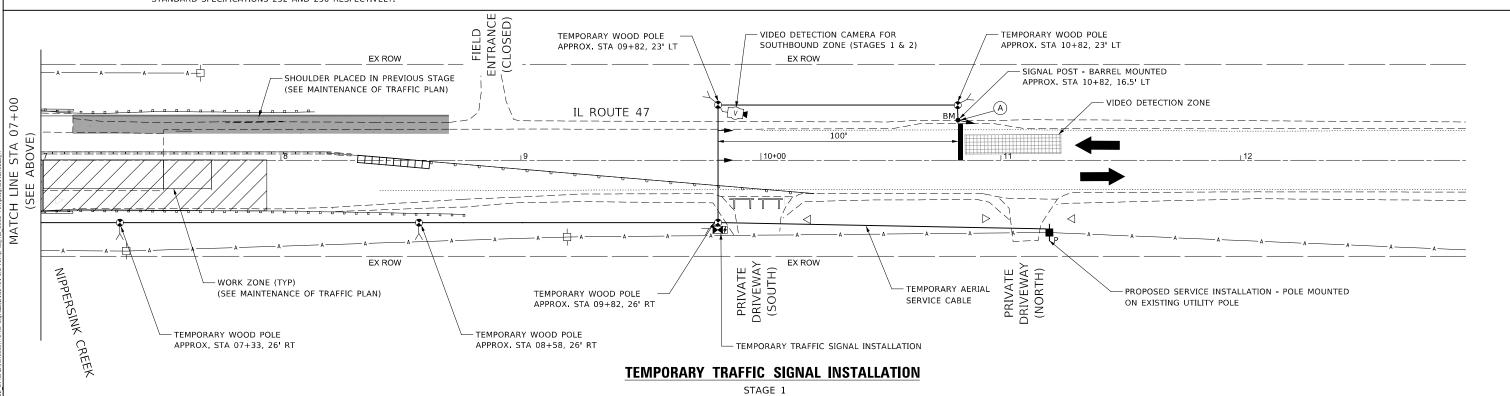

STATE OF ILLINOIS

**DEPARTMENT OF TRANSPORTATION** 

TOTAL SHEE NO. 75 38

COUNTY

McHENRY


CONTRACT NO. 62T01

FAP 0326 22 BJ

TEMPORARY TRAFFIC SIGNAL INSTALLATION - STAGE 1

IL-47 OVER NIPPERSINK CREEK - STRUCTURE NO. 056-0053

SCALE: AS SHOWN SHEET 1 OF 1 SHEETS STA.

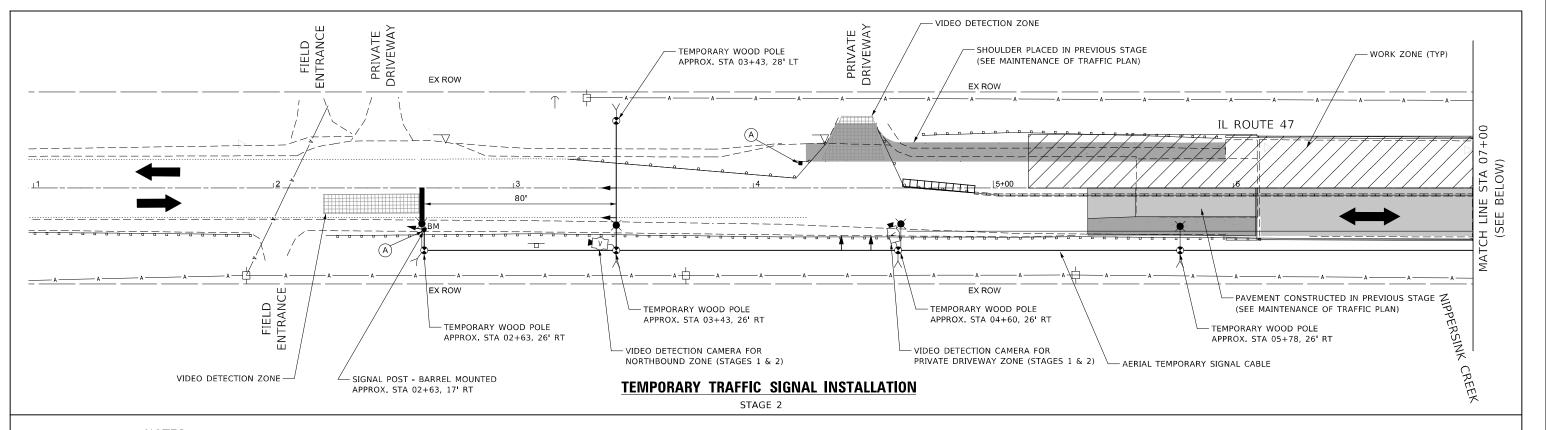

#### NOTES:

JSER NAME = USMM706094

DESIGNED - PAS

HECKED - MJM

- PAS

DRAWN

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R10-6aL 24" x 30" 3 REQUIRED


- 1. THE CONTRACTOR SHALL PROVIDE ENOUGH CABLE SLACK TO RELOCATE THE TEMPORARY BARREL/BLOCK MOUNTED SIGNAL POSTS TO THE SATISFACTION OF THE ENGINEER.
- 2. THE EXACT LOCATION OF ALL SUBSURFACE UTILITIES IN THE VICINITY OF THE PROPOSED WOOD POLES SHALL BE FIELD VERIFIED BY THE CONTRACTOR BEFORE THE INSTALLATION OF ANY COMPONENTS OF THE TEMPORARY TRAFFIC SIGNAL SYSTEM. THE CONTRACTOR SHALL USE EXTREME CAUTION TO AVOID THE OVERHEAD POWER LINES. THIS WORK WILL NOT BE PAID FOR SEPARATELY AND SHALL BE CONSIDERED INCLUDED IN THE CONTRACT UNIT COST FOR TEMPORARY TRAFFIC SIGNAL INSTALLATION.

REVISED

REVISED

REVISED

3. RESTORATION OF THE TEMPORARY LIGHTING AND TRAFFIC SIGNAL WORK AREA SHALL BE CONSIDERED INCLUDED IN THE CONTRACT UNIT COST FOR TEMPORARY LIGHTING FOR SINGLE LANE STAGING AND TEMPORARY TRAFFIC SIGNAL INSTALLATION. ALL DAMAGE TO MOWED LAWNS SHALL BE REPLACED WITH AN APPROVED SOD, AND ALL DAMAGE TO UNMOWED FIELDS SHALL BE SEEDED IN ACCORDANCE WITH STANDARD SPECIFICATIONS 252 AND 250 RESPECTIVELY.

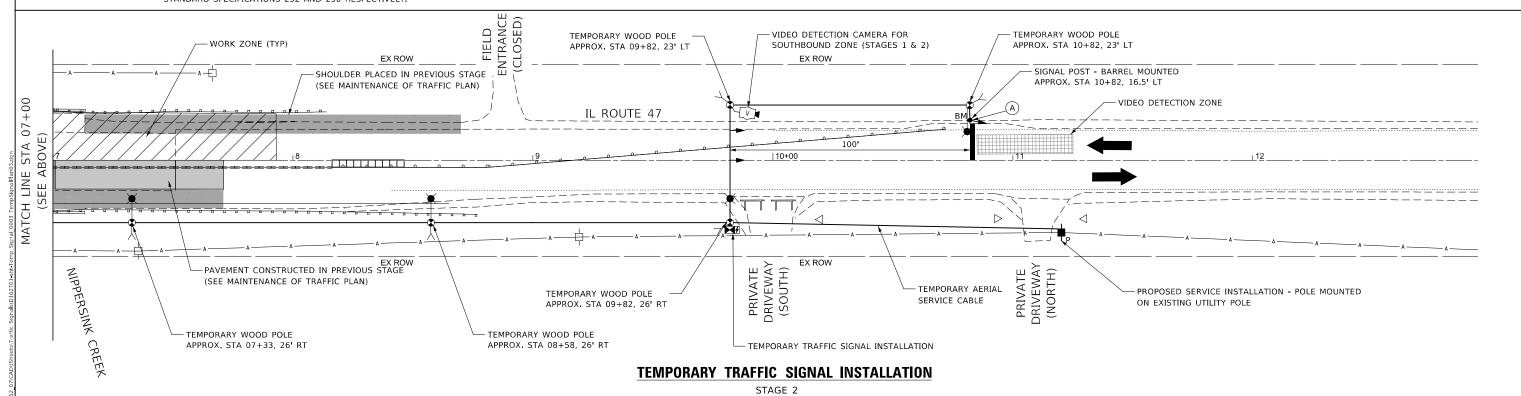

STATE OF ILLINOIS

**DEPARTMENT OF TRANSPORTATION** 

COUNTY

McHENRY

CONTRACT NO. 62T01

326


FAP 0326 22 BJ


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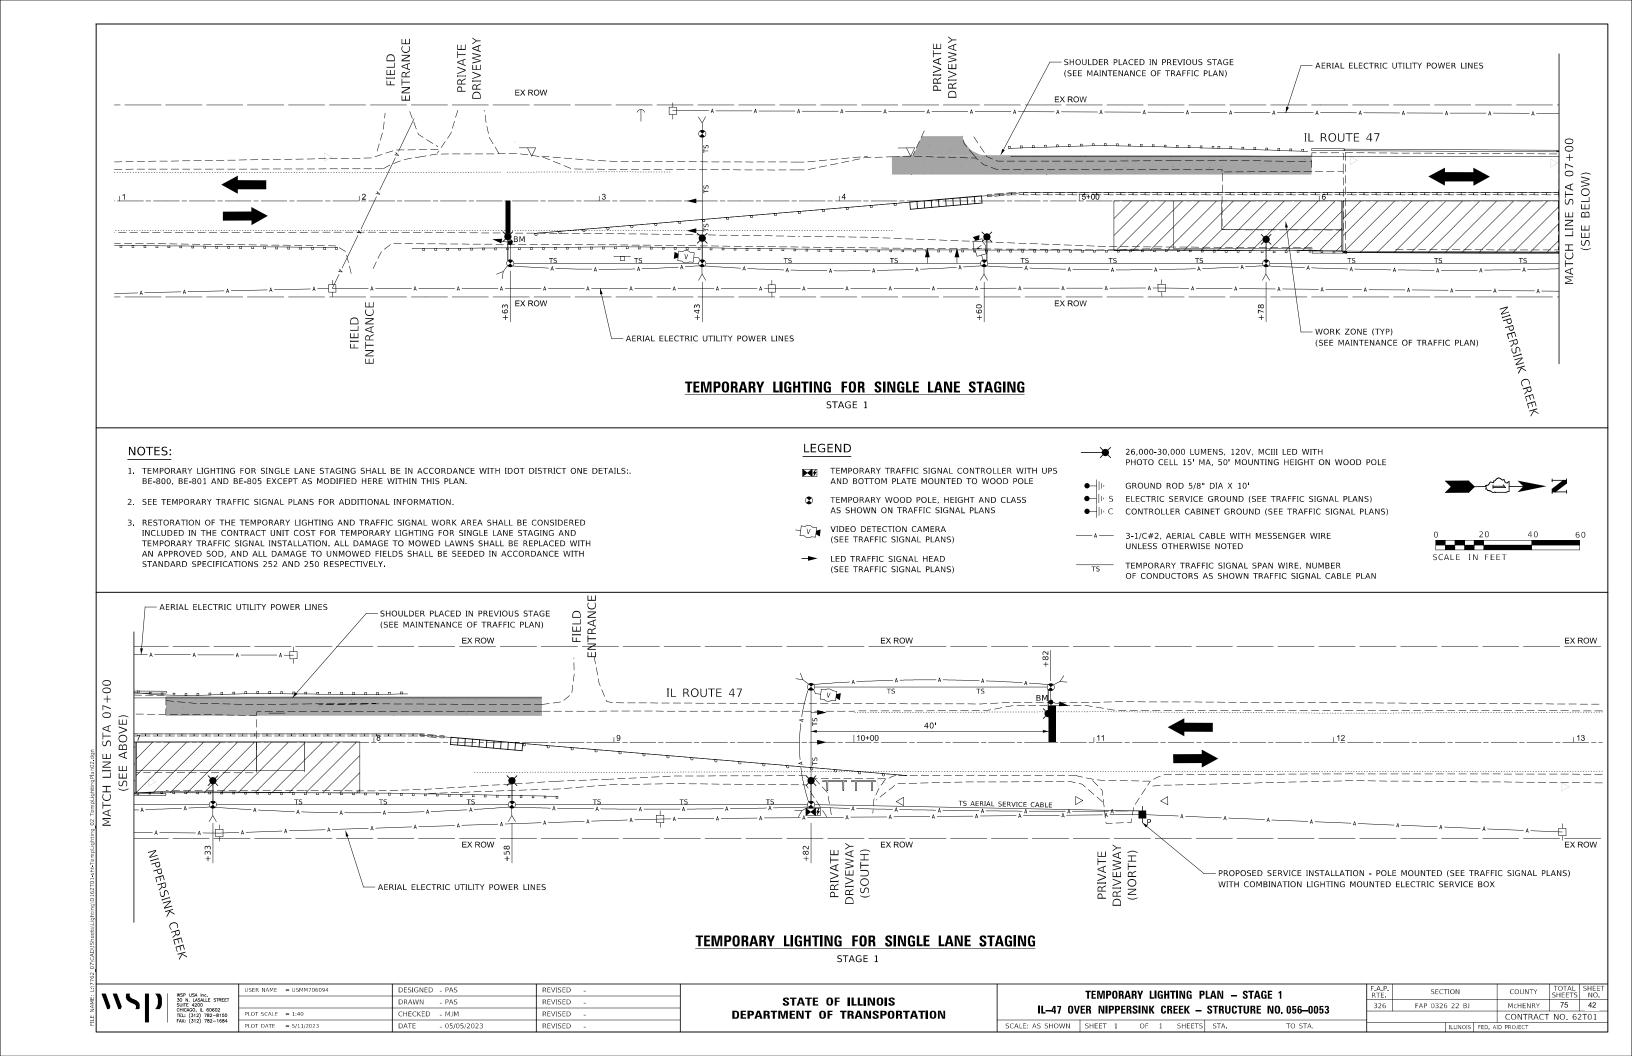
TEMPORARY TRAFFIC SIGNAL INSTALLATION — STAGE 2


IL-47 OVER NIPPERSINK CREEK - STRUCTURE NO. 056-0053


SCALE: AS SHOWN SHEET 1 OF 1 SHEETS STA.



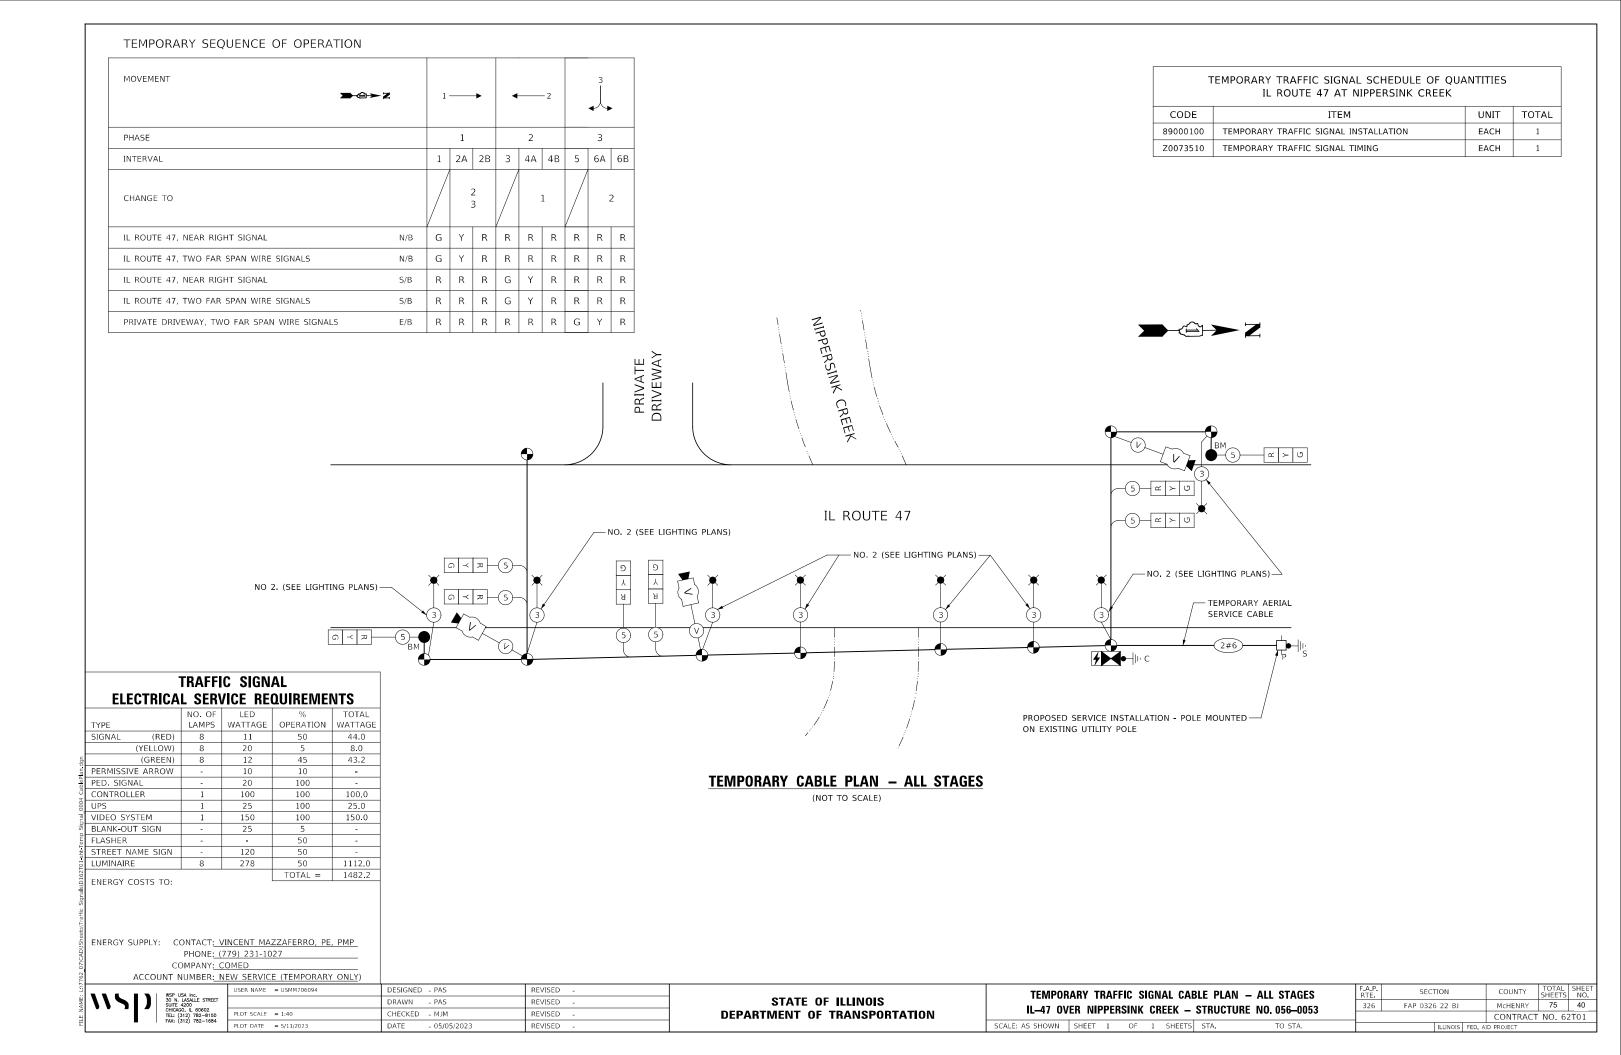

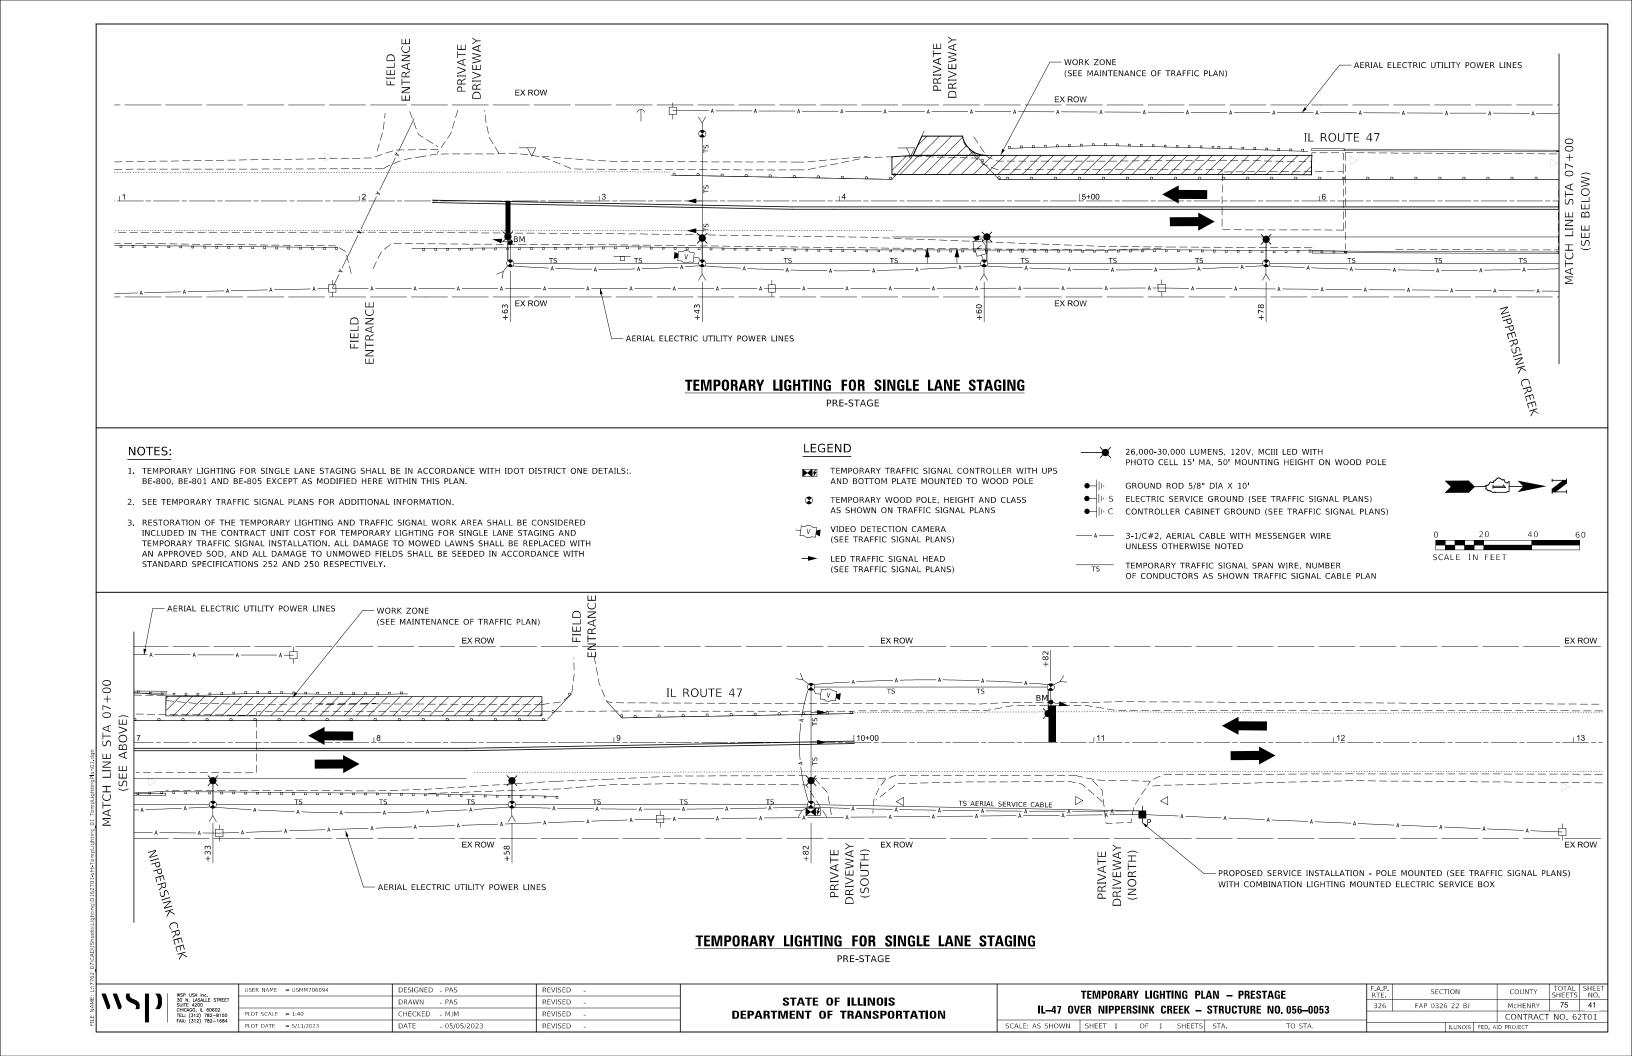

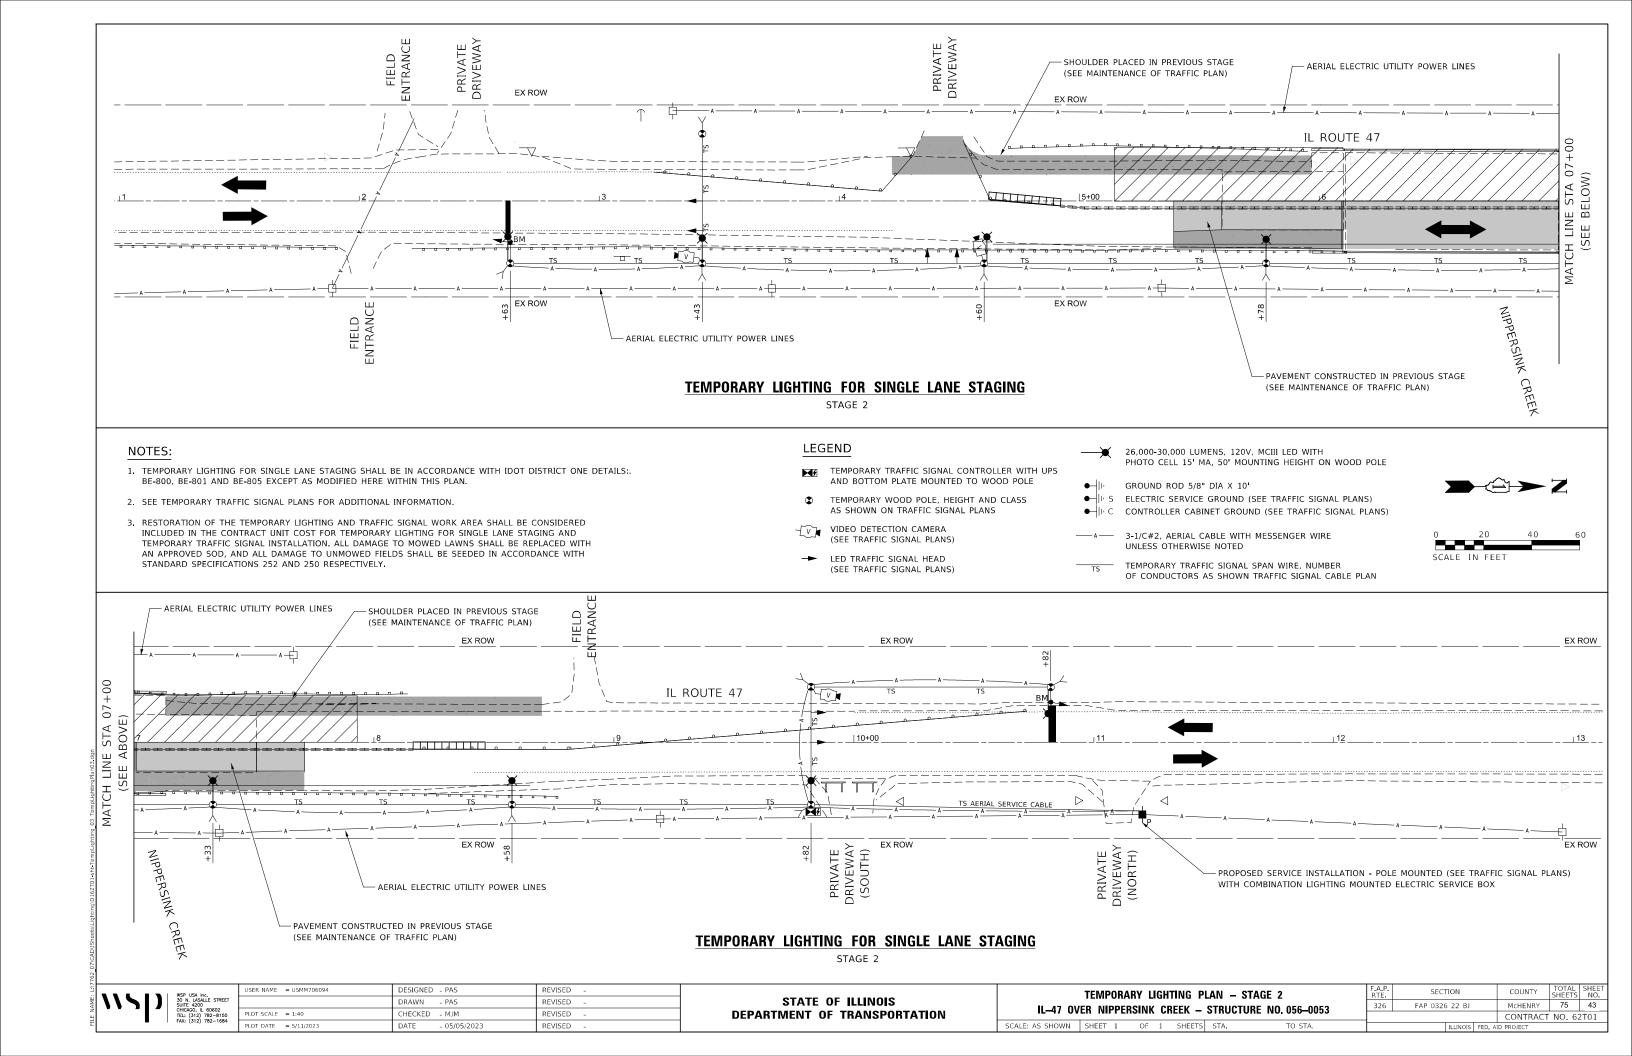


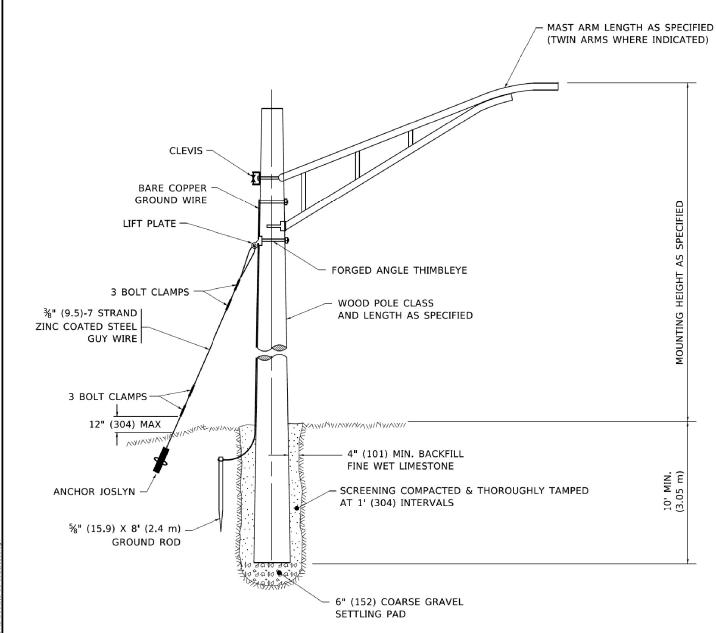



### NOTE:

- 1. ALL DIMENSIONS IN INCHES (MILLIMETERS) UNLESS OTHERWISE INDICATED.
- 2. MAST ARM SHALL BE RATED FOR THE SPECIFIED MOUNTING HEIGHT.

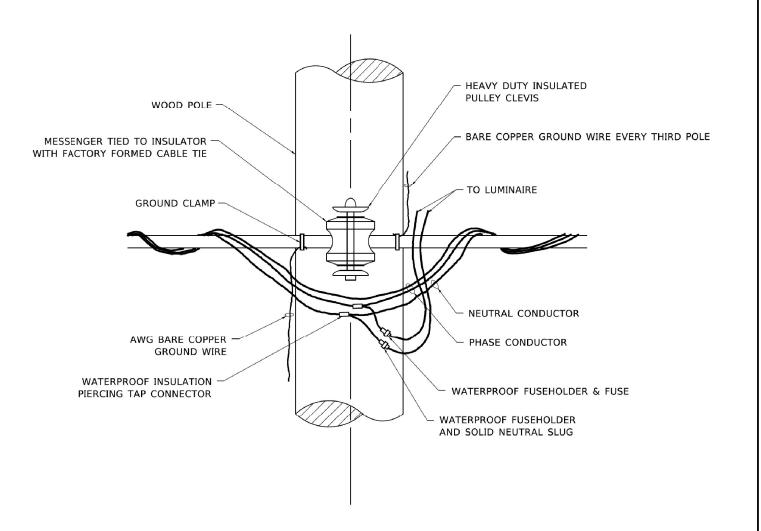

# TEMPORARY LIGHT POLE ATTACHMENT DETAIL


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	DRAWN -	REVISED - R.T. 07-26-16	STATE OF ILLINOIS
PLOT SCALE = 50.0010 ' / in.	CHECKED -	REVISED -	DEPARTMENT OF TRANSPORTATION
PLOT DATE = 4/19/2019	DATE -	REVISED -	


 COUNTY
 TOTAL SHEETS NO.

 McHENRY
 75
 44

 CONTRACT
 NO. 62T01

on 4/19/2019 3:24

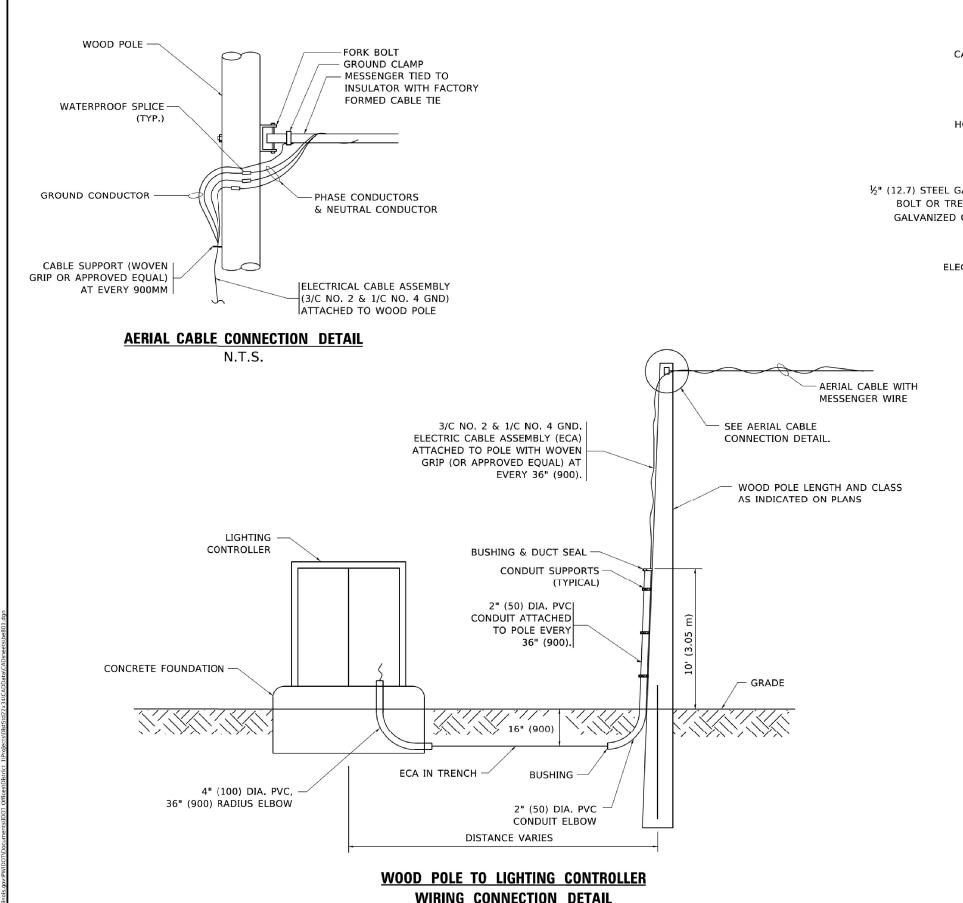

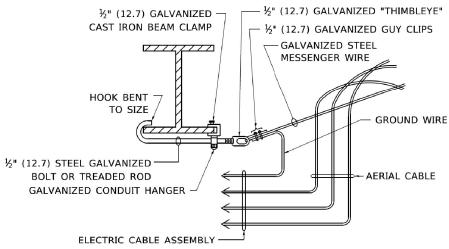

# **AERIAL CABLE** ATTACHED TO STRUCTURE

NOT TO SCALE

#### NOTES:

- 1. ALL DIMENSIONS IN INCHES (MILLIMETERS) UNLESS OTHERWISE INDICATED.
- 2. SEE PROPOSED LIGHTING PLAN FOR CONDUIT, CABLE AND ROUTING.
- 3. THE CONTRACTOR SHALL PROVIDE INTERMEDIATE SUPPORTS TO MAINTAIN MINIMUM CLEARANCES. REFER TO AERIAL AERIAL CABLE ATTACHED TO STRUCTURE DETAIL.
- 4. COST OF SPLICES AND MOUNTING HARDWARE SHALL BE INCLUDED IN THE UNIT PRICE FOR AERIAL CABLE.

# WIRING CONNECTION DETAIL


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USER NAME = footemj	DESIGNED -	REVISED - 08-08-03
	DRAWN -	REVISED -
PLOT SCALE = 50,0000 ' / in.	CHECKED -	REVISED -
PLOT DATE = 4/19/2019	DATE -	REVISED -

STAT	E OF	: ILLINOIS
DEPARTMENT	OF	TRANSPORTATION

SCALE: NONE

	F.A. P. RTE.	SECTION	COUNTY	TOTAL SHEETS	SHEET NO.
TEMPORARY AERIAL CABLE INSTALLATION	326	FAP 0326 22 BJ	McHENRY	75	45
		BE-801	CONTRACT	NO. 62	?T01
SHEET 1 OF 1 SHEETS STA. TO STA.		ILLINOIS FED. AI	D PROJECT		

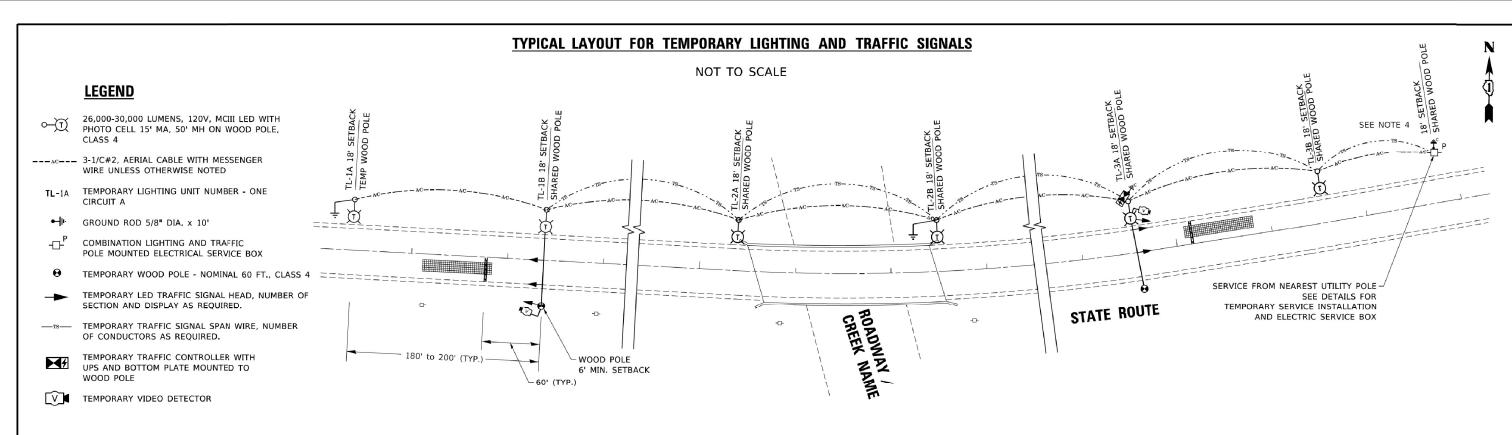

# **GENERAL NOTES:**

1. CONTACT TO THE ELECTRIC UTILITY SHALL BE INITIATED BEFORE THE PRECONSTRUCTION MEETING, AND DOCUMENTATION OF CONTACT SHALL BE PRESENTED AT THAT MEETING. NO PLACEMENT OF POLES WILL BE ALLOWED WITHOUT EVIDENCE OF A SIGNED AGREEMENT WITH THE ELECTRIC UTILITY, FURNISHED TO THE ENGINEER.

2. UNLESS OTHERWISE INDICATED, AND EXCEPT AS OTHERWISE NOTED, THIS STANDARDIZED LAYOUT SHALL APPLY FOR BRIDGES NOT EXCEEDING A 250-FOOT SPAN. FOR BRIDGE SPANS IN EXCESS OF 250 FEET, THE POLES IMMEDIATELY ADJACENT TO THE BRIDGE SHALL BE 100-FOOT POLES (90-FOOT MOUNTING HEIGHT), WITH 56,000-60,000 LUMENS TYPE III LED HIGH-MAST LUMINAIRES AS APPROVED BY THE ENGINEER.

3. THE LAYOUT OF THE TEMPORARY EQUIPMENT WILL VARY BASED ON FIELD CONDITIONS, STAGING, UTILITY IMPACTS, AND THE ELECTRIC SERVICE LOCATION AS COORDINATED WITH THE ELECTRIC UTILITY. THE CONTRACTOR SHALL SUBMIT A PLAN INDICATING THE SETTING OF POLES, TRAFFIC SIGNALS, AND COMBINED SERVICE. THIS PLAN MUST BE APPROVED BY THE ENGINEER BEFORE ANY POLES ARE PLACED

4. THE ELECTRIC SERVICE SHALL BE 240/120V. WHERE 240V SERVICE IS NOT AVAILABLE, THE CONTRACTOR MAY SUBMIT A PROPOSAL FOR 120V SERVICE. DROP CABLE, MAIN BREAKER, AND ALL OTHER SERVICE APPURTENANCES SHALL BE APPROPRIATELY RATED AND INCLUDED REGARDLESS OF THE SERVICE VOLTAGE APPLIED.

5. THE TEMPORARY LIGHTING AND TRAFFIC SIGNAL INSTALLATION SHALL SHARE ANY COMMON ELEMENTS SUCH AS WOOD POLES, ELECTRICAL SERVICE, ELECTRIC SERVICE BOX, CABLE, ETC. THE CONTRACTOR SHALL COORDINATE TEMPORARY LIGHTING AND TRAFFIC SIGNAL


6. THE LIGHT POLE SETBACK FROM THE EDGE OF TRAVEL PAVEMENT SHALL BE 18 FT. UNLESS THE LIGHT POLE IS BEHIND GUARDRAIL. THE LIGHT POLES INSTALLED BEHIND THE GUARDRAIL OR BARRIER WALL SHOULD HAVE AT LEAST 8 FT. SETBACK FROM THE BACK OF THE SHOULDER AND OR AS DIRECTED BY THE ENGINEER.

7. EACH LIGHTING UNIT SHALL BE CONTROLLED BY A PHOTO CELL MOUNTED ON EACH LUMINAIRE WITH THE LIGHTING CIRCUIT FED FROM THE TEMPORARY SERVICE DISCONNECT BOX. OTHER MEANS OF LUMINAIRE CONTROL CAN BE CONSIDERED IF APPROVED BY THE ENGINEER.

8. THE CONTRACTOR SHALL SPLICE AERIAL CABLE AT THE LIGHT POLE USING HEAT SHRINKABLE CAPS WITH THE FACTORY APPLIED WATERPROOF SEALENT OR AN APPROVED UL LISTED AERIAL TAP DEVICE.

9. ALL AREAS DISTURBED UNDER THIS CONTRACT SHALL BE RESTORED TO THE ORIGINAL CONDITION OR BETTER, TO THE SATISFACTION OF THE ENGINEER.

10. THIS LAYOUT IS ONLY FOR SINGLE LANE STAGING WITHOUT PRIVATE DRIVEWAYS WITHIN

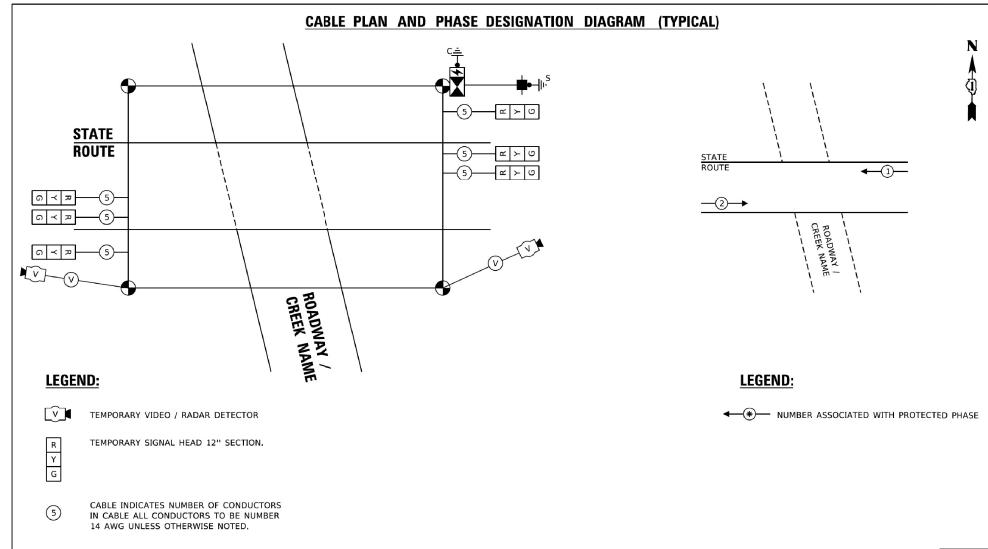


SCALE: NONE

REVISED - 07/28/2020 USER NAME = leysa DESIGNED -DRAWN REVISED LOT SCALE = 50,0000 ' / in CHECKED REVISED PLOT DATE = 8/18/2020 DATE 01/14/2010 REVISED


STATE OF ILLINOIS DEPARTMENT OF TRANSPORTATION TEMPORARY LIGHTING AND TRAFFIC SIGNALS FAP 0326 22 BJ McHENRY FOR SINGLE LANE STAGING CONTRACT NO. 62T01 BE-805 OF 3 SHEETS STA. SHEET 1 TO STA.

SHEETS NO.

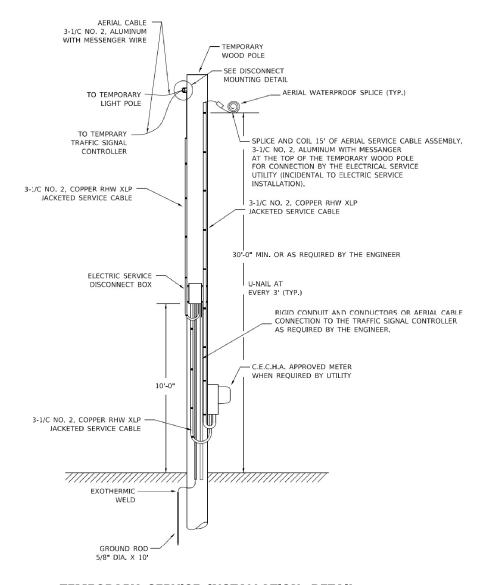


# **TEMPORARY SERVICE INSTALLATION DETAIL**

NOT TO SCALE

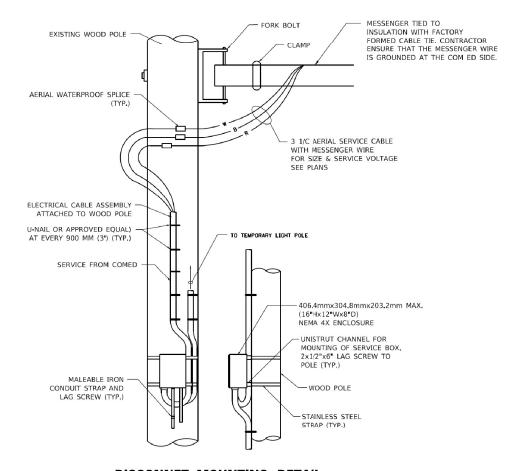

# **DISCONNET MOUNTING DETAIL**

NOT TO SCALE

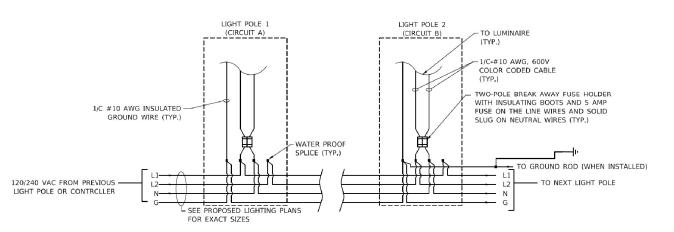


# **LIGHT POLE WIRING DETAIL**

NOT TO SCALE

USER NAME = footemj	DESIGNED - MP	REVISED -		TEMPORARY LIGHTING AND TRAFFIC SIGNALS FOR SINGLE LANE STAGING		F.A.P.	SECTION	COUNTY	TOTAL SI	HEET NO
	DRAWN -	REVISED -	STATE OF ILLINOIS			326	FAP 0326 22 BJ	McHENRY	75	47
PLOT SCALE = 50.0000 ' / in.	CHECKED -	REVISED -	DEPARTMENT OF TRANSPORTATION				BE-805	CONTRACT	F NO. 62T(	01
PLOT DATE = 4/19/2019	DATE - 01/14/10	REVISED -		SCALE: NONE SHEET 2 OF 3 SH	EETS STA. TO STA.		ILLINOIS FE	ED. AID PROJECT		


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#### NOTES:

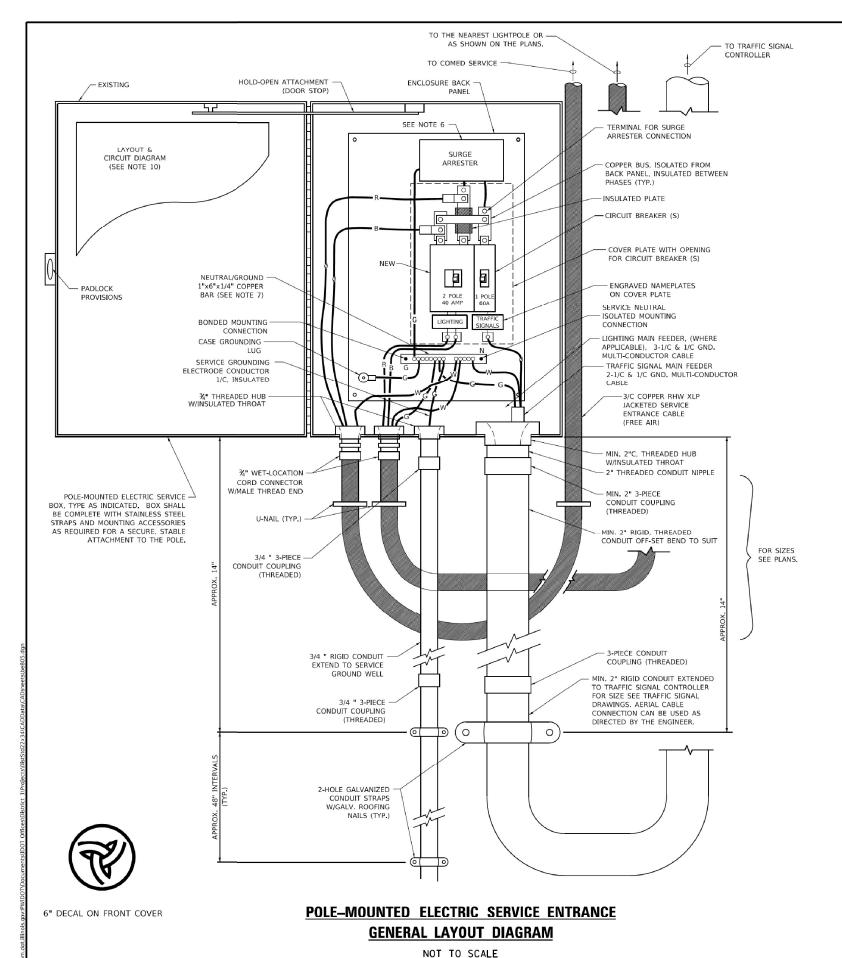- ELECTRIC SERVICE SHALL BE OF THE VOLTAGE INDICATED OR DESIGNATED BY THE ENGINEER. AND SERVICE DROP CABLE SHALL BE COMPATIBLE WITH THE SERVICE ACCORDINGLY. SOME INSTALLATIONS MAY CALL FOR SERVICE ENTRANCE EQUIPMENT SUITABLE FOR 3-WIRE SERVICE EVEN THOUGH INITIALLY WIRED FOR 2-WIRE SERVICE.
- THE POLE-MOUNTED ELECTRIC SERVICE BOX SHALL BE CONFIGURED AND FULLY EQUIPPED FOR 240/120V 3W SERVICE, COMPLETE WITH LIGHTING MAIN BREAKER AND TRAFFIC SIGNALS MAIN BREAKER AS REQUIRED.
- THE ELECTRIC SERVICE EQUIPMENT ASSEMBLY SHALL BE UL LISTED AS SUITABLE FOR USE AS SERVICE ENTRANCE EQUIPMENT.
- 4. THE ELECTRIC SERVICE EQUIPMENT ENCLOSURE SHALL BE NEMA 4X STAINLESS STEEL, NOMINALLY 12\*W X 16\*H X 8\*D, WITH A PIANO-HINGED DOOR, STEEL BACK PANEL, FAST-ACTING STAINLESS STEEL ENCLOSURE CLAMPS, PADLOCK PROVISIONS AND DOOR STOP, HOFFMAN CATALOG NO. A-16H1208SS6LP/A-16 P12/A-DSTOPK/C-PMK12, OR APPROVED EQUAL.
- 5. CIRCUIT BREAKERS SHALL BE THERMAL MAGNETIC BOLT-ON TYPE WITH A MINIMUM INTERRUPTING CAPACITY OF 25,000 SYMMETRICAL AMPERES AT 240 VOLTS. THEY SHALL BE LOCKABLE IN THE "OFF" POSITION FOR COMPLIANCE WITH OSHA LOCK-OUT/ TAG-OUT REQUIREMENTS. HANDLES SHALL BE TRIP FREE.
- 6. THE SURGE PROTECTOR SHALL BE SUITABLE FOR THE SERVICE VOLTAGE SINGLE PHASE 60HZ AC, WITH A SURGE ENERGY CAPABILITY OF 2160 JOULES OR BETTER AT 8/20 MICRO-SECONDS, RATED -40 TO 60 DEGREES C., WITH LED OPERATING INDICATORS, AND SHALL BE UL LISTED PER UL 1449, CUTLER-HAMMER CMOV230L065XST OR APPROVED EQUAL.

- BUS BARS, CONNECTORS, AND LUGS SHALL BE COPPER, INSULATED AND ISOLATED, AND CONFIGURED TO PREVENT SHORTED CONDITIONS FROM TIGHTENING TERMINATIONS, ETC. THE OVERALL BUS SECTION SHALL BE CONFIGURED BEHIND AN INSULATING BARRIER SHIELD WHICH IS REMOVABLE FOR ACCESS TO CONNECTIONS, OR THE ASSEMBLY SHALL BE A MANUFACTURED SPECIALTY PANELBOARD, CUTLER-HAMMER PRL2A OR APPROVED EXILATED.
- 8. THE COMBINATION GROUND AND NEUTRAL BAR SHALL BE CONFIGURED WITH SEPARATE GROUND AND NEUTRAL SECTIONS AND SPARE TERMINALS AS INDICATED. THE HEADS OF GROUND SCREWS SHALL BE PAINTED GREEN. THE HEADS OF NEUTRAL SCREWS SHALL BE PAINTED WHITE. THE SERVICE NEUTRAL AND SERVICE GROUNDING ELECTRODE CONDUCTOR SHALL BE TERMINATED ADJACENT TO EACH OTHER AT THE DIVIDE BETWEEN THE SECTIONS AND WIRING SHALL BE TERMINATED ONLY UPON THE APPROPRIATE SECTION.
- THE WIRING TERMINALS, INCLUDING THE GROUND/NEUTRAL BAR SHALL BE ARRANGED TO PROVIDE ADEQUATE ROOM FOR PERFORMING FIELD TERMINATIONS.
- 10. A PLASTIC LAMINATED LAYOUT AND CIRCUIT DIAGRAM SHALL BE MECHANICALLY SECURED TO THE INTERIOR SIDE OF THE ENCLOSURE DOOR.
- 11. A 2-COLOR ENGRAVED PLASTIC NAMEPLATE, ATTACHED WITH SCREWS AND ENGRAVED AS INDICATED, SHALL BE PROVIDED FOR EACH MAIN BREAKED.
- 12. LUGS AND CONNECTORS SHALL BE RATED FOR 75 C CONDUCTOR.
- 13. THE EXACT MOUNTING HEIGHT OF THE BOX SHALL BE FIELD DETERMINED TO AVOID OBSTRUCTIONS AND PUBLIC ACCESS. TYPICAL HEIGHT SHALL BE APPROXIMATELY 10 FEET ABOVE GRADE.



SCALE

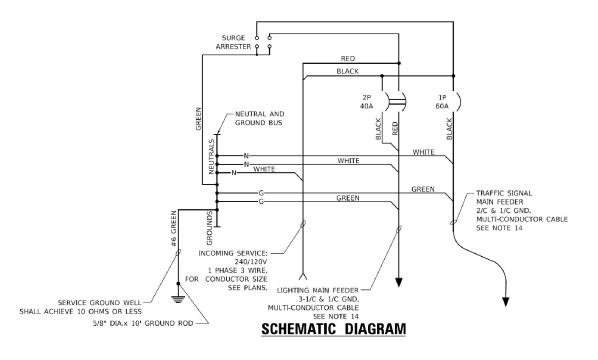REVISED -

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STATE OF ILLINOIS
DEPARTMENT OF TRANSPORTATION

TEMPORARY LIGHTING AND TRAFFIC SIGNALS
FOR SINGLE LANE STAGING

TEMPORARY LIGHTING AND TRAFFIC SIGNALS
FOR SINGLE LANE STAGING

TOTAL SHEET SIGNALS
FOR SINGLE LANE STAGING

TOTAL SHEET SIGNALS
FOR SIGNALS
FAP 0326 22 BJ MCHENRY 75 48

TO STALL SHEET SIGNALS
FOR SHEET SIGNALS
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USER NAME = footemi

LOT SCALE = 50.0000 ' / in


LOT DATE = 4/19/2019

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DRAWN

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DATE



AGGREGATE SHOULDER REMOVAL

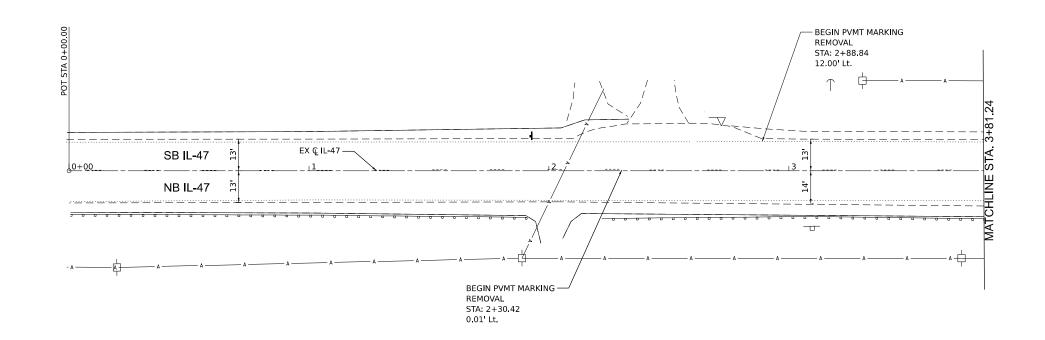DRIVEWAY PAVEMENT REMOVAL

PAVEMENT REMOVAL

HOT-MIX ASPHALT SURFACE REMOVAL,  $1\frac{3}{4}$ "

77 GUARDRAIL REMOVAL


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ΕT		DRAWN -	REVISED -
	PLOT SCALE = 40.000 / in.	CHECKED -	REVISED -
	PLOT DATE = 5/3/2023	DATE 05/05/2023	REVISED -


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DEPARTMENT	0F	TRANSPORTATION

I RT						F.A.P SECTION			COUNTY	TOTAL SHEETS	SHEET NO.		
	REMOVAL PLANS							0326 FAP 032622 BJ		McHENRY	75	49	
											CONTRACT	NO. 62	2T01
	SCALE: 1":20'	SHEET 1	OF	3	SHEETS	STA.	TO STA.	ILLINOIS FED. AID PROJECT					

GUARDRAIL REMOVAL -STA: 5+59.41 — OFFSET: 19.00 LT STA: 5+95.29 OFFSET: 20.63' LT STA: 5+57.81 -OFFSET: 21.94' LT STA: 5+19.41 OFFSET: 19.00' LT\ STA: 7+13.39 -OFFSET: 19.19' LT - STA: 8+70.00 — STA: 5+97.28 OFFSET: 11' LT STA: 7+50.99 STA: 7+90.99 STA: 4+34.43 OFFSET: 27.00' LT\ OFFSET: 11' LT OFFSET: 19.00' LT OFFSET: 19.00' LT STA: 4+51.35 /OFFSET: 27.00' LT STA: 4+29.79 OFFSET: 19.00' LT \_\_\_ EX @ IL-47 OFFSET: 19.00' LT STA: 4+22.00 XXXX \_OFFSET: 18 43 TT SB IL-47 CONC HMA OFFSET: 11' LT L5+00 CONC NB IL-47 HMA CONC STA: 5+59.41 STA: 5+97.09 STA: 7+13.34 STA: 7+50.91 OFFSET: 20.00' Rt. OFFSET: 20.00' Rt. OFFSET: 20.00' Rt. OFFSET: 19.89' Rt. AGGREGATE SHOULDER REMOVAL DRIVEWAY PAVEMENT REMOVAL PAVEMENT REMOVAL HOT-MIX ASPHALT SURFACE REMOVAL, 1¾" → → GUARDRAIL REMOVAL COUNTY TOTAL SHEETS NO.

McHENRY 75 50 DESIGNED -REVISED SECTION STATE OF ILLINOIS **REMOVAL PLANS** DRAWN REVISED 0326 FAP 032622 BJ CHECKED -REVISED -**DEPARTMENT OF TRANSPORTATION** CONTRACT NO. 62T01 PLOT DATE = 5/3/2023 DATE 05/05/2023 SCALE: 1": 20' SHEET 2 OF 3 SHEETS STA. TO STA. REVISED -

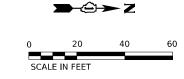

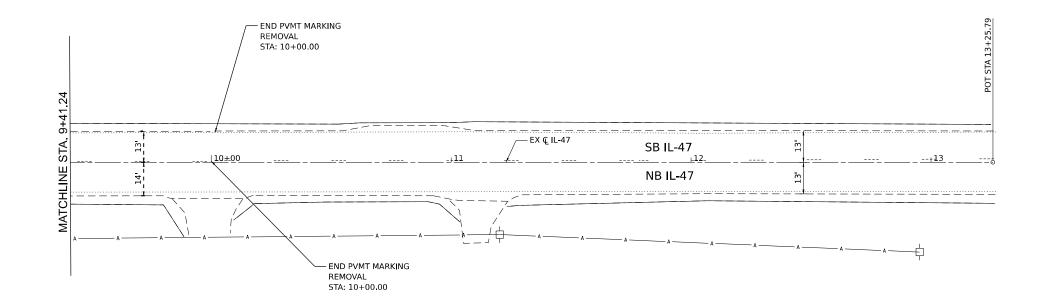

AGGREGATE SHOULDER REMOVAL

DRIVEWAY PAVEMENT REMOVAL

PAVEMENT REMOVAL

HOT-MIX ASPHALT SURFACE REMOVAL, 1¾"


→ → GUARDRAIL REMOVAL

)	WSP USA Inc. 30 N. LASALLE STREET SUITE 4200	
	CHICAGO, IL 60602 TEL: (312) 782-8150	
	FAX: (312) 782-1684	

	USER NAME = USHA669697	DESIGNED -	REVISED -
ΕT		DRAWN -	REVISED -
	PLOT SCALE = 40.000 / in.	CHECKED -	REVISED -
	PLOT DATE = 5/3/2023	DATE 05/05/2023	REVISED -

STATE 0	F ILLINOIS
DEPARTMENT OF	TRANSPORTATION

	F.A.P SECTION			COUNTY	TOTAL SHEETS	SHEET NO.	
	0326	0326 FAP 032622 BJ		McHENRY	75	51	
					CONTRACT	NO. 62	2T01
SCALE: 1": 20' SHEET 3	OF 3 SHEETS STA.	TO STA.		ILLINOIS FED. AID PROJECT			

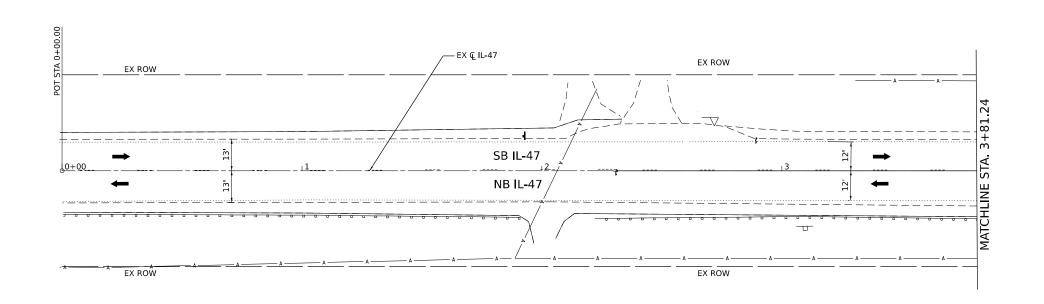

HOT-MIX ASPHALT SURFACE COURSE, IL-9.5, MIX "D", N70, 2" HOT-MIX ASPHALT BINDER COURSE, IL-19.0, N70, 6"

HOT-MIX ASPHALT SURFACE COURSE, IL-9.5, MIX "D", N70,  $1\frac{3}{4}$ " HOT-MIX ASPHALT BINDER COURSE, IL-19.0, N70, 8"

HOT-MIX ASPHALT SURFACE COURSE, IL-9.5, MIX "D", N70, 3"

HOT-MIX ASPHALT SURFACE COURSE, IL-9.5, MIX "D", N70, 1¾"

HMA BUTT JOINT (SEE BUTT JOINT AND HMA TAPER DETAILS)

HOT-MIX ASPHALT SURFACE COURSE, IL-9.5, MIX "D", N50, 2" HOT-MIX ASPHALT BASE COURSE, 6"


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34	PLOT DATE	= 5/3/2023	DATE	05/05/2023

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STATE	: OF	ILLINOIS
DEPARTMENT	0F	<b>TRANSPORTATION</b>

	F.A.P RTE	SEC <sup>-</sup>	TION	COUNTY	TOTAL SHEETS	SHEET NO.						
	ROADWAY PLANS								2622 BJ	McHENRY	75	52
										CONTRACT	NO. 6	2T01
SCALE: N.T.S	SHEET 1	OF	3	SHEETS	STA.	TO STA.	ILLINOIS FED. AID PROJECT					

LEGEND



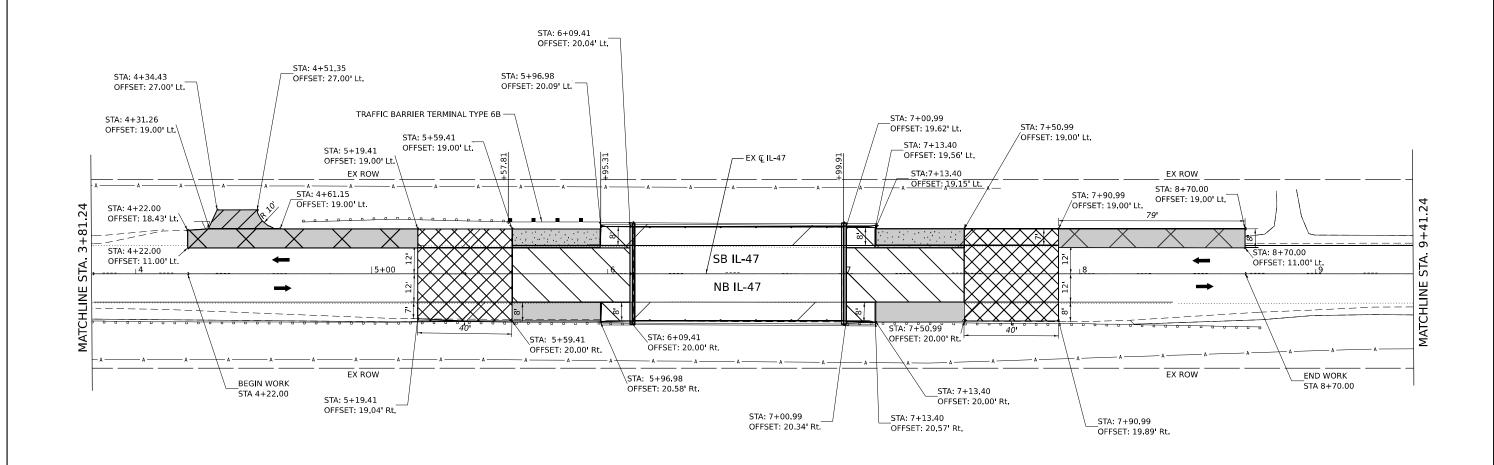

HOT-MIX ASPHALT SURFACE COURSE, IL-9.5, MIX "D", N70, 2" HOT-MIX ASPHALT BINDER COURSE, IL-19.0, N70, 6"

HOT-MIX ASPHALT SURFACE COURSE, IL-9.5, MIX "D", N70,  $1\frac{3}{4}$ " HOT-MIX ASPHALT BINDER COURSE, IL-19.0, N70, 8"



HOT-MIX ASPHALT SURFACE COURSE, IL-9.5, MIX "D", N70, 3"



HOT-MIX ASPHALT SURFACE COURSE, IL-9.5, MIX "D", N70, 1¾"



HMA BUTT JOINT (SEE BUTT JOINT AND HMA TAPER DETAILS)

HOT-MIX ASPHALT SURFACE COURSE, IL-9.5, MIX "D", N50, 2" HOT-MIX ASPHALT BASE COURSE, 6"





2. THE CONTRACTOR SHALL COORDINATE DRIVEWAY WORK WITH PROPERTY OWNER.

3. RAISED REFLECTIVE PAVEMENT MARKERS SHALL NOT BE INSTALLED WITHIN BRIDGE LIMITS.

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USA Inc. LASALLE STREET = 4200 AGO, IL 60602 (312) 782-8150 (312) 782-1684	USER NAME = USHA669697	DESIGNED -	REVISED -
		DRAWN -	REVISED -
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	PLOT DATE = 5/3/2023	DATE 05/05/2023	REVISED -

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DEPARTMENT	0F	TRANSPORTATION


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							F.A.P RTE	SECT	ION		COUNTY	TOTAL SHEETS	SHEET NO.
ROADWAY PLANS						0326	326 FAP 032622 BJ			McHENRY	75	53	
										CONTRACT	NO. 62	2T01	
SHEET	2	OF	3	SHEETS	STA.	TO STA.			ILLINOIS	FED. All	D PROJECT		

SCALE IN FEET

LEGEND



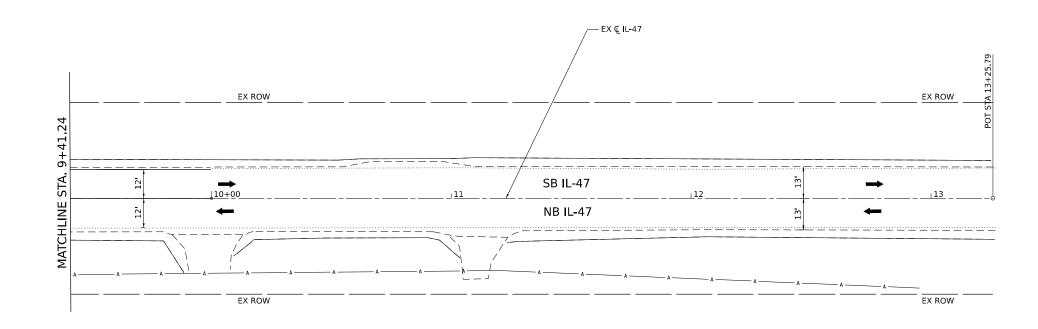

HOT-MIX ASPHALT SURFACE COURSE, IL-9.5, MIX "D", N70, 2" HOT-MIX ASPHALT BINDER COURSE, IL-19.0, N70, 6"

HOT-MIX ASPHALT SURFACE COURSE, IL-9.5, MIX "D", N70,  $1\frac{3}{4}$ " HOT-MIX ASPHALT BINDER COURSE, IL-19.0, N70, 8"

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HMA BUTT JOINT (SEE BUTT JOINT AND HMA TAPER DETAILS)

HOT-MIX ASPHALT SURFACE COURSE, IL-9.5, MIX "D", N50, 2" HOT-MIX ASPHALT BASE COURSE, 6"

1. SEE HOT-MIX ASPHALT MIXTURE REQUIREMENTS TABLE FOR MIXTURE DESIGN.

0	20	40	60
SCALE	IN FEET		


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E STREET			DRAWN	-
60602 2-8150	PLOT SCALE	= 40.000 ' / in.	CHECKED	-
2-1684	PLOT DATE	= 5/3/2023	DATE	05/05/2023

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DEPARTMENT	0F	TRANSPORTATION

				F.A.P RTE	SECT	TION	COUNTY	TOTAL SHEETS	SHEET NO.		
ROADWAY PLANS							FAP 032	2622 BJ	McHENRY	75	54
									CONTRACT	NO. 6	2T01
LE: N.T.S	SHEET	OF	SHEETS	STA.	TO STA.			ILLINOIS FED	. AID PROJECT		

LEGEND

REVISED REVISED REVISED -SCALE: REVISED -

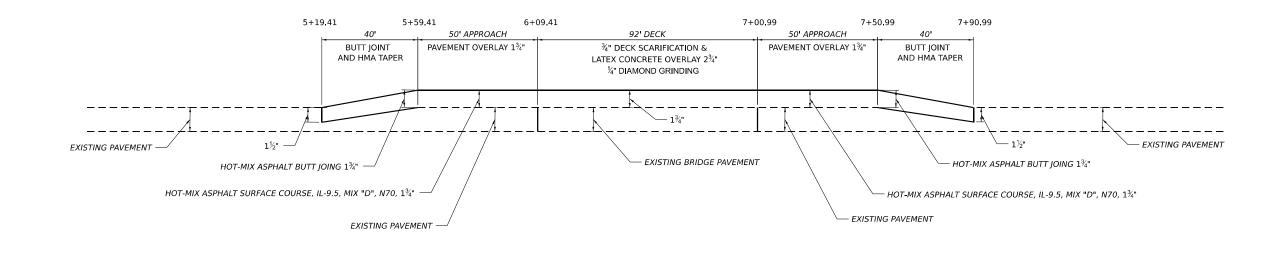


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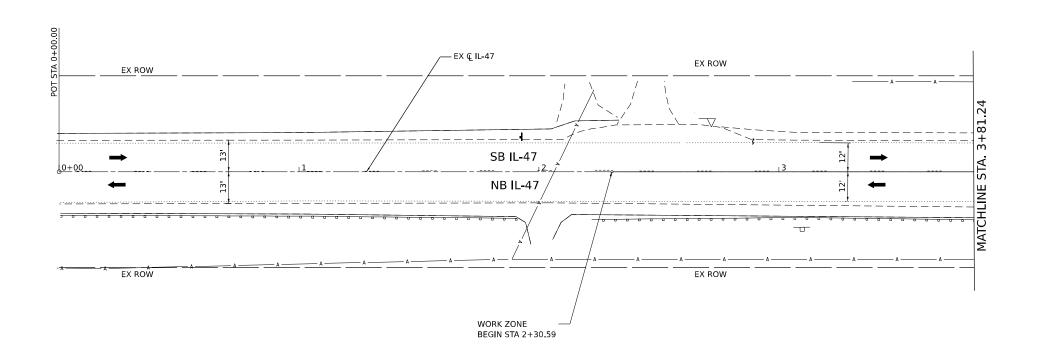
WSP USA Inc. 30 N. LASALLE ST SUITE 4200 CHICAGO, IL 606C TEL: (312) 782-818 FAX: (312) 782-16

STATE OF ILLINOIS DEPARTMENT OF TRANSPORTATION

ROADWAY PROFILE

SCALE: N.T.S SHEET 2 OF 3 SHEETS STA. TO STA.



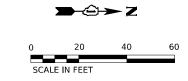

PERIMETER EROSION BARRIER

PLOT DATE = 5/3/2023

DESIGNED -

CHECKED -


DATE 05/05/2023

DRAWN

TOTAL QUANTITY FOR PERIMETER EROSION BARRIER ON THIS SHEET IS 0 FEET.
 PERIMETER EROSION BARRIER SHALL BE INSTALLED PRIOR TO ANY WORK COMMENCING AND SHALL REMAIN IN PLACE UNTIL THE END OF CONSTRUCTION.

REVISED -							F.A.P RTE	SECTION	COUNTY	TOTAL SHEETS	SHEET
REVISED -	STATE OF ILLINOIS		EDOCIONI CONITDOI DIANIC			0326	FAP 032622 BJ	McHENRY	75	56	
REVISED -	DEPARTMENT OF TRANSPORTATION								CONTRACT	NO. 62	2T01
REVISED -		SCALE: N.T.S	SHEET 1	OF 3 SHEETS	STA.	TO STA.		ILLINOIS FED. AII	PROJECT		



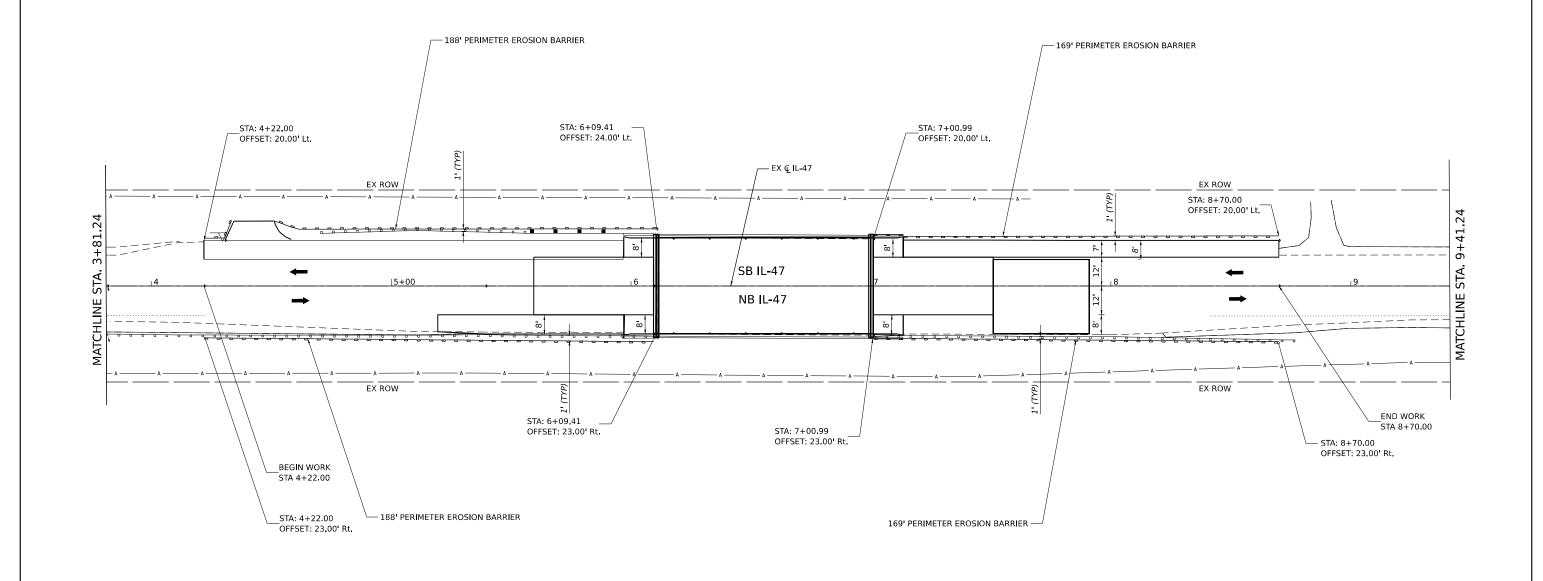





TOTAL QUANTITY FOR PERIMETER EROSION BARRIER ON THIS SHEET IS 714 FEET.
 PERIMETER EROSION BARRIER SHALL BE INSTALLED PRIOR TO ANY WORK COMMENCING AND SHALL REMAIN IN PLACE UNTIL THE END OF CONSTRUCTION.

15	)	WSP USA Inc. 30 N, LASALLE STRE SUITE 4200 CHICAGO, IL 60602 TEL: (312) 782-8150

TEL: (312) 782-8150 FAX: (312) 782-1684

PERIMETER EROSION BARRIER

JSER NAME = USHA669697 DESIGNED -REVISED DRAWN REVISED CHECKED -REVISED -PLOT DATE = 5/3/2023 DATE 05/05/2023 REVISED -

STATE OF ILLINOIS **DEPARTMENT OF TRANSPORTATION** 


SCALE: N.T.S

COUNTY TOTAL SHEETS NO.

McHENRY 75 57 SECTION **EROSION CONTROL PLANS** 0326 FAP 032622 BJ CONTRACT NO. 62T01 SHEET 2 OF 3 SHEETS STA. TO STA.





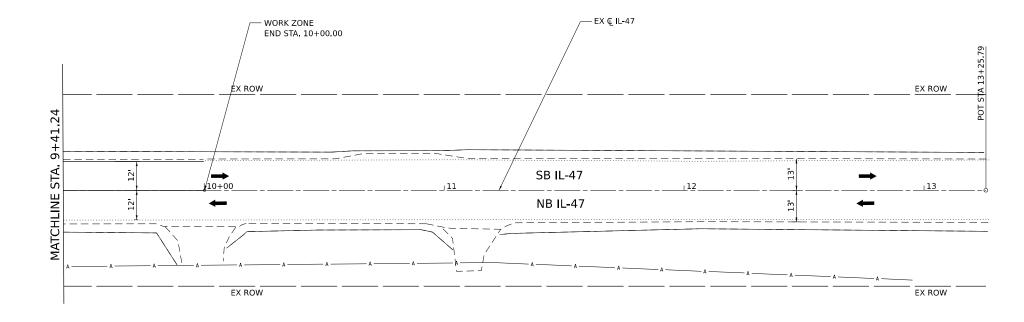

PERIMETER EROSION BARRIER

PLOT DATE = 5/3/2023

DESIGNED -

CHECKED -

DATE 05/05/2023

DRAWN

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REVISED -


TOTAL QUANTITY FOR PERIMETER EROSION BARRIER ON THIS SHEET IS 0 FEET.
 PERIMETER EROSION BARRIER SHALL BE INSTALLED PRIOR TO ANY WORK COMMENCING AND SHALL REMAIN IN PLACE UNTIL THE END OF CONSTRUCTION.

OTATE OF HAMOIO						_	F.A.P RTE	SECTION	COUNTY	TOTAL SHEETS	SHEET NO.
STATE OF ILLINOIS DEPARTMENT OF TRANSPORTATION _		ERO	SION	CONTRO	)L PLAN	S	0326	FAP 032622 BJ	McHENRY	75	58
									CONTRACT	NO. 62	2T01
	SCALE: N.T.S	SHEET	OF	SHEETS	STA.	TO STA.		ILLINOIS FED. A	D PROJECT		

Existing Structure: S.N. 056-0053 is a single span PPC I-Beam structure with a total length of 92'-7" and a total out to out width of 43'-2". The stub abutments are supported on concrete piles.

The structure was constructed in 1985 under section 104B(1)R-83.

Traffic shall be maintained utilizing Stage Construction and temporary traffic signals. Traffic Control:

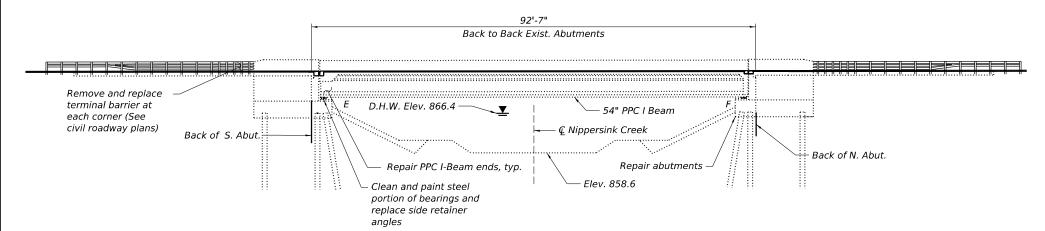

#### **ELEVATION**

# SCOPE OF WORK

- Perform bridge deck scarification  $\frac{3}{4}$  inch.
- Replace existing joints with preformed joint strip seals.
- Repair bridge deck and approach
- Construct bridge deck latex concrete overlay, 2¾ inches
- Perform  $\frac{1}{4}$ " diamond grinding.
- Perform PPC I-beam repairs.
- Clean and paint steel portion of bearings at both abutments and replace side retainer angles.
- Apply protective coat to deck and parapets.
- Repair abutments.

## **INDEX OF SHEETS**

- General Plan & Elevation
- General Notes & Bill of Material
- Stage Construction Details
- Deck and Approach Slab Repair Plan
- Joint Replacement I
- Joint Replacement II
- Preformed Joint Strip Seal
- Framing Plan

SHEET 1 OF 11 SHEETS

- Beam Repair Details
- Abutment Repair Details
- Bar Splicer Assembly & Mechanical Splicer Details

#### **DESIGN SPECIFICATIONS**

2002 AASHTO Standard Specifications for Highway Bridges with Interims

## LOADING HS-20 & ALT.

No allowance for future wearing surface.

#### **DESIGN STRESSES**

### FIELD UNITS (NEW CONSTRUCTION)


f'c - 4,000 psi (Superstructure) fy = 60,000 psi (Reinforcement)

#### FIELD UNITS (EXIST. CONSTRUCTION)

 $f^{c} = 3,500 \text{ psi}$ 

fc = 6,000 psi (PPC Units)

fy = 60,000 psi (Reinforcement) fy = 36,000 psi (M270 Grade 36)

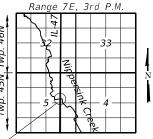


Proposed

6/21/2023

Date .

LOCATION SKETCH

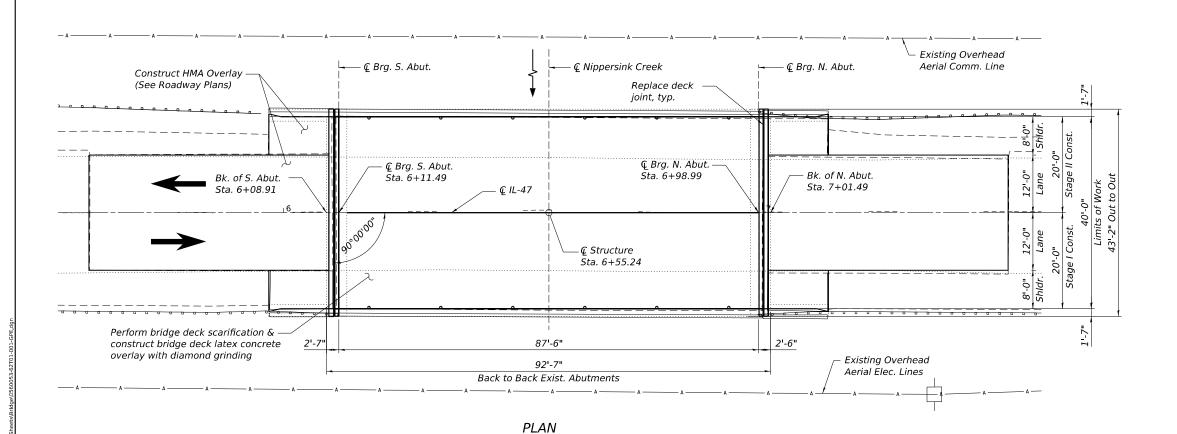

Signed PATRICK J. LAUX, S.E. II. Lic. No. 081-007655 Expires 11-30-2024.

GENERAL PLAN & ELEVATION IL-47 OVER NIPPERSINK CREEK F.A.P. RTE 0326 - SECTION 0326 22 BJ McHENRY COUNTY STATION 6+55.24

S.N. 056-0053

USER NAME = USMN679328	DESIGNED	-	MN	REVISED	-	
	DRAWN	-	MN	REVISED	-	
PLOT SCALE = 19:11.9904 ':" / in.	CHECKED	-	PJL	REVISED	-	
PLOT DATE = 6/21/2023	DATE	-	6/21/2023	REVISED	-	

**STATE OF ILLINOIS DEPARTMENT OF TRANSPORTATION** 

SECTION 0326 FAP 0326 22 BJ McHENRY 74 59 CONTRACT NO. 62T01

# GENERAL NOTES

- 1. Reinforcement bars designated (E) shall be epoxy coated.
- 2. Plan dimensions and details relative to existing plans are subject to nominal construction variations. The Contractor shall field verify existing dimensions and details affecting new construction and make necessary approved adjustments prior to construction or ordering materials. Such variations shall not be cause for additional compensation for a change in scope of the work, however, the Contractor will be paid for the quantity actually furnished at the unit price bid for the work.
- 3. Existing reinforcement bars extending into the removal area shall be cleaned, straightened and incorporated into the new construction. Any reinforcement bars that are damaged during concrete removal shall be replaced with an approved bar splicer or anchorage system. Cost included with Concrete Removal.
- 4. Protective coat shall be applied to the new latex concrete overlay and to the front and top face of bridge parapets.
- 5. Cost of removal and disposal of existing expansion joints shall be included in the cost of Concrete Removal.
- 6. Joint openings shall be adjusted according to Article 520.04 of the Std. Specs. when the deck is poured at an ambient temperature other than 50°F.
- 7. Expansion joints shall be fabricated to conform to the existing cross slope of the bridge.
- 8. The Contractor shall exercise care during removal of existing joints to ensure that the slab, beams, and diaphragms' integrity will not be detrimentally impacted. The Contractor shall repair any damage(s) to the slab, beams, and diaphragms caused by his/her operation as directed by the Engineer at no additional cost to the Department.


# TOTAL BILL OF MATERIAL

ІТЕМ	UNIT	SUPER	SUB	TOTAL
Concrete Removal	Cu. Yd.	3.9	-	3.9
Concrete Superstructure	Cu. Yd.	4.8	-	4.8
Protective Coat	Sq. Yd.	495	-	495
Reinforcement Bars, Epoxy Coated	Pound	770	-	770
Bar Splicers	Each	8	-	8
Preformed Joint Strip Seal	Foot	84	-	84
Acrylic Coating	Sq. Yd.	11	-	11
Fiber Wrap	Sq. Ft.	99	-	99
Cleaning and Painting Bearings	Each	14	-	14
Bridge Deck Grooving (Longitudinal)	Sq. Yd.	234	-	234
Approach Slab Repair (Partial Depth)	Sq. Yd.	27	-	27
Bridge Deck Latex Concrete Overlay, 2 3/4 Inches	Sq. Yd.	390	-	390
Bridge Deck Scarification 3/4 Inch	Sq. Yd.	390	-	390
Structural Repair of Concrete (Depth Equal To or Less Than 5 Inches)	Sq. Ft.	-	13	13
Deck Slab Repair (Full Depth, Type I)	Sq. Yd.	1	-	1
Diamond Grinding (Bridge Section)	Sq. Yd.	406	-	406
Precast Prestressed Concrete I-Beam Repair	Sq. Ft.	27	-	27


\* Areas of deck repair shown are estimated. The Engineer shall show actual locations of deck repairs on as-built plans.

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# STAGE I CROSS SECTION (Looking North)

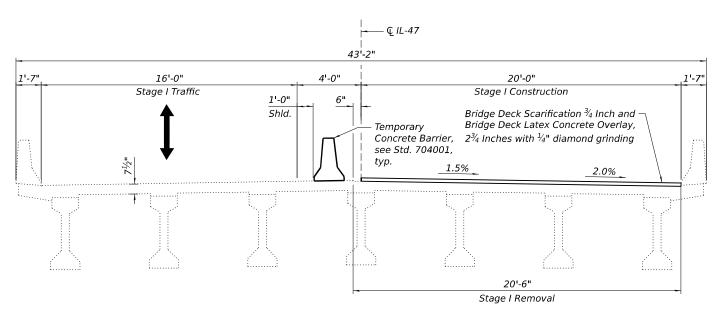

# STAGE II CROSS SECTION

(Looking North)

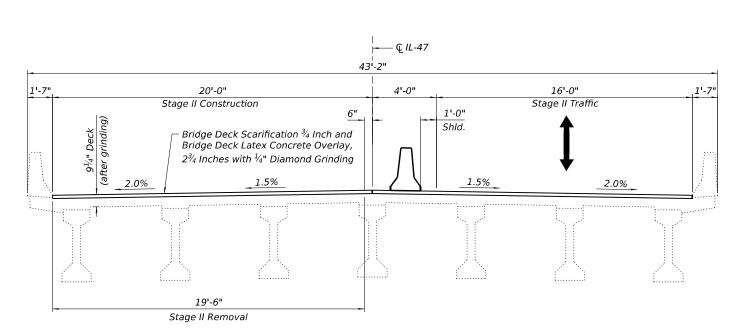
ונוצייו	WSP USA Inc. 30 N. LASALLE STREET SUITE 4200 CHICAGO, IL 60602 TEL: (312) 782-8150 FAX: (312) 782-1684
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STATE OF ILLINOIS DEPARTMENT OF TRANSPORTATION

 				TION DETAILS STRUCTURE NO. 056-0053	_
SHEET	3	OF	11	SHEETS	

F.A.P RTE	SECT	ION		COUNTY	TOTAL SHEETS	SHEET NO.
0326 FAP 0326 22 BJ				McHENRY	74	61
			CONTRACT	NO. 62	T01	
		ILLINOIS	FED AL	D PROJECT		



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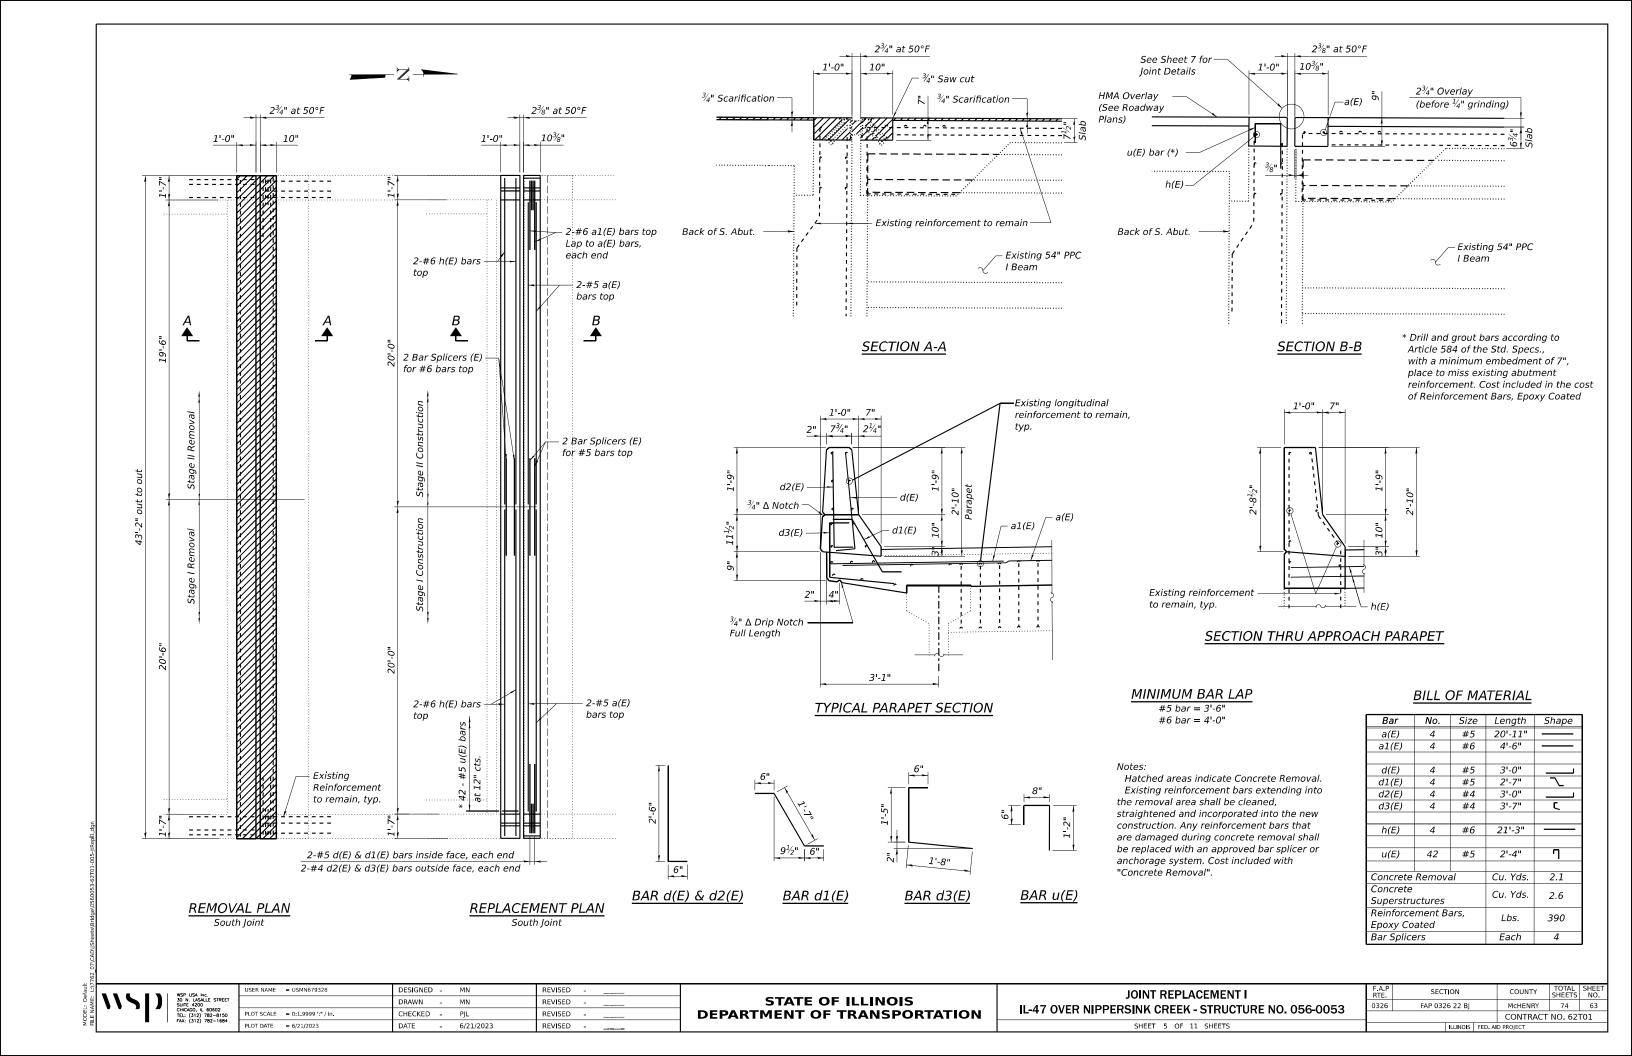
STATE OF ILLINOIS
DEPARTMENT OF TRANSPORTATION

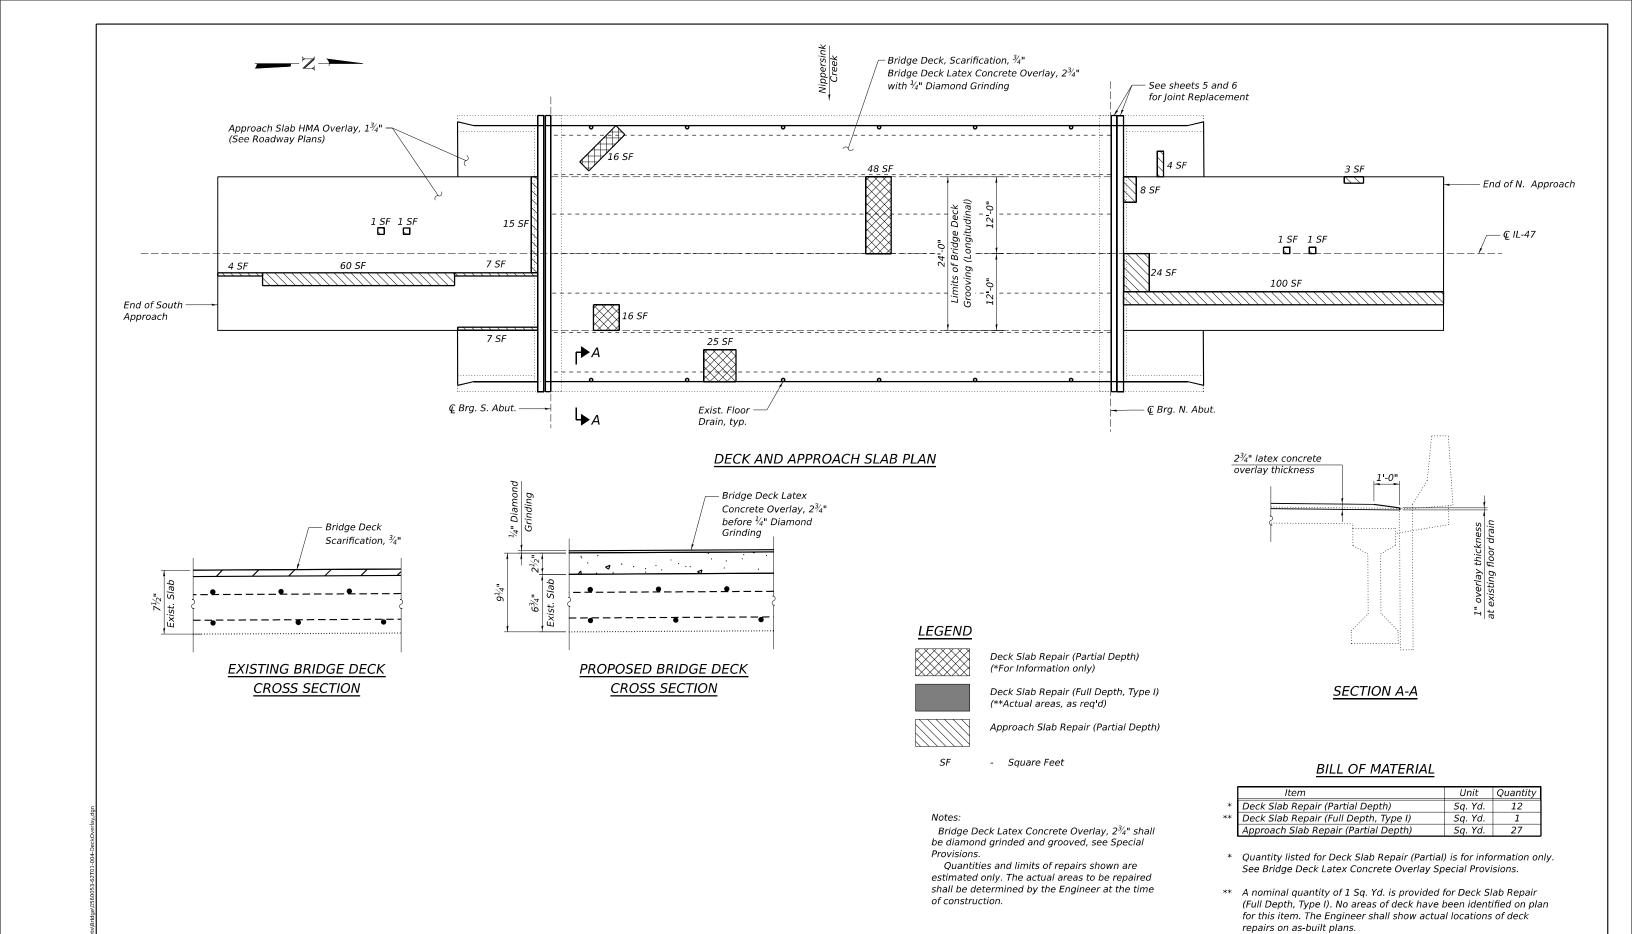
DECK AND APPROACH SLAB REPAIR PLAN

IL-47 OVER NIPPERSINK CREEK - STRUCTURE NO. 056-0053

SHEET 4 OF 11 SHEETS

F.A.P RTE	SECTION	COUNTY	TOTAL SHEETS	SHEET NO.
0326	FAP 0326 22 BJ	McHENRY	74	62
		CONTRACT	NO. 62	Γ01
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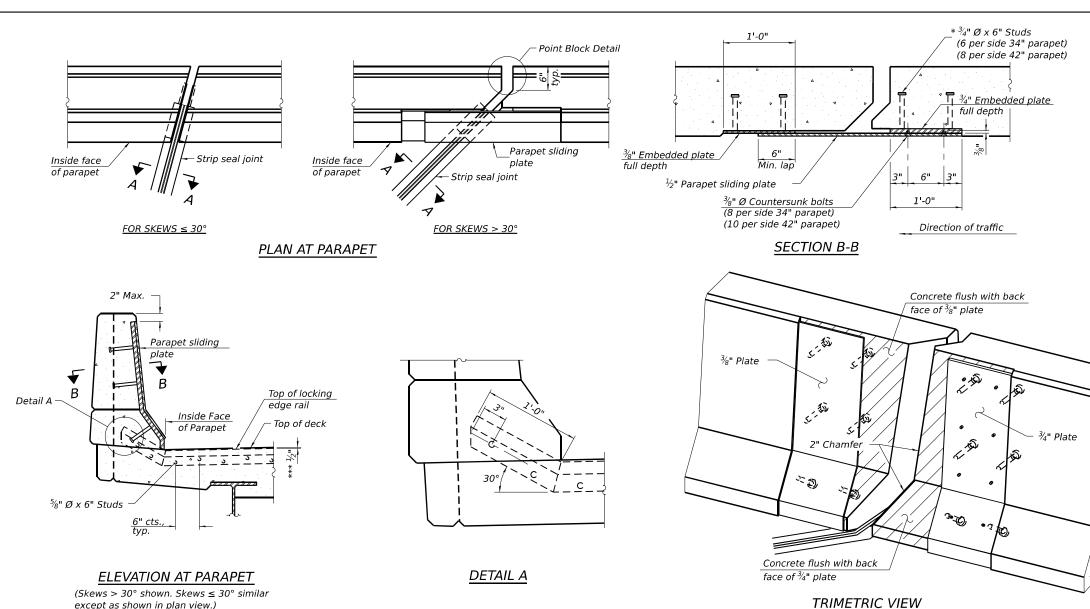


PJL REVISED LOT DATE = 6/21/2023 DATE - 6/21/2023 REVISED

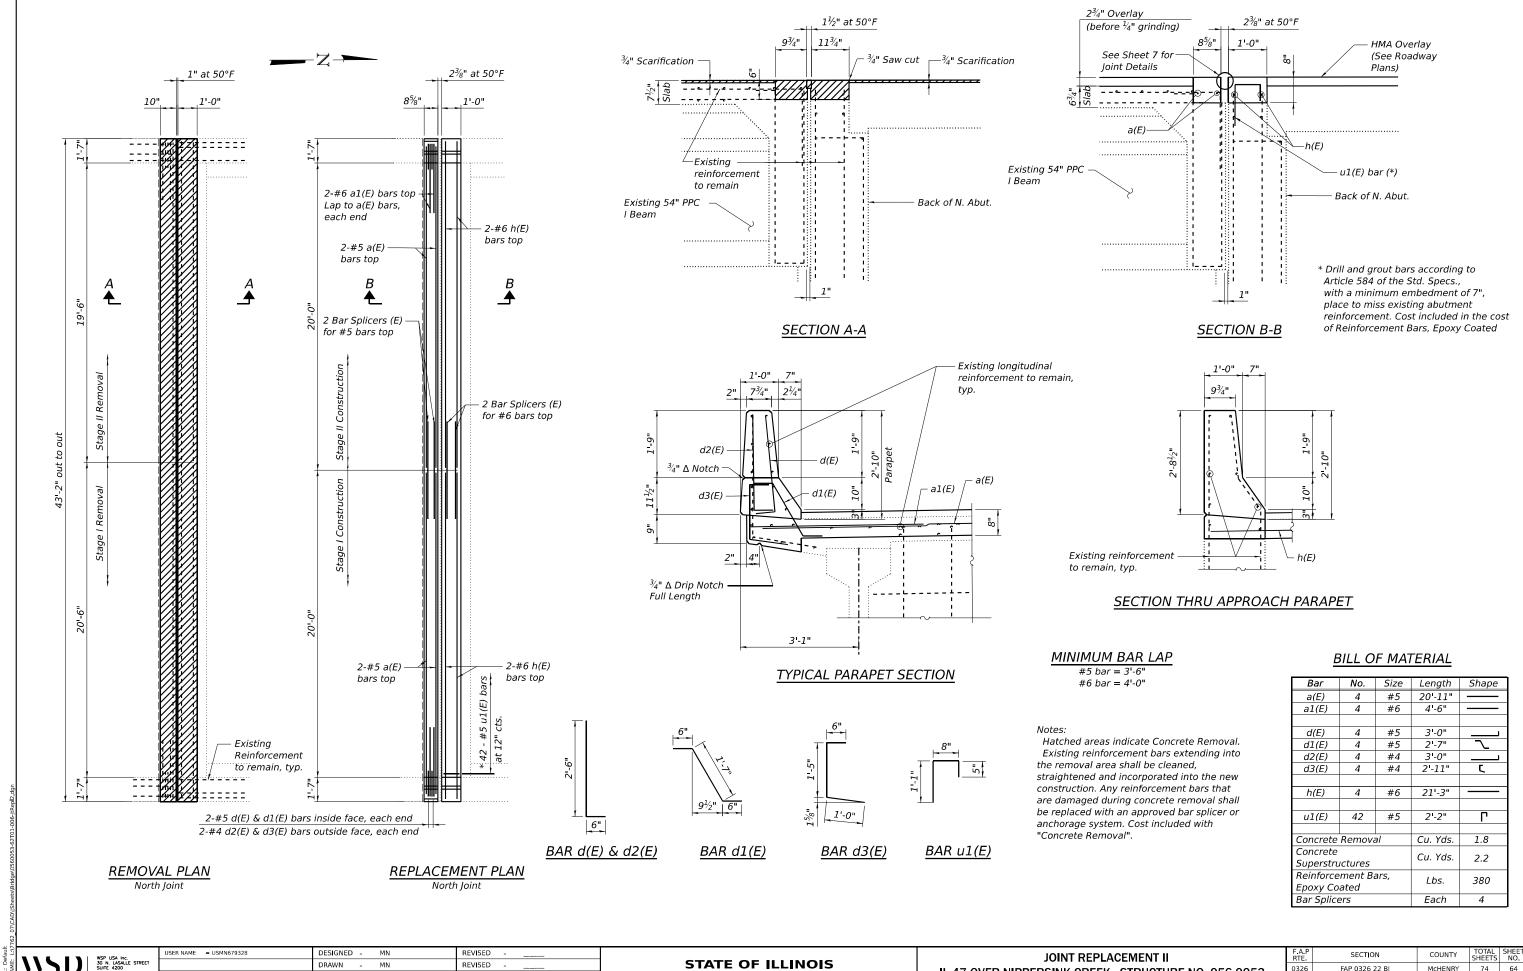**DEPARTMENT OF TRANSPORTATION** 

IL-47 OVER NIPPERSINK CREEK - STRUCTURE NO. 056-0053 SHEET 6 OF 11 SHEETS

F.A.P RTE	SECT	ION		COUNTY	TOTAL SHEETS	SHEET NO.
0326	FAP 0326 22 BJ			McHENRY	74	64
				CONTRACT	NO. 62	T01
		ILLINOIS	FED. AI	D PROJECT		



Notes:

The strip seal shall be made continuous and shall have a minimum thickness of  $\frac{1}{4}$ ". The configuration of the strip seal shall match the configuration of the locking edge rails. Open or "webbed" strip seal gland configurations are not permitted. The gland shall be sized for a maximum rated movement of 4 inches.

The locking edge rails depicted are configured for typical applications and are conceptual only. The actual configuration of the locking edge rails and matching strip seal may vary from manufacturer to manufacturer provided they fit the application and meet the minimum anchorage shown. Flanged edge rails, however, will not be allowed. Locking edge rails may exceed the  $4\frac{1}{2}$ " maximum depth provided the anchorage system is revised according to the manufacturer's recommendation.

The manufacturer's recommended installation methods shall be followed.

All steel components shall be galvanized after fabrication according to Article 520.03 of the Standard Specifications.

The Maximum space between locking edge rail segments shall be  $\frac{3}{16}$ " and sealed with a suitable sealant; however, any rail joint within 10' measured perpendicular to the face of the curb or parapet shall be welded as shown in the locking edge rail splice detail.

Cost of parapet sliding plates, embedded plates, and anchorage studs included with Preformed Joint Strip Seal.

34" F-shape barrier shown, 42" F-shape similar as noted. The concrete opening below the strip seal will vary based on the locking edge rail chosen by the Contractor. Deck and parapet lengths shown elsewhere in the plans are dimensioned to the concrete opening, not the joint opening, and are based on the rolled locking edge rail. If the Contractor elects to use a different locking edge rail, dimensional adjustments may be required. One exception to this would be the strip seal joint at the end of the precast bridge approach slab. For these cases the pavement connector length shall be adjusted, not the length of the bridge approach slab.

except as shown in plan view.)

at 50° F

at 50° F


SHOWING ROLLED RAIL JOINT

Strip seal

Locking edge rail

Top of concrete

\*\*\* Prior to 1/2" grinding

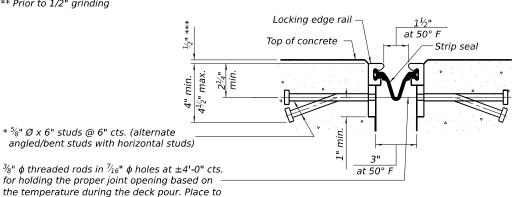

(Showing embedded plates only)

LOCKING EDGE RAILS


WELDED RAIL

*7*∕16"

<u>ROLLED</u>

(EXTRUDED) RAIL

\*\* Back gouge not required if complete joint penetration is verified by mock-up.

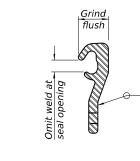

# LOCKING EDGE RAIL SPLICE

The inside of the locking edge rail groove shall be free of weld residue. Rolled rail shown, welded rail similar.

#### BILL OF MATERIAL

Item	Unit	Total
Preformed Joint Strip Seal	Foot	84

#### SECTION A-A

\* Granular or solid flux filled headed studs conforming to Article 1006.32 of the Std. Specs., automatically end welded.

miss studs. All rods shall be burned, or sawed

off flush with the plates after concrete is set.

**STATE OF ILLINOIS** 

PREFORMED JOINT STRIP SEAL IL-47 OVER NIPPERSINK CREEK - STRUCTURE NO. 056-0053 SHEET 7 OF 11 SHEETS


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			CONTRACT	NO. 62	Γ01
	ILLINOIS	FED AL	D PROJECT		

1½" max.

DESIGNED -REVISED DRAWN MN REVISED PJL REVISED LOT DATE = 6/21/2023 DATE REVISED - 6/21/2023

**DEPARTMENT OF TRANSPORTATION** 

SHOWING WELDED RAIL JOINT

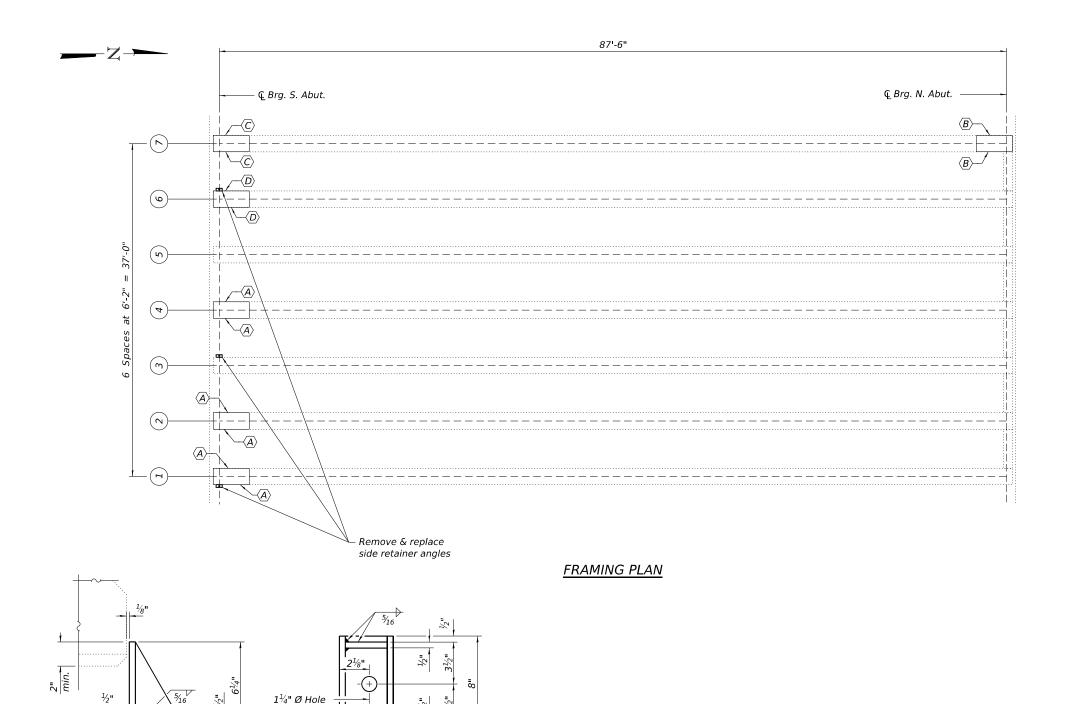

 $\langle A \rangle$  - Location of PPC I-Beam Repair A

 $\langle \overline{B} \rangle$  - Location of PPC I-Beam Repair B

 $\langle z \rangle$  - Location of PPC I-Beam Repair C

 $\langle \overline{\mathsf{D}} \rangle$  - Location of PPC I-Beam Repair D

 $\langle E \rangle$  - Location of PPC I-Beam Repair E

See sheet 9 for PPC I-Beam Repair details.

#### Notes:

Plan dimensions and details relative to existing plans are subject to normal construction variations. The Contractor shall field verify existing dimensions and details affecting new construction and make necessary approved adjustments prior to construction or ordering of materials. Such varations shall not be cause for additional compensation for a change in scope of the work, however, the Contractor will be paid for the quantity actually furnished at the unit price bid for the work.

The Contractor shall use extreme care during concrete removal so as not to damage the PPC I-beam. See Special Provisions for "Fiber Wrap".

See Special Provisions for "Precast Concrete I-Beam Renair"

Acrylic coating shall be placed over Fiber Wrap repairs. Two coats shall be applied. See Special Provisions for "Fiber Wrap".

# **BILL OF MATERIAL**

Item	Unit	Quantity
Fiber Wrap	Sq. Ft.	99
Acrylic Coating	Sq. Yd.	11
Precast Prestressed Concrete I-Beam Repair	Sq. Ft.	27

# SIDE RETAINER

½" Stainless steel plate, A240, Type 304,

No. 1 finish.

Equivalent rolled angle with stiffeners will be allowed in lieu of welded plates.

(3 Required)

#### Notes:

Side retainers and stainless steel plates shall be included in the cost of Cleaning and Painting Bearings. Side retainers shall be hot dip galvanized according to AASHTO M111.


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STATE OF ILLINOIS DEPARTMENT OF TRANSPORTATION

FRAMING PLAN
IL-47 OVER NIPPERSINK CREEK - STRUCTURE NO. 056-0053

SHEET 8 OF 11 SHEETS



 BEAM REPAIR DETAILS
 F.A.P RTE.
 SECTION
 COUNTY
 TOTAL SHEETS NO.
 SHEETS NO.

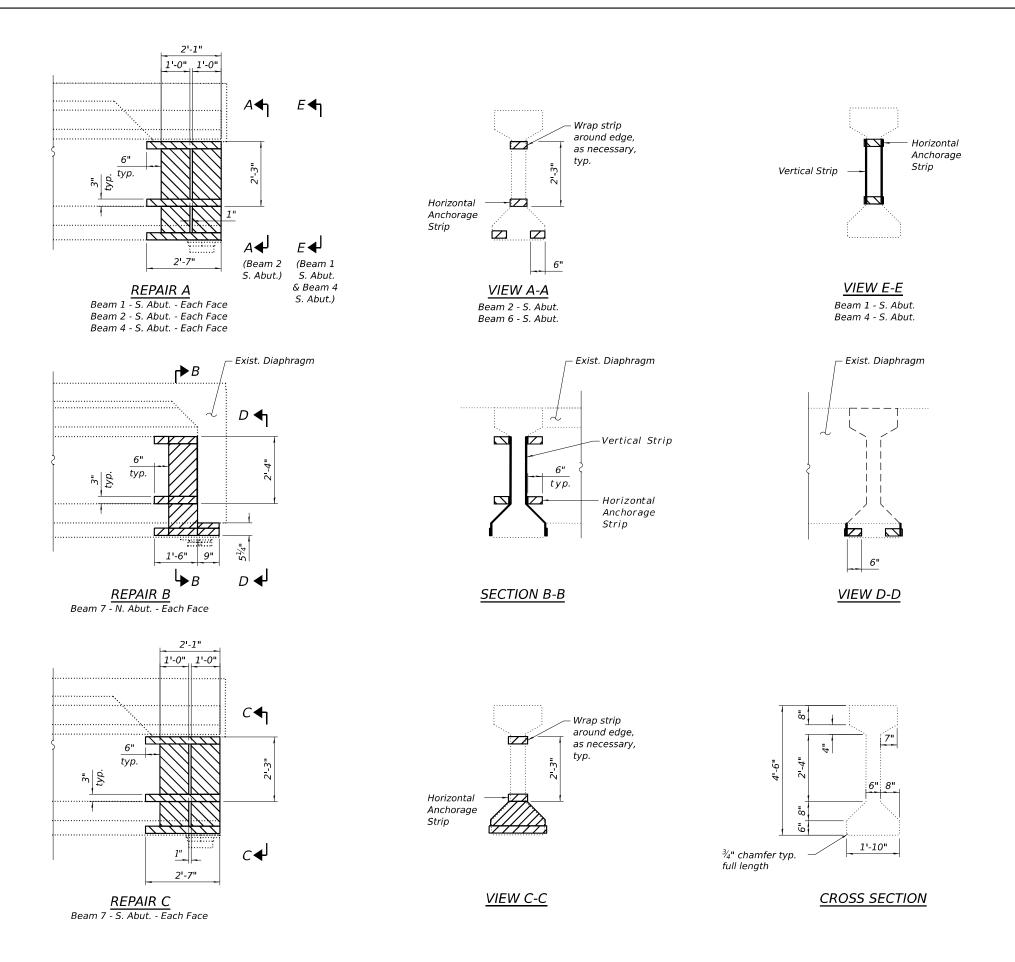 IL-47 OVER NIPPERSINK CREEK - STRUCTURE NO. 056-0053
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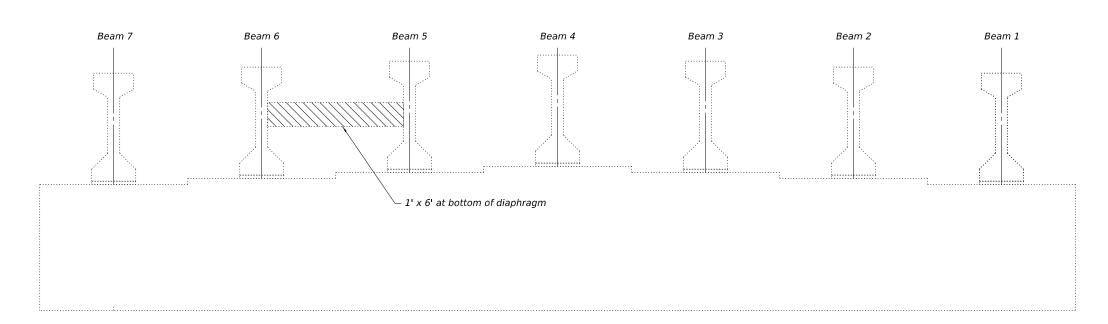
 SHEET 9 OF 11 SHEETS
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REPAIR D


Beam 6 - S. Abut. - Each Face

ightharpoonup A

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# NORTH ABUTMENT (Looking North)



# SOUTH ABUTMENT (Looking South)
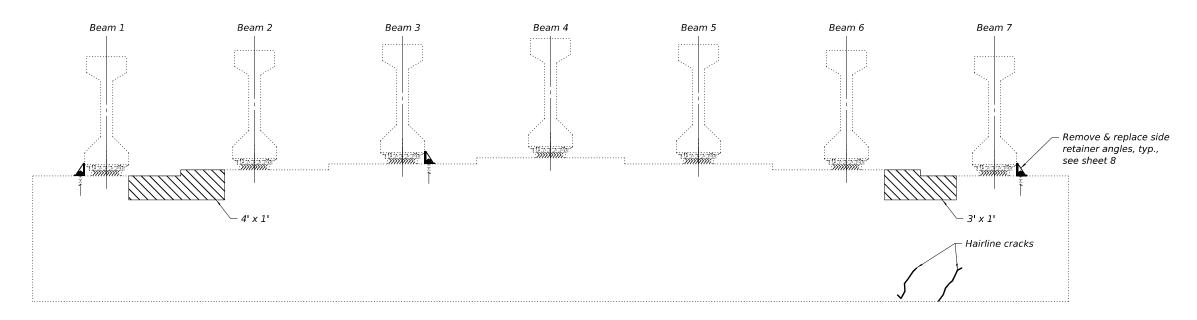
#### Note:

Repair of existing abutments shall include but not be limited to the areas shown. The actual areas to be repaired shall be determined by the Engineer at the time of construction.

# <u>LEGEND</u>



- Structural Repair of Concrete (Depth Equal To or Less Than 5 Inches)

# **BILL OF MATERIAL**

Item	Unit	Quantity
Structural Repair of Concrete (Depth equal to or less then 5 inches)	Sq. Ft.	13

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ABUTMENT REPAIR

IL-47 OVER NIPPERSINK CREEK - STRUCTURE NO. 056-0053


SHEET 10 OF 11 SHEETS

 
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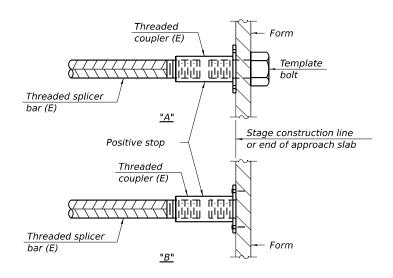
# STANDARD BAR SPLICER ASSEMBLY PLAN

(All components shall be provided from one supplier)

Threaded splicer bar length = min. lap length +  $1\frac{1}{2}$ " + thread length


\* Epoxy not required on Bar Splicer Assembly components used in conjunction with black bars.

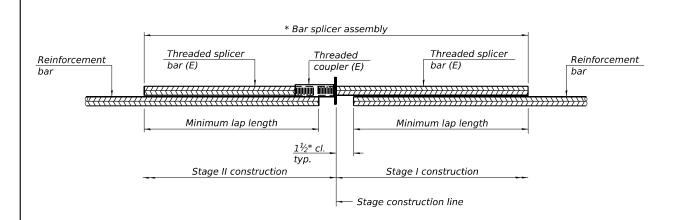Location	Bar size	No. assemblies required	Minimum lap length
S. Joint - Deck	#5	2	3'-6"
S. Joint - Abutment	#6	2	4'-0"
N. Joint - Deck	#5	2	3'-6"
N. Joint - Abutment	#6	2	4'-0"



# INSTALLATION AND SETTING METHODS

- "A": Set bar splicer assembly by means of a template bolt.
- "B": Set bar splicer assembly by nailing to wood forms or cementing to steel forms.
  - (E) : Indicates epoxy coating.

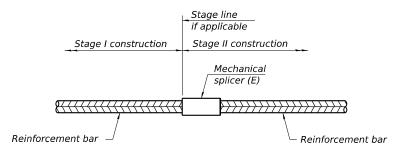

# STANDARD MECHANICAL SPLICER

Location	Bar size	No. assemblies required

#### Notes:

Splicer bars shall be deformed with threaded ends and have a minimum 60 ksi yield strength.

All reinforcement shall be lapped and tied to the splicer bars.

Bar splicer assemblies shall be epoxy coated according to the requirements for reinforcement bars. See Section 508 of the Standard Specifications and Special Provisions.

See approved list of bar splicer assemblies and mechanical splicers for alternatives.

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CHICAGO, IL 60602
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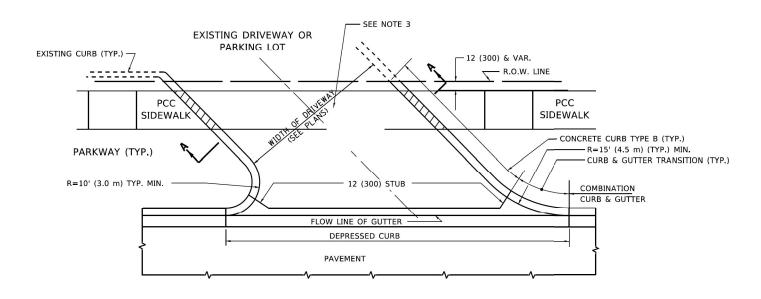
SHEET 11 OF 11 SHEETS


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			CONTRACT	NO. 62	Γ01	
		ILLINOIS	FED. AI	D PROJECT		

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DEPARTMEN

### WITH CONCRETE CURB, TYPE B



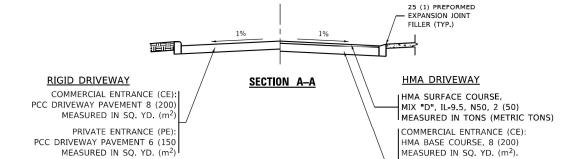

WITH CONCRETE CURB, TYPE B

PRIVATE ENTRANCE (PE): HMA BASE COURSE, 6 (150) MEASURED IN SQ. YD. (m²). R.O.W. LINE

B

WIDTH OF DRIVEWAY
(SEE PLANS)

B

COMBINATION

CURB AND GUTTER

ADJACENT TO PCC / HMA SHOULDER

R.O.W. LINE

ADJACENT TO CURB AND GUTTER

R.O.W. LINE

ADJACENT TO CURB AND GUTTER


R.O.W. LINE

R.O.W. LINE

R.O.W. LINE

R.O.W. LINE

ADJACENT TO CURB AND GUTTER

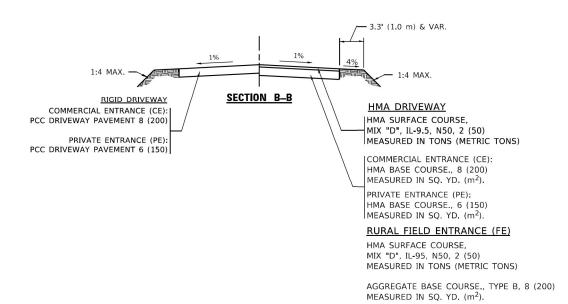

#### **GENERAL NOTES**

- DRIVEWAY SLOPES, LOCATIONS, & GEOMETRIC LAYOUT SHALL BE IN ACCORDANCE WITH THE LATEST EDITION OF THE "HANDBOOK FOR POLICY ON PERMITS FOR ACCESS DRIVEWAYS TO STATE HIGHWAYS". FOR FURTHER LAYOUT REQUIREMENTS, REFER TO ILLUSTRATIONS IN THE PERMIT HANDBOOK. DRIVEWAYS SHALL BE REPLACED IN KIND, UNLESS OTHERWISE NOTED ON THE PLANS.
- 2. COMMERCIAL DRIVEWAYS SHALL BE CONSTRUCTED WITH CONCRETE CURB, TYPE B RETURNS EXCEPT WHEN THE SIDEWALK EDGE IS 4 FEET (1.2 METERS) OR LESS FROM THE BACK OF CURB, CONSTRUCT A FLARE DRIVEWAY WITHOUT CURB.

ALL DIMENSIONS ARE IN INCHES (MILLIMETERS) UNLESS OTHERWISE NOTED.


DRIVEWAY DETAILS — DISTANCE BETWEEN R.O.W.

AND FACE OF CURB & EDGE OF SHOULDER ≥15′(4.5m)

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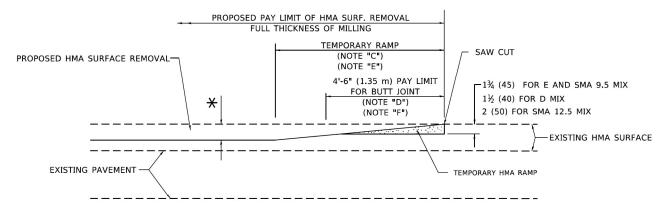
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#### WILLED TEIM CHAIT HAWI

(FOR BUTT JOINT AND HMA TAPER SEE DETAIL BELOW)

# OPTION 1

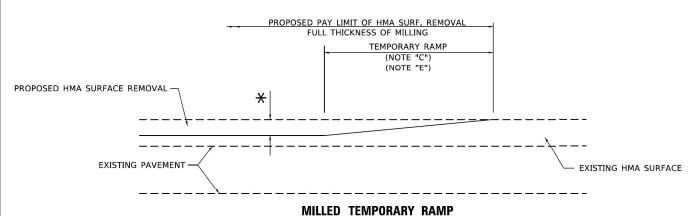


#### HMA CONSTRUCTED TEMPORARY RAMP


(FOR BUTT JOINT AND HMA TAPER SEE DETAIL BELOW)


# OPTION 2

# TYPICAL TEMPORARY RAMP

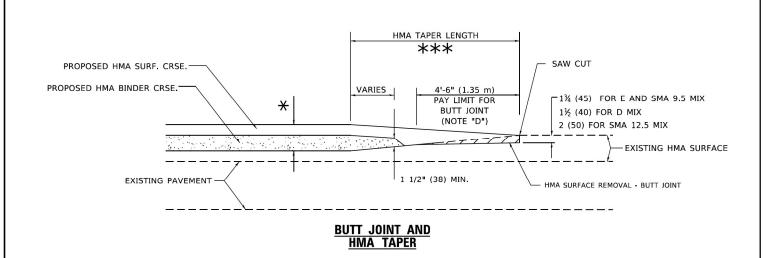

# TYPICAL BUTT JOINT AND HMA TAPER FOR MILLING AND RESURFACING

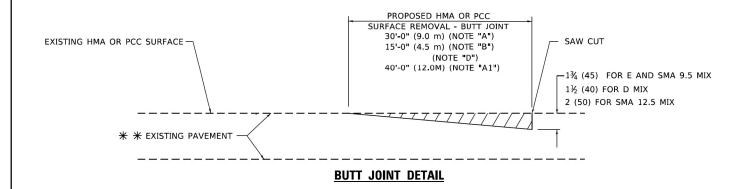

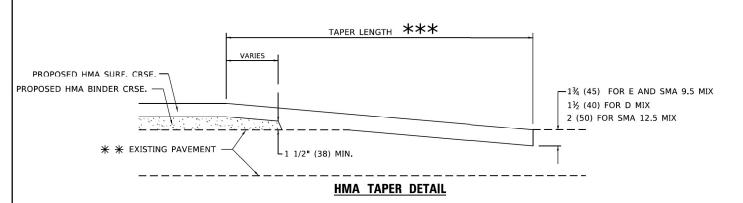

# TYPICAL BUTT JOINT AND HMA TAPER FOR RESURFACING ONLY

\*\* PC CONCRETE, HMA OR HMA RESURFACED PAVEMENT.

#### **GENERAL NOTES**

- A. MAINLINE ARTERIAL ROADWAYS AND MAJOR SIDE ROADS.
- A1. INTERSTATES
- B. MINOR SIDE ROADS.
- C. THE TEMP. RAMP SHALL BE CONSTRUCTED IMMEDIATELY UPON REMOVAL OF THE EXISTING HMA SURFACE.
- D. THE BUTT JOINT SHALL BE CONSTRUCTED IMMEDIATELY PRIOR TO PLACING THE PROPOSED HMA COURSES.
- E. TAPER THE TEMP. RAMP AT A RATE OF 3' 4" (1.02m) PER 1 INCH (25 mm) OF MILLING THICKNESS.
  - \* SEE TYPICAL SECTIONS FOR MILLING THICKNESS.
- F. SEE ARTICLE 406.08 AND 406.14 OF THE STANDARD SPECIFICATIONS FOR "HMA AND/OR PCC SURFACE REMOVAL, BUTT JOINT".
- \*\*\* 20'-0" (6.1 m) PER 1 (25) RESURFACING (NOTE "A")
  10'-0" (3.0 m) PER 1 (25) RESURFACING (NOTE "B")

#### **BASIS OF PAYMENT**


- THE BUTT JOINT WILL BE PAID FOR AT THE CONTRACT UNIT PRICE PER SQUARE YARD (SQUARE METER) FOR "HOT-MIX ASPHALT SURFACE REMOVAL - BUTT JOINT" OR FOR "PORTLAND CEMENT CONCRETE SURFACE REMOVAL- BUTT JOINT".
- THE TEMPORARY RAMP AND SAW CUT SHALL BE INCLUDED IN THE UNIT COST FOR HMA OR PCC SURFACE REMOVAL-BUTT JOINT.

SCALE: NONE

ALL DIMENSIONS ARE IN INCHES (MILLIMETERS) UNLESS OTHERWISE SHOWN.

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#### NOTES:

- 1. SIDE ROAD WITH A SPEED LIMIT OF 40 MPH (60 km/h) OR LESS AS SHOWN ON THE DRAWING AND AS DIRECTED BY THE ENGINEER:
- a) ONE "ROAD CONSTRUCTION AHEAD" SIGN 36 x 36 (900x900) WITH A FLASHER MOUNTED ON IT APPROXIMATELY 200' (60 m) IN ADVANCE OF THE MAIN ROUTE.
- b) THE CLOSED PORTION OF THE MAIN ROUTE SHALL BE PROTECTED BY BLOCKING WITH TYPE I, TYPE II OR TYPE III BARRICADES, 1/3 OF THE CROSS SECTION OF THE CLOSED PORTION.
- SIDE ROAD WITH A SPEED LIMIT GREATER THAN 40 MPH (60 km/h) AS SHOWN ON THE DRAWING AND AS DIRECTED BY THE ENGINEER:
- a) ONE "ROAD CONSTRUCTION AHEAD" SIGN 48 x 48 (1.2 m x 1.2 m) WITH A FLASHER MOUNTED ON IT APPROXIMATELY 500' (150 m) IN ADVANCE OF THE MAIN ROUTE.
- THE CLOSED PORTION OF THE MAIN ROUTE SHALL BE PROTECTED BY
  b) BLOCKING WITH TYPE III BARRICADES, 1/2 OF THE CROSS SECTION
  OF THE CLOSED PORTION.
- 3. CONES MAY BE SUBSTITUTED FOR BARRICADES OR DRUMS AT HALF THE SPACING DURING DAY OPERATIONS. CONES SHALL BE A MINIMUM OF 28 (710) IN HEIGHT
- WHEN THE SIDE ROAD LIES BETWEEN THE BEGINNING OF THE MAINLINE
  4. SIGNING AND THE WORK ZONE, A SINGLE HEADED ARROW (M6-1) SHALL
  BE USED IN LIEU OF THE DOUBLE HEADED ARROW (M6-4).

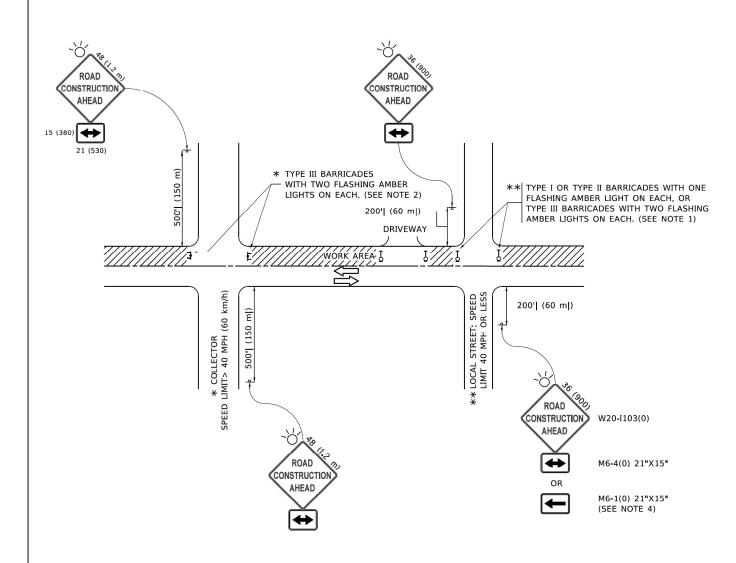SCALE: NONE

- WHEN WORK IS BEING PERFORMED ON A SIDE ROAD OR DRIVEWAY, FOLLOW THE APPLICABLE STANDARD(S). THE DIRECTIONAL ARROW (M6-1 OR M6-4) SHALL BE COVERED OR REMOVED WHEN NO LONGER CONSISTENT WITH THE TRAFFIC CONTROL SET-UP.
- 6. ADVANCE WARNING SIGNS ARE TO BE OMITTED ON DRIVEWAYS UNLESS OTHERWISE SPECIFIED IN THE PLANS OR BY THE ENGINEER
- THE TRAFFIC CONTROL AND PROTECTION FOR SIDE ROADS, INTERSECTIONS, AND DRIVEWAYS SHALL BE INCLUDED IN THE COST OF SPECIFIED TRAFFIC CONTROL STANDARDS OR ITEMS.

All dimensions are in inches (millimeters) unless otherwise shown.

WSP USA Inc. 30 N. LASALLE STREET SUITE 4200 CHCAGO, IL 60602 TEL: (312) 782-8160 FAX: (312) 782-8168

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 - L.H.A.
 REVISED
 - A. HOUSEH 10-15-96

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 REVISED
 - T. RAMMACHER 01-06-00

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 A. SCHUETZE 09-15-16

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TRAFFIC CONTROL AND PROTECTION FOR SIDE ROADS, INTERSECTIONS, AND DRIVEWAYS


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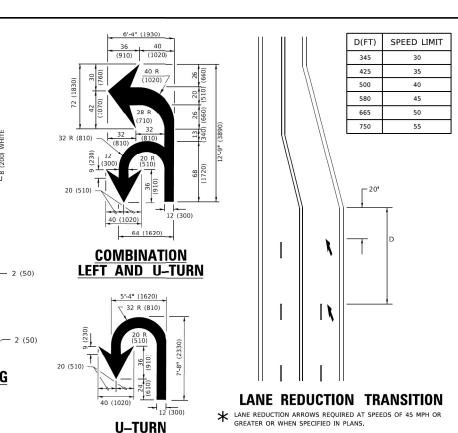
47 FAP 032622 BJ MCHENRY 75 72

TC-10 CONTRACT NO. 62T01

ILLINOIS FED. AID PROJECT



FULL SIZE LETTERS 8' (2.4 m) AND ARROWS SHALL BE USED. AREA = 15.6 SQ. FT. (1.5 m<sup>2</sup>) (III) AREA = 20.8 SQ. FT. (1.9 m)<sup>2</sup> \* TURN LANES IN EXCESS OF 400' (120 m) IN LENGTH MAY HAVE AN ADDITIONAL SET OF ARROW - "ONLY" INSTALLED MIDWAY BETWEEN THE OTHER TWO SETS OF ARROW - "ONLY". TYPICAL LEFT (OR RIGHT) TURN LANE TYPICAL TURN LANE MARKING

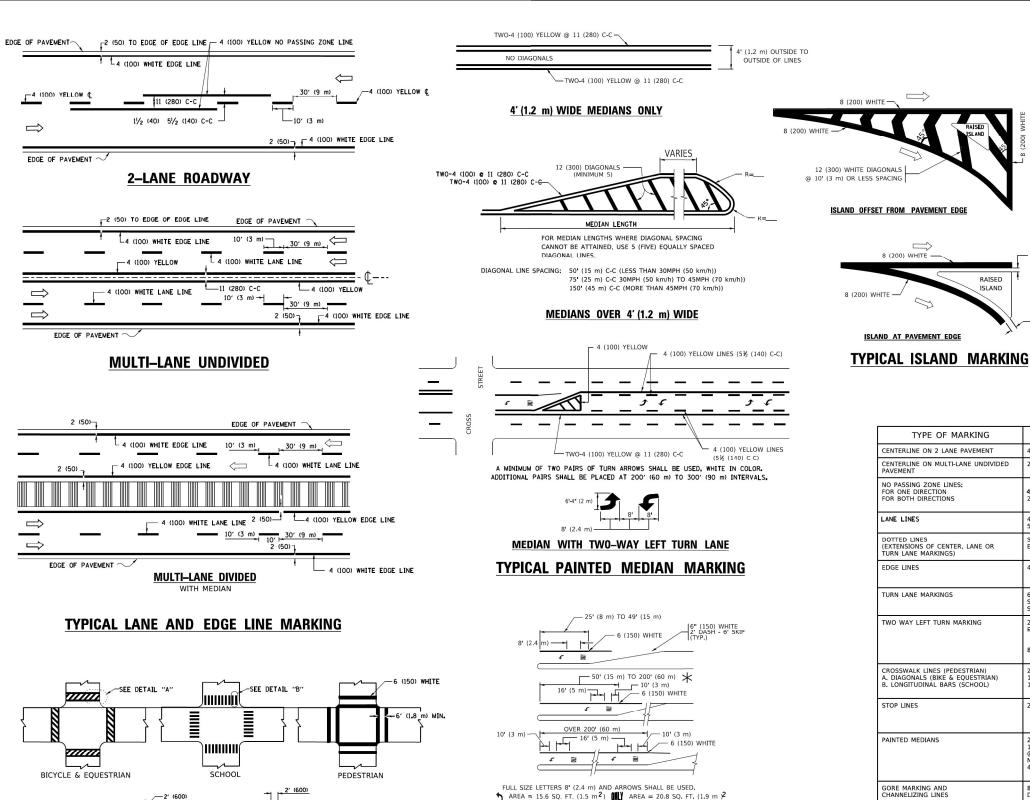

TYPE OF MARKING WIDTH OF LINE PATTERN COLOR SPACING / REMARKS CENTERLINE ON 2 LANE PAVEMENT YELLOW 10' (3 m) LINE WITH 30' (9 m) SPACE SOLID YELLOW NO PASSING ZONE LINES: FOR ONE DIRECTION FOR BOTH DIRECTIONS 5½ (140) C-C FROM SKIP-DASH CENTERLINE 11 (280) C-C OMIT SKIP-DASH CENTERLINE BETWEEN **4 (100)** 2 @ 4 (100) LANE LINES SKIP-DASH SKIP-DASH 10' (3 m) LINE WITH 30' (9 m) SPACE (100) (125) ON FREEWAYS DOTTED LINES EXTENSIONS OF CENTER, LANE OR FURN LANE MARKINGS) SAME AS LINE BEING EXTENDED SAME AS LINE BEING 2' (600) LINE WITH 6' (1.8 m) SPACE EDGE LINES SOLID OUTLINE MEDIANS IN YELLOW 4 (100) YELLOW-LEFT WHITE-RIGHT 6 (150) LINE; FULL SIZE LETTERS & SYMBOLS (8' (2.4m) SOLID SEE TYPICAL TURN LANE MARKING DETAIL 10' (3 m) LINE WITH 30' (9 m) SPACE FOR SKIP-DASH; 5½ (140) C-C BETWEEN SOLID LINE AND SKIP-DASH LINE SEE TYPICAL TWO-WAY LEFT TURN MARKING DETAIL TWO WAY LEFT TURN MARKING YELLOW 8' (2.4m) LEFT ARROW 2 @ 6 (150) 12 (300) @ 45° 12 (300) @ 90° CROSSWALK LINES (PEDESTRIAN)
A. DIAGONALS (BIKE & EQUESTRIAN) NOT LESS THAN 6' (1.8 m) APART 2' (600) APART B. LONGITUDINAL BARS (SCHOOL) SOLID SEE TYPICAL CROSSWALK MARKING DETAILS. PLACE 4\* (1.2 m) IN ADVANCE OF AND PARALLEL TO CROSSWALK, IF PRESENT. OTHERWISE, PLACE AT DESIRED STOPPING POINT. PARALLEL TO CROSSROAD CENTERLINE, WHERE POSSIBLE STOP LINES 24 (600) SOLID WHITE 11 (280) C-C FOR THE DOUBLE LINE SEE TYPICAL PAINTED MEDIAN MARKING 2 @ 4 (100) WITH 12 (300) DIAGONALS @ 45° PAINTED MEDIANS SOLID YELLOW: TWO WAY TRAFFIC WHITE: ONE WAY TRAFFIC @ 45° NO DIAGONALS USED FO 4' (1.2 m) WIDE MEDIAN: DIAGONALS: 15' (4.5 m) C-C (LESS THAN 30MPH (50 km/h)) 20' (6 m) C-C 30MPH (50 km/h) TO 45MPH (70 km/h)) 30' (9 m) C-C (OVER 45MPH (70 km/h)) GORE MARKING AND CHANNELIZING LINES 24 (600) TRANSVERSE LINES; "RR" IS 6' (1.8 m) LETTERS; 16 (400) LINE FOR "X" RAILROAD CROSSING SOLID WHITE SEE STATE STANDARD 780001 AREA OF: "R"=3.6 SQ. FT. (0.33 m )2EACH
"X"=54.0 SQ. FT. (5.0 m )2 50' (15 m) C-C (LESS THAN 30MPH (50 km/h)) 75' (25 m) C-C (30 MPH (50 km/h) TO 45MPH (70 km/h)) 150' (45 m) C-C (OVER 45MPH (70 km/h)) SHOULDER DIAGONALS (REQUIRED FOR 12 (300) @ 45 SOLID WHITE - RIGHT YELLOW - LEFT SHOULDERS > 8') U TURN ARROW SEE DETAIL SOLID WHITE 2 ARROW COMBINATION SEE DETAIL SOLID WHITE 30.4 SF

FOR FURTHER DETAILS ON PAVEMENT MARKING REFER TO STANDARD SPECIFICATIONS FOR ROAD AND BRIDGE CONSTRUCTION AND STATE STANDARD 780001.

8 (200) WHITE -

ISLAND AT PAVEMENT EDGE

RAISED

All dimensions are in inches (millimeters unless otherwise shown.

DESIGNED -EVERS REVISED - C. JUCIUS 09-09-09 DRAWN REVISED - C. JUCIUS 07-01-13 CHECKED DATE REVISED - C. JUCIUS 04-12-16

-12 (300) WHITE

DETAIL "B"

-6 (150) WHITE

TYPICAL CROSSWALK MARKING


\* MARKINGS SHALL BE INSTALLED PARALLEL TO THE CENTERLINE OF

DETAIL "A"

THE ROAD WHICH IT CROSSES

STATE OF ILLINOIS **DEPARTMENT OF TRANSPORTATION** 

SECTION COUNTY DISTRICT ONE 47 FAP 032622 BJ McHENRY 75 73 TYPICAL PAVEMENT MARKINGS TC-13 CONTRACT NO. 62T01 OF 2 SHEETS STA SCALE: NONE SHEET 1

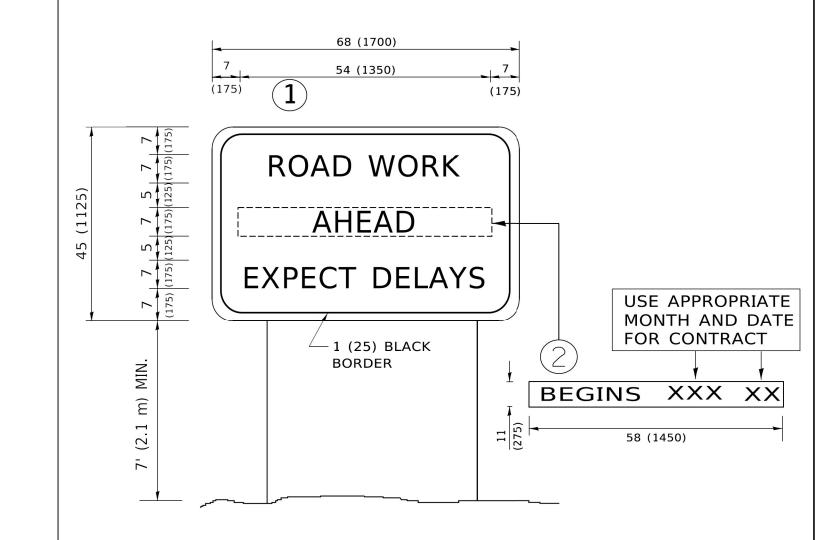

# NOTES:

- 1. USE BLACK LETTERING ON ORANGE BACKGROUND.
- 2. ERECT SIGNS IN ADVANCE OF THE LOCATION FOR THE "ROAD CONSTRUCTION AHEAD" SIGN AT LOCATIONS AS DIRECTED BY THE ENGINEER.
- 3. ERECT SIGN(1)WITH INSTALLED PANEL(2)ONE WEEK PRIOR TO THE START OF CONSTRUCTION.
- 4. REMOVE PANEL(2)SOON AFTER THE START OF CONSTRUCTION.
- 5. SEE SPECIAL PROVISION FOR "TEMPORARY INFORMATION SIGNING" FOR ADDITIONAL INFORMATION.

SHEET 1

6. ONE SIGN ASSEMBLY EQUALS 25.70 SQ. FT. (2.3 SQ. M.)

SCALE: NONE

7. SHALL BE PAID FOR AS TEMPORARY INFORMATION SIGNING.

ALL DIMENSIONS ARE IN INCHES (MILLIMETERS) UNLESS OTHERWISE SHOWN.

51			
		WSP USA Inc.	ι
	<b>1171</b>	30 N. LASALLE STREET SUITE 4200	Г
		CHICAGO, IL 60602 TEL: (312) 782-8150	F
1		FAX: (312) 782-1684	

USER NAME = footemj	DESIGNED -	REVISED	-	R. MIRS 09-15-97
	DRAWN -	REVISED	-	R. MIRS 12-11-97
PLOT SCALE = 50.0000 ' / in.	CHECKED -	REVISED	- T.	RAMMACHER 02-02-9
PLOT DATE = 3/4/2019	DATE -	REVISED	-	C. JUCIUS 01-31-07

STATE OF ILLINOIS								
DEPARTMENT	0F	TRANSPORTATION						

ARTE	RIAL RO	)AD			F.A. IL RTE.	SEC	TION		COUNTY TOTA		SH
INFORMATION SIGN					47	FAP 032622 BJ			McHENRY	75	7
					TC-22				CONTRACT	NO. 6	 2T0
OF 1	SHEETS	STA.	TO STA	١.			ILLINOIS	FED. A	ID PROJECT		



3.0" RADIUS, 0.5" BORDER, WHITE ON GREEN; REFLECTORIZED "DRIVEWAY" D; "ENTRANCE" D; STANDARD ARROW CUSTOM 12.0" x 5.0"

# NOTES:

- 1. HALF OF THE SIGNS WILL REQUIRE A LEFT HAND FACING ARROW.
- 2. TWO SIGNS SHALL BE USED AT EACH COMMERCIAL ENTRANCE PLACED BACK-TO-BACK: ONE WITH A RIGHT HAND ARROW (SHOWN) SHALL BE PLACED ON THE NEAR RIGHT SIDE THE DRIVEWAY AND ONE WITH A LEFT HAND ARROW SHALL BE PLACED ON THE FAR LEFT SIDE OF THE DRIVEWAY.
- 3. SIGNS TO BE PAID FOR AS ITEM "TEMPORARY INFORMATION SIGNING".

-					
	WSP USA Inc.	USER NAME = leysa	DESIGNED -	REVISED -	C. JUCIUS 02-15-07
AME	SUITE 4200		DRAWN -	REVISED -	
	CHICAGO, IL 60602 TEL: (312) 782-8150	PLOT SCALE = 50.0000 ' / in.	CHECKED -	REVISED -	
	FAX: (312) 782-1684	PLOT DATE = 8/6/2021	DATE -	REVISED -	

STATE	OF I	ILLINOIS
DEPARTMENT (	)F T	RANSPORTATION

SCALE: NONE

DRIVEWAY FRITRANCE CICAUNO					F.A. IL RTE.	SECT	TON		COUNTY	TOTAL SHEETS	SHEET NO.			
DRIVEWAY ENTRANCE SIGNING						47	47 FAP 032622 BJ		McHENRY	75	75			
						TC-26 CONTRACT NO. 62T0					T01			
	SHEET	1	OF	1	SHEETS	STA.	TO STA			ILLINOIS	FED. AI	D PROJECT		