

STAGING GENERAL NOTES

- 1. THE TRAFFIC CONTROL PLANS SHALL SERVE AS A GUIDE FOR SAFE DIVERSION OF TRAFFIC DURING EXECUTION OF THIS CONTRACT. THE CONTRACTOR MAY REQUEST TO IMPROVE OR MODIFY THE TRAFFIC CONTROL PLANS TO MEET CONSTRUCTION NEEDS BUT NOT AT THE EXPENSE OF PUBLIC SAFETY OR CONVENIENCE. ANY CHANGES TO THE TRAFFIC CONTROL PLANS SHALL BE SUBMITTED TO THE ENGINEER AND IDOT DISTRICT 2 TRAFFIC OPERATIONS FOR APPROVAL. THE ENGINEER SHALL BE INFORMED AT LEAST 10 DAYS IN ADVANCE OF ANY CHANGE REQUEST TO THE TRAFFIC CONTROL PLANS.
- 2. TRAFFIC CONDITIONS, ACCIDENTS, AND OTHER UNFORESEEN EMERGENCY CONDITIONS MAY REQUIRE THE ENGINEER TO RESTRICT, MODIFY, OR REMOVE LANE CLOSURES OR CHANNELIZATION SHOWN ON THE PLANS. THE CONTRACTOR SHALL MAKE THE NECESSARY ADJUSTMENTS DIRECTED BY THE ENGINEER WITHOUT DELAY. THE CONTRACTOR SHALL RESPOND WITHIN 30 MINUTES FROM THE TIME OF NOTIFICATIONS BY THE ENGINEER FOR CORRECTION, IMPROVEMENT, OR MODIFICATION OF THE MAINTENANCE OF TRAFFIC CONTROL DEVICES.
- 3. THE ATTENTION OF THE CONTRACTOR IS DIRECTED TO STANDARD SPECIFICATIONS ARTICLE 105.08. THE WORK ON THIS PROJECT WILL BE IN PROGRESS AT THE SAME TIME AS WORK ON OTHER SEPARATE ADJACENT CONTRACTS WHICH MAY INTERSECT THE LIMITS OF THIS PROJECT. THE CONTRACTOR SHALL COOPERATE WITH THE OTHER CONTRACTORS IN THE PHASING AND PERFORMANCE OF THIS WORK SO AS NOT TO DELAY, INTERRUPT, OR HINDER THE PROGRESS OR COMPLETION OF THE WORK BEING PERFORMED BY OTHER CONTRACTORS. NO ADDITIONAL COMPENSATION WILL BE ALLOWED FOR COMPLIANCE WITH THE ABOVE REQUIREMENTS, NOR FOR ANY DELAYS OR INCONVENIENCES RESULTING FROM THE ACTIVITIES OF OTHER CONTRACTORS. SHOULD A CONFLICT ARISE BETWEEN THE CONTRACTORS WITH RESPECT TO SEQUENCE OF CONSTRUCTION OR MAINTENANCE OF TRAFFIC REQUIREMENTS, SAID CONFLICTS SHALL BE RESOLVED ACCORDING TO STANDARD SPECIFICATIONS ARTICLE 105.08. THE CONTRACTORS SHALL INFORM EACH OTHER OF PROGRESS OF INTERSECTING PROJECTS AND GIVE FAIR WARNING TO THE OTHER CONTRACTORS WHEN A PROBLEM MIGHT BE ENCOUNTERED.
- 4. CHANGEABLE MESSAGE SIGNS SHALL BE PROVIDED TWO WEEKS IN ADVANCE OF STAGE SWITCHES, MAJOR CHANGES IN TRAFFIC PATTERNS, NEW SIGNALS (STARTING ON THE DAY THEY ARE TURNED ON FOR 2 WEEKS), RAMP CLOSURES, ETC; AND TWO WEEKS IN ADVANCE OF START OF WORK. CHANGEABLE MESSAGE SIGNS SHALL BE PAID AT THE CONTRACT UNIT PRICE PER CALENDAR MONTH.
- 5. TEMPORARY OFF-PEAK HOUR LANE CLOSURES AND FULL ROAD CLOSURES MUST BE REQUESTED THROUGH THE TRAFFIC OPERATIONS AND AS SPECIFIED IN THE SPECIAL PROVISIONS. WHEN OFF-PEAK HOUR, WEEKEND LANE CLOSURES, OR FULL ROAD CLOSURES ARE REQUIRED, A PORTABLE CHANGEABLE MESSAGE SIGN SHALL BE INSTALLED TWO WEEKS PRIOR TO THE CLOSURE. THE MESSAGE AND LOCATION OF THE SIGN WILL BE DETERMINED BY THE ENGINEER.
- 6. ALL ADVANCED WARNING SIGNS AND TEMPORARY PAVEMENT MARKINGS SHALL BE IN PLACE AND APPROVED BY THE ENGINEER PRIOR TO THE COMMENCEMENT OF ANY STAGE OF CONSTRUCTION.
- 7. UTILITIES AND BUILDINGS IN CONFLICT ARE TO BE REMOVED OR RELOCATED PRIOR TO CONSTRUCTION (BY OTHERS).
- 8. CONSTRUCTION TRAVEL TIME INFORMATION FOR SPECIFIC ROUTES DURING THE VARIOUS STAGES OF THE I-74 RECONSTRUCTION PROJECT WILL BE MANAGED UNDER A SEPARATE WORK ZONE TRAFFIC MANAGEMENT SYSTEM CONTRACT BY OTHERS. THAT CONTRACT WILL COLLECT TRAVEL TIME INFORMATION ON 19TH STREET AND THE ALTERNATE/DETOUR ROUTES, DETECT SPEEDS AND QUEUES DURING THE PEAK PERIODS, SUPPLEMENT EXISTING DIGITAL MESSAGE SIGN WITH PORTABLE DIGITAL MESSAGE SIGN (PDMS), AND COMMUNICATE TRAVEL TIME INFORMATION TO THE MOTORING PUBLIC THROUGH VARIOUS MESSAGING SOURCES. COORDINATION WITH THE WORK ZONE TRAFFIC SYSTEM CONTRACTOR WILL BE NECESSARY.
- 9. THE TEMPORARY CONCRETE BARRIER SHALL BE PINNED TO THE PAVEMENT WITH 3 PINS PER SECTION ON THE TRAFFIC SIDE OF THE BARRIER WALL AT THE LOCATIONS SHOWN ON THE STAGING PLAN SHEETS IN THE CONTRACT DOCUMENTS. TRANSITIONS SHALL BE ACCORDING TO THE SUPPLEMENTAL SPECIFICATION FOR TEMPORARY CONCRETE BARRIER. THE BARRIER UNIT AT EACH END SHALL BE ANCHORED WITH 6 ANCHOR PINS AS SPECIFIED IN ARTICLE 704.04. ALL ANCHORING AND PINNING HOLES SHALL BE CORE DRILLED.
- 10. THE PAVEMENT SHOWN BETWEEN THE BARRIER WALL AND THE REMOVAL AND/OR CONSTRUCTION AREA SHALL BE MAINTAINED AS SHOWN IN THE PLANS AND KEPT CLEAR OF ALL HAZARDS, SUCH AS VEHICLES, EQUIPMENT AND MATERIALS. IF THESE AREAS ARE NOT MAINTAINED AS SHOWN, ANY PINNING THAT IS REQUIRED AS A RESULT OF NOT MAINTAINING THIS, AND ANY OTHER WORK REQUIRED TO PIN, SUCH AS PROVIDING TRAFFIC CONTROL FOR A LANE CLOSRUE SHALL BE THE RESPONSIBILTY OF THE CONTRACTOR. THE MINIMUM PAVEMENT TO REMAIN IN PLACE BETWEEN THE BARRIER AND REMOVAL AREA SHALL BE 6 INCHES, EVEN WHEN THE BARRIER WALL IS PINNED.

TEMPORARY PAVEMENT TRANSITION DETAIL



PEDESTRIAN NOTES

- THE CONTRACTOR WILL BE RESPONSIBLE FOR ENSURING THAT ALL RESIDENCES, BUSINESSES AND OTHER FACILITIES ARE ACCESSIBLE AT ALL TIMES.
- 2. AT EACH POINT OF CLOSURE, A SUFFICIENT NUMBER OF BARRICADES MUST BE USED TO COMPLETELY CLOSE THE PATHWAY.
- PEDESTRIAN WALKWAYS MUST BE MAINTAINED FREE OF ANY OBSTRUCTIONS AND HAZARDS SUCH AS HOLES, DEBRIS, MUD, CONSTRUCTION EQUIPMENT, STORED MATERIALS, ETC. AND MUST BE BROOM SWEPT DAILY OR AS DIRECTED BY THE ENGINEER.
- 4. ALL HAZARDS NEAR OR ADJACENT TO WALKWAYS MUST BE CLEARLY DELINEATED.
- THE CONTRACTOR MUST MAINTAIN DISABLED PERSON PEDESTRIAN ACCESS TO CROSSWALKS AT ALL TIMES VIA ADA COMPLIANT WALKWAYS AND RAMPS THROUGH THE WORK ZONES. THESE ACCESSES MUST BE OBSERVED AND PROTECTED BY THE CONTRACTOR AT ALL TIMES.

SCALE:

SHEET NO.

FILE NAME : D2CONCD-HPS-sht-gennote71M.dgn

USER NAME = hehnØ1663	DESIGNED	-	MGJ	REVISED	-
	DRAWN	-	MGJ	REVISED	-
PLOT SCALE =	CHECKED	-	MTH	REVISED	-
PLOT DATE = 3/22/2017	DATE	-	3/23/2017	REVISED	-

STATE OF ILLINOIS **DEPARTMENT OF TRANSPORTATION**

							MOT	-001
STAGING PLAN				F.A.I RTE.	SECTION	COUNTY	TOTAL SHEETS	SHEE NO.
GENERAL NOTES			74	(81-1)R-1 & 81-1(HBR, HBR-1, HBR-	ROCK ISLAND	2042	205	
						CONTRACT	NO. 6	64E26
OF	SHEETS	STA.	TO STA.		ILLINOIS FED.	AID PROJECT		

MAINLINE AND RAMPS

STAGE 1-0 CONSTRUCTION:

PROPOSED I-74 MAINLINE: CONSTRUCT TEMPORARY PAVEMENT TO THE LIMITS SHOWN IN THE STAGING PLAN SHEETS. THIS WORK SHALL BE COMPLETED WITHIN TWO WEEKS. IF NOT COMPLETED WITHIN TWO WEEKS. THE CONTRACTOR SHALL PROVIDE TEMPORARY CONCRETE BARRIER AND TEMPORARY IMPACT ATTENUATORS TO SHIELD THE WORK ZONE. TEMPORARY CONCRETE BARRIER AND TEMPORARY IMPACT ATTENUATOR LAYOUT SHALL BE APPROVED BY IDOT. COST OF TEMPORARY CONCRETE BARRIER AND TEMPORARY IMPACT ATTENUATORS SHALL BE AT THE CONTRACTOR'S OWN EXPENSE.

PROPOSED RAMPS AC-A. AC-B AND AC-C: CONSTRUCT TEMPORARY PAVEMENT TO THE LIMITS SHOWN IN THE STAGING PLAN SHEETS.

STAGE 1-0 TRAFFIC PATTERNS:

EXISTING I-74 MAINLINE: MAINTAIN EXISTING TRAFFIC PATTERNS DURING THE DAY WITH SHOULDER CLOSURE USING TRAFFIC STANDARD 701101 SOUTH OF AVENUE OF THE CITIES AS SHOWN IN THE STAGING PLAN SHEETS. NIGHTLY LANE CLOSURE OF OUTSIDE LANE SOUTH OF AVENUE OF THE CITIES USING TRAFFIC STANDARD 701400 AND 701401. WORK SHALL ONLY BE PERFORMED WHEN A LANE CLOSURE IS IN PLACE. SEE STANDARD PROVISIONS FOR NIGHTLY CLOSURE HOURS

PROPOSED RAMPS AC-A, AC-B, AND AC-C: TRAFFIC SHIFTED PARTIALLY ONTO RAMP SHOULDER USING STANDARD 701456.

STAGE 1-1 CONSTRUCTION:

PROPOSED I-74 MAINLINE: SOUTH OF AVENUE OF THE CITIES. CONSTRUCT EARTHWORK, DRAINAGE, PERMANENT PAVEMENT, AND TEMPORARY PAVEMENT TO THE LIMITS SHOWN IN THE STAGING PLAN SHEETS.

PROPOSED RAMP AC-A: CONSTRUCT OUTSIDE PERMANENT PAVEMENT TO THE LIMITS SHOWN IN THE STAGING PLAN SHEETS.

PROPOSED RAMP AC-C: CONSTRUCT OUTSIDE PERMANENT AND TEMPORARY PAVEMENT TO THE LIMITS SHOWN IN THE STAGING PLAN SHEETS.

RAMPS: ALL OTHER RAMPS MAINTAIN EXISTING TRAFFIC PATTERNS.

STAGE 1-1 TRAFFIC PATTERNS:

EXISTING I-74 MAINLINE: MAINTAIN EXISTING TRAFFIC PATTERNS NORTH OF AVENUE OF THE CITIES. SOUTH OF AVENUE OF THE CITIES, TRAFFIC SHIFTED ONTO TEMPORARY PAVEMENT, OUTSIDE SHOULDER AND OUTSIDE LANE ADJACENT TO TEMPORARY CONCRETE BARRIER.

PROPOSED RAMPS AC-A. AC-B AND AC-C: TRAFFIC SHIFTED PARTIALLY ONTO RAMP SHOULDER USING STANDARD 701456.

RAMPS: ALL OTHER RAMPS MAINTAIN EXISTING TRAFFIC PATTERNS.

STAGE 1-2 CONSTRUCTION:

PROPOSED I-74 MAINLINE: SOUTH OF AVENUE OF THE CITIES, CONSTRUCT EARTHWORK, DRAINAGE, PERMANENT PAVEMENT, AND TEMPORARY PAVEMENT TO THE LIMITS SHOWN IN THE STAGING PLAN SHEETS.

PROPOSED RAMP AC-A: CONSTRUCT OUTSIDE EARTHWORK, DRAINAGE, AND PERMANENT PAVEMENT TO THE LIMITS SHOWN IN THE STAGING PLAN SHEETS.

PROPOSED RAMP AC-C: CONSTRUCT OUTSIDE TEMPORARY PAVEMENT. EARTHWORK, DRAINAGE, AND PERMANENT PAVEMENT TO THE LIMITS SHOWN IN THE STAGING PLAN SHEETS.

STAGE 1-2 TRAFFIC PATTERNS:

EXISTING I-74 MAINLINE: MAINTAIN EXISTING TRAFFIC PATTERNS NORTH OF AVENUE OF THE CITIES.

PROPOSED WB I-74 MAINLINE: SOUTH OF AVENUE OF THE CITIES, WB TRAFFIC SHIFTED ONTO MEDIAN. MEDIAN SHOULDER AND INSIDE LANE ADJACENT TO TEMPORARY CONCRETE BARRIER.

PROPOSED EB I-74 MAINLINE: SOUTH OF AVENUE OF THE CITIES, EB TRAFFIC SHIFTED ONTO MEDIAN SHOULDER AND INSIDE LANE ADJACENT TO TEMPORARY CONCRETE BARRIER.

PROPOSED RAMP AC-A: TRAFFIC SHIFTED INSIDE ONTO RAMP SHOULDER AND TEMPORARY PAVEMENT USING STANDARD 701456.

PROPOSED RAMP AC-C: TRAFFIC SHIFTED INSIDE PARTIALLY ONTO RAMP SHOULDER USING STANDARD 701456.

RAMPS: MAINTAIN CURRENT TRAFFIC PATTERNS ON ALL OTHER RAMPS AS SHOWN IN PLANS.

STAGE 1-3 CONSTRUCTION:

PROPOSED WB I-74 MAINLINE: SOUTH OF AVENUE OF THE CITIES, CONSTRUCT EARTHWORK, DRAINAGE, PERMANENT PAVEMENT, AND TEMPORARY PAVEMENT TO THE LIMITS SHOWN IN THE STAGING PLAN SHEETS.

PROPOSED EB I-74 MAINLINE: SAME AS STAGE 1-2.

PROPOSED RAMP AC-A: CONSTRUCT INSIDE EARTHWORK, DRAINAGE, AND PERMANENT PAVEMENT TO THE LIMITS SHOWN IN THE STAGING PLAN SHEETS.

STAGE 1-3 TRAFFIC PATTERNS:

EXISTING I-74 MAINLINE: MAINTAIN EXISTING TRAFFIC PATTERNS NORTH OF AVENUE OF THE CITIES.

PROPOSED WB I-74 MAINLINE: SOUTH OF AVENUE OF THE CITIES, WB TRAFFIC SHIFTED ONTO MEDIAN, MEDIAN SHOULDER AND INSIDE LANE ADJACENT TO TEMPORARY CONCRETE BARRIER.

PROPOSED EB I-74 MAINLINE: SAME AS STAGE 1-2.

PROPOSED RAMP AC-A: TRAFFIC SHIFTED TO PROPOSED RAMP AC-A.

PROPOSED RAMP AC-C: OPEN TO TRAFFIC.

EXISTING RAMPS: MAINTAIN CURRENT TRAFFIC PATTERNS ON RAMPS AC-B AND AC-D AS SHOWN IN PLANS.

STAGE 1-4 CONSTRUCTION:

PROPOSED I-74 MAINLINE: SOUTH OF AVENUE OF THE CITIES, CONSTRUCT MEDIAN BARRIER TO THE LIMITS SHOWN IN THE STAGING PLAN SHEETS.

STAGE 1-4 TRAFFIC PATTERNS:

EXISTING I-74 MAINLINE: MAINTAIN EXISTING TRAFFIC PATTERNS NORTH OF AVENUE OF THE CITIES.

PROPOSED I-74 MAINLINE: OPEN TO TWO LANES OF TRAFFIC USING TEMPORARY PAVEMENT MARKING

PROPOSED RAMP AC-A: OPEN TO TRAFFIC.

EXISTING RAMPS: MAINTAIN CURRENT TRAFFIC PATTERNS ON RAMPS AC-B. AC-C. AND AC-D AS SHOWN IN PLANS.

WINTER STAGE 2018-2019 TRAFFIC PATTERNS:

EXISTING I-74 MAINLINE: MAINTAIN EXISTING TRAFFIC PATTERNS NORTH OF AVENUE OF THE CITIES.

EXISTING RAMPS: MAINTAIN CURRENT TRAFFIC PATTERNS ON RAMPS AC-B, AC-C, AND AC-D AS SHOWN IN PLANS

PROPOSED I-74 MAINLINE: SAME AS STAGE 1-4.

PROPOSED RAMP AC-A: OPEN TO TRAFFIC

STAGE 2 CONSTRUCTION:

PROPOSED WB I-74 MAINLINE: CONSTRUCT EARTHWORK, DRAINAGE, PERMANENT PAVEMENT, MEDIAN BARRIER WALL, MEDIAN SHOULDER PAVEMENT AND RETAINING WALLS TO THE LIMITS SHOWN IN THE STAGING PLAN SHEETS FROM THE NORTHERN PROJECT LIMIT TO JUST SOUTH OF AVENUE OF THE CITIES. CONSTRUCT PROPOSED BRIDGES, SN 081-0179 (WB MAINLINE OVER 19TH ST.), SN 081-0182 (WB MAINLINE OVER 12TH AVE.), SN 081-0184 (WB MAINLINE OVER SB 19TH ST.) AS SHOWN IN THE STRUCTURAL PLAN SHEETS.

RAMP 7TH-A: CONSTRUCT EARTHWORK, DRAINAGE, PERMANENT PAVEMENT AND PROPOSED BRIDGE, SN 081-0179 (WB MAINLINE OVER 19TH ST.).

RAMP AC-B: CONSTRUCT TEMPORARY PAVEMENT TO THE LIMITS SHOWN IN THE STAGING PLAN SHEETS.

RAMP AC-D: CONSTRUCT EARTHWORK, DRAINAGE, AND PERMANENT PAVEMENT TO THE LIMITS SHOWN IN THE STAGING PLAN SHEETS.

STAGE 2 TRAFFIC PATTERNS:

EXISTING EB MAINLINE I-74: MAINTAIN EXISTING TRAFFIC PATTERNS.

EXISTING WB MAINLINE I-74: CLOSED AND DETOURED TO I-80 AND ALTERNATE I-280. LOCAL ACCESS TO IOWA IS MAINTAINED ON THE LOCAL ACCESS ROUTE CROSSING.

EXISTING RAMP S-7: CLOSED AND REPLACED WITH RAMP 7TH-A.

EXISTING RAMP 7-S: TRAFFIC REDUCED TO ONE LANE.

EXISTING RAMP AC-D: CLOSED USING STANDARD 701451

EXISTING RAMPS: MAINTAIN CURRENT TRAFFIC PATTERNS ON RAMPS 7-S, AC-B, AND AC-C AS SHOWN IN PLANS.

RAMP 7TH-A: UNDER CONSTRUCTION.

WINTER STAGE 2019-2020 TRAFFIC PATTERNS:

EXISTING EB MAINLINE I-74: MAINTAIN EXISTING TRAFFIC PATTERNS.

EXISTING WB MAINLINE I-74: CLOSED.

PROPOSED WB MAINLINE 1-74: OPEN TO THREE LANES OF TRAFFIC USING TEMPORARY PAVEMENT MARKINGS

EXISTING RAMPS: MAINTAIN CURRENT TRAFFIC PATTERNS ON RAMPS 7-S, AC-B, AND AC-C AS SHOWN IN PLANS.

EXISTING RAMP 7-S: TRAFFIC REDUCED TO ONE LANE.

EXISTING RAMP S-7: CLOSED AND REPLACED WITH RAMP 7TH-A.

RAMP 7TH-A: OPEN TO TRAFFIC.

RAMP AC-D: OPEN TO TRAFFIC.

MOT-002 DESIGNED - MGJ REVISED STAGING PLAN FILE NAME = USER NAME = hehn@1663 SECTION COUNTY STATE OF ILLINOIS DRAWN CBP REVISED CONSTRUCTION SEQUENCING NOTES 74 (81-1)R-1 & 81-1(HBR, HBR-1, HBR-2) ROCK ISLAND 2042 206 CHECKED МТН REVISED **DEPARTMENT OF TRANSPORTATION** CONTRACT NO. 64E26 SCALE: SHEET NO. OF SHEETS STA. TO STA. PLOT DATE = 3/22/2017 DATE 3/23/2017 REVISED

D2CONCD-HPS-sht-staging700M.dgn

STAGE 3 CONSTRUCTION:

PROPOSED EB I-74 MAINLINE: CONSTRUCT EARTHWORK, DRAINAGE, PERMANENT PAVEMENT, MEDIAN BARRIER WALL AND RETAINING WALLS TO THE LIMITS SHOWN IN THE STAGING PLAN SHEETS. CONSTRUCT PROPOSED BRIDGES, SN 081-0180 (EB MAINLINE OVER 19TH ST.) SN 081-0183 (EB MAINLINE OVER 12TH AVE.) AND SN 81-0185 (EB MAINLINE OVER SB 19TH ST.) AS SHOWN IN THE STRUCTURAL PLAN SHEETS

STAGE 3 TRAFFIC PATTERNS:

PROPOSED WB MAINLINE I-74: WB TRAFFIC REDUCED TO TWO LANES AND SHIFTED ONTO OUTSIDE SHOULDER AND OUTSIDE LANE ADJACENT TO TEMPORARY CONCRETE BARRIER. EB TRAFFIC REDUCED TO TWO LANES ONTO INSIDE SHOULDER AND INSIDE LANE OF THE WB PROPOSED PAVEMENT ADJACENT TO TEMPORARY CONCRETE BARRIER. EB TRAFFIC CROSSED BACK OVER USING STANDARD 701416, MODIFIED.

STAGE 3-1 CONSTRUCTION:

PROPOSED EB I-74 MAINLINE: CONSTRUCT EARTHWORK, DRAINAGE, PERMANENT PAVEMENT, MEDIAN SHOULDER PAVEMENT AND RETAINING WALLS TO THE LIMITS SHOWN IN THE STAGING PLAN SHEETS FROM THE NORTHERN PROJECT LIMIT TO JUST SOUTH OF AVENUE OF THE CITIES. CONSTRUCT PROPOSED BRIDGES, SN 081-0180 (EB MAINLINE OVER 19TH ST.), SN 081-0183 (EB MAINLINE OVER 12TH AVE.), AND SN 81-0185 (EB MAINLINE OVER SB 19TH ST.) AS SHOWN IN THE STRUCTURAL PLAN SHEETS.

RAMP 7TH-B: CONSTRUCT EARTHWORK, DRAINAGE AND PERMANENT PAVEMENT TO THE LIMITS SHOWN IN THE STAGING PLAN SHEETS.

RAMP AC-B: CONSTRUCT INSIDE RAMP EARTHWORK, DRAINAGE, AND PERMANENT PAVEMENT TO THE LIMITS SHOWN IN THE STAGING PLAN SHEETS.

RAMP AC-C: CONSTRUCT EARTHWORK, DRAINAGE, AND PERMANENT PAVEMENT TO THE LIMITS SHOWN IN THE STAGING PLAN SHEETS.

EXISTING RAMP 7-S: CLOSED AND REPLACED WITH RAMP 7TH-B.

EXISTING RAMP S-7: CLOSED AND REPLACED WITH RAMP 7TH-A.

RAMP 7TH-A: OPEN TO TRAFFIC.

RAMP 7TH-B: UNDER CONSTRUCTION.

STAGE 3-1 TRAFFIC PATTERNS:

PROPOSED WB MAINLINE I-74: WB TRAFFIC AND EB TRAFFIC SHALL BE MAINTAINED TO TWO LANES IN EACH DIRECTION USING STANDARD 701416

EXISTING RAMP 7-S: CLOSED AND REPLACED WITH RAMP 7TH-B.

EXISTING RAMP S-7: CLOSED AND REPLACED WITH RAMP 7TH-A.

RAMP 7TH-A: OPEN TO TRAFFIC.

RAMP 7TH-B: UNDER CONSTRUCTION.

RAMP AC-A: OPEN TO TRAFFIC.

EXISTING RAMP AC-B: TRAFFIC SHIFTED TO OUTSIDE OF RAMP AND TEMPORARY PAVEMENT USING STANDARD 701456.

EXISTING RAMP AC-C: CLOSED.

RAMP AC-D: OPEN TO TRAFFIC

STAGE 3-2 CONSTRUCTION:

PROPOSED EB I-74 MAINLINE: CONSTRUCT EARTHWORK, DRAINAGE, PERMANENT PAVEMENT, MEDIAN SHOULDER PAVEMENT AND RETAINING WALLS TO THE LIMITS SHOWN IN THE STAGING PLAN SHEETS FROM THE NORTHERN PROJECT LIMIT TO JUST SOUTH OF AVENUE OF THE CITIES. CONSTRUCT PROPOSED BRIDGES, SN 081-0180 (EB MAINLINE OVER 19TH ST.), SN 081-0183 (EB MAINLINE OVER 12TH AVE.) AND SN 81-0185 (EB MAINLINE OVER SB 19TH ST.) AS SHOWN IN THE STRUCTURAL PLAN SHEETS.

RAMP 7TH-B: CONSTRUCT EARTHWORK, DRAINAGE AND PERMANENT PAVEMENT TO THE LIMITS SHOWN IN THE STAGING PLAN SHEETS.

RAMP AC-B: CONSTRUCT OUTSIDE RAMP EARTHWORK, DRAINAGE, AND PERMANENT PAVEMENT TO THE LIMITS SHOWN IN THE STAGING PLAN SHEETS.

RAMP AC-C: SAME AS STAGE 3-1.

STAGE 3-2 TRAFFIC PATTERNS:

PROPOSED WB MAINLINE I-74: SAME AS STAGE 3-1.

EXISTING RAMP 7-S: CLOSED AND REPLACED WITH RAMP 7TH-B.

EXISTING RAMP S-7: CLOSED AND REPLACED WITH RAMP 7TH-A

RAMP 7TH-A: OPEN TO TRAFFIC.

RAMP 7TH-B: UNDER CONSTRUCTION.

RAMP AC-A: OPEN TO TRAFFIC.

RAMP AC-B: TRAFFIC SHIFTED TO INSIDE OF PROPOSED RAMP PAVEMENT AND SHOULDER.

EXISTING RAMP AC-C: CLOSED.

RAMP AC-D: OPEN TO TRAFFIC.

(MAINLINE STAGE 3 CONCURRENT TO LOCAL ROAD STAGING AND ADJACENT CONSTRACT AB: STAGES 3-0 THRU 3-3)

STAGE 3-4 CONSTRUCTION:

PROPOSED I-74 MAINLINE: CONSTRUCT PERMANENT MEDIAN BARRIER TO THE LIMITS SHOWN IN THE STAGING PLAN SHEETS.

STAGE 3-4 TRAFFIC PATTERNS:

PROPOSED WB I-74 MAINLINE: SAME AS STAGE 3-1.

PROPOSED EB I-74 MAINLINE: INSIDE LANE CLOSURE TO THE LMITS SHOWN IN THE STAGING SHEET PLANS USING STANDARD 701401

ALL PROPOSED RAMPS: OPEN.

FILE NAME = D2CONCD-HPS-sht-staging703M.dgn USER NAME = hehn@1663 DESIGNED - MGJ REVISED DRAWN CBP REVISED CHECKED мтн REVISED PLOT DATE = 3/22/2017 DATE 3/23/2017 REVISED

STATE OF ILLINOIS **DEPARTMENT OF TRANSPORTATION**

SCALE:

STAGING PLAN SECTION COUNTY CONSTRUCTION SEQUENCING NOTES 74 (81-1)R-1 & 81-1(HBR, HBR-1, HBR-2) ROCK ISLAND 2042 207 CONTRACT NO. 64E26 SHEET NO. OF SHEETS STA. TO STA.

MOT-003

LOCAL ROADS

STAGE 1-0 CONSTRUCTION:

RAMP AC-B, AC-C AND AC-D: CONSTRUCT TEMPORARY PAVEMENT TO THE LIMITS AS SHOWN IN THE STAGING PLAN SHEETS.

23RD STREET: CONSTRUCT TEMPORARY ENTRANCE AS SHOWN IN THE STAGING PLANS.

STAGE 1-0 TRAFFIC PATTERNS:

19TH STREET: NB LANES SHIFTED USING DISTRICT STANDARD 39.1

NB 19TH STREET: NB TRAFFIC REDUCED TO ONE LANE AND SHIFTED USING STANDARD 701601

SB 19TH STREET: SB TRAFFIC REDUCED TO ONE LANE AND SHIFTED USING STANDARD 701601

RAMP AC-B, AC-C AND AC-D: RAMP LANE REDUCED AND SHIFTED USING STANDARD 701456

23RD STREET: TRAFFIC REDUCED DURING CONSTRUCTION USING STANDARD 701501.

STAGE 1-1 CONSTRUCTION:

19TH STREET: CONSTRUCT EARTHWORK, DRAINAGE, SIDEWALK AND PERMANENT PAVEMENT TO THE LIMITS SHOWN IN THE STAGING PLAN SHEETS.

NB 19TH STREET: CONSTRUCT EARTHWORK, DRAINAGE, SIDEWALK AND PERMANENT PAVEMENT TO THE LIMITS SHOWN IN THE STAGING PLAN SHEETS.

SB 19TH STREET: CONSTRUCT EARTHWORK, DRAINAGE, SIDEWALK AND PERMANENT PAVEMENT TO THE LIMITS SHOWN IN THE STAGING PLAN SHEETS.

RAMP AC-A, AC-B, AC-C AND AC-D: CONSTRUCT EARTHWORK, DRAINAGE, PERMANENT PAVEMENT AND TEMPORARY PAVEMENT TO THE LIMITS AS SHOWN IN THE STAGING PLAN SHEETS.

STAGE 1-1 TRAFFIC PATTERNS:

19TH STREET: NB LANES SHIFTED USING DISTRICT STANDARD 39.1 NORTH OF 11TH AVE AND 19TH STREET CLOSED SOUTH OF 12TH AVENUE USING DISTRICT STANDARD 40.1. ALL SB TRAFFIC IS DETOURED ONTO I-74 EB AT 7TH AVE.

NB 19TH STREET: NB TRAFFIC REDUCED TO ONE LANE AND SHIFTED USING STANDARD 701601. NB 19TH STREET CLOSED NORTH OF AVENUE OF THE CITIES USING DISTRICT STANDARD 40.1. ALL TRAFFIC IS DETOURED ONTO I-74 WB AT

SB 19TH STREET: SB TRAFFIC FROM RAMP AC-C REMAINS AS ONE LANE OF TRAFFIC TO SOUTH OF RAMP AC-B

18th AVENUE: CLOSED AT INTERSECTION WITH NB 19TH STREET USING DISTRICT STANDARD 40.1.

RAMPS AC-A, AC-B, AC-C AND AC-D: RAMP LANE REDUCED AND SHIFTED USING STANDARD 701456.

STAGE 1-1A CONSTRUCTION:

SB 19TH STREET: CONSTRUCT EARTHWORK, DRAINAGE AND PERMANENT PAVEMENT TO THE LIMITS SHOWN IN THE STAGING PLAN SHEETS.

STAGE 1-1A TRAFFIC PATTERNS:

SB 19TH STREET: SB TRAFFIC FROM RAMP AC-C REMAINS AS ONE LANE OF TRAFFIC TO SOUTH OF RAMP AC-B.

STAGE 1-2 CONSTRUCTION:

19TH STREET: CONSTRUCT EARTHWORK, DRAINAGE, SIDEWALK, PERMANENT PAVEMENT AND TEMPORARY PAVEMENT TO THE LIMITS SHOWN IN THE STAGING PLAN SHEETS.

NB 19TH STREET: CONSTRUCT EARTHWORK, DRAINAGE, SIDEWALK AND PERMANENT PAVEMENT TO THE LIMITS SHOWN IN THE STAGING PLAN SHEETS.

SB 19TH STREET: CONSTRUCT EARTHWORK, DRAINAGE, SIDEWALK AND PERMANENT PAVEMENT TO THE LIMITS SHOWN IN THE STAGING PLAN SHEETS.

RAMPS AC-A, AC-B, AC-C AND AC-D: CONSTRUCT EARTHWORK, DRAINAGE, PERMANENT PAVEMENT AND TEMPORARY PAVEMENT TO THE LIMITS AS SHOWN IN THE STAGING PLAN SHEETS.

STAGE 1-2 TRAFFIC PATTERNS:

19TH STREET: NB LANES SHIFTED USING DISTRICT STANDARD 39.1 NORTH OF 11TH AVE AND 19TH STREET CLOSED SOUTH OF 12TH AVENUE USING DISTRICT STANDARD 40.1. ALL SB TRAFFIC IS DETOURED ONTO I-74 EB AT 7TH AVE.

NB 19TH STREET: NB TRAFFIC REDUCED TO ONE LANE AND SHIFTED USING STANDARD 701601. NB 19TH STREET CLOSED NORTH OF AVENUE OF THE CITIES USING DISTRICT STANDARD 40.1. ALL TRAFFIC IS DETOURED ONTO I-74 WB AT

18th AVENUE: CLOSED AT INTERSECTION WITH NB 19TH STREET USING DISTRICT STANDARD 40.1.

RAMPS AC-A, AC-B, AC-C AND AC-D: RAMP LANE REDUCED AND SHIFTED USING STANDARD 701456

SB 19TH STREET: SB TRAFFIC FROM RAMP AC-C REMAINS AS ONE LANE OF TRAFFIC TO SOUTH OF RAMP AC-B.

STAGE 1-3 CONSTRUCTION:

19TH STREET: CONSTRUCT EARTHWORK, DRAINAGE, SIDEWALK, PERMANENT PAVEMENT AND TEMPORARY PAVEMENT TO THE LIMITS SHOWN IN THE STAGING PLAN SHEETS.

NB 19TH STREET: CONSTRUCT EARTHWORK, DRAINAGE, SIDEWALK AND PERMANENT PAVEMENT TO THE LIMITS SHOWN IN THE STAGING PLAN SHEETS.

SB 19TH STREET: CONSTRUCT EARTHWORK, DRAINAGE, SIDEWALK AND PERMANENT PAVEMENT TO THE LIMITS SHOWN IN THE STAGING PLAN SHEETS.

12TH AVENUE: CONSTRUCT EARTHWORK, DRAINAGE, SIDEWALK AND PERMANENT PAVEMENT TO THE LIMITS SHOWN IN THE STAGING PLAN SHEETS.

RAMPS AC-A AND AC-B: CONSTRUCT EARTHWORK, DRAINAGE, PERMANENT PAVEMENT AND TEMPORARY PAVEMENT TO THE LIMITS AS SHOWN IN THE STAGING PLAN SHEETS.

STATE OF ILLINOIS

STAGE 1-3 TRAFFIC PATTERNS:

19TH STREET: NB LANES SHIFTED USING DISTRICT STANDARD 39.1 NORTH OF 11TH AVE AND 19TH STREET CLOSED SOUTH OF 11TH AVENUE USING DISTRICT STANDARD 40.1. ALL SB TRAFFIC IS DETOURED ONTO I-74 EB AT 7TH AVE AND LOCAL TRAFFIC SOUTH OF 7TH AVE IS REDUCED TO ONE LANE USING STANDARD 701601

NB 19TH STREET: NB TRAFFIC REDUCED TO ONE LANE AND SHIFTED USING STANDARD 701601. NB 19TH STREET CLOSED NORTH OF AVENUE OF THE CITIES USING DISTRICT STANDARD 40.1. ALL TRAFFIC IS DETOURED ONTO I-74 WB AT RAMP AC-D

12TH AVENUE: CLOSED USING DISTRICT STANDARD 40.1.

11TH AVENUE A: TRAFFIC LIMITED TO RIGHT TURN ONLY ONTO 19TH ST.

18th AVENUE: CLOSED AT INTERSECTION WITH NB 19TH STREET USING DISTRICT STANDARD 40.1.

RAMPS AC-A, AC-B AND AC-D: RAMP LANE REDUCED AND SHIFTED USING STANDARD 701456.

STAGE 1-4 CONSTRUCTION:

AVENUE OF THE CITIES: MILL AND RESURFACE AND PROPOSED SIDEWALK RAMPS TO THE LIMITS SHOWN IN THE ROADWAY PLAN SHEETS.

23RD STREET: REMOVE TEMPORARY ENTRANCE AND REPLACE TO EXISTING CONDITIONS AS SHOWN IN THE STAGING PLANS.

STAGE 1-4 TRAFFIC PATTERNS:

19TH STREET: NB LANES SHIFTED USING DISTRICT STANDARD 39.1 AND ALL MOVEMENTS OPEN

AVENUE OF THE CITIES: EB AND WB TRAFFIC LANES REDUCED AND SHIFTED DURING RESURFACING OPERATIONS USING STANDARD 701601 AND DISTRICT STANDARD 35.1 DURING WORKING CLOSURES ONLY

23RD STREET: TRAFFIC REDUCED DURING CONSTRUCTION USING STANDARD 701501.

STAGE 2-0 CONSTRUCTION:

19TH STREET: CONSTRUCT DRAINAGE AND TEMPORARY PAVEMENT INCLUDING TEMPORARY RUNAROUND UNDER EXISTING EB I-74 TO THE LIMITS SHOWN IN THE STAGING PLAN SHEETS.

STAGE 2-0 TRAFFIC PATTERNS:

19TH STREET: SB TRAFFIC REDUCED TO ONE LANE AND BOTH DIRECTIONS SHIFTED DURING TEMPORARY PAVEMENT CONSTRUCTION USING STANDARD 701601 AND DISTRICT STANDARD 39.1. SEE STRUCTURAL PLAN SHEETS AND SCHEDULE FOR BRIDGE DETAILS.

STAGE 2 TRAFFIC PATTERNS:

NB 19TH STREET: NB TRAFFIC REDUCED TO ONE LANE DURING MAINLINE DETOUR USING STANDARD 701601.

STAGE 2-1 CONSTRUCTION:

19TH STREET: CONSTRUCT PROPOSED PIERS, RETAINING WALLS, DRAINAGE AND TEMPORARY PAVEMENT TO THE LIMITS SHOWN IN THE STAGING PLAN SHEETS AND STRUCTURAL PLAN SHEETS.

SB 19TH STREET: CONSTRUCT PROPOSED PIERS, RETAINING WALLS AND DRAINAGE TO THE LIMITS SHOWN IN THE STAGING PLAN SHEETS AND STRUCTURAL PLAN SHEETS.

12TH AVENUE: CONSTRUCT PROPOSED PIERS, RETAINING WALLS, DRAINAGE AND SIDEWALK TO THE LIMITS SHOWN IN THE STAGING PLAN SHEETS AND STRUCTURAL PLAN SHEETS.

MOT-004

COUNTY

CONTRACT NO. 64E26

FILE NAME = D2CONCD-HPS-sht-staging701M.dgn

DESIGNED - MGJ REVISED USER NAME = hehn@1663 DRAWN CBP REVISED CHECKED MTH REVISED PLOT DATE = 3/22/2017 3/23/2017 REVISED DATE

DEPARTMENT OF TRANSPORTATION

SHEET NO. OF SHEETS STA.

SCALE:

STAGING PLAN SECTION CONSTRUCTION SEQUENCING NOTES 74 (81-1)R-1 & 81-1(HBR, HBR-1, HBR-2) ROCK ISLAND 2042 208 TO STA.

STAGE 2-1 TRAFFIC PATTERNS:

19TH STREET: NB 19TH ST. TRAFFIC TO PROVIDE 2 OPEN LANES DURING I-74 DETOUR STAGES. SB TRAFFIC REDUCED TO ONE LANE USING STANDARD 701601 AND BOTH DIRECTIONS SHIFTED DURING BRIDGE CONSTRUCTION USING DISTRICT STANDARD 39.1. SEE STRUCTURAL PLAN SHEETS AND SCHEDULE FOR BRIDGE DETAILS.

SB 19TH STREET: SB TRAFFIC REDUCED TO ONE LANE.

12TH AVENUE: WB TRAFFIC REDUCED TO ONE LANE USING STANDARD 701611 AND BOTH LANES SHIFTED USING DISTRICT STANDARD 39.1.

STAGE 2-2 CONSTRUCTION:

19TH STREET: CONSTRUCT PROPOSED PIERS, RETAINING WALLS, DRAINAGE AND TEMPORARY PAVEMENT TO THE LIMITS SHOWN IN THE STAGING PLAN SHEETS AND STRUCTURAL PLAN SHEETS.

SB 19TH STREET: CONSTRUCT PROPOSED PIERS. RETAINING WALLS AND DRAINAGE TO THE LIMITS SHOWN IN THE STAGING PLAN SHEETS AND STRUCTURAL PLAN SHEETS.

12TH AVENUE: CONSTRUCT PROPOSED PIERS, RETAINING WALLS, DRAINAGE AND SIDEWALK TO THE LIMITS SHOWN IN THE STAGING PLAN SHEETS AND STRUCTURAL PLAN SHEETS.

STAGE 2-2 TRAFFIC PATTERNS:

19TH STREET: NB 19TH ST. TRAFFIC TO PROVIDE 2 OPEN LANES DURING I-74 DETOUR STAGES. SB TRAFFIC REDUCED TO ONE LANE USING STANDARD 701601 AND BOTH DIRECTIONS SHIFTED DURING BRIDGE CONSTRUCTION USING DISTRICT STANDARD 39.1. SEE STRUCTURAL PLAN SHEETS AND SCHEDULE FOR BRIDGE DETAILS

SB 19TH STREET: SB TRAFFIC REDUCED TO ONE LANE AND SHIFTED USING DISTRICT STANDARD 39.1.

12TH AVENUE: WB TRAFFIC REDUCED TO ONE LANE USING STANDARD 701606 AND BOTH LANES SHIFTED.

STAGE 2-3 CONSTRUCTION:

19TH STREET: CONSTRUCT PROPOSED WB I-74 MAINLINE BRIDGE DECK OVER 19TH ST. AND DRAINAGE TO THE LIMITS SHOWN IN THE STAGING PLAN SHEETS AND STRUCTURAL PLAN SHEETS.

STAGE 2-3 TRAFFIC PATTERNS:

19TH STREET: NB 19TH ST. TRAFFIC TO PROVIDE 2 OPEN LANES DURING I-74 DETOUR STAGES. SB TRAFFIC REDUCED TO ONE LANE USING STANDARD 701601 AND NB LANES SHIFTED DURING BRIDGE CONSTRUCTION USING DISTRICT STANDARD 39.1. SEE STRUCTURAL PLAN SHEETS AND SCHEDULE FOR BRIDGE DETAILS.

WINTER STAGE TRAFFIC PATTERNS:

19TH STREET: TRAFFIC PATTERN FROM STAGE 2-3 TO REMAIN THRU WINTER STAGE USING STANDARD 701601 AND DISTRICT STANDARD 39.1.

STAGE 3-0 CONSTRUCTION:

19TH STREET: CONSTRUCT EARTHWORK, PROPOSED SIDEWALK, DRAINAGE AND TEMPORARY PAVEMENT TO THE LIMITS SHOWN IN THE STAGING PLAN SHEETS.

STAGE 3-0 TRAFFIC PATTERNS:

19TH STREET: SB TRAFFIC REDUCED TO ONE LANE USING STANDARD 701601 AND NB TRAFFIC SHIFTED USNG DISTRICT STANDARD 39.1 DURING ROAD AND BRIDGE CONSTRUCTION. SEE STRUCTURAL PLAN SHEETS AND SCHEDULE FOR BRIDGE DETAILS.

STAGE 3-1 CONSTRUCTION:

19TH STREET: CONSTRUCT PROPOSED PIERS AND TEMPORARY PAVEMENT TO THE LIMITS SHOWN IN THE STAGING PLAN SHEETS AND STRUCTURAL PLAN

SB 19TH STREET: CONSTRUCT PROPOSED PIERS. RETAINING WALLS AND DRAINAGE TO THE LIMITS SHOWN IN THE STAGING PLAN SHEETS AND STRUCTURAL PLAN SHEETS.

12TH AVENUE: CONSTRUCT PROPOSED PIERS, RETAINING WALLS AND DRAINAGE TO THE LIMITS SHOWN IN THE STAGING PLAN SHEETS AND STRUCTURAL PLAN SHEETS.

STAGE 3-1 TRAFFIC PATTERNS:

19TH STREET: NB TRAFFIC REDUCED TO ONE LANE USING DISTRICT STANDARD 35.1 AND SB TRAFFIC REDUCED TO ONE LANE USING DISTRICT STANDARD 35.1 DURING ROAD AND BRIDGE CONSTRUCTION. SEE STRUCTURAL PLAN SHEETS AND SCHEDULE FOR BRIDGE DETAILS.

SB 19TH STREET: SB TRAFFIC REDUCED TO ONE LANE.

12TH AVENUE: WB TRAFFIC REDUCED TO ONE LANE USING STANDARD 701611 AND BOTH LANES SHIFTED USING DISTRICT STANDARD 39.1.

STAGE 3-2 CONSTRUCTION:

19TH STREET: CONSTRUCT SB EARTHWORK, DRAINAGE, PERMANENT PAVEMENT, PROPOSED PIERS, RETAINING WALLS AND TEMPORARY PAVEMENT TO THE LIMITS SHOWN IN THE STAGING PLAN SHEETS AND STRUCTURAL PLAN SHEETS.

SB 19TH STREET: CONSTRUCT PROPOSED PIERS, RETAINING WALLS AND DRAINAGE TO THE LIMITS SHOWN IN THE STAGING PLAN SHEETS AND STRUCTURAL PLAN SHEETS.

12TH AVENUE: CONSTRUCT PROPOSED PIERS, RETAINING WALLS AND DRAINAGE TO THE LIMITS SHOWN IN THE STAGING PLAN SHEETS AND STRUCTURAL PLAN

RAMP 7TH-B: CONSTRUCT UP TO STA 523+00 THIS STAGE.

STAGE 3-2 TRAFFIC PATTERNS:

19TH STREET: NB AND SB TRAFFIC REDUCED TO ONE LANE AND BOTH DIRECTIONS SHIFTED DURING ROAD AND BRIDGE CONSTRUCTION USING STANDARD 701611 AND DISTRICT STANDARD 39.1. SEE STRUCTURAL PLAN SHEETS AND SCHEDULE FOR BRIDGE DETAILS.

SB 19TH STREET: SB TRAFFIC REDUCED TO ONE LANE AND SHIFTED USING DISTRICT STANDARD 39.1.

12TH AVENUE: WB TRAFFIC REDUCED TO ONE LANE USING STANDARD 701606.

STAGE 3-3 CONSTRUCTION:

19TH STREET: CONSTRUCT NB EARTHWORK, DRAINAGE, SIDEWALK, PERMANENT PAVEMENT, PROPOSED PIERS, RETAINING WALLS AND TEMPORARY PAVEMENT TO THE LIMITS SHOWN IN THE STAGING PLAN SHEETS AND STRUCTURAL PLAN SHEETS

11TH AVE A: CONSTRUCT PERMANENT PAVEMENT TO THE LIMITS SHOWN IN THE STAGING AND ROADWAY PLAN SHEETS

12TH AVENUE: MILL AND RESURFACE PAVEMENT TO THE LIMITS SHOWN IN THE STAGING PLAN SHEETS.

STAGE 3-4 CONSTRUCTION

19TH STREET: CONSTRUCT PROPOSED EB I-74 MAINLINE BRIDGE DECK OVER 19TH ST., CONSTRUCT 19TH ST. EARTHWORK, DRAINAGE AND PROPOSED MEDIANS AND REMOVE EXISTING SIDEWALK TO THE LIMITS SHOWN IN THE STAGING PLAN SHEETS.

STAGE 3-4 TRAFFIC PATTERNS:

19TH STREET: SB TRAFFIC REDUCED TO ONE LANE USING STANDARD 701601 AND NB TRAFFIC REDUCED TO ONE LANE USING DISTRICT STANDARD 35.1 DURING MEDIAN AND BRIDGE CONSTRUCTION. SEE STRUCTURAL PLAN SHEETS AND SCHEDULE FOR BRIDGE DETAILS.

STAGE 3-4A CONSTRUCTION:

19TH STREET: REMOVE EXISTING SIDEWALK AND CONSTRUCT EARTHWORK TO THE LIMITS SHOWN IN THE STAGING PLAN SHEETS.

STAGE 3-4A TRAFFIC PATTERNS:

19TH STREET: SB TRAFFIC REDUCED TO ONE LANE DURING SIDEWALK REMOVAL AND GRADING OPERATIONS USING STANDARD 701606 DURING WORK HOURS.

FILE NAME = D2CONCD-HPS-sht-staging702M.dgn

DESIGNED - MGJ USER NAME = hehn@1663 REVISED DRAWN CBP REVISED CHECKED MTH REVISED PLOT DATE = 3/22/2017 REVISED DATE 3/23/2017

STATE OF ILLINOIS **DEPARTMENT OF TRANSPORTATION**

SCALE:

STAGING PLAN SECTION COUNTY CONSTRUCTION SEQUENCING NOTES 74 (81-1)R-1 & 81-1(HBR, HBR-1, HBR-2) ROCK ISLAND 2042 209 CONTRACT NO. 64E26 SHEET NO. OF SHEETS STA. TO STA.

MOT-005



LEGEND

WORK ZONE

WORK ZONE SEPARATE CONTRACT

COMPLETED CONSTRUCTION

FILE NAME = ...\D2CONCD-ABC-sht-staging201-1.dgn \$MODELNAME\$

USER NAME = jtardy DESIGNED - SJP REVISED -DRAWN - SJP REVISED PLOT SCALE = 1" = 50" CHECKED - JJT REVISED PLOT DATE = 3/23/2017 - 3/23/2017 REVISED

STATE OF ILLINOIS DEPARTMENT OF TRANSPORTATION

STAGING PLAN
STAGING OVERVIEW
STAGE 1-1
OF SHEETS STA. 81+00 SCALE: 1" = 50' SHEET NO.

TO STA. 155+00








ASPHALT RESURFACING (ONLY NEXT TO TEMPORARY PAVEMENT)—
HOT-MIX ASPHALT SURFACE REMOVAL, 2 1/4"
1 1/4" POLYMERIZED HOT-MIX ASPHALT SURFACE COURSE, MIX "E", N90

1" POLYMERIZED LEVELING BINDER (MACHINE METHOD), N90

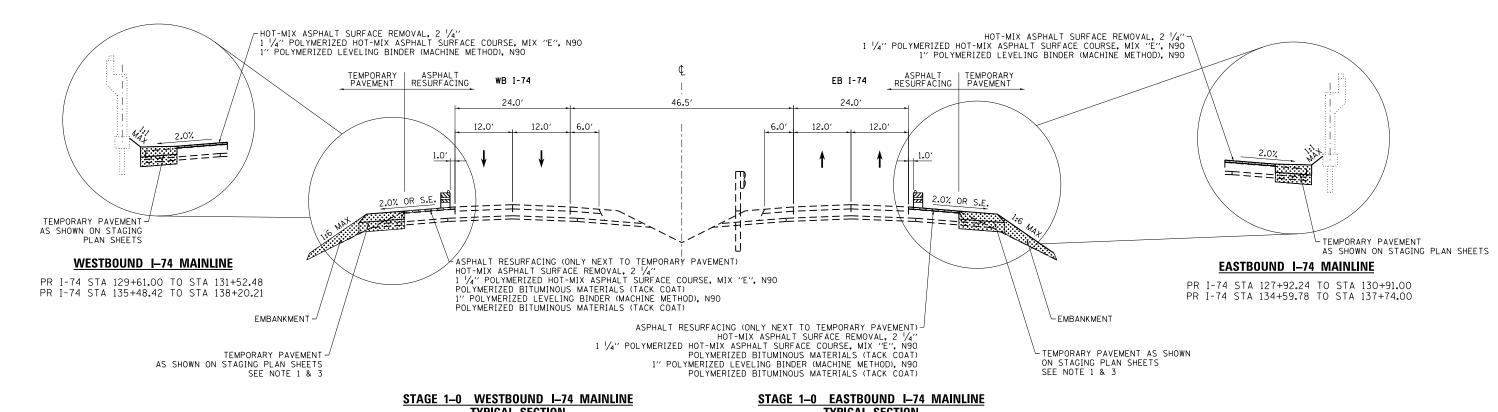


TYPICAL SECTION

PR I-74 STA 115+00.00 TO STA 123+01.38 PR I-74 STA 127+01.05 TO STA 156+05.44

TYPICAL SECTION

PR I-74 STA 114+00.00 TO STA 117+32.35 PR I-74 STA 116+00.00 TO STA 159+00.00

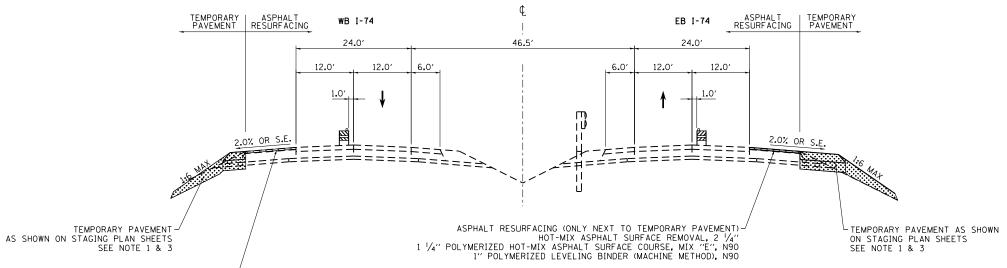

STAGE 1-0 NIGHTIME LANE CLOSURE

PR I-74 STA 115+00.00 TO STA 123+01.38 PR I-74 STA 127+01.05 TO STA 156+05.44

STAGE 1-0 WESTBOUND I-74 MAINLINE

TYPICAL SECTION

STAGE 1-0 EASTBOUND I-74 MAINLINE **TYPICAL SECTION**

PR I-74 STA 114+00.00 TO STA 117+32.35 PR I-74 STA 123+34.36 TO STA 159+00.00

LEGEND:

WORK ZONE

COMPLETED CONSTRUCTION (PREVIOUS STAGE WORK ZONE)

TEMPORARY PAVEMENT (SEE NOTE 1)

DIRECTION OF TRAFFIC

DRUM OR BARRICADE W/ STEADY BURN LIGHT CONCRETE BARRIER


VERTICAL PANEL

- SEE CONTRACT SPECIAL PROVISIONS FOR TEMPORARY PAVEMENT DESIGN DETAILS.
- 2. SEE MOT STAGING SHEETS FOR TEMPORARY CONCRETE BARRIER PINNING AND PLACEMENT LOCATIONS. (SEE IDOT STANDARD 704001 FOR ANCHORING DETAILS)
- 3. THE CONTRACTOR SHALL NOT LEAVE ANY DROP-OFF GREATER THAN 12" OVERNIGHT OR WHEN WORKERS ARE NOT PRESENT. EXCAVATION OPERATIONS SHALL BE PLANNED SUCH THAT DROP-OFFS ARE IMMEDIATELY BACKFILLED TO WITHIN 12" OF THE PAVEMENT SURFACE OR A 1:4 COMPACTED AGGREGATE WEDGE SHALL BE PLACED ADJACENT TO THE EDGE OF TRAVELED WAY WITHIN THIS WORK ZONE (COST SHALL BE INCIDENTAL TO THE TRAFFIC CONTROL AND PROTECTION PAY ITEM).

						MOT-010
FILE NAME =	USER NAME = jtardy	DESIGNED - SJP	REVISED -		STAGING PLAN	F.A.I SECTION COUNTY SHEET NO
\D2CONCD-ABC-sht-Staging101.dgn		DRAWN - SJP	REVISED -	STATE OF ILLINOIS	STAGING TYPICAL SECTIONS - 1-74 MAINLINE	74 (81-1)R-1 & 81-1(HRR, HBR-1, HBR-2) ROCK ISLAND 2042 214
	PLOT SCALE = 1" = 50"	CHECKED - JJT	REVISED -	DEPARTMENT OF TRANSPORTATION	STAGE 1-0	CONTRACT NO. 64E26
\$MODELNAME\$	PLOT DATE = 3/23/2017	DATE - 3/23/2017	REVISED -		SCALE: 1" = 50' SHEET NO. OF SHEETS STA. 81+00 TO STA. 155+00	ILLINOIS FED. AID PROJECT





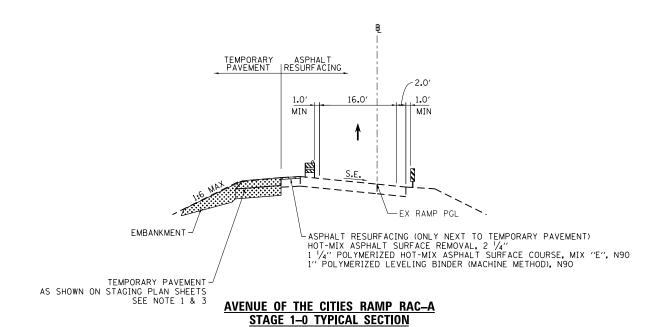

PR RAMP RAC-A STA 1018+90.65 TO STA 1023+05.41

TEMPORARY PAVEMENT

1.0'

1.0'

NIN

2.0%


RAMP PGL

TEMPORARY PAVEMENT

AS SHOWN ON STAGING PLAN SHEETS
SEE NOTE 1 & 3


AVENUE OF THE CITIES RAMP RAC-C STAGE 1-0 TYPICAL SECTION

PR RAMP RAC-C STA 734+18.25 TO STA 739+72.71

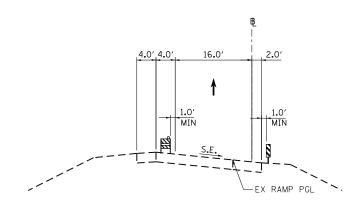

AVENUE OF THE CITIES RAMP RAC-B STAGE 1-0 TYPICAL SECTION

PR RAMP RAC-B STA 925+16.07 TO STA 930+09.32

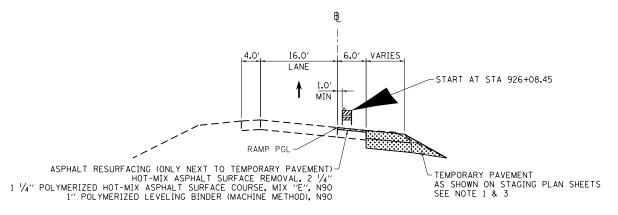

AVENUE OF THE CITIES RAMP RAC-B STAGE 1-0A TYPICAL SECTION

PR RAMP RAC-B STA 927+09.07 TO STA 934+68.45

LEGEND:

WORK ZONE

COMPLETED CONSTRUCTION
(PREVIOUS STAGE WORK ZONE)

TEMPORARY PAVEMENT (SEE NOTE 1)

DRUM OR BARRICADE W/ STEADY BURN LIGHT

CONCRETE BARRIER

VERTICAL PANEL


VERTICAL FAR

NOTES

- SEE CONTRACT SPECIAL PROVISIONS FOR TEMPORARY PAVEMENT DESIGN DETAILS.
- 2. SEE MOT STAGING SHEETS FOR TEMPORARY CONCRETE BARRIER PINNING AND PLACEMENT LOCATIONS. (SEE IDOT STANDARD 704001 FOR ANCHORING DETAILS)
- 3. THE CONTRACTOR SHALL NOT LEAVE ANY DROP-OFF GREATER THAN 12" OVERNIGHT OR WHEN WORKERS ARE NOT PRESENT. EXCAVATION OPERATIONS SHALL BE PLANNED SUCH THAT DROP-OFFS ARE IMMEDIATELY BACKFILLED TO WITHIN 12" OF THE PAVEMENT SURFACE OR A 1:4 COMPACTED AGGREGATE WEDGE SHALL BE PLACED ADJACENT TO THE EDGE OF TRAVELED WAY WITHIN THIS WORK ZONE (COST SHALL BE INCIDENTAL TO THE TRAFFIC CONTROL AND PROTECTION PAY ITEM).


STAGING PLAN USER NAME = jtardy DESIGNED - SJP FILE NAME = REVISED SECTION COUNTY ..\D2CONCD-ABC-sht-Staging102.dgn DRAWN SJIP REVISED STATE OF ILLINOIS STAGING TYPICAL SECTIONS - I-74 RAMPS 74 (81-1)R-1 & 81-1(HBR, HBR-1, HBR-2) ROCK ISLAND 2042 215 SCALE: 1" = 50" | SHEET NO. | OF | SHEETS | STA. 81+00 PLOT SCALE = 1" = 50" CHECKED JJT REVISED **DEPARTMENT OF TRANSPORTATION** CONTRACT NO. 64E26 \$MODELNAME\$ PLOT DATE = 3/23/2017 TO STA. 155+00 3/23/2017 REVISED



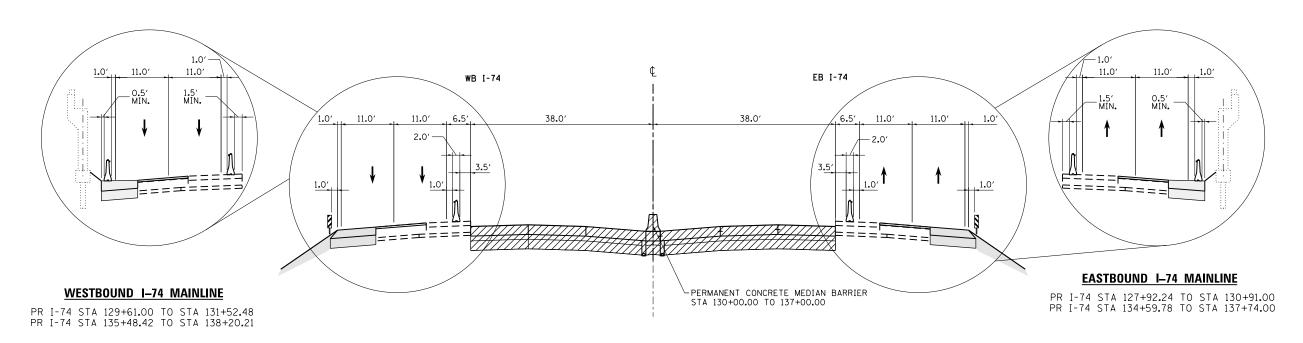

STAGE 1–1 I–74 MAINLINE TYPICAL SECTION

PR I-74 STA 122+00.00 TO STA 138+36.24

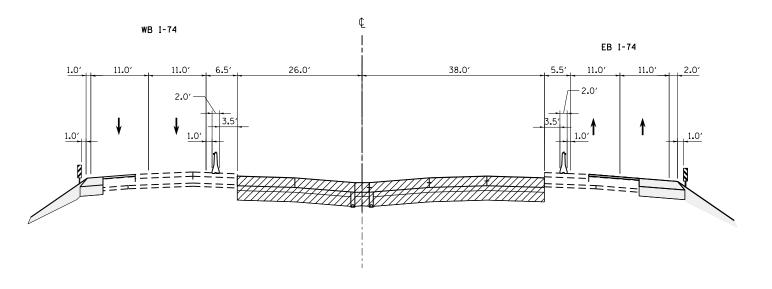

STAGE 1–1 I–74 MAINLINE TYPICAL SECTION

PR I-74 STA 138+36.24 TO STA 155+00.00

LEGEND:

WORK ZONE

COMPLETED CONSTRUCTION (PREVIOUS STAGE WORK ZONE)

TEMPORARY PAVEMENT (SEE NOTE 1)

DIRECTION OF TRAFFIC

DRUM OR BARRICADE W/ STEADY BURN LIGHT


MOT-012

VERTICAL PANEL

CONCRETE BARRIER


- 1. SEE CONTRACT SPECIAL PROVISIONS FOR TEMPORARY PAVEMENT DESIGN DETAILS.
- 2. SEE MOT STAGING SHEETS FOR TEMPORARY CONCRETE BARRIER PINNING AND PLACEMENT LOCATIONS. (SEE IDOT STANDARD 704001 FOR ANCHORING DETAILS)

FILE NAME =	USER NAME = jtardy	DESIGNED - SJP	REVISED -		STAGING PLAN	F.A.I SECTION	COUNTY TOTAL SHEET SHEETS NO.
\D2CONCD-ABC-sht-Staginglll.dgn		DRAWN - SJP	REVISED -	STATE OF ILLINOIS	STAGING TYPICAL SECTIONS - 1-74 MAINLINE	74 (81-1)R-1 & 81-1(HBR, HBR-1, HBR-2)	ROCK ISLAND 2042 216
	PLOT SCALE = 1" = 50"	CHECKED - JJT	REVISED -	DEPARTMENT OF TRANSPORTATION	STAGE 1–1		CONTRACT NO. 64E26
\$MODELNAME\$	PLOT DATE = 3/23/2017	DATE - 3/23/2017	REVISED -		SCALE: 1" = 50' SHEET NO. OF SHEETS STA. TO STA.	ILLINOIS FED. A	ID PROJECT

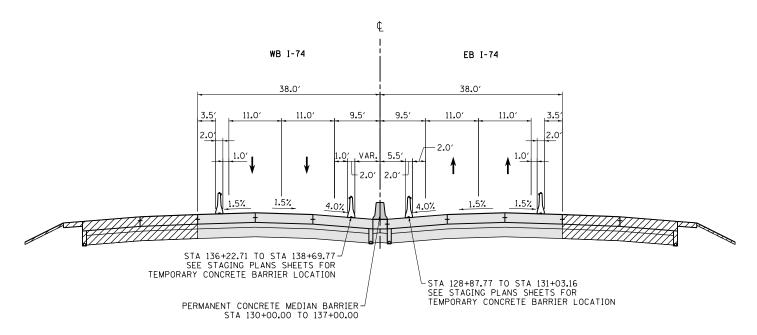

STAGE 1-2 & STAGE 1-3 I-74 MAINLINE TYPICAL SECTION

PR I-74 STA 122+00.00 TO STA 141+16.88

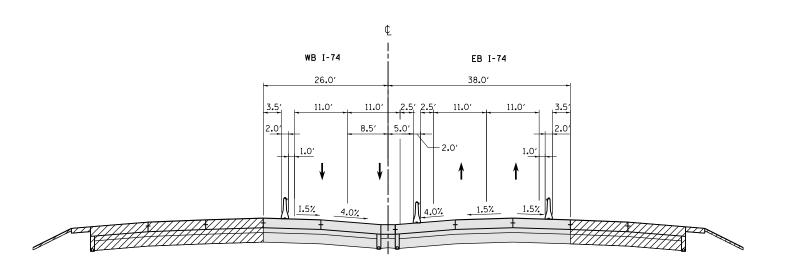

STAGE 1-2 & STAGE 1-3 I-74 MAINLINE TYPICAL SECTION

PR I-74 STA 138+36.27 TO STA 155+00.00

LEGEND:

WORK ZONE

COMPLETED CONSTRUCTION (PREVIOUS STAGE WORK ZONE)



TEMPORARY PAVEMENT (SEE NOTE 1)



DIRECTION OF TRAFFIC

DRUM OR BARRICADE W/ STEADY BURN LIGHT


MOT-013

VERTICAL PANEL

CONCRETE BARRIER


- 1. SEE CONTRACT SPECIAL PROVISIONS FOR TEMPORARY PAVEMENT DESIGN DETAILS.
- 2. SEE MOT STAGING SHEETS FOR TEMPORARY CONCRETE BARRIER PINNING AND PLACEMENT LOCATIONS. (SEE IDOT STANDARD 704001 FOR ANCHORING DETAILS)

FILE NAME =	USER NAME = jtardy	DESIGNED - SJP	REVISED -		STAGING PLAN	F.A.I SECTION	COUNTY TOTAL SHEET
\D2CONCD-ABC-sht-Staging112.dgn		DRAWN - SJP	REVISED -	STATE OF ILLINOIS	STAGING TYPICAL SECTIONS - 1-74 MAINLINE	74 (81-1)R-1 & 81-1(HRR, HBR-1, HBR-2)	ROCK ISLAND 2042 217
	PLOT SCALE = 1" = 50"	CHECKED - JJT	REVISED -	DEPARTMENT OF TRANSPORTATION	STAGE 1-2 & STAGE 1-3		CONTRACT NO. 64E26
\$MODELNAME\$	PLOT DATE = 3/23/2017	DATE - 3/23/2017	REVISED -		SCALE: 1" = 50" SHEET NO. OF SHEETS STA. TO STA.	THE INDIS FED. A	ND PROJECT

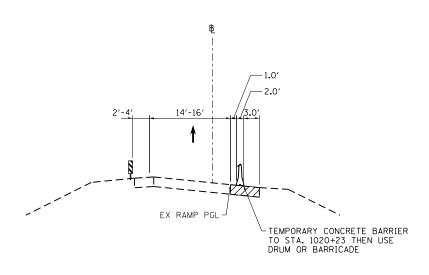


AVENUE OF THE CITIES RAMP RAC-A STAGE 1-1 TYPICAL SECTION

PR RAMP RAC-A STA 1015+36.50 TO STA 1023+05.41

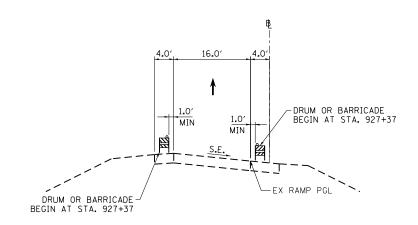


AVENUE OF THE CITIES RAMP RAC-B STAGE 1-2 TYPICAL SECTION

PR RAMP RAC-B STA 925+16.07 TO STA 930+09.32

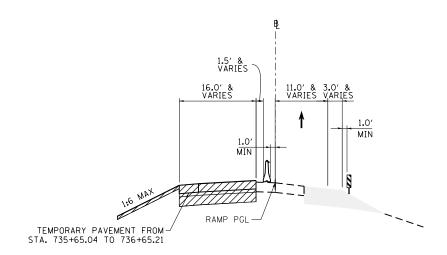

AVENUE OF THE CITIES RAMP RAC-C STAGE 1-1 TYPICAL SECTION

PR RAMP RAC-C STA 735+65.04 TO STA 737+85.25

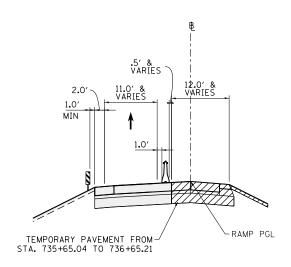

AVENUE OF THE CITIES RAMP RAC-C STAGE 1-2 TYPICAL SECTION

PR RAMP RAC-C STA 735+65.04 TO STA 737+85.25

LEGEND:

	WORK ZONE
	COMPLETED CONSTRUCTION (PREVIOUS STAGE WORK ZONE)
	TEMPORARY PAVEMENT (SEE NOTE 1)
†	DIRECTION OF TRAFFIC
	DRUM OR BARRICADE W/ STEADY BURN LIGHT
1	CONCRETE BARRIER
Ş	VERTICAL PANEL


NOTES

- 1. SEE CONTRACT SPECIAL PROVISIONS FOR TEMPORARY PAVEMENT DESIGN DETAILS.
- 2. SEE MOT STAGING SHEETS FOR TEMPORARY CONCRETE BARRIER PINNING AND PLACEMENT LOCATIONS. (SEE IDOT STANDARD 704001 FOR ANCHORING DETAILS)
- 3. THE CONTRACTOR SHALL NOT LEAVE ANY DROP-OFF GREATER THAN 12" OVERNIGHT OR WHEN WORKERS ARE NOT PRESENT. EXCAVATION OPERATIONS SHALL BE PLANNED SUCH THAT DROP-OFFS ARE IMMEDIATELY BACKFILLED TO WITHIN 12" OF THE PAVEMENT SURFACE OR A 1:4 COMPACTED AGGREGATE WEDGE SHALL BE PLACED ADJACENT TO THE EDGE OF TRAVELED WAY WITHIN THIS WORK ZONE (COST SHALL BE INCIDENTAL TO THE TRAFFIC CONTROL AND PROTECTION PAY ITEM).

STAGING PLAN USER NAME = jtardy DESIGNED FILE NAME = REVISED SECTION COUNTY STATE OF ILLINOIS DRAWN REVISED STAGING TYPICAL SECTIONS - 1-74 MAINLINE 74 (81-1)R-1 & 81-1(HBR, HBR-1, HBR-2) ROCK ISLAND 2042 218 STAGE 1-2 & STAGE 1-3
SHEET NO. OF SHEETS STA. PLOT SCALE = CHECKED REVISED **DEPARTMENT OF TRANSPORTATION** CONTRACT NO. 64E26 \$MODELNAME\$ PLOT DATE = 3/23/2017 DATE SHEETS STA.

..\D2CONCD-ABC-sht-Staging112A.dgn

- 3/23/2017 REVISED

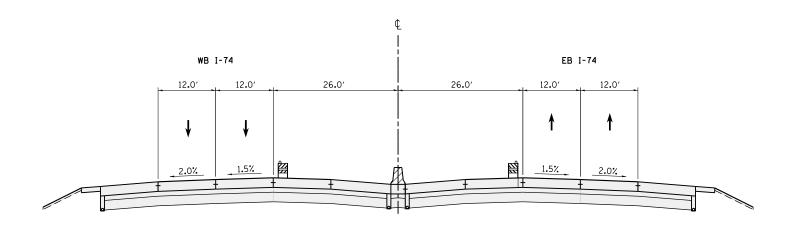

YEAR 1-4 I-74 MAINLINE TYPICAL SECTION

PR I-74 STA 137+00 TO STA 155+00.00

LEGEND:

WORK ZONE

COMPLETED CONSTRUCTION (PREVIOUS STAGE WORK ZONE)

TEMPORARY PAVEMENT (SEE NOTE 1)

DIRECTION OF TRAFFIC


DRUM OR BARRICADE W/ STEADY BURN LIGHT

CONCRETE BARRIER

VERTICAL PANEL

- 1. SEE CONTRACT SPECIAL PROVISIONS FOR TEMPORARY PAVEMENT DESIGN DETAILS.
- 2. SEE MOT STAGING SHEETS FOR TEMPORARY CONCRETE BARRIER PINNING AND PLACEMENT LOCATIONS.
 (SEE IDOT STANDARD 704001 FOR ANCHORING DETAILS)

						MOT-015
FILE NAME =	USER NAME = jtardy	DESIGNED - SJP	REVISED -		STAGING PLAN	F.A.I SECTION COUNTY SHEETS NO
\D2CONCD-ABC-sht-Staging113.dgn		DRAWN - SJP	REVISED -	STATE OF ILLINOIS	STAGING TYPICAL SECTIONS - 1-74 MAINLINE	74 (81-1)R-1 & 81-1(HBR, HBR-1, HBR-2) ROCK ISLAND 2042 219
	PLOT SCALE = 1" = 50"	CHECKED - JJT	REVISED -	DEPARTMENT OF TRANSPORTATION	STAGE 1–4	CONTRACT NO. 64E26
#MODEL NAME#	0.07.0.75.0.00.000.7	0.175 7.07.0017	DEVICED		CONF. 14 FOU CUEFT NO. OF CUEFTS CTA. TO CTA	

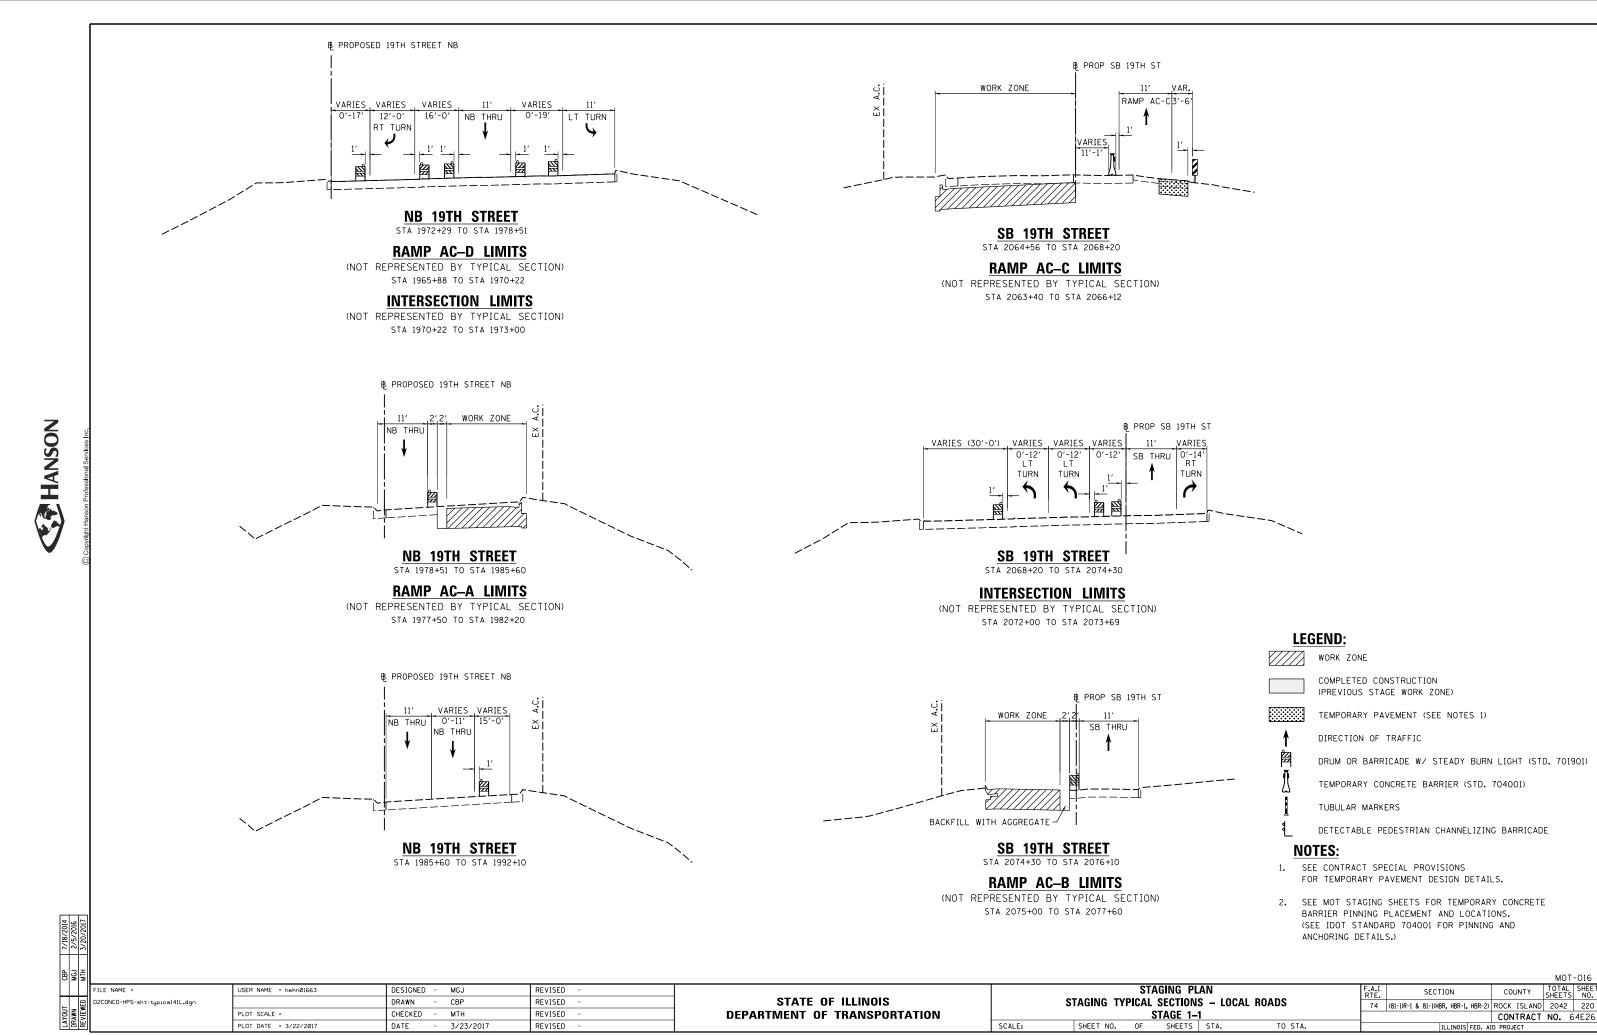

COUNTY

CONTRACT NO. 64E26



USER NAME = hehn@1663 DESIGNED - MGJ REVISED D2CONCD-HPS-sht-typical44L.dgn DRAWN CBP REVISED CHECKED мтн REVISED PLOT DATE = 3/22/2017 DATE REVISED 3/23/2017

STATE OF ILLINOIS **DEPARTMENT OF TRANSPORTATION**

STAGING PLAN STAGING TYPICAL SECTIONS - LOCAL ROADS STAGE 1-1A

OF SHEETS STA.


SECTION COUNTY 74 (81-1)R-1 & 81-1(HBR, HBR-1, HBR-2) ROCK ISLAND 2042 221 CONTRACT NO. 64E26

BE PROP SB 19TH ST WORK ZONE SB THRU HOLE BACKFILLED WITH AGGREGATE AFTER STAGE 1-1

SB 19TH STREET STA 2074+30 TO STA 2076+10

RAMP AC-B LIMITS

(NOT REPRESENTED BY TYPICAL SECTION) STA 2075+00 TO STA 2077+60

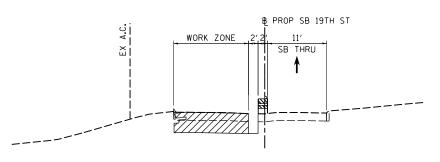

SB 19TH STREET STA 2076+10 TO STA 2078+00

RAMP AC-B LIMITS

(NOT REPRESENTED BY TYPICAL SECTION) STA 2075+00 TO STA 2077+60

LEGEND:

WORK ZONE

COMPLETED CONSTRUCTION

(PREVIOUS STAGE WORK ZONE)

TEMPORARY PAVEMENT (SEE NOTES 1) DIRECTION OF TRAFFIC

DRUM OR BARRICADE W/ STEADY BURN LIGHT (STD. 701901)

TEMPORARY CONCRETE BARRIER (STD. 704001)

TUBULAR MARKERS

DETECTABLE PEDESTRIAN CHANNELIZING BARRICADE

NOTES:

- 1. SEE CONTRACT SPECIAL PROVISIONS FOR TEMPORARY PAVEMENT DESIGN DETAILS.
- 2. SEE MOT STAGING SHEETS FOR TEMPORARY CONCRETE BARRIER PINNING PLACEMENT AND LOCATIONS. (SEE IDOT STANDARD 704001 FOR PINNING AND ANCHORING DETAILS.)

TO STA.

DEPARTMENT OF TRANSPORTATION

STAGE 1-2
OF SHEETS STA.

TO STA.

SHEET NO.

SCALE:

CONTRACT NO. 64E26

HANSON

CHECKED

DATE

PLOT DATE = 3/22/2017


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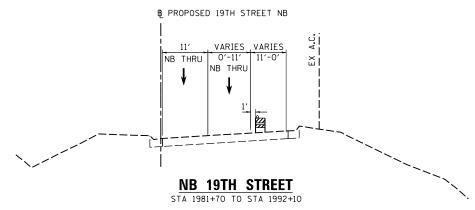
3/23/2017

REVISED

REVISED





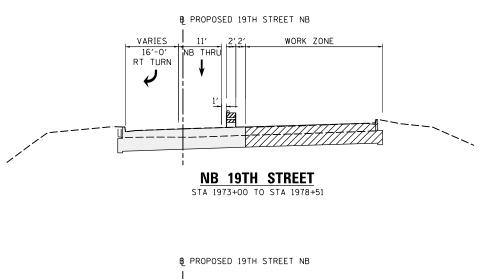

LEGEND:

WORK ZONE

COMPLETED CONSTRUCTION (PREVIOUS STAGE WORK ZONE)

TEMPORARY PAVEMENT (SEE NOTES 1)

DIRECTION OF TRAFFIC

TUBULAR MARKERS

DRUM OR BARRICADE W/ STEADY BURN LIGHT (STD. 701901)


TEMPORARY CONCRETE BARRIER (STD. 704001)


DETECTABLE PEDESTRIAN CHANNELIZING BARRICADE


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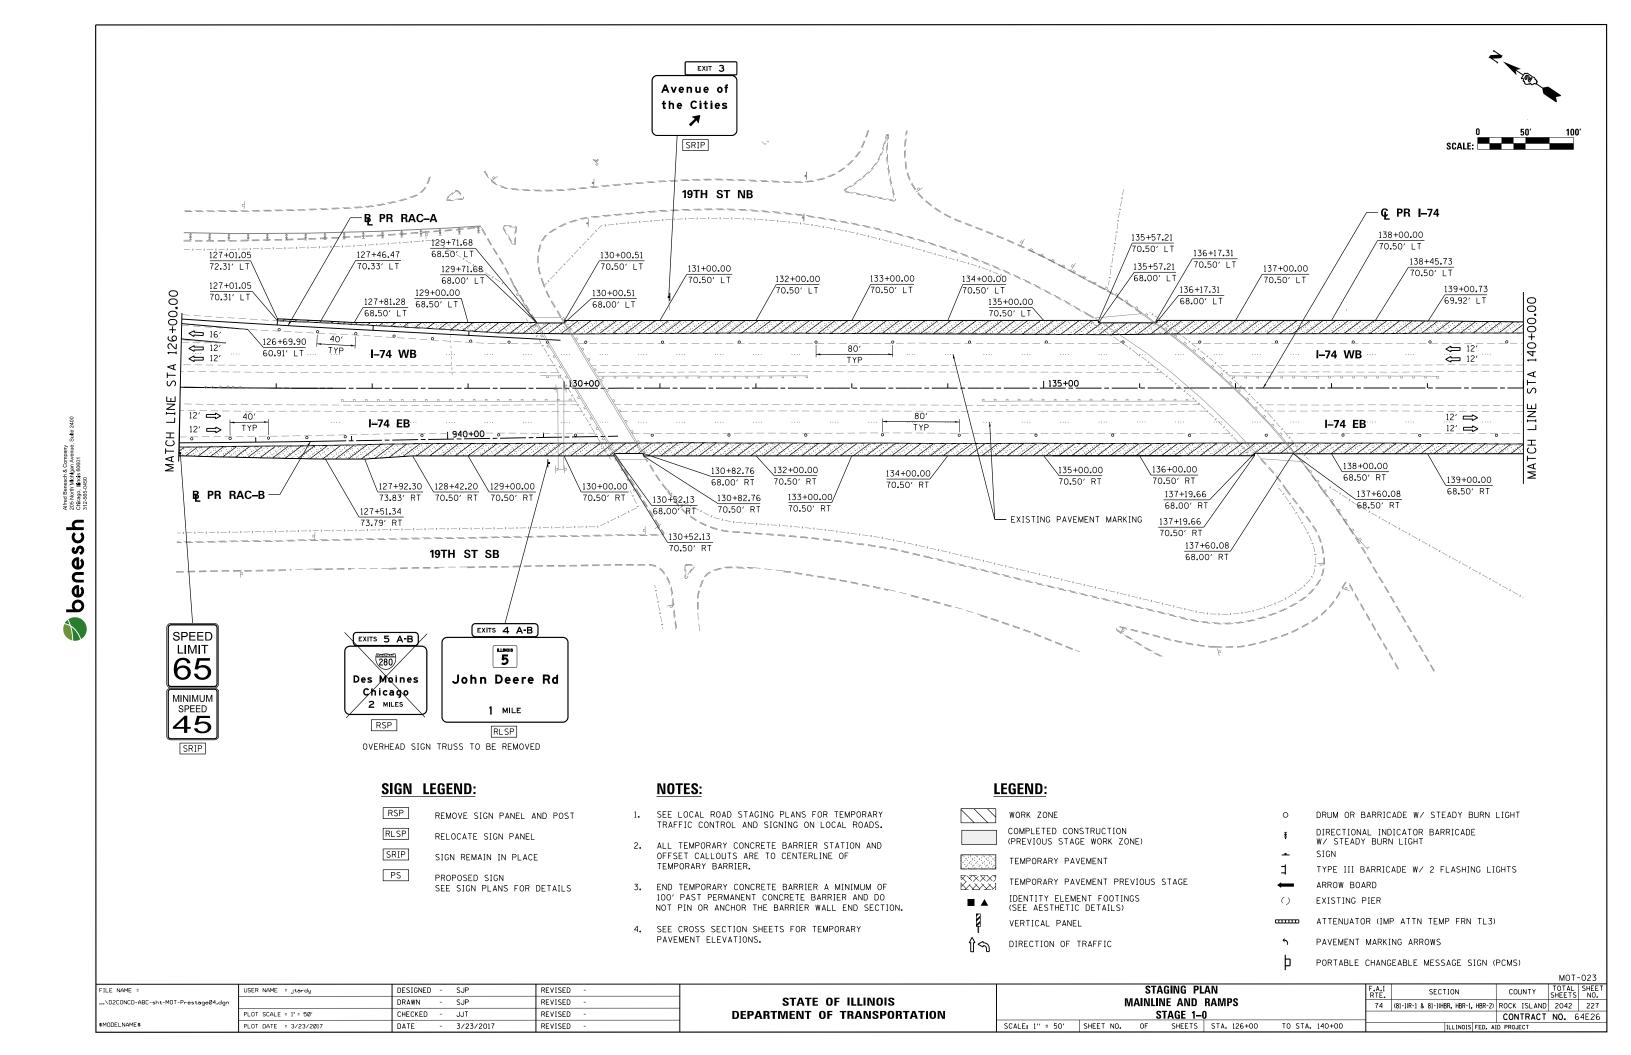
- 1. SEE CONTRACT SPECIAL PROVISIONS FOR TEMPORARY PAVEMENT DESIGN DETAILS.
- 2. SEE MOT STAGING SHEETS FOR TEMPORARY CONCRETE BARRIER PINNING PLACEMENT AND LOCATIONS. (SEE IDOT STANDARD 704001 FOR PINNING AND ANCHORING DETAILS.)


STAGING PLAN USER NAME = hehn@1663 DESIGNED - MGJ REVISED SECTION COUNTY STATE OF ILLINOIS STAGING TYPICAL SECTIONS - LOCAL ROADS D2CONCD-HPS-sht-typical47L.dgn DRAWN CBP REVISED 74 (81-1)R-1 & 81-1(HBR, HBR-1, HBR-2) ROCK ISLAND 2042 223 STAGE 1-3
OF SHEETS STA. CHECKED мтн REVISED **DEPARTMENT OF TRANSPORTATION** CONTRACT NO. 64E26 SCALE: TO STA. PLOT DATE = 3/22/2017 DATE REVISED 3/23/2017



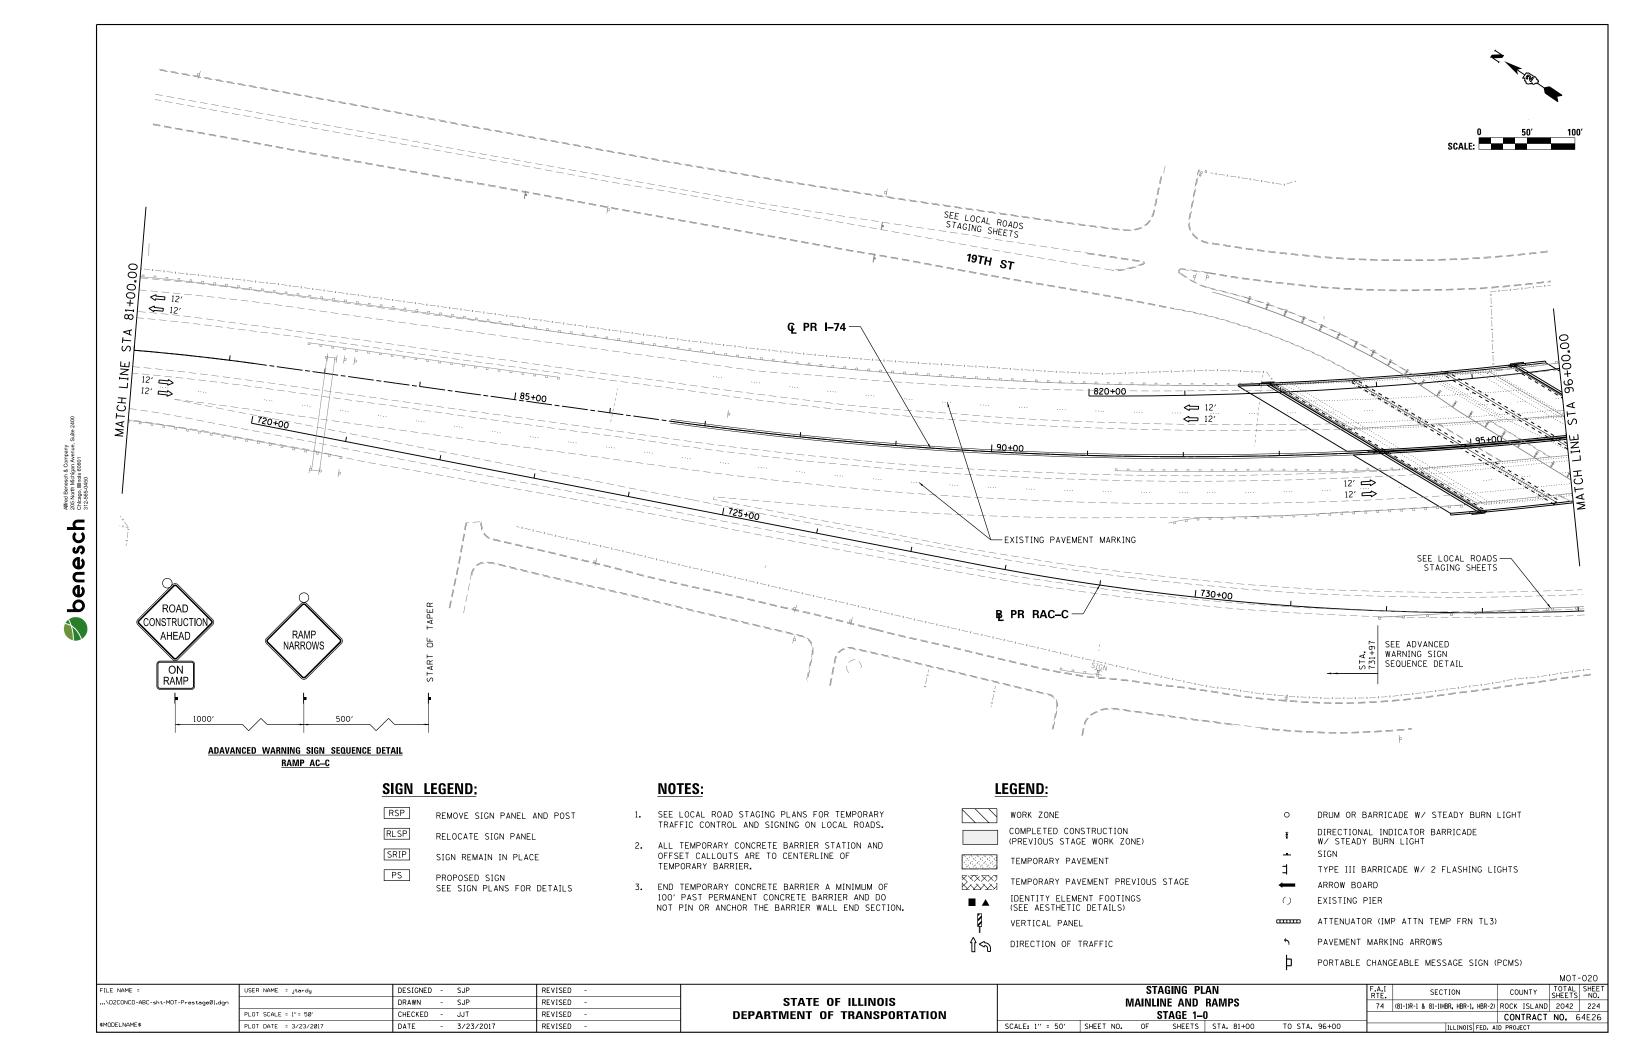


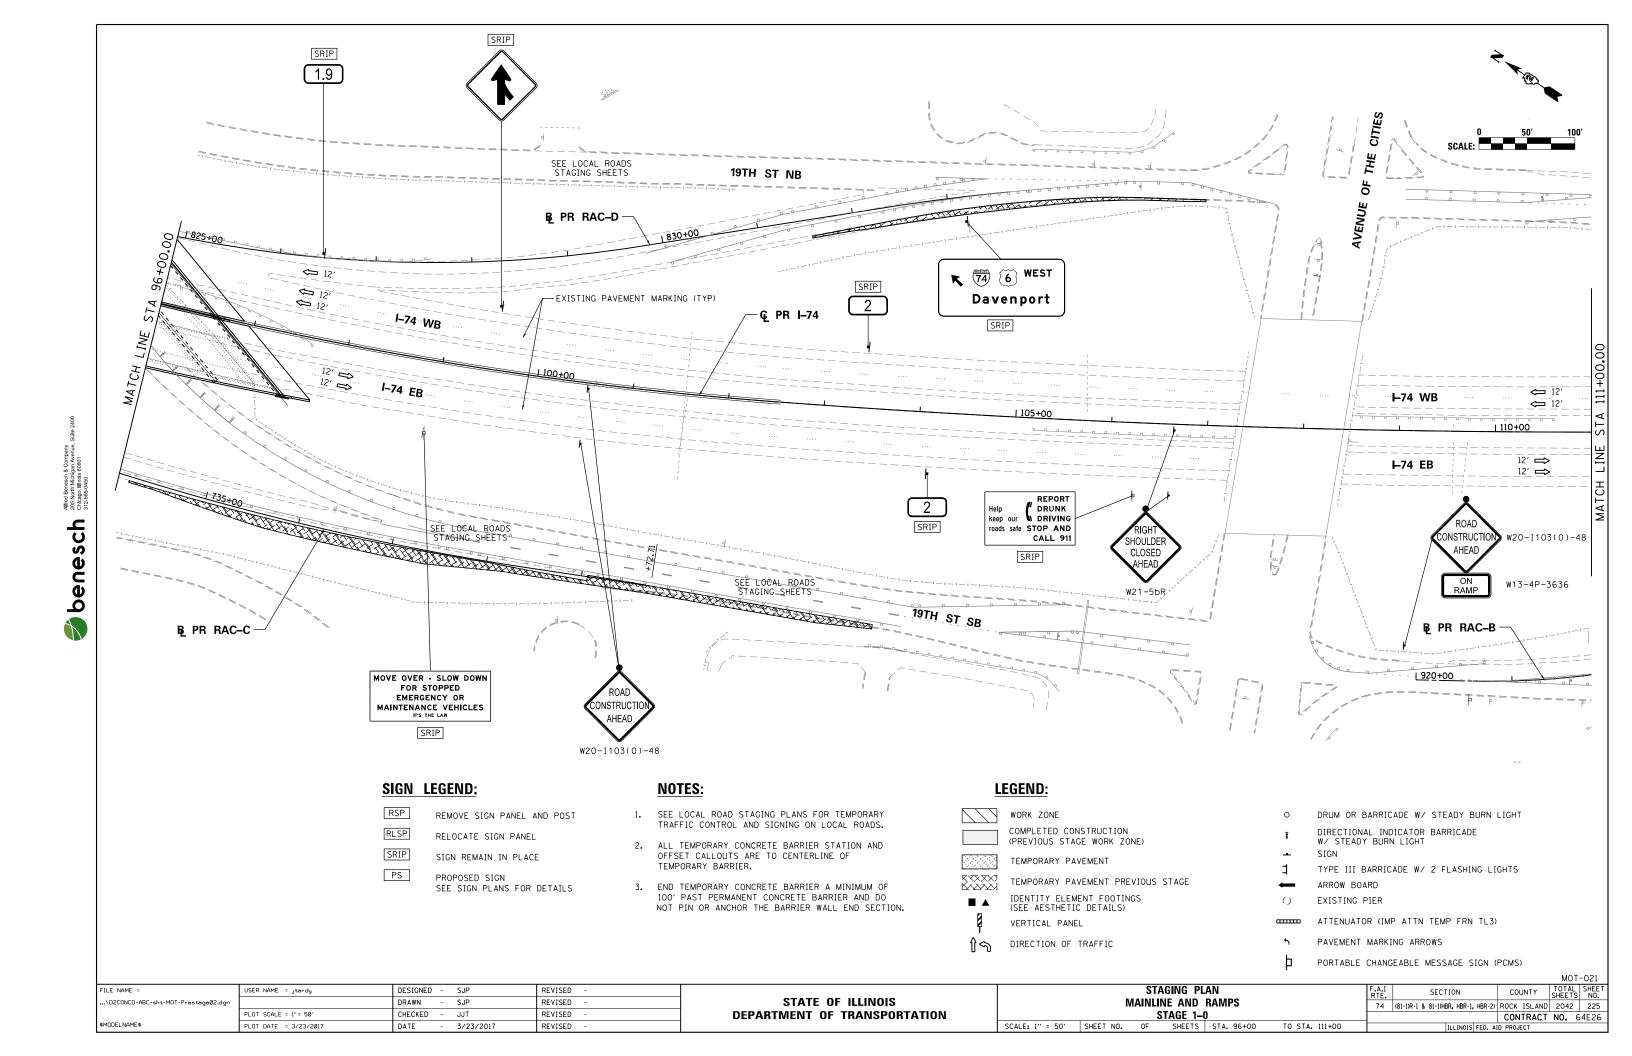


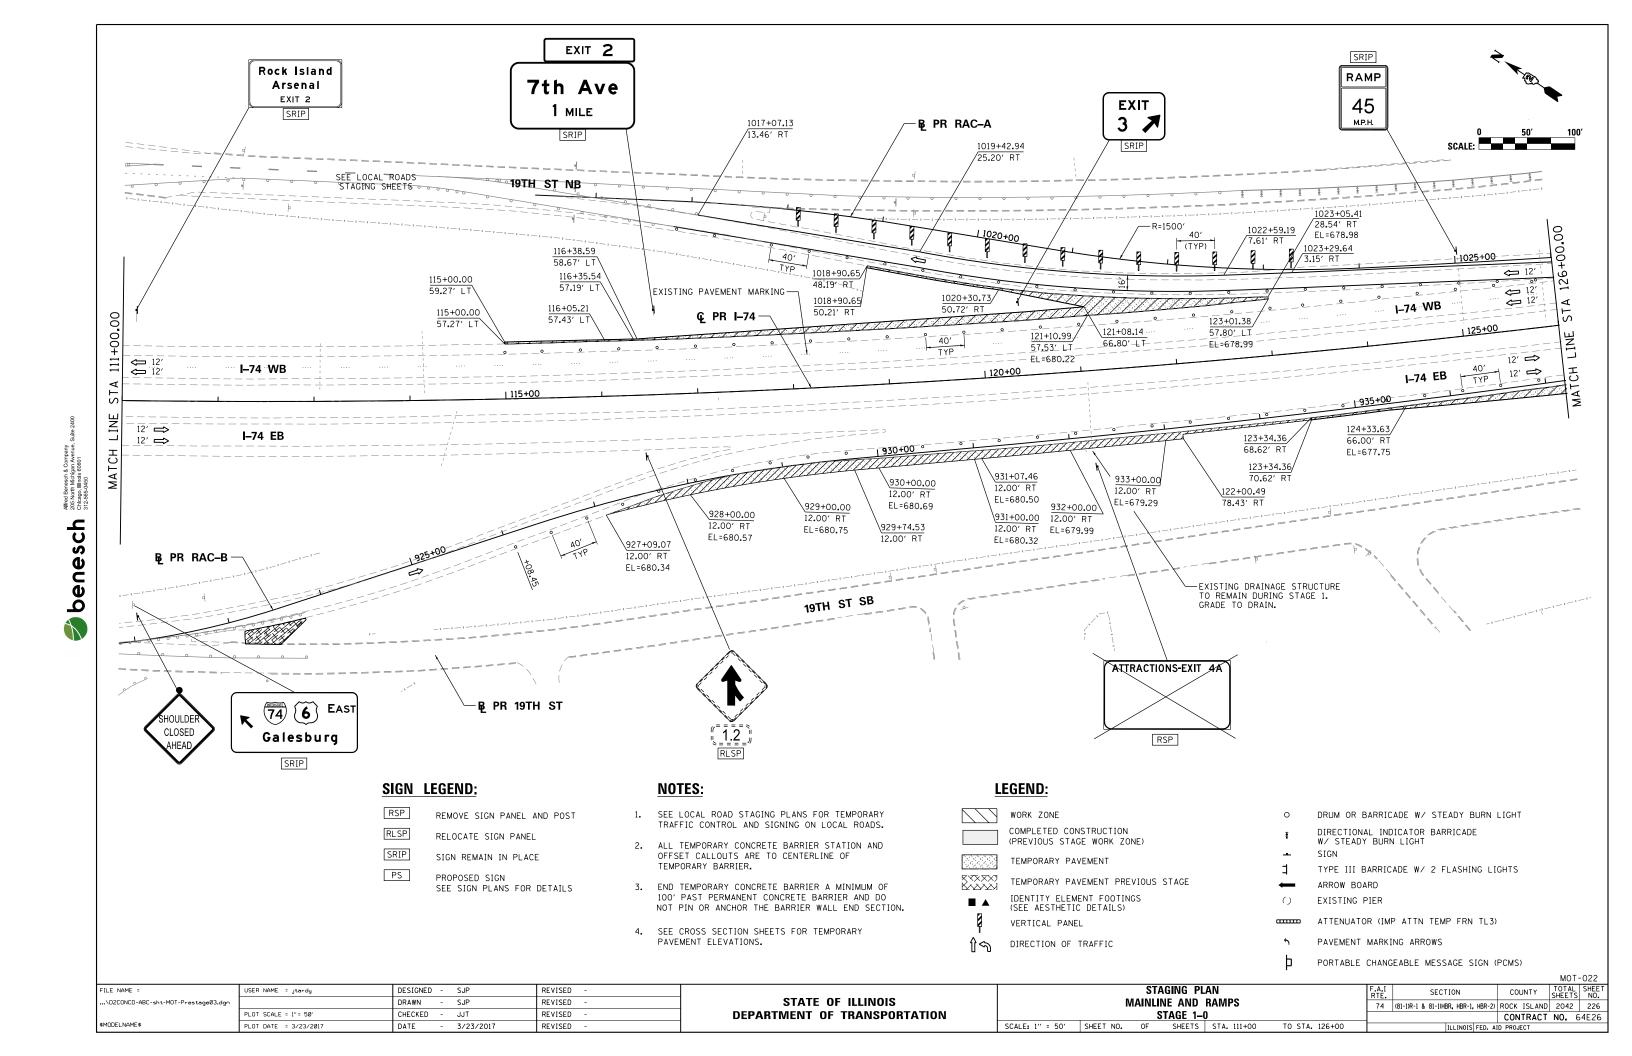


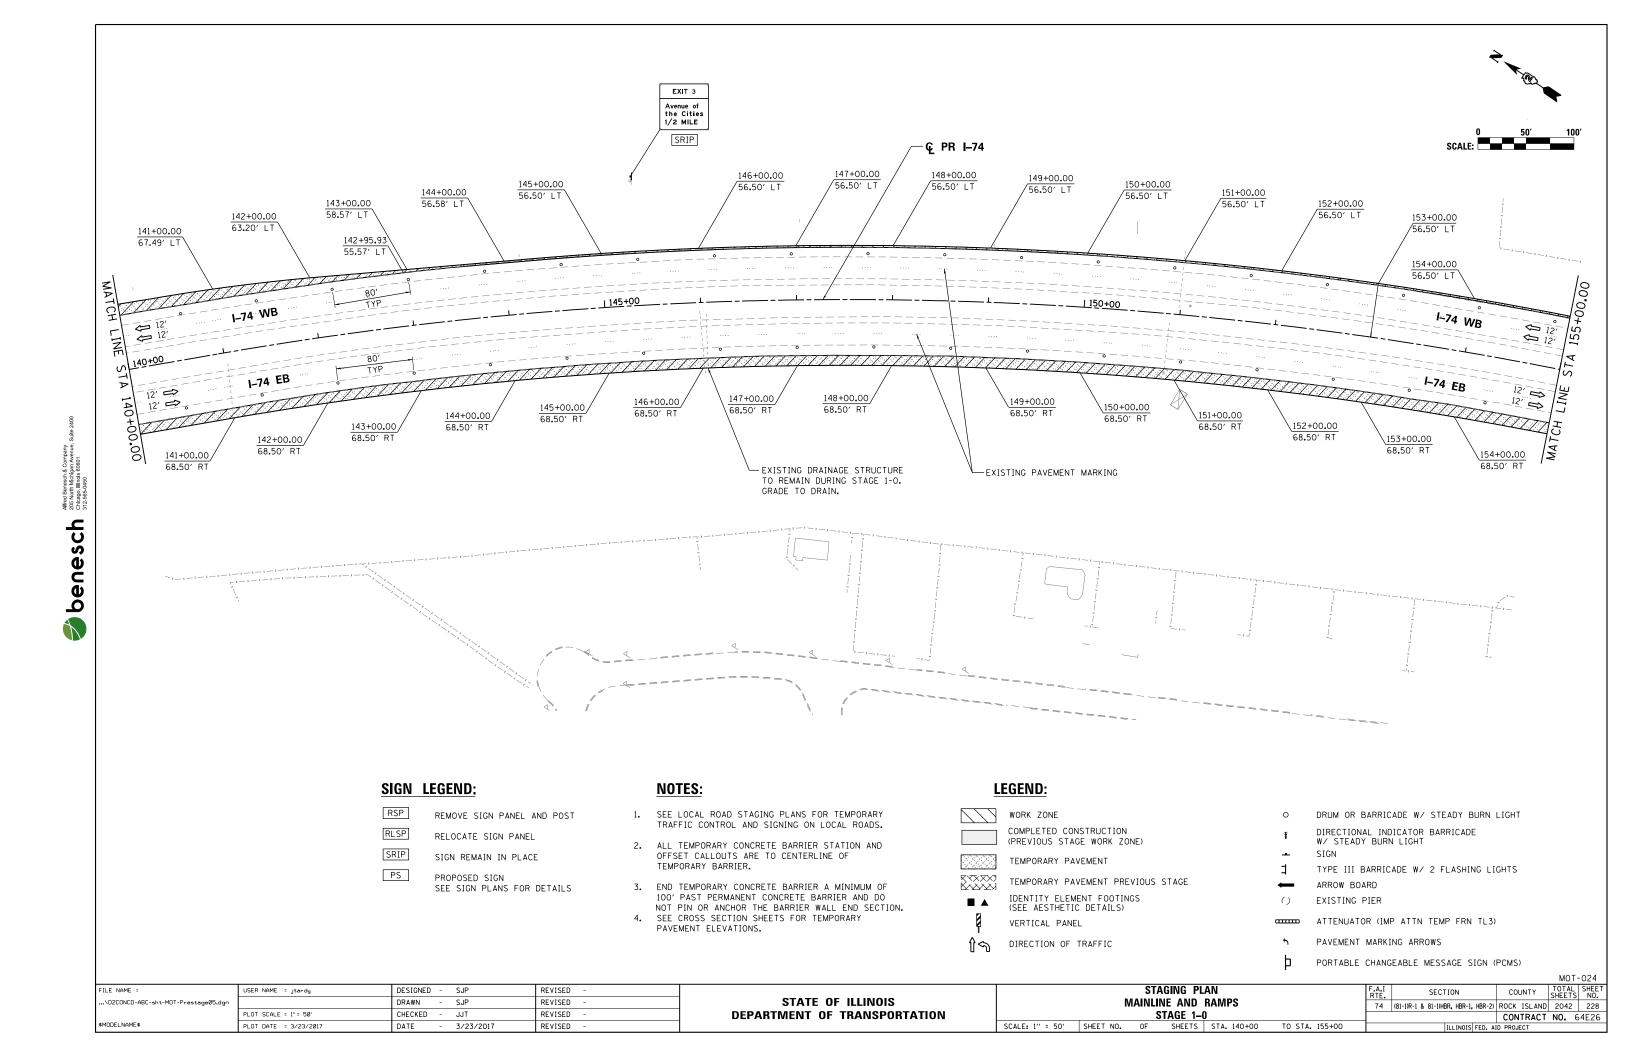



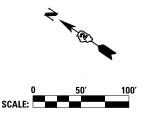

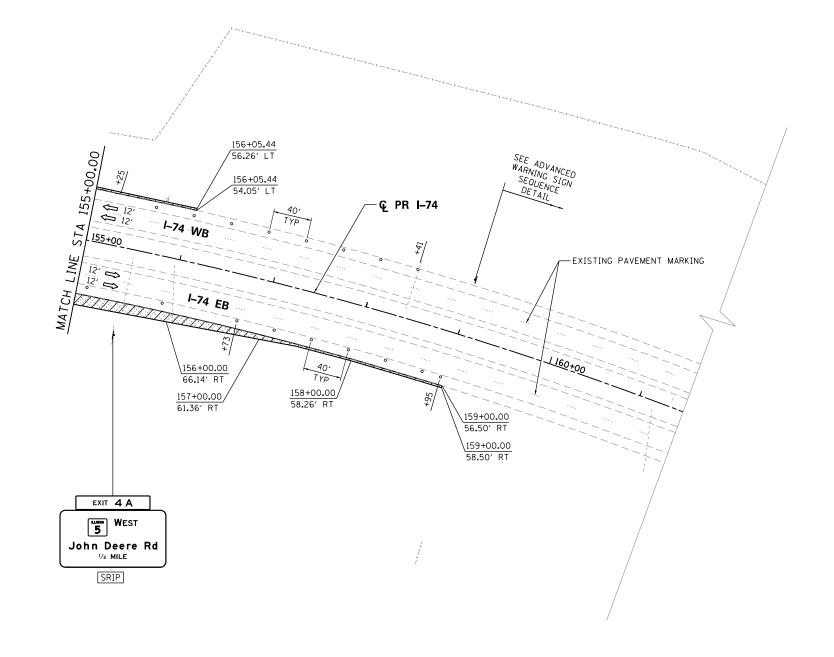

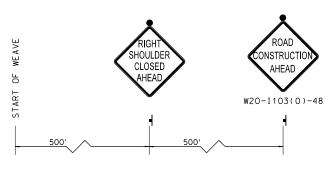

ADAVANCED WARNING SIGN SEQUENCE DETAIL WESTBOUND

SIGN LEGEND:

RSP REMOVE SIGN PANEL AND POST

RLSP RELOCATE SIGN PANEL

SRIP SIGN REMAIN IN PLACE

PS PROPOSED SIGN
SEE SIGN PLANS FOR DETAILS


NOTES:

- 1. SEE LOCAL ROAD STAGING PLANS FOR TEMPORARY TRAFFIC CONTROL AND SIGNING ON LOCAL ROADS.
- 2. ALL TEMPORARY CONCRETE BARRIER STATION AND OFFSET CALLOUTS ARE TO CENTERLINE OF TEMPORARY BARRIER.
- 3. END TEMPORARY CONCRETE BARRIER A MINIMUM OF 100' PAST PERMANENT CONCRETE BARRIER AND DO NOT PIN OR ANCHOR THE BARRIER WALL END SECTION.
- 4. SEE CROSS SECTION SHEETS FOR TEMPORARY PAVEMENT ELEVATIONS.

LEGEND:



WORK ZONE

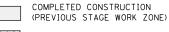



TEMPORARY PAVEMENT



TEMPORARY PAVEMENT PREVIOUS STAGE
IDENTITY ELEMENT FOOTINGS
(SEE AESTHETIC DETAILS)




VERTICAL PANEL


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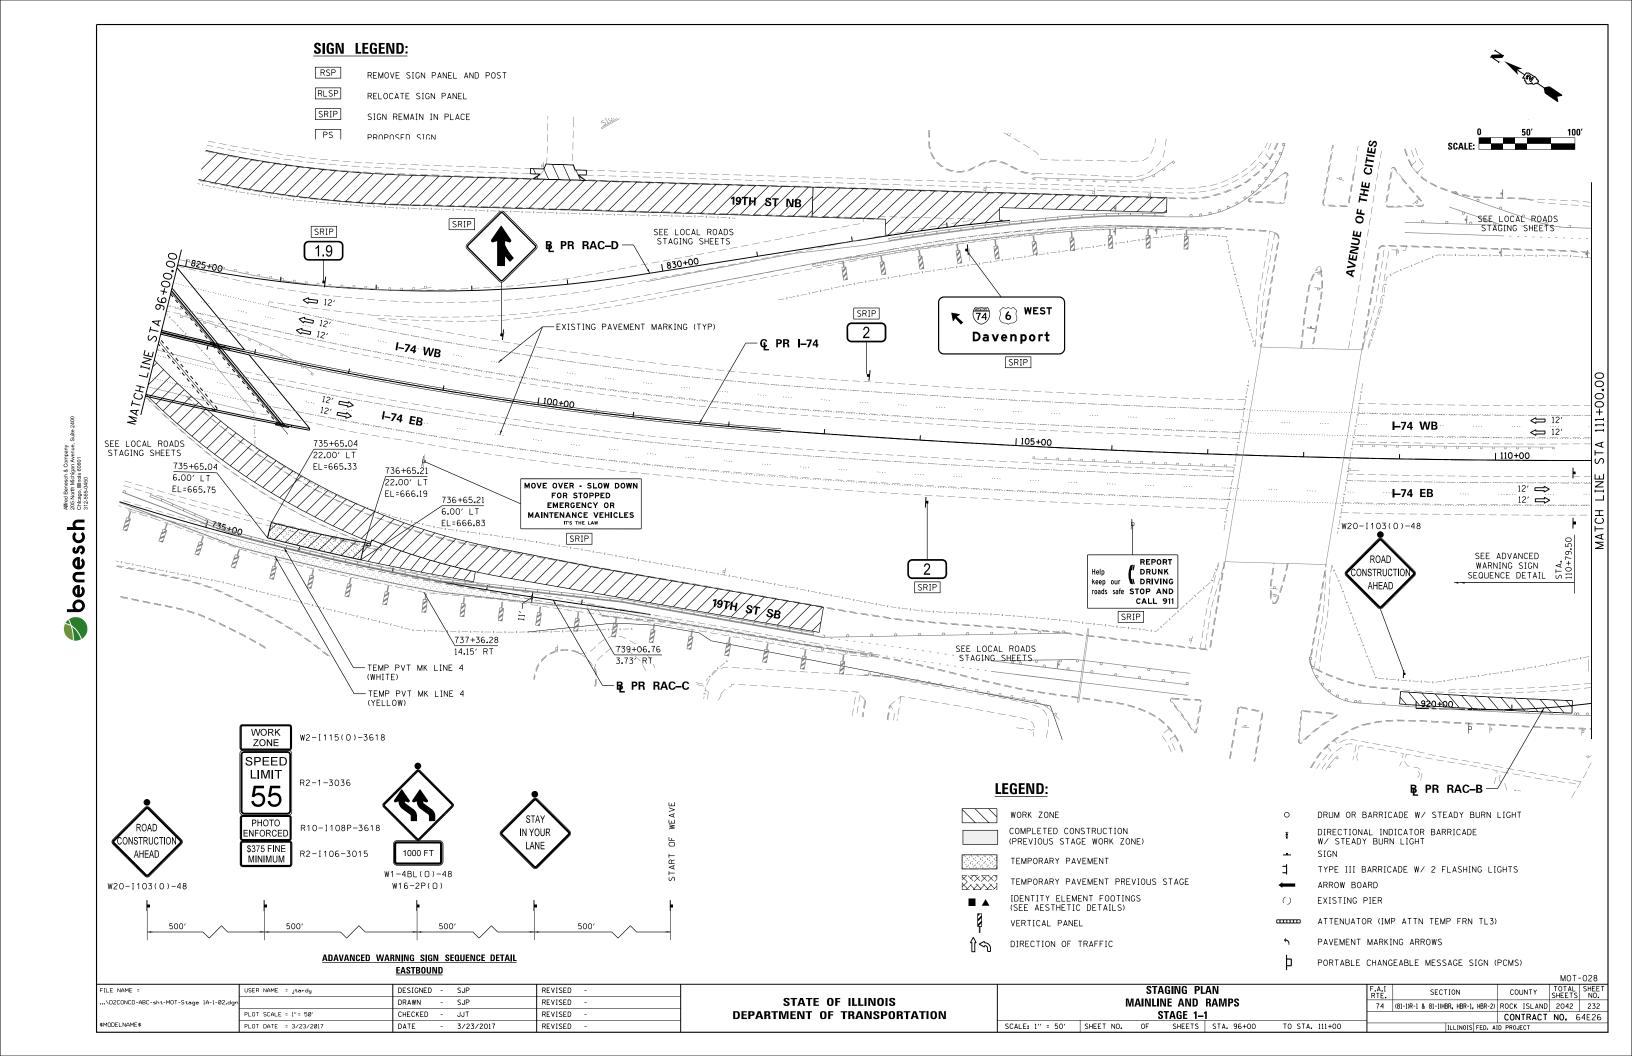
DIRECTION OF TRAFFIC


- O DRUM OR BARRICADE W/ STEADY BURN LIGHT
- DIRECTIONAL INDICATOR BARRICADE W/ STEADY BURN LIGHT
- SIGN
- TYPE III BARRICADE W/ 2 FLASHING LIGHTS
- ARROW BOARD
- () EXISTING PIER
- ATTENUATOR (IMP ATTN TEMP FRN TL3)
- ↑ PAVEMENT MARKING ARROWS
- portable changeable message sign (pcms)


MOT-025 USER NAME = jtardy DESIGNED - SJP STAGING PLAN FILE NAME = REVISED SECTION COUNTY STATE OF ILLINOIS **MAINLINE AND RAMPS** ...\D2CONCD-ABC-sht-MOT-Prestage06.dgr DRAWN SJP REVISED 74 (81-1)R-1 & 81-1(HBR, HBR-1, HBR-2) ROCK ISLAND 2042 229 SCALE: 1" = 50' SHEET NO. OF SHEETS STA. 155+00 PLOT SCALE = 1" = 50" CHECKED JJT REVISED **DEPARTMENT OF TRANSPORTATION** CONTRACT NO. 64E26 \$MODELNAME\$ TO STA. PLOT DATE = 3/23/2017 DATE 3/23/2017 REVISED




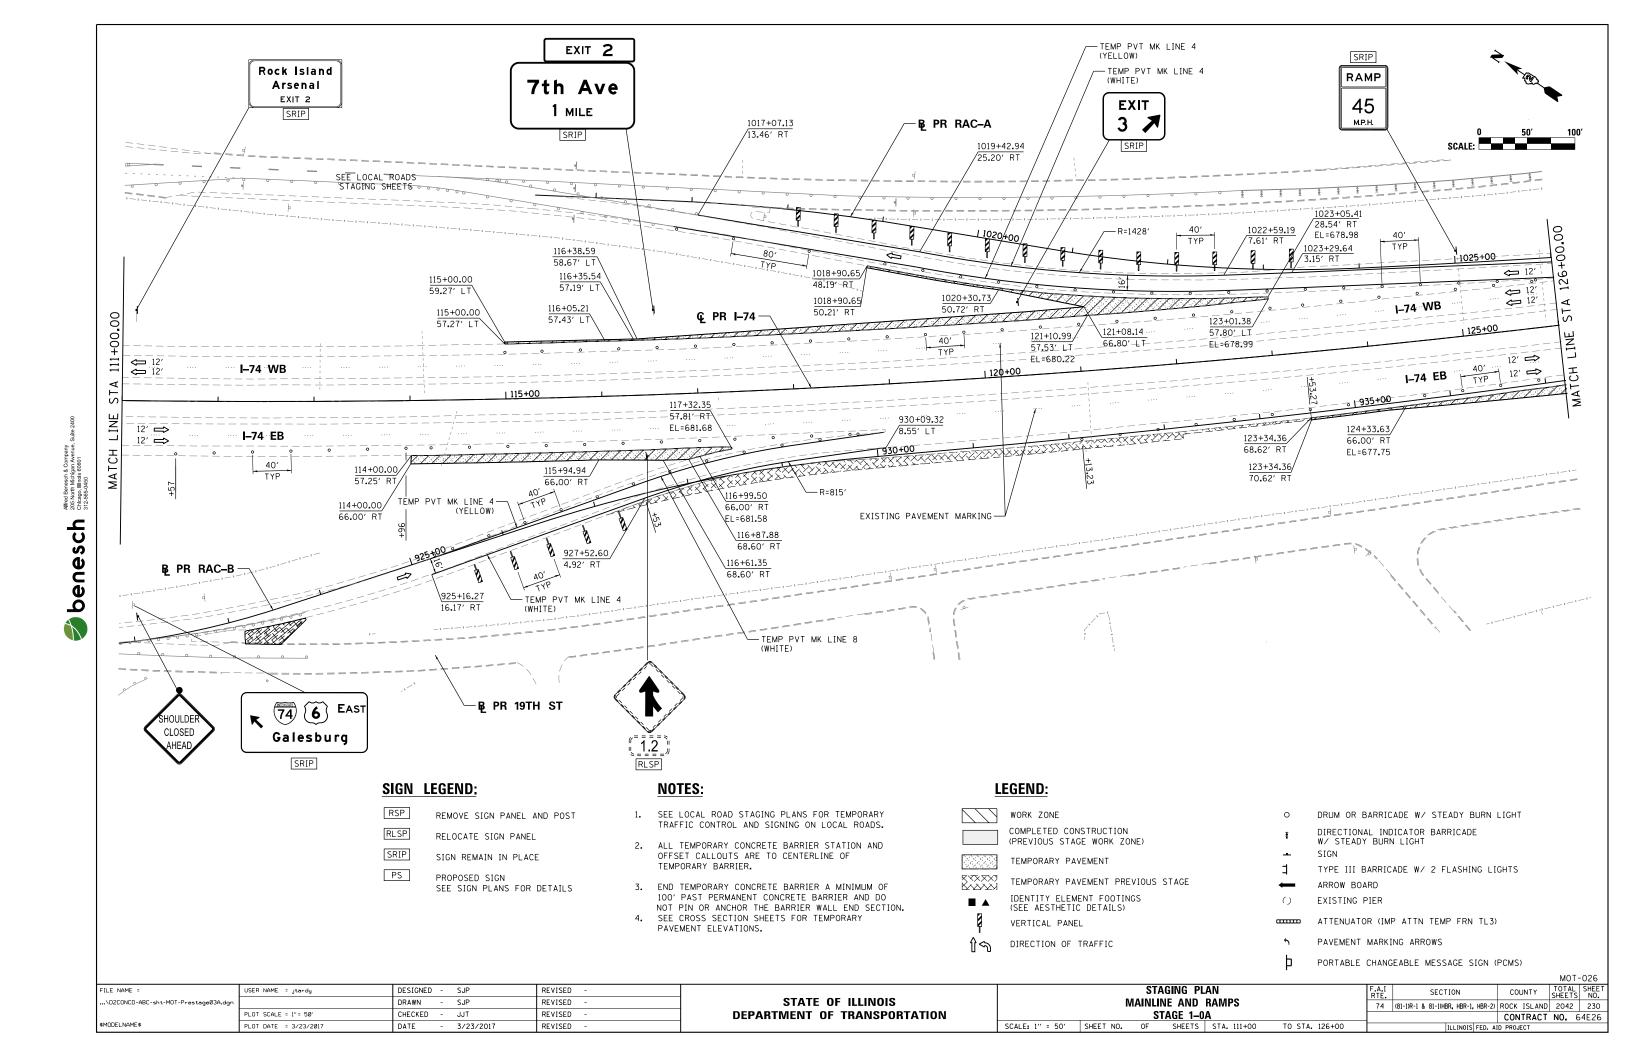


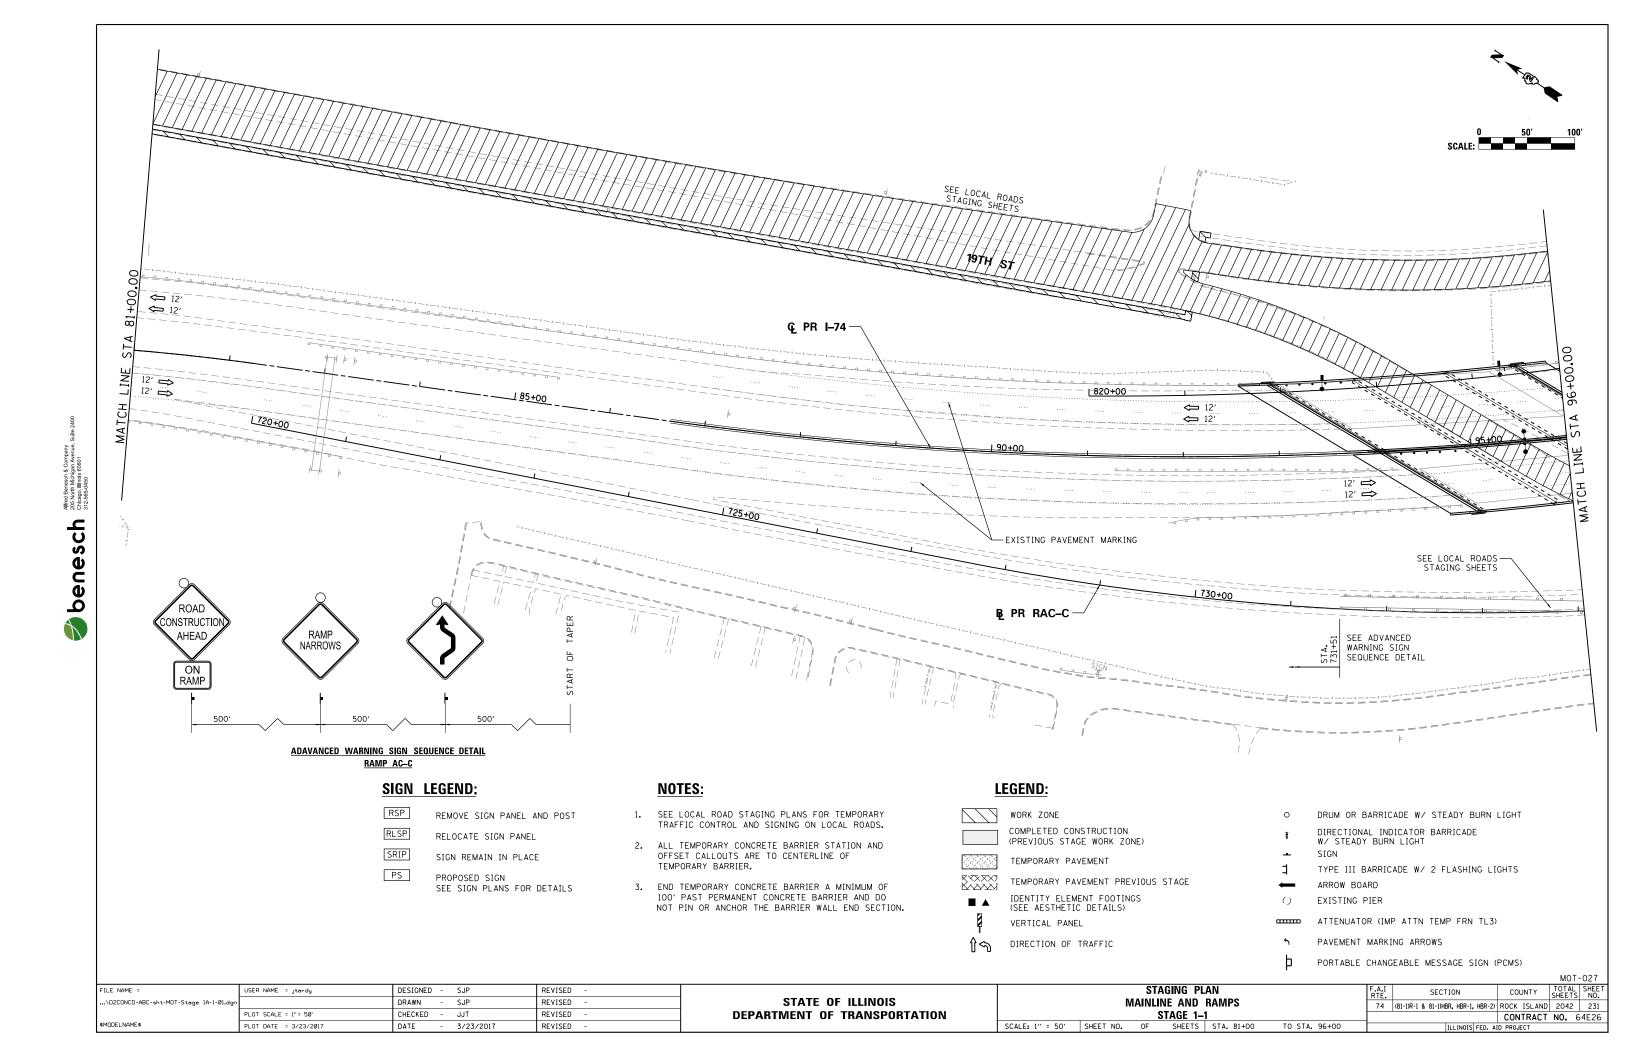

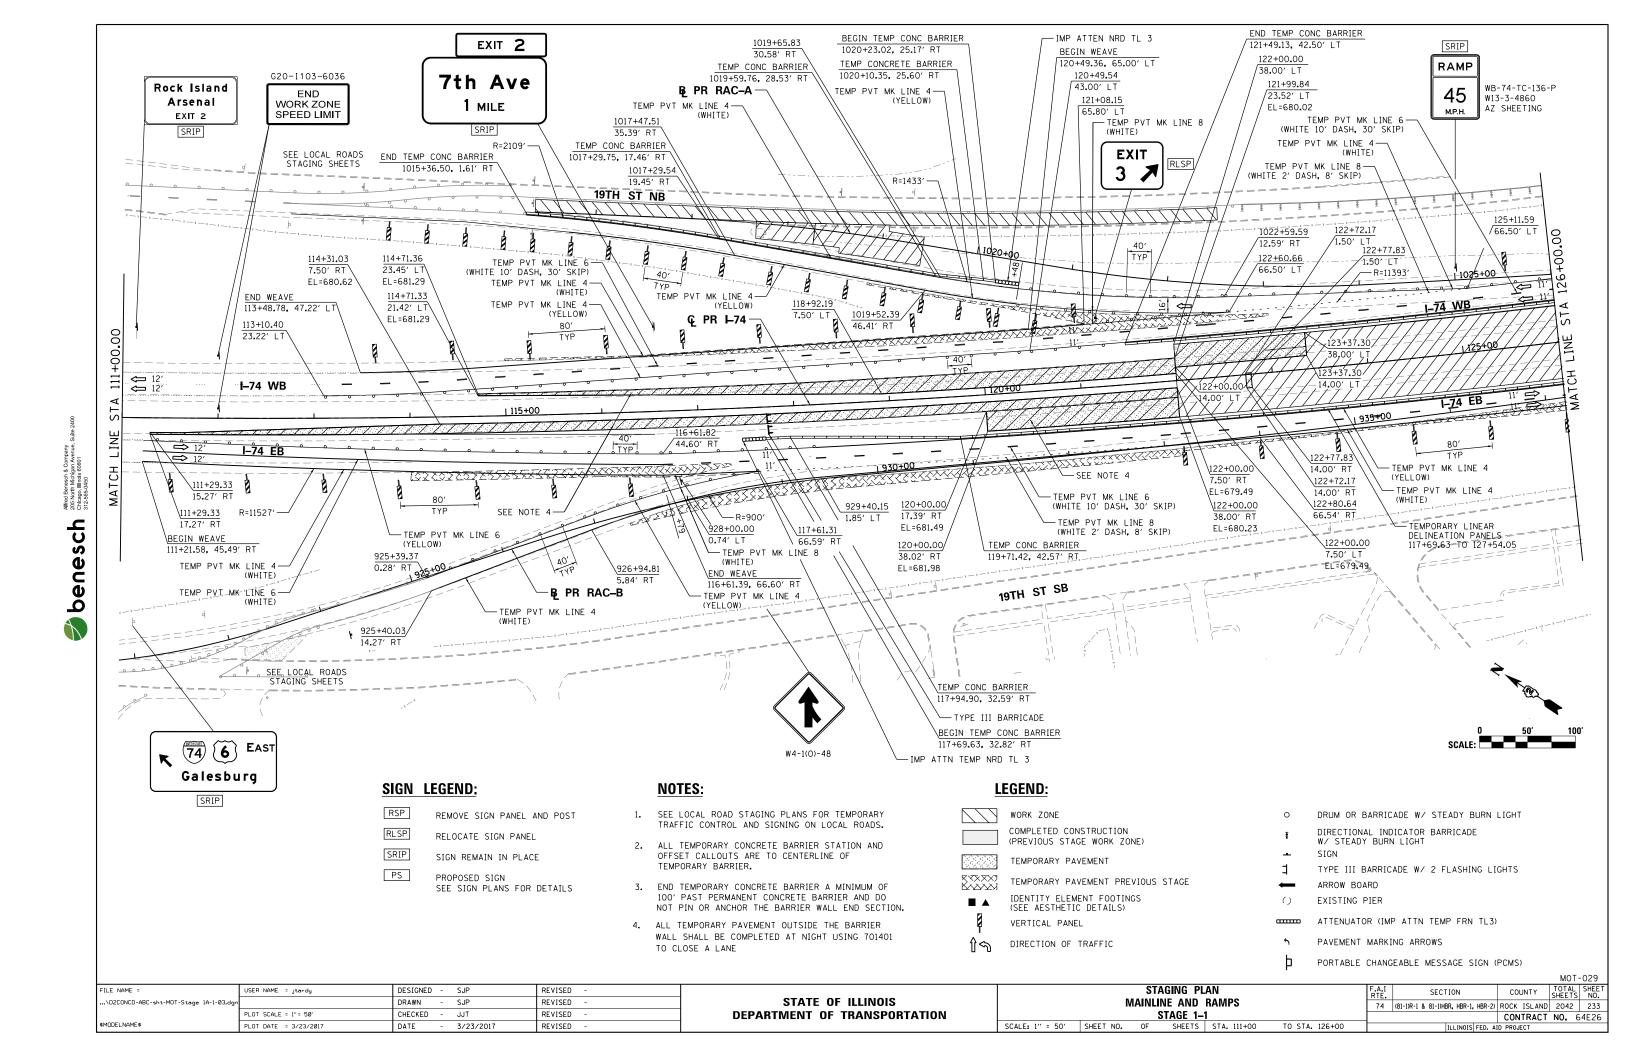

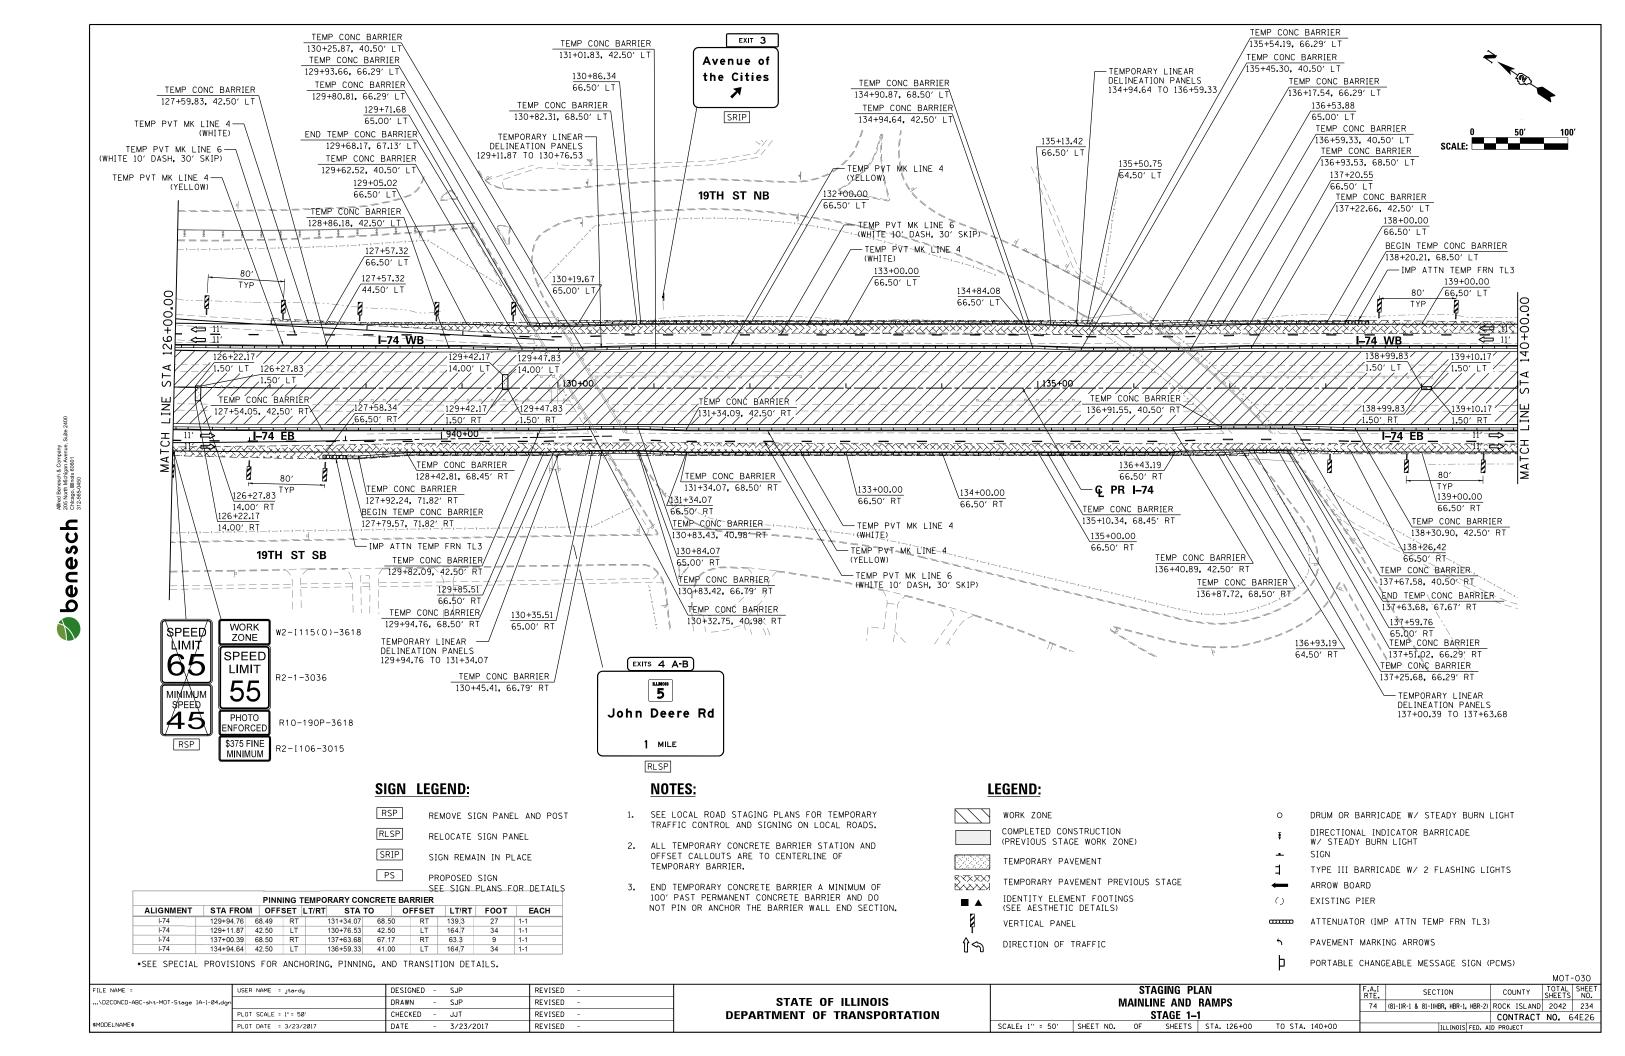

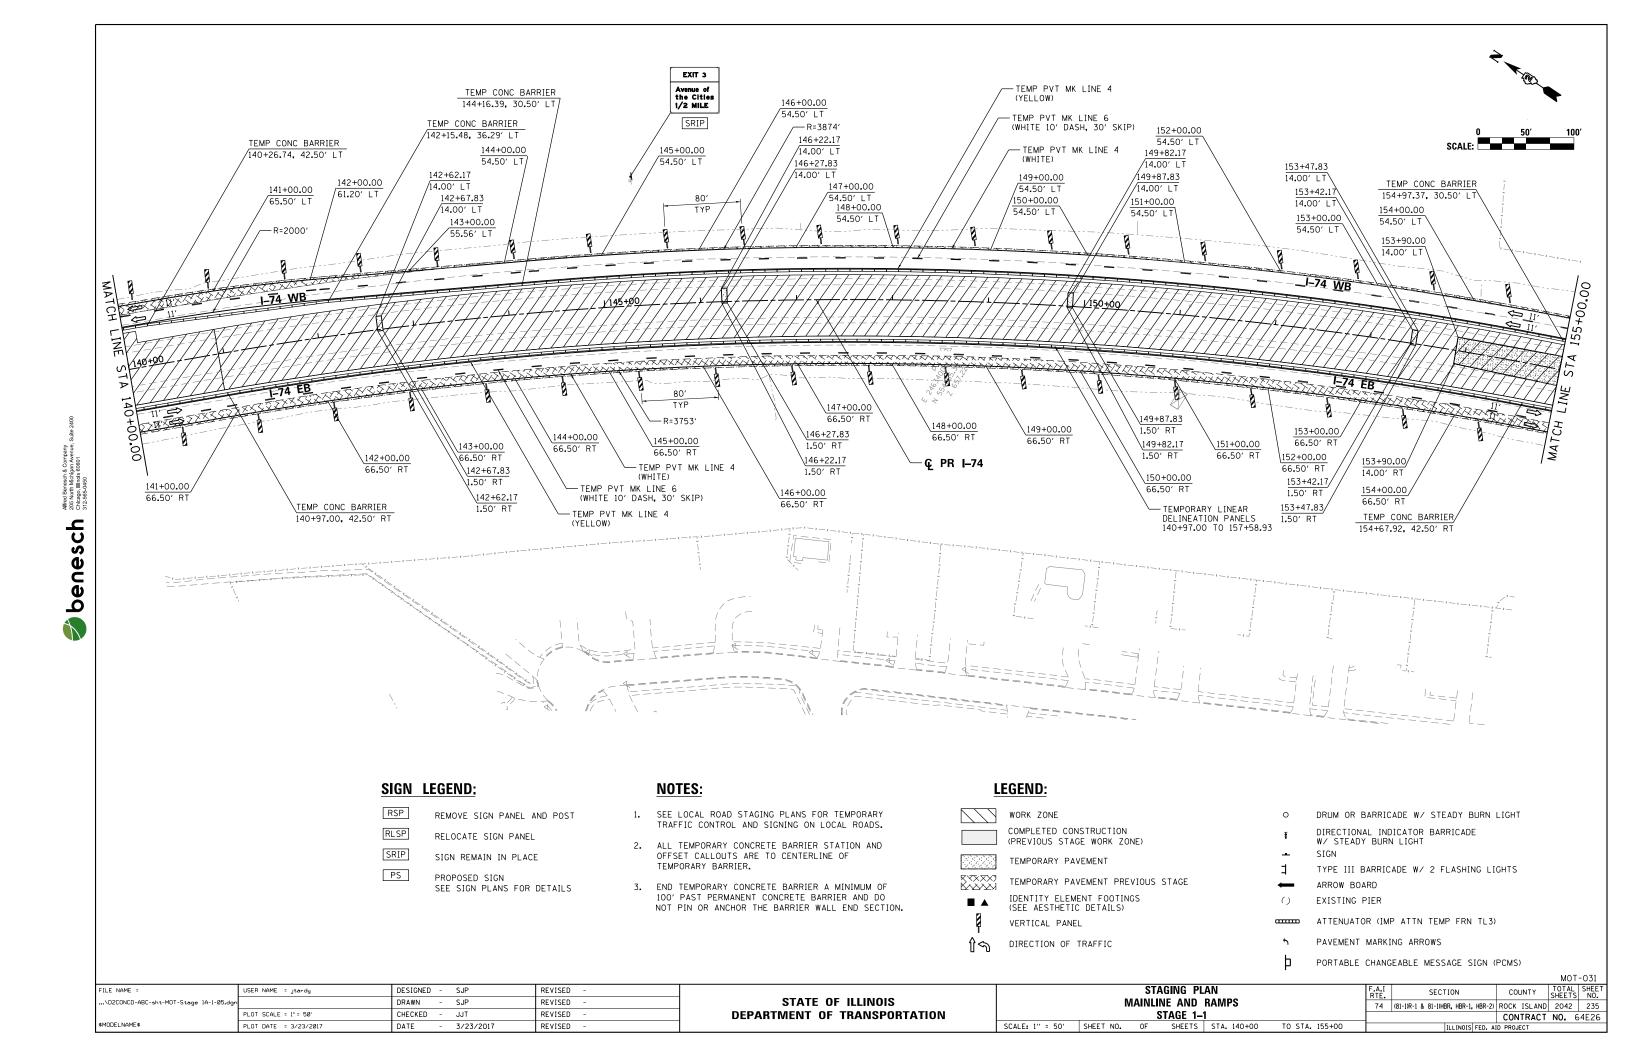

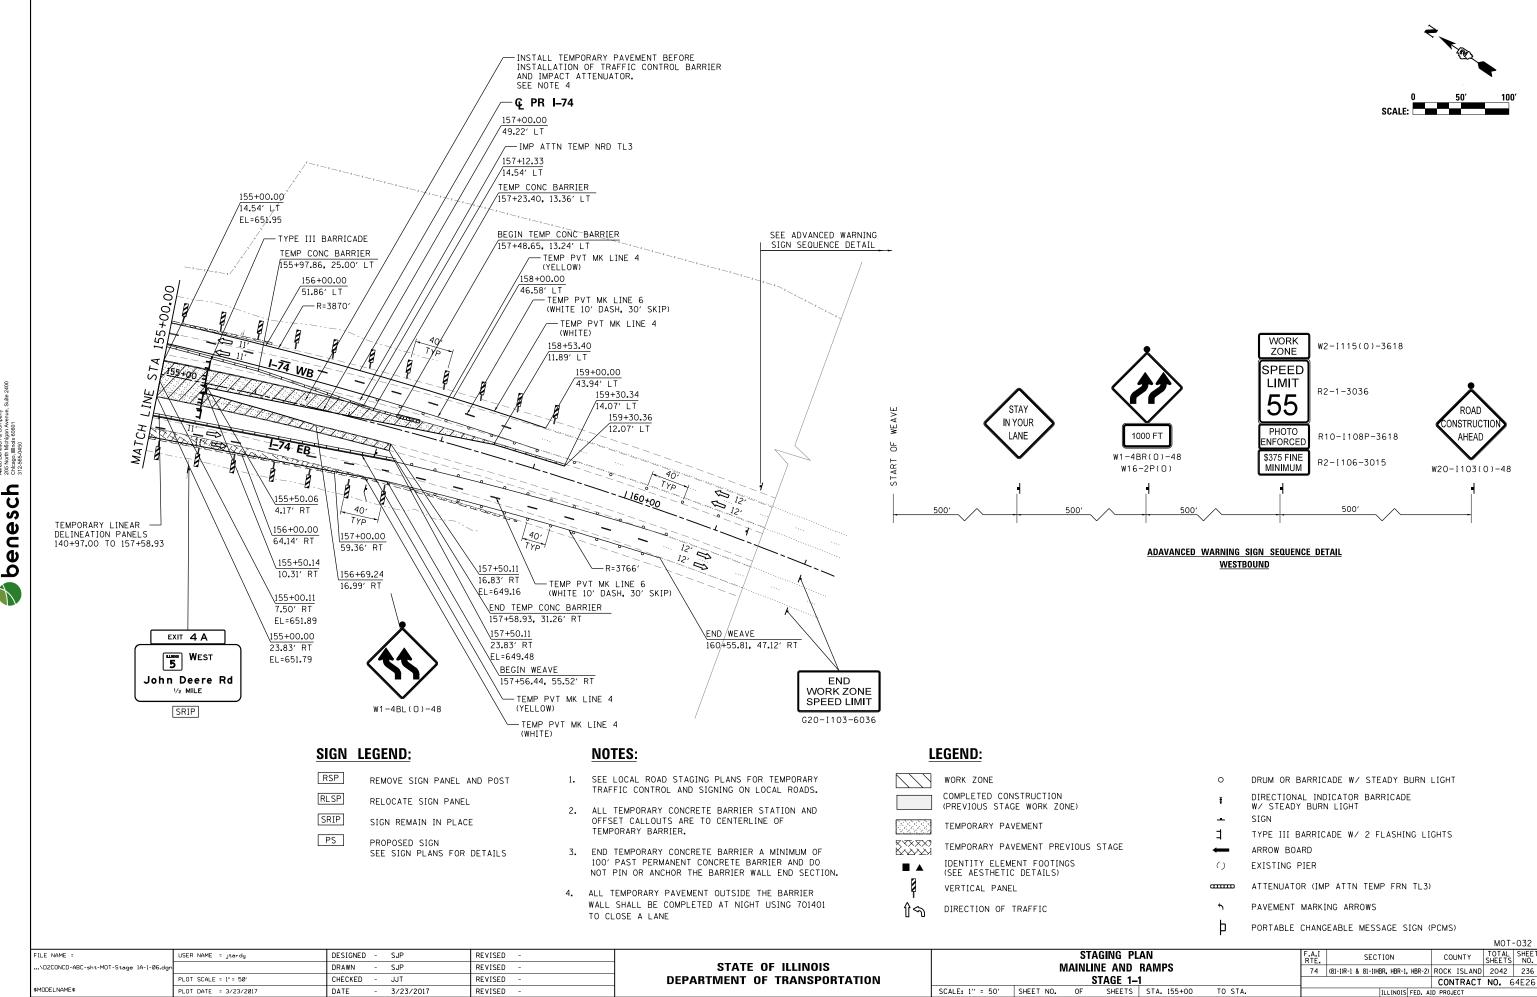

SCALE: 1" = 50' SHEET NO.

TO STA.

\$MODELNAME\$


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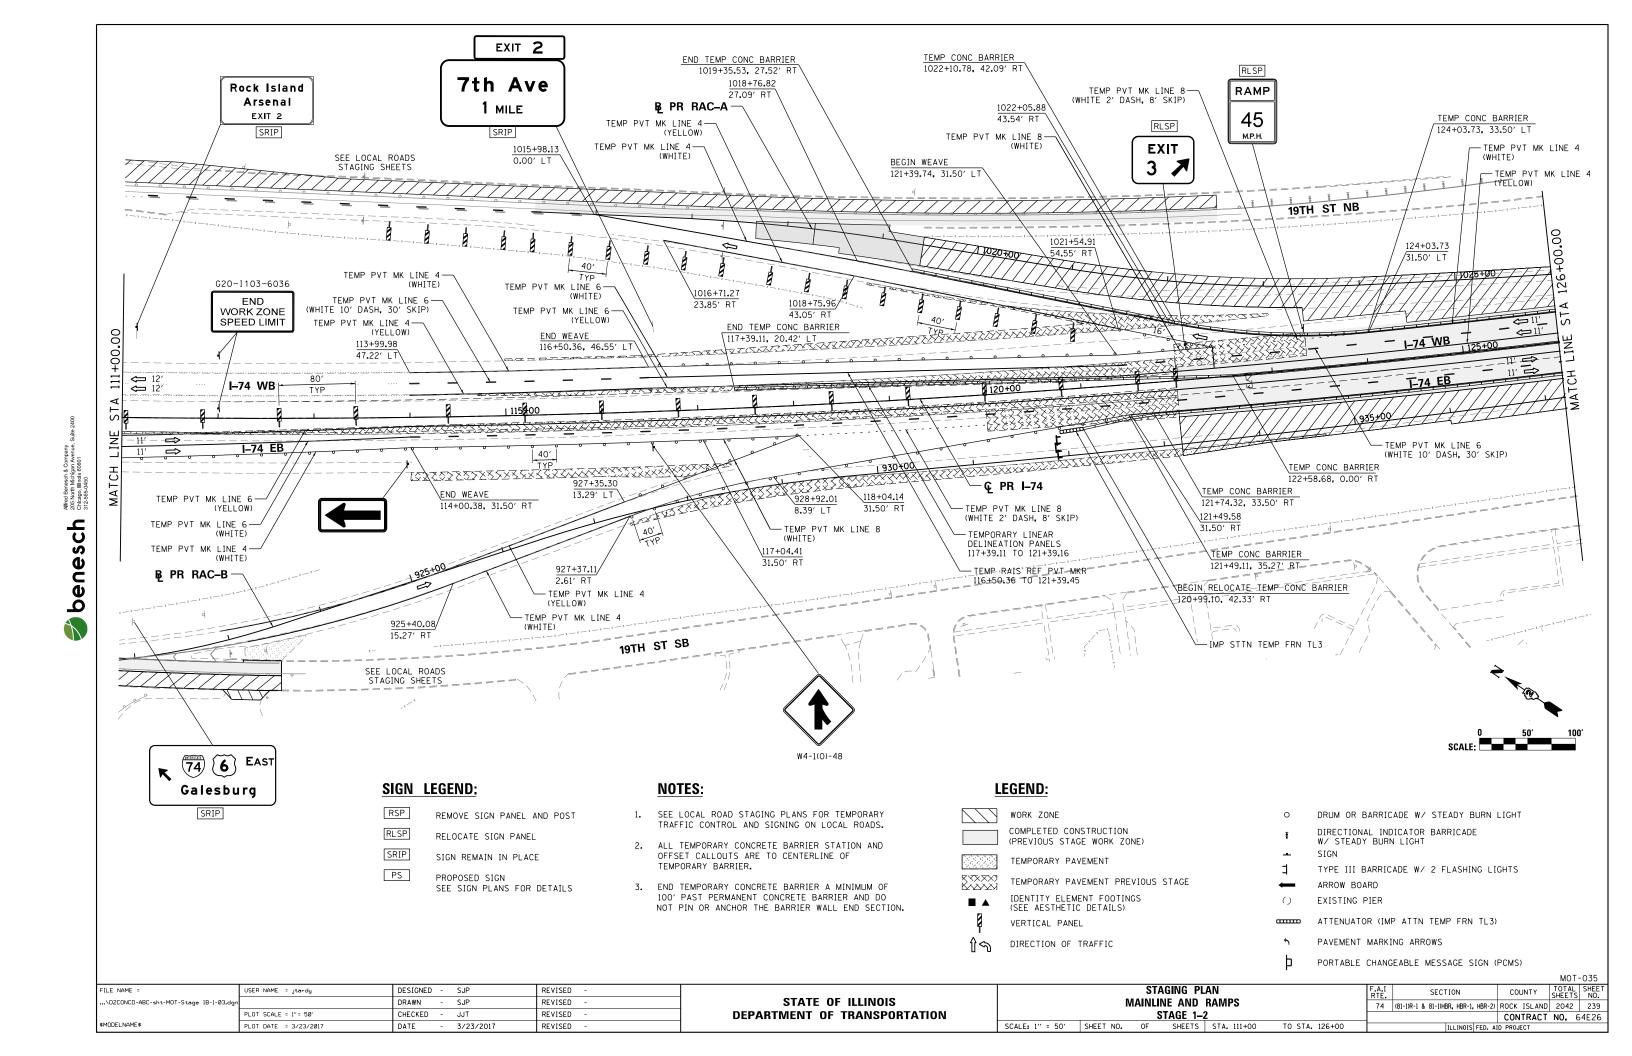
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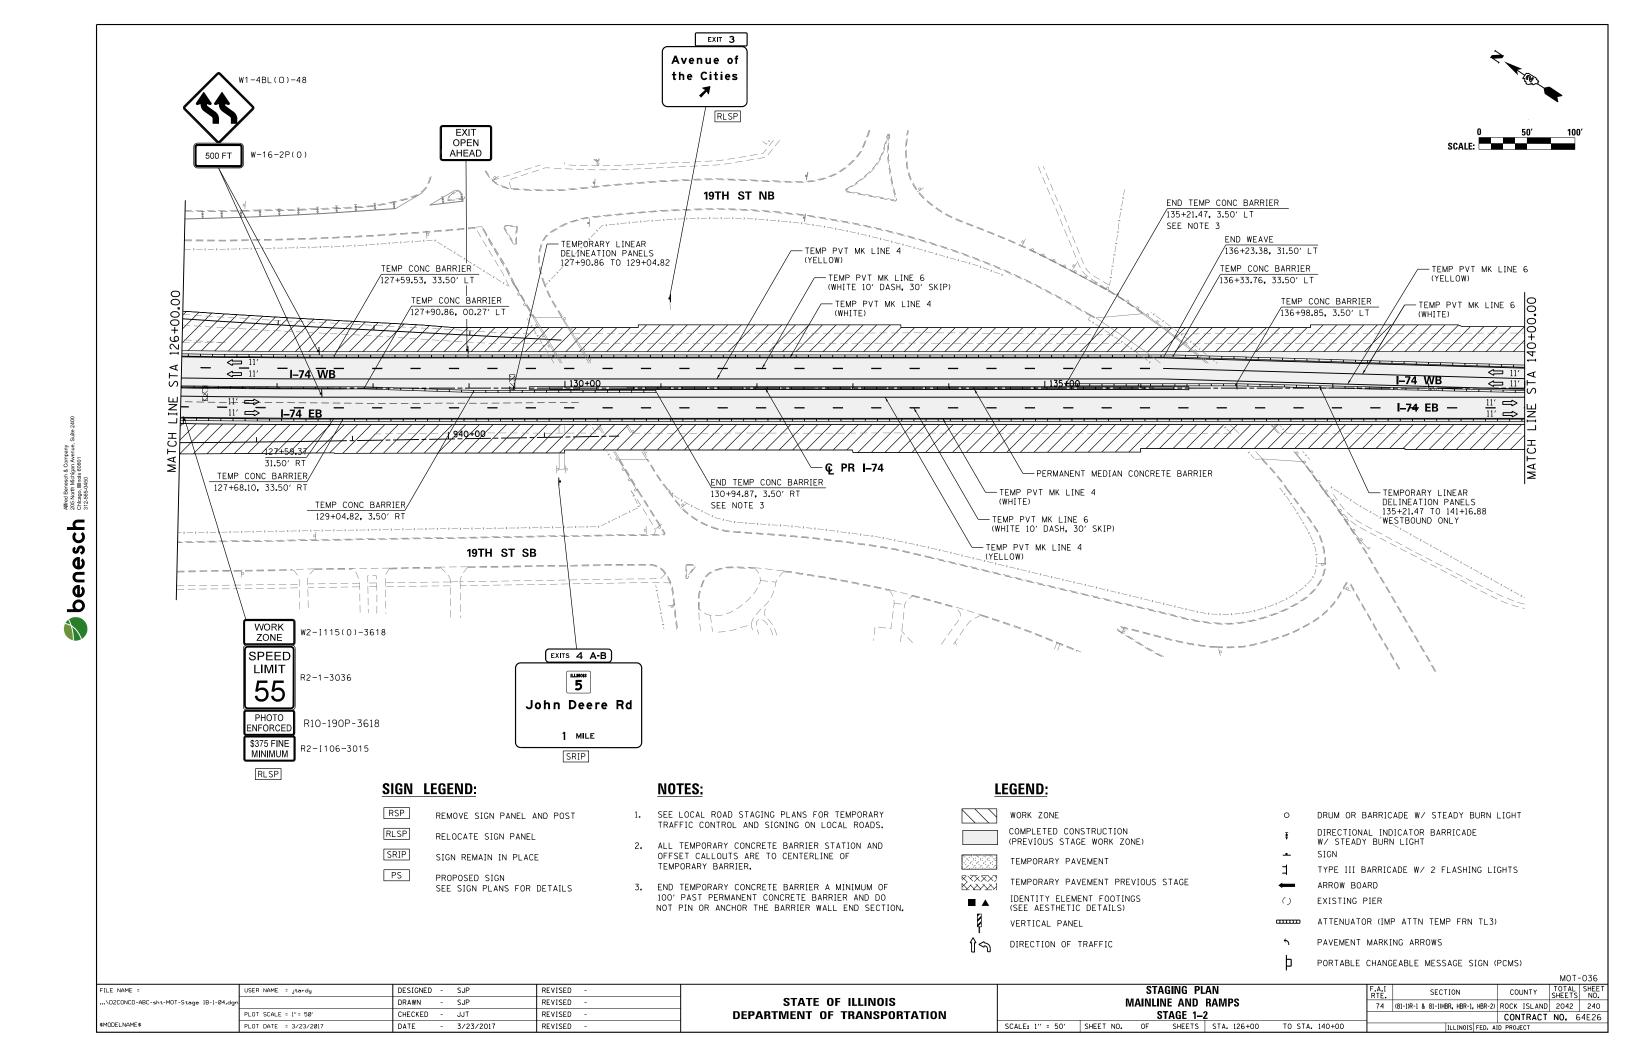
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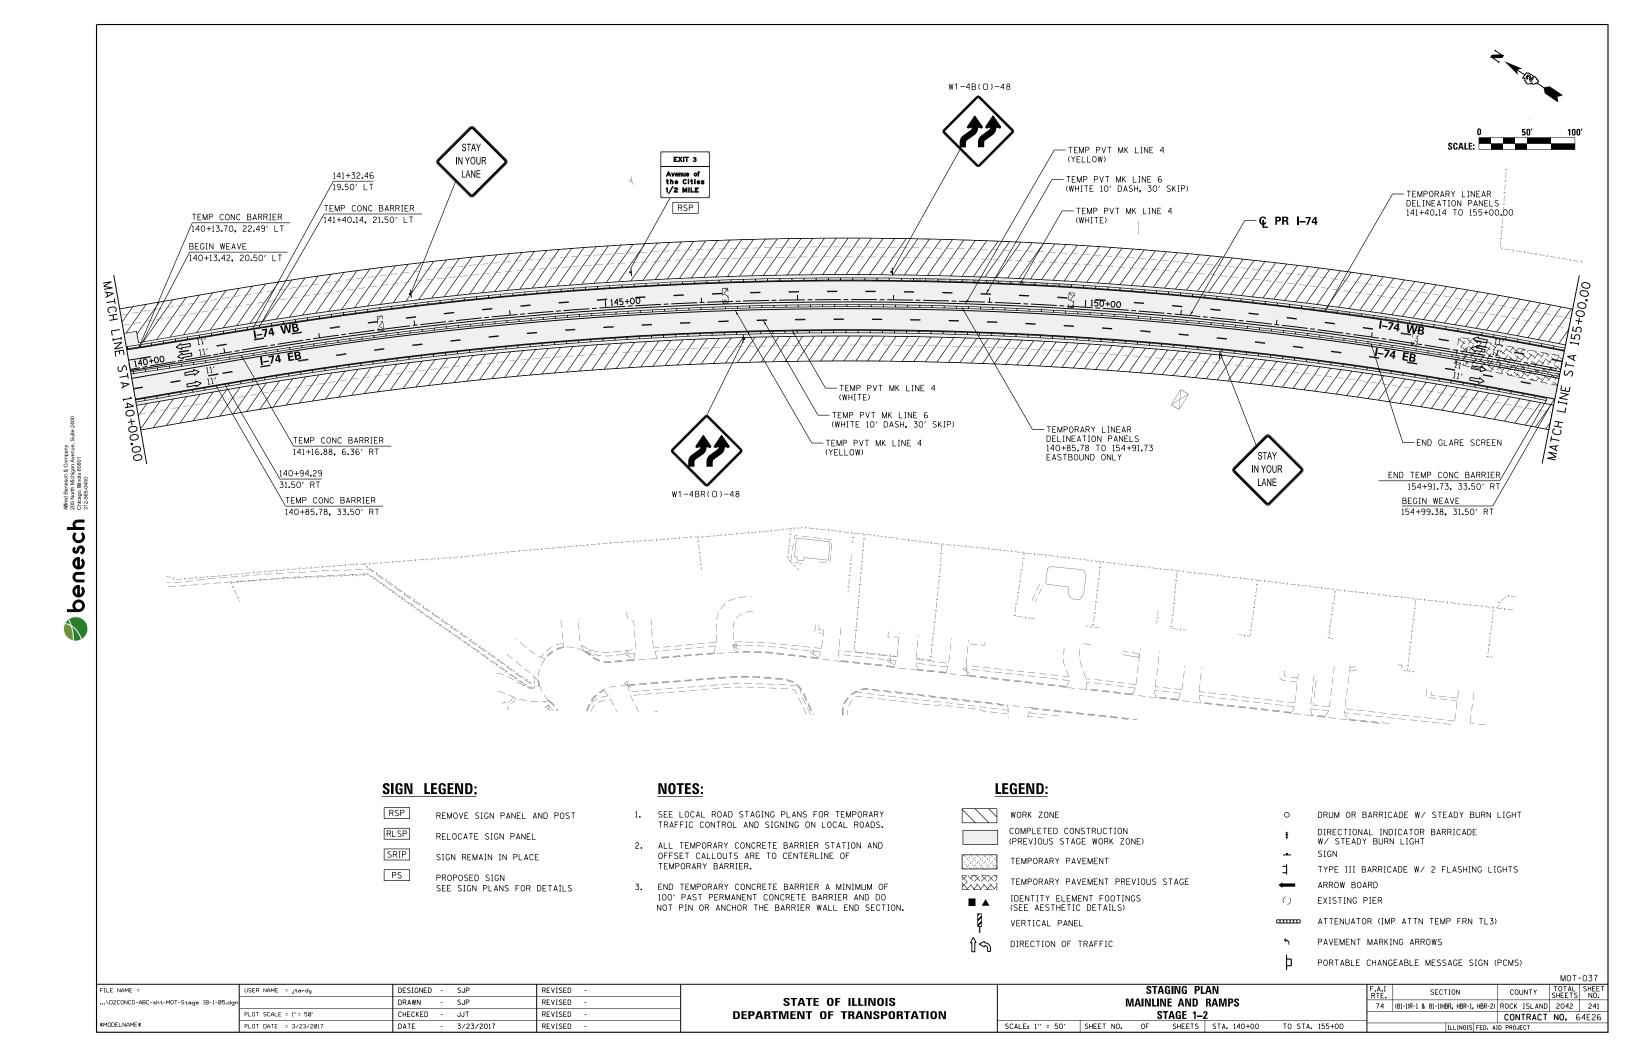
REVISED


CONTRACT NO. 64E26







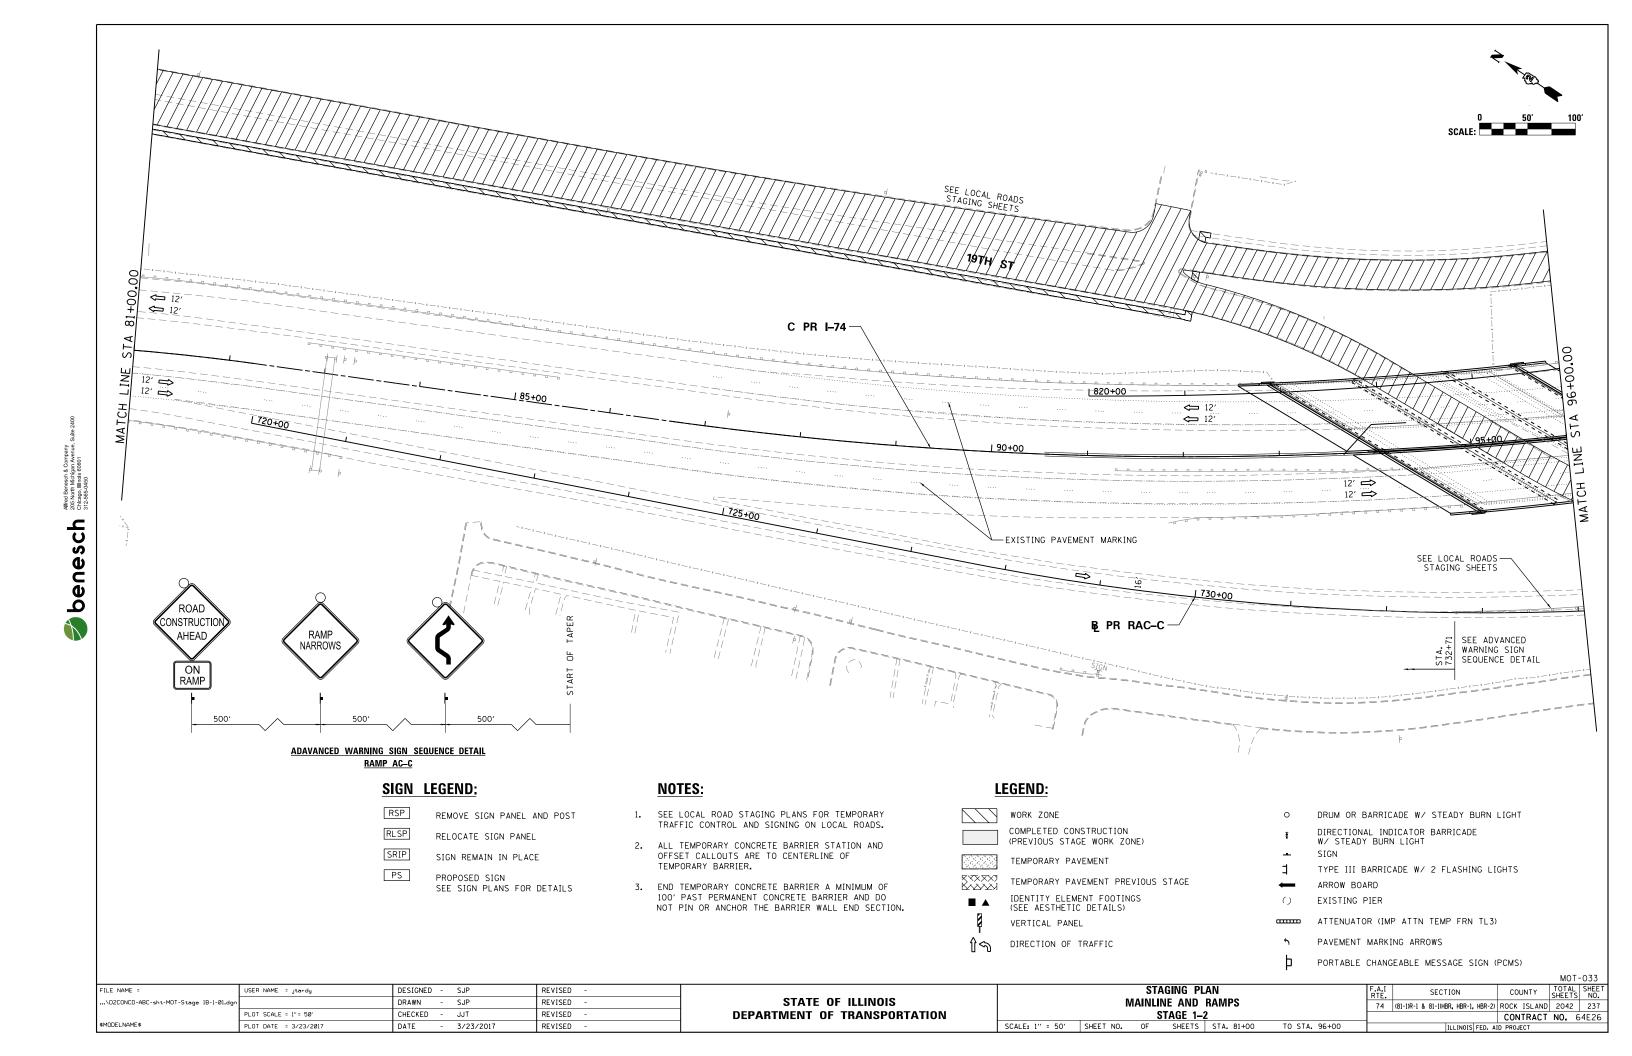

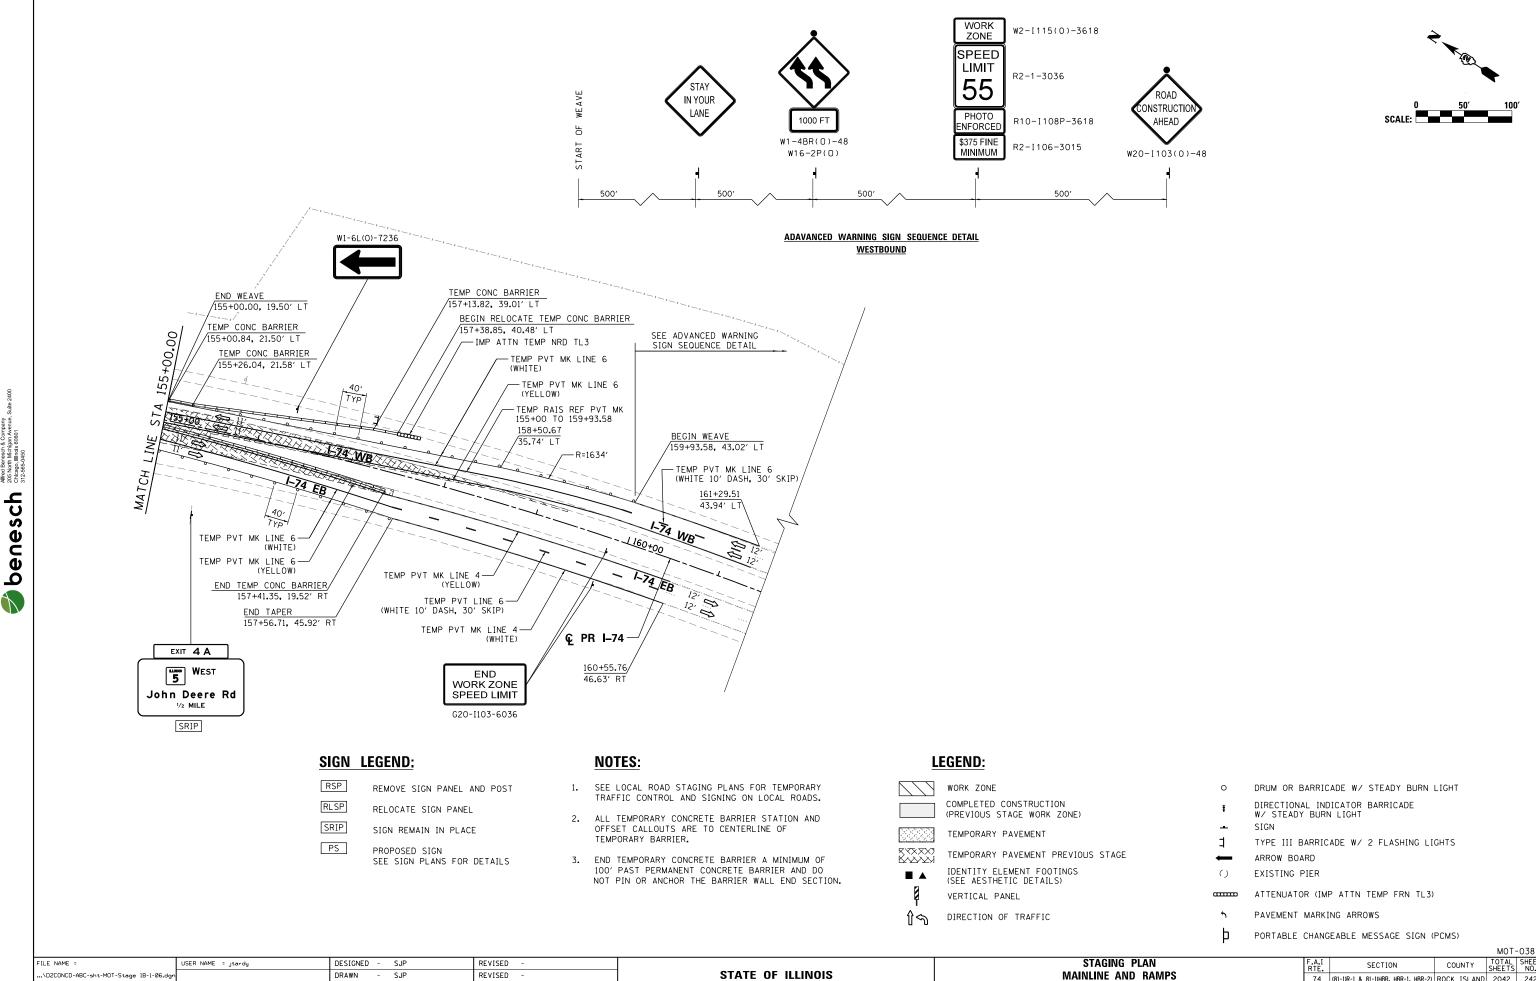

DEPARTMENT OF TRANSPORTATION

PLOT SCALE = 1" = 50"

PLOT DATE = 3/23/2017

\$MODELNAME\$

CHECKED

DATE

JJT

3/23/2017

REVISED


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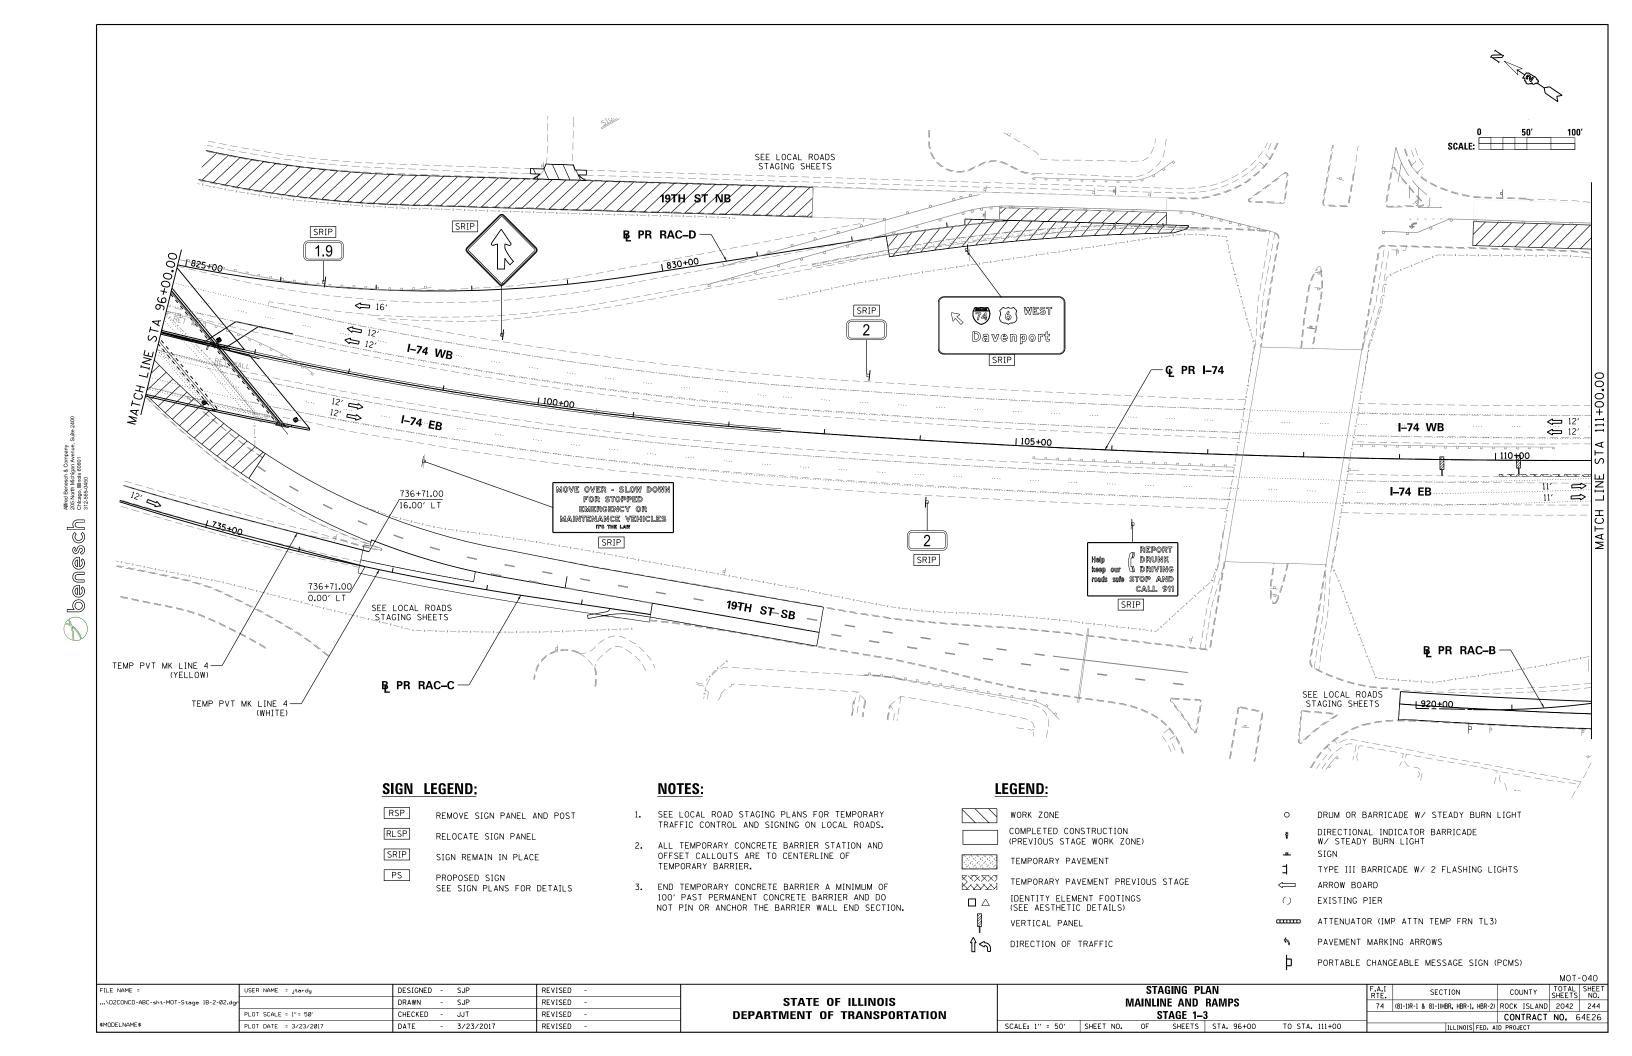
 STAGE 1-2


 SCALE: 1" = 50'
 SHEET NO.
 OF
 SHEETS
 STA. 155+00


TO STA.


74 (81-1)R-1 & 81-1(HBR, HBR-1, HBR-2) ROCK ISLAND 2042 242 CONTRACT NO. 64E26




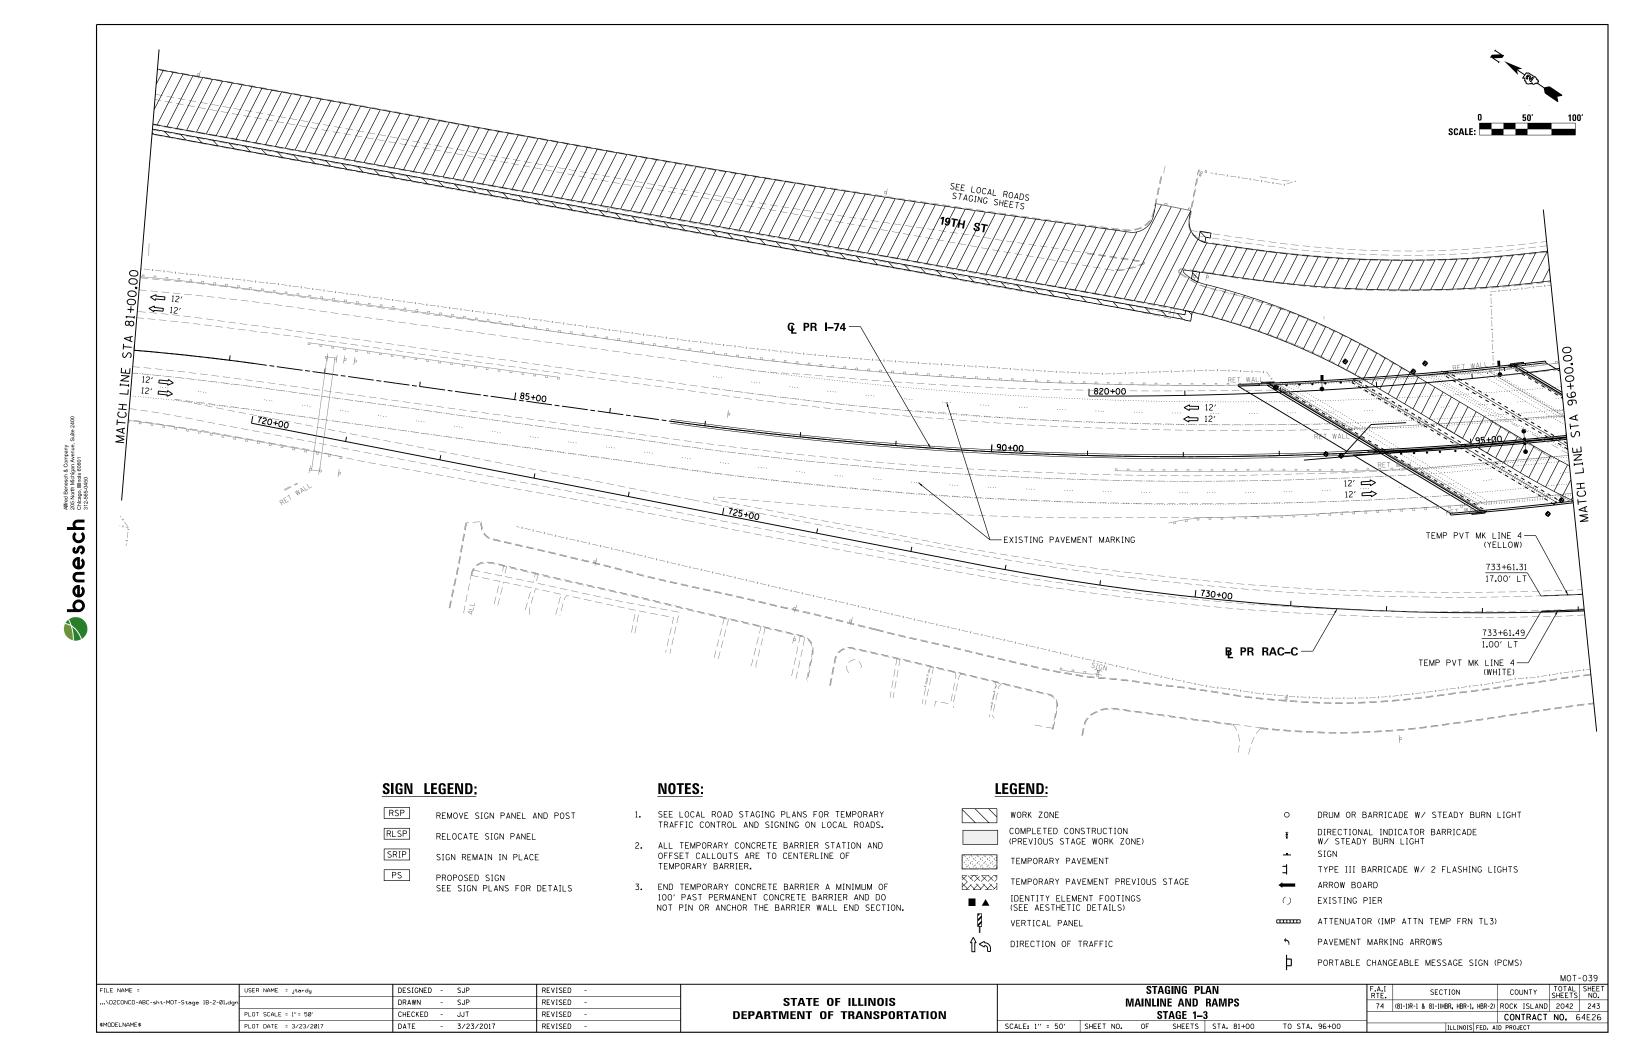


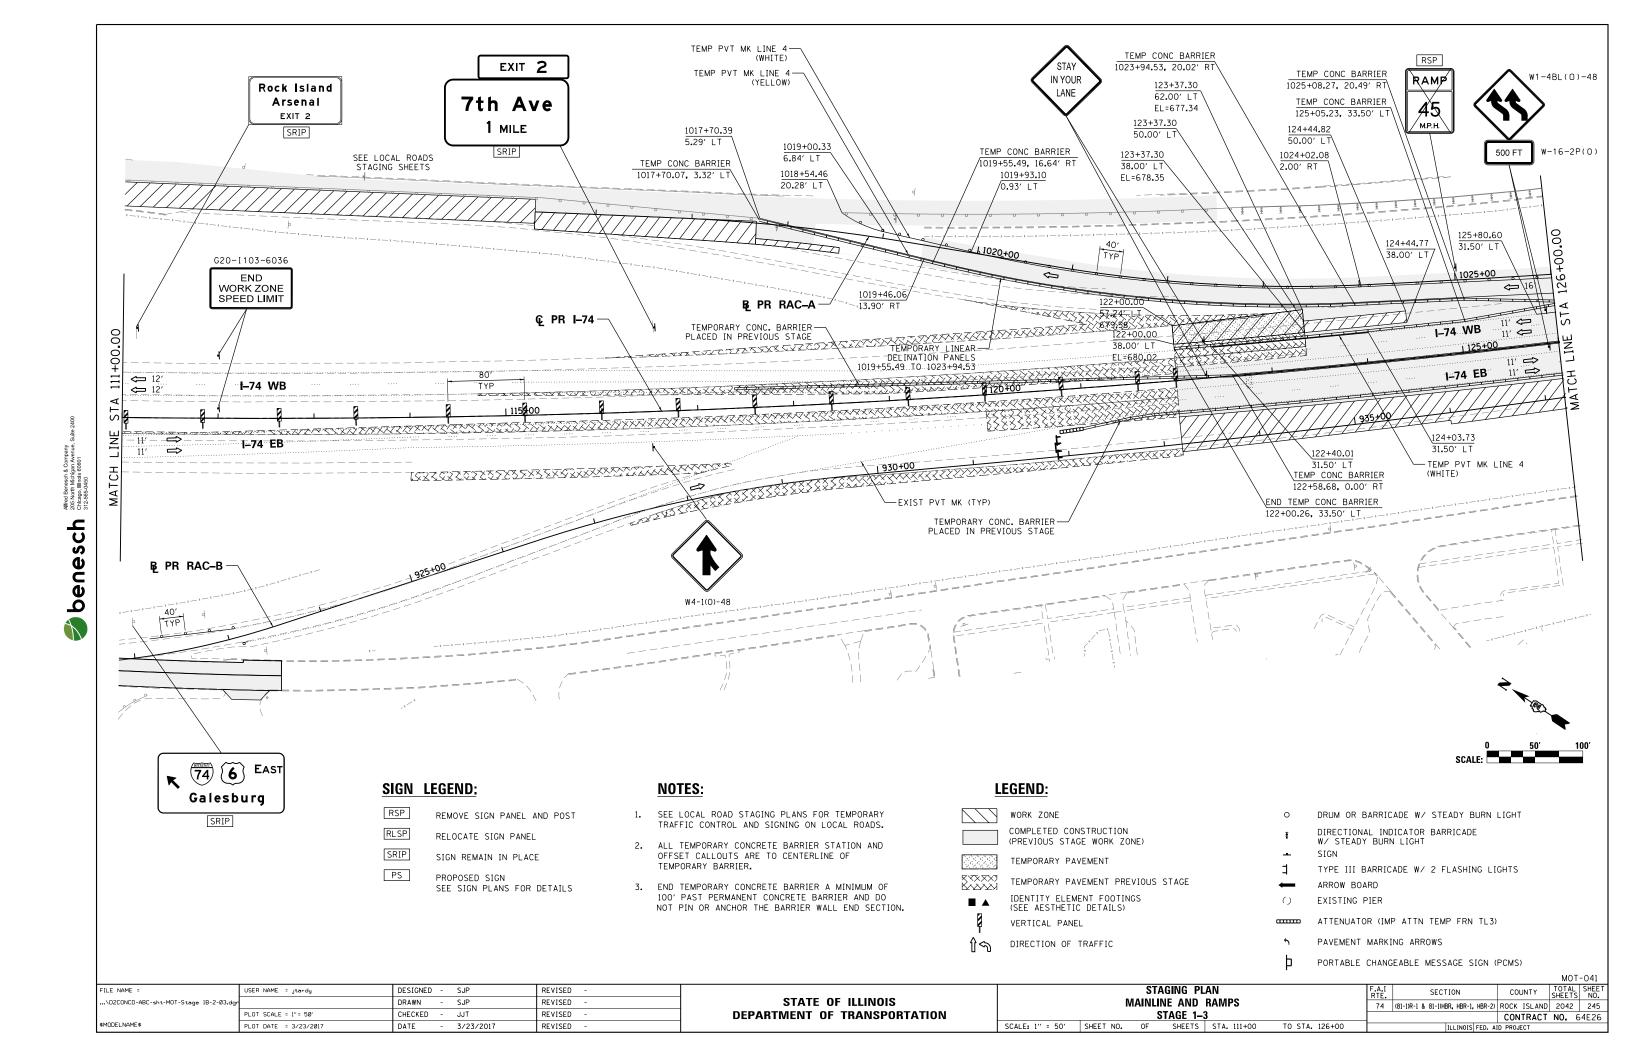


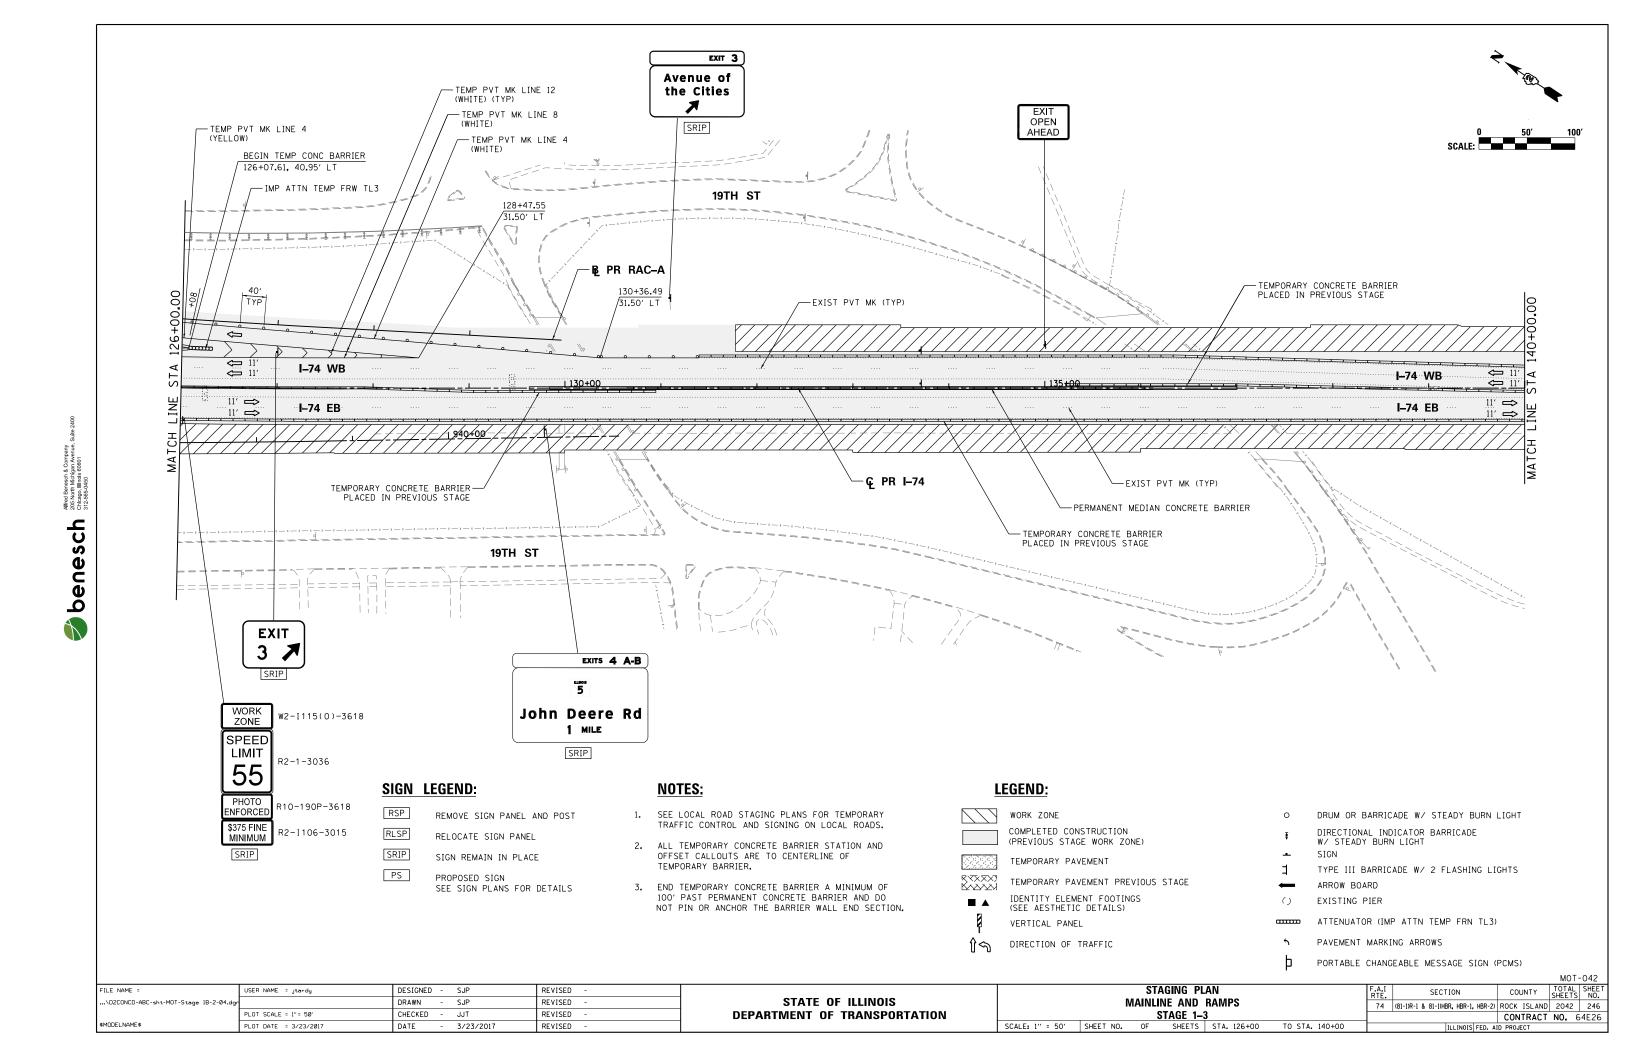


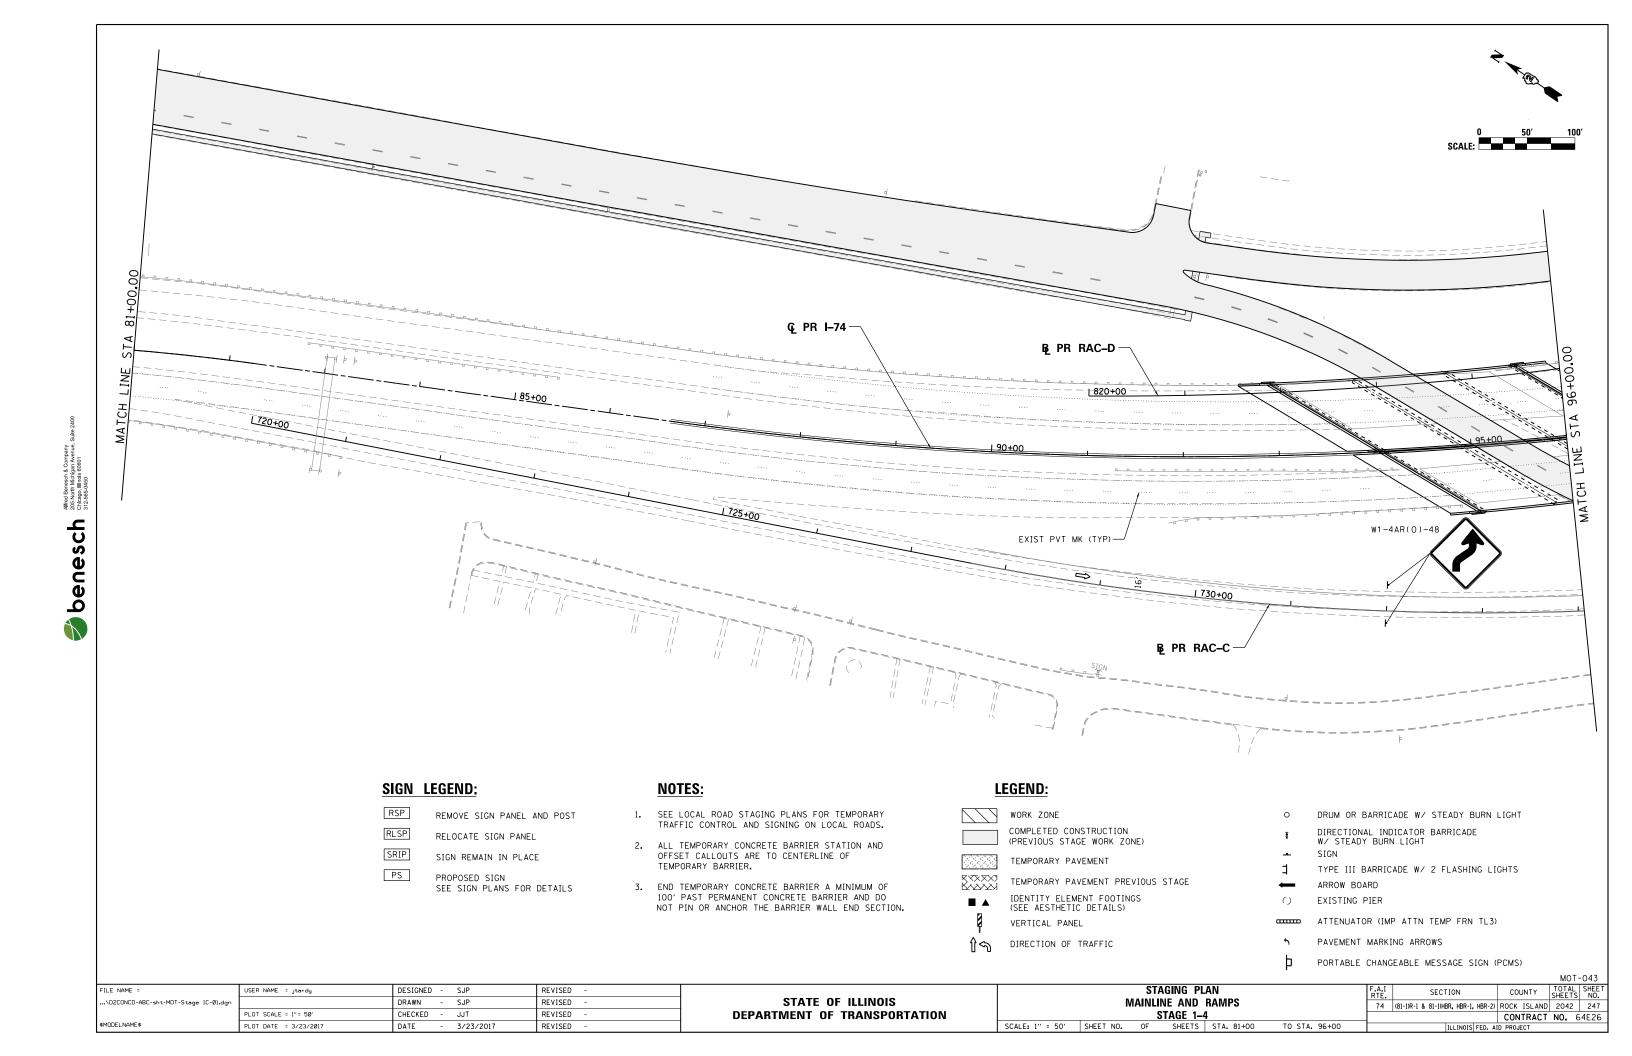

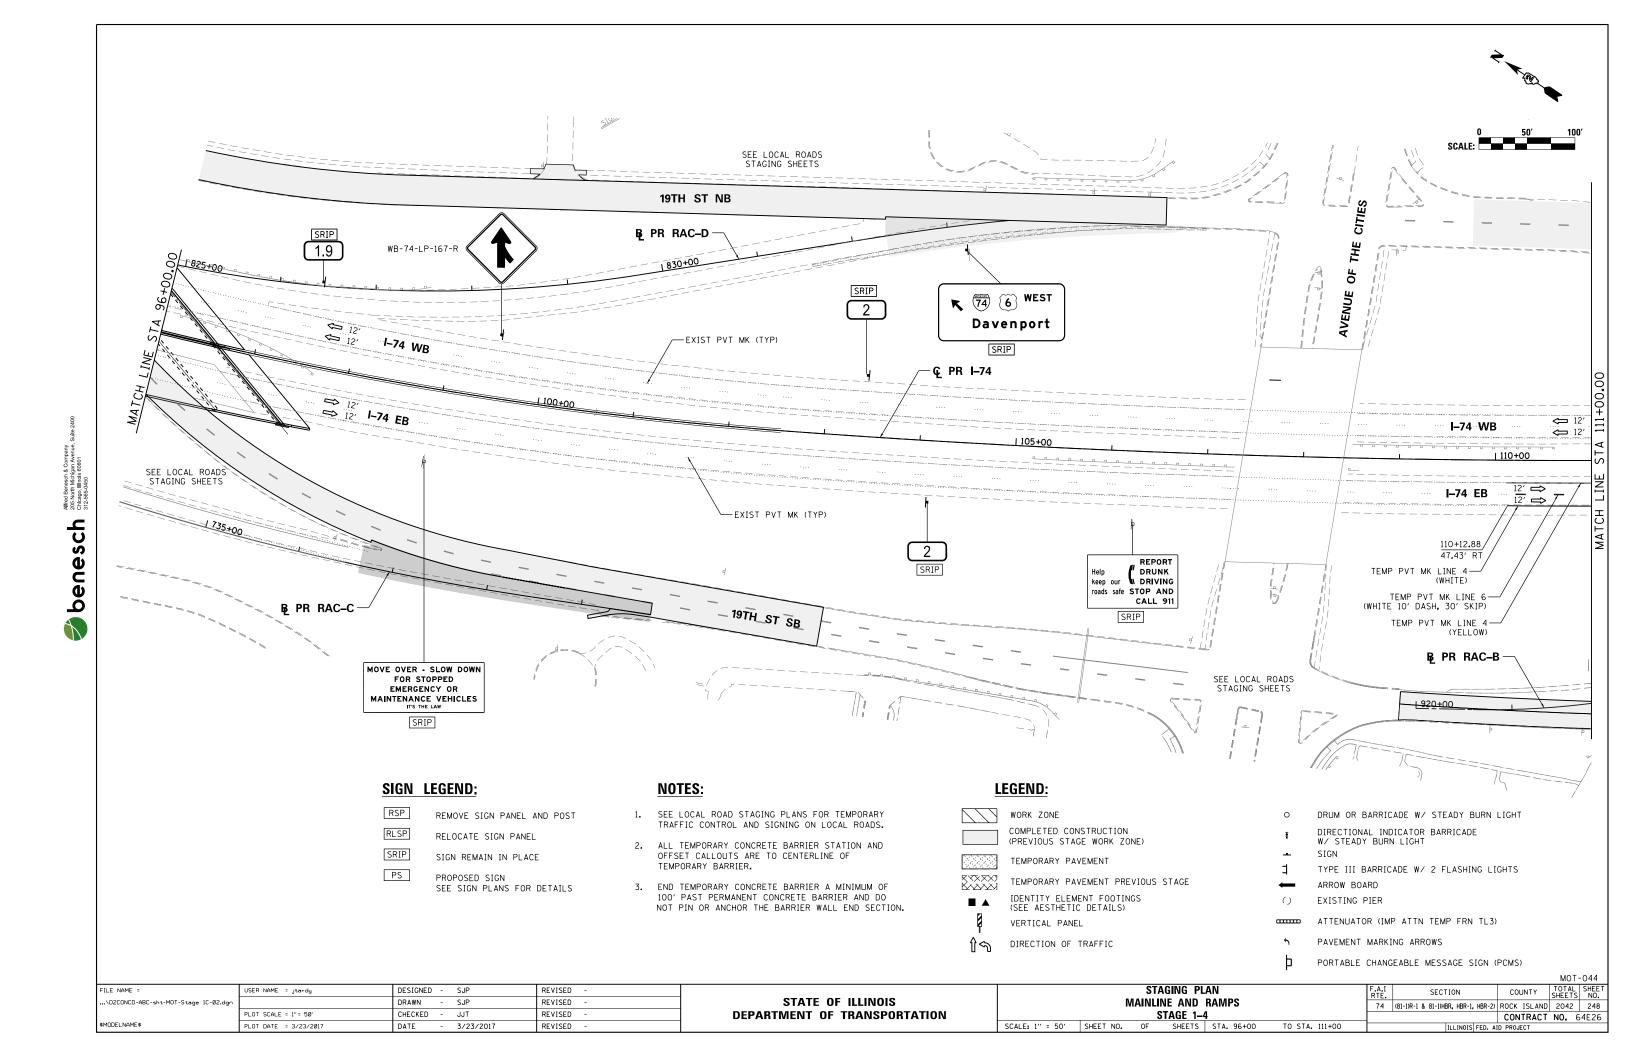


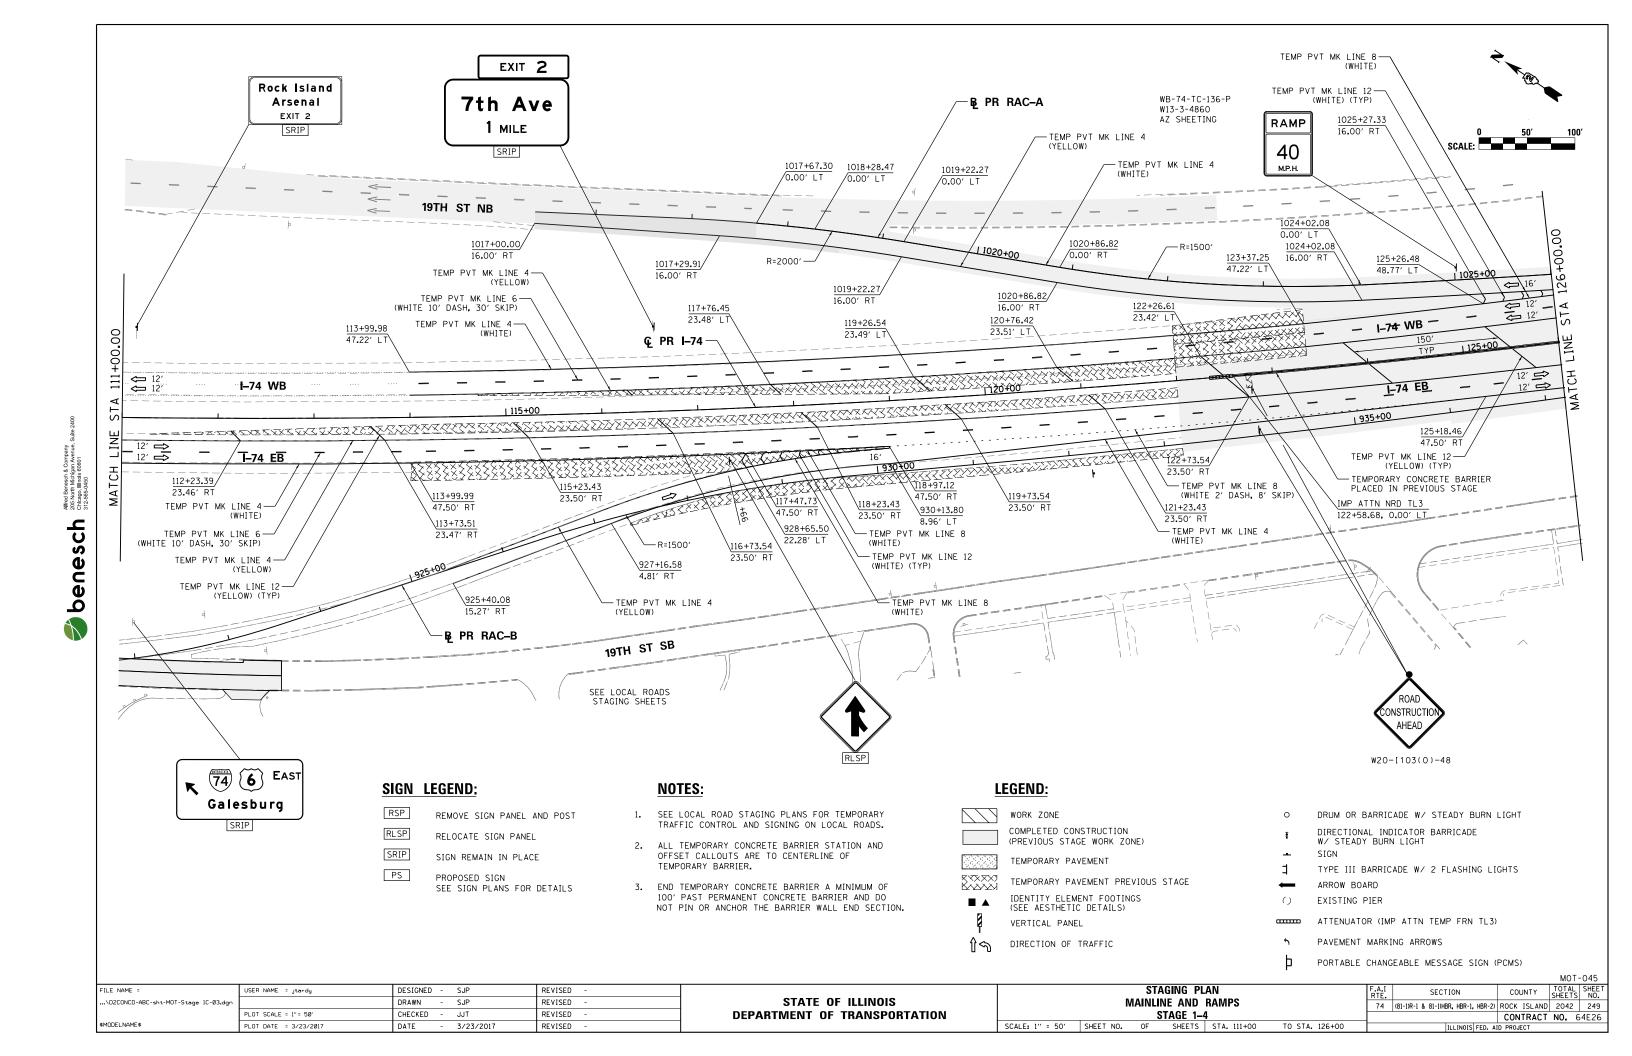


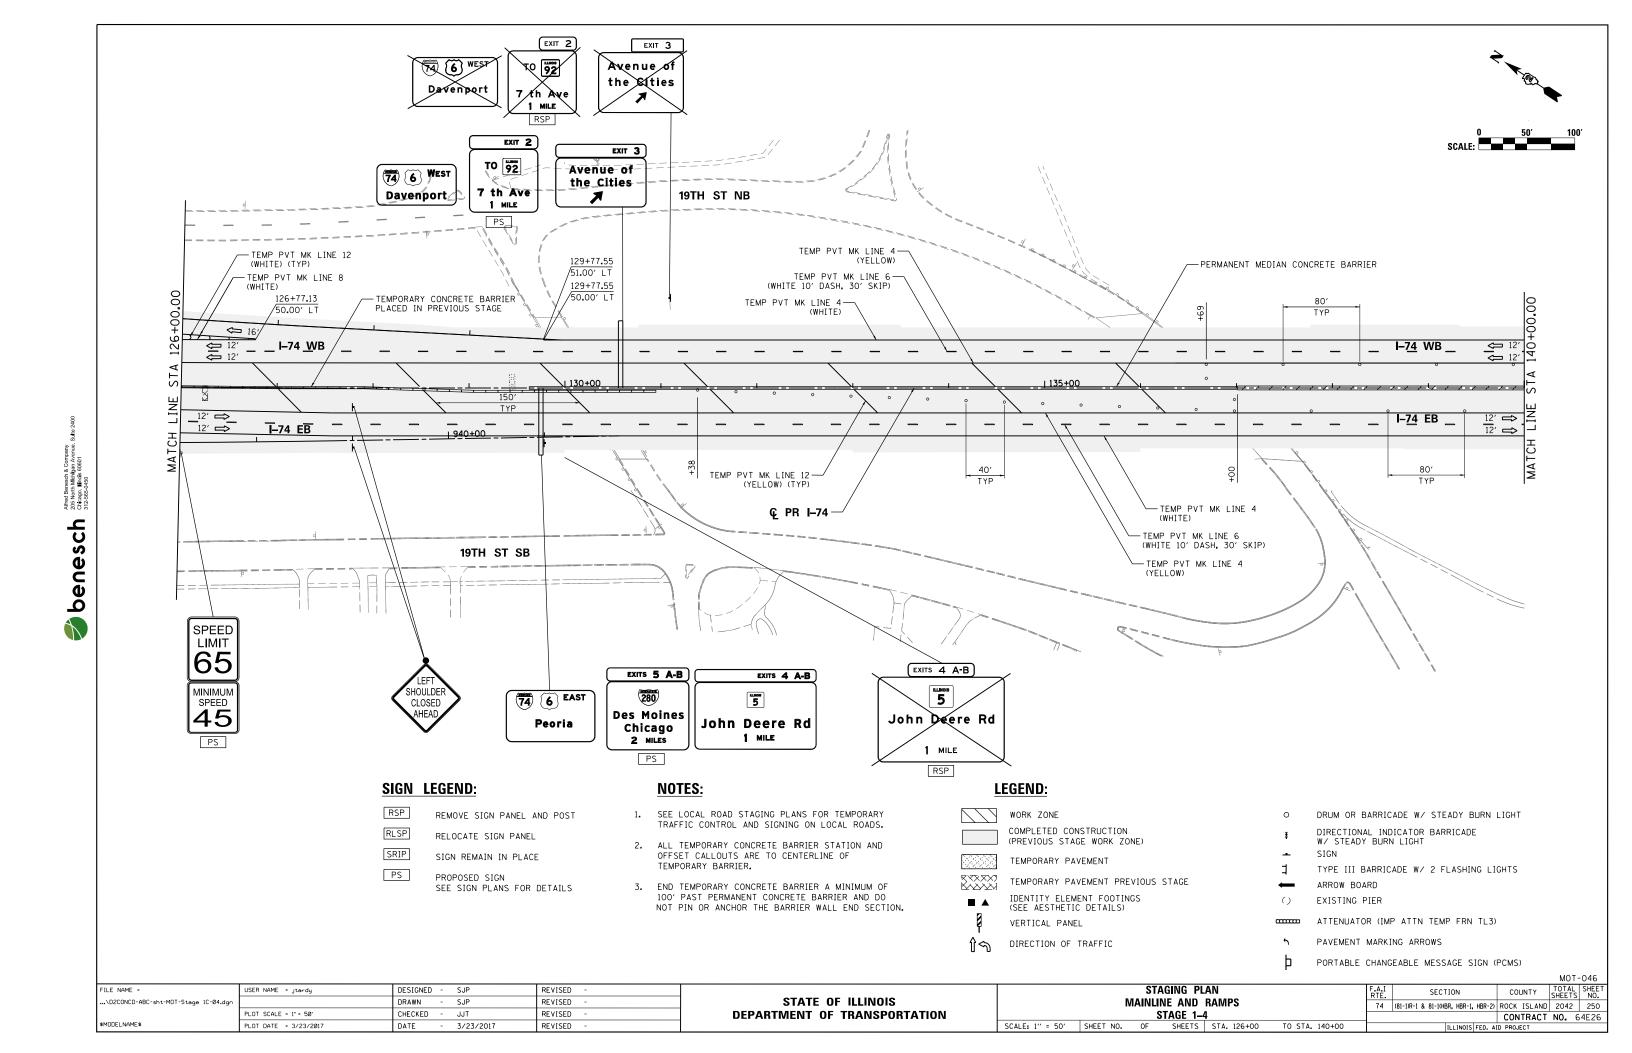


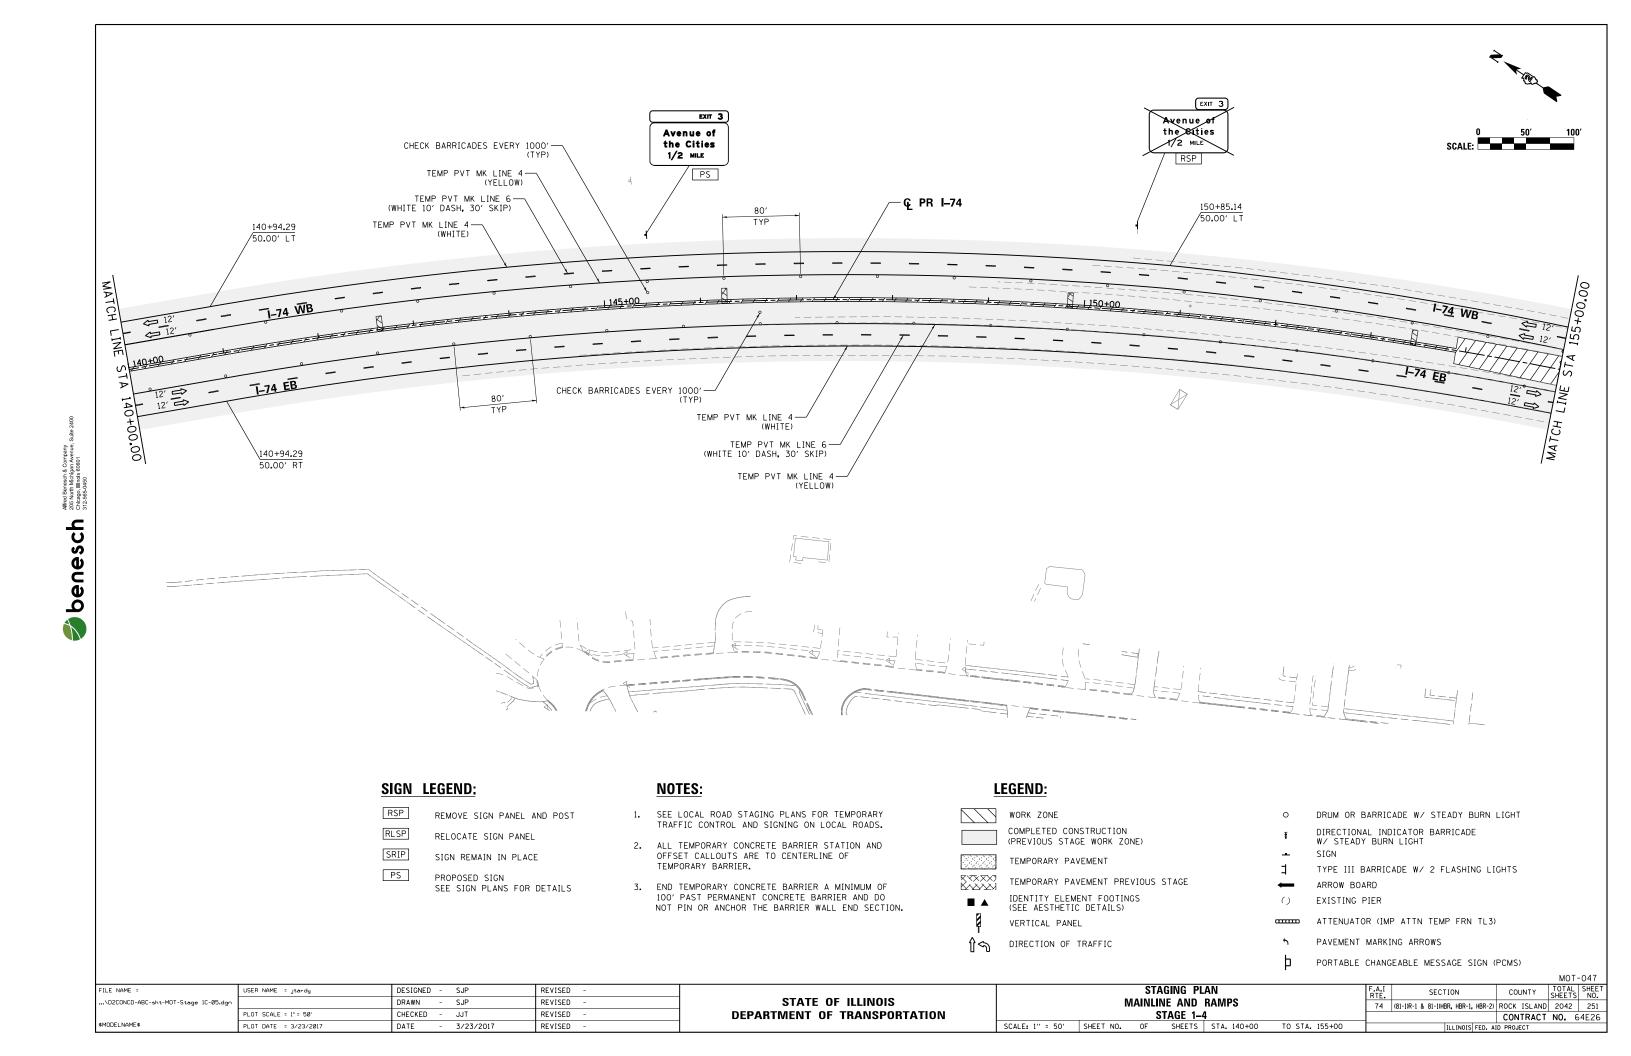



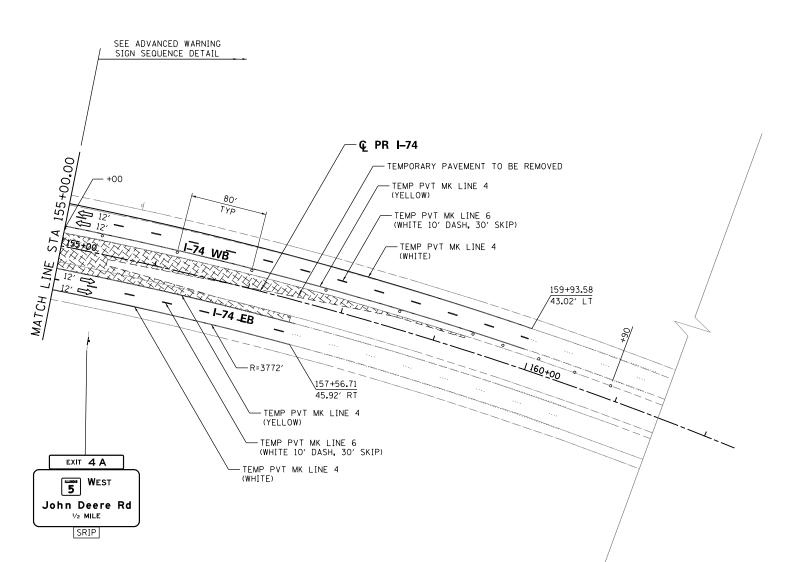

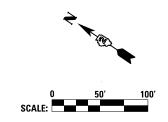

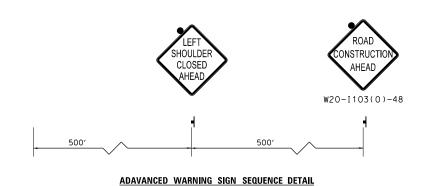

WESTBOUND

SIGN LEGEND:

REMOVE SIGN PANEL AND POST

RELOCATE SIGN PANEL

SRIP SIGN REMAIN IN PLACE

PROPOSED SIGN SEE SIGN PLANS FOR DETAILS

NOTES:

1. SEE LOCAL ROAD STAGING PLANS FOR TEMPORARY TRAFFIC CONTROL AND SIGNING ON LOCAL ROADS.

2. ALL TEMPORARY CONCRETE BARRIER STATION AND OFFSET CALLOUTS ARE TO CENTERLINE OF TEMPORARY BARRIER.

3. END TEMPORARY CONCRETE BARRIER A MINIMUM OF 100' PAST PERMANENT CONCRETE BARRIER AND DO NOT PIN OR ANCHOR THE BARRIER WALL END SECTION.

LEGEND:



WORK ZONE

COMPLETED CONSTRUCTION (PREVIOUS STAGE WORK ZONE)



TEMPORARY PAVEMENT



TEMPORARY PAVEMENT PREVIOUS STAGE IDENTITY ELEMENT FOOTINGS (SEE AESTHETIC DETAILS)



VERTICAL PANEL

Ŷ\ DIRECTION OF TRAFFIC DRUM OR BARRICADE W/ STEADY BURN LIGHT

DIRECTIONAL INDICATOR BARRICADE W/ STEADY BURN LIGHT

SIGN

TYPE III BARRICADE W/ 2 FLASHING LIGHTS

ARROW BOARD EXISTING PIER

ATTENUATOR (IMP ATTN TEMP FRN TL3)

PAVEMENT MARKING ARROWS


PORTABLE CHANGEABLE MESSAGE SIGN (PCMS)


TY	TOTAL SHEETS	SHEET NO.
		050


MOT-048


DESIGNED - SJP STAGING PLAN USER NAME = jtardy REVISED FILE NAME = SECTION COUNT STATE OF ILLINOIS ...\D2CONCD-ABC-sht-MOT-Stage 1C-06.dgr DRAWN SJP REVISED **MAINLINE AND RAMPS** 74 (81-1)R-1 & 81-1(HBR, HBR-1, HBR-2) ROCK ISLAND 2042 252 STAGE 1-4


SCALE: 1" = 50' SHEET NO. OF SHEETS STA. 155+00 PLOT SCALE = 1" = 50" CHECKED JJT REVISED **DEPARTMENT OF TRANSPORTATION** CONTRACT NO. 64E26 \$MODELNAME\$ TO STA. PLOT DATE = 3/23/2017 DATE 3/23/2017 REVISED

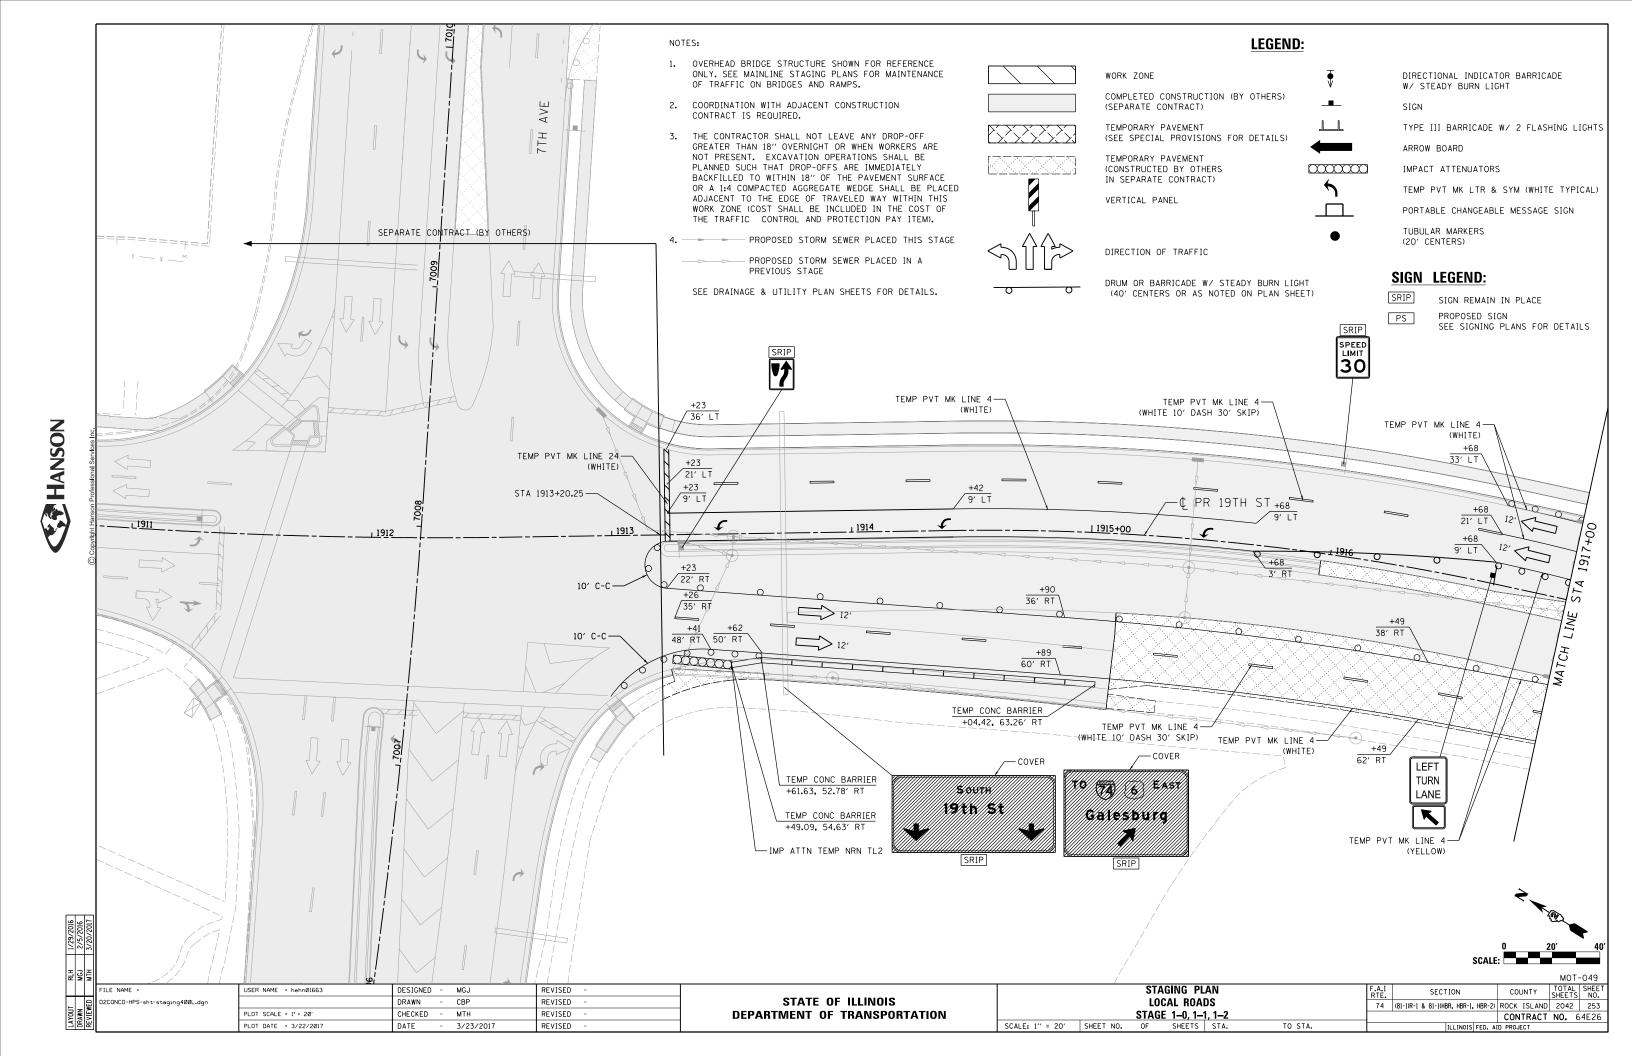


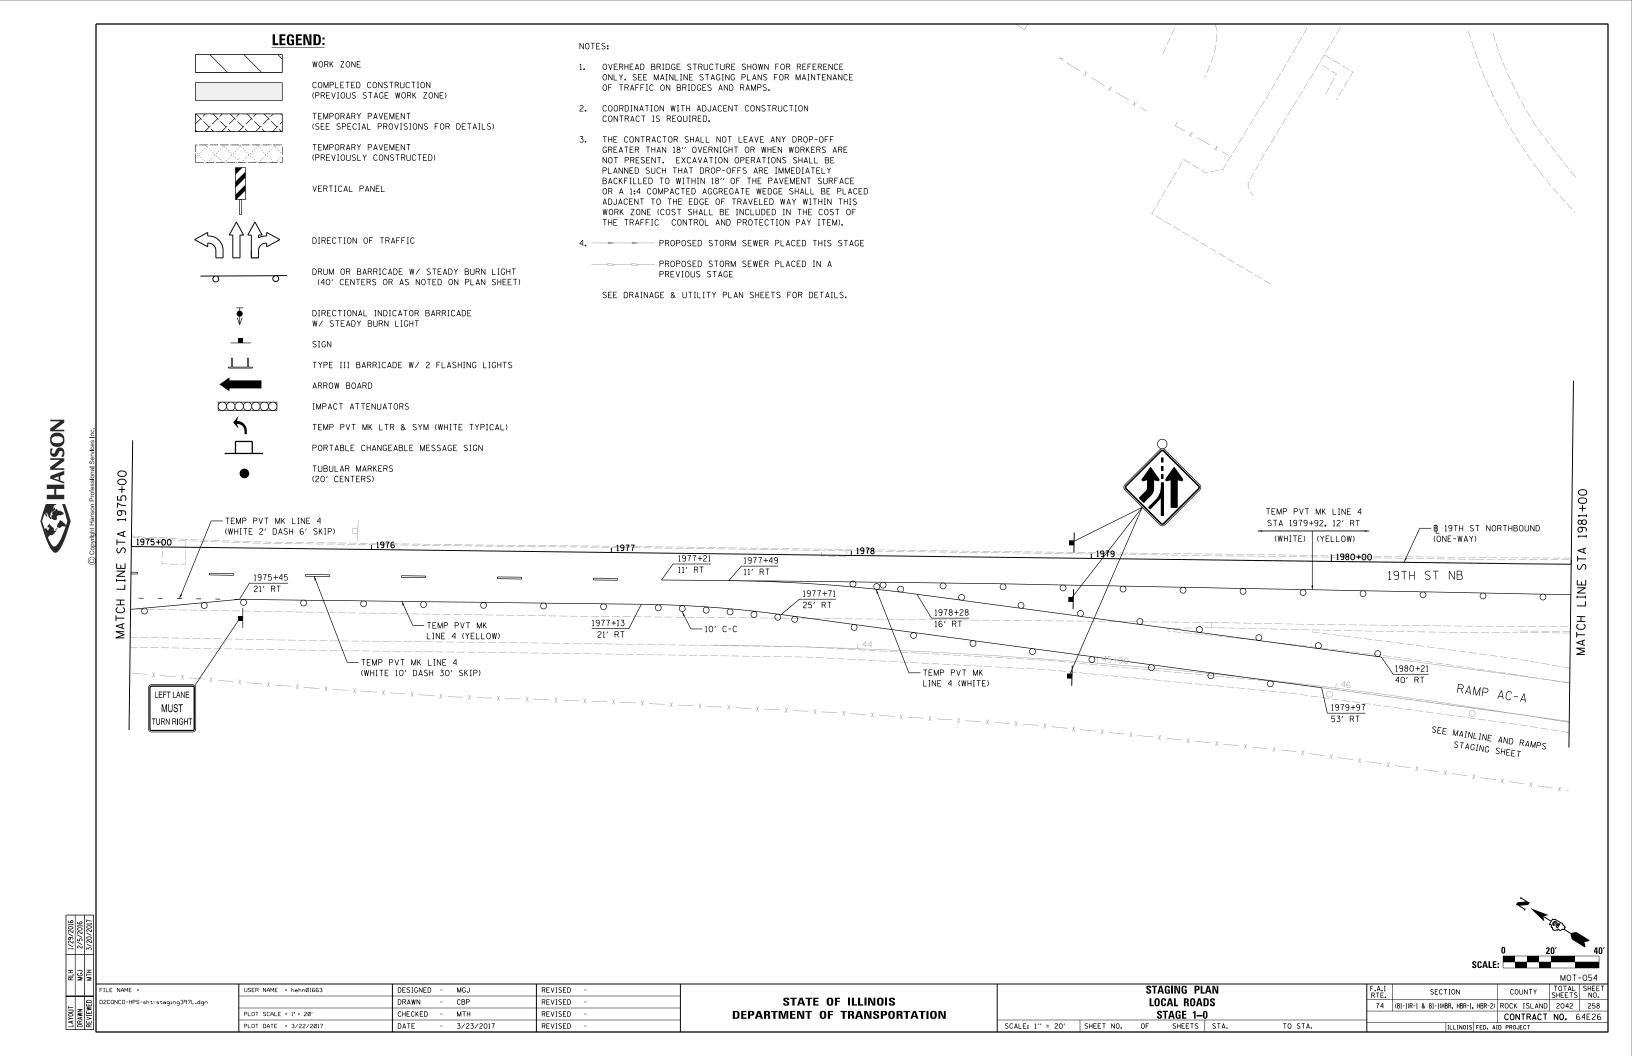

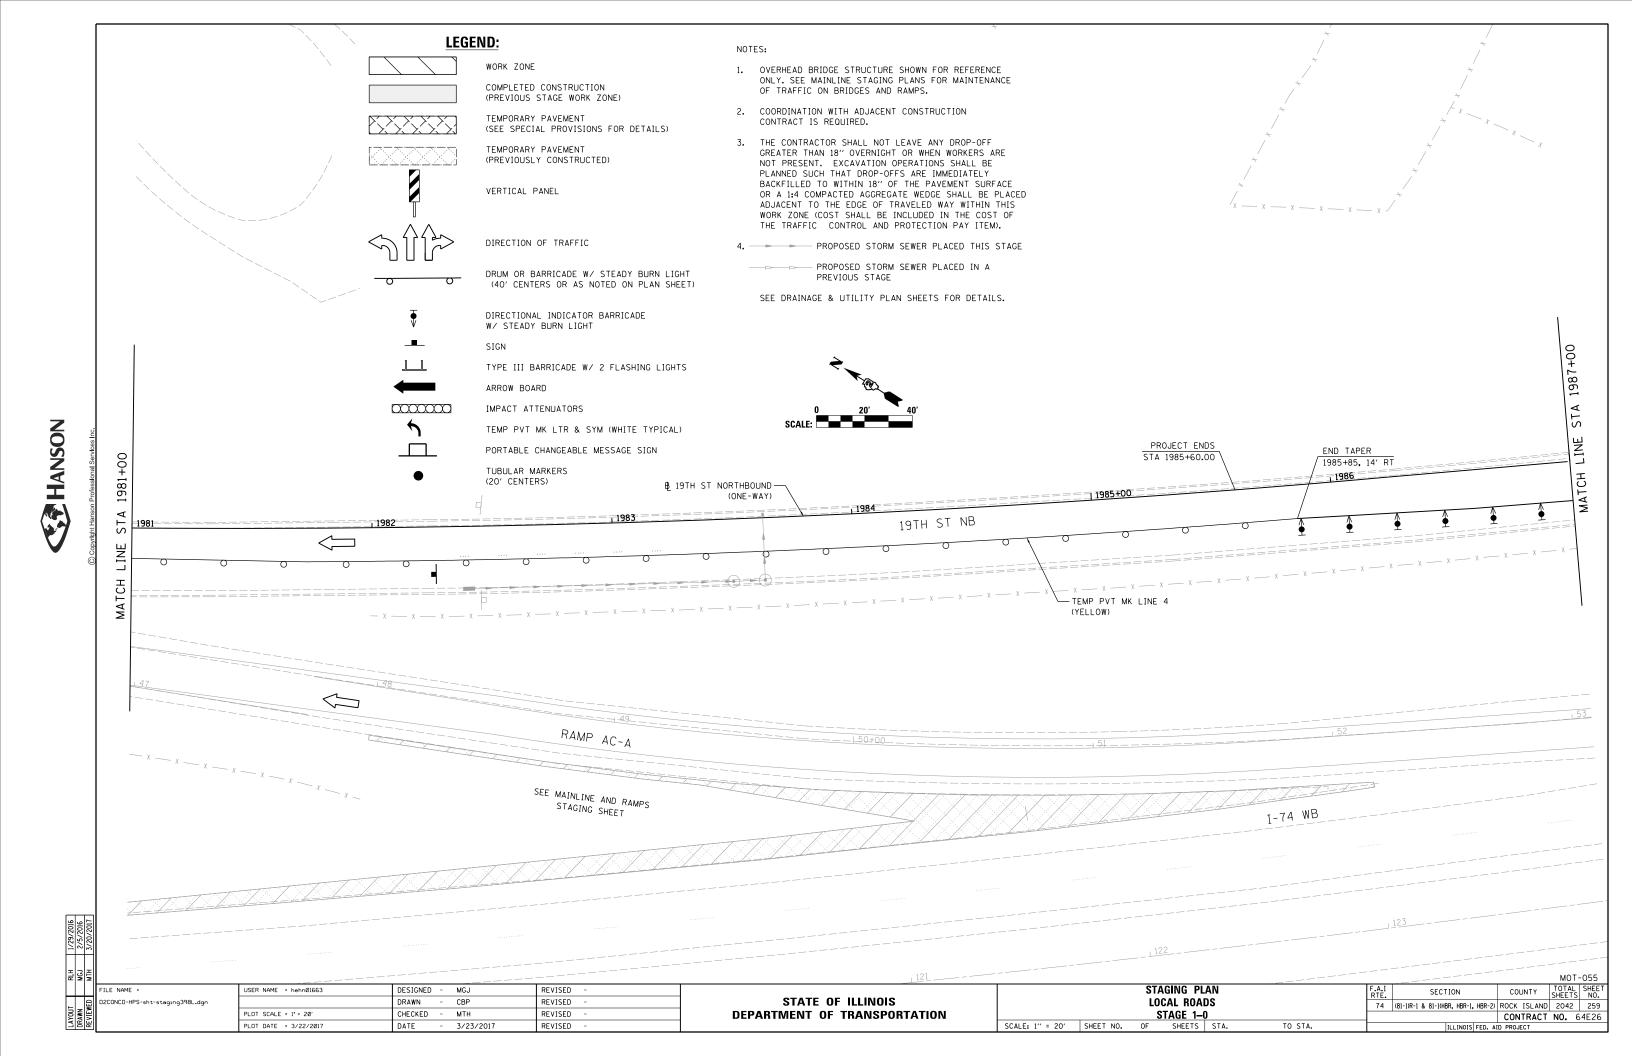


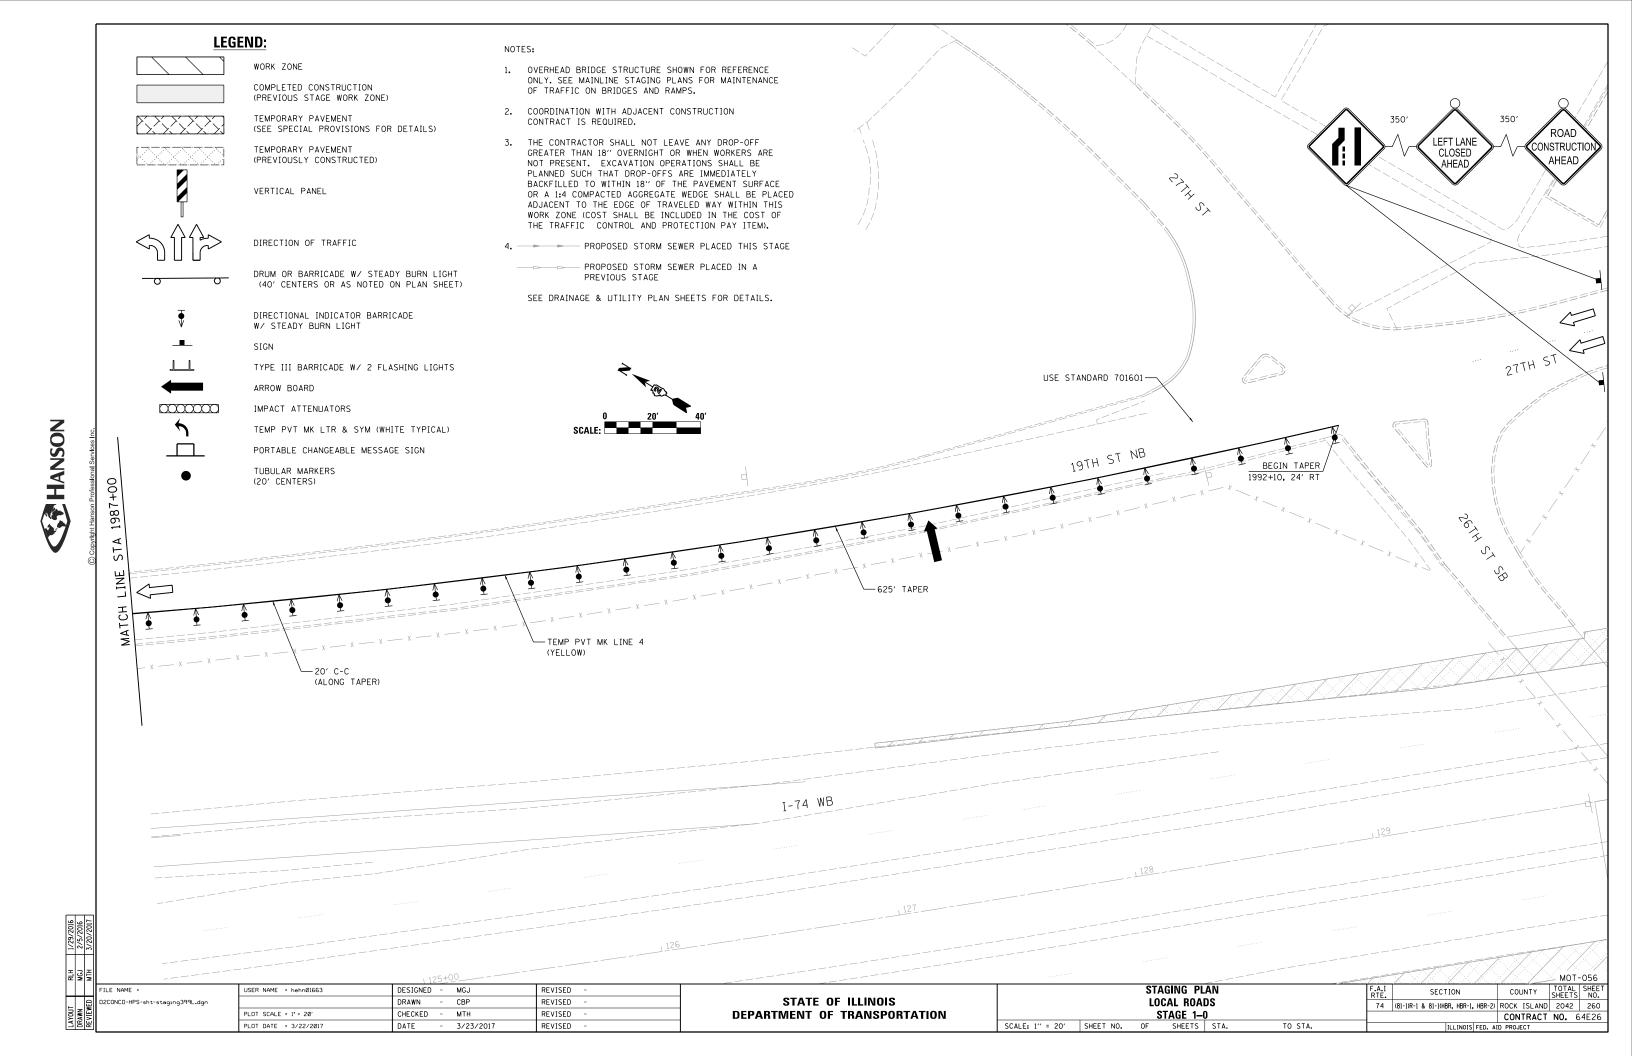

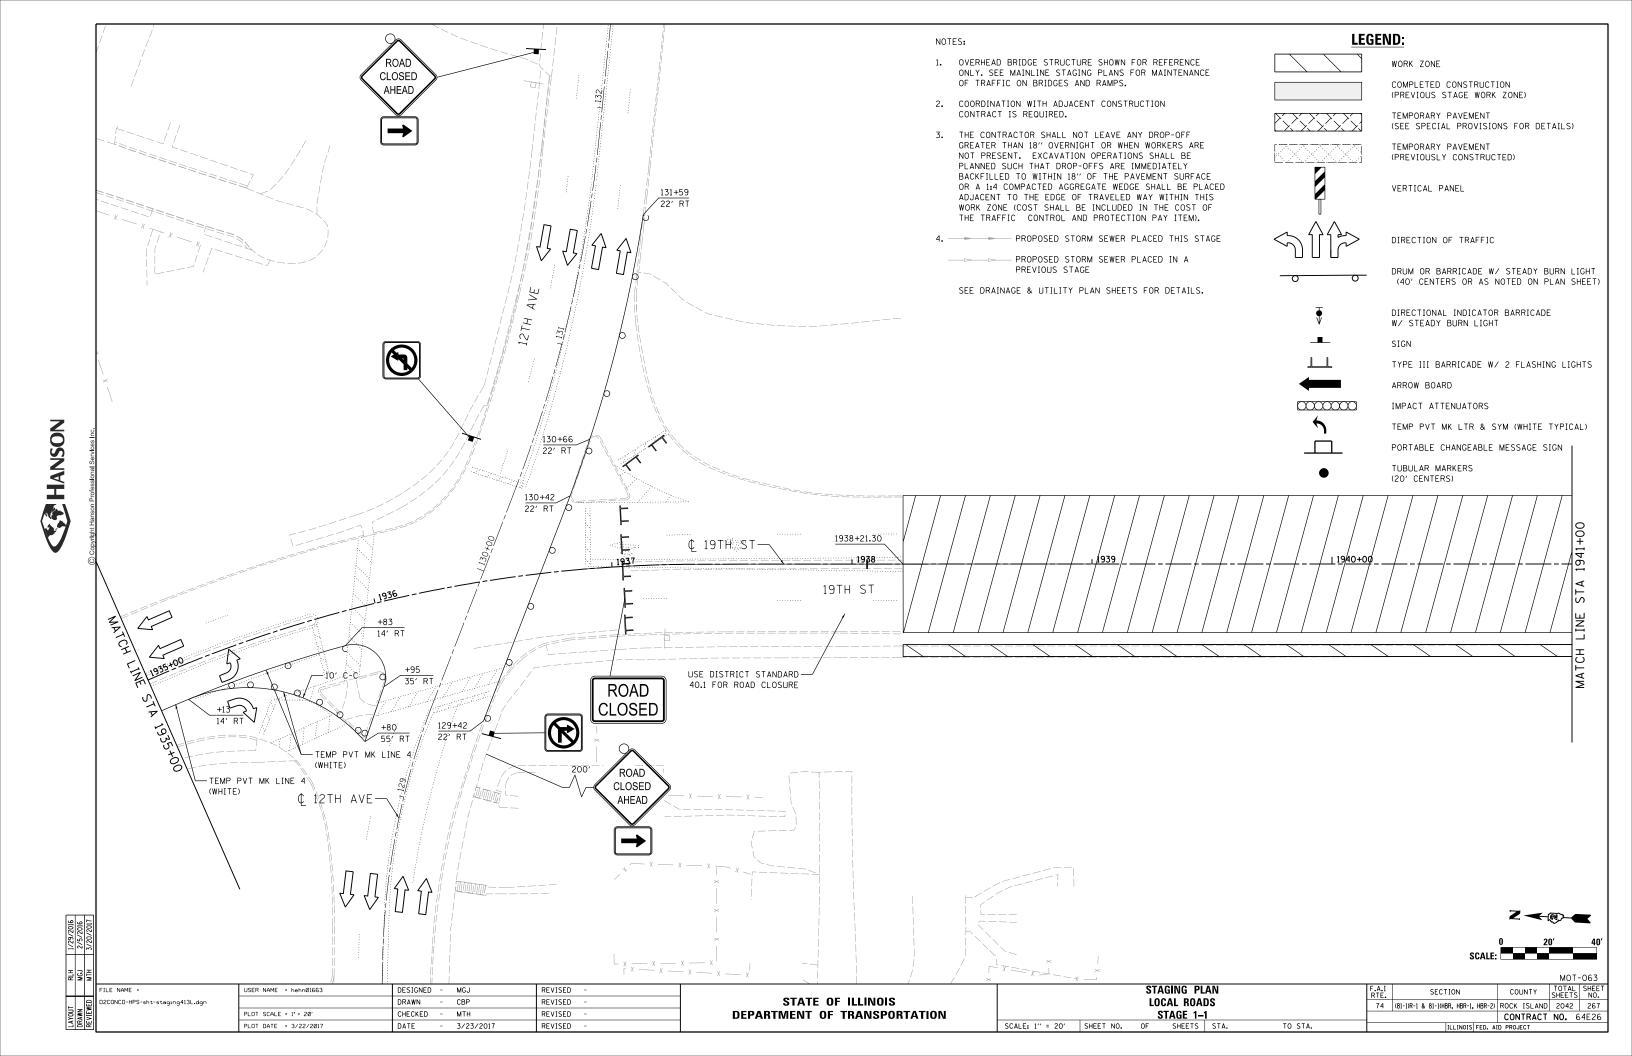


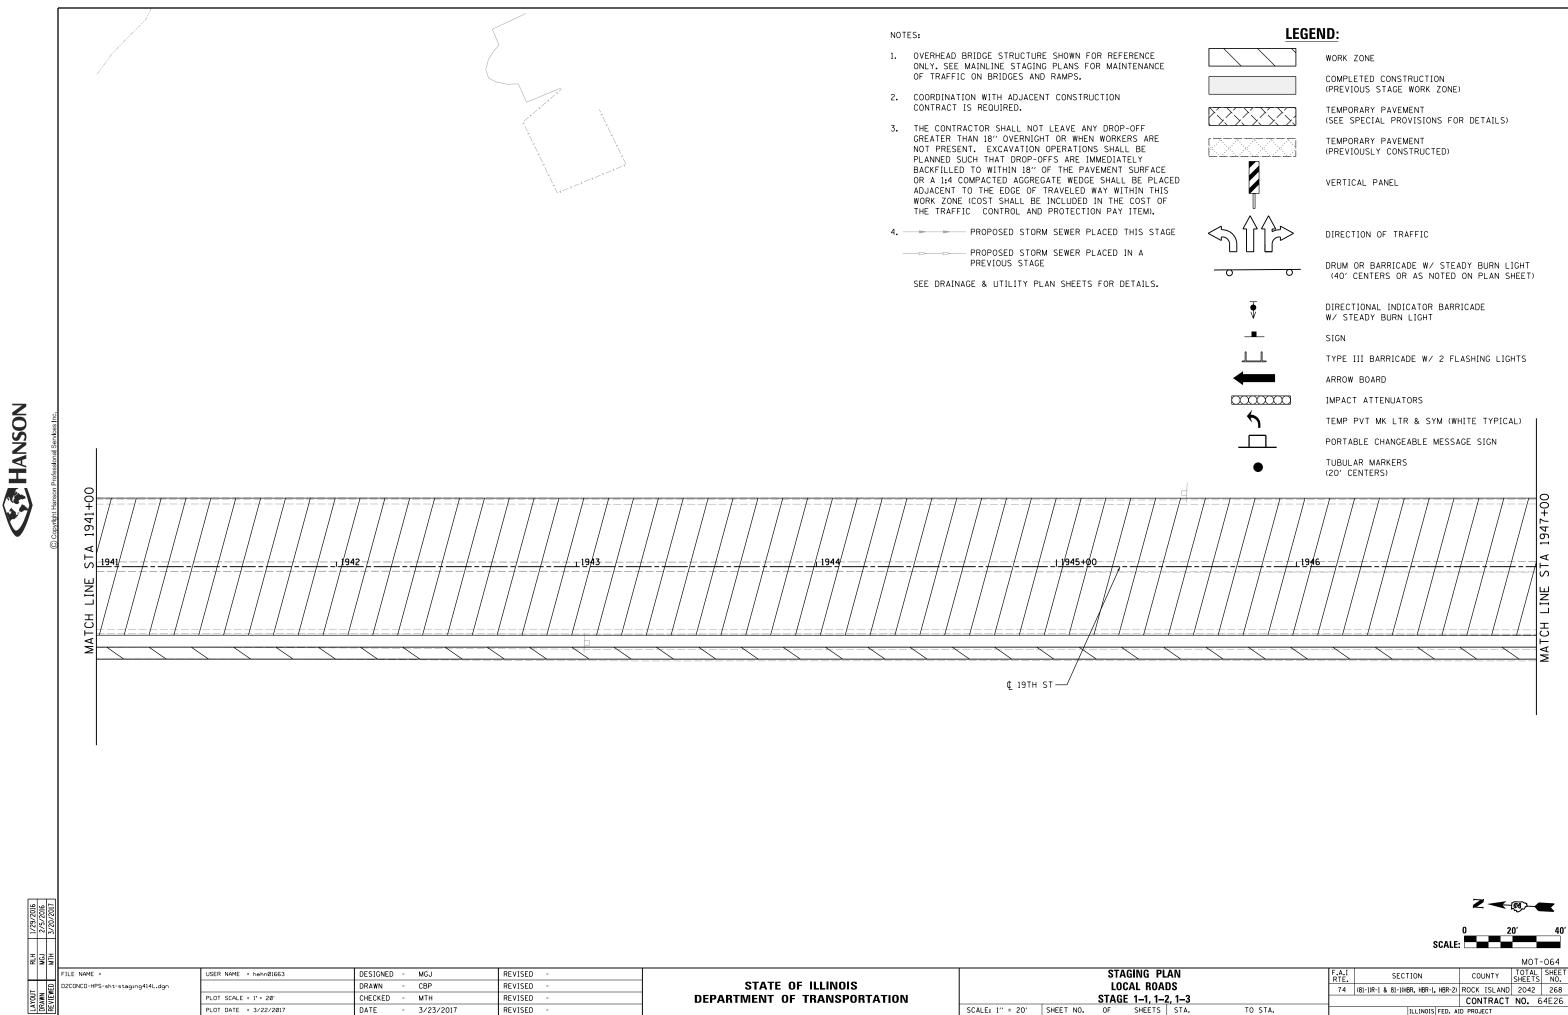



TO STA.

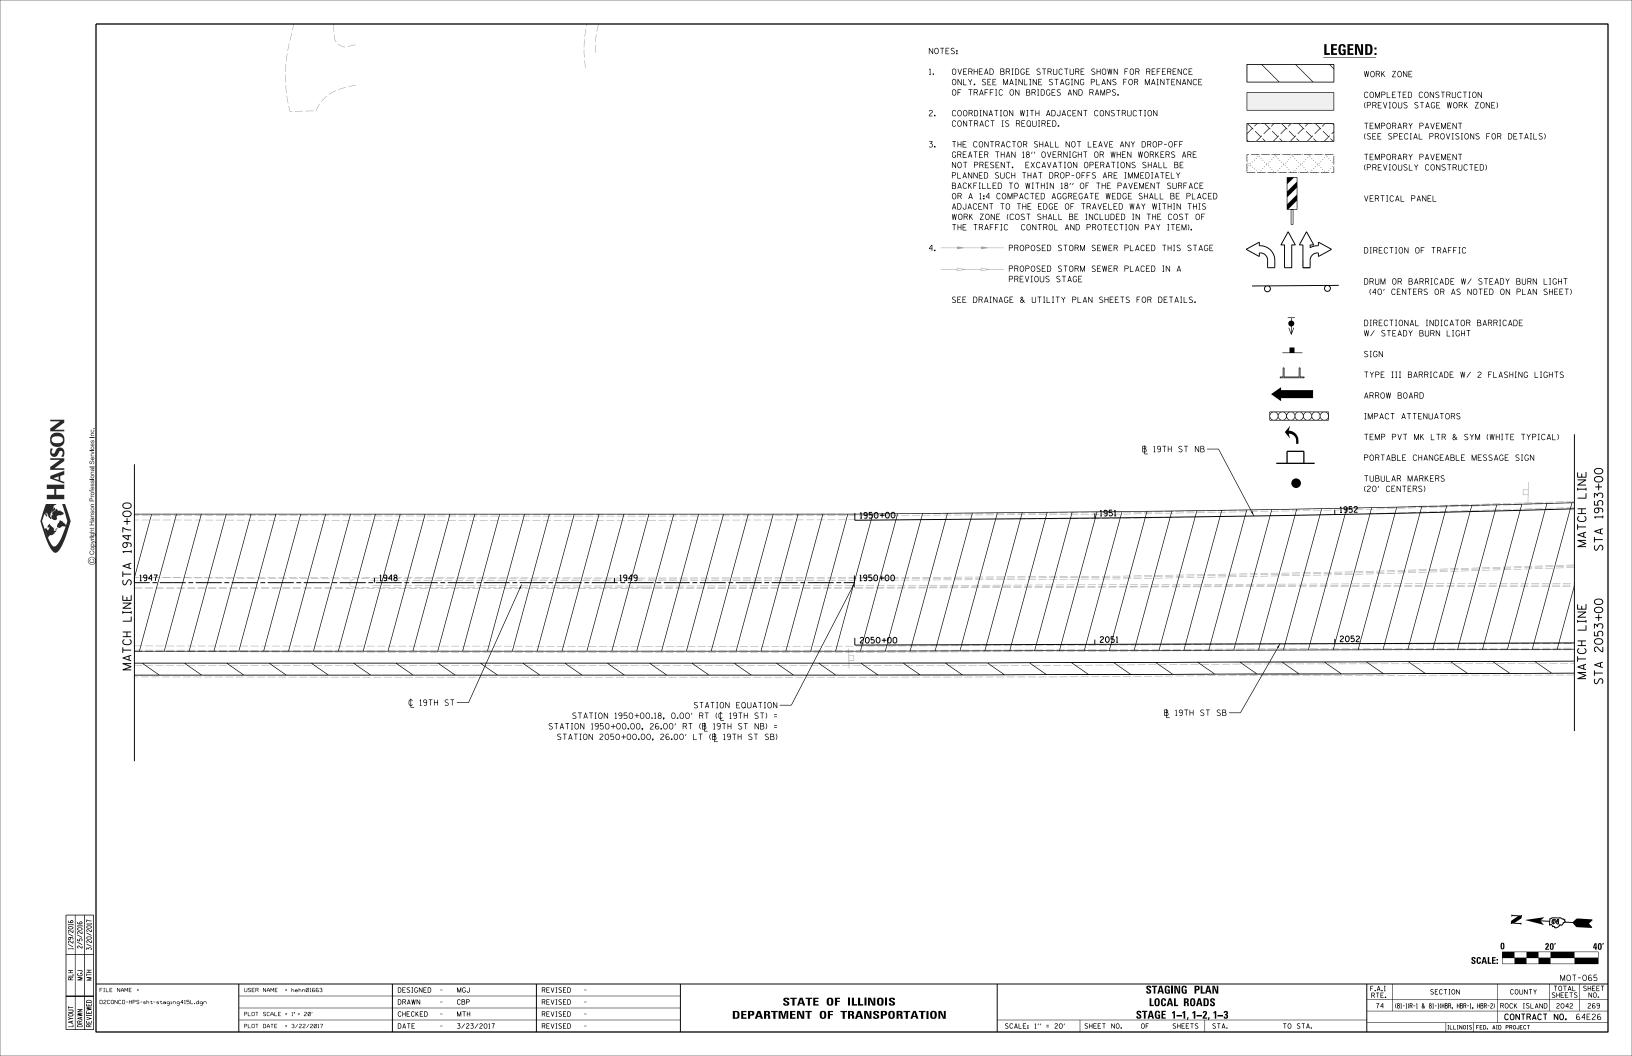

HANSON

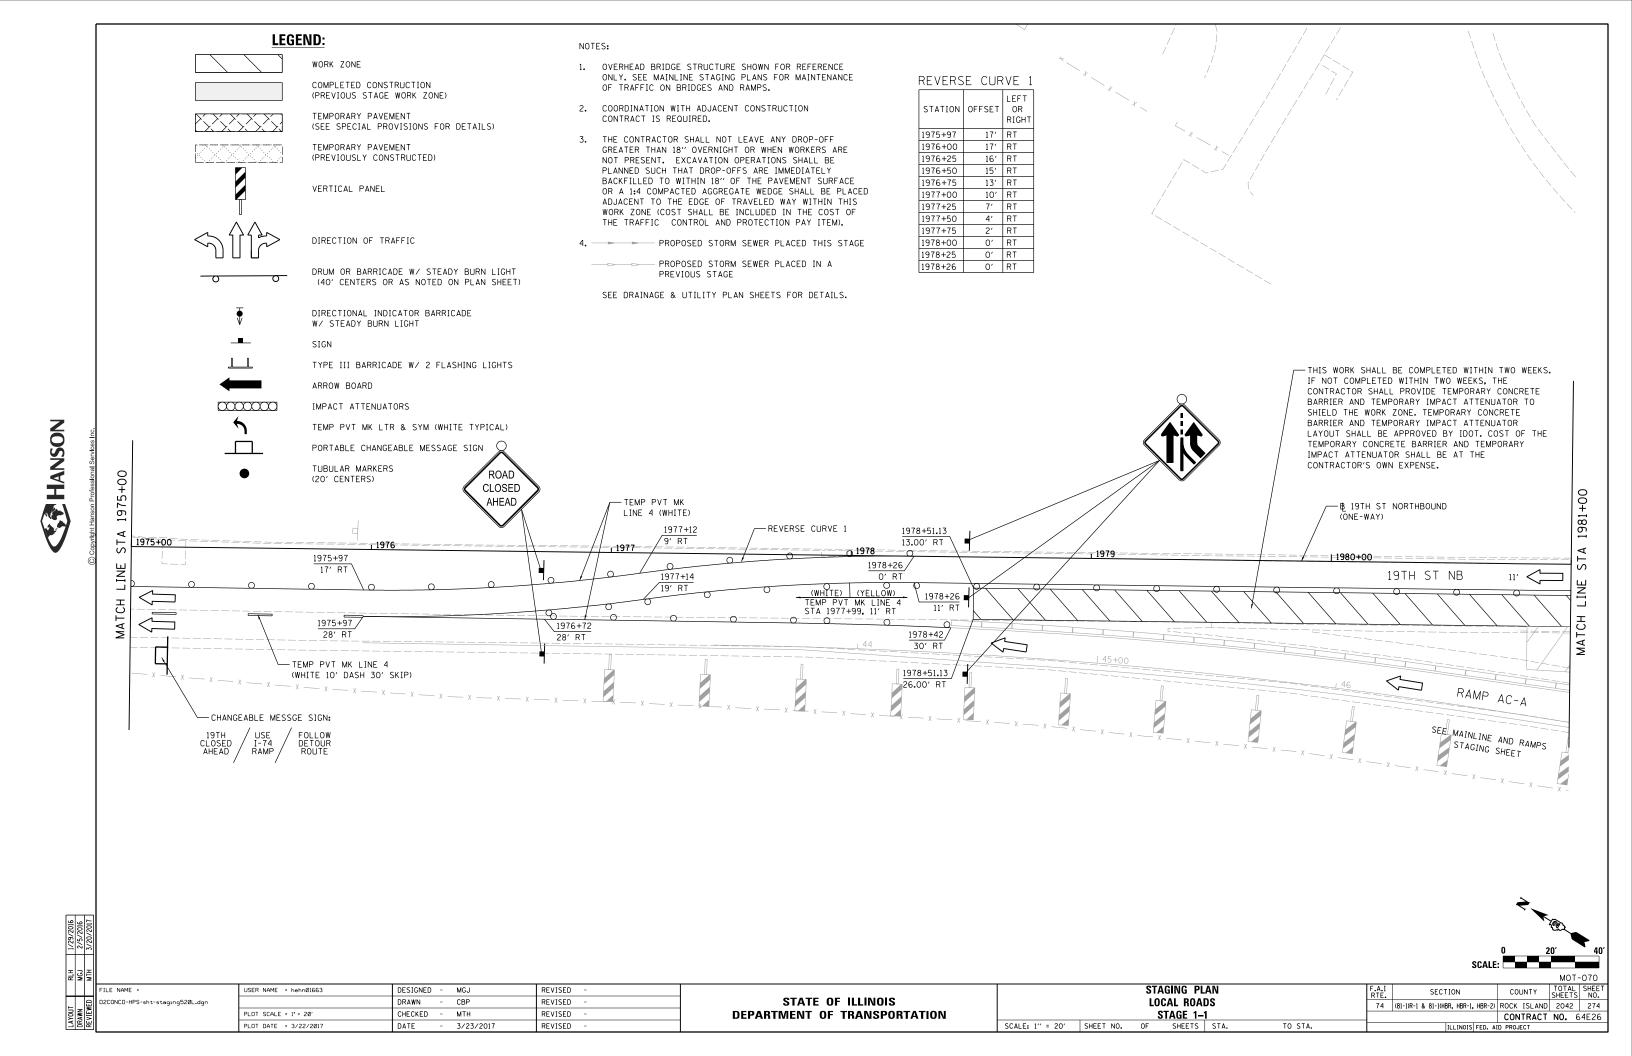

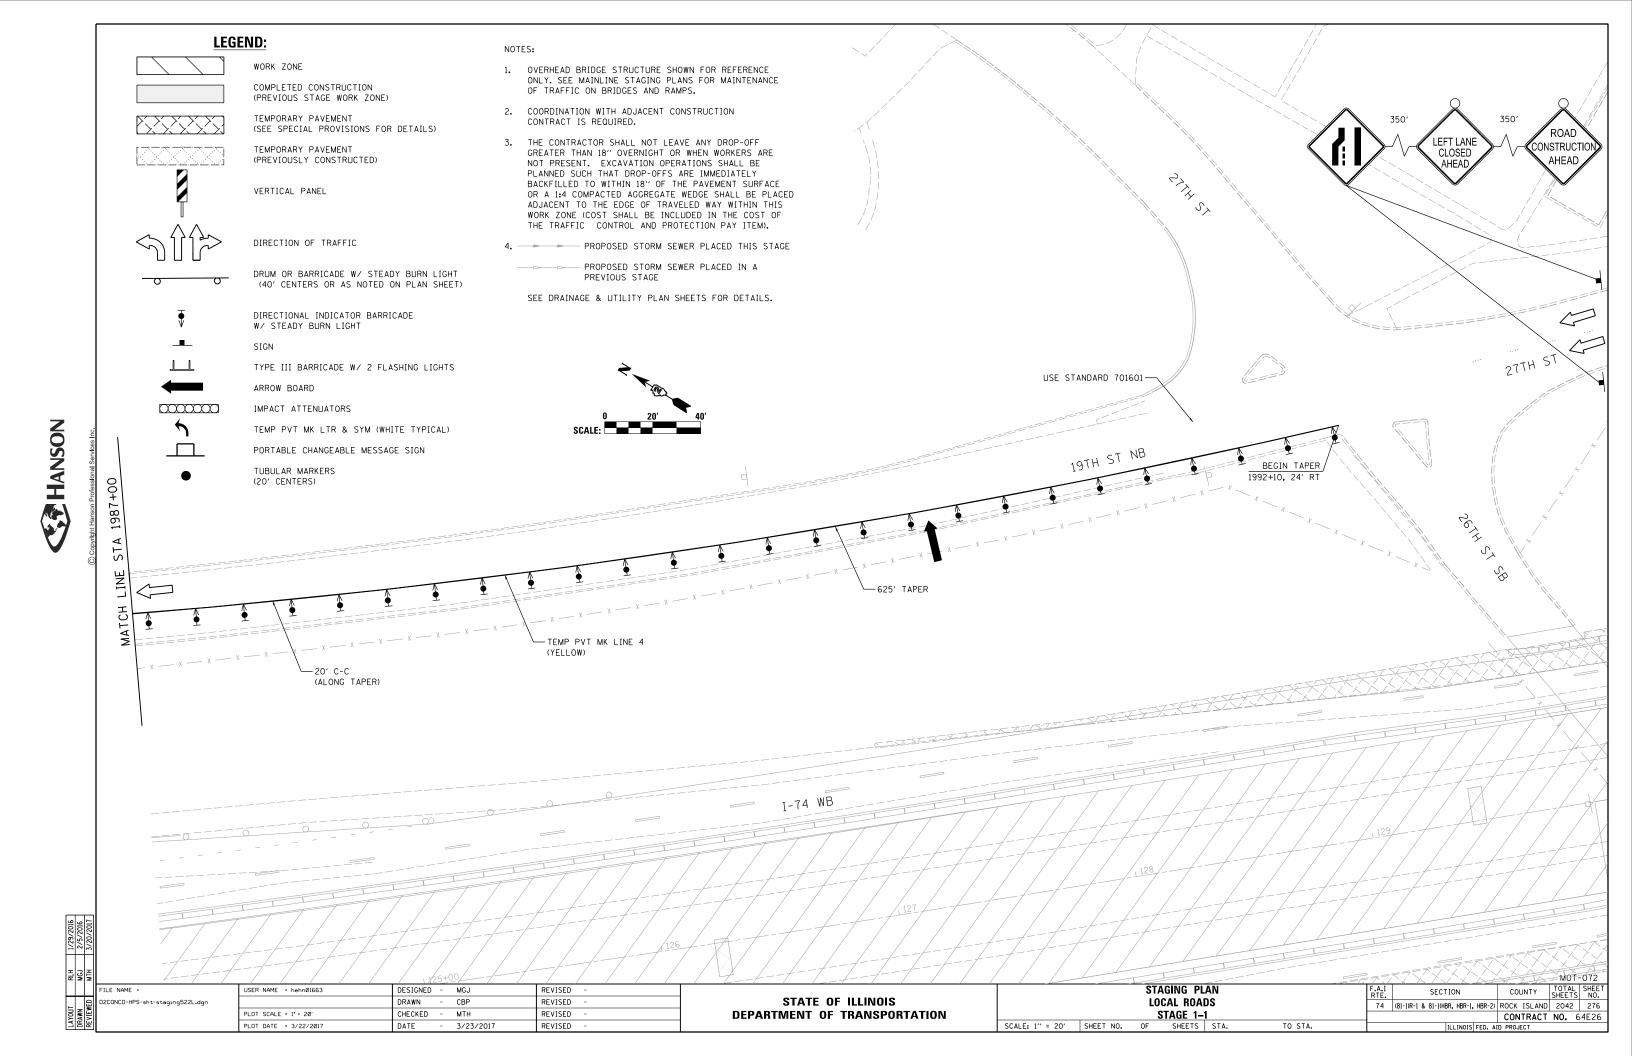

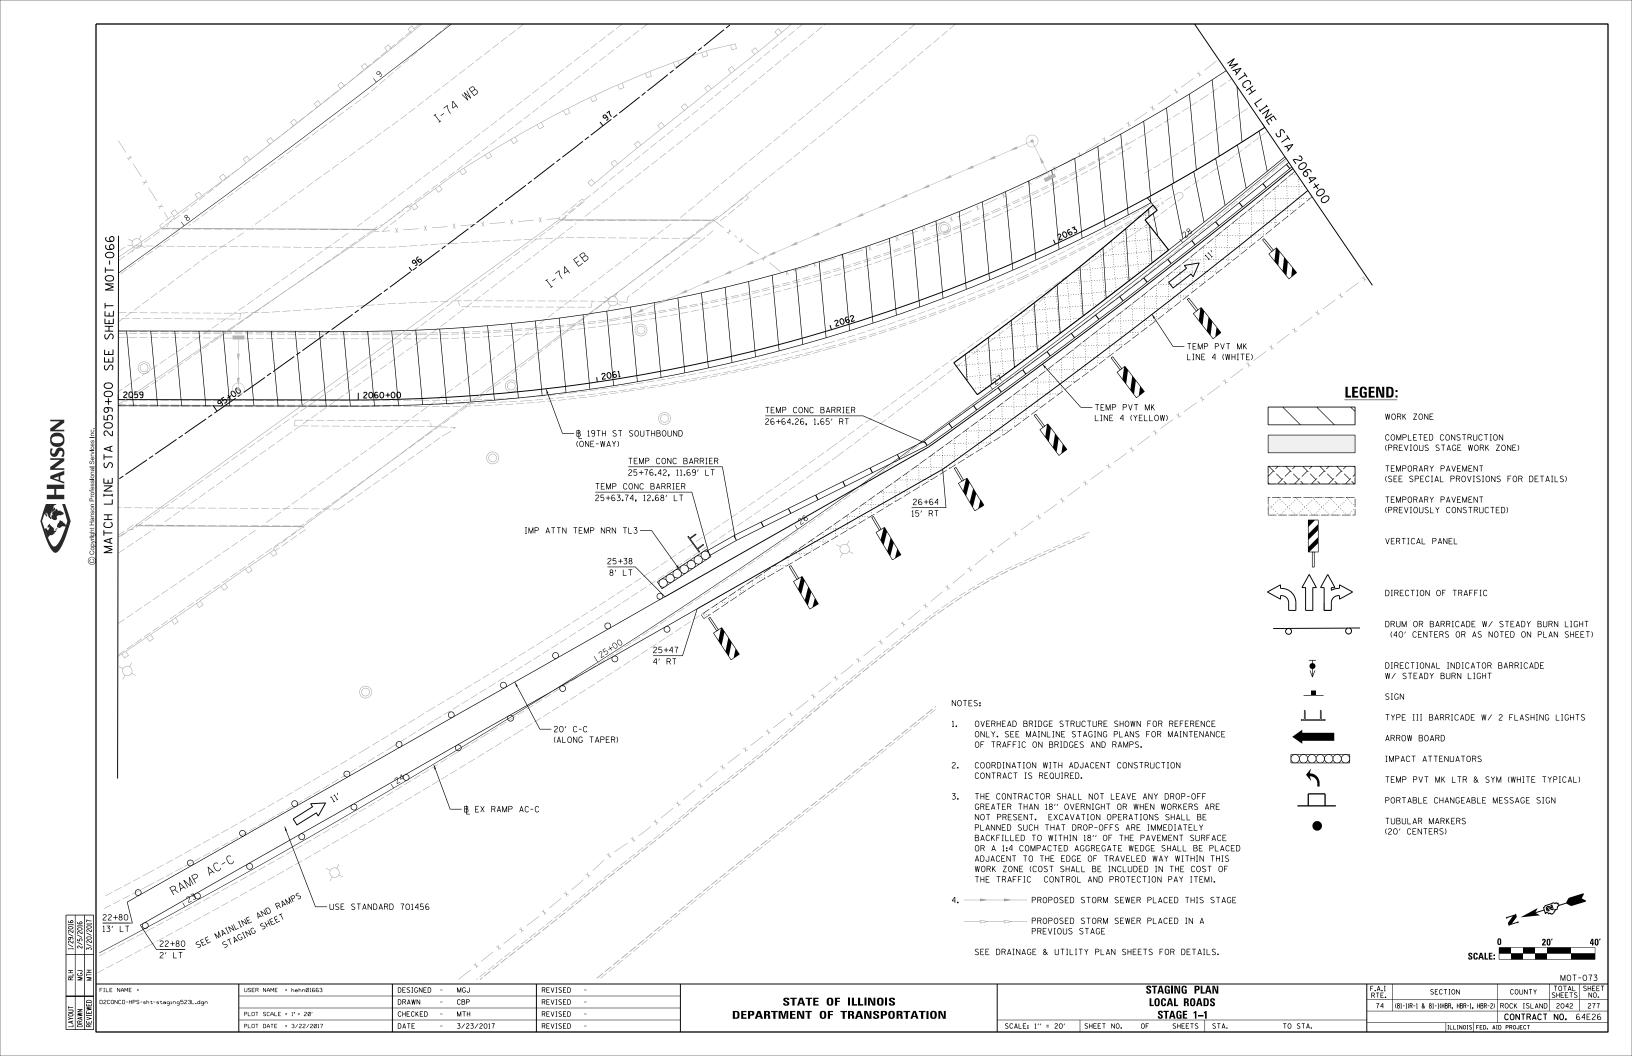

PLOT DATE = 3/22/2017

DATE


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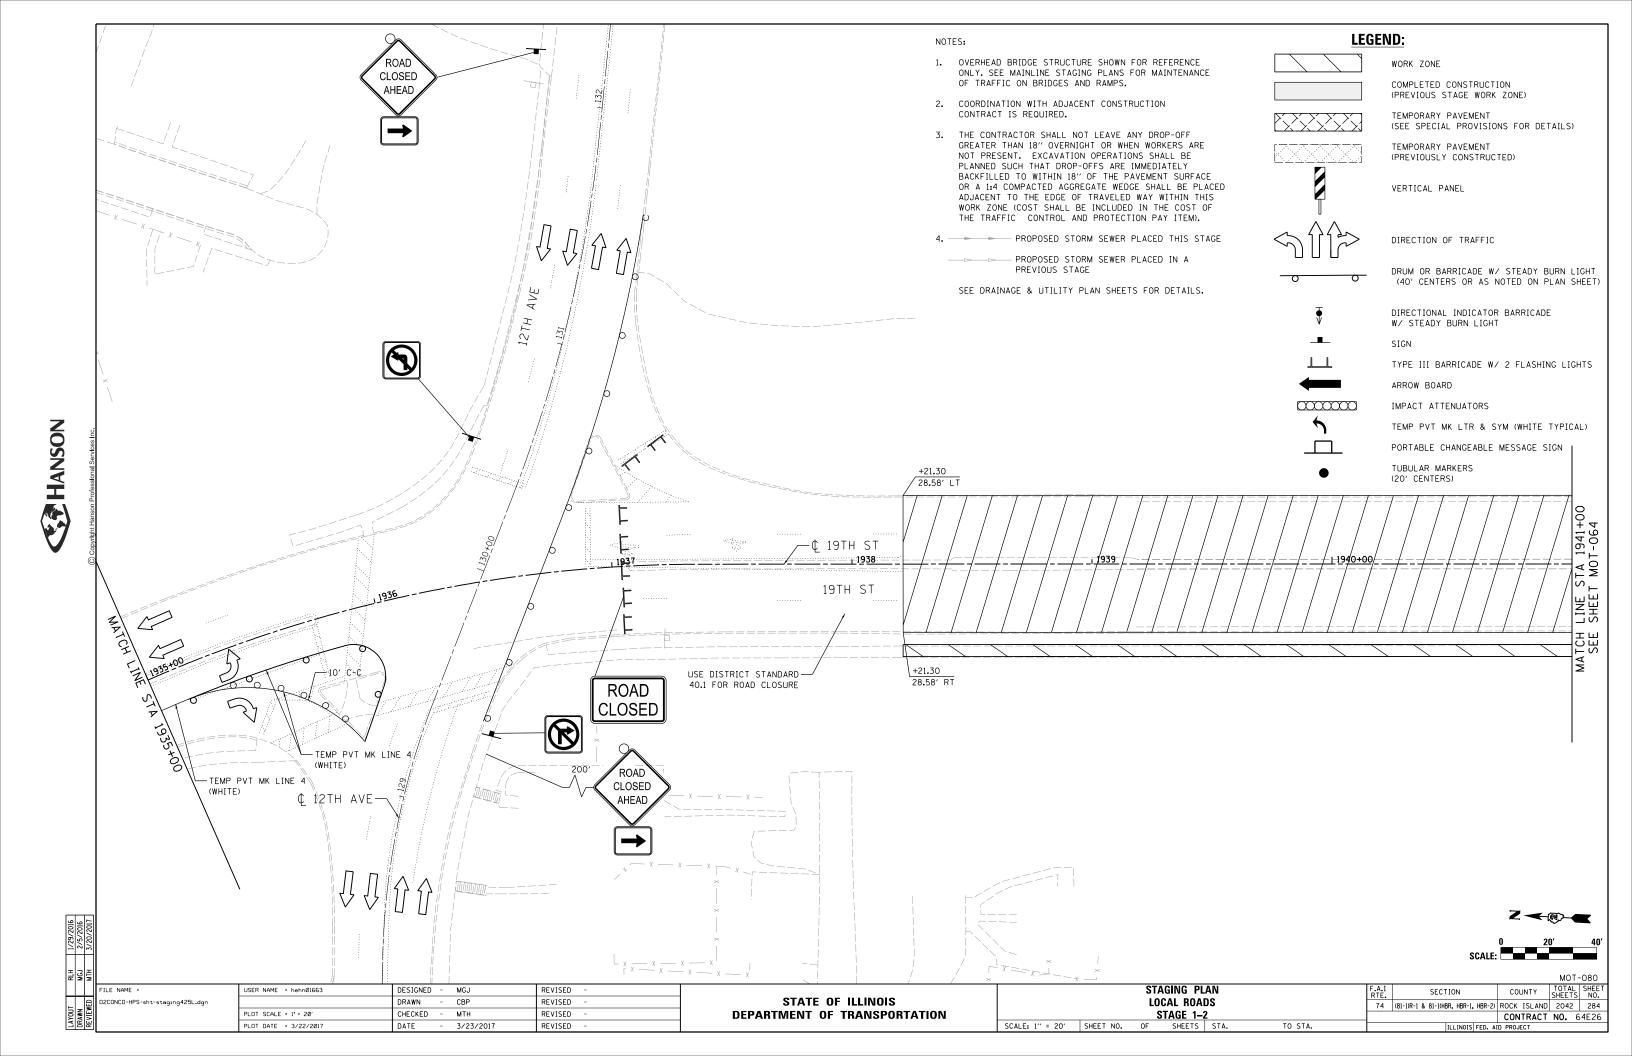
REVISED

LEGEND: NOTES: OVERHEAD BRIDGE STRUCTURE SHOWN FOR REFERENCE ONLY. SEE MAINLINE STAGING PLANS FOR MAINTENANCE OF TRAFFIC ON BRIDGES AND RAMPS. COMPLETED CONSTRUCTION (PREVIOUS STAGE WORK ZONE) 2. COORDINATION WITH ADJACENT CONSTRUCTION TEMPORARY PAVEMENT CONTRACT IS REQUIRED. (SEE SPECIAL PROVISIONS FOR DETAILS) 3. THE CONTRACTOR SHALL NOT LEAVE ANY DROP-OFF TEMPORARY PAVEMENT GREATER THAN 18" OVERNIGHT OR WHEN WORKERS ARE (PREVIOUSLY CONSTRUCTED) NOT PRESENT. EXCAVATION OPERATIONS SHALL BE PLANNED SUCH THAT DROP-OFFS ARE IMMEDIATELY BACKFILLED TO WITHIN 18" OF THE PAVEMENT SURFACE VERTICAL PANEL OR A 1:4 COMPACTED AGGREGATE WEDGE SHALL BE PLACED ADJACENT TO THE EDGE OF TRAVELED WAY WITHIN THIS WORK ZONE (COST SHALL BE INCLUDED IN THE COST OF THE TRAFFIC CONTROL AND PROTECTION PAY ITEM). DIRECTION OF TRAFFIC 4. PROPOSED STORM SEWER PLACED THIS STAGE PROPOSED STORM SEWER PLACED IN A DRUM OR BARRICADE W/ STEADY BURN LIGHT PREVIOUS STAGE (40' CENTERS OR AS NOTED ON PLAN SHEET) SEE DRAINAGE & UTILITY PLAN SHEETS FOR DETAILS. PINNING TEMPORARY CONCRETE BARRIER DIRECTIONAL INDICATOR BARRICADE W/ STEADY BURN LIGHT ALIGNMENT STA FROM OFFSET LT/RT STA TO OFFSET LT/RT FOOT 2064+35.37 14.85 RT 2064+60.71 RT 25.34' SB 19th Street 11.99 2065+99.39 3.20 RT 2068+02.10 2.44 RT 202.72' TYPE III BARRICADE W/ 2 FLASHING LIGHTS *SEE SPECIAL PROVISIONS FOR ANCHORING, PINNING, AND TRANSITION DETAILS. ARROW BOARD 0000000 IMPACT ATTENUATORS TEMP PVT MK LTR & SYM (WHITE TYPICAL) PORTABLE CHANGEABLE MESSAGE SIGN TUBULAR MARKERS (20' CENTERS) 2068+20.00 -B 19TH ST SOUTHBOUND 2064+(TEMP PVT MK LINE 4-26.58' LT (ONE-WAY) (WHITE 2' DASH 6' SKIP) 2069-TEMP CONC BARRIER 2068+14.77, 2.44' RT STA RAMP AC-C 15′ RT MATCH 2068+85 2066+12 15' RT 13' RT RECON RESURF TEMP CONC BARRIER CONSTRUCTION LIMITS 28+79.46, 3.33' RT STATION 2068+20.00 16' RT TEMP PVT MK LINE 4 (WHITE) TEMP PVT MK LINE 4 (YELLOW) STAGING PLAN USER NAME = hehn@1663 DESIGNED - MGJ REVISED SECTION COUNTY STATE OF ILLINOIS LOCAL ROADS D2CONCD-HPS-sht-staging524L.dgn DRAWN CBP REVISED 74 (81-1)R-1 & 81-1(HBR, HBR-1, HBR-2) ROCK ISLAND 2042 278 CHECKED МТН REVISED **DEPARTMENT OF TRANSPORTATION** STAGE 1-1 CONTRACT NO. 64E26

SCALE: 1" = 20' SHEET NO. OF SHEETS STA.

TO STA.



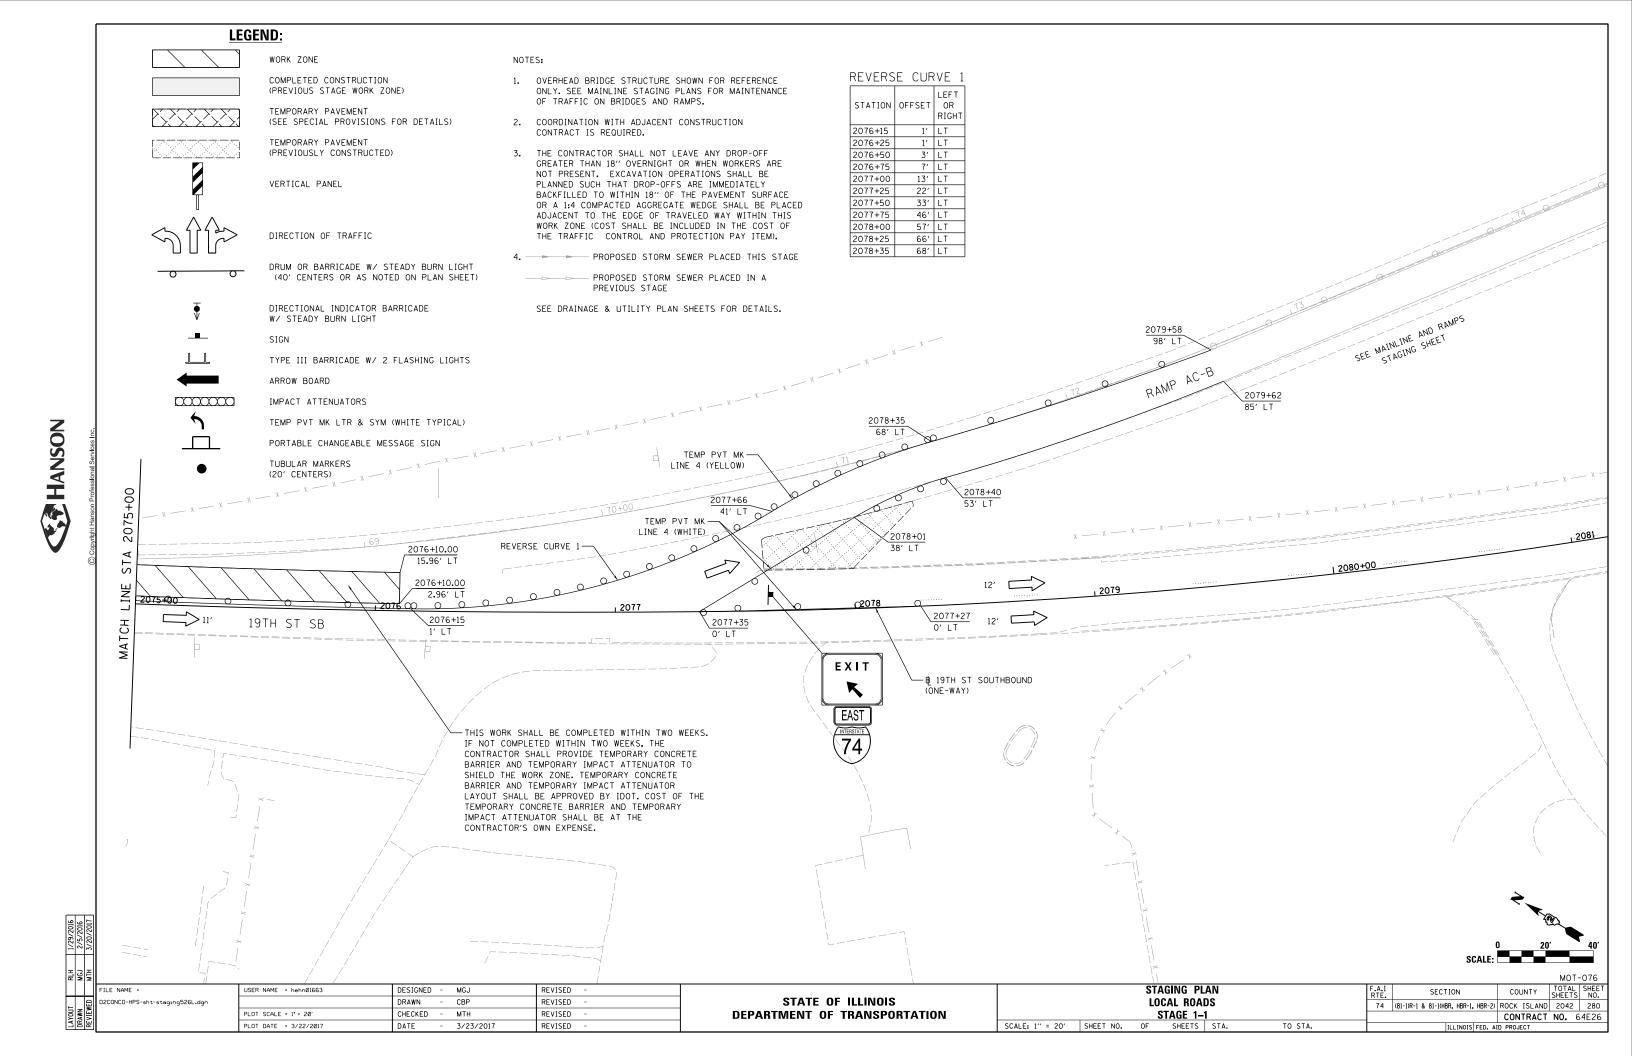

LEGEND:

WORK ZONE

COMPLETED CONSTRUCTION (PREVIOUS STAGE WORK ZONE)



TEMPORARY PAVEMENT (SEE SPECIAL PROVISIONS FOR DETAILS)



TEMPORARY PAVEMENT (PREVIOUSLY CONSTRUCTED)



VERTICAL PANEL



DIRECTION OF TRAFFIC

DRUM OR BARRICADE W/ STEADY BURN LIGHT (40' CENTERS OR AS NOTED ON PLAN SHEET)



DIRECTIONAL INDICATOR BARRICADE W/ STEADY BURN LIGHT

TYPE III BARRICADE W/ 2 FLASHING LIGHTS

ARROW BOARD

IMPACT ATTENUATORS

TEMP PVT MK LTR & SYM (WHITE TYPICAL)

PORTABLE CHANGEABLE MESSAGE SIGN

TUBULAR MARKERS (20' CENTERS)

NOTES:

- OVERHEAD BRIDGE STRUCTURE SHOWN FOR REFERENCE ONLY. SEE MAINLINE STAGING PLANS FOR MAINTENANCE OF TRAFFIC ON BRIDGES AND RAMPS.
- COORDINATION WITH ADJACENT CONSTRUCTION CONTRACT IS REQUIRED.
- THE CONTRACTOR SHALL NOT LEAVE ANY DROP-OFF GREATER THAN 18" OVERNIGHT OR WHEN WORKERS ARE NOT PRESENT. EXCAVATION OPERATIONS SHALL BE PLANNED SUCH THAT DROP-OFFS ARE IMMEDIATELY BACKFILLED TO WITHIN 18" OF THE PAVEMENT SURFACE OR A 1:4 COMPACTED AGGREGATE WEDGE SHALL BE PLACED ADJACENT TO THE EDGE OF TRAVELED WAY WITHIN THIS WORK ZONE (COST SHALL BE INCLUDED IN THE COST OF THE TRAFFIC CONTROL AND PROTECTION PAY ITEM).

PROPOSED STORM SEWER PLACED THIS STAGE

PROPOSED STORM SEWER PLACED IN A PREVIOUS STAGE

SEE DRAINAGE & UTILITY PLAN SHEETS FOR DETAILS.


ROAD CLOSED MOT-067 TA 1965+00 B 19TH ST NORTHBOUND --USE DISTRICT STANDARD 40.1 FOR ROAD CLOSURE (ONE-WAY) 19TH ST NB TEMP PVT MK LINE 4 (WHITE) B EX RAMP AC-D RAMP AC-D STAGING PLAN SECTION COUNTY LOCAL ROADS STATE OF ILLINOIS


USER NAME = hehn@1663 DESIGNED - MGJ REVISED DRAWN CBP REVISED CHECKED мтн REVISED PLOT DATE = 3/22/2017 DATE 3/23/2017 REVISED

DEPARTMENT OF TRANSPORTATION

74 (81-1)R-1 & 81-1(HBR, HBR-1, HBR-2) ROCK ISLAND 2042 285 SCALE: 1" = 20' SHEET NO. OF SHEETS STA. CONTRACT NO. 64E26 TO STA.


D2CONCD-HPS-sht-staging426L.dgn

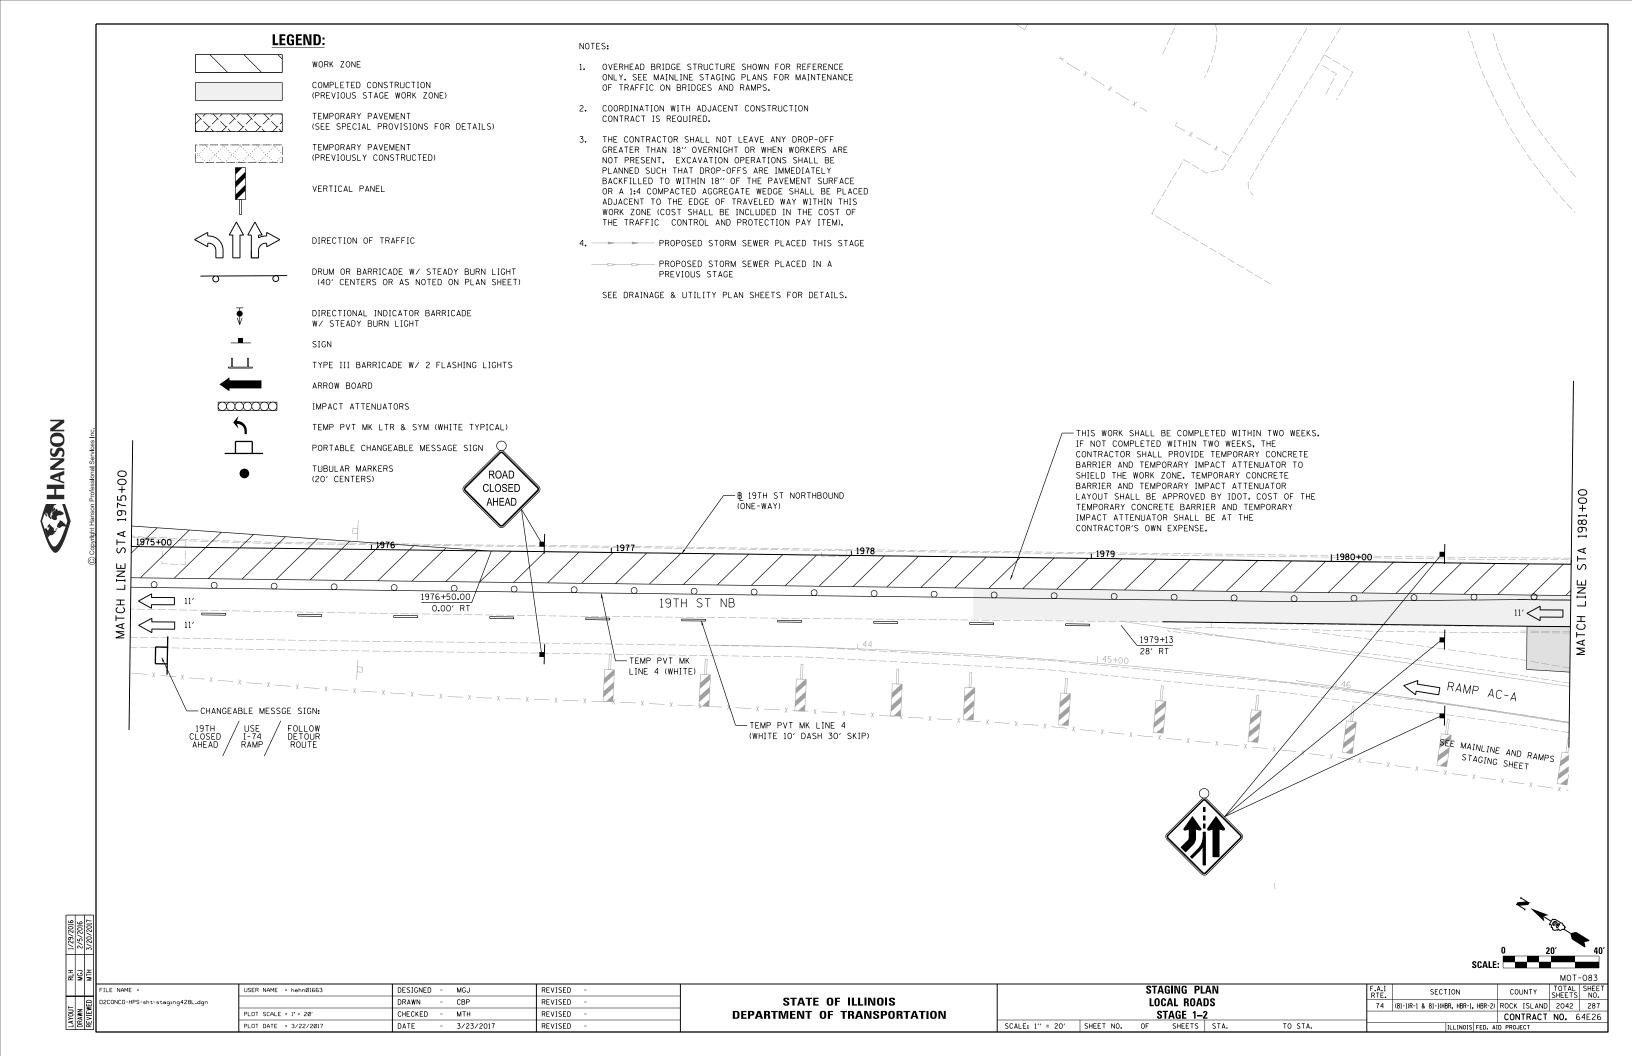

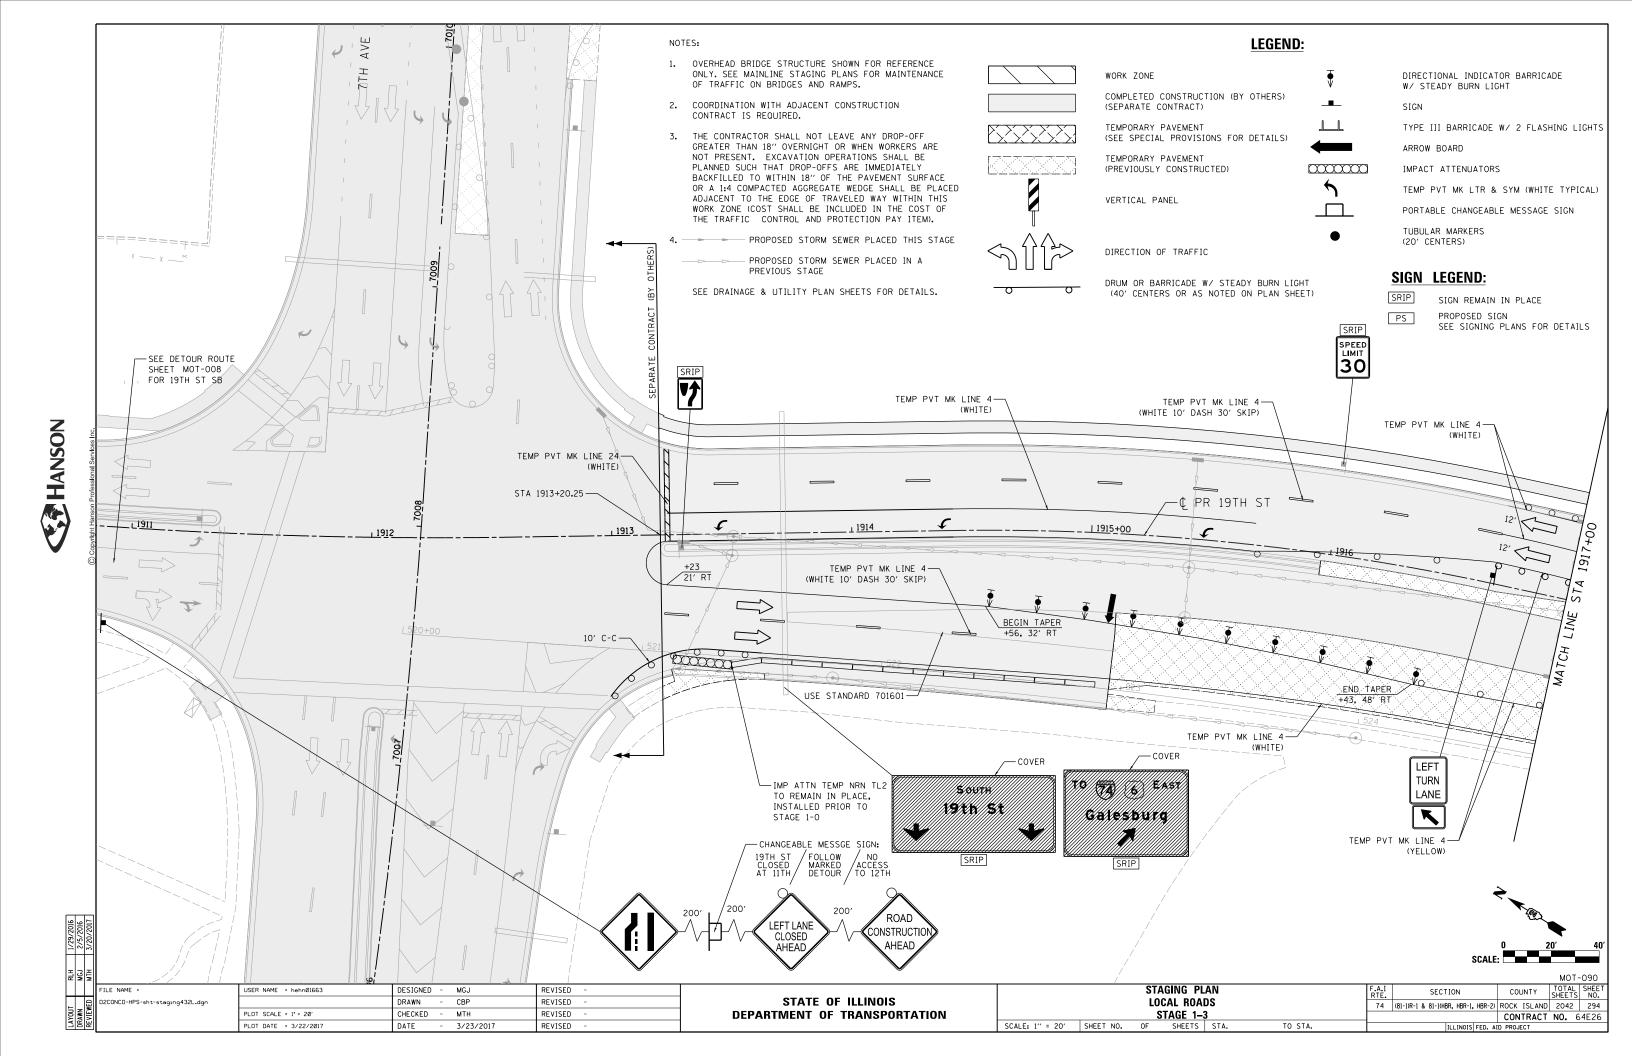

PLOT DATE = 3/22/2017 DATE 3/23/2017 REVISED

SCALE: 1" = 20' SHEET NO. OF SHEETS STA. TO STA.

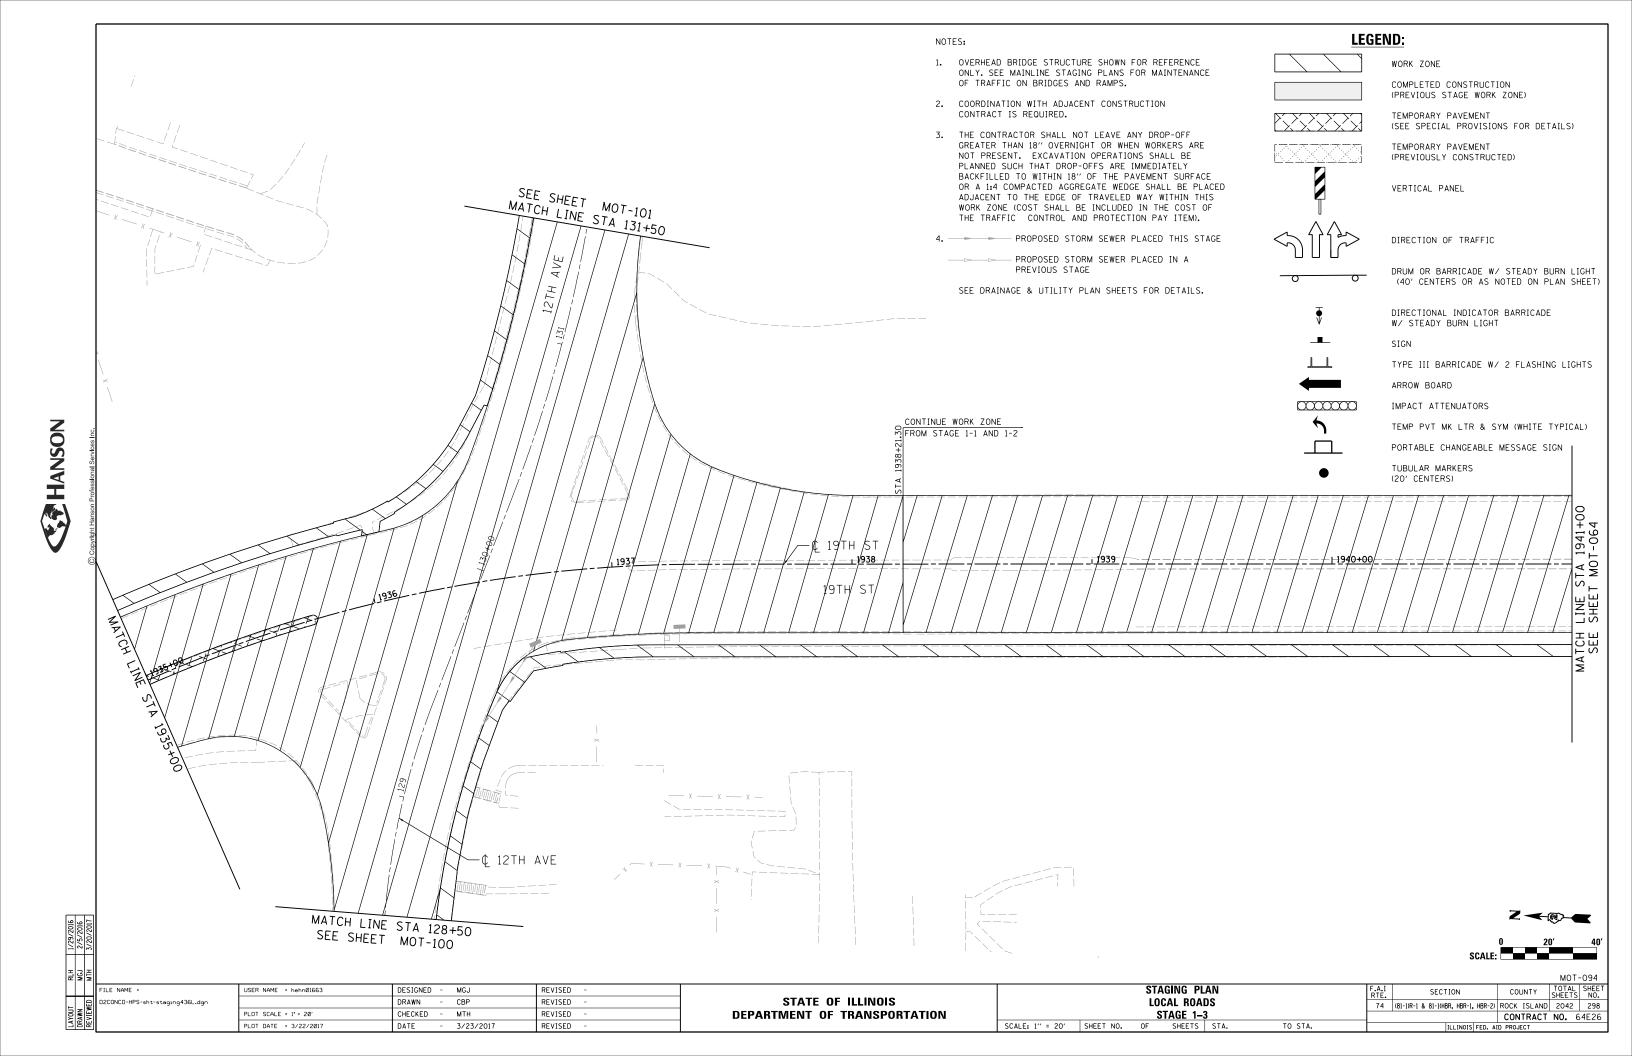

D2CONCD-HPS-sht-staging437L.dgn

USER NAME = hehn@1663

DRAWN CBP CHECKED мтн PLOT DATE = 3/22/2017 DATE 3/23/2017

DESIGNED - MGJ

REVISED REVISED REVISED

REVISED

1965+04/

102' RT

STATE OF ILLINOIS **DEPARTMENT OF TRANSPORTATION**

LOCAL ROADS SCALE: 1" = 20' SHEET NO. OF SHEETS STA.

STAGING PLAN SECTION 74 (81-1)R-1 & 81-1(HBR, HBR-1, HBR-2) ROCK ISLAND 2042 299 TO STA.

1968+18

1968+06.12

IMPACT ATTENUATOR SHALL BE AT THE SCALE:

CONTRACTOR'S OWN EXPENSE.

13.00' RT

MOT-095 COUNTY CONTRACT NO. 64E26