TRAFFIC DATA

BLOOMINGBANK ROAD ADT (YEAR) = 2100 (2014)SPEED LIMIT = 25 MPH

LONGCOMMON ROAD

ADT (YEAR) = 2700 (2014)

SPEED LIMIT = 25 MPH

INDEX OF SHEETS (SEE SHEET 2)

HIGHWAY STANDARDS (SEE SHEET 2)

STATE OF ILLINOIS

DEPARTMENT OF TRANSPORTATION

SECTION 17-00084-00-MS СООК ILLINOIS CONTRACT NO. 61E89

PLANS FOR PROPOSED FEDERAL AID HIGHWAY

FAU 3569 (BLOOMINGBANK ROAD), BARRYPOINT ROAD TO RIVERSIDE ROAD FAU 1693 (RIVERSIDE ROAD), QUINCY STREET TO BNSF RR RESURFACING, SIDEWALKS, INTERSECTION IMPROVEMENTS, LANDSCAPING SECTION No. 17–00084–00–MS PROJECT No. H6BY(634) VILLAGE OF RIVERSIDE **COOK COUNTY** JOB No: C-91-151-18



JOINT UTILITY LOCATION INFORMATION FOR EXCAVATION 1-800-892-0123 OR 811

ENGINEERING SCALES. REDUCED SIZED PLANS WILL NOT CONFORM TO STANDARD SCALES. IN MAKING MEASUREMENTS ON REDUCED PLANS, THE ABOVE SCALES MAY BE USED.

DESIGN DESIGNATION: MINOR COLLECTOR (URBAN)

DESIGN DESIGNATION: MAJOR COLLECTOR (URBAN)

CHRISTOPHER B. BURKE ENGINEERING, LTD. mont. Illinois 60018

RANGE 12 EAST BEGIN RIVERSIDE RD **IMPROVEMENTS** STA. 300 + 00.00END BLOOMINGBANK RD **BEGIN BLOOMINGBANK RD** IMPROVEMENTS STA. 100 + 50.00 END RIVERSIDE RD IMPROVEMENTS STA. 302 + 16

LONGCOMMON ROAD
GROSS LENGTH = 216 LINEAL FEET (0.04 MILES)
NET LENGTH = 216 LINEAL FEET (0.04 MILES)

RIVERSIDE TOWNSHIP

BLOOMINGBANK ROAD GROSS LENGTH = 480 LINEAL FEET (0.09 MILES) NET LENGTH = 480 LINEAL FEET (0.09 MILES)

TOTAL
GROSS LENGTH = 696 LINEAL FEET (0.13 MILES)
NET LENGTH = 696 LINEAL FEET (0.13 MILES)

MAY 10 ANTHONY J. DeRICCO ILLINOIS REGISTRATION No. 062-057484 EXPIRATION DATE: II/30/2019



RELEASING FOR

LOCATION OF SECTION INDICATED THUS: -

PRINTED BY AUTHORITY OF THE STATE OF ILLINOIS

STATE OF ILLINOIS
DEPARTMENT OF TRANSPORTATION

ILLINOIS REGISTRATION No. 062-060829

H CHIRISTOPHER HOLT

CONTRACT NO. 61E89

DOUGLAS J. GOTHAM ILLINOIS REGISTRATION No. 157-000575 EXPIRATION DATE: 08/31/18

GENERAL NOTES

- ALL CONSTRUCTION SHALL BE DONE IN ACCORDANCE WITH THE DETAILS IN THE PLANS, THE SPECIAL PROVISIONS INCLUDED IN THE CONTRACT DOCUMENTS, AND THE CURRENT EDITION OF THE FOLLOWING STATE OF ILLINOIS SPECIFICATIONS: (REFERRED TO AS THE "STANDARD SPECIFICATIONS AND RECURRING SPECIAL PROVISIONS", THE "STANDARD SPECIFICATIONS FOR TRAFFIC CONTROL ITEMS", THE "MANUAL ON UNIFORM TRAFFIC CONTROL DEVICES FOR STREETS AND HIGHWAYS", THE "MANUAL OF TEST PROCEDURES FOR MATERIALS" AND THE "STANDARD SPECIFICATIONS FOR WATER AND SEWER MAIN CONSTRUCTIONS IN ILLINOIS."
- ANY EXISTING OR PROPOSED STORM SEWER DAMAGED BY THE CONTRACTOR DURING CONSTRUCTION SHALL BE REPLACED BY THE CONTRACTOR 2.
- EXPOSED SUBGRADE MUST BE COVERED WITHIN 24 HOURS OF EXCAVATION, UNSTABLE SUBGRADE AREAS, AS DETERMINED BY THE ENGINEER, RESULTING FROM THE CONTRACTOR'S FAILURE TO COVER THE SUBGRADE SHALL BE EXCAVATED AND BACKFILLED WITH POROUS GRANULAR EMBANKMENT, SUBGRADE.
- THE CONTRACTOR SHALL BE RESPONSIBLE FOR CONTACTING THE OWNERS OF ALL EXISTING FACILITIES SO THAT THE UTILITIES AND THEIR APPURTENANCES MAY BE LOCATED AND/OR ADJUSTED, IF NECESSARY, PRIOR TO THE START OF CONSTRUCTION OPERATIONS.
- THE LOCATIONS OF EXISTING DRAINAGE STRUCTURES, STORM AND SANITARY SEWERS, WATER SERVICE LINES AND OTHER UTILITY LINES ARE APPROXIMATE, AND THE VERTICAL LOCATIONS ARE TO BE DETERMINED IN THE FIELD BY THE CONTRACTOR.
- THE CONTRACTOR SHALL BE RESPONSIBLE FOR THE PROTECTION OF ALL UNDERGROUND OR SURFACE UTILITIES EVEN THOUGH THEY MAY NOT BE SHOWN ON THE PLANS. ANY UTILITY THAT IS DAMAGED BY THE CONTRACTOR DURING CONSTRUCTION SHALL BE REPAIRED TO THE SATISFACTION OF THE ENGINEER OR OWNER, OR REPLACED.
- WHEN IT IS NECESSARY TO SHUT OFF A WATER MAIN, THE CONTRACTOR SHALL PROVIDE THE VILLAGE A MINIMUM 48 HOUR ADVANCE NOTICE, AND THE CONTRACTOR WILL BE RESPONSIBLE FOR NOTIFYING ALL AFFECTED RESIDENTS. THE JILLAGE WILL PROVIDE THE NECESSARY FORMS AND DETERMINE THE LIMITS
- THE CONTRACTOR SHALL NOT OPEN OR SHUT ANY WATER VALVES OR FIRE HYDRANTS. IF WATER IS NEEDED DURING CONSTRUCTION ACTIVITIES THE CONTRACTOR MUST CONTACT THE RIVERSIDE WATER DEPARTMENT AT (708) 442-3590.
- BEFORE STARTING ANY EXCAVATION, THE CONTRACTOR SHALL CALL "J.J.L.I.E." AT 800-892-0123 FOR FIELD LOCATIONS OF BURIED ELECTRIC, TELEPHONE, CABLE AND GAS FACILITIES AND THE VILLAGE OF RIVERSIDE PUBLIC WORKS DEPT. AT (708) 442-3590 FOR FIELD LOCATIONS OF BURIED WATER, SANITARY AND STORM FACILITIES (48-HOUR ADVANCE NOTIFICATION IS REQUIRED).
- DURING CONSTRUCTION OPERATIONS, WHENEVER ANY LOOSE MATERIAL IS DEPOSITED IN THE FLOW LINES OF DRAINAGE STRUCTURES SUCH THAT THE NATURAL FLOW OF WATER IS OBSTRUCTED, IT SHALL BE REMOVED AT THE CLOSE OF EACH WORKING DAY. AT THE CONCLUSION OF CONSTRUCTION, ALL DRAINAGE AND UTILITY STRUCTURES SHALL BE FREE OF DIRT AND DEBRIS.
- ALL SEWER AND WATER SERVICES CROSSED BY NEW STORM SEWERS SHALL BE PROPERLY LOCATED AND PROTECTED DURING CONSTRUCTION. ANY DAMAGE DONE TO SAID SERVICES NOT CONSIDERED TO BE IN CONFLICT WITH THE PROPOSED CONSTRUCTION SHALL BE REPAIRED BY THE CONTRACTOR.
- THE ENDS OF EXISTING DRAINAGE LINES AND HOLES IN EXISTING MANHOLES WHICH ARE NOT TO BE INCORPORATED INTO THE PROPOSED IMPROVEMENTS DESIGNATED BY THE ENGINEER SHALL BE SEALED WITH A PORTLAND CEMENT MORTAR TO THE SATISFACTION OF THE ENGINEER.
- THE CONTRACTOR SHALL CONFIRM ALL EXISTING STORM SEWER PIPE SIZES AND INVERTS PRIOR TO ORDERING STRUCTURES. ANY MODIFICATION OF STRUCTURES DUE TO THE FAILURE OF THE CONTRACTOR TO PERFORM THIS TASK AND MAY LEAD TO THE REJECTION OF THE STRUCTURE IN THE FIELD. PIPE TYPES INDICATED ON THESE PLANS AT THE STRUCTURE CALL-OUTS ARE THE EXISTING TYPES IDENTIFIED IN THE FIELD. PROPOSED PIPE IS PVC.
- THE CONTRACTOR SHALL PROVIDE ACCESS TO ABUTTING PROPERTIES AT ALL TIMES DURING THE CONSTRUCTION OF THIS PROJECT EXCEPT FOR PERIODS OF SHORT DURATION AS APPROVED BY THE ENGINEER.
- IT SHALL BE THE CONTRACTOR'S RESPONSIBILITY TO VERIFY ALL DIMENSIONS AND CONDITIONS EXISTING IN THE FIELD PRIOR TO ORDERING MATERIALS AND BEGINNING CONSTRUCTION. 15.
- THE CONTRACTOR SHALL BE RESPONSIBLE FOR RE-ERECTING ALL SIGNS AND POSTS REMOVED DURING CONSTRUCTION. IF DURING CONSTRUCTION THE CONTRACTOR DAMAGES ANY EXISTING SIGNS, HE/SHE WILL REPLACE THE SIGN.
- 17. THE CONTRACTOR SHALL SAWCUT AND REMOVE ONLY THE NECESSARY AREA OF EXISTING PAVEMENT NEEDED TO INSTALL PROPOSED STORM SEWER.
- THE CONTRACTOR SHALL BE RESPONSIBLE FOR NOTIFYING ALL AFFECTED RESIDENTS AND THE VILLAGE OF RIVERSIDE 48 HOURS PRIOR TO ANY ROAD CLOSURE.
- AT THE END OF EACH DAY, IT SHALL BE THE CONTRACTORS RESPONSIBILITY TO ASSURE THAT ALL STREETS ADJACENT TO THE PROJECT ARE FREE OF ALL CONSTRUCTION RELATED DEBRIS INCLUDING DIRT, STONE, NAILS ETC. THIS WORK SHALL BE DONE TO THE SATISFACTION OF THE ENGINEER AS COORDINATED WITH THE VILLAGE OF RIVERSIDE.
- THE CONTRACTOR SHALL COMPLETE ALL UTILITY WORK PRIOR TO PAVEMENT REMOVAL. THE CONTRACTOR SHALL ONLY REMOVE THE PORTION OF PAVEMENT NECESSARY TO INSTALL PROPOSED UTILITIES. PAVEMENT REMOVED FOR UTILITY WORK SHALL BE RESTORED AS INDICATED ON THE PLANS. ALL PAVEMENT REMOVED FOR UTILITY WORK MUST BE SAWCUT.
- THE CONTRACTOR AND ENGINEER SHALL FIELD VERIFY ALL DRAINAGE STRUCTURES TO DETERMINE WHETHER EACH STRUCTURE REQUIRES REMOVAL AND REPLACEMENT, RECONSTRUCTION, OR
- THE CONTRACTOR AND ENGINEER SHALL FIELD VERIFY ALL THE EXISTING PAVEMENT AFTER THE EXISTING BITUMINOUS SURFACE IS REMOVED TO DETERMINE THE ARES THAT PATCHING IS REQUIRED
- CURB HEIGHTS SHOWN ON THE PLANS ARE ESTIMATED. THE CONTRACTOR SHALL LOWER THE CURB HEIGHT AS NECESSARY TO ACHIEVE POSITIVE DRAINAGE FROM THE FRONT OF WALK TO THE BACK OF CURB. NO CURB HEAD HEIGHT SHALL BE POURED LESS THAN 3 INCHES
- ALL REMOVED FRAMES AND LIDS SHALL BE DELIVERED TO THE PUBLIC WORKS FACILITY AT 3860 COLUMBUS BLVD. RIVERSIDE, ILLINOIS.
- THE CONTRACTOR SHALL BE CAUTIOUS OF HEAVY STUDENT FOOT TRAFFIC DURING THE HOURS OF 8:00 AM 8:30 AM AND 2:30 PM 3:15 PM. SEVERAL AREA SCHOOLS ARE LOCATED NEAR THE
- IT IS THE CONTRACTOR'S SOLE RESPONSIBILITY TO COORDINATE WITH THE <u>BNSF</u> RAILROAD WHENEVER CONSTRUCTION ACTIVITY IS WITHIN 25 FEET OF THE RAILROAD ROW. THE CONTRACTOR SHALL RETAIN FLAGMEN EMPLOYED AND DESIGNATED BY THE <u>BNSF</u> RAILROAD TO MONITOR ON-COMING TRAIN TRAFFIC, AND ADVISE CONTRACTOR PERSONNEL WHEN ACTIVITY ON OR NEAR THE RAILROAD RIGHT-OF-WAY MAY PROCEED, THIS ITEM WILL BE PAID FOR ACCORDING TO ARTICLE 107.12 AND WILL BE REIMBURSED ACCORDING TO ARTICLE 109.05.

MWRD TYPICAL GENERAL NOTES

THE HUDD LOCAL CEWED CA	CTCAC CENTION CICIO A	SEETAE SHIET OF MATTETED AT LEAST	-
THE MWKD LUCAL SEWER ST	2 IEM2 SECTION FIELD O	OFFICE MUST BE NOTIFIED AT LEAS'	
THE IOL WEST THE BAVE BOT	OR TO THE COUNTY CHOCKE	NT OF ANY WORK (CALL TOR-599-40	

- 2. ELEVATION DATUM IS CCD.
- 3. NO FLOOR DRAINS
- 4. NO FOOTING DRAINS AND DOWNSPOUTS
- 5. ALL SANITARY SEWER PIPE MATERIALS AND JOINTS (AND STORM SEWER PIPE MATERIALS AND JOINTS IN A COMBINED SEWER AREA) SHALL CONFORM TO:

PIPE MATERIAL SPEC.	JOINT SPEC.
VITRIFIED CLAY PIPE VCP C-700 VCP (NO-BEL) C-700 JOINT COLLAR	C-425 C-425 D-1784
CONCRETE PIPE C-14 RCP C-76 ACP C-428	C-443 C-443 D-1869
ABS SEWER PIPE SOLID WALL 6" DIA. ABS D-2751	SDR 23.5 D-2751
ABS COMPOSITE/TRUSS PIPE 8"-15" DIA. ABS D-2680	D-2680
PVC GRAVITY SEWER PIPE 6"-15" DIA. SDR 26 D-3034 D-2855	D-3212 OR
18"-27" DIA. F/DY=46 F-675	D-3212 OR
D-2855 CISP A-74 DIP A-21.51	C-564 A-21.11

(NOTE: THE DISTRICT HAS APPROVED LESS COMMON PIPE MATERIALS ON A QUALIFIED BASIS IN ADDITION TO THOSE ABOVE. PLEASE CONTACT THE DISTRICT IF CONSIDERING USING PIPE NOT LISTED ABOVE.)

- 6. ALL SANITARY SEWER CONSTRUCTION (AND STORM SEWER CONSTRUCTION IN COMBINED SEWER AREAS), REQUIRES STONE BEDDING WITH STONE 1°4" TO 1" IN SIZE, WITH MINIMUM BEDDING THICKNESS EQUAL TO1°4THE OUTSIDE DIAMETER OF THE SEWER PIPE, BUT NOT LESS THAN FOUR (4) INCHES NOR MORE THAN EIGHT (8) INCHES. MATERIAL SHALL BE CA-10 RC A-13 AND SHALL BE EXTENDED AT LEAST 12" ABOVE THE TOP OF THE PIPE WHEN USING PVC.
- 7. COUPLINGS THAT CREATE A WATERTIGHT SEAL SHALL BE USED IN THE CONNECTION OF SEWER PIPES OF DISSIMILAR MATERIALS.
- 8. WHEN CONNECTING TO AN EXISTING SEWER MAIN BY MEANS OTHER THAN AN EXISTING WYE, TEE, OR AN EXISTING MANHOLE, ONE OF THE FOLLOWING METHODS SHALL BE USED:
- 1. CIRCULAR SAW-CUT OF SEWER MAIN BY PROPER TOOLS AND PROPER INSTALLATION OF A SADDLE.
- 2. REMOVE AN ENTIRE SECTION OF PIPE (BREAKING ONLY THE TOP OF ONE BELL) AND REPLACE WITH A WYE OR TEE BRANCH SECTION.
- WITH PIPE CUTTER, NEATLY AND ACCURATELY CUT OUT DESIRED LENGTH OF PIPE FOR INSERTION OF PROPER FITTING, USING WATER TIGHT SEAL COUPLINGS TO HOLD IT FIRMLY IN PLACE.
- 9. WHENEVER A SANITARY/COMBINED SEWER CROSSES UNDER A WATERMAIN, THE MINIMUM VERTICAL DISTANCE FROM THE TOP OF THE SEWER TO THE BOTTOM OF THE WATERMAIN SHALL BE 18 INCHES. FIRTHERMORE, A MINIMUM HORIZONTAL DISTANCE OF 10 FEET BETWEEN SANITARY/COMBINED SEWERS AND WATERMAINS SHALL BE MAINTAINED UNLESS: THE SEWER IS LAID IN A SEPARATE TRENCH, KEEPING A MINIMUM 18" VERTICAL SEPARATION; OR THE SEWER IS LAID IN THE SAME TRENCH WITH THE WATERMAIN LOCATED A THE OPPOSITE SIDE ON A BENCH OF UNDISTURBED EARTH, KEEPING A MINIMUM 18" VERTICAL SEPARATION, IF EITHER THE VERTICAL OR HORIZONTAL DISTANCES DESCRIBED ABOVE CAN NOT BE MAINTAINED, OR THE SEWER CROSSES ABOVE THE WATERMAIN, THE SEWER SHALL BE CONSTRUCTED TO WATERMAIN STANDARDS.
- ALL EXISTING SEPTIC SYSTEMS SHALL BE ABANDONED. ABANDONED TANKS SHALL BE FILLED WITH GRANULAR MATERIAL OR REMOVED.
- 11. ALL SANITARY MANHOLES, (AND STORM MANHOLES IN COMBINED SEWER AREAS), SHALL HAVE A MINIMUM INSIDE DIAMETER OF 48 INCHES, AND SHALL BE CAST IN PLACE OR PRE-CAST REINFORCED CONCRETE.
- 12. ALL INLET AND OUTLET PIPES OF SANITARY SEWER MANHOLES AND OTHER UNDERGROUND STRUCTURES (AND IN COMBINED SEWER AREAS, ALSO ALL COMBINED/STORM SEWER MANHOLES, CATCH BASINS, INLETS, AND UNDERGROUND DETENTION STORAGE STRUCTURES) SHALL BE JOINED WITH WATERTIGHT FLEXIBLE RUBBER CONNECTORS CONFORMING TO A.S.T.M. C-4443 AND C-923 WITH STAINLESS STEEL BAND.

INDEX OF SHEETS

<u> </u>	
DESCRIPTION	SHEET NO
COVER SHEET	1
GENERAL NOTES	2
SUMMARY OF QUANTITIES	3
TYPICAL SECTIONS	4 - 5
ALIGNMENT, TIES AND BENCHMARKS	6
REMOVAL PLAN	7
PROPOSED PLAN	8
PAVEMENT MARKING PLAN	9
ROADWAY GRADING	10
PARKWAY AND ADA GRADING	11 - 14
LANDSCAPING PLAN	15 - 16
ELECTRICAL PLAN	17 - 19
CONSTRUCTION DETAILS	20 - 22
DISTRICT ONE DETAILS	23 - 29
DISTRICT ONE DETAILS	
DETAILS FOR FRAMES AND LIDS ADJUSTMENT WITH MILLING	BD-08
PAVEMENT PATCHING FOR HMA SURFACED PAVEMENT	BD-22
BUTT JOINT AND HMA TAPER DETAILS	BD-32
TRAFFIC CONTROL AND PROTECTION FOR SIDE ROADS, ITERSECTIONS AND DRIVEWAYS	TC-10
DISTRICT I TYPICAL PAVEMENT MARKINGS	TC-13
SHORT TERM PAVEMENT MARKING LETTERS AND SYMBOLS	TC-16
ARTERIAL ROAD INFORMATION SIGN	TC-22

HIGHWAY STANDARDS

STANDARD SYMBOLS, ABBREVIATIONS AND PATTERNS	000001-06
PERPENDICULAR CURB RAMPS FOR SIDEWALKS	424001-10
DIAGONAL CURB RAMPS FOR SIDEWALKS	424006-03
CORNER PARALLEL CURB RAMPS FOR SIDEWALKS	424011-03
MID BLOCK CURB RAMPS FOR SIDEWALKS	424016-04
DEPRESSED CORNER FOR SIDEWALKS	424021-04
ENTRANCE/ALLEY PEDESTRIAN CROSSINGS	424026-02
CLASS C AND D PATCHES	442201-03
CATCH BASIN, TYPE A	602001-02
MANHOLE, TYPE A	602401-04
PRECAST REINFORCED CONCRETE FLAT SLAB TOP	602601-05
MANHOLE STEPS	602701-02
FRAME AND LIDS, TYPE 1	604001-04
CONCRETE CURB TYPE B AND COMBINATION CONCRETE CURB AND GUTTER	606001-07
OFF - ROAD OPERATIONS, 2L, 2W, 15' (4.5 M) TO 24" (600 MM) FROM PAVEMENT EDGE	701006-05
OFF-ROAD MOVING OPERATIONS, 2L, 2W, DAY ONLY	701011-04
LANE CLOSURE, 2L, 2W, SHORT TIME OPERATIONS	701301-04
LANE CLOSURE, 2L, 2W MOVING OPERATIONS - DAY ONLY	701311-03
URBAN LANE CLOSURE, 2L, 2W-UNDIVIDED	701501-06
URBAN LANE CLOSURE MULTILANE INTERSECTION	701701-10
SIDEWALK CORNER OR CROSSWALK CLOSURE	701801-06
TRAFFIC CONTROL DEVICES	701901-07
SIGN PANEL MOUNTING DETAILS	720001-01
SIGN PANEL ERECTION DETAILS	720006-04
TYPICAL PAVEMENT MARKINGS	780001-05

FILE NAME =	USER NAME = dschroeder	DESIGNED -	REVISED -
N:\RIVERSIDE\120544.00072\CIVIL\NOT_1205	4_00072.SHT	DRAWN -	REVISED -
	PLOT SCALE = 40'	CHECKED -	REVISED -
Default	PLOT DATE = 6/13/2018	DATE -	REVISED -

SCALE:

GENERAL NOTES	F.A.U. RTES.	SECTION	COUNTY	SHEETS	SHE NO
METRA STATION PEDESTRIAN ACCESS IMPROVEMENTS	1693 3569	17-00084-00-MS	COOK	29	2
METHA STATION TEDESTINAN ASSESS INITIOVENIENTS			CONTRACT	T NO.	61E8
SHEET 1 OF 1 SHEETS STA. TO STA.		THE TWO TE EED AT	IN PROJECT		

SUMMARY OF QUANTITIES

		CODE NUMBER	ITEM	UNIT	OOO4.
	_	20101000	TEMPORARY FENCE	FOOT	384
S		20101200	TREE ROOT PRUNING	EACH	7
		20200100	EARTH EXCAVATION	CU YD	152
\exists		20201200	REMOVAL AND DISPOSAL OF UNSUITABLE MATERIAL	CU YD	50
1		20800150	TRENCH BACKFILL	CU YD	109
S	*	21101810	COMPOST FURNISH AND PLACE, 3"	SQ YD	145
s		25200200	SUPPLETMENTAL WATERING	UNIT	5
1		28000510	INLET FILTERS	EACH	7
1	*	30300001	AGGREGATE SUBGRADE IMPROVEMENT	CU YD	50
1		35101500	AGGREGATE BASE COURSE, TYPE B	CU YD	158
1		40600290	BITUMINOUS MATERIALS (TACK COAT)	POUND	1874
1		40600400	MIXTURE FOR CRACKS, JOINTS AND FLANGEWAYS	TON	5
		40600625	LEVELING BINDER (MACHINE METHOD), N50	TON	167
1		40600982	HOT-MIX ASPHALT SURFACE REMOVAL - BUTT JOINT	SQ YD	72
1		40603335	HOT-MIX ASPHALT SURFACE COURSE, MIX "D", N50	TON	241
1		42400800	DETECTABLE WARNINGS	SQ FT	90
1		44000100	PAVEMENT REMOVAL	SQ YD	926
#		44000300	CURB REMOVAL	FOOT	49
#		44000500	COMBINATION CONCRETE CURB AND GUTTER REMOVAL	FOOT	999
1	*	44000600	SIDEWALK REMOVAL	SQ FT	3951
#		44201713	CLASS D PATCHES, TYPE I, 6 INCH	SQ YD	32
1		44201717	CLASS D PATCHES, TYPE II, 6 INCH	SQ YD	60
\downarrow	\exists	44201721	CLASS D PATCHES, TYPE III, 6 INCH	SQ YD	101
#		44201723	CLASS D PATCHES, TYPE IV, 6 INCH	SQ YD	156
#	*	56500600	DOMESTIC WATER SERVICE BOX TO BE ADJUSTED	EACH	2
#		60200105	CATCH BASIN, TYPE A, 4' DIAMETER, TYPE 1 FRAME, OPEN LID	EACH	2
#		60206905	CATCH BASIN, TYPE C, TYPE 1 FRAME, OPEN LID	EACH	1
#		60300410	VALVE BOX FRAMES TO BE ADJUSTED WITH NEW FRAMES	EACH	2
#	1	60406000	FRAMES AND LIDS, TYPE 1, OPEN LID	EACH	1
#	1	60406100	FRAMES AND LIDS, TYPE 1, CLOSED LID	EACH	1
‡	\downarrow	60600605	CONCRETE CURB, TYPE B	FOOT	127
#	$\overline{}$		 PECIAL PROVISION		
s		INDICATES A S	PECIALTY ITEM		

		CODE NUMBER	ІТЕМ	UNIT	0004 TOTAL QUANTITY
F	-	61140000	STORM SEWERS (SPECIAL), 8"	FOOT	90
F	F	67100100	MOBILIZATION	LSUM	1
F		70102620			
F			TRAFFIC CONTROL AND PROTECTION STANDARD 701501	LSUM	1
L		70102635	TRAFFIC CONTROL AND PROTECTION STANDARD 701701	LSUM	1
F	H	70102640	TRAFFIC CONTROL AND PROTECTION STANDARD 701801	LSUM	1
-	H	70107005	PAVEMENT MARKING BLACKOUT TAPE, 5"	FOOT	260
Ë		70107007	PAVEMENT MARKING BLACKOUT TAPE, 7"	FOOT	145
L.		70300220	TEMPORARY PAVEMENT MARKING - LINE 4"	FOOT	520
:		70300280	TEMPORARY PAVEMENT MARKING - LINE 24"	FOOT	110
-	H	70300100	SHORT TERM PAVEMENT MARKING	FOOT	630
-	F	70300150	SHORT TERM PAVEMENT MARKING REMOVAL	SQ FT	210
5	F				
		78000100	THERMOPLASTIC PAVEMENT MARKING - LETTERS AND SYMBOLS	SQ FT	47
S		78000200	THERMOPLASTIC PAVEMENT MARKING - LINE 4"	FOOT	676
S		78000400	THERMOPLASTIC PAVEMENT MARKING - LINE 6"	FOOT	370
S		78000500	THERMOPLASTIC PAVEMENT MARKING - LINE 8"	FOOT	111
S		78000600	THERMOPLASTIC PAVEMENT MARKING - LINE 12"	FOOT	20
S		78000610	THERMOPLASTIC PAVEMENT MARKING - LINE 16"	FOOT	44
S	H	78000650	THERMOPLASTIC PAVEMENT MARKING - LINE 24"	FOOT	50
S		81028710	UNDERGROUND CONDUIT, COILABLE NONMETALLIC CONDUIT, 3/4" DIA	FOOT	325
S	F				
	L	81702100	ELECTRIC CABLE IN CONDUIT, 600V (XLP-TYPE USE) 1/C NO. 12	FOOT	980
S	*	89502376	REBUILD EXISTING HANDHOLE	EACH	1
S	*	A 2005040	TREE, GYMNOCLADUS DIOICUS ESPRESSO-JFS (ESPRESSO KENTUCKY COFFEETREE), 2-1/2" CALIPER, BALLED AND BURLAPPED	EACH	1
s	*	B2000766	TREE, AMELANCHIER X GRANDIFLORA AUTUMN BRILLIANCE (AUTUMN BRILLIANCE SERVICE BERRY), 6' HEIGHT, SHRUB FORM, BALLED AND BURLAPPED	EACH	2
S	*	A2C05660	TREE, OSTRYA VIRGINIANA (IRONWOOD), 7' HEIGHT, CLUMP FORM, BALLED AND BURLAPPED	EACH	3
s	*	C2003424	SHRUB, HYDRANGEA ARBORESCENS ANNABELLE (ANNABELLE SMOOTH HYDRANGEA), 2' HEIGHT, BALLED AND BURLAPPED	EACH	8
S	*	C2C06218	SHRUB, RIBES AMERICANUM (WILD BLACK CURRANT), 18" HEIGHT, CONTAINER	EACH	32
S	*	K0012990	PERENNIAL PLANTS, ORNAMENTAL TYPE, GALLON POT	UNIT	3
S	*	K1003680	MULCH	SQ YD	362
Á	*			52,15	502
S			SPECIAL PROVISION SPECIALTY ITEM		


		CODE NUMBER	ITEM	UNIT	OOO4- TOTAL QUANTITY
S	*	X0322792	BEDDING MATERIAL, SPECIAL	CU YD	27
	*	X0327319	COMBINED SEWERS, CLASS A, TYPE 2, 24"	FOOT	20
S	*	X0324345	COMBINED SEWER REMOVAL 24"	FOOT	30
S	*	X0325170	PLANTING BED PREPARATION	SQ FT	943
	*	X0326862	STRUCTURES TO BE ADJUSTED	EACH	6
S	*	X0539700	TREE FRAME AND GRATE	EACH	3
5	*	X0840000	SANITARY SEWER REMOVAL 8"	FOOT	20
S	*	X1800014	DIERVILLA KODIAK ORANGE (KODIAK ORANGE BUSH-HONEYSUCKLE), 24" HEIGHT, 5 GALLON CONTAINER	EACH	31
S	*	X2520700	SODDING, (SPECIAL)	SQ YD	573
	*	X4401198	HOT-MIX ASPHALT SURFACE REMOVAL, VARIABLE DEPTH	SQ YD	2756
5	*	X6022810	MANHOLES, SANITARY, 4'-DIAMETER, TYPE 1 FRAME, CLOSED LID	EACH	1
5	*	X6022820	MANHOLES, SANITARY, 5'-DIAMETER, TYPE 1 FRAME, CLOSED LID	EACH	1
	*	X6030310	FRAMES AND LIDS TO BE ADJUSTED (SPECIAL)	EACH	3
	*	X6064200	COMBINATION CONCRETE CURB AND GUTTER, TYPE B-6.12 (SPECIAL)	FOOT	1304
	*	X6640200	TEMPORARY CHAIN LINK FENCE	FOOT	350
5	*	X8140230	HANDHOLE, COMPOSITE CONCRETE (SPECIAL)	EACH	2
╡	*	XX007899	MASONRY WALL	FOOT	79
S	*	XX008910	PAVEMENT MARKING (SPECIAL)	SQ FT	847
	*	XX024100	EXPOSED AGGREGATE SURFACE	SQ FT	2395
S	*	Z0059600	SANITARY SEWER, TYPE 2 8"	FOOT	25
	*	Z0003855	BICYCLE RACKS	EACH	10
	*	Z0004002	BOLLARDS	EACH	6
	*	Z0017800	DRAINAGE & UTILITY STRUCTURES TO BE RECONSTRUCTED (SPECIAL)	EACH	2
\exists	*	Z0018700	DRAINAGE STRUCTURE TO BE REMOVED	EACH	3
	*	Z0030850	TEMPORARY INFORMATION SIGNING	SQFT	103
5	*	Z0033024	MAINTAIN EXISTING LIGHTING SYSTEM	LSUM	1
	*	Z0062458	TEMPORARY PAVEMENT (VARIABLE DEPTH)	TON	20
\exists	*	Z0007430	TEMPORARY SIDEWALK	SQ FT	1500
	*	Z0048665	RAILROAD PROTECTIVE LIABILITY INSURANCE	LSUM	1
	*	XX003219	UNIT PAVERS	SQ FT	7013
S	*		PECIAL PROVISION SPECIALTY ITEM		

USER NAME = dschroeder	DESIGNED -	REVISED =	
4_00072.SHT	DRAWN -	REVISED -	
PLOT SCALE = 40'	CHECKED -	REVISED -	
PLOT DATE = 5/10/2018	DATE -	REVISED -	
	4_00072.SHT PLOT SCALE = 40'	4.00072,SHT	4.00072,SHT

STATE OF ILLINOIS
DEPARTMENT OF TRANSPORTATION

		SU	MMARY	OF QU	ANTITIE	S
	METRA	STATION	PEDES1	RIAN A	ACCESS	IMPROVEMENTS
SCALE:		SHEET 1	0F 1	SHEETS	STA.	TO STA.

F.A.U. RTES.	SECTION	COUNTY	TOTAL	SHEET NO.
1693 3569	17-00084-00-MS	COOK	29	3
		CONTRAC	T NO. (51E89
	ILLINOIS FED.	AID PROJECT		

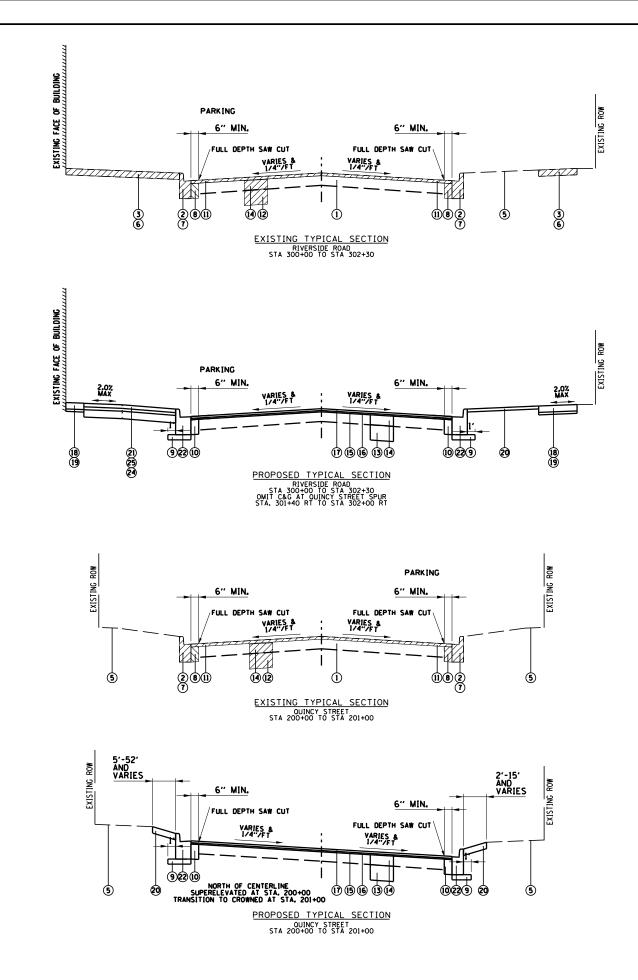

DESIGNED -

DRAWN

DATE

CHECKED

REVISED

REVISED

REVISED

REVISED

FILE NAME =

N:\RIVERSIDE\120544.00072\CIVIL\TYP_01_120544_00072.SHT

PLOT DATE = 5/10/2018

HOT-MIX ASPHALT MIXTURE REQUIREMENTS	
MIXTURE ITEM	AIR VOIDS • Ndes
PAVEMENT RESURFACING	
HOT-MIX ASPHALT SURFACE COURSE, MIX "D". N50 (IL 9.5mm); 1.5"	4% e 50 GYR
LEVELING BINDER (MACHINE METHOD), N50; 1"	4% e 50 GYR
PATCHING	
CLASS D PATCHES (HMA BINDER IL-19mm); 6" (IN 2 LIFTS)	4% e 70 GYR
TEMPORARY PAVEMENT	
HMA SURFACE COURSE, MIX "D", N7O (IL 9.5mm), VARIABLE	4% e 70 GYR
TEMPORARY SIDEWALK	
HMA SURFACE COURSE, MIX "D", N70 (IL 9.5mm), 2"	4% e 70 GYR

NOTES: THE UNIT WEIGHT USED TO CALCULATE ALL HMA MIXTURE QUANTITIES IS 112 LBS/SO YD/IN. THE "AC TYPE" FOR POLYMERIZED HMA MIXES SHALL BE "SBS/SBR PC 76-22" AND FOR NON-POLYMERIZED HMA THE "AC TYPE" SHALL BE "PG 64-22" UNLESS MODIFIED BY DISTRICT ONE SPECIAL PROVISIONS.

FOR HMA FULL DEPTH "AC TYPE" SEE SPECIAL PROVISIONS. FOR USE OF RECYCLED MATERIALS SEE SPECIAL PROVISIONS.

EXISTING HMA PAVEMENT SHALL BE MILLED PRIOR TO CLASS D PATCHING.

LEGEND

ITEMS TO BE REMOVED

EXISTING HMA PAVEMENT

EXISTING COMBINATION CONCRETE CURB AND GUTTER

EXISTING EXPOSED AGGREGATE SURFACE

EXISTING PORTLAND CEMENT CONCRETE SIDEWALK

(5) EXISTING SOIL AND GROUND COVER

SIDEWALK REMOVAL (AS DIRECTED BY THE ENGINEER IN THE FIELD)

COMBINATION CONCRETE CURB AND GUTTER REMOVAL (AS DIRECTED BY THE ENGINEER IN THE FIELD)

EXISTING PAVEMENT REMOVAL (INCLUDED IN THE COST OF COMBINATION CONCRETE CURB AND GUTTER TYPE B-6.12, SPECIAL)

SUBBASE GRANULAR MATERIAL, TYPE B, 4" (INCLUDED IN THE COST OF COMBINATION CONCRETE CURB AND GUTTER TYPE B-6.12, SPECIAL)

P.C.C. BASE COURSE (INCLUDED IN THE COST OF COMBINATION CONCRETE CURB AND GUTTER TYPE B-6.12, SPECIAL)

HOT MIX ASPHALT SURFACE REMOVAL. VARIABLE DEPTH

REMOVAL AND DISPOSAL OF UNSUITABLE MATERIALS (AS DIRECTED BY THE ENGINEER IN THE FIELD)

AGGREGATE SUBGRADE IMPROVEMENT (AS DIRECTED BY THE ENGINEER IN THE FIELD)

CLASS D PATCHES, VARIOUS TYPES, 6 INCH (AS DIRECTED BY THE ENGINEER IN THE FIELD)

BITUMINOUS MATERIALS (TACK COAT)

LEVELING BINDER (MACHINE METHOD), N50

HMA SURFACE COURSE, MIX "D", N50 - 1.5"

EXPOSED AGGREGATE SURFACE
(AS DIRECTED BY THE ENGINEER IN THE FIELD)

2" AGGREGATE BASE COURSE (INCLUDED IN THE COST OF PORTLAND CEMENT CONCRETE SIDEWALK, 5" AND EXPOSED AGGREGATE SURFACE)

20 SODDING, (SPECIAL)

21

COMBINATION CONCRETE CURB AND GUTTER TYPE B-6.12 (SPECIAL)

BEDDING MATERIAL, SPECIAL OR PLANTING BED PREPARATION

AGGREGATE BASE COURSE, TYPE B (INCLUDED IN THE COST OF UNIT PAVERS)


BEDDING SAND, 2 1/4" (INCLUDED IN THE COST OF UNIT PAVERS)


26 PAVEMENT REMOVAL

27 CONCRETE CURB. TYPE B


(28) MASONRY WALL FOR PLANTING BED (SEE CONSTRUCTION DETAILS)


SECTION COUNTY TYPICAL SECTIONS STATE OF ILLINOIS COOK 29 4 17-00084-00-MS METRA STATION PEDESTRIAN ACCESS IMPROVEMENTS **DEPARTMENT OF TRANSPORTATION** CONTRACT NO. 61E89 OF 2 SHEETS STA.

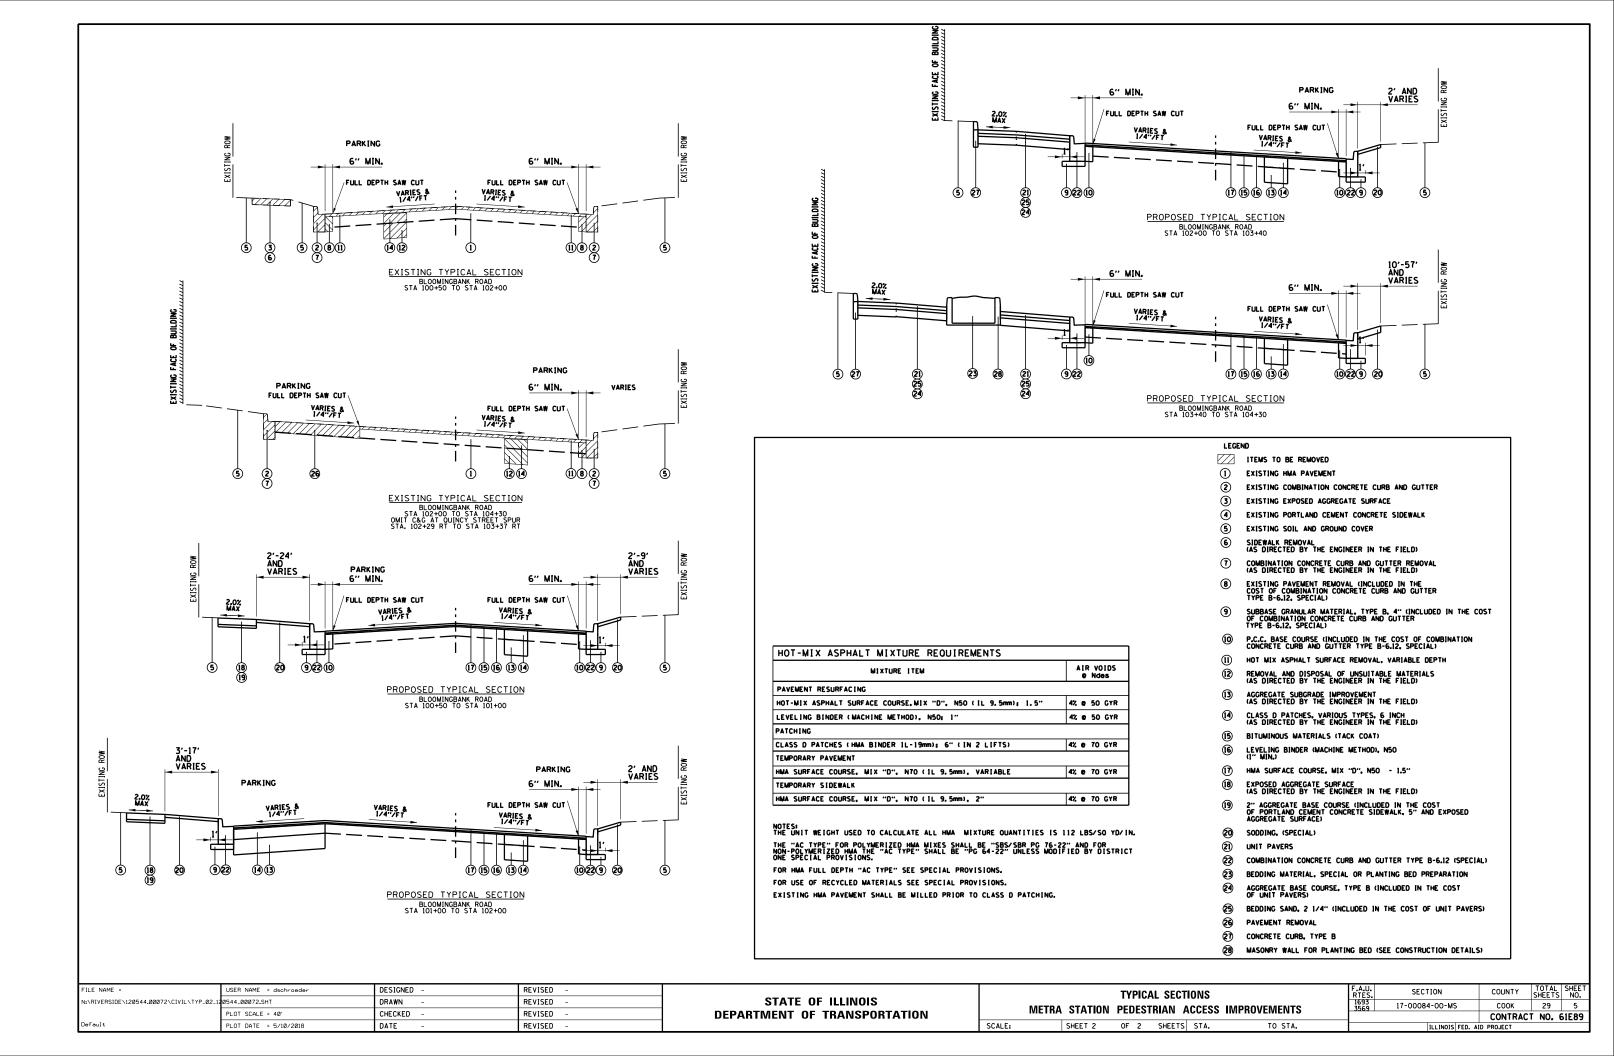


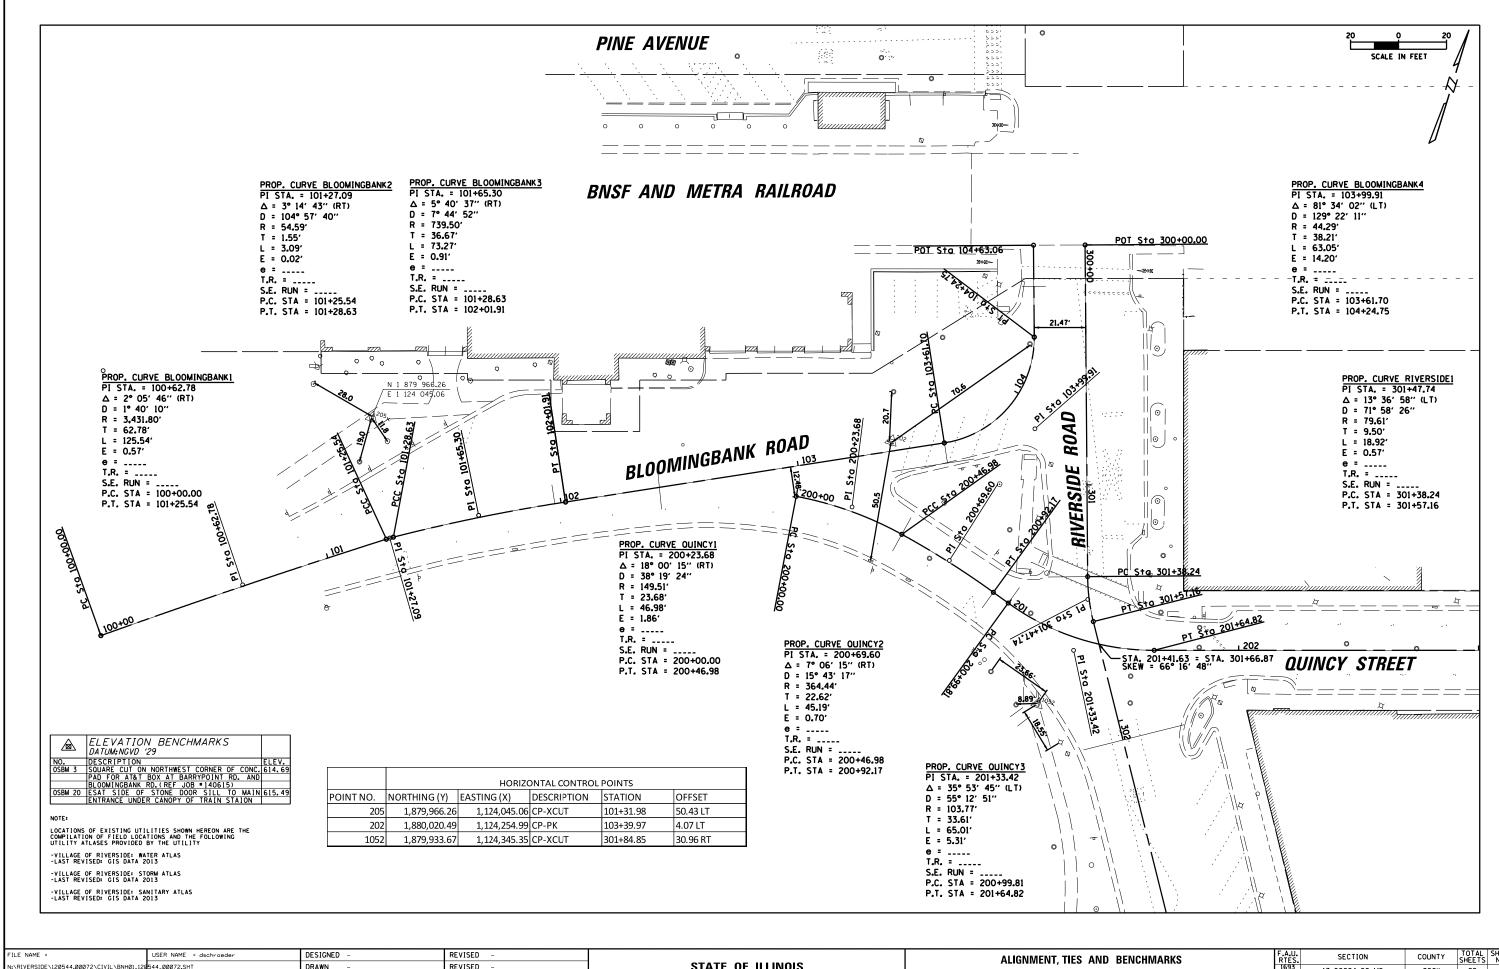



FILE NAME =	USER NAME = dschroeder	DESIGNED -	REVISED -			ALIGNN	JENT TIE	CINA 2	BENCHM	ΔRKS	F.A.U.	SECTION	COUNTY	TOTAL SHEET
N:\RIVERSIDE\120544.00072\CIVIL\BNH01_120	544_00072.SHT	DRAWN -	REVISED -	STATE OF ILLINOIS						MPROVEMENTS	1693 3569	17-00084-00-MS	соок	29 6
	PLOT SCALE = 40'	CHECKED -	REVISED -	DEPARTMENT OF TRANSPORTATION		IVIETNA STATIUN	I LEDES!	INIAN P	ICCESS II	WIPHUVEIWIEIVI 3	3303		CONTRAC	T NO. 61E89
Default	PLOT DATE = 5/10/2018	DATE -	REVISED -		SCALE:	SHEET 1	OF 1	SHEETS	STA.	TO STA.		ILLINOIS FED.	AID PROJECT	
		1				1 3 1 2 1						10011015 1001	AID THOOLET	_

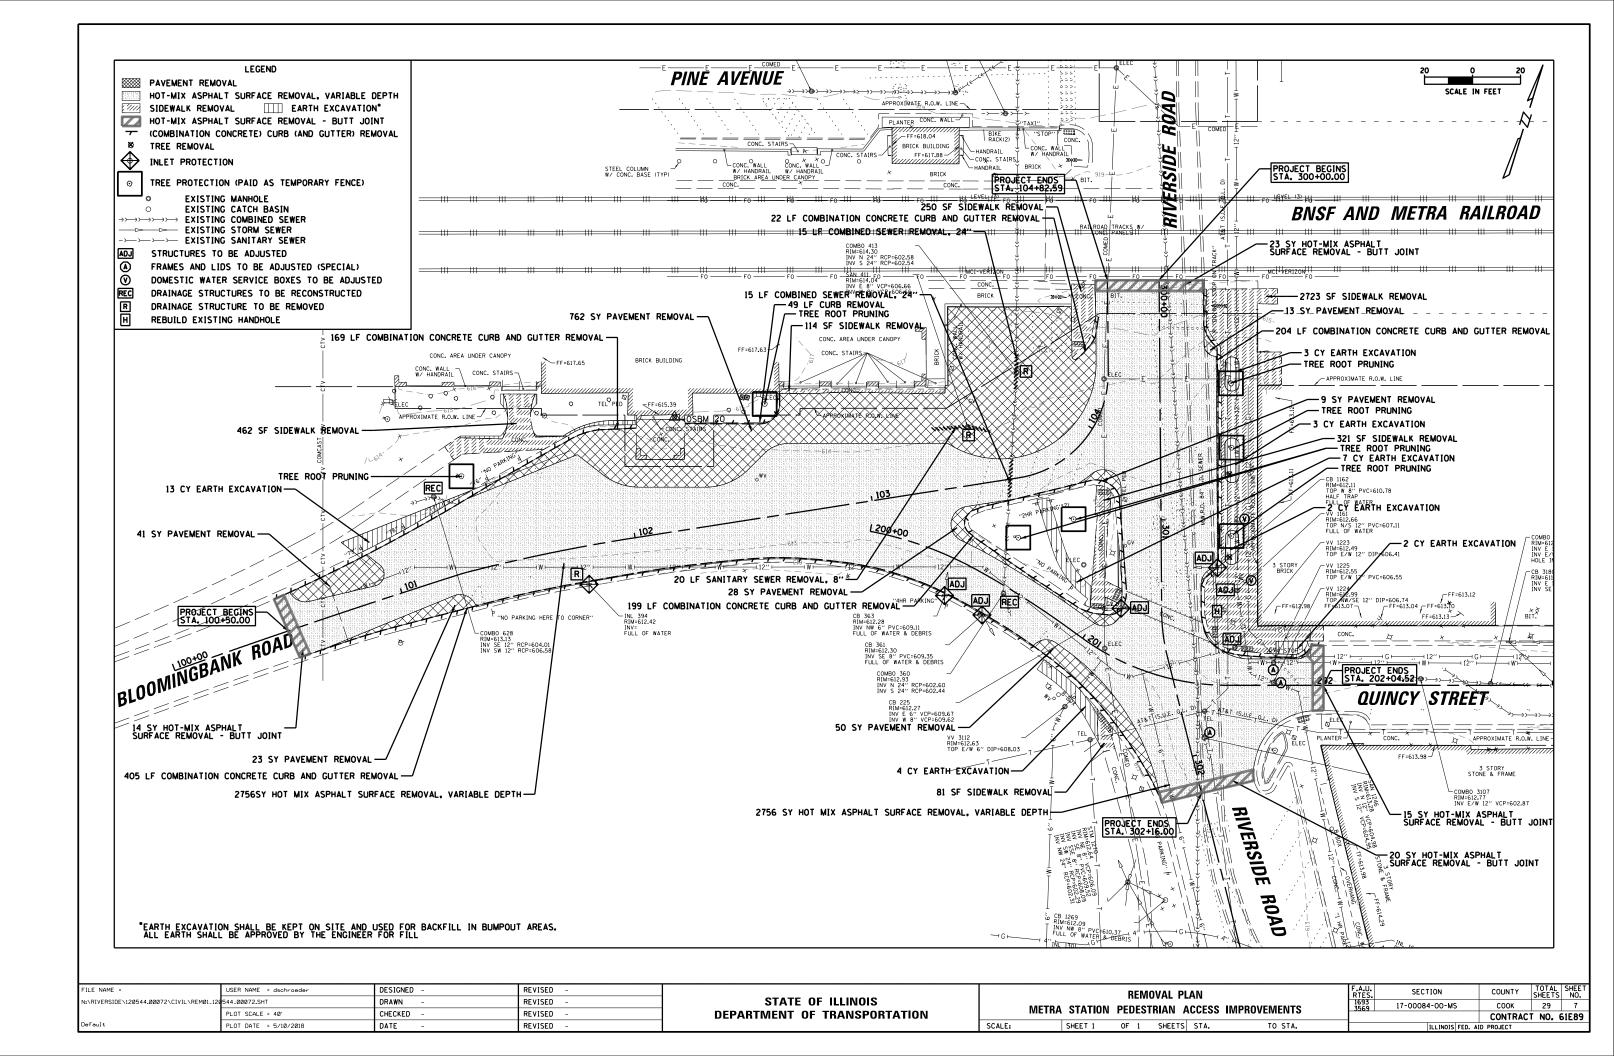


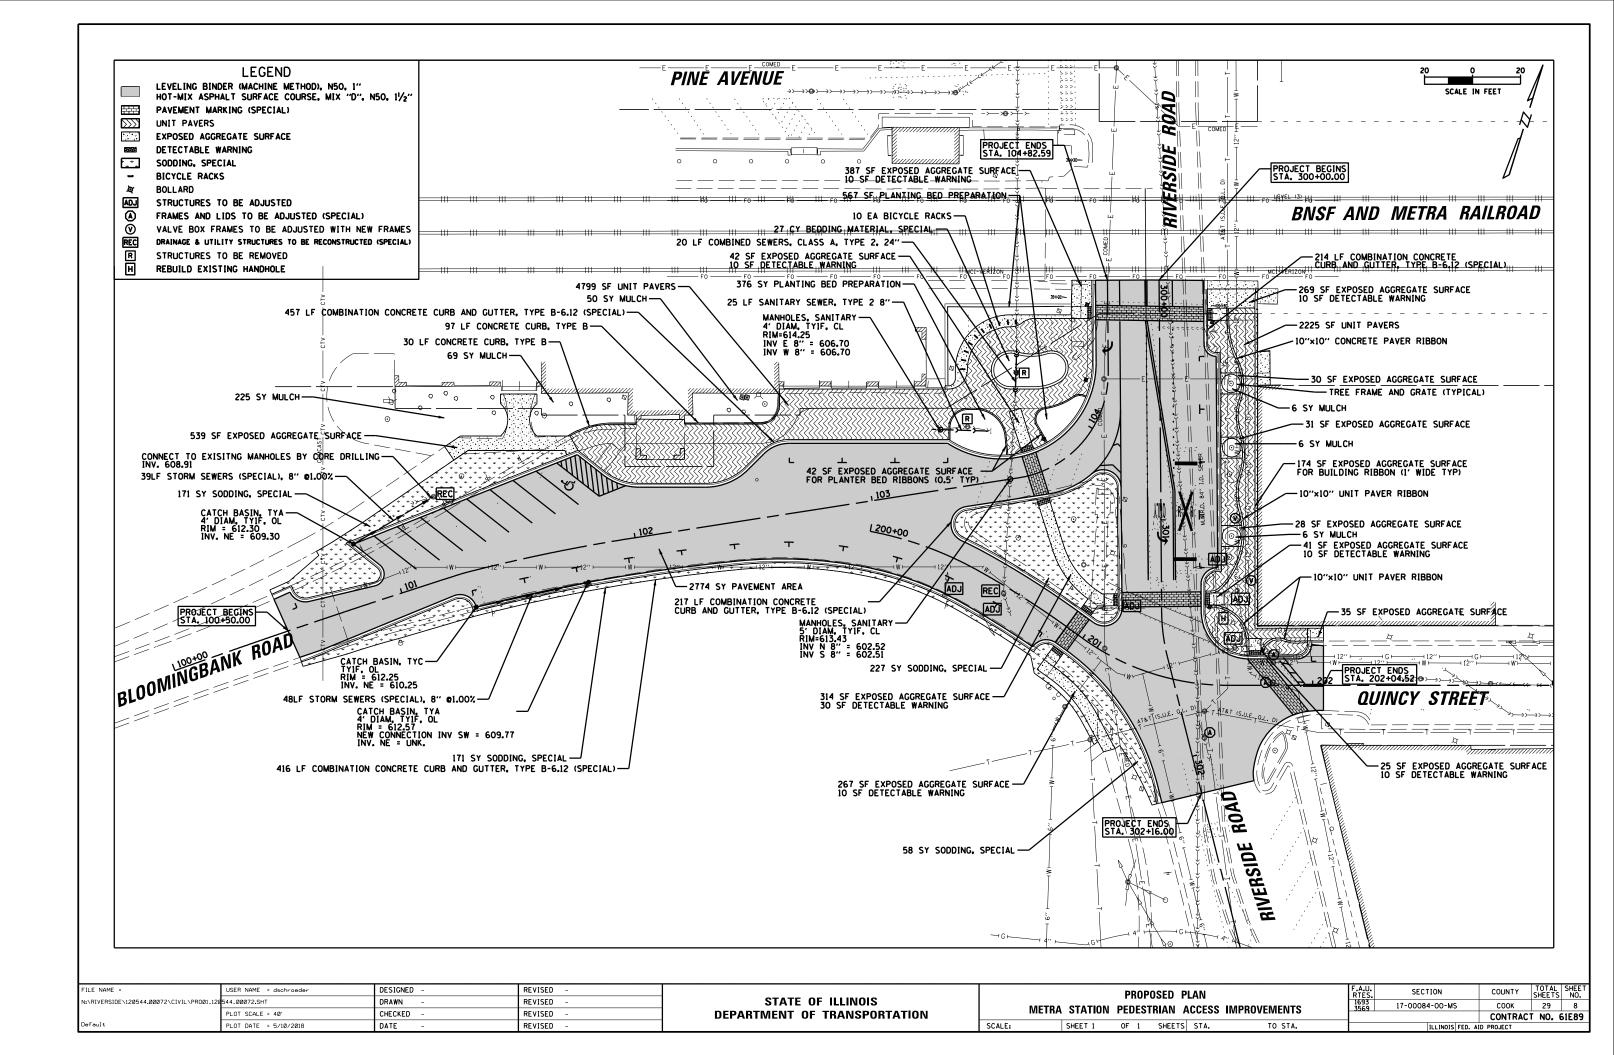


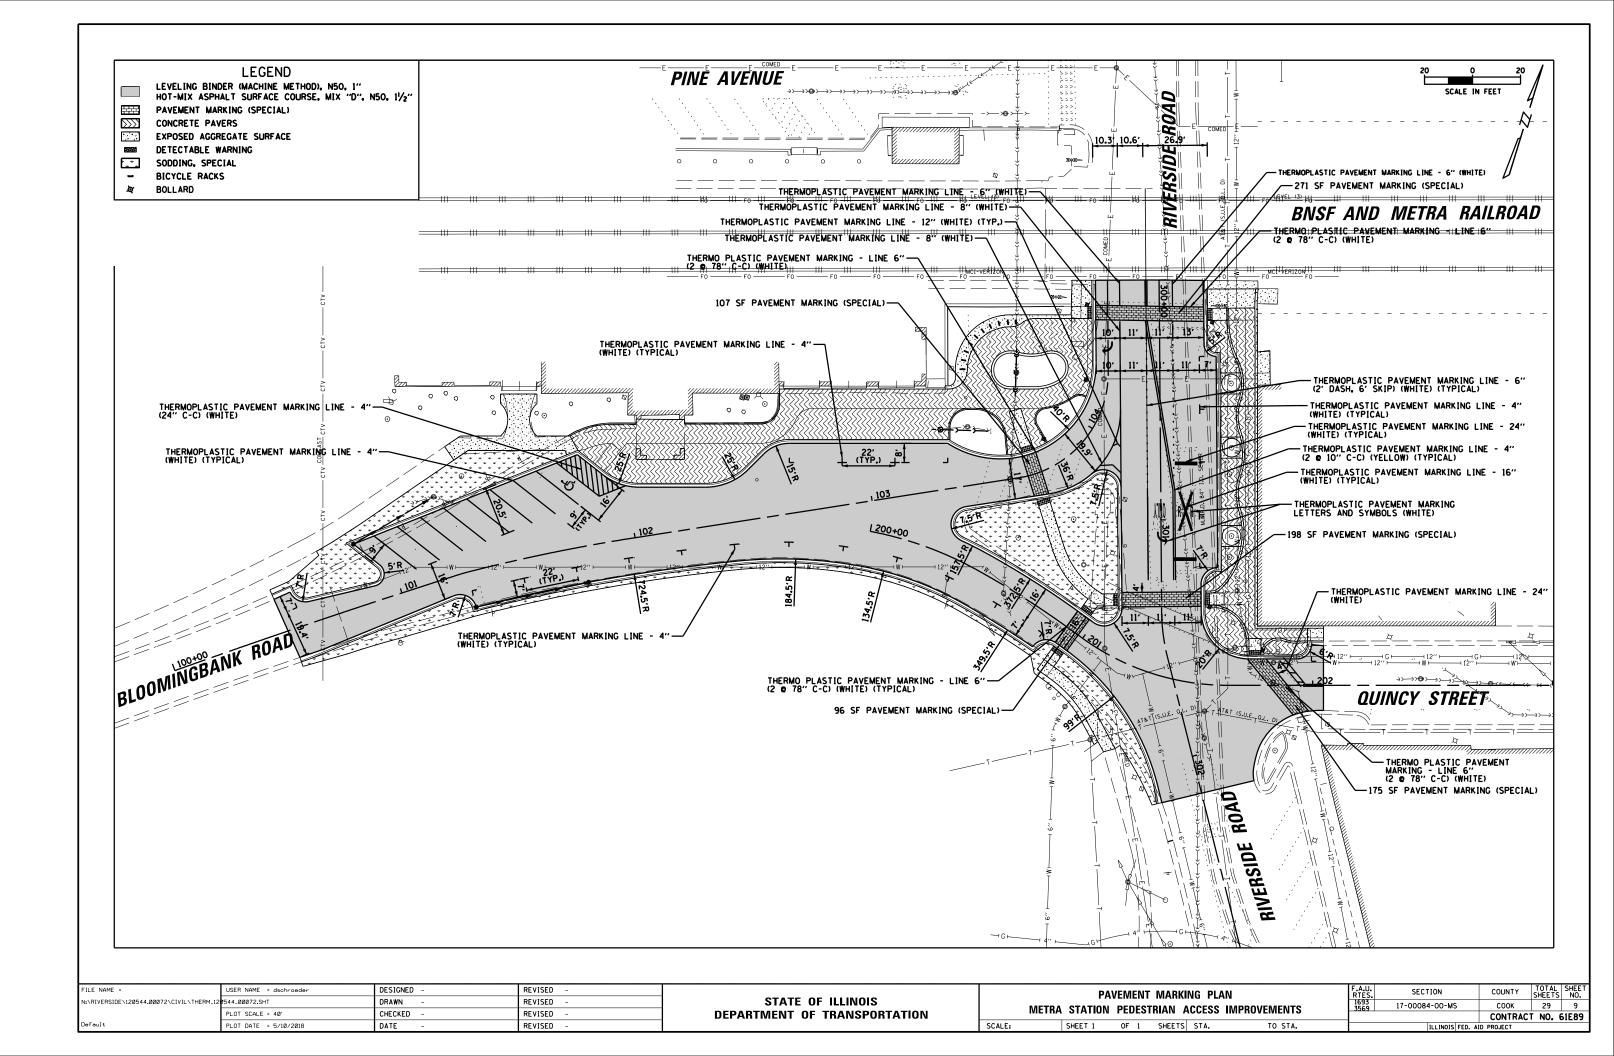


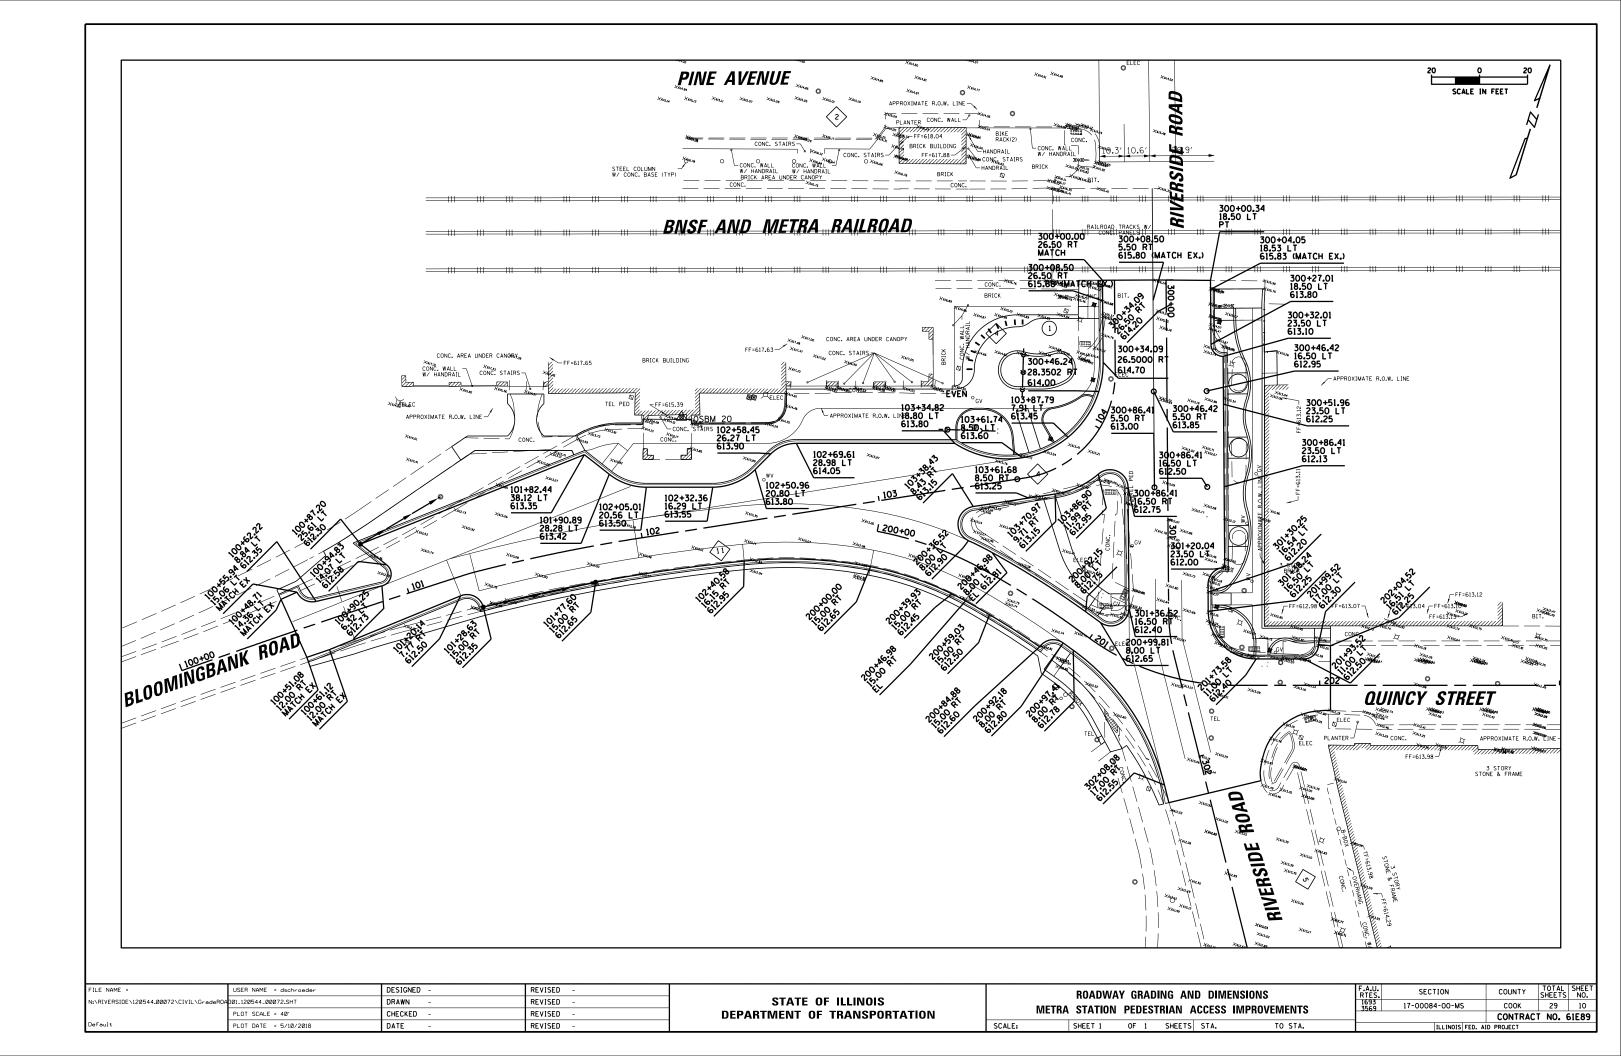

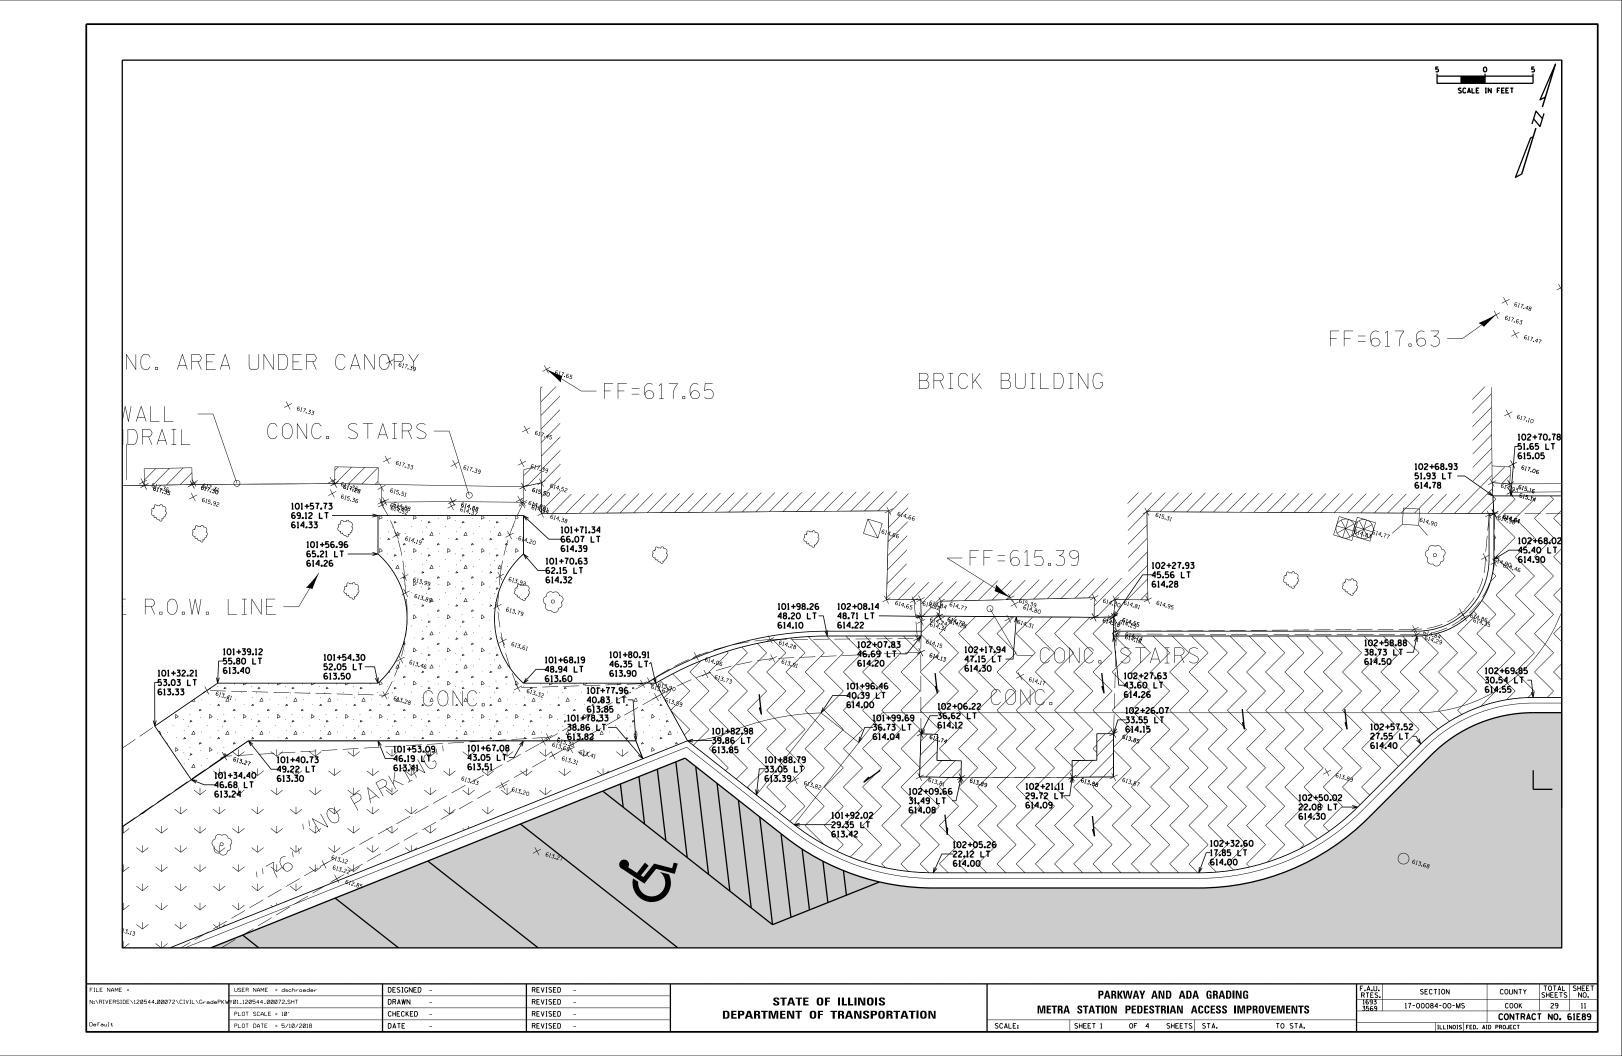

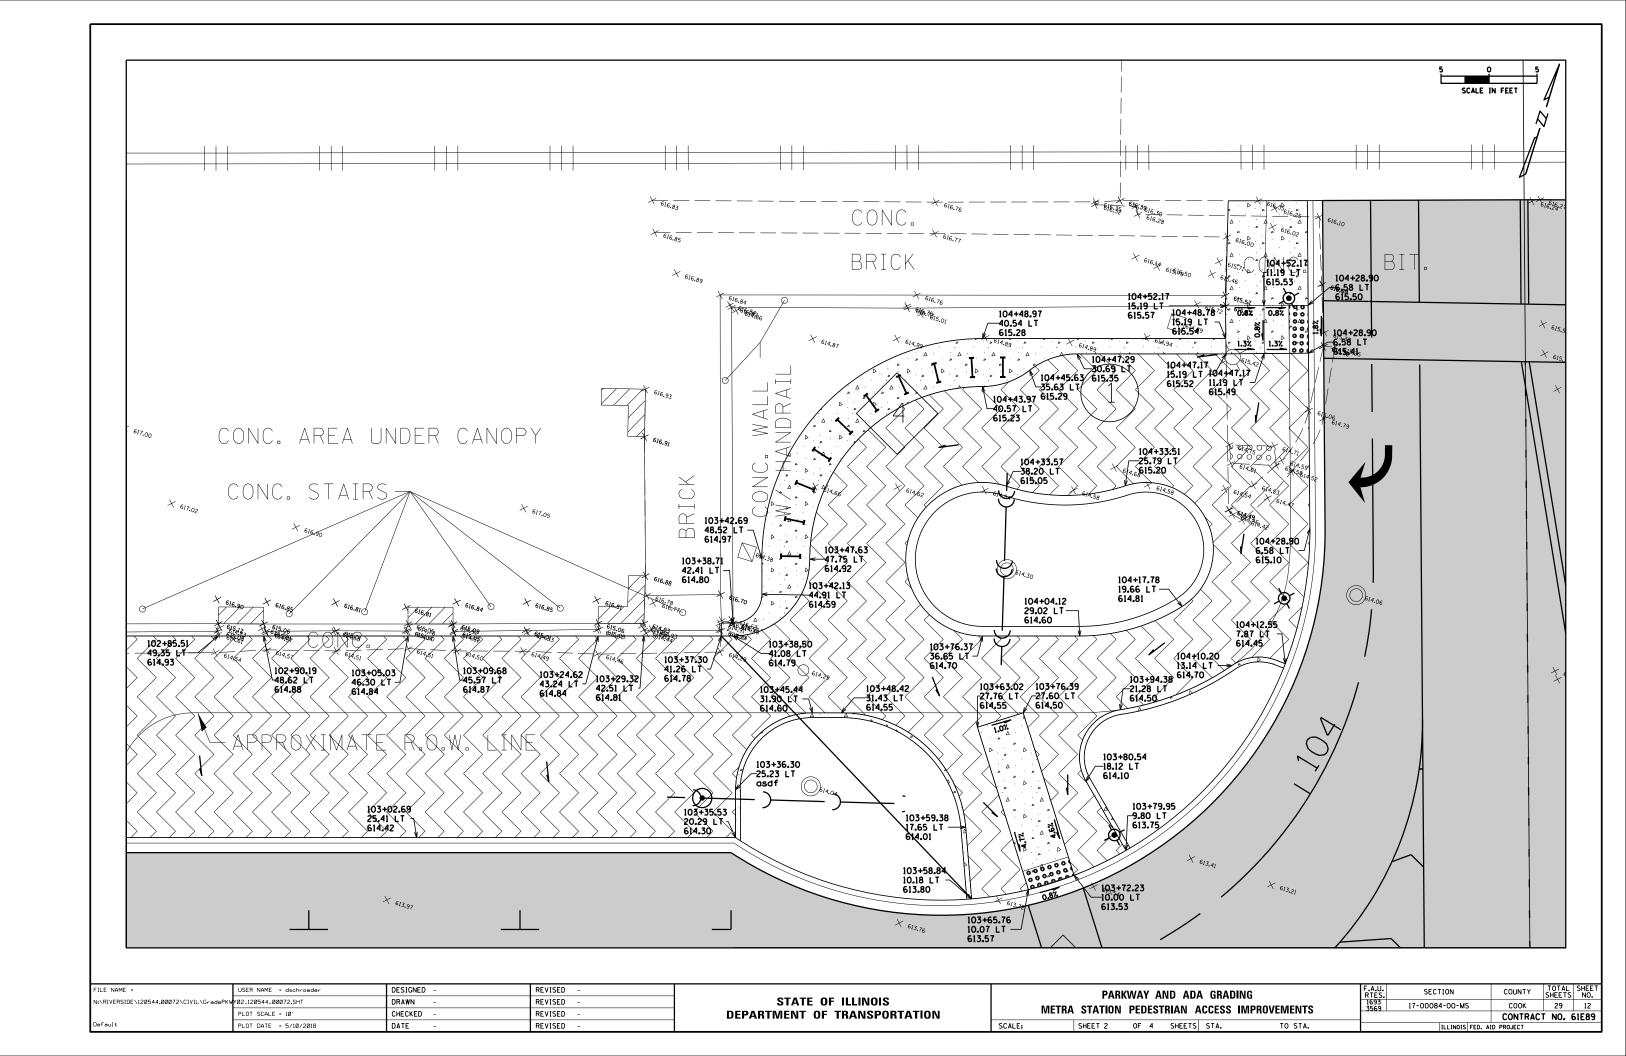

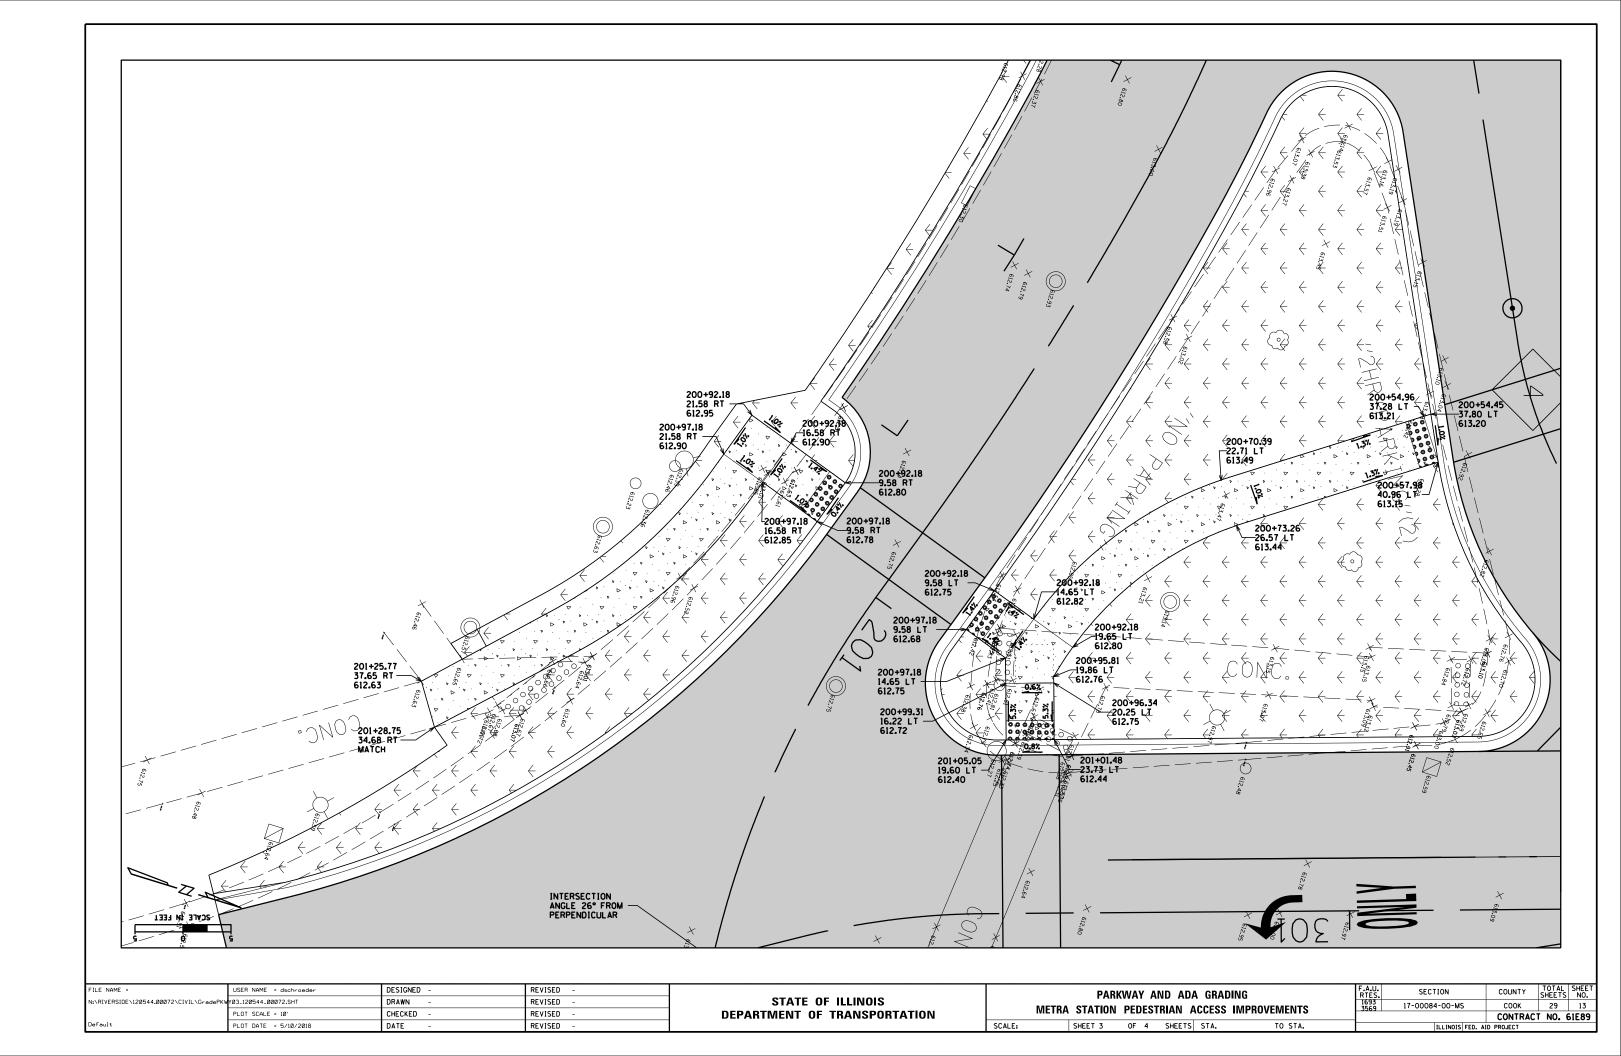

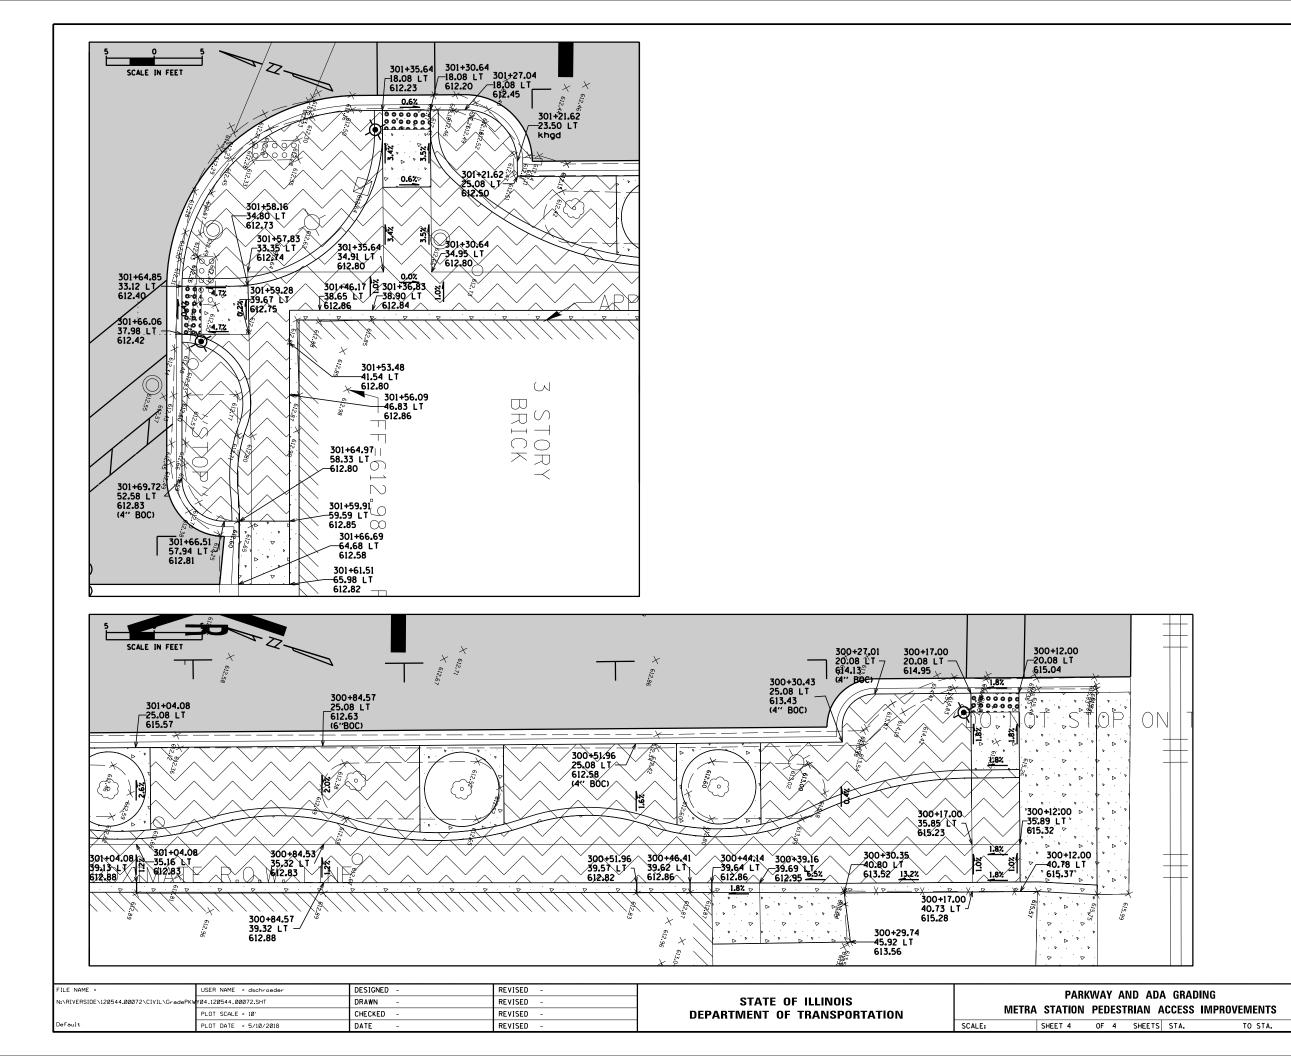

TOTAL SHEET SHEETS NO.


COOK 29 14

CONTRACT NO. 61E89

COUNTY

SECTION

17-00084-00-MS

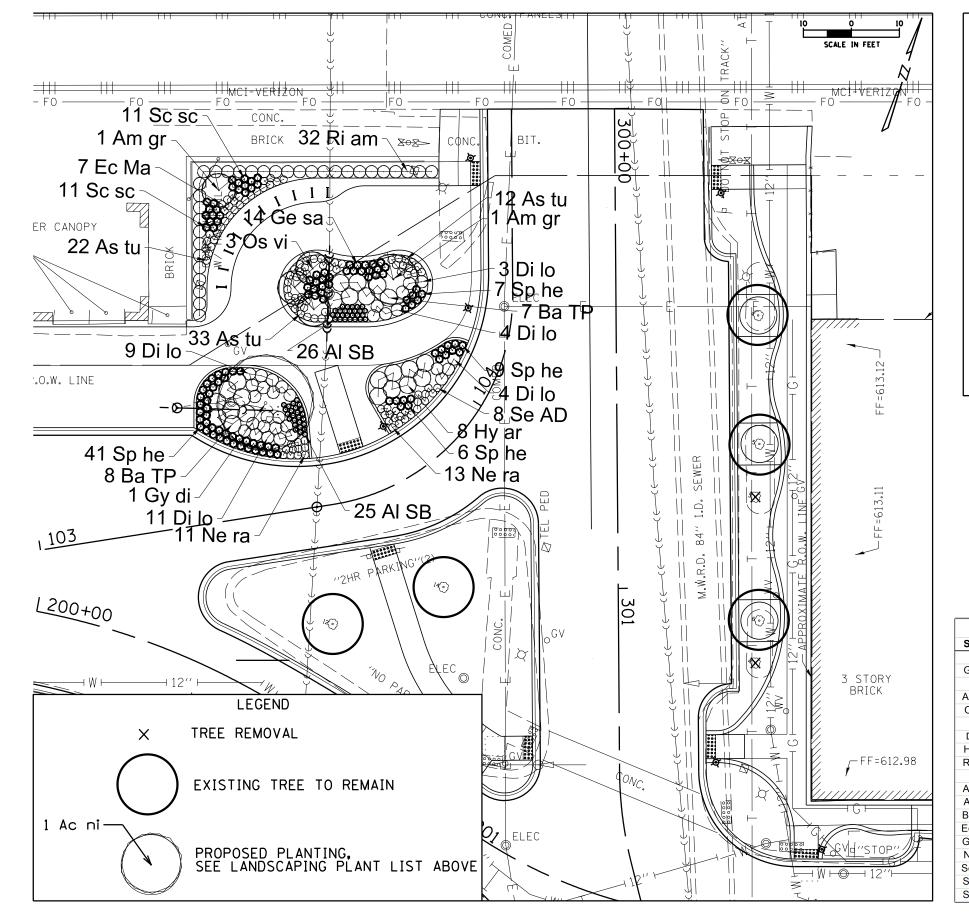

GENERAL CONSTRUCTION NOTES:

- ALL ALTERATIONS MUST BE APPROVED BY THE LANDSCAPE ARCHITECT. CONTRACTORS MUST VERIFY ALL QUANTITIES AND OBTAIN ALL PROPER PERMITS AND LICENSES FROM THE PROPER AUTHORITIES.
 ALL MATERIAL MUST MEET INDUSTRY STANDARDS AND THE LANDSCAPE ARCHITECT HAS THE RIGHT TO REFUSE ANY POOR MATERIAL OR WORKMANSHIP. 3.
- LANDSCAPE ARCHITECT IS NOT RESPONSIBLE FOR UNSEEN SITE
- 5.
- EXCAVATE ALL AT GRADE PLANTERS TO A DEPTH OF 18" AND BACKFILL WITH TOPSOIL.
 PROVIDE POSITIVE DRAINAGE AT ALL TIMES. DO NOT OBSTRUCT NATURAL OR DESIGNED DRAINAGE FLOW PATTERN.
 AMENDED SOIL FOR PLANTING SHALL BE MIXED THOROUGHLY PRIOR TO 6.
- 7.
- PLANTING.
 ALL PLANTINGS SHALL BE SPACED EQUAL DISTANT, BACKFILLED WITH
 AMENDED SOIL IN A HOLE TWICE THE ROOTBALL DIAMETER, WATERED,
 FERTILIZED, PRUNED AND HAVE ALL TAGS AND ROPES REMOVED.
 TREES SHALL BE STAKED AND GUYED AS NECESSARY AND CREATE 8.

- WATERING SAUCERS AT BASE.


 IF NEEDED WIDEN THE OPENINGS OF TREE GRATES BY 2" RADIUS TO ACCOMMODATE THE EXISTING TREES.

 ADD AMENDED SOIL TO EXCAVATED AREAS AROUND EXISTING TREES.

 ALL MASS PLANTED SHRUB BEDS TO BE BERMED 2" TO 3" ABOVE GRADE
- ALL MASS PLANTED SHRUB BEDS TO BE BERMED 2" TO 3" ABOVE GRADE AND MEET DRAINAGE REQUIREMENTS.
 LAWN AND BED AREAS SHALL BE ROTOTILLED AND CLUMPS OF SOIL, AGGREGATES AND DEBRIS RAKED OUT AND REMOVED FROM THE SITE.
 ALL BEDS SHALL BE EDGED, HAVE WEED PRE-EMERGENTS APPLIED AT THE RECOMMENDED RATE, AND SHREDDED HARDWOOD MULCH SPREAD AT A MINIMUM OF 4" DEPTH.
 ALL DEBRIS SHALL BE REMOVED FROM THE SITE AND DISPOSED
- OF PROPERLY.

	P	LANT LIST			
SYM.	BOTANICAL NAME	COMMON NAME	Qty.	Size	Cond.
	Deciduous Shade Trees				
Gy di	Gymnocladus dioicus 'Expresso'	Expresso Kentucky Coffeetree	1	2.5"	B & B
	Deciduous Ornamental Trees				
Am gr	Amelanchier grandiflora 'Autumn Brillance'	Autumn Brillance Serviceberry	2	6' Shrub	B & B
Os vi	Ostrya virginiana	Ironwood	3	7' Clump	B & B
	Deciduous Shrubs				
Di lo	Diervilla 'Kodiak Orange Bush'	Kodiak Orange Bush Honeysuckle	31	#5, 24" Ht.	Cont.
Hy ar	Hydrangea arborescens 'Annabelle'	8	2' Ht.	B & B	
Ri am	Ribes americanum	Wild Black Current	32	18" Ht.	Cont.
	Perennials				
AI SB	Allium 'Summer Beauty'	Summer Beauty Onion	51	#1	Cont.
As tu	Asclepias tuberosa	Butterfly Weed	67	#1	Cont.
Ba TP	Baptisia x varicolor 'Twilite'	Baptisia Twilite Prairieblues	15	#1	Cont.
Ec Ma	Echinacea 'Magnus'	Magnus Coneflower	7	#1	Cont.
Ge sa	Geranium sanguineum 'Max Frei'	Max Frei Bloody Cranesbill	14	#1	Cont.
Ne ra	Nepeta racemosa 'Walker's Low'	Walker's Low Catmint	24	#1	Cont.
Se AD	Sedum 'Autumn Delight'	Autumn Delight Sedum	8	#1	Cont.
Sc sc Schizachyrium scoparium		Little Bluestem	22	#1	Cont.
Sp he	Sporobolus heterolepis	Prairie Dropseed	63	#1	Cont.

FILE NAME =	USER NAME = dschroeder	DESIGNED -	REVISED -			LAND	SCAPIN	IG PLAN	AND DET	ΓΔΙΙ ς	F.A.U.	SECTION	COUNTY	TOTAL SHEET
N:\RIVERSIDE\120544.00072\CIVIL\LSP-12054	4_00072.sht	DRAWN -	REVISED -	STATE OF ILLINOIS	",					MPROVEMENTS	1693 3569	17-00084-00-MS	соок	29 15
	PLOT SCALE = 20'	CHECKED -	REVISED -	DEPARTMENT OF TRANSPORTATION	IVI	IEIRA STATIUI	IN PEDI	ESINIAN	ACCESS I	INIPROVEINIENTS	3303		CONTRAC	CT NO. 61E89
Default	PLOT DATE = 5/10/2018	DATE -	REVISED -		SCALE:	SHEET 1	0F	2 SHEET	S STA.	TO STA.		ILLINOIS FED. A	D PROJECT	

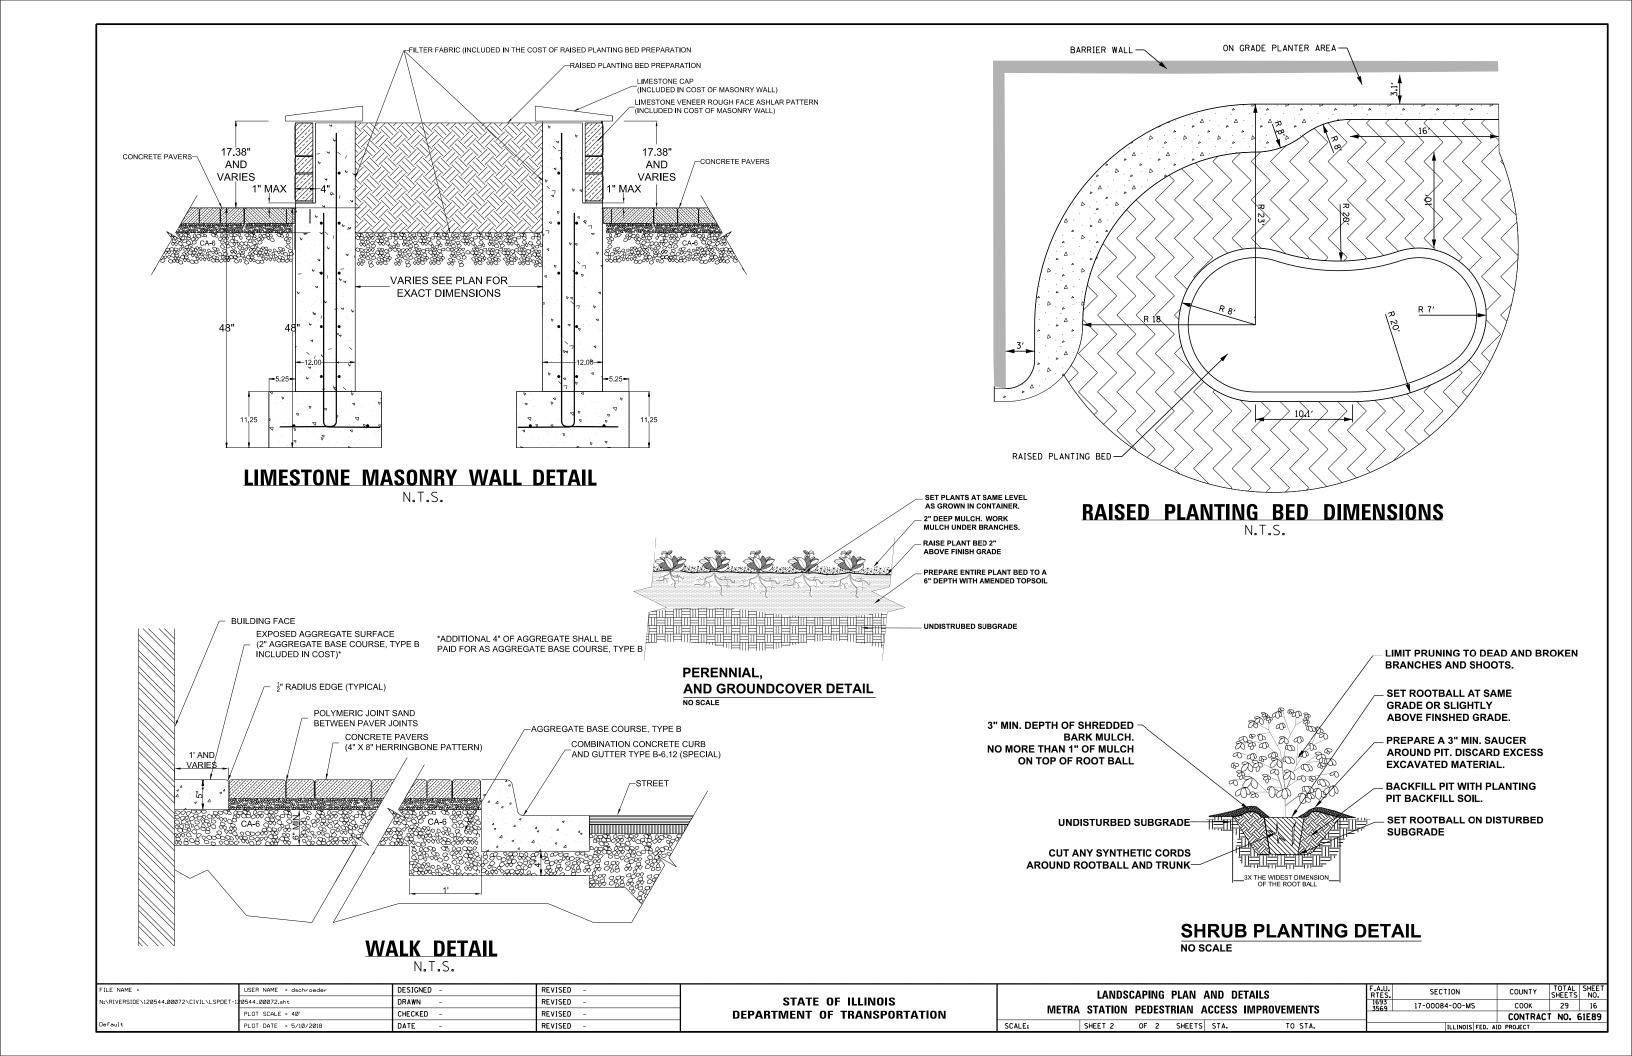

LEGEND PROPOSED 23W LED DECORATIVE BOLLARD EXISTING 100W MERCURY VAPOR LUMINAIRE ON 8'-6" DECORATIVE POLE PROPOSED 11" × 18" COMPOSITE CONCRETE HANDHOLE EXISTING 11" X 18" COMPOSITE CONCRETE HANDHOLE PROPOSED CONDUIT EXISTING CONDUIT

POLE/DECORATIVE POLE/BOLLARD IDENTIFIER
(LP - EX. POLE)


PI-CKT A CIRCUIT IDENTIFIER (PL - EX. PLATFORM POLE)
(B - PROP. BOLLARD)


SET BACK (FROM FOC TO © OF POLE)

LIGHTING BILL OF MATERIALS


DESCRIPTION	<u>UNIT</u>	QUANTITY
TRENCH BACKFILL	CY YD	27
UNDERGROUND CONDUIT. COILABLE NONMETALLIC CONDUIT. 34" DIA.	FOOT	325
ELECTRIC CABLE IN CONDUIT, 600V (XLP-TYPE USE) 1/C NO. 12	FOOT	980
HANDHOLE, COMPOSITE CONCRETE (SPECIAL)	EACH	1
BOLLARDS	EACH	6
MAINTAIN EXISTING LIGHTING SYSTEM	L SUM	1


120V CIRCUIT
TO CONTROLLER
IN TRAIN STATION CONDUCTOR SCHEDULE RAILROAD 1) 1/C =12, 1/C =12 N & 1/C =12 GND LIGHTING GENERAL NOTES THE EXACT LOCATIONS OF ALL UTILITIES SHALL BE VERIFIED BY THE CONTRACTOR BEFORE THE INSTALLATION OF ANY COMPONENTS OF THE LIGHTING SYSTEM. FOR THE LOCATIONS OF THE UTILITIES, CALL JULIE TOLL FREE AT (800) 892-0123. THE CONTRACTOR SHALL BE SOLELY RESPONSIBLE FOR JOB SITE SAFETY AS WELL AS SUPERVISION/DIRECTION AND MEANS/METHODS OF CONSTRUCTION. ALL WORK SHALL BE IN ACCORDANCE WITH THE LATEST EDITION OF THE FOLLOWING SPECIFICATIONS, WHICH ARE HEREBY MADE A PART HEREOF: -REMOVE EXISTING METAL HANDHOLE (HHG) AND REPLACE WITH PROPOSED, COMPOSITE CONCRETE HANDHOLE LP15 CKT 29 A. "STANDARD SPECIFICATIONS FOR ROAD AND BRIDGE CONSTRUCTION", AS PREPARED BY IDOT. B. "THE NATIONAL ELECTRICAL CODE". C. MUNICIPAL CODES & STANDARDS. NO MATERIALS SHALL BE DELIVERED TO THE JOB SITE UNTIL ALL PERTINENT EQUIPMENT SUBMITTALS HAVE BEEN REVIEWED BY THE ENGINEER. THE INSTALLATION OF BURIED WARNING TAPE, SPECIFIED AS PART OF TRENCH FOR UNDERGROUND CONDUITS, SHALL BE REVIEWED BY THE ENGINEER PRIOR TO BACKFILLING OR DURING PLOWING OPERATIONS, AS APPLICABLE. RIVERSIDE ROAD THE CONTRACTOR SHALL LABEL ALL WIRES WITH WIRE MARKERS INDICATING THE CIRCUIT ID IN EVERY CONTROLLER, POLE BASE, HAND HOLE AND SPLICE/CONNECTION POINT. WIRE MARKERS SHALL BE WHITE NYLON WITH INTEGRAL MECHANICAL FASTENER WITH MINIMUM $\frac{7}{4}$ " X 1" WRITEABLE AREA. ALL UNDERGROUND WIRING SHALL BE MINIMUM "8 COPPER (OR SIZE AS SHOWN ON THE PLANS) XLP TYPE-USE, EXTRA ABRASION RESISTANCE, 600 VOLTS, BURIED A MINIMUM 30 INCHES BELOW FINISHED GRADE, FOLLOWING THE ROADWAY OR SIDEWALK EDGE. ALL POLE HANDHOLES SHALL FACE AWAY FROM TRAFFIC OR AWAY FROM ROAD. THE CONTRACTOR SHALL BE RESPONSIBLE FOR THE ESTABLISHMENT OF THE TOP OF FOUNDATION ELEVATION WITH THE FINISHED GRADE. EXISTING HH4 10. EQUIPMENT GROUND CONDUCTORS SHALL BE SPLICED AND BONDED AT EACH LIGHT POLE OR OTHER PIECE OF EQUIPMENT. **EXISTING** EXISTING HH IT SHALL BE THE CONTRACTOR'S RESPONSIBILITY TO MARK THE PROPOSED LOCATIONS OF ALL LIGHT POLES FOR EXAMINATION AND CONFIRMATION WITH THE ENGINEER. ALL UTILITIES SHALL BE LOCATED PRIOR TO MARKING PROPOSED LOCATIONS. THE ELECTRICAL CONTRACTOR SHALL FURNISH TWO SETS OF FULL SIZE RECORD DRAWINGS TO THE ENGINEER UPON COMPLETION OF THE LIGHTING AND ELECTRICAL IMPROVEMENTS. THE DRAWINGS SHALL SHOW THE INSTALLED LOCATIONS OF ALL LIGHT POLES, JUNCTION BOXES & CONTROLLER CABINETS. THE DRAWINGS WILL BE REVIEWED BY THE ENGINEER. UPON COMPLETION OF THE PROPOSED LIGHTING IMPROVEMENTS, THE CONTRACTOR SHALL PERFORM ELECTRICAL TESTING AND VERIFY THAT THE INSTALLTION COMPLIES WITH THE LATEST EDITION OF THE STANDARD SPECIFICATIONS FOR ROAD AND BRIDGE CONSTRUCTION IN ILLINOIS. 4. COILABLE NONMETALLIC CONDUIT SHALL BE SCHEDULE 80 UNDER PAVED AREAS CAUTION NOTICE TO CONTRACTOR THE CONTRACTOR IS SPECIFICALLY CAUTIONED THE LOCATION AND/OR ELEVATION OF EXISTING AND PROPOSED UTILITIES AS SHOWN ON THESE PLANS. THE INFORMATION IS NOT TO BE RELIED ON AS BEING EXACT OR COMPLETE. THE CONTRACTOR MUST CALL THE 240V CIRCUIT TO STREET LIGHTING CONTROLLER LOCAL UTILITY LOCATION CENTER AT LEAST 72 HOURS BEFORE ANY EXCAVATION TO REQUEST EXACT FIELD LOCATIONS OF 120V CIRCUIT
TO STREET
LIGHTING CONTROLLER THE UTILITIES. IT SHALL BE THE RESPONSIBILITY OF THE THE VILLAGE OF RIVERSIDE WILL OWN AND CONTRACTOR TO INFORM ENGINEER OF ANY EXISTING UTILITIES MAINTAIN THE PROPOSED LIGHTING SYSTEM. WHICH CONFLICT WITH THE PROPOSED IMPROVEMENTS. REVISED DESIGNED -SECTION COUNTY RIVERSIDE ROAD /RIVERSIDE METRA STATION IMPROVEMENT N:\RIVERSIDE\120544.00072\Mech\LGT_120544.00072_01.SHT DRAWN RJJ REVISED STATE OF ILLINOIS 17-00084-00-MS COOK PROPOSED ELECTRICAL PLAN CHECKED -AJD REVISED **DEPARTMENT OF TRANSPORTATION** CONTRACT NO. 61E89 SCALE: 1" = 1' SHEET FEB 21, 2018 REVISED

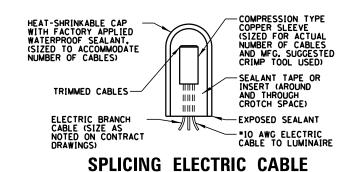

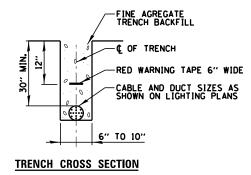

ELECTRIC CONDUIT INSTALLATIONN.T.S.

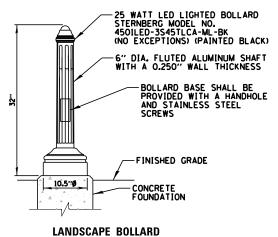


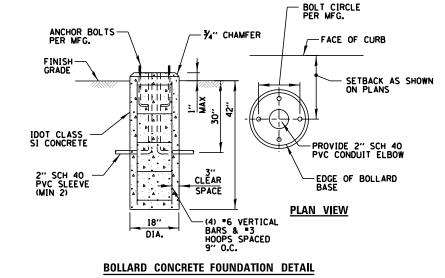

NOTES:

- 1. CONTRACTOR SHALL COORDINATE SIZE AND ORIENTATION OF BOLT CIRCLE, WITH BOLLARD MANUFACTURER.
- 2. CONCRETE FOUNDATION, ANCHOR BOLTS, SPARE RACEWAYS AND FASTENERS SHALL BE INCLUDED IN THE CONTRACT UNIT PRICE FOR "BOLLARDS".
- 3. FOUNDATIONS SHALL NOT PROTRUDE MORE THAN 4" ABOVE FINISHED GRADE INCLUDING ANCHOR RODS.


LANDSCAPE BOLLARD/FOUNDATION DETAIL N.T.S.

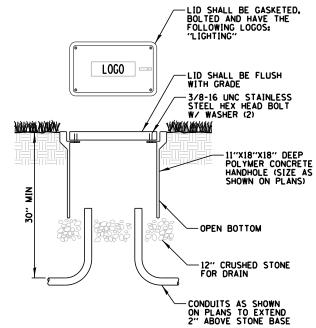


NOTES:

- 1. ALL SPLICES SHALL BE WATERPROOF. SEE SPLICING DETAIL.
- 2. POLYMER CONCRETE HANDHOLE AND LID SHALL BE GREY.
- 3. BOX & LID SHALL MEET/EXCEED ANSI TIER 15 LOADING REQUIREMENTS, AND BE TESTED IN ACCORDANCE WITH THE LATEST EDITION OF THE ANSI/SCTE 77 "SPECIFICATION FOR UNDERGROUND ENCLOSURE INTEGRITY". AND THE PROVISIONS OF PARAGRAPHS 5.2.3 AND 5.2.4 OF WESTERN UNDERGROUND COMMITTEE GUIDE 3.6.

POLYMER CONCRETE HANDHOLE

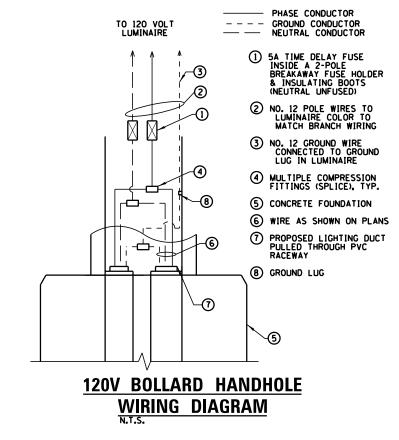

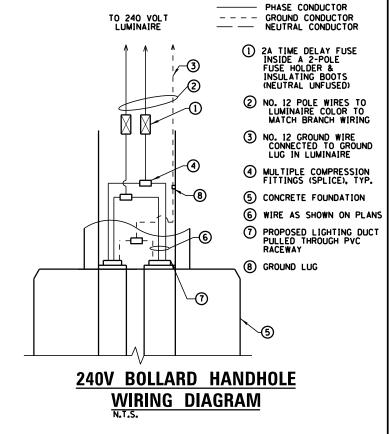

- 1	FILE NAME =	USER NAME = dschroeder	DESIGNED	-	AJD	REVISED -
-	N:\RIVERSIDE\120544.00072\Mech\LDT_12054	4.00072_01.SHT	DRAWN	-	RJJ	REVISED -
-		PLOT SCALE = 2'	CHECKED	-	AJD	REVISED -
ı	Default	PLOT DATE = 5/10/2018	DATE	-	FEB 21, 2018	REVISED -


STATE OF ILLINOIS
DEPARTMENT OF TRANSPORTATION


RIVERSIDE ROAD / RIVERSIDE METRA STATION IMPROVEMENT


ELECTRICAL DETAILS (1 OF 2)

SCALE: 1" = 1' SHEET OF SHEETS STA. TO STA.

_		TILLINOIS FED. A		NO.	31503
			CONTRACT	NO. 6	51E89
	1693	17-00084-00-MS	соок	29	18
	F.A.U RTE.	SECTION	COUNTY	TOTAL SHEETS	SHEET NO.

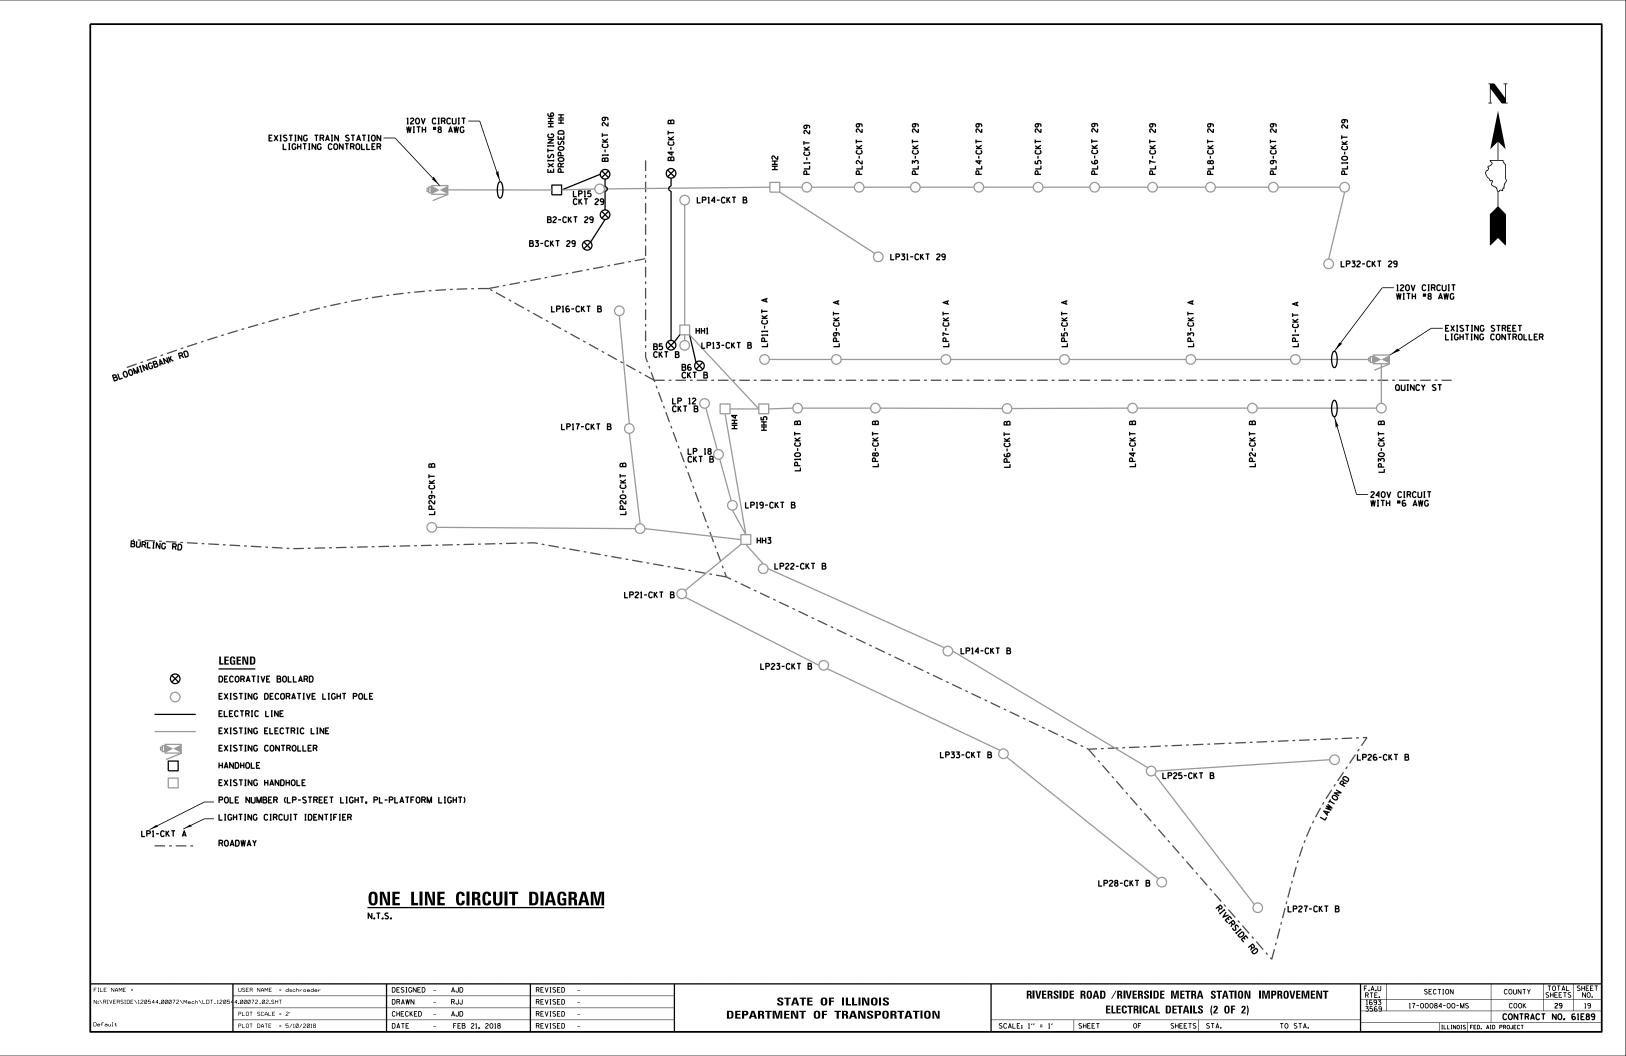

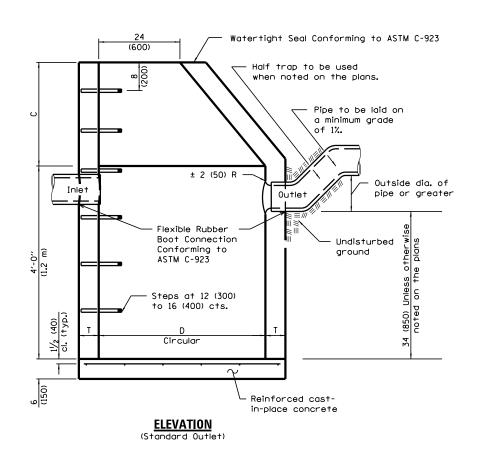

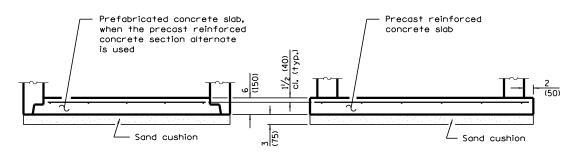

ALTERNATE BOTTOM SLAB

ALTERNATE MATERIALS FOR WALLS Precast Reinforced Concrete Section 5'-0" (1.2 m) 30 (750) 4 (100) 5 (125) Cast-in-place Concrete 4'-0" (1.2 m) 30 (750) 6 (150) 5 (125)

• For precast reinforced concrete sections, dimension "C" may vary from the dimension given to plus 6 (150).

GENERAL NOTES


Bottom slabs shall be reinforced with a minimum of 0.20 sq. in./ft (420 sq. mm/m) in both directions with a maximum spacing of 12 (300).

Bottom slabs may be connected to the riser as determined by the fabricator; however, only a single row of reinforcement around the perimeter may be utilized.

See Standard 602601 for optional precast reinforced concrete flat slab top.

See Standard 602701 for details of steps.


All dimensions are in inches (millimeters) unless otherwise shown.

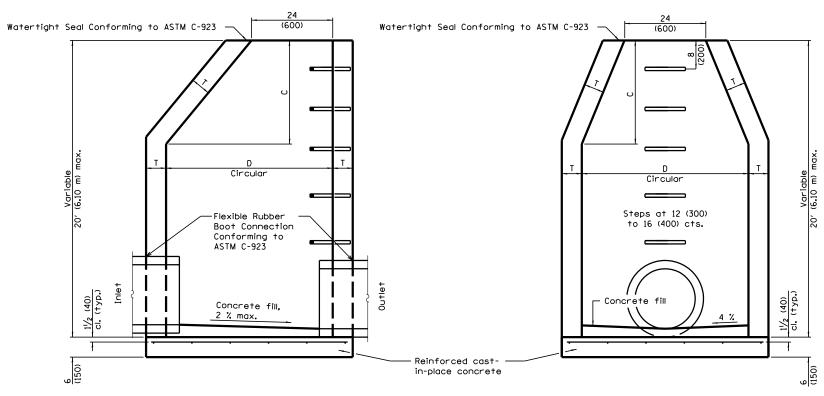

MANHOLES, TYPE A

<u>ELEVATION – ECCENTRIC</u>

ELEVATION – CONCENTRIC

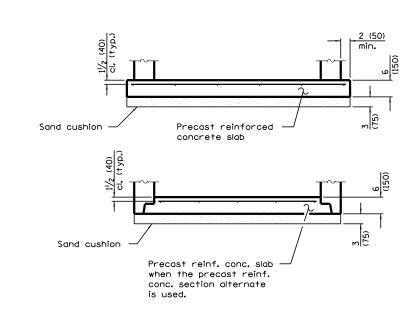

ALTERNATE BOTTOM SLAB

ALTERNATE MATERIALS FOR WALLS	D	C•	T (min.)
Precast Reinforced	4'-0'' (1.2 m)	30 (750)	4 (100)
Concrete Section	5'-0'' (1.5 m)	3'-9" (1.15 m)	5 (125)
Cast-in-place Concrete	4'-0'' (1.2 m)	30 (750)	6 (150)
	5'-0'' (1.5 m)	3'-9" (1.15 m)	6 (150)

• For precast reinforced concrete sections, dimension "C" may vary from the dimension given to plus 6 (150).

GENERAL NOTES

Bottom slabs shall be reinforced with a minimum of 0.31 sq. in./ft. (660 sq. mm/m) in both directions with a maximum spacing of 12 (300).

Bottom slabs may be connected to the riser as determined by the fabricator; however, only a single row of reinforcement around the perimeter may be utilized.


See Standard 602701 for details of steps.

See Standard 602601 for optional Precast Reinforced Concrete Flat Slab Top.

All dimensions are in inches (millimeters) unless otherwise shown.


CATCH BASIN, TYPE A


FILE NAME =	USER NAME = dschroeder	DESIGNED -	REVISED -		CONSTRUCTION DETAILS	A.U. SECTION	COUNTY TOTAL SHEET
N:\RIVERSIDE\120544.00072\CIVIL\DET_1205	400083.SHT	DRAWN -	REVISED -	STATE OF ILLINOIS		1693 3569 17-00084-00-MS	COOK 29 20
	PLOT SCALE = 40'	CHECKED -	REVISED -	DEPARTMENT OF TRANSPORTATION	METRA STATION PEDESTRIAN ACCESS IMPROVEMENTS	1369	CONTRACT NO. 61E89
Default	PLOT DATE = 5/10/2018	DATE -	REVISED -		SCALE: SHEET 1 OF 3 SHEETS STA. TO STA.	ILLINOIS FED.	AID PROJECT

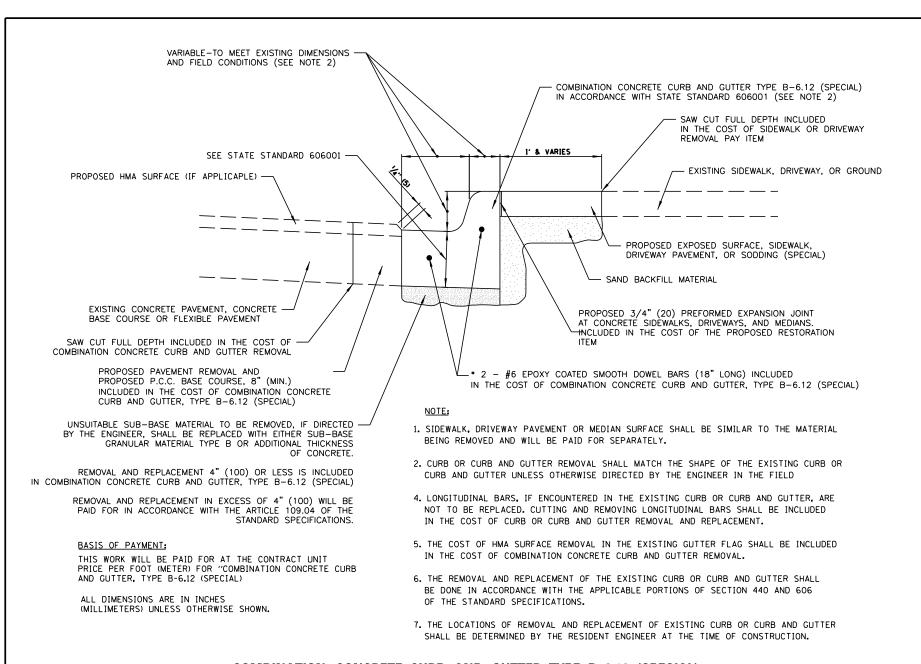

COMBINATION CONCRETE CURB AND GUTTER, TYPE B-6.12 (SPECIAL)

FIL	E NAME =	USER NAME = dschroeder	DESIGNED -	REVISED -				CON	NISTRII	CTION	DETAILS		F.A.U.	SECTION	COUNTY	TOTAL SHEET
N:\	RIVERSIDE\120544.00072\CIVIL\DET_1205	400083_02.SHT	DRAWN -	REVISED -	STATE OF ILLINOIS		BALTDA OTA					ADDOVERACTIO	1693 3569	17-00084-00-MS	СООК	29 21
		PLOT SCALE = 40'	CHECKED -	REVISED -	DEPARTMENT OF TRANSPORTATION		METRA STA	HUN P	LENE2 I	KIAN	ACCE22 IN	/IPROVEMENTS	3569			T NO. 61E89
Def	ault	PLOT DATE = 5/10/2018	DATE -	REVISED -		SCALE:	SHEET	2 (OF 3	SHEETS	S STA.	TO STA.		ILLINOIS FED. AI	D PROJECT	

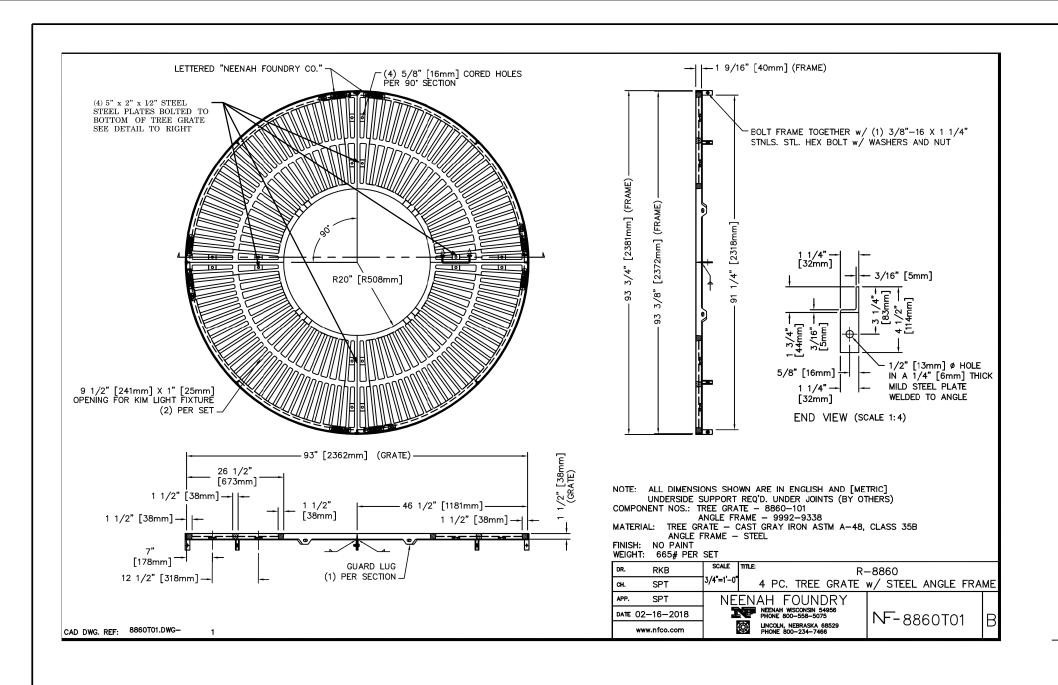


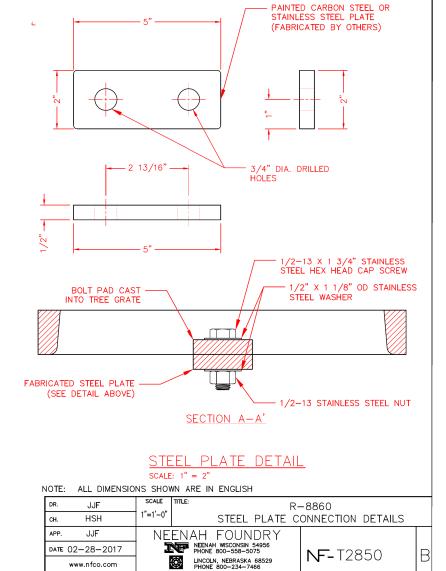


FILE NAME =	USER NAME = dschroeder	DESIGNED -	REVISED -	
N:\RIVERSIDE\120544.00072\CIVIL\DET_1205	400083_03.SHT	DRAWN -	REVISED -	
	PLOT SCALE = 40'	CHECKED -	REVISED -	
Default	PLOT DATE = 5/10/2018	DATE -	REVISED -	

STATE OF ILLINOIS
DEPARTMENT OF TRANSPORTATION

Ī	CONSTRUCTION DE	TAILS	F.A.U. RTES.	SECTION	COUNTY	TOTAL SHEETS	SHEET NO.
I	METRA STATION PEDESTRIAN ACC	ESS IMPROVEMENTS	1693 3569	17-00084-00-MS	COOK	29	22
l	WEIRA STATION TEDESTINAN ACC	LOG IIVII IIOVLIVILIVIO			CONTRACT	NO. 6	61E89
ı	SCALE: SHEET 3 OF 3 SHEETS S	A. TO STA.		ILLINOIS FED. A	D PROJECT		

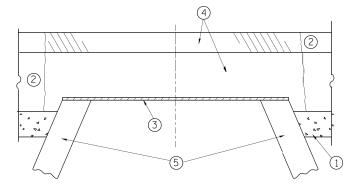

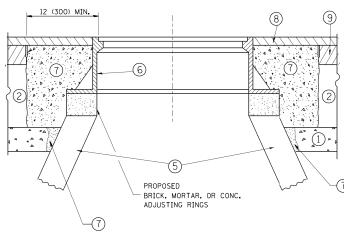

EXISTING BROKEN FRAMES AND LIDS SHALL BE REMOVED AND DISPOSED OF BY THE CONTRACTOR AND SHALL BE REPLACED AS DIRECTED BY THE ENGINEER. REPLACEMENT FRAMES AND LIDS WILL BE PAID FOR IN ACCORDANCE WITH ARTICLE 109,04 OF THE STANDARD SPECIFICATIONS UNLESS A SEPARATE PAY ITEM HAS BEEN PROVIDED.

IF THE EXISTING LIDS ARE OPEN, THE FRAME WILL BE ADJUSTED TO THE ELEVATION OF THE MILLED PAVEMENT SURFACE PRIOR TO THE MILLING OPERATION. THE FRAME WILL NOT BE REMOVED AND COVERED BY THE METAL PLATE.

CITY OF CHICAGO CASTINGS ARE THE PROPERTY OF THE CITY AND THE CONTRACTOR SHALL NOTIFY THE CITY FOR REMOVAL AND DISPOSITION OF THE CASTINGS.

THE METAL PLATE USED TO COVER THE STRUCTURE SHALL REMAIN THE PROPERTY OF THE CONTRACTOR.

WHEN STRUCTURES ARE TO BE ADJUSTED OR RECONSTRUCTED, THE LOWERING AND RAISING OF THE FRAMES AND LIDS WILL NOT BE PAID FOR SEPARATELY BUT WILL BE INCLUDED IN THE COST OF THE CORRESPONDING PAY ITEM.

CONSTRUCTION PROCEDURES

STAGE 1 (BEFORE PAVEMENT MILLING)

- A) REMOVE A MINIMUM OF 12 (300) OF THE PAVEMENT FROM
- AROUND THE STRUCTURE.
 B) REMOVE THE EXISTING FRAME AND LID FROM THE STRUCTURE.
- C) COVER THE STRUCTURE OPENING WITH A 36 (900) DIAMETER METAL PLATE.

 D) BACKFILL WITH CRUSHED STONE AND A MINIMUM 11/2 (40)
- D) BACKFILL WITH CRUSHED STONE AND A MINIMUM 11/2 (40 THICK HMA SURFACE MIX APPROVED BY THE ENGINEER.

STAGE 2 (AFTER PAVEMENT MILLING)

- A) REMOVE THE HMA SURFACE MIX AND CRUSHED STONE.
- B) INSTALL THE FRAME AND LID; ADJUST THE FRAME TO ITS FINAL SURFACE ELEVATION.
- C) THE SURROUNDING SPACE SHALL BE FILLED WITH CLASS PP-1*
 CONCRETE TO THE ELEVATION OF THE SURFACE OF THE EXISTING
 BASE COURSE OR THE BINDER COURSE.
- *UNLESS OTHERWISE SPECIFIED IN THE PLANS.

THE PROCEDURE EXPLAINED ABOVE SHALL CONFORM TO THE APPLICABLE PORTIONS OF SECTIONS 353, 406, 602, AND 603 OF THE STANDARD SPECIFICATIONS EXCEPT THAT "THE CONTRACTOR SHALL ADJUST THE STRUCTURES TO THE FINISHED PAVEMENT ELEVATION NO MORE THAN 5 CALENDAR DAYS PRIOR TO PLACEMENT OF THE FINAL LIFT OF SURFACE UNLESS APPROVED BY THE ENGINEER."

LEGEND

- 1 SUB-BASE GRANULAR MATERIAL
- (6) FRAME AND LID (SEE NOTES)
- 2 EXISTING PAVEMENT

(5) EXISTING STRUCTURE

- (7) CLASS PP-1* CONCRETE
- 3 36 (900) DIAMETER METAL PLATE
- 8 PROFOSED HMA SURFACE COURSE
- PROPOSED CRUSHED STONE AND HMA SURFACE MIX
- (9) PROFOSED HMA BINDER COURSE

LOCATION OF STRUCTURES:

THE CONTRACTOR WILL BE REQUIRED TO KEEP A RECORD OF THE LOCATIONS OF THE BURIED STRUCTURES ACCORDING TO THE STATION AND DISTANCE LEFT OR RIGHT OF THE CENTERLINE OF PAVEMENT. UPON CCMPLETION OF THE WORK, THE CONTRACTOR WILL DELIVER THE RECORD TO THE ENGINEER.

BASIS OF PAYMENT:

REMOVING FRAMES AND LIDS ON DRAINAGE AND UTILITY STRUCTURES IN THE PAVEMENT PRIOR TO MILLING, AND ADJUSTING TO FINAL GRADE PRIOR TO PLACING THE SURFACE COURSE, WILL BE PAID FOR AT THE CONTRACT UNIT PRICE EACH FOR "FRAMES AND LIDS TO BE ADJUSTED (SPECIAL)."

THIS WORK WILL NOT BE PAID FOR WHEN DRAINAGE AND UTILITY STRUCTURES ARE SPECIFIED FOR PAYMENT AS STRUCTURE RECONSTRUCTION.

NEW FRAMES AND LIDS, WHEN SPECIFIED, WILL BE PAID FOR SEPARATELY.


DETAILS FOR FRAMES AND LIDS ADJUSTMENT WITH MILLING

ALL DIMENSIONS ARE IN INCHES (MILLIMETERS) UNLESS OTHERWISE SHOWN

FILE NAME =	USER NAME = bauerdl	DESIGNED	-	R. SHAH	REVISED	- R. WIEDEMAN 05-14-04
c:\pw_work\pwidot\bauerdl\d0108315\bd08.	dgn	DRAWN	-		REVISED	- R. BORO 01-01-C7
	PLOT SCALE = 1968.5000 '/ m	CHECKED	-		REVISED	- R. BORO 03-09-11
	PLOT DATE = 12/6/2011	DATE	-	10-25-94	REVISED	- R. BORO 12-06-11

STATE OF ILLINOIS	
DEPARTMENT OF TRANSPORTATION	

DETAILS FOR						
	FRAMES AND	LIDS	ADJUSTM	ENT WITH	I MILLING	356
SCALE: NONE	SHEET NO. 1	OF 1	SHEETS	STA.	TO STA.	FED.

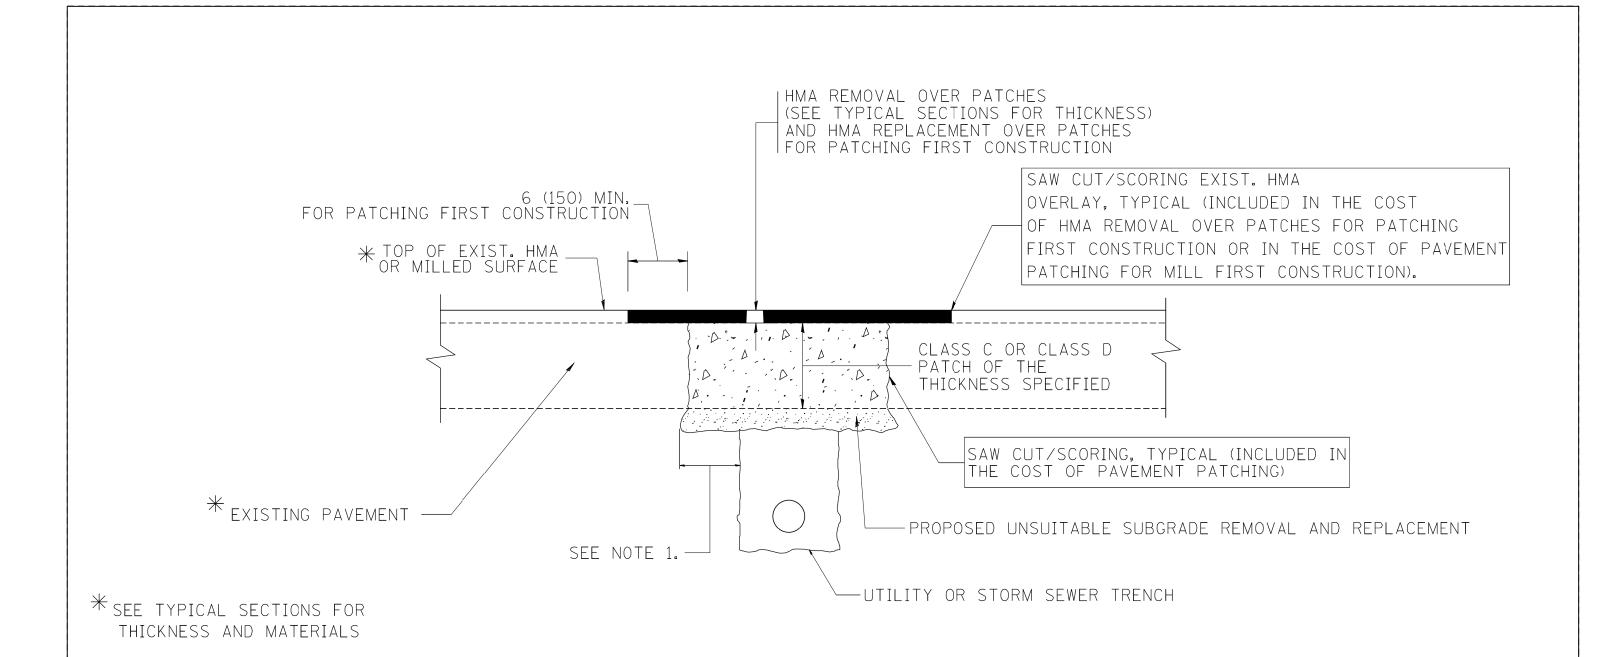

- 1. THE WIDTH OF THE FULL DEPTH PATCH OVER A TRENCH SHALL BE 12 (300) WIDER ON EACH SIDE OF THE TRENCH.
- 2. FOR METHOD OF MEASUREMENT AND BASIS OF PAYMENT, SEE RECURRING SPECIAL PROVISION "PATCHING WITH HOT-MIX ASPHALT OVERLAY REMOVAL".

SEQUENCE OF CONSTRUCTION (PATCHING FIRST)


- 1. REMOVE THE EXISTING HMA MATERIAL OVER THE AREA TO BE PATCHED.
- 2. REMOVE AND REPLACE WITH CLASS C OR D PATCH.
- 3. REPLACE HMA MATERIAL OVER THE AREA TO BE PATCHED.

SEQUENCE OF CONSTRUCTION (MILLING FIRST)


- 1. MILL HMA FIRST IF THERE IS AT LEAST $4\frac{1}{2}$ INCHES OR MORE OF HMA MATERIAL ON TOP OF THE EXISTING PAVEMENT OR IF THE PAVEMENT IS FULL DEPTH HMA. A MINIMUM OF 2 INCHES OF HMA MATERIAL SHALL BE IN PLACE AFTER MILLING.
- 2. REMOVE AND REPLACE WITH FULL DEPTH CLASS D PATCHES TO TOP OF MILLED SURFACE.

ALL DIMENSIONS ARE IN INCHES (MILLIMETERS) UNLESS OTHERWISE SHOWN.

c:\projects\diststd22x34\bd22.dgn	USER NAME = bauerdl	DESIGNED - R. SHAH DRAWN -	REVISED - A. ABBAS 04-27-98 REVISED - R. BORO 01-01-07	STATE OF ILLINOIS		PAVEMENT PATCHING FOR		RTE. SECTION 1693 17-00084-00-MS	COUNTY SHEETS NO.
	PLOT SCALE = 50.000 ' / [N.	CHECKED -	REVISED - R. BORO 09-04-07	DEPARTMENT OF TRANSPORTATION		HMA SURFACED PAVEMENT		BD400-04 (BD-22)	CONTRACT NO. 61E89
	PLOT DATE = 10/27/2008	DATE - 10-25-94	REVISED - K. ENG 10-27-08		SCALE: NONE	SHEET NO. 1 OF 1 SHEETS STA. TO S	TA.	FED. ROAD DIST. NO. 1 ILLINOIS FED. A	ID PROJECT

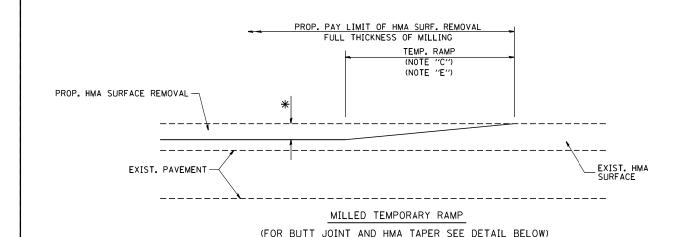


OPTION 1

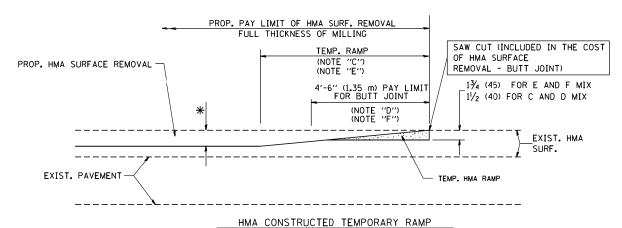

(FOR BUTT JOINT AND HMA TAPER SEE DETAIL BELOW)


OPTION 2 TYPICAL TEMPORARY RAMP

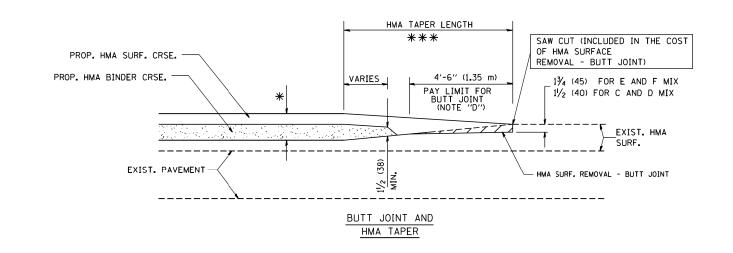


TYPICAL BUTT JOINT AND HMA TAPER FOR MILLING AND RESURFACING

FILE NAME = goglianobt DESIGNED - M. DE YONG REVISED - R. SHAH 10-25-94
W:\distatd\22x34\bd32.dgn
PLOT SCALE = 50,0000 '/ IN.
PLOT DATE = 1/4/2008
DATE - 06-13-90
REVISED - R. SHAH 10-25-94
REVISED - A. ABBAS 03-21-97
REVISED - M. GOMEZ 04-06-01
REVISED - M. GOMEZ 04-06-01

STATE OF ILLINOIS
DEPARTMENT OF TRANSPORTATION

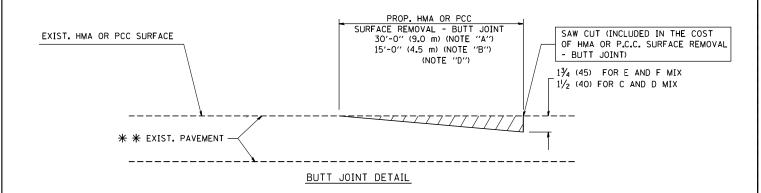

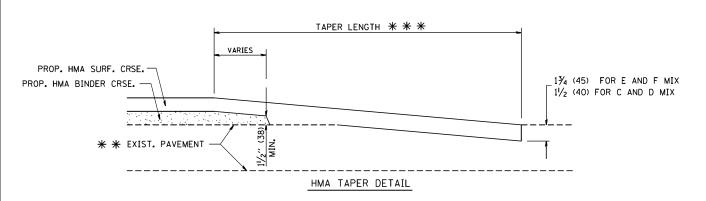

TYPICAL BUTT JOINT AND HMA TAPER FOR RESURFACING ONLY

* * PC CONCRETE, HMA OR HMA RESURFACED PAVEMENT.

NOTES


- A: MAINLINE ROADWAYS AND MAJOR SIDE ROADS.
- B: MINOR SIDE ROADS.
- C: THE TEMP. RAMP SHALL BE CONSTRUCTED IMMEDIATELY UPON REMOVAL OF THE EXISTING HMA SURFACE.
- D: THE BUTT JOINT SHALL BE CONSTRUCTED IMMEDIATELY PRIOR TO PLACING THE PROPOSED HMA COURSES.
- E: TAPER THE TEMP. RAMP AT A RATE OF 3'-0" (900 mm) PER 1 INCH (25 mm) OF MILLING THICKNESS.
- F: INSTALLATION AND REMOVAL OF THE 4'-6" (1.35 m) TEMP. RAMP IS INCLUDED IN COST OF HMA SURFACE REMOVAL BUTT JOINT
- G: SEE ARTICLE 406.08 AND 406.14 OF THE STANDARD SPECIFICATIONS FOR "HMA AND/OR PCC SURFACE REMOVAL, BUTT JOINT".
- * SEE TYPICAL SECTIONS FOR MILLING THICKNESS.
- ** * 20'-0" (6.1 m) PER 1 (25) RESURFACING (NOTE "A") 10'-0" (3.0 m) PER 1 (25) RESURFACING (NOTE "B")

BASIS OF PAYMENT:

THE BUTT JOINT WILL BE PAID FOR AT THE CONTRACT UNIT PRICE PER SQUARE YARD (SQUARE METER)
FOR "HOT-MIX ASPHALT SURFACE REMOVAL - BUTT JOINT" OR FOR "PORTLAND CEMENT CONCRETE SURFACE REMOVAL- BUTT JOINT".

SCALE: NONE

ALL DIMENSIONS ARE IN INCHES (MILLIMETERS) UNLESS OTHERWISE SHOWN.

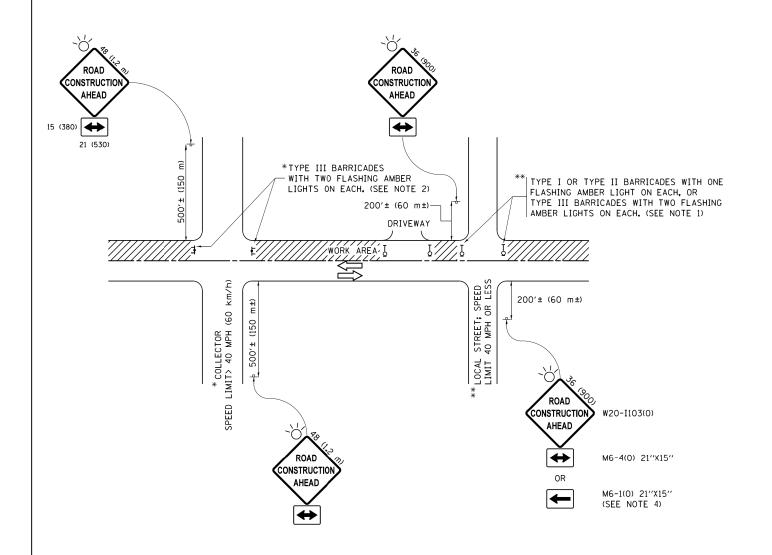

- SIDE ROAD WITH A SPEED LIMIT OF 40 MPH (60 km/h) OR LESS AS SHOWN ON THE DRAWING AND AS DIRECTED BY THE ENGINEER:
 - a) ONE "ROAD CONSTRUCTION AHEAD" SIGN 36 x 36 (900x900) WITH A FLASHER MOUNTED ON IT APPROXIMATELY 200" (60 m) IN ADVANCE OF THE MAIN ROUTE.
 - b) THE CLOSED PORTION OF THE MAIN ROUTE SHALL BE PROTECTED BY BLOCKING WITH TYPE I, TYPE II OR TYPE III BARRICADES, 1/3 OF THE CROSS SECTION OF THE CLOSED PORTION.
- 2. SIDE ROAD WITH A SPEED LIMIT GREATER THAN 40 MPH (60 km/h) AS SHOWN ON THE DRAWING AND AS DIRECTED BY THE ENGINEER:
 - a) ONE "ROAD CONSTRUCTION AHEAD" SIGN 48 x 48 (1.2 m x 1.2 m) WITH A FLASHER MOUNTED ON IT APPROXIMATELY 500" (150 m) IN ADVANCE OF THE MAIN ROUTE.
 - b) THE CLOSED PORTION OF THE MAIN ROUTE SHALL BE PROTECTED BY BLOCKING WITH TYPE III BARRICADES, 1/2 OF THE CROSS SECTION OF THE CLOSED PORTION.
- 3. CONES MAY BE SUBSTITUTED FOR BARRICADES OR DRUMS AT HALF THE SPACING DURING DAY OPERATIONS. CONES SHALL BE A MINIMUM OF 28 (710) IN HEIGHT
- 4. WHEN THE SIDE ROAD LIES BETWEEN THE BEGINNING OF THE MAINLINE SIGNING AND THE WORK ZONE, A SINGLE HEADED ARROW (M6-1) SHALL BE USED IN LIEU OF THE DOUBLE HEADED ARROW (M6-4).

- 5. WHEN WORK IS BEING PERFORMED ON A SIDE ROAD OR DRIVEWAY, FOLLOW THE APPLICABLE STANDARD(S). THE DIRECTIONAL ARROW (M6-1 OR M6-4) SHALL BE COVERED OR REMOVED WHEN NO LONGER CONSISTENT WITH THE TRAFFIC CONTROL SET-UP.
- 6. ADVANCE WARNING SIGNS ARE TO BE OMITTED ON DRIVEWAYS UNLESS OTHERWISE SPECIFIED IN THE PLANS OR BY THE FNGINFFR.
- 7. THE TRAFFIC CONTROL AND PROTECTION FOR SIDE ROADS, INTERSECTIONS, AND DRIVEWAYS SHALL BE INCLUDED IN THE COST OF SPECIFIED TRAFFIC CONTROL STANDARDS OR ITEMS.


All dimensions are in inches (millimeters) unless otherwise shown.

FILE NAME =	USER NAME = footemj	DESIGNED - L.H.A.	REVISED	- A. HOUSEH 10-15-96
pw:\\ILØ84EBIDINTEG.:ll:no:s.gov:PWIDOT\Do	cuments\IDOT Offices\District 1\Projects\Dist	DRAWN \CADD a ta\CADsheets\tc10.dgn	REVISED	-T. RAMMACHER 01-06-00
	PLOT SCALE = 50.000 '/ in.	CHECKED -	REVISED	- A. SCHUETZE 07-01-13
Default	PLOT DATE = 9/15/2016	DATE - 06-89	REVISED	- A. SCHUETZE 09-15-16

STATI	E 01	FILLINOIS
DEPARTMENT	0F	TRANSPORTATION

					TION FOR DRIVEWAYS
SCALE: NONE	SHEET 1	OF 1	SHEETS	STA.	TO STA.

A.U. TE.	SECTION		COUNTY	TOTAL SHEETS	SHE
693 569	17-00084-00-MS		соок	29	20
	TC-10		CONTRACT	NO. (51E8
	TILL INOIS FEE) Δ1	D PROJECT		

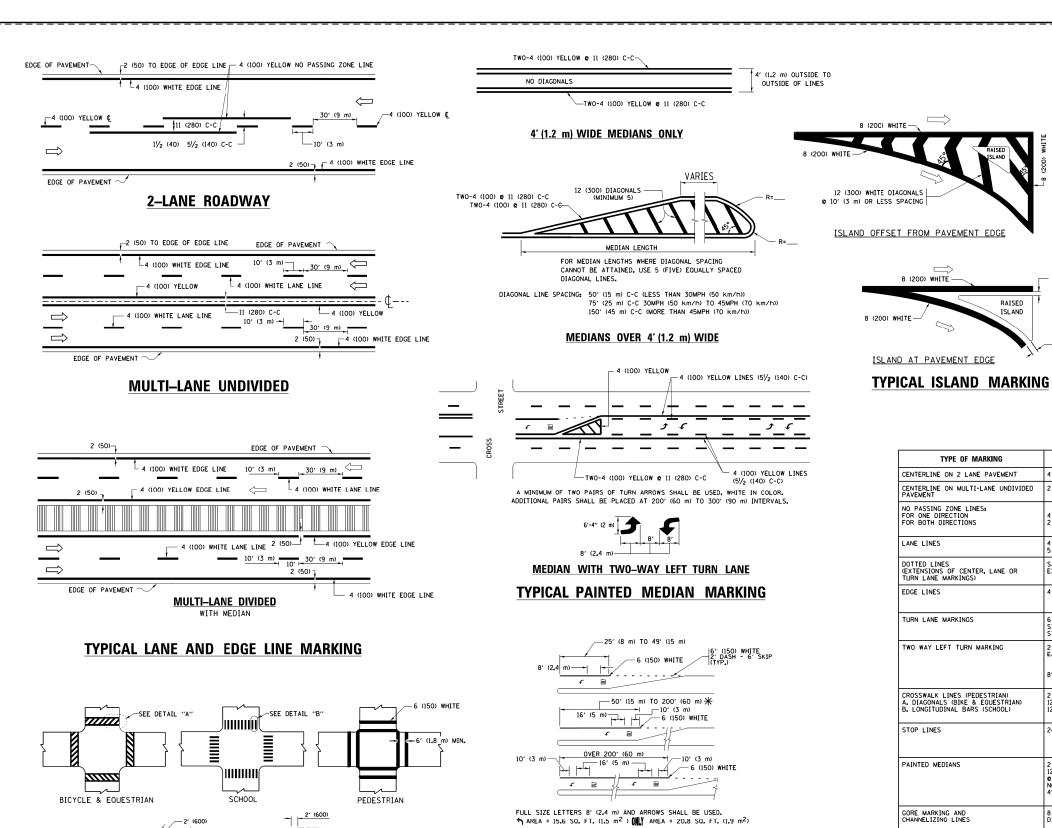


TURN LANES IN EXCESS OF 400' (120 m) IN LENGTH MAY HAVE AN ADDITIONAL SET OF ARROW - "ONLY" INSTALLED MIDWAY BETWEEN THE OTHER TWO SETS OF ARROW - "ONLY". TYPICAL LEFT (OR RIGHT) TURN LANE TYPICAL TURN LANE MARKING

SCALE:

8 (200) WHITE -

RAISED

ISLAND

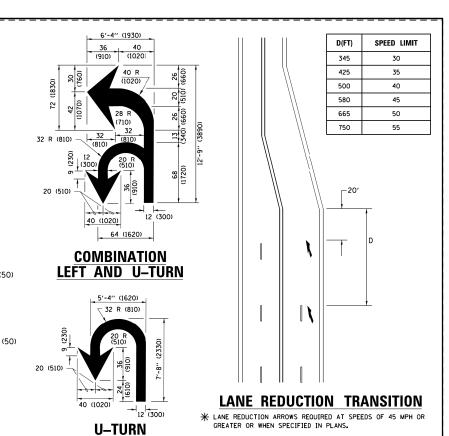

TYPE OF MARKING	WIDTH OF LINE	PATTERN	COLOR	SPACING /REMARKS
CENTERLINE ON 2 LANE PAVEMENT	4 (100)	SKIP-DASH	YELLOW	10' (3 m) LINE WITH 30' (9 m) SPACE
CENTERLINE ON MULTI-LANE UNDIVIDED PAVEMENT	2 @ 4 (100)	SOLID	YELLOW	11 (280) C-C
NO PASSING ZONE LINES: FOR ONE DIRECTION FOR BOTH DIRECTIONS	4 (100) 2 e 4 (100)	SOLID SOLID	YELLOW YELLOW	5½ (140) C-C FROM SKIP-DASH CENTERLINE 11 (280) C-C OMIT SKIP-DASH CENTERLINE BETWEEN
LANE LINES	4 (100) 5 (125) ON FREEWAYS	SKIP-DASH SKIP-DASH	WHITE WHITE	10' (3 m) LINE WITH 30' (9 m) SPACE
DOTTED LINES (EXTENSIONS OF CENTER, LANE OR TURN LANE MARKINGS)	SAME AS LINE BEING EXTENDED	SKIP-DASH	SAME AS LINE BEING EXTENDED	2' (600) LINE WITH 6' (1.8 m) SPACE
EDGE LINES	4 (100)	SOLID	YELLOW-LEFT WHITE-RIGHT	OUTLINE MEDIANS IN YELLOW
TURN LANE MARKINGS	6 (150) LINE; FULL SIZE LETTERS & SYMBOLS (8' (2.4m))	SOLID	WHITE	SEE TYPICAL TURN LANE MARKING DETAIL
TWO WAY LEFT TURN MARKING	2 @ 4 (100) EACH DIRECTION 8' (2.4m) LEFT ARROW	SKIP-DASH AND SOLID IN PAIRS	YELLOW	10' (3 m) LINE WITH 30' (9 m) SPACE FOR SKIP-DASH; 5½; (140) C-C BETWEEN SOLID LINE AND SKIP-DASH LINE SEE TYPICAL TWO-WAY LEFT TURN MARKING DETAIL
CROSSWALK LINES (PEDESTRIAN) A. DIAGONALS (BIKE & EOUESTRIAN) B. LONGITUDINAL BARS (SCHOOL)	2 e 6 (150) 12 (300) e 45° 12 (300) e 90°	SOLID SOLID SOLID	WHITE WHITE WHITE	NOT LESS THAN 6' (1.8 m) APART 2' (600) APART 2' (600) APART SEE TYPICAL CROSSWALK MARKING DETAILS.
STOP LINES	24 (600)	SOLID	WHITE	PLACE 4' (1,2 m) IN ADVANCE OF AND PARALLEL TO CROSSWALK, IF PRESENT, OTHERWISE, PLACE AT DESIRED STOPPING POINT. PARALLEL TO CROSSROAD CENTERLINE, WHERE POSSIBLE
PAINTED MEDIANS	2 @ 4 (100) WITH 12 (300) DIAGONALS @ 45° NO DIAGONALS USED FOR 4' (1.2 m) WIDE MEDIANS	SOLID	YELLOW: TWO WAY TRAFFIC WHITE: ONE WAY TRAFFIC	11 (280) C-C FOR THE DOUBLE LINE SEE TYPICAL PAINTED MEDIAN MARKING.
GORE MARKING AND CHANNELIZING LINES	8 (200) WITH 12 (300) DIAGONALS @ 45°	SOLID	WHITE	DIACONALS: 15' (4,5 m) C-C (LESS THAN 30MPH (50 km/h)) 20' (6 m) C-C 30MPH (50 km/h) TO 45MPH (70 km/h)) 30' (9 m) C-C (OVER 45MPH (70 km/h))
RAILROAD CROSSING	24 (600) TRANSVERSE LINES; "RR" IS 6' (1.8 m) LETTERS; 16 (400) LINE FOR "X"	SOLID	WHITE	SEE STATE STANDARD 780001 AREA OF: "%"3.5 SO. FT. (0.33 m ²) EACH "X""54.0 SO. FT. (5.0 m ²)
SHOULDER DIAGONALS (REQUIRED FOR SHOULDERS > 8')	12 (300) © 45°	SOLID	WHITE - RIGHT YELLOW - LEFT	50' (15 m) C-C (LESS THAN 30MPH (50 km/h)) 75' (25 m) C-C (30 MPH (50 km/h) TO 45MPH (70 km/h)) 150' (45 m) C-C (0VER 45MPH (70 km/h))
U TURN ARROW	SEE DETAIL	SOLID	WHITE	16.3 SF
2 ARROW COMBINATION LEFT AND U TURN	SEE DETAIL	SOLID	WHITE	30.4 SF

FOR FURTHER DETAILS ON PAVEMENT MARKING REFER TO STANDARD SPECIFICATIONS FOR ROAD AND BRIDGE CONSTRUCTION AND STATE STANDARD 780001.

FILE NAME =	USER NAME = leysa	DESIGNED - EVERS	REVISED -	C. JUCIUS 09-09-09
W:\diststd\22x34\tcl3.dgn		DRAWN -	REVISED -	C. JUCIUS 07-01-13
	PLOT SCALE = 50.000 '/ in.	CHECKED -	REVISED -	C. JUCIUS 12-21-15
Default	PLOT DATE = 6/23/2017	DATE - 03-19-90	REVISED -	C. JUCIUS 04-12-16

TYPICAL CROSSWALK MARKING

 \divideontimes MARKINGS SHALL BE INSTALLED PARALLEL TO THE CENTERLINE OF

12 (300) WHITE


DETAIL "B"

6 (150) WHITE


DETAIL "A"

STATE OF ILLINOIS **DEPARTMENT OF TRANSPORTATION**


		[DIST	RICT OF	NE		F.A.U. RTE.	SECTION	COUNTY	TOTAL SHEETS	SHEET NO.	
	TYPI	CVI I	DΛV	EMENT	MARKING	c	1693 3569	17-00084-00-MS	соок	29	27	
		UAL I	~	LIVILIVI	IVIAIIKIIVU	<u> </u>		TC-13	CONTRACT	NO.	61E89	
: NONE	SHEET 1	OF	1	SHEETS	STA.	TO STA.		TILLINOIS FED. AT	D PROJECT			

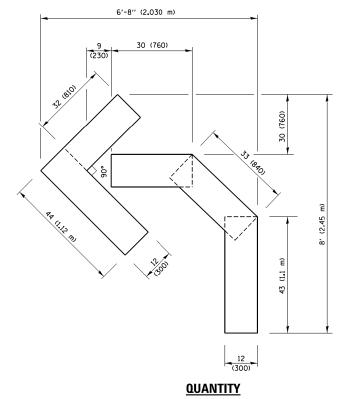

4 (100) LINE = 45.5 ft. (13.9 m) 15.2 sq. ft. (1.41 sq. m)

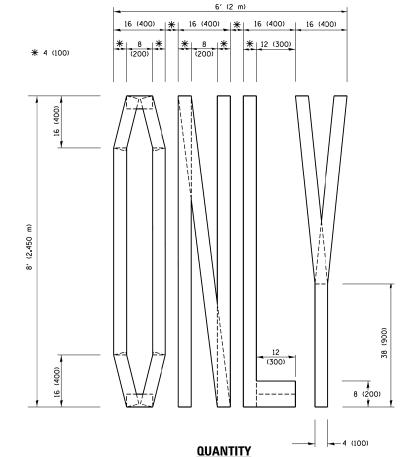

4 (100) LINE = 64.1 ft. (19.5 m) 21.4 sq. ft. (1.99 sq. m)

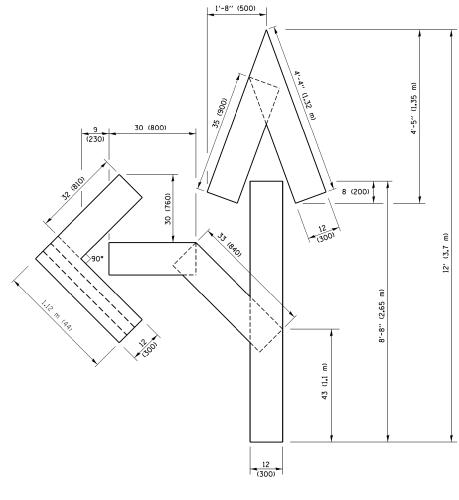


QUANTITY

4 (100) LINE = 82.5 ft. (25.1 m) 27.5 sq. ft. (2.53 sq. m)

NOTE:


ALL QUANTITIES OF PLACEMENT ARE REPRESENTED IN LINEAR FEET OF 4" LINES TO MATCH THE 4" TEMPORARY TAPE PAY ITEM AND REPRESENTS THE TOTAL QUANTITY OF 4" TAPE REQUIRED.

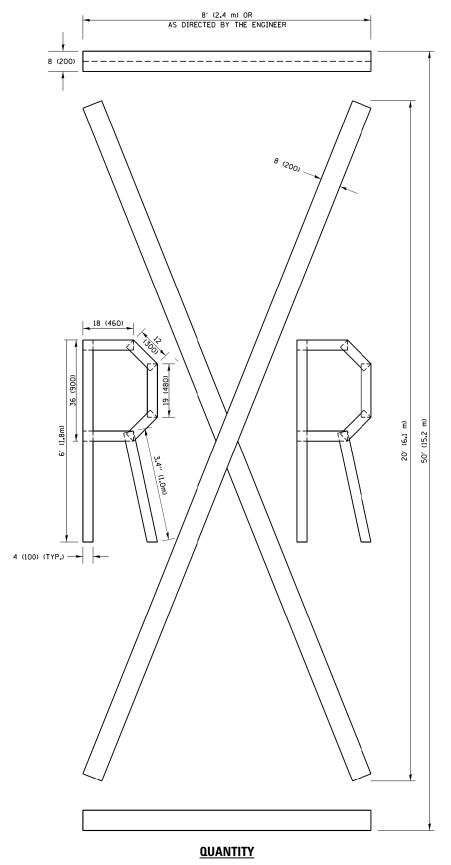

4 (100) LINE = 225.9 ft. (68.9 m) 75.3 sq. ft. (6.99 sq. m)

All dimensions are in inches (millimeters) unless otherwise shown.

FILE NAME =	USER NAME = footemj	DESIGNED -	REVISED -T. RAMMACHER 03-02-98			F.A.U. SECTION	COUNTY TOTAL SHEET
pw:\\ILØ84EBIDINTEG.illinois.gov:PWIDOT\Da	cuments\IDOT Offices\District 1\Projects\Dis	sta DRAWM \CADData\CADsheets\tc16.dgn	REVISED -E. GOMEZ 08-28-00	STATE OF ILLINOIS	SHORT TERM PAVEMENT MARKING LETTERS AND SYMBOLS	1693 17-00084-00-MS	COOK 29 28
	PLOT SCALE = 50.0000 '/ in.	CHECKED -	REVISED -E. GOMEZ 08-28-00	DEPARTMENT OF TRANSPORTATION		TC-16	CONTRACT NO. 61E89
	PLOT DATE = 9/15/2016	DATE - 09-18-94	REVISED - A. SCHUETZE 09-15-16		SCALE: NONE SHEET NO. 1 OF 1 SHEETS STA. TO STA.		AID PROJECT

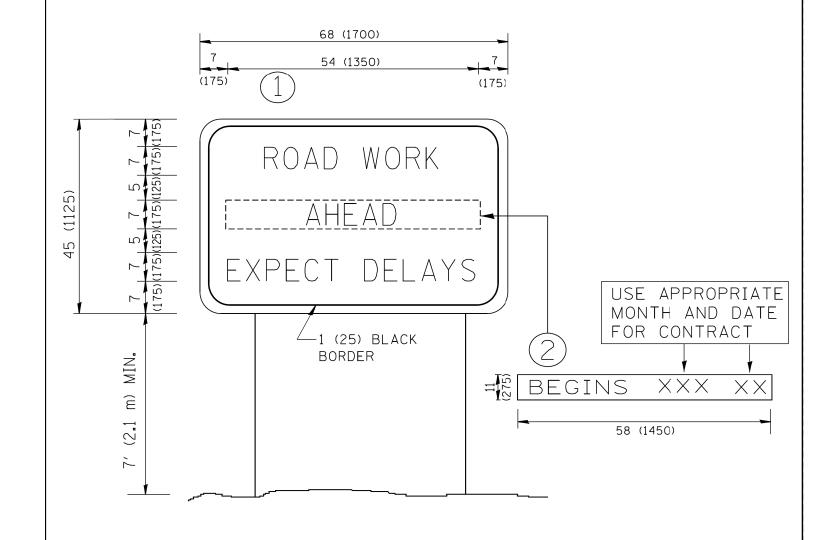

- 1. USE BLACK LETTERING ON ORANGE BACKGROUND.
- 2. ERECT SIGNS IN ADVANCE OF THE LOCATION FOR THE "ROAD CONSTRUCTION AHEAD" SIGN AT LOCATIONS AS DIRECTED BY THE ENGINEER.
- 3. ERECT SIGN (1) WITH INSTALLED PANEL (2) ONE WEEK PRIOR TO THE START OF CONSTRUCTION.
- 4. REMOVE PANEL (2) SOON AFTER THE START OF CONSTRUCTION.
- 5. SEE SPECIAL PROVISION FOR "TEMPORARY INFORMATION SIGNING" FOR ADDITIONAL INFORMATION.
- 6. ONE SIGN ASSEMBLY EQUALS 25.70 SQ. FT. (2.3 SQ. M.)
- 7. SHALL BE PAID FOR AS TEMPORARY INFORMATION SIGNING.

ALL DIMENSIONS ARE IN INCHES (MILLIMETERS) UNLESS OTHERWISE SHOWN.

FILE NAME =		USER NAME = gaglianobt	DESIGNED -	REVISED - R. MIRS 09-15-97		ARTERIAL ROAD	F.A.U.	SECTION	COUNTY	TOTAL SHEET
W:\diststd\22x34\	\tc22.dgn		DRAWN -	REVISED - R. MIRS 12-11-97	STATE OF ILLINOIS		1693	17-00084-00-MS	соок	29 29
		PLOT SCALE = 50.000 '/ IN.	CHECKED -	REVISED -T. RAMMACHER 02-02-99	DEPARTMENT OF TRANSPORTATION	INFORMATION SIGN	3569	TC-22	CONTRACT	NO. 61E89
		PLOT DATE = 1/4/2008	DATE -	REVISED - C. JUCIUS 01-31-07		SCALE: NONE SHEET NO. 1 OF 1 SHEETS STA. TO STA.	FED. ROAD	DIST. NO. 1 ILLINOIS FED.	DIS FED. AID PROJECT	