


- LEGEND**
- SAN SANITARY MANHOLE TO BE ADJUSTED
 - ADJ INLET TO BE ADJUSTED
 - SP FRAME AND LID TO BE ADJUSTED (SPECIAL)

- STORM STRUCTURES**
- ST MH-3
STA 92+65, 21' RT
MANHOLE, TY A, TY 1 FR, CL 4' DIA
RIM = 596.73
INV 593.63 SW & NE 15"
INV 593.69 S 12"
 - CB-2
STA 92+60, 26' RT
CATCH BASIN, TY C, TY 1 FR, OL
RIM = 596.73
INV 595.24 N 12"
 - CB-5
STA 93+55, 25' RT
CATCH BASIN, TY C, TY 1 FR, OL
RIM = 597.53
INV 594.49 SW 15"
INV 594.49 NE 12"
 - FES-1
STA 94+45, 32' RT
PRECAST REINFORCED CONCRETE FLARED END
SECTIONS 12"
INV 596.27 NE

- STORM SEWER PIPES**
- P-4
7 LF OF 12" STRG, TY 1 @ 2.21%
TBF = 1.7 CY
 - P-5
90 LF OF 15" STRG, TY 1 @ 0.96%
TBF = 26.4 CY
 - P-6
90 LF OF 12" STRG, TY 1 @ 1.98%
TBF = 15.6 CY

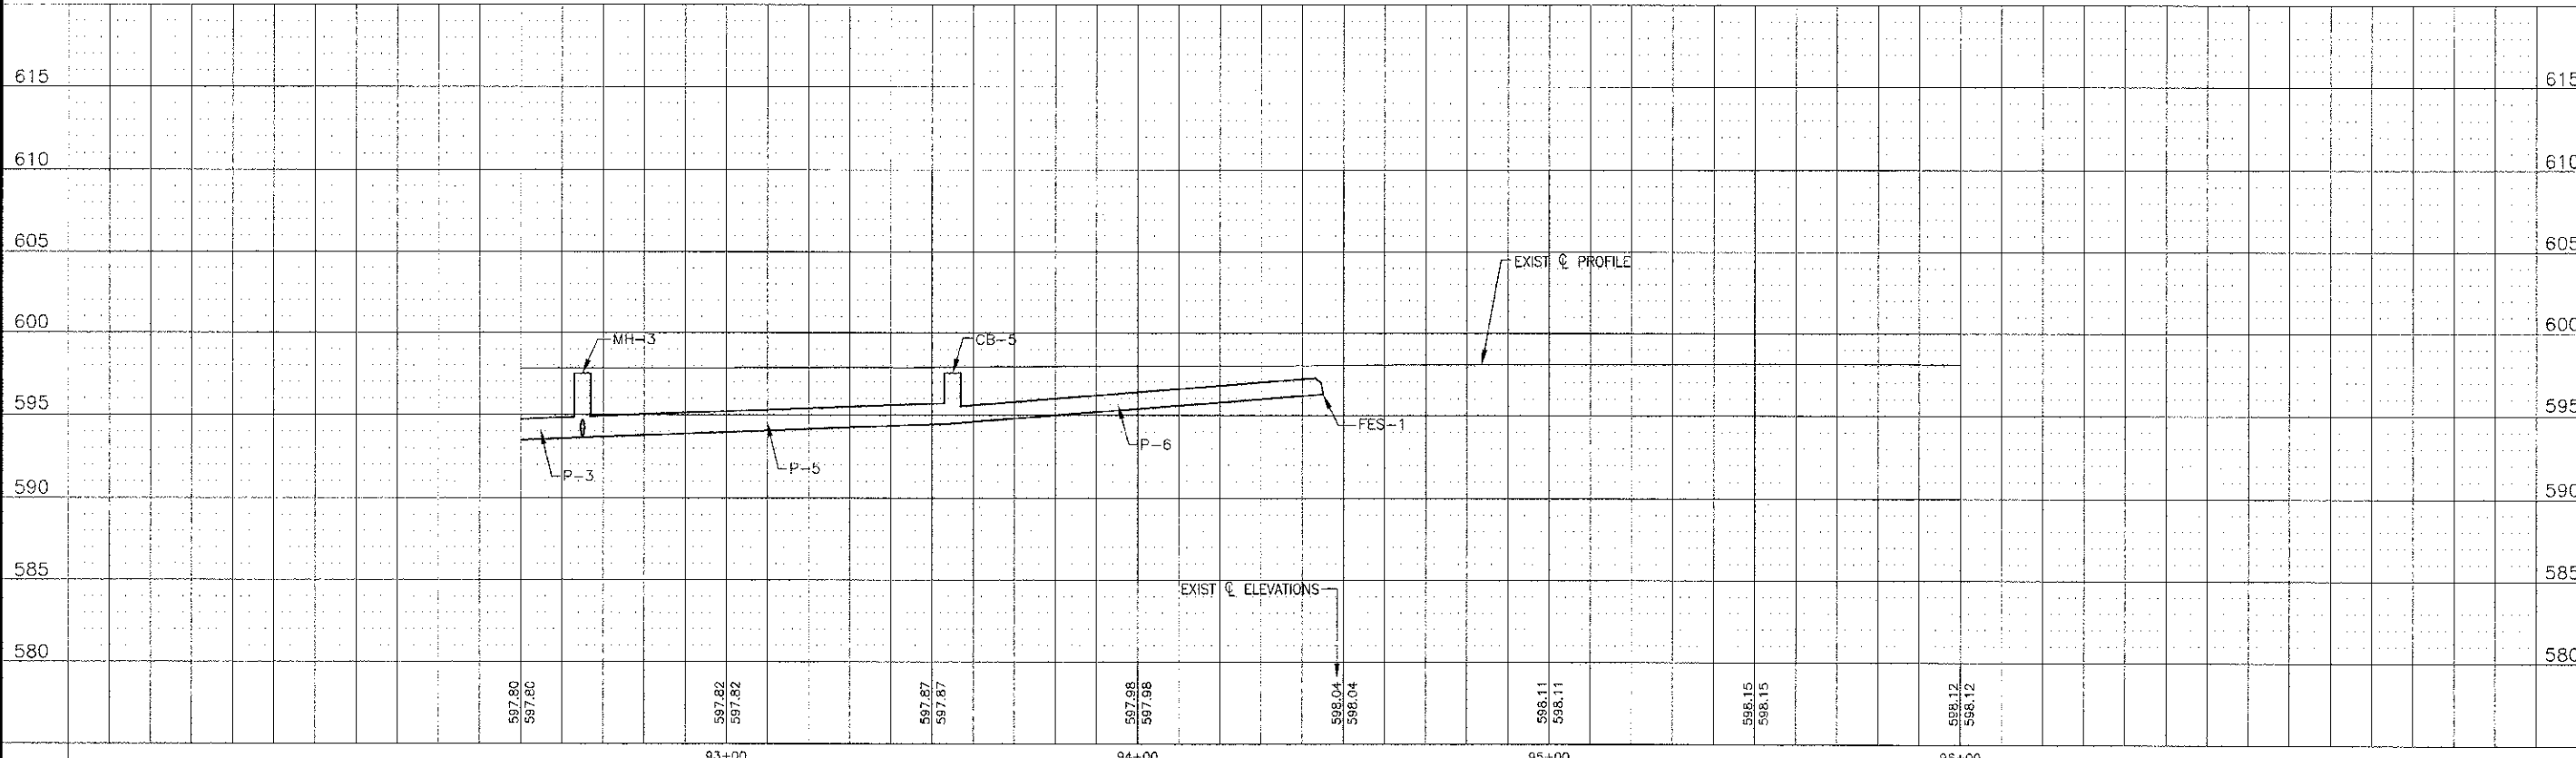

	DESIGNED - REW	REVISED -	STATE OF ILLINOIS DEPARTMENT OF TRANSPORTATION	PLAN AND PROFILE CLAIRE BOULEVARD	F.A.U. RITE	SECTION	COUNTY	TOTAL SHEETS	SHEET NO.
	DRAWN - UKB	REVISED -			1596	10 00028-CO-RS	COOK	21	10
	CHECKED - EDH	REVISED -			CONTRACT NO.: 63692				
	DATE - 04-20-12	REVISED -			SCALE: HORIZ. 1"=20' / VERT. 1"=5' PROJECT NO: 100493 STA 96+00 TO STA 92+50				

I:\PROJECTS\100493\100493-CLARETT\DWG\100493-PLAN\DWG-P111
 Date: 04/20/12, By: Baxter Woodman, Inc.
 State of Illinois - Professional Engineer
 License No. - 187-00112 - Exp. 04-30-13