INDEX OF SHEETS

SHEET NO.

TITLE SEE SHT. NO. 2 FOR INDEX TO SHEETS STATE OF ILLINOIS

DEPARTMENT OF TRANSPORTATION

DIVISION OF HIGHWAYS

PLANS FOR PROPOSED FEDERAL AID PROJECT


METROPOLITAN CORRIDOR BEAUTIFICATION AND PEDESTRIAN ACCESS ACCOMODATION PROJECT

NORTHWEST SIDE OF ROUND LAKE METROPOLITAN RAIL RAILROAD STATION LANDSCAPING AND BEAUTIFICATION

> PROJECT NO.: TE-00D1 (757) **SECTION: 06-00028-00-LS**

> > **LAKE COUNTY**

JOB NO.: C-91-150-07 **LOCATION MAP**

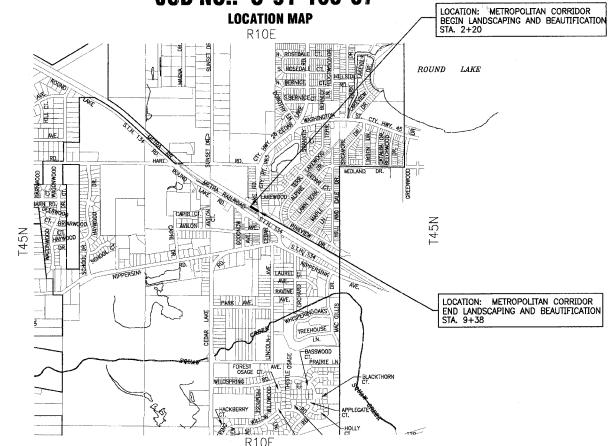

815.609.7425

Itasca, Illinois 630.773.1870

SECTION 06-00028-00-LS FED AID PROJECT


CONTRACT NO.: 83930



PROJECT MANAGER

ELECTRICAL ENGINEER

DATE: 4-13-07

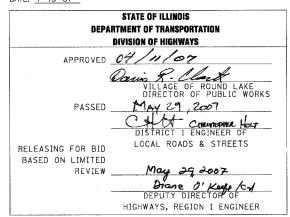

PROJECT LOCATED IN THE VILLAGE OF ROUND LAKE

STANDARD NO.

DESIGN

STANDARD

SEE SHT. NO. 2 FOR STANDARDS

CALL JULIE 1-800-892: 0123 WITH THE FOLLOWING. COUNTY = CITY-TWINSHP=

FOLL SIZE PLANS HAVE BEEN PREPARED USING STANDARD ENGINEERING SCALES. REDUCED SIZED PLANS WILL NOT CONFORM TO STANDARD SCALES. IN MAKING MEASUREMENTS ON REDUCED SIZE PLANS, THE ABOVE SCALES SHALL BE USED.

Crystal Lake, Illinois 815.459.1260 (OFFICE WHICH PREPARED PLANS)

> Mokena, Illinois 708.478.2090

Burlington, Wisconsin 262.763.7834

DeKalb, Illinois 815.787.3111



GROSS LENGTH OF IMPROVEMENT = 718 LIN. FT. OR 0.136 MILES

NET LENGTH OF IMPROVEMENT = 718 LIN. FT. OR 0.136 MILES

Rockford, Illinois

Grayslake, Illinois

847.223.5088

815.489.1551

CONTRACT NO. 83930

PRINTED BY THE AUTHORITY OF THE STATE OF ILLINOIS PROJECT NO.: 060749.40

COUNTY LAKE SECTION: 06-00028-00-LS

AVON TOWNSHIP

BAXTER & WOODMAN, INC. STATE OF ILLINOIS — PROFESSIONAL DESIGN FIRM LICENSE NO. - 184-001121 - EXPIRES 4/30/2007

Plainfield, Illinois

GENERAL NOTES

- 1. ALL CONSTRUCTION SHALL BE DONE IN ACCORDANCE WITH THE DETAILS IN THE PLANS. THE SPECIAL PROVISIONS INCLUDED IN THE CONTRACT DOCUMENTS, AND THE LATEST EDITION OF THE FOLLOWING STATE OF ILLINOIS SPECIFICATIONS: "THE STANDARD SPECIFICATIONS FOR ROAD AND BRIDGE CONSTRUCTION" (REFERED TO AS THE "STANDARD SPECIFICATIONS"), THE "SUPPLEMENTAL SPECIFICATIONS AND RECURRING SPECIAL PROVISIONS", THE "STANDARD SPECIFICATIONS FOR TRAFFIC CONTROL ITEMS", THE "MANUAL ON UNIFORM TRAFFIC CONTROL DEVICES FOR STREETS AND HIGHWAYS", THE "MANUAL OF TEST PROCEDURES FOR MATERIALS" AND THE "STANDARD SPECIFICATIONS FOR WATER AND SEWER MAIN CONSTRUCTION IN ILLINOIS".
- 2. THE LOCATIONS OF PUBLIC OR PRIVATE UTILITIES SHOWN ON THE PLANS ARE APPROXIMATE AND THE VILLAGE DOES NOT GUARANTEE THEIR ACCURACY. THE CONTRACTOR SHALL HAVE THE RESPECTIVE UTILITY COMPANIES FIELD LOCATE ALL THEIR FACILITIES PRIOR TO BEGINNING CONSTRUCTION. THE CONTRACTOR SHALL ALSO VERIFY THE DEPTHS OF THE EXISTING UTILITIES IF NECESSARY. ANY RELOCATION OR LOWERING OF UTILITIES SHALL BE COORDINATED BY THE CONTRACTOR.
- THE CONTRACTOR SHALL BE RESPONSIBLE FOR THE PROTECTION OF ALL UNDERGROUND OR SURFACE UTILITIES EVEN THOUGH THEY MAY NOT BE SHOWN ON THE PLANS. ANY UTILITY THAT IS DAMAGED DURING CONSTRUCTION SHALL BE REPAIRED OR REPLACED AT THE CONTRACTOR'S EXPENSE TO THE SATISFACTION OF THE ENGINEER OR VILLAGE.
- THE CONTRACTOR SHALL NOTIFY THE VILLAGE DIRECTOR OF PUBLIC WORKS AT LEAST 48 HOURS IN ADVANCE OF BEGINNING WORK TO OBTAIN VILLAGE UTILITY LOCATIONS AND SHALL COORDINATE ALL CONSTRUCTION OPERATIONS WITH THE ENGINEER.
- 5. MATERIALS RESULTING FROM THE REMOVAL OF PAVEMENT, DRIVEWAYS, CURB AND GUTTER, HOT-MIX ASPHALT SURFACES, ETC. SHALL BE REMOVED AT THE END OF EACH DAY TO AN APPROVED SITE. IN THE JUDGMENT OF THE VILLAGE, SHOULD IT BE NECESSARY TO REMOVE SUCH MATERIALS, THE VILLAGE WILL HAVE THE MATERIAL REMOVED AND THE CONTRACTOR WILL BE BILLED (CHARGED)
- 6. THE CONTRACTOR MAY OBTAIN MUNICIPAL WATER IN BULK, AT NO CHARGE, AS LONG AS THERE IS NOT A "WATERING BAN IN EFFECT.
 THE INDISCRIMINATE USE OF FIRE HYDRANTS IS STRICTLY PROHIBITED. WATER FOR CONSTRUCTION SHALL BE METERED OR
 OTHERWISE ACCOUNTED FOR AND A DAILY LOG MAINTAINED. THE CONTRACTOR SHALL PROVIDE THE WATER TRUCK AND DRIVER REQUIRED TO OBTAIN AND TRANSPORT THIS WATER. THE VILLAGE RESERVES THE RIGHT TO RESTRICT OR REFUSE THE USE OF VILLAGE WATER IF DEEMED NECESSARY.
- 7. THE CONTRACTOR SHALL PROTECT AND CAREFULLY PRESERVE ALL SECTION OR SUBSECTION MONUMENTS OR PROPERTY OR
 REFERENCE MARKERS UNTIL THE OWNERS, HIS AGENT OR AN AUTHORIZED SURVEYOR HAS WITNESSED OR OTHERWISE REFERENCED
- EXISTING BUILDING FOUNDATION AND CONCRETE WALL DIMENSIONS AND ELEVATIONS ARE SHOWN FOR REFERENCE ONLY. FIELD VERIFY CONDITIONS PRIOR TO CONSTRUCTION, ALL VERIFICATION SHALL BE INCLUDED IN THE APPLICABLE REMOVAL PAY ITEM.
- PROVIDE TEMPORARY SHORING OF EXISTING STRUCTURES AS REQUIRED DURING CONSTRUCTION. ALL SHORING SHALL BE INCLUDED
- 10. ANY SIGNS OR MAILBOXES THAT ARE IN CONFLICT WITH THE PROPOSED CONSTRUCTION SHALL BE REMOVED AND REPLACED IN ACCORDANCE WITH VILLAGE STANDARDS AND INCLUDED IN THE PAY ITEM FOR SIDEWALK REMOVAL. MAIL SERVICE SHALL BE
- 11. EXISTING PAVEMENT, DRIVEWAY PAVEMENT, CURB AND GUTTER AND SIDEWALK TO REMAIN IN PLACE SHALL BE SAW CUT FULL DEPTH
 TO PROVIDE A NEAT VERTICAL FACE BETWEEN THE PROPOSED AND EXISTING AND SHALL BE INCLUDED IN THE PRICE OF THE
- 12. IN AREAS WHERE THE EXISTING DRIVEWAY, OR SIDEWALK IS TO BE REMOVED AND REPLACED, THE REMOVAL AND DISPOSAL OF ANY ADDITIONAL MATERIAL REQUIRED TO ESTABLISH THE PROPOSED DRIVEWAY OR SIDEWALK SUBGRADE ELEVATION SHALL BE INCLUDED IN THE PAY ITEMS, DRIVEWAY PAVEMENT REMOVAL OR SIDEWALK REMOVAL.
- 13. EXISTING CURB AND GUTTER, ROADWAY PAVEMENT AND CONCRETE RETAINING WALL INFRASTRUCTURE WITHIN THE CEDAR LAKE ROAD RIGHT-OF-WAY ARE TO REMAIN. THE CONTRACTOR SHALL TAKE EXTREME CAUTION WHEN ACCESSING THE SITE TO PRESERVE THIS EXISTING INFRASTRUCTURE. IF THE EXISTING INFRASTRUCTURE IS DAMAGED, THE INFRASTRUCTURE SHALL BE REPLACED IN KIND TO THE SATISFACTION OF LAKE COUNTY DIVISION OF TRANSPORTATION, THE VILLAGE AND THE ENGINEER. REPLACEMENT SHALL BE
- 14. THE CONTRACTOR SHALL PROVIDE AND INSTALL TWO (2) WEIGHTED SANDBAGS ON EACH TYPE I OR TYPE II BARRICADE USED. ONE (1) WEIGHTED SANDBAG SHALL BE PLACED ACROSS EACH BOTTOM RAIL.
- 15. PORTLAND CEMENT CONCRETE SIDEWALK SHALL BE THICKENED AT LOCATIONS WHERE THE SIDEWALK CROSSES DRIVEWAYS. TRANSVERSE EXPANSION JOINTS 3/4" SHALL BE PLACED EVERY 50 FEET OR AS DIRECTED BY THE ENGINEER. TRANSVERSE CONTRACTION JOINTS SHALL BE PLACED EVERY 5-FEET.
- 16. ALL POSTS, RAILROAD TIES, AND DECORATIVE TIMBER IN CONFLICT WITH THE PROPOSED IMPROVEMENTS SHALL BE REMOVED AND RELOCATED OR PROPERLY DISPOSED OF AS DETERMINED BY THE ENGINEER AT THE TIME OF CONSTRUCTION AND SHALL BE INCLUDED IN THE COST OF DEBRIS REMOVAL. EVERY EFFORT SHALL BE MADE BY THE CONTRACTOR WHEN REMOVING THESE ITEMS TO PRESERVE THEM FROM HARM. ITEMS NOT RELOCATED SHALL BE PROPERLY DISPOSED OF BY THE CONTRACTOR.
- 17. FURNISHED EXCAVATION FROM AN OFF-SITE LOCATION, IF NECESSARY, SHALL BE INCLUDED IN THE ITEM EARTH EXCAVATION
- 18. A PORTABLE BATHROOM(S) SHALL BE PLACED ON THE JOB SITE(S) AND RELOCATED WHEN NECESSARY SO IT IS ACCESSIBLE TO WORKERS. IF WORK IS OCCURRING AT SEVERAL LOCATIONS, ONE PORTABLE BATHROOM SHALL BE PLACED AT EACH LOCATION WITHIN A REASONABLE DISTANCE FROM THE WORK AS DETERMINED BY THE ENGINEER. THIS SHALL BE INCLUDED IN THE COST OF THE
- 19. THE MC-30 PRIME COAT APPLICATION RATE SHALL BE 0.3 GAL/SY.
- 20. FOR STEEL BARS CERTIFICATION, PLEASE CONTACT IDOT BUREAU OF MATERIALS AT (847) 705-4361.

LAKE COUNTY DIVISION OF TRANSPORTATION GENERAL NOTES

- 21. THE REVIEW AND APPROVAL OF THESE FINAL ENGINEERING PLANS AND SPECIFICATIONS BY THE LAKE COUNTY DIVISION OF TRANSPORTATION
 DOES NOT CONSTITUTE A RELEASE FROM OR GRANT OF VARIATION FROM THE RULES, REGULATIONS, AND SPECIFICATIONS REQUIRED IN THE
 LAKE COUNTY HIGHWAY UTILITY AND FACILITY PLACEMENT ORDINANCE, LATEST EDITION, AS AMENDED, OR ANY SUCCESSOR DOCUMENT OR DOCUMENTS THERETO. THE PERMITTEE, THE PERMITTEE'S DESIGNATED REPRESENTATIVES, AND/OR ALL SUCCESSORS AND ASSIGNS SHALL BE SOLELY RESPONSIBLE FOR ALL WORK AND IMPROVEMENTS WITHIN THE LIMITS OF THE COUNTY HIGHWAY RIGHT-OF-WAY. UNLESS OTHERWIS SPECIFIED, APPROVED IN WRITING BY THE LAKE COUNTY COUNTY ENGINEER, AND ON FILE WITH THE LAKE COUNTY DIVISION OF TRANSPORTATION, ALL WORK AND MATERIALS NECESSARY TO CONSTRUCT UTILITIES AND FACILITIES AND RESTORE THE RIGHT-OF-WAY WITHIN THE LIMITS OF THE COUNTY HIGHWAY SHALL BE IN CONFORMANCE WITH THE RULES, REGULATIONS, AND SPECIFICATIONS OF THE LAKE COUNTY UTILITY AND FACILITY PLACEMENT ORDINANCE, LATEST EDITION, AS AMENDED, OR ANY SUCCESSOR DOCUMENT OR DOCUMENTS THERETO.
- 22. THE CONSTRUCTION, INCLUDING MATERIALS USED, OF THIS UTILITY AND FACILITY SHALL BE IN ACCORDANCE WITH APPLICABLE PORTIONS OF THE MOST RECENT EDITIONS OF "THE STANDARD SPECIFICATIONS FOR ROAD AND BRIDGE CONSTRUCTION", THE "SUPPLEMENTAL SPECIFICATIONS AND RECURRING SPECIAL PROVISIONS", "ILLINOIS MANUAL ON UNIFORM TRAFFIC CONTROL DEVICES FOR STREETS AND HIGHWAYS" AND "STANDARD SPECIFICATIONS FOR TRAFFIC CONTROL ITEMS": INCLUDING ALL AMENDMENTS AND SUCCESSOR DOCUMENTS TO THE AFOREMENTIONED DOCUMENTS AS PUBLISHED OR ADOPTED BY THE ILLINOIS DEPARTMENT OF TRANSPORTATION UNLESS OTHERWISE STATED IN THESE ENGINEERING PLANS.
- 23. THE CONSTRUCTION OF THIS UTILITY OR FACILITY SHALL ALSO BE IN ACCORDANCE WITH THE "LAKE COUNTY HIGHWAY UTILITY AND FACILITY PLACEMENT ORDINANCE," LATEST EDITION, AS AMENDED, OR ANY SUCCESSOR DOCUMENT OR DOCUMENTS THERETO.
- 24. THE LAKE COUNTY DIVISION OF TRANSPORTATION SHALL NOT BE HELD LIABLE FOR ANY ERRORS OR OMISSIONS IN THESE ENGINEERING PLANS OR FOR ANY ADDITIONAL WORK, WHICH MAY BE NEEDED DUE TO ERRORS OR OMISSIONS IN THESE ENGINEERING PLANS.
- 25. THE PERMITTEE SHALL BE RESPONSIBLE FOR ANY ADDITIONAL WORK, AND ALL COSTS THEREOF, REQUIRED BECAUSE OF ERRORS OR OMISSIONS IN THESE ENGINEERING PLANS AND FOR THE CORRECTION OF ANY CONSTRUCTION, MAINTENANCE, OR SAFETY PROBLEMS, WHICH BECOME APPARENT DURING CONSTRUCTION OR BY INSPECTIONS MADE BY THE PERSON IN CHARGE OR THE LAKE COUNTY DIVISION OF
- 26. THE PERSON IN CHARGE SHALL NOTE ANY CHANGES FROM THESE ENGINEERING PLANS AND SHALL NOTIFY THE PERMIT DEPARTMENT OF THE LAKE COUNTY DIVISION OF TRANSPORTATION ABOUT ANY CHANGES THAT DEVIATE FROM THE INTENT OF THE ENGINEERING PLANS.

SUGGESTED STAGES OF CONSTRUCTION

PEDESTRIAN ACCESS.

PEDESTRIAN ACCESS SHALL BE MAINTAINED AT ALL TIMES.

CONSTRUCTION HOURS.
CONSTRUCTION ACTIVITY WITHIN THE PROJECT LIMITS SHALL OCCUR BETWEEN 7:00 AM AND 7:00 PM IN ACCORDANCE WITH

EMERGENCY ACCESS SHALL BE MAINTAINED AT ALL TIMES.

CONSTRUCTION OPERATIONS INVOLVING THE TEMPORARY CLOSING OF DRIVES OR THE ROAD SHALL NOT BE COMMENCED WITHOUT AT LEAST THREE (3) DAYS PRIOR NOTICE TO THE VILLAGE AND COUNTY BY THE CONTRACTOR. THE CONTRACTOR WILL ALSO BE REQUIRED TO PROVIDE A 48-HOUR NOTICE TO AFFECTED PARTIES BY DISTRIBUTING WRITTEN NOTICES

STORAGE OF CONSTRUCTION MATERIALS AND EQUIPMENT IS PERMITTED ON THE EXISTING PARKING LOT LOCATED IMMEDIATELY WEST OF CEDAR LAKE ROAD. NO CONSTRUCTION MATERIALS SHALL BE STORED AT ANY OTHER LOCATION.

THE CONTRACTOR SHALL UTILIZE A MECHANICAL SWEEPER TO CLEAN STREETS AFFECTED BY CONTRACTORS OPERATIONS, INCLUDING HAUL ROUTES, AT LEAST TWICE PER WEEK AND ADDITIONALLY AS DIRECTED BY THE ENGINEER. THIS WORK SHALL BE INCLUDED IN THE COST OF CONSTRUCTION

CONSTRUCTION STAGING SEQUENCE:

- STAGE I: CONCRETE DEMOLITION AND REMOVAL.
- STAGE II: SITE RESTORATION.

TEMPORARY EROSION CONTROL MEASURES SHALL BE INSTALLED PRIOR TO THE COMMENCEMENT OF CONSTRUCTION. WHERE PARKWAYS ARE DISTURBED, TEMPORARY EROSION CONTROL MEASURES SHALL BE ESTABLISHED WITHIN 21 DAYS OF THE COMPLETION OF DISTURBANCE AND MAINTAINED TO THE SATISFACTION OF THE VILLAGE AND COUNTY.

STAGE I: CONCRETE DEMOLITION AND REMOVAL

- PHASE 1: SUBMIT FENCE SHOP DRAWINGS FOR REVIEW.
- SAWCUT CONCRETE. PHASE 2: REMOVE SITE DEBRIS
- PHASE 3: REMOVE CONCRETE FROM BUILDING SLABS, FOUNDATION WALLS AND BINS.
- PHASE 4: REMOVE EXISTING GRAVEL, HOT-MIX ASPHALT (MAINTAINING PORTIONS FOR SITE ACCESS), UNSUITABLE MATERAILS AND FARTH EXCAVATION
- PHASE 5: COMMENCE REMOVAL WORK FOR NEW DRIVEWAY TO ACCESS METRA SITE.
- INSTALL STREET LIGHT FOUNDATION.
 PHASE 6: STABILIZE ALL DAMAGED PARKWAYS WITH TEMPORARY EROSION CONTROL SEEDING

STAGE II: SITE RESTORATION.

- COMMENCE INSTALLING TOPSOIL, EXCELSIOR BLANKET AND SEEDING ON DISTURBED AREAS. INSTALL GRANULAR STRUCTURAL FILL IN CONCRETE BIN VOID.
 INSTALL CONCRETE PAD AT LANDSCAPE BED.
- PHASE 2: COMMENCE INSTALLING FENCE INSTALL STREET LIGHT AND HANDHOLE.
 COMPLETE INSTALLATION OF NEW DRIVEWAY TO METRA SITE.
- PHASE 3: REMOVE REMAINING HOT-MIX ASPHALT (PREVIOUSLY RETAINED FOR SITE ACCESS) AND UNSUITABLE MATERAILS. ENSURE REMOVAL IS STAGED TO PREVENT DAMAGE TO FINAL GRADED AREAS.

COMPLETE INSTALLING TOPSOIL, EXCELSIOR BLANKET AND SEEDING ON DISTURBED AREAS.

- PHASE 4: REMOVE EXISTING SIDEWALK, DRIVEWAY APRON AND CURB AND GUTTER AT SITE ACCESS TO CEDAR LAKE ROAD.
- PHASE 5: INSTALL REPLACEMENT SIDEWALK, RESTORE DRIVEWAY APRON AREA AND INSTALL CURB AND GUTTER AT SITE ACCESS TO CEDAR LAKE ROAD.

SECTION COUNTY 06-00028-00-LS LAKE 18 TO ST ILLINOIS FED AID PROJEC C-91-150-07 TE-00D1(757)

CONTRACT NO.: 83930

COMMITMENTS

- 1. JULIE MEMBER COMPANIES HAVE ADVISED OF A POSSIBLE UTILITY SERVICE(S) LATERALLY CROSSING THE PROJECT SITE IN THE VICINITY OF STA. 5+75. THE POSSIBLE UTILITY SERVICE(S), MAY SERVE THE ROUND LAKE METRA STATION. PRIOR TO CONSTRUCTION, THE CONTRACTOR IS RESPONSIBLE TO VERIFY THE PRESENCE OF SAID UTILITY SERVICE(S) AND NOTIFY THE VILLAGE, ENGINEER AND JULIE MEMBER COMPANY(S) OF THE IMPACT, IMPACT MAY RESULT IN MODIFICATIONS TO THE PROPOSED GRADING PLAN AS WELL AS ADJUSTMENT IN QUANTITIES, TO ENSURE ADEQUATE VERTICAL SEPARATION OF THE POSSIBLE UTILITY SERVICE(S) IS PROVIDED. ALL ACTIVITIES ASSOCIATED WITH THIS INVESTIGATION AND SUBSEQUENT ACTION ARE INCLUDED IN THE COST OF THE CONTRACT.
- 2. IN ADDITION TO THE PROCUREMENT OF RAILROAD PROTECTIVE LIABILITY INSURANCE, ANY CONTRACTOR(S), SUB-CONTRACTOR(S) ETC. REQUIRING ACCESS TO THE METRA PROPERTY FOR THIS WORK SHALL BE REQUIRED TO OBTAIN METRA'S RIGHT OF ENTRY AGREEMENT, PRIOR TO THE COMMENCEMENT OF ANY WORK ON

BENCHMARKS

SOUTH FLANGE BOLT ON FIRE HYDRANT AT SOUTH SIDE ROUTE 134 BETWEEN "ACE HARDWARE" AND "LAKES BOWL"

FLEVATION = 777.58

CHISLED "X' ON TOP OF CURB AT ENTRANCE TO ATM NEAR THE ENTRANCE OF "ACE HARDWARE"

ELEVATION = 774.03

 CHISELED "X" ON TOP OF CONCRETE RETAINING WALL APPROXIMATELY 51.6 FEET NORTH OF THE CENTERLINE OF THE MAIN TRACK AT METRA GRADE CROSSING AT CEDAR LAKE ROAD. "X" IS ON WEST SIDE OF CEDAR LAKE ROAD BETWEEN SIDEWALK AND BACK OF CURB

FLEVATION = 793.60

HIGHWAY STANDARDS

000001-04 - STANDARD SYMBOLS, ABBREVIATIONS AND PATTERNS

280001-03 - TEMPORARY EROSION CONTROL SYSTEMS

701502-01 URBAN LANE CLOSURE, 2L, 2W, WITH BIDIRECTIONAL LEFT TURN LANE

LANE CLOSURE MULTILANE 1W OR 2W CROSSWALK OR 701801-03 -

702001-06 - TRAFFIC CONTROL DEVICES

INDEX OF SHEETS

COVER SHEET	
INDEX OF SHEETS, GENERAL NOTES, COMMITMENTS, BENCHMARKS,	SUGGESTED
STAGES OF CONSTRUCTION AND HIGHWAY STANDARDS	
SUMMARY OF QUANTITIES	
TYPICAL SECTIONS AND HOT-MIX ASPHALT MIXTURE REQUIREMENTS	TABLE
SCHEDULE OF MATERIALS	
PLAN: METROPOLITAN CORRIDOR - DEMOLITOIN PLAN STA 1+00 To	0 STA 10+0
DI LUI LICTORDALITTILI GARDIDAD CILILI GALDINIA DI LUI	

PLAN: METROPOLITAN CORRIDOR - FINAL GRADING PLAN STA 1+00 TO STA 10+00

PLAN: METROPOLITAN CORRIDOR - EROSION AND SEDIMENT CONTROL PLAN STA 1+00 TO STA. 10+00
PLAN: METROPOLITAN CORRIDOR - LANDSCAPE PLAN STA 8+00 TO STA 9+50
PLAN: METROPOLITAN CORRIDOR - LIGHTING PLAN STA 8+00 TO STA 9+50

MISCELLANEOUS DETAILS

DISTRICT 1 (TC-10) TRAFFIC CONTROL AND PROTECTION FOR SIDE ROADS, INTERSECTIONS AND STREETS

DISTRICT 1 (TC-18) SIGNING FOR FLAGGING OPERATIONS AT WORK ZONE 13.

DISTRICT 1 (TC-22) TEMPORARY INFORMATION SIGNING

DISTRICT 1 (BM-14) METHOD OF FLAGGING CROSS SECTIONS: METROPOLITAN CORRIDOR 15. 16–18.

INDEX TO SHEETS, GEN. NOTES, COMMITMENTS, **BENCHMARKS, SUGGESTED STAGES OF**

CONSTRUCTION AND HIGHWAY STANDARDS

SHEET NO.

12.

SESIGNED 8Y	SCALE
MW₽	NONE
ORAWN BY	PROJECT NO.
UKB	060749
CHECKED BY	SHEET NO.
MWP	
DATE	2 OF 18
2-09-07	Z UF 10

4-4-07 VILLAGE/IDOT/LCDOT/METRA REVIEW 2 5-10-07 VILLAGE/IDOT/LCDOT/METRA REVIEW



Baxter & Woodman
Crystal Lake, Illinois 815.459,1260
Burkington Nisconsin 262.763.7834
Mokena, Illinois 815.787 3111
Crayslako, Illinois 947.223.5088

VILLAGE OF ROUND LAKE, ILLINOIS METROPOLITAN CORRIDOR BEAUTIFICATION AND PEDESTRIAN ACCESS ACCOMMODATION PROJECT

F.A. ROUTE NO.	SECTION	COUNTY	TOTAL SHEETS	SHEET NO.
	06-00028-00-LS	LAKE	18	3
STA.	TO ST	Α.		
FED. ROAD C-91-) pist. no. 150-07	ILLINOIS	FED AID TE-00D1	PROJECT (757)
CONTRA	CT NO.: 83930		·····	

SUMMARY OF QUANTITIES

CODE PAY ITEM DESCRIPTION NUMBER	UNIT	QUANTITY	NSTRUCTION CO Y003	Y030-1
20100110 TREE REMOVAL (6 TO 15 UNITS DIAMETER)	UNIT	82	82	
20100110 TREE REMOVAL (0 TO 13 DINITS DIAMETER)	UNIT	46	46	
20101000 TEMPORARY FENCE	FOOT	775	775	
20200100 EARTH EXCAVATION	CUYD	1,031	1,031	
20201200 REMOVAL AND DISPOSAL OF UNSUITABLE MATERIALS	CU YD	607	607	
21101630 TOPSOIL FURNISH AND PLACE - 8" 21400100 GRADING AND SHAPING OF DITCHES	SQ YD FOOT	5,983 579	5,983 579	
25000100 SEEDING, CLASS 1	ACRE	1.24	1.24	
25000400 NITROGEN FERTLIZER NUTRIENT	POUND	112	112	
25000500 PHOSPHORUS FERTLIZER NUTRIENT	POUND	112	112	
25000600 POTASSIUM FERTLIZER NUTRIENT	POUND	112	112	
25100401 EXCELSIOR BLANKET, SPECIAL 25200200 SUPPLEMENTAL WATERING	SQ YD UNIT	5,983 36	5,983 36	*******************
28000250 TEMPORARY EROSION CONTROL SEEDING	POUND	124	124	
280003300 TEMPORARY DITCH CHECKS	EACH	4	4	
35101600 AGGREGATE BASE COURSE, TYPE B 4"	SQ YD	70	70	***************************************
35101800 AGGREGATE BASE COURSE, TYPE B 6"	SQ YD	322	322	
40600100 BITUMINOUS MATERIALS (PRIME COAT)	GALLON	60	60	TOTAL PROFESSION AND AND AND AND AND AND AND AND AND AN
10600300 AGGREGATE (PRIME COAT) 10603080 HOT-MIX ASPHALT BINDER COURSE, IL-19.0, N50	TON TON	2 101	2 101	
10603080 HOT-MIX ASPHALT SINDER COURSE, IL-19.0, N50 10603310 HOT-MIX ASPHALT SURFACE COURSE, MIX C, N50	TON	34	34	
12300400 PORTLAND CEMENT CONCRETE DRIVEWAY, 8 INCH	SQ YD	8	8	milled and see that the control of t
2400200 PORTLAND CEMENT CONCRETE SIDEWALK 5 INCH	SQ FT	630	630	
2400410 PORTLAND CEMENT CONCRETE SIDEWALK 8 INCH	SQ FT	120	120	***************************************
4000198 HOT-MIX ASPHALT SURFACE REMOVAL, VARIABLE DEPTH	SQ YD	1,840	1,840	
14000200 DRIVEWAY PAVEMENT REMOVAL 14000300 CURB REMOVAL	SQ YD FOOT	20 72	20 72	
HOOOGOO SIDEWALK REMOVAL	SQFT	650	650	
14004700 SIDEWALK REMOVAL (SPECIAL)	SQ FT	11,148	11,148	
14213200 SAW CUTS	FOOT	786	786	
0102400 CONCRETE REMOVAL	CUYD	67	67	
56500600 DOMESTIC WATER SERVICE BOXES TO BE ADJUSTED 50605100 COMBINATION CONCRETE CURB AND GUTTER, TYPE B-6.24 (ABUTTING EXISTING PAVEMENT)	EACH FOOT	72	1 72	
67100100 MOBILIZATION	L SUM	1	1	
70102622 TRAFFIC CONTROL AND PROTECTION, STANDARD 701502	L SUM	1	1	
70102640 TRAFFIC CONTROL AND PROTECTION, STANDARD 701801	L SUM	1	1	
31400735 HANDHOLE, COMPOSITE CONCRETE SPECIAL	EACH	1	<u> </u>	
B1603040 UNIT DUCT, 600V, 2-1C NO. 6, 1/C NO. 8 GROUND (XLP-TYPE USE) 1" DIA. POLYETHYLENE	FOOT FOOT	50 60		
31702120 ELECTRICAL CABLE IN CONDUIT, 600V, (XLP-TYPE USE), 1/C NO. 8 31702130 ELECTRICAL CABLE IN CONDUIT, 600V, (XLP-TYPE USE), 1/C NO. 6	FOOT	120		12
31900200 TRENCH AND BACKFILL FOR ELECTRICAL WORK	FOOT	40		
3600210 LIGHTING POLE FOUNDATION, 24" DIAMETER (SPECIAL)	FOOT	5	TO THE REAL PROPERTY OF STREET, THE PARTY OF	******************
A2000118 TREE, ACER FREEMANII AUTÚMN BLAZE (AUTÚMN BLAŽE FREEMAN MAPLE) 3" CALIPER, BALLED AND BURLAPPED	EACH	2	2	
C2006236 SHRUB, RIBES ALPINUM (ALPINE CURRANT), 3' HEIGHT, BALLED AND BURLAPPED	EACH	10	10	******************
K1003455 LANDSCAPE FILL SOIL K1005481 SHREDDED BARK MULCH 3"	CU YD SQ YD	20 59	20 59	42 - 144 - 148 - 1
(0301115 LANDSCAPE EDGING	FOOT	145	145	
(0301407 PERENNIAL PLANTS, GALLON POT	UNIT	2.14	2.14	
(0320239 CONCRETE WALL REMOVAL	FOOT	446	446	
(0321158 PARK BENCHES	EACH	1	1	
(0322256 TEMPORARY INFORMATION SIGNING (0323360 WOODEN POLE REMOVAL	SQ FT EACH	51.4	51.4 2	
(0323553 ORNAMENTAL FENCE, WROUGHT IRON	FOOT	256	256	
(0323973 SEDIMENT CONTROL, SILT FENCE	FOOT	991	991	•
(0323974 SEDIMENT CONTROL, SILT FENCE MAINTENANCE	FOOT	991	991	
(X001621 BRICK PAVER REMOVAL	SQ FT	15	15	
(X005317 GRANULAR STRUCTURAL FILL	CU YD	460	460	
IZ177600 REMOVE EXISTING BUMPER BLOCKS OU15500 DEBRIS REMOVAL	EACH L SUM	13	13 1	
10019600 DUST CONTROL WATERING	UNIT	12	12	
20022800 FENCE REMOVAL	FOOT	289	289	
0048665 RAILROAD PROTECTIVE LIABILITY INSURANCE	LSUM	1	1	
XCOL95; LUMINAIRE, METAL HALIDE, 100 WATT, TYPE III, SPECIAL	EACH	1		
XXOOLA9U LIGHT POLE, ALUMINIUM, 14', SPECIAL	EACH	1		
COLLARY CONCRETE FOUNDATION WALL REMOVAL	FOOT	743	743	
CX COL 998 GRAVEL REMOVAL	SQ YD	2,100	2,100	
XXXXXXXXXXXXXXXXXXXXXXXXXXXXXXXXXXXXXX	FOOT	84	84	
NDICATES SPECIALITY ITEM			<u> </u>	


CONSULTANTS R	EV. NO.	DATE	DESCRIPTION
	1	4/4/07	VILLAGE/IDOT/LCDOT/METRA REVIEW
****	2	5/10/07	VILLAGE/IDOT/LCDOT/METRA REVIEW
* - REFER TO EQUIPMENT MANUFACTURER'S SHOP DRAWINGS			/
1" .5" 0 1" 2" 3"			



Buxter & Woodmax Crystal Lake. Illinois 015-459-126 Burlington. Wisconstin 262-269-788. Mokema, Hibroris 084-82-80 DeKalb, Illinois 0847-223-506 Crugslake. Illinois 0847-223-506 Bockford, Illinois 1915-489-151 VILLAGE OF ROUND LAKE, ILLINOIS
METROPOLITAN CORRIDOR BEAUTIFICATION
AND PEDESTRIAN ACCESS ACCOMMODATION PROJECT

SUMMARY OF QUANTITIES

	1	
-	DESIGNED BY	. SCALE :
	MWP	NONE
	DRAWN SY	PROJECT NO.
	PMP	060749
	CHECKED BY	SHEET NO.
	MWP	
	DATE	3 OF 18
	2-09-07	OUT IO

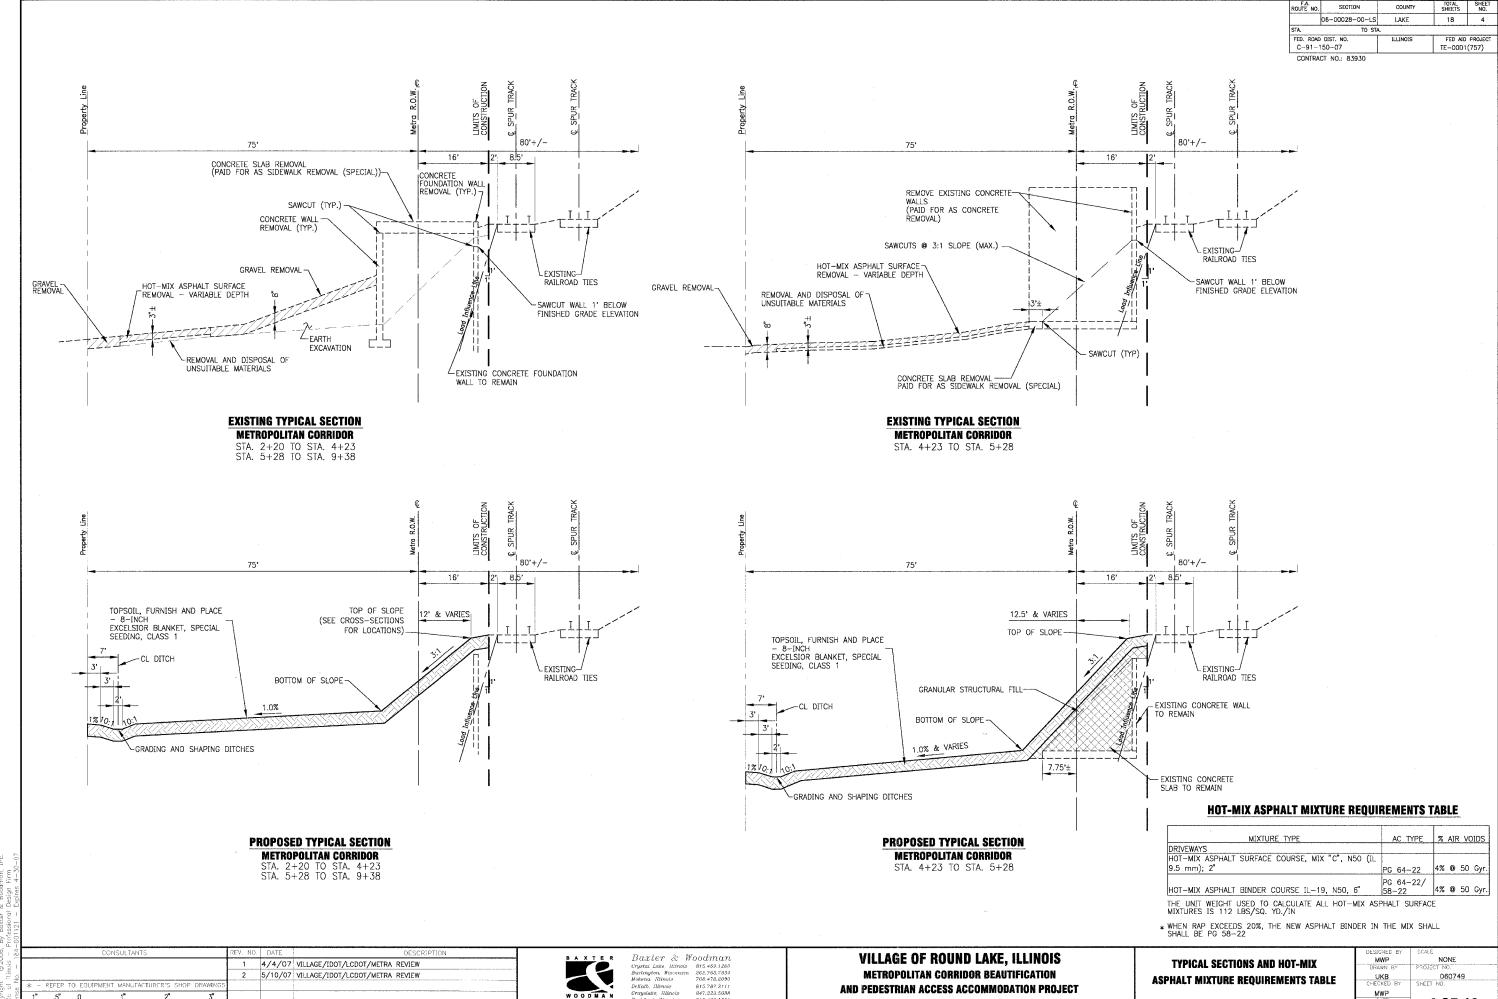

4 OF 18

I.\ROULK\060749 ITEP\DWGS\Plotted: 5-09-07 @ 1:54pm Copyright @2006, By Boxter

F.A. ROUTE NO.	SECTION	COUNTY	TOTAL SHEETS	SHEET NO.
	06-00028-00-LS	LAKE	18	5
STA.	TO ST	Ā.		
FED. ROAD C-91-	DIST. NO. 150-07	ILLINOIS	FED AID TE-00D1	PROJECT (757)
CONTRACT NO.: 83930				

EARTHWORK

LOCATION STA TO STA	UNDERCUT AND PGE REPLACEMENT	UNSUITABLE EXCAVATION (TOPSOIL)	REMOVAL & DISPOSAL OF UNSUITABLE MATERIAL	EARTH EXCAVATION	UTILITY EXCAVATION	EXCESS STRUCTURE EXCAVATION	TOTAL SUITABLE EXCAVATION	EXCAVATION TO BE USED IN EMBANKMENT (15% SHRINKAGE)	EMBANKMENT	EARTHWORK BALANCE WASTE (+) OR SHORTAGE (-)
	(CY)	(CY)	(CY)	(CY)	(CY)	(CY)	(CY)	(CY)	(CY)	(CY)
METRA CORRIDOR										
02+20 03+00	0	39	39	0	0	0	0	0	2	-a
03+00 04+00	0	110	110		0	0	0	0	8	-8
04+00 05+00	0	120	120	37	0	0	37	31	5	26
05+00 06+00	0	130	130	190	0	0	190	162	0	162
06+00 07+00	0	85	85	330	0	0	330	281	11	270
07+00 08+00	0	28	28	365	0	0	365	310	40	270
08+00 09+38	0	95	95	109	0	. 0	109	93	14	7'
TOTALS	0	607	607	1,031	0	0	1,031	877	80	79

TOTAL 1,031 607 0 797

EARTHWORK SUMMARY

EARTH EXCAVATION
REMOVAL AND DISPOSAL OF UNSUITABLE MATERIAL
POROUS GRANULAR EMBANKMENT
EXCESS EXCAVATION

EARTHWORK NOTES:
ASSUME 8 INCH DEPTH OF TOPSDIL PLACEMENT
FOR REMOVAL & DISPOSAL OF UNSUITABLE MATERIAL
ASSUME 8 INCH DEPTH OF TOPSDIL EXCAVATION & 5-INCH WERE PAVEMENT EXISTS
ASSUME 15% SHRINKAGE OF EARTH EXCAVATION TO BE REUSED AS EMBANKMENT

CONCRETE REMOVAL

LOCATION	N D STA	DESCRIPTION	CONCRETE FOUNDATION WALL REMOVAL (FOOT)	SIDEWALK REMOVAL (SPECIAL)	SAW CUTS	CONCRETE REMOVAL	CONCRETE WALL REMOVAL (FOOT)	SIDEWALK REMOVAL (SQ FT)
03+24	04+25	BUILDING	318	3, 880	0	0	0	0
04+24	05+28	BINS	0	320	423	. 67	0	0
05+28	05+68	CONC. SLAB	0	738	139	ο.	116	0
05+64	06+79	CONC. WALLS	0	0	80	О	267	0
06+80	07+52	CONC. SLAB	0	2, 300	63	0	63	0
07+52	08+12	BUILDING	425	3, 910	81	0	0	350
08+46	09+38	SIDEWALK	0	0	0	0	О	300
								, , , , , , , , , , , , , , , , , , , ,
		TOTALS	743	11, 148	786	67	446	650


	ei.		-07	
~	Ä	8	1-30-07	
50KA	lman	Ē	74	l
ιŏ V	hook	esigr	Expires	l
@ 1:13 PM By: 560KAR	Baxter & Woodman,	Professional Design Firm	1	l
2	1X.e	ssion	21	İ
 @	ã	Profe	184-001121	
07.0		ī	84-	t
2/7/2007	t 🕲 2007,	Illinois	1	ľ
2	⊚ ;:	Ξ	ZO.	ļ.,




Baxter & Woodman Crystal Lake, Illimois 815,459,1269 Burlington, Wicconson 827,627,843, Mekena, Illimois 708,478,2090 DeKalb, Illimois 915,787,311 Grupstoke, Illimois 915,459,1535 Randford, Illimois 915,469,1535 Pataryleid, Illimois 915,689,7425 VILLAGE OF ROUND LAKE, ILLINOIS
METROPOLITAN CORRIDOR BEAUTIFICATION
AND PEDESTRIAN ACCESS ACCOMMODATION PROJECT

SCHEDULE OF MATERIALS

	DESIGNED BY	SCALE
	₩₽	NONE
	DRAWN BY	PROJECT NO.
	PMP	060749
	CHECKED BY	SHEFT NO.
	MWP	
- 1	DATE	E NE 10
- 1	2-09-07	JUFIO

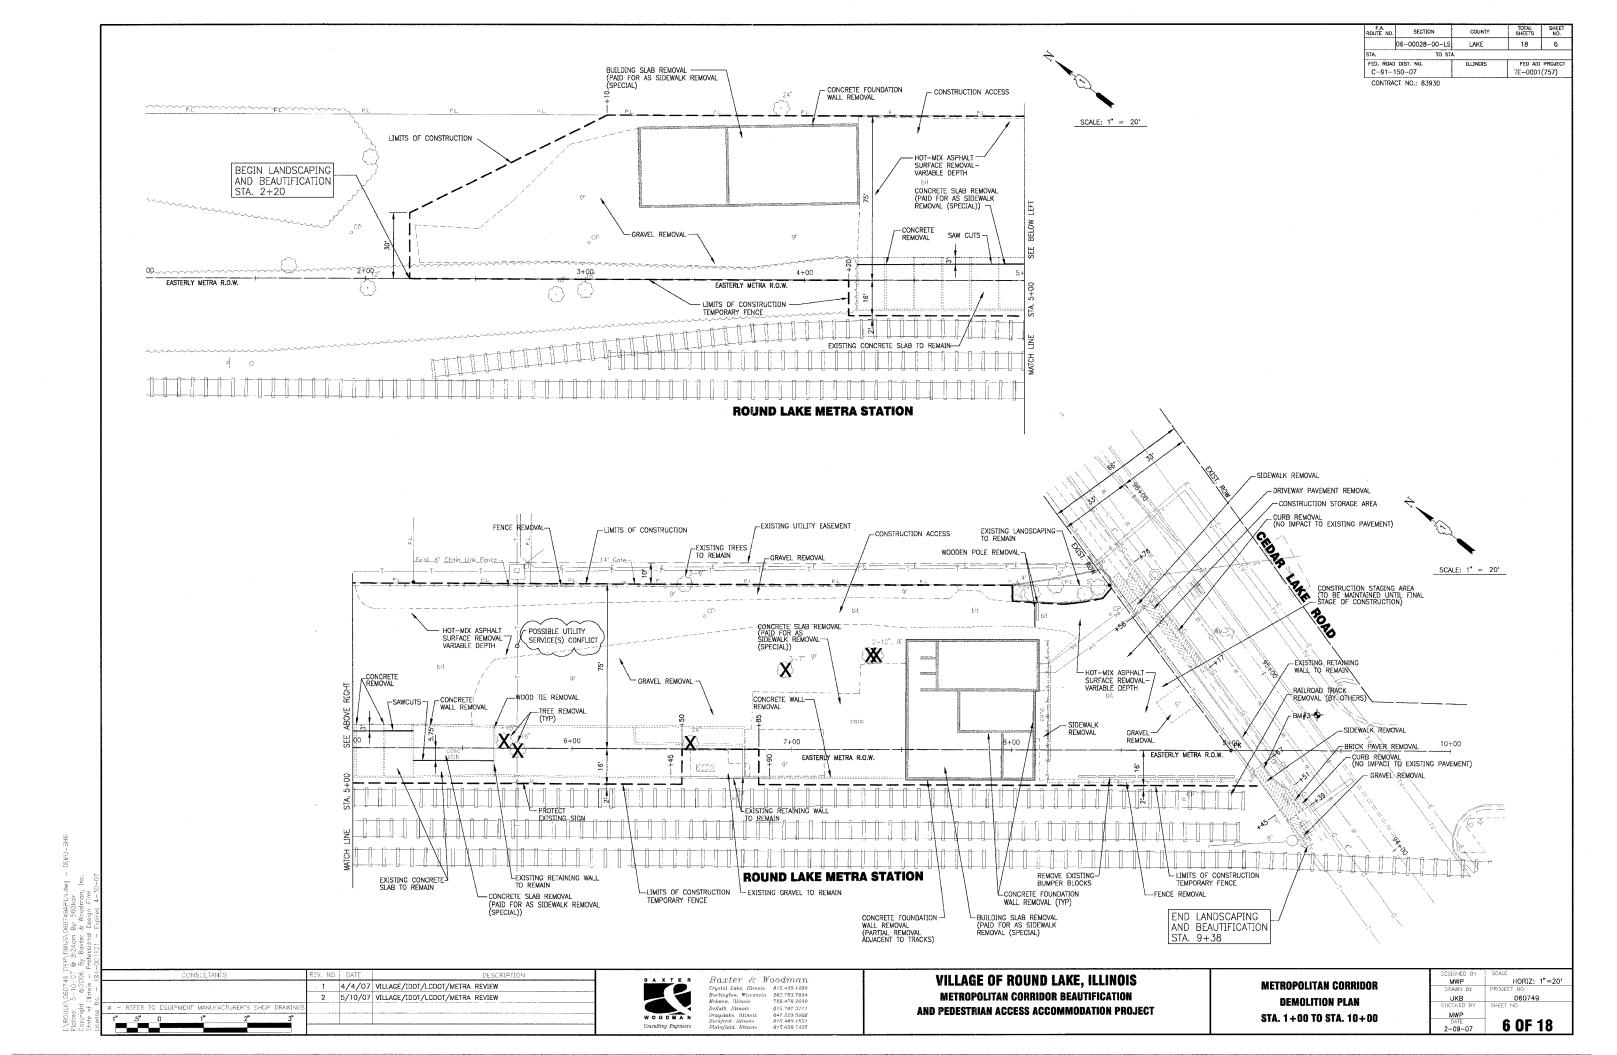


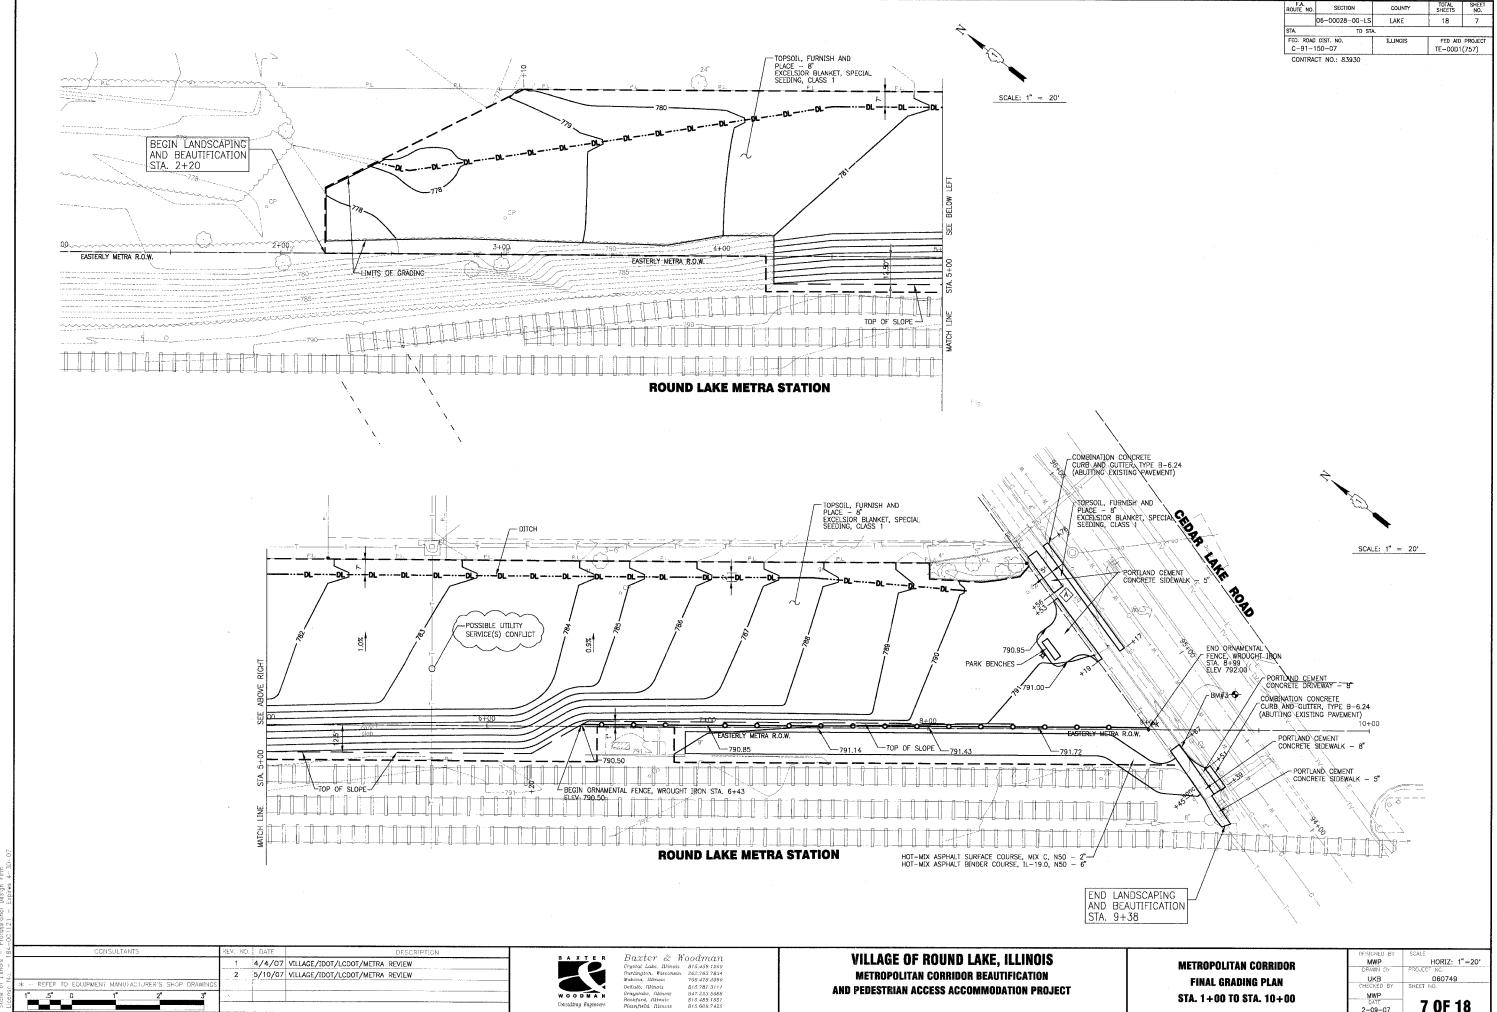

STA. 1+00 TO STA. 10+00

7 OF 18


2-09-07

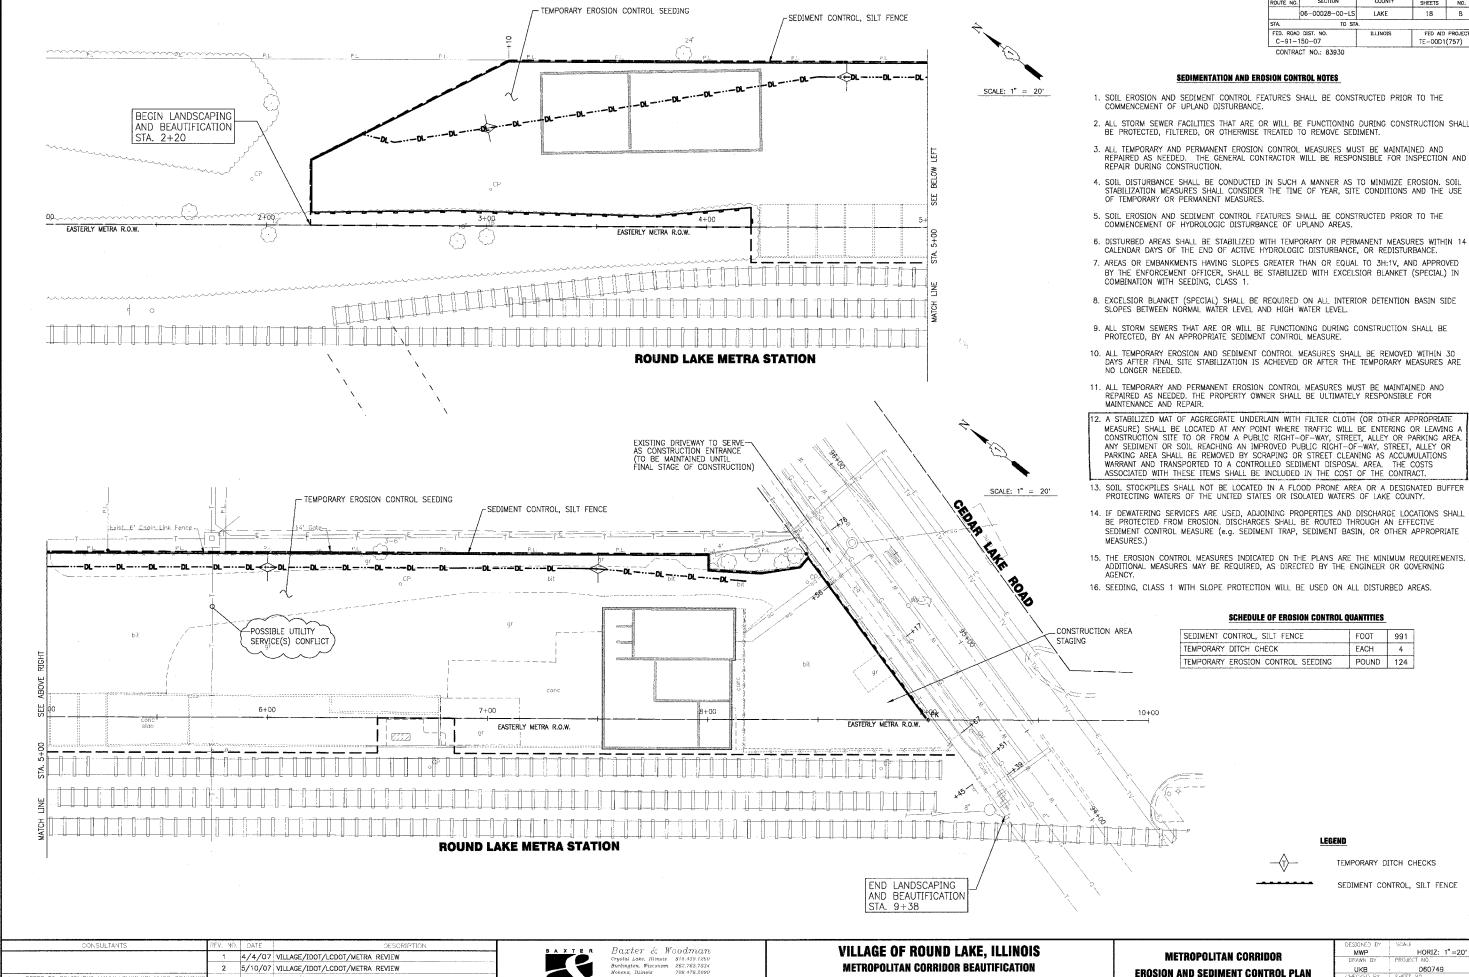

AND PEDESTRIAN ACCESS ACCOMMODATION PROJECT

EROSION AND SEDIMENT CONTROL PLAN STA. 1+00 TO STA. 10+00

DESIGNED BY	SCALE
MWP	HORIZ: 1"=20'
DRAWN BY	PROJECT NO.
UKB	060749
CHECKED BY	SHEET NO.
·MWP	j
DATE 2-09-07	8 OF 18

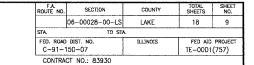


LANDSCAPING NOTES

- 1, PLANT NAMES CONFORM TO THE NAMES GIVEN IN 'STANDARDIZED PLANT NAMES' 1942 EDITION, PREPARED BY THE AMERICAN JOINT COMMITTEE ON HORTICULTURE NOMENCLATURE. NAMES OR VARIETIES NOT INCLUDED THEREIN CONFORM GENERALLY WITH NAMES ACCEPTED IN THE NURSERY TRADE. PLANT MATERIAL TO BE SECURED FROM NURSERIES WITHIN THE NORTHERN ILLINOIS AREA.
- 2, SHREDDED BARK MULCH 3" THE RATE OF APPLICATION SHALL BE FOR A FULL THREE INCH DEPTH (3") OF MULCH TO BE APPLIED TO THE PLANTING BED. FINAL GRADE OF MULCH AT THE WALK EDGE (AFTER SETTLING OCCURS) SHOULD BE ONE INCH (1") BELOW THE ADJACENT WALK AND SEATING AREA.
- 3. TREES WITH WIRE BASKETS SHALL HAVE THE TOP 1/2 OF THE WIRE BASKET REMOVED PRIOR TO PLANTING.
- 4. PLANTING BED PREPARATION: REMOVE EXISTING CONCRETE, STONE AND SOIL TO A DEPTH OF FIFTEEN INCHES (15"). REPLACE TO GRADE WITH A MINIMUM OF TWELVE INCHES (12") OF TOP SOIL, APPROVED BY THE VILLAGE AND ENGINEER. TOP DRESS THE ENTIRE BED WITH A TWO INCH LAYER (2") OF PEAT MOSS ALONG WITH A ONE INCH LAYER (1") OF MUSHROOM COMPOST AND A GRANULAR FERTILIZER AND SHALL BE INCLUDED IN THE LANDSCAPE FILL SOIL PAY ITEM. THE ENTIRE BED SHALL BE ROTO—TILLED JUST PRIOR TO THE INSTALLATION OF PLANTS. THE DAYLILLIES AND THE DWARF FOUNTAIN GRASS WILL BE PLANTED TWO FEET (2") ON CENTER. THE TURF EDGE OF THE BED SHALL BE NEATLY EDGED TO A DEPTH OF FOUR INCHES (4").
- 5. THE PLANTS WILL BE INSPECTED BY THE VILLAGE OF ROUND LAKE PRIOR TO PLANTING. ALL PLANT MATERIAL WILL BE GUARANTEED FOR ONE YEAR (1) AFTER ACCEPTANCE.

LANDSCAPING QUANTITIES

	TREES CODE NUMBER A2000118	DESCRIPTION TREE, ACER FREEMANII AUTUMN BLAZE (AUTUMN BLAZE FREEMAN MAPLE) 3" CALIPER, BALLED AND BURLAPPED	COMMON NAME Autumn Blaze Freeman Maple	BOTANICAL NAME Acer x freemanii 'Autumn Biaze'	SIZE (CALIPER) 3.0"	UNIT EACH	QUANTITY 2
	SHRUBS CODE NUMBER	DESCRIPTION	COMMON NAME	BOTANICAL NAME	SIZE	UNIT	QUANTITY
-	C2006236	SHRUB, RIBES ALPINUM (ALPINE CURRANT), 3' HEIGHT, BALLED AND BURLAPPED	Alpine Currant	Ribes alpinum	(FT. HT.) 3'	EACH	10
	PERENNIALS CODE NUMBER	DESCRIPTION	COMMON NAME	BOTANICAL NAME	SIZE (GAL.)	UNIT	QUANTITY
\	X0301407	PERENNIAL PLANTS, GALLON POT	Dwarf Fountain Grass	Pennisetum alopecuroides 'Hameln'	1 GAL.	100/UNIT	1.12
			Little Wine Cup Daylilly	Hemerocallis'Little Wine Cup'	1 GAL.	100/UNIT	1.02
	MISCELLANEOUS CODE NUMBER K1005481 K1003455	DESCRIPTION SHREDDED BARK MULCH 3" LANDSCAPE FILL SOIL	COMMON NAME Shredded Bark Mulch Landscape Fill Soil	BOTANICAL NAME	SIZE 3" depth	UNIT SQ. YD. CU. YD.	QUANTITY 59 20

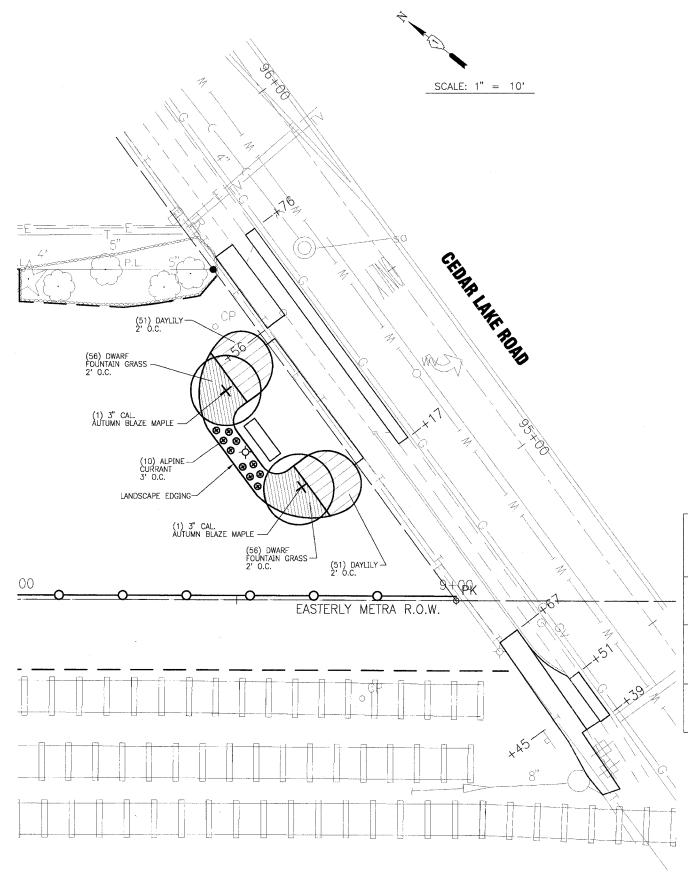

CONSULTANTS

REV. NO. DATE

1 4/4/07 VILLAGE/IDOT/LCDOT/METRA REVIEW

2 5/10/07 VILLAGE/IDOT/LCDOT/METRA REVIEW

* - REFER TO FQUIPMENI MANUFACTURER'S SHOP DRAWINGS

1" 5" 0 1" 2" 3"




Baxter & Woodman Crystal Lake, Iltinois 815.459.1280 Burlington, Kirconsin 267.637.834 Mokena, Rilinois 708.478.2090 McKath, Iltinois 815.787.3111 Grapstake, Rilinois 815.489.1551 Planfyield, Riknois 815.689.7425 VILLAGE OF ROUND LAKE, ILLINOIS
METROPOLITAN CORRIDOR BEAUTIFICATION
AND PEDESTRIAN ACCESS ACCOMMODATION PROJECT

METROPOLITAN CORRIDOR LANDSCAPE PLAN STA. 8+00 TO STA. 9+50 DESIGNED BY MWP HORIZ: 1"=10'
DRAWN BY PROJECT NO.
UKB O60749
CHECKED BY SHEET NO.
MWP
DATE 2-09-07

DATE DATE TO THE TOTAL SHEET NO.

9 OF 18

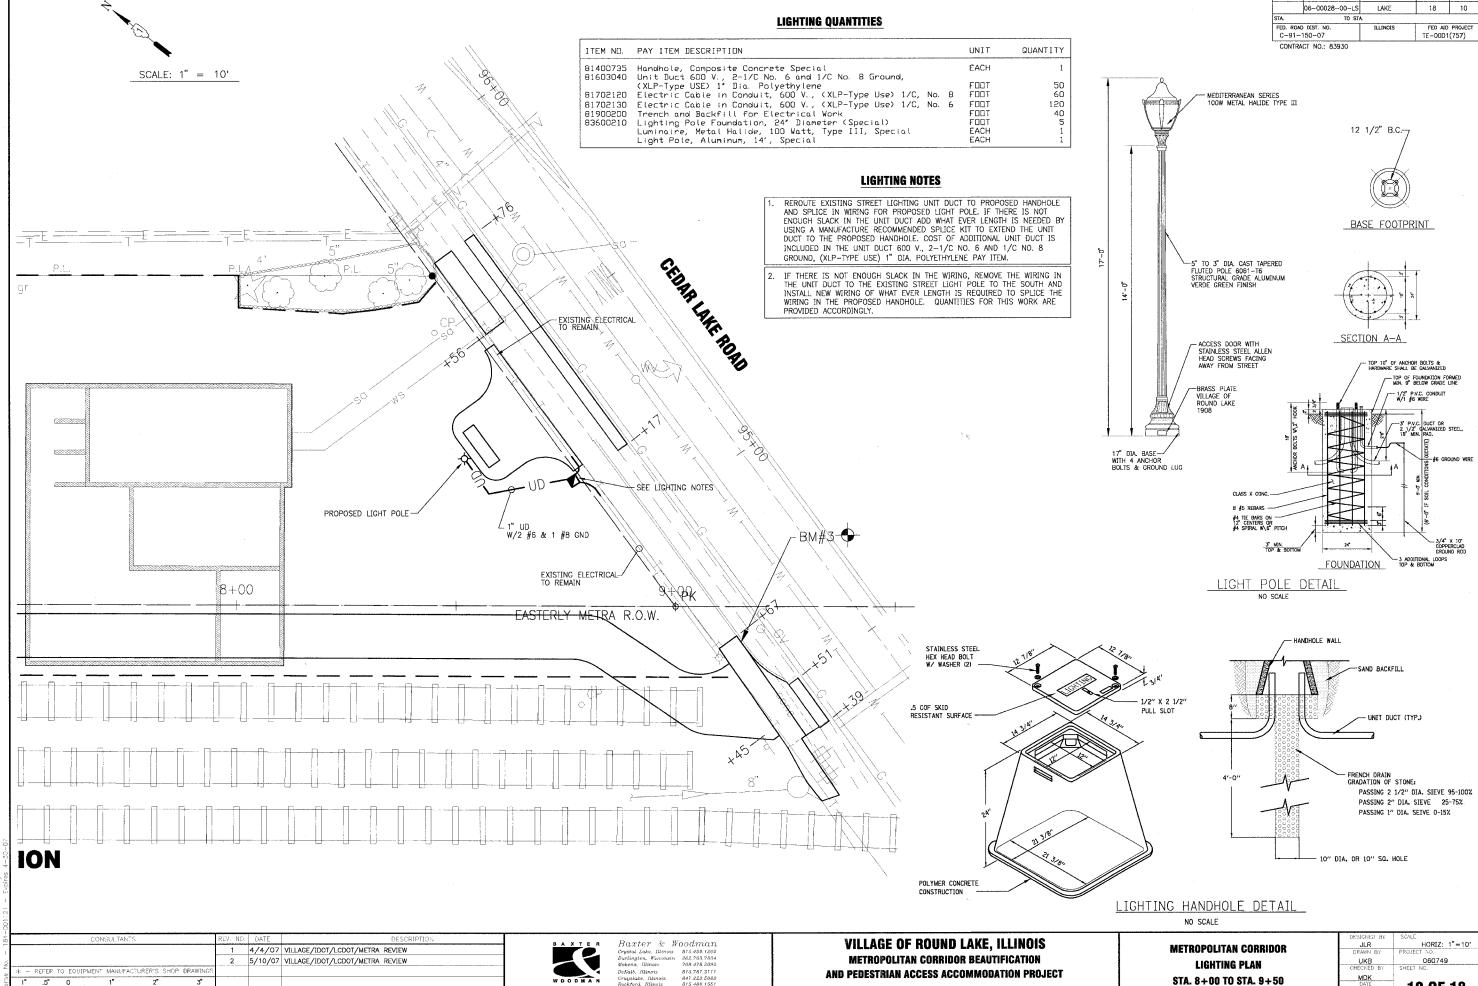


SECTION

10 OF 18

2-09-07

5 – IU-O W BOSLECT: 1917: 2004/dr Blinnis – Professional Design Firm No. – 184–2011(2) – Expires 4–33–07

CONTRACT NO.: 83930

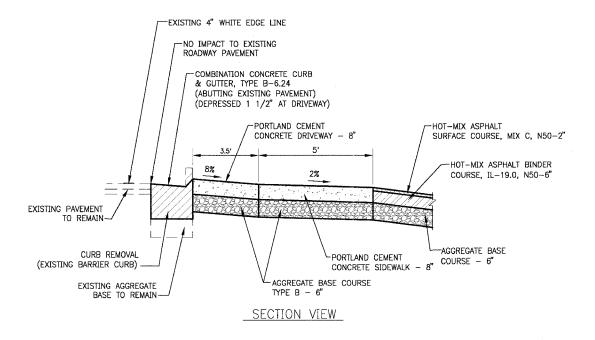

TOP RAIL

POST—2" SQUARE

MID RAIL

PICKETS—5/8" SQUARE

SOLID

ORNAMENTAL FENCE, WROUGHT IRON


ORNAMENTAL FENCE, WROUGHT IRON


NO SCALE

PORTLAND CEMENT CONDRETE

DRIVEWAY - 8"

DETAIL NO SCALE

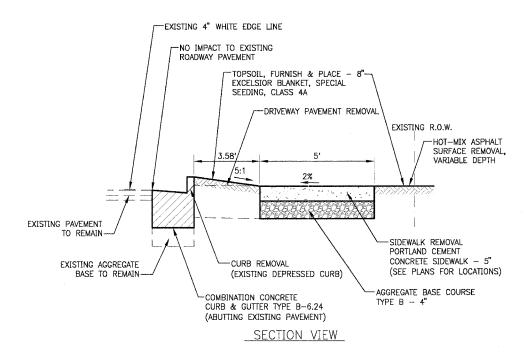

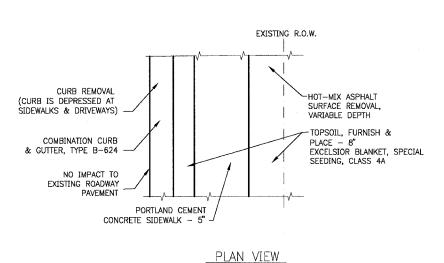

CURB REMOVAL, SIDEWALK REMOVAL,

COMBINATION CONCRETE CURB AND GUTTER, TYPE B-6.24

(ABUTTING EXISTING PAVEMENT)

AND PORTLAND CEMENT CONCRETE SIDEWALK - 5" DETAIL

NO SCALE

CONSULTANTS

REV NO. DATE

1 4/4/07 VILLAGE/IDOT/LCDOT/METRA REVIEW

2 5/10/07 VILLAGE/IDOT/LCDOT/METRA REVIEW

* - REFER TO EQUIPMENT MANUFACTURER'S SHOP DRAWINGS

1" .5" 0 1" 2" 3"



Baxter & Woodman
Crystal Lake, Rivors 815.459.1260
Burlington, Wisconsin 282.783.7841
Makens, Rivors 815.787.3111
Crystake, Rivors 815.787.3111
Crystake, Rivors 847.223.6088
Rackferd, Illinois 815.489.1551
Plainfield, Historis 815.489.1551

VILLAGE OF ROUND LAKE, ILLINOIS
METROPOLITAN CORRIDOR BEAUTIFICATION
AND PEDESTRIAN ACCESS ACCOMMODATION PROJECT

MISCELLANEOUS DETAILS

DESCRIED BY MWP NONE


ORAWN BY PROJECT NO.

UKB 080749

CHEKED BY SHEET NO.

MWP
DATE
2-09-07 11 OF 18

F.A.U. ROUTE NO.	SECTION	COUNTY	TOTAL SHEETS	SHEET NO.
	06-00028-00-LS	LAKE	18	12
STA. TO ST				
FED. ROAD DIST. NO. C-91-150-07		ILLINOIS	FED AID PROJECT TE-00D1(757)	

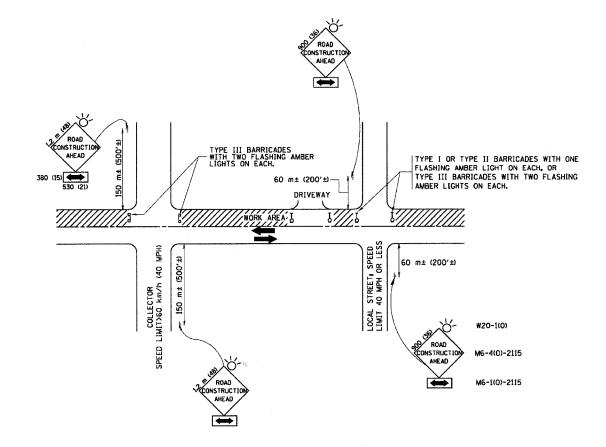

TRAFFIC CONTROL AND PROTECTION FOR SIDE ROADS, INTERSECTIONS, AND DRIVEWAYS

NOTES:

- A. FOR NO LANE RESTRICTION ON THE SIDE ROAD OR DRIVEWAYS
- 1. SIDE ROAD WITH A SPEED LIMIT OF 60 km/h (40 MPH) OR LESS AS SHOWN ON THE DRAWING AND AS DIRECTED BY THE ENGINEER:
- O) ONE ROAD CONSTRUCTION AMEAD SIGN 900x900 (36x36) WITH A FLASHER AND FLAG MOUNTED ON IT APPROXIMATELY 60 m (200") IN ADVANCE OF THE MAIN ROUTE.
- b) THE CLOSED PORTION OF THE MAIN ROUTE SHALL BE PROTECTED BY BLOCKING WITH TYPE 1, TYPE 11 OR TYPE 111 BARRICADES, 1/3 OF THE CROSS SECTION OF THE CLOSED PORTION.
- 2. SIDE ROAD WITH A SPEED LIMIT GREATER THAN 60 km/h (40 MPH) AS SHOWN ON THE DRAWING AND AS DIRECTED BY THE ENGINEER:
- O) ONE HOAD CONSTRUCTION AHEAD SIGN 1.2 m x 1.2 m (48x48) WITH A FLASHER MOUNTED ON IT APPROXIMATELY 150 m (500') IN ADVANCE OF THE MAIN ROUTE.
- b) THE CLOSED PORTION OF THE MAIN ROUTE SHALL BE PROTECTED BY BLOCKING WITH TYPE III BARRICADES, 1/2 OF THE CROSS SECTION OF THE CLOSED PORTION.
- 3. WHEN THE SIDE ROAD LIES BETWEEN THE BEGINNING OF THE MAINLINE SIGNING AND THE WORK ZONE, A SINGLE HEADED ARROW (MG-1) SHALL BE USED IN LIEU OF THE DOUBLE HEADED ARROW (MG-4).

B. FOR A LANE CLOSURE ON A SIDE ROAD OR DRIVEWAY:

- USE APPLICABLE PORTIONS OF THE TYPICAL APPLICATION OF TRAFFIC CONTROL DEVICES (STD. 701501, STD. 701606 OR THE APPROPRIATE STANDARD). THE SPACING OF SIGNS AND BARRICADES SHALL BE ADJUSTED FOR FIELD CONDITIONS AS DIRECTED BY THE ENGINEER. THE DIRECTIONAL ARROW SHALL BE COVERED OR REMOVED WHEN NO LONGER CONSISTENT WITH THE SIDE ROAD LANE CLOSURE.
- C. ADVANCE WARNING SIGNS ARE TO BE OMITTED ON DRIVEWAY UNLESS OTHERWISE NOTED.
- D. THE TRAFFIC CONTROL AND PROTECTION FOR SIDE ROADS, INTERSECTIONS, AND DRIVEWAYS SHALL BE INCIDENTAL TO THE COST OF SPECIFIED TRAFFIC CONTROL STANDARDS OR ITEMS.

REVISIO	NS		
NAME		DATE	
LHA		6/89	т
T. RAMMACHER	09	/08/94	
J. OBERLE	10	/18/95	
A. HOUSEH	03	/06/96	
A. HOUSEH	10	/15/96	
T. RAMMACHER	01	/06/00	
			٠.
		· · · · · · · · · · · · · · · · · · ·	SC

ILLINOIS DEPARTMENT OF TRANSPORTATION TRAFFIC CONTROL AND PROTECTION FOR SIDE ROADS, INTERSECTIONS, AND DRIVEWAYS


DATE: 2/15/2006


CHECKED BY TC-10

F.A.U. ROUTE NO.	SECTION	COUNTY	TOTAL	SHEET
	06-00028-00-LS	LAKE	18	13
STA. TO STA				
FED. ROAD DIST. NO. C-91-150-07		ILLINOIS		PROJECT 01(757)

SIGNING FOR FLAGGING OPERATIONS AT WORK ZONE OPENINGS

WORK ZONE EXIT OPENING

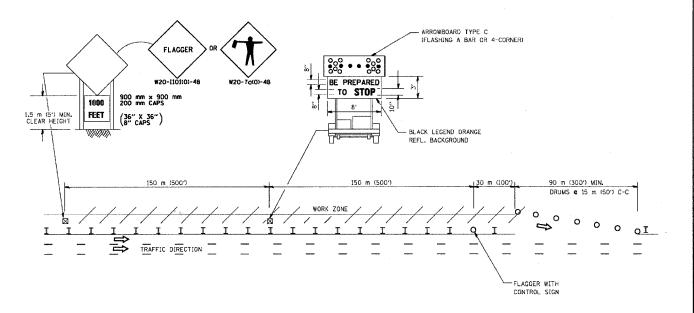

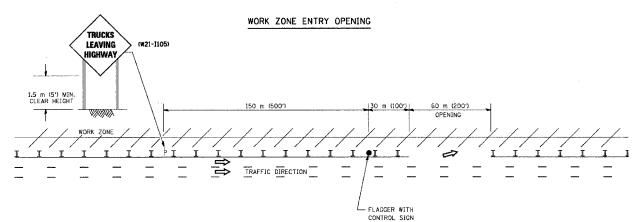

NOTES

- 1. The Arrowboard, the Flagger Ahead trailer mounted sign, and the Trucks Leaving Highway sign shall be removed or turned away from traffic and the exit and entry openings shall be closed when the flagging operation ceases.
- 2. Work Zone Exit Openings should be a minimum of one half mile apart.
- 3. Exiting the work zone at any place other than at a Work Zone Exit Opening will be prohibited.


4. All vehicles shall enter the work zone at entry openings, using their turn signals to warn motorists

ALL DIMENSIONS ARE IN MILLIMETERS (INCHES) UNLESS OTHERWISE SHOWN

REVISIONS		ILLINOIS DEPARTMENT OF TRANSPORTATION		
NAME DATE		TELINOIS DELAGRACIAL OF THANSPORTATION		
DWS	8/98			
JAF	4/03			
JAF	2/06	SIGNING FOR FLAGGING OPERATIONS		
		AT WORK ZONE OPENINGS		
		AT WORK ZONE OPENINGS		
	·			


SCALE: NONE DATE: 3/1/2006 DRAWN BY CADD CHECKED BY TC-18

F.A.U. OUTE NO.	SECTION	COUNTY	TOTAL SHEETS	SHEET NO.		
	06-00028-00-LS	LAKE	18	14		
TA.	A. TO STA.					
	DIST. NO. -150-07	ILLINOIS	FED ALD TE-00D	PROJECT 1(757)		

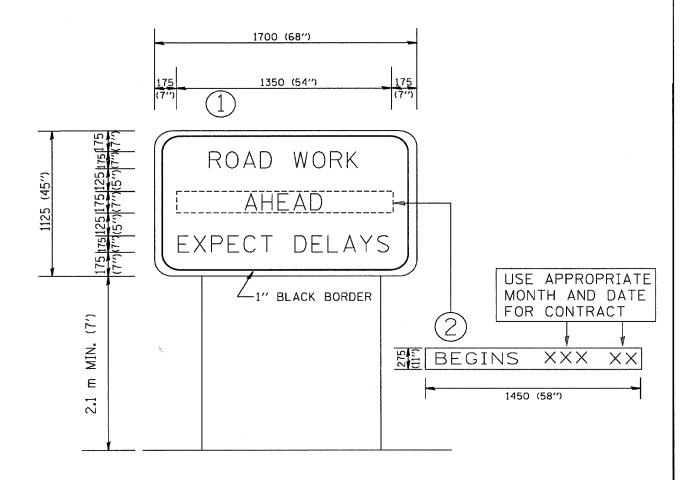


NOTES:

- 1. USE BLACK LETTERING ON ORANGE BACKGROUND.
- 2. ERECT SIGNS IN ADVANCE OF THE LOCATION FOR THE "ROAD CONSTRUCTION AHEAD" SIGN AT LOCATIONS AS DIRECTED BY THE ENGINEER.
- 3. ERECT SIGN () WITH INSTALLED PANEL (2) ONE WEEK PRIOR TO THE START OF CONSTRUCTION.
- 4. REMOVE PANEL 2 SOON AFTER THE START OF CONSTRUCTION.
- 5. SEE SPECIAL PROVISION FOR "TEMPORARY INFORMATION SIGNING" FOR ADDITIONAL INFORMATION.
- 6. ONE SIGN ASSEMBLY EQUALS 2.3 SQ. M. (25.70 SQ. FT.)

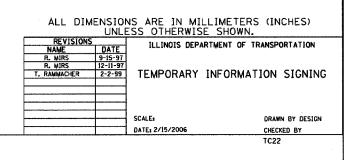

Hed: 5-09-07 @ 9.59cm By: 550km pyright @2006 By Baster & Waodman, Inc. ate of Illinois - Professional Design Firm errs No. - 164-001121 - Expires 4-30-07

F.A.U. ROUTE NO.	SECTION	COUNTY	TOTAL SHEETS	SHEET NO.
	06-00028-00-LS	LAKE	18	15
STA. TO STA		ι.		
FED. ROAD DIST. NO. C-91-150-07		ILLINOIS	FED ALD TE-000	PROJECT 1(757)

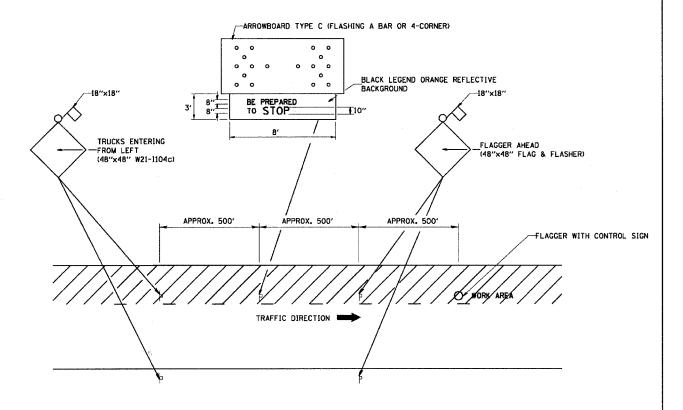


METHOD OF FLAGGING

NOTE:


- 1. SIGNS SHALL BE MOUNTED AT A MINIMUM CLEARANCE HEIGHT OF 5 FEET
- 2. ALL SIGNS SHALL BE REMOVED WHEN THE FLAGGING OPERATION CEASES.
- 3. THIS CASE ALSO APPLIES WHEN THE WORK ZONE IS ON THE RIGHT.
 UNDER THESE CONDITIONS "TRUCKS ENTERING FROM RIGHT" SIGNS SHALL
 BE SUBSTITUTED FOR "TRUCKS ENTERING FROM LEFT" SIGNS. ALSO
 THE ARROWBOARD AND "BE PREPARED TO STOP" SIGNS SHALL BE
 RELOCATED TO THE RIGHT SIDE OF THE ROAD.
- 4. WORK ZONE ACCESS POINTS SHOULD BE A MINIMUM OF ONE HALF MILE APART. MEDIAN WORK ZONE ACCESS POINTS SHOULD NOT BE LOCATED OPPOSITE OF EACH OTHER.
- 5. NIGHTTIME FLAGGING OPERATIONS: THE FLAG STATION SHALL BE LIGHTED WITH ADDITIONAL LIGHTS OTHER THAN STREET LIGHTS. THE FLAGGER CONTROL SIGN AND THE FLAGGER'S VEST SHALL BE REFLECTORIZED. IN ADDITION, THE FLAGGER SHALL HAVE A FLASHLIGHT OR LIGHTED WAND.

REVISIONS	ILLINOIS DEPARTMENT	ILLINOIS DEPARTMENT OF TRANSPORTATION		
NAME DAT	E ILLINOIS DEFANTMENT	OF TRANSPORTATION		
RAY RITCHIE 5/10/	00			
	METHOD OF	FLAGGING		
	_ METHOD OF	FLAUGING		
	SCALE: NOT TO SCALE	DRAWN BY C.A.D.		
	DATE: 2/15/2006	CHECKED BY		
The state of the s		BM-14		


Mitad: 5-09 07 @ 10.03cm By: 560km ptytyl (2006, by Boxter & Wordmon, Inc. Bytyle of Illinois – Professional Design Final onse No. 134-001121 – Expires 4–50–07

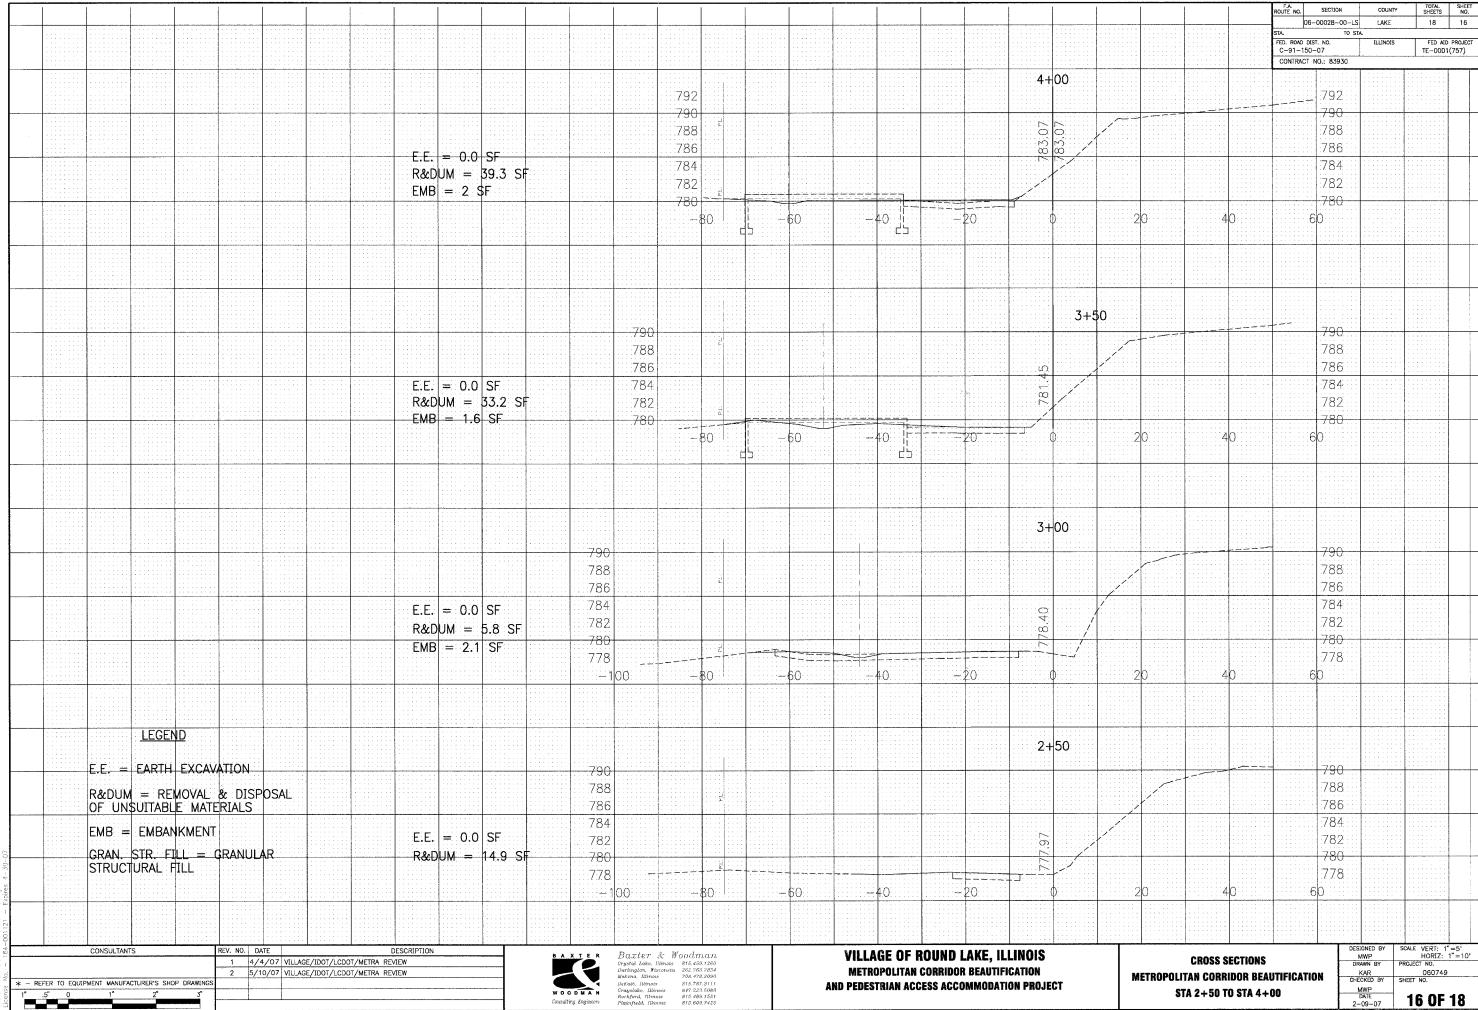

16 OF 18

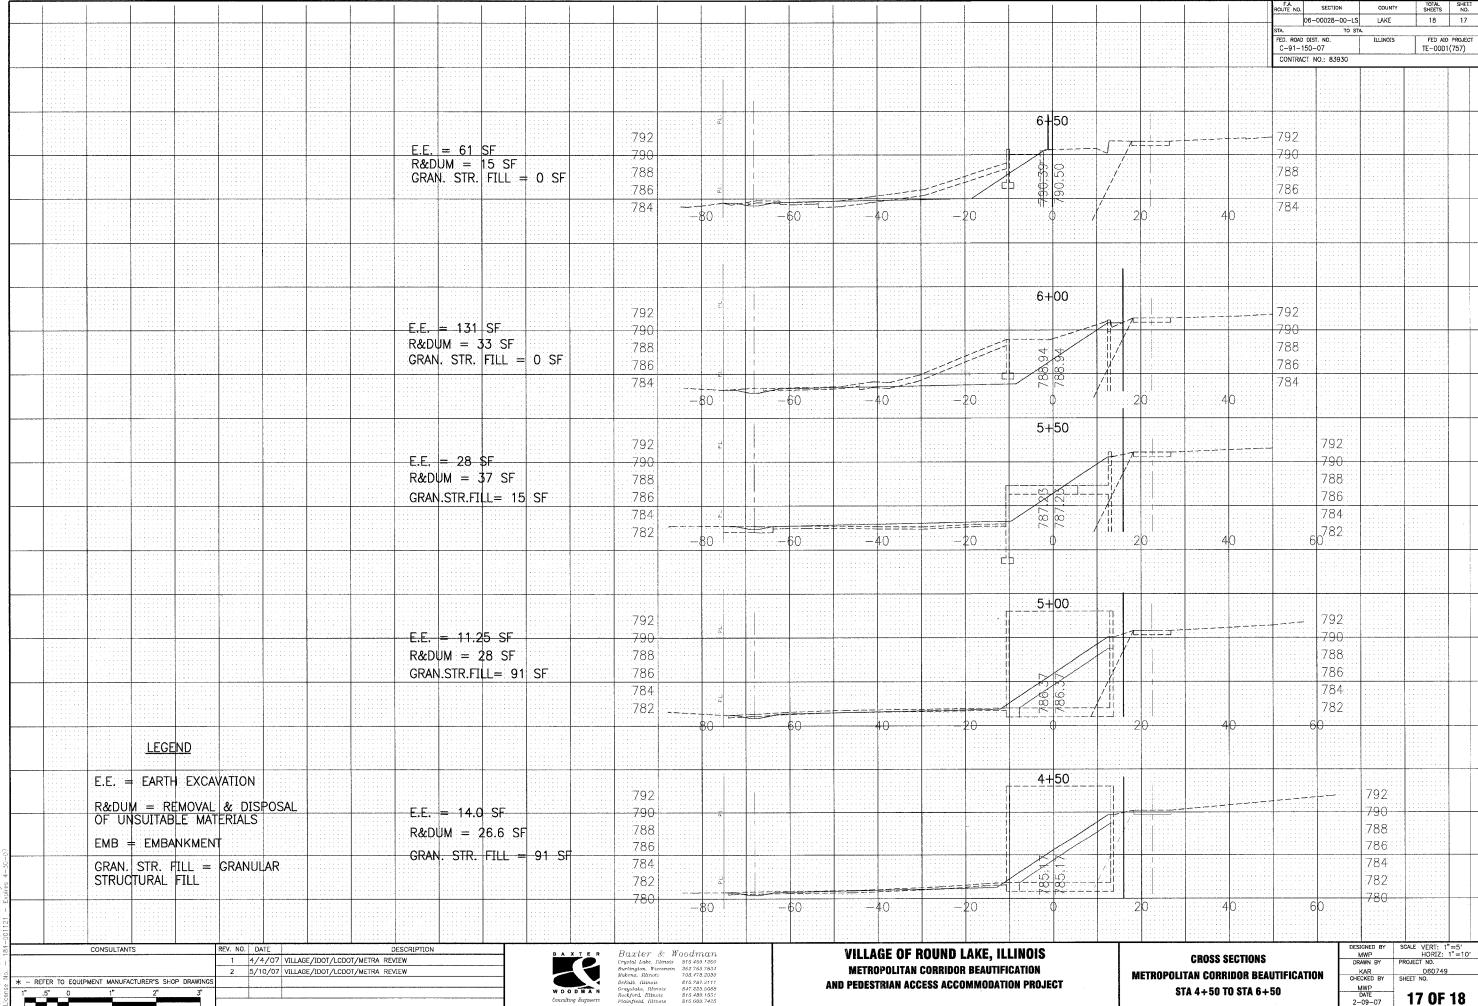

17 OF 18

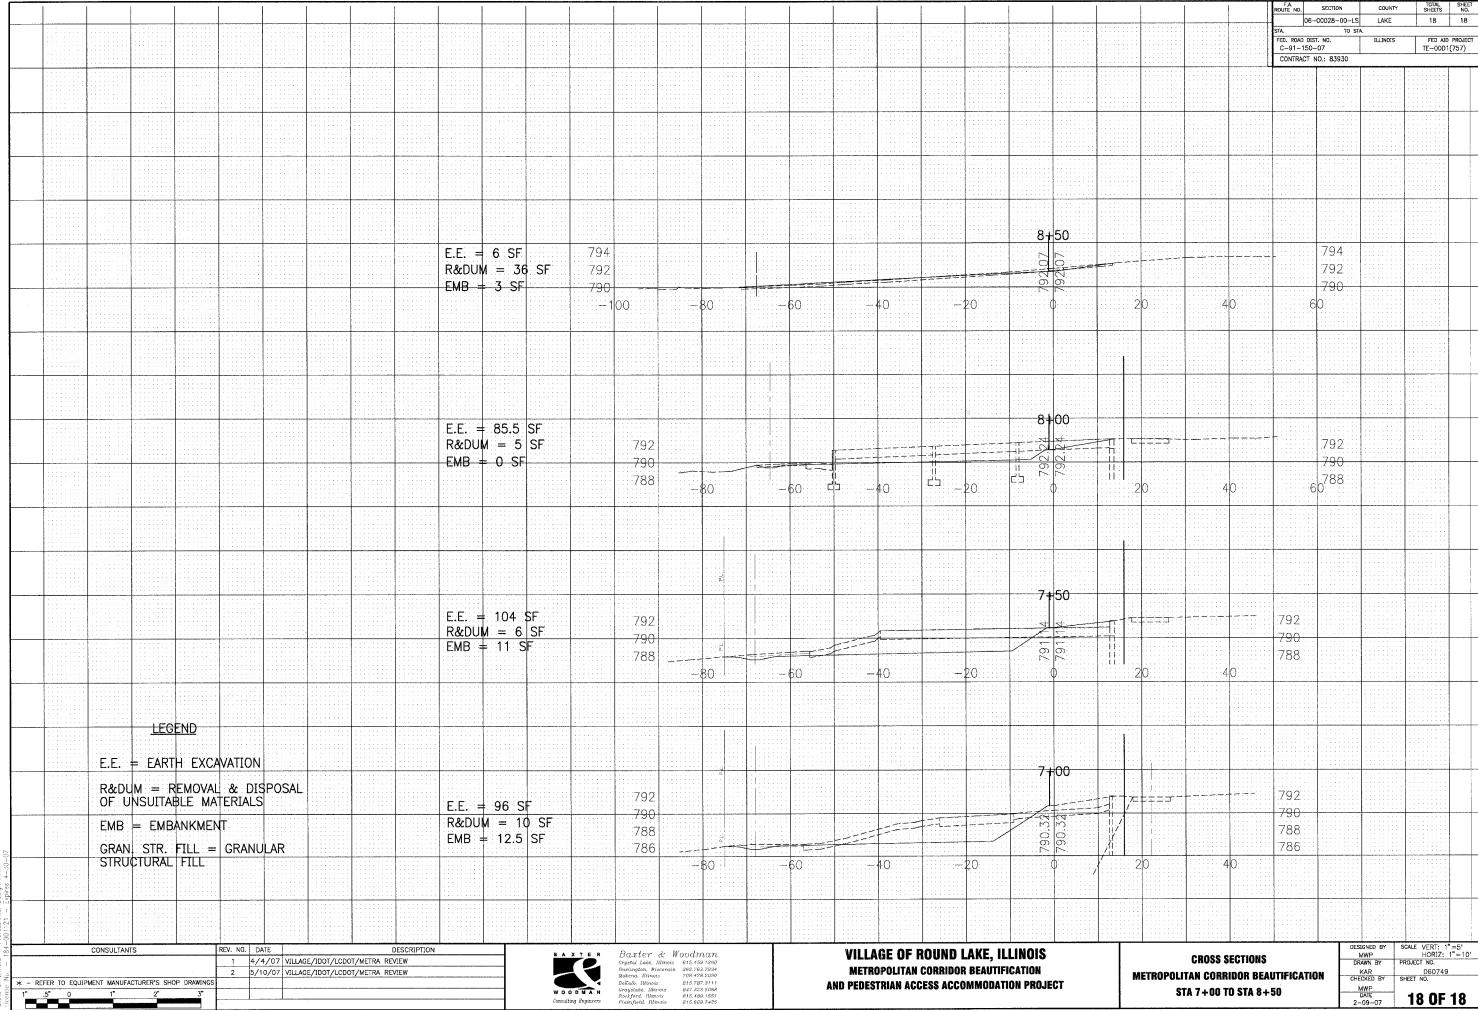

19—07 Ф. 7:45pm: Ву: 560kar 12006, Бу Ялхіна & Жообтап, Inc. 23 — Professional Design Firm. — 184—001:21 — Expires 4—30—07