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08-02-2024 LETTING ITEM 050 COVER SHEET

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SCHEDULES OF QUANTITIES

5. PROPOSED TYPICAL SECTIONS

6-7. **REMOVAL PLAN SHEETS**

PROPOSED PLAN SHEETS

ADA DETAIL SHEET

SIDEWALK SIDE CURB DETAIL

HIGHWAY STANDARDS

STANDARD SYMBOLS, ABBREVIATIONS, AND PATTERNS 000001-08

TEMPORARY EROSION CONTROL SYSTEMS 280001-07

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CLASS C&D PATCHES 442201-03

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701006-05 OFF-RD OPERATIONS 2L 2W 15'TO 24" FROM PAVEMENT EDGE

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701901-09 TRAFFIC CONTROL DEVICES

UTILITIES

0

0

0

AMEREN (ELECTRIC) 8420 N. UNIVERSITY ST. ATTN: ZACH ALEXANDER 309-210-7588

AMEREN (GAS) 8420 N. UNIVERSITY ST. **PEORIA. IL 61615** ATTN: ZACH WILSON 309-645-4458

2315 N. KNOXVILLE AVE. PEORIA, IL 61604 ATTN: BILL CONOVER 309-550-8043

VILLAGE OF CREVE COEUR 103 N. THORNCREST AVE. CREVE COEUR, IL ATTN: TERRY KEOGEL 309-251-8838

COMCAST 3517 N. DRIES LANE PEORIA, IL 61604 ATTN: PAUL KAUSCH 309-643-3986

i3 BROADBAND 602 HIGH POINT LANE EAST PEORIA. IL 61611 ATTN: FRANK MARTINEZ 217-671-4211


VILLAGE OF CREVE COEUR WATER DEPARTMENT ATTN: BROCK YOUNG 309-214-0153

BEGIN IMPROVEMENTS

GROVELAND ST

STA 13+08

CATALOG NO. 036524-00 CONTRACT NO. 89861

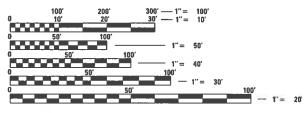

FULL SIZE PLANS HAVE BEEN PREPARED USING STANDARD ENGINEERING SCALES. REDUCED SIZED PLANS WILL NOT CONFORM TO STANDARD SCALES. IN MAKING MEASUREMENTS ON REDUCED PLANS, THE ABOVE SCALES MAY BE USED.


J.U.L.I.E.

JOINT UTILITY LOCATION INFORMATION FOR EXCAVATION 1-800-892-0123 OR 811

STATE OF ILLINOIS DEPARTMENT OF TRANSPORTATION **DIVISION OF HIGHWAYS**

PLANS FOR PROPOSED LOCAL AGENCY IMPROVEMENT FEDERAL-AID PROJECT

SAFE ROUTES TO SCHOOL SECTION: 22-00049-00-SW PROJECT: 4FZB(537) **TAZEWELL COUNTY VILLAGE OF CREVE COEUR** C-94-076-24

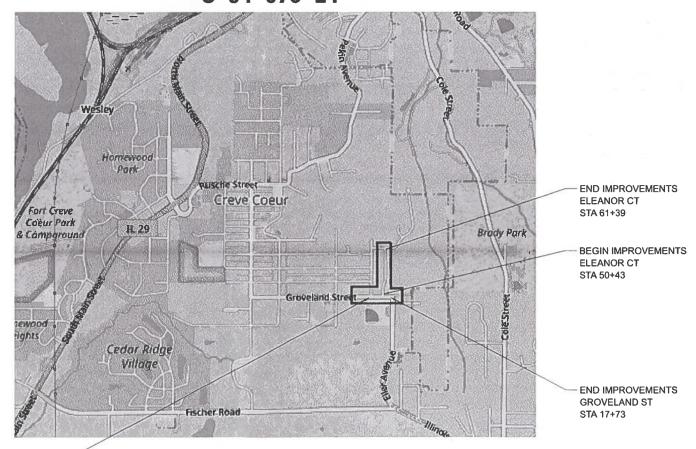

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SECTION 5.8 TOWNSHIP T25N RANGE R4W FUNCTIONAL CLASSIFICATION - MAJOR COLLECTOR LENGTH = 465 FT. = 0.088 MILE FUNCTIONAL CLASSIFICATION - LOCAL ROAD

LOCATION MAP

NOT TO SCALE

LENGTH = 1096 FT. = 0.210 MILE

TAZEWELL 11 22-00049-00-SW CONTRACT NO. 89861



VILLAGE OF CREVE COEUR, ILLINOIS

APRIL 29 Releasing For Bid Based on Limited Review 20 24 Same DEPUTY DIRECTOR OF HIGHWAYS, REGION THREE ENGINEER STATE OF ILLINOIS
DEPARTMENT OF TRANSPORTATION





1603 NORTH GALENA ROAD PEORIA HEIGHTS, ILLINOIS 61616 PHONE: (309) 687-5566 WWW HERMANNASSOC COM

ILLINOIS PROFESSIONAL DESIGN FIRM NO. 184.004714

TRANSPORTATION . MUNICIPAL ENGINEERING . LAND DEVELOPMENT

ASBESTOS INSPECTION . CONSTRUCTION OBSERVATION

GENERAL NOTES

- ALL CONSTRUCTION SHALL COMPLY WITH THE CURRENT EDITIONS OF THE ILLINOIS DEPARTMENT OF TRANSPORTATION'S "STANDARD SPECIFICATIONS FOR ROAD AND BRIDGE CONSTRUCTION," - HEREINAFTER REFERRED TO AS THE "STANDARD SPECIFICATIONS," "SUPPLEMENTAL SPECIFICATIONS AND RECURRING SPECIAL PROVISIONS," AND THE "MANUAL ON UNIFORM TRAFFIC CONTROL DEVICES."
- 2. THE CONTRACTOR SHALL VERIFY ALL BENCHMARKS AND HORIZONTAL CONTROL POINTS FOR ACCURACY PRIOR TO STARTING CONSTRUCTION AND REPORT ANY DISCREPANCIES TO THE ENGINEER.
- 3. VEGETATION IN THE FORM OF BUSHES, SHRUBS, OR OTHER SMALL PLANT MATERIAL THAT INTERFERES WITH THE PROPOSED CONSTRUCTION SHALL BE TRIMMED OR REMOVED ONLY TO THE DEGREE WHICH IS NECESSARY TO ACCOMPLISH THE PROPOSED WORK. THIS WORK SHALL BE CONSIDERED INCIDENTAL TO THE CONTRACT.
- 4. THE CONTRACTOR SHALL NOTIFY AND RECEIVE APPROVAL FROM THE ENGINEER PRIOR TO REMOVING OR COVERING UP ANY SURVEY MONUMENTS OR PROPERTY MARKERS.
- 5. THE CONTRACTOR SHALL CONFINE THE CONSTRUCTION WITHIN THE RIGHT OF WAY, EASEMENTS, OR CONSTRUCTION LIMITS SHOWN ON THE PLANS.
- CONTRACTOR SHALL TAKE REASONABLE PRECAUTIONS SO AS TO PREVENT DAMAGE FROM OCCURING TO ALL EXISTING BUILDINGS, STRUCTURES, PUBLIC, AND PRIVATE PROPERTY AS A RESULT OF CONSTRUCTION.
- SIGNS, MAILBOXES, FENCE, FENCE RAILS, POSTS, LANDSCAPING ITEMS NOT IDENTIFIED ON THE BID SCHEDULE WHICH ARE DAMAGED OR DISTURBED DURING CONSTRUCTION SHALL BE REPLACED WITH LIKE MATERIALS AND CONSTRUCTION. THIS WORK SHALL BE INCLUDED IN THE CONTRACT AMOUNT.
- ACCESS MUST BE MAINTAINED TO ALL EXISTING PROPERTIES DURING CONSTRUCTION IN ACCORDANCE WITH ARTICLE 107.09 UNLESS ARRANGEMENTS ARE MADE IN WRITING BY THE CONTRACTOR WITH THE PROPERTY OWNERS WITH A COPY TO THE ENGINEER FOR SHORT TERM CLOSURES.
- THE CONTRACTOR SHALL COMPLY WITH THE LEGAL STREET LOADING LIMITS ESTABLISHED BY THE LOCAL AGENCY. THE CONTRACTOR SHALL BE RESPONSIBLE FOR ANY DAMAGE CAUSED BY LUGS OR CLEATS ON TREADS OR WHEELS, EXCESSIVE WEIGHTS, AND LOADS, ETC.
- 10. ALL LIMITS OF REMOVAL SHALL BE SAWCUT FULL DEPTH PRIOR TO REMOVAL. ALL SAWCUTTING WILL BE CONSIDERED INCIDENTAL TO THE CONTRACT.
- 11. EARTH EXCAVATION AND BACKFILL FOR THE PROPOSED IMPROVEMENTS SHALL BE INCLUDED IN THE UNIT COST OF THE VARIOUS PROJECT ITEMS.

UTILITY NOTES

- THE LOCATIONS OF EXISTING UTILITIES AS SHOWN ON THE PLANS ARE BASED ON CAREFUL FIELD INVESTIGATION AND THE BEST INFORMATION AVAILABLE, BUT THEY ARE NOT GUARANTEED. IT SHALL BE THE CONTRACTOR'S RESPONSIBILITY TO ASCERTAIN THEIR EXACT LOCATION FROM THE UTILITY COMPANIES AND BY FIELD INSPECTION.
- 2. THE CONTRACTOR SHALL BE RESPONSIBLE FOR PROTECTING UTILITY PROPERTY FROM CONSTRUCTION OPERATIONS AS OUTLINED IN ARTICLE 107.39 OF THE "STANDARD SPECIFICATIONS." CALL J.U.L.I.E. AT 1-800-892-0123 A MINIMUM OF 48 HOURS IN ADVANCE OF DIGGING OPERATIONS. THE CONTRACTOR SHALL COORDINATE ANY REQUIRED UTILITY ADJUSTMENTS WITH THE APPROPRIATE UTILITY COMPANY.
- ABANDONED UNDERGROUND UTILITIES THAT CONFLICT WITH CONSTRUCTION SHALL BE DISPOSED OF OUTSIDE THE LIMITS OF RIGHT OF WAY ACCORDING TO ARTICLE 202.03 OF THE STANDARD SPECIFICATIONS AND AS DIRECTED BY THE ENGINEER. THIS WORK WILL NOT BE PAID FOR SEPARATELY, BUT SHALL BE INCLUDED IN THE COST OF THE CONTRACT.
- 4. ANY ADJUSTMENTS TO UTILITIES AND/OR APPURTENANCES INCLUDING BUT NOT LIMITED TO: VALVES, MANHOLES, HYDRANTS, POLES, PEDESTALS, ETC. SHALL BE PERFORMED BY THE RESPECTIVE UTILITY COMPANY OWNER. THE CONTRACTOR SHALL COORDINATE AND COOPERATE WITH THE UTILITY TO ACCOMPLISH THE WORK. THIS WORK WILL NOT BE PAID FOR SEPARATELY, BUT SHALL BE CONSIDERED INCIDENTAL TO THE CONTRACT.

HORIZONTAL & VERTICAL CONTROL POINTS - INFORMATION

١	IUMBER	NORTHING	EASTING	STATION OFFSET	ELEVATION	DESCRIPTION
CP #0	10000	1447865.093	2459578.241	17+65.52 37.32 RT	732.072	CPH SET IR/CAP
CP #1	10001	1447870.647	2459387.765	15+75.12 29.43 RT	735.318	CPH SET IR/CAP
CP #2	10002	1447864.397	2459136.369	13+23.67 32.60 RT	740.959	CPH SET IR/CAP
CP #3	10003	1448139.441	2459391.337	52+34.95 24.43 LT	729.761	CHIS X
CP #4	10004	1448399.695	2459492.160	55+06.98 24.78 RT	715.769	CHIS X
CP #5	10005	1448561.444	2459440.964	56+69.56 23.72 LT	710.332	CHIS X
CP #6	10006	1448776.497	2459485.602	58+83.84 24.49 RT	699.286	CHIS X
CP #7	10007	1449076.485	2459472.166	NORTH OF ELEANOR CT.	690.995	CPH SET IR/CAP

BENCHMARK - INFORMATION

NUMBER	NORTHING	EASTING	STATION	OFFSET	ELEVATION	DESCRIPTION
ВМ1	1447924.698	2459446.920	50+23.63	35.12 RT	735.82	HYD N-NE BOLT
BM2	1447872.831	2459117.831	13+05.24	23.94 RT	741.88	HYD N-NE BOLT
вм3	1448998.493	2459481.637	61+05.87	24.22 RT	693.32	HYD N-NE BOLT

ALIGNMENT INFORMATION - GROVELAND STREET

POINT	STATION	NORTHING	EASTING
POT STA.	10+08.54	1447893.132	2458820.866
POT STA.	18+24.71	1447903.134	2459636.967

ALIGNMENT INFORMATION – ELEANOR COURT

POINT	STATION	NORTHING	EASTING
POT STA.	50+00.00	1447900.381	2459412.279
PC STA.	51+59.64	1448059.987	2459409.125
PI STA.	52+38.31	1448138.640	2459407.467
PRC STA.	53+14.57	1448210.902	2459438.571
PI STA.	53+91.92	1448281.951	2459469.149
PT STA.	54+66.99	1448359.293	2459468.054
POT STA.	61+54.32	1449046.536	2459456.614

SCALE:



USER NAME = jessica	DESIGNED	-	MHS	REVISED	-	4/29/2024
	DRAWN	-	MHS	REVISED	-	
PLOT SCALE = 0.1667 / in.	CHECKED	-	JAS	REVISED	-	
PLOT DATE = 4/29/2024	DATE	-	3/15/2024	REVISED	-	

	GROVELAND ST AND ELEANOR CT						F.A. RTE	SEC ⁻	ΓΙΟΝ		COUNTY	TOTAL SHEETS	SHEET NO.
GENERAL NOTES							22-0004	9 - 00-SW		TAZEWELL	11	2	
										CONTRACT	NO. 898	61	
	SHEET	OF	SHEETS	STA.	Т	O STA.			ILLINOIS	FED. All	D PROIECT		

SUMMARY OF QUANTITIES

PAYITEM	PAY ITEM DESCRIPTION	UNIT	QUANTITY
25200100	SODDING	SQYD	506
35 10 1600	AGGREGATE BASE COURSE, TYPE B 4*	SQYD	616
			72 .
42400800	DETECTABLE WARNINGS	SQFT	23
44000500	COMBINATION CURB AND GUTTER REMOVAL	FOOT	55
44000600	SIDEWALK REMOVAL	SQ FT	2574
44201335	CLASS C PATCHES, TYPE IV, 8 INCH	SQYD	45
50603800	COMBINATION CONCRETE CURB AND GUTTER, TYPE B-6.12	FOOT	55
67100100	MOBILIZATION	LSUM	1
72400500	RELOCATE SIGN PANEL ASSEMBLY - TYPE A	EACH	1
X4240420	PORTLAND CEMENT CONCRETE SIDEWALK 4 INCH (SPECIAL)	SQFT	5752
X7010216	TRAFFIC CONTROL AND PROTECTION, (SPECIAL)	LSUM	1
Z0013798	CONSTRUCTION LAYOUT	LSUM	1

= 7	HERMANN & Associatos, LLC
	Civil Engineers

USER HAME = jessica	DESIGNED	_	MHS	REVISED	-	4/29/2024
	DRAWN	-	MHS	REVISED	-	
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PLOT DATE = 4/29/2024	DATE	-	3/15/2024	REVISED	~	

GROVELAND ST AND ELEANOR CT SUMMARY OF QUANTITIES							SECTION		COUNTY	TOTAL SHEETS	SHEET NO.
							22-00049-00-SW		TAZEWELL	11	3
									CONTRACT	NO. 898	61
CALE:	SHEET	OF	SHEETS	STA.	TO STA.		ILUNOIS FED. AID PROJECT				

SODI	25200100			
LOCA	AREA			
STATION	то	STATION	RT/LT	SQ YD
13+08.11	TO	16+12.15	RT	40.4
16+62.32	TO	17+73.04	RT	15.4
50+43.49	TO	52+40.30	RT	135.8
55+53.28	ТО	56+18.09	LT	47.4
56+36.64	TO	57+01.18	RT	47.9
58+96.23	TO	59+06.72	RT	6.7
59+18.68	TO	59+68.58	RT	34.4
59+42.51	TO	61+30.16	LT	131.2
61+09.41	TO	61+24.66	RT	46.5
	LOCA STATION 13+08.11 16+62.32 50+43.49 55+53.28 56+36.64 58+96.23 59+18.68 59+42.51	13+08.11 TO 16+62.32 TO 50+43.49 TO 55+53.28 TO 56+36.64 TO 58+96.23 TO 59+18.68 TO 59+42.51 TO	LOCATION STATION TO STATION 13+08.11 TO 16+12.15 16+62.32 TO 17+73.04 50+43.49 TO 52+40.30 55+53.28 TO 57+01.18 58+96.23 TO 59+06.72 59+18.68 TO 59+68.58 59+42.51 TO 61+30.16	LOCATION STATION TO STATION RT/LT 13+08.11 TO 16+12.15 RT 16+62.32 TO 17+73.04 RT 50+43.49 TO 52+40.30 RT 55+53.28 TO 56+18.09 LT 56+36.64 TO 57+01.18 RT 59+06.23 TO 59+06.72 RT 59+18.68 TO 59+68.58 RT 59+42.51 TO 61+30.16 LT

	SIDEWALK	X4240420	35101600			
	LOCA	PCC SIDEWALK 4" (SPECIAL)	AGG BASE COURSE, TY B, 4"			
					AREA	AREA
ALIGNMENT	STATION	то	STATION	RT/LT	SQ FT	SQ YD
GROVELAND ST	13+08.11	TO	16+12.15	RT	1818.5	184.6
SKOVELAND ST	16+62.32	TO	17+73.04	RT	658.2	67.0
	50+43.49	TO	52+40.30	RT	954.7	106.1
	55+53.28	TO	56+18.09	LT	324.0	36.0
	56+36.74	TO	57+01.18	RT	322.0	35.8
ELEANOR CT	58+96.23	TO	59+06.72	RT	52.5	5.8
	59+18.68	TO	59+68.58	RT	249.5	27.7
	59+42.51	TO	61+30.16	LT	965.3	107.3
	61+09.41	TO	61+24.66	RT	406.3	45.1
				TOTAL	5752	616

DETECTABLE WARNINGS	42400800	SIDEWALK REMOVAL						44000600
LOCATION	AREA		ALIGNMENT	STATION	то	STATION	RT/LT	SQ FT
		GROVELAND ST	13+08.11	TO	16+12.15	RT	1188.8	
	SQ FT		GROVELAND 31	16+62.32	TO	17+73.04	RT	429.6
LEANOR CT NORTH END (LT)	12.2		ELEANOR CT	50+43.49	TO	51+61.42	RT	590.0
LEANOR CT NORTH END (RT)	10.0		LLLANONCI		TO	61+24.66	RT	365.0
TOTAL	23						TOTAL	2574

COMBINATION CONCRETE CURB & GUTTER	44000500	60603800	
LOCATION	COMBINATION CURB AND GUTTER REMOVAL	COMBINATION CONCRETE CURB AND GUTTER, TYPE B-6.12	
	LENGTH	LENGTH	
	FOOT	FOOT	
ELEANOR CT NORTH END (LT)	23.6	23.6	
ELEANOR CT NORTH END (RT)	31.2	31.2	
TOTAL	55	55	

CLASS C PATCHES, TYPE IV, 8 INCH	44201335
LOCATION	AREA
	SQ YD
NORTH END OF ELEANOR CT	45.0
TOTAL	45

RELOCATE SIG	72400500		
L	UNIT		
STATION	OFFSET	RT/LT	EACH
61+25.27	24.13	RT	1.0
		TOTAL	1

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 CHECKED
 JAS

 DATE
 3/15/2024
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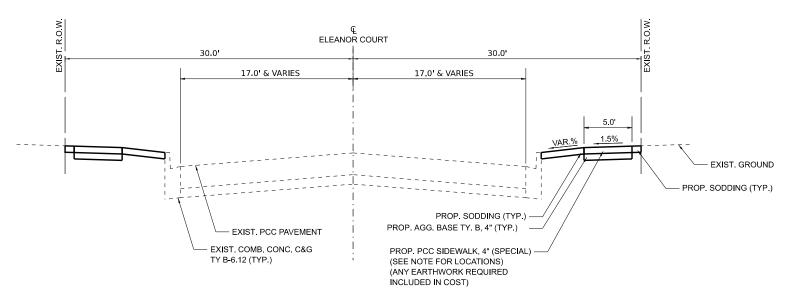
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COUNTY TOTAL SHEET NO.

TAZEWELL 11 4 CONTRACT NO. 89861

ILLINOIS FED. AID PROJECT

	GROVELAND ST AND ELEANOR CT								F.A. RTE	SECTION
STATE OF ILLINOIS	SCHEDULE OF QUANTITIES								22-00049-00-SW	
TMENT OF TRANSPORTATION		3011	LDULL	OF QU	JANI	IIILS				
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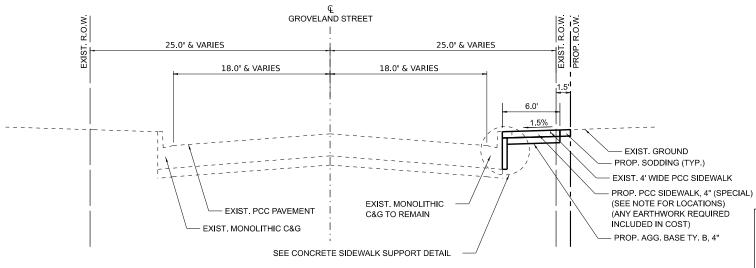


PROPOSED ELEANOR CT TYPICAL SECTION

NOT TO SCALE STA 50+43 TO STA 61+39

NOTE: PROPOSED SIDEWALK LOCATIONS

STA 50+43.49 RT TO 52+40.32 RT STA 55+53.28 LT TO 56+18.09 LT STA 56+36.74 RT TO 57+01.18 RT STA 58+96.23 RT TO 59+06.72 RT STA 59+18.68 RT TO 59+68.58 RT STA 59+42.51 LT TO 61+24.60 LT STA 61+09.41 RT TO 61+23.66 RT



PROPOSED GROVELAND ST TYPICAL SECTION

NOT TO SCALE STA 13+08 TO STA 17+73

NOTE: PROPOSED SIDEWALK LOCATIONS

STA 13+08.36 RT TO 16+12.20 RT STA 16+62.31 RT TO 17+72.97 RT

AGG. BASE COURSE, TY. B, 4" CONTROLLED LOW-STRENGTH MATERIAL
CONCRETE SIDEWALK SUPPORT DETAIL
NOT TO SCALE INCLUDED IN COST OF PCC SIDEWALK, 4" (SPECIAL)


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STATE OF ILLINOIS
DEPARTMENT OF TRANSPORTATION

SCALE:

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GROVELAND ST AND ELEAN	OR CT	F.A. RTE.	SECTION		COUNTY	TOTAL SHEETS	SHEE NO.
TYPICAL SECTIONS			22-00049-00-SW		TAZEWELL	11	5
THIOAE SECTIONS					CONTRACT	NO. 898	61
SHEET 1 OF 1 SHEETS STA+	TO STA+		ILLINOIS	FED. AID	PROJECT		

ects\350_Creve Coeur\350.003.23 SRIS Phase I & II\Drawings\Sheel

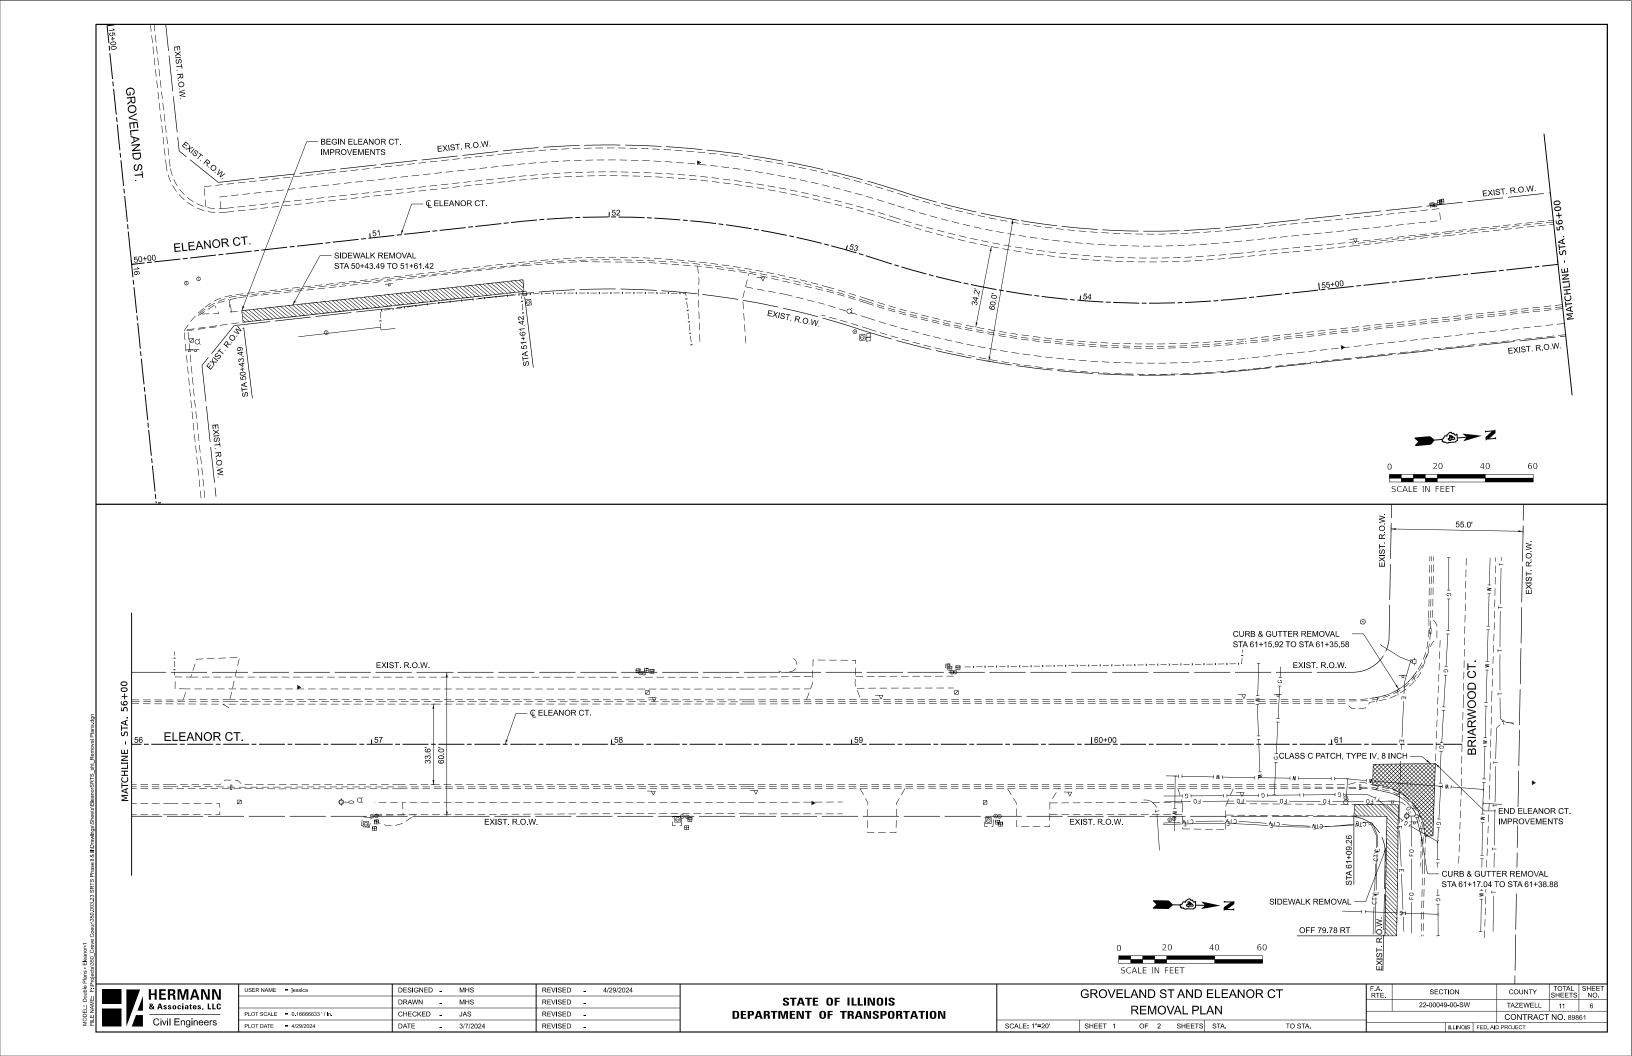

HERMANN
& Associates, LLC
Civil Engineers

USER NAME = jessica	DESIGNED - MHS	REVISED - 4/29/2024
	DRAWN - MHS	REVISED -
PLOT SCALE = 0.16666633 ' / In.	CHECKED - JAS	REVISED -
PLOT DATE = 4/29/2024	DATE - 3/7/2024	REVISED -

STATE OF ILLINOIS
DEPARTMENT OF TRANSPORTATION

GROVELAND ST AND ELEANOR CT
REMOVAL PLAN


SHEET 2 OF 2 SHEETS STA. TO STA.


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F.A. SECTION

22-00049-00-SW


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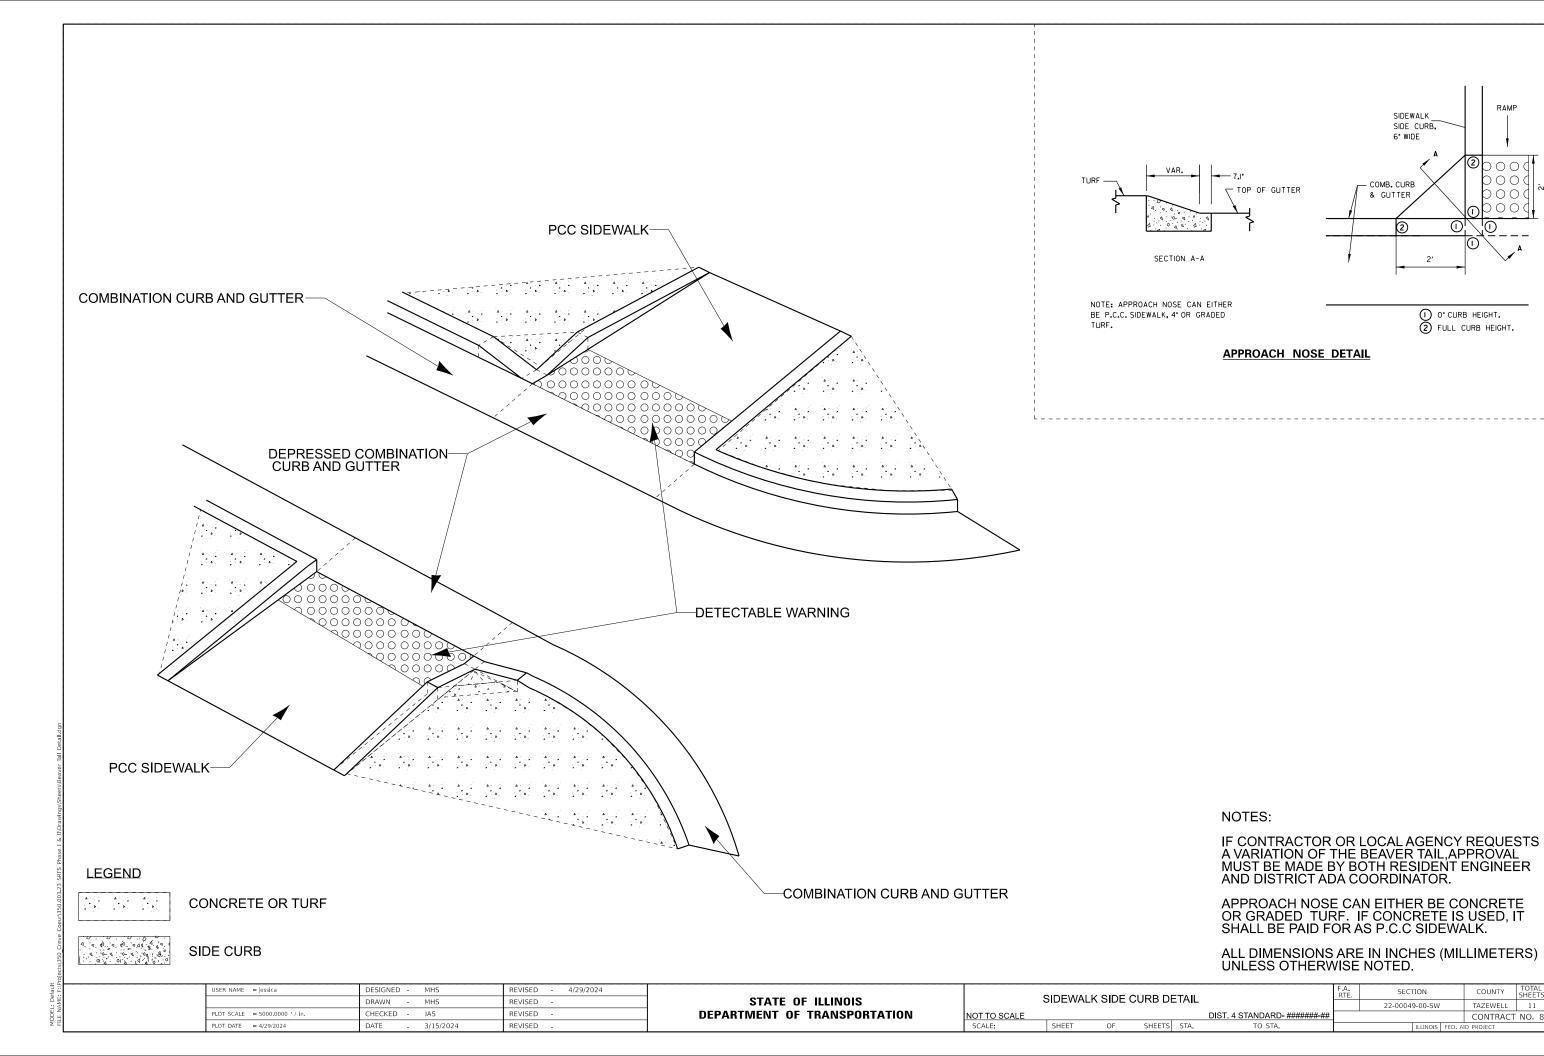


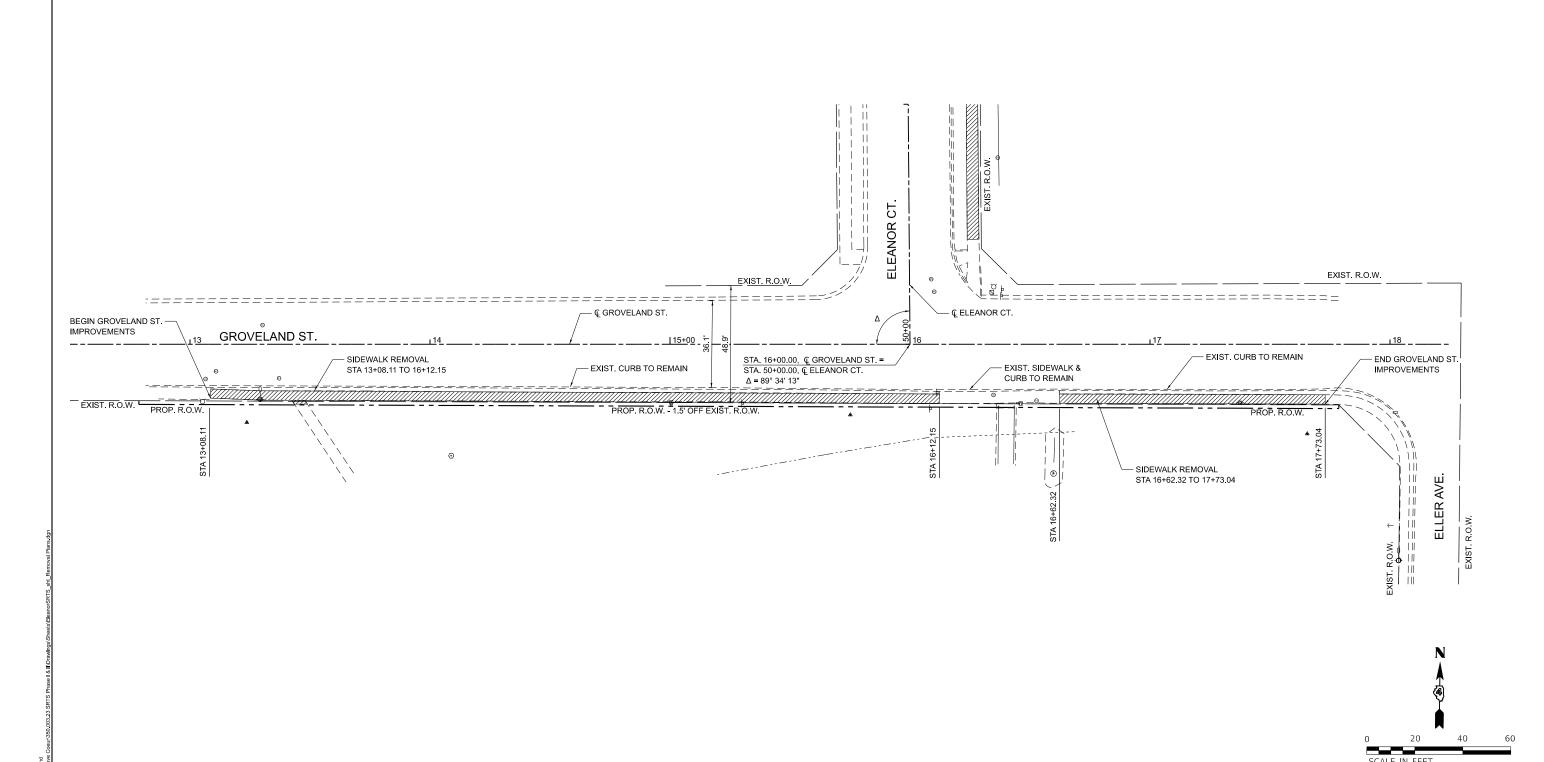

ELEANOR CT. EXIST. R.O.W. € ELEANOR CT. BEGIN GROVELAND ST. IMPROVEMENTS GROVELAND ST. STA. 16+00.00, Q GROVELAND ST. = STA. 50+00.00, Q ELEANOR CT. - EXIST. CURB TO REMAIN – EXIST. UTILITY POLE TO REMAIN (TYP.) EXIST. CURB TO REMAIN - EXIST. SIGN TO REMAIN – END GROVELAND ST. IMPROVEMENTS STA 12+78.69 Δ = 89° 34' 13" OFF 23.56 RT EXIST. R.O.W. PROP. R.O.W. - 1.5' OFF EXIST. R.O.W. PROP ROW STA 12+78.68 OFF 25.06 RT STA 17+78.69 OFF 25.32 RT PCC SIDEWALK, 4", (SPECIAL) STA 13+08.11 TO 16+12.15 └─ CP #2 - CONSTRUCTION STA 17+78.68 CP #0 LIMITS, TYP. PCC SIDEWALK, 4", (SPECIAL) STA 16+62.32 TO 17+73.04 OFF 26.82 RT PARKVIEW MIDDLE SCHOOL 800 GROVELAND ST. 20 COUNTY TOTAL SHEET NO.

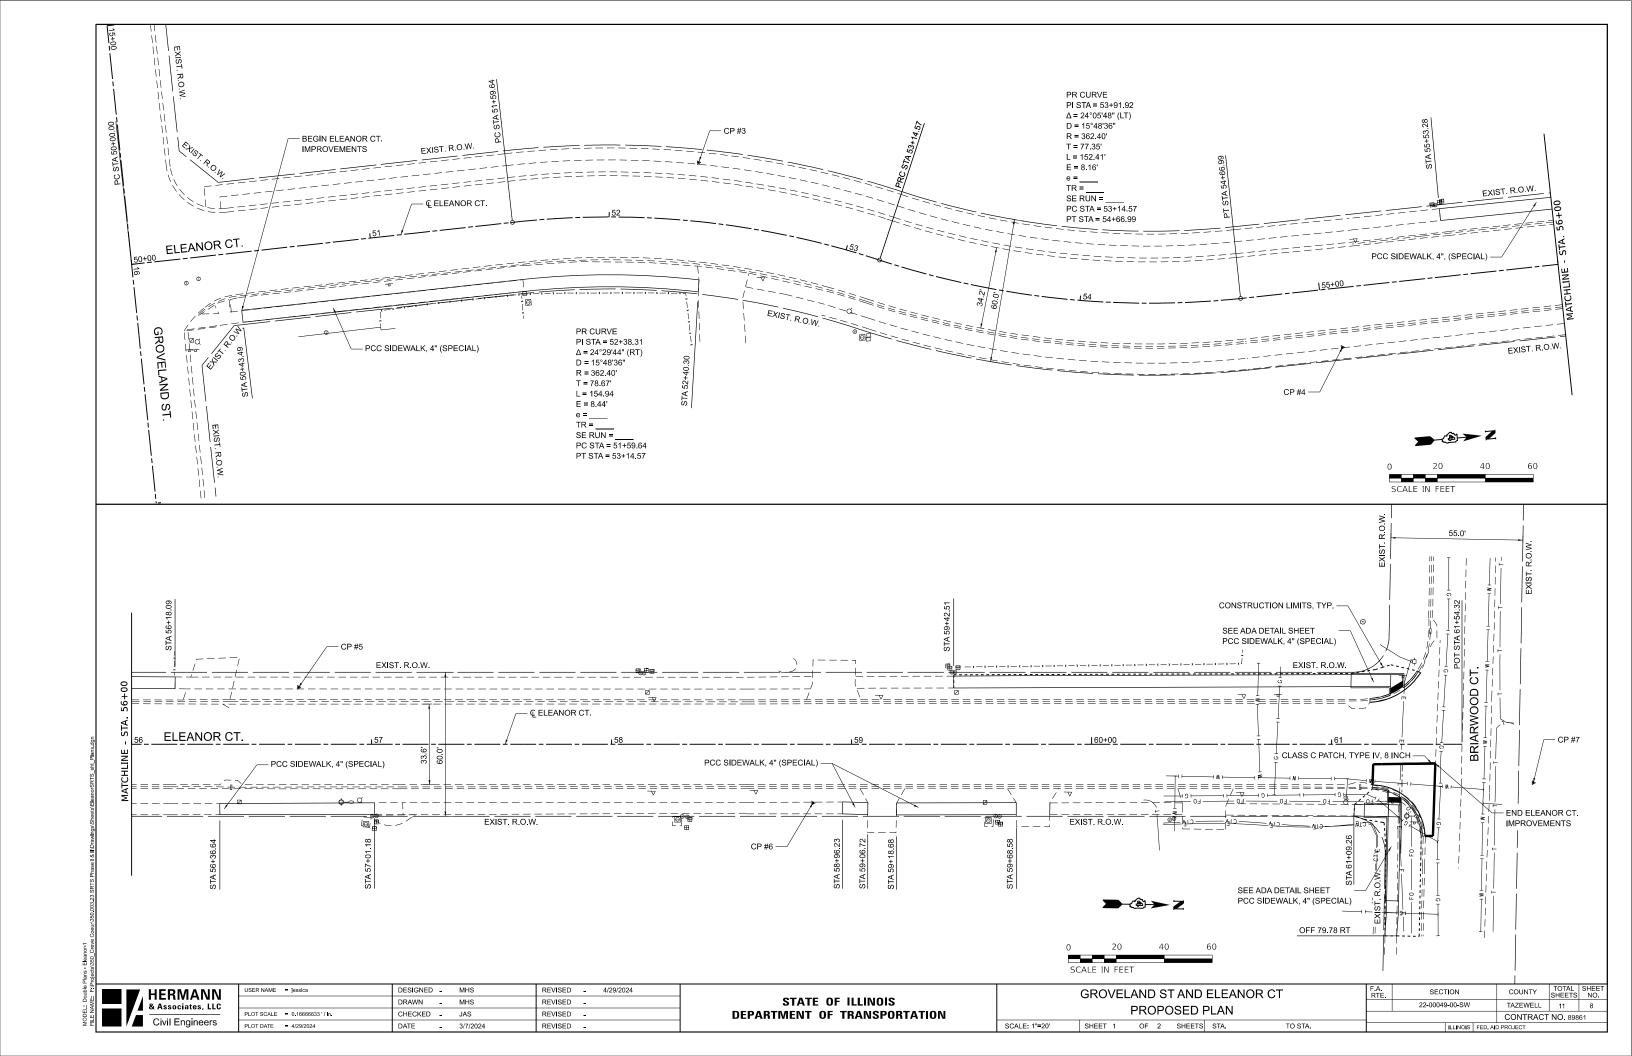TAZEWELL 11 9 DESIGNED MHS REVISED - 4/29/2024 HERMANN & Associates, LLC USER NAME = jessica GROVELAND ST AND ELEANOR CT SECTION REVISED -STATE OF ILLINOIS DRAWN - MHS 22-00049-00-SW PROPOSED PLAN Civil Engineers CHECKED - JAS REVISED -**DEPARTMENT OF TRANSPORTATION** CONTRACT NO. 89861 SCALE: 1"=20' SHEET 2 OF 2 SHEETS STA. PLOT DATE = 4/29/2024 REVISED -



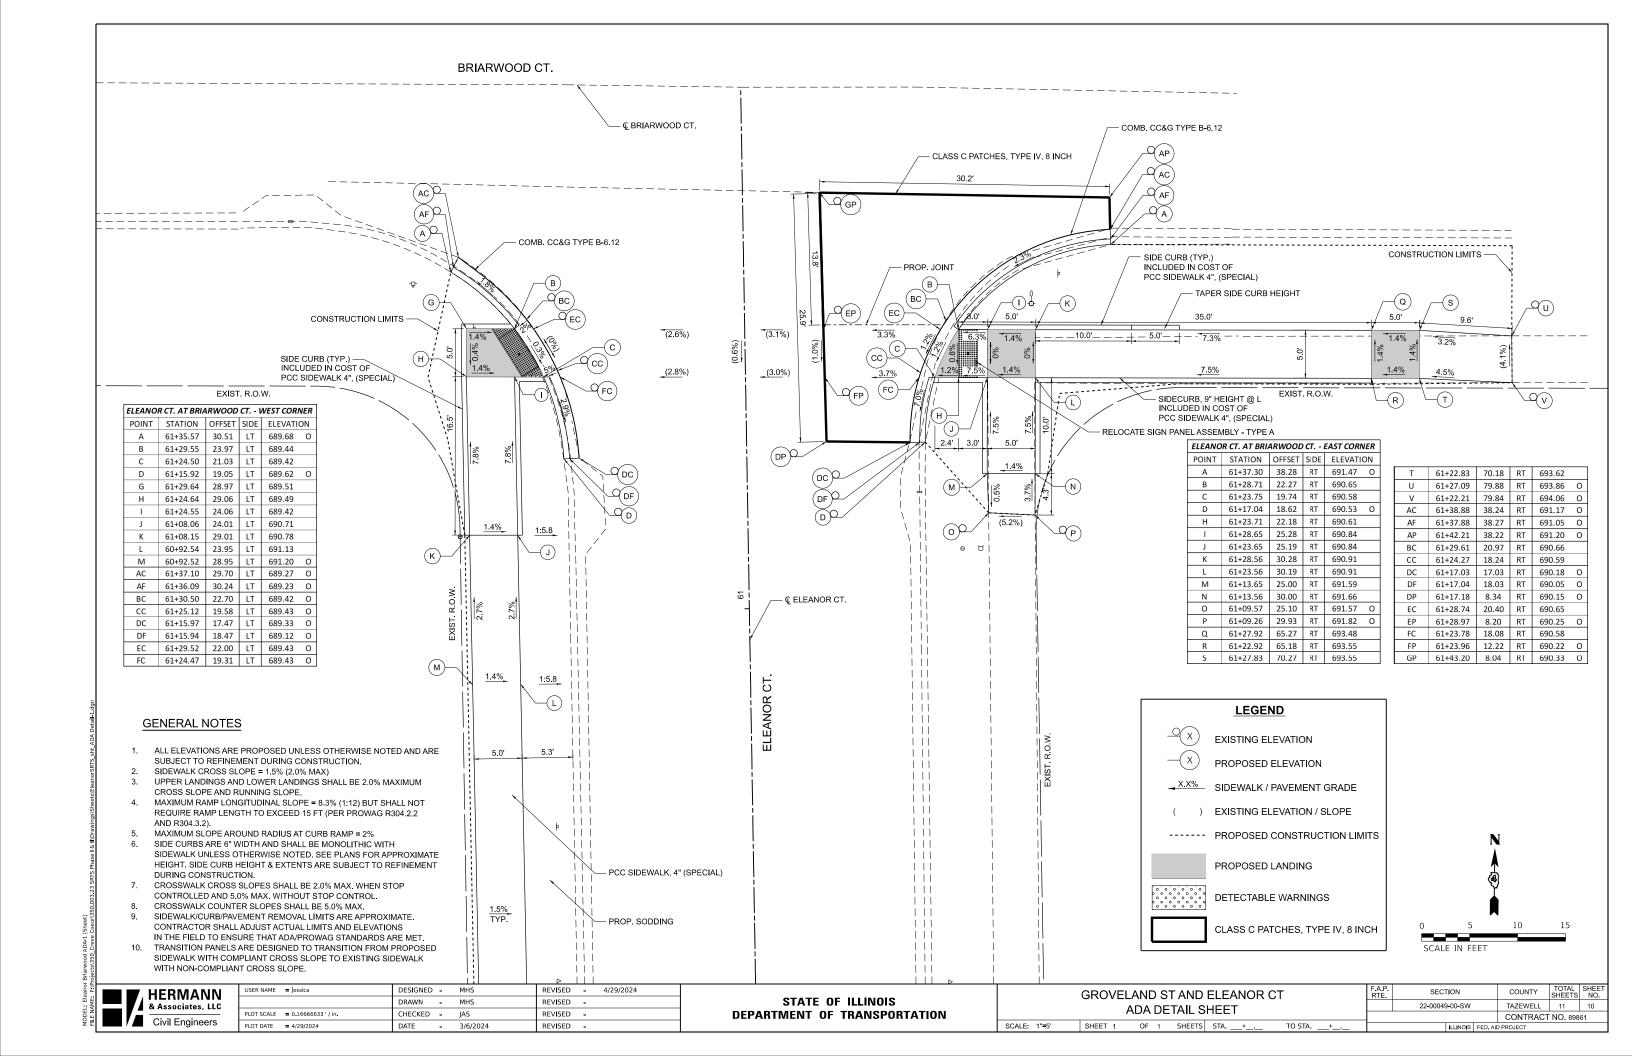

SIDE CURB. 6" WIDE

O" CURB HEIGHT.

FULL CURB HEIGHT.

TAZEWELL 11 11

CONTRACT NO. 89861