

08-03-13 LETTING ITEM 066 STATE OF ILLINOIS INDEX OF SHEETS SHEET NO. DESCRIPTION DEPARTMENT OF TRANSPORTATION TITLE SHEET GENERAL NOTES **DIVISION OF HIGHWAYS** 2 HIGHWAY STANDARDS AND LEGEND 4-5 SUMMARY OF QUANTITIES PLANS FOR PROPOSED EXISTING TYPICAL SECTIONS PROPOSED TYPICAL SECTIONS HORIZONTAL ALIGNMENT LAYOUT AND CONTROL 9-11 REMOVAL PLANS STREET IMPROVEMENTS 12-14 ROADWAY PLANS TRAFFIC CONTROL PLANS 16 INTERSECTION DETAILS 17-18 PAVEMENT MARKING PLANS 19-25 TRAFFIC SIGNAL PLANS ROADWAY LIGHTING PLANS 26-28 MISCELLANEOUS DETAILS 29-31 **CITY OF URBANA CHAMPAIGN COUNTY, ILLINOIS** SECTION: 12-00518-00-TL PROJECT NO. TCSP-IL10(106) TRANSPORTATION, COMMUNITY, AND SYSTEM PRESERVATION PROGRAM **GOODWIN AVENUE - F.A.U. ROUTE 7175** INTERSECTION IMPROVEMENTS AT GREEN STREET **ILLINOIS HIGHWAY STANDARD DRAWINGS** (SEE SHEET NO. 3) END IMPROVEMENTS GOODWIN AVENUE STA. 33+99.00 MAIN ST END IMPROVEMENTS GREEN STREET STA. 503+09.00 SPRINGFIELD AV FAU ROUTE 7175 (GOODWIN AVENUE) = MAJOR COLLECTOR ADT = 6,100 (2013/2033) FAU ROUTE 7126 (GREEN STREET) = MINOR ARTERIAL ADT = 10,900 (2013/2033) LICENSE EXPIRES 11/30/2013 GREEN ST REEN S IGH ST ILLINOIS ST BEGIN IMPROVEMENTS GOODWIN AVENUE STA. 32+04.00 BEGIN IMPROVEMENTS GREEN STREET STA. 497+41.00 and NEVADA ST PROFESSIONAL ENGINEER CLARK DIETZ, INC. FOR SHEETS 1-25 AND 29-31 FULL SIZE PLANS HAVE BEEN PREPARED USING STANDARD

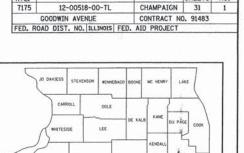



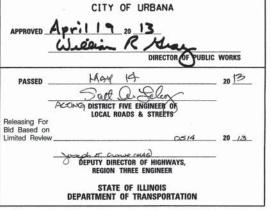

### PRINTED BY THE AUTHORITY OF THE STATE OF ILLINOIS



125 WEST CHURCH STREET CHAMPAIGN, IL 61820 PHONE: 217.373.8900 FAX: 217.373.8923

1-800-892-0123 OR 811

ENGINEERING SCALES. REDUCED SIZED PLANS WILL NOT

ON REDUCED PLANS, THE ABOVE SCALES MAY BE USED.

JOINT UTILITY LOCATION INFORMATION FOR EXCAVATION

CONFORM TO STANDARD SCALES. IN MAKING MEASUREMENTS

0

0

0

0

TOTAL LENGTH OF IMPROVEMENT

LOCATION MAP

SCALE : 1" = 500"

TOTAL LENGTH OF GOODWIN AVENUE IMPROVEMENT = 195 FEET = 0.04 MILES

TOTAL LENGTH OF GREEN STREET IMPROVEMENT = 568 FEET = 0.11 MILES

= 763 FEET = 0.15 MILES

04-18-2013

LICENSE EXPIRES 11-30-2013

Charle Conster

PROFESSIONAL ENGINEER CLARK DIETZ, INC. FOR SHEETS 26-28

DATE: 04/18/20/3 LICENSE EXPIRES 11-30-2013

## **GENERAL NOTES**

- 1. ALL FLEVATIONS SHOWN REFER TO THE N.A.V.D. 1988 DATUM.
- 2. WHEREVER IN THE PLANS OR SPECIFICATIONS THE TERM "STANDARD SPECIFICATIONS" IS USED IT SHALL BE UNDERSTOOD BY THE CONTRACTOR TO MEAN THE "STANDARD SPECIFICATIONS FOR ROAD AND BRIDGE CONSTRUCTION" AS PREPARED BY THE DEPARTMENT OF TRANSPORTATION OF THE STATE OF ILLINOIS AND ADOPTED ON JANUARY 1, 2012.
- 3. WHEREVER IN THE PLANS OR SPECIFICATIONS THE TERMS "STANDARD SPECIFICATIONS FOR WATER MAIN CONSTRUCTION" OR "STANDARD SPECIFICATIONS FOR SEWER CONSTRUCTION" ARE USED IT SHALL BE UNDERSTOOD BY THE CONTRACTOR TO MEAN THE "STANDARD SPECIFICATIONS FOR WATER AND SEWER CONSTRUCTION IN ILLINOIS" AS PREPARED BY ISPE, UCA, APWA, ASCE, AND IML AND ADOPTED IN JULY 2009.
- 4. ANY REFERENCE TO STANDARDS THROUGHOUT THE PLANS SHALL BE INTERPRETED TO BE THE LATEST STANDARDS OF THE DEPARTMENT AS SHOWN ON THE HIGHWAY STANDARDS AND LEGEND SHEET NO. 3.
- 5. IT IS THE CONTRACTOR'S RESPONSIBILITY TO ASCERTAIN EXISTING FIELD CONDITIONS BEFORE BIDDING ON THE PROJECT.
- 6. THE CONTRACTOR SHALL BE REQUIRED TO COMPLY WITH STATE REGULATIONS REGARDING AIR, WATER, AND NOISE POLLUTION.
- 7. THE CONTRACTOR SHALL TAKE CARE NOT TO STORE OR DISPOSE OF DEBRIS OR UNSUITABLE MATERIALS WITHIN THE LIMITS OF THE IMPROVEMENT AND SHALL TAKE CARE TO LIMIT CONSTRUCTION ACTIVITIES TO WITHIN THE RIGHT-OF-WAY AND EASEMENT AREAS, UNNECESSARY ENCROACHMENTS ONTO PRIVATE OR PUBLIC AREAS WILL NOT BE ALLOWED.
- 8. WHERE SECTION OR SUBSECTION MONUMENTS, BENCHMARKS. OR IRON PIPE MONUMENTS ARE ENCOUNTERED. THE ENGINEER SHALL BE NOTIFIED BEFORE WHERE SECTION ON SUBSECTION MONOMENTS, BENCHMARKS, OR TROW FIFE MONOMENTS ARE ENCOUNTERED, THE ENGINEER SHALL BE ROTHER OF THE SECTION SUCH MONUMENTS ARE REMOVED. THE CONTRACTOR SHALL BE RESPONSIBLE FOR HAVING AN ILLINOIS REGISTERED LAND SURVEYOR OR AGENT HAS WITNESSED OR OTHERWISE REFERENCED THEIR LOCATION. THE CONTRACTOR SHALL BE RESPONSIBLE FOR HAVING AN ILLINOIS REGISTERED LAND SURVEYOR REESTABLISH ANY MONUMENTS UNNECESSARILY DESTROYED BY HIS OR HER OPERATIONS. THIS WORK WILL NOT BE PAID FOR SEPARATELY BUT SHALL BE INCLUDED IN THE COST OF CONSTRUCTION LAYOUT, AND NO ADDITIONAL COMPENSATION WILL BE ALLOWED.
- 9. ALL STREET RETURNS HAVE RADII DESIGNATED TO THE EDGE OF PAVEMENT UNLESS OTHERWISE NOTED ON THE PLANS.
- 10. THE EXCAVATION FOR THIS PROJECT IS CLASSIFIED AS EARTH EXCAVATION IN ACCORDANCE WITH SECTION 202 OF THE STANDARD SPECIFICATIONS AND AS PROVIDED IN THE SPECIAL PROVISIONS, THE EARTH EXCAVATION SHALL INCLUDE THE REMOVAL OF EARTH AND UNCLASSIFIED MATERIALS. THE CONTRACTOR SHALL NOTIFY
  ALL UTILITY COMPANIES AND AGENCIES PRIOR TO EXCAVATION OPERATIONS, EARTH EXCAVATION WILL NOT BE MEASURED FOR PAYMENT BUT SHALL BE INCLUDED IN THE COST OF THE SPECIFIC CONSTRUCTION PAY ITEM REQUIRING THE EXCAVATION, AND NO ADDITIONAL COMPENSATION WILL BE ALLOWED. THE REMAINING EXCAVATION IS CLASSIFIED AS PAVEMENT REMOVAL, COMBINATION CURB AND GUTTER REMOVAL, SIDEWALK REMOVAL, AND RETAINING WALL REMOVAL.
- 11. IT MAY BE NECESSARY TO UNDERCUT AND REMOVE EARTH AND ORGANIC MATERIAL AT LOCATIONS DETERMINED BY THE ENGINEER, ALL UNSTABLE, UNSUITABLE, OR ORGANIC MATERIAL SHALL BE DISPOSED OF OFF THE SITE AS DIRECTED BY THE ENGINEER. THIS WORK SHALL BE MEASURED AND PAID FOR AS REMOVAL AND DISPOSAL OF UNSUITABLE MATERIAL. SEE THE "SUBGRADE REMOVAL AND REPLACEMENT DETAIL" AND THE SPECIAL PROVISIONS FOR ADDITIONAL INFORMATION.
- 12. TREES TO BE REMOVED: THE INDICATED TREES (INCLUDING STUMPS) TO BE REMOVED WILL BE SUITABLY MARKED BY THE ENGINEER BEFORE TREE REMOVAL OPERATIONS BEGIN. ALL TREES, STUMPS, AND ROOTS SHALL BE COMPLETELY REMOVED AND DISPOSED OF. THIS WORK SHALL BE INCLUDED IN THE COST OF THE TREE REMOVAL AND NO ADDITIONAL COMPENSATION WILL BE ALLOWED. NO TREE SHALL BE REMOVED WITHOUT DIRECTION FROM THE ENGINEER TO DO SO.
- 13. TREES TO BE SAVED: PARTICULAR EFFORT SHALL BE MADE TO SAVE ALL EXISTING DESIRABLE TREES OR SHRUBS. ONLY A MINIMUM OF GRADING WILL BE PERMITTED AROUND TREES AS DETERMINED BY THE ENGINEER. THE CONTRACTOR SHALL BE HELD RESPONSIBLE FOR UNNECESSARY DAMAGE TO TREES, SHRUBS, OR LANDSCAPING INTENDED TO BE SAVED, AND ANY ITEMS DAMAGED BY THE CONTRACTOR SHALL BE REPLACED IN-KIND AS DIRECTED BY THE ENGINEER AND
- 14. TREES TO BE PRUNED: TREE PRUNING WILL BE PERFORMED BY THE CITY OF URBANA, THE CONTRACTOR SHALL NOTIFY THE CITY OF URBANA OF TREES THAT WILL REQUIRE PRUNING A MINIMUM OF 48 HOURS IN ADVANCE OF THE WORK.
- 15. THE EXISTING TRAFFIC SIGNS AND POSTS WHICH INTERFERE WITH THE CONSTRUCTION SHALL BE REMOVED AND RESET, AS THE CASE MAY BE, AS DIRECTED BY THE ENGINEER. THIS WORK SHALL BE PERFORMED IN ACCORDANCE WITH ARTICLE 107.25 OF THE STANDARD SPECIFICATIONS. EXISTING SIGNS THAT WILL NOT BE RESET SHALL BE RETURNED TO THE CITY OF JUBBANA'S PUBLIC WORKS GARAGE AT 706 SOUTH GLOVER AVENUE, REFER TO THE SPECIAL PROVISION FOR "TRAFFIC CONTROL AND PROTECTION (SPECIAL)" FOR ADDITIONAL INFORMATION ON REMOVING AND RESETTING THE EXISTING TRAFFIC SIGNS AND POSTS, REMOVING AND RESETTING THE EXISTING TRAFFIC SIGNS AND POSTS WILL NOT BE MEASURED FOR PAYMENT BUT SHALL BE INCLUDED IN THE COST OF THE VARIOUS REMOVAL PAY ITEMS, AND NO ADDITIONAL COMPENSATION WILL BE ALLOWED.
- 16. ONLY EXISTING PAVEMENTS AND BASE COURSES COMPOSED OF PORTLAND CEMENT CONCRETE, HOT-MIX ASPHALT, OR BRICK SHALL BE MEASURED AND PAID FOR AS PAVEMENT REMOVAL IN ACCORDANCE WITH SECTION 440 OF THE STANDARD SPECIFICATIONS. NO ADDITIONAL COMPENSATION WILL BE ALLOWED FOR PAVEMENT REMOVAL ITEMS DUE TO VARIATIONS IN THE EXISTING PAVEMENT TYPE, THICKNESS, OR AMOUNT OF REINFORCEMENT. THE ADJUSTMENT OF QUANTITIES AS SPECIFIED IN ARTICLE 440.07 OF THE STANDARD SPECIFICATIONS SHALL NOT APPLY. REMOVAL OF OTHER TYPES OF PAVEMENT COMPOSITION SUCH AS AGGREGATE OR OIL AND CHIP SHALL BE CLASSIFIED AS EARTH EXCAVATION.
- 17. THE FINISHED EARTHWORK SHALL HAVE VEGETATIVE SUSTAINING SOIL COVERING THE TOP 6 INCHES IN AREAS TO BE SEEDED OR SODDED. THE TOPSOIL REQUIRED WILL OT BE PAID FOR SEPARATELY BUT SHALL BE INCLUDED IN THE COST OF SEEDING (COMPLETE) OR SODDING, AND NO ADDITIONAL COMPENSATION WILL BE ALLOWED.
- 18. ALL DISTURBED AREAS SHALL BE SEEDED OR SODDED AS SHOWN ON THE PLANS. SEEDING OR SODDING SHALL BE DONE AS SOON AS EACH CONSTRUCTION STAGE IS COMPLETE AS DIRECTED BY THE ENGINEER. EXISTING TURF WHICH IS DAMAGED OUTSIDE THE LIMITS OF RIGHT-OF-WAY, EASEMENTS, OR GRADING SHALL BE REESTABLISHED WITH SOD AS DIRECTED BY THE ENGINEER AT THE CONTRACTOR'S EXPENSE.
- 19. THE ENGINEER SHALL BE THE SOLE JUDGE CONCERNING CURING TIME FOR THE VARIOUS HOT-MIX ASPHALT LIFTS.

20. THE FOLLOWING RATES OF APPLICATION HAVE BEEN ASSUMED IN CALCULATING PLAN QUANTITIES: BITUMINOUS PRIME COAT - PAVED SURFACE
BITUMINOUS PRIME COAT - AGGREGATE BASE
AGGREGATE PRIME COAT - PAVED SURFACE 0.05 TO 0.10 GAL/SQ YD 0.25 TO 0.50 GAL/SQ YD 2 TO 4 LBS/SO YD 112 LBS/SQ YD/INCH THICK 2.05 TON/CU YD AGGREGATE MATERIALS

- 21. UTILITY LOCATIONS WERE PLOTTED FROM INFORMATION FURNISHED BY THE VARIOUS UTILITY COMPANIES, AND THEIR ACCURACY SHOULD BE CONSIDERED APPROXIMATE. NO RESPONSIBILITY IS ACCEPTED FOR THE UTILITY LOCATIONS AS SHOWN OR THAT ALL UTILITY FACILITIES ARE SHOWN. THE UTILITY LOCATIONS FROM IN THE PLANS ARE APPROXIMATE AND REPRESENT LOCATIONS PRIOR TO ANY UTILITY RELOCATIONS REQUIRED TO ACCOMMODATE THE PROPOSED CONSTRUCTION. THE CONTRACTOR IS ADVISED THAT SOME UTILITY COMPANIES MAY HAVE RELOCATED THEIR FACILITIES PRIOR TO THE START OF CONSTRUCTION UNDER THIS CONTRACT. BEFORE COMMENCING CONSTRUCTION OPERATIONS, THE CONTRACTOR SHALL OBTAIN FROM THE ENGINEER ANY AVAILABLE INFORMATION REGARDING THE RELOCATED POSITIONS OF UTILITIES WITHIN THE PROJECT LIMITS, WHETHER VARIOUS UTILITIES HAVE BEEN RELOCATED OR REMAIN IN THEIR ORIGINAL LOCATION, IT SHALL BE THE RESPONSIBILITY OF THE CONTRACTOR TO DETERMINE THEIR EXACT LOCATION AT THE TIME OF CONSTRUCTION AND TO PROTECT SAME. THE CONTRACTOR SHALL ALSO BE RESPONSIBLE FOR AVOIDING CONFLICTS BETWEEN OVERHEAD UTILITY LINES AND THE EQUIPMENT USED DURING CONSTRUCTION, REFER TO THE "STATUS OF UTILITIES" SHEET WITHIN THE SPECIAL PROVISIONS FOR ADDITIONAL INFORMATION RECARDING KNOWN UTILITY RELOCATIONS OR ADJUSTMENTS REQUIRED FOR THE PROPOSED CONSTRUCTION. THE CONTRACTOR'S ATTENTION IS DIRECTED TO THE SPECIAL PROVISION ENTITLED "COOPERATION WITH UTILITIES" AND ARTICLE 107.31 OF THE STANDARD SPECIFICATIONS.
- 22. THE CONTRACTOR SHALL COORDINATE CONSTRUCTION ACTIVITIES WITH THE UTILITY COMPANIES.
- 23. THE CONTRACTOR SHALL BE RESPONSIBLE FOR PROTECTING UTILITY PROPERTY FROM CONSTRUCTION OPERATIONS AS OUTLINED IN ARTICLE 107.31 OF THE STANDARD SPECIFICATIONS. THE JULIE NUMBER IS 800-892-0123.
- 24. LITTLITY OWNERS: INDICATES J.U.L.I.E. MEMBER

\* AMEREN TP 1112 WEST ANTHONY DRIVE (217) 383-7280

201 DEVONSHIRE DRIVE

CHAMPAIGN, ILLINOIS 61820

\* COMCAST 303 FAIRLAWN DRIVE URBANA, ILLINOIS 618 ANA, ILLINOIS 61801 (217) 383-8031

706 SOUTH GLOVER AVENUE URBANA, ILLINOIS 61802 (217) 384-2385

\* UNIVERSITY OF ILLINOIS FACILITIES AND SERVICES 1501 SOUTH OAK STREET CHAMPAIGN, ILLINOIS 61820 (217) 333-0340

URBANA, ILLINOIS 61803

(217) 367-3409

AND EDUCATIONAL SERVICES
DIGITAL COMPUTER LABORATORY 1304 WEST SPRINGFIELD AVENUE URBANA, ILLINOIS 61801 \* URBANA & CHAMPAIGN SANITARY DISTRICT (217) 333-1637 1100 EAST UNIVERSITY AVENUE

UNIVERSITY OF ILLINOIS

CAMPUS INFORMATION TECHNOLOGIES

- 25. ABANDONED UNDERGROUND UTILITIES THAT CONFLICT WITH CONSTRUCTION SHALL BE REMOVED AND DISPOSED OF OUTSIDE THE LIMITS OF THE RIGHT-OF-WAY ACCORDING TO ARTICLE 202,03 OF THE STANDARD SPECIFICATIONS AND AS APPROVED BY THE ENGINEER, THIS WORK WILL NOT BE PAID FOR SEPARATELY BUT SHALL BE INCLUDED IN THE COST OF THE VARIOUS REMOVAL PAY ITEMS, AND NO ADDITIONAL COMPENSATION WILL BE ALLOWED.
- 26. ALL SALVAGEABLE FRAMES AND GRATES WHICH ARE NOT INCORPORATED IN THE WORK SHALL BECOME THE PROPERTY OF THE CONTRACTOR. THE CONTRACTOR'S BID PRICE THE VARIOUS STORM DRAINAGE WORK SHOULD REFLECT THE SALVAGE VALUE OF THE ITEMS.
- 27. ALL TRENCHES AND EXCAVATIONS FOR DRAINAGE PIPES, STRUCTURES, OR STRUCTURE REMOVALS BELOW OR WITHIN TWO FEET LATERALLY OF THE PROPOSED PAVEMENT. SIDEWALK, OR CURB AND GUTTER SHALL BE BACKFILLED WITH CONTROLLED LOW-STRENGTH MATERIAL (CLSM) AS SHOWN ON THE PLANS AND IN ACCORDANCE WITH
  SECTION 593 OF THE STANDARD SPECIFICATIONS AND THE DETAIL IN THE PLANS. THE BACKFILLING WITH CONTROLLED LOW-STRENGTH MATERIAL AROUND DRAINAGE
  STRUCTURES WILL NOT BE PAID FOR SEPARATELY BUT SHALL BE INCLUDED IN THE COST OF THE VARIOUS DRAINAGE STRUCTURE PAY ITEMS, AND NO ADDITIONAL COMPENSATION WILL BE ALLOWED.
- 28. STORM SEWER, WATER MAIN QUALITY SHALL BE USED AT LOCATIONS WHERE LATERAL SEPARATION BETWEEN THE SEWER AND WATER MAIN IS LESS THAN 10 FEET, OR WHERE THE WATER MAIN CROSSES BELOW THE SEWER, REGARDLESS OF VERTICAL SEPARATION, OR WHERE THE BOTTOM OF THE WATER MAIN IS LESS THAN 18 INCHES ABOVE THE TOP OF THE SEWER, THE MATERIAL SHALL BE CONCRETE PRESSURE PIPE OR DUCTILE IRON PIPE MEETING THE REQUIREMENTS OF SECTIONS 40-2.01, 40-2.02, AND 40-2.05 OF THE STANDARD SPECIFICATIONS FOR WATER AND SEWER CONSTRUCTION IN ILLINOIS. PVC PIPE WILL NOT BE ALLOWED.
- 29. THE TOP-OF-FRAME ELEVATIONS REFERRED TO IN THE DRAINAGE STRUCTURE CALL-OUTS FOR A TYPE 1 FRAME AND LID ARE TAKEN ADJACENT TO THE PAVEMENT OR GROUND SURFACE
- 30. THE TOP-OF-FRAME ELEVATIONS REFERRED TO IN THE DRAINAGE STRUCTURE CALL-OUTS FOR A TYPE 11 FRAME AND GRATE PLACED WITHIN TYPE B-6.12 CURB AND GUTTER ARE TAKEN ALONG THE EDGE OF FRAME WHICH IS COLINEAR WITH THE EDGE OF PAVEMENT. THIS FRAME ELEVATION IS 1/4" LOWER THAN THE ADJACENT EDGE OF PAVEMENT ELEVATION FOR ASPHALT PAVEMENTS. THE TYPE 11 FRAMES AND GRATES SHALL BE PROVIDED WITH OPEN FACE CURB BOXES AS DESCRIBED IN THE SPECIAL PROVISIONS. SEE THE "TYPE 11 FRAME AND GRATE DETAIL" FOR ADDITIONAL INFORMATION.
- 31. WHEN CONNECTIONS ARE TO BE MADE TO EXISTING PIPING AND STRUCTURES, THE LOCATION AND ELEVATION OF THE EXISTING PIPING SHALL BE FIELD VERIFIED AND NOTIFICATION GIVEN TO THE ENGINEER IF THE EXISTING PIPING IS FOUND TO BE DIFFERENT THAN THAT SHOWN ON THE PLANS, WHERE SUCH DISCREPANCY IS FOUND, WORK SHALL NOT PROCEED UNTIL DIRECTED ACCORDINGLY BY THE ENGINEER.
- 32. WHERE PROPOSED SEWERS ARE TO BE CONNECTED INTO EXISTING MANHOLES OR EXISTING SEWERS, THE CONNECTIONS SHALL BE MADE IN A WORKMANLIKE MANNER, AND MASONRY SHALL BE CONSTRUCTED AROUND THEM TO PREVENT LEAKAGE. CONNECTIONS OF PROPOSED SEWERS TO EXISTING STRUCTURES SHALL BE MADE BY CORE DRILLING HOLES IN THE STRUCTURES. THE COST OF MAKING ANY SEWER CONNECTIONS TO AN EXISTING STRUCTURE OR PIPE SHALL BE INCLUDED IN THE COST OF THE NEW SEWER, AND NO ADDITIONAL COMPENSATION WILL BE ALLOWED.
- 33. THE EXISTING SEWERS TO BE REMOVED FOR THE PROPOSED IMPROVEMENTS SHALL BE REMOVED IN ACCORDANCE WITH SECTION 551 OF THE STANDARD SPECIFICATIONS EXCEPT THAT SALVAGING OF THE PIPE WILL NOT BE REQUIRED, EXISTING PIPES SHALL BE PLUGGED AT THE LOCATIONS SHOWN ON THE PLANS IN ACCORDANCE WITH THE SPECIAL PROVISIONS AND AS DIRECTED BY THE ENGINEER.
- 34. EXISTING PAVEMENTS, CURBS AND GUTTERS, AND SIDEWALKS IN WHICH THE TOP SURFACE IS TO BE JOINED TO THE PROPOSED WORK SHALL BE SO JOINED THROUGH SAW CUT JUNCTURES, 3/4" EXPANSION JOINT MATERIAL SHALL BE PLACED AT THESE JUNCTURES AS DIRECTED BY THE ENGINEER. THIS WORK SHALL BE INCLUDED IN THE COST OF THE PROPOSED PAVEMENT, CURB AND GUTTER, OR SIDEWALK, AND NO ADDITIONAL COMPENSATION WILL BE ALLOWED.
- 35. WHERE THE PROPOSED COMBINATION CONCRETE CURB AND GUTTER JOINS THE EXISTING CURB AND GUTTER, A TRANSITION BETWEEN THE TWO CONFIGURATIONS MAY BE REQUIRED. THIS WORK SHALL BE INCLUDED IN THE COST OF THE PROPOSED CURB AND GUTTER, AND NO ADDITIONAL COMPENSATION WILL BE ALLOWED.
- 36. THE CONTRACTOR SHALL PROVIDE AND INSTALL TWO WEIGHTED SAND BAGS ON EACH TYPE II BARRICADE USED (ONE WEIGHTED SAND BAG ACROSS EACH BOTTOM RAIL).
- 37, FOR STABILIZATION, ALL TYPE III BARRICADES SHALL REQUIRE A MINIMUM OF FOUR SAND BAGS PER BARRICADE.
- 38. HORIZONTAL CONTROL TIES ARE SHOWN FOR THE CONTRACTOR TO PHYSICALLY LOCATE MONUMENTATION IN THE FIELD. IT IS THE CONTRACTOR'S RESPONSIBILITY TO MAINTAIN CONTROL POINTS OR TO USE ADDITIONAL TIES AS NECESSARY TO INSURE THAT CONTROL POINTS CAN BE ACCURATELY REPLICATED DURING CONSTRUCTION.
- 39. THE CITY OF URBANA WILL BE RESPONSIBLE FOR NOTIFYING THE PUBLIC, THE UNITED STATES POSTAL SERVICE, THE CHAMPAIGN-URBANA MASS TRANSIT DISTRICT, THE EMERGENCY SERVICE AGENCIES, AND THE UNIVERSITY OF ILLINOIS OF ALL ROAD CLOSURES AND CHANGES IN THE TRAFFIC CONTROL PLANS. THE CONTRACTOR SHALL NOTIFY THE CITY OF URBANA OF ALL ROAD CLOSURES AND CHANGES IN THE TRAFFIC CONTROL PLANS A MINIMUM OF 48 HOURS IN ADVANCE OF THE WORK.
- 40. THE CONTRACTOR SHALL BE RESPONSIBLE FOR CLEANUP OF THE SITE PRIOR TO FINAL ACCEPTANCE IN ACCORDANCE WITH ARTICLE 104.06 OF THE STANDARD SPECIFICATIONS. THIS WORK SHALL ALSO INCLUDE CLEANING ALL DRAINAGE FACILITIES OF FOREIGN MATERIALS IN ACCORDANCE WITH ARTICLE 602.15 OF THE STANDARD SPECIFICATIONS. THIS WORK SHALL BE PERFORMED AS DIRECTED BY THE ENGINEER, AND NO ADDITIONAL COMPENSATION WILL BE ALLOWED.
- 41. PARKING METER REMOVAL WILL BE PERFORMED BY THE CITY OF URBANA, THE CONTRACTOR SHALL CONTACT THE CITY OF URBANA FOR REMOVAL OF THE PARKING METERS. THE CONTRACTOR SHALL REMOVE AND DISPOSE OF THE PARKING METER POSTS AT THE LOCATIONS SHOWN ON THE PLANS, EXISTING PARKING METER POSTS THAT ARE REMOVED SHALL NOT BE REUSED. THE CONTRACTOR SHALL INSTALL NEW PARKING METER POSTS AT THE LOCATIONS SHOWN ON THE PLANS, THE CITY OF URBANA WILL FURNISH AND INSTALL THE NEW PARKING METERS.
- 42. ALL OPEN TRENCHES OR EXCAVATIONS SHALL BE PROTECTED BY THE CONTRACTOR USING A METHOD APPROVED BY THE ENGINEER, THIS WORK WILL NOT BE PAID FOR SEPARATELY BUT SHALL BE INCLUDED IN THE COST OF THE VARIOUS REMOVAL PAY ITEMS, AND NO ADDITIONAL COMPENSATION WILL BE ALLOWED. THE CONTRACTOR SHALL MAINTAIN PEDESTRIAN ACCESS TO ALL BUILDINGS WITHIN THE PROJECT LIMITS AT ALL TIMES DURING CONSTRUCTION.
- 43. THE HORIZONTAL COORDINATE SYSTEM IS BASED ON A GPS CALIBRATION OF CITY OF URBANA HORIZONTAL CONTROL POINTS.
- 44. IN SOME AREAS, WORK IS TO BE PERFORMED OUTSIDE OF THE RIGHT-OF-WAY BUT TEMPORARY CONSTRUCTION EASEMENTS ARE NOT SHOWN. IN THESE AREAS THE ADJACENT PROPERTY IS OWNED BY THE UNIVERSITY OF ILLINOIS. THE CITY OF URBANA AND THE UNIVERSITY OF ILLINOIS HAVE AN AGREEMENT TO ALLOW WORK TO BE PERFORMED ON UNIVERSITY PROPERTY FOR THIS PROJECT, THE CONTRACTOR SHALL USE REASONABLE CARE TO AVOID DISTURBING PORTIONS OF THE UNIVERSITY'S PROPERTY NOT NECESSARY TO THE CONSTRUCTION OPERATIONS. IF, IN THE JUDGMENT OF THE ENGINEER, AREAS ARE DISTURBED UNNECESSARILY, THE CONTRACTOR SHALL RESTORE THESE AREAS AT HIS/HER OWN EXPENSE.

#### EROSION CONTROL GENERAL NOTES

- 1. THE TEMPORARY EROSION CONTROL SYSTEMS SHALL BE INSTALLED AND MAINTAINED BY THE CONTRACTOR AT THE LOCATIONS SHOWN ON THE ROADWAY PLANS AND AS DIRECTED BY THE ENGINEER. INLET FILTERS SHALL BE PLACED AT ALL DRAINAGE STRUCTURES WITH OPEN LIDS OR GRATES THAT ARE WITHIN PAVED AREAS. THIS WORK SHALL BE PERFORMED IN ACCORDANCE WITH STANDARD 280001 AND SECTION 280 OF THE STANDARD SPECIFICATIONS.
- ADDITIONAL TEMPORARY EROSION CONTROL SYSTEMS MAY BE REQUIRED DURING CONSTRUCTION. THE SYSTEMS SHALL BE PLACED AS DIRECTED BY THE ENGINEER AND WILL BE PAID FOR IN ACCORDANCE WITH SECTION 280 OF THE STANDARD SPECIFICATIONS.
- 3. SEEDING AND SODDING OF DISTURBED FARTH AREAS SHALL BE DONE AS SOON AS POSSIBLE AFTER COMPLETION OF EACH STAGE OF THE PROJECT TO EXPEDITE THE ESTABLISHMENT OF VEGETATION. THE FINAL GRADING AND SHAPING MUST BE APPROVED BY THE ENGINEER BEFORE SEEDING OR SODDING IS PERFORMED
- 4. REFER TO THE ROADWAY PLANS FOR ADDITIONAL INFORMATION.

#### EROSION CONTROL SYSTEMS INSTALLATION SEQUENCE

- 1. INSTALL INLET FILTERS AT EXISTING DRAINAGE STRUCTURES PRIOR TO THE START OF WORK OR AS DIRECTED BY THE ENGINEER.
- 2. INSTALL INLET FILTERS AT PROPOSED DRAINAGE STRUCTURES AS SOON AS THE STRUCTURES HAVE BEEN CONSTRUCTED.
- 3. MAINTAIN ALL EROSION CONTROL SYSTEMS UNTIL SUCH TIME THAT THEY CAN BE REMOVED AS DIRECTED BY THE ENGINEER
- 4. PLACE SEED OR SOD AS SOON AS THE FINAL GRADING AND SHAPING ARE COMPLETE AND APPROVED BY THE ENGINEER.
- 5. REMOVE AND CLEANUP ALL REMAINING EROSION CONTROL SYSTEMS AS DIRECTED BY THE ENGINEER.

FILE NAME =	DESIGNED - J.A.J.	REVISED -	F.A.U. RTE. SECTION					COUNTY TOTAL SHEET NO.
p:\U0070070_Urbana - Goodwin Green TCSP\Plans\sheets\02 general notes.dgn	DRAWN - D.L.M.	REVISED -	STATE OF ILLINOIS		GENERAL NOTES	7175	12-00518-00-TL	CHAMPAIGN 31 2
PLOT DATE =	CHECKED - S.M.W.	REVISED -	DEPARTMENT OF TRANSPORTATION				GOODWIN AVENUE	CONTRACT NO. 91483
4/22/2013 8:57:30 PM	DATE - 04/2013	REVISED -		SCALE : NONE	SHEET NO. 2 OF 31 SHEETS STA. TO STA.	FED. ROAD	DIST. NO.   ILLINOIS   FED.	. AID PROJECT

#### ILLINOIS HIGHWAY STANDARD DRAWINGS

STANDARD NO.	DESCRIPTION
000001-06	STANDARD SYMBOLS, ABBREVIATIONS, AND PATTERNS
280001-07	TEMPORARY EROSION CONTROL SYSTEMS
420001-07	PAVEMENT JOINTS
424001-07	CURB RAMPS FOR SIDEWALKS
424011-01	CORNER PARALLEL CURB RAMPS
442101-07	CLASS B PATCHES
602301-03	INLET, TYPE A
602306-03	INLET, TYPE B
602401-03	MANHOLE TYPE A
602601-02	PRECAST REINFORCED CONCRETE FLAT SLAB TOP
602701-02	MANHOLE STEPS
604051-03	FRAME AND GRATE, TYPE 11
606001-05	CONCRETE CURB TYPE B AND COMBINATION CONCRETE CURB & GUTTER
668001-01	METHOD OF RESETTING - USGS & NGS - BENCHMARKS
701006-04	OFF-ROAD OPERATIONS, 2L-2W, 15' TO 24" FROM PAVEMENT EDGE
701301-04	LANE CLOSURE, 2L, 2W, SHORT TIME OPERATIONS
701311-03 701501-06 701601-08 701701-08	LANE CLOSURE, 2L, 2W, MOVING OPERATIONS - DAY ONLY
701501-06	URBAN LANE CLOSURE, 2L, 2W, UNDIVIDED
701601-08	URBAN LANE CLOSURE, MULTILANE, 1W OR 2W WITH NONTRAVERSIBLE MEDIAN
701701-08	URBAN LANE CLOSURE, MULTILANE, INTERSECTION
701801-05	LANE CLOSURE, MULTILANE 1W OR 2W CROSSWALK OR SIDEWALK CLOSURE
701901-02	TRAFFIC CONTROL DEVICES
720001-01	SIGN PANEL MOUNTING DETAILS
720006-03	SIGN PANEL ERECTION DETAILS
720011-01	METAL POSTS FOR SIGNS, MARKERS & DELINEATORS
729001-01	APPLICATIONS OF TYPES A & B METAL POSTS (FOR SIGNS & MARKERS)
780001-03	TYPICAL PAVEMENT MARKINGS
805001-01	ELECTRICAL SERVICE INSTALLATION DETAILS
814001-02	HANDHOLES
814006-02	DOUBLE HANDHOLES
830006-01	LIGHT POLE ALUMINUM DAVIT ARM
836001-02	LIGHT POLE FOUNDATION
857001-01 862001-01	STANDARD PHASE DESIGNATION DIAGRAMS AND PHASE SEQUENCE UNINTERRUPTABLE POWER SUPPLY (UPS) TRAFFIC SIGNAL GROUNDING AND BONDING
873001-02	TRAFFIC SIGNAL GROUNDING AND BONDING
873001-02 876001-02	PEDESTRIAN PUSH BUTTON POST
877011-05	
877011-05 878001-09	CONCRETE FOUNDATION DETAILS
880006-01	TRAFFIC SIGNAL MOUNTING DETAILS
886001-01	DETECTOR LOOP INSTALLATIONS
886006-01	TYPICAL LAYOUTS FOR DETECTOR LOOPS

#### LEGEND

EXISTING		PROPOSED	EXISTING		PROPOSED
	- WATER LINE		<b>A</b>	MONUMENT	
IRRW	IRRIGATION WATER LINE			IRON PIN/PIPE FOUND	
G	- GAS LINE		⊠	RIGHT-OF-WAY MARKER	
—	OVERHEAD ELECTRIC		6	SOIL BORING	
—UGE	- UNDERGROUND ELECTRIC		0	PAVEMENT CORE	
RWL	ROADWAY LIGHTING		$\bowtie$	TRAFFIC SIGNAL CONTROL BOX	X
—- ОНТ	OVERHEAD TELEPHONE		8-0	TRAFFIC SIGNAL POST	•
ugT	UNDERGROUND TELEPHONE		<u> </u>	TRAFFIC SIGNAL MAST ARM	• 1
	UNDERGROUND TELEPHONE (FIBER OPTIC)		V V	PEDESTRIAN PUSH BUTTON POST	<b>₽</b> ₹
CATV	CABLE TELEVISION		Ø	TRAFFIC SIGNAL HANDHOLE	
COM	COMMUNICATION LINE		0	TRAFFIC SIGNAL JUNCTION BOX	õ
F0	FIBER OPTIC LINE		808 C 8	RR CROSSING GATE	0
STM	STEAM LINE		30X	RR FLASHING SIGNAL	
—_FM>—	FORCE MAIN		**	RR CROSSBUCK	
				STREET SIGN	
-		72500 720	===	TRAFFIC SIGN	
-		1- 1-	Þ	DELINEATOR	
		T			
	INLET OR CATCH BASIN	•	B-O-B	PARKING LOT LIGHT	
0	MANHOLE	$\mathbf{O}$	×	YARD LIGHT	
olW	UTILITY WARNING SIGN		3	MAILBOX	
⊚W ⊚G	SERVICE BOX SHUTOFF		9	PARKING METER	
8	VALVE		CE	IRRIGATION CONTROL BOX	
W	WATER MANHOLE		CE-	IRRIGATION HEAD	
ДW	WATER METER		0	TANK FILLER CAP	
Д	FIRE HYDRANT		8	INSPECTION WELL	
ДC	GAS METER		°c0	CLEANOUT	
GR 6-0	GAS REGULATOR		000	DOWNSPOUT	
٤	GAS VENT PIPE		€	BOLLARD	
(E)	ELECTRIC MANHOLE		.0	FENCE POST	
ДE	ELECTRIC METER		o	GATE POST	
ΘE	ELECTRIC PEDESTAL		0~	FLAG POLE	
<b>□</b> E	ELECTRIC JUNCTION BOX	■ □	04	FLOOD LIGHT	
-0-	POWER POLE		II.	TREE STUMP	
ф>	POWER POLE W/LIGHT				
-ô-	POWER POLE W/TRANSFORMER		0	BUSH	
	ROADWAY LIGHTING CONTROLLER				
0-0	ROADWAY STREET LIGHT		₹. F	CONIFEROUS TREE	
¤	ORNAMENTAL STREET LIGHT		THE STATE OF THE S		
0)	GUY POLE		( • }	DECIDUOUS TREE	
0-	GUY WIRE		$\sim$		
:-0-	TELEPHONE POLE		(001)	PROPERTY PARCEL NUMBER	
1	TELEPHONE MANHOLE		*200	HOUSE ADDRESS NUMBER	
οT	TELEPHONE PEDESTAL		WTATE OF	೧೯೮೮ ನರ್ಮಗಳ ಹಂತಹವರ್ಣ ಸಾಹಾಸಕಾರಣೆ.	
[III]	PEDESTAL PAY PHONE				
F	PHONE BOOTH				

TILE NAME =	DESIGNED - J.A.J.	REVISED -	
o:\U0070070_Urbana - Goodwin Green TCSP\Plans\sheets\03 standards.dgn	DRAWN - K.L.R.	REVISED -	
PLOT DATE =	CHECKED - S.M.W.	REVISED -	
4/22/2013 8:57:30 PM	DATE - 04/2013	REVISED -	

STATE OF ILLINOIS DEPARTMENT OF TRANSPORTATION

		ID . FOELD	F.A.U. RTE.	SECTION	COUNTY	TOTAL	SHEET NO.
HIGHWAY SI	ANDARDS AN	ND LEGEND	7175	12-00518-00-TL	CHAMPAIGN	31	3
				GOODWIN AVENUE	CONTRACT	NO. 91	1483
SCALE : NONE SHEET NO. 3 0	F 31 SHEETS STA	. TO STA.	FED. ROAD	DIST. NO. ILLINOIS FED.	AID PROJECT		

	SUMMARY OF QUAN	ITITIES			TOTAL	0004 80% TCSP	0021 80% TCSP	0021 80% TCSP		-		SUMMARY	OF QUANTITIES			TOTAL	_	0021 80% TCSP	0021 80% TCSP
CODE NO.	ITEM			UNIT	QUANTITY	80% TCSP 20% LOCAL ROADWAY	LIGHTING	20% LOCAL SIGNALS		CODE NO.			ITEM		UNIT	QUANTITY	80% TCSP 20% LOCAL ROADWAY	20% LOCAL LIGHTING	20% LOCAL SIGNALS
20201200	REMOVAL AND DISPOSAL OF UNSUITABLE MATERIAL		-	CU YD	10	10			* 60	)266600 V	ALVE BOXES TO BI	E ADJUSTED			EACH	2	2		
20600110	GRANULAR EMBANKMENT, SPECIAL			TON	20	20			* 60	500060 R	EMOVING INLETS				EACH	2	2		
21001000	GEOTECHNICAL FABRIC FOR GROUND STABILIZATION	N		SQ YD	30	30			67	7100100 M	OBILIZATION				L SUM	1	1		
25200100	SODDING			SQ YD	80	80			70	300570 P	AVEMENT MARKING	TAPE, TYPE III 2	4"		FOOT	128	128		
25200200	SUPPLEMENTAL WATERING			UNIT	5	5			* 70	0301000 W	ORK ZONE PAVEME	NT MARKING REMOV	/AL		SQ FT	256	256		
28000510	INLET FILTERS			EACH	12	12			* 72	2000100 S	IGN PANEL - TYPE	1			SQ FT	43	43		
31101200	SUBBASE GRANULAR MATERIAL, TYPE B 4"			SQ YD	158	158			* 720	2000200 S	IGN PANEL - TYPE	2			SQ FT	50	50		
35101400	AGGREGATE BASE COURSE, TYPE B			TON	102	102			Δ 78	3000100 T	HERMOPLASTIC PAY	/EMENT MARKING -	LETTERS AND SYMBO	LS	SQ FT	125	125		
35300300	PORTLAND CEMENT CONCRETE BASE COURSE 8"			SQ YD	103	103			Δ 780	3000200 T	HERMOPLASTIC PAY	/EMENT MARKING -	LINE 4"		FOOT	723	723		
40201000	AGGREGATE FOR TEMPORARY ACCESS			TON	25	25			△ 780	3000400 T	HERMOPLASTIC PAY	/EMENT MARKING -	LINE 6"		FOOT	121	121		
40600100	BITUMINOUS MATERIALS (PRIME COAT)			GALLON	846	846			Λ 780	8000600 T	HERMOPLASTIC PAV	/EMENT MARKING -	LINE 12"		FOOT	997	997	****	
	AGGREGATE (PRIME COAT)		4	TON	17	17			Δ 780	3000650 T	HERMOPLASTIC PAV	/EMENT MARKING -	LINE 24"		FOOT	128	128		
	MIXTURE FOR CRACKS, JOINTS, AND FLANGEWAYS		ļ	TON	1	1							- LETTERS AND SYM	BOLS	SQ FT	2	2		
		TI 0.550 N70				85					NDERGROUND CONDI		ELTIENS AND STA	5025	FOOT				80
	POLYMERIZED LEVELING BINDER (MACHINE METHOD)	, IL-9.5FG, N70		TON	85											80			
	TEMPORARY RAMP			SQ YD	274	274						UIT, PVC, 11/4" DIA			FOOT	2			2
40603237	POLYMERIZED HOT-MIX ASPHALT BINDER COURSE,	IL-19.0FG, N70		TON	502	502						UIT, PVC, 1/2" DIA	•		FOOT	111			111
40603540	POLYMERIZED HOT-MIX ASPHALT SURFACE COURSE,	, MIX "D", N70		TON	415	415			Δ* 810	1028350 U	NDERGROUND CONDI	UIT, PVC, 2" DIA.			FOOT	312		106	206
42400300	PORTLAND CEMENT CONCRETE SIDEWALK 6 INCH			SQ FT	2800	2800			Δ* 810	1028360 U	NDERGROUND CONDI	UIT, PVC. 21/2" DIA	١.		FOOT	95			95
42400800	DETECTABLE WARNINGS			SQ FT	147	147			Δ* 810	1028370 U	NDERGROUND CONDI	JIT, PVC, 3" DIA.			FOOT	220			220
44000100	PAVEMENT REMOVAL			SQ YD	190	190			A* 810	1028390 U	NDERGROUND CONDI	UIT, PVC, 4" DIA.			FOOT	87	-		87
44000159	HOT-MIX ASPHALT SURFACE REMOVAL, 21/2"			SQ YD	402	402			Δ* 810	1028740 U	NDERGROUND CONDI	JIT, COILABLE NON	METALLIC CONDUIT, 1	½" DIA.	FOOT	350			350
44000164	HOT-MIX ASPHALT SURFACE REMOVAL, 33/4"			SQ YD	3826	3826			A ■ 810	1028750 U	NDERGROUND CONDI	JIT, COILABLE NON	METALLIC CONDUIT, 2	" DIA.	FOOT	1432		1432	
44000500	COMBINATION CURB AND GUTTER REMOVAL			FOOT	178	178			Δ 814	400700 H	ANDHOLE, PORTLAN	D CEMENT CONCRE	TE		EACH	3			3
44000600	SIDEWALK REMOVAL			SQ FT	2115	2115			Δ 814	400720 D	OUBLE HANDHOLE,	PORTLAND CEMENT	CONCRETE		EACH	1			1
44200990	CLASS B PATCHES, TYPE I, 12 INCH			SQ YD	25	25			Δ = 815	1500100 G	ULFBOX JUNCTION				EACH	7		7	
44200994	CLASS B PATCHES, TYPE II, 12 INCH			SQ YD	100	100			Δ * 815	1500120 G	ULFBOX JUNCTION,	COMPOSITE CONCR	RETE		EACH	7			7
44200998	CLASS B PATCHES, TYPE III, 12 INCH			SQ YD	25	25			Δ* 81	1702101 E	LECTRIC CABLE IN	CONDUIT, 600V (X	(LP-TYPE USE) 1/C NO	D. 14	FOOT	320		320	
44201000	CLASS B PATCHES, TYPE IV, 12 INCH			SQ YD	25	25			Δ * 81	1702120 E	LECTRIC CABLE IN	CONDUIT, 600V (X	(LP-TYPE USE) 1/C NO	D. 8	FOOT	5050		5050	
54248510	CONCRETE COLLAR		<u> </u>	CU YD	2	2			Δ * 830	000400 L	IGHT POLE, ALUMIN	NUM, 30 FT. M.H.,	10 FT. DAVIT ARM		EACH	5		5	
550A0050	STORM SEWERS, CLASS A, TYPE 1 12"			FOOT	16	16			Δ * 842	1200600 R	EMOVAL OF LIGHTI	NG UNIT, NO SALV	AGE		EACH	4		4	
550A0070	STORM SEWERS, CLASS A, TYPE 1 15"			FOOT	5	5			Δ * 842	1200804 R	EMOVAL OF POLE F	FOUNDATION			EACH	4		4	
	STORM SEWER REMOVAL 12"			FOOT	3	3			A * 85	700200 F	ULL-ACTUATED CON	TROLLER AND TYP	E IV CABINET		EACH	1			1
	STORM SEWER REMOVAL 15"			FOOT	7	7						OWER SUPPLY, STA			EACH	1			1
	in the second se											CONDUIT, SIGNAL							
	CONTROLLED LOW-STRENGTH MATERIAL			CU YD	6	6									FOOT	1750			1750
	INLETS, TYPE A, TYPE 11 FRAME AND GRATE			EACH	2	2						CONDUIT, SIGNAL			FOOT	150			150
	MANHOLES TO BE ADJUSTED			EACH	1	1						CONDUIT, SIGNAL	NO. 14 5C		FOOT	990			990
	CIAL PROVISIONS LTY ITEMS									SEE SPECI	AL PROVISIONS VITEMS	- 19-01-11							
=	n Green TCSPIPlans\sheets\04 summary.dgn	DESIGNED - J.A.J. DRAWN - J.A.J.	REVISED -				ST	ATE OF	113/19				SUMMARY OF	QUANTITIES	F.A RTE		SECTION 00518-00-TL		UNTY TO SHE
E = 4:05:43 PM		CHECKED - S.M.W.  DATE - 04/2013	REVISED -			D				PORTATIO		SCALE : NONE S	SHEET NO. 4 OF 31 SHEE			GOODWI	N AVENUE	CON	TRACT NO

	SUMMARY OF QUANTITIES	CONSTRUC	CTION CODE		0021	0021			SUMMARY OF QUANTITIES	CONSTRU	CTION CODE		0021	0021
CODE NO.	ITEM	UNIT	TOTAL	20% LOCAL ROADWAY	80% TCSP 20% LOCAL LIGHTING	20% LOCAL SIGNALS		CODE NO.	ITEM	UNIT	TOTAL QUANTITY	80% TCSP 20% LOCAL ROADWAY	20% LOCAL LIGHTING	20% LOCAL SIGNALS
	ELECTRIC CABLE IN CONDUIT, SIGNAL NO. 14 7C	FOOT	2150	HOADIIAI	LIGHTENO	2150	4		DI LIGHT POLE, SPECIAL	EACH	1	HONDIINI	1	OTOTINES
* 87301515	ELECTRIC CABLE IN CONDUIT, LEAD-IN, NO. 18 3 PAIR	FOOT	1660			1660	Δ*	X836012	O LIGHT POLE FOUNDATION, SPECIAL	EACH	6		6	
<ul> <li>87301795</li> </ul>	ELECTRIC CABLE IN CONDUIT, SERVICE NO. 3 1C	FOOT	785			785	Δ.	X873025	O ELECTRIC CABLE IN CONDUIT NO. 20 3/C, TWISTED, SHIELDED	FOOT	490			490
* 87301900		FOOT	660			660	Δ.	X876020	O ACCESSIBLE PEDESTRIAN SIGNALS	EACH	8			8
	TRAFFIC SIGNAL POST, 10 FT.	EACH	3			3		X876025	O VIBROTACTILE FEATURE	EACH	8			8
	TRAFFIC SIGNAL POST, 16 FT.	EACH	2			2			6 INDUCTIVE LOOP DETECTOR, RACK MOUNTED	EACH	10			10
						4			33 REMOVE EXISTING TRAFFIC SIGNAL EQUIPMENT, SPECIAL	L SUM	1			10
* 87600100		EACH	4				1			- 10 40-2		740		
	STEEL COMBINATION MAST ARM ASSEMBLY AND POLE 46 FT.	EACH	4			4			3 SEEDING (COMPLETE)	SQ YD	340	340		
* 87800100	CONCRETE FOUNDATION, TYPE A	FOOT	15			15			77 LUMINAIRE (SPECIAL)	EACH	1		1	
* 87800150	CONCRETE FOUNDATION, TYPE C	FOOT	4			4	Δ *	XX00806	8 LUMINAIRE INSTALLATION, TYPE 1	EACH	5		5	
* 87800415	CONCRETE FOUNDATION, TYPE E 36-INCH DIAMETER	FOOT	60			60	Δ*	XX00806	9 LUMINAIRE INSTALLATION, TYPE 2	EACH	4		4	
* 88040070	SIGNAL HEAD, POLYCARBONATE, LED, 1-FACE, 3-SECTION, BRACKET MOUNTED	EACH	2			2	Δ *	XX00860	8 CABLE, SPECIAL	FOOT	1250		1250	
* 88040090	SIGNAL HEAD, POLYCARBONATE, LED, 1-FACE, 3-SECTION, MAST ARM MOUNTED	EACH	6			6	٠	XZ12790	O RETAINING WALL REMOVAL	FOOT	10	10		
* 88040150	SIGNAL HEAD, POLYCARBONATE, LED, 1-FACE, 5-SECTION, BRACKET MOUNTED	EACH	2			2	*	Z001379	8 CONSTRUCTION LAYOUT	L SUM	1	1		
<b>88040160</b>	SIGNAL HEAD, POLYCARBONATE, LED, 1-FACE, 5-SECTION, MAST ARM MOUNTED	EACH	4			4		Z003670	O PARKING METER POSTS TO BE REMOVED	EACH	1	1		
* 88040260	SIGNAL HEAD, POLYCARBONATE, LED, 2-FACE, 1-3-SECTION, 1-5-SECTION, BRACKET MOUNTED	EACH	2			2		Z003870	O PERMANENT BENCH MARKS	EACH	1	1		
* 88102825	PEDESTRIAN SIGNAL HEAD, POLYCARBONATE, LED, 1-FACE, BRACKET MOUNTED WITH COUNTDOWN TIMER	EACH	8			8		Z004230	O PORTLAND CEMENT CONCRETE SIDEWALK CURB	FOOT	10	10		
Δ 88200100	TRAFFIC SIGNAL BACKPLATE	EACH	10			10		Z005664	18 STORM SEWERS, TYPE 1, WATER MAIN QUALITY PIPE, 12"	FOOT	3	3		
	DETECTOR LOOP, TYPE I	FOOT	705			705	1							
	LIGHT DETECTOR	EACH	2			2								
	LIGHT DETECTOR AMPLIFIER	EACH	1			1								
* 89502380	REMOVE EXISTING HANDHOLE	EACH	6			6								
* 89502385	REMOVE EXISTING CONCRETE FOUNDATION	EACH	10			10								
* K1003680	MULCH	SQ YD	340	340		On the same								
* X0322748	BICYCLE LANE MARKING	EACH	5	5				7-2						
* X6020084	MANHOLES, SPECIAL	EACH	1	1										
* X6024240	INLETS, SPECIAL	EACH	1	1										
* X6025600	MANHOLES TO BE ADJUSTED (SPECIAL)	EACH	15	15										
• X6026624	VALVE BOXES TO BE ADJUSTED (SPECIAL)	EACH	7	7										
* X6064200	COMBINATION CONCRETE CURB AND GUTTER, TYPE B-6.12 (SPECIAL)	FOOT	195	195		-								
* X6300230	STEEL POSTS	EACH	1	1										
	TRAFFIC CONTROL AND PROTECTION (SPECIAL)	L SUM	1	1										
	SERVICE INSTALLATION (SPECIAL)	EACH	1			1	1							
						-								
	JUNCTION BOX (SPECIAL)	EACH	4		4									
	REMOVE EXISTING JUNCTION BOX	EACH	3		1	2								- pass
* X8130130	JUNCTION BOX TO BE ADJUSTED	EACH	1	1										
	CIAL PROVISIONS						74		PECIAL PROVISIONS ALTY ITEMS					
AME =	DESIGNED - J.A.J.   REVISED -					TATE OF			SUMMARY OF QUANTITIES	F.A RTE	U.	SECTION	cc	UNTY

REVISED -


DATE - 04/2013

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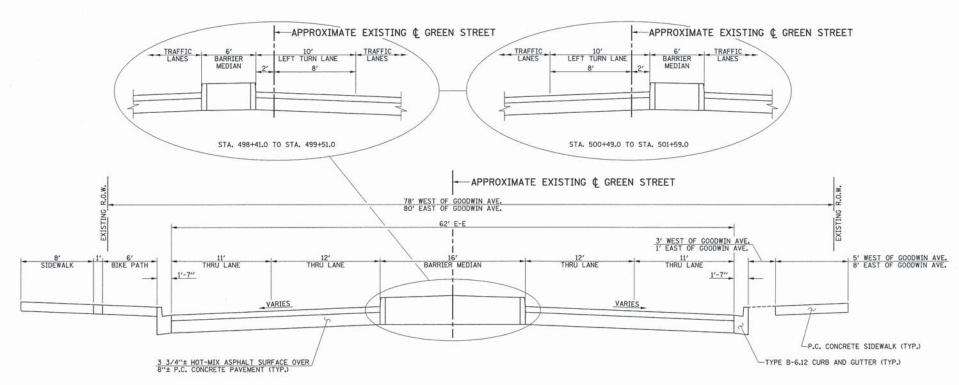
SCALE : NONE SHEET NO. 5 OF 31 SHEETS STA.

GOODWIN AVENUE CONTRACT NO. 91483
FED. ROAD DIST. NO. | ILLINOIS | FED. AID | PROJECT



# EXISTING TYPICAL CROSS SECTION GOODWIN AVENUE

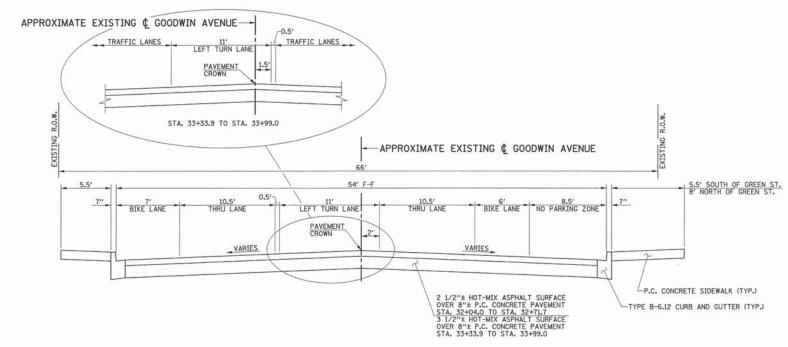
STA. 32+04.0 TO STA. 32+71.7 STA. 33+33.9 TO STA. 33+99.0





# EXISTING TYPICAL CROSS SECTION GREEN STREET STA. 497+41.0 TO STA. 503+09.0

NOTE
THE EXISTING PAVEMENT TYPES AND THICKNESSES WERE TAKEN FROM
EXISTING PLANS AND FROM PAVEMENT CORES AND REPRESENT THE BEST
AVAILABLE INFORMATION. NO ADDITIONAL COMPENSATION WILL BE ALLOWED
FOR PAVEMENT REMOVAL ITEMS DUE TO VARIATIONS IN PAVEMENT TYPES,
THICKNESSES, OR AMOUNT OF REINFORCEMENT. THE ADJUSTMENT OF QUANTITIES
AS SPECIFIED IN ARTICLE 440.07 OF THE STANDARD SPECIFICATIONS SHALL
NOT APPLY.

FILE NAME = p:\U0070070_Urbana - Goodwin Green TCSP\Plans\sheets\05 typical sections.dgn	DESIGNED - J.A.J. DRAWN - J.L.B.	REVISED -	STATE OF ILLINOIS	EXISTING TYPICAL SECTIONS			F.A.U. RTE.	SECTION 12-00518-00-TL	COUNTY	SHEETS NO.
PLOT DATE =	CHECKED - S.M.W.	REVISED -	DEPARTMENT OF TRANSPORTATION				G00	DOWIN AVENUE		NO. 91483
4/22/2013 8:57:31 PM	DATE - 04/2013	REVISED -		SCALE : NONE	SHEET NO. 6 OF 31 SHEETS	STA. 497+41.00 TO STA. 503+09.00				/

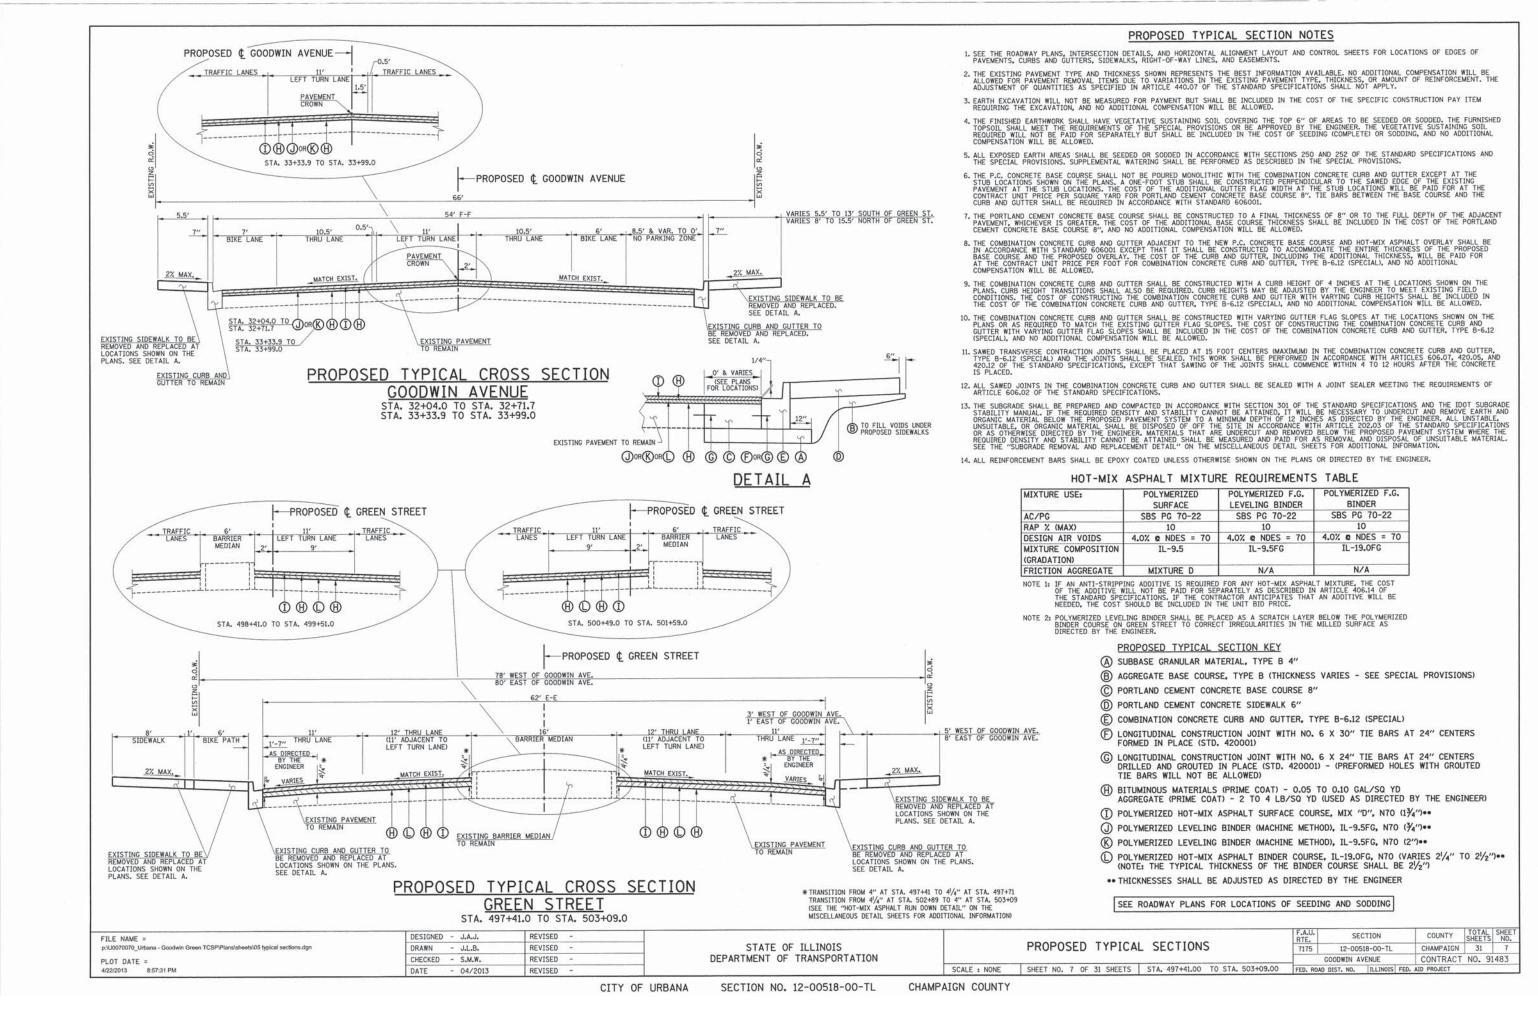

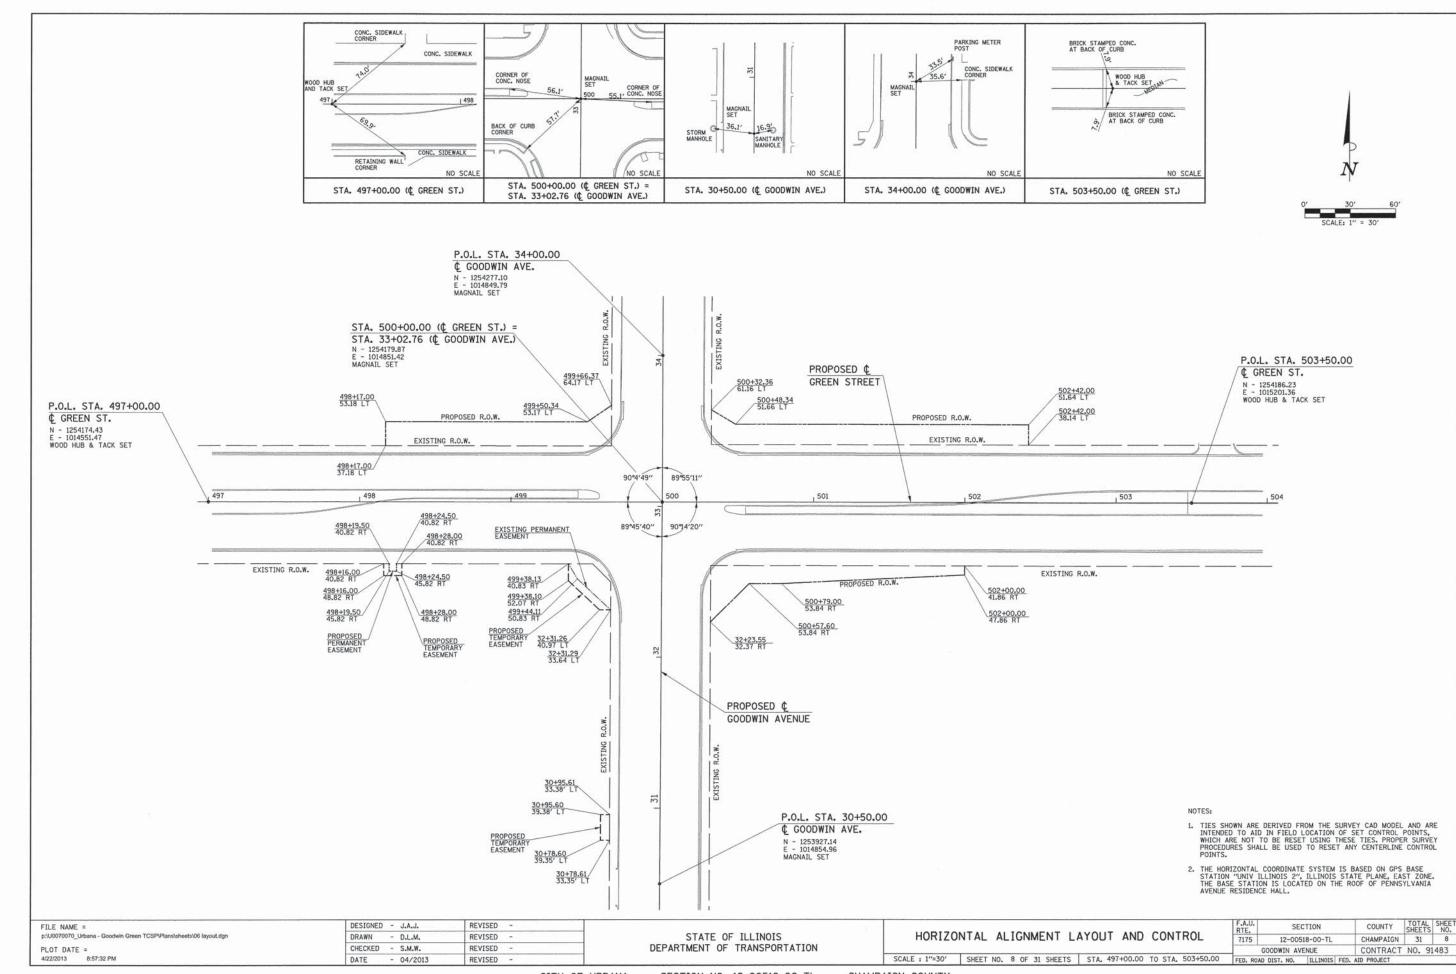

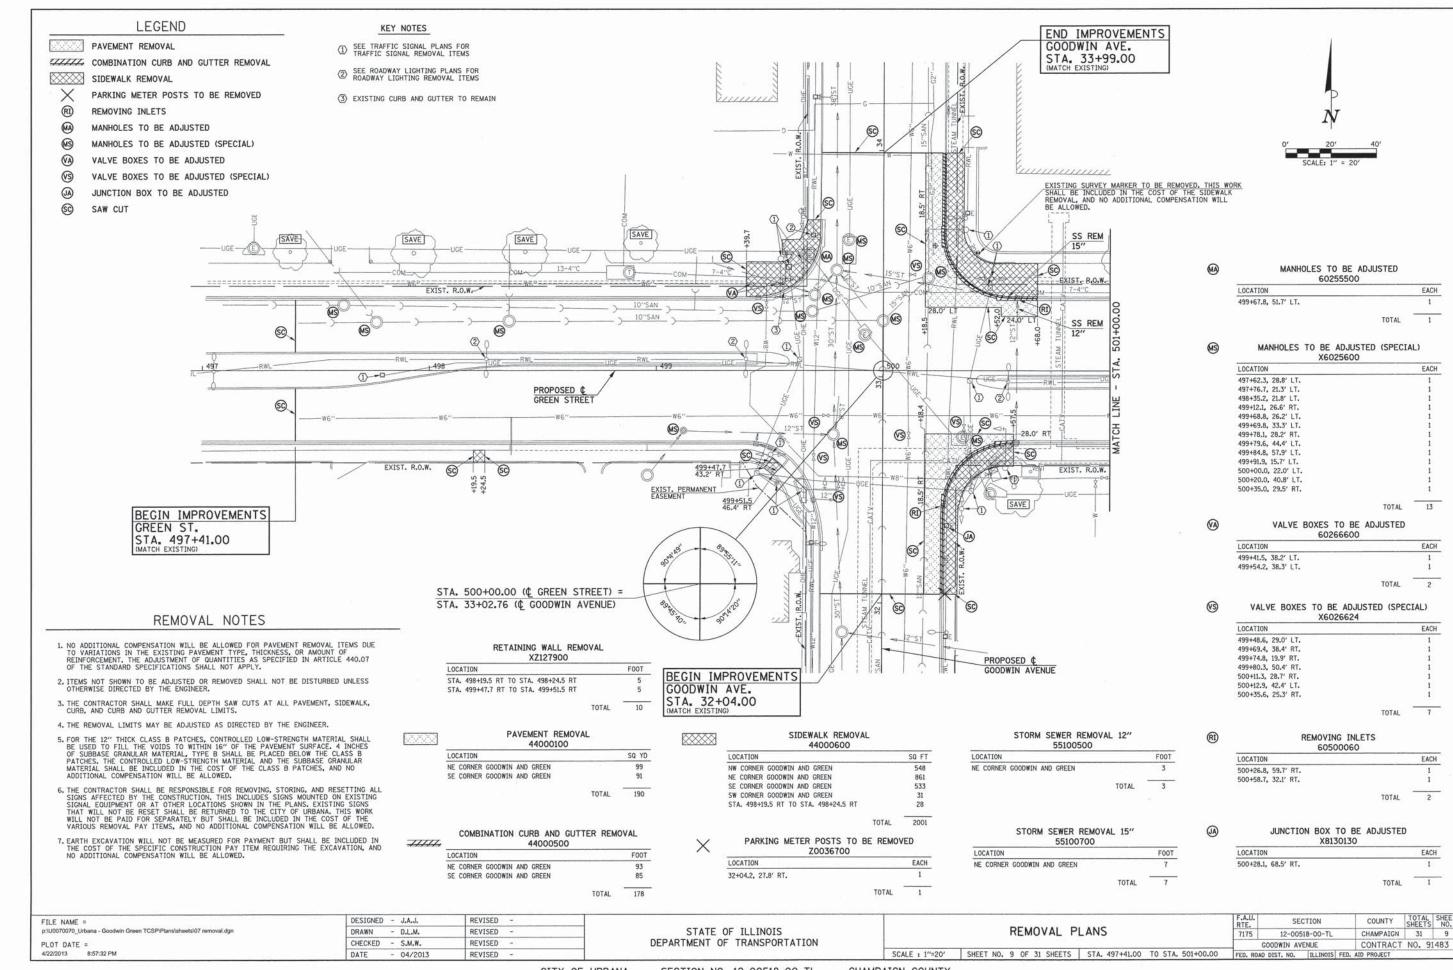

#### LEGEND

PAVEMENT REMOVAL

COMBINATION CURB AND GUTTER REMOVAL

SIDEWALK REMOVAL

PARKING METER POSTS TO BE REMOVED

RI REMOVING INLETS

MANHOLES TO BE ADJUSTED

MS MANHOLES TO BE ADJUSTED (SPECIAL)

VALVE BOXES TO BE ADJUSTED


(S) VALVE BOXES TO BE ADJUSTED (SPECIAL)


JUNCTION BOX TO BE ADJUSTED

SC) SAW CUT

#### KEY NOTES

- SEE TRAFFIC SIGNAL PLANS FOR TRAFFIC SIGNAL REMOVAL ITEMS
- ② SEE ROADWAY LIGHTING PLANS FOR ROADWAY LIGHTING REMOVAL ITEMS

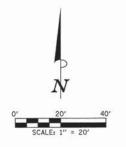

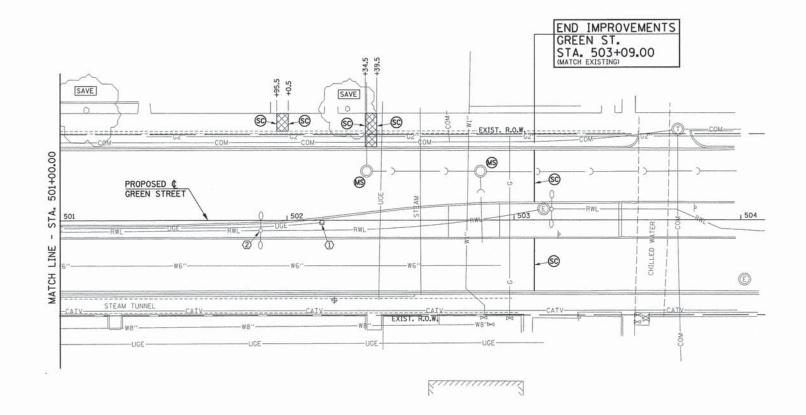

SIDEWALK REMOVAL
44000600

LOCATION S0 FT

STA. 501+95.5 LT TO STA. 502+00.5 LT 39
STA. 502+34.5 LT TO STA. 502+39.5 LT

TOTAL 114


COUNTY TOTAL SHEETS NO.


CHAMPAIGN 31 10


CONTRACT NO. 91483


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STATE OF ILLINOIS
DEPARTMENT OF TRANSPORTATION



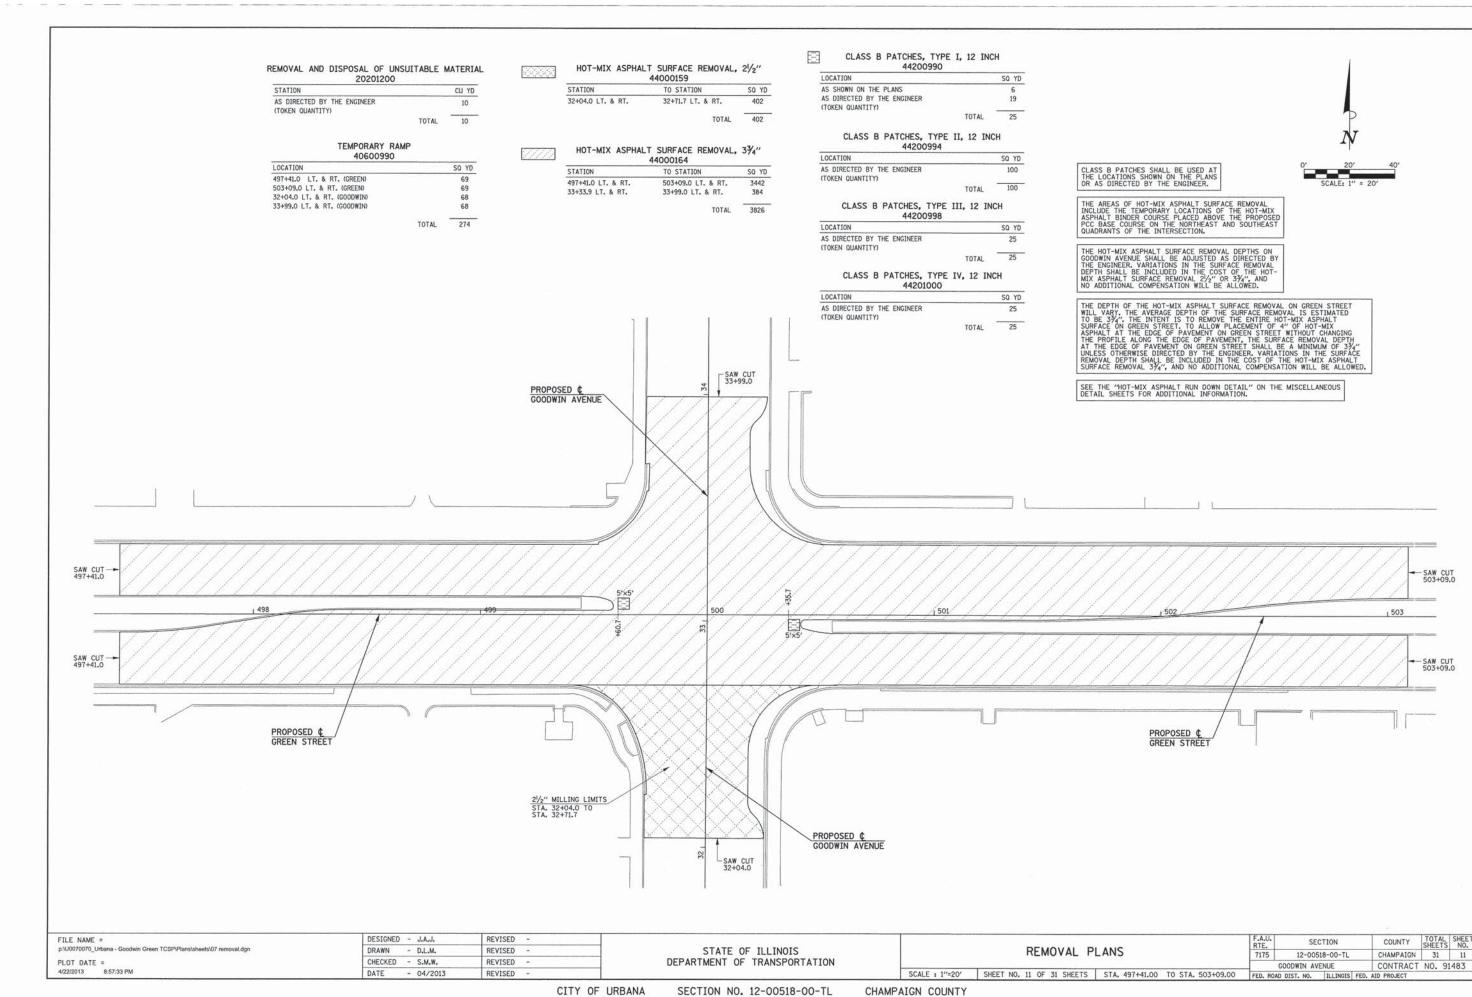

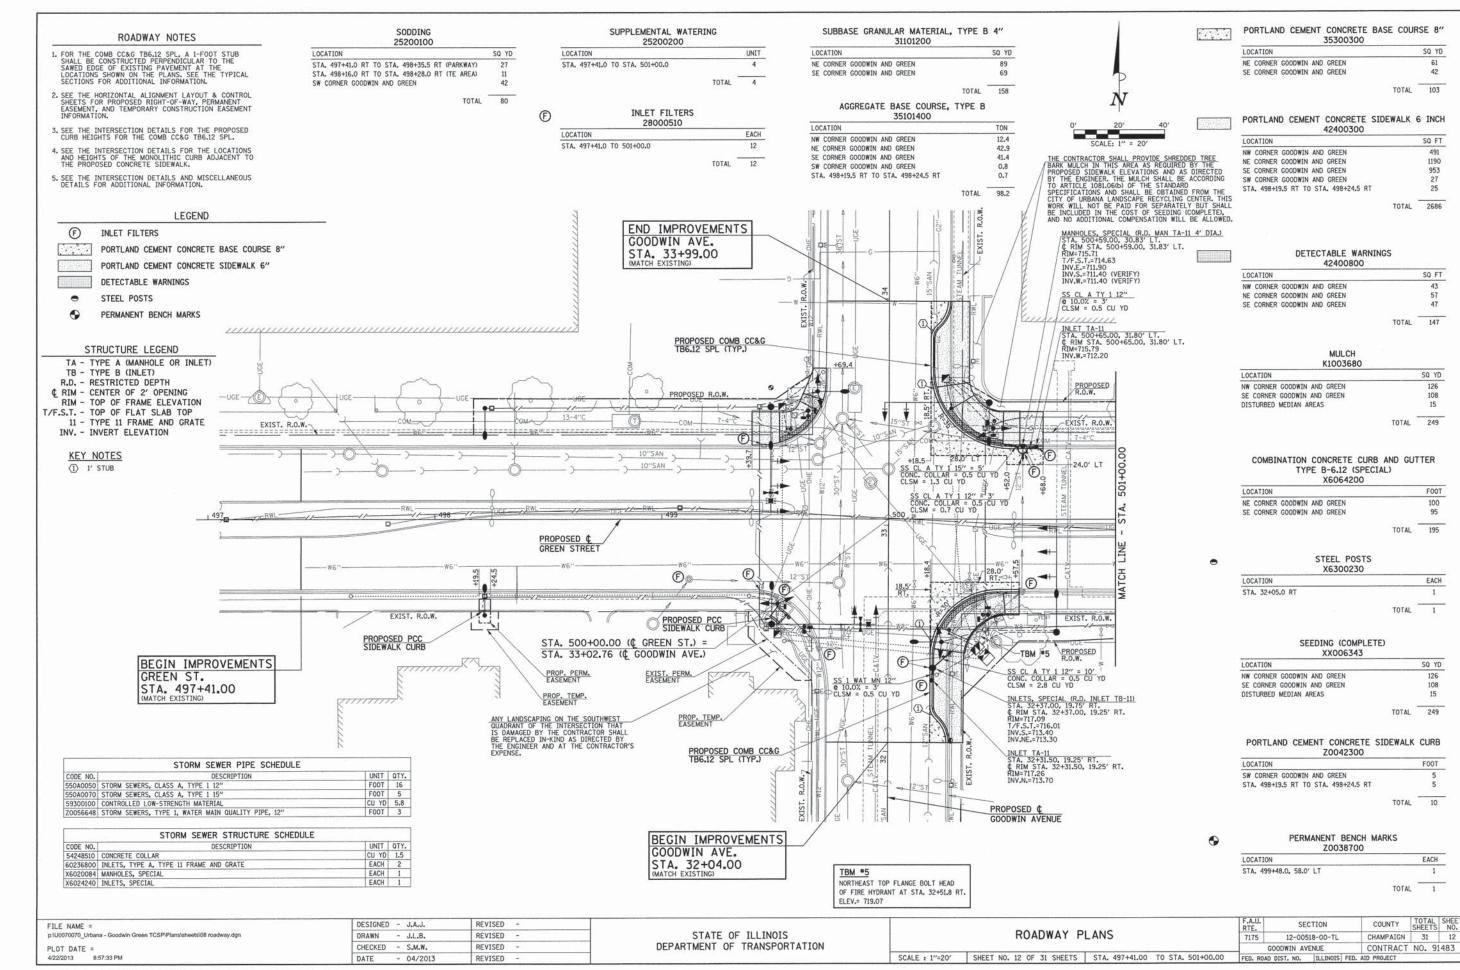

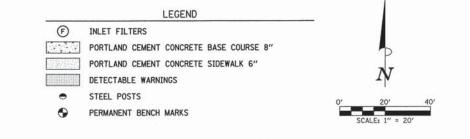

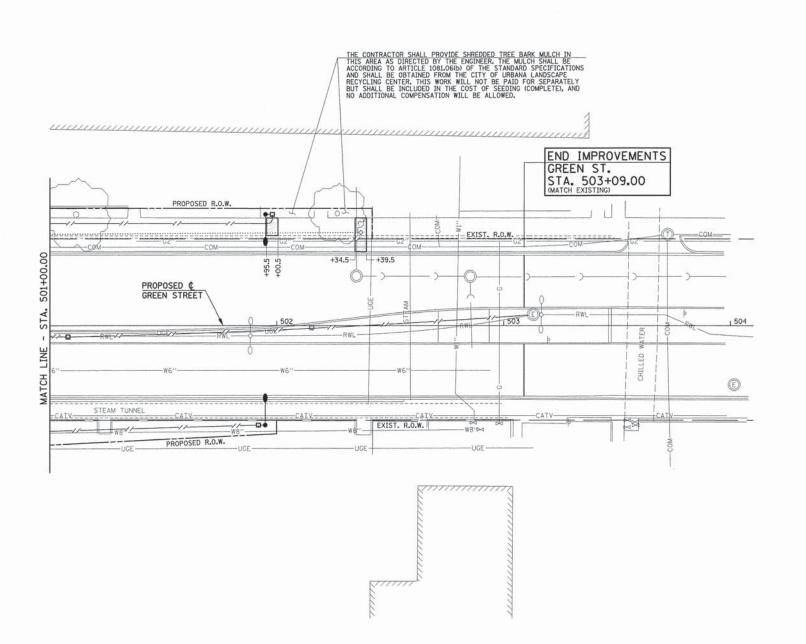SUPPLEMENTAL WATERING 25200200

LOCA	TION							UNI
STA.	501+00.0	RT	TO	STA.	502+00.0	RT		1
							TOTAL	-

#### AGGREGATE BASE COURSE, TYPE B

				- 3	5101400			
LOCA	TION							TON
STA.	501+95.5	LT	TO	STA.	502+00.5	LT		1.0
STA.	502+34.5	LT	TO	STA.	502+39.5	LT		1.9
							TOTAL	2.9

### PORTLAND CEMENT CONCRETE SIDEWALK 6 INCH


LOCA	TION							SQ FT
STA.	501+95.5	LT	TO	STA.	502+00.5	LT		39
STA.	502+34.5	LT	TO	STA.	502+39.5	LT		75
							TOTAL	114

#### MULCH K1003680

11200000		
LOCATION		SQ YD
STA. 501+00.0 RT TO STA. 502+00.0 RT		85
DISTURBED MEDIAN AREAS		6
	TOTAL	91

#### SEEDING (COMPLETE) XX006343

LOCATION		SQ Y
STA. 501+00.0 RT TO STA. 502+00.0 RT DISTURBED MEDIAN AREAS		85 6
	TOTAL	91

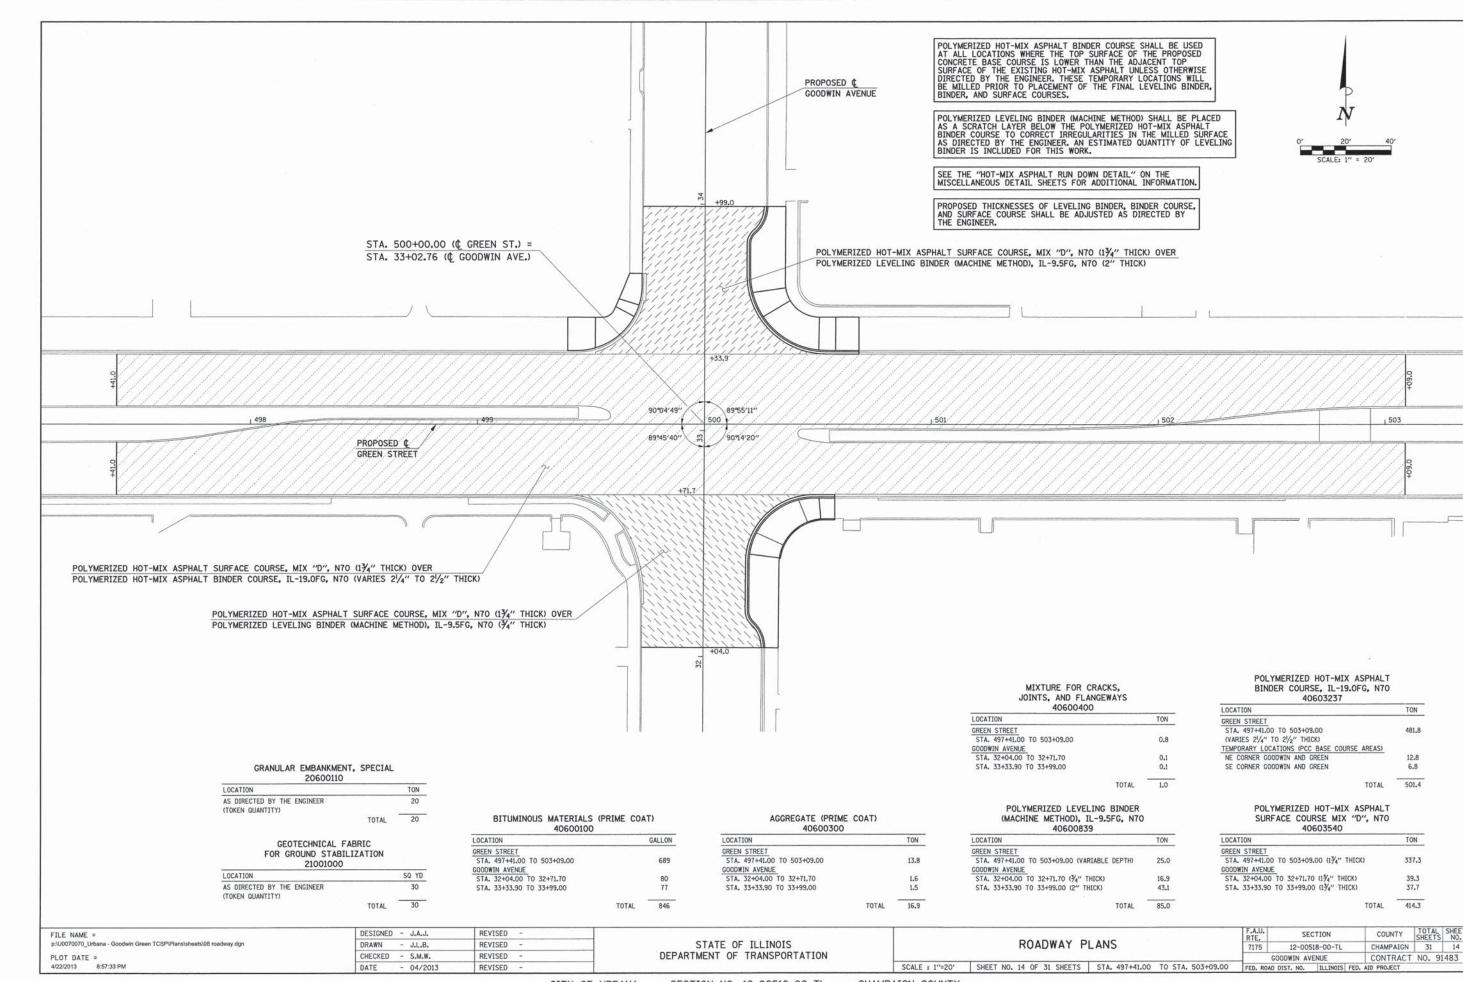

#### TRAFFIC CONTROL GENERAL NOTES

- 1. PRIOR TO THE START OF CONSTRUCTION OPERATIONS, THE CONTRACTOR SHALL SUBMIT A TRAFFIC CONTROL PLAN AND SEQUENCE OF CONSTRUCTION OPERATIONS TO THE ENGINEER FOR APPROVAL. THE CONTRACTOR SHALL MAINTAIN PEDESTRIAN ACCESS TO ALL BUILDINGS MITHIN THE PROJECT LIMITS AT ALL TIMES DURING CONSTRUCTION. THE CONTRACTOR SHALL LIMIT CONSTRUCTION OPERATIONS AT THE INTERSECTION TO TWO ADJACENT QUADRANTS AT A TIME, EITHER BOTH ON THE EAST SIDE OF GOODWIN AVENUE OR BOTH ON THE WEST SIDE OF GOODWIN AVENUE. THE CONTRACTOR TRAFFIC CONTROL PLAN AND SEQUENCE OF CONSTRUCTION OPERATIONS SHALL INCLUDE THESE REQUIREMENTS.
- NO DEVIATIONS FROM THE APPROVED TRAFFIC CONTROL PLAN WILL BE ALLOWED WITHOUT WRITTEN AUTHORIZATION FROM THE ENGINEER.
- ONE THRU LANE OF TRAFFIC SHALL BE MAINTAINED IN EACH DIRECTION ON GOODWIN AVENUE AND ON GREEN STREET EXCEPT AS OTHERWISE DIRECTED BY THE ENGINEER.
- 4. TRAFFIC CONTROL AND PROTECTION SHALL BE IN ACCORDANCE WITH THE APPLICABLE PORTIONS OF THE STANDARD SPECIFICATIONS FOR ROAD AND BRIDGE CONSTRUCTION; THE APPLICABLE GUIDELINES CONTAINED IN THE MANUAL ON UNIFORM TRAFFIC CONTROL DEVICES FOR STREETS AND HIGHWAYS, STANDARDS 701006, 701301, 701311, 701501, 701501, 701601, 701701, 701801, AND 701901; THE TRAFFIC CONTROL PLANS, AND THE SPECIAL PROVISIONS. DELETE ALL REFERENCES TO MEASUREMENT AND PAYMENT.
- 5. TRAFFIC CONTROL AND PROTECTION WILL BE PAID FOR AT THE CONTRACT LUMP SUM PRICE FOR TRAFFIC CONTROL AND PROTECTION ISPECIAL). THE TRAFFIC CONTROL AND PROTECTION INSTALLATION FOR EACH WORK AREA WILL NOT BE PAID FOR SEPRATELY, BUT SHALL BE INCLUDED IN THE LUMP SUM PRICE FOR THIS ITEM, ALL ADDITIONAL TRAFFIC CONTROL DEVICES AND TRAFFIC CONTROL SIGNS REQUIRED TO MAINTAIN THE TRAFFIC CONTROL OR AS DIRECTED BY THE ENGINEER SHALL BE INCLUDED IN THE LUMP SUM PRICE OF TRAFFIC CONTROL AND PROTECTION (SPECIAL).
- 6. TRAFFIC CONTROL SURVEILLANCE WILL NOT BE PAID FOR SEPARATELY FOR THIS PROJECT, THE CONTRACTOR SHALL BE RESPONSIBLE FOR INSPECTING AND MAINTAINING ALL TRAFFIC CONTROL DEVICES AT ALL TIMES INCLUDING NIGHTTIME, WEEKENDS, AND ANY TIME WORKERS AND THE SENT, THIS WORK SHALL BE PERFORMED IN ACCORDANCE WITH RECURRING SPECIAL PROVISION LRS3, THE COST OF ALL LABOR AND MATERIALS FOR THE MAINTENANCE OF TRAFFIC CONTROL DEVICES SHALL BE INCLUDED IN THE LUMP SUM PRICE OF TRAFFIC CONTROL AND PROTECTION (SPECIAL).
- THE CONTRACTOR SHALL MAINTAIN AT LEAST ONE POINT OF ACCESS TO EACH PROPERTY IN THE WORK AREA AT ALL TIMES.
- 8. FURNISHING, PLACING, SALVAGING, AND REMOVING ALL AGGREGATE THAT IS USED TO TEMPORARILY FILL ANY VOIDS OR TO PROVIDE TEMPORARY ACCESS FOR VEHICLES OR PEDESTRIANS WILL BE PAID FOR AT THE CONTRACT UNIT PRICE PER TON FOR AGGREGATE FOR TEMPORARY ACCESS. AN APPROXIMATE QUANTITY OF AGGREGATE FOR TEMPORARY ACCESS HAS BEEN INCLUDED FOR THIS WORK. THE USE OF AGGREGATE THAT IS SALVAGED FROM ONE TEMPORARY LOCATION AND USED AT A DIFFERENT LOCATION WILL ONLY BE PAID FOR AT THE ORIGINAL LOCATION, AND NO ADDITIONAL COMPENSATION WILL BE ALLOWED.
- 9. THE CONTRACTOR SHALL COVER OR REMOVE ANY EXISTING SIGN THAT CONFLICTS WITH THE TRAFFIC CONTROL PLAN AS DIRECTED BY THE ENGINEER. THE CONTRACTOR SHALL PROVIDE "NO PARKING" SIGNS (R7-1-1218) ALONG THE CORRIDOR AS DIRECTED BY THE ENGINEER. THE PROPOSED SIGNS SHALL BE INSTALLED IN ACCORDANCE WITH STANDARD 701901 AND AS DIRECTED BY THE ENGINEER.
- THE CONTRACTOR SHALL PROVIDE AND INSTALL TWO WEIGHTED SAND BAGS ON EACH TYPE II BARRICADE USED (ONE WEIGHTED SAND BAG ACROSS EACH BOTTOM RAIL).
- 11. FOR STABILIZATION, ALL TYPE III BARRICADES SHALL REQUIRE A MINIMUM OF FOUR SAND BAGS PER BARRICADE.
- 12. FLASHING LIGHTS SHALL BE PLACED ON ALL TYPE III BARRICADES IN ACCORDANCE WITH STANDARD 701901 UNLESS OTHERWISE DIRECTED BY THE ENGINEER, STEADY BURN LIGHTS SHALL BE PLACED ON ALL DRUMS AND BARRICADES (EXCEPT FOR TYPE III BARRICADES) IN ACCORDANCE WITH STANDARD 701901 UNLESS OTHERWISE DIRECTED BY THE ENGINEER.
- 13. TRAFFIC CONTROL DEVICES MAY BE ADJUSTED TO FIT FIELD CONDITIONS AS DIRECTED BY THE ENGINEER. ADDITIONAL TRAFFIC CONTROL DEVICES NOT ASSOCIATED WITH ANY TRAFFIC CONTROL STANDARD MAY BE REQUIRED AS DIRECTED BY THE ENGINEER. THE ADDITIONAL TRAFFIC CONTROL DEVICES SHALL BE INCLUDED IN THE LUMP SUM PRICE OF TRAFFIC CONTROL AND PROTECTION (SPECIAL).
- 15. TEMPORARY HOT-MIX ASPHALT RAMPS SHALL HAVE A MINIMUM TAPER RATE OF 1:40 (V:H) AND WILL BE PAID FOR AT THE CONTRACT UNIT PRICE PER SQUARE YARD FOR TEMPORARY RAMP. THE CONSTRUCTION, MAINTENANCE, AND REMOVAL OF TEMPORARY HOT-MIX ASPHALT RAMPS SHALL BE INCLUDED IN THE PRICE OF THIS ITEM.
- 16. TO THE FULLEST EXTENT POSSIBLE, THE EXISTING PAVEMENT MARKING SHALL BE USED FOR TRAFFIC CONTROL. WORK ZONE PAVEMENT MARKING SHALL BE INSTALLED AS REQUIRED BY THE TRAFFIC CONTROL STANDARDS AND THE TRAFFIC CONTROL PLAN AND AS DIRECTED BY THE ENGINEER. WORK ZONE PAVEMENT MARKING WILL BE PAID FOR AT THE CONTRACT UNIT PRICE PER FOOT FOR PAVEMENT MARKING TAPE, TYPE III 24" AND SHALL CONSIST OF 24" SOLID WHITE STOP LINES PLACED ON THE FINAL WEARING SURFACE OR AS OTHERWISE DIRECTE BY THE ENGINEER. WORK ZONE PAVEMENT MARKING REQUIRED BY THE TRAFFIC CONTROL STANDARDS WILL NOT BY PAID FOR SEPARATELY, AS DESCRIBED IN ARTICLE 703.07 OF THE STANDARD SPECIFICATIONS. ONLY PAVEMENT MARKING TAPE, TYPE III SHALL BE ALLOWED ON THE FINAL WEARING SURFACE.
- 17. THE CONTRACTOR SHALL REMOVE EXISTING PAVEMENT MARKINGS OR PREVIOUSLY INSTALLED WORK ZONE PAVEMENT MARKINGS THAT CONFLICT WITH THE TRAFFIC CONTROL PLAN AS DIRECTED BY THE ENGINEER. REMOVAL OF THE WORK ZONE PAVEMENT MARKINGS REQUIRED BY THE TRAFFIC CONTROL PLAN WILL BE PAID FOR AT THE CONTRACT UNIT PRICE PER SQUARE FOOT FOR WORK ZONE PAVEMENT MARKING REMOVAL, REMOVAL OF THE EXISTING PAVEMENT MARKINGS SHALL BE DONE IN ACCORDANCE WITH SECTION 783 OF THE STANDARD SPECIFICATIONS, REMOVAL OF EXISTING PAVEMENT MARKINGS AND WORK ZONE PAVEMENT MARKINGS REQUIRED BY THE TRAFFIC CONTROL STANDARDS WILL NOT BE PAID FOR SEPARTELY BUT SHALL BE INCLUDED IN THE COST OF THE WORK ZONE PAVEMENT MARKING REMOVAL, AND NO ADDITIONAL COMPENSATION WILL BE ALLOWED.
- 18. THE CONTRACTOR SHALL NOTIFY THE CITY OF URBANA OF ALL ROAD CLOSURES AND CHANGES TO THE TRAFFIC CONTROL PLAN A MINIMUM OF 48 HOURS IN ADVANCE OF THE WORK.
- 19. THE CITY OF URBANA WILL BE RESPONSIBLE FOR NOTIFYING THE PUBLIC, THE UNITED STATES POSTAL SERVICE, THE CHAMPAIGN-URBANA MASS TRANSIT DISTRICT, THE EMERGENCY SERVICE AGENCIES, AND THE UNIVERSITY OF ILLINOIS OF ALL ROAD CLOSURES AND CHANGES TO THE TRAFFIC CONTROL PLAN.
- 20. FOR SPECIFIC INSTRUCTIONS ON THE INCLUSION OF SIGNS, BARRICADES, AND OTHER TRAFFIC CONTROL DEVICES FOR INDIVIDUAL WORK ZONES, AND THE PLACEMENT THEREOF, REFER TO THE TRAFFIC CONTROL STANDARDS, THE STANDARD SPECIFICATIONS FOR ROAD AND BRIDGE CONSTRUCTION, AND THE SPECIAL PROVISIONS.
- 21. THE INITIAL TRAFFIC CONTROL SETUP AND SUBSEQUENT CHANGES BETWEEN TRAFFIC CONTROL STAGES SHALL PERFORMED DURING NON-PEAK TRAFFIC HOURS AS DIRECTED BY THE ENGINEER, FLAGGERS SHALL BE REQUIRE DURING THE INITIAL SETUP AND SUBSEQUENT CHANGES OF THE TRAFFIC CONTROL DEVICES AS DIRECTED BY
- 22. REFER TO THE SPECIAL PROVISIONS FOR ADDITIONAL REQUIREMENTS CONCERNING THE USE OF FLAGGERS.
- 23. REFER TO THE SPECIAL PROVISIONS FOR ADDITIONAL INFORMATION.

TRAFFIC SIGNAL AND ALL-WAY STOP CONTROL NOTES

- 1. THE INTERSECTION OF GOODWIN AVENUE AND GREEN STREET SHALL BE ALL-WAY STOP-CONTROLLED DURING THE CONSTRUCTION OF THE PROPOSED TRAFFIC SIGNAL IMPROVEMENTS AT THAT INTERSECTION. THE CONTRACTOR SHALL FURNISH, INSTALL, AND MAINTAIN TEMPORARY "STOP" SIGNS (R1-1-30), "ALL-WAY" SIGNS (R1-4-1806), AND "STOP AHEAD" SIGNS (W3-1-48) ON ALL INTERSECTION APPROACHES AS DIRECTED BY THE ENGINEER. THIS WORK WILL NOT BE PAID FOR SEPARATELY BUT SHALL BE INCLUDED IN THE COST OF TRAFFIC CONTROL AND PROTECTION (SPECIAL), AND NO ADDITIONAL COMPENSATION WILL BE ALLOWED.
- 2. THE DURATION OF THE ALL-WAY STOP-CONTROL SHALL BE KEPT TO A MINIMUM AS DIRECTED BY THE ENGINEER AND THE CITY OF URBANA.

#### TRAFFIC CONTROL STANDARDS

THE FOLLOWING TRAFFIC CONTROL STANDARDS ARE THE MINIMUM REQUIREMENTS FOR THE TRAFFIC CONTROL FOR THIS PROJECT WHEN LANES ARE OPEN TO TRAFFIC:


STANDARD	APPLICATION
701006	OFF-ROAD OPERATIONS ON VARIOUS STREETS FOR LANDSCAPING OPERATIONS, SIGN INSTALLATION, ETC.
701301	SHORT TIME LANE CLOSURE ON VARIOUS STREETS FOR CONSTRUCTION LAYOUT, DEBRIS CLEANUP, ETC.
701311	MOVING OPERATIONS LANE CLOSURE ON VARIOUS STREETS FOR LANDSCAPING WORK, PAVEMENT MARKING, DEBRIS CLEANUP, ETC.
701501	LANE CLOSURE ON VARIOUS STREETS FOR CONSTRUCTION ACTIVITIES THAT REQUIRE THE TEMPORARY CLOSURE OF ONE THRU LANE OF TRAFFIC.
701601	LANE CLOSURE ON VARIOUS STREETS FOR PAVEMENT PATCHING UNDER TWO-WAY TRAFFIC.
701701	LANE CLOSURE ON VARIOUS STREETS FOR INTERSECTION SHOULDER OPERATIONS, CORNER ISLAND OPERATIONS, LEFT-LANE OPERATIONS, ETC.
701801	SIDEWALK CLOSURES WITHIN PROJECT LIMITS
701901	TRAFFIC CONTROL DEVICES


#### TRAFFIC CONTROL BILL OF MATERIALS


CODE NUMBER	DESCRIPTION	UNIT	QUANTITY
40201000	AGGREGATE FOR TEMPORARY ACCESS	TON	25
70300570	PAVEMENT MARKING TAPE, TYPE III 24"	FOOT	128
70301000	WORK ZONE PAVEMENT MARKING REMOVAL	SQ FT	256
X7010216	TRAFFIC CONTROL AND PROTECTION (SPECIAL)	L SUM	1

NOTE: AN APPROXIMATE QUANTITY OF AGGREGATE FOR TEMPORARY ACCESS HAS BEEN INCLUDED FOR THIS WORK (SEE TRAFFIC CONTROL GENERAL NOTE 8).


COUNTY TOTAL SHEE NO. REVISED SECTION DESIGNED - J.A.J. FILE NAME = TRAFFIC CONTROL PLANS p:\U0070070\_Urbana - Goodwin Green TCSP\Plans\sheets\09 traffic control.dgn REVISED STATE OF ILLINOIS 12-00518-00-TL CHAMPAIGN 31 15 DRAWN - K.L.R. DEPARTMENT OF TRANSPORTATION CONTRACT NO. 91483 GOODWIN AVENUE CHECKED - S.M.W. REVISED PLOT DATE = SCALE : NONE SHEET NO. 15 OF 31 SHEETS STA. FED. ROAD DIST. NO. ILLINOIS FED. AID PROJECT 4/22/2013 8:57:34 PM DATE - 04/2013 REVISED

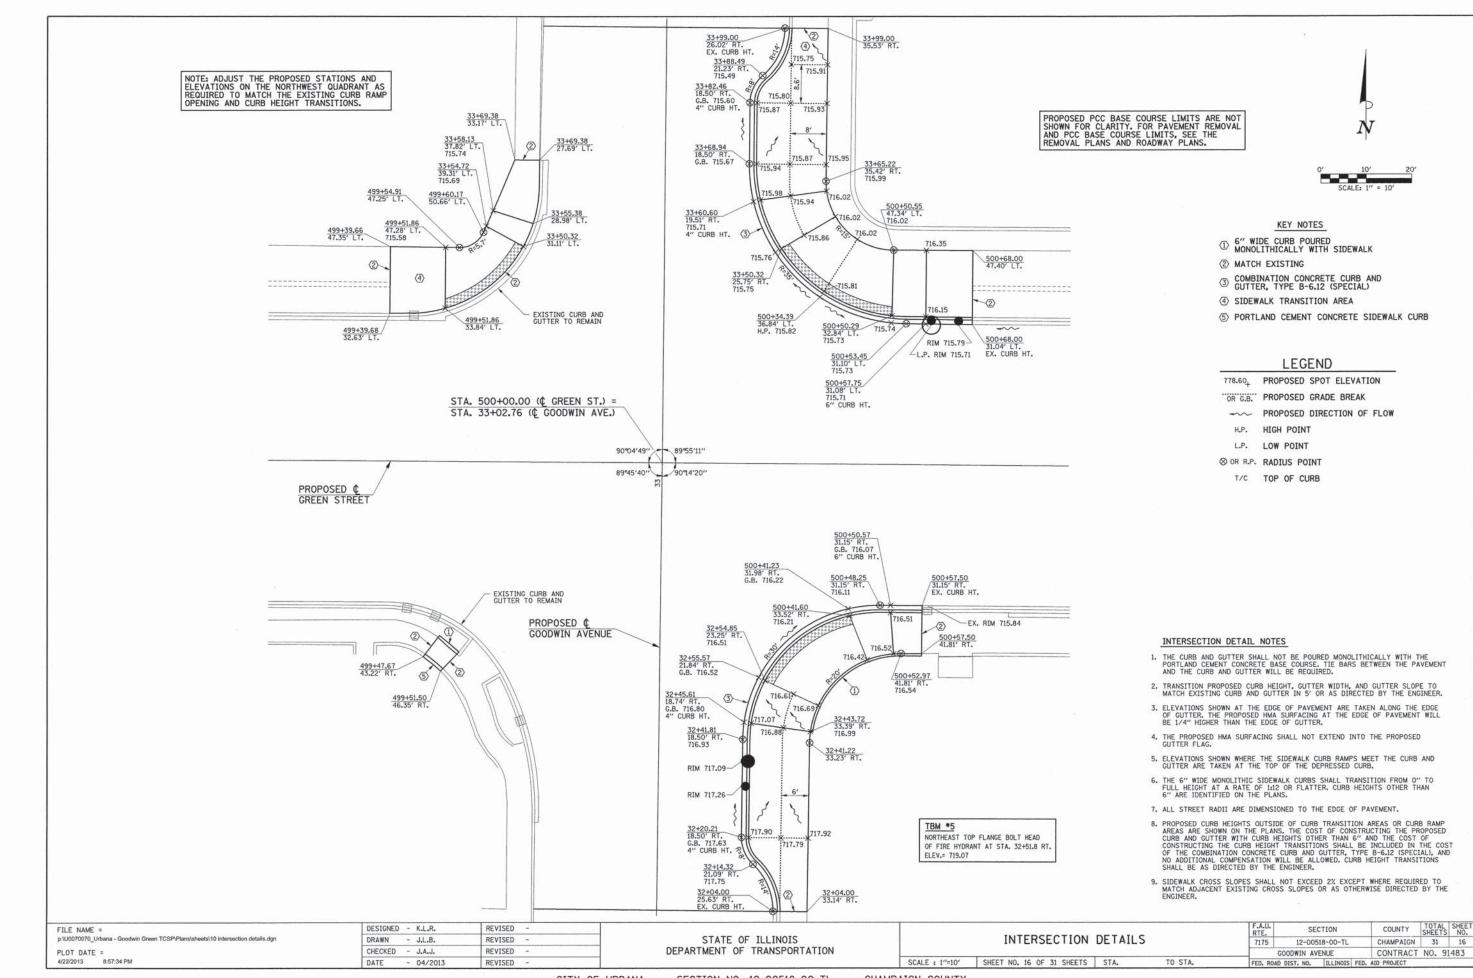

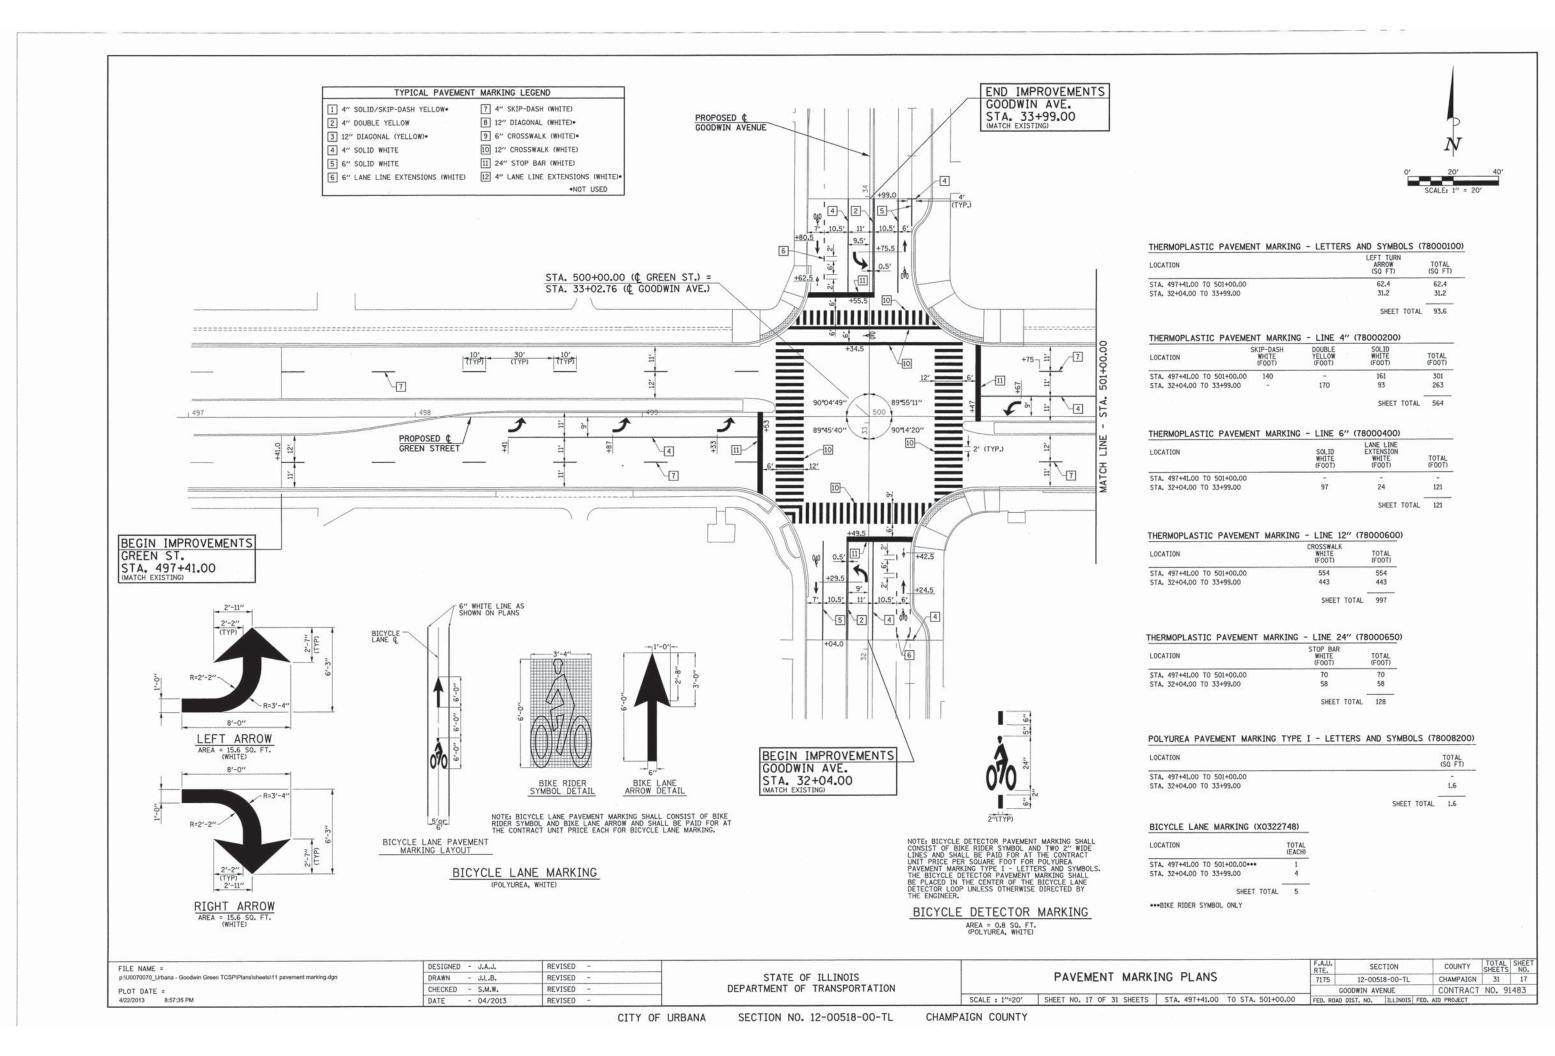

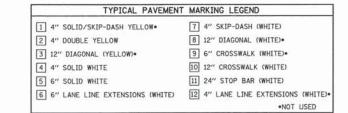

THERMOPLASTIC PAVEME	NT MARKING	- LINE 4"	(78000200)	
LOCATION	SKIP-DASH WHITE (FOOT)	DOUBLE YELLOW (FOOT)	SOLID WHITE (FOOT)	TOTAL (FOOT)
STA. 501+00.00 TO 503+09.00	100		59	159
			SHEET TOTAL	159

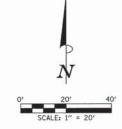


				J L	
A. 501+00.00	43 43 43 43 43		15, 11,		
MATCH LINE - STA.	+15 22 7	10°   30°   10°   (TYP)	0,00		PROPOSED ¢ GREEN STREET
W				1	
			END IMPR GREEN ST STA. 503- (MATCH EXISTING	OVEMENTS +09.00	


FILE NAME	
p:\U0070070_t	Jrbana - Goodwin Green TCSP\Plans\sheets\11 pavement marking.dgn
PLOT DATE	=
4/22/2013	8:57:35 PM


STATE OF ILLINOIS
DEPARTMENT OF TRANSPORTATION

	PAVE	EMEN	Т	MARK	NG	PLANS				
SCALE : 1"=20'	SHEET NO.	18 OF	31	SHEETS	STA.	501+00.00	ТО	STA.	503+09.00	

RTE.	SE	CTION	COUNTY	TOTAL	SHEE NO.
7175	12-005	18-00-TL	CHAMPAIGN	31	18
-	GOODWIN AV	ENUE	CONTRACT	NO. 91	483
ED. RO	AD DIST, NO.	ILLINOIS FED.	AID PROJECT		

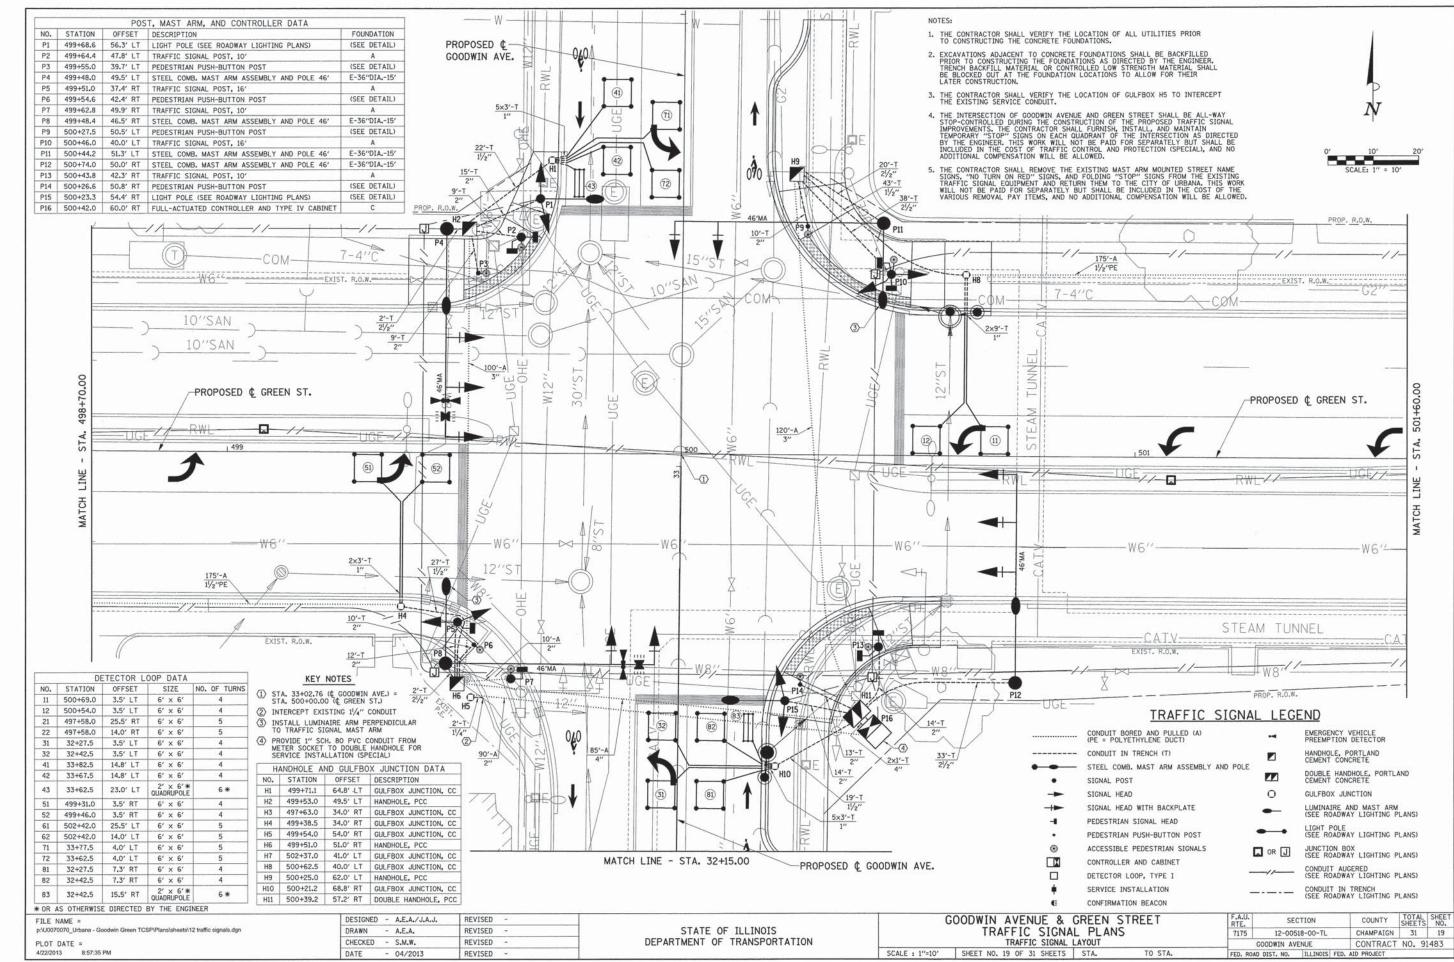

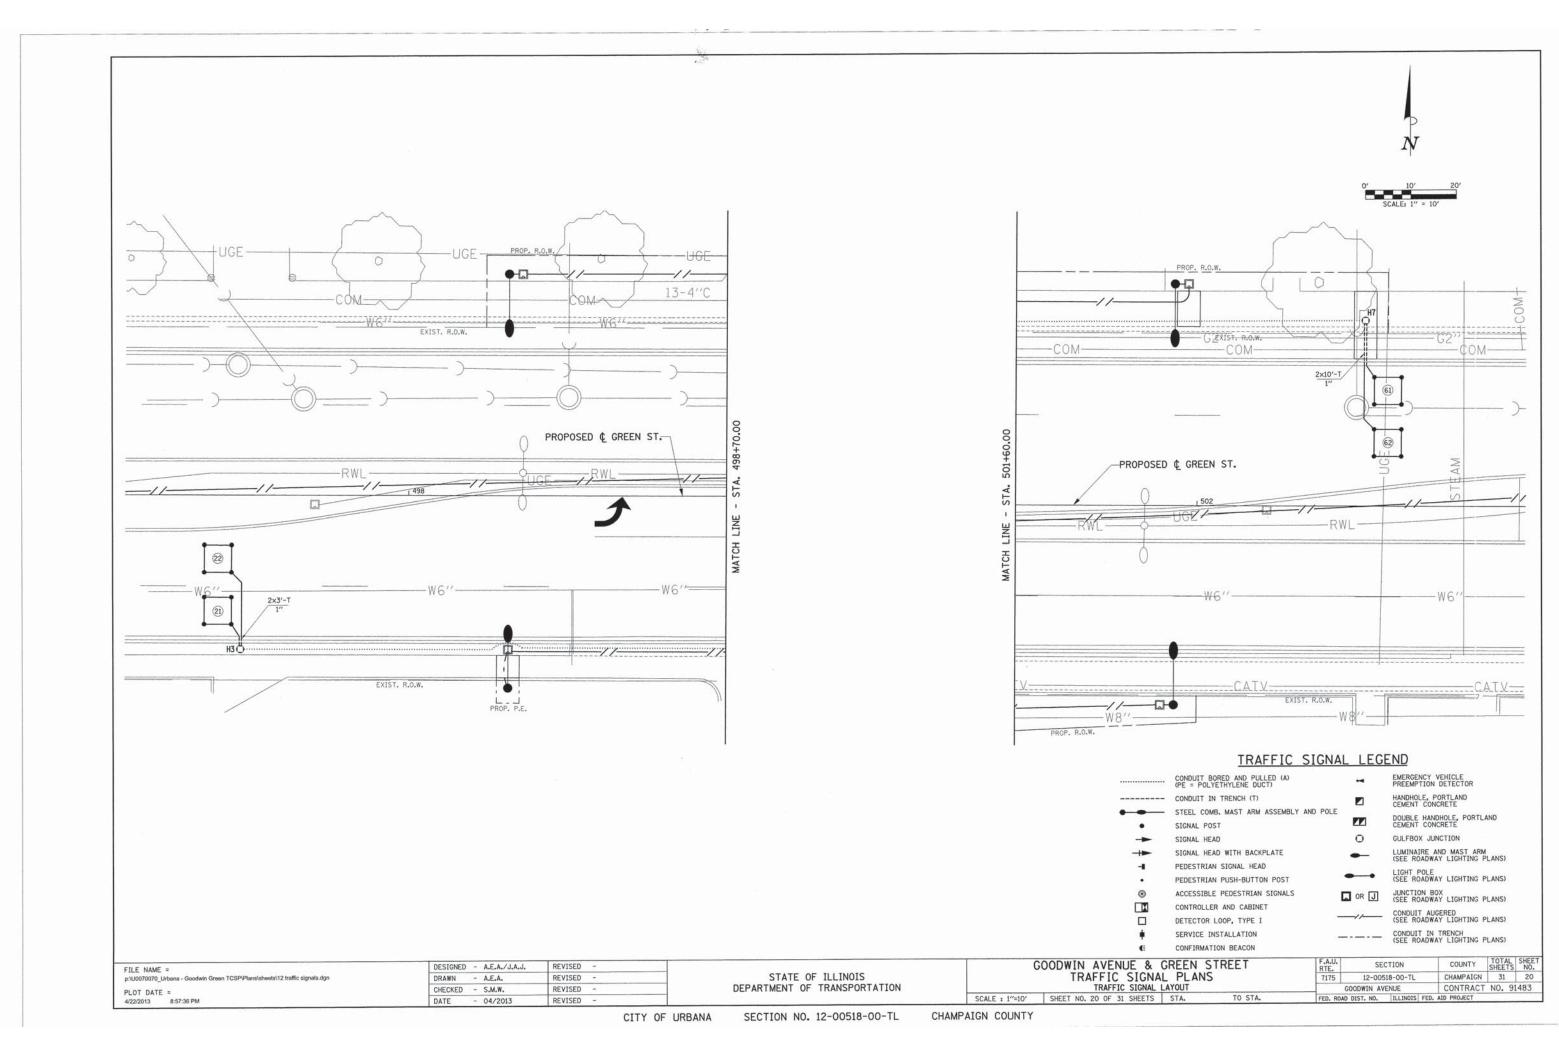

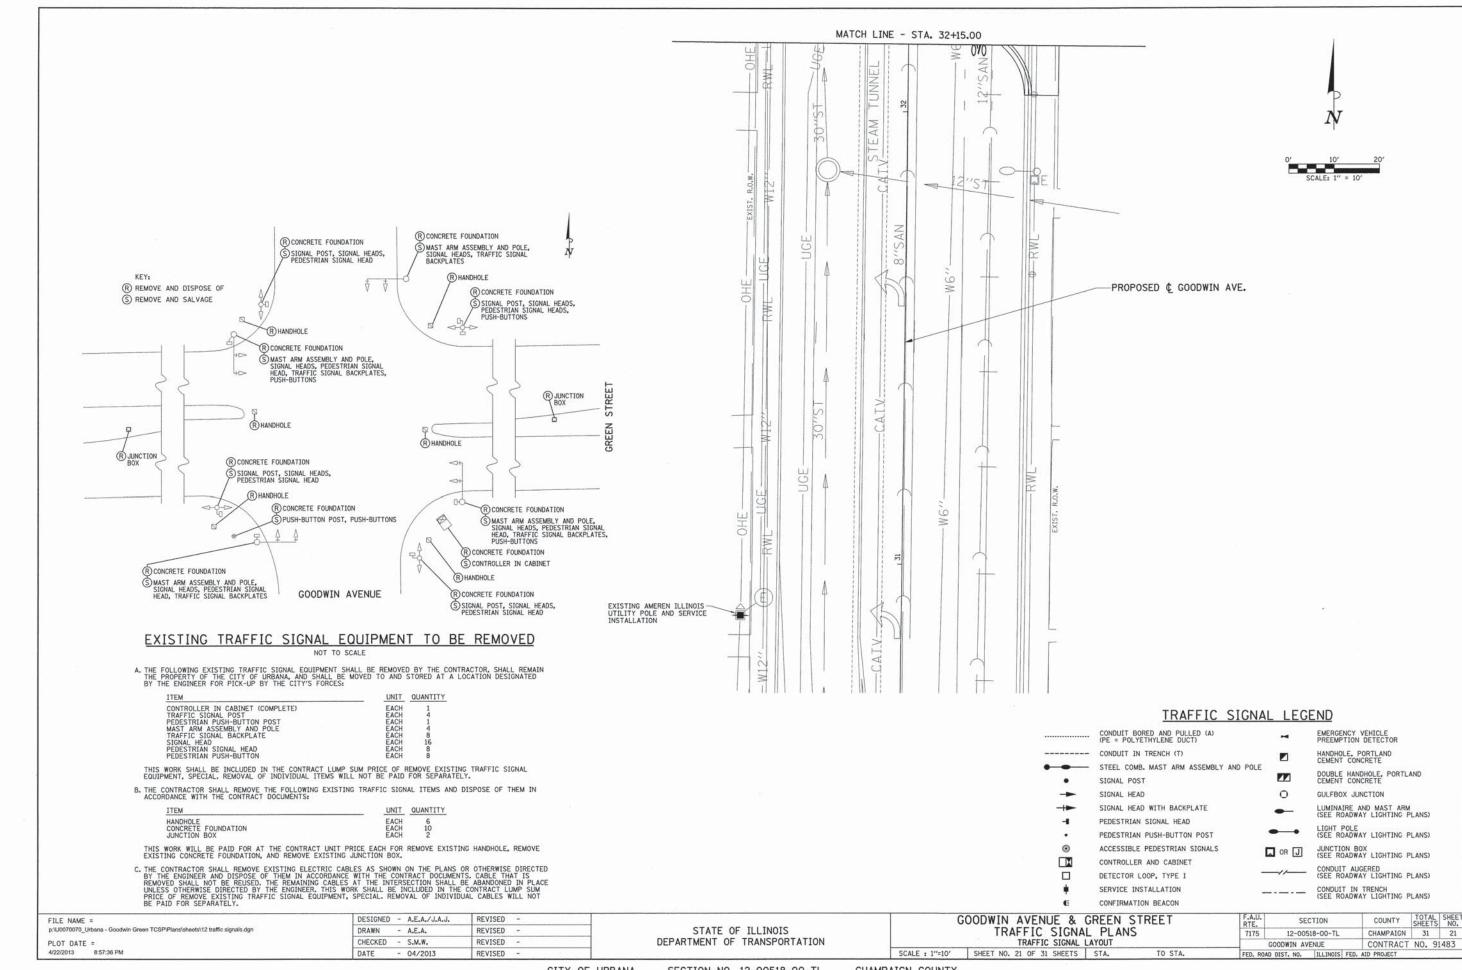

#### BILL OF MATERIALS


ITEM	UNIT	QUANTIT
SIGN PANEL - TYPE 1	SQ FT	43
SIGN PANEL - TYPE 2	SQ FT	50
UNDERGROUND CONDUIT, PVC, 1" DIA.	FOOT	80
UNDERGROUND CONDUIT, PVC, 11/4" DIA.	FOOT	2
UNDERGROUND CONDUIT, PVC, 11/2" DIA.	FOOT	111
UNDERGROUND CONDUIT, PVC, 2" DIA.	FOOT	206
UNDERGROUND CONDUIT, PVC, 21/2" DIA.	FOOT	95
UNDERGROUND CONDUIT, PVC, 3" DIA.	FOOT	220
UNDERGROUND CONDUIT, PVC, 4" DIA.	FOOT	87
UNDERGROUND CONDUIT, COILABLE NONMETALLIC CONDUIT, 11/2"	FOOT	350
HANDHOLE, PORTLAND CEMENT CONCRETE	EACH	3
DOUBLE HANDHOLE, PORTLAND CEMENT CONCRETE	EACH	1
GULFBOX JUNCTION, COMPOSITE CONCRETE	EACH	7
FULL-ACTUATED CONTROLLER AND TYPE IV CABINET	EACH	1
UNINTERRUPTABLE POWER SUPPLY, STANDARD	EACH	1
ELECTRIC CABLE IN CONDUIT, SIGNAL, NO. 14 2C	FOOT	1750
ELECTRIC CABLE IN CONDUIT, SIGNAL, NO. 14 3C	FOOT	150
ELECTRIC CABLE IN CONDUIT, SIGNAL, NO. 14 5C	FOOT	990
ELECTRIC CABLE IN CONDUIT, SIGNAL, NO. 14 7C	FOOT	2150
ELECTRIC CABLE IN CONDUIT, LEAD-IN, NO. 18 3 PAIR	FOOT	1660
ELECTRIC CABLE IN CONDUIT, SERVICE, NO. 3 IC	FOOT	785
ELECTRIC CABLE IN CONDUIT, EQUIPMENT GROUNDING CONDUCTOR, NO. 6 1C	FOOT	660
TRAFFIC SIGNAL POST, 10 FT.	EACH	3
TRAFFIC SIGNAL POST, 16 FT.	EACH	2
PEDESTRIAN PUSH-BUTTON POST, TYPE I	EACH	4
STEEL COMBINATION MAST ARM ASSEMBLY AND POLE 46 FT.	EACH	4
CONCRETE FOUNDATION, TYPE A	FOOT	15
CONCRETE FOUNDATION, TYPE C	FOOT	4
CONCRETE FOUNDATION, TYPE E 36-INCH DIAMETER	FOOT	60
SIGNAL HEAD, POLYCARBONATE, LED. 1-FACE, 3-SECTION, BRACKET MOUNTED	EACH	2
SIGNAL HEAD, POLYCARBONATE, LED. 1-FACE, 3-SECTION, MAST ARM MOUNTED	EACH	6
SIGNAL HEAD, POLYCARBONATE, LED, 1-FACE, 5-SECTION, BRACKET MOUNTED	EACH	2
SIGNAL HEAD, POLYCARBONATE, LED, 1-FACE, 5-SECTION, MAST ARM MOUNTED	EACH	4
SIGNAL HEAD, POLYCARBONATE, LED. 2-FACE, 1-3-SECTION, 1-5-SECTION, BRACKET MOUNTED	EACH	2
PEDESTRIAN SIGNAL HEAD, POLYCARBONATE, LED, 1-FACE, BRACKET MOUNTED WITH COUNTDOWN TIMER	EACH	8
TRAFFIC SIGNAL BACKPLATE	EACH	10
DETECTOR LOOP, TYPE I	FOOT	705
LIGHT DETECTOR	EACH	2
LIGHT DETECTOR AMPLIFIER	EACH	1
REMOVE EXISTING HANDHOLE	EACH	6
REMOVE EXISTING CONCRETE FOUNDATION	EACH	10
SERVICE INSTALLATION (SPECIAL)	EACH	1
REMOVE EXISTING JUNCTION BOX	EACH	2
ELECTRIC CABLE IN CONDUIT, NO. 20 3C, TWISTED, SHIELDED	FOOT	490
ACCESSIBLE PEDESTRIAN SIGNALS	EACH	8
VIBROTACTILE FEATURE	EACH	8
INDUCTIVE LOOP DETECTOR, RACK MOUNTED	EACH	10
REMOVE EXISTING TRAFFIC SIGNAL EQUIPMENT, SPECIAL	L SUM	1

#### TRAFFIC SIGNAL GENERAL NOTES

- 1. THE ACTUAL LOCATIONS OF ALL SIGNAL FOUNDATIONS, HANDHOLES, AND THE TRAFFIC SIGNAL CONTROLLER WILL BE VERIFIED IN THE FIELD BY THE ENGINEER.
- 2. POST MOUNTED SIGNAL HEADS SHALL BE INSTALLED SUCH THAT NO PART OF THE SIGNAL HEAD I WITHIN TWO (2) FEET OF THE FACE OF CURB. MAST ARM POLES SHALL BE PLACED SUCH THAT A MINIMUM DISTANCE OF SIX (6) FEET IS MAINTAINED BETWEEN THE CENTER OF THE POLE AND TH FACE OF CURB (NO THE MAST ARM SIDE) UNLESS OTHERWISE SHOWN ON THE PLANS.
- 3. BRACKET MOUNTED SIGNAL HEADS MOUNTED TO A LIGHT POLE SHALL BE MOUNTED WITH BLACK POLYCARBONATE BRACKETS FASTENED TO THE LIGHT POLE WITH BLACK STAINLESS STEEL BANDING THE TOP BRACKET SHALL BE SHIMMED AS REQUIRED FOR THE INSTALLATION.
- COMBINATION MAST ARM ASSEMBLIES SHALL BE FURNISHED WITH 15-FOOT LUMINAIRE ARMS WITH A MOUNTED LUMINAIRE HEIGHT OF 35 FEET.
- 5. ALL MAST ARM MOUNTED SIGNAL HEADS ON AN INDIVIDUAL MAST ARM SHALL BE MOUNTED SO THAT THE RED INDICATIONS ARE LEVEL WITH EACH OTHER UNLESS OTHERWISE DIRECTED BY THE ENGINEER.
- 6. 12" LENSES SHALL BE USED ON ALL SIGNAL FACES, LED INDICATIONS SHALL BE USED ON ALL SIGNAL HEADS AND PEDESITRIAN SIGNAL HEADS, PEDESTRIAN SIGNAL HEAD FACES SHALL BE SYMBOLS WITH COUNTDOWN TIMERS.
- 7. ACCESSIBLE PEDESTRIAN SIGNALS SHALL BE THE POLARA NAVIGATOR SYSTEM OR APPROVED EQUIVALENT.
- 8. THE LUMINAIRE ARM, LUMINAIRE POLE WIRING, LUMINAIRE, AND PHOTOCELL SHALL BE ERECTED WITH THE TRAFFIC SIGNAL MAST ARM POLE.
- 9. THE CONTRACTOR SHALL VERIFY THE EXACT LOCATION OF ALL UNDERGROUND UTILITIES PRIOR TO BEGINNING CONSTRUCTION.
- 10. NO ADDITIONAL COMPENSATION WILL BE ALLOWED FOR UNCOVERING OR HAND DIGGING AROUND UTILITIES.
- 11. NO ADDITIONAL COMPENSATION WILL BE ALLOWED FOR PLACING CONDUIT AT GREATER THAN 2 FOOT DEPTH.
- 12. A 1/4" POLYPROPYLENE PULL ROPE SHALL BE INSTALLED IN ALL CONDUIT RUNS EXCEEDING 20 FEET. A MINIMUM OF 2 FEET OF ROPE SHALL BE PROVIDED AT EACH END OF A CONDUIT RUN. THE ROPE SHALL BE INCLUDED IN THE COST OF THE RESPECTIVE CONDUIT PAY ITEM.
- I3. ALL ADAPTERS REQUIRED TO CONNECT THE PROPOSED CONDUIT TO THE EXISTING CONDUIT SHALL BE INCLUDED IN THE COST OF THE RESPECTIVE CONDUIT PAY ITEM.
- 14. THE CONTRACTOR SHALL BE RESPONSIBLE FOR OBTAINING ELECTRICAL SERVICE FOR THE TRAFFIC SIGNAL'S AND SHALL CONTACT THE UTILITY COMPANY AND THE CITY OF URBANA PRIOR TO COMMENCEMENT OF WOR FOR THE REQUIREMENTS FOR THE SERVICE INSTALLATION.
- 15. THE TRAFFIC SIGNAL CONTROLLER SHALL BE ORIENTED SUCH THAT INTERSECTION OPERATION AND
- 16. CONTROLLER PROGRAMMING OF SIGNAL TIMING WILL BE PROVIDED BY THE CITY OF URBANA.
- 17. THE CONFIRMATION BEACON SHALL BE INCLUDED IN THE COST OF THE LIGHT DETECTOR.
- 18. THE ELECTRIC CABLE FOR THE LIGHT DETECTOR SHALL BE A CONTINUOUS UNBROKEN RUN FROM THE LIGHT DETECTOR AMPLIFIER SPLICES IN THE CABLE SHALL NOT BE ALLOWED.
- 19. THE THREE SECTION AND FIVE SECTION SIGNAL HEADS THAT OPERATE TOGETHER IN THE SAME PHASE AT THE SAME LOCATION WILL BE COMBINED ON A SINGLE SEVEN CONDUCTOR CABLE. TWO PEDESTRIAN SIGNAL HEADS AT THE SAME LOCATION OR ON THE SAME SIGNAL HEADS AT THE SAME LOCATION OR ON THE SAME SIGNAL HEADS AT THE SAME LOCATION OR THE SAME SIGNAL HEAD SAME SIGNAL HEAD ON THE SAME SEVEN CONDUCTOR CABLE SPONT THE SAME SIGNAL HEAD ON PEDESTRIAN SIGNAL HEAD, WATERPROOF CABLE SPLICES SHALL BE ACCORDING TO ARTICLE BYSON OF THE STANDARD SPECIFICATIONS.
- 20. THE CONCRETE FOUNDATION FOR THE PEDESTRIAN PUSH-BUTTON POST SHALL BE INCLUDED IN THE COST OF THE PEDESTRIAN PUSH-BUTTON POST.
- 21. DETECTOR LOOPS SHALL BE INSTALLED AFTER CONSTRUCTION OF THE HMA SURFACE COURSE.
- 22. DISTURBED AREAS AROUND PROPOSED CONCRETE FOUNDATIONS SHALL BE BACKFILLED WITH CONTROLLED LOW-STRENGTH MATERIAL UNLESS OTHERWISE DIRECTED BY THE ENGINEER, THIS WORK SHALL BE INCLUDED IN THE COST OF THE CONCRETE FOUNDATION, AND NO ADDITIONAL COMPENSATION WILL BE ALLOWED.



PRO	POSED SIGN LOCATIONS
NO.	DESCRIPTION
P1	R10-11, R10-22
P4	R10-11, D3-1 (GOODWIN)
P5	R10-11
P8	R10-11, D3-1 (GREEN)
P10	R10-11
P11	R10-11, D3-1 (GREEN)
P12	R10-11, D3-1 (GOODWIN)
P15	R10-11, R10-22

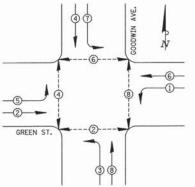

#### PHASE DESIGNATION DIAGRAM

#### PHASE DESIGNATION DIAGRAM LEGEND

DUAL ENTRY PHASE \* NUMBER REFERS TO ASSOCIATED PHASE

		-3-4==	ח				
	5)	7 =	  -	ф			* 2 3
× 3C 2" × 2C 2"	H6 1	P6	3	F	<u>0</u>	<del>9</del> <del>*</del> 9	P14 P14 P2 0
× 5C × 7C × 1C*6 CPND	2"/		P7 (2)10'	L	S (3) (2	1	
× 2C × 3C*20 T.S. × 5C × 7C × 3PR*18 L.I. 1 × 2C 1 × 7C 1 × 7C 1 × 7C 1 × 1C*6 GRND.	21/2"	P8	Q	-T	46'MA		X   X   X   X   X   X   X   X   X   X
- 41.1	H 3250	PT EXISTING			32	82 83	11/2" 2 × 3PR=18 L.I.
		3 × 1C*3 S	RVC. 2"	GO	ODWIN A	/ENUE	
			!	CAB	LE DIA	AGRAM	
			DETECTOR	LOOP	DATA		1
	NO.	SIZE	MODE	NO.	SIZE	MODE	
	11	6' × 6'	PRESENCE	51	6' x 6'	PRESENCE	
	12	6' x 6'	PRESENCE	52	6' × 6'	PRESENCE	
	21	6' x 6'	PULSE	61	6' x 6'	PULSE	
	00	01 01	DIII CC	00		DIII CE	

GOODWIN AVENUE

(5)

RR

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**国对**-3~

\$ + 0 × x-

11/2" 2 x 3PR\*18 L.I.

12

 BOND NEUTRAL TO GROUND AT SERVICE DISCONNECT

 $\mathbf{x}$ 

1

③ L.I.

T.S.

SRVC

11

11/2" [1 x 3PR=18 L.I.

61

62

 $2\frac{1}{2}$ " 1 × 7C 1 × 1C\*6 GRND.

CABLE DIAGRAM LEGEND

MAST ARM POLE, SIGNAL POST, PUSH-BUTTON POST, OR LIGHT POLE

EMERGENCY VEHICLE PREEMPTION DETECTOR

DETECTOR LOOP, TYPE I (WITH LOOP NO.)

DENOTES NUMBER OF CONDUCTORS ALL CABLE #14 EXCEPT AS INDICATED

LEAD-IN CABLE (TWISTED, SHIELDED)

ELECTRIC CABLE IN CONDUIT

SIGNAL FACE AND BACKPLATE

PEDESTRIAN SIGNAL FACE

CONFIRMATION BEACON

SERVICE INSTALLATION

TWISTED, SHIELDED

GROUNDING CABLE (GREEN)

NUMBER OF CABLES IN CONDUIT

SERVICE CABLE

CONTROLLER CABINET

DOUBLE HANDHOLE

GULFBOX JUNCTION

Y G \*

3C#20 T.S.

41 71

43 42 72

2 × 3PR\*18 L.I. 11/2"

1 × 7C 1 × 7C 1 × 1C\*6 GRND.

1 x 2C 2"

3 T.S.

7-2-0+4

1 × 2C 1 × 3C\*20 T.S. 21/2" 1 × 7C 1 × 1C\*6 GRND.

STREET

GREEN

22

21

1 × 3PR\*18 L.I. 11/2"/

2 x 3PR\*18 L.I. 11/2"

22	6' × 6'	PULSE	62	6' × 6'	PULSE
31	6' x 6'	PRESENCE	71	6' × 6'	PRESENCE
32	6' x 6'	PRESENCE	72	6' x 6'	PRESENCE
41	6' x 6'	PRESENCE	81	6' × 6'	PRESENCE
42	6' x 6'	PRESENCE	82	6' × 6'	PRESENCE
43	2' × 6' QUADRUPOLE	PRESENCE	83	2' × 6' QUADRUPOLE	PRESENCE
					3) = 10 AMPLIFIERS REQUIR ALL ON GREEN STREET.
		CUALL DE	IISED	IN BIKE I ANE	S AS SHOWN ON THE PLANS
NLE	SS OTHERWISE LENGTH OF TH	DIRECTED E	HE DI	ENGINEER. T	HE 6' DIMENSION SHALL BE TRAVEL. THE 2' DIMENSION DSS THE BIKE LANE.


EACH BIKE LANE LOOP SHALL USE THE REMAINING PAIR OF THE 3 PAIR LEAD-IN CABLE FOR THE ADJACENT VEHICLE LANE LOOPS BUT SHALL BE WIRED TO ITS OWN AMPLIFIER.

GOODWIN AVENUE & GREEN STREET
TRAFFIC SIGNAL PLANS
CABLE AND PHASE DESIGNATION DIAGRAMS / GENERAL NOTES / BILL OF MATERIALS
SCALE: NONE SHEET NO. 22 OF 31 SHEETS STA. TO STA. FED. 17


,	CONDUIT SIZE	100 M 10		
F.A.U. RTE.	SECTION	COUNTY	TOTAL	SHEET NO.
7175	12-00518-00-TL	CHAMPAIGN	31	22
	GOODWIN AVENUE	CONTRACT	NO. 91	483
EED BOA	D DIST NO THE INOIS FED	ATD PROJECT		77-7-


FILE NAME = p:\U0070070\_Urbana - Goodwin Green TCSP\Plans\sheets\12 traffic signals.dgn
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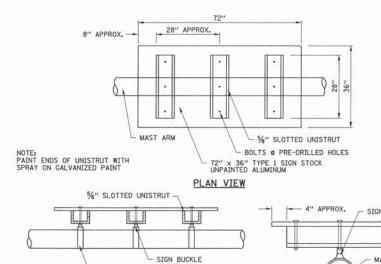
STATE OF ILLINOIS DEPARTMENT OF TRANSPORTATION

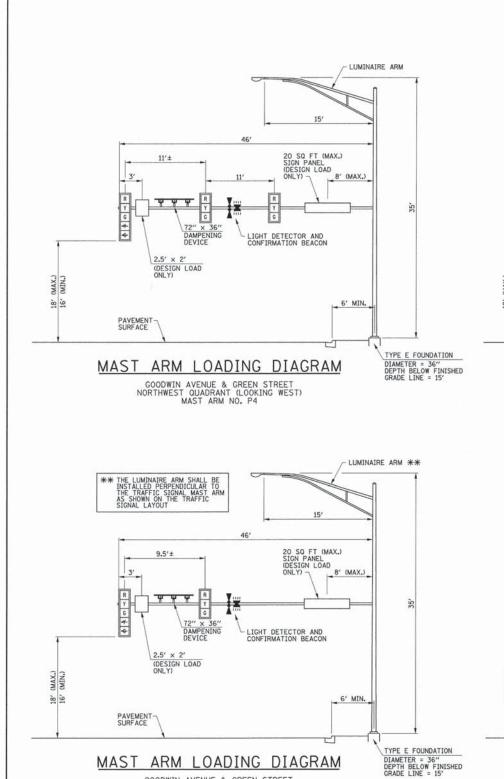

GOODWIN AVENUE & GREEN STREET SOUTHWEST QUADRANT (LOOKING SOUTH) MAST ARM NO. P8



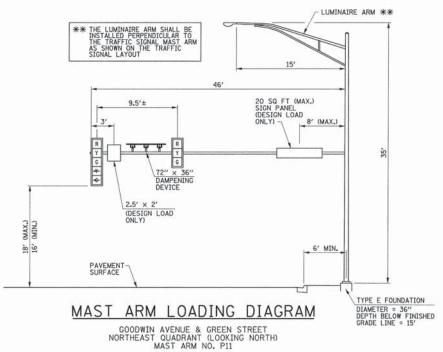

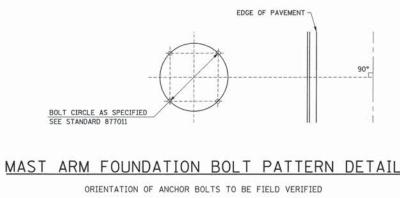

- SIGN BUCKLE - SIGN BUCKLE STAINLESS STEEL BANDING **ELEVATION** CROSS SECTION

MAST ARM MOUNTED DAMPENING DEVICE DETAIL

	15'	
	11'± 20 SQ FT (MAX.) SIGN PANEL	
	(DESIGN LOAD 8' (MAX.)	
	R V R R	35,
	6 72" × 36" OAMPENING	
1	DEVICE 2.5′ × 2′	
22	(DESIGN LOAD ONLY)	
18' (MAX.) 16' (MIN.)	. 6' MIN.	
	PAVEMENT - SURFACE	
		TYPE E FOUNDATIO
	MAST ARM LOADING DIAGRAM	DIAMETER = 36" DEPTH BELOW FINI: GRADE LINE = 15'

PHOTOCELL CONTROL

FILE NAME = PLOT DATE = 4/22/2013 8:57:36 PM

DESIGNED - A.E.A./J.A.J. REVISED -DRAWN - A.E.A. REVISED CHECKED - S.M.W. REVISED DATE 04/2013 REVISED


STATE OF ILLINOIS DEPARTMENT OF TRANSPORTATION


GOODWIN AVENUE & GREEN STREET TRAFFIC SIGNAL PLANS TRAFFIC SIGNAL DETAILS SCALE : NONE SHEET NO. 23 OF 31 SHEETS STA.

COUNTY TOTAL SHEETS NO.


CHAMPAIGN 31 23 SECTION 12-00518-00-TL CONTRACT NO. 91483 GOODWIN AVENUE FED. ROAD DIST. NO. | ILLINOIS | FED. AID PROJECT

- LUMINAIRE ARM

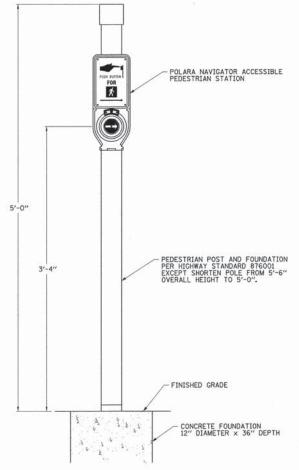

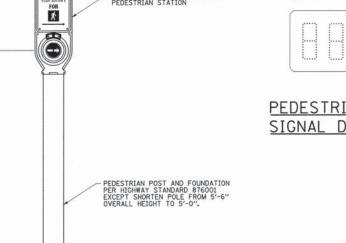

PEDESTRIAN PUSH-BUTTON POST DETAIL

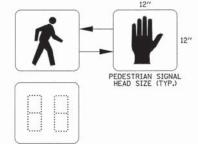


PEDESTRIAN COUNTDOWN SIGNAL DISPLAY DETAIL




THE PEDESTRIAN PUSH-BUTTON SIGNS SHALL BE INCLUDED IN THE COST OF THE ACCESSIBLE PEDESTRIAN SIGNALS.

PEDESTRIAN PUSH-BUTTON SIGN DETAIL

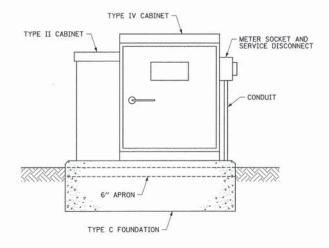

UPS BATTERY CABINET MOUNTING DETAIL

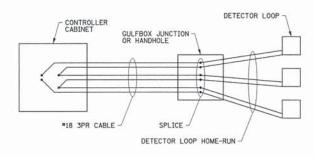

DETECTOR LOOP WIRING DETAIL

WIRED IN SERIES WITH MULTI-PAIR CABLE



#### MAST ARM MOUNTED STREET NAME SIGN DETAILS

TEXT: 12" UPPERCASE, 9" LOWERCASE, SERIES B TYPE A SHEETING REQUIRED COLORS:

WHITE (RETROREFLECTIVE) LEGEND: BORDER: WHITE (RETROREFLECTIVE) BACKGROUND: GREEN (RETROREFLECTIVE)







REGULATORY SIGN DETAILS


FILE NAME = p:\U0070070\_Urbana - Goodwin Green TCSP\Plans\sheets\12 traffic signals.dgn PLOT DATE =

DESIGNED - A.E.A./J.A.J. REVISED -DRAWN - A.E.A. REVISED -CHECKED - S.M.W. REVISED DATE - 04/2013 REVISED

STATE OF ILLINOIS DEPARTMENT OF TRANSPORTATION

GOODWIN AVENUE & GREEN STREET TRAFFIC SIGNAL PLANS TRAFFIC SIGNAL DETAILS SHEET NO. 24 OF 31 SHEETS STA. SCALE : NONE

COUNTY TOTAL SHEET NO. CHAMPAIGN 31 24 SECTION 12-00518-00-TL CHAMPAIGN 31 CONTRACT NO. 91483 GOODWIN AVENUE

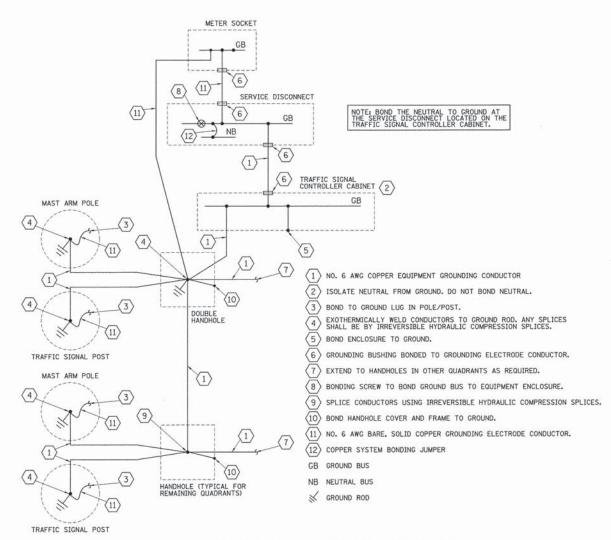


#### TRAFFIC SIGNAL GROUNDING DIAGRAM


ALL WIRES SHALL BE NO. 6 AWG STRANDED COPPER CONDUCTORS WITH XLP INSULATION UNLESS OTHERWISE INDICATED. THE INSULATION COLOR SHALL BE GREEN.

PANELBOARD TRAFFIC SIGNAL VOLTAGE 120/240		L MAIN_ BUS RATING			M.L.O. 60 AMPS			LOCATION: 500+42.0. 60.0' RT					
													PHASE/WIRE 1PH/3W
DESCRIPTION	CKT	LOAD	(VA)	AMPS/	CKT. BKR.	CKT.	AMPS/ POLES		(VA)		DESCRIPTION		
DESCRIPTION	NO.	Α	В	POLES		BKR.		Α	В	NO.	DESCRIPTION		
TRAFFIC SIGNAL EQUIPMENT	1	3500		40/1	-00	+00	20/2	610		2	STREET LIGHTING		
CONTROL EQUIPMENT			800	10/1	-0-	-	20/2		610	4	CIRCUIT B		
STREET LIGHTING	5	535		20/2	100 HO	10/1	300		6	PHOTOCELL			
CIRCUIT A	7	535							8	SPACE			
SUBTOTAL "A"		4035						910					
SUBTOTAL "B"			1335					V//////	610				

#### TRAFFIC SIGNAL CONTROLLER PANELBOARD SCHEDULE

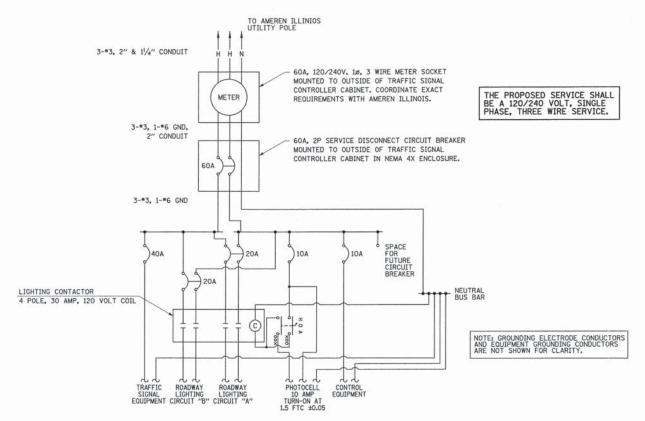


#### TRAFFIC SIGNAL CONTROLLER INSTALLATION DIAGRAM

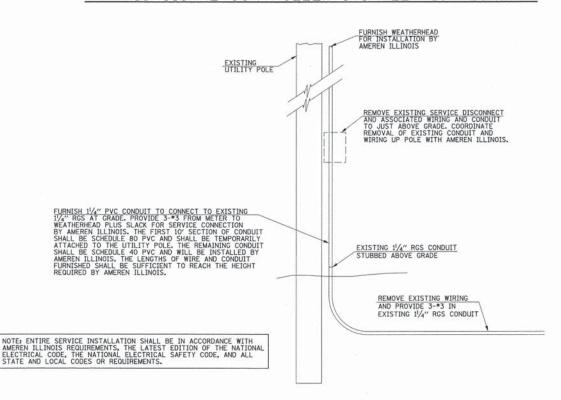

#### SERVICE INSTALLATION (SPECIAL) DIAGRAM

FILE NAME = p:\U0070070_Urbana - Goodwin Green TCSP\Ptans\sheets\12 traffic signals.dgn  PLOT DATE = 4/22/2013 8:57:39 PM	DESIGNED - M.L.S.	REVISED -			GOODWIN AVENUE & GREEN STREET	F.A.U. RTE.	SECTION	COUNTY TOTAL SH
	DRAWN - J.A.J. REVISED - CHECKED - C.E.C. REVISED -	STATE OF ILLINOIS	TRAFFIC SIGNAL PLANS			7175 12-00518-00-TL	CHAMPAIGN 31 2	
		REVISED -	DEPARTMENT OF TRANSPORTATION	TRAFFIC SIGNAL DETAILS			GOODWIN AVENUE	CONTRACT NO. 91483
	DATE - 04/2013	REVISED -		SCALE : NONE	SHEET NO. 25 OF 31 SHEETS STA. TO STA.	FED. ROAD	DIST. NO. ILLINOIS FEE	D. AID PROJECT

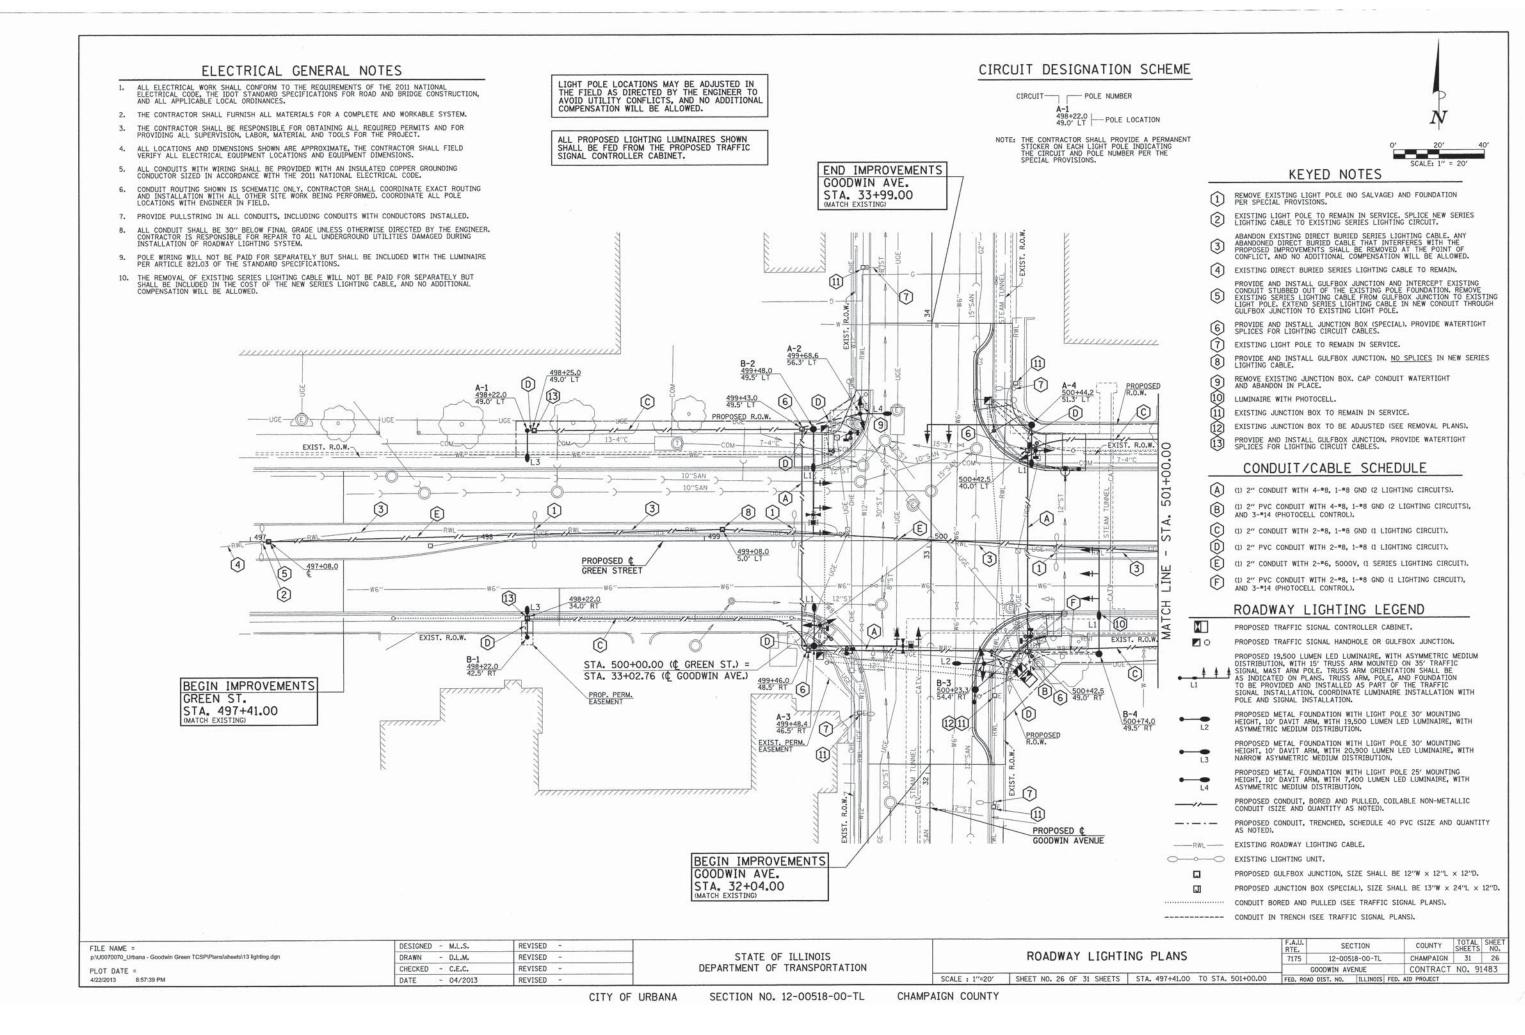

#### CIRCUIT DESIGNATION SCHEME

CIRCUIT POLE NUMBER

A-1


498+22.0


49.0' LT POLE LOCATION

NOTE: THE CONTRACTOR SHALL PROVIDE A PERMANENT STICKER ON EACH LIGHT POLE INDICATING THE CIRCUIT AND POLE NUMBER PER THE SPECIAL PROVISIONS.

LIGHT POLE LOCATIONS MAY BE ADJUSTED IN THE FIELD AS DIRECTED BY THE ENGINEER TO AVOID UTILITY CONFLICTS, AND NO ADDITIONAL COMPENSATION WILL BE ALLOWED.

ALL PROPOSED LIGHTING LUMINAIRES SHOWN SHALL BE FED FROM THE PROPOSED TRAFFIC SIGNAL CONTROLLER CABINET.

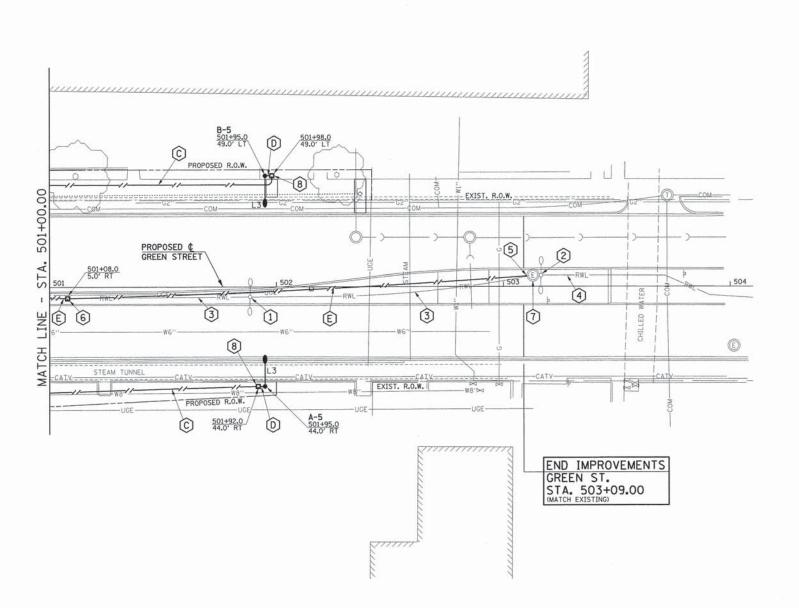

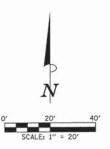

#### KEYED NOTES

- REMOVE EXISTING LIGHT POLE (NO SALVAGE) AND FOUNDATION PER SPECIAL PROVISIONS.
- 2 EXISTING LIGHT POLE TO REMAIN IN SERVICE, SPLICE NEW SERIES LIGHTING CABLE TO EXISTING SERIES LIGHTING CIRCUIT.
- ABANDON EXISTING DIRECT BURIED SERIES LIGHTING CABLE. ANY ABANDONED DIRECT BURIED CABLE THAT INTERFERES WITH THE PROPOSED IMPROVEMENTS SHALL BE REMOVED AT THE POINT OF CAUSE OF THE POINT OF CAUSE OF THE POINT OF CAUSE OF THE POINT OF THE P
- 4 EXISTING DIRECT BURIED SERIES LIGHTING CABLE TO REMAIN.
- REMOVE EXISTING SERIES LIGHTING CABLE FROM EXISTING MANHOLE TO EXISTING LIGHT POLE. TERMINATE NEW CONDUIT AT EXISTING MANHOLE. PROVIDE A WATERTIGHT SEAL AROUND CONDUIT PENETRATION, EXTEND SERIES LIGHTING CABLE FROM EXISTING MANHOLE TO EXISTING LIGHT POLE.
- 6 PROVIDE AND INSTALL GULFBOX JUNCTION. NO SPLICES IN NEW SERIES LIGHTING CABLE.
- (7) EXISTING MANHOLE TO REMAIN IN SERVICE.
- B PROVIDE AND INSTALL GULFBOX JUNCTION. PROVIDE WATERTIGHT SPLICES FOR LIGHTING CIRCUIT CABLES.

#### CONDUIT/CABLE SCHEDULE

- C (1) 2" CONDUIT WITH 2-\*8, 1-\*8 GND (1 LIGHTING CIRCUITS).
- (1) 2" PVC CONDUIT WITH 2-\*8, 1-\*8 GND (1 LIGHTING CIRCUITS).
- E (1) 2" CONDUIT WITH 2-06, 5000V, (1 SERIES LIGHTING CIRCUIT).

#### ROADWAY LIGHTING LEGEND

- PROPOSED TRAFFIC SIGNAL CONTROLLER CABINET.
- O PROPOSED TRAFFIC SIGNAL HANDHOLE OR GULFBOX JUNCTION.
- PROPOSED 19,500 LUMEN LED LUMINAIRE, WITH ASYMMETRIC MEDIUM DISTRIBUTION, WITH 15' TRUSS ARM MOUNTED ON 35' TRAFFIC SIGNAL MAST ARM POLE. TRUSS ARM ORIENTATION SHALL BE AS DICCATED ON PLANS, TRUSS ARM, POLE, AND FOUNDATION TO BE PROVIDED AND INSTALLED AS PART OF THE TRAFFIC SIGNAL INSTALLATION, CORDINATE LUMINAIRE INSTALLATION WITH POLE AND SIGNAL INSTALLATION.
- PROPOSED METAL FOUNDATION WITH LIGHT POLE 30' MOUNTING
  HEIGHT, 10' DAVIT ARM, WITH 19,500 LUMEN LED LUMINAIRE, WITH
  ASYMMETRIC MEDIUM DISTRIBUTION.
  - PROPOSED METAL FOUNDATION WITH LIGHT POLE 30' MOUNTING HEIGHT, 10' DAVIT ARM, WITH 20,900 LUMEN LED LUMINAIRE, WITH
  - PROPOSED METAL FOUNDATION WITH LIGHT POLE 25' MOUNTING HEIGHT, 10' DAVIT ARM, WITH 7,400 LUMEN LED LUMINAIRE, WITH ASYMMETRIC MEDIUM DISTRIBUTION.
  - PROPOSED CONDUIT, BORED AND PULLED, COILABLE NON-METALLIC CONDUIT (SIZE AND QUANTITY AS NOTED).
- PROPOSED CONDUIT, TRENCHED, SCHEDULE 40 PVC (SIZE AND QUANTITY AS NOTED).
- -----RWL----- EXISTING ROADWAY LIGHTING CABLE.
  - EXISTING LIGHTING UNIT.
- PROPOSED GULFBOX JUNCTION, SIZE SHALL BE 12"W x 12"L x 12"D.
- PROPOSED JUNCTION BOX (SPECIAL), SIZE SHALL BE 13"W  $\times$  24"L  $\times$  12"D.
- ..... CONDUIT BORED AND PULLED (SEE TRAFFIC SIGNAL PLANS).

----- CONDUIT IN TRENCH (SEE TRAFFIC SIGNAL PLANS).

FILE NAME = p:\U0070070\_Urbana - Goodwin Green TCSP\Plans\sheets\13 lighting.dgn
PLOT DATE =

4/22/2013

STATE OF ILLINOIS
DEPARTMENT OF TRANSPORTATION


ROADWAY LIGHTING PLANS


SCALE: 1"=20" SHEET NO. 27 OF 31 SHEETS STA. 501+00.00 TO STA. 503+09.00

LU. SECTION COUNTY TOTAL SHEE NO. 75 12-00518-00-TL CHAMPAIGN 31 27 GOODWIN AVENUE CONTRACT NO. 91483


AID PROJECT

	SUMMARY OF ROADWAY LIGHTING QUAN	VTITIES	S
CODE NO.	ITEM	UNIT	QUANTITY
81028350	UNDERGROUND CONDUIT, PVC, 2" DIA.	FOOT	106
81028750	UNDERGROUND CONDUIT, COILABLE NONMETALLIC CONDUIT, 2" DIA.	FOOT	1432
81500100	GULFBOX JUNCTION	EACH	7
81702101	ELECTRIC CABLE IN CONDUIT, 600V (XLP-TYPE USE) 1/C NO. 14	FOOT	320
81702120	ELECTRIC CABLE IN CONDUIT, 600V (XLP-TYPE USE) 1/C NO. 8	FOOT	5050
83000400	LIGHT POLE, ALUMINUM, 30 FT. M.H., 10 FT. DAVIT ARM	EACH	5
84200600	REMOVAL OF LIGHTING UNIT, NO SALVAGE	EACH	4
84200804	REMOVAL OF POLE FOUNDATION	EACH	4
X8130110	JUNCTION BOX (SPECIAL)	EACH	4
X8130125	REMOVE EXISTING JUNCTION BOX	EACH	1
X8300001	LIGHT POLE, SPECIAL	EACH	1
X8360120	LIGHT POLE FOUNDATION, SPECIAL	EACH	6
XX007797	LUMINAIRE (SPECIAL)	EACH	1
XX008068	LUMINAIRE INSTALLATION, TYPE 1	EACH	5
XX008069	LUMINAIRE INSTALLATION, TYPE 2	EACH	4
XX008608	CABLE, SPECIAL	FOOT	1250

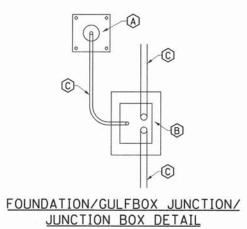

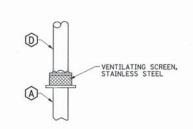

#### POLE/FOUNDATION DETAIL

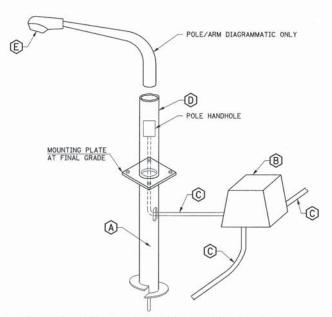


#### POLE/LUMINAIRE INSTALLATION DETAIL

#### KEYED NOTES


- (A) METAL FOUNDATION IN ACCORDANCE WITH STANDARD 836001 AND THE SPECIAL PROVISIONS.
- B GULFBOX JUNCTION OR JUNCTION BOX (SPECIAL) AS SHOWN ON THE PLANS.
- C CONDUIT AND CABLE AS SHOWN ON THE PLANS.
- D ALUMINUM LIGHT POLE AS SHOWN ON THE PLANS.
- E LED LUMINAIRE AS SHOWN ON THE PLANS.

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p:\U0070070_Urbana - Goodwin Green TCSP\Plans\sheets\13 lighting.dgn	DRAWN - D.L.M.	DRAWN - D.L.M. REVISED -	STATE OF ILLINOIS	ROADWAY LIGHTING PLANS	7175 12-00518-00-TL	CHAMPAIGN 31 28
PLOT DATE =	CHECKED - C.E.C.	REVISED -	DEPARTMENT OF TRANSPORTATION		GOODWIN AVENUE	CONTRACT NO. 91483
4/22/2013 8:57:40 PM	DATE - 04/2013	REVISED -		SCALE : NONE   SHEET NO. 28 OF 31 SHEETS   STA. TO STA.	FED. ROAD DIST. NO.   ILLINOIS   FED.	. AID PROJECT

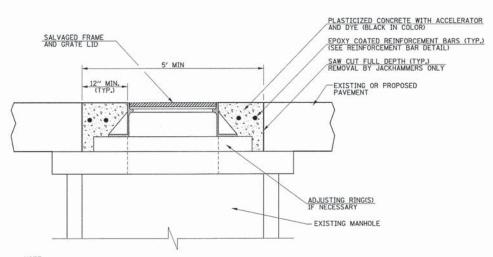


THIS WORK WILL BE PAID FOR AT THE CONTRACT UNIT PRICE EACH FOR MANHOLES TO BE ADJUSTED (SPECIAL), WHICH PRICE SHALL INCLUDE ALL LABOR, MATERIAL, AND EQUIPMENT NECESSARY TO COMPLETE THE WORK, INCLUDING SAW CUTTING, PAVEMENT REMOVAL, EXCAVATION, ADJUSTING RINGS, PLACEMENT OF THE SALVAGED FRAME AND LID, AND PLACEMENT OF THE PLASTICIZED BLACK CONCRETE PATCH WITH REINFORCEMENT BARS. SEE THE TEMPORARY PAVEMENT PATCH DETAIL AND THE SPECIAL PROVISIONS FOR ADDITIONAL INFORMATION.

#### MANHOLE ADJUSTMENT DETAIL WITHIN PAVEMENT AREAS

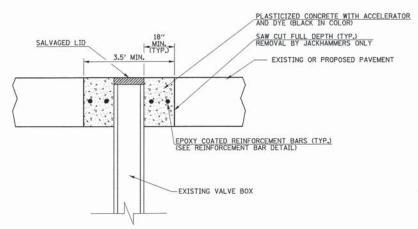

THIS WORK WILL BE PAID FOR AT THE CONTRACT UNIT PRICE EACH FOR VALVE BOXES TO BE ADJUSTED (SPECIAL), WHICH PRICE SHALL INCLUDE ALL LABOR, MATERIAL, AND COUPPMENT NECESSARY TO COMPLETE THE WORK, INCLUDING SAW CUTTING, PAYEMENT REMOVAL, EXCAVATION, ADJUSTMENT OF THE VALVE BOX, AND PLACEMENT OF THE PLASTICIZED BLACK CONCRETE PATCH WITH REINFORCEMENT BARS. SEE THE TEMPORARY PAVEMENT PATCH DETAIL AND THE SPECIAL PROVISIONS FOR ADDITIONAL INFORMATION.


#### VALVE BOX ADJUSTMENT DETAIL WITHIN PAVEMENT AREAS

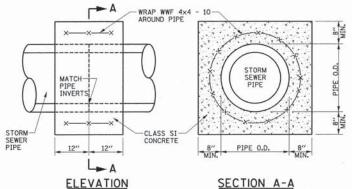

**ELEVATION** 


NOIE:
THE CONCRETE COLLARS SHALL BE UTILIZED WHERE CONNECTING STORM
SEWERS OF DIFFERENT TYPES OR AS DIRECTED BY THE ENGINEER. THE
COST OF CONSTRUCTING THE CONCRETE COLLARS WITH WELDED WIRE
FABRIC WILL BE PAID FOR AT THE CONTRACT UNIT PRICE PER CUBIC
YARD FOR CONCRETE COLLAR.

#### CONCRETE COLLAR DETAIL

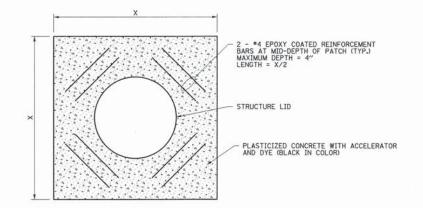

- 1. THE REINFORCEMENT BARS SHALL BE EPOXY COATED.
- THE REINFORCEMENT BARS SHALL BE INCLUDED IN THE COST OF THE MANHOLE ADJUSTMENT OR VALVE BOX ADJUSTMENT.
- THE MINIMUM CLEARANCE BETWEEN REINFORCEMENT BARS, CASTINGS, VALVE BOXES, AND PATCH EDGES SHALL BE 3 INCHES.

#### REINFORCEMENT BAR DETAIL

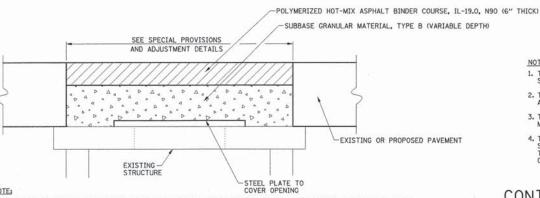

THIS DETAIL IS FOR THE TEMPORARY PAVEMENT PATCHES ABOVE STRUCTURES TO BE ADJUSTED IN PAVEMENT AREAS. THE TEMPORARY PAVEMENT PATCHES ARE REQUIRED UNTIL THE CASTINGS OR BOXES ARE ADJUSTED TO GRADE AFTER THE HAM RESURFACING IS COMPLETE AND THE PERMANENT CONCRETE PAVEMENT PATCHES ARE CONSTRUCTED. FURNISHING AND INSTALLING THE STEEL PLATE AND TEMPORARY PAVEMENT PATCHES, INCLUDING ALL POLYMERIZED HOT-MIX ASPHALT BINDER COURSE AND SUBBASE GRANULAR MATERIAL, SHALL BE INCLUDED IN THE STRUCTURE TO BE ADJUSTED, AND NO ADDITIONAL COMPENSATION WILL BE ALLOWED. SEE THE SPECIAL PROVISIONS FOR ADDITIONAL INFORMATION.

### TEMPORARY PAVEMENT PATCH DETAIL

COUNTY TOTAL SHEETS NO.
CHAMPAIGN 31 29 DESIGNED - J.A.J. REVISED SECTION FILE NAME = STATE OF ILLINOIS MISCELLANEOUS DETAILS DRAWN - D.L.M. REVISED DEPARTMENT OF TRANSPORTATION PLOT DATE = CHECKED - S.M.W. REVISED GOODWIN AVENUE CONTRACT NO. 91483 4/22/2013 8:57:40 PM 04/2013 REVISED SCALE : NONE SHEET NO. 29 OF 31 SHEETS STA. TO STA.

### SEE THE ROADWAY PLANS FOR THE LOCATION AND ELEVATION OF THE FRAMES AND GRATES. 2. THIS DETAIL IS APPLICABLE FOR PROPOSED TYPE 11 FRAMES AND GRATES PLACED WITHIN COMBINATION CONCRETE CURB AND GUTTER, TYPE 8-6.12 (SPECIAL). 3. THE TOP OF FRAME ELEVATIONS SHOWN ON THE ROADWAY PLANS ARE 0.02' LOWER THAN THE ADJACENT PROPOSED EDGE OF PAVEMENT ELEVATIONS FOR HMA PAVEMENT.

4. SEE STANDARD 604051 FOR ADDITIONAL INFORMATION.


CONCRETE FILLET ALL-INSIDE CORNER VOIDS

NOTES:

TOP OF FRAME ELEVATION AS SHOWN ON THE ROADWAY PLANS

PROPOSED TYPE 11 FRAME AND GRATE

#### TYPE 11 FRAME AND GRATE DETAIL

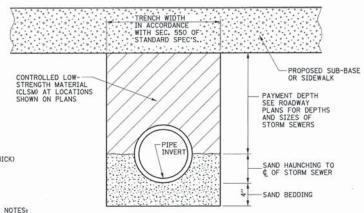


- THE CLSM SHALL BE PLACED IN LIFTS AS DESCRIBED IN SECTION 593 OF THE STANDARD SPECIFICATIONS.
- THE APPLICABLE ARTICLES OF SECTION 550 OF THE STANDARD SPECIFICATIONS SHALL APPLY FOR EXCAVATION, BEDDING, AND INSTALLATION OF STORM SEWERS.
- THE SAND BEDDING AND HAUNCHING SHALL BE INCLUDED IN THE COST OF THE PIPE MATERIAL, AND NO ADDITIONAL COMPENSATION WILL BE ALLOWED.
- 4. THE CLSM WILL BE PAID FOR IN ACCORDANCE WITH SECTION 593 OF THE STANDARD SPECIFICATIONS AND INCLUDES PAYMENT FOR THE MATERIAL AS SHOWN ON THE DETAIL. THE QUANTITIES SHOWN ON THE PLANS ARE BASED ON A DEPTH MEASURED FROM THE CENTERLINE OF THE PIPE TO THE BOTTOM LIMITS OF THE PROPOSED SUB-BASE OR SIDEWALK.

### CONTROLLED LOW-STRENGTH MATERIAL DETAIL

CITY OF URBANA

SECTION NO. 12-00518-00-TL

CHAMPAIGN COUNTY

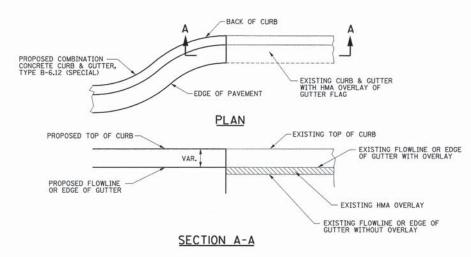


#### NOTES:

- 1. THE PROPOSED HMA OVERLY WILL BE 1/4" HIGHER THAN THE PROPOSED EDGE OF GUTTER.
- THE PROPOSED GUTTER FLAG SHALL NOT HAVE AN OVERLAY.
- 3. WHERE THE PROPOSED CURB AND GUTTER MEETS THE EXISTING CURB AND GUTTER. THE PROPOSED OVERLAY OF THE EXISTING GUTTER FLAG SHALL BE TRANSITIONED TO MATCH THE PROPOSED GUTTER FLAG WITHOUT OVERLAY AS DIRECTED BY THE ENGINEER.

### GUTTER FLAG DETAIL

EXISTING GUTTER FLAG WITH HMA OVERLAY AND PROPOSED GUTTER FLAG WITHOUT HMA OVERLAY

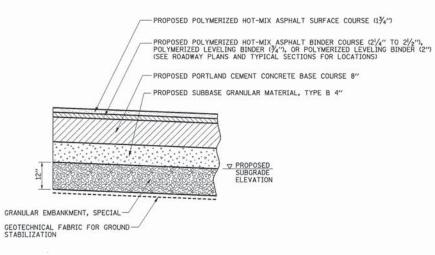

#### NOTES:

- 1. THIS WORK SHALL BE CONSTRUCTED AT LOCATIONS AS DIRECTED BY THE ENGINEER, SEE PROPOSED TYPICAL SECTION NOTE 13 FOR ADDITIONAL INFORMATION.
- 2. THIS WORK SHALL BE IN ACCORDANCE WITH SECTION 210 OF THE STANDARD SPECIFICATIONS. THE GRANULAR EMBANKMENT, SPECIAL WILL BE PAID FOR AT THE CONTRACT UNIT PRICE PER TON. THE GEOTECHNICAL FABRIC FOR GROUND STABILIZATION WILL BE PAID FOR AT THE CONTRACT UNIT PRICE PER SQUARE YARD. THE EARTH REMOVAL BELOW THE PROPOSED SUBGRADE ELEVATION LINE WILL BE PAID FOR AT THE CONTRACT UNIT PRICE PER CUBIC YARD FOR REMOVAL AND DISPOSAL OF UNSUITABLE MATERIAL.

#### SUBGRADE REMOVAL AND REPLACEMENT DETAIL

DESIGNED - J.A.J. REVISED FILE NAME = p:\U0070070\_Urbana - Goodwin Green TCSP\Plans\sheets\14 misc details.dgn DRAWN - D.I.M. REVISED CHECKED - S.M.W. REVISED PLOT DATE = 4/22/2013 8:57:40 PM REVISED


STATE OF ILLINOIS DEPARTMENT OF TRANSPORTATION

MISCELLANEOUS DETAILS 7175 SHEET NO. 30 OF 31 SHEETS STA. FED. ROAD DIST. NO. | ILLINOIS | FED. AID PROJECT

## VARIES -P.C. CONCRETE SIDEWALK 2% MAX. CONCRETE CURB CONSTRUCTED MONOLITHIC WITH SIDEWALK

THIS WORK WILL BE PAID FOR AS P.C. CONC. SIDEWALK 6", AT THE CONTRACT UNIT PRICE PER SOUARE FOOT OF TOP SURFACE AREA INCLUDING THE TOP SURFACE AREA OF THE CURB. THE COST OF CONSTRUCTING THE CURB TO THE HEIGHT SHOWN SHALL BE INCLUDED IN THE COST OF THE SIDEWALK.

#### SIDEWALK MONOLITHIC CURB DETAIL

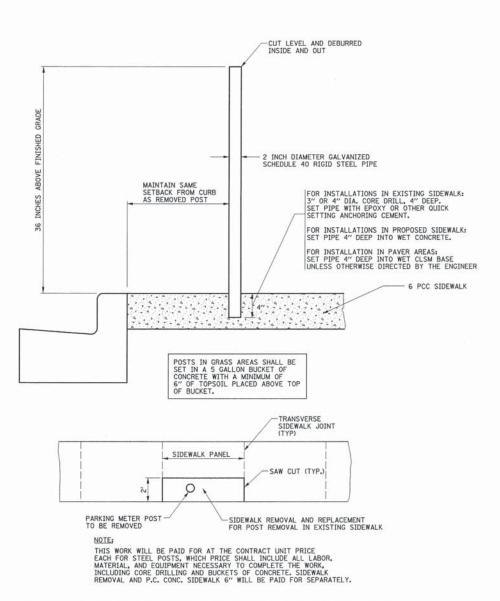

#### PARKING METER POST INSTALLATION DETAIL


COUNTY TOTAL SHEETS NO. CHAMPAIGN 31 30

CONTRACT NO. 91483

SECTION


12-00518-00-TL

GOODWIN AVENUE

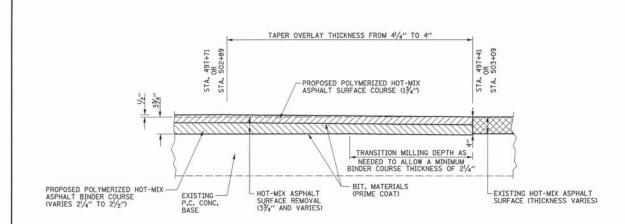


NOTE:
THIS WORK WILL NOT BE PAID FOR SEPARATELY BUT SHALL BE INCLUDED IN THE COST OF THE VARIOUS HOT-MIX ASPHALT SURFACE REMOVAL AND HOT-MIX ASPHALT PAY ITEMS, AND NO ADDITIONAL COMPENSATION WILL BE ALLOWED.

## HOT-MIX ASPHALT RUN DOWN DETAIL STA. 497+41 TO STA. 497+71 AND STA. 502+89 TO STA. 503+09

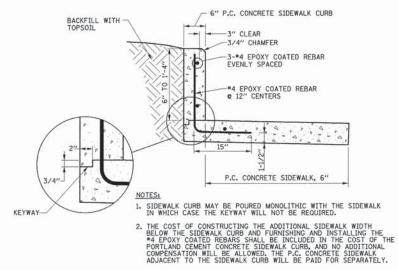

# PORTLAND CEMENT CONCRETE SIDEWALK CURB DETAIL

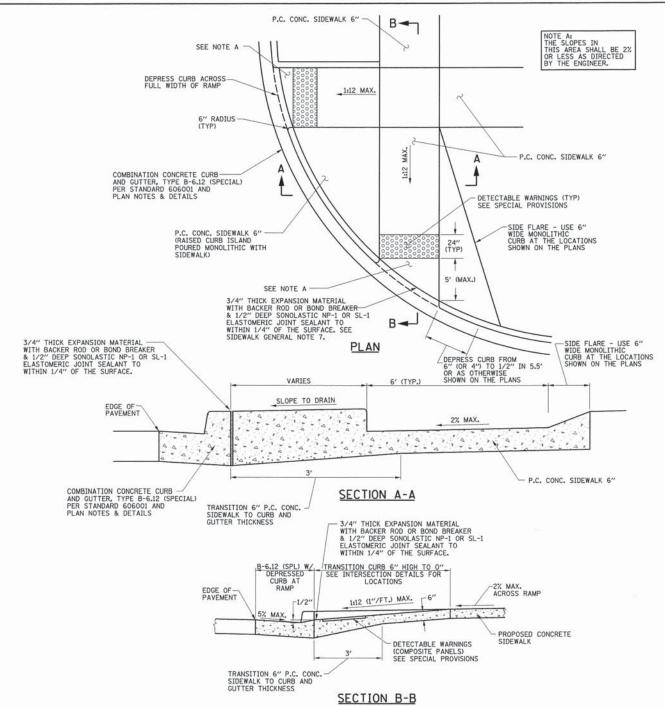

#### NOTES

- 1. THE COST OF CONSTRUCTING THE DEPRESSED CURB AS SHOWN SHALL BE INCLUDED IN THE COST OF CONSTRUCTING THE COMBINATION CONCRETE CURB AND GUTTER, TYPE B-6.12 (SPECIAL), AND NO ADDITIONAL COMPENSATION WILL BE ALLOWED.
- 2. THE COST OF FURNISHING AND INSTALLING THE 3/4" EXPANSION JOINTS AND THE COST OF CONSTRUCTING THE P.C. CONC. SIDEWALK THICKNESS TRANSITION, INCLUDING THE ADJACENT CURBING AS SHOWN, SHALL BE INCLUDED IN THE COST OF CONSTRUCTING THE PORTLAND CEMENT CONCRETE SIDEWALK 6 INCH, AND NO ADDITIONAL COMPENSATION WILL BE ALLOWED.
- 3. THE DETECTABLE WARNINGS SHALL HAVE A CONTRASTING COLOR APPROVED BY THE ENGINEER AND SHALL BE CONSTRUCTED IN ACCORDANCE WITH STANDARD 424001 AND THE STANDARD SPECIFICATIONS, THE DETECTABLE WARNINGS WILL BE PAID FOR AT THE CONTRACT UNIT PRICE PER SQUARE FOOT FOR DETECTABLE WARNINGS.
- 4. THE SIDEWALK CURB RAMP BELOW THE DETECTABLE WARNING PANELS SHALL BE A MINIMUM OF 6" THICK.
- 5. SEE THE STANDARD SPECIFICATIONS FOR ADDITIONAL SIDEWALK JOINT INFORMATION.
- 6. ALL EXPANSION JOINTS IN THE SIDEWALK SHALL BE SEALED. THE JOINT SEALANT SHALL BE SONOLASTIC NP-1 OR SL-1 ELASTOMERIC JOINT SEALANT MANUFACTURED BY SONNEBORN OR AN EQUIVALENT APPROVED ELASTOMERIC SEALANT. EXPANSION JOINTS SHALL BE SEALED TO WITHIN 1/4" OF THE FINISHED SURFACE.
- 7. EXPANSION JOINTS SHALL BE USED BETWEEN THE CURB AND GUTTER AND THE SIDEWALK. EXPANSION JOINTS SHALL BE USED AT OTHER LOCATIONS AS DIRECTED BY THE ENGINEER.

#### SIDEWALK CURB RAMP DETAIL

COUNTY TOTAL SHEE DESIGNED - J.A.J. REVISED FILE NAME = SECTION STATE OF ILLINOIS MISCELLANEOUS DETAILS p:\U0070070 Urbana - Goodwin Green TCSP\Plans\sheets\14 misc details.dgn DRAWN - D.I.M. REVISED CHAMPAIGN 31 31 12-00518-00-TL CHECKED - S.M.W. REVISED DEPARTMENT OF TRANSPORTATION CONTRACT NO. 91483 PLOT DATE = GOODWIN AVENUE 8:57:40 PM SHEET NO. 31 OF 31 SHEETS STA. DATE - 04/2013 REVISED SCALE : NONE FED. ROAD DIST. NO. | ILLINOIS | FED. AID PROJECT