08-02-13 LETTING ITEM 039

INDEX OF SHEETS

- 1. COVER SHEET, INDEX OF SHEETS
- 2. GENERAL NOTES & STATE STANDARDS
- 3. SUMMARY OF QUANTITIES
- 4. TYPICAL SECTIONS
- 5. DEMOLITION PLAN WAVERLY AVENUE
- 6. DEMOLITION PLAN SUMMIT STREET

SUMMIT ADT = 1,100 VPD

WAVERLY ADT = 700 VPD POSTED SPEED LIMIT = 25 MPH

ROAD CLASSIFICATION = LOCAL ROADWAY

- 7-8. SITE PLAN WAVERLY AVENUE
- 9. SITE PLAN SUMMIT STREET

10-12. DETAILS


STATE OF ILLINOIS
DEPARTMENT OF TRANSPORTATION
DIVISION OF HIGHWAYS


PLANS FOR PROPOSED FEDERAL AID HIGHWAY

WAVERLY ROAD: EXMOOR AVE TO 130' WEST OF PROSPECT SUMMIT STREET: SOUTH STREET TO ILLINOIS AVE SAFE ROUTE TO SCHOOLS

SECTION: 10-00086-00-SW PROJECT NO. SRTS-4009(011)

VILLAGE OF BARRINGTON LAKE COUNTY & COOK COUNTY JOB NO. C-40-002-10

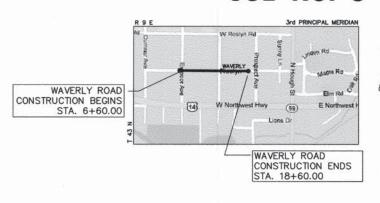

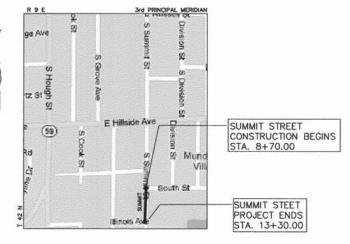


LOCATION MAP

(NOT TO SCALE)

PROJECT INFORMATION

GROSS AND NET LENGTH = 1,660 FT = 0.314 MI

FULL SIZE PLANS HAVE BEEN PREPARED USING STANDARD ENGINEERING SCALES. REDUCED SIZED PLANS WILL NOT CONFORM TO STANDARD SCALES. IN MAKING MEASUREMENTS ON REDUCED PLANS, THE BELOW SCALES MAY BF USED.

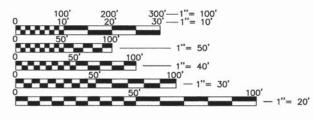

CONTRACT NO. 63842

FILE NAME 4251.001-DT(IDOT)





G A GEWALT HAMILTON ASSOCIATES, INC.


850 Forest Edge Drive Vernon Hills, IL. 60061

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F.A.U. RTE. SECTION COUNTY TOTAL SHEET NO. N/A 10-00086-00-SW LAKE/COOK 12 1 CONTRACT NO. 63842



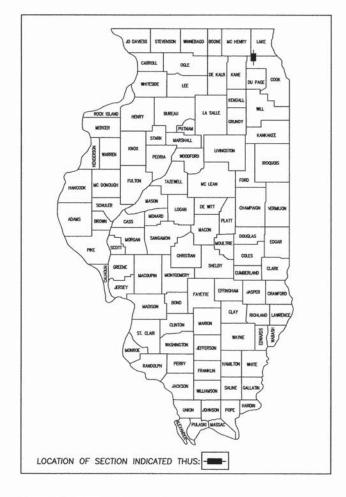

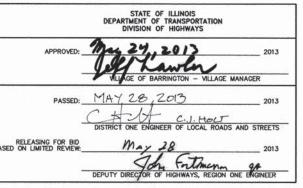

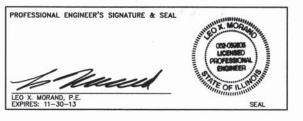PRINTED BY THE AUTHORITY OF THE STATE OF ILLINOIS

GENERAL NOTES

A-1 THE ILLINOIS DEPARTMENT OF TRANSPORTATION "STANDARD SPECIFICATIONS FOR ROAD AND BRIDGE CONSTRUCTION" LATEST EDITION, THE "STANDARD SPECIFICATIONS FOR WATER AND SEWER MAIN CONSTRUCTION IN ILLINOIS" LATEST EDITION, PROJECT SPECIFICATIONS, ALL APPLICABLE REQUIREMENTS OF THE ILLINOIS ENVIRONMENTAL PROTECTION AGENCY, MUNICIPALITY, ORDINANCES OF AUTHORITIES HAVING JURISDICTION AND ALL ADDENDA THERE SHALL GOVERN THIS WORK.

A-2 ALL REFERENCES TO "ENGINEER" SHALL BE INTERPRETED TO MEAN THE RESIDENT ENGINEER.

A-3 THE CONTRACTOR SHALL VERIFY ALL DIMENSIONS, AND CONDITIONS AFFECTING THEIR WORK WITH THE ACTUAL CONDITIONS AT THE JOB SITE. IN ADDITION, THE CONTRACTOR MUST VERIFY THE ENGINEERS' LINE AND GRADES. IF THERE ARE ANY DISCREPANCIES FROM WHAT IS SHOWN ON THE CONSTRUCTION PLANS, STANDARD SPECIFICATIONS AND/OR SPECIAL DETAILS, THE CONTRACTOR SHALL SECURE WRITTEN INSTRUCTION FROM THE ENGINEER PRIOR TO PROCEEDING WITH ANY PART OF THE WORK AFFECTED BY OMISSION OR DISCREPANCIES. FAILING TO SECURE SUCH INSTRUCTION, THE CONTRACTOR WILL BE CONSIDERED TO HAVE PROCEEDED AT HIS OWN RISK AND EXPENSE. IN THE EVENT OF ANY DOUBT OR QUESTION ARISING WITH RESPECT TO THE TRUE MEANING OF THE CONSTRUCTION PLANS OR SPECIFICATIONS, THE DECISION OF THE ENGINEER SHALL BE FINAL AND CONCLUSIVE.

A-4 IT IS THE CONTRACTOR'S RESPONSIBILITY TO ASCERTAIN EXISTING FIELD CONDITIONS PRIOR

A-5 EASEMENTS FOR THE EXISTING UTILITIES, BOTH PUBLIC AND PRIVATE, AND UTILITIES WITHIN PUBLIC RIGHTS-OF-WAY ARE SHOWN ON THE PLANS ACCORDING TO AVAILABLE RECORDS. THE CONTRACTOR SHALL BE RESPONSIBLE FOR DETERMINING THE EXACT LOCATION IN THE FIELD OF THESE UTILITY LINES AND THEIR PROTECTION FROM DAMAGE DUE TO CONSTRUCTION OPERATIONS. IF EXISTING UTILITY LINES OF ANY NATURE ARE ENCOUNTERED WHICH CONFLICT IN LOCATION WITH NEW CONSTRUCTION, THE CONTRACTOR SHALL NOTIFY THE ENGINEER SO THAT THE CONFLICT MAY

A-6 SAW CUTTING OF PAVEMENTS, SIDEWALK, ETC. SHALL BE TO FULL DEPTH AND SHALL RESULT IN A CLEAN STRAIGHT EDGE ON THE PORTION REMAINING. ALL SAW CUTTING SHALL BE CONSIDERED INCLUDED IN THE COST OF THE ITEM REMOVED.

A-7 THE CONTRACTOR SHALL PROTECT AND CAREFULLY PRESERVE ALL SECTION OR SUBSECTION MONUMENTS, PROPERTY CORNERS, AND REFERENCE MARKERS UNTIL THE ENGINEER, OR AN AUTHORIZED SURVEYOR HAS WITNESSED OR OTHERWISE REFERENCED THEIR LOCATIONS.

A-8 WHENEVER, DURING CONSTRUCTION OPERATIONS, LOOSE MATERIAL IS DEPOSITED IN THE FLOW A-8 WHENEVER, DURING CONSTRUCTION OPERATIONS, LOOSE MATERIAL IS DEPOSITED IN THE FLOW LINE OF GUTTERS, DRAINAGE STRUCTURES, DITCHES, ETC. SUCH THAT THE NATURAL FLOW LINE OF WATER IS OBSTRUCTED, THE LOOSE MATERIAL WILL BE REMOVED AT THE CLOSE OF EACH WORKING DAY, AT THE CONCLUSION OF CONSTRUCTION OPERATION, ALL DRAINAGE STRUCTURES AND FLOW LINES SHALL BE FREE FROM DIRT AND DEBRIS. THIS WORK SHALL BE CONSIDERED INCLUDED IN THE COST OF THE CONTRACT. THE CONTRACTOR'S FAILURE TO PROVIDE THE ABOVE WILL PRECLUDE ANY POSSIBLE ADDED COMPENSATION REQUESTED DUE TO DELAYS OR UNSUITABLE MATERIALS CREATED AS A RESULT THEREOF.

STORM SEWERS, WATER MAINS, AND UTILITIES

B-1 THE CONTRACTOR IS RESPONSIBLE FOR CONTACTING JULIE PRIOR TO THE START OF

 $B\!-\!2$ THE CONTRACTOR SHALL BE RESPONSIBLE FOR THE PROTECTION OF ALL UNDERGROUND AND SURFACE UTILITIES EVEN THOUGH THEY MIGHT NOT BE SHOWN ON THE PLANS. ANY UTILITY PROPERTY DAMAGED DURING CONSTRUCTION SHALL BE REPAIRED OR REPLACED TO THE SATISFACTION OF THE ENGINEER AT THE CONTRACTOR'S EXPENSE.

 $B\!-\!3$ THE VILLAGE OF BARRINGTON SHALL BE NOTIFIED A MINIMUM 3 DAYS PRIOR TO THE START OF CONSTRUCTION AT $847\!-\!673\!-\!1540.$

B-4 THE CONTRACTOR SHALL ENSURE THAT ALL WATER SYSTEM VALVE VAULTS, AND SANITARY SEWER MANHOLES REMAIN READILY ACCESSIBLE TO THE VILLAGE FOR EMERGENCY OPERATIONS. THE LOCATIONS OF ALL WATER AND SANITARY FACILITIES SHALL BE MARKED AND READILY VISIBLE AT ALL TIMES.

TRAFFIC CONTROL

D-1 SEE TRAFFIC CONTROL HIGHWAY STANDARDS CONCERNING TRAFFIC CONTROL AND

DEBRIS REMOVAL
MATERIALS RESULTING FROM THE REMOVAL OF ASPHALT SURFACES, UTILITY ADJUSTMENTS, RESTORATION WORK, ETC. SHALL BE REMOVED AT THE END OF EACH DAY TO AN APPROVED SITE.

IT WILL BE THE CONTRACTOR'S RESPONSIBILITY TO NOTIFY RESIDENTS AND THE ENGINEER WHEN ACCESS TO THEIR DRIVEWAYS WILL BE TEMPORARILY CLOSED DUE TO SIDEWALK REPLACEMENT, AND/OR DRIVEWAY REPLACEMENT. AT LOCATIONS WHERE THE DRIVEWAY IS SCHEDULED TO BE REMOVED, THE CONTRACTOR SHALL CONTACT THE BUSINESS/HOMEOWRER 24 HOURS PRIOR TO REMOVING THE CURB, SIDEWALK, OR DRIVE APPROACH. EVERY EFFORT SHALL BE MADE TO ACCOMMODATE ACCESS TO THESE PROPERTIES. THE CONTRACTOR SHALL NOT BE ALLOWED TO CLOSE A DRIVEWAY FOR MORE THAN 1 DAY UNDER UNLESS THE DRIVEWAY IS CLOSED FOR THE PURPOSE OF CURING CONCRETE PLACED AS A PART OF THIS CONTRACT. THE CONTRACTOR SHALL BE RESPONSIBLE FOR MAINTAINING THE BARRICADES TO PREVENT TRAFFIC FROM USING THE DRIVEWAYS DURING THIS PERIOD.

STREET SWEEPING AND PREPARATION
THE CONTRACTOR SHALL BE RESPONSIBLE FOR SWEEPING AND CLEANING STREETS OF ANY DEBRIS THE CONTRACTOR SHALL BE RESPONSIBLE FOR SWEEPING AND CLEANING STREETS OF ANY DEBRIS AND MATERIAL THAT HAS ACCUMULATED AS A RESULT OF THE CONSTRUCTION ACTIVITY. A MECHANICAL SWEEPER, MECHANICALLY DRIVEN AIR AND HANDWORK WITH SHOVEL AND BROOM SHALL BE UTILIZED TO PROVIDE A CLEAN STREET FOR THE MOTORING PUBLIC. WITHIN 24 HOURS OF PLACING PRIME COAT AND THE LAYING OF HMA, THE CONTRACTOR SHALL SWEEP THE PAVEMENT AND REMOVE STANDING WATER, EARTH, WEEDS, LEAVES, DIRT, CONSTRUCTION DEBRIS AND ALL LOOSE MATERIAL.

HIGHWAY STANDARDS:

STANDARD SYMBOLS, ABBREVIATIONS, AND PATTERNS PERPENDICULAR CURB RAMPS CLASS C & D PATCHES PRECAST REINFORCED CONCRETE FLARED END SECTION CATCH BASIN TYPE A CATCH BASIN TYPE C INLET TYPE A
MANHOLE TYPE A
PRECAST REINFORCED CONCRETE FLAT SLAB TOP
MANHOLE STEPS
FRAME AND LIDS TYPE 1
GRATE TYPE 8
CONCRETE CURB TYPE B AND COMBINATION CONC CURB AND GUTTER
TYPE A GUTTER (INLET, OUTLET & ENTRANCE)
OFF-RD OPERATIONS, 2L, 2W, MORE THAN 15' AWAY
OFF-RD OPERATIONS, 2L, 2W 15' TO 24" FROM PAVEMENT EDGE
LANE CLOSURE, 2L, 2W, SHORT TIME OPERATIONS
LANE CLOSURE, 2L, 2W, MOVING OPERATIONS-DAY ONLY
LANE CLOSURE, 2L, 2W, UNDIVIDED
SIDEWALK, CORNER OR CROSSWALK CLOSURE

DISTRICT 1 STANDARDS

701901-02

TRAFFIC CONTROL DEVICES

BD-07	STORM SEWER CONNECTION TO EXISTING SEWER
TC-10	TRAFFIC CONTROL AND PROTECTION PLAN FOR SIDE ROADS,
	INTERSECTIONS AND DRIVEWAYS

FILE NAME =	USER NAME = BJW	DESIGNED - BJW	REVISED -		VILLAGE	OF BARRINGTON - SA	FAU	SECTION	COUNTY	TOTAL	SHEET		
4251-001-DT(IDOT).dwg		DRAWN - BJW	REVISED -	STATE OF ILLINOIS	VILLAGE OF BARRINGTON - SAFE ROUTE TO SCHOOLS			N/A	10-00086-00-SW	LAKE/COOK	12	2	
	PLOT SCALE = 1:1	CHECKED - LXM	REVISED -	DEPARTMENT OF TRANSPORTATION	GENERAL NOTES & STATE STANDARDS				CONTRACT	F#: 63	842		
	PLOT DATE = 5/9/13	DATE - 5/9/13	REVISED -		SCALE: N.T.S.	SHEET NO. 2 OF 12 SHEETS	STA.	TO STA		ILLINOIS FED. A	ID PROJECT		

SUMMARY OF QUANTITIES

Code#	ltem	Unit	CONSTRUCTION TYPE CODE 0021 Quantity			
20100110	TREE REMOVAL (6 TO 15 UNITS DIAMETER)	UNIT	14			
20100210	TREE REMOVAL (OVER 15 UNITS DIAMETER)	UNIT	16			
20101100	TREE TRUNK PROTECTION	EACH	21			
20101200	TREE ROOT PRUNING	EACH	13			
20101300	TREE PRUNING (1 TO 10 INCH DIAMETER)	EACH	5	***************************************		
20101350	TREE PRUNING (OVER 10 INCH DIAMETER)	EACH	4			
20200100	EARTH EXCAVATION	CUYD	391			
20400800	FURNISHED EXCAVATION	CUYD	207			
20800150	TRENCH BACKFILL	CUYD	312			
21101615	TOPSOIL FURNISH AND PLACE, 4"	SQ YD	2,983			
25000400	NITROGEN FERTILIZER NUTRIENT	POUND	38			
25000500	PHOSPHORUS FERTILIZER NUTRIENT	POUND	38			
25000600	POTASSIUM FERTILIZER NUTRIENT	POUND	38			
	SODDING	SQ YD	2,983			
	SUPPLEMENTAL WATERING	UNIT	45			
	TEMPORARY DITCH CHECKS	FOOT	15			
	PERIMETER EROSION BARRIER	FOOT				
	INLET AND PIPE PROTECTION	EACH	1,120			
			22			
	AGGREGATE BASE COURSE, TYPE A 4"	SQ YD	1,675			
	AGGREGATE BASE COURSE, TYPE A 6"	SQ YD	124			
	AGGREGATE FOR TEMPORARY ACCESS	TON	55			
40800050	INCIDENTAL HOT-MIX ASPHALT SURFACING	TON	15			
42400200	PORTLAND CEMENT CONCRETE SIDEWALK 5 INCH	SQFT	7,297			
42400400	PORTLAND CEMENT CONCRETE SIDEWALK 7 INCH	SQFT	1,037			
44000200	DRIVEWAY PAVEMENT REMOVAL	SQ YD	405			
44000500	COMBINATION CURB AND GUTTER REMOVAL	FOOT	380			
44201705	CLASS D PATCHES, TYPE II, 5 INCH	SQ YD	15			
44201709	CLASS D PATCHES, TYPE III, 5 INCH	SQ YD	20			
44201711	CLASS D PATCHES, TYPE IV, 5 INCH	SQ YD	450			
44213204	TIE BARS 3/4"	EACH	199			
50105220	PIPE CULVERT REMOVAL	FOOT	375			
542A0217	PIPE CULVERTS, CLASS A, TYPE 1 12"	FOOT	150			
54213657	PRECAST REINFORCED CONCRETE FLARED END SECTIONS 12"	EACH	9			
550A2320	STORM SEWERS, RUBBER GASKET, CLASS A, TYPE 1 12"	FOOT	108			
550A2520	STORM SEWERS, RUBBER GASKET, CLASS A, TYPE 2 12"	FOOT	149			
550A2530	STORM SEWERS, RUBBER GASKET, CLASS A, TYPE 2 15"	FOOT	323			
55100500	STORM SEWER REMOVAL 12"	FOOT	35			
56400300	FIRE HYDRANTS TO BE ADJUSTED	EACH	1			
	DOMESTIC WATER SERVICE BOXES TO BE ADJUSTED	EACH	1			
	CATCH BASINS, TYPE A, 4'-DIAMETER, TYPE 1 FRAME, CLOSED LID					

			CONSTRUCTION TYPE CODE 0021	
Code#	Item	Unit	Quantity	Quantity
60206905	CATCH BASINS, TYPE C, TYPE 1 FRAME, OPEN LID	EACH	1	
60218400	MANHOLES, TYPE A, 4'-DIAMETER, TYPE 1 FRAME, CLOSED LID	EACH	1	
60221100	MANHOLES, TYPE A, 5'-DIAMETER, TYPE 1 FRAME, CLOSED LID	EACH	1	
60234200	INLETS, TYPE A, TYPE 1 FRAME, OPEN LID	EACH	1	
60236200	INLETS, TYPE A, TYPE 8 GRATE	EACH	2	
60250200	CATCH BASINS TO BE ADJUSTED	EACH	1	
60500050	REMOVING CATCH BASINS	EACH	1	
60603800	COMBINATION CONCRETE CURB AND GUTTER, TYPE B-6.12	FOOT	495	
67100100	MOBILIZATION	LSUM	1	
70102620	TRAFFIC CONTROL AND PROTECTION, STANDARD 701501	LSUM	1	
70102640	TRAFFIC CONTROL AND PROTECTION, STANDARD 701801	LSUM	1	
72400310	REMOVE SIGN PANEL - TYPE 1	SQFT	13	
72400710	RELOCATE SIGN PANEL - TYPE 1	SQFT	13	
72900100	METAL POST - TYPE A	FOOT	26	
B20000124	TREE, ACER CAMPESTRE, 3" CALIPER, TREE FORM, BALLED AND	EACH	2	
X4240800	DETECTABLE WARNINGS (SPECIAL)	SQFT	40	
Z0004510	HOT-MIX ASPHALT DRIVEWAY PAVEMENT, 3"	SQ YD	309	
Z0013798	CONSTRUCTION LAYOUT	LSUM	1	
Z0076600	TRAINEES	HOUR		500
Z0076604	TRAINEES TRAINING PROGRAM GRADUATE	HOUR		500


* SPECIALTY ITEMS

FILE NAME =	USER NAME = BJW	DESIGNED - BJW	REVISED -	
4251-001-DT(IDOT).dwg		DRAWN - BJW	REVISED -	7. 3.
	PLOT SCALE = 1:1	CHECKED - LXM	REVISED -	
	PLOT DATE = 5/9/13	DATE - 5/9/13	REVISED -	

STATE OF ILLINOIS
DEPARTMENT OF TRANSPORTATION


VILLAGE	OF							ROUTE ITITIES	то	SCHOOLS
SCALE: N.T.S.	1	SHEET NO.	3	OF	12	SHEETS	STA	ι .	TOST	Ä

FAU	SECTION	COUNTY	TOTAL	SHEET NO.
N/A	10-00086-00-SW	LAKE/COOK	12	3
		CONTRACT	# 63	842

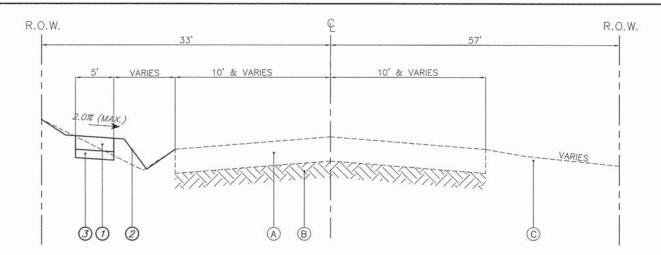

TYPICAL SECTION

SUMMIT STREET STA. 12+48 - 13+27

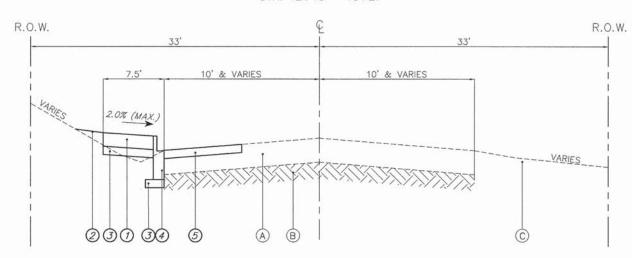


TYPICAL SECTION

SUMMIT STREET STA. 8+80 - 12+48

HOT-MIX ASPHALT MIXTURE REQUIREMENTS

MIXTURE TYPE	AIR VOIDS
PAVEMENT PATCHING	
HOT-MIX ASPHALT SURFACE COURSE, MIX 'D', N50, (IL 9.5 mm) 2"	4% @ 50 GYR
HOT-MIX ASPHALT BINDER COURSE, IL-19.0, N50, 3"	4% @ 50 GYR
INCIDENTAL HOT MIX ASPHALT SURFACING	
HOT-MIX ASPHALT SURFACE COURSE, MIX 'D', N50, (IL 9.5 mm)	4% @ 50 GYR
DRIVEWAYS	
HOT-MIX ASPHALT SURFACE COURSE, MIX 'D', N50, (IL 9.5 mm) 3"	4% @ 50 GYR

THE UNIT WEIGHT TO CALCULATE ALL HMA SURFACE MIXTURE QUANTITIES IS 112 LBS/SQ YD/IN.
THE 'AC TYPE' FOR POLYMERIZED HMA MIXES SHALL BE 'SBS/SBR PG 76-22' AND FOR
NON-POLYMERIZED HMA THE 'AC TYPE' SHALL BE 'PG 640-22' UNLESS MODIFIED BY DISTRICT ONE
SPECIAL PROVISIONS. FOR USE OF RECYCLED MATERIAL SEE D-1 SPECIAL PROVISIONS

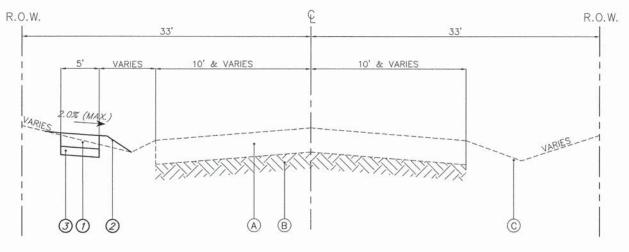


TYPICAL SECTION


WAVERLY ROAD STA. 6+60 - 18+60


TYPICAL SECTION LEGEND


- A EXISTING HOT-MIX ASPHALT PAVEMENT
- B EXISTING SUBBASE
- © EXISTING TOPSOIL AND SOD
- 1) PORTLAND CEMENT CONCRETE SIDEWALK, 5"
- 2 RESTORATION, 4" TOPSOIL AND SOD
- 3 AGGREGATE BASE COURSE, 4"
- 4 COMBINATION CONCRETE CURB & GUTTER, B6.12
- 5 CLASS D PATCHES, 5"


FILE NAME =	USER NAME = BJW	DESIGNED - BJW	REVISED -	STATE OF HILINOIS VILLAGE OF BARRINGTON - SAFE ROUTE TO SCHOOLS REL				VILLAGE OF BARRINGTON - SAFE BOLITE TO SCHOOLS		SECTION	COUNTY	TOTAL SH
4251-001-DT(IDOT).dwg		DRAWN - BJW	REVISED -	STATE OF ILLINOIS	TYPICAL SECTIONS		VILLAGE OF BANKINGTON SAFE HOUSE TO SCHOOLS		10-00086-00-SW	LAKE/COOK	(12	
	PLOT SCALE = 1:1	CHECKED - LXM	REVISED -	DEPARTMENT OF TRANSPORTATION			11/11	10 00000 00 011	CONTRACT			
	PLOT DATE = 5/9/13	DATE - 5/9/13	REVISED -		SCALE N.T.S. SHEET NO. 4 OF 12 SHEETS STA TO STA				ILLINOIS FED.	AID PROJECT		

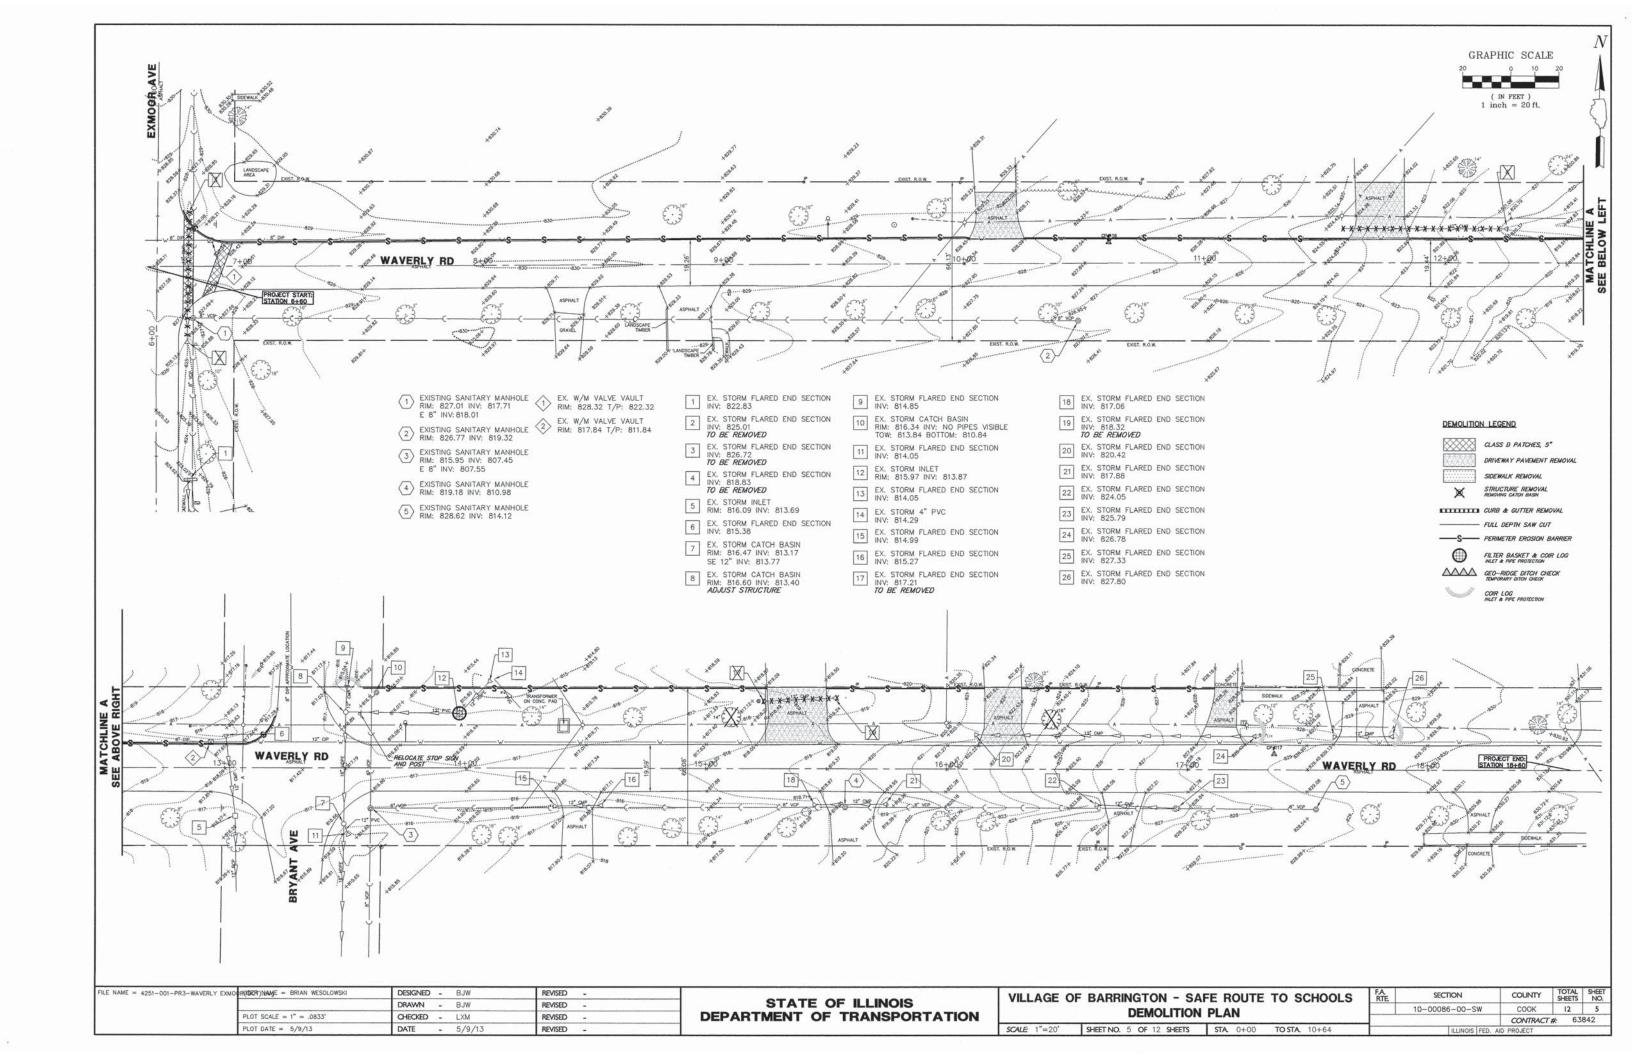


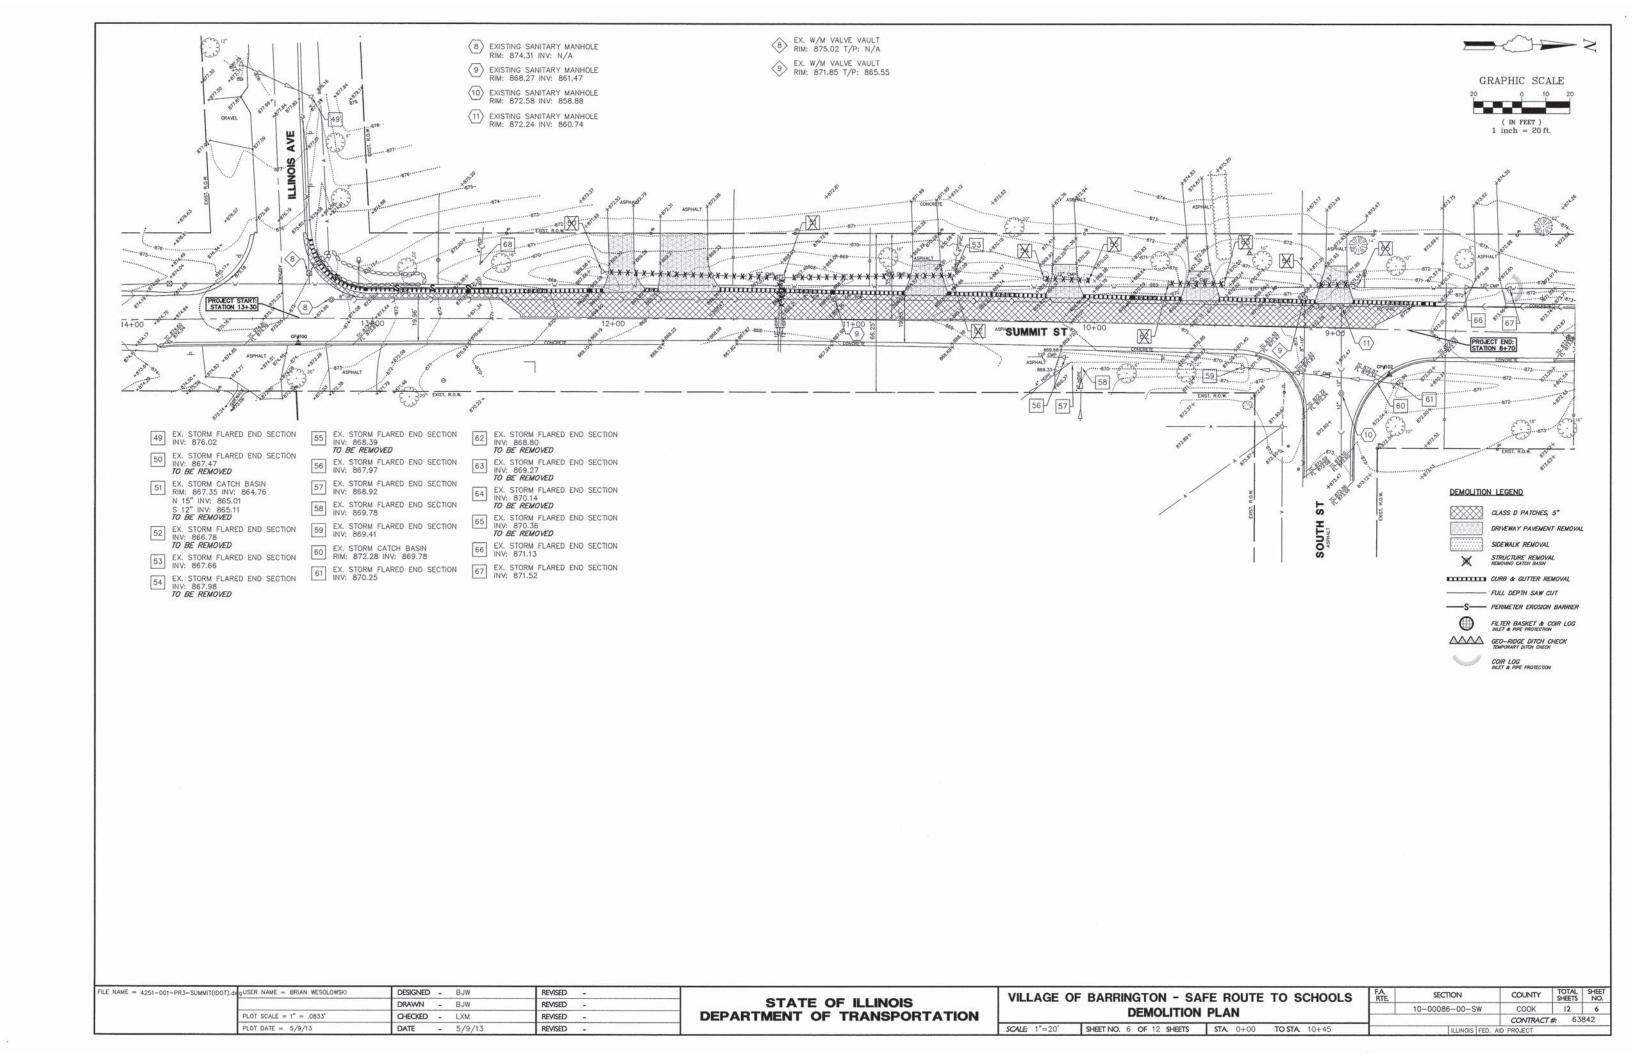

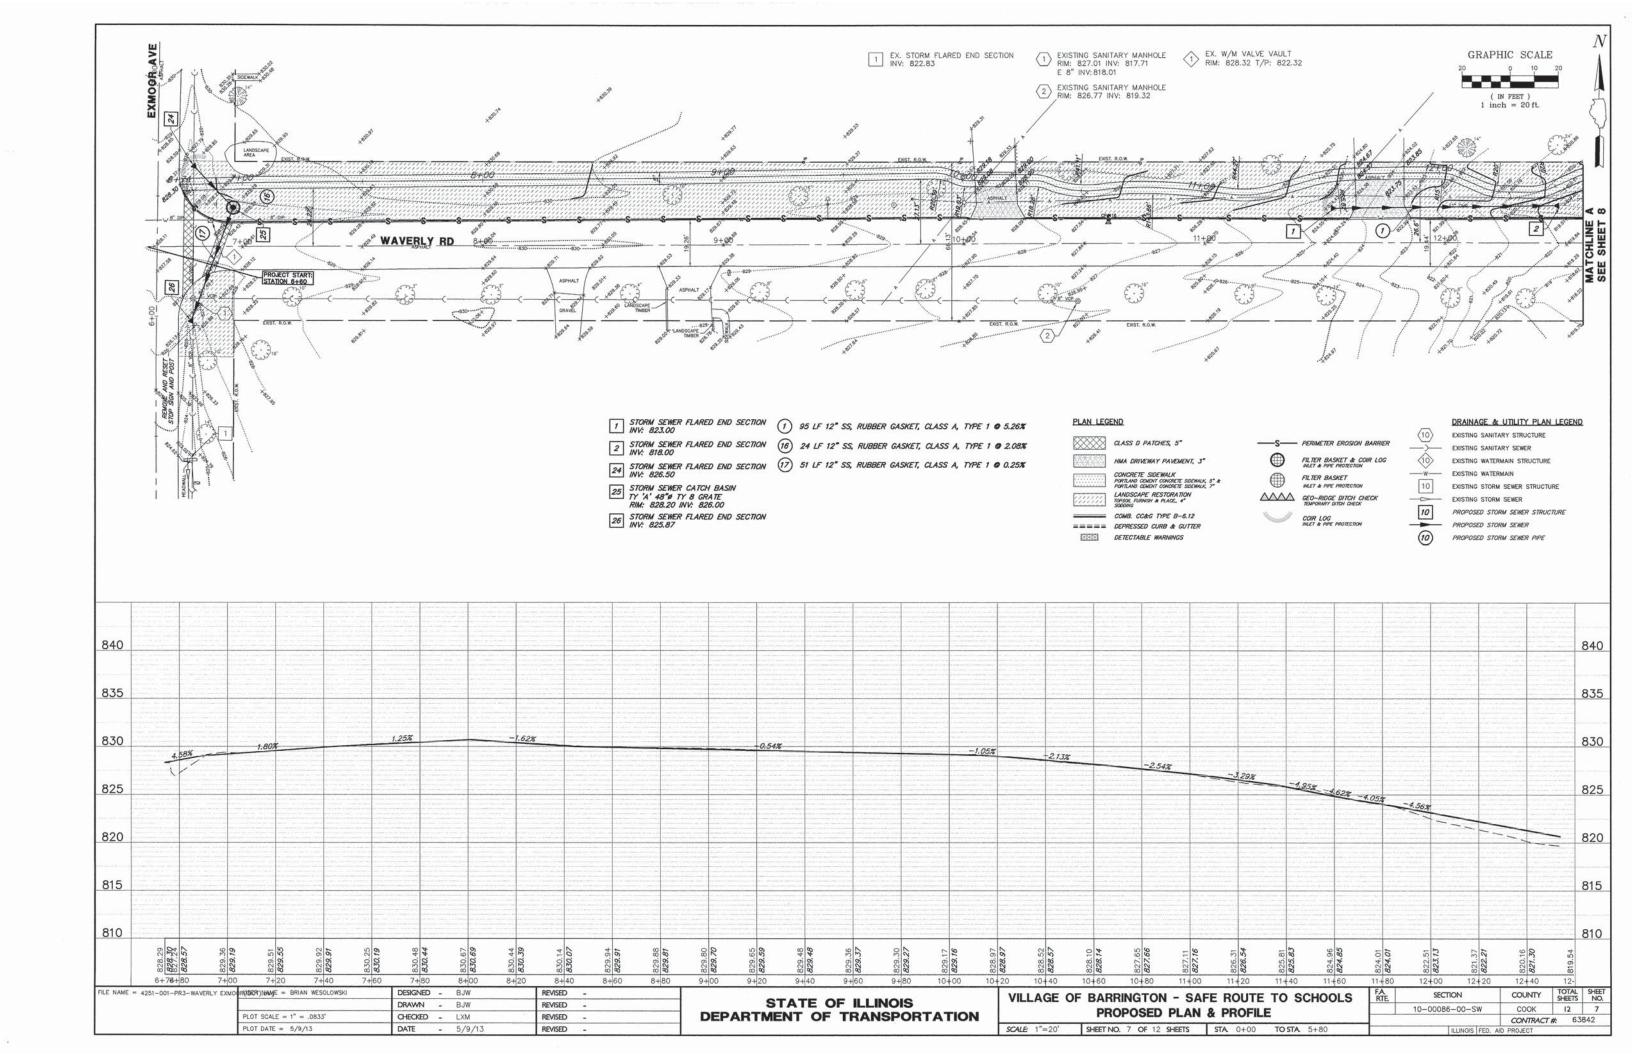

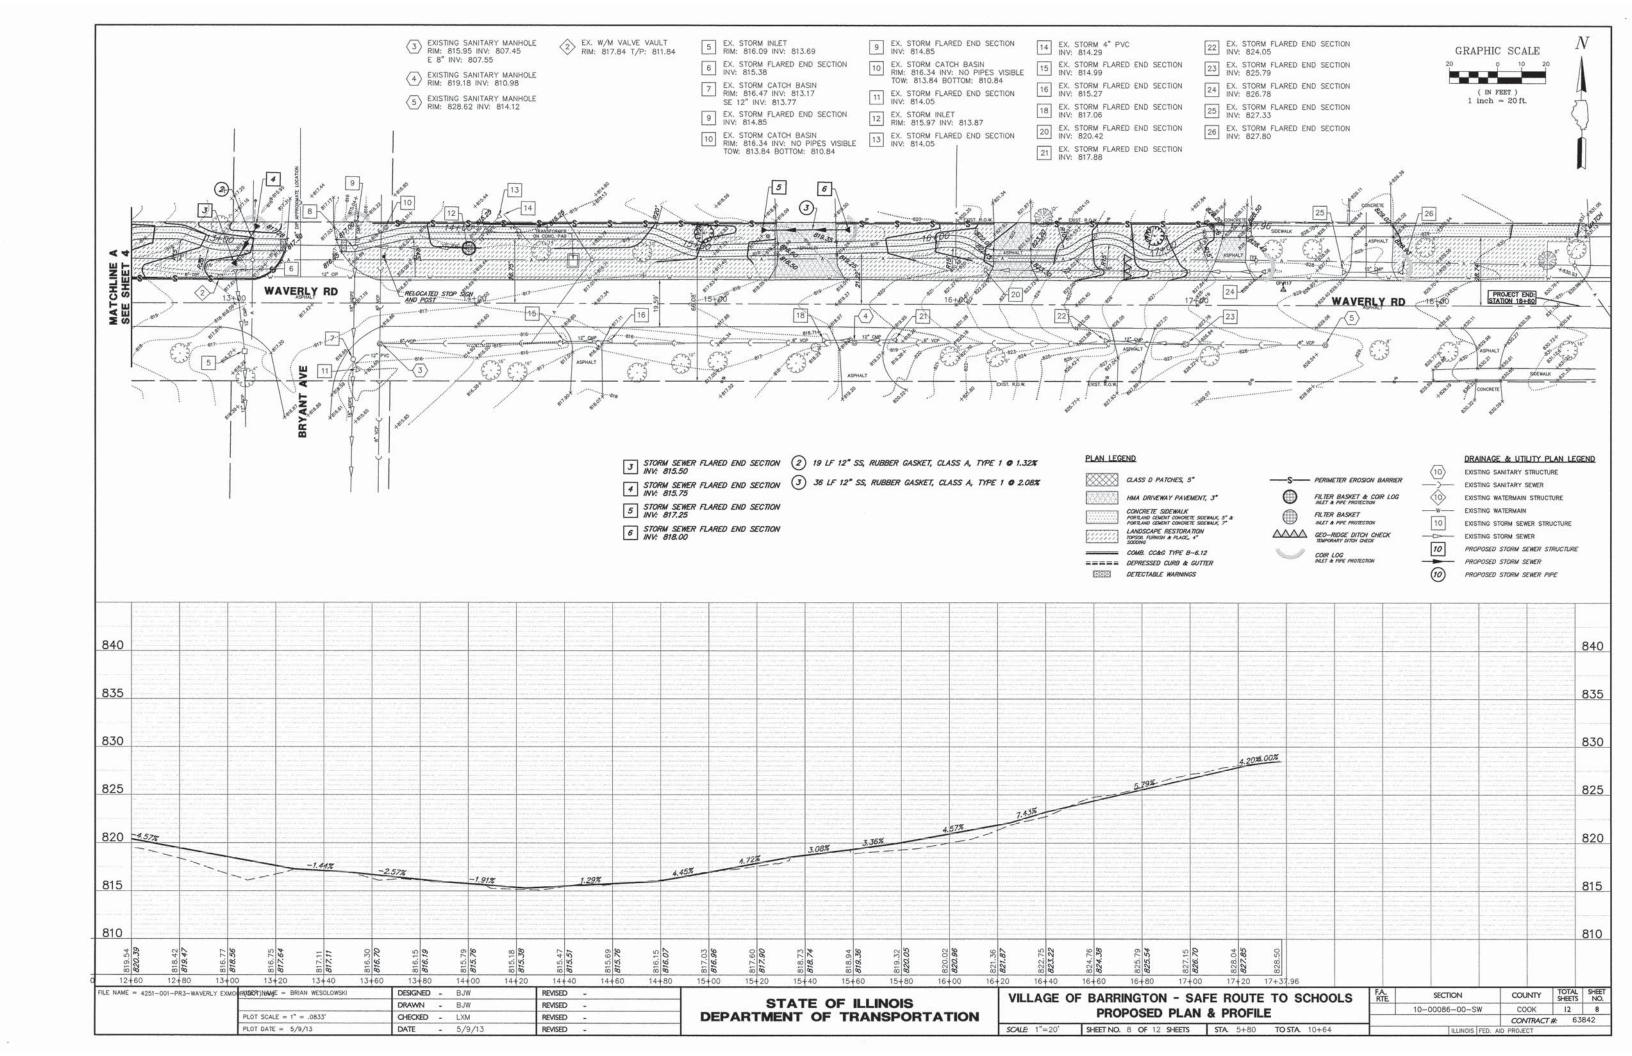

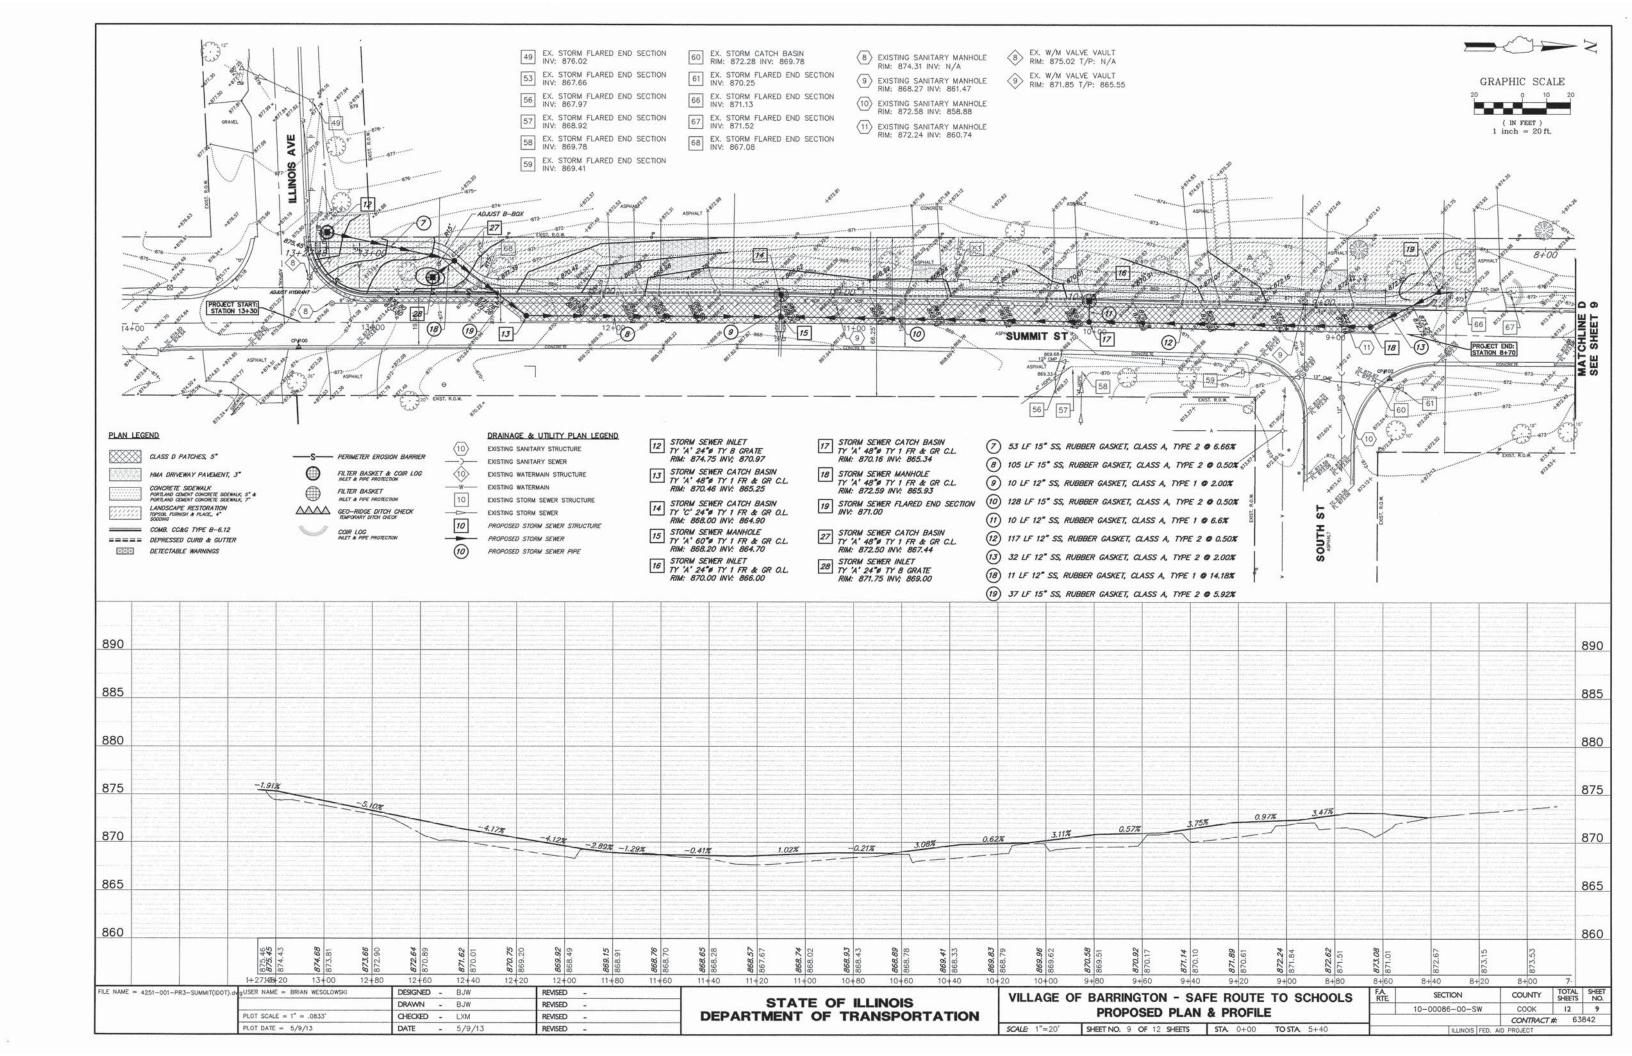

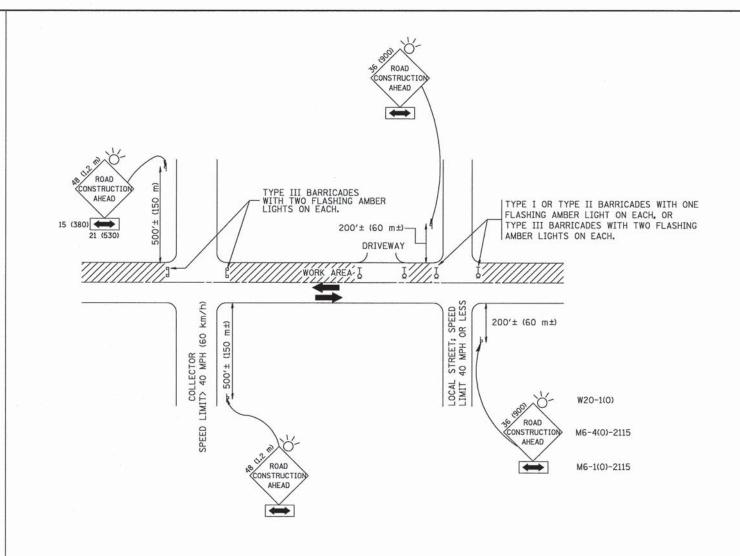

NOTES:

- A. FOR NO LANE RESTRICTION ON THE SIDE ROAD OR DRIVEWAYS
- 1. SIDE ROAD WITH A SPEED LIMIT OF 40 MPH (60 km/h) OR LESS AS SHOWN ON THE DRAWING AND AS DIRECTED BY THE ENGINEER:
- O) ONE ROAD CONSTRUCTION AHEAD SIGN 36 x 36 (900x900) WITH A FLASHER AND FLAG MOUNTED ON IT APPROXIMATELY 200' (60 m) IN ADVANCE OF THE MAIN ROUTE.
- b) THE CLOSED PORTION OF THE MAIN ROUTE SHALL BE PROTECTED BY BLOCKING WITH TYPE I, TYPE II OR TYPE III BARRICADES, 1/3 OF THE CROSS SECTION OF THE CLOSED PORTION.
- 2. SIDE ROAD WITH A SPEED LIMIT GREATER THAN 40 MPH (60 km/h) AS SHOWN ON THE DRAWING AND AS DIRECTED BY THE ENGINEER:
- d) ONE ROAD CONSTRUCTION AHEAD SIGN 48 \times 48 (1.2 m \times 1.2 m) WITH A FLASHER MOUNTED ON IT APPROXIMATELY 500' (150 m) IN ADVANCE OF THE MAIN ROUTE.
- b) THE CLOSED PORTION OF THE MAIN ROUTE SHALL BE PROTECTED BY BLOCKING WITH TYPE III BARRICADES, 1/2 OF THE CROSS SECTION OF THE CLOSED PORTION.
- WHEN THE SIDE ROAD LIES BETWEEN THE BEGINNING OF THE MAINLINE SIGNING AND THE WORK ZONE, A SINGLE HEADED ARROW (MG-1) SHALL BE USED IN LIEU OF THE DOUBLE HEADED ARROW (MG-4).


- B. FOR A LANE CLOSURE ON A SIDE ROAD OR DRIVEWAY:
- USE APPLICABLE PORTIONS OF THE TYPICAL APPLICATION OF TRAFFIC CONTROL DEVICES (STD. 701501, STD. 701606 OR THE APPROPRIATE STANDARD). THE SPACING OF SIGNS AND BARRICADES SHALL BE ADJUSTED FOR FIELD CONDITIONS AS DIRECTED BY THE ENGINEER. THE DIRECTIONAL ARROW SHALL BE COVERED OR REMOVED WHEN NO LONGER CONSISTENT WITH THE SIDE ROAD LANE CLOSURE.
- C. ADVANCE WARNING SIGNS ARE TO BE OMITTED ON DRIVEWAY UNLESS OTHERWISE NOTED.
- D. THE TRAFFIC CONTROL AND PROTECTION FOR SIDE ROADS, INTERSECTIONS, AND DRIVEWAYS SHALL BE INCIDENTAL TO THE COST OF SPECIFIED TRAFFIC CONTROL STANDARDS OR ITEMS.

All dimensions are in millimeters (inches) unless otherwise shown.

STATE OF ILLINOIS DEPARTMENT OF TRANSPORTATION


VILLAGE OF BARRINGTON - SAFE ROUTE TO SCHOOLS
SIDE ROADS, INTERSECTIONS, AND DRIVEWAYS


SCALE NONE SHEET NO. 10 OF 12 SHEETS STA. TO STA.

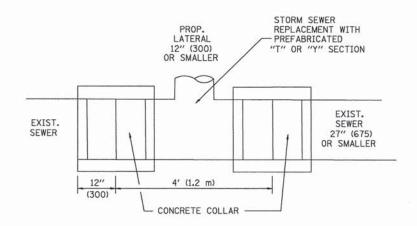


DETAIL "A"

LATERAL CONNECTION TO EXISTING SEWER OF 27" (675) OR SMALLER

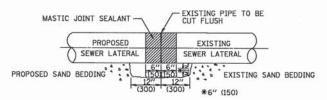

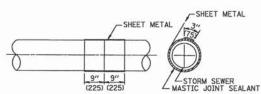


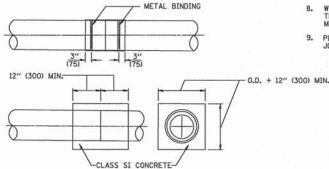

DETAIL "B" CLASS SI CONCRETE COLLAR

CONSTRUCTION SEQUENCE

- CUT THE EXISTING END OF THE PIPE SO AS TO PRESENT A FLUSH BUTT JOINT. BRUSH AND CLEAN ALL PIPES.
- 2. APPLY THE MASTIC JOINT SEALANT TO THE FIRST $6^{\prime\prime}$ (150) OF EACH PIPE.
- BUTT THE PIPES TOGETHER LEAVING A MINIMUM OF 12' \times 6' (300 \times 150) DEEP EXCAVATION UNDER AND AROUND EACH PIPE END.
- CUT A PIECE OF SHEET METAL GAGE NO. 19 1.1 (0.0418) 18" (450) WIDE BY THE OUTSIDE CIRCUMFERANCE OF THE PIPE PLUS 3" (75) LONG.
- WRAP THE SHEET METAL AROUND THE PIPES, 9" (225) ON EACH SIDE OF THE JOINT, STARTING AT THE TOP OF THE PIPE.
- LAP THE SHEET METAL AT LEAST 3" (75) AT THE TOP OF THE PIPE AND PLACE THE MASTIC JOINT SEALANT BETWEEN THE LAP.
- PLACE TWO METAL BANDS AROUND THE SHEET METAL AND TIGHTEN.
- 8. WIPE OFF ANY EXCESS MASTIC JOINT SEALANT THAT OOZES OUT FROM BETWEEN THE SHEET METAL AND THE PIPES.
- 9. PLACE CLASS SI CONCRETE AROUND THE

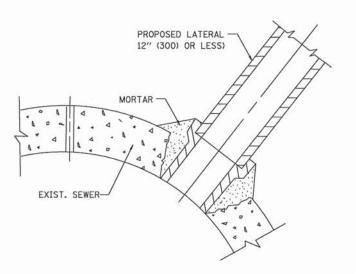

DETAIL "C"

PROPOSED LATERAL CONNECTION TO EXISTING SEWER OF 30" (750) OR LARGER

NOTES

MATERIAL

MATERIAL USED FOR THE TEE OR WYE SECTION SHALL BE COMPATIBLE WITH THE EXISTING STORM SEWER OR THE PROPOSED STORM SEWER.

CONSTRUCTION METHODS

- I. THIS WORK SHALL BE CONSTRUCTED IN CONFORMANCE WITH THE APPLICABLE PORTIONS OF SECTION 550 OF THE STANDARD SPECIFICATIONS.
- II. CONNECTION TO AN EXISTING STORM SEWER SHALL BE BY EITHER OF THE FOLLOWING METHODS: A) PROPOSED STORM SEWER CONNECTION TO EXISTING SEWER OF 27" (675) OR SMALLER SEE DETAIL "A" AND "B".
 - B) PROPOSED STORM SEWER CONNECTION TO EXISTING SEWER OF 30" (750) OR LARGER SEE

IF THE EXISTING SEWER PIPE IS CRACKED, BROKEN OR OTHERWISE DAMAGED BY THE CONTRACTOR IN MAKING THE CIRCULAR OPENING, THE CONTRACTOR SHALL REPLACE THAT SECTION OF PIPE WITH PIPE EQUAL AND SIMILAR IN ALL RESPECTS TO THE PIPE IN THE EXISTING SEWER, IN A CAREFUL WORKMANLIKE MANNER, WITHOUT EXTRA COMPENSATION.

CARE MUST BE TAKEN TO PREVENT DEBRIS FROM ENTERING THE SEWER. ALL DEBRIS WHICH ENTERS THE SEWER MUST BE REMOVED. THE SEWER MUST BE LEFT CLEAN AND UNOBSTRUCTED UPON COMPLETION OF THE CONTRACT.

CARE MUST BE TAKEN TO PREVENT ANY PART OF THE NEW PIPE CONNECTION FROM PROJECTING INTO THE EXISTING SEWER.

BASIS OF PAYMENT

TEE OR WYE CONNECTIONS SHALL BE PAID FOR AT THE CONTRACT UNIT PRICE EACH FOR STORM SEWER TEE OR WYE OF THE TYPE AND SIZE SPECIFIED IN THE PLANS, THIS PRICE SHALL INCLUDE ALL EXCAVATION OF THE TRENCH, REMOVAL OF THE EXISTING STORM SEWER, FURNISHING AND INSTALLING THE SPECIFIED TEE OR WYE SECTION, FURNISHING AND INSTALLING THE REQUIRED CONCRETE COLLAR, AND ALL OTHER MATERIAL NECESSARY TO COMPLETE THIS WORK AS SHOWN AND SPECIFIED.

REMOVAL AND REINSTALLATION OF EXISTING STORM SEWER ADJACENT TO THE PROPOSED TEE OR WYE SECTION, FOR THE PURPOSE OF FACILITATING THE INSTALLATION OF THE TEE OR WYE SECTION, WILL NOT BE PAID FOR SEPARATELY BUT SHALL BE INCLUDED IN THE

TRENCH BACKFILL, EXCAVATION IN ROCK AND REMOVAL AND REPLACEMENT OF UNSUITABLE MATERIAL BELOW PLAN BEDDING GRADE WILL BE PAID FOR SEPARATELY.


CONCRETE COLLAR FOR CONNECTING A PROPOSED STORM SEWER TO AN EXISTING STORM SEWER WILL NOT BE PAID PAID FOR SEPARATELY BUT SHALL BE INCLUDED IN THE COST OF THE PROPOSED STORM SEWER.

FILE NAME =	USER NAME = BJW	DESIGNED - M. DE YONG	REVISED - M. DE YONG 05-08-92
4251-001-DT(IDOT).dwg		DRAWN -	REVISED - R. SHAH 09-09-94
	PLOT SCALE =	CHECKED -	REVISED - R. SHAH 10-25-94
	PLOT DATE = 5/9/13	DATE - 07-25-90	REVISED - R. SHAH 06-12-96

STATE OF ILLINOIS **DEPARTMENT OF TRANSPORTATION**

CONNECTION TO EXISTING SEWER	N/A RD	10-00086-00-S 500-01 (BD-7
VILLAGE OF BARRINGTON - SAFE ROUTE TO SCHOOLS	FAU. RTE	SECTION


TOTAL SHEETS SHEET NO. COUNTY LAKE/COOK 12 11 CONTRACT #: 63842 SCALE NONE SHEET NO. 11 OF 12 SHEETS STA. TO STA FED. ROAD DIST, NO. 1 ILLINOIS FED. AID PROJECT

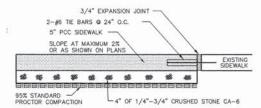

NOTE:

- SET 3/4" EXPANSION JOINTS AT POINTS ABUTTING CURB OR PAVEMENT AND AT 45" MAX. INTERVALS.
- CONTROL JOINTS SHALL BE 1/8" TO 1/4" WIDE AND 1/4 OF THE SIDEWALK THICKNESS DEEP. THE EDGE OF THE CONTROL JOINTS SHALL BE GIVEN A 1/4" RADIUS.
- 3. SIDEWALK WIDTH AS SHOWN ON PLANS.
- 4. SIDEWALK SHALL FOLLOW ALL ADA STANDARDS.
- 5. SIDEWALK THROUGH DRIVEWAYS SHALL BE 7" PCC WITH 6" AGGREGATE BASE COURSE.

PCC SIDEWALK DETAIL

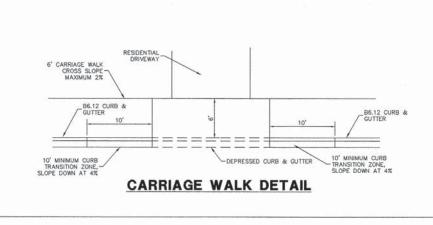

FILE NAME = 4251-001-DT(IDOT).dwg	USER NAME = BJW	DESIGNED - BJW	REVISED -	STATE OF HILINOIS	VILLAGE OF BARRINGTON - SAFE ROUTE TO SCHOOLS DETAILS			FAU RTE	SECTION	COUNTY	TOTAL	SHEET NO.
		DRAWN - BJW	REVISED -	STATE OF ILLINOIS DEPARTMENT OF TRANSPORTATION				N/A	10-00086-00-SW	LAKE/COOK	12	12
	PLOT SCALE = 1:1	CHECKED - LXM	REVISED -		DETAILS						CONTRACT #:	
	PLOT DATE = 5/9/13	DATE - 5/9/13	REVISED -		SCALE: N.T.S. SHEET NO. 12 OF 12 SHEETS STA. TO STA.		TO STA	ILLINOIS FED. AID PROJECT				