STATE OF ILLINOIS


DEPARTMENT OF TRANSPORTATION

DIVISION OF HIGHWAYS

PROPOSED HIGHWAY PLANS

FAU 2857 (ASHLAND AVE)
SECTION 146-T
AT LITTLE CALUMENT RIVER
STORM SEWER (NEW)

COOK COUNTY C-91-223-12

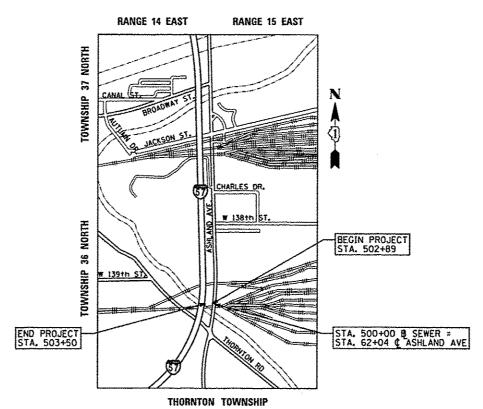

GROSS AND NET LENGTH OF PROJECT = 352 FEET (0.07 MILES)

FOR INDEX OF SHEETS, SEE SHEET NO. 2

TRAFFIC DATA

0

0

0

EXISTING ADT =15,600 (2011) SPEED LIMIT =40 MPH

THE IMPROVEMENT IS LOCATED WITHIN THE VILLAGES OF DIXMOOR AND RIVERDALE

0 190' 200' 390' — 1" = 100'
0 10' 20' 30' — 1" = 10'
0 50' 100' 1" = 50'
0 50' 100' 1" = 40'
0 50' 100' — 1" = 30'
0 50' 100' — 1" = 20'

FULL SIZE PLANS HAVE BEEN PREPARED USING STANDARD ENGINEERING SCALES. REDUCED SIZED PLANS WILL NOT CONFORM TO STANDARD SCALES. IN MAKING MEASUREMENTS ON REDUCED PLANS, THE ABOVE SCALES MAY BE USED.

J.U.L.I.E.
JOINT UTILITY LOCATION INFORMATION FOR EXCAVATION
1-800-892-0123
OR 811
C.U.A.N.
CHICAGO UTILITY ALERT NETWORK
1-312-744-7000


PROJECT ENGINEER: PETER JOHNSTON (GRAEF) 773-399-0112 PROJECT MANAGER: KEN ENG (IDOT) 847-705-4247


CONTRACT NO. 60R82

GREEF 8501 W. Higgins Road; Suite 280 Chicago, Illinois 60631 (773) 399-0112

D-91-223-12



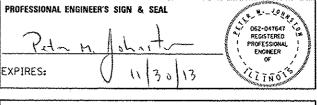

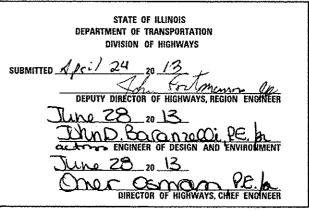

PRINTED BY THE AUTHORITY OF THE STATE OF ILLINOIS

INDEX OF SHEETS

SHEET NO. DESCRIPTION

- 1 COVER SHEET
- INDEX OF SHEETS, HIGHWAY STANDARDS AND GENERAL NOTES
- 3 SUMMARY OF QUANTITIES
- 4 ALIGNMENT AND BENCHMARKS
- 5 EROSION CONTROL AND RESTORATION PLAN
- 6 DRAINAGE PLAN AND PROFILE
- 7-12 S. U. E. PLANS
- 13 DRIVEWAY DETAILS DISTANCE BETWEEN R.O. W. AND FACE OF CURB IS LESS THAN 15' (8002)
- DETAILS FOR DEPRESSED CURB & GUTTER AND SHOULDER TREATMENT AT TBT TY 1 SPL (BD 34)
- 15 TRAFFIC CONTROL AND PROTECTION FOR SIDE ROADS, INTERSECTIONS, AND DRIVEWAYS (TC 10)
- 16 ARTERIAL ROAD INFORMATION SIGN (TC 22)

HIGHWAY STANDARDS

SID. NO.	IIILE
000001-06	STANDARD SYMBOLS, ABBREVIATIONS AND PATTERNS
001001-02	AREAS OF REINFORCEMENT BARS
280001-07	TEMPORARY EROSION CONTROL SYSTEMS
424026-01	ENTRANCE / ALLEY PEDESTRIAN CROSSINGS
542001-03	CONCRETE END SECTIONS FOR PIPE CULVERTS 15" THRU 84" DIAMETER
602401-03	MANHOLE, TYPE A
602601-02	PRECAST REINFORCED CONCRETE FLAT SLAB TOP
602701-02	MANHOLE STEPS
604001-03	FRAME AND LIDS, TYPE 1
701101-03	OFF ROAD OPERATIONS, MULTILANE, 15. TO 24. FROM PAVEMENT EDGE
701106-02	OFF ROAD OPERATIONS, MULTILANE, MORE THAN 15. (4.5 m) AWAY
701601-08	URBAN LANE CLOSURE, MULTILANE, 1W OR 2W WITH NONTRAVERSABLE MEDIAN
701901-02	TRAFFIC CONTROL DEVICES

GENERAL NOTES

- BEFORE STARTING ANY EXCAVATION. THE CONTRACTOR SHALL CALL "J. U. L. I. E." AT BOO-892-0123 FOR FIELD LOCATIONS OF BURIED ELECTRIC, TELEPHONE AND GAS FACILITIES. (48 HOUR NOTIFICATION IS REQUIRED).
- 2. THE CONTRACTOR SHALL COORDINATE CONSTRUCTION ACTIVITIES WITH UTILITY COMPANIES.
- 3. THE CONTRACTOR WILL NOT BE ALLOWED TO SET UP A YARD OR FIELD OFFICE ON STATE PROPERTY WITHOUT WRITTEN PERMISSION FROM THE DEPARTMENT.
- 4. THE CONTRACTOR SHALL CONTACT THE TRAFFIC CONTROL SUPERVISOR AT (847) 705-4470

 A MINIMUM 72 HOURS IN ADVANCE OF BEGINNING WORK.
- 5. THE CONTRACTOR SHALL BE REQUIRED TO PROVIDE ACCESS TO ABUTTING PROPERTY AT ALL TIMES DURING THE CONSTRUCTION OF THIS PROJECT.
- 6. IT SHALL BE THE CONTACTOR'S RESPONSIBILITY TO VERIFY ALL DIMENSIONS AND CONDITIONS EXISTING IN THE FIELD PRIOR TO CONSTRUCTION AND ORDERING OF MATERIALS.
- FOR STORM SEWER CONSTRUCTED UNDER THE ROADWAY, BACKFILLING METHODS TWO AND THREE AUTHORIZED UNDER THE PROVISIONS OF ARTICLE 550, 07 OF THE STANDARD SPECIFICATIONS WILL NOT BE ALLOWED.
- 8. THE COST OF CONNECTING EXISTING STORM SEWERS TO PROPOSED STORM SEWERS AND TO
 PROPOSED DRAINAGE STRUCTURES AND THE COST OF CONNECTING PROPOSED STORM SEWERS
 TO EXISTING DRAINAGE STRUCTURES WILL NOT BE PAID FOR SEPARATELY BUT INCLUDED
 IN THE COST OF THE VARIOUS DRAINAGE ITEMS.

THE ENTAR					100% 57	ATE
		PAY ITEM NUMBER	DESCRIPTION	UNIT	URBAN TOTAL QUANTITY	0044 DRAINAGE
		20100500 ,	TREE REMOVAL, ACRES	ACRE	0.10	0.10
		20800150	TRENCH BACKFILL	CU YD	733	733
	-	21101615	TOPSOIL FURNISH AND PLACE, 4"	SO YO	041	941
		21101013	TO SOLE LOUNTED AND PEACE, 4	30 10	941	941
		25000210	SEEDING, CLASS 2A	ACRE	0. 20	0. 20
11.					·	
	-	25000400	NITROGEN FERTILIZER NUTRIENT	POUND	18	18
		25000600	POTACCION ECOTO TEO MITOICALY	00:418	10	
		25000600	POTASSIUM FERTILIZER NUTRIENT	POUND	18	18
		25100630	EROSION CONTROL BLANKET	\$0 YD	941	941
a t						······································
		28000250	TEMPORARY EROSION CONTROL SEEDING	POUND	10	10
		28000400	PERIMETER EROSION BARRIER	FOOT	1,057	1.057
	-	28100109	STONE RIPRAP, CLASS A5	SO YO	16	16
					To a second seco	
		28200200	FILTER FABRIC	. SO YD	16	16
						····
		40200800	AGGREGATE SURFACE COURSE, TYPE B	TON	281	281
:		54261236	CONCRETE END SECTION, STANDARD 542001, 36", 1:2	EACH	1	1
•			31.000.000.000.000.000.000.000.000.000.0	- CAON	•	1
		550A0450	STORM SEWERS, CLASS A, TYPE 2 36"	FOOT	319	319
	-	550A0750	STORM SEWERS, CLASS A. TYPE 3 36"	FOOT	132	132
	-	60221100	MANHOLES, TYPE A, 5'*DIAMETER, TYPE 1 FRAME, CLOSED LID	EACH	5	5
	\vdash	20121100	THE I FRAME, CLUSED LID	LACO	J	
		60500040	REMOVING MANHOLES	EACH	T Comment	1
. •						
•	*	66900200	NON-SPECIAL WASTE DISPOSAL	CU YD	800	800_
	*	66900450	SPECIAL WASTE PLANS AND REPORTS	L SUM	I.	1
N.						

100% STATE	_	TE	74	S	1/4	0	10	
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	PAY ITEM NUMBER	DESCRIPTION	UNIT	URBAN TOTAL QUANTITY	0044 DRAINAGE
*	66900530	SOIL DISPOSAL ANALYSIS	EACH	2	2
	67000400	ENGINEER'S FIELD OFFICE, TYPE A	CAL MO	6	6
	67100100	MOBILIZATION	L SUM	1	1
	70102630	TRAFFIC CONTROL AND PROTECTION, STANDARD 701601	L SUM	1	1
	20013798	CONSTRUCTION LAYOUT	L SUM	1	1
	20030850	TEMPORARY INFORMATION SIGNING	SO FT	51	51
	Z0048665	RAILROAD PROTECTIVE LIABILITY INSURANCE	L SUM	1	1
	Z0064800	SELECTIVE CLEARING	UNIT	6	6
			L		

* Specialty Items

ASHLAND AVE. (THORNTON RD. - BROADWAY ST.) SUMMARY OF QUANTITIES

SCALE: 1"=50" SHEET 1 OF 1 SHEETS STA.


F.A.U. RTE. 2857

TO STA.

SECTION 146-T

FILE NAME =	USER NAME = 1485	DESIGNED	*	EF	REVISED -
H\Job=28!]\28!138!2-86\CAD\S\t+\dgn\88\	60R82\0160R82-±ht-509.dgn	DRAWN	-	EF	REVISED -
	PLOT SCALE * 100.0000 1/ in.	CHECKED	•	RS	REVISED ~
	PLOT DATE * 5/6/2013	DATE	-	05-09-2013	REVISED -

STATE OF ILLINOIS
DEPARTMENT OF TRANSPORTATION

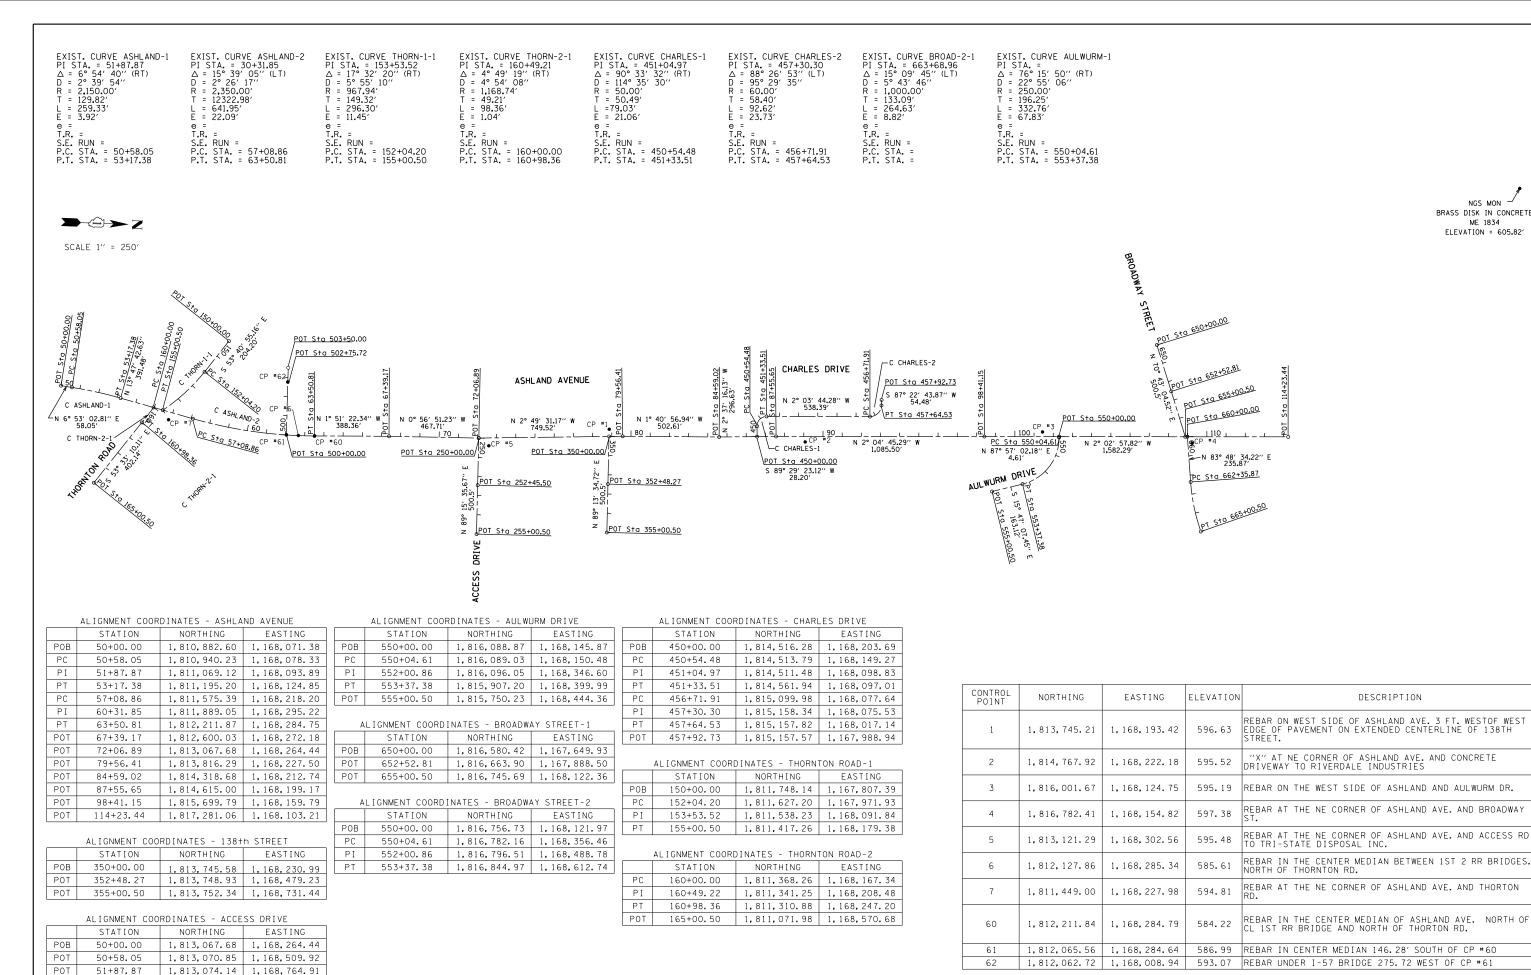

FILE NAME

USER NAME = 1485

PLOT SCALE = 500.0000 '/ in.

PLOT DATE = 4/25/2013

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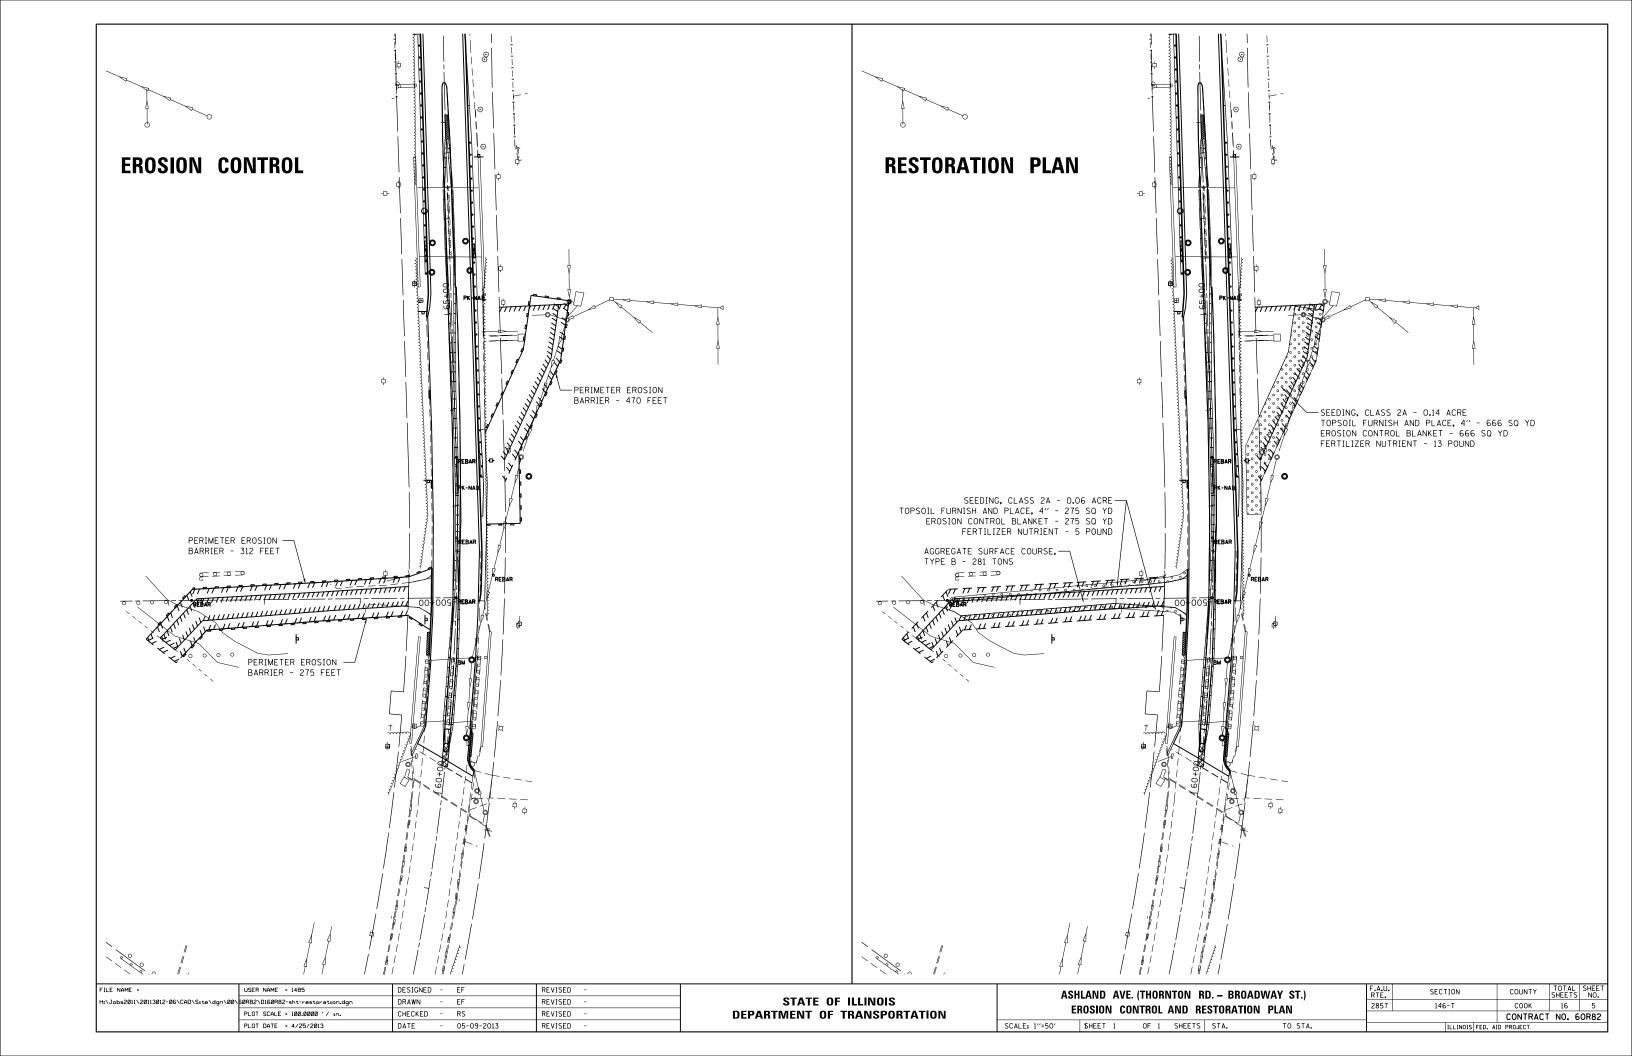
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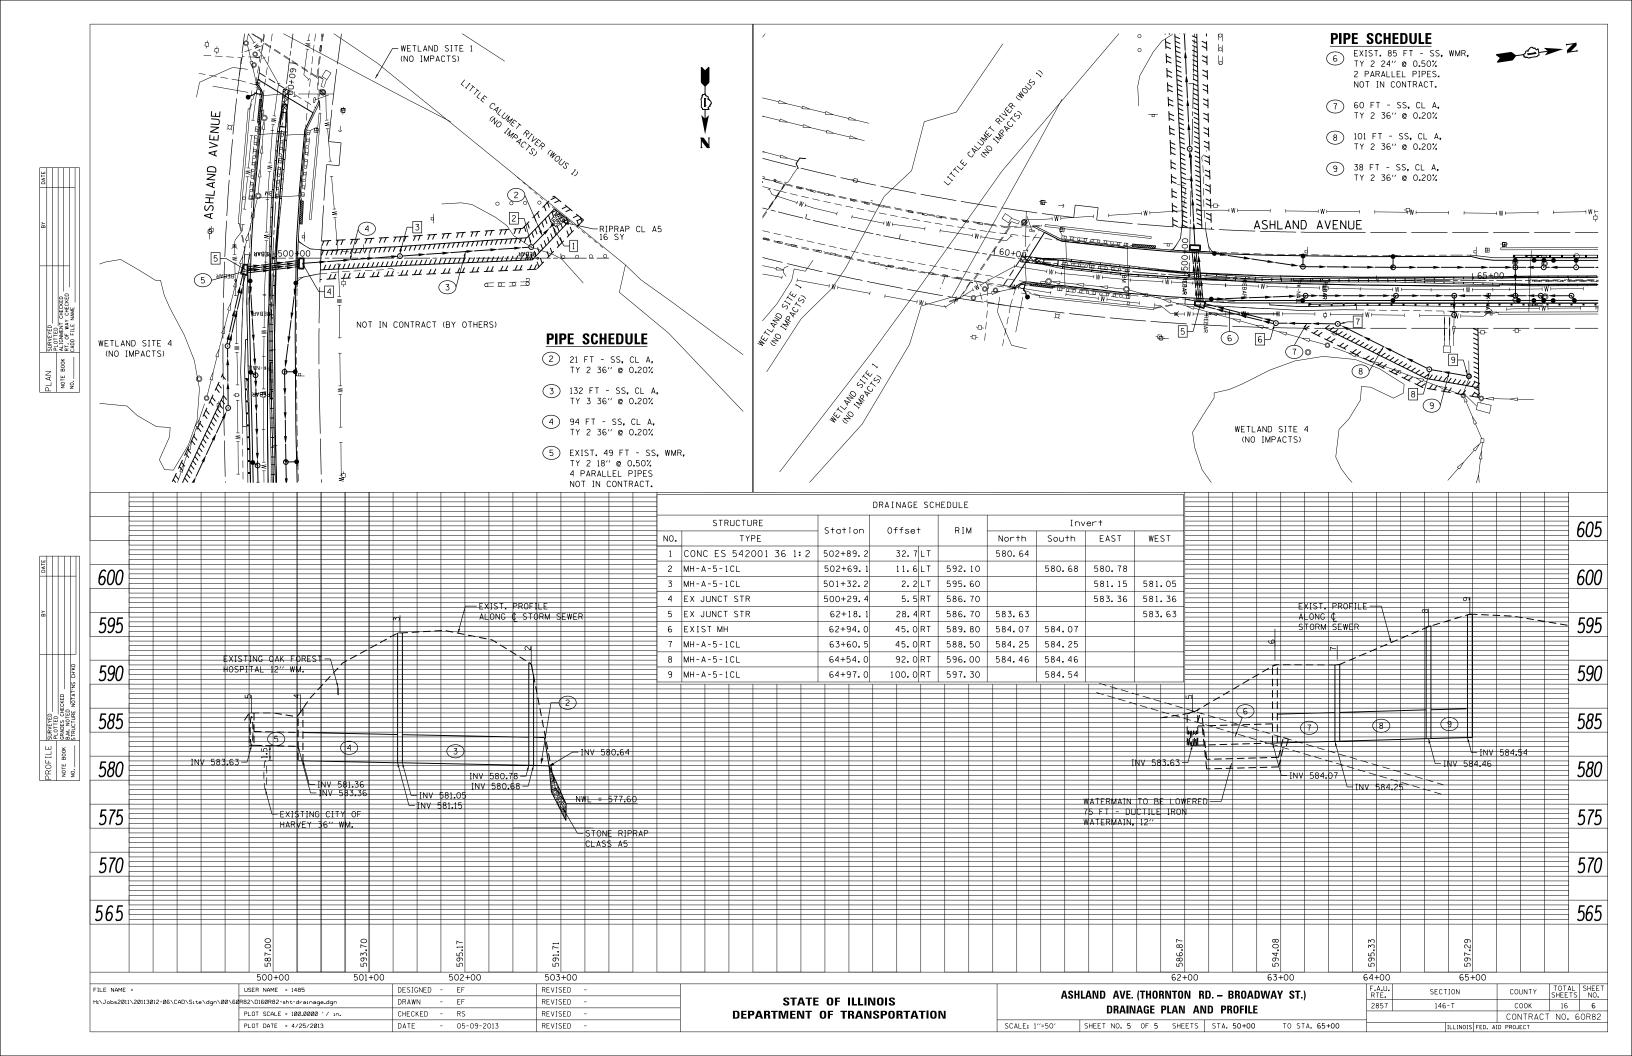
CTATE OF HIMMOR	ASH	ILAND A	VE. (THOR	NTON R	D. – BR	OADWAY ST.)	F.A.U. RTE.	SEC	TION	COUNTY	TOTAL SHEETS	SHEET NO.
STATE OF ILLINOIS	ALIGNMENTS AND BENCHMARKS				2857	146	- T	соок	16	4		
DEPARTMENT OF TRANSPORTATION			JINIVILINIO							CONTRAC	T NO. 6	50R82
	SCALE: 1"=250"	SHEET	1 OF 1	SHEETS	STA.	TO STA.			ILLINOIS FED.	AID PROJECT		

NGS MON BRASS DISK IN CONCRETE


ME 1834 ELEVATION = 605.82'


DESCRIPTION







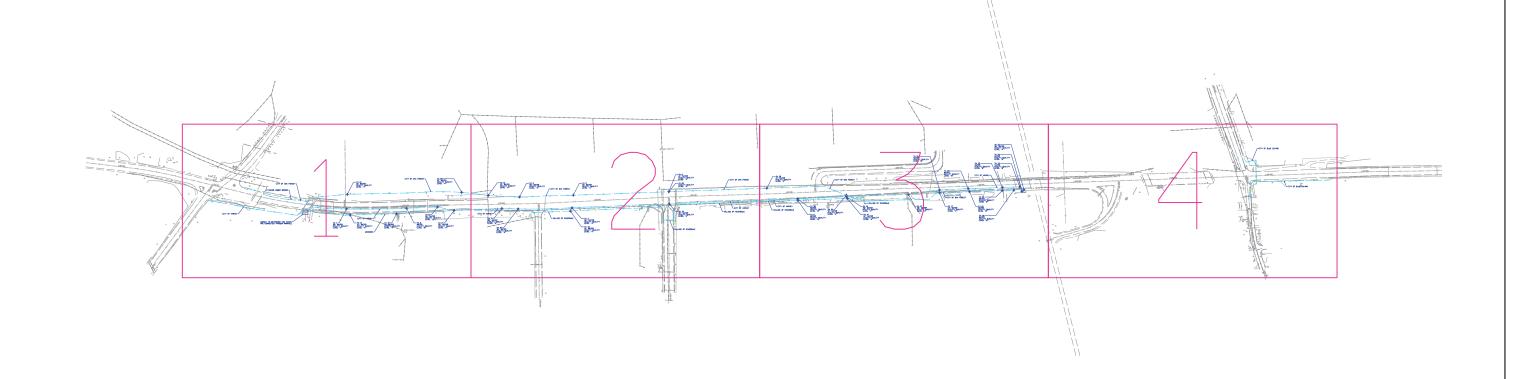

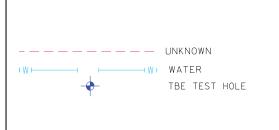

CITY OF BLUE ISLAND = WATER CITY OF HARVEY = WATER
CITY OF OAK FOREST = WATER UNKNOWN = WATER
VILLAGE OF RIVERDALE = WATER

UTILITY OWNERS

Utilities shown on these plans as depicted in the legend have been investigated by Cardno TBE in accordance with SUE Industry Standards. All other information shown has been provided to Cardno TBE by others. Cardno TBE SUE field investigation was performed 9/06/12 through 9/20/12. Changes to utilities after 9/20/12 may have been made and therefore may result in variances from this plan. Consideration should be given to updating this plan if deemed advisable prior to final design and construction.

ALL UTILITIES SHOWN QUALITY LEVEL "B" UNLESS NOTED OTHERWISE.



TBE Job No. IL09510509 SUE Plan Page: Cover


Utility Quality Level "A" : Visually Verified Test Hole Utility Quality Level "B" : Designating/non Visually Verified Test Hole


Utility Quality Level "C": Research with Survey Utility Quality Level "D" : Records Research


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DRAWN	SRK	REVISED
CHECKED	KFS	REVISED
DATE	9/2812	REVISED


STATE OF ILLINOIS DEPARTMENT OF TRANSPORTATION Ashland Avenue; Broadway to Thornton Road Blue Island, İllinois

COUNTY TOTAL SHEETS NO.
Cook 16 7 SECTION 2857 146-T 2011-054-1 Contract No. 60P64 60R82

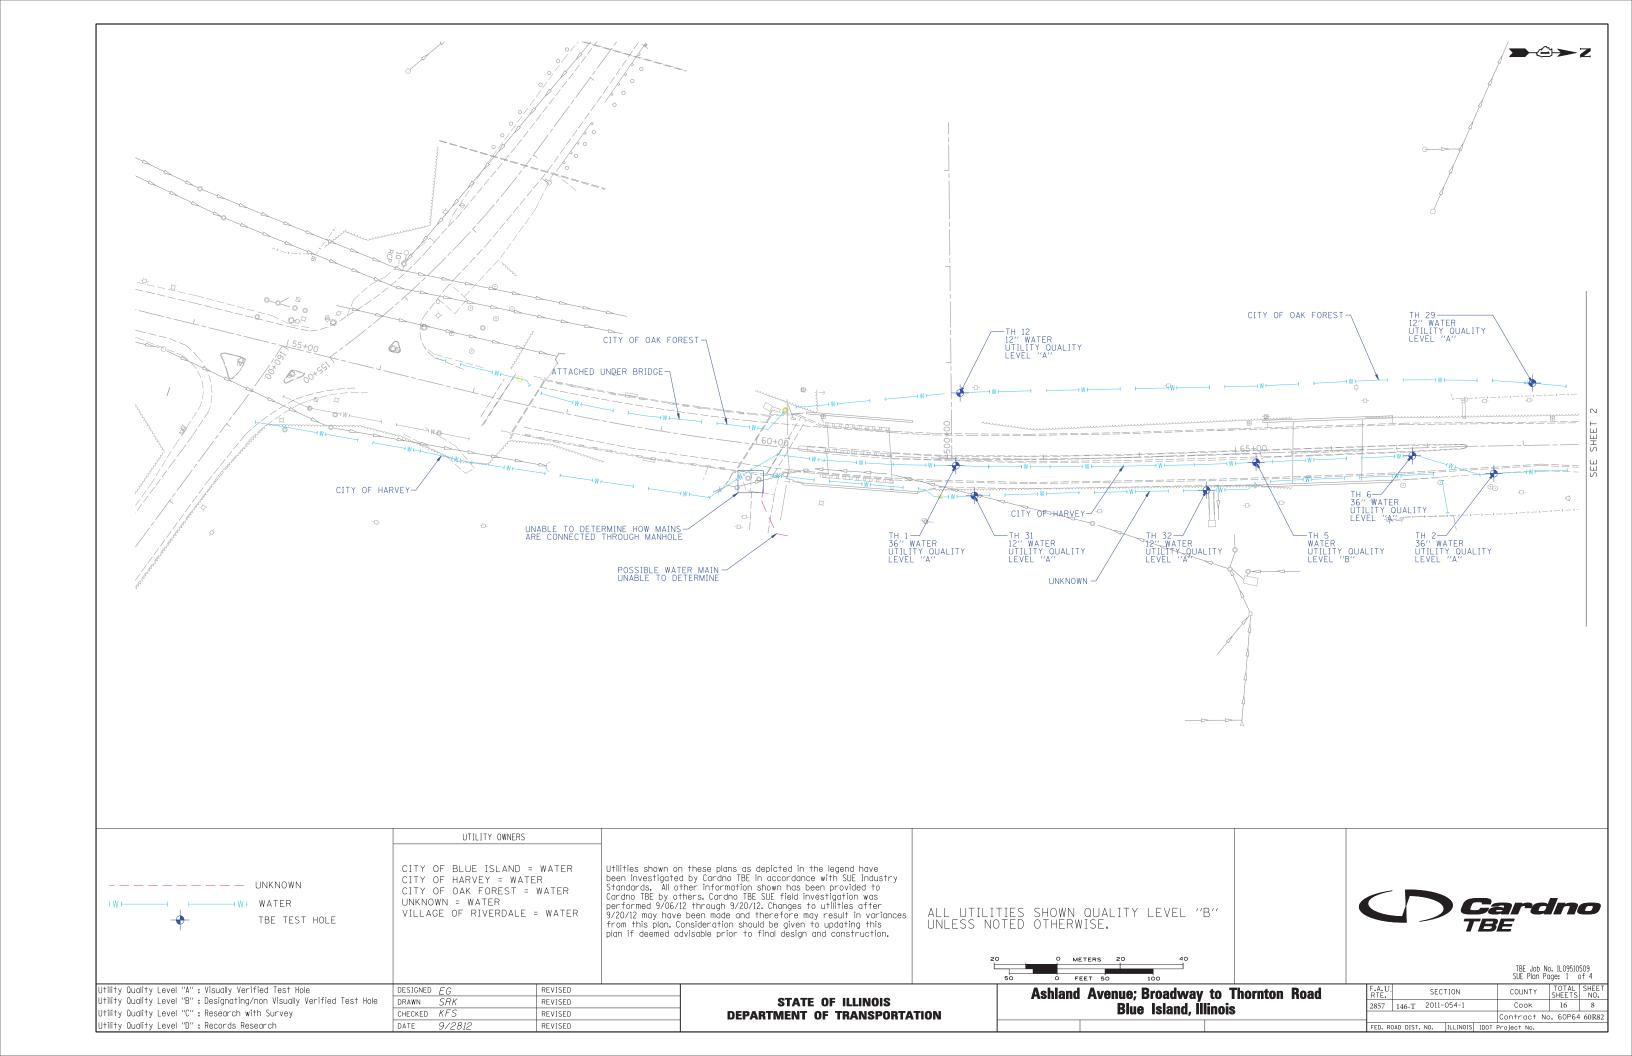

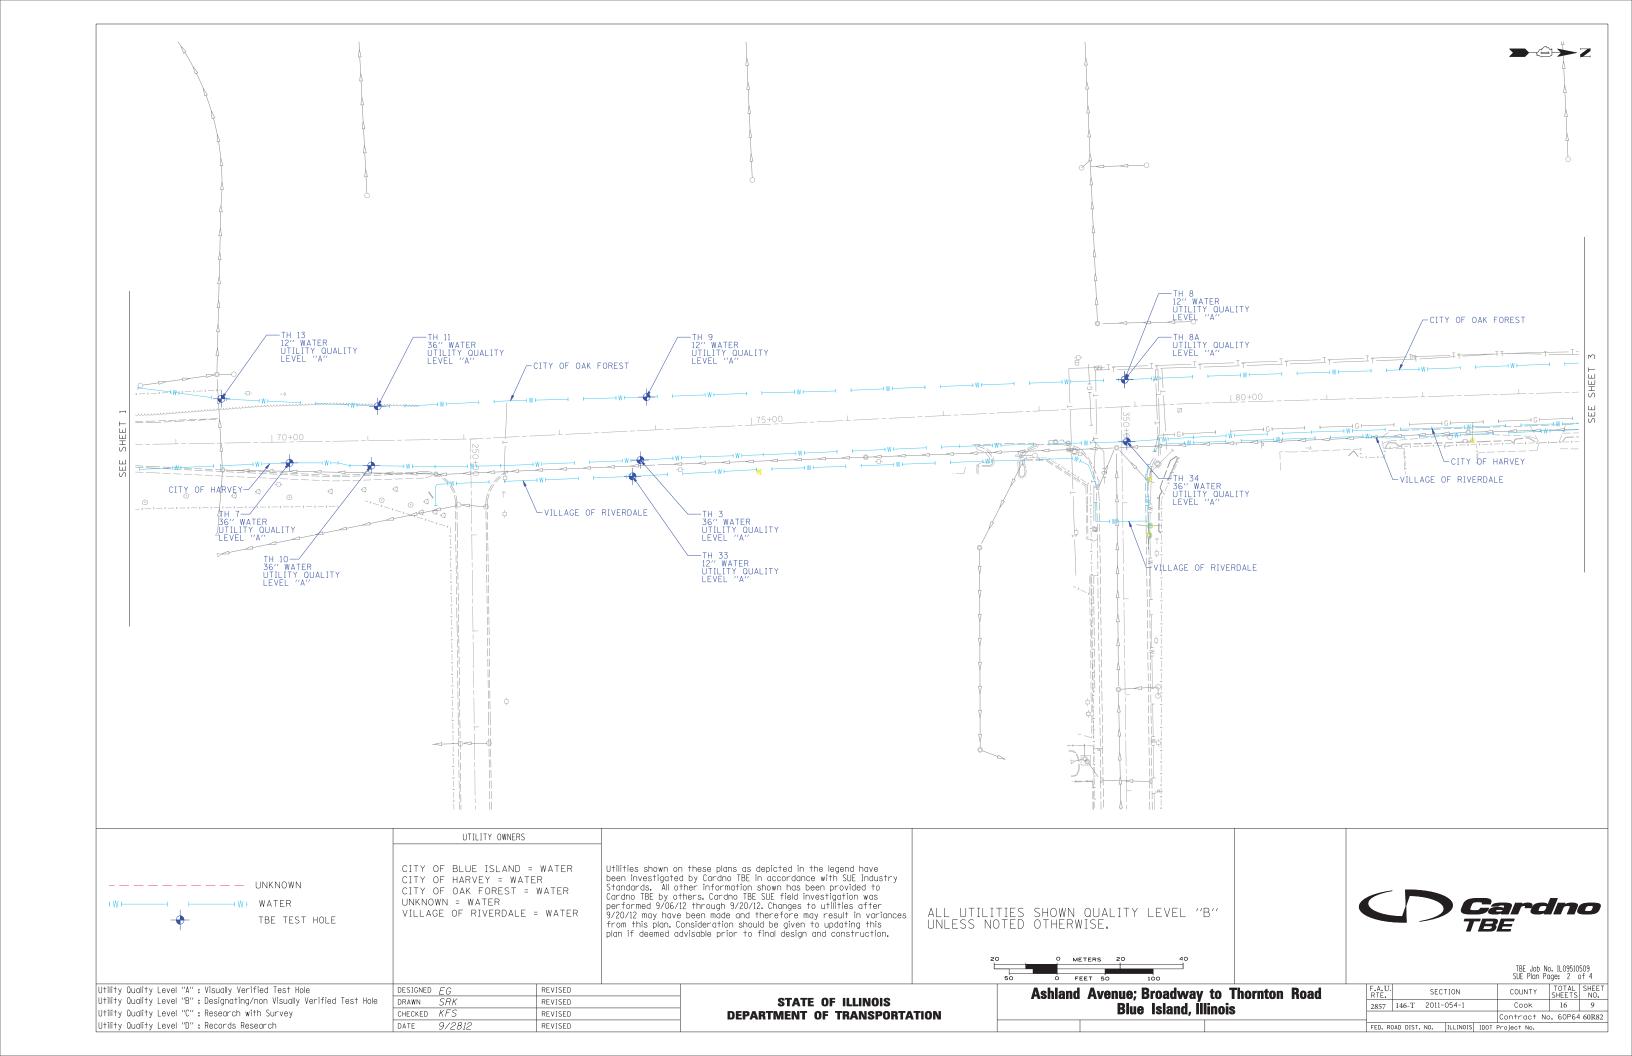

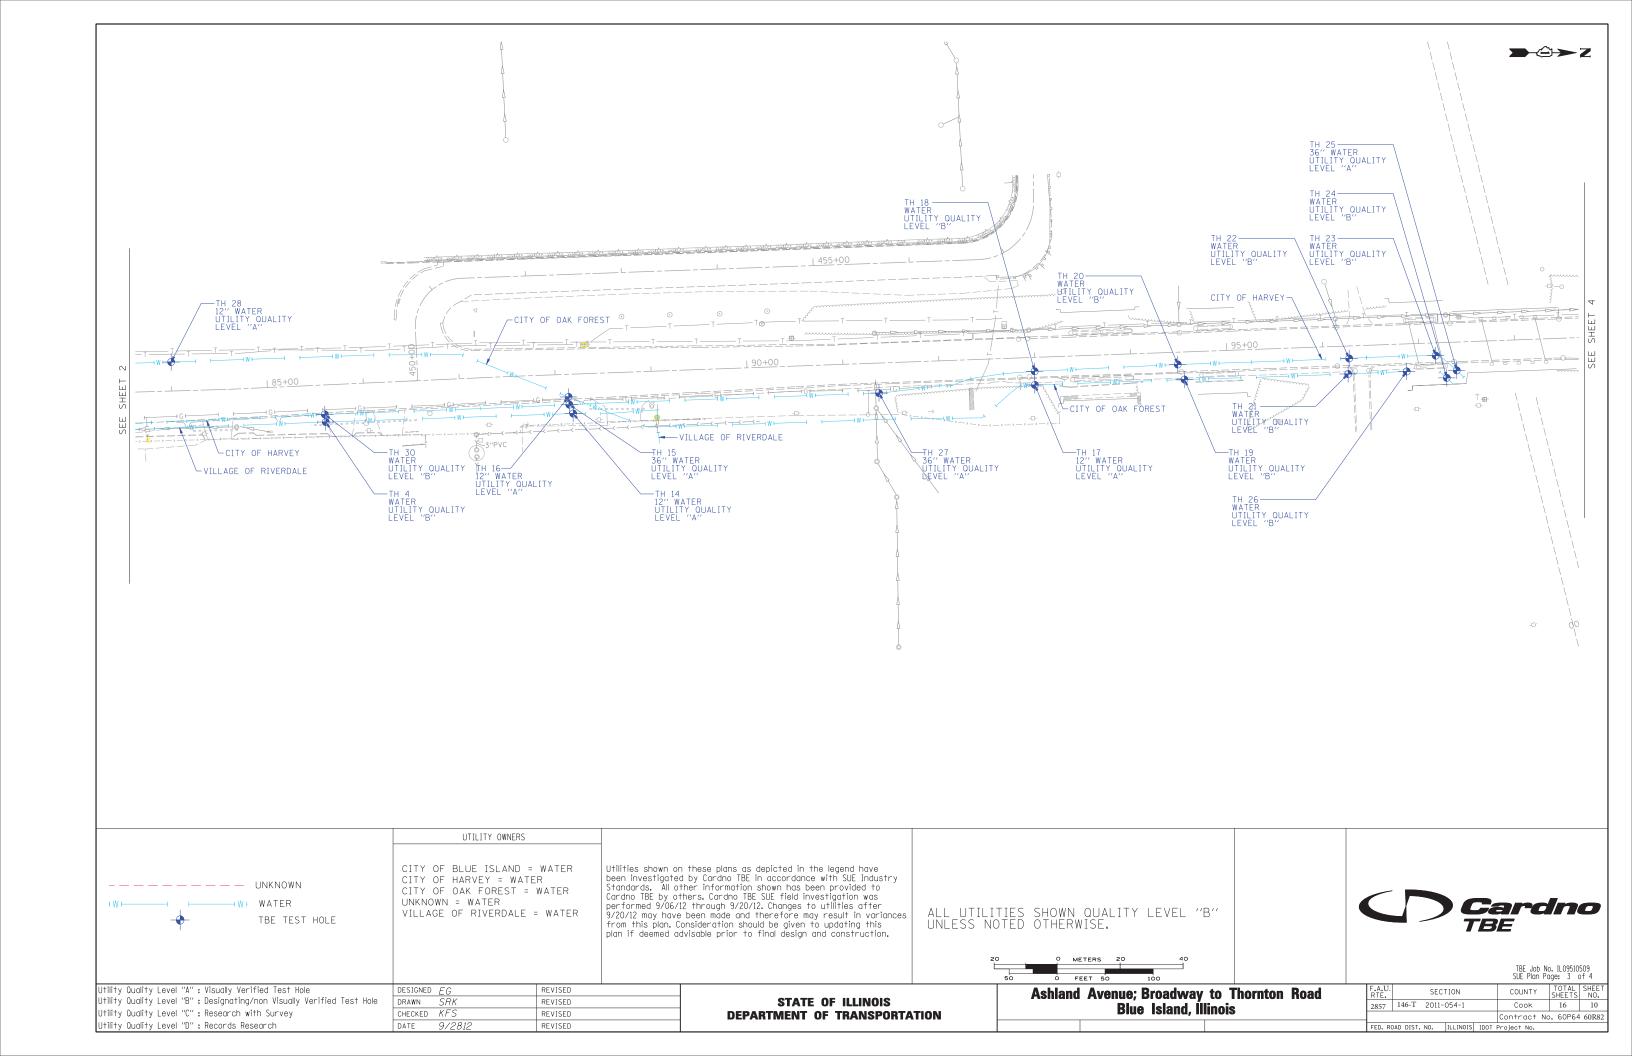

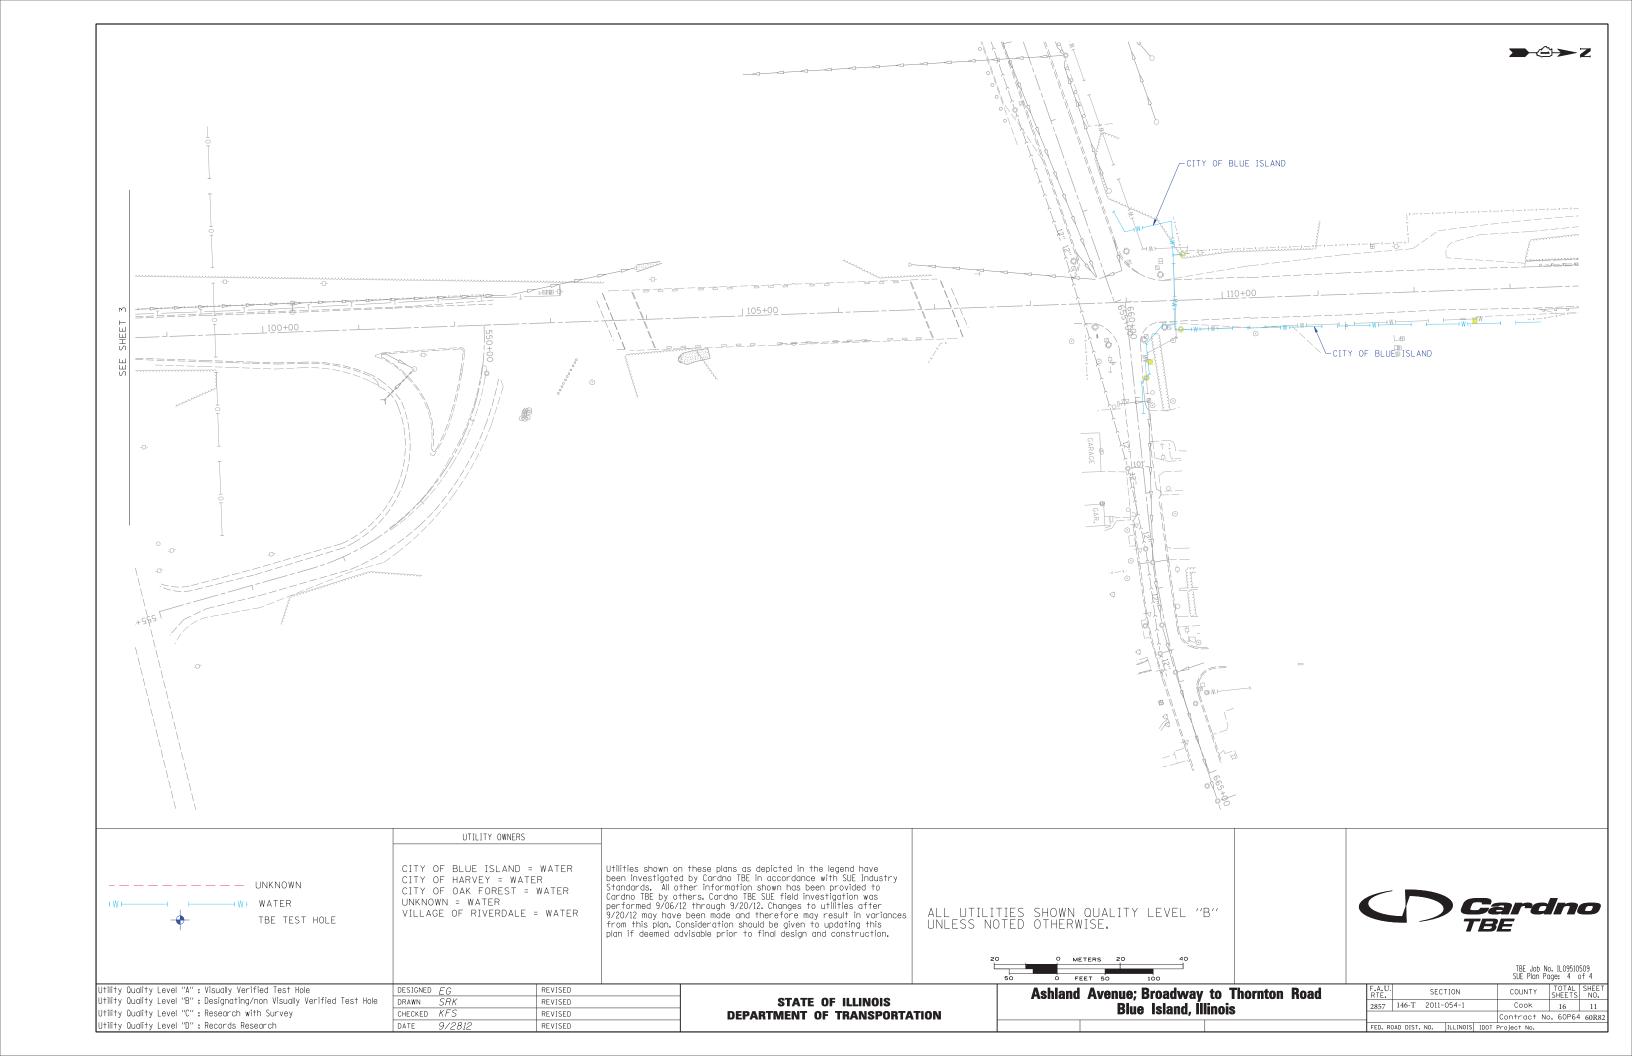

VERIFIED UTILITY INFORMATION												
TEST HOLE #	SIZE &	TYPE	NORTHING	EASTING	EXISTING TOP ELEVATION	EXISTING CUT	REFERENCE ELEVATION	COMMENTS				
1	36′′	W	1812069.68	1168292.19	582.09′	4.45′	586.54′	UTILITY QUALITY "A"				
2	36′′	W	1812630.15	1168300.42	580.85′	4.71′	585.56′	UTILITY QUALITY "A"				
3	36′′	W	1813244.62	1168286.40	589.78′	5.31′	595.09′	UTILITY QUALITY "A"				
4	N/A	W	1814420.43	1168246.77	592.22′	5.99′	598.21′	UTILITY QUALITY "B"				
5	N/A	W	1812382.44	1168288.95	575.85′	4.51′	580.36′	UTILITY QUALITY "B"				
6	36′′	W	1812545.22	1168281.90	577.32′	4.62′	581.94′	UTILITY QUALITY "A"				
7	36′′	W	1812879.15	1168289.32	588.71′	5.00′	593.71′	UTILITY QUALITY "A"				
8	12′′	W	1813749.10	1168202.75	592.20′	4.57′	596.77′	UTILITY QUALITY "A"				
8.4	3′′	UNK	1813749.06	1168202.63	594.47′	2.30′	596.77′	UTILITY QUALITY "A"				
9	12′′	W	1813251.11	1168220.76	590.71′	5.07′	595.78′	UTILITY QUALITY "A"				
10	36′′	W	1812964.22	1168292.21	591.33′	3.61′	594.94′	UTILITY QUALITY "A"				
11	12′′	W	1812970.94	1168230.39	590.22′	4.94′	595.16′	UTILITY QUALITY "A"				
12	12′′	W	1812074.15	1168216.50	589.67′	1.91′	591.58′	UTILITY QUALITY "A"				
13	12′′	W	1812808.20	1168222.58	591.40′	2.42′	593.82′	UTILITY QUALITY "A"				
14	12′′	W	1814678.13	1168237.91	592.26′	3.27′	595.53′	UTILITY QUALITY "A"				
15	36′′	W	1814674.17	1168228.66	591.09′	5.92′	597.01′	UTILITY QUALITY "A"				
16	12′′	W	1814673.36	1168220.66	592.74′	4.33′	597.07′	UTILITY QUALITY "A"				
17	12′′	W	1815159.11	1168208.11	583.02′	4.36′	587.38′	UTILITY QUALITY "B"				
18	N/A	W	1815158.88	1168193.91	580.36′	7.21′	587.57′	UTILITY QUALITY "B"				
19	N/A	W	1815314.96	1168202.50	583.29′	5.00′	588.29′	UTILITY QUALITY "B"				
20	N/A	W	1815308.00	1168186.81	582.07′	5.49′	587.56′	UTILITY QUALITY "B"				
21	N/A	W	1815485.43	1168196.72	583.06′	4.69′	587.75′	UTILITY QUALITY "B"				
22	N/A	W	1815486.52	1168180.55	582.67′	4.75′	587.42′	UTILITY QUALITY "B"				
23	N/A	W	1815576.67	1168177.56	583.40′	4.22′	587.62′	UTILITY QUALITY "B"				
24	N/A	W	1815588.26	1168200.76	585.86′	4.78′	590.64′	UTILITY QUALITY "B"				
25	36′′	W	1815598.65	1168193.01	583.91′	4.50′	588.41′	UTILITY QUALITY "A"				
26	N/A	W	1815546.45	1168194.08	582.59′	5.32′	587.91′	UTILITY QUALITY "B"				
27	36′′	W	1814996.76	1168216.62	583.83′	5.81′	589.64′	UTILITY QUALITY "A"				
28	12′′	W	1814259.37	1168184.28	592.54′	5.22′	597.76′	UTILITY QUALITY "A"				
29	12′′	W	1812670.37	1168206.17	589.81′	2.10′	591.91′	UTILITY QUALITY "A"				
30	N/A	W	1814419.45	1168238.82	592.31′	5.68′	597.99′	UTILITY QUALITY "B"				
31	12′′	W	1812089.05	1168323.50	586.70′	1.99′	588.69′	UTILITY QUALITY "A"				
32	12′′	W	1812330.83	1168317.88	579.49′	2.47′	581.96′	UTILITY QUALITY "A"				
33	12′′	W	1813236.43	1168303.40	590.19′	5.39′	595.58′	UTILITY QUALITY "A"				
34	36′′	W	1813751.44	1168267.31	591.10′	6.11′	597.21′	UTILITY QUALITY "A"				

NOTES TH #4, 19, 21, 24 & 26 - Unable to verify size & material of pipe due to excessive ground water infiltration within the excavated hole. However, by utilizing an air lance we were able to feel what is believed to be the top of a 12" water main. TH #5, 18, 20, 22, 23 & 30 - Unable to verify size & material of pipe due to excessive ground water infiltration within the excavated hole. However, by utilizing an air lance we were ableto feel what is believed to be the top & sides of a 36" water main. TH #8A -Found unknown utility while excavating for water main. Appears to be a fiberglass material. TH #17 - Briefly exposed 12" main before excessive ground water infiltrated the excavated hole. Manual depth was taken.

TH #34 - 36" water offset taken from centerline of 138th Street.

ABBREVIATIONS

UNK = UNKNOWN W = WATER

ALL INFORMATION SHOWN WAS OBTAINED FROM A LOCATION SURVEY.



Checked By: _

TBE Job No. IL09510509


DESIGNED ED REVISED STATE OF ILLINOIS DRAWN SRK REVISED CHECKED KFS REVISED DATE 9/28/12


Ashland Ave. Broadway to Thornton Rd. Blue Island, IL

COUNTY TOTAL SHEET NO.

Cook 16 12 COUNTY 2857 146-T 2 11-054-1 Contract No. 60P64 FED. ROAD DIST. NO. ILLINOIS

DEPARTMENT OF TRANSPORTATION

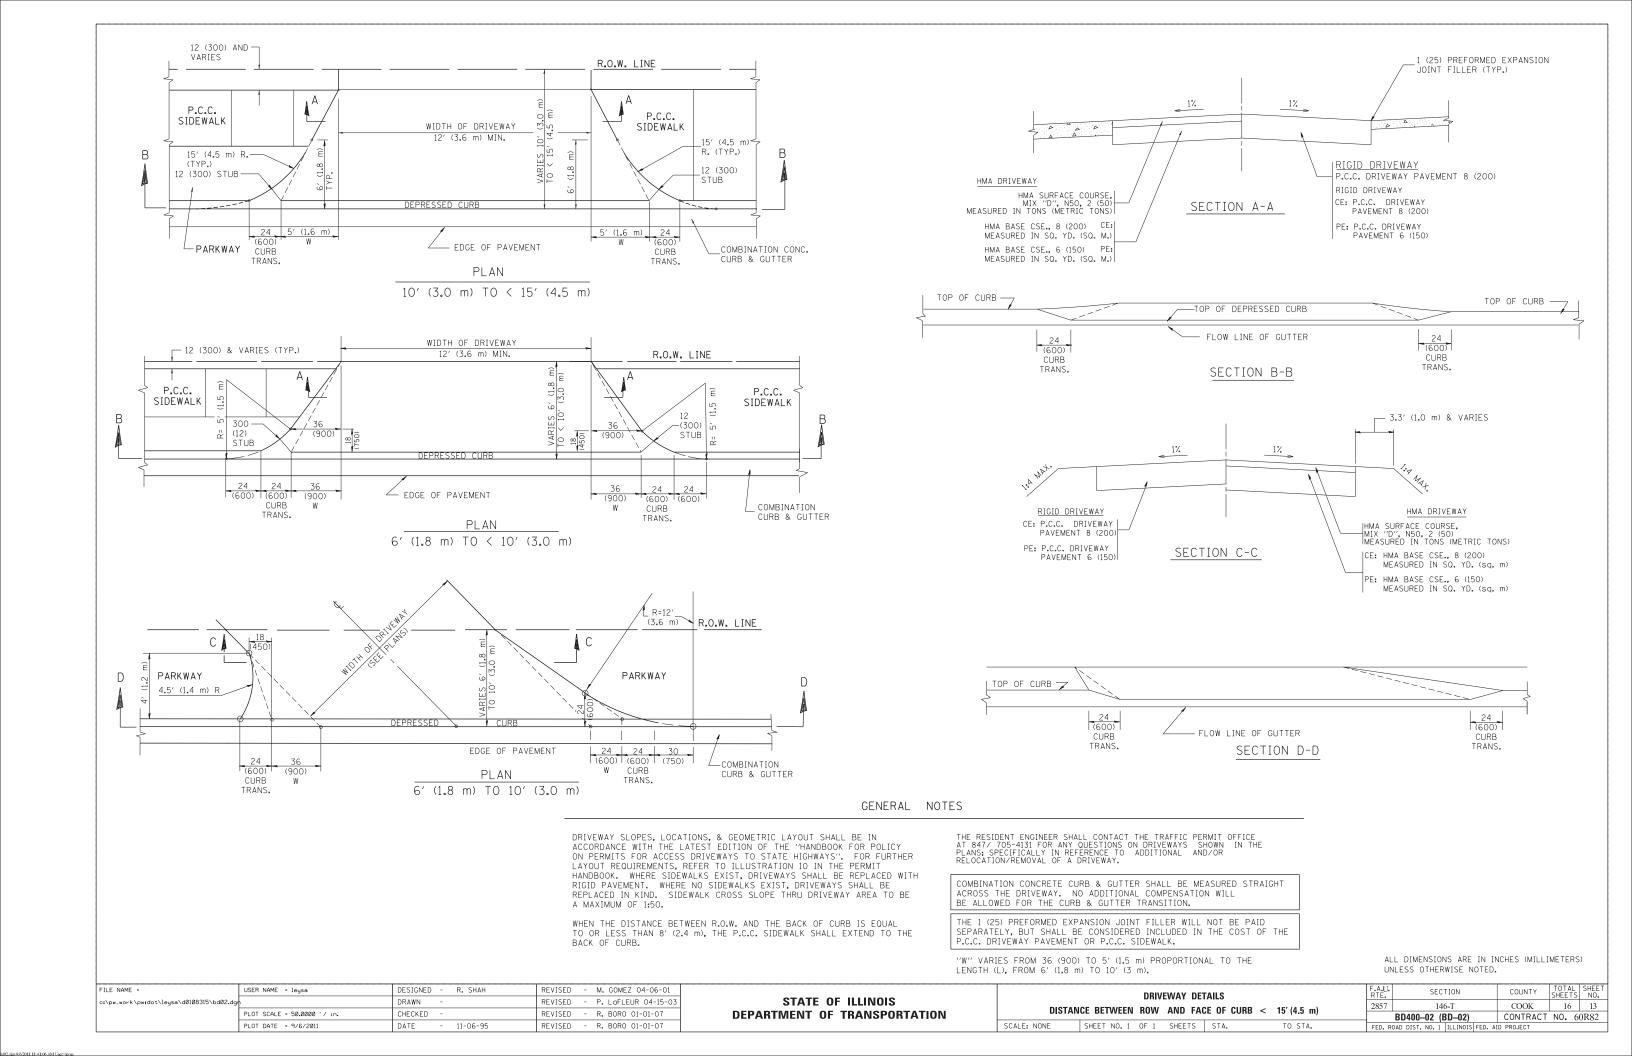

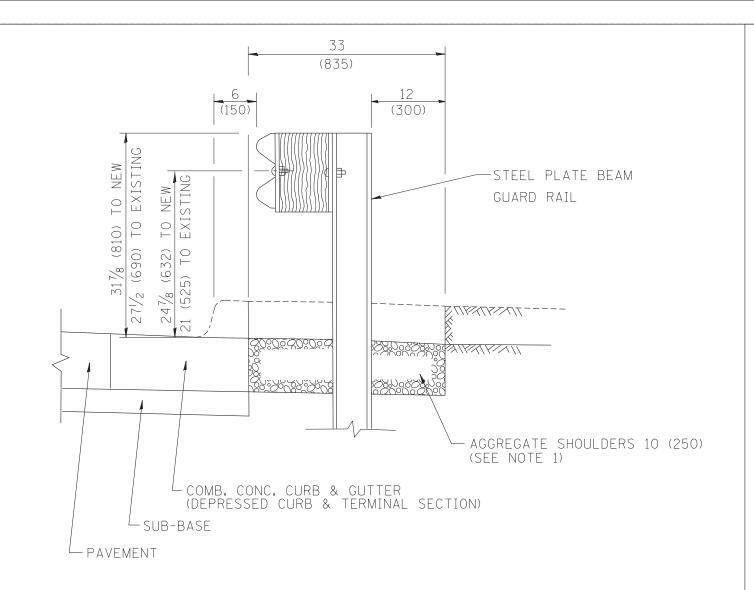


SECTION A-A

- NOTES: 1. THE AGGREGATE SHOULDER, 10" OR HMA SHOULDER, 6" (IF REQUIRED) SHALL EXTEND UNDER THE TRAFFIC BARRIER TERMINAL.
 - 2. "EXISTING" GUARDRAIL REFERS TO CONNECTING TERMINAL SECTION TO GUARD RAILING PRIOR TO THE MIDWEST GUARDRAIL SYSTEM.
 - 3. THE CONTRACTOR SHALL VERIFY THE TYPE/HEIGHT OF GUARDRAIL IN-PLACE BEFORE ORDERING THE NEW TERMINAL SECTION. COST INCLUDED WITH THE COST OF THE TERMINAL. THE TERMINAL SECTION HEIGHT TO BE PLACED MUST MATCH THE HEIGHT OF THE IN-PLACE GUARDRAIL.

DETAILS FOR STEEL PLATE BEAM
GUARD RAIL ADJACENT TO CURB AND GUTTER

[FOR ROADWAY SPEED 35 MPH (60 kmh) TO 45 MPH (70 kmh)]

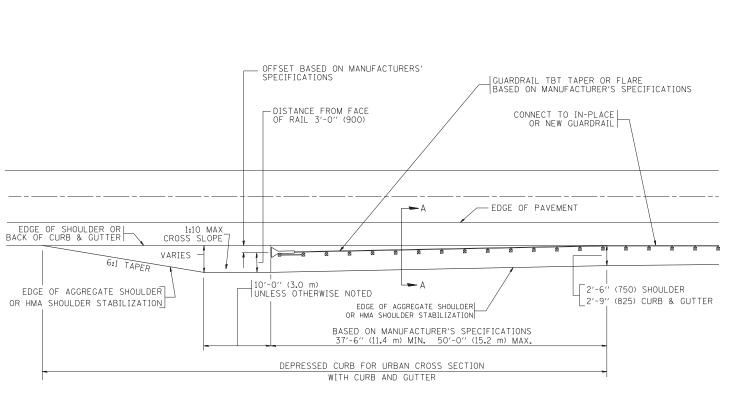

DEPRESSED CURB AND GUTTER AND SHOULDER TREATMENT AT TBT TY. 1 SPL.

BASIS OF PAYMENT: HMA SHOULDERS 6 (150) (IF REQUIRED) WILL BE

PAID FOR AT THE CONTRACT UNIT PRICE
PER SQUARE YARD (SQUARE METER) FOR
"HOT-MIX ASPHALT SHOULDERS 6" (150 mm)".

STEEL PLATE BEAM GUARD RAIL AND TRAFFIC BARRIER TERMINAL, OF THE TYPE SPECIFIED WILL BE PAID FOR SEPARATELY.

TBT = TRAFFIC BARRIER TERMINAL

ALL DIMENSIONS ARE IN INCHES (MILLIMETERS) UNLESS OTHERWISE SHOWN.

FILE NAME = DESIGNED - M. DE YONG REVISED - E. GOMEZ 08-28-00 USER NAME = drivakosqn c:\pw_work\PWIDOT\DRIVAKOSGN\d0108315\bd34.dqn DRAWN REVISED R. BORO 01-01-07 CHECKED REVISED R. BORO 12-08-2008 PLOT DATE = 9/21/2009 R. BORO 09-14-2009 DATE 09-22-90 REVISED

STATE OF ILLINOIS
DEPARTMENT OF TRANSPORTATION


DETAILS FOR DEPRESSED CURB & GUTTER AND SHOULDER TREATMENT AT TBT TY 1 SPL

SHEET NO. 1 OF 1 SHEETS STA. TO STA.

SCALE: NONE

AJJ. SECTION COUNTY TOTAL SHEETS NO. 2857 146-T COOK 16 14

BD600-10 (BD 34) CONTRACT NO. 60R82

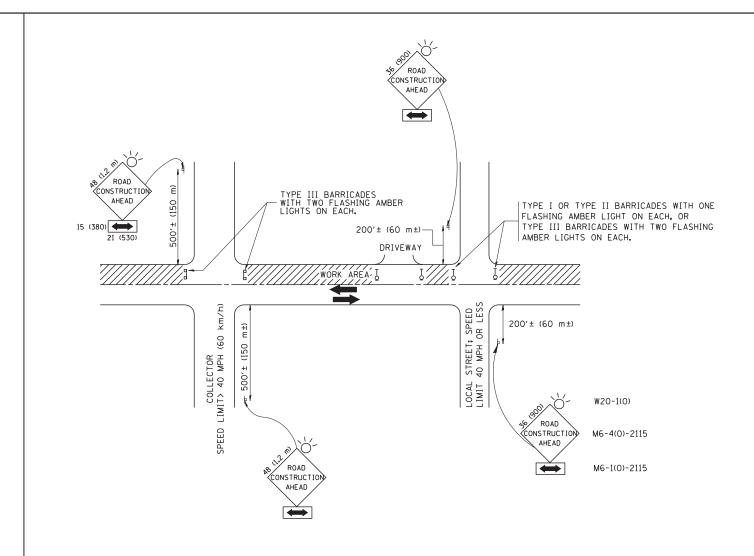

TRAFFIC CONTROL AND PROTECTION FOR SIDE ROADS, INTERSECTIONS, AND DRIVEWAYS

NOTES:

- A. FOR NO LANE RESTRICTION ON THE SIDE ROAD OR DRIVEWAYS
- 1. SIDE ROAD WITH A SPEED LIMIT OF 40 MPH (60 km/h) OR LESS AS SHOWN ON THE DRAWING AND AS DIRECTED BY THE ENGINEER:
- O) ONE ROAD CONSTRUCTION AHEAD SIGN 36 x 36 (900x900) WITH A FLASHER AND FLAG MOUNTED ON IT APPROXIMATELY 200' (60 m) IN ADVANCE OF THE MAIN ROUTE.
- b) THE CLOSED PORTION OF THE MAIN ROUTE SHALL BE PROTECTED BY BLOCKING WITH TYPE I, TYPE II OR TYPE III BARRICADES, 1/3 OF THE CROSS SECTION OF THE CLOSED PORTION.
- 2. SIDE ROAD WITH A SPEED LIMIT GREATER THAN 40 MPH (60 km/h) AS SHOWN ON THE DRAWING AND AS DIRECTED BY THE ENGINEER:
- a) one road construction ahead sign 48 \times 48 (1.2 m \times 1.2 m) with a FLASHER MOUNTED ON IT APPROXIMATELY 500' (150 m) IN ADVANCE OF THE MAIN ROUTE.
- b) THE CLOSED PORTION OF THE MAIN ROUTE SHALL BE PROTECTED BY BLOCKING WITH TYPE III BARRICADES, 1/2 OF THE CROSS SECTION OF THE CLOSED PORTION.
- 3. WHEN THE SIDE ROAD LIES BETWEEN THE BEGINNING OF THE MAINLINE SIGNING AND THE WORK ZONE, A SINGLE HEADED ARROW (M6-1) SHALL BE USED IN LIEU OF THE DOUBLE HEADED ARROW (M6-4).

SCALE: NONE

B. FOR A LANE CLOSURE ON A SIDE ROAD OR DRIVEWAY:

USE APPLICABLE PORTIONS OF THE TYPICAL APPLICATION OF TRAFFIC CONTROL DEVICES (STD. 701501, STD. 701606 OR THE APPROPRIATE STANDARD). THE SPACING OF SIGNS AND BARRICADES SHALL BE ADJUSTED FOR FIELD CONDITIONS AS DIRECTED BY THE ENGINEER. THE DIRECTIONAL ARROW SHALL BE COVERED OR REMOVED WHEN NO LONGER CONSISTENT WITH THE SIDE ROAD LANE CLOSURE.


- C. ADVANCE WARNING SIGNS ARE TO BE OMITTED ON DRIVEWAY UNLESS OTHERWISE NOTED.
- D. THE TRAFFIC CONTROL AND PROTECTION FOR SIDE ROADS, INTERSECTIONS, AND DRIVEWAYS SHALL BE INCIDENTAL TO THE COST OF SPECIFIED TRAFFIC CONTROL STANDARDS OR ITEMS.

All dimensions are in millimeters (inches) unless otherwise shown.

FILE NAME =	USER NAME = gaglianobt	DESIGNED - LHA	REVISED - J. OBERLE 10-18-95
W:\diststd\22x34\tc10.dgn		DRAWN -	REVISED - A. HOUSEH 03-06-96
	PLOT SCALE = 50.000 '/ IN.	CHECKED -	REVISED - A. HOUSEH 10-15-96
	PLOT DATE = 1/4/2008	DATE - 06-89	REVISED -T. RAMMACHER 01-06-00

STATI	E OI	: ILLINOIS
DEPARTMENT	OF	TRANSPORTATION

TRAFFIC CONTR	OL AND P	ROTECTIO	N FOR	F.A.U. RTE.	SECTION	COUNTY	TOTAL SHEETS	SHEET NO.
SIDE ROADS, INTER	PECTIONS	AND DE	IVEWAVE	2857	146-T	COOK	16	15
 SIDE NUADS, INTE	1950 10149	, AND DR	IIVEVVAIS	TC-10 CONTRACT NO. 60F				
SHEET NO. 1 OF 1	SHEETS	STA.	TO STA.	FED. R	OAD DIST. NO. 1 ILLINOIS FED. A			

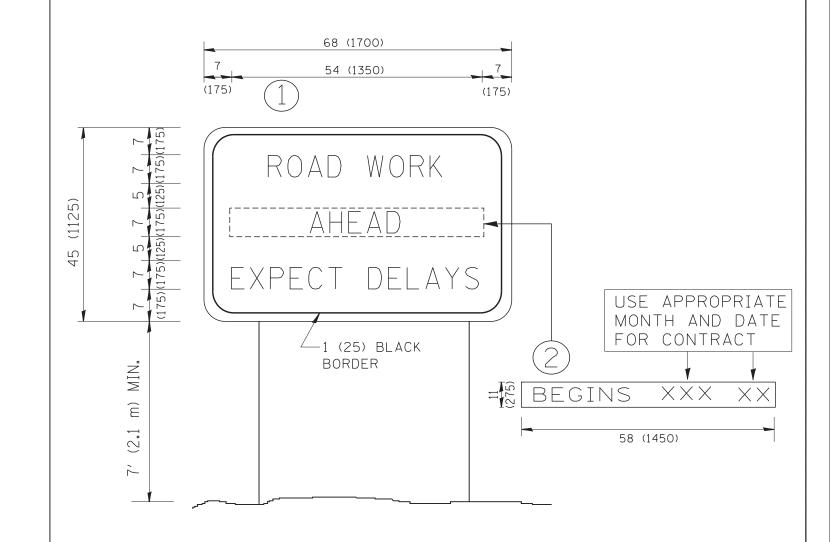

NOTES:

- 1. USE BLACK LETTERING ON ORANGE BACKGROUND.
- 2. ERECT SIGNS IN ADVANCE OF THE LOCATION FOR THE "ROAD CONSTRUCTION AHEAD" SIGN AT LOCATIONS AS DIRECTED BY THE ENGINEER.
- 3. ERECT SIGN (1) WITH INSTALLED PANEL (2) ONE WEEK PRIOR TO THE START OF CONSTRUCTION.
- 4. REMOVE PANEL (2) SOON AFTER THE START OF CONSTRUCTION.
- 5. SEE SPECIAL PROVISION FOR "TEMPORARY INFORMATION SIGNING" FOR ADDITIONAL INFORMATION.
- 6. ONE SIGN ASSEMBLY EQUALS 25.70 SQ. FT. (2.3 SQ. M.)
- 7. SHALL BE PAID FOR AS TEMPORARY INFORMATION SIGNING.

ALL DIMENSIONS ARE IN INCHES (MILLIMETERS) UNLESS OTHERWISE SHOWN.

FILE NAME =	USER NAME = gaglianobt	DESIGNED -	REVISED - R. MIRS 09-15-97			ARTERIAL ROAD		F.A.U.	SECTION	COUNTY	TOTAL SHEET
W:\diststd\22x34\to22.dgn		DRAWN -	REVISED - R. MIRS 12-11-97	STATE OF ILLINOIS					146-T	COOK	16 16
	PLOT SCALE = 50.000 '/ IN.	CHECKED -	REVISED -T. RAMMACHER 02-02-99	DEPARTMENT OF TRANSPORTATION	INFORMATION SIGN				TC-22	CONTRACT	NO. 60R82
	PLOT DATE = 1/4/2008	DATE -	REVISED - C. JUCIUS 01-31-07		SCALE: NONE	SHEET NO. 1 OF 1 SHEETS STA.	TO STA.	FED. ROAD		ED. AID PROJECT	