08-01-2025 LETTING ITEM 050

0

0

0

FOR INDEX OF SHEETS, SEE SHEET NO. 2

TRAFFIC DATA MADISON COUNTY LINE TO OHIO ST.

2023 ADT = 13500 (ACTUAL)2026 ADT = 13700 (ESTMATED)2046 ADT = 15100 (ESTIMATED)SU = 4.4% MU = 2.8%

OHIO ST. TO EB/WB 1-55

2023 ADT = 17200 (ACTUAL)2026 ADT = 17500 (ESTMATED)2046 ADT = 19300 (ESTIMATED)SU = 8.7% MU = 11.9%

EBWB 1-55 TO COLLINSVILLE RD 2023 ADT = 3500 (ACTUAL)2026 ADT = 3600 (ESTMATED)2046 ADT = 3900 (ESTIMATED)

SU = 10.7% MU = 5.1%

INTERSERCTION OMISSION

N.B. STA. 137 + 20.00 TO 142 + 38.00 S.B. STA. 136 + 54.00 TO 138 + 30.


1-800-892-0123

STATE OF ILLINOIS DEPARTMENT OF TRANSPORTATION

PROPOSED HIGHWAY PLANS

FAP/FAU ROUTE 594/9213 (IL 203) SECTION (580,581)RS-2 PROJECT NHPP-D5M6(311) DESIGNED OVERLAY - ADA ST. CLAIR COUNTY

C-98-088-19

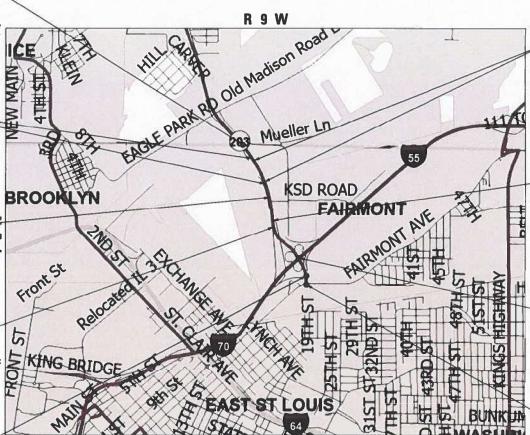

GROSS LENGTH = 7307.76 FT. = 1.38 MILE NET LENGTH = 4908.76 FT. = 0.93 MILE

PROJECT OMISSION N.B. IL 203 STA. 145 + 75.50 TO

STA. 157 + 45.50

STATION EQUATION N.B. IL 203 STA. 35 + 86.00 (BK) =

STA. 131 + 55.00 (AH

BRIDGE OMISSION S.N. 082-0028

STA. 13 + 35.00 TO STA. 16 + 74.00

BEGIN PROJECT COLLINSVILLE RD STA. 2 + 08.00LAT: 38.64191

LONG: -90.12711

(580,581)RS-2 ILLINOIS CONTRACT NO. 76M55 * FAP 594/FAU 9213

* 44 + 2 = 46 TOTAL SHEETS

D-98-069-19



FUNCTIONAL CLASSIFICATION OTHER PRINCIPAL ARTERIAL

STATE OF ILLINOIS **DEPARTMENT OF TRANSPORTATION**

> PRINTED BY THE AUTHORITY OF THE STATE OF ILLINOIS

> > **REV - MS**

STATION EQUATION N.B. IL 203 STA. 142 + 49.76 (BK) =STA. 140 + 00.50 (AH

OR 811

PROJECT ENGINEER: CHERYL KEPLAR PROJECT MANAGER: BRANDON HUMPHREYS

STATION EQUATION S.B. IL 203

END PROJECT

STA. 168 + 35.50

LONG: -90.13759

PROJECT OMISSION

STA. 144 + 46.00 TO STA. 157 + 06.00

S.B. IL 203

LAT: 38.65996

MADISON COUNTY LINE

STA. 38 + 10.00 (BK) =STA. 129 + 00.00 (AH

BRIDGE OMISSION

S.N. 082-0029 STA. 5 + 50.00 TO

STA.7 + 73.00

CONTRACT NO. 76M55

INDEX OF SHEETS

COVER SHEET

INDEX OF SHEETS, HIGHWAY STANDARDS, GENERAL NOTES, MIXTURE REQUIREMENT AND COMMITMENTS

3-7 SUMMARY OF QUANTITIES 8-18 TYPICAL SECTIONS

19-29 SCHEDULE OF QUANTITIES

30 REMOVAL PLAN

31 INTERSECTION DETAILS

32 SIDEWALK RAMP DETAILS TRAFFIC SIGNAL PLANS 32A-32B

33-35 PAVEMENT MARKING

36-38 GUARDRAIL PLANS

DETECTOR LOOP 39-41 42-43 DETAIL

LOCATION MAP

GENERAL NOTES

1. UTILITIES KNOWN TO HAVE FACILITIES WITHIN THE PROJECT AREA:

AMEREN ILLINOIS
AT&T ILLINOIS
CHARTER COMMUNICATIONS, INC.
ILLINOIS AMERICAN WATER COMPANY
VERIZON BUSINESS
METRO EAST SANITARY DISTRICT
ZAYO GROUP LLC

- 2. THE PROPOSED PAVEMENT MARKING SHALL MATCH THE LOCATIONS OF THE EXISTING PAVEMENT MARKING, AS DIRECTED BY THE ENGINEER.
- 3. FOUR CHANGEABLE MESSAGE SIGNS SHALL BE REQUIRED FOR THIS PROJECT. THEY SHALL BE PLACED TWO WEEKS PRIOR TO ANY LANE CLOSURE AND SHALL REMAIN UP FOR THE DURATION OF THE PROJECT. THE CHANGEABLE MESSAGE SIGNS SHALL BE PLACED ALONG IL 203 OR AT THE DIRECTION OF THE ENGINEER.
- 4. THE CONTRACTOR SHALL PROVIDE POSITIVE AND ADEQUATE DRAINAGE AT ALL TIMES.
- 5. THE DEPARTMENT STRONGLY ENCOURAGES THE PRIME CONTRACTOR AND THEIR APPROVED SUB-CONTRACTORS TO HIRE MINORITY, WOMEN AND DISADVANTAGED INDIVIDUALS FROM ITS FEDERALLY FUNDED HIGHWAY CONSTRUCTION CAREERS TRAINING PROGRAM (HCCTP) TO HELP MEET WORKFORCE AND TRAINEE GOALS. THIS PROGRAM IS TRAINING MINORITIES, WOMEN AND DISADVANTAGED INDIVIDUALS IN HIGHWAY CONSTRUCTION-RELATED SKILLS, E.G., MATH FOR THE TRADES, JOB READINESS, TECHNICAL SKILLS COURSEWORK (CARPENTRY, CONCRETE FLATWORK, BLUEPRINT READING, SITE PLANS, SITE WORK, TOOLS USE, ETC.) AND OSHA 10 HOUR CERTIFICATION, TO PREPARE THEM FOR A CAREER IN THE HIGHWAY CONSTRUCTION TRADES, GRADUATES ARE WELL-TRAINED AND READY TO BECOME PRODUCTIVE ENTRY-LEVEL CONSTRUCTION WORKERS, CONTACT THE DISTRICT 8 EEO OFFICE AT 618-346-3360 AND/OR THE HCCTP COORDINATOR AT 618-874-6528 TO LEARN MORE ABOUT THE PROGRAM AND FOR ASSISTANCE IN MEETING WORKFORCE AND TRAINEE GOALS.
- 6. THE INTENT OF THE MILLING IS TO REMOVE THE HMA RESURFACING ONLY. THE UNDERLYING CONCRETE PAVEMENT SHALL NOT BE DISTURBED.
- 7. THE CONTRACTOR SHOULD BE ADVISED THAT IDOT CONTRACT 76T17 (BRIDGE REPLACEMENT, INTERSECTION RECONSTRUCTION ON IL 203) WILL BE UNDER CONSTRUCTION AT OR AROUND THE TIME OF LETTING OF THIS PROJECT. ALL WORK DONE ON CONTRACT 76T17 IS BEING OMITTED FROM THE DESCRIPTION OF THE PROJECT.
- 8. ONLY SHORT TERM PAVEMENT MARKING REMOVAL FROM THE FINAL SURFACE SHALL BE PAID FOR AS "SHORT TERM PAVEMENT MARKING REMOVAL."
- ALL REMOVED GUADRAIL COMPONENTS ARE THE PROPERTY OF THE CONTRACTOR, AND THE SALVAGE VALUE OF SAID COMPONENTS SHALL BE REFLECTED IN THE CONTRACTOR'S BID.
- 10. THE TEMPORARY RAMPS USED ON ALL SIDE STREETS AND ENTRANCES SHALL BE 3 FEET IN LENGTH SO AS NOT TO INTERFERE WITH THE THRU TRAFFIC LANES.
- 11. ALL PATCHING ON THIS PROJECT SHALL BE COMPLETED PRIOR TO BITUMINOUS SURFACE REMOVAL.
- 12. ALL CURB, CURB AND GUTTER, AND MEDIAN REPLACEMENT SHALL BE COMPLETED PRIOR TO THE HMA SURFACE BEING PLACED.
- 13. THE CONTRACTOR SHALL PROVIDE POSITIVE AND ADEQUATE DRAINAGE AT ALL TIMES.
- 14. TRAFFIC SHALL NOT BE ALLOWED ON MILLED SURFACE, EXCEPT TO CROSS AT SIDE ROADS. BINDER MUST BE PLACED PRIOR TO ALLOWING TRAFFIC TO UTILIZE THE LANE.
- 15. BASED ON STRUCTURAL ANALYSIS CONDUCTED BY IDOT, THE FOLLOWING STRUCTURES CAN BE CROSSED WITH AN EMPTY MTD WITH THE FOLLOWING MAXIMUM GROSS WEIGHT RESTRICTION:

 - 082-0026 (40 TONS) 082-0027 (40 TONS) 082-0028 (40 TONS) 082-0029 (40 TONS)

IF THE SAME MTD IS USED THROUGHOUT THE ENTIRE CONTRACT, THEN IT MUST BE LIMITED TO AN EMPTY GROSS WEIGHT \leq 40 TONS

HIGHWAY STANDARDS

HIGHWAY STANDARDS

000001-08
001006
01006
020001-10
420001-10
420001-10
PAVEMENT JOINTS
420001-10
PAVEMENT JOINTS
424001-12
PAVEMENT WELDED WIRE REINFORCEMENT
424001-12
PERPENDICULAR CURB RAMPS FOR SIDEWALKS
424006-06
DIAGONAL CURB RAMPS FOR SIDEWALKS
424010-10
CLASS B PATCHES
606301-04
PC CONCRETE ISLANDS AND MEDIAN
63001-13
STELL PLATE BEAM GUARDRAIL
630301-09
SHOULDER WIDENING FOR TYPE 1 (SPECIAL) GUARDRAIL TERMINALS
631011-10
TRAFFIC BARRIER TERMINAL, TYPE 5
631031-18
TRAFFIC BARRIER TERMINAL, TYPE 6B
701301-05
701301-04
DFF-ROAD OPERATIONS, MUITILANE, 15¹ TO 24¹ FROM PAVEMENT EDGE
701301-04
LANE CLOSURE, 2L, 2W, MOVING OPERATIONS
701311-03
LANE CLOSURE, MUITILANE, AT ENTRANCE OR EXIT, RAMP, FOR SPEEDS ≥ 45 MPH
701422-10
LANE CLOSURE, MUITILANE, DAY OPERATIONS ONLY, FOR SPEEDS ≥ 45 MPH
701422-10
LANE CLOSURE, MUITILANE, FOR SPEEDS ≥ 45 MPH TO 55 MPH
701422-10
LANE CLOSURE, MUITILANE, FOR SPEEDS ≥ 45 MPH TO 55 MPH
701422-10
LANE CLOSURE, MUITILANE, FOR SPEEDS ≥ 45 MPH TO 55 MPH
701426-05
PARTIAL EXIT RAMP CLOSURE, FREEWAY/EXPRESSWAY
701506-10
URBAN LANE CLOSURE, MUITILANE, FOR SPEEDS ≥ 45 MPH TO 55 MPH
701426-05
PARTIAL EXIT RAMP CLOSURE, FREEWAY/EXPRESSWAY
701506-10
URBAN SINGLE LANE CLOSURE, MULTILANE, 2W WITH MOUNTABLE MEDIAN
701701-10
URBAN LANE CLOSURE, MULTILANE, STEED SPEEDS
725001-10
URBAN LANE CLOSURE, MULTILA 782001-01 CURB REFLECTORS
782006-01 GUARDRAIL AND BARRIER WALL REFLECTOR MOUNTING DETAILS
873001-02 TRAFFIC SIGNAL GROUNDING & BONDING
877001-08 STEEL MAST ARM ASSEMBLY AND POLE 16' THROUGH 55'
877002-04 STEEL MAST ARM ASSEMBLY AND POLE 56' THROUGH 75'
878001-11 CONCRETE FOUNDATION DETAILS
886001-01 DETECTOR LOOP INSTALLATIONS
886006-01 TYPICAL LAYOUT FOR DETECTOR LOOPS

COMMITMENTS

NONE

	M I >	KTURE REQUIREM	1ENTS	
MIXTURE USE	POLY SURFACE	BINDER	SHOULDER (lower)	SHOULDER (surface)
AC / PG	SBS PG 70-28	PG 64-22	PG 64-22	PG 64-22
DESIGN AIR VOIDS	4.0% @ Ndes=90	4.0% @ Ndes=90	4.0% @ Ndes=30	4.0% @ Ndes=30
MIX COMPOSITION (GRADATION)	IL 9.5	IL 19.0	IL 19.0L	IL 9.5L
FRICTION AGG	MIXTURE "D"	MIXTURE "B"		
QUALITY MGMT PROGRAM	QCP	QCP	QC/QA	QC/QA
MatTranDev Required?	YES	YES	NO	NO
Γ	TURN LANES	< 500 FEET	1	
MIXTURE USE	POLY SURFACE	BINDER		
AC/PG	SBS PG 70-28	PG 64-22		
DESIGN AIR VOIDS	4.0% @ Ndes=90	4.0% @ Ndes=90		
MIX COMPOSITION (GRADATION)	IL 9.5	IL 19.0		
FRICTION AGG	MIXTURE "D"	MIXTURE "B"		
QUALITY MGMT PROGRAM	QC/QA	QC/QA		
MatTranDev Required?	NO	NO		

JSER NAME = edison.zohfonyi DESIGNED -REVISED DRAWN REVISED HECKED . REVISED PLOT DATE = 6/26/2025 DATE REVISED

STATE OF ILLINOIS DEPARTMENT OF TRANSPORTATION

INDEX OF SHEETS, HIGHWAY STANDARDS, GENERAL NOTES, COMMITMENTS AND MIXTURE REQUIREMENT OF 1 SHEETS STA.

SECTION COUNTY (580.581)RS-2 ST CLAIR 44 * FAP 594/FAU 9213 CONTRACT NO. 76M55 80% FED 20% STATE

CONSTR. CODE

-		— r	T:	
0005			TOT::	ROADWAY
CODE NO.	ITEM	UNIT	TOTAL QUANTITY	0005 URBAN
NO.	HEM	ONTI	QUANTITY	URBAN
20101400	NITROGEN FERTILIZER NUTRIENT	POUND	7	7
20101500	PHOSPHORUS FERTILIZER NUTRIENT	POUND	7	7
00404000	DOTAGOU MA FEDTULTED AU TRIENT	DOLIND.	7	7
20101600	POTASSIUM FERTILIZER NUTRIENT	POUND	7	7
25000210	SEEDING, CLASS 2A	ACRE	0.08	0.08
		D		
40600290	BITUMINOUS MATERIALS (TACK COAT)	POUND	29559	29559
40600370	LONGITUDINAL JOINT SEALANT	FOOT	11428	11428
40600405	MATERIAL TRANSFER DEVICE	TON	6314	6314
40600982	HOT-MIX ASPHALT SURFACE REMOVAL - BUTT JOINT	SQ YD	5106	5106
40600990	TEMPORARY RAMP	SQ YD	1444	1444
40603090	HOT-MIX ASPHALT BINDER COURSE, IL-19.0, N90	TON	4073	4073
40604164	POLYMERIZED HOT-MIX ASPHALT SURFACE COURSE, IL-9.5, MIX "D", N90	TON	2715	2715
42400100	PORTLAND CEMENT CONCRETE SIDEWALK 4 INCH	SQ FT	1529	1529
42400800	DETECTABLE WARNINGS	SQ FT	115	115
44000100	PAVEMENT REMOVAL	SQ YD	290	290
	TAVENTE TI INDIVIOUAL	30(1)	250	250
	1		1	I.

80% FED 20% STATE

CONSTR. CODE

				ROADWAY
CODE	ITEM	UNIT	TOTAL	0005 URBAN
NO.	II EWI	UNIT	QUANTITY	URBAN
44000158	HOT-MIX ASPHALT SURFACE REMOVAL, 2 1/4"	SQ YD	46635	46635
44000500	COMBINATION CURB AND GUTTER REMOVAL	FOOT	275	275
				3
44000600	SIDEWALK REMOVAL	SQ FT	2567	2567
				-
44001980	CONCRETE BARRIER DEMOVAL	FOOT	186	186
44001960	CONCRETE BARRIER REMOVAL	FOOT	100	100
44003100	MEDIAN REMOVAL	SQ FT	1389	1389
44200050	WELDED WIRE REINFORCEMENT	SQ YD	4368	4368
44201007	CLASS B PATCHES, TYPE II, 13 INCH	SQ YD	644	644
				=
44201011	CLASS B PATCHES, TYPE III, 13 INCH	SQ YD	154	154
11201011	ob ee b 17 (to lies, 111 e lii, 10 liter)	00.15	104	104
11001010	OLAGO D DATOUTO TYPE IV. 40 INOLI	00.145	4000	4000
44201013	CLASS B PATCHES, TYPE IV, 13 INCH	SQ YD	4368	4368
44201299	DOWEL BARS 1 1/2"	EACH	1972	1972
44213200	SAW CUTS	FOOT	7244	7244
44213204	TIE BARS 3/4"	EACH	575	575
48102100	ACCRECATE MEDGE SHOULDED TYPE B	TON	776	776
70 102 100	AGGREGATE WEDGE SHOULDER, TYPE B	ION	776	770
48203100	HOT-MIX ASPHALT SHOULDERS	TON	2857	2857

REV - MS

	USER NAME = edison.zohfonyi	DESIGNED -	REVISED -
- 1		DRAWN -	REVISED -
- 1		CHECKED -	REVISED -
	PLOT DATE = 6/26/2025	DATE -	REVISED -

	SUMMARY OF QUANTITY						F.A.* RTE. SECTION			COUNTY	TOTAL SHEETS	SHEET NO.
	4					(580,581)RS-2)RS-2 ST. CLAIR		44	3		
						* FAI	P 594/FAU 9213		CONTRACT	NO. 76	M55	
	SHEET 1	OF	5	SHEETS	STA.	TO STA.	ILLINOIS FED. AID PROJECT					

80% FED 20% STATE

CONSTR. CODE

80% FED 20% STATE

CONSTR. CODE

CODE NO.	ITEM	UNIT	TOTAL QUANTITY	ROADWA\ 0005 URBAN
60605000	COMBINATION CONCRETE CURB AND GUTTER, TYPE B-6.24	FOOT	215	215
60608600	COMBINATION CONCRETE CURB AND GUTTER, TYPE M-6,06	FOOT	2761	2761
60618300	CONCRETE MEDIAN SURFACE, 4 INCH	SQFT	289	289
60618320	CONCRETE MEDIAN SURFACE, 6 INCH	SQ FT	6880	6880
3				
63000003	STEEL PLATE BEAM GUARDRAIL, TYPE A, 9 FOOT POSTS	FOOT	1350	1350
63100045	TRAFFIC BARRIER TERMINAL, TYPE 2	EACH	8	8
63100070	TRAFFIC BARRIER TERMINAL, TYPE 5	EACH	1	1
63100085	TRAFFIC BARRIER TERMINAL, TYPE 6	EACH	4	4
63100089	TRAFFIC BARRIER TERMINAL, TYPE 6B	EACH	2	2
63100167	TRAFFIC BARRIER TERMINAL, TYPE 1 (SPECIAL) TANGENT	EACH	9	9
63200310	GUARDRAIL REMOVAL	FOOT	2197.25	2197.25
67100100	MOBILIZATION	L SUM	1	1
70100310	TRAFFIC CONTROL AND PROTECTION, STANDARD 701421	L SUM	1	1
70100320	TRAFFIC CONTROL AND PROTECTION, STANDARD 701422	L SUM	1	1

				ROADWAY
CODE			TOTAL	0005
NO.	ITEM	UNIT	QUANTITY	URBAN
70100420	TRAFFIC CONTROL AND PROTECTION, STANDARD 701411	EACH	6	6
70100825	TRAFFIC CONTROL AND PROTECTION, STANDARD 701456	L SUM	1	1
70100025	TRAFFIC CONTROL AND PROTECTION, STANDARD 701450	L SOIVI		
70102625	TRAFFIC CONTROL AND PROTECTION, STANDARD 701606	L SUM	1	1
70102634	TRAFFIC CONTROL AND PROTECTION, STANDARD 701611	L SUM	1	1
70102635	TRAFFIC CONTROL AND PROTECTION, STANDARD 701701	L SUM	1	1
70102640	TRAFFIC CONTROL AND PROTECTION, STANDARD 701801	L SUM	1	1
70107025	CHANGEABLE MESSAGE SIGN	CAL DA	616	616
70300100	SHORT TERM PAVEMENT MARKING	FOOT	6530	6530
70300150	SHORT TERM PAVEMENT MARKING REMOVAL	SQFT	2193	2193
70300211	TEMPORARY PAVEMENT MARKING LETTERS AND SYMBOLS - PAINT	SQFT	450	450
70300241	TEMPORARY PAVEMENT MARKING - LINE 6"- PAINT	FOOT	30713	30713
70300251	TEMPORARY PAVEMENT MARKING - LINE 8"- PAINT	FOOT	371	371
70300261	TEMPORARY PAVEMENT MARKING - LINE 12"- PAINT	FOOT	689	689
70300281	TEMPODADY DAVEMENT MADRING LINE 24" DAINT	FOOT	179	179
70300281	TEMPORARY PAVEMENT MARKING - LINE 24"- PAINT	FOOT	1/9	1/9

* SPECIALTY ITEM

	USER NAME = edison.zohfonyi	DESIGNED -	REVISED -		SUMMARY OF QUANTITY		i i	F.A.*	SECTION	COUNTY	TOTAL	SHEET	
Ī		DRAWN -	REVISED -	STATE OF ILLINOIS	Somman of QOANTIT				(580,581)RS-2	ST. CLAIR	44	4	
		CHECKED -	REVISED -	DEPARTMENT OF TRANSPORTATION				* FAP 594/FAU 9213		CONTRACT NO. 76M55		155	
	PLOT DATE = 6/26/2025	DATE -	REVISED -		SCALE:	SHEET 2 OF 5 SHEETS	STA.	TO STA.		ILLINOIS FED. AID	PROJECT		=

80% FED 20% STATE CONSTR. CODE 80% FED 20% STATE

CONSTR. CODE	l
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					ROADWAY 0005	
	CODE			TOTAL		
	NO.	ITEM	UNIT	QUANTITY	URBAN	
:	72400710	RELOCATE SIGN PANEL - TYPE 1	SQFT	1	1	
	72501000	TERMINAL MARKER - DIRECT APPLIED	EACH	9	9	
	72001000		Z/(G)1	Ů		
	78000100	THERMOPLASTIC PAVEMENT MARKING - LETTERS AND SYMBOLS	SQFT	450	450	
	78000400	THERMOPLASTIC PAVEMENT MARKING - LINE 6"	FOOT	30713	30713	
:	78000500	THERMOPLASTIC PAVEMENT MARKING - LINE 8"	FOOT	371	371	
	78000600	THERMOPLASTIC PAVEMENT MARKING - LINE 12"	FOOT	689	689	
	78000650	THERMOPLASTIC PAVEMENT MARKING - LINE 24"	FOOT	179	179	
•	7600050	THERWOPLASTIC PAVEIVIENT WARKING - LINE 24	FOOT	179	179	
:	78100100	RAISED REFLECTIVE PAVEMENT MARKER	EACH	192	192	
	78200005	GUARDRAIL REFLECTORS, TYPE A	EACH	37	37	
	78200020	CURB REFLECTORS	EACH	122	122	
	78300200	RAISED REFLECTIVE PAVEMENT MARKER REMOVAL	EACH	192	192	
	78300202	PAVEMENT MARKING REMOVAL - WATER BLASTING	SQFT	16575	16575	
	78300202 81028220 85000200	UNDERGROUND CONDUIT, GALVANIZED STEEL, 3" DIA.	FOOT	450	450	
	85000200	MAINTENANCE OF EXISTING TRAFFIC SIGNAL INSTALLATION	EACH	1	1	

CODE			TOTAL	ROADWAY 0005
NO.	ITEM	UNIT	QUANTITY	URBAN
87301245	ELECTRIC CABLE IN CONDUIT, SIGNAL NO. 14 5C	FOOT	3350	3350
87301255	ELECTRIC CABLE IN CONDUIT, SIGNAL NO. 14 7C	FOOT	605	605
87301900	ELECTRIC CABLE IN CONDUIT, EQUIPMENT GROUNDING CONDUCTOR, NO. 6 1C	FOOT	550	550
87502670	TRAFFIC SIGNAL POST, ALUMINUM 13 FT.	EACH	1	1
87700140	STEEL MAST ARM ASSEMBLY AND POLE, 20 FT.	EACH	1	1
87700260	STEEL MAST ARM ASSEMBLY AND POLE, 44 FT.	EACH	1	1
87700270	STEEL MAST ARM ASSEMBLY AND POLE, 46 FT.	EACH	1	1
87800100	CONCRETE FOUNDATION, TYPE A	FOOT	10	10
87800400	CONCRETE FOUNDATION, TYPE E 30-INCH DIAMETER	FOOT	10	10
87800415	CONCRETE FOUNDATION, TYPE E 36-INCH DIAMETER	FOOT	28	28
87900200	DRILL EXISTING HANDHOLE	EACH	3	3
88030020	SIGNAL HEAD, LED, 1-FACE, 3-SECTION, MAST-ARM MOUNTED	EACH	5	5
88030050	SIGNAL HEAD, LED, 1-FACE, 3-SECTION, BRACKET MOUNTED	EACH	5	5
88030070	SIGNAL HEAD, LED, 1-FACE, 4-SECTION, BRACKET MOUNTED	EACH	1	1

* SPECIALTY ITEM

										J
USER NAME = edison.zohfonyi	DESIGNED -	REVISED -	STATE OF HANDIS SUMMARY OF QUANTITY		F.A.* RTE.	SECTION	COUNTY	TOTAL	SHEET NO.	1
	DRAWN -	REVISED -	STATE OF ILLINOIS DEPARTMENT OF TRANSPORTATION	Comment of Goaletti		(580,581)RS-2	ST. CLAIR	44	5	1
	CHECKED -	REVISED -			* FAP	P 594/FAU 9213	CONTRACT	NO. 76N	Л55	1
PLOT DATE = 6/26/2025	DATE -	REVISED -		SCALE: SHEET 3 OF 5 SHEETS STA. TO STA.		ILLINOIS FED. A	ID PROJECT		_	1

80% FED 20% STATE

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COI		ITEM	UNIT	TOTAL QUANTITY	ROADWAY 0005 URBAN
8803008	SIGNAL HEAD, LED, 1-F	ACE, 4-SECTION, MAST ARM MOUNTED	EACH	1	1
8803010	SIGNAL HEAD, LED. 1-F	ACE, 5-SECTION, BRACKET MOUNTED	EACH	2	2
				4	_
8803011	SIGNAL HEAD, LED, 1-F	ACE, 5-SECTION, MAST-ARM MOUNTED	EACH	2	2
8810271	PEDESTRIAN SIGNAL HI WITH COUNTDOWN TIM	EAD, LED, 1-FACE, BRACKET MOUNTED ER	EACH	2	2
8820010	TRAFFIC SIGNAL BACKI	PLATE	EACH	8	8
8950020	RELOCATE EXISTING PE	EDESTRIAN SIGNAL HEAD	EACH	2	2
8950230	REMOVE ELECTRIC CAI	BLE FROM CONDUIT	FOOT	11500	11500
8950235	REMOVE AND REINSTAL	L ELECTRIC CABLE FROM CONDUIT	FOOT	56	56
8950237	5 REMOVE EXISTING TRA	FFIC SIGNAL EQUIPMENT	EACH	1	1
8950238	5 REMOVE EXISTING CON	ICRETE FOUNDATION	EACH	3	3
X140003	1 REMOVE PEDESTRIAN I	PUSH-BUTTON	EACH	3	3
X440202	CONCRETE MEDIAN SU	RFACE REMOVAL	SQ FT	2880	2880
X876020) ACCESSIBLE PEDESTR	AN SIGNALS	EACH	3	3
X876020	1 PEDESTRIAN PUSH-BUT	TON POST	EACH	3	3

* SPECIALTY ITEM

USER NAME = edison.zohfonyi	DESIGNED -	REVISED -		SUMMARY OF QUANTITY					F.A.*	SECTION	COUNTY	TOTAL	SHEET	
	DRAWN -	REVISED -	STATE OF ILLINOIS		Comments of Goaltins				(580,581)RS-2	ST. CLAIR	44	6		
	CHECKED -	REVISED -	DEPARTMENT OF TRANSPORTATION							* FAP	594/FAU 9213	CONTRAC	T NO. 76M	55
PLOT DATE = 6/26/2025	DATE -	REVISED -		SCALE:	SHEET 4	OF 5	SHEETS	STA.	TO STA.	ILLINOIS FED. AID		AID PROJECT		

80% FED 20% STATE


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CODE			TOTAL	ROADWAY 0005
NO.	ITEM	UNIT	QUANTITY	URBAN
X8760204	RELOCATE EXISTING PEDESTRIANPUSH-BUTTON POST	EACH	3	3
X8860105	DETECTOR LOOP REPLACEMENT	FOOT	2706	2706
X8950307	REMOVE EXISTING PEDESTRIAN SIGNAL HEAD	EACH	2	2
Z0036200	PAINT CURB	FOOT	257	257
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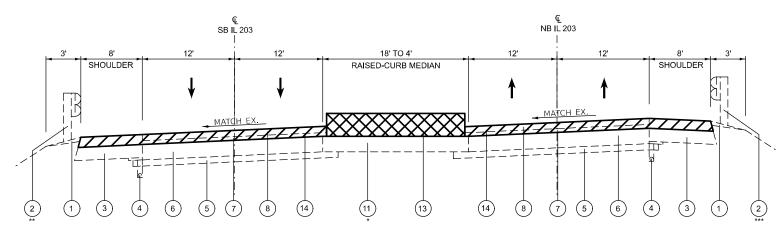
* SPECIALTY ITEM

USER NAME = edison.zohfonyi	DESIGNED -	REVISED -		SUMMARY OF QUANTITY				F.A.*	SECTION	COUNTY	TOTAL SHEETS	IEET NO.		
	DRAWN -	REVISED -	STATE OF ILLINOIS					/			(580,581)RS-2	ST. CLAIR	44	7
	CHECKED -	REVISED -	DEPARTMENT OF TRANSPORTATION	SCALE: SHEET 5 OF 5 SHEETS STA. TO STA.					* FAP	594/FAU 9213	CONTRAC	T NO. 76M5	5	
PLOT DATE = 6/26/2025	DATE -	REVISED -				TO STA.	ILLINOIS FEI		ED. AID PROJECT					

STA. 2+08.00 TO 3+98.00



EXISTING TYPICAL SECTION STA. 4+97 TO 5+50.00

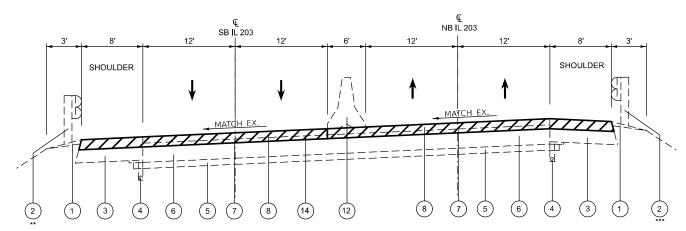

EXISTING TYPICAL SECTION

STA. 3+98 TO 4+97.00

STA. 5+50.00 TO 7+29.00 (NB BRIDGE OMISSION) STA. 5+55.00 TO 7+32.00 (SB BRIDGE OMISSION) STA. 7+32.00 TO 13+35.00

LEGEND

- (1) EXISTING AGGREGATE WEDGE SHOULDER, TYPE B
- (2) EXISTING STEEL PLATE BEAM GUARDRAIL
- (3) EXISTING BITUMINOUS SHOULDERS, 10"
- (4) EXISTING PIPE UNDERDRAINS
- (5) EXISTING 6" SUB-BASE GRANULAR MATERIAL
- 6 EXISTING 10" PCC PAVEMENT
- 7 EXISTING HMA LEVEL BINDER, 3/4"
- 8 EXISTING HMA SURFACE COURSE, 11/2"
- 9 EXISTING PCC PAVEMENT
- (10) EXISTING CONCRETE C&G, TYPE M-6.06
- (11) EXISTING CONCRETE MEDIAN SURFACE
- (12) EXISTING CONCRETE BARRIER (TO BE REMOVED)
- (13) PROPOSED MEDIAN SURFACE REMOVAL
- (14) PROPOSED HMA SURFACE REMOVAL, 2 1/2"
- (15) PROPOSED AGGREGATE WEDGE SHOULDER, TYPE B
- (16) PROPOSED STEEL PLATE BEAM GUARDRAIL, TYPE A, 9' POST
- (17) PROPOSED HMA SHOULDER, 11/2"
- (18) PROPOSED BITUMINOUS MATERIAL (TACK COAT)
- (19) PROPOSED LONGITUDINAL JOINT SEALANT
- (20) PROPOSED HMA BINDER COURSE, 11/2"
- (21) PROPOSED HMA SURFACE COURSE, 11/2"
- (22) PROPOSED CONCRETE C&G, TYPE M-6.06
- (23) PROPOSED CONCRETE MEDIAN SURFACE, 6"
- (24) PROPOSED HMA SHOULDER, 21/4"
- * FROM STA. 2+25.00 TO STA. 4+87.00 FROM STA 5+72.00 TO STA. 7+43.00 FROM STA. 8+44.00 TO STA. 13+35.00 FROM STA. 16+74.00 TO STA. 20+59.00
- ** FROM STA. 6+99.00 TO STA. 8+79.00 FROM STA. 11+36.60 TO STA. 13+51.40 FROM STA. 16+57.70 TO STA. 17+39.50
- *** FROM STA. 4+11.50 TO STA. 5+83.90 FROM STA. 6+99.00 TO STA. 7+82.55 FROM STA. 8+69.00 TO STA. 10+52.10 FROM STA. 11+66.60 TO STA. 13+52.10 FROM STA. 16+57.70 TO STA. 18+47.80

USER NAME = edison.zohfonyi	DESIGNED -	REVISED -
	DRAWN -	REVISED -
	CHECKED -	REVISED -
PLOT DATE = 5/9/2025	DATE _	REVISED -


STATE OF ILLINOIS
DEPARTMENT OF TRANSPORTATION

SCALE:


 TYPICAL SECTIONS
 F.A.* RTE. RTE. SECTION
 SECTION COUNTY SHEETS NO.
 * (580,581)RS-2
 ST. CLAIR
 44
 8

 * FAP 594/FAU 9213
 CONTRACT NO. 76M55

neet. Typical Sections 1 [2] feet. . NAME: c:\pw_work\pwidot\illinois.gov_edison.zohfonyi@illinois.gov\d`

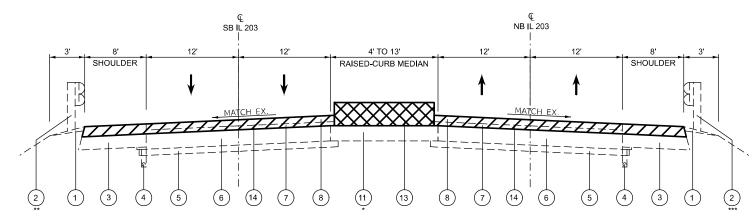


STA. 13+35.00 TO 16+74.00 (BRIDGE OMISSION) STA. 16+74.00 TO 20+59.00

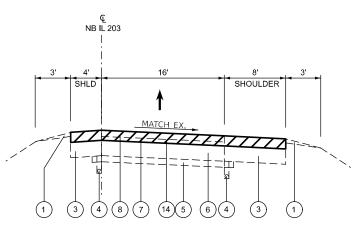

EXISTING TYPICAL SECTION NB 203 CONNECTOR

STA. 20+59.00 TO 26+69.00 STA. 32+64.00 TO 35+86.00

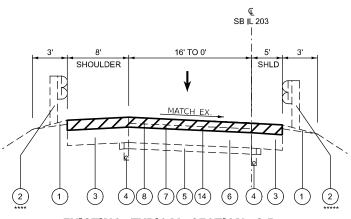

EXISTING TYPICAL SECTION S.B. 203


STA. 20+59.00 TO 27+55.00 STA. 27+55.00 TO 28+88.00 (PCC PAVEMENT OMISSION) STA. 28+88.00 TO 38+10.00

LEGEND


- (1) EXISTING AGGREGATE WEDGE SHOULDER, TYPE B
- 2 EXISTING STEEL PLATE BEAM GUARDRAIL
- (3) EXISTING BITUMINOUS SHOULDERS, 10"
- (4) EXISTING PIPE UNDERDRAINS
- 5 EXISTING 6" SUB-BASE GRANULAR MATERIAL
- 6 EXISTING 10" PCC PAVEMENT
- 7 EXISTING HMA LEVEL BINDER, 3/4"
- 8 EXISTING HMA SURFACE COURSE, 11/2"
- 9 EXISTING PCC PAVEMENT
- (10) EXISTING CONCRETE C&G, TYPE M-6.06
- (11) EXISTING CONCRETE MEDIAN SURFACE
- (12) EXISTING CONCRETE BARRIER (TO BE REMOVED)
- (13) PROPOSED MEDIAN SURFACE REMOVAL
- (14) PROPOSED HMA SURFACE REMOVAL, 2 1/4"
- (15) PROPOSED AGGREGATE WEDGE SHOULDER, TYPE B
- (16) PROPOSED STEEL PLATE BEAM GUARDRAIL, TYPE A, 9' POST
- (17) PROPOSED HMA SHOULDER, 11/2"
- (18) PROPOSED BITUMINOUS MATERIAL (TACK COAT)
- (19) PROPOSED LONGITUDINAL JOINT SEALANT
- (20) PROPOSED HMA BINDER COURSE, 21/4"
- (21) PROPOSED HMA SURFACE COURSE, 11/2"
- 22) PROPOSED CONCRETE C&G, TYPE M-6.06
- (23) PROPOSED CONCRETE MEDIAN SURFACE, 6"
- (24) PROPOSED HMA SHOULDER, 21/4"
 - * FROM STA. 3+98.00 TO STA. 4+87.00 FROM STA 5+72.00 TO STA. 7+43.00 FROM STA. 8+44.00 TO STA. 13+35.00 FROM STA. 16+74.00 TO STA. 20+59.00
 - ** FROM STA. 6+93.00 TO STA. 8+81.00 FROM STA. 11+32.00 TO STA. 14+07.00 FROM STA. 16+92.00 TO STA. 17+35.00
 - *** FROM STA. 4+08.00 TO STA. 5+94.00 FROM STA. 6+93.00 TO STA. 7+88.00 FROM STA. 8+68.00 TO STA. 10+55.00 FROM STA. 12+14.00 TO STA. 14+07.00 FROM STA. 16+92.00 TO STA. 18+53.00
- **** FROM STA. 27+96.00 TO STA. 29+85.00
- ***** FROM STA. 28+10.00 TO STA. 31+93.00

USER NAME = edison.zohfonyi	DESIGNED -	REVISED -				TYPICAL SEC	TIONS		F.A.*	SECTION	COUNTY	TOTAL	SHEET
	DRAWN -	REVISED -	STATE OF ILLINOIS			I II IOAL OLG			*	(580.581)RS-2	ST. CLAIR	44	9
	CHECKED -	REVISED -	DEPARTMENT OF TRANSPORTATION						* FAP	594/FAU 9213	CONTRAC	CT NO. 76	M55
PLOT DATE = 5/9/2025	DATE -	REVISED -		SCALE:	SHEET 2	OF 11 SHEET	S STA.	TO STA.		ILLINOIS FED. AIL	PROJECT		

MODEL: Typical Sections-2 [Sneet]
Ell F NAMF: ct/pw workhowidghillingis gov. edison zohfonvi@illingis gov/d1[

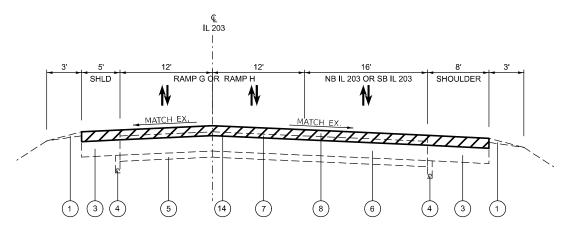


N.B. 203 STATION EQUATION 35+86.00 BK = 131+55.00 AH RAMP H STA. 130+05.00 TO 131+55.00 RAMP G STA. 124+91.34 TO 129+00.00

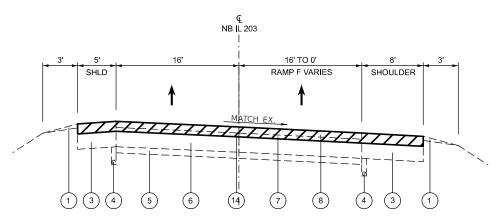

EXISTING TYPICAL SECTION NB 203 CONNECTOR

STA. 26+69.00 TO 32+64.00

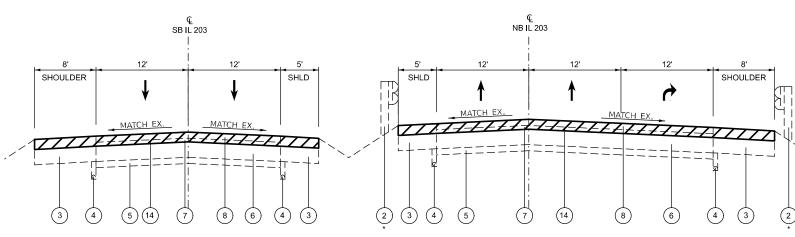

EXISTING TYPICAL SECTION S.B. 203

STATION EQUATION 38+10.00 BK = 129+00.0 STA, 129+00.00 TO 136+54.00

EXISTING TYPICAL SECTION N.B. 203

STATION EQUATION 35+86.00 BK = 131+55.00 AH STA. 131+55.00 TO 133+85.00

<u>LEGEND</u>

- (1) EXISTING AGGREGATE WEDGE SHOULDER, TYPE B
- (2) EXISTING STEEL PLATE BEAM GUARDRAIL
- (3) EXISTING BITUMINOUS SHOULDERS, 10"
- (4) EXISTING PIPE UNDERDRAINS
- (5) EXISTING 6" SUB-BASE GRANULAR MATERIAL
- 6 EXISTING 10" PCC PAVEMENT
- 7 EXISTING HMA LEVEL BINDER, 3/4"
- 8 EXISTING HMA SURFACE COURSE, 11/2"
- 9 EXISTING PCC PAVEMENT
- (10) EXISTING CONCRETE C&G, TYPE M-6.06
- (11) EXISTING CONCRETE MEDIAN SURFACE
- (12) EXISTING CONCRETE BARRIER (TO BE REMOVED)
- (13) PROPOSED MEDIAN SURFACE REMOVAL
- (14) PROPOSED HMA SURFACE REMOVAL, 2 1/4"
- (15) PROPOSED AGGREGATE WEDGE SHOULDER, TYPE B
- (16) PROPOSED STEEL PLATE BEAM GUARDRAIL, TYPE A, 9' POST
- (17) PROPOSED HMA SHOULDER, 11/2"
- (18) PROPOSED BITUMINOUS MATERIAL (TACK COAT)
- (19) PROPOSED LONGITUDINAL JOINT SEALANT
- (20) PROPOSED HMA BINDER COURSE, 21/4"
- (21) PROPOSED HMA SURFACE COURSE, 11/2"
- (22) PROPOSED CONCRETE C&G, TYPE M-6.06
- (23) PROPOSED CONCRETE MEDIAN SURFACE, 6"
- (24) PROPOSED HMA SHOULDER, 21/4"

* FROM STA. 131+43 TO STA. 133+09.00

 USER NAME
 = edison.zohfonyi
 DESIGNED
 REVISED

 DRAWN
 REVISED

 CHECKED
 REVISED

 PLOT DATE
 = 5/9/2025
 DATE
 REVISED

STATE OF ILLINOIS
DEPARTMENT OF TRANSPORTATION


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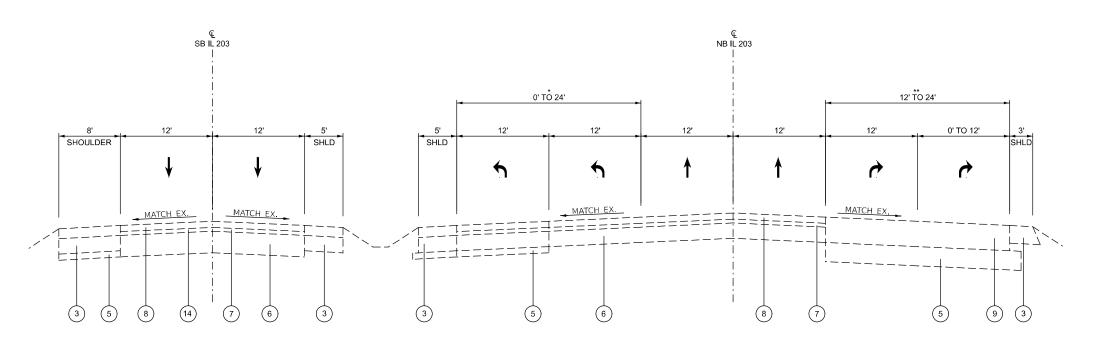
 TYPICAL SECTIONS
 F.A.* SECTION COUNTY TOTAL SHEET SHOOL
 SHEETS NO.

 *
 (580,581)RS-2
 ST. CLAIR 44 10
 * FAP 594/FAU 9213
 CONTRACT NO. 76M55

 SHEET 3
 OF 11 SHEETS STA.
 TO STA.
 ILLINOIS FED. AUD PROJECT

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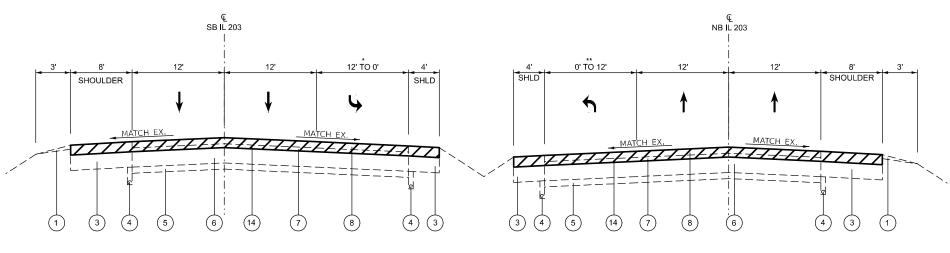


EXISTING TYPICAL SECTION N.B. 203
TA. 137+20.00 TO 142+38.00 (INTERSECTION OMISSION)

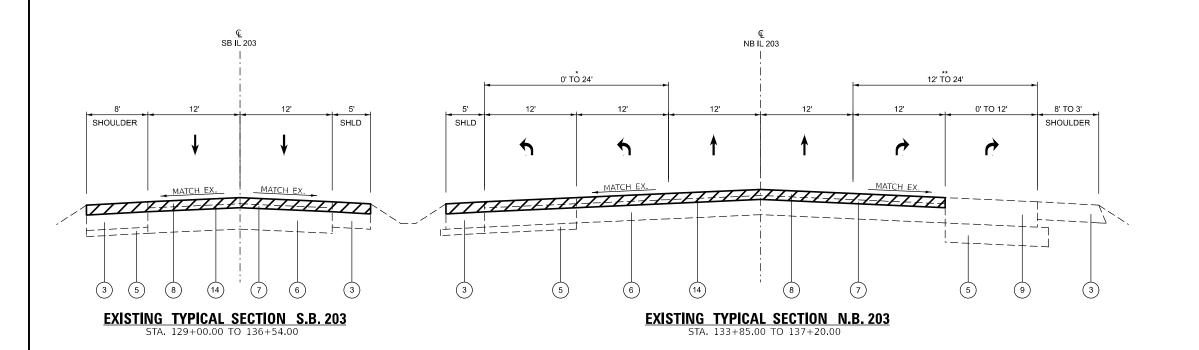LEGEND

- 1 EXISTING AGGREGATE WEDGE SHOULDER, TYPE B
- (2) EXISTING STEEL PLATE BEAM GUARDRAIL
- (3) EXISTING BITUMINOUS SHOULDERS, 10"
- (4) EXISTING PIPE UNDERDRAINS
- (5) EXISTING 6" SUB-BASE GRANULAR MATERIAL
- (6) EXISTING 10" PCC PAVEMENT
- 7 EXISTING HMA LEVEL BINDER, 3/4"
- 8 EXISTING HMA SURFACE COURSE, 11/2"
- 9 EXISTING PCC PAVEMENT
- (10) EXISTING CONCRETE C&G, TYPE M-6.06
- (11) EXISTING CONCRETE MEDIAN SURFACE
- (12) EXISTING CONCRETE BARRIER (TO BE REMOVED)
- (13) PROPOSED MEDIAN SURFACE REMOVAL
- (14) PROPOSED HMA SURFACE REMOVAL, 2 1/4"
- (15) PROPOSED AGGREGATE WEDGE SHOULDER, TYPE B
- (16) PROPOSED STEEL PLATE BEAM GUARDRAIL, TYPE A, 9' POST
- (17) PROPOSED HMA SHOULDER, 11/2"
- (18) PROPOSED BITUMINOUS MATERIAL (TACK COAT)
- (19) PROPOSED LONGITUDINAL JOINT SEALANT
- (20) PROPOSED HMA BINDER COURSE, 2%"
- (21) PROPOSED HMA SURFACE COURSE, 11/2"
- (22) PROPOSED CONCRETE C&G, TYPE M-6.06
- 23) PROPOSED CONCRETE MEDIAN SURFACE, 6"
- (24) PROPOSED HMA SHOULDER, 21/4"
 - * FROM STA. 133+86.00 TO STA. 140+61.00
 - ** FROM STA. 136+77.00 TO STA. 140+61.00


JSER NAME = edison.zohfonyi DESIGNED -REVISED -SECTION COUNTY TYPICAL SECTIONS STATE OF ILLINOIS DRAWN REVISED (580,581)RS-2 ST. CLAIR 44 CHECKED -REVISED **DEPARTMENT OF TRANSPORTATION** * FAP 594/FAU 9213 CONTRACT NO. 76M55 SCALE: SHEET 4 OF 11 SHEETS STA. PLOT DATE = 5/9/2025 TO STA. DATE REVISED




STA, 138+30.00 TO 144+46.00

EXISTING TYPICAL SECTION N.B. 203

STA. 142+38.00 TO 142+49.76 STATION EQUATION 142+49.76 BK = 140+00.5 AH STA. 140+00.5 TO 145+75.5

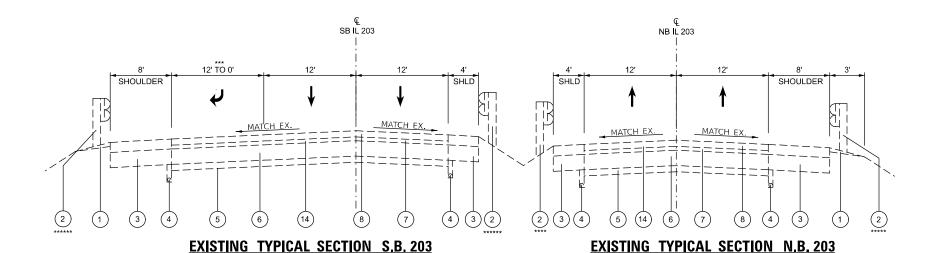

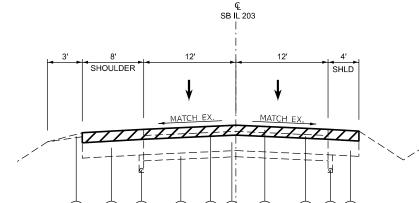

EXISTING TYPICAL SECTION S.B. 203

NB IL 203

A' 12' 12' 8' 3'

SHOULDER

MATCH EX.

MATCH EX.

MATCH EX.

(3) (4) (5) (14) (6) (7) (8) (4) (3) (1)

EXISTING TYPICAL SECTION N.B. 203


STA. 157+45.5 TO 168+35.50

<u>LEGEND</u>


- 1 EXISTING AGGREGATE WEDGE SHOULDER, TYPE B
- (2) EXISTING STEEL PLATE BEAM GUARDRAIL
- 3 EXISTING BITUMINOUS SHOULDERS, 10"
- 4 EXISTING PIPE UNDERDRAINS
- (5) EXISTING 6" SUB-BASE GRANULAR MATERIAL
- 6 EXISTING 10" PCC PAVEMENT
- 7 EXISTING HMA LEVEL BINDER, 3/4"
- 8 EXISTING HMA SURFACE COURSE, 11/2"
- 9 EXISTING PCC PAVEMENT
- (10) EXISTING CONCRETE C&G, TYPE M-6.06
- (11) EXISTING CONCRETE MEDIAN SURFACE
- (12) EXISTING CONCRETE BARRIER (TO BE REMOVED)
- (13) PROPOSED MEDIAN SURFACE REMOVAL
- (14) PROPOSED HMA SURFACE REMOVAL, 2 1/4"
- (15) PROPOSED AGGREGATE WEDGE SHOULDER, TYPE B
- (16) PROPOSED STEEL PLATE BEAM GUARDRAIL, TYPE A, 9' POST
- (17) PROPOSED HMA SHOULDER, 11/2"
- (18) PROPOSED BITUMINOUS MATERIAL (TACK COAT)
- (19) PROPOSED LONGITUDINAL JOINT SEALANT
- (20) PROPOSED HMA BINDER COURSE, 21/4"
- (21) PROPOSED HMA SURFACE COURSE, 11/2"
- (22) PROPOSED CONCRETE C&G, TYPE M-6.06
- (23) PROPOSED CONCRETE MEDIAN SURFACE, 6"
- (24) PROPOSED HMA SHOULDER, 21/4"
 - * FROM STA. 138+17.00 TO STA. 142+57.00
 - ** FROM STA. 139+94.45 TO STA. 145+75.45
 - *** FROM STA. 144+13.00 TO STA. 150+09.00
 - **** FROM STA. 151+36.5 TO STA. 152+67.5
 - ***** FROM STA. 151+42.5 TO STA. 152+67.5
 - ****** FROM STA. 154+84.5 TO STA. 157+03.5

JSER NAME = edison.zohfonyi DESIGNED -REVISED SECTION COUNTY TYPICAL SECTIONS **STATE OF ILLINOIS** DRAWN REVISED (580,581)RS-2 ST. CLAIR 44 CHECKED -REVISED **DEPARTMENT OF TRANSPORTATION** * FAP 594/FAU 9213 CONTRACT NO. 76M55 SCALE: SHEET 5 OF 11 SHEETS STA. PLOT DATE = 5/9/2025 TO STA. DATE REVISED

MODEL: Typical Sections-5 [Sheet] FILE NAME: c:\pw_work\pwidot\illinois.gov_edison.zohfonyi@illino

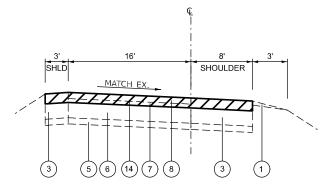


RAMP A STA. 16+20.00 TO 17+05.00 RAMP D STA. 1+00.00 TO 2+67.00 RAMP B STA. 2+00.00 TO 3+45.00 RAMP E STA. 0+00.00 TO 2+74.00

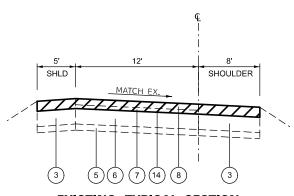

EXISTING TYPICAL SECTION

RAMP C STA 11+88 00 TO 12+39 25

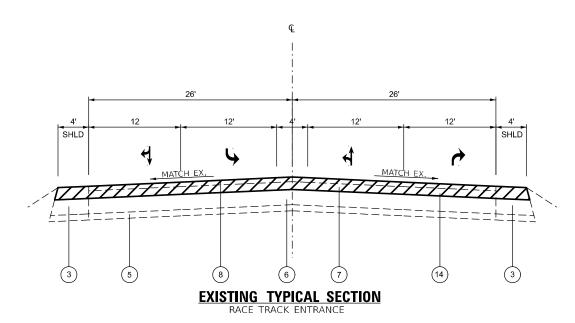

<u>LEGEND</u>


- (1) EXISTING AGGREGATE WEDGE SHOULDER, TYPE B
- (2) EXISTING STEEL PLATE BEAM GUARDRAIL
- 3 EXISTING BITUMINOUS SHOULDERS, 10"
- 4 EXISTING PIPE UNDERDRAINS
- (5) EXISTING 6" SUB-BASE GRANULAR MATERIAL
- 6 EXISTING 10" PCC PAVEMENT
- 7 EXISTING HMA LEVEL BINDER, 3/4"
- 8 EXISTING HMA SURFACE COURSE, 11/2"
- 9 EXISTING PCC PAVEMENT
- (10) EXISTING CONCRETE C&G, TYPE M-6.06
- (11) EXISTING CONCRETE MEDIAN SURFACE
- (12) EXISTING CONCRETE BARRIER (TO BE REMOVED)
- (13) PROPOSED MEDIAN SURFACE REMOVAL
- (14) PROPOSED HMA SURFACE REMOVAL, 2 1/4"
- (15) PROPOSED AGGREGATE WEDGE SHOULDER, TYPE B
- (16) PROPOSED STEEL PLATE BEAM GUARDRAIL, TYPE A, 9' POST
- (17) PROPOSED HMA SHOULDER, 11/2"
- (18) PROPOSED BITUMINOUS MATERIAL (TACK COAT)
- (19) PROPOSED LONGITUDINAL JOINT SEALANT
- (20) PROPOSED HMA BINDER COURSE, 21/4"
- (21) PROPOSED HMA SURFACE COURSE, 11/2"
- 22) PROPOSED CONCRETE C&G, TYPE M-6.06
- (23) PROPOSED CONCRETE MEDIAN SURFACE, 6"
- PROPOSED HMA SHOULDER, 21/4"

MODEL: Typical Sections-6 [Sheet]
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USER NAME = edison.zohfonyi	DESIGNED -	REVISED -
	DRAWN -	REVISED -
	CHECKED -	REVISED -
PLOT DATE = 5/9/2025	DATE -	REVISED -


STATE OF ILLINOIS
DEPARTMENT OF TRANSPORTATION

TYPICAL SECTIONS						F.A.* RTE	SEC ⁻	TION		COUNTY	TOTAL SHEETS	SHEET NO.	
							*	(580,58	1)RS-2		ST. CLAIR	44	13
							* FAP 594/FAU 9213				CONTRACT	NO. 76	M55
	SHEET 6	OF	11	SHEETS	STA.	TO STA.			ILLINOIS	FED. AII	D PROJECT		

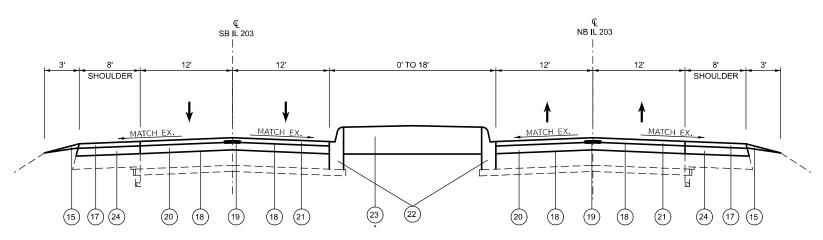


PROPOSED TYPICAL SECTION

STA, 2+08,00 TO 3+98,00

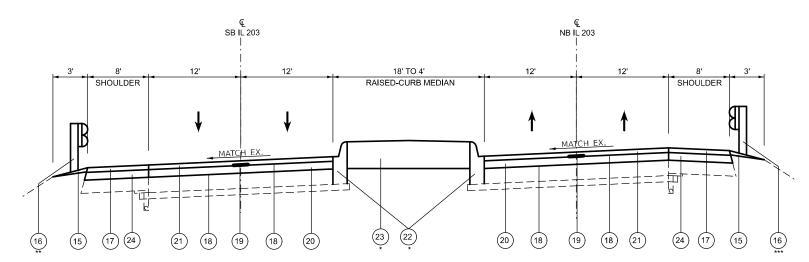

PROPOSED TYPICAL SECTION

STA. 3+98 TO 5+50.00 STA. 5+50.00 TO 7+29.00 (NB BRIDGE OMISSION) STA. 5+55.00 TO 7+32.00 (SB BRIDGE OMISSION) STA. 7+32.00 TO 13+35.00

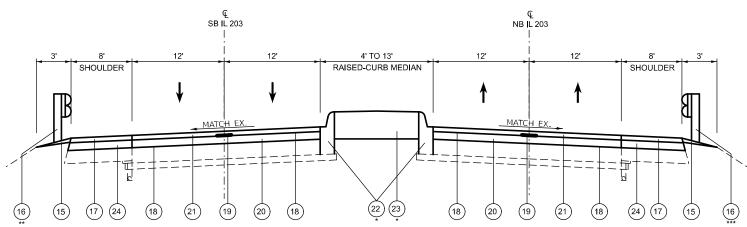

PROPOSED TYPICAL SECTION

STA. 13+35.00 TO 16+74.00 (BRIDGE OMISSION) STA. 16+74.00 TO 20+59.00

USER NAME = edison.zohfonyi	DESIGNED -	REVISED -
	DRAWN -	REVISED -
	CHECKED -	REVISED -
PLOT DATE = 5/9/2025	DATE -	REVISED -


STATE OF ILLINOIS
DEPARTMENT OF TRANSPORTATION

| F.A.* | SECTION | TOTAL | SHE | SHEET | STA. | TO STA. | SHEET | SECTION | COUNTY | TOTAL | SHEET | SHEET | SHEET | SHEET | SHEET | STA. | TO STA. | SHEET | SHEET | SHEET | STA. | TO STA. | SHEET | SHEET

LEGEND


- (1) EXISTING AGGREGATE WEDGE SHOULDER, TYPE B
- (2) EXISTING STEEL PLATE BEAM GUARDRAIL
- 3 EXISTING BITUMINOUS SHOULDERS, 10"
- (4) EXISTING PIPE UNDERDRAINS
- 5 EXISTING 6" SUB-BASE GRANULAR MATERIAL
- (6) EXISTING 10" PCC PAVEMENT
- 7 EXISTING HMA LEVEL BINDER, 3/4"
- 8 EXISTING HMA SURFACE COURSE, 11/2"
- 9 EXISTING PCC PAVEMENT
- (10) EXISTING CONCRETE C&G, TYPE M-6.06
- (11) EXISTING CONCRETE MEDIAN SURFACE
- (12) EXISTING CONCRETE BARRIER (TO BE REMOVED)
- (13) PROPOSED MEDIAN SURFACE REMOVAL
- (14) PROPOSED HMA SURFACE REMOVAL, 2 1/4"
- (15) PROPOSED AGGREGATE WEDGE SHOULDER, TYPE B
- (16) PROPOSED STEEL PLATE BEAM GUARDRAIL, TYPE A, 9' POST
- (17) PROPOSED HMA SHOULDER, 11/2"
- (18) PROPOSED BITUMINOUS MATERIAL (TACK COAT)
- (19) PROPOSED LONGITUDINAL JOINT SEALANT
- $\stackrel{-}{20}$ PROPOSED HMA BINDER COURSE, 1½"
- (21) PROPOSED HMA SURFACE COURSE, 11/2"
- (22) PROPOSED CONCRETE C&G, TYPE M-6.06
- 23) PROPOSED CONCRETE MEDIAN SURFACE, 6"
- (24) PROPOSED HMA SHOULDER, 21/4"
 - * FROM STA. 3+98.00 TO STA. 4+87.00 FROM STA 5+72.00 TO STA. 7+43.00 FROM STA. 8+44.00 TO STA. 13+35.00 FROM STA. 16+74.00 TO STA. 20+59.00
 - ** FROM STA. 6+99.00 TO STA. 8+79.00 FROM STA. 11+36.60 TO STA. 13+51.40 FROM STA. 16+57.70 TO STA. 17+39.50
 - *** FROM STA. 4+11.50 TO STA. 5+83.90 FROM STA. 6+99.00 TO STA. 7+82.55 FROM STA. 8+69.00 TO STA. 10+50.00 FROM STA. 11+66.60 TO STA. 13+52.10 FROM STA. 16+57.70 TO STA. 18+47.80

E NAME: c:\pw_work\pwidot\illinois.gov_edison.zohfonyi@illinois.g

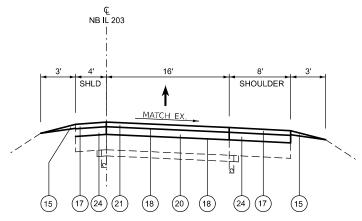


PROPOSED TYPICAL SECTION **NB 203 CONNECTOR**

STA. 20+59.00 TO 26+69.00 STA. 32+64.00 TO 35+86.00

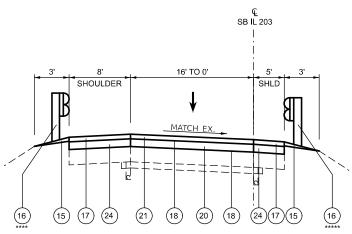

PROPOSED TYPICAL SECTION S.B. 203

STA. 27+55.00 TO 28+88.00 (PCC PAVEMENT OMISSION) STA. 28+88.00 TO 38+10.00

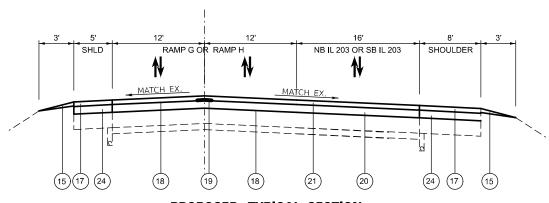

PROPOSED TYPICAL SECTION

N.B. 203 STATION EQUATION 35+86.00 BK = 131+55.00 AH RAMP H STA. 130+05.00 TO 131+55.00 RAMP G STA. 124+91.34 TO 129+00.00


LEGEND

- (1) EXISTING AGGREGATE WEDGE SHOULDER, TYPE B
- (2) EXISTING STEEL PLATE BEAM GUARDRAIL
- (3) EXISTING BITUMINOUS SHOULDERS, 10"
- (4) EXISTING PIPE UNDERDRAINS
- (5) EXISTING 6" SUB-BASE GRANULAR MATERIAL
- 6 EXISTING 10" PCC PAVEMENT
- 7 EXISTING HMA LEVEL BINDER, 3/4"
- 8 EXISTING HMA SURFACE COURSE, 11/2"
- 9 EXISTING PCC PAVEMENT
- (10) EXISTING CONCRETE C&G, TYPE M-6.06
- (11) EXISTING CONCRETE MEDIAN SURFACE
- (12) EXISTING CONCRETE BARRIER (TO BE REMOVED)
- (13) PROPOSED MEDIAN SURFACE REMOVAL
- (14) PROPOSED HMA SURFACE REMOVAL, 2 1/4"
- (15) PROPOSED AGGREGATE WEDGE SHOULDER, TYPE B
- (16) PROPOSED STEEL PLATE BEAM GUARDRAIL, TYPE A, 9' POST
- (17) PROPOSED HMA SHOULDER, 11/2"
- (18) PROPOSED BITUMINOUS MATERIAL (TACK COAT)
- (19) PROPOSED LONGITUDINAL JOINT SEALANT
- (20) PROPOSED HMA BINDER COURSE, 21/4"
- (21) PROPOSED HMA SURFACE COURSE, 11/2"
- (22) PROPOSED CONCRETE C&G, TYPE M-6.06
- (23) PROPOSED CONCRETE MEDIAN SURFACE, 6"
- (24) PROPOSED HMA SHOULDER, 21/4"
- **** FROM STA. 27+96.00 TO STA. 29+85.00
- ***** FROM STA. 28+10.00 TO STA. 31+93.00

USER NAME = edison.zohfonyi	DESIGNED -	REVISED -
	DRAWN -	REVISED -
	CHECKED -	REVISED -
PLOT DATE = 5/9/2025	DATE -	REVISED -


	TYPICA	L SECT	IONS		F.A.* RTE	SECTION	COUNTY	TOTAL SHEETS	SHEET NO.
					*	(580,581)RS-2	ST. CLAIR	44	15
					* FAF	9594/FAU 9213	CONTRAC	NO. 76	M55
SHEET 8	OF 11	SHEETS	STA.	TO STA.		ILLINOIS FE	D. AID PROJECT		

STATE OF ILLINOIS **DEPARTMENT OF TRANSPORTATION** SCALE:

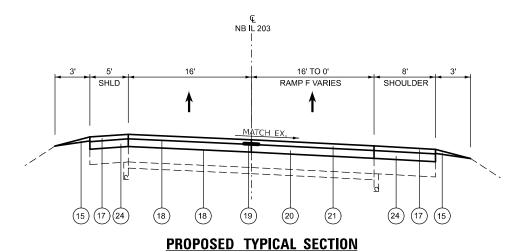

NB 203 CONNECTOR

STA. 26+69.00 TO 32+64.00

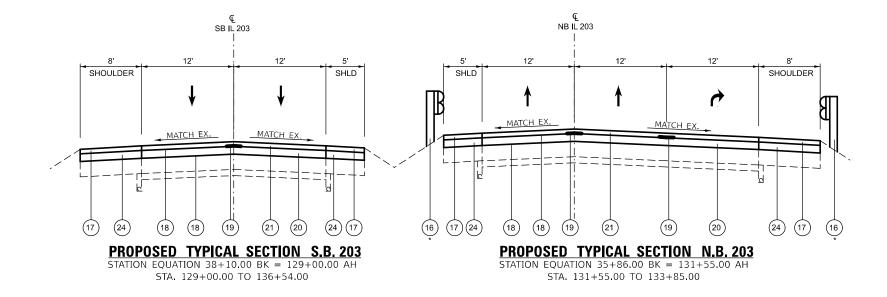

LEGEND


- (1) EXISTING AGGREGATE WEDGE SHOULDER, TYPE B
- (2) EXISTING STEEL PLATE BEAM GUARDRAIL
- (3) EXISTING BITUMINOUS SHOULDERS, 10"
- 4 EXISTING PIPE UNDERDRAINS
- (5) EXISTING 6" SUB-BASE GRANULAR MATERIAL
- 6 EXISTING 10" PCC PAVEMENT
- (7) EXISTING HMA LEVEL BINDER, 3/4"
- (8) EXISTING HMA SURFACE COURSE, 11/2"
- 9 EXISTING PCC PAVEMENT
- (10) EXISTING CONCRETE C&G, TYPE M-6.06
- (11) EXISTING CONCRETE MEDIAN SURFACE
- (12) EXISTING CONCRETE BARRIER (TO BE REMOVED)
- (13) PROPOSED MEDIAN SURFACE REMOVAL
- (14) PROPOSED HMA SURFACE REMOVAL, 2 1/4"
- (15) PROPOSED AGGREGATE WEDGE SHOULDER, TYPE B
- (16) PROPOSED STEEL PLATE BEAM GUARDRAIL, TYPE A, 9' POST
- (17) PROPOSED HMA SHOULDER, 11/2"
- (18) PROPOSED BITUMINOUS MATERIAL (TACK COAT)
- (19) PROPOSED LONGITUDINAL JOINT SEALANT
- (20) PROPOSED HMA BINDER COURSE, 21/4"
- (21) PROPOSED HMA SURFACE COURSE, 11/2"
- (22) PROPOSED CONCRETE C&G, TYPE M-6.06
- (23) PROPOSED CONCRETE MEDIAN SURFACE, 6"
- (24) PROPOSED HMA SHOULDER, 21/4"

* FROM STA. 131+43 TO STA. 133+09.00

FILE NAME: c:\pw work\pwidot\illinois.go

STATE OF ILLINOIS
DEPARTMENT OF TRANSPORTATION

SCALE:

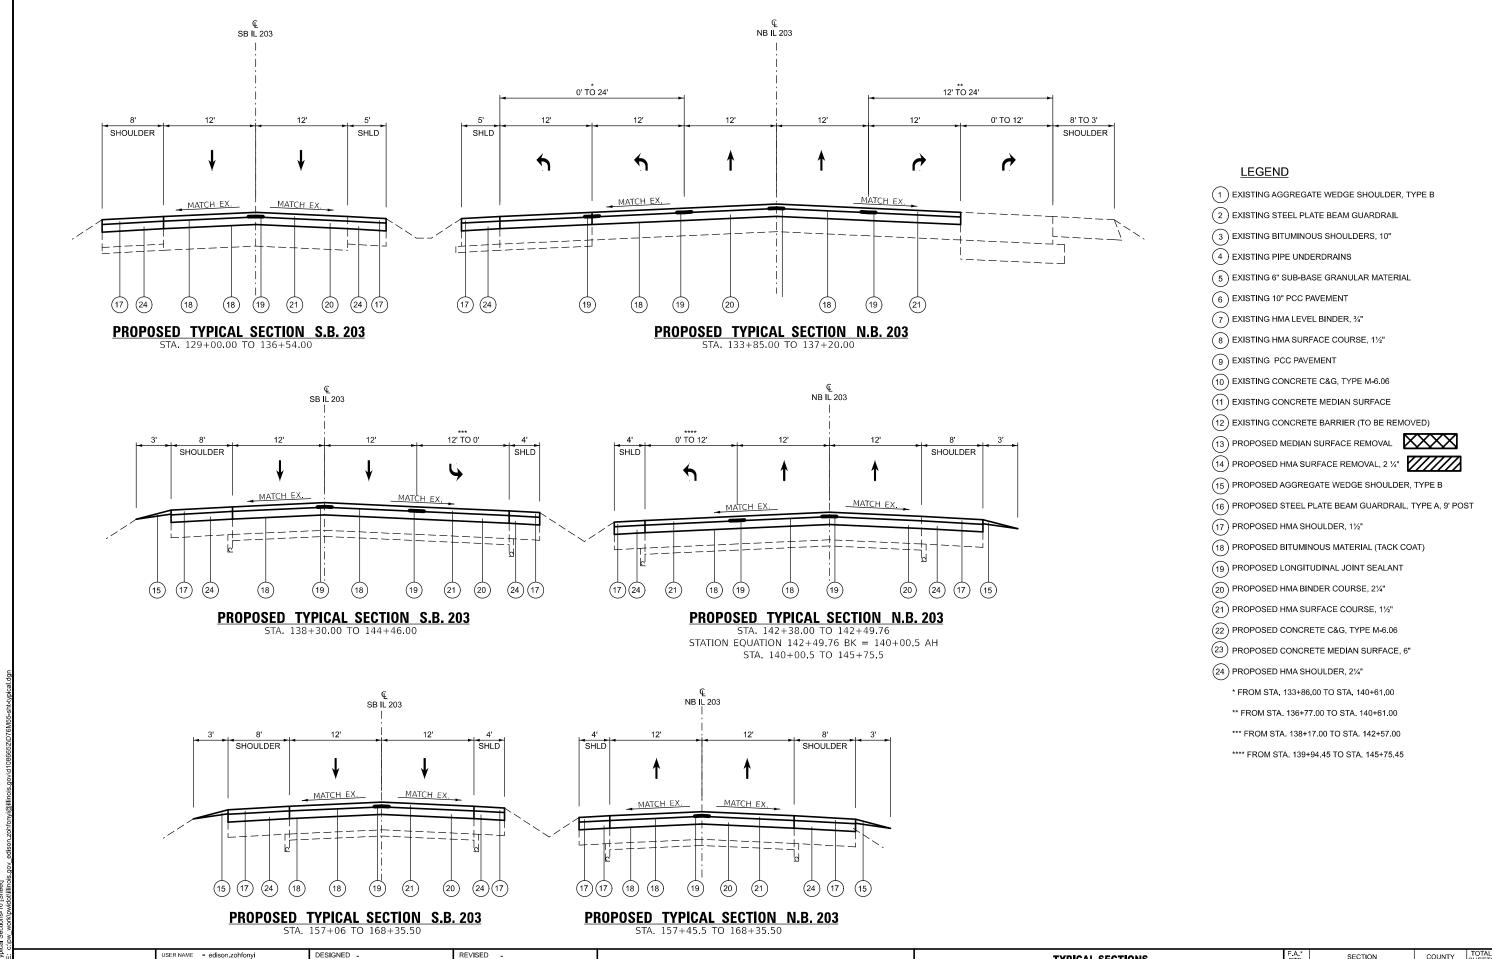

STATE OF ILLINOIS DEPARTMENT OF TRANSPORTATION

DESIGNED -

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DRAWN

DATE

PLOT DATE = 5/9/2025

REVISED -

REVISED


REVISED

REVISED

TYPICAL SECTIONS SHEET 10 OF 11 SHEETS STA.


TO STA.

SECTION COUNTY (580,581)RS-2 ST. CLAIR 44 * FAP 594/FAU 9213 CONTRACT NO. 76M55

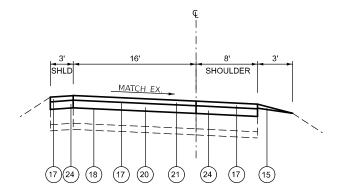


PROPOSED TYPICAL SECTION

RAMP A STA. 16+20.00 TO 17+05.00 RAMP D STA. 1+00.00 TO 2+67.00 RAMP B STA. 2+00.00 TO 3+45.00 RAMP E STA. 0+00.00 TO 2+74.00

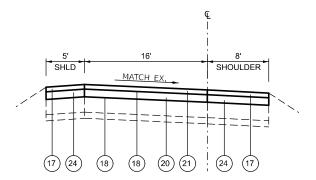

PROPOSED TYPICAL SECTION RAMP C STA. 11+88.00 TO 12+39.25

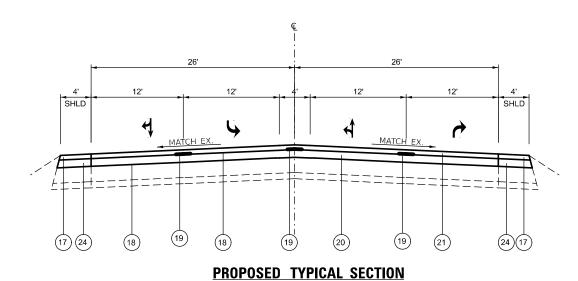

<u>LEGEND</u>

- (1) EXISTING AGGREGATE WEDGE SHOULDER, TYPE B
- (2) EXISTING STEEL PLATE BEAM GUARDRAIL
- (3) EXISTING BITUMINOUS SHOULDERS, 10"
- (4) EXISTING PIPE UNDERDRAINS
- (5) EXISTING 6" SUB-BASE GRANULAR MATERIAL
- 6 EXISTING 10" PCC PAVEMENT
- 7 EXISTING HMA LEVEL BINDER, ¾"
- 8 EXISTING HMA SURFACE COURSE, 11/2"
- 9 EXISTING PCC PAVEMENT
- (10) EXISTING CONCRETE C&G, TYPE M-6.06
- (11) EXISTING CONCRETE MEDIAN SURFACE
- (12) EXISTING CONCRETE BARRIER (TO BE REMOVED)
- (13) PROPOSED MEDIAN SURFACE REMOVAL
- (14) PROPOSED HMA SURFACE REMOVAL, 2 1/4"
- (15) PROPOSED AGGREGATE WEDGE SHOULDER, TYPE B
- (16) PROPOSED STEEL PLATE BEAM GUARDRAIL, TYPE A, 9' POST
- (17) PROPOSED HMA SHOULDER, 11/2"
- (18) PROPOSED BITUMINOUS MATERIAL (TACK COAT)
- (19) PROPOSED LONGITUDINAL JOINT SEALANT
- (20) PROPOSED HMA BINDER COURSE, 21/4"
- (21) PROPOSED HMA SURFACE COURSE, 11/2"
- (22) PROPOSED CONCRETE C&G, TYPE M-6.06
- (23) PROPOSED CONCRETE MEDIAN SURFACE, 6"
- (24) PROPOSED HMA SHOULDER, 21/4"

 USER NAME
 = edison.zohfonyi
 DESIGNED
 REVISED

 DRAWN
 REVISED

 CHECKED
 REVISED

 PLOT DATE
 = 5/9/2025
 DATE
 REVISED

STATE OF ILLINOIS
DEPARTMENT OF TRANSPORTATION

SCALE:

ois.gov_edison.zohfonyi@illinois.gov\d1086652\D76M55-sht-ty

LE NAME: c:\pw work\pwid

					RESUR	FACING	SCHEDU	JLE N.B.	IL 203			
STAT	TION	DIMEN	ISION	HMA SURFACE REMOVAL 2 1/4"	LONGITUDINAL JOINT SEALANT	BITUMINOUS MATERIALS (TACK COAT)	BITUMINOUS MATERIALS (TACK COAT)	HMA BINDER COURSE IL-19.0 MIX "B" N90	HMA BINDER COURSE IL-19.0 MIX "B" N90	POLYMERIZED HMA SURFACE COURSE IL-9.5	POLYMERIZED HMA SURFACE COURSE IL-9.5	MATERIAL TRANSFER
		LENGTH	WIDTH	REMOVAL 2 1/4	JOINT SEALANT	1ST PASS	2ND PASS	(MAINLINE)	(TURN LANES)	MIX "D" N90 (MAINLINE)	MIX "D" N90 (TURN LANES)	DEVICE
FROM	ТО	FEET	FEET	SQ YD	FEET	POUND	POUND	TON	TON	TON	TON	TON
2+08.00	5+50.00	342.00	24	912.0	342.0	410.4	205.2	114.91		76.6		191.5
5+50.00	7+29.00						BRIDGE	OMISSION SN - 082-002	29			
7+29.00	13+35.00	606.00	24	1616.0	606.0	727.2	363.6	203.62		135.7		339.4
13+35.00	16+74.00		BRIDGE OMISSION SN - 082-0028									
16+74.00	20+59.00	385.00	24	1026.7	770.0	462.0	231	129.36		86.2		215.6
20+59.00	26+69.00	610.00	16	1084.4		488.0	244	136.64		91.1		227.7
26+69.00	32+64.00	595.00	32	2115.6	595.0	952.0	476	266.56		177.7		444.3
32+64.00	35+86.00	322.00	16	572.4		257.6	128.8	72.13		48.1		120.2
						STATION EQUAT	ION STA. 35+86.00 B	K = 131+55.00 AH				
131+55.00			36	920.0	460.0	414.0	207	115.92		77.3		193.2
133+85.00	133+85.00 137+20.00		36	2010.0	1340.0	603.0	301.5	168.84	84.42	112.6	56.3	281.4
137+20.00	142+38.00		INTERSECTION OMISSION									
142+38.00	142+49.76	11.76	24	31.4	11.8	14.1	7.06	3.95		2.6		6.6
						STATION EQUAT	ON STA. 142+49.76	BK = 140+00.5 AH				
140+00.50	145+75.50	575.00	24	2300.0	1150.0	690.0	345	193.20	96.60	128.8	64.4	322.0
145+75.50	157+45.50						Р	ROJECT OMISSION				
157+45.50	168+35.50	1090.00	24	2906.7	1090.0	1308.0	654	366.24		244.2		610.4
RAM	1P H											
130+05.00	131+55.00	150.00	24	400.0	150.0	180.0	90	50.40		33.6		84.0
RAM												
1+00.00	2+67.00	167.00	16	296.9		133.6	66.8	37.41		24.9		62.3
RAM												
0+00.00	2+74.00	274.00	16	487.1		219.2	109.6	61.33		40.9		102.3
	<u> </u>											
	TOTA	L		16679	6515	6859	3430	1921	181	1280	121	3201

			SI	DEWALK AND N	MEDIAN	SCHEDULE						
STA	TION	CONCRETE MEDIAN SURFACE REMOVAL	CONCRETE MEDIAN SURFACE, 6 INCH	PORTLAND CEMENT CONCRETE SIDEWALK 4 INCH	DETECTABLE WARNINGS	CONCRETE MEDIAN SURFACE, 4 INCH	SIDEWALK REMOVAL	MEDIAN REMOVAL	PAVEMENT REMOVAL	CONCRETE BARRIER REMOVAL		
STATION I		SQ FT	SQ FT	SQ FT	SQ FT	SQ FT	SQ FT	SQ FT	SQ YD	FOOT		
2+25.00	4+87.00	2880	2880									
4+87.00	5+72.00		362							71		
5+72.00	7+32.00				BRIDGE OMISSIO	N SN - 082-0029			•			
7+32.00 7+43.00		50	50									
8+44.00	13+35.00	1736	1736									
13+35.00	16+74.00	BRIDGE OMISSION SN - 082-0028										
16+74.00	20+59.00	1852	1852									
NE QUADRANT	AT OHIO ST.			1302	38		2567		290	115		
NE QUADRANT ISL	AND AT OHIO ST.							344				
SE QUADRANT ISL	AND AT OHIO ST.			112	24	289		216				
SE QUADRANT	AT OHIO ST.			115	13							
NW QUADRANT AT	AT OHIO ST. LT				40			367				
NW QUADRANT AT	NW QUADRANT AT AT OHIO ST. RT							462				
TO	TAL	2880	6880	1529	115	289	2567	1389	290	186		

MODEL: Schedule of Quantity [Sheet]

USER NAME = edison.zohfonyi

PLOT DATE = 6/24/2025

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DATE

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REVISED -

REVISED -

STATE OF ILLINOIS
DEPARTMENT OF TRANSPORTATION

SCALE:

				RE	SURFACI	NG SCH	EDULE	S.B. IL 2	03			
STA	TION	DIME	NSION	HMA SURFACE	LONGITUDINAL	BITUMINOUS MATERIALS	BITUMINOUS MATERIALS	HMA BINDER COURSE IL-19.0	HMA BINDER COURSE IL-19.0	POLYMERIZED HMA SURFACE COURSE IL-9.5	POLYMERIZED HMA SURFACE COURSE IL-9.5	MATERIAL TRANSFER
		LENGTH	WIDTH	REMOVAL 2 1/4"	JOINT SEALANT	(TACK COAT) 1ST PASS	(TACK COAT) 2ND PASS	MIX "B" N90 (MAINLINE)	MIX "B" N90 (TURN LANES)	MIX "D" N90 (MAINLINE)	MIX "D" N90 (TURN LANES)	DEVICE
FROM	ТО	FEET	FEET	SQ YD	FEET	POUND	POUND	TON	TON	TON	TON	TON
2+08.00	5+55.00	347.00	24	925.3	347.0	416.4	208.2	116.59		77.7		194.3
5+55.00	7+32.00						BRIDGE OMISSION S	N - 082-0029				
7+32.00	13+35.00	603.00	24	1608.0	603.0	723.6	361.8	202.61		135.1		337.7
13+35.00	16+74.00											
16+74.00	20+59.00	385.00	24	1026.7	385.0	462.0	231	129.36		86.2		215.6
20+59.00	27+55.00	696.00	16	1237.3		556.8	278.4	155.90		103.9		259.8
27+55.00	28+88.00						PCC PAVEMENT	OMISSION				
28+88.00	37+10.00	822.00	16	1461.3		657.6	328.8	184.13		122.8		306.9
					STATIO	N EQUATION STA. 38	+10.00 BK = 129+00	D.00 AH				
129+00.00	136+54.00	754.00	24	2010.7	754.0	904.8	452.4	253.34		168.9		422.2
136+54.00	138+30.00						INTERSECTION (DMISSION				
138+30.00	144+46.00	616.00 24		2464.0	1232.0	739.2	369.6	206.98	103.49	138.0	69.0	345.0
144+46.00	157+06.00			PROJECT OMISSION								
157+06.00	168+35.50	1129.50	24	3012.0	1129.5	1355.4	677.7	379.51		253.0		632.5
RAN	MP G								•			
124+91.34	129+00.00	408.66	24	1089.8	408.7	490.4	245.196	137.31		91.5		228.8
RAN	MP A							-	_			
16+20.00	17+05.00	85.00	16	151.1		68.0	3/1	19.04		12.7		31.7
RAI	MP B							-	_	-		
2+00.00	3+45.00	145.00	16	257.8		116.0	58	32.48		21.7		54.1
RAI	MP C											
11+88.00	12+39.25	51.25	16	91.1		41.0	20.5	11.48		7.7		19.1
RACE TRAC	K ENTRANCE	54.00	52	312.0	54.0	140.4	70.2	39.31		26.2		65.5
	IOIA	L		15647	4913	6672	3336	1868	103	1245	69	3113

MODEL: Schedule of Quantity-1 [Sheet]

USER NAME = edison.zohfonyi	DESIGNED -	REVISED -
	DRAWN -	REVISED -
	CHECKED -	REVISED -
PLOT DATE = 5/8/2025	DATE -	REVISED -

STATE OF ILLINOIS
DEPARTMENT OF TRANSPORTATION

S	CHEDULI	E OF QU	ANTITIE	s	F.A.* RTE.	SECTION	COUNTY	TOTAL SHEETS	SHEET NO.
					*	(580,581)RS-2	ST. CLAIR	44	20
					* FAP 594/FAU 9213 CONT			ACT NO. 76M55	
SHEET 2	OF 11	SHEETS	STA.	TO STA.		ILLINOIS FED. A	D PROJECT		

			НМА	SHOU	LDER	SCHEDU	LE N.B.	IL 203		
			DIMENSION				BITUMINOUS	BITUMINOUS		HMA SHOULDER
STA	TION		HMA SHOU	LDER WIDTH	AREA	HMA SURFACE REMOVAL 2 1/4"	MATERIALS (TACK COAT)	MATERIALS (TACK COAT)	HMA SHOULDER 2 1/4" (LOWER)	1 1/2"
		LENGTH	EAST	WEST		REMOVAL 2 1/4	1ST PASS	2ND PASS	2 1/4 (LOWER)	(SURFACE)
FROM	TO	FEET	FEET	FEET	SQ YD	SQ YD	POUND	POUND	TON	TON
2+08.00	5+50.00	342	8	0	304.0	304.0	136.8	68.4	38.3	25.5
5+50.00	7+29.00				BRIDGE OMISSION SN - 082-0029				•	•
7+29.00	7+72.00	43.00	8	0	38.2	38.2	17.2	8.6	4.8	3.2
8+32.00	10+15.00	183.00	8	0	162.7	162.7	73.2	36.6	20.5	13.7
10+69.00	13+35.00	266.00	8	0	236.4	236.4	106.4	53.2	29.8	19.9
13+35.00	16+74.00					BRIDGE OMISSI	ION SN - 082-0028	-		
16+74.00	20+59.00	385	8	0	342.2	342.2	154	77	43.1	28.7
20+59.00	26+69.00	610	8	4	813.3	813.3	366	183	102.5	68.3
26+69.00	32+64.00	595	8	5	859.4	859.4	386.75	193.4	108.3	72.2
32+64.00	35+86.00	322	8	4	429.3	429.3	193.2	96.6	54.1	36.1
				STAT	ION EQUATION	STA. 38+86.00 BK = 1	131+55.00 AH			
131+55.00	133+85.00	230.00	8	5	332.2	332.2	149.5	74.75	41.9	27.9
133+85.00	137+20.00	335.00	0	5	186.1	186.1	83.75	41.875	23.5	15.6
137+20.00	142+38.00					INTERSECT	TON OMISSION			
142+38.00	142+49.76	11.76	8	4	15.7	15.7	7.056	3.53	2.0	1.3
				STAT	ION EQUATION	STA. 142+49.76 BK =	140+00.5 AH		•	
140+00.50	145+75.50	575	8	4	766.7	766.7	345	172.5	96.6	64.4
145+75.50	157+45.50					PROJECT OMISSION				
157+45.50	168+35.50	1090	8	4	1453.3	1453.3	654	327	183.1	122.1
RAI	MP H			•			•			
130+05.00	131+55.00	150	8	5	216.7	216.7	97.5	48.75	27.3	18.2
RAI	MP D									
1+00.00	2+67.00	167	8	3	204.1	204.1	91.85	45.93	25.7	17.1
RAI	MP E									
0+00.00	2+74.00	274	8	3	334.9	334.9	150.7	75.35	42.2	28.1
		TOT	AL	·		6695	3013	1506	844	562

MODEL: Schedule of Quantity-2 [Sheet]

USER NAME = edison.zohfonyi	DESIGNED -	REVISED -
	DRAWN -	REVISED -
	CHECKED -	REVISED -
PLOT DATE = 5/8/2025	DATE -	REVISED -

STATE OF ILLINOIS
DEPARTMENT OF TRANSPORTATION

	SCH	EDL	JLE	OF QUA	ANTITIES	<u> </u>	F.A.* RTE	SECTION	COUNTY	TOTAL SHEETS	SHEET NO.
							*	(580,581)RS-2	ST. CLAIR	44	21
							* FA	P 594/FAU 9213	CONTRACT	NO. 761	M55
SHEET 3	3	OF	11	SHEETS	STA.	TO STA.		ILLINOIS FED. A	D PROJECT		

			HMA	SHOU	LDER	SCHEDU	LE S.B.	IL 203		
STA	TION	LENGTH		LDER WIDTH	AREA	HMA SURFACE REMOVAL 2 1/4"	BITUMINOUS MATERIALS (TACK COAT)	BITUMINOUS MATERIALS (TACK COAT)	HMA SHOULDER 2 1/4" (LOWER)	HMA SHOULDEF 1 1/2" (SURFACE)
			EAST	WEST			1ST PASS	2ND PASS		
FROM	ТО	FEET	FEET	FEET	SQ YD	SQ YD	POUND	POUND	TON	TON
2+08.00	4+47.00	239	0	8	212.4	212.4	95.6	47.8	26.8	17.8
4+83.00	5+55.00	72	0	8	64.0	64.0	28.8		8.1	
5+55.00	7+32.00					1	ON SN - 082-0029		T	
7 32.00	11 65.00	433.00	0	8	384.9	384.9	173.2	86.6	48.5	32.3
12+49.00	13+35.00	86.00	0	8	76.4	76.4	34.4		9.6	
13+35.00	16+74.00					BRIDGE OMISSI	ON SN - 082-0028			
16 74.00	20 59.00	385	0	8	342.2	342.2	154	77	43.1	28.7
20+59.00	27+55.00	696	5	8	1005.3	1005.3	452.4		126.7	
27+55.00	28+88.00					PCC PAVEM	ENT OMISSION			
28 88.00	38 10.00	922	5	8	1331.8	1331.8	599.3	299.65	167.8	111.9
				STATI	ON EQUATION	STA. 38+10.00 BK = 1	.29+00.00 AH			
129+00.00 136+54.00		754.00	5	8	1089.1	1089.1	490.1	245.05	137.2	91.5
136 54.00	138 30.00					INERSECTI	ON OMISSION			
138+30.00	144+46.00	616.00	4	5	616.0	616.0	277.2		77.6	
144+46.00	157+06.00					PROJECT	OMISSION			
157 06.00	168 35.50	1129.5	4	8	1506.0	1506.0	677.7	338.85	189.8	126.5
RAN	MP G									
124 91.34	129 00.00	408.66	8	5	590.3	590.3	265.629	132.8	74.4	49.6
RAN	MP A									
16+20.00	17+05.00	85	8	3	103.9	103.9	46.75	23.4	13.1	8.7
	MP B									
2+00.00	3+45.00	145	8	3	177.2	177.2	79.75	39.9	22.3	14.9
D 4 4	MD C									
	MP C	F1 25	1 0		74.0	74.0	22.2425	10.7	0.2	6.3
11+88.00	12+39.25	51.25	8	5	74.0	74.0	33.3125	16.7	9.3	6.2
RACE TRACI	K ENTRANCE	45	4	4	40.0	40.0	18	9	5.0	3.4
		ТОТ	<u>l</u> Al			7614	3426	1317	959	492

MODEL: Schedule of Quantity-3 [Sheet]

USER NAME = edison.zohfonyi	DESIGNED -	REVISED -
	DRAWN -	REVISED -
	CHECKED -	REVISED -
PLOT DATE = 5/8/2025	DATE -	REVISED -

STATE OF ILLINOIS
DEPARTMENT OF TRANSPORTATION

SCHEDULE OF QUANTITIES						SEC ⁻	TION		COUNTY	TOTAL SHEETS	SHEET NO.
					*	(580,58	1)RS-2		ST. CLAIR	44	22
					* FAI	594/FAU 9213			CONTRACT	NO. 76	M55
SHEET 4	OF 11	SHEETS	STA.	TO STA.			ILLINOIS	FED, AII	D PROJECT		

AGGREGATE WEDGE SHOULDER, TYPE B, N.B. IL 203

				IMENSION	IS		ACCDECATE WEDGE
STA	AT I ON	DEPTH	LENCTH	WID	OTH	AREA	AGGREGATE WEDGE SHOULDER, TYPE B
			LENGTH	EAST	WEST	1	JINOULDEN, TITL D
FROM	TO	INCH	FEET	FEET	FEET	SQ YD	TON
2+08.00	5+50.00	3	342	3	0	114.00	19.95
5+50.00	7+29.00			BRIDGE O	MISSION SN	1 - 082-002	9
7+29.00	7+72.00	3	43	3	0	14.33	2.51
8+32.00	10+15.00	3	183	3	0	61.00	10.67
10+69.00	13+35.00	3	266	3	0	88.67	15.52
13+35.00	16+74.00			BRIDGE O	MISSION SN	l - 082-002	8
16+74.00	20+59.00	3	385	3	0	128.33	22.46
20+59.00	26+69.00	3	610	3	3	406.67	71.17
26+69.00	32+64.00	3	595	3	3	396.67	69.42
32+64.00	35+86.00	3	322	3	3	214.67	37.57
	STAT	ION EQUATI	ON STA. 38	3+86.00 BK	= 131+55.	00 AH	
141+70.00	142+49.76	3	79.76	0	3	26.59	4.65
	STAT	ION EQUATI	ON STA. 14	12+49.76 B	K = 140+00).5 AH	
140+00.50	145+75.50	3	575	3	0	191.67	33.54
145+75.50	157+45.50			PR	ROJECT OMI:	SSION	
157+45.50	168+35.50	3	1090	3	0	363.33	63.58
RAI	MP H						
130+05.00	131+55.00	3	150	3	3	100.00	17.50
RAI	MP D						
1+00.00	2+67.00	3	167	3	0	55.67	9.74
RAI	MP E						
0+00.00	2+74.00	3	274	3	0	91.33	15.98
		TOTAL					394

AGGREGATE WEDGE SHOULDER, TYPE B, S.B. IL 203

				0 5			
				DIMENSIONS		AGGREGATE WEDGE	
STA	TION	DEPTH	LENGTH	WI	DTH	AREA	SHOULDER, TYPE B
			LENGIN	EAST	WEST		SHOOLDEN, THE B
FROM	TO	INCH	FEET	FEET	FEET	SQ YD	TON
2+08.00	4+47.00	3	239	0	3	79.67	13.94
4+83.00	5+55.00	3	72	0	3	24.00	4.20
5+50.00	7+32.00			BRIDGE ON	MISSION SN -	082-0029	
7+32.00	11+65.00	3	433	3	0	144.33	25.26
12+49.00	13+35.00	3	86	3	0	28.67	5.02
13+35.00	16+74.00			BRIDGE ON	MISSION SN -	082-0028	
16+74.00	20+59.00	3	385	0	3	128.33	22.46
20+59.00	27+55.00	3	696	0	3	232.00	40.60
27+55.00	28+88.00			PCC F	PAVEMENT OM	SSION	
28+88.00	38+10.00	3	922	3	3	614.67	107.57
		STATION EQU	NATION STA.	38+10.00 BK	= 129:00.00) AH	
138+29.00	144+46.00	3	617	0	3	205.67	35.99
144+46.00	157+06.00			PR	OJECT OMISS	ION	
157+06.00	168+35.50	3	1129.5	0	3	376.50	65.89
RAN	ИР G						
124+91.34	129+30.00	3	408.66	3	3	272.44	47.68
RAN	ИР А						
16+20.00	17+05.00	3	85	3	0	28.33	4.96
RAP	ИР В						
2+00.00	3+45.00	3	145	3	0	48.33	8.46
		TOTAL					382

	CUR	B AND GUT	TER SCHEDI	JLE					
STA	TION	COMBINATION CONCRETE CURB & GUTTER REMOVAL	COMBINATION CONCRETE CURB & GUTTER TYPE M-6.06	COMBINATION CONCRETE CURB & GUTTER TYPE B-6.24	CURB REFLECTORS	PAINT CURB			
FROM	ТО	FEET	FEET	FEET	EACH	FEET			
2+25.00	2+94.00	138	138		8	58			
2+94.00	4+87.00		386		14				
4+87.00	5+72.00		170		6				
5+72.00	7+32.00		BRIDGE OMISSIC	DN SN - 082-0029					
7+32.00	7+43.00		22		1				
8+44.00	13+35.00		982		37				
13+35.00	16+74.00	BRIDGE OMISSION SN - 082-0028							
16+74.00	20+59.00		770		29	58			
SOUTHWEST CONNER ISLAND I	L 203 AT COLLINSVILLE RD.				15	76			
SOUTHEAST CONNER ISLA	ND IL 203 AT OHIO ST.	45	86		11	65			
NORTHEAST CONNER ISLA	ND IL 203 AT OHIO ST.	65							
NE QUADRANT	AT OHIO ST.		207	188					
SE QUADRANT	AT OHIO ST.	27		27					
TO	TAL	275	2761	215	122	257			

USER NAME = edison.zohfonyi	DESIGNED -	REVISED -
	DRAWN -	REVISED -
	CHECKED -	REVISED -
PLOT DATE = 6/24/2025	DATE -	REVISED -

STATE OF ILLINOIS DEPARTMENT OF TRANSPORTATION

 SCHEDULE OF QUANTITIES
 F.A.* RTE. RTE. SECTION
 * (580,581)RS-2

 * FAP 594/FAU 9213
 * FAP 594/FAU 9213
 ILLINOI

DELE: Scriedure of Cuaritiy—; Criedij E NAME: c:\pw work\pwidot\illinois.gov edison.zohfonyi@illinois.gov\c

			PATCI	HING	SCHE	EDUL	E N.	B. IL	_ 203			
						CLAS	SS B PATO	CHES				
PATCH			LENGTH	WIDTH	AREA	_	13 INCHES		WELDED WIRE			
NO.	STATION	LANE		****	7	TYPE II			REINFORCEMENT	1 1/2"	3/4"	CUTS
			FEET	FEET	SQ YD	SQ YD	SQ YD	SQ YD	SQ YD	EACH	EACH	FOOT
1	2+88.00	1	6	12	8	8			54.15			
2	2+88.00	2	6	12	8	8				20		48
3	3+38.00	1	6	12	8	8				20		48
4	3+38.00	2	6	12	8	8				20		48
5	4+28.00	1	6	12	8	8				20		48
6	4+28.00	2	6	12	8	8				20		48
7	4+76.00	1	6	12	8	8				20		48
8	4+76.00	2	6	12	8	8				20		48
9	5+07.00	1	6	12	8	8				20		48
10	5+07.00	2	6	12	8	8				20		48
11	6+69.00	1	6	12	8	8				20		48
12	6+69.00	2	6	12	8	8				20		48
13	7+18.00	1	6	12	8	8				20		48
14	7+18.00	2	6	12	8	8				20		48
15	8+49.00	1	6	12	8	8				20		48
16	8+49.00	2	6	12	8	8				20		48
17	26+37.00	1	6	15	10	10				24		57
18	27+48.00	2	6	15	10	10				24		57
19	28+54.00	2	6	12	8	8				20		48
20	28+76.00	2	6	12	8	8				20		48
21	29+24.00	2	6	12	8	8				20		48
22	29+74.00	2	6	12	8	8				20		48
23	30+27.00	2	6	12	8	8				20		48
24	30+60.00	2	6	12	8	8				20		48
25	31+16.00	1	6	12	8	8				20		48
26	31+16.00	2	6	12	8	8						
27	32+40.00	1	6	16	11	11				28		60
					QUATION STA.							
28	140+36.50	2	12	12	16	<u> </u>	16			20		60
29	167+14.00	1	40	12	54			54	54		19	
30	167+14.00	2	8	12	11	11						-
31	168+02.00	2	10	12	14	14				20		56
32	168+12.00	1	8	12	11	11				20		52
					INTERCECT	ION BAT	CHINC					
	Z AT OHIO TA				INTERSECT	TON PAT	CHING					Ι
	3 AT OHIO ST. 137+20.00 TO 142+38.00	ALL LANES	518	48	2763	-		2763	2763	28	258	1180
. دد	13/720.00 10 142+38.00	TOTAL	710	1 40	2/03	259	16	2817	2763	684	258	2842
	1,00/_ //	ANTICIPATED FAIL	LIRES			259	2	2817	2817	69	277	2842
	10% F	TOTAL	01/LJ			285	18	3099	3099	753	305	3127

MODEL: Schedule of Quantity-5 [Sheet]

STATE OF ILLINOIS DEPARTMENT OF TRANSPORTATION

SCHEDULE OF QUANTITIES						SEC.	TION		COUNTY	TOTAL SHEETS	SHEET NO.
					*	(580,58	1)RS-2		ST. CLAIR	44	24
					* FAI	P 594/FAU 9213			CONTRACT	NO. 76	M55
SHEET 6	OF 11	SHEETS	STA.	TO STA.			ILLINOIS	FED. AII	O PROJECT		

		P	<u> </u>	<u>ING</u>	<u>SCHE</u>				_ 203			
						CLAS	S B PATO	CHES	WELDED WIRE	DOWEL BARS	TIE BARS	SAW
PATCH			LENGTH	WIDTH	AREA		13 INCHES	S				1
NO.	STATION	LANE				TYPE II	TYPE III	TYPE IV	REINFORCEMENT	1 1/2"	3/4"	CUT
			FEET	FEET	SQ YD	SQ YD	SO YD	SQ YD	SQ YD	EACH	EACH	FOO
1	4+03.00	2	_			30 10	30 10	114	114		42	_
2	5+83.00	2	85 6	12 12	114	8		114	114	20 20	42	206 48
3	6+08.00	1	20	12	27	8		27	27	20	9	76
4	6+08.00	2	10	12	14	14		21	21	20	9	56
5	6+58.00	1	20	12	27	14		27	27	20	9	76
6	6+58.00	2	20	12	27			27	27	20	9	76
7	7+08.00	1	6	12	8	8		21	21	20	<u> </u>	48
8	7+08.00	2	6	12	8	8				20		48
9	8+08.00	1	6	12	8	8				20		48
10	8+08.00	2	6	12	8	8				20		48
10	0 1 00.00				UATION STA. 3		C = 129 + 00	.00 AH		20		10
11	138+75.00	1	6	12	8	8		l		20		48
12	138+75.00	2	6	12	8	8				20		48
13	138+75.00	LEFT TURN LN	6	12	8	8				20		48
14	139+15.00	1	6	12	8	8				20		48
15	139+75.00	1	18	12	74		24			20		72
16	139+75.00	2	8	12	11	11				20		52
17	140+50.00	1	14	12	19		19			20		64
18	142+98.00	1	12	12	16		16			20		60
19	142+98.00	2	12	12	16		16			20		60
20	143+78.00	2	6	12	8	8				20		48
21	145+78.00	2	6	12	8	8				20		48
22	147+96.00	1	6	12	8	8				20		48
23	147+96.00	2	6	12	8	8				20		48
24	148+96.00	2	6	12	8	8				20		48
25	149+56.00	1	8	12	11	11				20		52
26	149+56.00	2	8	12	11	11				20		52
27	150+06.00	1	6	12	8	8				20		48
28	150+06.00	2	6	12	8	8				20		48
29	150+56.00	1	6	12	8	8				20		48
30	150+56.00	2	6	12	8	8				20		48
31	151+06.00	1	30	12	40			40	40	20	14	96
32	151+06.00	2	30	12	40			40	40	20	14	96
33	151+79.00	1	8	12	11	11				20		52
34	151+79.00	2	8	12	11	11				20		52
35	152+79.00	2	20	12	27			27	27	20	9	76
36	153+09.00	1	6	12	8	8				20		48
37	153+09.00	2	6	12	8	8				20		48
38	153+59.00	1	6	12	8	8				20		48
39	153+59.00	2	6	12	8	8				20		48
40	154+34.00	1	12	12	16		16			20		60
41	154+34.00	2	12	12	16		16			20		60
42	155+34.00	1	6	12	8	8				20		48
43	155+34.00	2	12	12	16		16			20		60
44	156+34.00	2	8	12	11	11				20		52
45	157+40.00	1	6	12	8	8				20		48
46	157+40.00	2	6	12	8	8				20		48
47	157+90.00	2	30	12	40			40	40	20	14	96
48	158+90.00	2	60	12	80			80	80	20	29	156
49	159+90.00	2	10	12	14	14				20		56
50	162+70.00	2	6	12	8	8				20		48
51	163+20.00	1	6	12	8	8				20		48
52	163+20.00	2	6	12	8	8				20	-	48
53	163+90.00	2	20	12	27			27	27	20	9	76
54	165 90.00	2	6	12	8	8 ON DAT				20		48
		T		IN	TERSECTI	UN PAT	CHING		I	1	Γ	
	03 AT OHIO ST.											
55	136+54.00 TO 138+30.00	ALL LANES	176	36	704			704	704	28	87	460
		TOTAL	IDEC			326	123	1153	1153	1108	245	374
	10%	ANTICIPATED FAILU	IKES			33	13	116	116	111	25	375
		TOTAL				359	136	1269	1269	1219	270	411

MODEL: Schedule of Quantity-6 [Sheet] FILE NAME: c:\pw work\pwidot\tillinois.gov edisc

STATE OF ILLINOIS
DEPARTMENT OF TRANSPORTATION

SCALE:

			F	PAVE	MENT	MAR	KING	SCHE	DULE N	. B . I	L 203			
	ATION ATION		THERMOPL	ASTIC AN			ENT MARKIN		PAVEMENT MARK I NG	SHORT TERM	SHORT TERM PAVEMENT		EFLECTIVE T MARKER	RAISED REFLECTIVE
FROM	ТО	WHITE SOLID	WHITE SKIP-DASH	YELLOW SOLID	SOLID LINE	8" WHILE SOLID LINE	24" WHITE STOP LINE	AND SYMBOLS	REMOVAL - WATER BLASTING	PAVEMENT MARK I NG	MARK I NG REMOVAL	ONE WAY CRYSTAL	TWO WAY AMBER	PAVEMENT MARKER REMOVAL
		FEET	FEET	FEET	FEET	FEET	FEET	SQ FT	SQ FT	FEET	SQ FT	EACH	EACH	EACH
2+08.00	2+26.00	18	10						14	10	4			
2+26.00	5+50.00	324	90	324					369	150	50	5		5
5+50.00	7+29.00	179	50	179					204	90	30	3		3
7+29.00	9+96.00	267	70	267					302	130	44	4		4
9+96.00	10+54.00		20	58					39	20	7	1		1
10+54.00	13+35.00	281	80	281					321	130	44	4		4
13+35.00	16+74.00	339	90	339					384	160	54	5		5
16+74.00	26+96.00	1022	260						641	470	157	13		13
26+96.00	27+10.00	14		14					14	10	4			
27+10.00	29+20.00	210	60	210					240	100	34	3		3
29+20.00	34+59.00	539	140	539					609	250	84			
34+59.00	35+86.00	127	40	127					147	60	20			
35+86.00	131+55.00				•		STATIO	N EQUATION S	STA. 35+86.00 BK	= 131+55.00	AH			
131+55.00	134+01.00	246	140	246					316	50	17	8		8
134+01.00	135+42.00	141	110	141					196	70	24	4		4
135+42.00	137+24.00	182	140	182					252	50	17	6		6
137+24.00	140+84.00	720	180	360	177	160	91	220	1032	480	160	20		20
141+51.00	142+49.76		30	98.76	116				65	50	17	2		2
141+51.00	140+00.50						STATIO	N EQUATION S	STA. 142+49.76 B	K = 140+00.5	AH			
140+00.50	142+26.50	226	60	226					256	110	37	3		3
142+26.50	145+75.50	698	90	349				40	609	80	27	5		5
145+75.50	157+45.50				•	•	•	PF	ROJECT OMISSION	•				
157+45.50	168+35.50	1090	280	1090					1230	400	134	14		14
RAN	MP H													
130+05.00	131+55.00	150	40	150					170	60	20	2		2
RAN	MP D													
1+00.00	2+67.00	167		167					167	70	24			
														1
RAN	MP E													+
0+00.00	2+74.00	274		274					274	100	34			
														1
OHIO	O ST.	156	100	312	130		28	70	410	160	54			+
														+
TC	TAI	7370	2080	5934	423	160	119	330	8261	3260	1097	102	0	102

MODEL: Schedule of Quantity-7 [Sheet]

USER NAME = edison.zohfonyi	DESIGNED -	REVISED -
	DRAWN -	REVISED -
	CHECKED -	REVISED -
PLOT DATE = 6/24/2025	DATE -	REVISED -

STATE OF ILLINOIS
DEPARTMENT OF TRANSPORTATION

S	CHEDU	JLE	OF QUA	ANTITIE	s	F.A.* SECTION COUNT			TOTAL SHEETS	SHEET NO.
							(580,581)RS-2	ST. CLAIR	44	26
							P 594/FAU 9213	CONTRACT	NO. 761	M55
SHEET 8	OF	11	SHEETS	STA.	TO STA.		ILLINOIS FED.	AID PROJECT		

				РΑ	VEMEN	IT M	ARKI	NG SC	HEDU	LE S.B	. IL	203			
LOCA	ATION		THE	RMOPLAST	IC AND TEMP	PORARY PA	AVEMENT M	IARK I NG		PAVEMENT	SHORT	SHORT TERM		EFLECTIVE	RAISED
STA	ATION		LINE - 6"		LINE - 12"	8" WHITE	12" WHITE	24" WHITE	LETTERS	MARKING REMOVAL -	TERM	PAVEMENT	PAVEMEN ⁻	T MARKER	REFLECTIVE PAVEMENT
FROM	ТО	WIIITE SOLID	WIIITE SKIP-DASH	YELLOW SOLID	YELLOW LINE DIAGONAL	SOL ID LINE	SOL ID LINE	SIOP LINE	ANI) SYMBOLS	WATER BLASTING	PAVEMENT MARKING	MARKING REMOVAL	ONE WAY CRYSTAL	TWO WAY AMBER	MARKER REMOVAL
		FEET	FEET	FEET	FEET	FEET	FEET	FEET	SQ FT	SQ FT	FEET	SQ FT	EACH	EACH	EACH
2+08.00	2+26.00	18	10					24		62	40	14			
2+26.00	4+40.00	214	60	214		211			40	425	140	47	3		3
4+40.00	5+55.00		30	115						73	60	20	2		2
5+55.00	7+32.00	177	50	177						202	9()	30	3		3
7+32.00	12+13.00	481	130	481						546	220	74	7		7
12+13.00	12+79.00		20	66						43	20	7	1		1
12+79.00	13+35.00	56	20	56						66	30	10	1		1
13+35.00	16+74.00	339	90	339						384	160	54	5		5
16 74 . 00	27 55 . 00	1081		1081						1081	500	167	14		14
27+55.00	28+88.00	133	40	133						153	70	24	2		2
28+88.00	35+99.00	711		711						711	330	110			
35+99.00	38+10.00	211	60	211						241	100	34	3		3
38+10.00	129+00.00							STATION EQUA	TION STA. 3	8+10.00 BK = 129	+00.00 AH				
129+00.00	137+48.00	848	220	848						958	390	130	11		11
138+19.00	140+46.00	454	60	227	65		116	36	40	664	180	60	6		6
140+46.00	144+46.00	400	100	400						450	190	64	5		5
144+46.00	157+06.00		•				•		PROJECT	OMISSION	•			•	
157+06.00	168+35.50	1129.5	290	1129.5						1275	420	140	15		1.5
RAI	MP G														
124+91.34	129+00.00	408.66	110	408.66						464	150	50	6		6
RAI	MP A														
16+20.00	17+05.00	85		85						85	40	14			
RAI	MP B														
2+00.00	3+45.00	145		145						145	60	20			
RAI	MP C	1													
11+88.00	12+39.25			51.25						26	20	7			
RACE TRAC	CK ENTRANCE	54		216			85		40	260	60	20		6	6
ТС	OTAL	6945	1290	7094	65	211	201	60	120	8314	3270	1096	84	6	90

MODEL: Schedule of Quantity-8 [Sheet]

USER NAME = edison.zohfonyi	DESIGNED -	REVISED -
	DRAWN -	REVISED -
	CHECKED -	REVISED -
PLOT DATE = 6/24/2025	DATE -	REVISED -

STATE OF ILLINOIS	
DEPARTMENT OF TRANSPORTATION	

SCHEDULE OF QUANTITIES							SECTION		COUNTY	TOTAL SHEETS	SHEET NO.
							(580,581)RS-2 ST. CL/		ST. CLAIR	44	27
						* FAF	P 594/FAU 9213		CONTRACT	NO. 76	M55
SHEET 9	OF	11	SHEETS	STA.	TO STA.		ILLINOIS	FED. AII	O PROJECT		

				GUARDR.	AIL AND	TRAFFIC I	BARRIERS)			
STA	TION	LOCATION	STEEL PLATE BEAM GUARDRAIL TYPE A, 9 FOOT POSTS	TRAFFIC BARRIER TERMINAL, TYPE 1 (SPECIAL) TANGENT	TRAFFIC BARRIER TERMINAL, TYPE 2		TRAFFIC BARRIER TERMINAL, TYPE 6	TRAFFIC BARRIER TERMINAL, TYPE 6B	TERMINAL MARKER DIRECT APPLIED	GUARDRAIL REFLECTORS, TYPE A	GUARDRAIL REMOVAL
FROM	ТО	1	FOOT	EACH	EACH	EACH	EACH	EACH	EACH	EACH	FOOT
4+11.50	4+49.00	NB-RT		1					1		37.50
4+49.00	5+49.00	NB-RT	100.00							3	100.00
5+49.00	5+83.90	NB-RT						1			37.50
6+99.00	7+36.50	NB-RT				1					37.50
7+36.50	7+74.00	NB-RT	37.50							1	37.50
7+74.00	7+82.55	NB-RT			1						8.55
6+99.00	7+36.50	SB-LT						1			37.50
7+36.50	8+36.50	SB-LT	100.00							3	100.00
8+36.50	8+79.00	SB-LT		1					1		37.50
8+69.00	9+06.50	NB-RT		1					1		37.50
9+06.50	10+19.00	NB-RT	112.50							3	112.50
10+19.00	10+56.50	NB-RT			1						37.50
11+36.60	11+74.10	SB-LT			1						37.50
11+74.10	13+11.60	SB-LT	137.50							4	137.50
13+11.60	13+51.40	SB-LT					1				39.80
11+66.60	12+04.10	NB-RT		1					1		37.50
12+04.10	13+29.10	NB-RT	125.00							3	125.00
13+29.10	13+52.10	NB-RT					1				23.00
16+57.70	16+95.20	NB-RT					1				37.50
16+95.20	18+07.70	NB-RT	112.50							3	112.50
18+07.70	18+47.80	NB-RT			1						40.10
16+57.70	16+95.20	SB-LT					1				37.50
16+95.20	17+07.70	SB-LT	12.50								12.50
17+07.70	17+39.50	SB-LT		1					1		31.80
27+96.00	28+33.50	SB-LT			1						37.50
28+33.50	29+71.00	SB-LT	137.50							4	137.50
29+71.00	29+85.00	SB-LT		1					1		14.00
28+10.00	28+47.50	SB-RT			1						37.50
28+47.50	31+47.50	SB-RT	300.00							8	300.00
31+47.50	31+93.00	SB-RT		1					1		45.50
131+43.00	131+80.50	NB-RT/LT		2					2		75.00
131+80.50	132+68.00	NB-RT/LT	175.00							5	175.00
132+68.00	133+09.00	NB-RT/LT			2						82.00
	TOTAL		1350.00	9	8	1	4	2	9	37	2197.25

USER NAME = edison.zohfonyi	DESIGNED -	REVISED -
	DRAWN -	REVISED -
	CHECKED -	REVISED -
PLOT DATE = 5/9/2025	DATE -	REVISED -

STATE OF ILLINOIS	
DEPARTMENT OF TRANSPORTATION	

SCALE:

sc	HEDULE	ANTITIES	F.A.* RTE	SECTI	ION		COUNTY	TOTAL SHEETS	SHEET NO.		
					*	(580,581)RS-2 ST. CLAIR 44		44	28		
					* FAP 594/FAU 9213 CONTRACT NO			NO. 76	M55		
SHEET 10	OF 11	SHEETS	STA.	TO STA.		l l	ILLINOIS	FED. AII	O PROJECT		

TEMPORARY RAMP/ACCESS SCHEDULE N.B. IL 203

CL OF ENTRANCE OR	LOCATION	LENGTH	WIDTH	TEMPORARY RAMP	COMMENTS		
SIDEROAD		FEET	FEET	SQ YD			
2+08.00		12.5	83	116	BEGIN PROJECT		
5+50.00		12.5	32	45	BRIDGE OMISSION		
7+29.00		12.5	32	45	BRIDGE OMISSION		
8+06.00	R	3	80	27	OUTER RD		
10+40.00	R	3	85	29	RAMP D		
13+35.00		12.5	32	45	BRIDGE OMISSION		
16+74.00		12.5	32	45	BRIDGE OMISSION		
17+98.00	R	3	85	29	RAMP E		
26+96.00	R	3	20	7	RAMP F		
	STATION	EQUATION STA	. 35+86.00 Bk	$\zeta = 131 + 55.00$	AH		
137+20.00		12.5	48	67	INTERSECTION OMISSION		
142+38.00		12.5	48	67	INTERSECTION OMISSION		
STATION EQUATION STA. 142+49.76 BK = 140+00.5 AH							
145+75.50		12.5	36	50	PROJECT OMISSION		
157+45.50		12.5	36	50	PROJECT OMISSION		
168+35.50		12.5	36	50	END PROJECT		
	ТОТ	AL		672			

SURFACE REMOVAL BUTT-JOINT S.B. IL 203

			<u> </u>				
STATION	LOCATION	LENGTH	WIDTH	HMA SURFACE REMOVAL BUTT-JOINT	COMMENTS		
		FEET	FEET	SQ YD			
2+08.00		30	105	350	BEGIN PROJECT		
4+63.00	L	7.5	55	46	RAMP A		
5+55.00		60	32	214	BRIDGE OMMISSION		
7+32.00		60	32	214	BRIDGE OMMISSION		
12+45.00	L	7.5	65	55	RAMP B		
13+35.00		60	32	214	BRIDGE OMMISSION		
16+74.00		60	32	214	BRIDGE OMMISSION		
17+79.00	L	7.5	65	55	RAMP C		
27+55.00		65	29	210	PCC PAVEMENT OMMISSION		
28+88.00		65	29	210	PCC PAVEMENT OMMISSION		
	STATI	ON EQUATION S	STA. 38+10.00	BK = 129+00.00	AH		
124+91.34		7 . 5	37	31	RAMP G		
136+54.00		60	37	247	INTERSECTION OMISSION		
138+30.00		60	37	247	INTERSECTION OMISSION		
144+46.00		30	48	160	PROJECT OMISSION		
157+06.00		30	48	160	PROJECT OMISSION		
168+35.50		30	36	120	END PROJECT		
TOTAL 2747							

TEMPORARY RAMP/ACCESS SCHEDULE S.B. IL 203


		ט. ט	1 -	203	
CL OF ENTRANCE OR	LOCATION	LENGTH	WIDTH	TEMPORARY RAMP	COMMENTS
SIDEROAD		FEET	FEET	SQ YD	
2+08.00		12.5	105	146	BEGIN PROJECT
4+63.00	L	3	55	19	RAMP A
5+55.00		12.5	32	45	BRIDGE OMISSION
7+32.00		12.5	32	45	BRIDGE OMISSION
12+45.00	L	3	65	22	RAMP B
13+35.00		12.5	32	45	BRIDGE OMISSION
16+74.00		12.5	32	45	BRIDGE OMISSION
17+79.00	L	3	65	22	RAMP C
27+55.00		12.5	29	41	PCC PAVEMENT OMISSION
28+88.00		12.5	29	41	PCC PAVEMENT OMISSION
	STATIC	ON EQUATION S	TA. 38+10.00	BK = 129 + 00.00) AH
124+91.34		3	37	13	RAMP G
136+54.00		12.5	37	52	INTERSECTION OMISSION
138+30.00		12.5	37	52	INTERSECTION OMISSION
144+46.00		12.5	48	67	PROJECT OMISSION
157+06.00		12.5	48	67	PROJECT OMISSION
168+35.50		12.5	36	50	END PROJECT
	TOTA	AL .		772	

SURFACE REMOVAL BUTT-JOINT N.B. IL 203


STATION	LOCATION	LENGTH WIDTH		HMA SURFACE REMOVAL BUTT-JOINT	COMMENTS
		FEET	FEET	SQ YD	
2+08.00		30	83	277	BEGIN PROJECT
5 50 . 00		60	32	214	BRIDGE OMISSION
7+29.00		60	32	214	BR I DGE
8+06.00	R	7.5	80	67	OUTER RD
10 40 . 00	R	7.5	85	71	RAMP D
13+35.00		60	32	214	BRIDGE OMISSION
16+74.00		60	32	214	BRIDGE OMISSION
17:98.00	R	7.5	85	71	RAMP E
26+96.00	R	7.5	20	17	RAMP F
	STATIO	N EQUATION ST	A. 35+86.00 E	3K = 131 + 55.00	AH
137 20.00		60	48	320	INTERSECTION OMISSION
142+38.00		60	48	320	INTERSECTION OMISSION
	STATIO	N EQUATION ST	A. 142+49.76	BK = 140+00.5	AH
145+75.50		30	36	120	PROJECT OMISSION
157+45.50	7+45.50		36	120	PROJECT OMISSION
168+35.50		30	36	120	END PROJECT
	TOTA	AL		2359	


USER NAME = edison.zohfonyi	DESIGNED -	REVISED -
	DRAWN -	REVISED -
	CHECKED -	REVISED -
PLOT DATE = 5/8/2025	DATE -	REVISED -

SCHEDULE OF QUANTITIES			F.A.* RTE	SEC ⁻	TION	COUNTY	TOTAL SHEETS	SHEET NO.				
			*	(580,58	1)RS-2		ST. CLAIR	44	29			
			* FA	P 594/FAU 9213			CONTRACT NO. 76M55					
11	OF	11	SHEETS	STA.	TO STA.			ILLINOIS	FED. AII	D PROJECT		

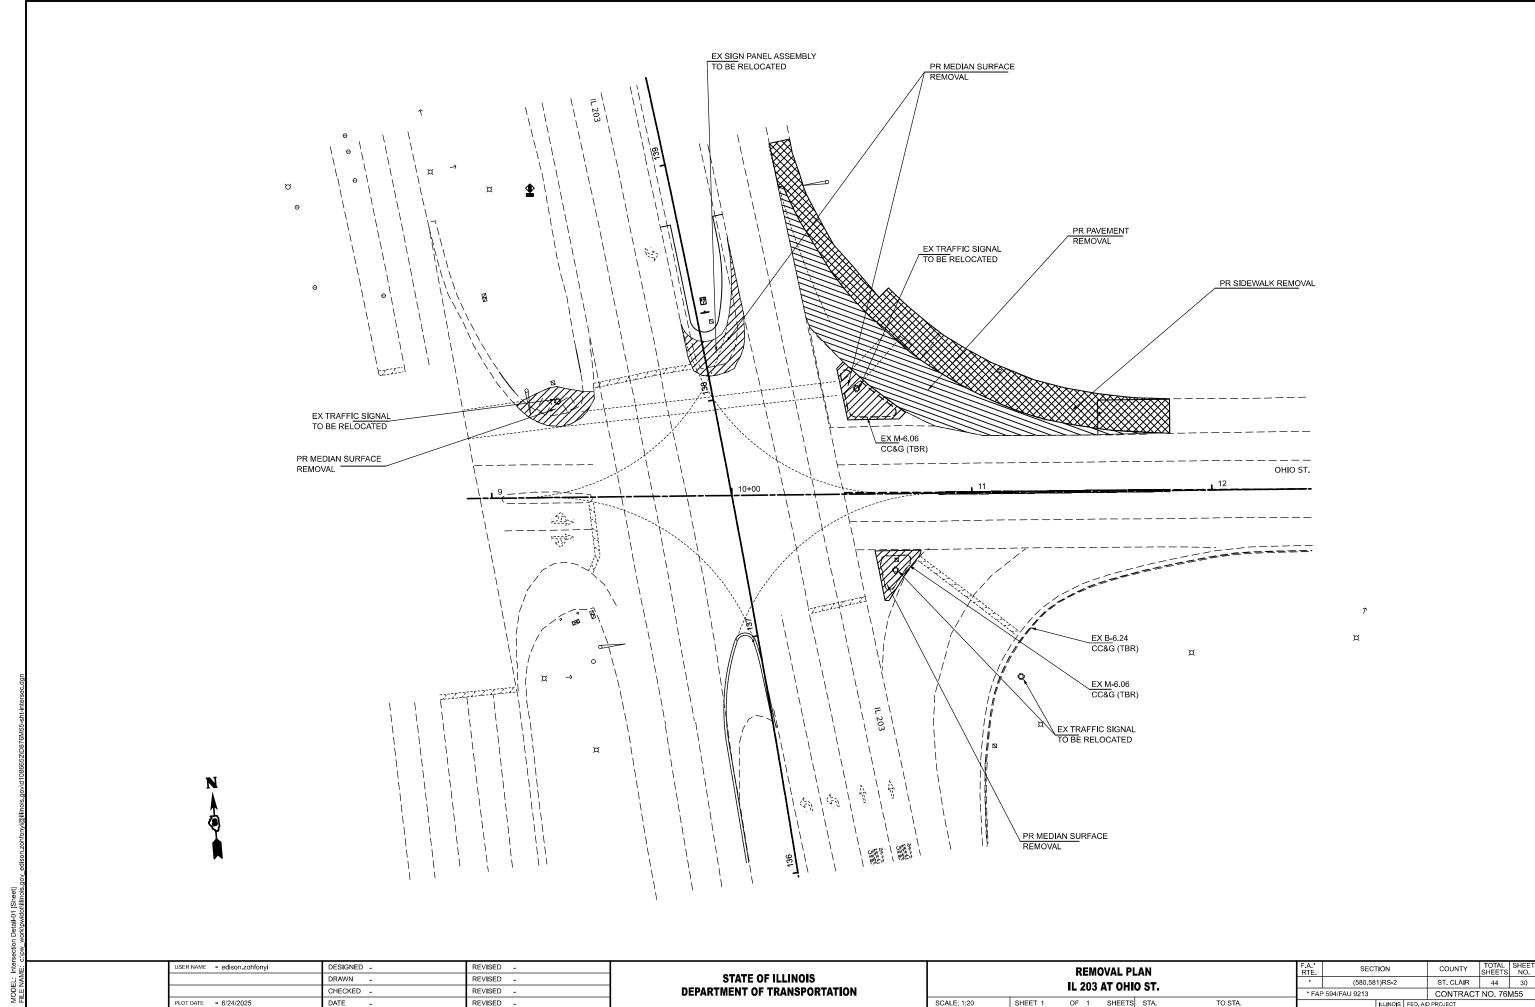

OF 1 SHEETS STA. TO STA.

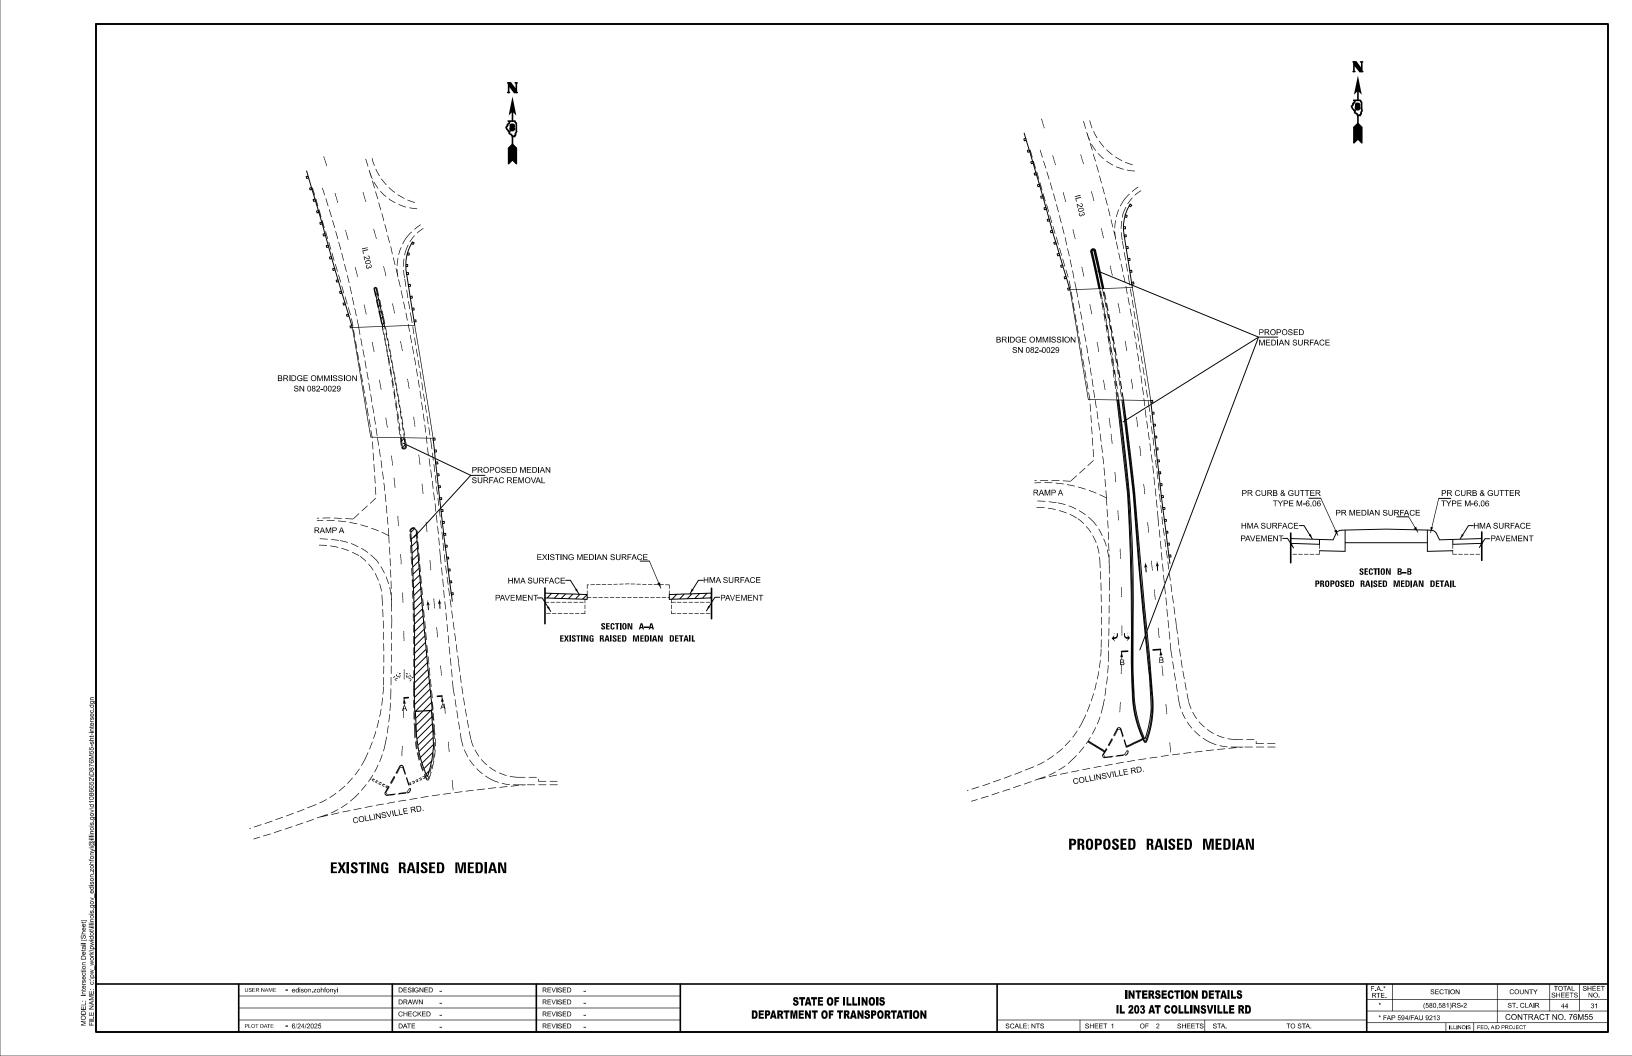

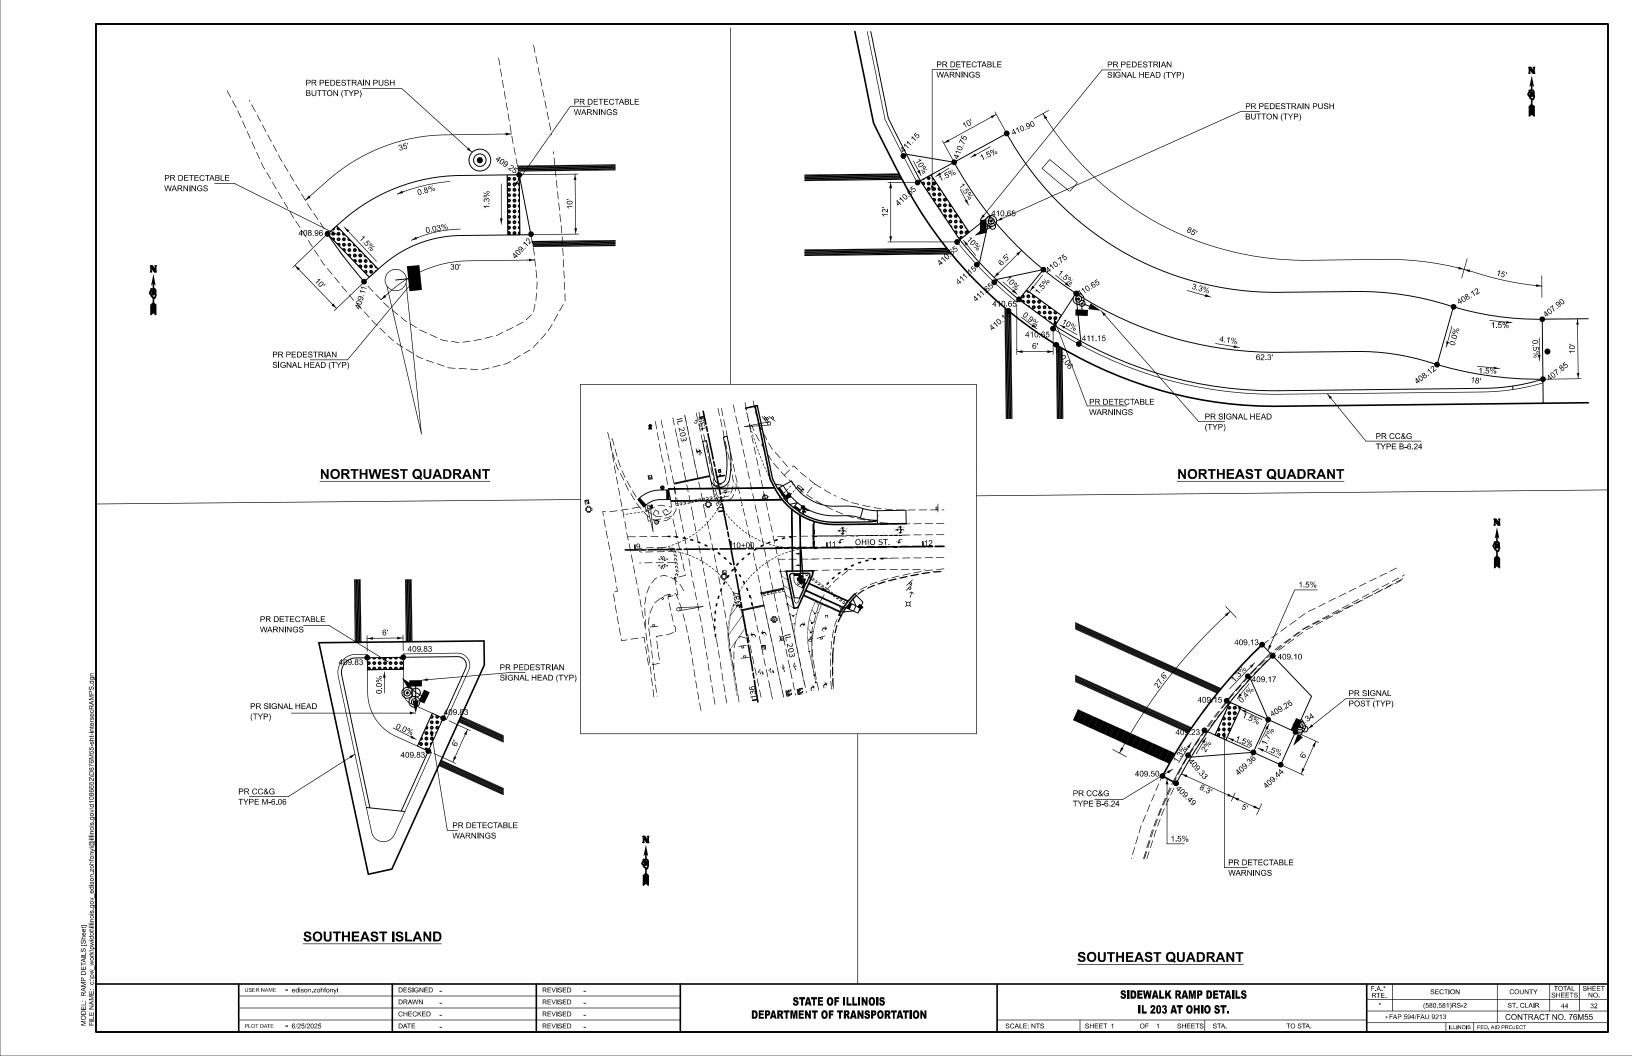

TRAFFIC SIGNAL SCHEDULE

CODE NO.	ITEM	UNIT	QUANTITY
25000210	SEEDING, CLASS 2A	ACRE	0.08
20101400	NITROGEN FERTILIZER NUTRIENT	POUND	7
20101500	PHOSPHORUS FERTILIZER NUTRIENT	POUND	7
20101600	POTASSIUM FERTILIZER NUTRIENT	POUND	7
72400710	RELOCATE SIGN PANEL - TYPE 1	SQ FT	1
81028220	UNDERGROUND CONDUIT, GALVANIZED STEEL, 3" DIA.	FOOT	450
85000200	MAINTENANCE OF EXISTING TRAFFIC SIGNAL INSTALLATION	EACH	1
87301245	ELECTRIC CABLE IN CONDUIT, SIGNAL NO. 14 5C	FOOT	3350
87301255	ELECTRIC CABLE IN CONDUIT, SIGNAL NO. 14 7C	FOOT	605
87301900	ELECTRIC CABLE IN CONDUIT, EQUIPMENT GROUNDING CONDUCTOR, NO. 6 1C	FOOT	550
87502670	TRAFFIC SIGNAL POST, ALUMINUM 13 FT.	EACH	1
87700140	STEEL MAST ARM ASSEMBLY AND POLE, 20 FT.	EACH	1
87700260	STEEL MAST ARM ASSEMBLY AND POLE, 44 FT.	EACH	1
87700270	STEEL MAST ARM ASSEMBLY AND POLE, 46 FT.	EACH	1
87800100	CONCRETE FOUNDATION, TYPE A	FOOT	10
87800400	CONCRETE FOUNDATION, TYPE E 30-INCH DIAMETER	FOOT	10
87800415	CONCRETE FOUNDATION, TYPE E 36-INCH DIAMETER	FOOT	28
87900200	DRILL EXISTING HANDHOLE	EACH	3
88030020	SIGNAL HEAD, LED, 1-FACE, 3-SECTION, MAST-ARM MOUNTED	EACH	5
88030050	SIGNAL HEAD, LED, 1-FACE, 3-SECTION, BRACKET MOUNTED	EACH	5
88030070	SIGNAL HEAD, LED, 1-FACE, 4-SECTION, BRACKET MOUNTED	EACH	1
88030080	SIGNAL HEAD, LED, 1-FACE, 4-SECTION, MAST ARM MOUNTED	EACH	1
88030100	SIGNAL HEAD, LED, 1-FACE, 5-SECTION, BRACKET MOUNTED	EACH	2
88030110	SIGNAL HEAD, LED, 1-FACE, 5-SECTION, MAST-ARM MOUNTED	EACH	2
88102717	PEDESTRIAN SIGNAL HEAD, LED, 1-FACE, BRACKET MOUNTED WITH COUNTDOWN TIMER	EACH	2
88200510	TRAFFIC SIGNAL BACKPLATE, RETROREFLECTIVE	EACH	8
89500200	RELOCATE EXISTING PEDESTRIAN SIGNAL HEAD	EACH	2
89502385	REMOVE EXISTING CONCRETE FOUNDATION	EACH	3
89502300	REMOVE ELECTRIC CABLE FROM CONDUIT	FOOT	11500
89502350	REMOVE AND REINSTALL ELECTRIC CABLE FROM CONDUIT	FOOT	56
89502375	REMOVE EXISTING TRAFFIC SIGNAL EQUIPMENT	EACH	1
X1400031	REMOVE PEDESTRIAN PUSH-BUTTON	EACH	3
X8760200	ACCESSIBLE PEDESTRIAN SIGNALS	EACH	3
X8760201	PEDESTRIAN PUSH-BUTTON POST	EACH	3
X8760204	RELOCATE EXISTING PEDESTRIANPUSH-BUTTON POST	EACH	3
X8950307	REMOVE EXISTING PEDESTRIAN SIGNAL HEAD	EACH	2

LEGEND:

\boxtimes	EXISTING TRAFFIC CONTROLLER CABINET
\rightarrow	EXISTING SIGNAL HEAD (NO BACKPLATE)
+>	EXISTING SIGNAL HEAD (WITH BACKPLATE)
	EXISTING HANDHOLE
	EXISTING DOUBLE HANDHOLE
0	EXISTING TRAFFIC SIGNAL POST
D	EXISTING STEEL MAST ARM ASSEMBLY AND POLE
	EXISTING UNDERGROUND CONDUIT
0	EXISTING PEDESTRIAN PUSH BUTTON
-0	EXISTING PEDESTRIAN SIGNAL HEAD
-	PROPOSED SIGNAL HEAD (NO BACKPLATE)
+	PROPOSED SIGNAL HEAD (WITH BACKPLATE)
•	PROPOSED TRAFFIC SIGNAL POST
	PROPOSED SIEEL MASI ARM ASSEMBLY AND POLE
	PROPOSED UNDERGROUND CONDUIT
0	PROPOSED PEDESTRIAN PUSH BUTTON
-	PROPOSED PEDESTRIAN SIGNAL HEAD WITH COUNTDOWN TIME

HIGHWAY STANDARDS

873001-02 TRAFFIC SIGNAL GROUNDIND & BONDING 878001-11 CONCRETE FOUNDATION DETAILS

: c:\pw_work\pwidot\illinois.gov_edison.zohfonyi@illinois.gov\d1086652\D876M5t


USER NAME = edison.zohfonyi	DESIGNED -	REVISED -
	DRAWN -	REVISED -
	CHECKED -	REVISED -
PLOT DATE = 6/26/2025	DATE -	REVISED -


STATE OF ILLINOIS DEPARTMENT OF TRANSPORTATION	
	SCALE:

COUNTY TOTAL SHEET NO.

ST. CLAIR 44 32B USER NAME = edison.zohfonyi DESIGNED -REVISED -TRAFFIC SIGNAL PLAN SECTION STATE OF ILLINOIS
DEPARTMENT OF TRANSPORTATION DRAWN -REVISED -(580,581)RS-2 IL 203 AT OHIO ST. CONTRACT NO. 76M55

ILLINOIS FED. AID PROJECT CHECKED -REVISED -PLOT DATE = 6/26/2025 DATE REVISED -SCALE: SHEET 2 OF 2 SHEETS STA. TO STA.

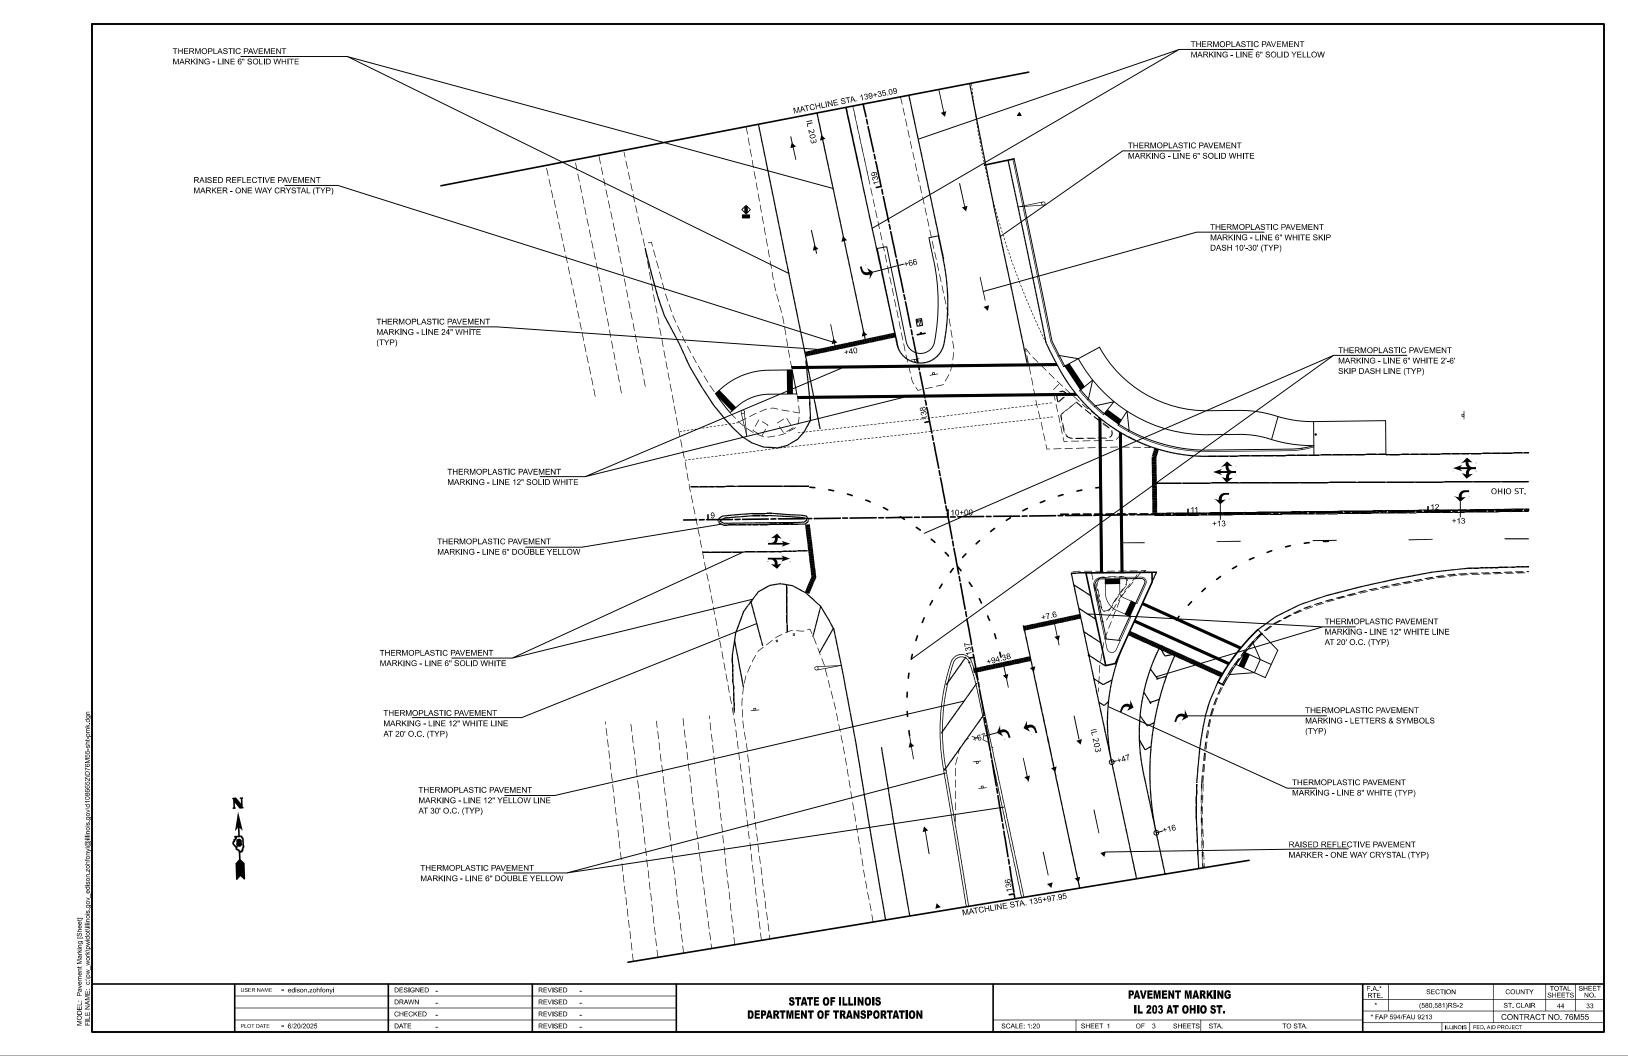


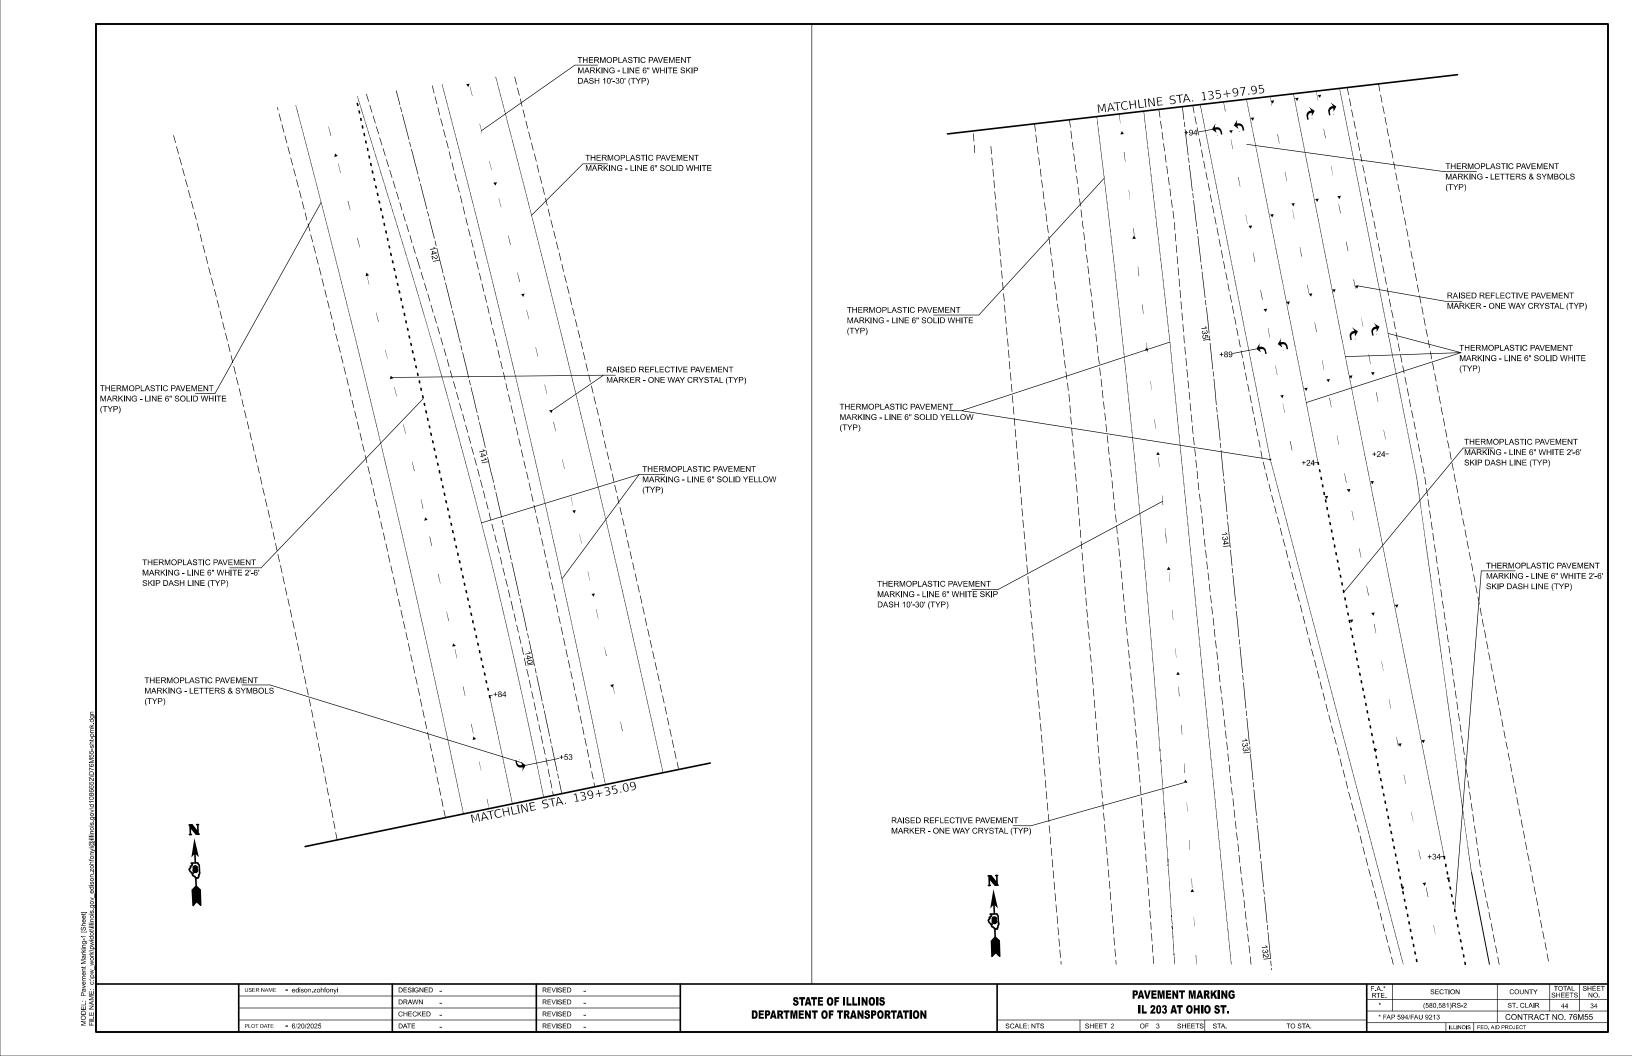


THERMOPLASTIC PAVEMENT
MARKING - LINE 6" SOLID YELLOW THERMOPLASTIC PAVEMENT
MARKING - LINE 6" SOLID YELLOW THERMOPLASTIC PAVEMENT
MARKING - LINE 6" WHITE SKIP DASH 10'-30' (TYP) RAMP A THERMOPLASTIC PAVEMENT
MARKING - LETTERS & SYMBOLS THERMOPLASTIC PAVEMENT MARKING - LINE 24" WHITE THERMOPLASTIC PAVEMENT THERMOPLASTIC PAVEMENT MARKING - LINE 6" SOLID WHITE MARKING - LINE 6" SOLID WHITE THERMOPLASTIC PAVEMENT____ MARKING - LINE 8" WHITE (TYP) COLLINSVILLE RD THERMOPLASTIC PAVEMENT MARKING - LINE 24" WHITE COUNTY TOTAL SHEET NO.

ST. CLAIR 44 35 JSER NAME = edison.zohfonyi DESIGNED -REVISED -SECTION PAVEMENT MARKING STATE OF ILLINOIS REVISED -DRAWN (580,581)RS-2 IL 203 AT COLLINSVILLE RD. DEPARTMENT OF TRANSPORTATION CHECKED -REVISED -* FAP 594/FAU 9213 CONTRACT NO. 76M55 PLOT DATE = 6/20/2025 DATE REVISED -SHEET 3 OF 3 SHEETS STA. TO STA.

RAISED REFLECTIVE PAVEMENT MARKER - ONE WAY CRYSTAL (TYP)

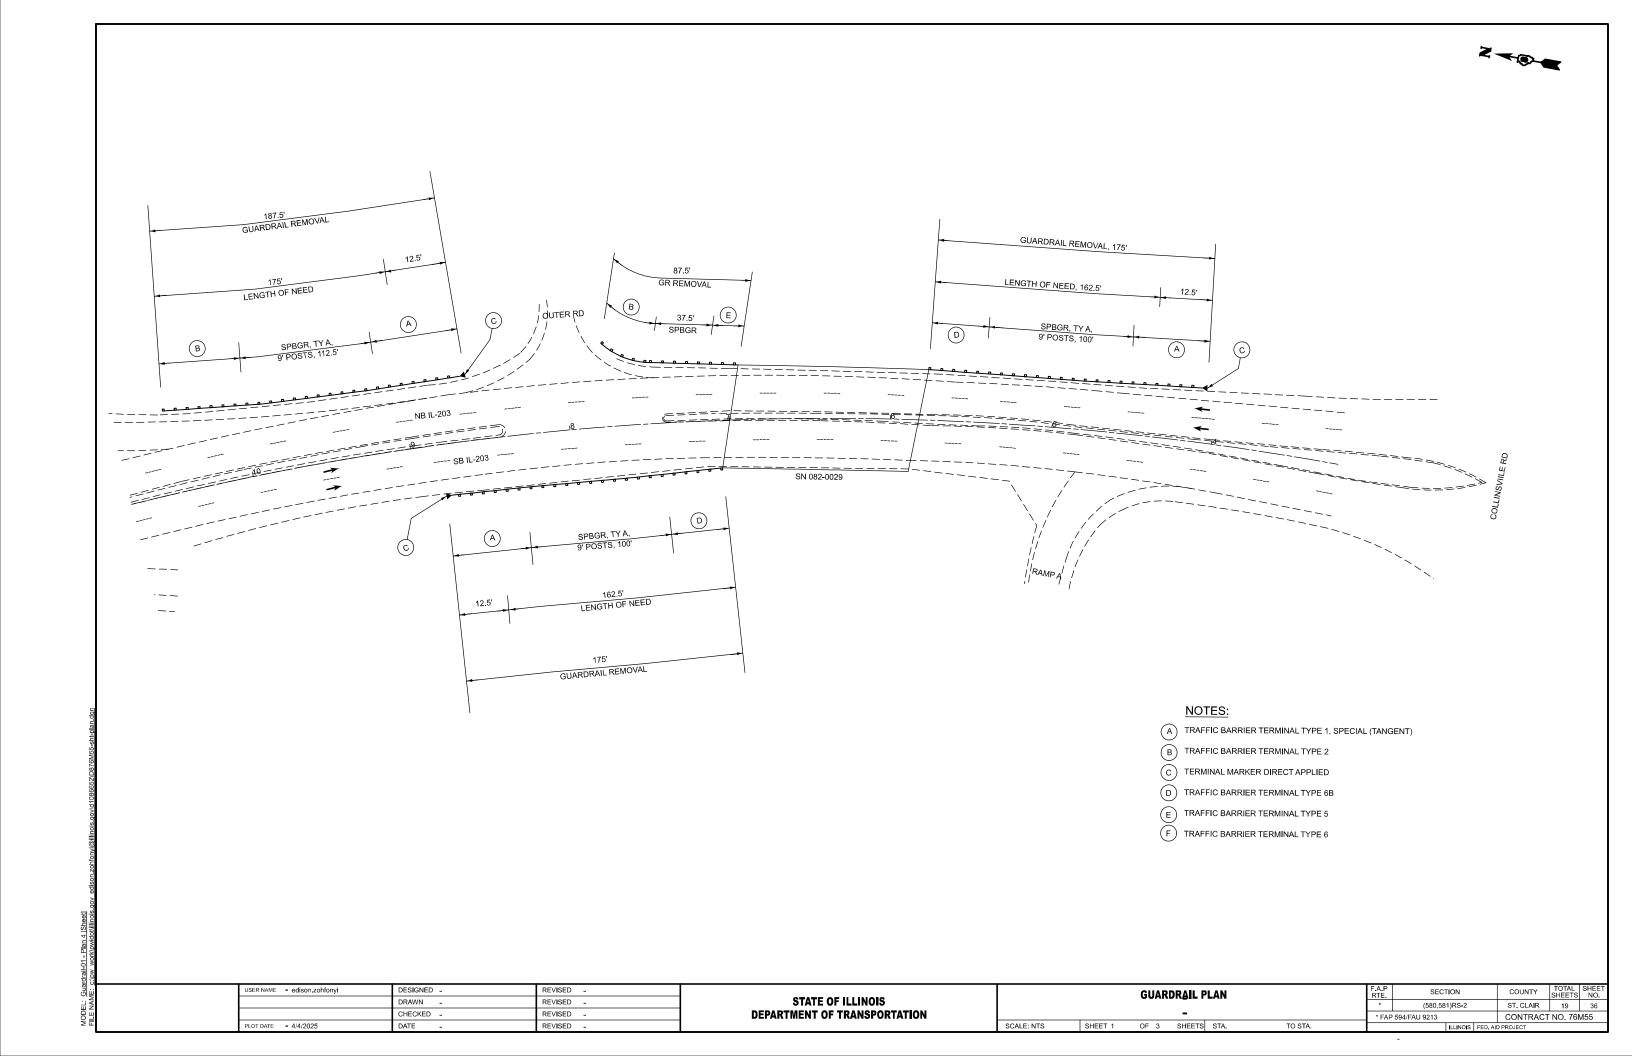


GUARDRAIL REMOVAL 12.5' 187.5' 185' GUARDRAIL REMOVAL LENGTH OF NEED A SPBGR, TY A, 9' POSTS 125' RAMP E SN 082-0028 209' GUARDRAIL REMOVAL GUARDRAIL REMOVAL NOTES: (A) TRAFFIC BARRIER TERMINAL TYPE 1, SPECIAL (TANGENT) B TRAFFIC BARRIER TERMINAL TYPE 2 C TERMINAL MARKER DIRECT APPLIED D TRAFFIC BARRIER TERMINAL TYPE 6B E TRAFFIC BARRIER TERMINAL TYPE 5 F TRAFFIC BARRIER TERMINAL TYPE 6 | COUNTY | TOTAL SHEET | NO. |
| ST. CLAIR | 44 | 37 |
| CONTRACT NO. 76M55 USER NAME = edison.zohfonyi DESIGNED -REVISED -GUARDRAIL PLAN SECTION STATE OF ILLINOIS DEPARTMENT OF TRANSPORTATION DRAWN -REVISED -(580,581)RS-2 CHECKED -REVISED -* FAP 594/FAU 9213 PLOT DATE = 5/8/2025 SHEET 2 OF 3 SHEETS STA. TO STA.

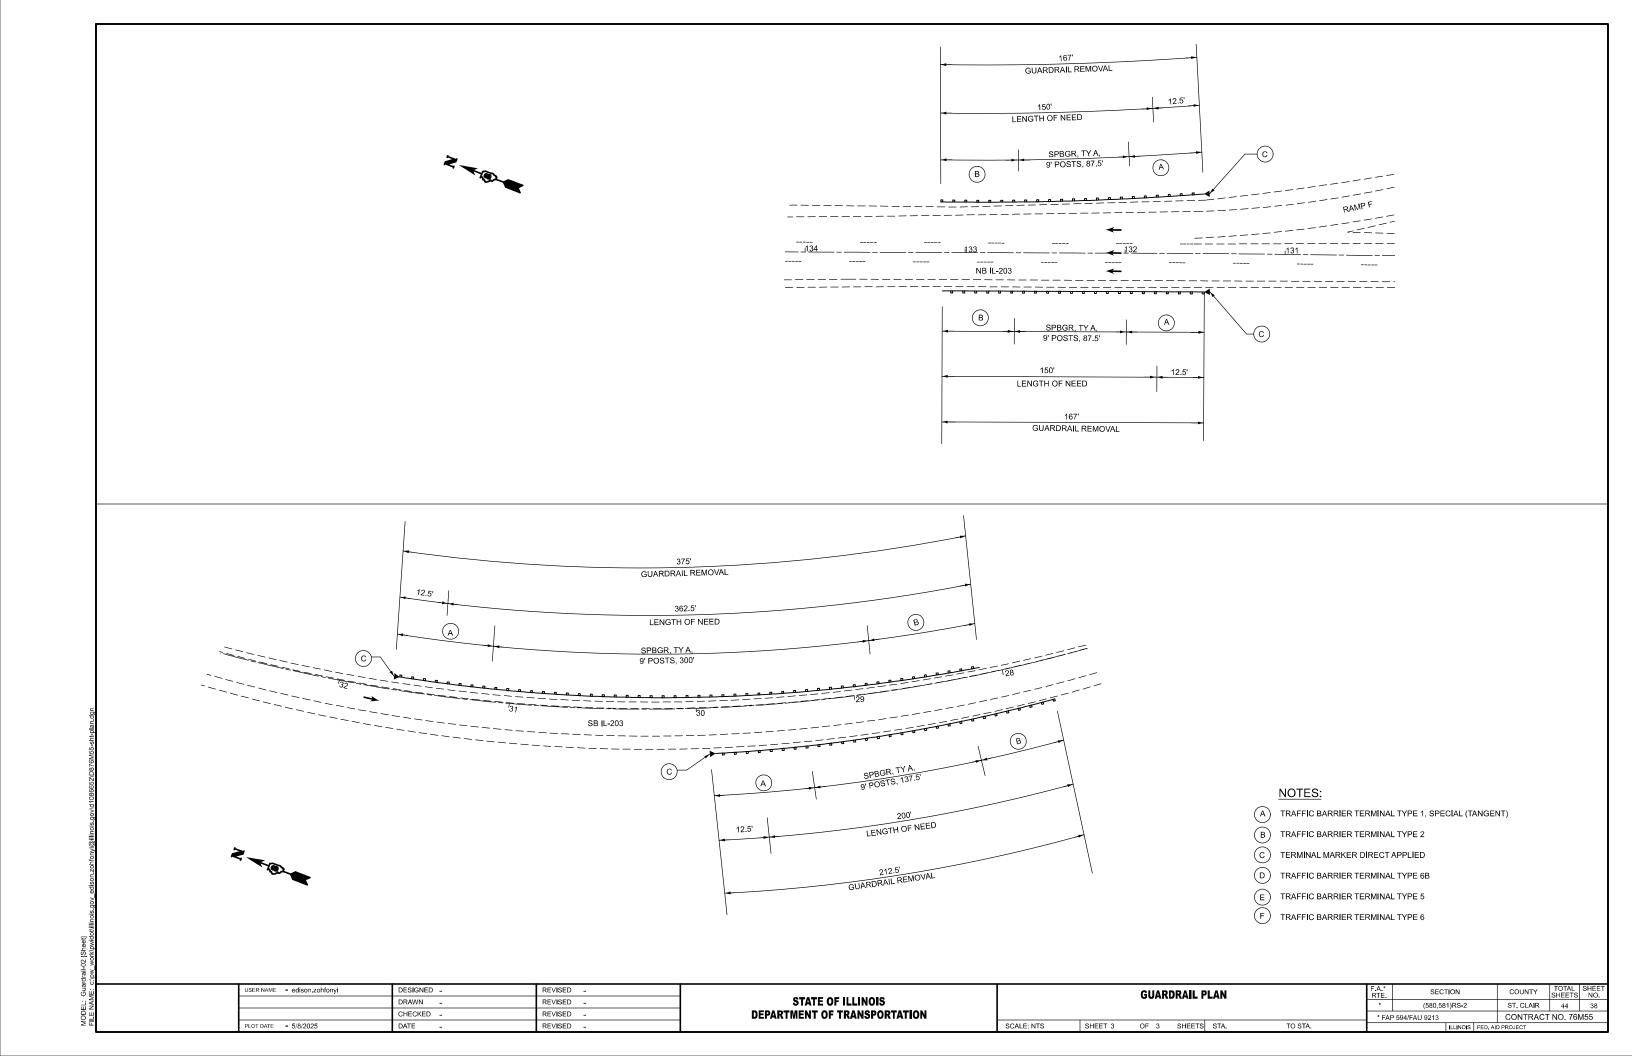

S	CHEDULE OF QUANTITIES	TOTAL OUANTITIES	IL 203 AT	
CODE NO	ITEM	UNIT	90/11111123	OHIO ST.
X8860105	DETECTOR LOOP REPLACEMENT	FOOT	2706	2706

HIGHWAY STANDARDS

886001-01 DETECTOR LOOP INSTALLATIONS 886006-01 TYPICAL LAYOUT FOR DETECTOR LOOPS

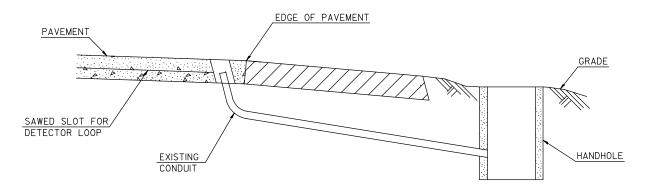

DETAIL (NO SCALE)

RE-USE EXISTING DETECTOR LOOP LEAD-IN CONDUIT

- I DRILL OUT PAVEMENT SEALANT AND CLEAN EXISTING CONDUIT.

 2 REMOVE EXISTING CABLE TO HANDHOLE.


 3 INSTALL LOOP LEAD-IN CONDUCTORS IN CONDUIT.

 4 SPLICE NEW DETECTOR LOOP LEAD-IN CONDUCTORS TO EXISTING LEAD-IN CABLE IN HANDHOLE.

 5 FILL HOLE WITH APPROVED SEALER PREVENT SEALER FROM ENTERING INTO CONDUIT.

NOT A PAY ITEM. THE COST OF THIS WORK SHALL BE INCLUDED IN THE PAY ITEM "DETECTOR LOOP, TYPE I"

USER NAME = edison.zohfonyi	DESIGNED -	REVISED -		DETE	CTOR LOO	P RFPI Δ	CEMENT	ΔΥ STANDARD.	F.A.*	SECTION	COUNTY	TOTAL	SHEET	
	DRAWN -	REVISED -	STATE OF ILLINOIS	DETECTOR LOOP REPLACEMENT, HIGHWAY STANDARD, GENERAL NOTES. SCHEDULE OF QUANTITIES AND DETAIL							(580,581)RS-2	ST. CLAIR	44	39
	CHECKED -	REVISED -	DEPARTMENT OF TRANSPORTATION	GENERAL NOTES, SCHEDOLE OF QUANTITIES AND DETAIL						* FAP 594/FAU 9213		CONTRACT NO. 76M		M55
PLOT DATE = 6/23/2025	DATE -	REVISED -		SCALE: NTS	SHEET 1	OF 3	SHEETS	STA.	TO STA.		ILLINOIS FED. AI	D PROJECT		

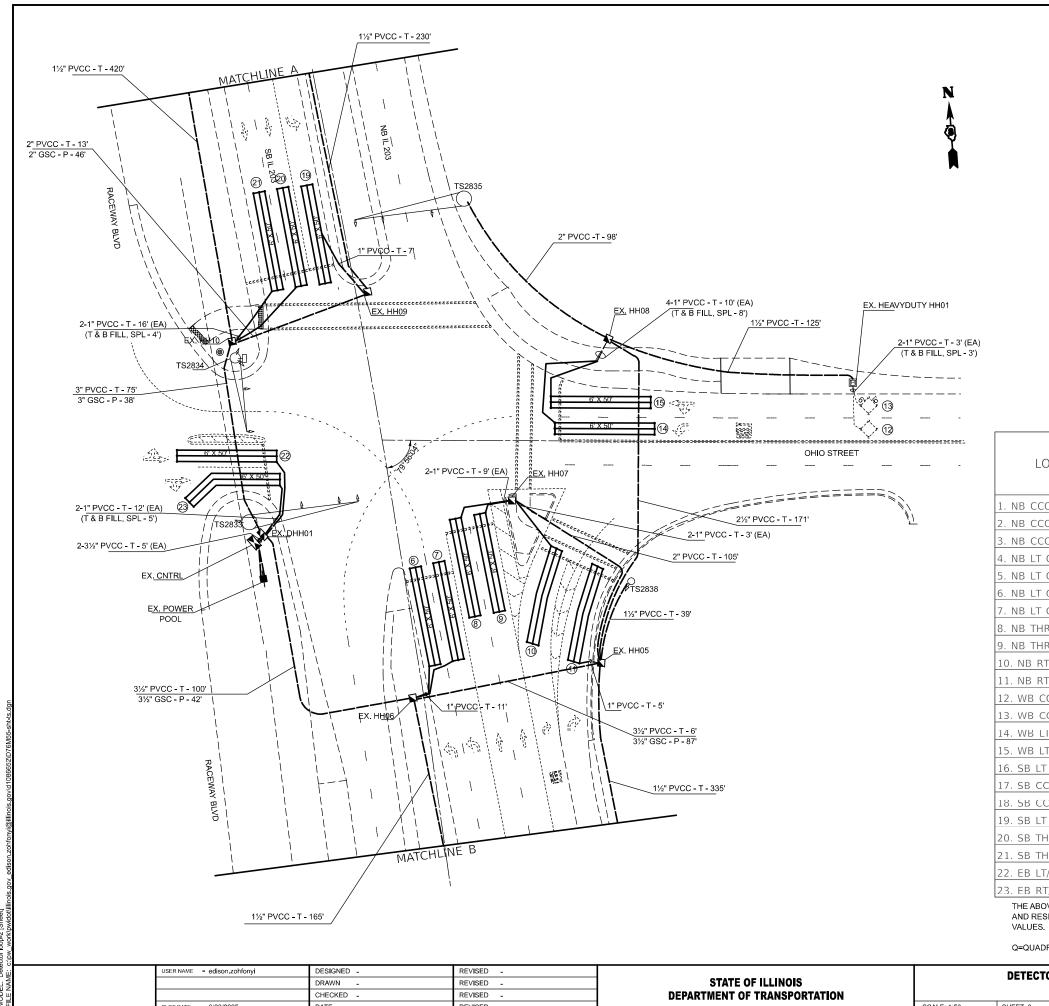



LOOP	PHASE (Ф)	LOOP SIZE (FT. X FT.)	REQUIRED # OF TURNS	CACUI ATFD INDUCTANCE MICROHENRIES (µH)	CAI CUI ATED RESISTANCE OHMS (Ω)
1. NB CCO	2	6' X 6'	7	502.87	3.53
2. NB CCO	2	6' X 6'	7	502.21	3.52
3. NB CCO		6' X 6'	7	499.79	3.46
4. NB LT CCO	5	6' X 6'	6	326.16	1.98
5. NB LT CCO	5	6' X 6'	6	328.58	2.04
6. NB LT CD	5	6' X 50'(Q)	3-6-3	858.82	3.25
7. NB LT CD	5	6' X 50'(Q)	3-6-3	862.34	3.33
8. NB THRU CD	2	6' X 50'(Q)	3-6-3	868.28	3.46
9. NB THRU CD	2	6' X 50'(Q)	3-6-3	866.74	3.43
10. NB RT CD		6' X 50'(Q)	3-6-3	866.74	3.43
11. NB RT CD		6' X 50'(Q)	3-6-3	811.08	2.16
12. WB CCO		6' X 6'	6	308.78	1.59
13. WB CCO		6' X 6'	6	306.14	1.53
14. WB LI CD		6' X 50'(Q)	3-6-3	853.98	3.14
15. WB LT/THRU CD		6' X 50'(Q)	3-6-3	851.12	3.07
16. SB LT CCO	1	6' X 6'	6	309.78	1.59
17. SB CCO	6	6' X 6'	7	491.65	3.28
18. SB CCO	6	6' X 6'	7	488.35	3.2
19. SB LT CD	1	6' X 50'(Q)	3-6-3	840.78	2.84
20. SB THRU CD	6	6' X 50'(Q)	3-6-3	819.66	2.36
21. SB THRU CD	6	6' X 50'(Q)	3-6-3	816.8	2.29
22. EB LT/THRU CD		6' X 50'(Q)	3-6-3	795.9	1.82
23. EB RT/THRU CD		6' X 50'(Q)	3-6-3	792.82	1.75

AND RESISTANCE. ACTUAL MEASURED VALUES SHOULD BE WITHIN +/- 20% OF THESE

Q=QUADRAPOLE

USER NAME = edison.zohfonyi	DESIGNED -	REVISED -			OR LOO	P REPLACEMENT	ΡΙ ΔΝ	F.A.*	SECTION	COUNTY	TOTAL	SHEET	
	DRAWN -	REVISED -	STATE OF ILLINOIS		DEILOI		AT OUIO CT	LAN	*	(580,581)RS-2	ST, CLAIR	44	40
	CHECKED -	REVISED -	DEPARTMENT OF TRANSPORTATION	IL 203 AT OHIO ST.						2 594/FAU 9213	CONTRAC	T NO. 76	M55
PLOT DATE = 6/23/2025	DATE -	REVISED -		SCALE: 1:50	SHEET 2	OF 3	SHEETS STA.	TO STA.		ILLINOIS FED.	AID PROJECT		

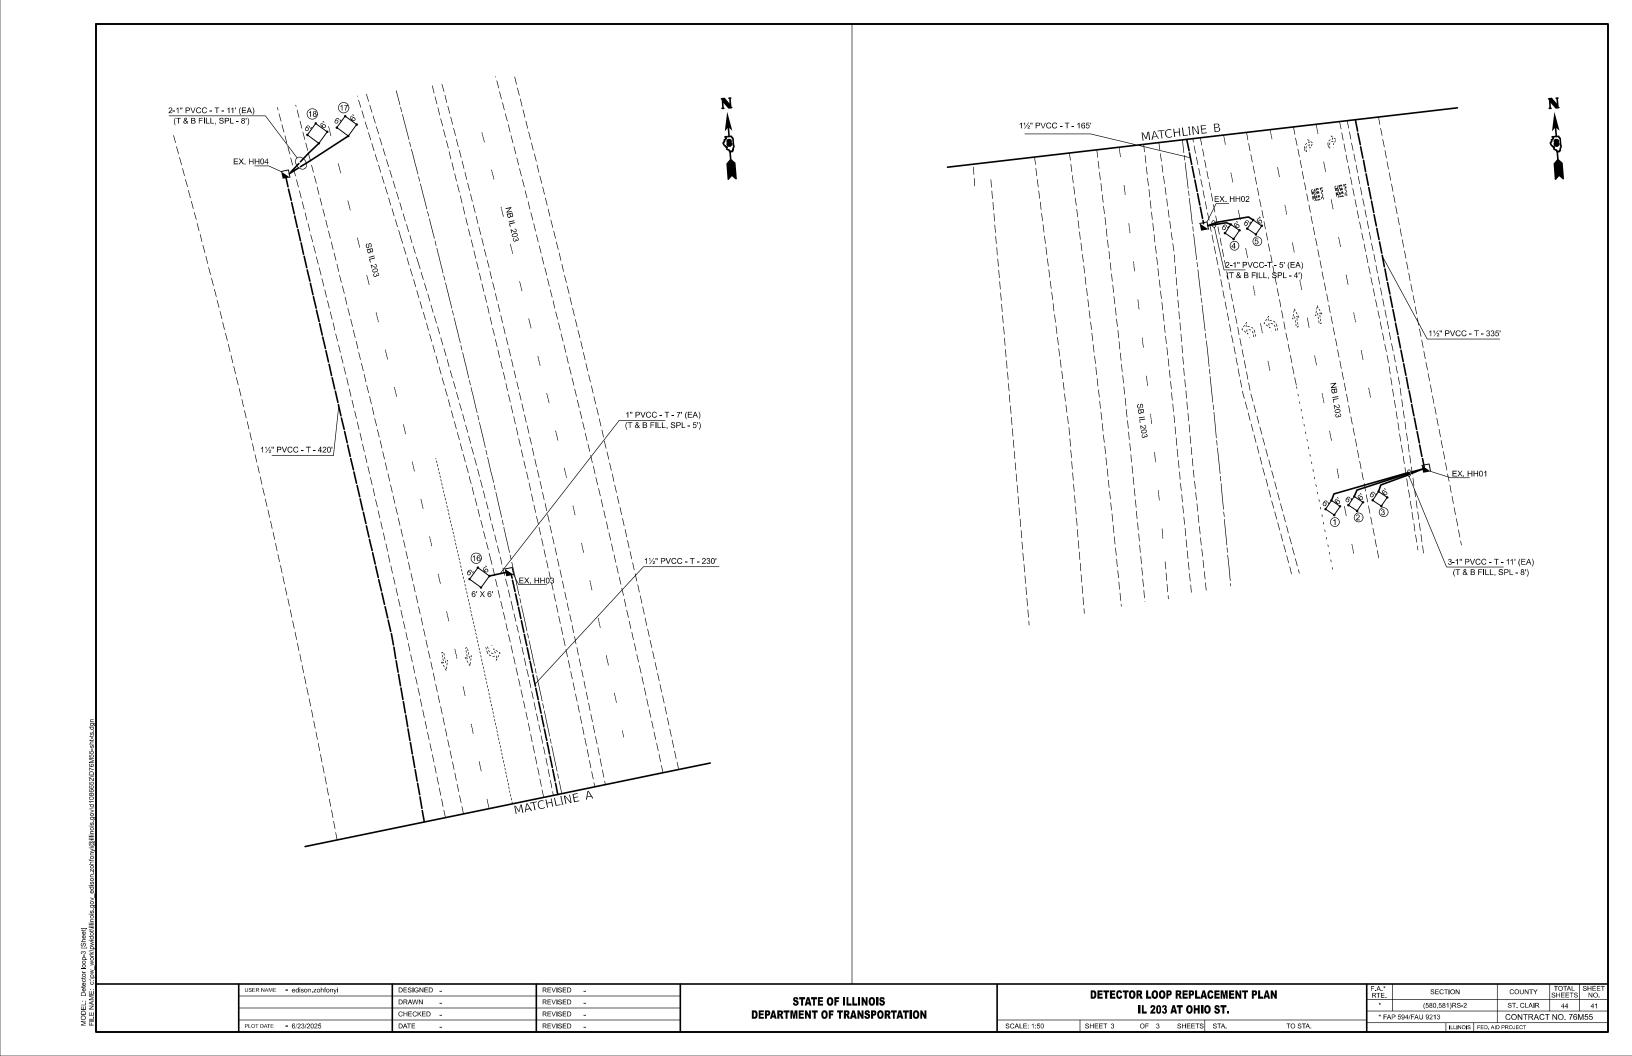

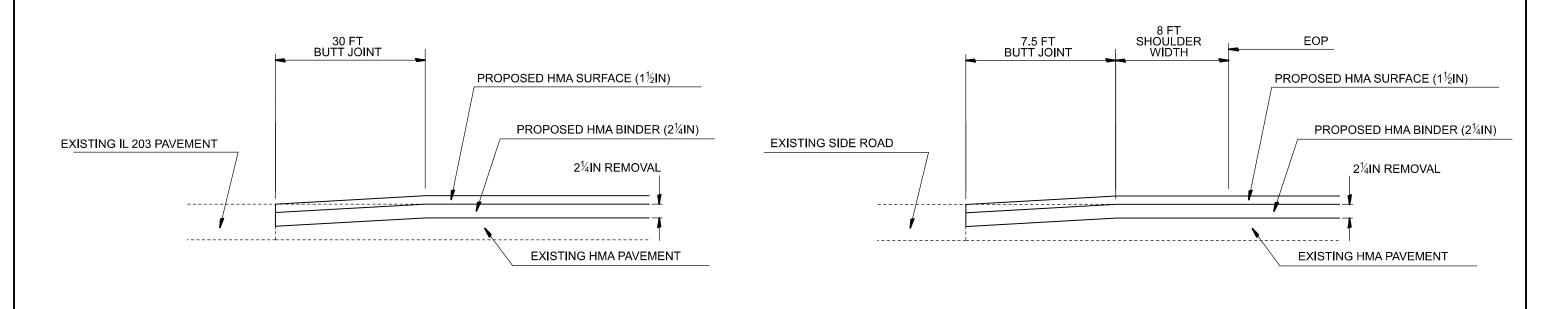


HMA SURFACE REMOVAL-BUTT JOINT AT BEGINNING AND END OF PROJECT

(N.T.S.)

HMA SURFACE REMOVAL-BUTT JOINT AT SIDE ROADS IN EX. HMA SECTION


(N.T.S.)

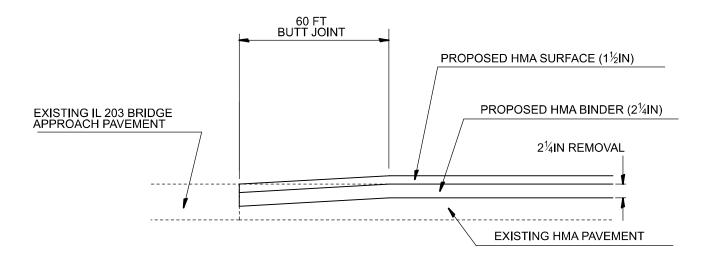

HMA SURFACE REMOVAL-BUTT JOINT AT 082-0028, 080-0029


(N.T.S.)

USER NAME = edison.zohfonyi	DESIGNED -	REVISED -					ETAILS		F.A.*	SECTION	COUNTY	TOTAL SHEET	ſ	
	DRAWN -	REVISED -	STATE OF ILLINOIS								(580,581)RS-2	ST. CLAIR	44 42	-
	CHECKED -	REVISED -	DEPARTMENT OF TRANSPORTATION								* FAP 594/FAU 9213		T NO. 76M55	1
PLOT DATE = 5/8/2025	DATE -	REVISED -		SCALE: NTS	SHEET 1	OF 2	SHEETS	STA.	TO STA.	f	ILLINOIS FED. AI	PROJECT		1

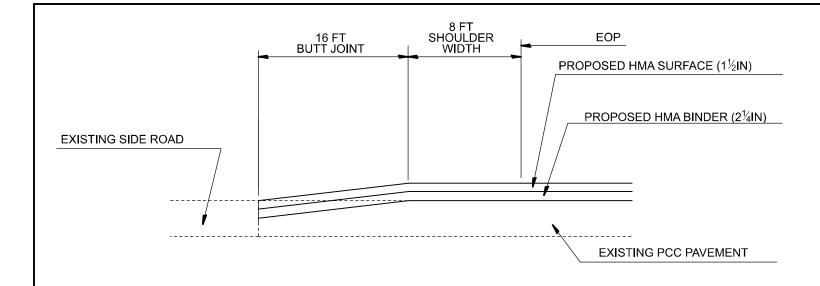

HMA SURFACE REMOVAL-BUTT JOINT AT SIDE ROADS IN EX. CONCRETE SECTION


(N.T.S.)

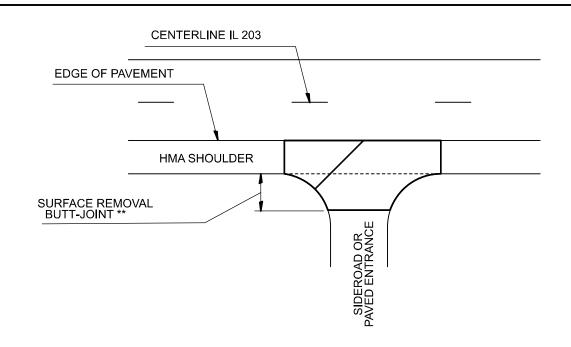

SIDEROAD DETAIL

AREA TO BE PAVED WITH BINDER AND SURFACE COURSE FOR SIDE ROADS

** EXTENDS 16 FT FROM EDGE OF SHOULDER IN EX. CONCRETE SECTION, EXTENDS 7.5 FT FROM EDGE OF SHOULDER IN EX. HMA SECTION

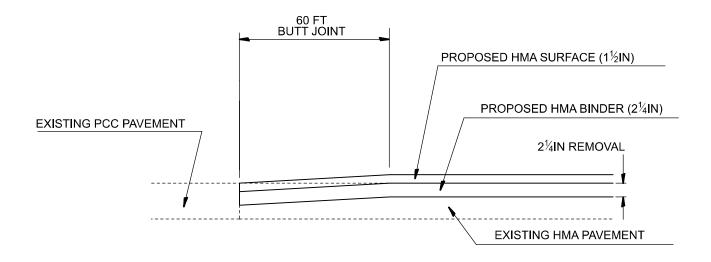

HMA SURFACE REMOVAL-BUTT JOINT AT EXISITING HMA JOINTS TO PCC

(N.T.S.)

USER NAME = edison.zohfonyi	DESIGNED -	REVISED -	
	DRAWN -	REVISED -	
	CHECKED -	REVISED -	
PLOT DATE = 5/8/2025	DATE -	REVISED -	

STATE OF ILLINOIS								
DEPARTMENT OF TRANSPORTATION								

DETAILS							F.A.* RTE.	SECTION		COUNTY	TOTAL SHEETS	SHEET NO.
							*	(580,581)RS-2		ST. CLAIR	44	43
							* FAF	594/FAU 9213		CONTRACT	NO. 76	<i>I</i> 55
CALE: NTS	SHEET 2	OF	2	SHEETS	STA.	TO STA.		ILLINOIS FED. AID PROJECT				

END PROJECT IL 203 AT MADISON COUNTY LINE STA. 168+35.50 PROJECT OMISSION

N.B. IL 203

STA. 145+75.50 TO 157+45.50 PROJECT OMISSION S.B. IL 203 STA. 144+46.00 TO 157+06.00 INTERSECTION OMISS<u>ION</u> S.B. IL 203 STA. 136+54.00 TO 138+30.00 STATION EQUATION N.B. IL203 STA. 142+49.76 BK = STA. 140+00.5 AH INTERSECTION OMISSION N.B. STA. 137+20.00 TO 142+38.00 STATION EQUATION STA. 35+86 N.B. IL 203 = STA. 131+55.00 RAMP H STATION EQUATION STA, 38+10.00 S.B. IL 203 = STA. 129+00.00 RAMP G PC STA. 0+00 RAMP E STA. 16+71.89 © IL 203 CONN. END RESURFACING N.B. RAMP H END RESURFACING AT PAVEMENT JOINT STA. 130+05.00 S.B. RAMP G STA. 124+91.34 RAMP E BRIDGE OMISSION SN 082-0028 STA. 13+35.00 TO 16+74.00 RAMP C PT STA. 12+93.26 RAMP C STA. 17+04.82 © IL 203 STA. 0+00 RAMP D STA. 8+50.00 © IL 203 CONN. PC STA. 0+00 RAMP B STA. 13+50 € IL 203 CONN. ✓ BRIDGE OMISSION SN 082-0029 STA. 5+50.00 TO 7+32.00 STA. 17+29.21 RAMP A / STA. 4+75.81 © IL 203 CONN. BEGIN PROJECT
IL 203 AT COLLINSVILLE RD STA. 2+08.00 COUNTY TOTAL SHEET NO.

ST. CLAIR 44 44 USER NAME = edison.zohfonyi DESIGNED -REVISED -SECTION **LOCATION MAP** STATE OF ILLINOIS DRAWN REVISED -(580,581)RS-2 **DEPARTMENT OF TRANSPORTATION** CHECKED -REVISED -* FAP/FAU 594/9213 CONTRACT NO. 76M55 PLOT DATE = 5/7/2025 SCALE: NTS SHEET 1 OF 1 SHEETS STA. TO STA. DATE REVISED .