08-01-2025 LETTING ITEM 033 INDEX OF SHEETS

GENERAL & JOB SPECIFIC NOTES

SUMMARY OF QUANTITIES

SCHEDULE OF QUANTITIES

STATE OF ILLINOIS

DEPARTMENT OF TRANSPORTATION

PEORIA 27 1 11RS-6:GRS-3:10RS-9 ILLINOIS CONTRACT NO. 68J62

D-94-086-24

HIGHWAY STANDARDS

15-19 PLAN SHEETS

COVER SHEET

LINE DIAGRAM

TYPICAL SECTIONS

20-21 TRAFFIC SIGNAL PLANS 22-27 DISTRICT CADD STANDARDS

2-3

4-7

14

0

0

420001-10	701311-03
606001-08	701501-06
606301-04	701502-09
630001-13	701701-10
631011-10	701901-10
701201-05	780001-05
701301-04	781001-04

PROPOSED HIGHWAY PLANS

FAU ROUTE 6658 / FAP ROUTE 671(IL 8/FARMINGTON RD.) **SECTION 11RS-6;GRS-3;10RS-9 3P RESURFACING PEORIA COUNTY**


C-94-114-24

DISTRICT STANDARDS

PROJECT ENDS STA. 89+18

DESIGN DESIGNATION

IL 8 (FARMINGTON RD.) MINOR ARTERIAL ADT = 12,200 (2023) MU = 0.6% (2023) SU = 2.5% (2023)

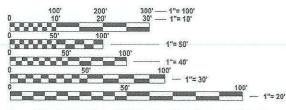

FULL SIZE PLANS HAVE BEEN PREPARED USING STANDARD ENGINEERING SCALES. REDUCED SIZED PLANS WILL NOT CONFORM TO STANDARD SCALES. IN MAKING MEASUREMENTS ON REDUCED PLANS. THE ABOVE SCALES MAY BE USED.

J.U.L.I.E.

JOINT UTILITY LOCATION INFORMATION FOR EXCAVATION 1-800-892-0123 OR 811

CATALOG NO. 036569-00D CONTRACT NO. 68J62

PROJECT ENGINEER: REBECCA MARRUFFO 309-671-3394 PROJECT MANAGER: RAYMOND SAMARA 309-369-7100

GROSS LENGTH = 8889 FT. = 1.680 MILES **NET LENGTH = 8739 FT. = 1.66 MILES**

WEST PEORIA

STA. EQUATION: STA. 104+84 (BK) = STA, 5+15 (AH)

PROJECT DESCRIPTION: RESURFACING ON IL 8 (FARMINGTON RD.) FROM MAIN STREET TO E. OF KICKAPOO CREEK RD, PROJECT INCLUDES GUARDRAIL, PAVEMENT MARKING, AND RESURFACING S.N. 072-0056.

LOCATION OF SECTION INDICATED THUS: - -

PROJECT BEGINS STA. 99+98

> STATE OF ILLINOIS DEPARTMENT OF TRANSPORTATION SUBMITTED May 22 2025 Kenail A Garnett KSD

PRINTED BY THE AUTHORITY OF THE STATE OF ILLINOIS

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GENERAL NOTES

107.00 COMMITMENTS

Commitments are not to be altered without the written approval of all parties to which the commitment was made.

No commitments have been made on this project.

107.09A CONSECUTIVE SIDE STREET (ROAD) CLOSURE - PROHIBITED

- 1. No two consecutive side streets (roads) may be closed at the same time during construction. The Contractor must alternate streets (roads).
- 2. Adjacent sideroads will not be closed simultaneously. BLR Standard 21 shall be used for all local road closures without any entrances within the closed area. BLR Standard 22 can be used where it is necessary to allow local traffic access.

204.00 ENVIRONMENTAL REVIEWS

Prior to the use of any proposed borrow areas, use areas (temporary access roads, detours, run-arounds, etc.) and/or waste areas, the Contractor shall file the required environmental resource request surveys according to Section 107.22 of the Standard Specifications. These surveys are required in order for the Department to conduct cultural and biological resource surveys for the proposed site.

The required environmental resource documentation shall include the following:

- * BDE Form 2289 (Borrow Site Review)
- * BDE Form 2290 (Waste/Use Area Review)
- * A location map showing the size limits and location of the use area
- * Color photographs depicting the use area
- * Borrow Area Entry Agreement form D4 Pl0101

Prior to any waste materials being removed from the construction site the required environmental resource surveys shall be obtained and filed by the Contractor. Excess waste products removed from the construction site shall be disposed of as required in Section 202.03 of the Standard Specifications.

Any protruding metal bars shall be removed prior to the disposal of broken concrete at approved disposal sites.

Please note that a minimum of four weeks shall be allowed for the District to obtain the required waste site environmental clearances and six weeks for the required borrow site environmental clearances.

351.08 AGGREGATE FOR DRIVEWAY REPLACEMENT

The material used for construction of permanent aggregate driveways shall be gravel or crushed stone, as directed by the Engineer, to replace in kind the existing aggregate driveways.

No additional compensation shall be provided for this requirement but shall be considered as included in the cost of the pay item for the aggregate as specified on the plans.

406.01 BRIDGE OVERLAY NOTIFICATION

After placement of the bridge deck overlay, the Resident Engineer shall notify the District Bridge Maintenance Engineer of the "as constructed" milling depth and overlay thickness for updating the Illinois Highway Information System.

06.05 POLYMERIZED BITUMINOUS MATERIALS (TACK COAT) RATES

Surface Type	Residual Rate
Milled (HMA or PCC)	0.08 lb / sq ft
Existing Pavement	0.08 lb / sq ft
Fog Coat (between lifts)	0.08 lb / sq ft

406.18

BUTT JOINT CUTTING TIME RESTRICTION

Butt joints shall not be milled more than three (3) days prior to placement of the HMA surface course.

406.19

PAVING SURFACE COURSE

Continuous paving operations on the main roadway shall be maintained at all times during the construction of the hot-mix asphalt surface. No interruptions for side roads, entrances, turn lanes, etc. will be allowed.

503.00 CROSSING EXISTING STRUCTURES WITH EQUIPMENT

SN 072-0056 may be crossed with the empty MTD with the maximum gross weight restriction of 40 tons. Any structures not listed above shall be verified by the resident prior to beginning work.

606,00 MEDIAN ISLAND NOSES

When constructing median and island noses the following criteria should be followed:

- * Barrier curb shall be used to construct noses when the mdeian or island surrounds a mast arm or other non-breakaway foundation.
- * Ramped noses shall be used on medians or islands with breakaway posts.

701.01 ADDITIONAL SUPPLEMENTAL TRAFFIC CONTROL

The Department reserves the right at any time to add additional Traffic Control Systems or devices within the active contract limits, by means of an additional contract. All terms of Article 105.08 of the Standard Specifications shall be followed by each Contractor.

780.00 NO PASSING ZONE VERIFICATION

The resident shall contact Operations to verify the location of no passing zones prior to placement of centerline striping.

USER NAME = david.green	DESIGNED -	REVISED -
	DRAWN -	REVISED -
	CHECKED -	REVISED -
PLOT DATE = 5/15/2025	DATE -	REVISED -

GENERAL NOTES					F.A.P RTE.	SECTION		COUNTY	TOTAL SHEETS	SHEET NO.
			671	11RS-6;GRS-3;10RS-9		PEORIA	27	2		
						CONTRACT	NO. 68.	J62		
	SHEET 1 OF 2 SHEETS STA. TO STA.				ILLINOIS FE	ED. AID F	PROJECT			

MIX REQUIREMENTS:

The following mixture requireme	ents are applicable for this pro	ject:			
Location(s):	Location(s): Mainline Mainline		Mainline		
Mixture Use(s):	Polymer Surface 1.75"	Polymer Level Binder 1"	Incidental Surface		
AC/PG:	SBS or SBR 70-28	SBS or SBR 70-22	PG 58-28		
Design Air Voids:	4.0% @ N=50	4.0% @ N=50	4.0% @ N=50		
Mixture Composition: (Mixture Gradation)	IL 9.5	IL 4.75	IL 9.5		
Friction Aggregate:	Mix D	N/A	Mix C		
Quality Management Program:	PFP	PFP	QCQA		
MTD:	YES	YES	NO		

Note: 1) Individual lift thickness of each mix type will be no less than 3 times nominal maximum aggregate size and no more than 6 times nominal maximum aggregate size, unless otherwise approved by the Engineer.

For design purposes, mixture weight for all mixes is determined to be 112.0 lb/s.y./in., unless otherwise noted.
 Sublot sizes for PFP and QCP mixes will be 1000 tons, unless otherwise agreed to by the Engineer and the paving contractor.

JOB SPECIFIC NOTES

- 1. Drop offs between traffic lanes during the milling and overlay operations shall be in accordance with article 701.07 of the Standard Specifications.
- Proposed aggregate shoulders are due to low spots in existing aggregate.
- Vertical holes shall be constructed in the proposed island pavement. The holes shall be 24 inches in diameter or 24 inches square and they shall be free of any obstruction, except earth, for a depth of 5 feet as directed by the Engineer. Any holes not used for the placement of signs shall be filled and compacted flush with the top of the island pavement. The top 3 inches of said compacted fill shall consist of a hot-mix asphalt mixture. All holes in which the sign posts are installed at the same time of this contract shall be similarly filled.

This work, including any required pavement removal necessary to construct the sign post holes, will not be paid for separately but shall be included in the contract unit price per Square Foot for ISLAND PAVEMENT REMOVAL AND REPLACEMENT.

4. When flaggers are utilized within the intersections during any construction stage, signals shall be switched to flashing red to minimize confusion to motorists, and the Engineer shall be notified.

STATUS OF UTILITIES:

No utility conflicts have been found within the project limits. Utilities located within the ROW consist of:

COMPANY	CONTACT PERSON	CONTACT INFO		
Ameren Illinois –	Jon Reick	309-258-3901		
Electric		jreick@ameren.com		
Ameren Illinois – Gas	Zach Wilson	309-645-4458		
		zwilson@ameren.com		
ATT – Distribution	Bill Conover	309-550-8043		
		wc2473@att.com		
I3 Broadband		engineering@i3broadband.net		
Illinois American	Charles Barton	309-258-9151		
Water		charles.barton@amwater.com		
Bluebird	Jeremy Carr	309-713-6442		
		jeremy.carr@bluebirdnetwork.com		
Greater Peoria Sanitary		engineering@gpsd.org		
Pleasant Valley Water	Joe Loftus	309-645-0707		
District		pvpwd@comcast.net		
Stratus Network	Tyler Evans	309-417-3291		
		tevens@stratusnet.com		

					CONSTRUCT	CONSTRUCTION CODE				
				PEORIA COUNTY	PEORIA COUNTY	PEORIA COUNTY	PEORIA COUNTY			
					93.3% STATE / 6.7% W. PEORIA		100% STATE			
				FRONTAGE ROAD	0000000 0000 01 00000 - 480 00 Personal 000 00000	TRAFFIC SIGNALS	TRAFFIC SIGNALS			
CODE			TOTAL	0005	0021	0021	0021			
NO.	ITEM	UNIT	QUANTITY	URBAN	URBAN	URBAN	URBAN			
40200100	AGGREGATE SURFACE COURSE, TYPE A	TON	64	64						
40600295	POLYMERIZED BITUMINOUS MATERIALS (TACK COAT)	POUND	68250	68250						
40600405	MATERIAL TRANSFER DEVICE	TON	5362	5362						
10000100	IN THE WALL THE WAS EXPECTED.	10.1		0002						
40600982	HOT-MIX ASPHALT SURFACE REMOVAL - BUTT JOINT	SQ YD	850	850						
40600990	TEMPORARY RAMP	SQ YD	1004	1004						
40603200	POLYMERIZED HOT-MIX ASPHALT BINDER COURSE, IL-4.75, N50	TON	1899	1899						
40604160	POLYMERIZED HOT-MIX ASPHALT SURFACE COURSE, IL-9.5, MIX "D", N50	TON	3464	3464						
		1	,							
40800050	INCIDENTAL HOT-MIX ASPHALT SURFACING	TON	979	979						
44000156	HOT-MIX ASPHALT SURFACE REMOVAL, 1 3/4"	SQ YD	940	940						
44000160	HOT-MIX ASPHALT SURFACE REMOVAL, 2 3/4"	SQ YD	39370	39370						
48101200	AGGREGATE SHOULDERS, TYPE B	TON	128	128						
		gual 20008 1850		to A 1808)						
60260100	INLETS TO BE ADJUSTED	EACH	1	1						
63000001	STEEL PLATE BEAM GUARDRAIL, TYPE A, 6 FOOT POSTS	FOOT	363	363						
02402245	TDAFFIO DADDIED TEDMINAL TYPE O	E 4 6 1 1								
63100045	TRAFFIC BARRIER TERMINAL, TYPE 2	EACH	1	1						

*= SPECIALTY ITEM

USER NAME = david.green	DESIGNED -	REVISED -
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	CHECKED -	REVISED -
PLOT DATE = 5/22/2025	DATE -	REVISED -

STATE OF ILLINOIS DEPARTMENT OF TRANSPORTATION

SUMMARY OF QUANTITIES					F.A.P RTE.	SECTION	COUNTY	TOTAL SHEETS	SHEET NO.
				671	11RS-6;GRS-3;10RS-9	PEORIA	27	4	
						CONTRAC	T NO. 68.	J62	
SHEET 1 OF 4 SHEETS STA. TO STA.					ILLINOIS FED.	ID PROJECT			

				CONSTRUCTION CODE					
				PEORIA COUNTY	PEORIA COUNTY	PEORIA COUNTY	PEORIA COUNTY		
				100% STATE	93.3% STATE / 6.7% W. PEORIA		100% STATE		
				FRONTAGE ROAD	TRAFFIC SIGNALS	TRAFFIC SIGNALS	TRAFFIC SIGNALS		
CODE			TOTAL	0005	0021	0021	0021		
NO.	ITEM	UNIT	QUANTITY	URBAN	URBAN	URBAN	URBAN		
63100167	TRAFFIC BARRIER TERMINAL, TYPE 1 (SPECIAL) TANGENT	EACH	1	1					
00100101		2,1011	'	·					
63200310	GUARDRAIL REMOVAL	FOOT	439	439					
67100100	MOBILIZATION	L SUM	1	1					
70100450	TRAFFIC CONTROL AND PROTECTION, STANDARD 701201	L SUM	1	1					
70102620	TRAFFIC CONTROL AND PROTECTION, STANDARD 701501	L SUM	1	1					
70102622	TRAFFIC CONTROL AND PROTECTION, STANDARD 701502	L SUM	1	1					
70102635	TRAFFIC CONTROL AND PROTECTION, STANDARD 701701	L SUM	1	1					
70107025	CHANGEABLE MESSAGE SIGN	CAL DA	100	100					
70300100	SHORT TERM PAVEMENT MARKING	FOOT	4706	4706					
70200450	OLIODI TEDM DAVEMENT MADIZINO DEMOVAL	00.57	040	040					
70300150	SHORT TERM PAVEMENT MARKING REMOVAL	SQ FT	618	618					
72501000	TERMINAL MARKER - DIRECT APPLIED	EACH	1	1					
78009000	MODIFIED URETHANE PAVEMENT MARKING - LETTERS AND SYMBOLS	SQ FT	762	762		_			
78009004	MODIFIED URETHANE PAVEMENT MARKING - LINE 4"	FOOT	22897	22897					
78009006	MODIFIED URETHANE PAVEMENT MARKING - LINE 6"	FOOT	17420	17420					
70009000	INIODII ILD ONE II MINE PAVEINIENT INIAMNING - LINE 0	1 1001	11420	17420		_			

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PLOT DATE = 5/22/2025	DATE -	REVISED -

STATE OF ILLINOIS
DEPARTMENT OF TRANSPORTATION

SUMMARY OF QUANTITIES					F.A.P RTE.	SECTION	COUNTY	TOTAL SHEETS	SHEET NO.
				671	11RS-6;GRS-3;10RS-9	PEORIA	27	5	
							CONTRACT	NO. 68	162
SHEET 2	OF 4	SHEETS	STA.	TO STA.		ILLINOIS FED. AI	D PROJECT		

						CONSTRUCT				
					PEORIA COUNTY	PEORIA COUNTY	PEORIA COUNTY	PEORIA COUNTY		
_					P 40000 Make the 2004 Make the 24	93.3% STATE / 6.7% W. PEORIA	The supposition which the topological and the supposition of the suppo	100% STATE		
					FRONTAGE ROAD	TRAFFIC SIGNALS	TRAFFIC SIGNALS	TRAFFIC SIGNALS		
	CODE			TOTAL	0005	0021	0021	0021		
-	NO.	ITEM	UNIT	QUANTITY	URBAN	URBAN	URBAN	URBAN		
*	78009008	MODIFIED URETHANE PAVEMENT MARKING - LINE 8"	FOOT	2226	2226					
Ė	7000000	MODIFIED ONE TRANSPORTED TO MANAGEMENT OF LINE OF	1001	2220	2220					
*	78009012	MODIFIED URETHANE PAVEMENT MARKING - LINE 12"	FOOT	1204	1204					
-	70000012	MODIFIED ONE TRANSPORT IN MARKET TO THE 12	1001	1204	1204					
*	78009024	MODIFIED URETHANE PAVEMENT MARKING - LINE 24"	FOOT	561	561					
-	70000021	most les orient de l'Avenient in didito en e e	1001							
*	78011000	GROOVING FOR RECESSED PAVEMENT MARKING, LETTERS AND SYMBOLS	SQ FT	762	762					
ŀ										
*	78011025	GROOVING FOR RECESSED PAVEMENT MARKING 5"	FOOT	22897	22897					
-										
*	78011035	GROOVING FOR RECESSED PAVEMENT MARKING 7"	FOOT	17420	17420					
-										
*	78011045	GROOVING FOR RECESSED PAVEMENT MARKING 9"	FOOT	2226	2226					
-										
*	78011065	GROOVING FOR RECESSED PAVEMENT MARKING 13"	FOOT	1204	1204					
-										
*	78011125	GROOVING FOR RECESSED PAVEMENT MARKING 25"	FOOT	561	561					
ŀ										
*	78100100	RAISED REFLECTIVE PAVEMENT MARKER	EACH	360	360					
ŀ										
	78300200	RAISED REFLECTIVE PAVEMENT MARKER REMOVAL	EACH	374	374					
f										
-				<u> </u>						
-	78300202	PAVEMENT MARKING REMOVAL - WATER BLASTING	SQ FT	444	444					
f										
-				ļ						
	X4400196	HOT-MIX ASPHALT SURFACE REMOVAL (SPECIAL)	SQ YD	993	993					
ļ				1						
-										
	X4402815	ISLAND PAVEMENT REMOVAL AND REPLACEMENT	SQ FT	60	60					
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USER NAME = david.green	DESIGNED -	REVISED -			SUMMARY OF QUANTITIES		F.A.P	SECTION	COUNTY	TOTAL SHEET
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	CHECKED -	REVISED -	DEPARTMENT OF TRANSPORTATION							T NO. 68J62
PLOT DATE = 5/22/2025	DATE	PEVISED		SCALE:	SHEET 3 OF A SHEETS STA	TO STA		TURIOR FED AV	DDO IFOT	

					CONSTRUCT	TION CODE	
				PEORIA COUNTY	PEORIA COUNTY	PEORIA COUNTY	PEORIA COUNTY
				100% STATE	93.3% STATE / 6.7% W. PEORIA	93.3% STATE / 6.7% PEORIA	100% STATE
				FRONTAGE ROAD	TRAFFIC SIGNALS	TRAFFIC SIGNALS	TRAFFIC SIGNALS
CODE			TOTAL	0005	0021	0021	0021
NO.	ITEM	UNIT	QUANTITY	URBAN	URBAN	URBAN	URBAN
X6350204	LINEAR DELINEATOR PANELS, 4 INCH	EACH	5	5			
X8891011	VIDEO VEHICLE DETECTION SYSTEM, 3 CAMERA	EACH	3		1	1	1
XZ013798	CONSTRUCTION STATION LAYOUT	L SUM	1	1			
Z0001002	GUARDRAIL AGGREGATE EROSION CONTROL	TON	60	60			
Z0076604	TRAINEES - TRAINING PROGRAM GRADUATE	HOUR	1,000	1,000			
Z0004556	HOT-MIX ASPHALT SURFACE REMOVAL (DECK)	SQ YD	447	447			

Ø 0042 *= SPECIALTY ITEM

MODEL: SOQ [Sheet] - 4
FILE NAME: c:\pw_work\pwidot\greendm

USER NAME = david.green	DESIGNED -	REVISED -	
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PLOT DATE = 5/22/2025	DATE -	REVISED -	

STATE OF ILLINOIS DEPARTMENT OF TRANSPORTATION

;	SUMN	IARY	OF QUA	ANTITIES		F.A.P RTE.	SECTION	COUNTY	TOTAL SHEETS	SHEET NO.
						671	11RS-6;GRS-3;10RS-9	PEORIA	27	7
								CONTRACT	NO. 68	J62
SHEET 4	0	- 4	SHEETS	STA.	TO STA.		ILLINOIS FED. AII	D PROJECT		

								,	Р	AVEMENT S	CHEDULE								
	LOCA	TION		LENGTH	WIDTH	AREA	HMA SURFACE REMOVAL - BUTT JOINT	TEMPORARY RAMP	POLY. HMA COURSE, I "D",	L-9.5, MIX N50	COURSE, IL- 4.75, N50		HMA SURFACE REMOVAL (SPECIAL)	HMA SURFACE REMOVAL, 2 3/4"	HMA SURFACE REMOVAL, 1 3/4"	HMA SURFACE REMOVAL (DECK)	MATERIAL TRANSFER DEVICE	INCIDENTAL HMA SURFACING	
				FOOT	FOOT	00.1/0	00.1/0	00 VD	1.75"	JT	1.0"	0.08 LB/SQ FT	JT	JT	00.1/0	00 1/0	1.75"	TON	
11.8 / \	V. FARMINGT	ON RD		FOOT	FOOT	SQ YD	SQ. YD.	SQ. YD.	TON	TON	TON	POUND	POUND	SQ. YD.	SQ. YD.	SQ. YD.	SQ. YD.	TON	TON
STA.	99+98.0	TO	101+23.0	125.0	Varies	1132.2	130.7	152.8	111.0	1.4	63.4	1630.3	19.2	13.9	1132.2			175.7	
STA.	101+23.0	то	102+75.0	152.0	55.0	928.9	100.1	102.0	91.0	1.7	52.0	1337.6	23.3	16.9	928.9			144.7	
STA.	102+75.0	то	103+93.0	118.0	Var. 55 to 41.5	993.2	_		97.3	1.3	55.6	1430.2	18.1	13.1	993.2			154.2	
STA.	103+93.0	то	104+84.0	91.0	41.5	419.6			41.1	1.0	23.5	604.2	13.9	10.1	419.6			65.6	
ST	A. EQ: 104+84	(BK) =	5+15 (AH)																
STA.	05+15.0	ТО	19+88.0	1473.0	41.5	6792.2			665.6	16.0	380.4	9780.7	225.8	163.7	6792.2			1062.0	
STA.	19+88.0	то	22+56.0	268.0	Var. 41.5 to 24	975.2			95.6	2.9	54.6	1404.3	41.1	29.8	975.2			153.1	
STA.	22+56.0	то	31+09.0	853.0	24.0	2274.7			222.9	4.6	127.4	3275.5	65.4	47.4	2274.7			354.9	
STA.	31+09.0	TO	31+39.0	30.0	24.0	80.0	_		7.8	0.2	4.5	115.2	2.3	1.7	80.0		447.0	12.5	
STA.	31+39.0	TO	32+61.0	122.0	33.0	447.3	_		43.8	0.7	4.5	322.1	14.0	6.8	00.0		447.3	44.5	
STA.	32+61.0	TO	32+91.0	30.0	24.0	80.0 53.3	_		7.8	0.2	4.5	57.6	2.3	1.7	80.0			12.5	
STA.	32+91.0 33+11.0	ТО	33+11.0 34+10.0	20.0 99.0	24.0 Var. 24 to 40	352.0			5.2 34.5	0.1 1.6	3.0 19.7	76.8 506.9	1.5 22.8	1.1 16.5	53.3 352.0			8.3 55.8	
STA.	34+10.0	ТО	35+71.0	161.0	Var. 40 to 52	822.9			80.6	3.5	46.1	1185.0	49.4	35.8	822.9			130.2	
STA.	35+71.0	ТО	38+88.0	317.0	52.0	1831.6			179.5	6.9	102.6	2637.4	97.2	70.4	1831.6			289.0	
STA.	38+88.0	ТО	43+05.0	417.0	38.0	1760.7			173.5	9.1	98.6	2535.4	127.8	92.7	1760.7			280.2	
STA.	43+05.0	ТО	45+34.0	229.0	Var. 38 to 34	916.0			89.8	5.0	51.3	1319.0	70.2	50.9	916.0			146.1	
STA.	45+34.0	то	48+37.0	303.0	34.0	1144.7			112.2	3.3	64.1	1648.3	46.4	33.7	1144.7			179.6	
STA.	48+37.0	то	50+26.0	189.0	48.0	1008.0			98.8	3.1	56.4	1451.5	43.5	31.5	1008.0			158.3	
STA.	50+26.0	то	61+83.0	1157.0	34.0	4370.9			428.3	15.7	244.8	6294.1	221.7	160.7	4370.9			688.9	
STA.	61+83.0	то	63+59.0	176.0	Var. 34 to 38	704.0	_		69.0	1.9	39.4	1013.8	27.0	19.6	704.0			110.3	
STA.	63+59.0	то	66+95.0	336.0	38.0	1418.7			139.0	3.7	79.4	2042.9	51.5	37.3	1418.7			222.1	
STA.	66+95.0	то	71+01.0	406.0	Var. 38 to 24	1398.4	_		137.0	4.4	78.3	2013.8	62.2	45.1	1398.4			219.8	
STA.	71+01.0	то	81+40.0	1039.0	24.0	2770.7			271.5	5.7	155.2	3989.8	79.6	57.7	2770.7			432.3	
STA.	81+40.0		81+50.0	10.0	24.0	26.7	26.7	48.9	2.6	0.1	1.5	38.4	0.8	0.6	26.7			4.2	
867 6750 880	RR OM	ISSION	1	5 558 8	8 8 2 8 2 8	K-1500046	\$1.500 MHZ												
STA.	83+00.0	то	83+10.0	10.0	24.0	26.7	26.7	48.9	2.6	0.1	1.5	38.4	0.8	0.6	26.7			4.2	
STA.	83+10.0	то	89+08.0	598.0	24.0	1594.7	St. Committee		156.3	3.3	89.3	2296.3	45.8	33.2	1594.7			248.8	
STA.	89+08.0	то	89+18.0	10.0	24.0	26.7	26.7	48.9	2.6	0.1	1.5	38.4	0.8	0.6	26.7			4.2	
		1		TOTAL			210.7	299.4	3366.3	97.3	1898.5	49083.8	1374.3	992.8	33902.3		447.3	5362.1	
				D SUBTOTAL	-		639.3	704.8				5578.8			2907.4	327.4			556
				R SUBTOTAL	1							3390.6			2560.6	26 1442			362.6
				E SUBTOTAL								8822.4				612.7			60
			GRAN	D TOTAL			850.0	1004.0	346	4.0	1899.0	6825	0.0	993.0	39370.0	940.0	447.0	5362.0	979.0
* SN	072-0056: 1.7	'5" SU	RFACE																
JT =	JOINT TRIMN	IING																	

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USER NAME = david.green	DESIGNED -	REVISED -
	DRAWN -	REVISED -
	CHECKED -	REVISED -
PLOT DATE = 5/22/2025	DATE -	REVISED -

STATE OF ILLINOIS DEPARTMENT OF TRANSPORTATION

SCALE:

sc	HEDULE	OF QUANTITIES		F.A.P RTE.	SECTION
				671	11RS-6;GRS-
SHEET 1	OF 5	SHEETS STA.	TO STA.		l I

SIDEROAD PAVEMENT SCHEDULE													
LOCATION	AREA	HMA SURFACE REMOVAL - BUTT JOINT	HMA SURFACE REMOVAL, 2 3/4"	HMA SURFACE REMOVAL, 1 3/4"	TEMPORARY RAMP	POLY. BIT. MATERIALS (TACK COAT)	INCIDENTAL HMA SURFACING	ISLAND PAVEMENT REMOVAL AND REPLACEMENT					
						0.08 LB/SQ FT							
	SQ. FT.	SQ. YD.	SQ. YD.	SQ. YD.	SQ. YD.	POUND	TON	SQ. FT.					
SIDEROADS													
ALLEY	338.1	18.2		19.4	30.6	54.1	3.7						
N. PARK ROAD	4437.7	38.6	454.5		69.3	710.0	75.9	60.0					
N. RHODORA AVE.	1405.3	43.1		113.1	61.1	224.8	15.3						
N. STEVER AVE.	975.0	37.5		70.8	50.9	156.0	10.6						
N. STERLING AVE.	8393.6	83.9	848.8		132.4	1343.0	143.6						
N. PIERSON AVE.	2443.6	35.9	235.6		48.9	391.0	41.8						
W. SOUTHPORT RD (IL 8)	5183.9	54.0	522.0		91.7	829.4	88.7						
N. SWORDS AVE.	7884.1	29.5	846.5		48.9	1261.5	134.9						
N. STELLA CT.	742.2	26.6		55.9	40.7	118.8	8.1						
N. HAVEN CT.	167.2	7.8		10.8	40.7	26.8	1.8						
N. ABEL CT.	786.7	30.0		57.4	40.7	125.9	8.6						
N. RABER RD.	2110.0	234.4			48.9	337.6	23.0						
SUBTOTAL		639.3	2907.4	327.4	704.8	5578.8	556.0	60.0					
GRAND TOTAL		SEE PAVEMENT SCHEDULE											

	SHOULDER SCHEDULE													
	LOCA	TION		LENGTH	WIDTH	AGGREGATE SHOULDERS, TYPE B 1 INCH	HMA SURFACE REMOVAL, 2 3/4"	INCIDENTAL HMA SURFACING 2 3/4 INCH	POLY. BIT. MATERIALS (TACK COAT) 0.08 LB/SQ FT					
				FOOT	FOOT	TON	SQ. YD.	TON	POUND					
RT. IL	8/W. FARMIN	GTO	N RD		, , , ,		54, 12,		7 5 5 1.12					
STA.	19+88.0	ТО	24+59.0	471.0	10.0		523.3	80.6	753.6					
STA.	24+59.0	ТО	31+09.0	650.0	3.0	12.3								
STA.	32+91.0	TO	33+11.0	20.0	3.0	0.4								
STA.	40+94.0	ТО	43+05.0	211.0	6.0		140.7	21.7	202.6					
STA.	43+05.0	TO	45+34.0	229.0	3.0	4.3								
STA.	51+76.0	ТО	55+49.0	373.0	8.0		331.6	51.1	477.4					
STA.	55+49.0	TO	81+50.0	2601.0	3.0	49.4								
	RR OMI	VISIO	N											
STA.	83+00.0	TO	89+18.0	618.0	3.0	11.7								
LT. IL	8/W. FARMIN	GTON	I RD											
STA.	25+65.0	TO	31+09.0	544.0	3.0	10.3								
STA.	32+91.0	TO	33+11.0	20.0	3.0	0.4								
STA.	33+11.0	TO	46+70.0	1359.0	9.0		1359.0	209.3	1957.0					
STA.	66+95.0	TO	81+50.0	1455.0	3.0	27.6								
	RR OM	SSIO	N											
STA.	83+00.0	ТО	89+18.0	618.0	3.0	11.7	206.0							
			SUBTOTAL			128.2	2560.6	362.6	3390.6					
		G	RAND TOTAL	_		128	SEE	PAVEMENT SCI	HEDULE					

MODEL: Schedule [Sheet] - 2 FILE NAME: c:\pw_work\pwidot\greendm\d109974

 USER NAME
 = david.green
 DESIGNED
 REVISED

 DRAWN
 REVISED

 CHECKED
 REVISED

 PLOT DATE
 = 5/22/2025
 DATE
 REVISED

STATE OF ILLINOIS DEPARTMENT OF TRANSPORTATION

SCALE:

			ENTRANCE S	SCHEDULE		
ENTRANCE NO.	TYPE	AREA	AGGREGATE SURFACE COURSE, TYPE A	POLY. BIT. MATERIALS (TACK COAT)	INCIDENTAL HMA SURFACING	HMA SURFACE REMOVAL, 1 3/4"
		SQ. FT.	TON	POUND	TON	SQ. YD.
RT. IL 8/W. FARMINGTON RE	0					
1	PE	539.0		862.4	5.9	59.9
3	PE	250.0		400.0	2.7	27.8
4	FE	215.0	2.4			
5	PE	290.0		464.0	3.2	32.2
6	PE	150.0		240.0	1.6	16.7
7	PE	300.0		480.0	3.3	33.3
8	PE	830.0	9.5			
10	PE	320.0		512.0	3.5	35.6
11	PE	120.0	1.4			
13	PE	132.0	1.5			
18	PE	315.0	3.6			
21	PE	275.0	3.1			
23	CE	250.0		400.0	2.7	27.8
24	CE	260.0		416.0	2.8	28.9
31	CE	200.0		320.0	2.2	22.2
33	CE	385.0		616.0	4.2	42.8
LT. IL 8/W. FARMINGTON RE	D.					
2	CE	90.0	1.0			
9	CE	455.0		728.0	5.0	50.6
12	PE	295.0	3.4			
14	PE	203.0	2.3			
15	PE	100.0		160.0	1.1	11.1
16	PE	100.0	1.1	160.0	1.1	11.1
17	PE	180.0	2.1			
19	PE	215.0		344.0	2.3	23.9
20	PE	250.0	2.8			
22	PE	135.0		216.0	1.5	15.0
25	CE	200.0	2.3			
26	CE	320.0		512.0	3.5	35.6
27	CE	950.0	10.8			
28	CE	515.0		824.0	5.6	57.2
29	CE	450.0	5.1			
30	CE	1050.0	12.0			
32	CE	730.0		1168.0	7.9	81.1
SUBTOTAL		64.4	8822.4	60.0	612.7	
GRAND TOTAL			64.0		SEE PAVEMENT SCHEDUL	E

MODEL: Schedule [Sheet] - 3
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STATE OF ILLINOIS DEPARTMENT OF TRANSPORTATION

SCALE:

	PAVEMENT MARKING TABLE																	
LOCATION	PAVEMENT	URETHANE MARKING - ENTERLINE)	GROOVING FOR RECESSED PAVEMENT MARKING 5"	MODIFIED URETHANE PAVEMENT MARKING - LINE 6" (EDGE LINES/ CROSSWALKS)	GROOVING FOR RECESSED PAVEMENT MARKING 7"		HANE MENT	GROOVING FOR RECESSED PAVEMENT MARKING 9"	MOD URET PAVE MARKING	HANE MENT	GROOVING FOR RECESSED PAVEMENT MARKING 13"	*MODIFIED URETHANE PAVEMENT MARKING - LINE 24"	GROOVING FOR RECESSED PAVEMENT MARKING 25"	MODIFIED URETHANE PAVEMENT MARKING - LETTERS AND SYMBOLS	GROOVING FOR RECESSED PAVEMENT MARKINGS, LETTERS AND SYMBOLS	RAISED REFLECTIVE PAVEMENT MARKER	RAISED REFLECTIVE PAVEMENT MARKER REMOVAL	*PAVEMENT MARKING REMOVAL - WATER BLASTING
	YELLOW	YELLOW		WHITE]	WH	IITE]	WHITE	YELLOW]	WHITE]					
	SOLID	CL SKIP		SOLID		SOLID	DOTTED		SOLID	SOLID		SOLID		WHITE	WHITE			
	FOOT	FOOT	FOOT	FOOT	FOOT	FOOT	FOOT	FOOT	FOOT	FOOT	FOOT	FOOT	FOOT	SQ. FT.	SQ. FT.	EACH	EACH	SQ. FT.
IL 8/W. Farmington Rd.	404.0		404.0	201.0	201.0	100.0		400.0	100.5	25.0	107.5	251.2	2512					444
STA. 99+98.0 TO 101+23.0	424.0		424.0	694.0	694.0	422.0		422.0	102.5	25.0	127.5	351.0	351.0		0.0	6 18	6	444
STA. 101+23.0 TO 104+84.0	1444.0		1444.0	722.0	722.0					228.0	228.0		2			18	18	
STA. EQ: 104+84 (BK) = 5+15 (AH) STA. 05+15.0 TO 10+34.0	2076.0		2076.0	1038.0	1038.0					260.0	260.0					26	26	
STA. 09+15.0 TO 10+34.0 STA. 10+34.0 TO 15+84.0	2200.0		2200.0	1100.0	1100.0					85.0	85.0					28	42	
STA. 15+84.0 TO 23+16.0	2220.0		2220.0	1185.0	1185.0	340.0		340.0		33.0	33.0			62.4	62.4	37	37	
STA. 23+16.0 TO 34+10.0	1134.0	270.0	1404.0	2188.0	2188.0	340.0		340.0		33.0	33.0			02.4	02.4	14	14	+
STA. 34+10.0 TO 48+37.0	3120.0	380.0	3500.0	2019.0	2019.0	436.0	51.0	487.0		75.0	75.0	25.0	25.0	156.0	156.0	85	85	+
STA. 48+37.0 TO 71+01.0	5088.0	640.0	5728.0	4160.0	4160.0	350.0	01.0	350.0		116.0	116.0	30.0	30.0	312.0	312.0	121	121	
STA. 71+01.0 TO 81+50.0	1099.0	999.0	2098.0	2098.0	2098.0	000.0		000.0		110.0	110.0	30.0	30.0	61.2	61.2	13	13	
RR OMISSION	1000.0	555.5	2000.0	2555.5	2000.0							00.0	00.0	01.2	01.2	1.9	,,,	
STA. 83+00.0 TO 89+18.0	1090.0	40.0	1130.0	1236.0	1236.0							30.0	30.0	61.2	61.2	8	8	
SIDEROADS	MANUAL & A.M.	or an Associ																
PARK RD.	120.0		120.0	205.0	205.0	341.0		341.0	138.0		138.0	20.0	20.0	62.4	62.4			
STERLING AVE.	176.0		176.0	120.0	120.0	176.0		176.0	141.0		141.0	45.0	45.0	31.2	31.2	5	5	
PIERSON AVE.	80.0		80.0	55.0	55.0	300000000000000000000000000000000000000		(1350)-450(00000000	1130 40 591300000		NO. 1001150/080A00000	10.0	10.0	15.6	15.6	-		
IL 8 (SOUTHPORT RD.)	130.0		130.0	185.0	185.0							10.0	10.0	Q 500k II				
SWORDS AVE.	137.0	30.0	167.0	415.0	415.0	110.0		110.0				10.0	10.0					
SUBTOTAL	20538.0	2359.0	22897.0	17420.0	17420.0	2175.0	51.0	2226.0	381.5	822.0	1203.5	561.0	561.0	762.0	762.0	360.4	374.4	444.0
GRAND TOTAL	228	97.0	22897.0	17420.0	17420.0	222		2226.0	120		1204.0	561.0	561.0	762.0	762.0	360.0	374.0	444.0
* SPACING BETWEEN CROSSV	VALK LADD	ER MARKIN	NGS SHALL B	E 24"												100000	393.92	11000 40

**PAVEMENT MARKING REMOVAL - WATER BLASTING INCLUDES 2 CROSSWALKS THAT CROSS MAIN STREET

USER NAME = david.green DESIGNED -REVISED -DRAWN -REVISED -CHECKED -REVISED -PLOT DATE = 5/22/2025 DATE REVISED -

STATE OF ILLINOIS DEPARTMENT OF TRANSPORTATION

SECTION SCHEDULE OF QUANTITIES 11RS-6;GRS-3;10RS-9 CONTRACT NO. 68J62 SHEET 4 OF 5 SHEETS STA.

COUNTY TOTAL SHEET NO.
PEORIA 27 11

SHORT TER PAVEMENT		NG TABLE EMENT MARKING		SHORT	LOCATION					
REMOVAL*		LINE 24"		CENTERLINE/TU APPLICAT			_			
SQ. FT.	FOOT	# OF APPLICATIONS	FOOT	# OF APPLICATIONS						
).	ON RE	FARMINGTO	L 8/W.		
34.6			312.0	3	104+84.0	TO	99+98.0	STA.		
					5+15 (AH)	BK) =	EQ: 104+84 (STA. I		
34.6			312.0	3	10+34.0	TO	05+15.0	STA.		
37.3			336.0	3	15+84.0	ТО	10+34.0	STA.		
57.3	10.0	3.0	456.0	3	23+16.0	ТО	15+84.0	STA.		
37.3			336.0	3	34+10.0	ТО	23+16.0	STA.		
156.6	93.0	3.0	852.0	3	48+37.0	то	34+10.0	STA.		
190.2	50.0	3.0	1413.0	3	71+01.0	то	48+37.0	STA.		
42.6	10.0	3.0	324.0	3	81+50.0	TO	71+01.0	STA.		
					RR OMISSION					
28.0	10.0	3.0	192.0	3	89+18.0	ТО	83+00.0	STA.		
618.5	173.0		4533.0			SUBTOTAL				
618.0		6.0	470		L	GRAND TOTAL				

	GUARDRAIL SCHEDULE													
		LOCATION			GUARDRAIL LOCATION REMOVAL							LINEAR DELINEATOR PANELS, 4 INCH	TERMINAL MARKER - DIRECT APPLIED	GUARDRAIL AGGREGATE EROSION CONTROL
					FOOT	FOOT	EACH	EACH	EACH	EACH	TON			
RT. STA. 13+27 TO 17+66		439.0	362.5	1.0	1.0	5.0	1.0	60.0						
	TOTAL				439.0	363.0	1.0	1.0	5.0	1.0	60.0			

INLETS TO BE ADJUSTED					
LOCATION	EACH				
MAIN ST. / IL 8 (NE QUAD)	1				
TOTAL	1				


JOBSITE TABLE										
LOCATION	MOBILIZATION	CHANGEABLE MESSAGE SIGN*	CONSTRUCTION STATION LAYOUT	balletings and the real filtering between the control of the contr	DELLA SERVICIO POR ED CARA DE CARA DESCRIPTOR DE CONTRA POR EN	TRAFFIC CONTROL AND PROTECTION, STANDARD 701502	AND PROTECTION,			
	L SUM	CAL DAY	LSUM	L SUM	L SUM	L SUM	L SUM			
JOBSITE	1.0	100.0	1.0	1.0	1.0	1.0	1.0			
TOTAL	1.0	100.0	1.0	1.0	1.0	1.0	1.0			
* 5 BOARDS FOR 20 DAYS EACH										

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Schedule	c:\pw	
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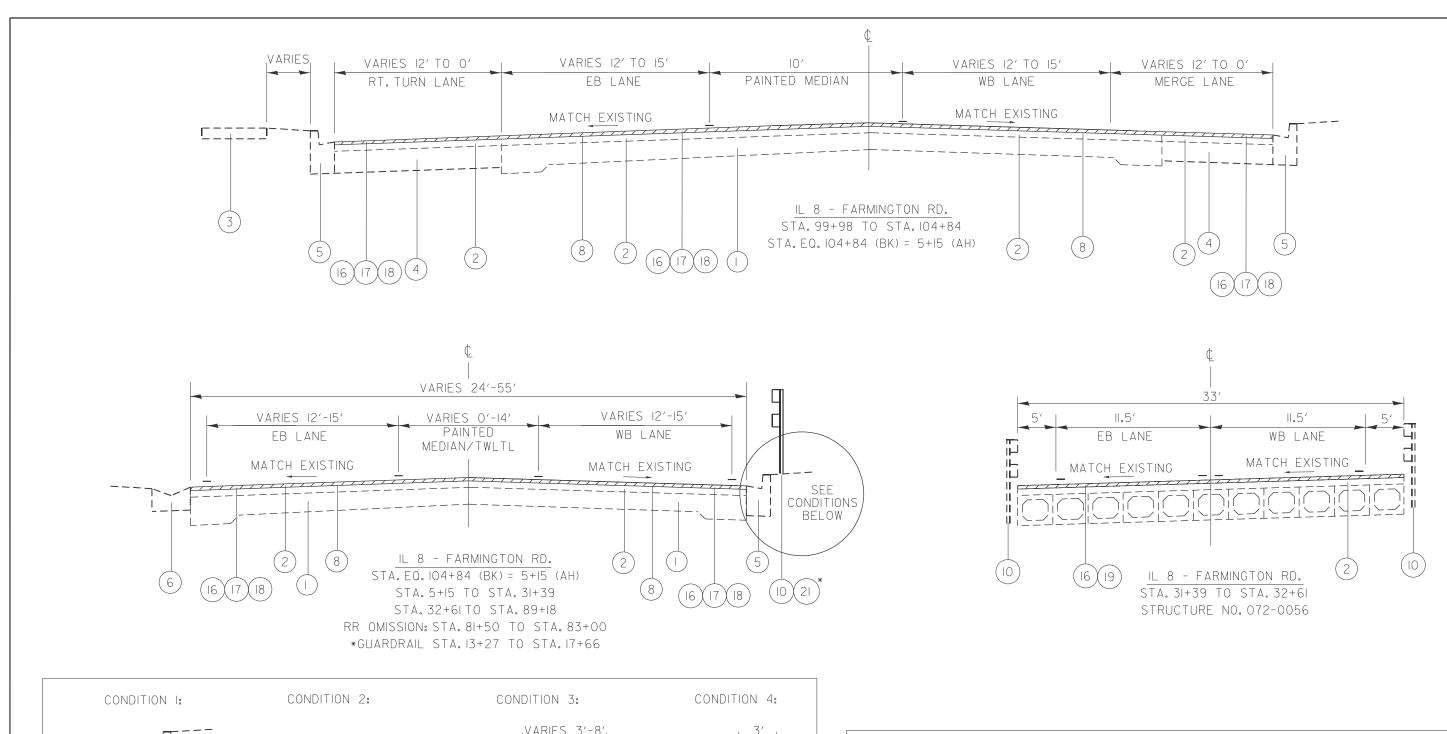
USER NAME = david.green	DESIGNED -	REVISED -
	DRAWN -	REVISED -
	CHECKED -	REVISED -
PLOT DATE = 5/22/2025	DATE -	REVISED -


STATE OF ILLINOIS
DEPARTMENT OF TRANSPORTATION

	SCHED	ULE	OF QU	ANTITIES	}	F.A.P RTE.	SEC.	TION		COUNTY	TOTAL SHEETS	SHEE NO.
				671	11RS-6;GR	S-3;10RS	-9	PEORIA	27	12		
										CONTRAC	T NO. 68	J62
HEET 5	OF	5	SHEETS	STA.	TO STA.			ILLINOIS	FED. AII	PROJECT		

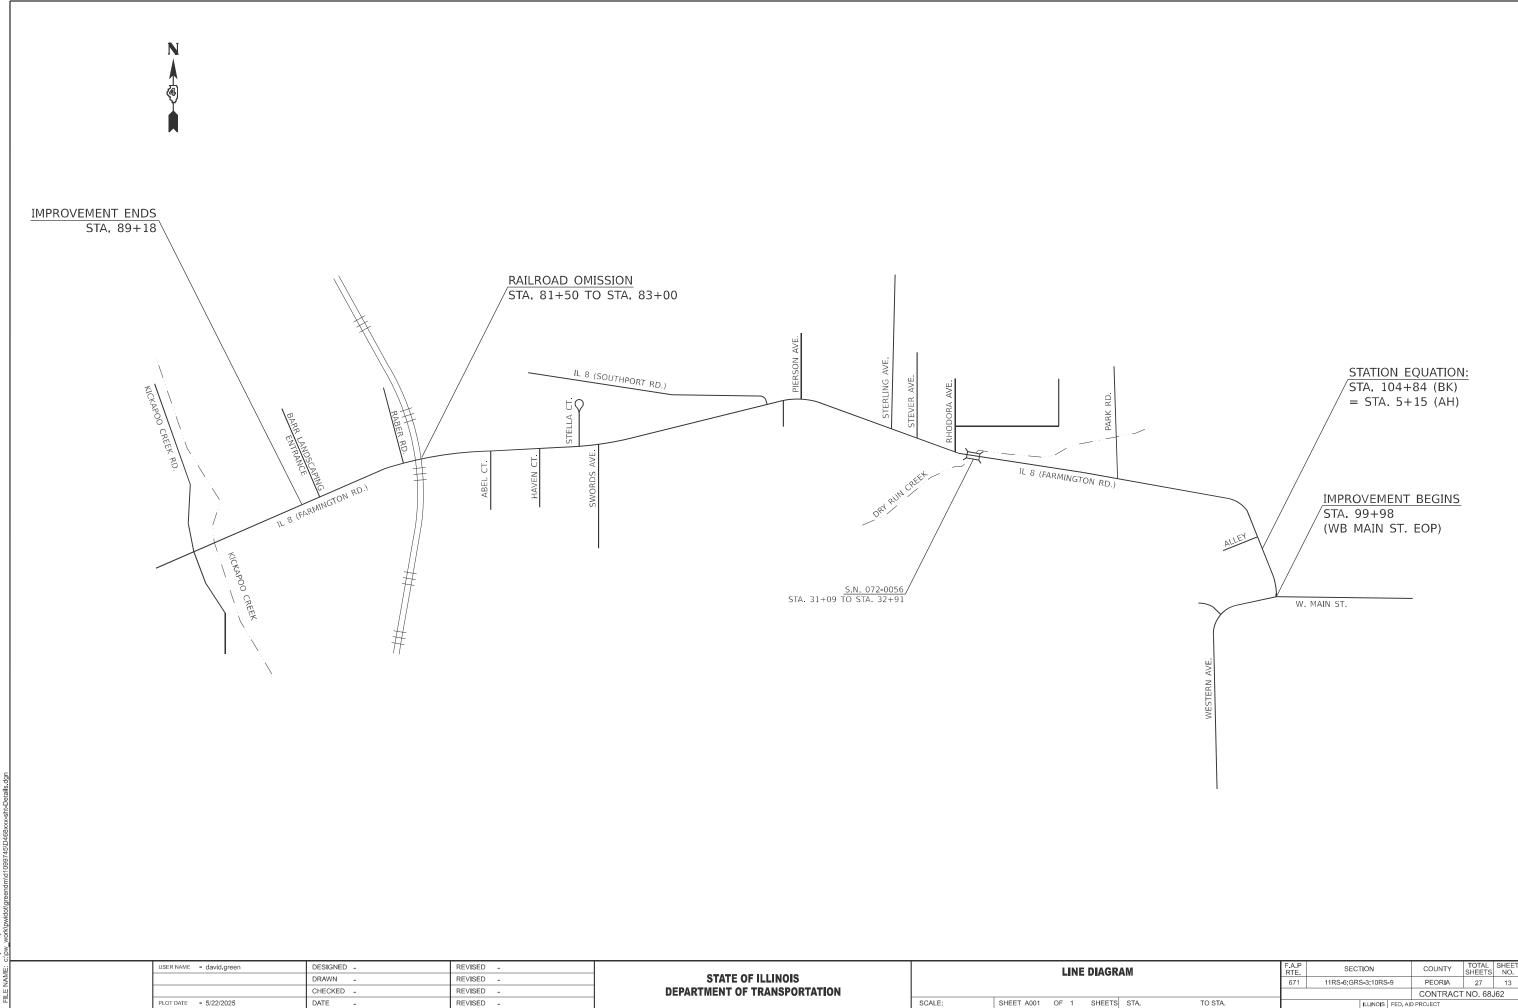

MODEL: Detail [Sheet] - 2



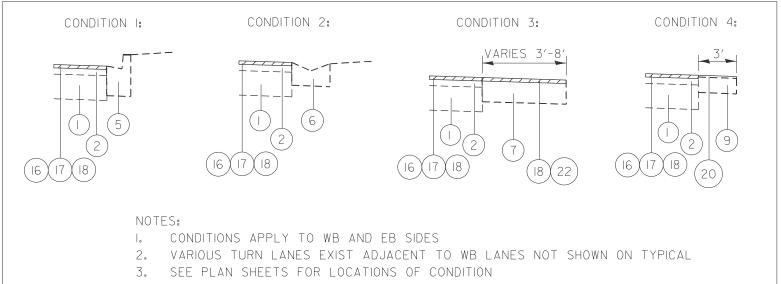

EXISTING ITEMS


- I. 9-6-9, P.C.C. PAVEMENT
- 2. HMA OVERLAY, VARIABLE DEPTH
- 3. P.C.C. SIDEWALK
- 4. P.C.C. BASE COURSE, 8"
- 5. COMB. CONC. CURB & GUTTER
- 6. CONCRETE GUTTER, TYPE B
- . HMA SHOULDER
- 8. AREA REFLECTIVE CRACK CONTROL
- 9. AGGREGATE SHOULDERS
- IO. GUARDRAIL


PROPOSED ITEMS


- 16. POLY. HMA SURF. COURSE, IL-9.5, MIX "D", N50, I.75"
- 17. POLY. HMA BIND. COURSE, IL-4.75, N50, I.O"
- 18. HMA SURFACE REMOVAL, 2.75"
- 19. HMA SURFACE REMOVAL(DECK), 1.75"
- 20. AGGREGATE SHOULDERS, TYPE B, I"
- 21. GUARDRAIL
- 22. INCIDENTAL HMA SURFACING, 2.75"

USER NAME = david.green	DESIGNED -	REVISED -				TYPICA	L SECTIONS		F.A.P	SECTION	COUNTY	TOTAL SHEET
	DRAWN -	REVISED -	STATE OF ILLINOIS				L OLO HONO		671	11RS-6:GRS-3:10RS-9	PEORIA	27 14
	CHECKED -	REVISED -	DEPARTMENT OF TRANSPORTATION								CONTRAC	T NO. 68J62
PLOT DATE = 5/15/2025	DATE -	REVISED -		SCALE:	SHEET 1	OF 1	SHEETS STA.	TO STA.		ILLINOIS FED. AI	PROJECT	




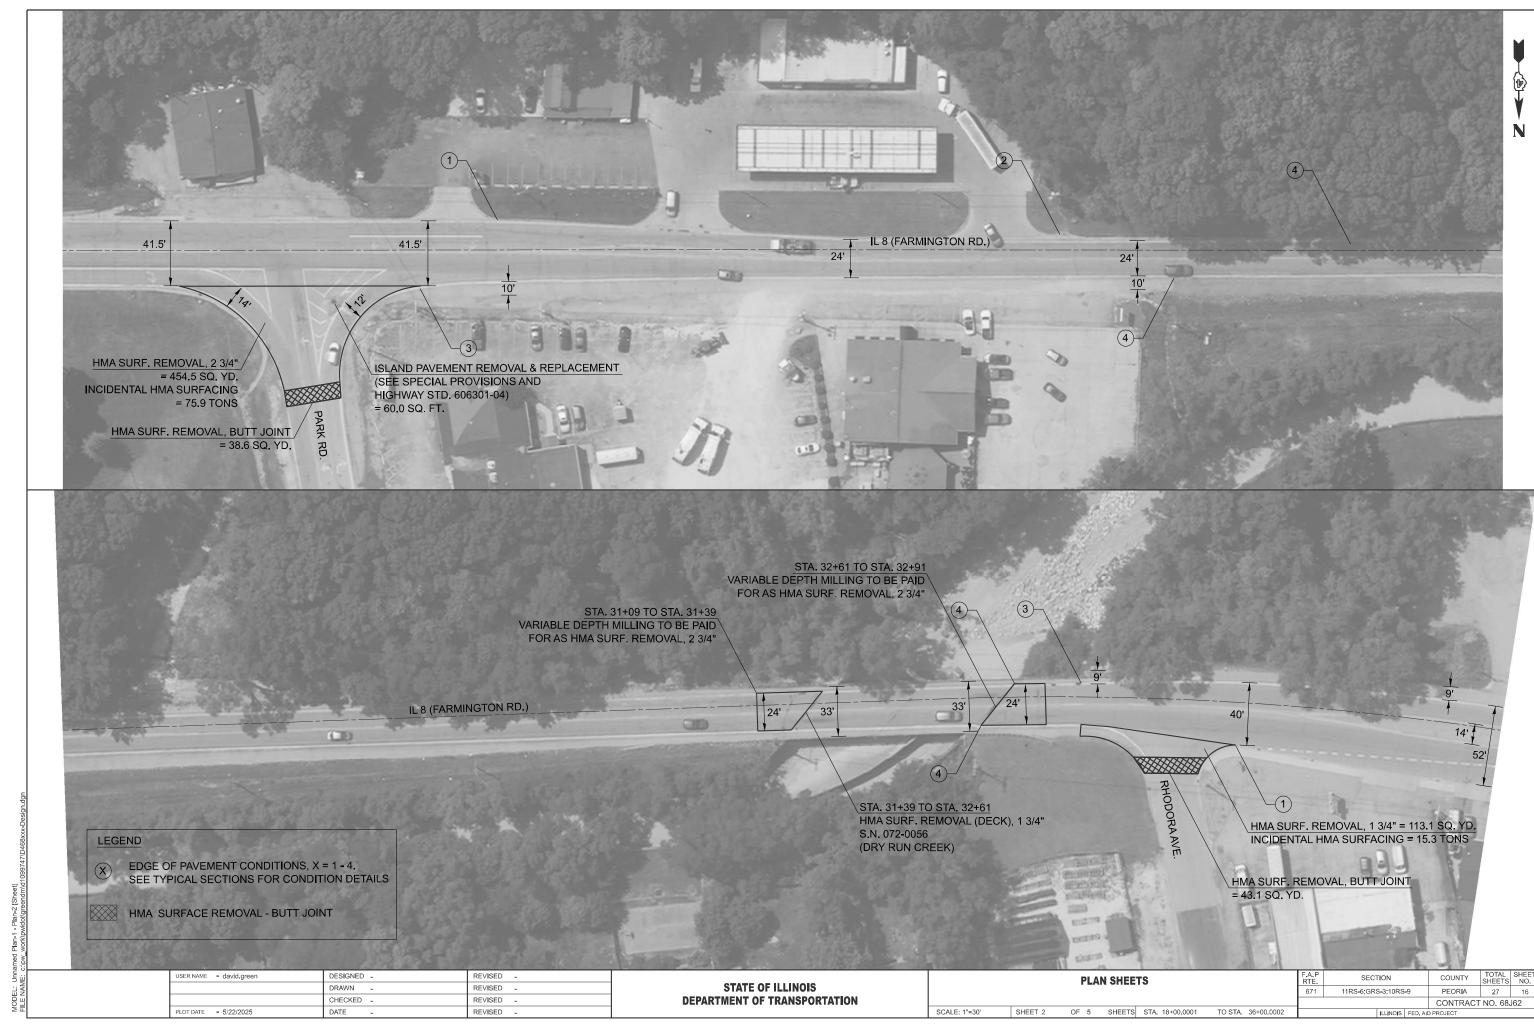

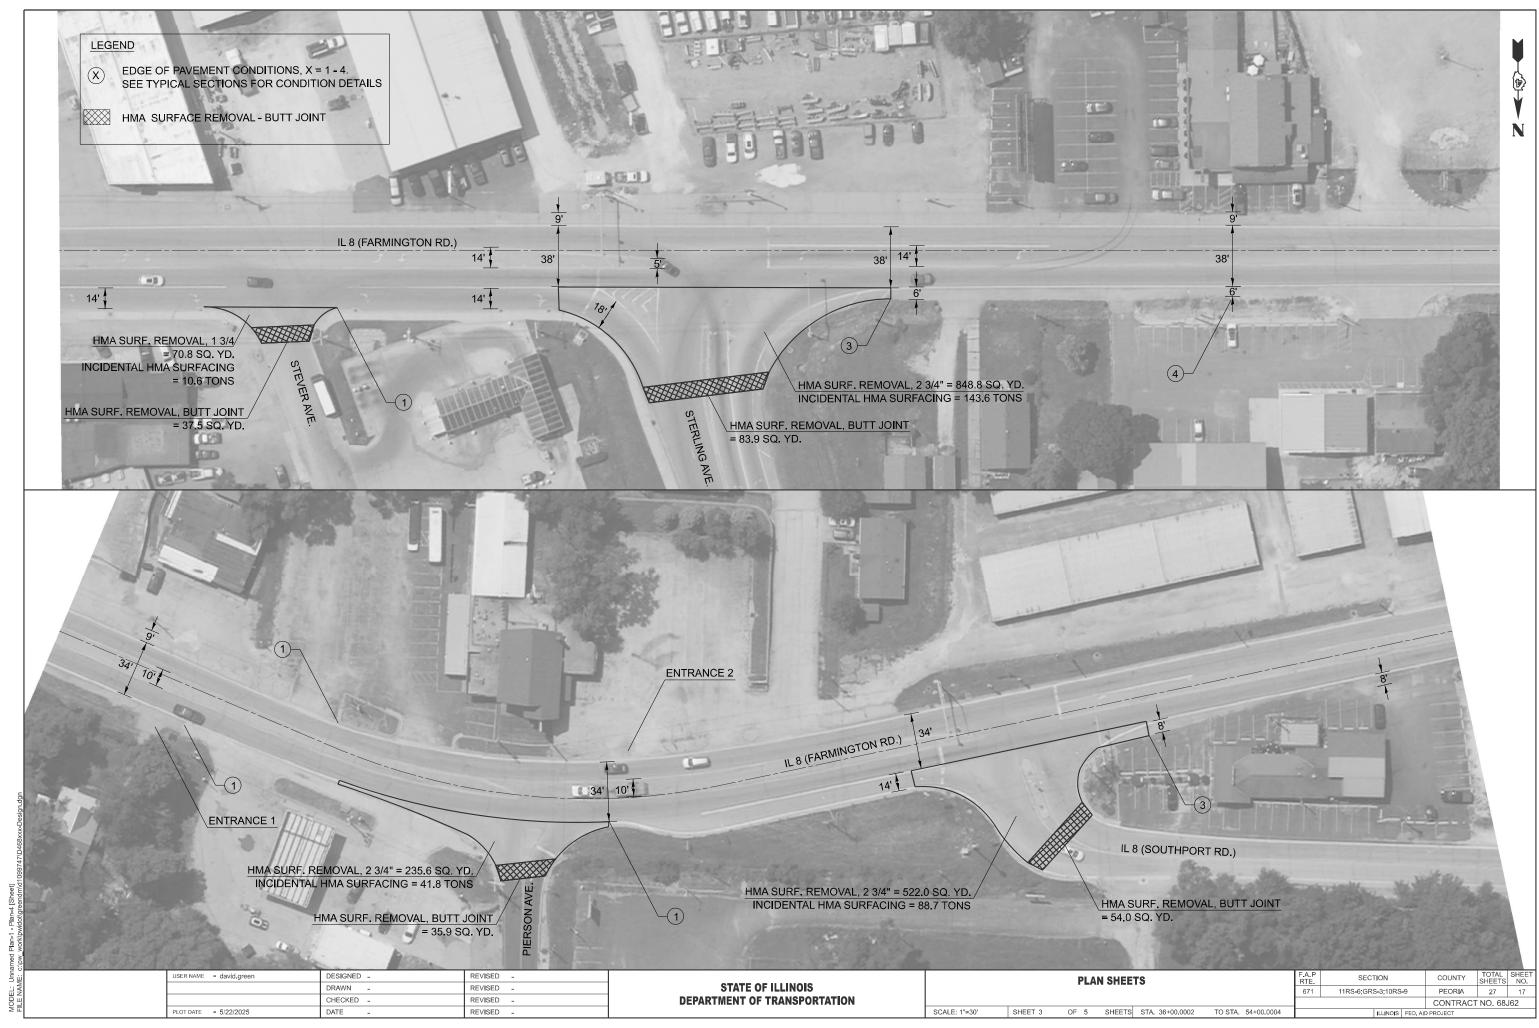

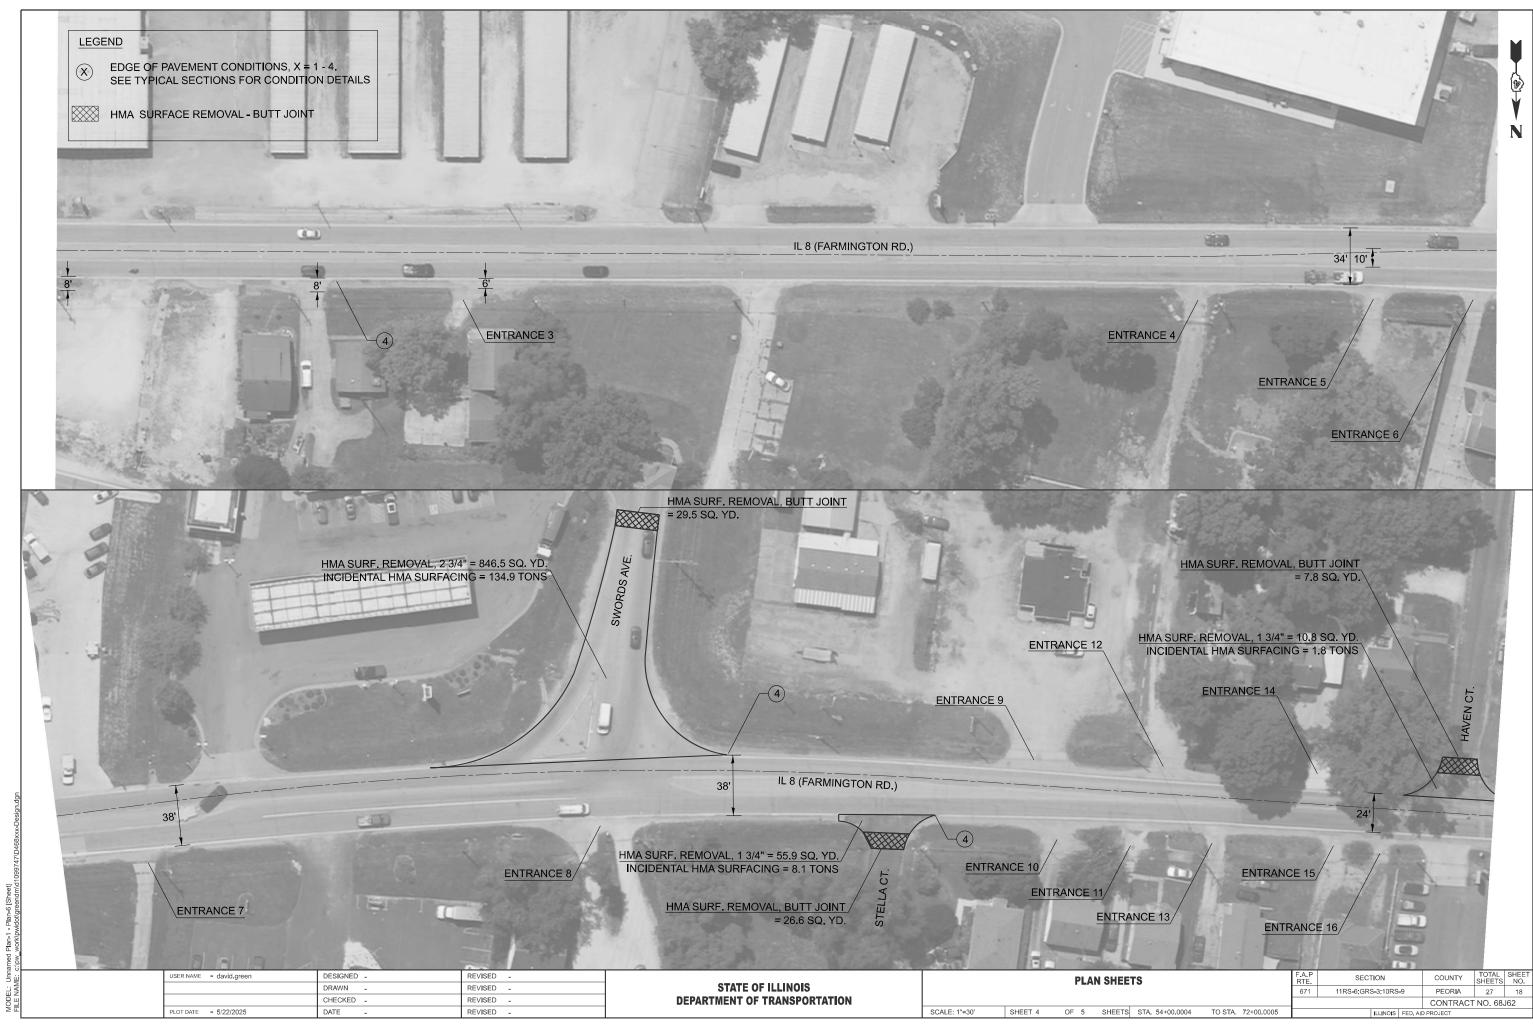



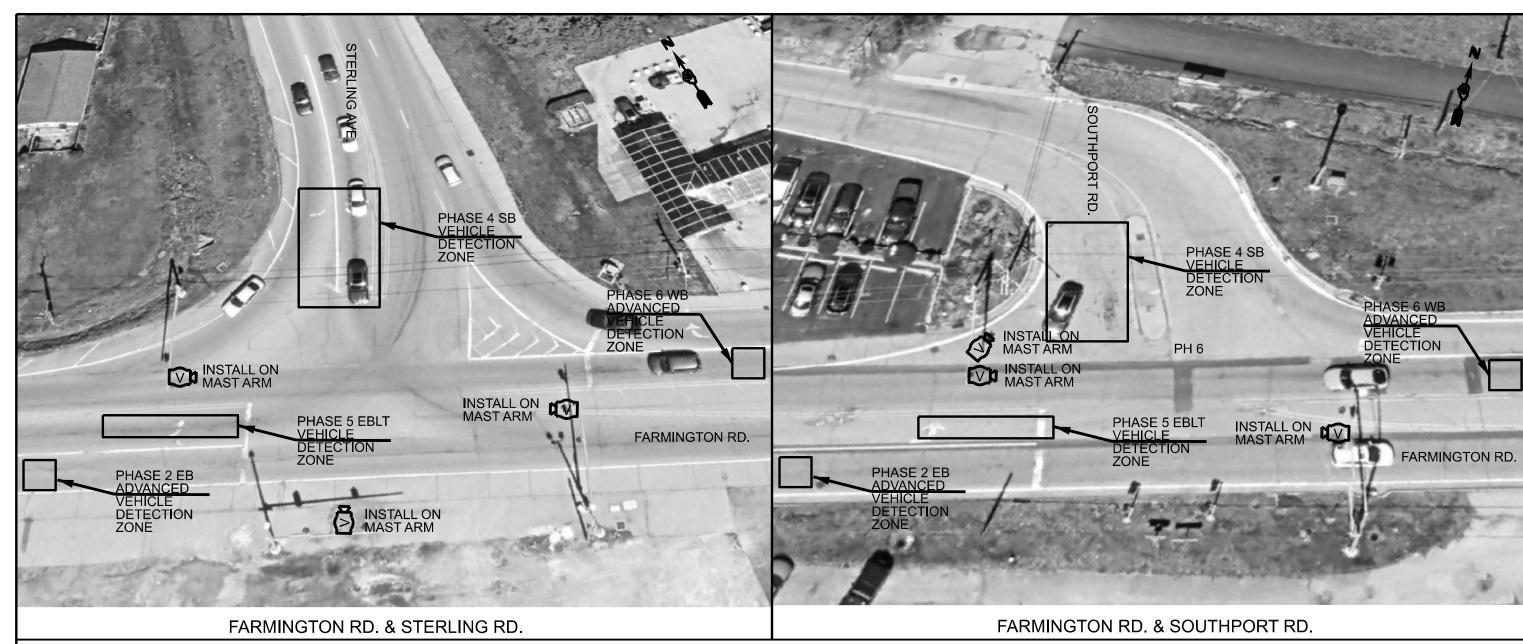

MAST ARM INSTALLATION - CONSTRUCTION NOTES

- THE CONTRACTOR SHALL SCHEDULE THE INSTALLATION OF THE PROPOSED VIDEO DETECTION SYSTEMS ONLY DURING THE HOURS OF 8:30 AM TO 3:00 PM MONDAY THROUGH FRIDAY
- THE CONTRACTOR WILL BE ALLOWED TO PLACE THE INTERSECTION INTO ALL-RED FLASH MODE AND ALL-WAY STOP CONTROL ONLY DURING THE HOURS SPECIFIED ABOVE TO FACILITATE THE INSTALLATION OF THE PROPOSED TRAFFIC SIGNAL COMPONENTS.
- THE CONTRACTOR SHALL FURNISH AND INSTALL A MINIMUM OF TWO STOP SIGNS PER APPROACH WHEN THE INTERSECTION IS OPERATING IN ALL-RED FLASH MODE OR ALL-WAY STOP CONTROL
- ALL COSTS (LABOR, MATERIALS, AND EQUIPMENT) ASSOCIATED WITH THESE REQUIREMENTS SHALL BE INCLUDED IN THE CONTRACT BID PRICE FOR THE PROPOSED MAST ARMS. THERE WILL BE NO ADDITIONAL COMPENSATION FOR THIS WORK

CONSTRUCTION NOTES

- ANY MAINTENANCE OF EXISTING TRAFFIC SIGNALS WILL BE CONSIDERED EXTRA WORK IN ACCORDANCE WITH ARTICLE 109.04 OF THE STANDARD SPECIFICATIONS
- THE LOCATION OF ALL UTILITIES AND PRIVATELY OWNED FACILITIES SHALL BE FIELD VERIFIED BY THE CONTRACTOR PRIOR TO THE INSTALLATION OF
- THE CONTRACTOR SHALL BE RESPONSIBLE FOR LOCATING EXISTING IDOT ELECTRICAL FACILITIES AT HIS/HER OWN EXPENSE IF REQUIRED. THE CONTRACTOR SHALL ALSO BE LIABLE FOR ANY DAMAGE TO IDOT FACILITIES RESULTING FROM INACCURATE LOCATING.
- ELECTRICAL WORK SHALL CONFORM WITH NATIONAL, STATE, AND LOCAL CODES

DATE

LOT DATE = 1/7/2025

- THE EXISTING TRAFFIC SIGNALS SHALL REMAIN IN OPERATION DURING THE CONSTRUCTION OF THE PROPOSED TRAFFIC SIGNALS.
- THE CONTRACTOR SHALL PROVIDE ELECTRICAL CABLE SLACK IN ACCORDANCE WITH ARTICLE 873.03.
- ELECTRICAL CABLE WILL BE MEASURED FOR PAYMENT IN ACCORDANCE WITH ARTICLE 873.04.
- ALL SURPLUS MATERIALS SHALL BE DISPOSED OF IN ACCORDANCE WITH ARTICLE 202.03 OF THE STANDARD SPECIFICATIONS
- ALL VIDEO DETECTION CAMERAS SHALL BE INSTALLED ON THE TRAFFIC SIGNAL MAST ARM. CAMERAS SHALL BE CENTERED OVER THE APPROACH (INCLUDES BOTH THRU AND LEFT TURN LANES) AND INSTALLED ON FIVE FT. EXTENSION BRACKETS.

REVISED


BILL OF MATERIALS						
FARMINGTON RD. @ STERLING AVE. & SOUTHPORT RD.						
VIDEO VEHICLE DETECTION SYSTEM, 3 CAMERA	EACH	2.0				

SCALE:

SHEET _

-	COST OF REMOVING ENSTING I	LEINIS SHALL BE INCLUDED IN T	HE COST OF THE PROPOSED I	TEMO.	
٦	USER NAME = trevor.hanson	DESIGNED	REVISED		PROF
		DRAWN	REVISED	STATE OF ILLINOIS	FARMIN
		CHECKED	REVISED	DEPARTMENT OF TRANSPORTATION	FARMING


PROPOSED TRAFFIC SIGNALS	F.A.P RTE	SECTION	COUNTY	TOTAL SHEETS	SHEET NO.
MINGTON RD. & STERLING AVE.	671	11RS-6;GRS-3;10RS-9	PEORIA	27	20
MINGTON RD. & SOUTHPORT RD.			CONTRACT	NO. 68	J62
OF SHEETS STA TO STA		ILLINOIS FEE	AID DDO IECT		

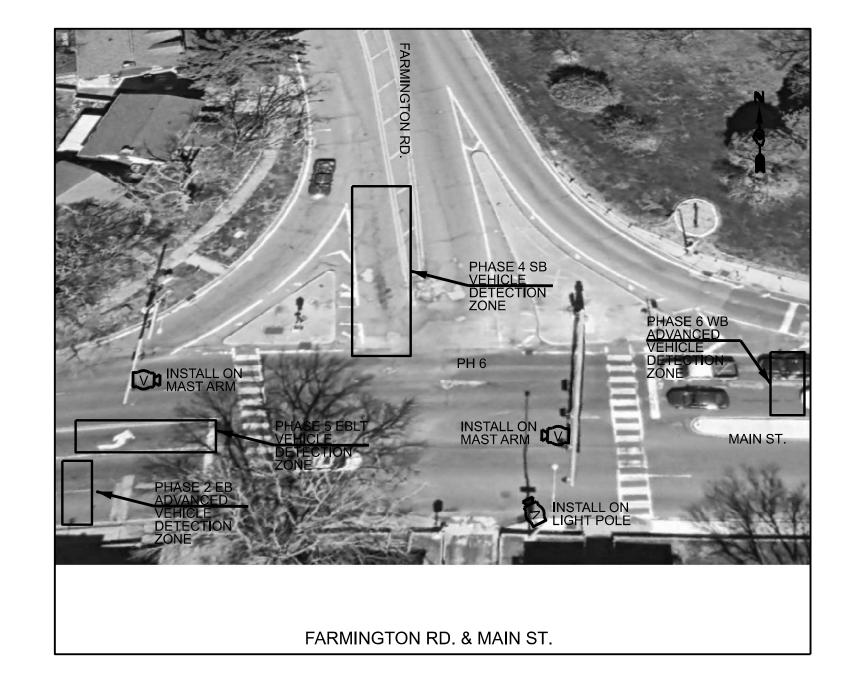

BILL OF MATERIALS FARMINGTON RD. @ MAIN ST.								
VIDEO VEHICLE DETECTION SYSTEM, 3 CAMERA	EACH	1.0						

USER NAME = trevor.hanson	DESIGNED	REVISED	STATE OF ILLINOIS PROPOSED TRAFFIC SIGNALS FARMINGTON RD, & MAIN ST.		DD	ADAGER	TDACEL	C SIGNALS		F.A.P RTF	SECTION	COUNTY	TOTAL	SHEET
	DRAWN	REVISED		671	11RS-6;GRS-3;10RS-9	PEORIA	27	21						
	CHECKED -	REVISED	DEPARTMENT OF TRANSPORTATION			· · · · · · · · · · · · · · · · · · ·	CONTRAC	T NO. 68	3J62					
PLOT DATE = 1/7/2025	DATE	REVISED		SCALE:	SHEET _	OF	SHEETS	STA	TO STA.		ILLINOIS FED. A	ID PROJECT		

MODEL: Default

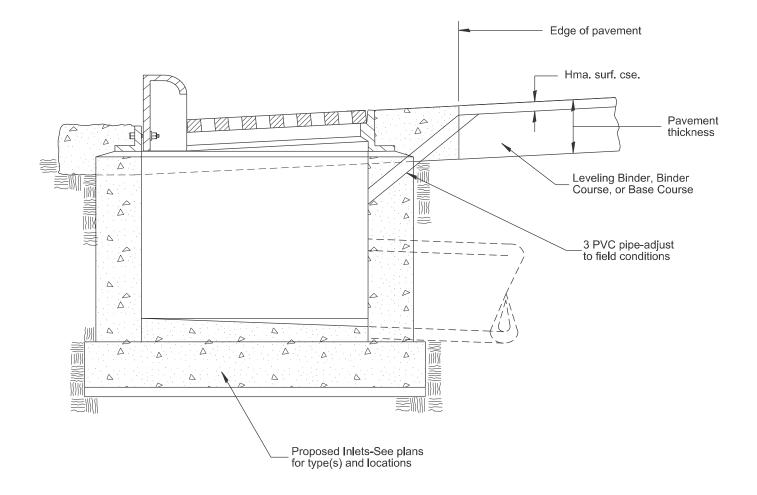

GENERAL NOTES:

- 1. Temporary Drainage This work consists of furnishing and installing a 3 PVC pipe in the proposed inlet to facilitate drainage off the pavement prior to the placement of bituminous surface course.
- 2. Adequate pavement drainage shall be maintained during all phases of construction.
- 3. The PVC pipe is to be filled with mortar prior to surface course placement.
- 4. This detail applies to all inlet types.


USER NAME = david.green	DESIGNED -	REVISED -		TEMPORARY INLET DRAINAGE TREATMENT	F.A.P RTE	SECTION	COUNTY	TOTAL	SHEET
	DRAWN -	REVISED -	STATE OF ILLINOIS	ILMFORARI MELI DRAMAGE IRLAIMENI	671	11RS-6:GRS-3:10RS-9	PEORIA	27	22
	CHECKED -	REVISED -	DEPARTMENT OF TRANSPORTATION		DIS	STRICT 4 DETAIL NO. 602401	CONTRAC	T NO. 68	J62
PLOT DATE = 5/15/2025	DATE -	REVISED -		SCALE:NOT TO SCALE SHEET 1 OF 6 SHEETS STA. TO STA.		ILLINOIS FED. AI	D PROJECT		

RDRAIL INSTALLATIONS WHERE GRADES ARE EQUAL TO OR GREATER THAN 1% AND AT INLETS. (INCLUDE DISTRICT SPECIAL PROVISION) INTROL" AT GUARDRAIL INSTALLATIONS WHERE GRADES ARE LESS THAN 1% (INCLUDE DISTRICT SPECIAL PROVISION). ICARI F DIVIDING LINE IS IL 97. PCC or
HMA
Shoulder
ThicknessSee plans
Comb. CC&G, Type B
Pan Width - See Plans
Geotextile Fabric (stapled)
Guardrail Aggregate
Erosion Control


TYPICAL SECTION WITH COMBINATION CONCRETE CURB & GUTTER


GENERAL NOTES: GUARDRAIL AGGREGATE EROSION CONTROL


- This work shall consist of grading as needed, furnishing and installing geotextile
 fabric and staples, and furnishing, placing and shaping crushed aggregate around
 and behind Steel Plate Beam Guardrail posts in accordance with Plan Details.
- 2. Before placing the aggregate and the Geotextile Fabric, weeds and grass shall be removed from the area to be covered.
- After the area has been prepared, and in a dry condition, the Geotextile fabric shall be placed with a 12 minimum overlap. A knife cut for guardrail post installation is necessary.
- 4. The aggregate shall be deposited, compacted and shaped by either mechanical or hand methods, in a manner reasonably true to line and grade.
- 5. The Contractor shall have the option of placing the guardrail before or after the Geotextile Fabric and Aggregate are in place. If the guardrail is placed after the Geotextile Fabric and Aggregate, then any voids must be filled and the aggregate returned to line and grade.
- 6. Materials shall meet the following requirements:
- A. The crushed aggregate shall be CA1 gradation in accordance with Article 1004.01(c) of the Standard Specifications.
- B. The Geotextile Fabric shall be nonwoven fabric in accordance with Article 1080.02 of the Standard Specifications.

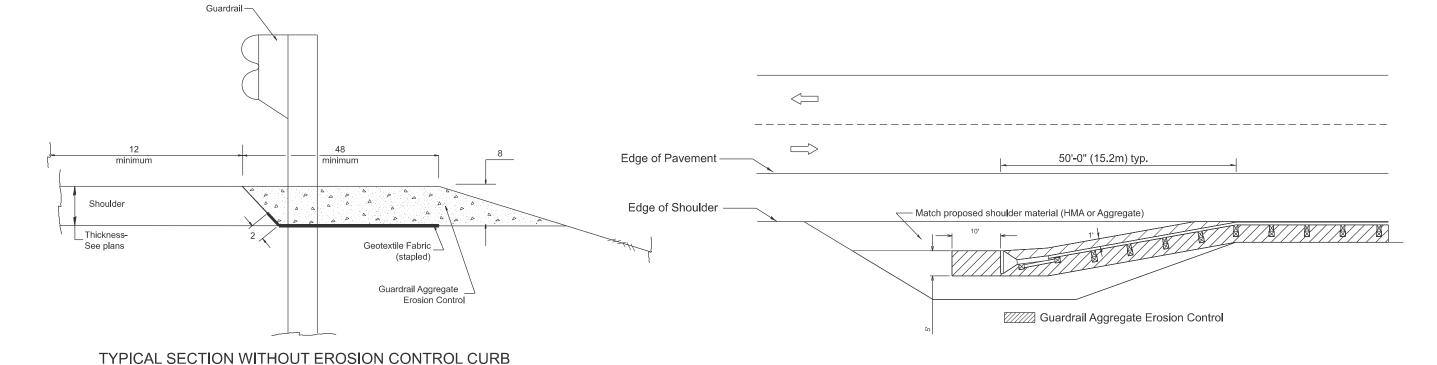

USER NAME = david.green	DESIGNED -	REVISED -		GUARDRAIL EROSION CONTROL TREATMENTS	F.A.P	SECTION	COUNTY	SHEETS NO
	DRAWN -	REVISED -	STATE OF ILLINOIS	COARDINALE ERCOPORT CONTINUE TREATMENT	671	11RS-6:GRS-3:10RS-9	PEORIA	27 23
	CHECKED -	REVISED -	DEPARTMENT OF TRANSPORTATION		DISTR	RICT 4 DETAIL NO. 630101	CONTRACT	T NO. 68J62
PLOT DATE = 5/15/2025	DATE -	REVISED -		SCALE:NOT TO SCALE SHEET 2 1 OF 62 SHEETS STA. TO STA.		ILLINOIS FED.	AID PROJECT	

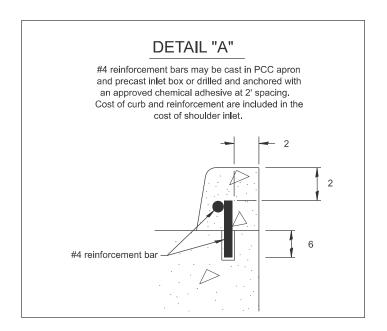


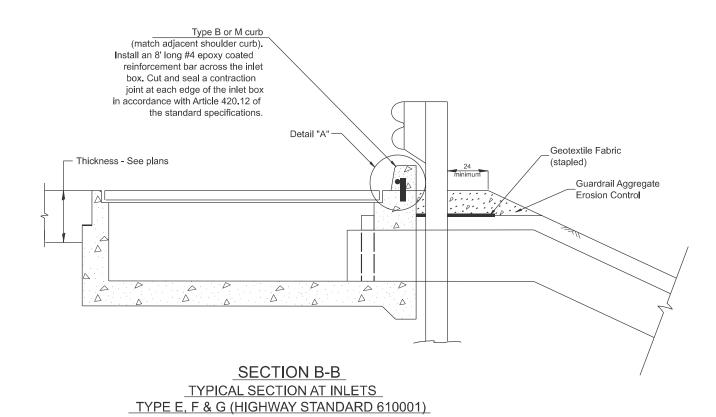

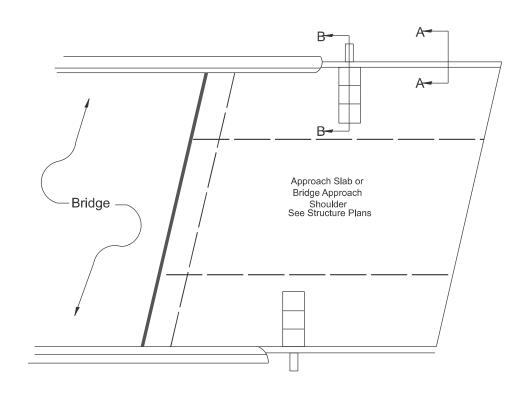

PLAN VIEW


APPROACH SLAB OR SHOULDER PLACEMENT

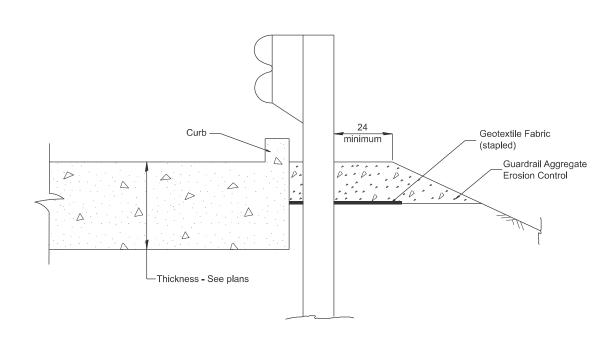

SECTION A-A

TYPICAL SECTION WITH BRIDGE APPROACH CURB

USER NAME = david.green	DESIGNED -	REVISED -		GUARDRAIL EROSION CONTROL TREATMENTS	F.A.P RTF	SECTION	COUNTY	TOTAL SHEET
	DRAWN -	REVISED -	STATE OF ILLINOIS	COARBIALE ERCOTOR CONTROL TREATMENTO	671	11RS-6:GRS-3:10RS-9	PEORIA	27 24
	CHECKED -	REVISED -	DEPARTMENT OF TRANSPORTATION		DIST	RICT 4 DETAIL NO. 630101	CONTRACT	NO. 68J62
PLOT DATE = 5/22/2025	DATE -	REVISED -		SCALE:NOT TO SCALE SHEET 3 2 OF 62 SHEETS STA. TO STA.		ILLINOIS FED. A	ID PROJECT	

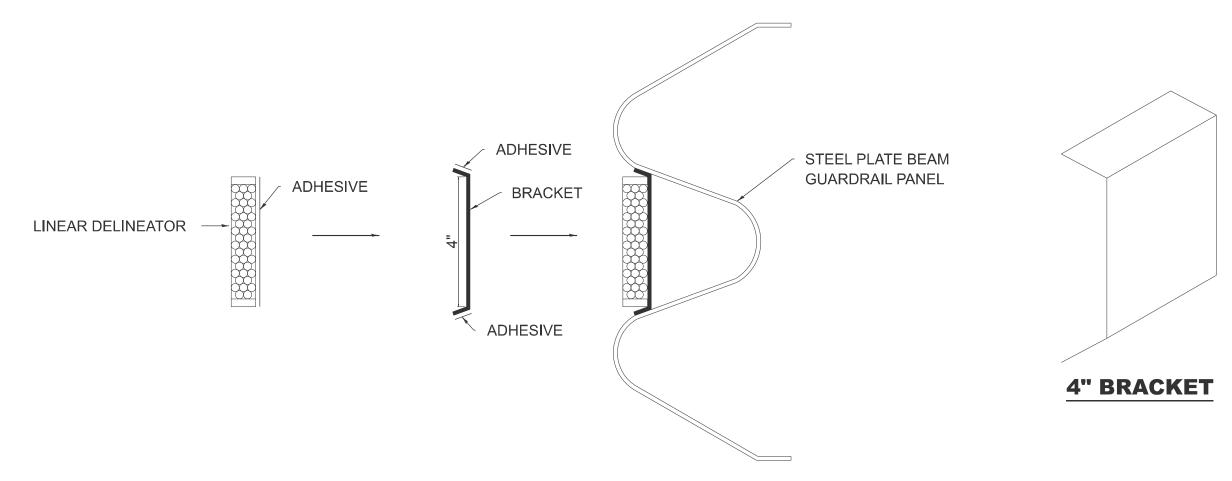

LINEAR DELINEATOR APPLICATION TO STANDARD GALVANIZED GUARDRAIL

LINEAR DELINEATOR SHALL BE APPLIED ACCORDING TO THE MANUFACTURER'S RECOMMENDATIONS

MODEL: Named Boundary Sheet H

USER NAME = david.green	DESIGNED -	REVISED -	ı
	DRAWN -	REVISED -	
	CHECKED -	REVISED -	
PLOT DATE = 5/15/2025	DATE -	REVISED -	

STATE OF ILLINOIS
DEPARTMENT OF TRANSPORTATION

		LINEAR	DELIN	IEATOR AI	F.A.P RTE.	SECTION	COUNTY	TOTAL SHEETS	SHE		
ı		STAND	ARD G	ALVANIZE	671	11RS-6;GRS-3;10RS-9	PEORIA	27	25		
I		STAILD	AIND C	ALVANIEL	D GOAINE	MAIL	DIS	STRICT 4 DETAIL NO. 635003	CONTRACT	NO. 68.	62
l	SCALE: NOT TO SCALE SHEET 4 OF 6 SHEETS STA. TO STA.							ILLINOIS FED. AI	D PROJECT		

FLUSH PAVED MEDIAN: TWO-WAY LEFT TURN LANE WITH ONE-WAY LEFT TURN LANE AT SIGNALIZED INTERSECTION

TYPICAL PAVEMENT MARKING LEGEND

(Note: This is a District Standard Legend. Some elements may not apply to specific project.)

- 1 4 Solid (Yellow)
- 2 4 Solid (White)
- 3 2-6 Crosswalk @ 6'-6" min C.-C. (White)
 2-8 Crosswalk @ 6'-6" min C.-C. (White) (When traffic signals are present.)
- 4 6 Skip-Dash (White)
- 30' 10' (See Special Note 1)

- 5 8 Solid (White)
- 6 12 Diagonal (White) (Item 6) is shown on Std. 780001)
- 7 24 Stop Bar (White)
- 8 Letters & Arrows (See Std. 780001 and Special Notes 2 & 3)
- 9 4 Skip-Dash (Yellow) | 30' | 10' | (See Special Note 1)
- 10 12 Diagonal (Yellow) (See Table A)

 45°

 11 4 Double Solid (Yellow)

SPECIAL NOTES

- Skip-Dæshmærkingswillbæænterætlbæthesen both ends of city blocks and shall be placed in alignment transversely across the pavement.
- 2. The following shall apply to arrows located in one-way left turn lanes:
- A. A minimum of two (2) arrows is required.
- B. The maximum spacing between arrows is 80'.
- C. Arrows shall be evenly spaced if three (3) or more are required.
- 3. The following shall apply to arrow pairs located in two-way left turn lanes:
- A. A minimum of two (2) arrow pairs is required. B. The maximum spacing between arrow pairs
- C. Arrow pairs shall be evenly spaced if three (3) or more are required.
- D. The spacing between Bi Directional Left Turn Arrows is 33'.

GENERAL NOTES

- 1. Refer to State Standard 780001 for additional Pavement Markings including letters & arrows.
- See Plans for Pavement Markings adjacent to curbed islands and medians, and through lane reductions.
- 3. Refer to Article 780.13 for letter, number and symbol areas (sq. ft.)
- Areas are grooved 1" beyond each edge for the following symbols: Through Arrow= 14.8 sq. ft, Large Left or Right Arrow= 21.9 sq. ft.
 Arrow Combination Left (or Right) and Through= 34.9 sq. ft, Wrong Way Arrow= 29.5 sq. ft, Railroad Crossing Symbol= 69.8 sq. ft. (For further information, refer to BDE Special Provision: Grooving for Recessed Pavement Markings)

 USER NAME
 = david.green
 DESIGNED
 REVISED

 DRAWN
 REVISED

 CHECKED
 REVISED

 PLOT DATE
 = 5/22/2025
 DATE
 REVISED

STATE OF ILLINOIS
DEPARTMENT OF TRANSPORTATION


is 200'.

 TYPICAL PAVEMENT MARKINGS
 F.A.P. RTE.
 SECTION
 COUNTY SHEETS NO.
 TOTAL SHEETS NO.

 671
 11RS-6;GRS-3;10RS-9
 PEORIA
 27
 26

 DISTRICT 4 DETAIL NO. 780001
 CONTRACT NO. 68 JGZ

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 SHEET 5 1
 OF 62
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 STA.
 TO STA.
 ILLINOIS FED. AD PROJECT

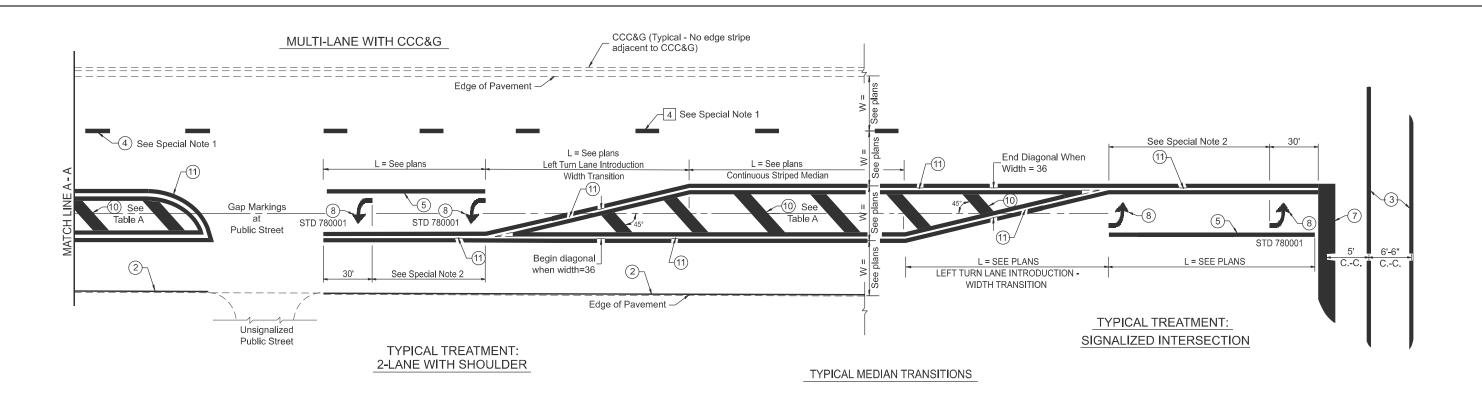


FLUSH PAVED MEDIAN: RESTRICTED LEFT TURN LANE

TABLE A

RECOMMENDED SPACING BETWEEN DIAGONAL LINES

SPEED LIMIT RANGECONTINUOUSINTERSECTION CHANNELIZATION (Includes Width Transitions for Median and Left Turn Lane Introductions)Less Than 30 mph50'15'30 - 45 mph75'20'Over 45 mph150'30'

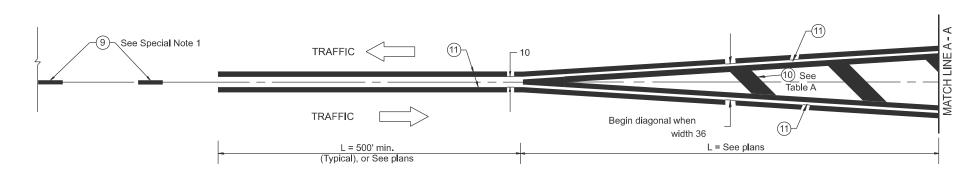

MEDIAN INTRODUCTION - WIDTH TRANSITIONS

USER NAME = david.green	DESIGNED -	REVISED -		TYPICAL PAVEMENT MARKINGS	F.A.P SECTION	COUNTY TOTAL SHEET
	DRAWN -	REVISED -	STATE OF ILLINOIS	THE TAVE MENT MANAGEROS	671 11RS-6;GRS-3;10RS-9	PEORIA 27 27
	CHECKED -	REVISED -	DEPARTMENT OF TRANSPORTATION		DISTRICT 4 DETAIL NO. 780001	CONTRACT NO. 68J62
PLOT DATE = 5/15/2025	DATE -	REVISED -		SCALE:NOT TO SCALE SHEET 6 2 OF 62 SHEETS STA. TO STA.	ILLINOIS FED. A	AID PROJECT