
1:27

SIGN ID		WB-WP-0350			
STRUCTU	JRE NUMBER	-			
SIZE	EXIT PLAQUE	-			
(W x H)	MAIN PANEL	7'-6" x 5	'-0"		
MOUNTIN	NG / TYPE	GROUND	/ WOOD POST		
MOUNTIN	NG LOCATION	LEFT			
		TYPE:	REFLECTIVE - ZZ		
~	BACKGROUND	COLOR:	GREEN		
SHEETING / COLOR	BACKGROUND	TYPE:	-		
) / C		COLOR:	-		
ING		TYPE:	REFLECTIVE - ZZ		
HE	LEGEND /	COLOR:	WHITE		
U1	BORDER	TYPE:	-		
		COLOR:	-		

## SIGN DETAIL

1:27


SIGN ID		RB-GM-0	RB-GM-0170		
STRUCTU	JRE NUMBER	-	-		
SIZE	EXIT PLAQUE	-			
(W x H)	MAIN PANEL	13'-6" x	11'-0"		
IITNUOM	NG / TYPE	GROUND	/ BREAKAWAY		
IITNUOM	NG LOCATION	RIGHT			
		TYPE:	REFLECTIVE - ZZ		
~	BACKCBOUND	COLOR:	GREEN		
OLOF	BACKGROUND	TYPE:	-		
) C		COLOR:	-		
JING.		TYPE:	REFLECTIVE - ZZ		
SHEETING / COLOR	LEGEND /	COLOR:	WHITE		
U)	BORDER	TYPE:	-		
		COLOR:	-		

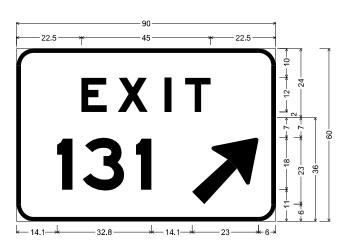

6.0" Radius, 1.5" Border, White on Green; "EXIT", E Mod 2K 225% spacing;

6.0" Radius, 1.5" Border, White on Green; "131", E Mod 2K; Arrow Custom - 29.3" 45°; Table of widths and spaces

able of Mattle and Spaces								
	E		Х		ı		Т	
22.5	8.9	3.8	10.4	5.7	2.4	4.9	8.9	22.5
	1		3		1		7	
14 1	54	34	146	4 0	54	14 1	23 (	าโดก

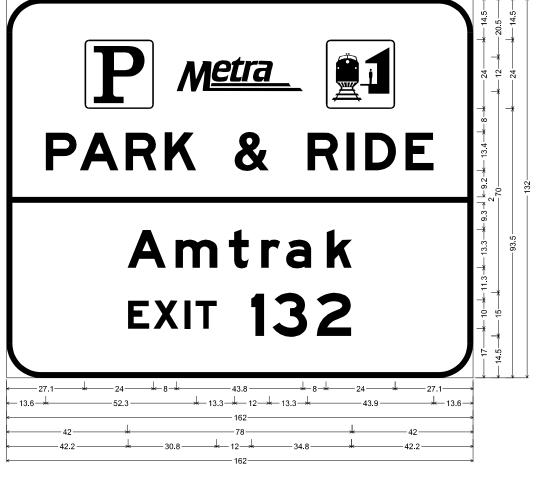

5-EB-005-G;

Drawn by : DW;

12.0" Radius, 2.0" Border, White on Green;

Parking; Train Station; "PARK & RIDE", E Mod 2K; "Amtrak", E Mod 2K; "EXIT", E Mod 2K; "132", E Mod 2K;

Table of widths and spaces

DIMENSIONS ARE IN INCHES.TENTHS

Accurate GROUP, INC.

USER NAME = jschumann	DESIGNED - JLS	REVISED -
	DRAWN - JLS	REVISED -
PLOT SCALE = 100.000 / in.	CHECKED - AB	REVISED -
PLOT DATE = 4/22/2025	DATE - 4/25/2025	REVISED -


DIMENSIONS ARE IN INCHES.TENTHS

STATE OF ILLINOIS								
DEPARTMENT (	OF TRANSPORTATION							

									F.A.I. RTE	SEC <sup>-</sup>	TION		COUNTY	TOTAL SHEETS	SHEET NO.
			SIGN	PA	ANEL DI	ETAILS			80	FAI 80 21 IN	TERCHAI	NGE	WILL	1209	501
													CONTRACT	NO. 62	R22
ONE	SHEET	10	OF	14	SHEETS	STA.	TO S	TA.			ILLINOIS	FED. AI	D PROJECT		

1:15


SIGN ID		RB-GM-0	RB-GM-0190		
STRUCTI	JRE NUMBER	-			
SIZE	EXIT PLAQUE	-			
(W x H)	MAIN PANEL	12'-6" x	5'-6"		
MOUNTI	NG / TYPE	GROUND	/ BREAKAWAY		
MOUNTI	NG LOCATION	RIGHT			
		TYPE:	REFLECTIVE - ZZ		
~	BACKCBOUND	COLOR:	GREEN		
) JLOF	BACKGROUND	TYPE:	-		
0) / (0		COLOR:	-		
SHEETING / COLOR		TYPE:	REFLECTIVE - ZZ		
里	LEGEND /	COLOR:	WHITE		
, s	BORDER	TYPE:	-		
		COLOR:	-		

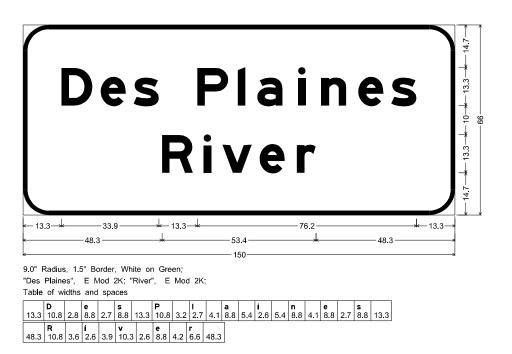

SIGN DETAIL

1:20

SIGN ID		NB-GM-0	NB-GM-0170		
STRUCTU	JRE NUMBER	-			
SIZE	EXIT PLAQUE	-			
(W x H)	MAIN PANEL	14'-0" x	14'-6"		
IITNUOM	NG / TYPE	GROUND	/ BREAKAWAY		
IITNUOM	NG LOCATION	RIGHT			
		TYPE:	REFLECTIVE - ZZ		
~	BACKCBOLIND	COLOR:	GREEN		
OLOF	BACKGROUND	TYPE:	-		
00 / :		COLOR:	-		
SHEETING / COLOR		TYPE:	REFLECTIVE - ZZ		
HEE	LEGEND /	COLOR:	WHITE		
S	BORDER	TYPE:	-		
		COLOR:	-		

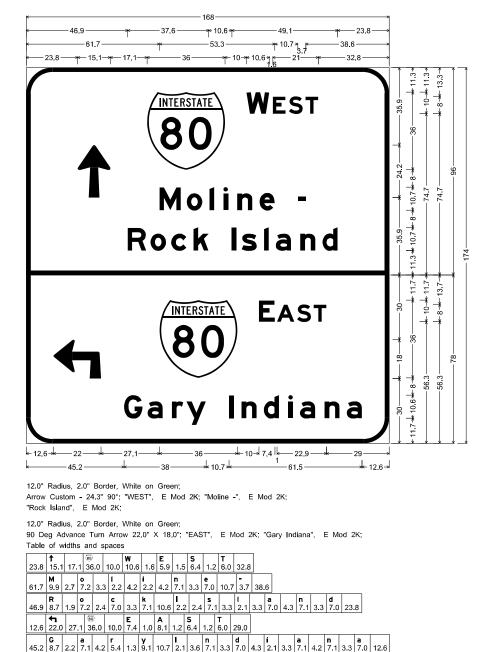

DIMENSIONS ARE IN INCHES TENTHS

Accurate GROUP, INC.

DIMENSIONS ARE IN INCHES TENTHS

JSER NAME = jschumann	DESIGNED - JLS	REVISED -
	DRAWN - JLS	REVISED -
PLOT SCALE = 100.000 ' / in.	CHECKED - AB	REVISED -
PLOT DATE = 4/22/2025	DATE - 4/25/2025	REVISED -

STATE OF ILLINOIS
DEPARTMENT OF TRANSPORTATION

								F.A.I. RTE	SECTION		COUNTY	TOTAL SHEETS	SHEET NO.
			SIGN	I PA	NEL DI	ETAILS		80	FAI 80 21 INTERCHAI	NGE	WILL	1209	502
											CONTRACT	NO. 621	R22
SCALE: NONE	SHEET	11	OF	14	SHEETS	STA.	TO STA.		ILLINOIS	FED. AI	D PROJECT		


1:50

SIGN ID		NB-GM-0211			
STRUCTU	JRE NUMBER	-			
SIZE	EXIT PLAQUE	-			
(W x H)	MAIN PANEL	14'-0" x (	6'-6"		
MOUNTIN	NG / TYPE	GROUND	/ BREAKAWAY		
MOUNTIN	NG LOCATION	LEFT			
		TYPE:	REFLECTIVE - ZZ		
~	DACKEDOLIND	COLOR:	GREEN		
SHEETING / COLOR	BACKGROUND	TYPE:	-		
) C		COLOR:	-		
ING		TYPE:	REFLECTIVE - ZZ		
HEE	LEGEND /	COLOR:	WHITE		
S	BORDER	TYPE:	-		
		COLOR:	-		

## SIGN DETAIL

1:20

SIGN ID		SB-GM-0220		
STRUCTU	JRE NUMBER	-		
SIZE	EXIT PLAQUE	-		
(W x H)	MAIN PANEL	14'-0" x	6'-6"	
IITNUOM	NG / TYPE	GROUND	/ BREAKAWAY	
IITNUOM	NG LOCATION	LEFT		
		TYPE:	REFLECTIVE - ZZ	
~	DACKEROUND	COLOR:	GREEN	
OLOF	BACKGROUND	TYPE:	-	
) / C		COLOR:	-	
NI N		TYPE:	REFLECTIVE - ZZ	
SHEETING / COLOR	LEGEND /	COLOR:	WHITE	
S	BORDER	TYPE:	-	
		COLOR:	-	

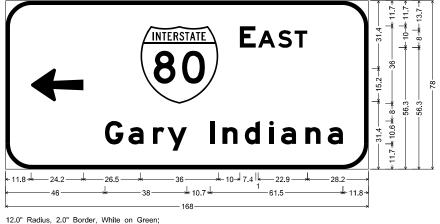


12.0" Radius, 2.0" Border, White on Green;

Arrow Custom - 24.3" 180°; "EAST", E Mod 2K; "Gary Indiana", E Mod 2K;

Table of widths and spaces

	+		(6	0		E		Α		5		т		1								
11.8	24.2	26	.5   3	6.0	10.0	7.4	1.0	8.1	1.2	6.4	1.2	6.0	28.2									
	G		a		r		У		1		n		d		i		а		n		а	
46.0	8.7	2.2	7.1	4.2	5.4	1.3	9.1	10.7	2.1	3.6	7.1	3.3	7.0	4.3	2.1	3.3	7.1	4.2	7.1	3.3	7.0	11.8

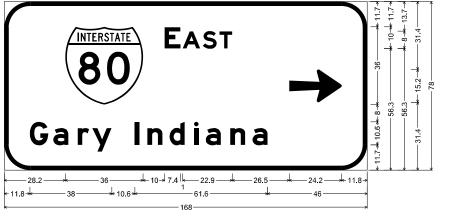

12.0" Radius, 2.0" Border, White on Green;

"EAST", E Mod 2K; "Gary Indiana", E Mod 2K; Arrow Custom - 24.3" 0°;

Table of widths and spaces

	80		E			<b>ا</b> ا	9	5		Т			<b>→</b>		1								
8.2	36.0	10	.0 7	.4 1	1.0 8	3.1	.2 6	3.5	1.2	5.9	26.	5 2	4.2	11.8									
	G		a	Ė	lr.	T	Tv.	T				n		ч	Ī	i		a		n			а
R	8.6	23		43	5.3	. 1 1 2	o 1	1 10	าดไ	22			3.3	7 1	42	22	3.3	7 0	4.3		`	133	3.3 7

DIMENSIONS ARE IN INCHES, TENTHS



USER NAME = jschumann	DESIGNED - JLS	REVISED -
	DRAWN - JLS	REVISED -
PLOT SCALE = 100.000 / in.	CHECKED - AB	REVISED -
PLOT DATE = 4/22/2025	DATE - 4/25/2025	REVISED -


						F.A.I. RTE	SECTION		COUNTY	TOTAL SHEETS	SHEET NO.		
			SIGN	P#	NEL DE	80	FAI 80 21 INTERCHAN	IGE	WILL	1209	503		
											CONTRACT	NO. 621	R22
SCALE: NONE SHEET 12 OF 14 SHEETS STA. TO STA.									ILLINOIS	FED. AII	D PROJECT		


1:50

IGN ID		RA-GM-0	143				
TRUCTU	JRE NUMBER	-					
IZE	EXIT PLAQUE	-					
W x H)	MAIN PANEL	8'-6" x 3'-6"					
	NG / TYPE	GROUND	/ BREAKAWAY				
IOUNTI	NG LOCATION	-					
		TYPE:	REFLECTIVE - ZZ				
~	BACKGROUND	COLOR:	GREEN				
OLOF	BACKGROUND	TYPE:	-				
) /:		COLOR:	-				
SHEETING / COLOR		TYPE:	REFLECTIVE - ZZ				
出	LEGEND /	COLOR:	WHITE				
55	BORDER	TYPE:	-				
		COLOR:	-				

## **SIGN DETAIL**

SIGN ID		NB-GM-0	310					
STRUCTU	JRE NUMBER	-						
SIZE	EXIT PLAQUE	-						
(W x H)	MAIN PANEL	10'-0" x	10'-0" x 10'-0"					
MOUNTII	NG / TYPE	GROUND	/ BREAKWAY					
MOUNTII	NG LOCATION	RIGHT						
		TYPE:	REFLECTIVE - AP					
~	BACKGROUND	COLOR:	GREEN					
SHEETING / COLOR	BACKGROUND	TYPE:	-					
) ) (		COLOR:	-					
NE		TYPE:	REFLECTIVE - AP					
HEE	LEGEND /	COLOR:	WHITE					
S	BORDER	TYPE:	-					
		COLOR:	-					

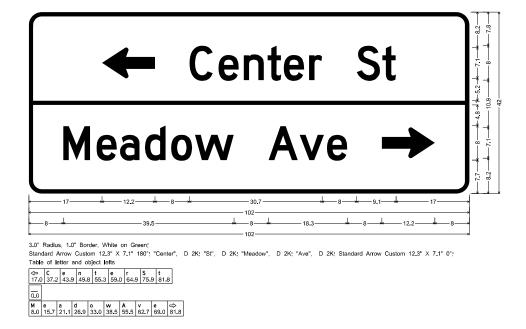

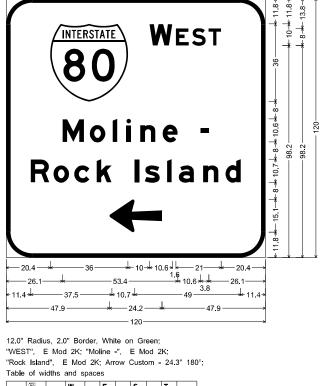

	(80)		W			Ε		s		Т					
20.4	36.0	10.	0 10	0.6	1.6	6.0	1.4	6.5	1.2	5.9	2	0.4			
	М		0		1		i		n			е		-	
26.1	<b>M</b> 10.0	2.6	7.3	3.3	3 2.	1 4.	3 2.	1 4.	3 7.	.0 3	3.3	7.1	10.6	3.8	26.1
	R		0		С		k								
11.4	<b>R</b> 8.6	1.9	7.3	2.3	7.1	3.3	7.0								
		1		s		1		а		n	1		d		]
	10.7	2.1	2.5	7.0	3.	3 2.	1 3.	3 7.	1 4.	3 7	'.0	3.3	7.0	11.4	
	+														
47.9	<b>←</b> 24.2	47.	9												

DIMENSIONS ARE IN INCHES, TENTHS

DIMENSIONS ARE IN INCHES, TENTHS




USER NAME = jschumann	DESIGNED - JLS	REVISED -
	DRAWN - JLS	REVISED -
PLOT SCALE = 100.000 / in.	CHECKED - AB	REVISED -
PLOT DATE = 4/22/2025	DATE - 4/25/2025	REVISED -

I						F.A.I. RTE	SECTION	COUNTY	TOTAL SHEETS	SHEET NO.				
ı				SIGN	PA	NEL DE	TAILS		80	FAI 80 21 INTERCH	ANGE	WILL	1209	504
ļ												CONTRACT	NO. 621	R22
l	SCALE: NONE	SHEET	13	OF	14	SHEETS	STA.	TO STA.	ILLINOIS FED. AID PROJECT					


1:10


SIGN ID		RC-TS-01	.50				
STRUCTU	JRE NUMBER	-					
SIZE	EXIT PLAQUE	-					
(W x H)	MAIN PANEL	6'-6" x 2'-6"					
MOUNTIN	IG / TYPE	GROUND	/ TELESCOPING				
MOUNTIN	IG LOCATION	RIGHT					
		TYPE:	REFLECTIVE - ZZ				
~	BACKGROUND	COLOR:	GREEN				
OLOF	BACKGROUND	TYPE:	-				
) / C		COLOR:	-				
ING		TYPE:	REFLECTIVE - ZZ				
SHEETING / COLOR	LEGEND /	COLOR:	WHITE				
	BORDER	TYPE:	-				
		COLOR:	-				

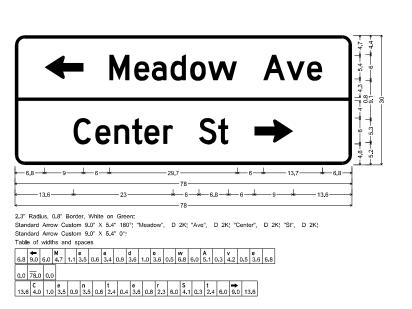

**SIGN DETAIL** 

1:50

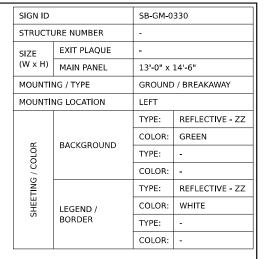

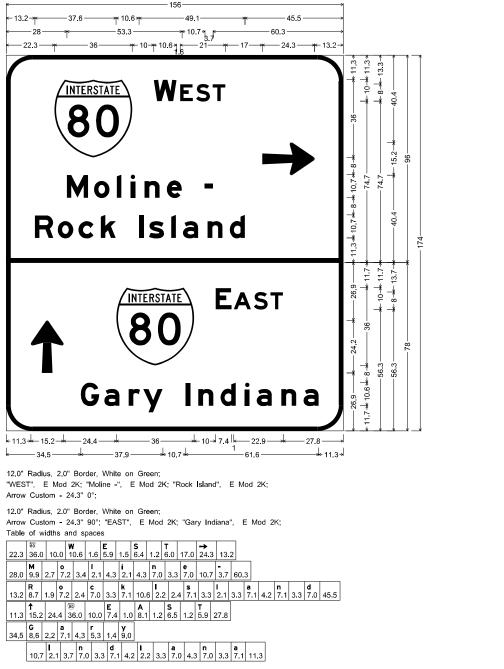

DIMENSIONS ARE IN INCHES.TENTHS

Accurate GROUP. INC.


USER NAME = jschumann	DESIGNED - JLS	REVISED -
	DRAWN - JLS	REVISED -
PLOT SCALE = 100.000 ' / in.	CHECKED - AB	REVISED -
PLOT DATE = 4/24/2025	DATE - 4/25/2025	REVISED -

STATE OF ILLINOIS


DIMENSIONS ARE IN INCHES.TENTHS

	01011				F.A.I. RTE	SECTION	COUNTY	TOTAL SHEETS	SHEET NO.
	SIGN	PANEL DI	HAILS		80	FAI 80 21 INTERCHANGE	WILL	1209	505
							CONTRACT	NO. 62	₹22
SCALE: NONE	SHEET 14 OF	14 SHEETS	STA.	TO STA.		ILLINOIS FED. A	D PROIECT		

**DEPARTMENT OF TRANSPORTATION** 

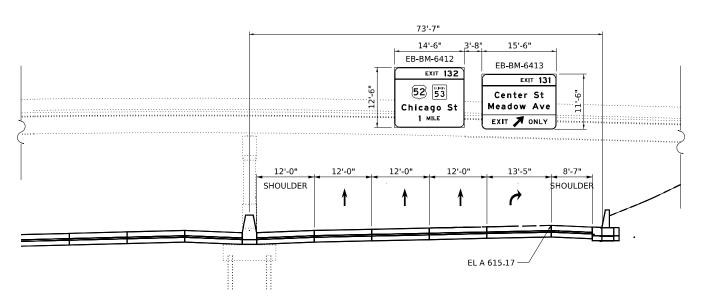

## STRUCTURE 1B099I080R131.6 PROPOSED MOUNTING DETAIL EXISTING OVERHEAD SIGN STRUCTURE - BRIDGE EB I-80, STA. 641+39 (LOOKING EAST)

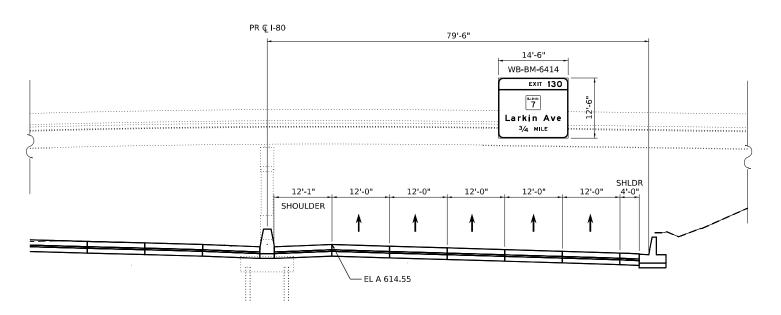


STRUCTURE 1B099I080L131.6
PROPOSED MOUNTING DETAIL
EXISTING OVERHEAD SIGN STRUCTURE - BRIDGE
WB I-80, STA. 641+95
(LOOKING WEST)

USER NAME = jschumann	DESIGNED - JLS	REVISED -
	DRAWN - JLS	REVISED -
PLOT SCALE = 20.000 / in.	CHECKED - AB	REVISED -
PLOT DATE = 6/9/2025	DATE - 4/25/2025	REVISED -

STATE	OF ILLINOIS	
DEPARTMENT C	OF TRANSPORTATION	

	an n	ΛΟL	F.A.I. RTE	SECT	COUNTY TOTA		SHEE NO.						
I-80									FAI 80 21 IN	TERCHANGE	WILL	1209	506
I=00											CONTRACT	Γ NO. 62I	322
SCALE: NONE	SHEET	1	OF	6	SHEETS	STA.	TO STA.	ILLINOIS FED. AID PROJECT					

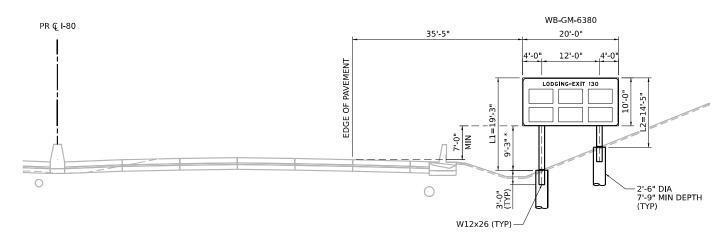


PROPOSED SIGN WB-GM-6380

MOUNTING DETAIL

STRUCTURAL STEEL BREAKAWAY SIGNPOSTS

WB I-80, STA. 638+00

(LOOKING WEST)

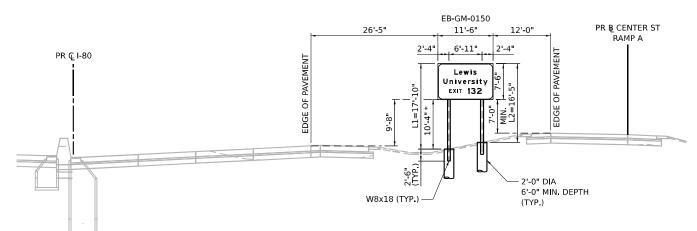


PROPOSED SIGN EB-GM-0150

MOUNTING DETAIL

STRUCTURAL STEEL BREAKAWAY SIGNPOSTS

EB I-80, STA. 15+00

(LOOKING EAST)

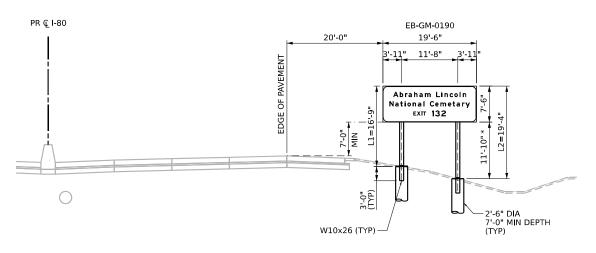

SCALE: NONE

PROPOSED SIGN EB-GM-0190

MOUNTING DETAIL

STRUCTURAL STEEL BREAKAWAY SIGNPOSTS

EB I-80, STA. 19+00


(LOOKING EAST)

NOTE: \* CLEAR HEIGHT


<b>A</b> A	c	C GF	<b>U</b>	r , IN	a c.	t	e	

USER NAME = jschumann	DESIGNED - JLS	REVISED -
	DRAWN - JLS	REVISED -
PLOT SCALE = 20.000 ' / in.	CHECKED - AB	REVISED -
PLOT DATE = 4/22/2025	DATE - 4/25/2025	REVISED -

	SIG	in N	/10U	INTING	DETAILS	F.A.I. RTE	SECT	TION		COUNTY	TOTAL SHEETS	SH I
				I-80		80	FAI 80 21 INTERCHANGE			WILL	1209	
				1-00						CONTRACT	NO. 62	₹2
SHEET	2	OF	6	SHEETS	STA.	TO STA.	ILLINOIS FED. AID			D PROJECT		

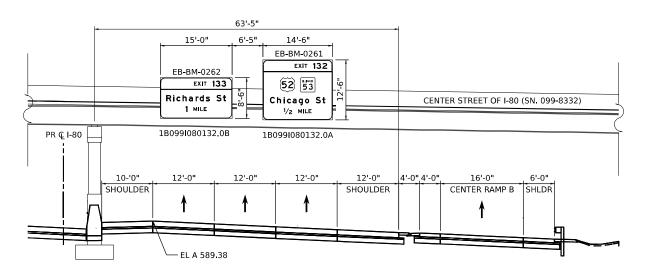

## STRUCTURE 1B099I080132.0 (A & B) MOUNTING DETAIL PROPOSED OVERHEAD SIGN STRUCTURE - BRIDGE EB I-80, STA. 26+95 (LOOKING EAST)

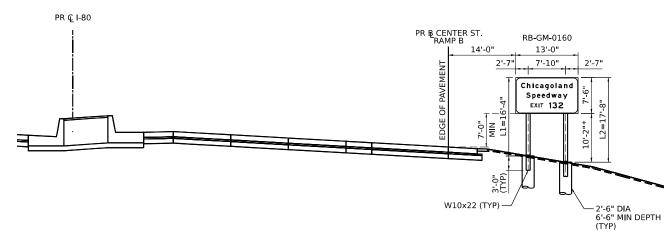

## PROPOSED SIGN RB-GM-0160 MOUNTING DETAIL STRUCTURAL STEEL BREAKAWAY SIGNPOSTS EB I-80 RAMP B, STA. 16+36 (LOOKING EAST)


NOTE: \* CLEAR HEIGHT

Accurate GROUP, INC.
----------------------


USER NAME = jschumann	DESIGNED - JLS	REVISED -
	DRAWN - JLS	REVISED -
PLOT SCALE = 20.000 / in.	CHECKED - AB	REVISED -
PLOT DATE = 6/9/2025	DATE - 4/25/2025	REVISED -

STATI	E OF	ILLINOIS
DEPARTMENT	0F	TRANSPORTATION


	F.A.I. RTE	SEC	COUNTY	TOTAL SHEETS	SHEET NO.									
	I-80	80	80 FAI 80 21 INTERCHANGE			WILL	1209	508						
1-00												CONTRACT	NO. 62	R22
SCALE: NONE	SHEET	3	OF	6	SHEETS	STA.	TO STA.	ILLINOIS FED. AID PRO			ID PROJECT			

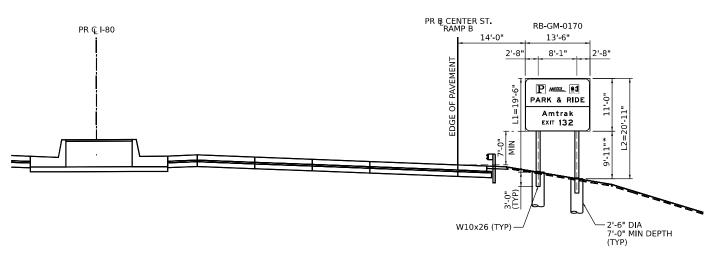

# PROPOSED SIGN RB-GM-0170 MOUNTING DETAIL STRUCTURAL STEEL BREAKAWAY SIGNPOSTS EB I-80 RAMP B, STA. 17+88 (LOOKING EAST)

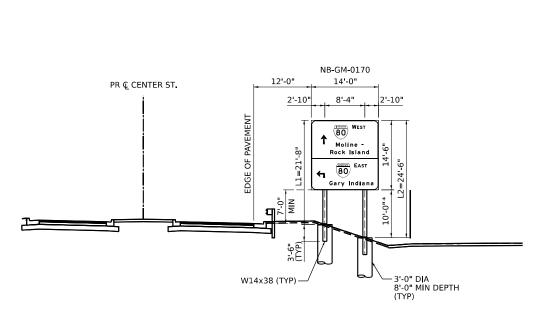

PROPOSED SIGN NB-GM-0170
MOUNTING DETAIL
STRUCTURAL STEEL BREAKAWAY SIGNPOSTS
NB CENTER ST, STA. 17+00
(LOOKING NORTH)

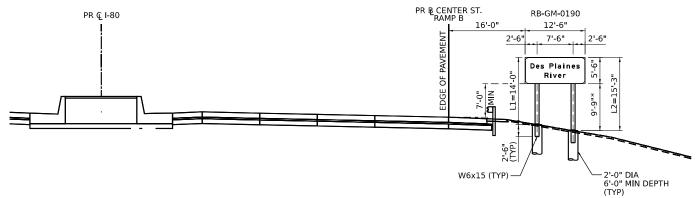

PROPOSED SIGN RB-GM-0190
MOUNTING DETAIL
STRUCTURAL STEEL BREAKAWAY SIGNPOSTS
EB I-80 RAMP B, STA. 19+38
(LOOKING EAST)

NOTE: \* CLEAR HEIGHT


<b>A</b> A	c	C GF	<b>U</b>	r , IN	a c.	t	e	

USER NAME = jschumann	DESIGNED - JLS	REVISED -
	DRAWN - JLS	REVISED -
PLOT SCALE = 20.000 / in.	CHECKED - AB	REVISED -
PLOT DATE = 4/22/2025	DATE - 4/25/2025	REVISED -

STATI	E OI	F ILLINOIS
DEPARTMENT	0F	TRANSPORTATION

SCALE: NONE

	SIG	N N	/IOU	INTING	DETAIL	.S	F.A.I. RTE	SECTION	COUNTY	TOTAL SHEETS	SHEE NO.
		_00	ΛNI	D CENT	ED CT		80	FAI 80 21 INTERCHANGE	WILL	1209	509
1	'	-00	AIN	D CENT	LN 31				CONTRACT	NO. 621	R22
SHEET	4	OF	6	SHEETS	STA.	TO STA.		ILLINOIS FE	ED. AID PROJECT		

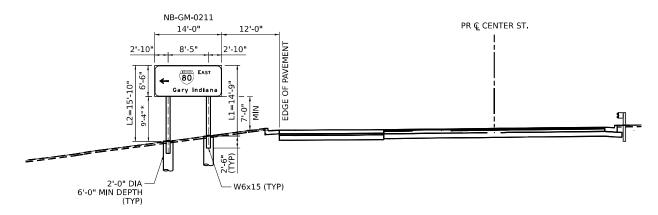


PROPOSED SIGN NB-GM-0211

MOUNTING DETAIL

STRUCTURAL STEEL BREAKAWAY SIGNPOSTS

NB CENTER ST, STA. 21+86

(LOOKING NORTH)

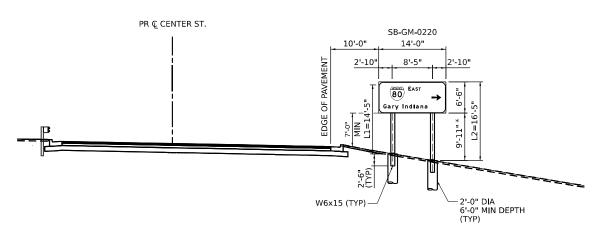

PROPOSED SIGN SB-GM-0220

MOUNTING DETAIL

STRUCTURAL STEEL BREAKAWAY SIGNPOSTS

SB CENTER ST, STA. 22+44

(LOOKING SOUTH)

NOTE: \* CLEAR HEIGHT




USER NAME = jschumann	DESIGNED - JLS	REVISED -
	DRAWN - JLS	REVISED -
PLOT SCALE = 20.000 / in.	CHECKED - AB	REVISED -
PLOT DATE = 6/9/2025	DATE - 4/25/2025	REVISED -

STATE OF	ILLINOIS
DEPARTMENT OF	TRANSPORTATION

SCALE: NONE

	SIC	GN I	viol	INTING	DETAILS		F.A.I. RTE	SEC	TION		COUNTY	TOTAL SHEETS	SHEET NO.
			CER	NTER S	г		80	FAI 80 21 IN	TERCHAI	NGE	WILL	1209	510
			ULI	VILII 3							CONTRACT	NO. 62	R22
SHEET	5	OF	6	SHEETS	STA.	TO STA.			ILLINOIS	FED. A	AID PROJECT		

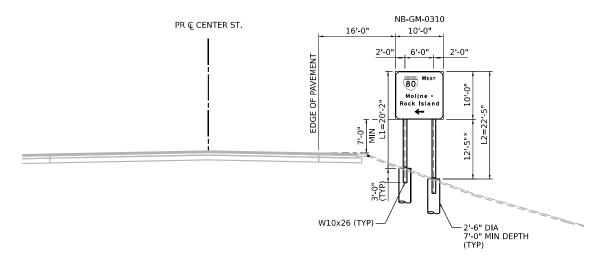


PROPOSED SIGN NB-GM-0310

MOUNTING DETAIL

STRUCTURAL STEEL BREAKAWAY SIGNPOSTS

NB CENTER ST, STA. 31+00

(LOOKING NORTH)

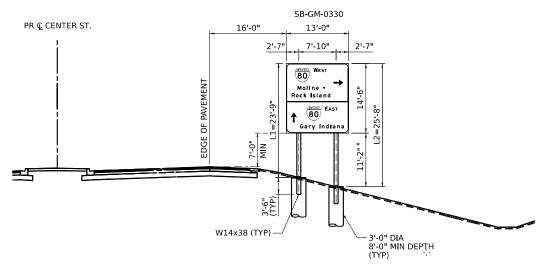

PROPOSED SIGN SB-GM-0330

MOUNTING DETAIL

STRUCTURAL STEEL BREAKAWAY SIGNPOSTS

SB CENTER ST, STA. 33+85

(LOOKING SOUTH)

SCALE: NONE


NOTE: \* CLEAR HEIGHT

A	c	C GF	<b>U</b>	r , In	a c.	t	e	

USER NAME = jschumann	DESIGNED - JLS	REVISED -
	DRAWN - JLS	REVISED -
PLOT SCALE = 20.000 / in.	CHECKED - AB	REVISED -
PLOT DATE = 6/9/2025	DATE - 4/25/2025	REVISED -

STATE OF ILLINOIS	
DEPARTMENT OF TRANSPORTATION	


	SIG	an r	viol	JNTING	DETAILS		F.A.I. RTE	SEC	TION		COUNTY	TOTAL SHEETS	SHEET NO.
			CE	NTER S	т		80	FAI 80 21 IN	TERCHAN	IGE	WILL	1209	511
			UL	WILL 3	•						CONTRACT	NO. 62	R22
ET	6	OF	6	SHEETS	STA.	TO STA.			ILLINOIS	FED. AI	D PROJECT		

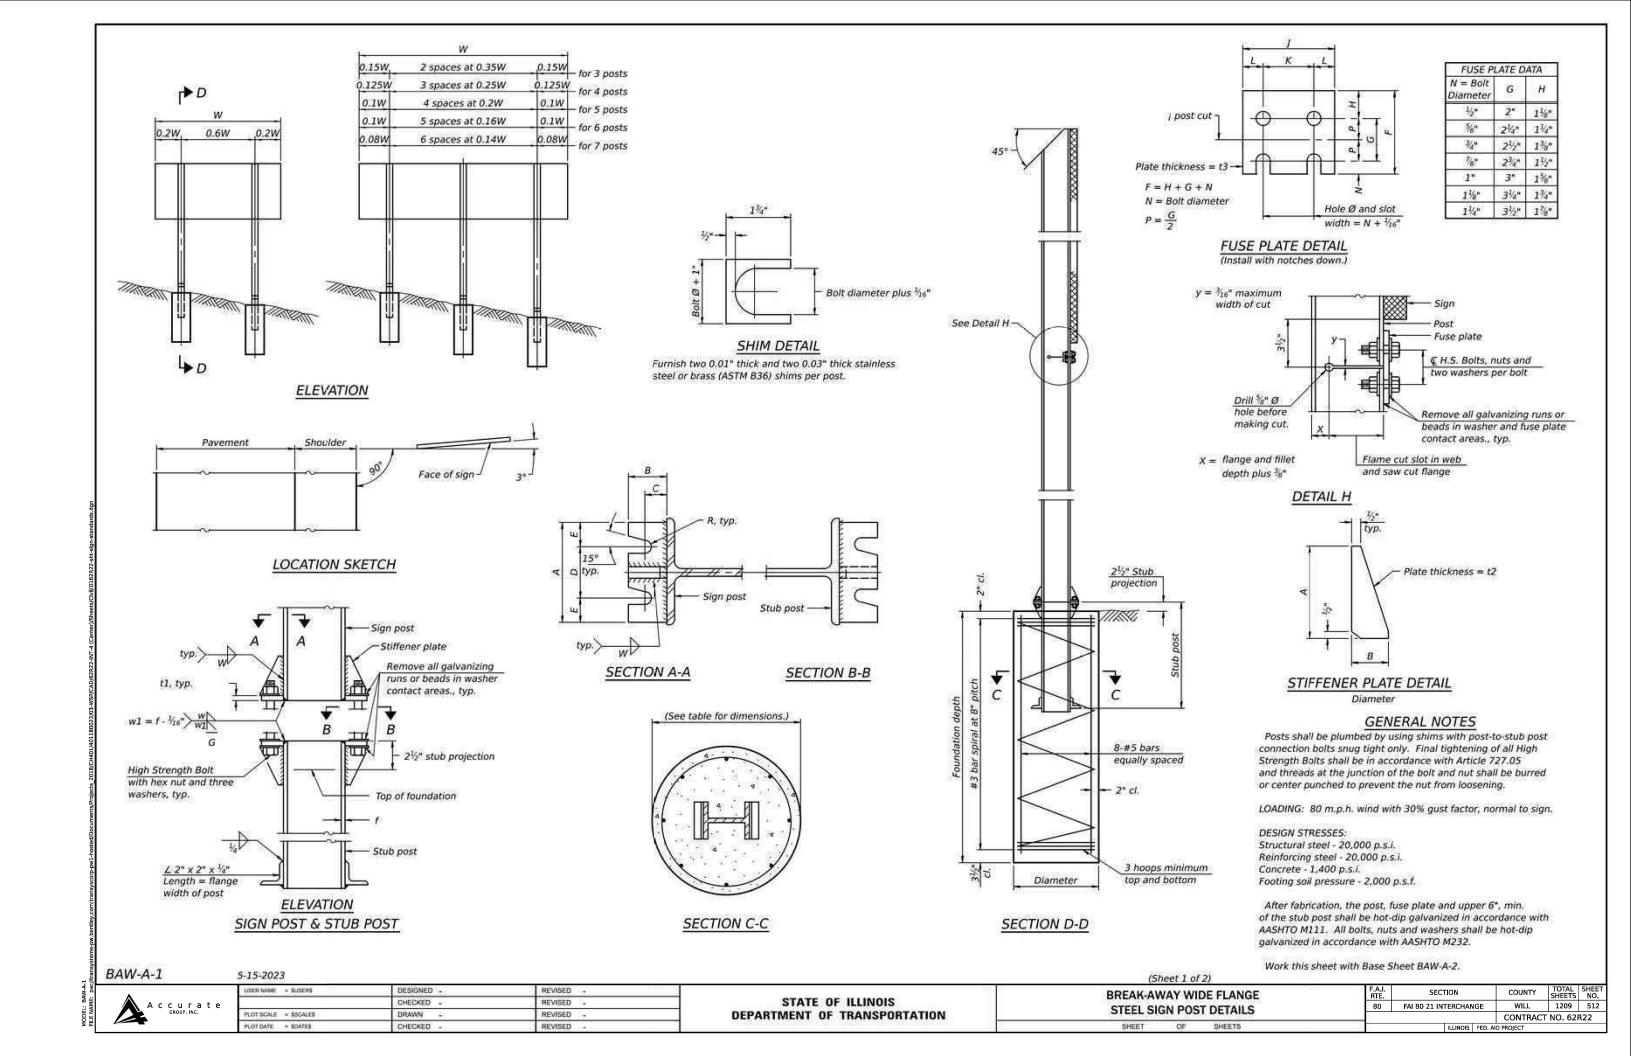

			CONC	CRETE FOUNDA	TION TABL	E				PC	OST TO	STUB I	POST C	ONNEC	TION D	ATA			FUSE PLATE DATA			
POST		Foundation	on	Reinforcement				Stub Post														i
1 , 03,	Diameter	*Minimum	Concrete(1)	Vertical Bars	Bar S		Ibs. (2)	Length	Bolt Size	Α	В	С	D	Ε	t1	t2	R	W	Ĵ	K	L	t3
	Diameter	Depth	cu. yds.)	Length	Diameter	Length	(a)	Length														
W6x9	2'-0"	6'-0"	0.70	5'-9"	1'-8½"	79'-0"	78	2'-3"	5⁄8" x 3 <sup>1</sup> ⁄4"	6"	21/4"	11/4"	3½"	11/4"	3/4"	1/2"	11/ <sub>32</sub> "	1∕4"	4"	21/4"	7∕8"	1/4"
W6x15	2'-0"	6'-0"	0.70	5'-9"	1'-8½"	79'-0"	78	2'-6"	5⁄8" x 3 <sup>1</sup> ⁄4"	6"	21/4"	11/4"	<i>3</i> ½"	11/4"	3/4"	1/2"	11/32"	1/4"	6"	3½"	1½"	3/8"
W8x18	2'-0"	6'-0"	0.70	5'-9"	1'-8½"	79'-0"	78	2'-6"	<sup>3</sup> / <sub>4</sub> " x 3 <sup>3</sup> / <sub>4</sub> "	6"	2½"	1¾"	31/4"	13/8"	1"	1/2"	13/ <sub>32</sub> "	<i>⁵</i> ⁄16"	51/4"	2¾"	1½"	3/8"
W10x22	2'-6"	6'-6"	1.18	6'-3"	2'-2½"	105'-0"	92	3'-0"	<sup>3</sup> / <sub>4</sub> " x 3 <sup>3</sup> / <sub>4</sub> "	6"	2½"	13/8"	31/4"	13/8"	1"	1/2"	13/ <sub>32</sub> "	5∕16"	5 <sup>3</sup> / <sub>4</sub> "	2¾"	1½"	1/2"
W10x26	2'-6"	7'-0"	1.27	6'-9"	2'-2½"	112'-0"	98	3'-0"	7⁄8" x 4"	7"	23/4"	1½"	4"	1½"	1"	3/4"	15/ <sub>32</sub> "	3/8"	5¾"	2¾"	1½"	5/8"
W12x26	2'-6"	7'-9"	1.41	7'-6"	2'-2½"	119'-0"	107	3'-0"	<sup>7</sup> ⁄ <sub>8</sub> " x 4"	7"	23/4"	1½"	4"	1½"	1"	3/4"	15/ <sub>32</sub> "	3/8"	6½"	3½"	1½"	5/8"
W14x30	3'-0"	7'-3"	1.90	7'-0"	2'-8½"	145'-0"	113	3'-0"	<sup>7</sup> ⁄8" x 4"	7"	23/4"	1½"	4"	1½"	1"	3/4"	15/ <sub>32</sub> "	3/8"	6¾"	3½"	15/8"	1/2"
W14x38	3'-0"	8'-0"	2.09	7'-9"	2'-8½"	153'-0"	122	3'-6"	1" x 4½"	7½"	3"	13/4"	4"	1¾"	11/4"	3/4"	17/ <sub>32</sub> "	3/8"	6 <sup>3</sup> / <sub>4</sub> "	3½"	15/8"	1/2"
W16x45	3'-0"	8'-6"	2.23	8'-3"	2'-8½"	162'-0"	130	3'-6"	1" x 4½"	7½"	3"	13/4"	4"	13/4"	11/4"	3/4"	17/32"	3/8"	7"	3½"	13/4"	1/2"

<sup>\*</sup>Dimensional changes required for varying site conditions shall be approved by the Engineer.

												ATE BOLT	SIZE								
POST				,							Si	gn Height									
	4'-0"	5'-0"	6'-0"	7'-0"	8'-0"	9'-0"	10'-0"	11'-0"	12'-0"	13'-0"	14'-0"	15'-0"	16'-0"	17'-0"	18'-0"	19'-0"	20'-0"	21'-0"	22'-0"	23'-0"	24'-0"
W6x9	½" x 1½"	½" x 1½"	½" x 1½"	½" x 1½"																	
W6x15	½" x 1¾"	½" x 1¾"	½" x 1¾"	5⁄8" x 2"	5⁄8" x 2"	<sup>3</sup> / <sub>4</sub> " x 2"	<sup>3</sup> / <sub>4</sub> " x 2"	<sup>3</sup> / <sub>4</sub> " x 2"	<sup>3</sup> / <sub>4</sub> " x 2"												
W8x18	½" x 1¾"	½" x 1¾"	½" x 1¾"	½" x 1¾"	5⁄8" x 2"	5⁄8" x 2"	<sup>3</sup> / <sub>4</sub> " x 2"	<sup>3</sup> / <sub>4</sub> " x 2"	<sup>3</sup> ⁄ <sub>4</sub> " x 2"	<sup>3</sup> ⁄ <sub>4</sub> " x 2"				.——							
W10x22	½" x 2"	½" x 2"	½" x 2"	½" x 2"	½" x 2"	5/8" x 2"	5⁄8" x 2"	3/4" x 2 <sup>1</sup> /4"	3/4" x 2 <sup>1</sup> /4"	3/4" x 2 <sup>1</sup> /4"	3/4" x 21/4"	<sup>3</sup> / <sub>4</sub> " x 2 <sup>1</sup> / <sub>4</sub> "	3/4" x 2 <sup>1</sup> /4"								
W10x26	½" x 2"	½" x 2"	½" x 2"	½" x 2"	½" x 2"	5/8" x 21/4"	5⁄8" x 2 <sup>1</sup> ⁄4"	3/4" x 2 <sup>1</sup> / <sub>2</sub> "	3/4" x 2 <sup>1</sup> / <sub>2</sub> "	3/4" x 2 <sup>1</sup> /2"	3/4" x 21/2"	<sup>3</sup> / <sub>4</sub> " x 2 <sup>1</sup> / <sub>2</sub> "	<sup>3</sup> / <sub>4</sub> " x 2 <sup>1</sup> / <sub>2</sub> "	<sup>3</sup> / <sub>4</sub> " x 2 <sup>1</sup> / <sub>2</sub> "							
W12x26	½" x 2"	½" x 2"	½" x 2"	½" x 2"	½" x 2"	5/8" x 2 <sup>1</sup> /4"	5⁄8" x 2 <sup>1</sup> ⁄4"	<sup>3</sup> / <sub>4</sub> " x 2 <sup>1</sup> / <sub>2</sub> "	3/4" x 2 <sup>1</sup> /2"	3/4" x 2 <sup>1</sup> /2"	3/4" x 21/2"	3/4" x 2 <sup>1</sup> / <sub>2</sub> "	3/4" x 2 <sup>1</sup> /2"	<sup>3</sup> / <sub>4</sub> " x 2 <sup>1</sup> / <sub>2</sub> "	<sup>3</sup> / <sub>4</sub> " x 2 <sup>1</sup> / <sub>2</sub> "						
W14x30	½" x 2"	½" x 2"	½" x 2"	½" x 2"	½" x 2"	5⁄8" x 2"	5⁄8" x 2"	3/4" x 2 <sup>1</sup> /4"	<sup>3</sup> / <sub>4</sub> " x 2 <sup>1</sup> / <sub>4</sub> "	<sup>3</sup> / <sub>4</sub> " x 2 <sup>1</sup> / <sub>4</sub> "	$\frac{3}{4}$ " x $2\frac{1}{4}$ "	$\frac{3}{4}$ " x $2\frac{1}{4}$ "	<sup>3</sup> / <sub>4</sub> " x 2 <sup>1</sup> / <sub>4</sub> "	<sup>3</sup> / <sub>4</sub> " x 2 <sup>1</sup> / <sub>4</sub> "	<sup>3</sup> / <sub>4</sub> " x 2 <sup>1</sup> / <sub>4</sub> "	<sup>3</sup> / <sub>4</sub> " x 2 <sup>1</sup> / <sub>4</sub> "	<sup>3</sup> / <sub>4</sub> " x 2 <sup>1</sup> / <sub>4</sub> "				
W14x38	½" x 2"	½" x 2"	½" x 2"	½" x 2"	½" x 2"	5/8" x 2 <sup>1</sup> / <sub>4</sub> "	5⁄8" x 2 <sup>1</sup> ⁄4"	3/4" x 2 <sup>1</sup> / <sub>2</sub> "	3/4" x 2 <sup>1</sup> / <sub>2</sub> "	3/4" x 2 <sup>1</sup> /2"	3/4" x 2 <sup>1</sup> / <sub>2</sub> "	<sup>7</sup> ⁄ <sub>8</sub> " x 2 <sup>1</sup> ∕ <sub>2</sub> "	<sup>7</sup> ⁄ <sub>8</sub> " x 2 <sup>1</sup> ∕ <sub>2</sub> "	1" x 2¾"	1" x 2¾"	1" x 2¾"	1" x 2¾"	1" x 2¾"	1" x 2¾"	1" x 2¾"	1" x 2¾"
W16x45		½" x 2"	½" x 2"	½" x 2"	½" x 2"	½" x 2"	½" x 2"	5/8" x 2 <sup>1</sup> / <sub>4</sub> "	5/8" x 2 <sup>1</sup> / <sub>4</sub> "	5/8" x 2 <sup>1</sup> / <sub>4</sub> "	3/4" x 2 <sup>1</sup> / <sub>2</sub> "	3/4" x 21/2"	½" x 2½"	<sup>7</sup> / <sub>8</sub> " x 2 <sup>1</sup> / <sub>2</sub> "	<sup>7</sup> ⁄ <sub>8</sub> " x 2 <sup>1</sup> ⁄ <sub>2</sub> "	1" x 23/4"	1" x 23/4"	1" x 2 <sup>3</sup> / <sub>4</sub> "	1" x 2¾"	1" x 2¾"	1" x 2¾"

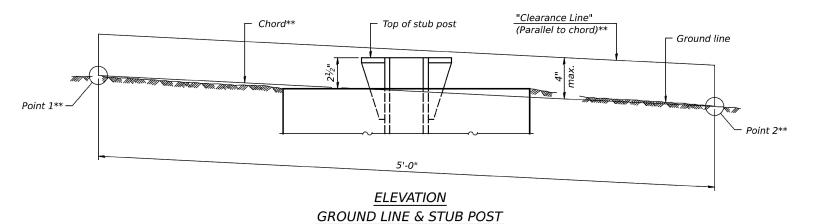

\*\* For all "Point 1" and "Point 2" locations, "Clearance Line" must be at or above top of stub post.

- Quantity includes all concrete necessary for one foundation.
- 2 Includes reinforcement bars and spiral hooping for one foundation.

BAW-A-2

5-15-2023

Accurate GROUP, INC.

USER NAME = \$USER\$	DESIGNED -	REVISED -
	CHECKED -	REVISED -
PLOT SCALE = \$SCALE\$	DRAWN -	REVISED -
PLOT DATE = \$DATE\$	CHECKED -	REVISED -

STATE OF ILLINOIS
DEPARTMENT OF TRANSPORTATION

(Sh	eet 2 of	2)	
		DE FLANGE	
STEEL SIG	an POS	ST TABLES	
CHEET	OF	CHEETC	

SHEET INTENTIONALLY LEFT BLANK

Accurate GROUP, INC.

USER NAME = jschumann	DESIGNED - AK	REVISED -
	DRAWN - AK	REVISED -
PLOT SCALE = 100.000 / in.	CHECKED - AB	REVISED -
PLOT DATE = 6/11/2025	DATE - 4/25/2025	REVISED -

STATE OF ILLINOIS DEPARTMENT OF TRANSPORTATION

						F.A.I. RTE	SECTION		COUNTY	TOTAL SHEETS	SHEET NO.
			I-80			80	FAI 80 21 INTERCHAN	GE	WILL	1209	514
			1-00						CONTRACT	NO. 62F	R22
ALE:	SHEET	OF	SHEETS	STA.	TO STA.		ILLINOIS	FED. AIC	PROJECT		


SHEET INTENTIONALLY LEFT BLANK

Accurate


USER NAME = jschumann	DESIGNED - AK	REVISED -
	DRAWN - AK	REVISED -
PLOT SCALE = 100.000 ' / in.	CHECKED - AB	REVISED -
PLOT DATE = 6/11/2025	DATE - 4/25/2025	REVISED -

STATE OF ILLINOIS DEPARTMENT OF TRANSPORTATION

						F.A.I. RTE	SECT	ION		COUNTY	TOTAL SHEETS	SHEET NO.
			I-80			80	FAI 80 21 INT	TERCHAN	IGE	WILL	1209	515
			1-00							CONTRAC	Γ NO. 62	R22
SCALE:	SHEET	OF	SHEETS	STA.	TO STA.			ILLINOIS	FED. All	D PROJECT		

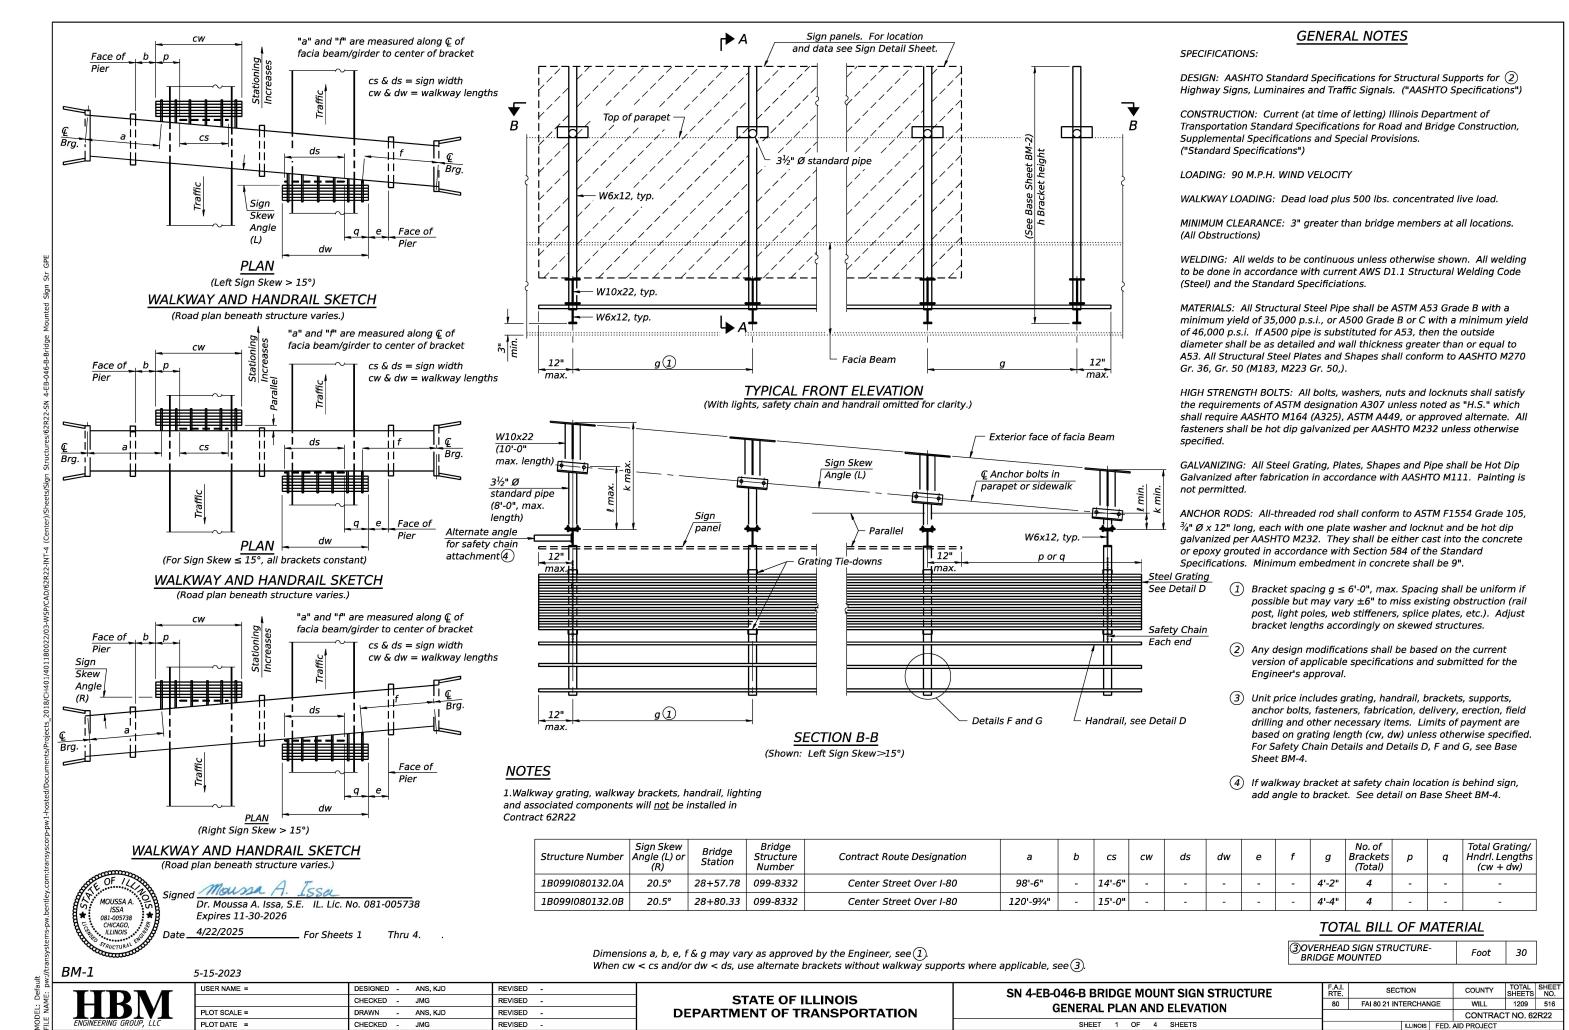

4/24/2025 2:12:49 PI

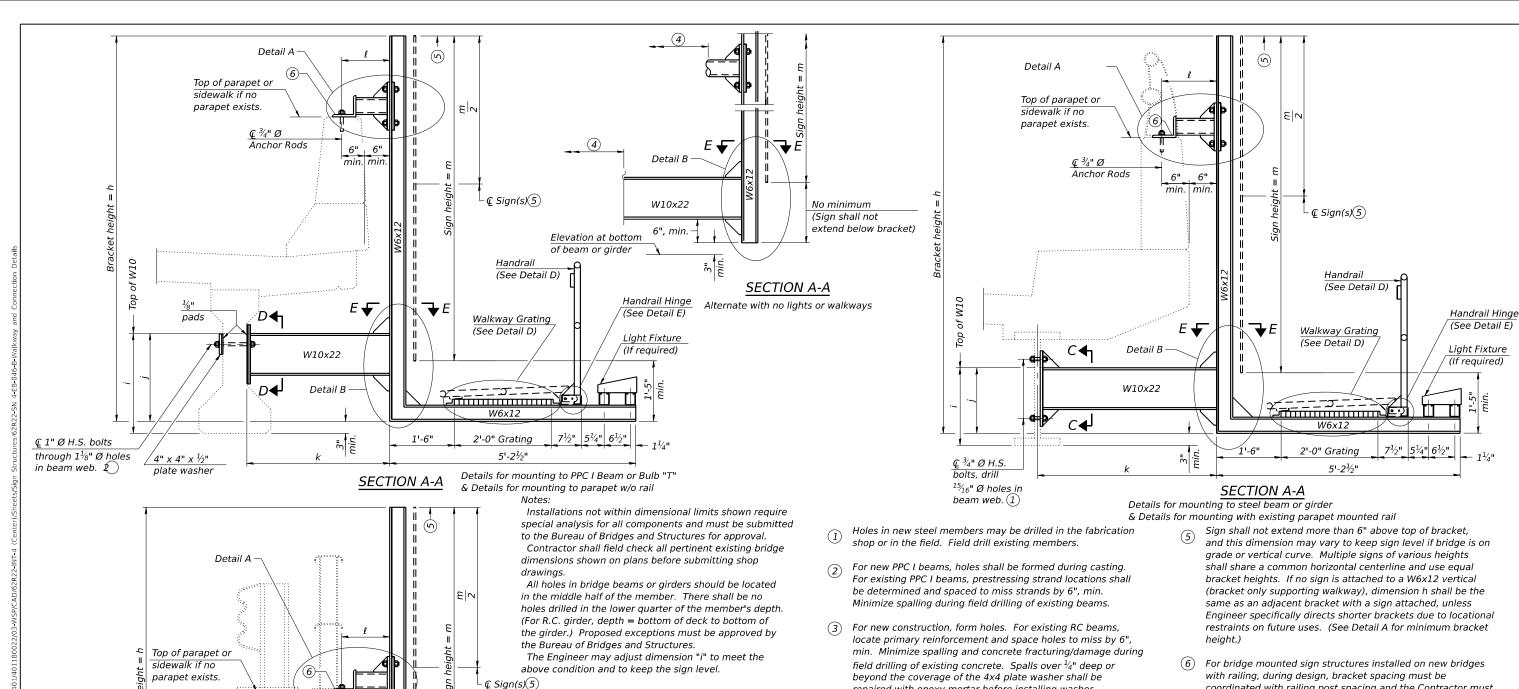

beyond the coverage of the 4x4 plate washer shall be repaired with epoxy mortar before installing washer.

For attachment details of  $3\frac{1}{2}$ " pipe and W10x22, see other sections as applicable.

## *NOTES:*

- 1. Walkway grating, walkway brackets, handrail, lighting, and associated components of the sign structure/sign panel will not be installed.
- coordinated with railing post spacing and the Contractor must install upper brackets prior to railing installation. For bridge mounted sign structures installed on existing bridges with railing, during design, brackets spacing must be coordinated with railing post spacing and the Contractor must temporarily remove sections of railing to facilitate upper bracket installation. If it is determined during design that existing railings can't be removed, alternate upper connection details must be developed for the contract plans and approved by the Bureau of Bridges and Structures.

\*  $i = 2'-7\frac{3}{8}$ " for 1B099I080132.0A at north bracket above splice plate

k max. Structure Number Station (15'-0" (10'-0" max.) (8'-0" max.) max.) 1B099I080132.0A 28+57.78 12'-6" \*2'-5" 1'-5" 8'-61/4" 5'-8½" 12'-6" 8'-6" 1B099I080132.0B 28+80.33 8'-6" 2'-6" 1'-5" 8'-81/2" 5'-10%"

5-15-2023

through  $1\frac{1}{8}$ " Ø holes

(3) **©** 1" Ø H.S. bolts

in girder.

USER NAME = DESIGNED - ANS, KJD REVISED CHECKED - JMG REVISED ANS, KJD REVISED CHECKED -JMG REVISED

Ç ¾" Ø

pads

′4" x 4" x ½"

plate washer

Anchor Rods

Detail B

W10x22

Handrail

H<u>andrail Hinge</u>

(See Detail E)

Walkway Grating

W6x12

5'-2½"

2'-0" Grating

SECTION A-A

Details for mounting to integral reinforced concrete girder & Details for mounting on safety curb with surface-mount bridge rail

(See Detail D)

(See Detail D)

**STATE OF ILLINOIS DEPARTMENT OF TRANSPORTATION** 

For Details A & B, Sections C-C, D-D

For Details D & E, see Base Sheet BM-4.

and E-E, see Base Sheet BM-3.


Light Fixture


(If required)

7½" 5¼" 6½" - 1¼"

SN 4-EB-046-B BRIDGE MOUNT SIGN STRUCTURE WALKWAY AND CONNECTION DETAILS SHEET 2 OF 4 SHEETS

SECTION COUNTY 80 FAI 80 21 INTERCHANGE WILL 1209 517 CONTRACT NO. 62R22

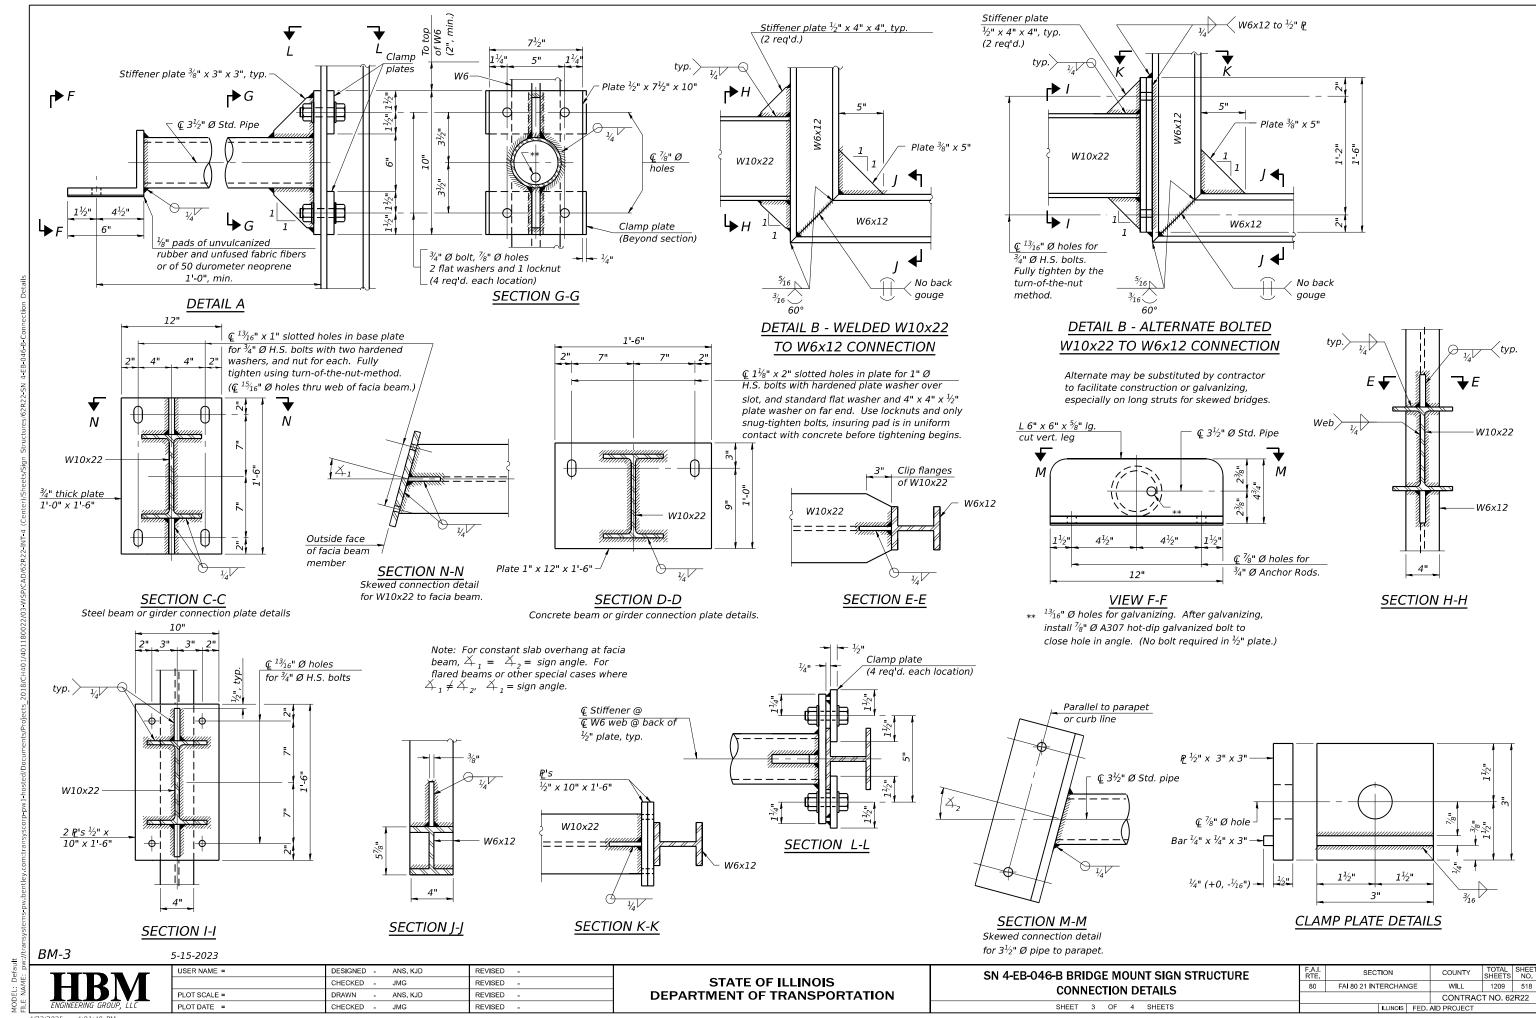


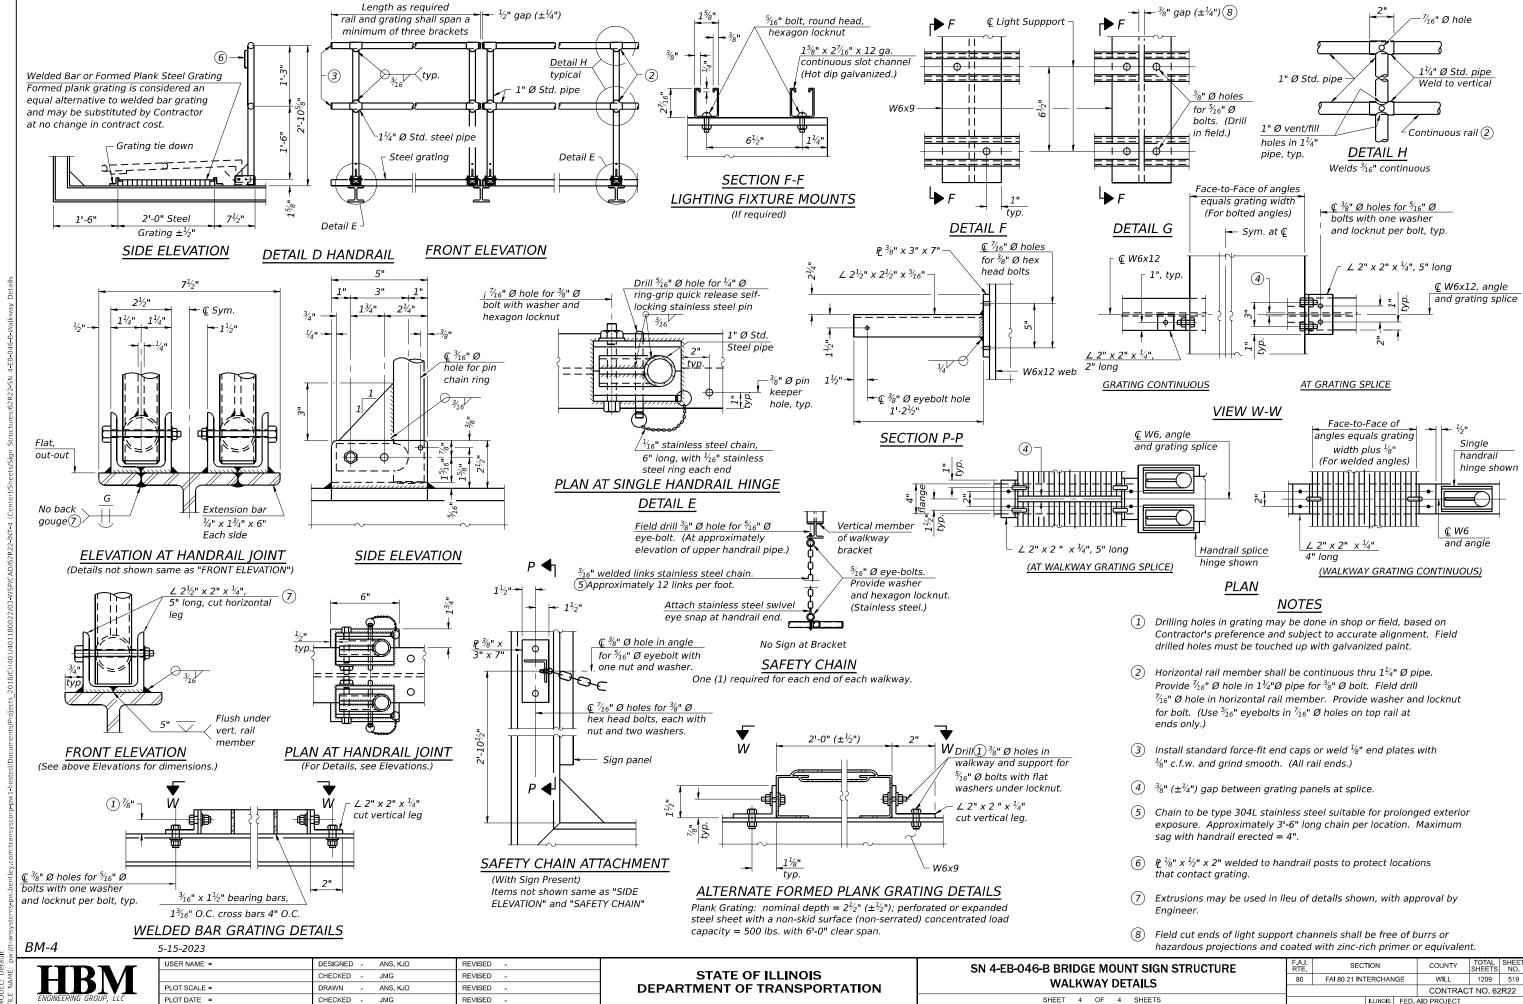

4/22/2025 4:01:44 PM

## **LANDSCAPING SCHEDULE**

		COMPOST FURNISH AND PLACE, 2"	TOPSOIL EXCAVATION AND PLACEMENT	SEEDING, CLASS 1A	SEEDING, CLASS 1B	SEEDING, CLASS 2A	SEEDING, CLASS 4	SEEDING, CLASS 4B	NITROGEN FERTILIZER NUTRIENT	POTASSIUM FERTILIZER NUTRIENT	EROSION CONTROL BLANKET	VINE-PARTHENOCISSUS QUINQUEELOIA ENGEL MANNII (ENGELMANNI VIRGINIA CREEPER), 1-GALLON POT	COARSE SAND PLACEMENT, 2"
LOCATION	STATION	SQ YD	CU YD	ACRE	ACRE	ACRE	ACRE	ACRE	POUND	POUND	SQ YD	EACH	SQ YD
I-80 MAINLINE	STATION 621+00 TO STATION 633+00	17	19	0	0.03	0	0.26	0.03	29	29	1549	75	1404
I-80 MAINLINE	STATION 633+00 TO STATION 12+00.00	191	264	0	1.16	0.34	2.44	0.48	398	398	21393	859	14133
I-80 MAINLINE	STATION 12+00.00 TO STATION 26+00.00	237	499	0	0.43	5.66	1.46	0.80	752	752	40414	1068	10938
I-80 MAINLINE	STATION 26+00.00 TO STATION 39+00.00	121	575	0	3.69	2.90	0.30	2.74	867	867	46609	544	14714
CENTER ST	STATION 11+00.00 TO STATION 26+00.00	15	285	0	0.78	2.77	1.00	0.22	429	429	23087	69	5905
CENTER ST	STATION 33+00.00 TO STATION 43+00.00	134	402	0	0.89	2.96	2.62	0.25	605	605	32525	603	13891
MARKET ST	STATION 800+16 TO STATION 803+29	0	13	0.21	0.00	0.00	0.00	0.00	19	19	1016	0	0
ILLINOIS ST	STATION 900+36 TO STATION 902+11	0	10	0.17	0.00	0.00	0.00	0.00	15	15	823	0	0
S RAYNOR AVE	STATION 1000+37 TO STATION 1001+90	0	5	0.09	0.00	0.00	0.00	0.00	8	8	436	0	0
COCHRANE AV	STATION 1009+00 TO STATION 1013+00	0	9	0.15	0.00	0.00	0.00	0.00	14	14	726	0	0
JASPER ST	STATION 2000+00 TO STATION 2002+00	0	7	0.12	0.00	0.00	0.00	0.00	11	11	581	0	0
	TOTAL	715	2088	0.75	7.00	14.75	8.25	4.75	3146	3146	169158	3218	60984

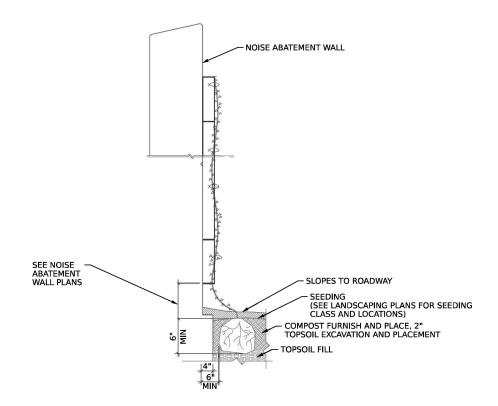

**VINE DETAIL** 

SCALE: NONE

## Accurate GROUP, INC.


USER NAME = jschumann	DESIGNED - AK	REVISED -
	DRAWN - AK	REVISED -
PLOT SCALE = 100.000 ' / in.	CHECKED - AB	REVISED -
PLOT DATE = 4/23/2025	DATE - 4/25/2025	REVISED -


## STATE OF ILLINOIS DEPARTMENT OF TRANSPORTATION


LAN	LANDSCAPING NOTES AND DETAILS						F.A.I. SECTION COUNTY				TOTAL SHEETS	SHEET NO.	
I-80					80	FAI 80 21 INTERCHANG	WILL	1209	520				
				1-00							CONTRACT	NO. 62	R22
SHEET	1	OF	1	SHEETS	STA.		TO STA.		ILLIMOIS	EED AI	DECT		


## **LANDSCAPING NOTES:**


- 1. VILLAGE WATER AND SEWER MAINS MAY BE LOCATED IN THE LANDSCAPE AREA. THE CONTRACTOR SHALL NOT BE ALLOWED TO PROCEED WITH ANY PLANTING WORK UNTIL ALL UTILITY OWNERS FIELD LOCATE THEIR FACILITIES WHICH MAY INTERFERE WITH CONSTRUCTION OPERATIONS. THE ACTUAL LOCATION OF PROPOSED LANDSCAPING WILL BE ADJUSTED IN THE FIELD TO AVOID UTILITIES.
- UNDERBRUSH OR DEBRIS AT PLANTING LOCATIONS SHALL BE REMOVED AND DISPOSED OF ACCORDING TO SECTION 201 OF THE STANDARD SPECIFICATIONS. THIS WORK WILL NOT BE PAID FOR SEPARATELY, BUT THE COSTS SHALL BE CONSIDERED AS INCLUDED IN THE CONTRACT UNIT PRICES FOR THE CONSTRUCTION ITEMS INVOLVED, AND NO ADDITIONAL COMPENSATION WILL BE ALLOWED.
- 3. THE CONTRACTOR SHALL PROCURE ALL VINE PLANTINGS WITHIN 4 WEEKS OF AWARD OF CONTRACT TO ENSURE THAT THERE WILL BE ADEQUATE QUANTITIES AVAILABLE FOR PLANTING SEASON.
- 4. VINES SHALL BE PLANTED ON BOTH SIDES OF THE NOISE ABATEMENT WALLS WHERE POSSIBLE.

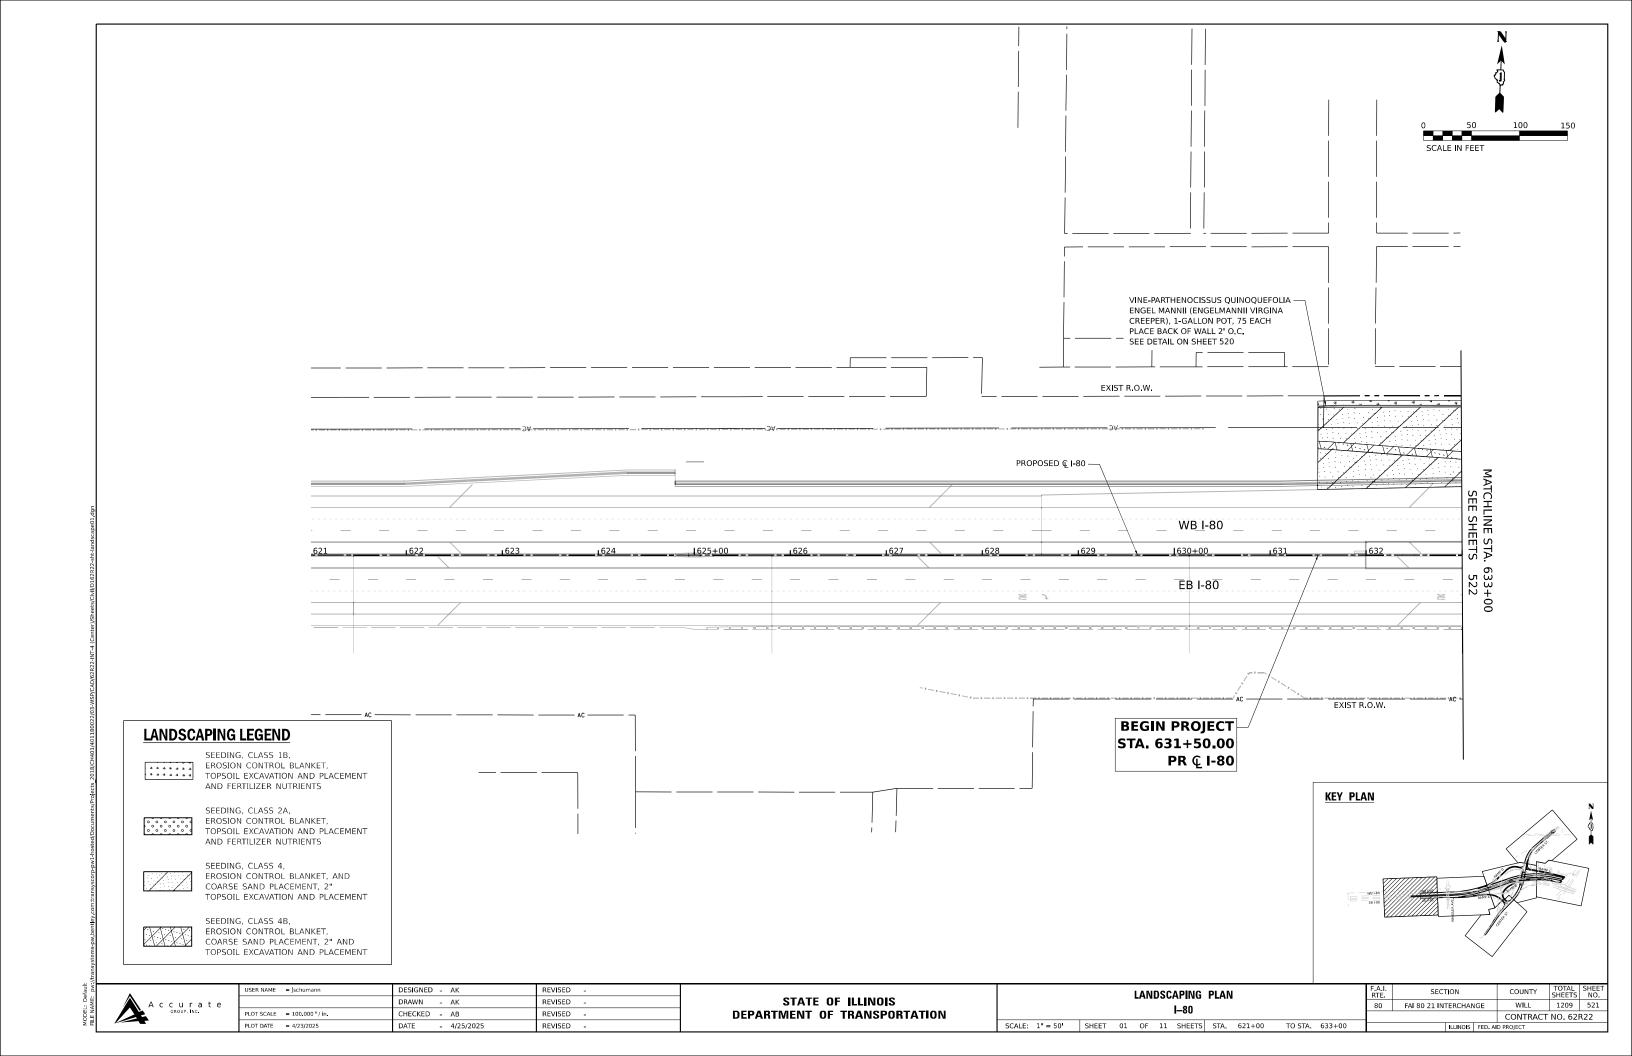

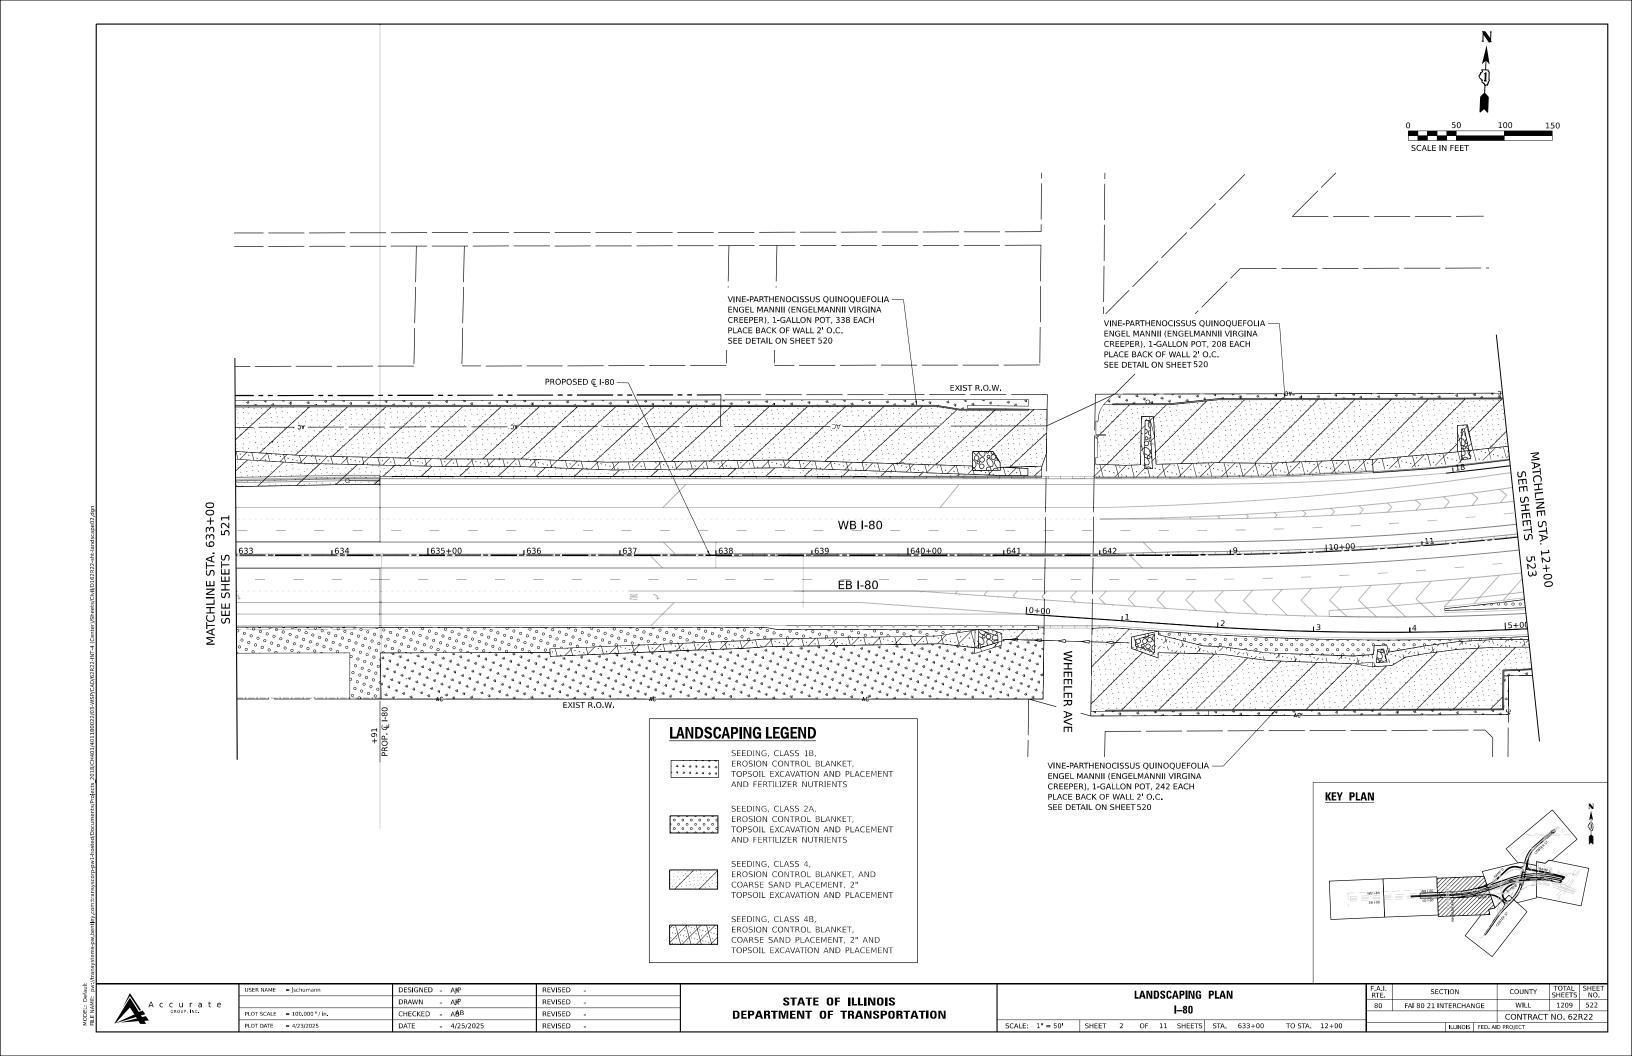

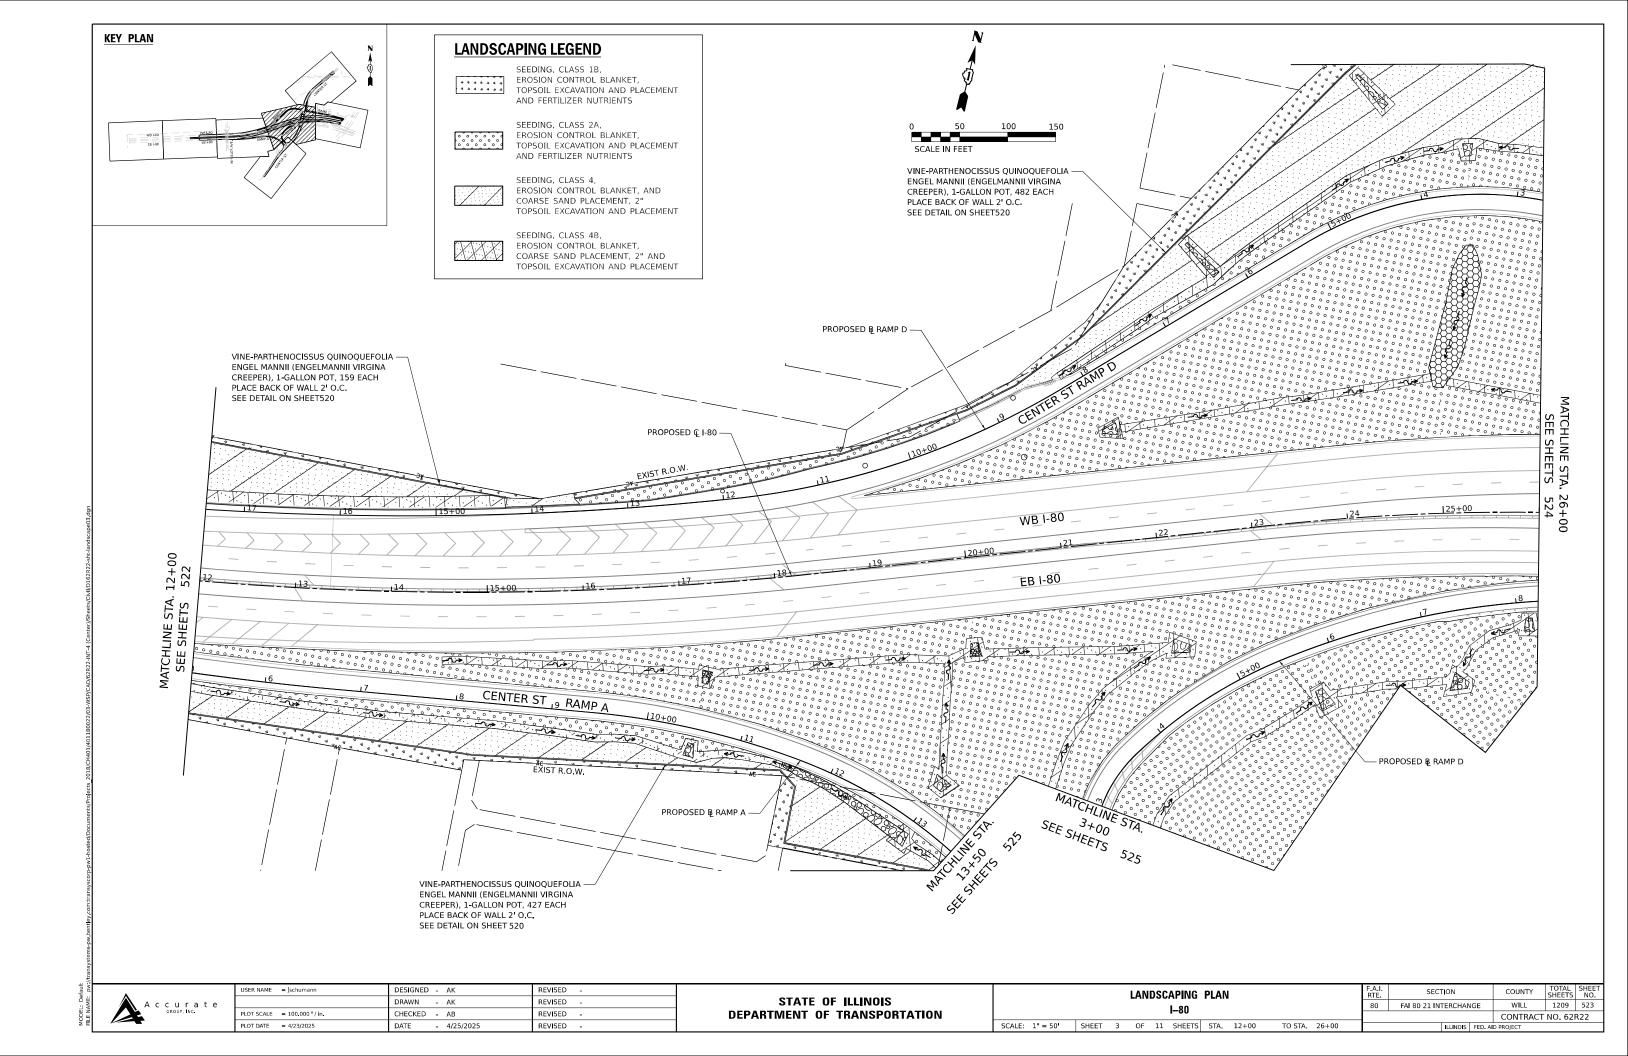

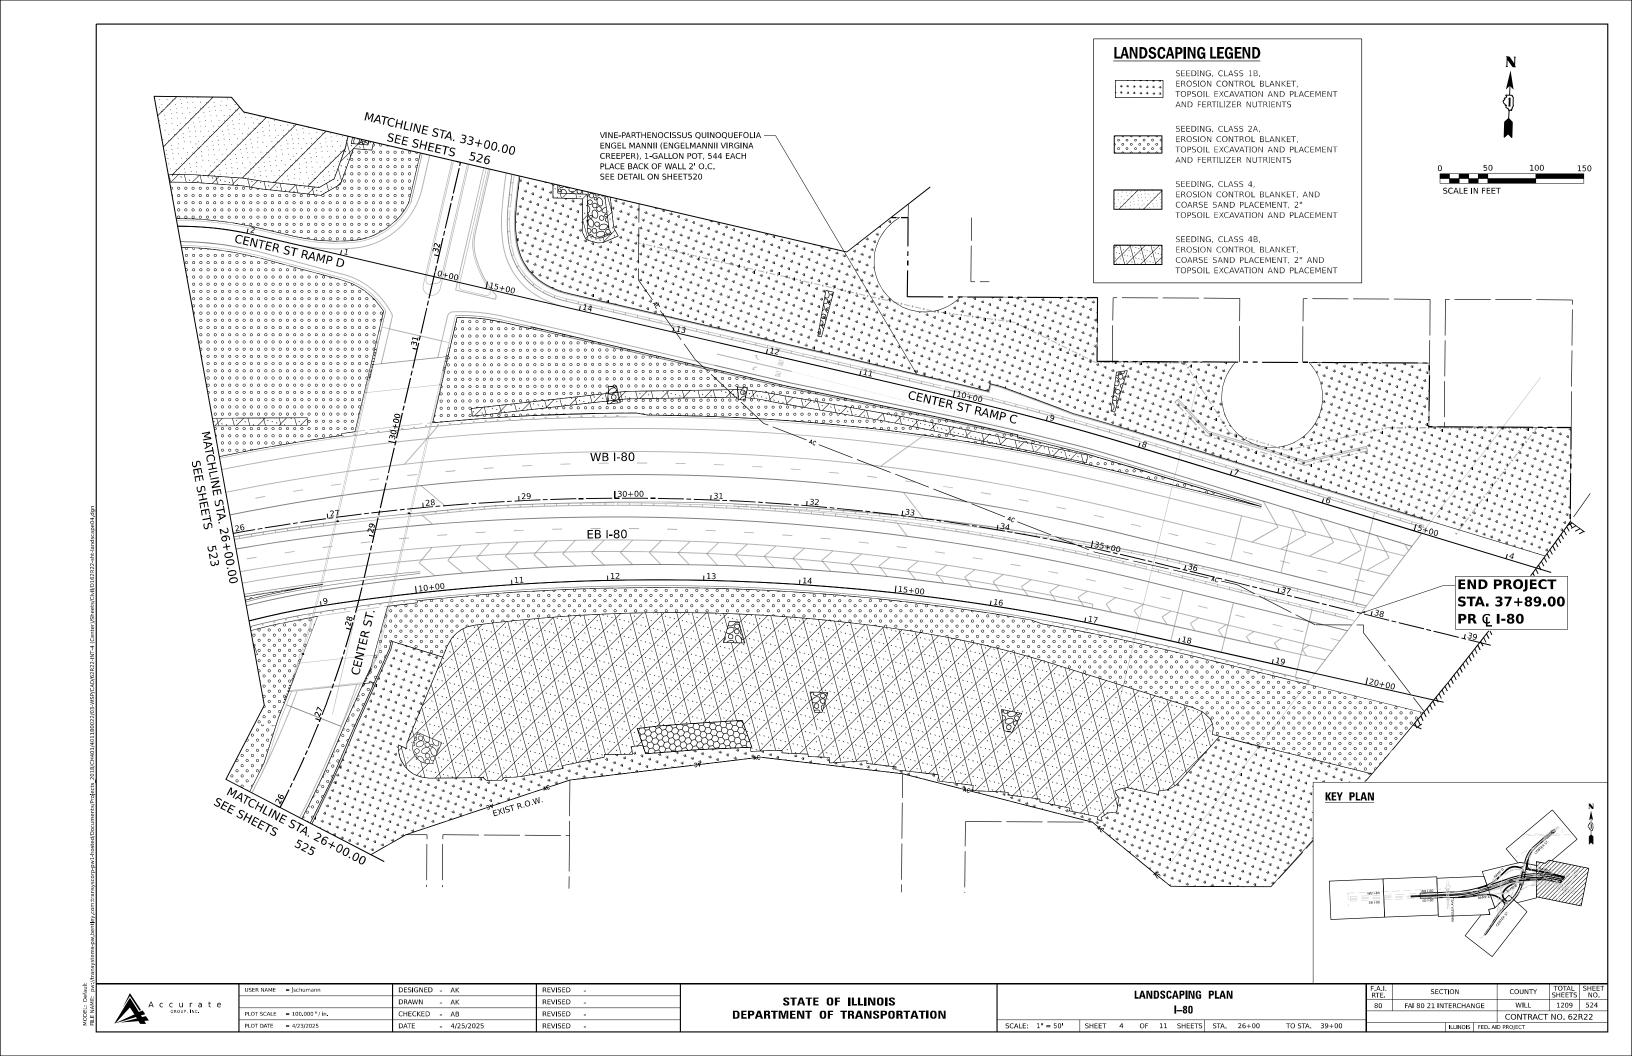

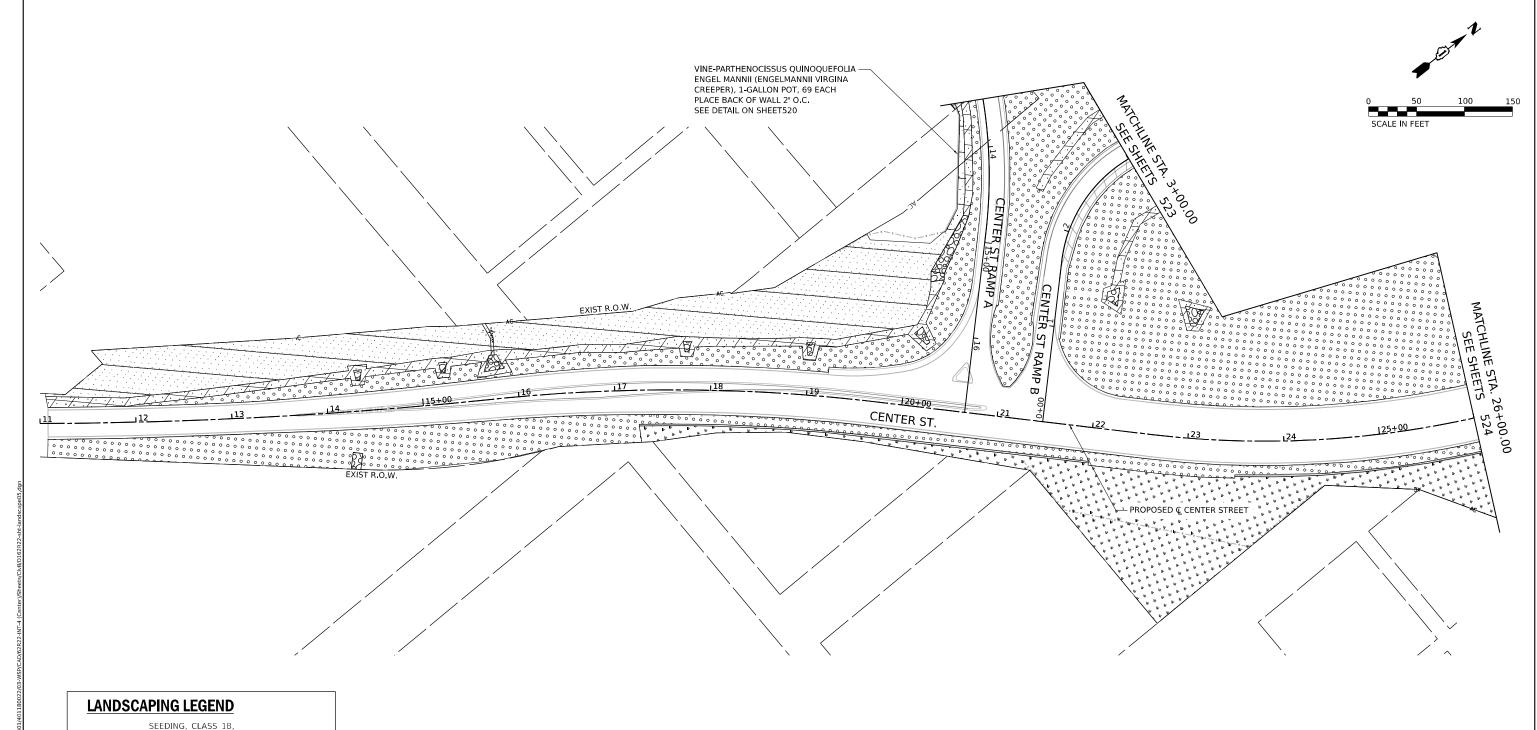

\* \* \* \* \* \* \* \*

SEEDING, CLASS 1B, EROSION CONTROL BLANKET, TOPSOIL EXCAVATION AND PLACEMENT AND FERTILIZER NUTRIENTS




SEEDING, CLASS 2A, EROSION CONTROL BLANKET, TOPSOIL EXCAVATION AND PLACEMENT AND FERTILIZER NUTRIENTS



SEEDING, CLASS 4, EROSION CONTROL BLANKET, AND COARSE SAND PLACEMENT, 2" TOPSOIL EXCAVATION AND PLACEMENT



SEEDING, CLASS 4B, EROSION CONTROL BLANKET, COARSE SAND PLACEMENT, 2" AND TOPSOIL EXCAVATION AND PLACEMENT

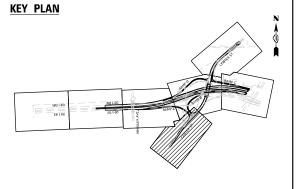



A C C U GROUP	r In	a c.	t	e	
---------------	---------	---------	---	---	--


USER NAME = jschumann	DESIGNED - AK	REVISED -
	DRAWN - AK	REVISED -
PLOT SCALE = 100.000 / in.	CHECKED - AB	REVISED -
PLOT DATE = 4/23/2025	DATE - 4/25/2025	REVISED -


STATE OF	ILLINOIS
DEPARTMENT OF	TRANSPORTATION


			LAN	DSC	APING	PLAN	ı			F.A.I. RTE	SEC	TION		COUNTY	TOTAL SHEETS	SHEET NO.
			C	ENIT	ER STR	FFT				80	FAI 80 21 IN	TERCHAI	IGE	WILL	1209	525
			-	LIVI	LII JIII	LLI								CONTRACT	NO. 62	R22
SCALE: 1" = 50'	SHEET	5	OF	11	SHEETS	STA.	11+00	TO STA.	26+00			ILLINOIS	FED. A	ID PROJECT		

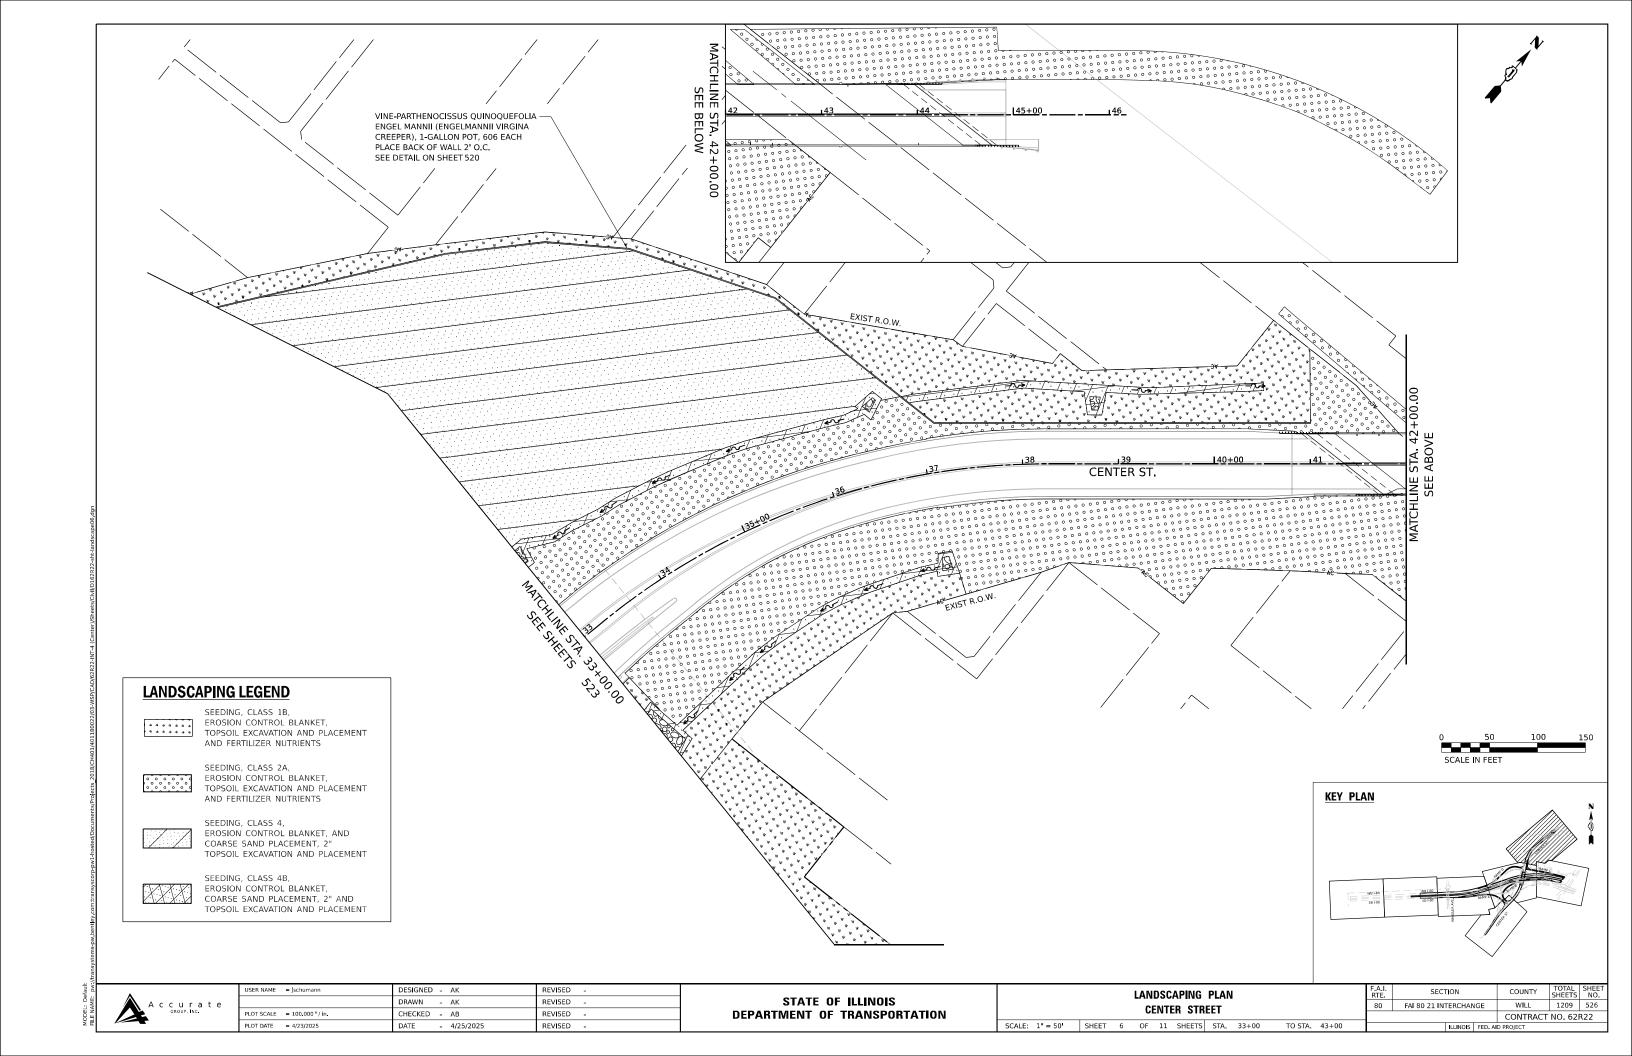


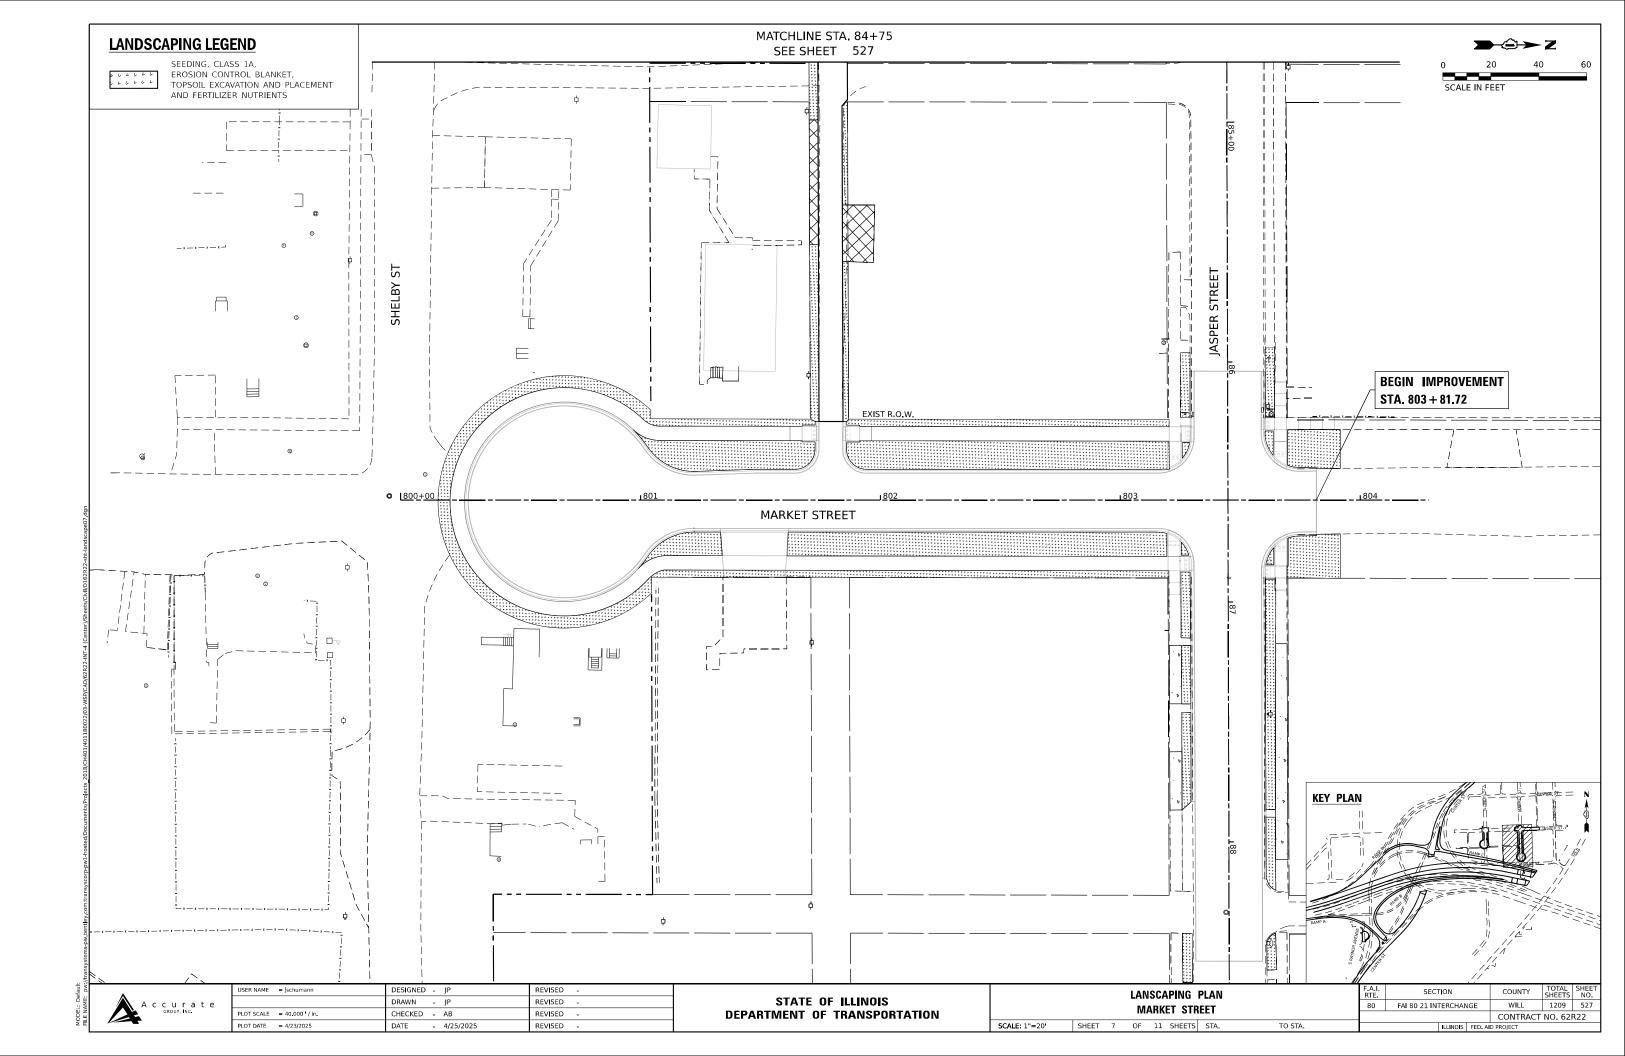

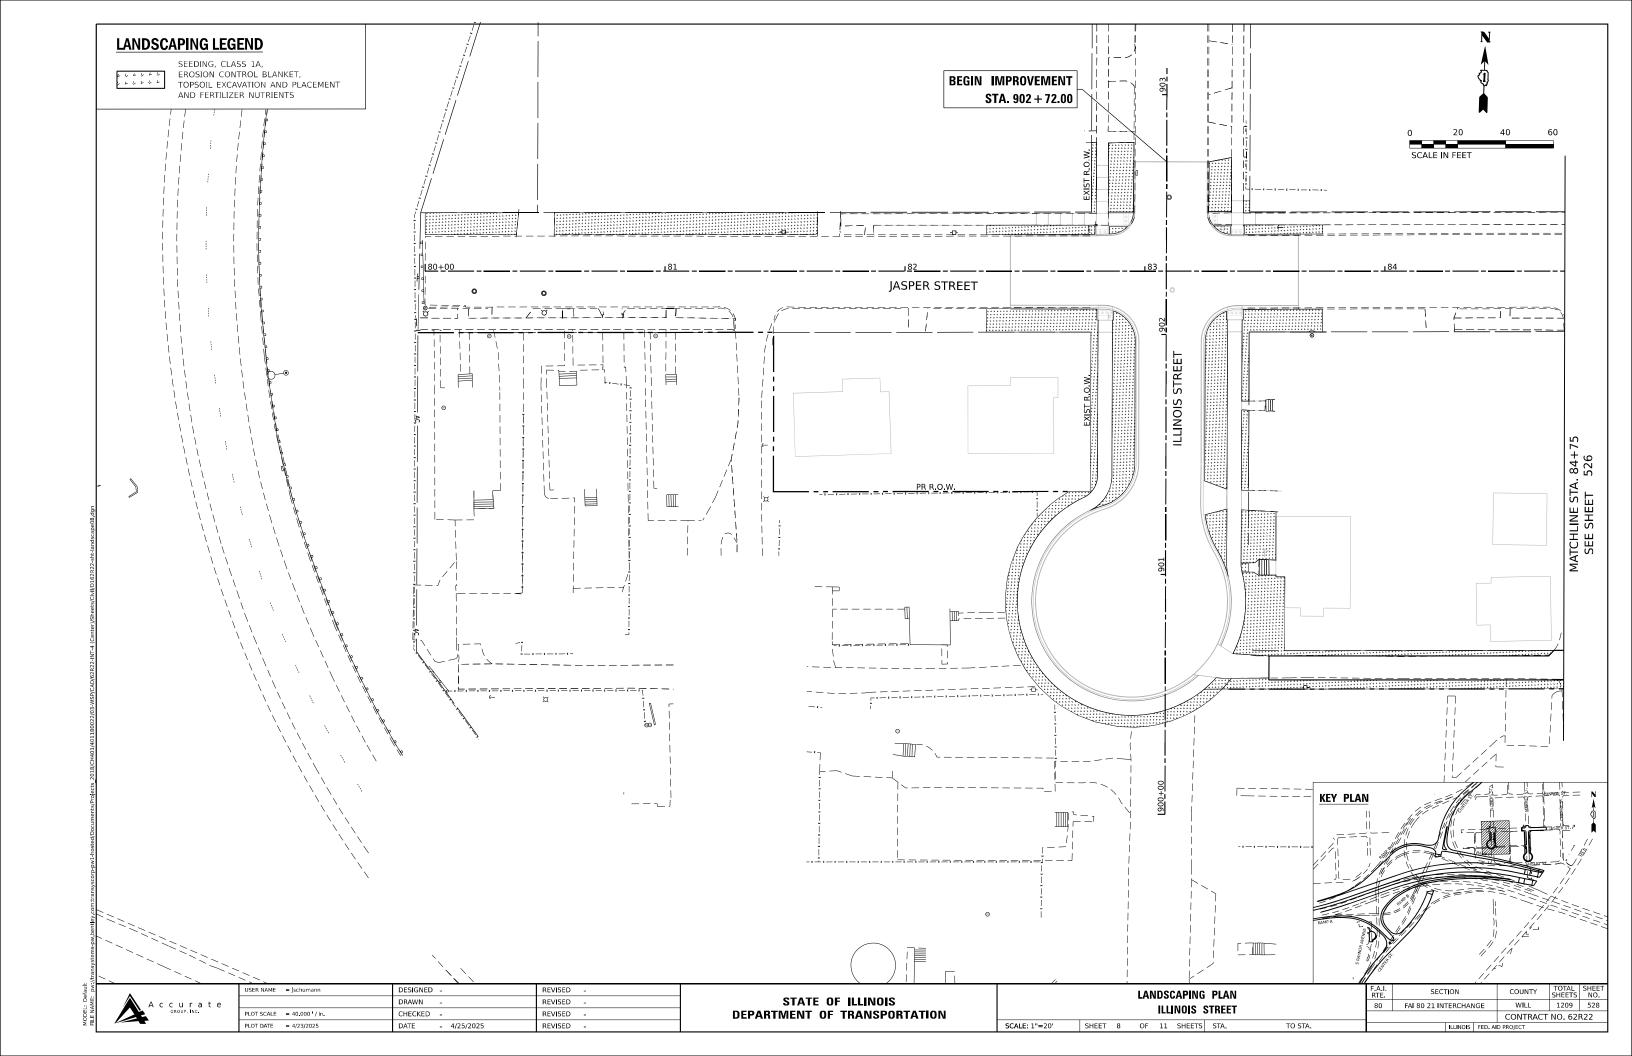

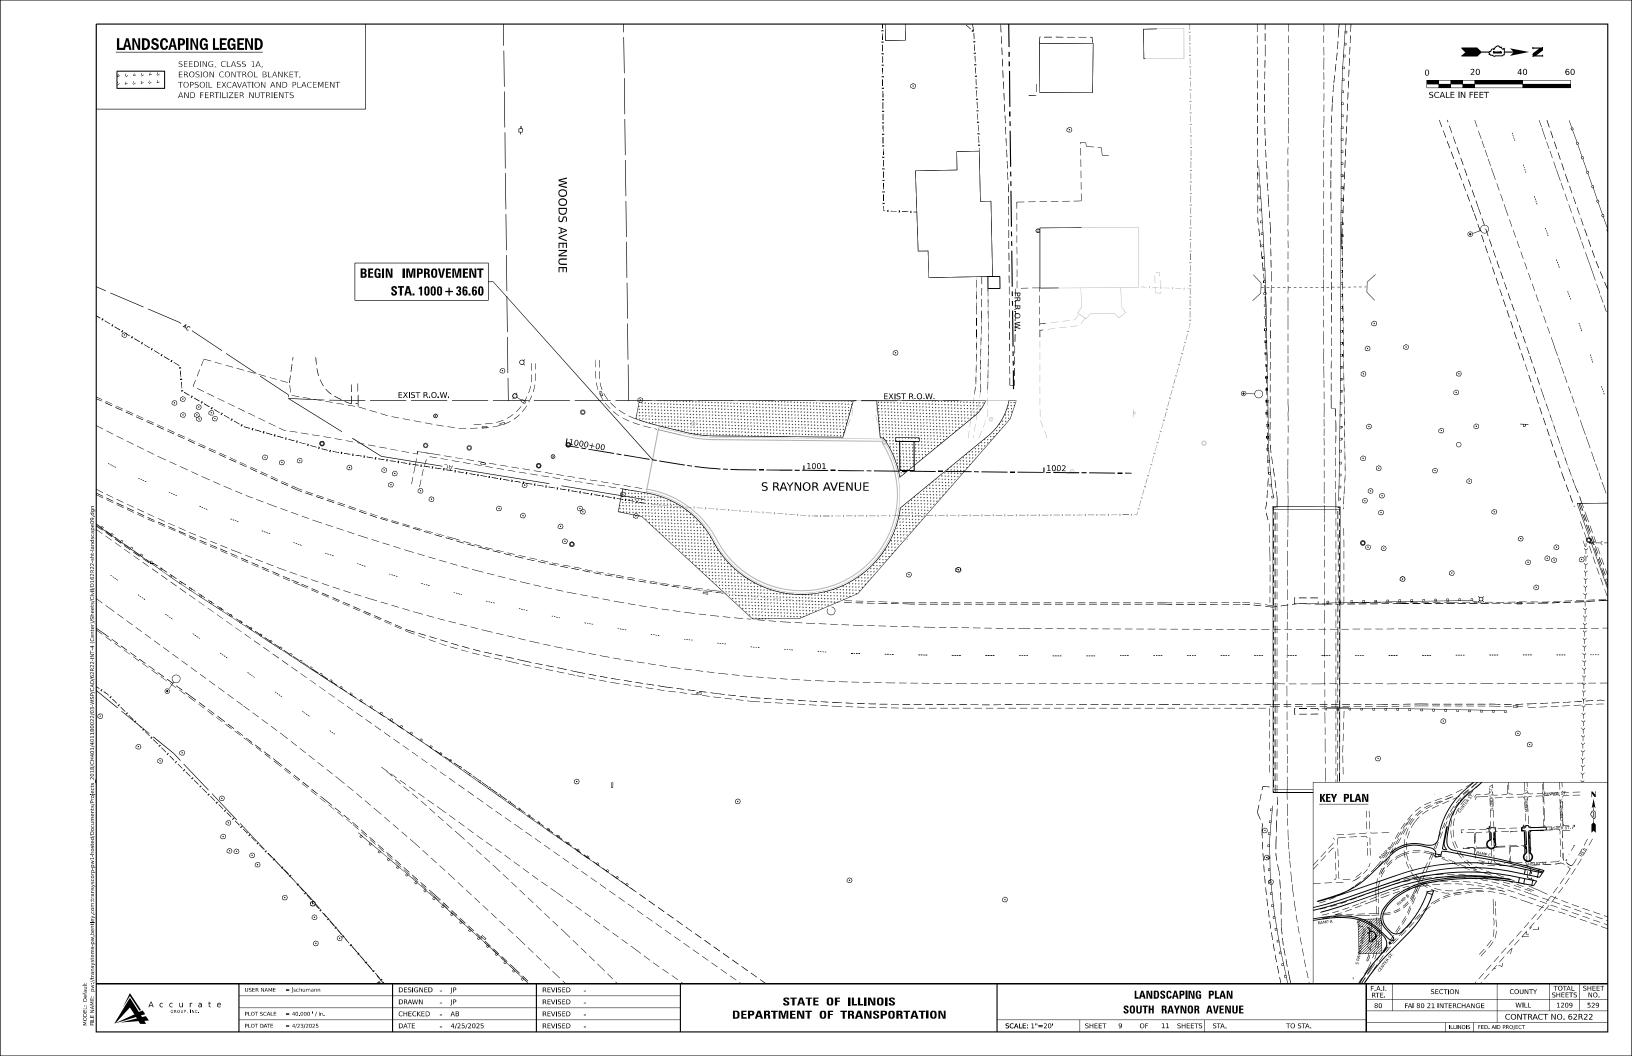


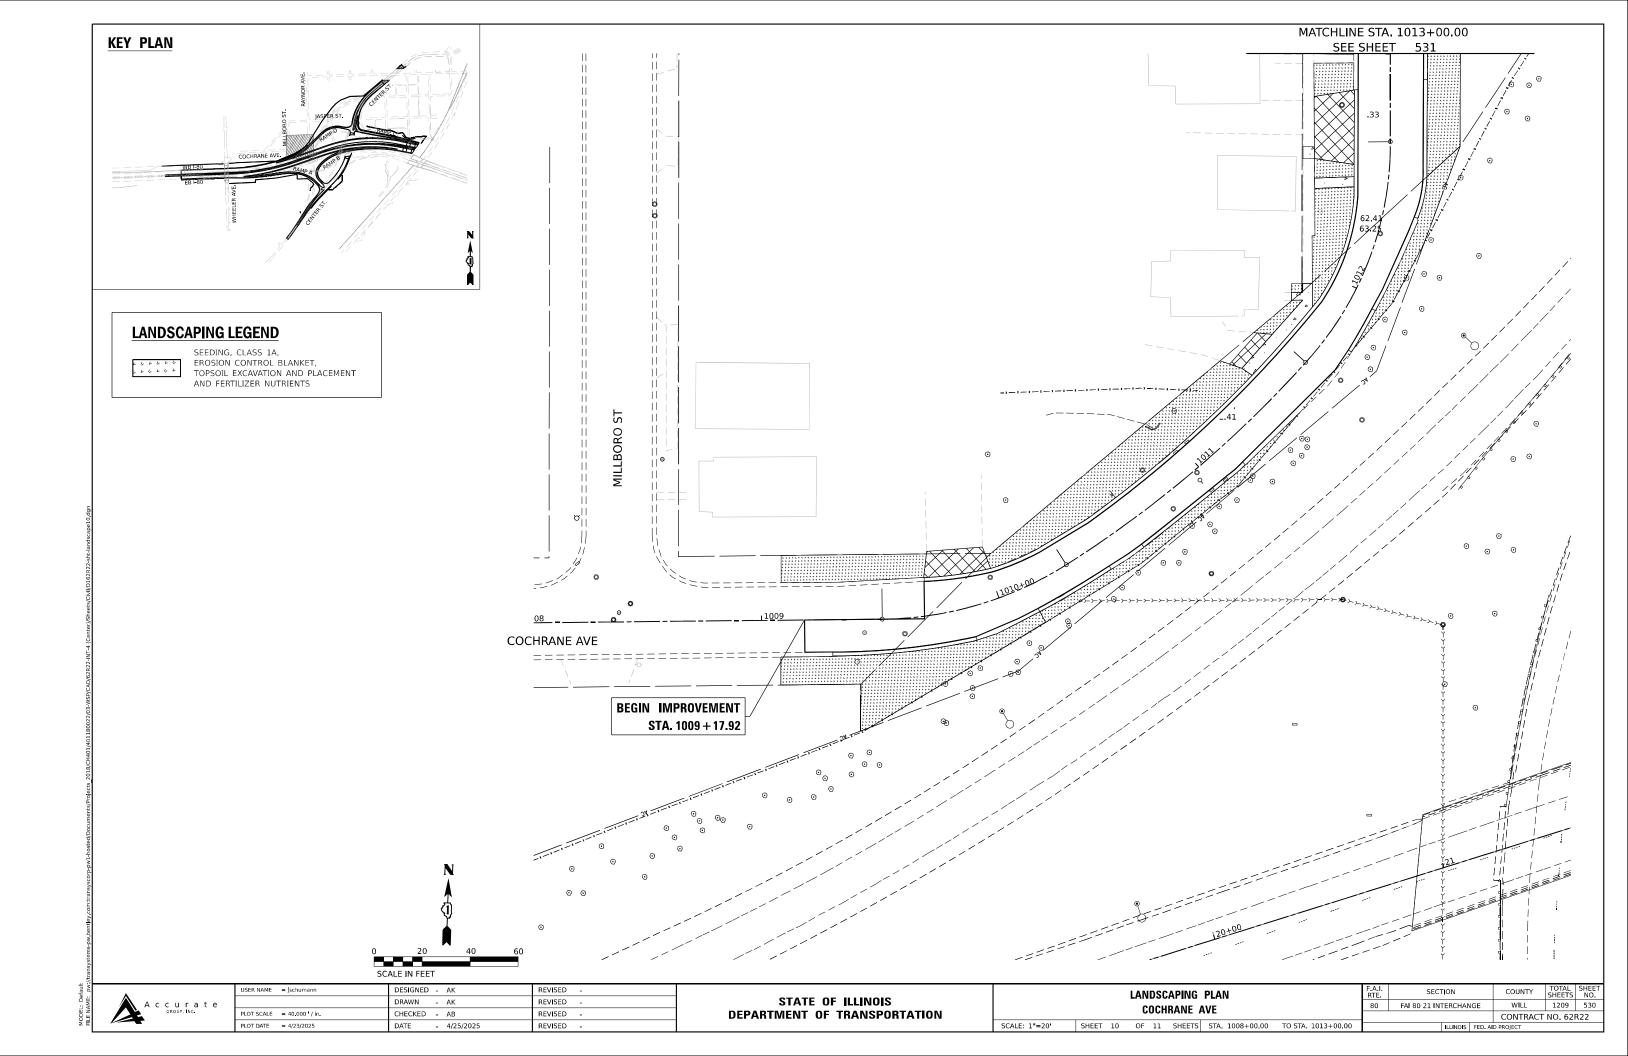

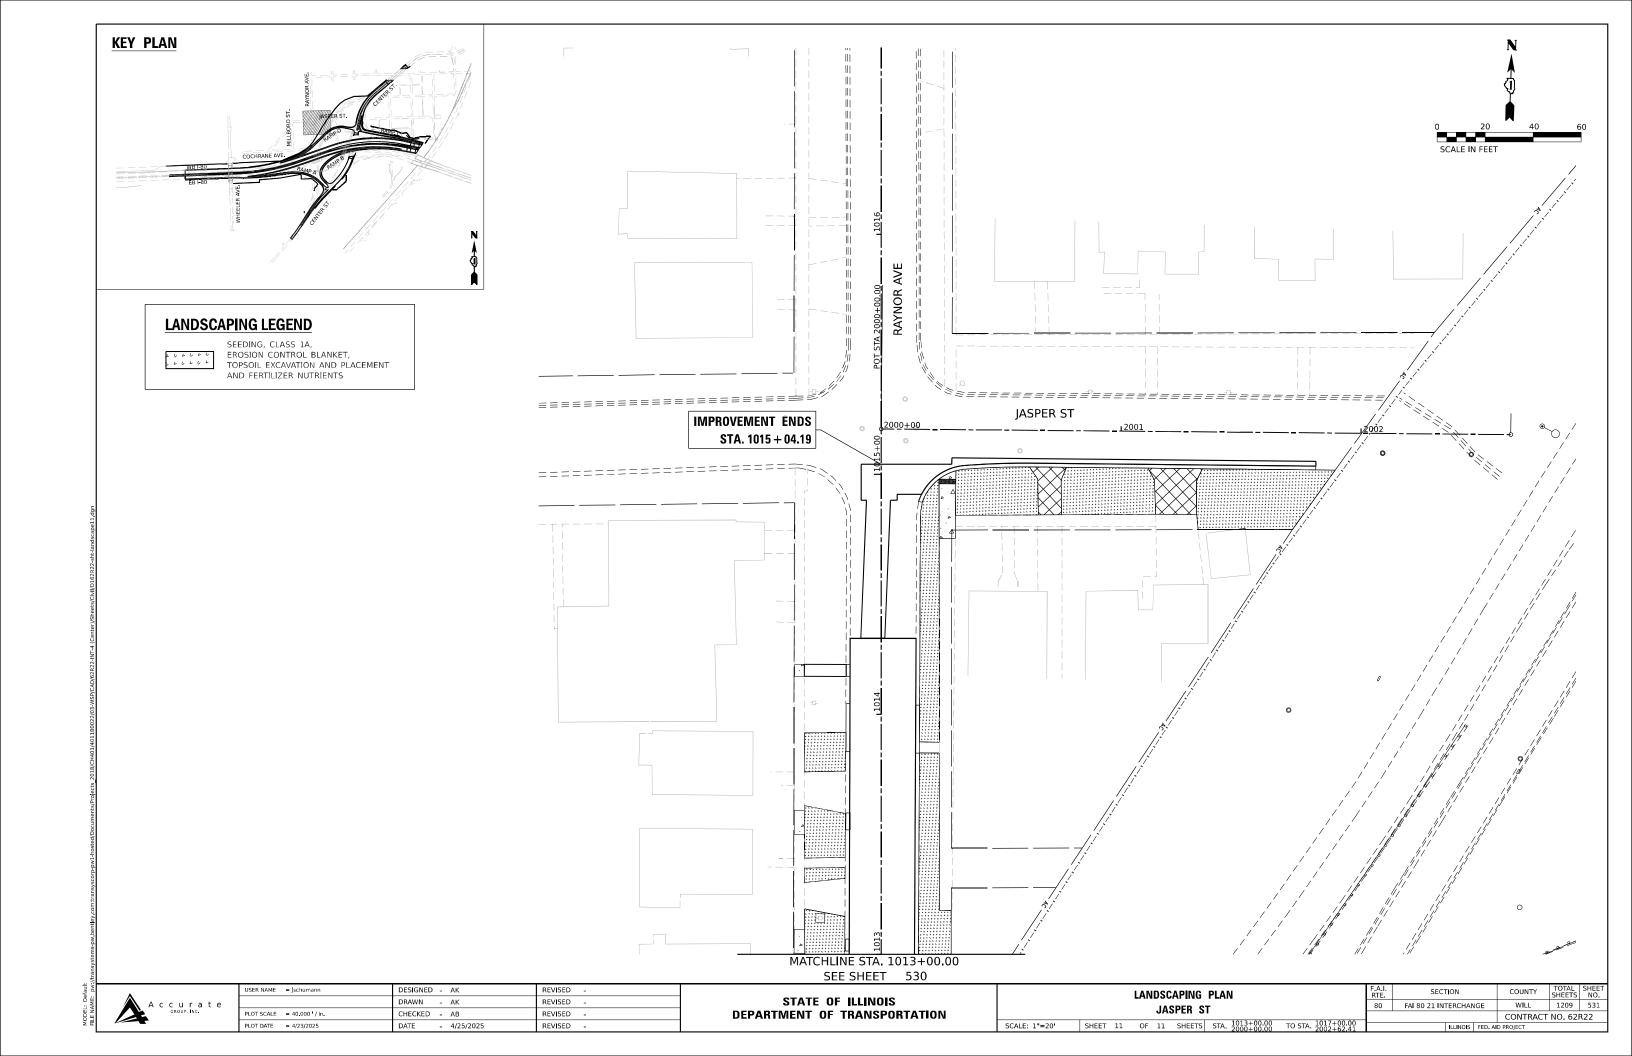

LIGHTI	NG AND ELECTRICAL LEGEND
SYMBOL	DESCRIPTION
0—(E)	EXISTING LIGHTING UNIT TO REMAIN
¤—Œ(	EXISTING STRUCTURE MOUNTED LIGHTING UNIT TO REMAIN
¤—R	EXISTING WALL MOUNTED UNIT TO BE REMOVED. EXISTING POLE AND MAST ARM SHALL NOT BE SALVAGED, EXISTING LUMINAIRE SHALL BE SALVAGED.
○— <u>`</u> R`	EXISTING GROUND MOUNTED UNIT TO BE REMOVED. EXISTING FOUNDATION, POLE, MAST ARM, AND T-BASE SHALL NOT BE SALVAGED, EXISTING LUMINAIRE SHALL BE SALVAGED.
<u>~</u>	PROPOSED IDOT LIGHTING UNIT MOUNTED ON BREAKAWAY DEVICE CONCRETE FOUNDATION, 47.5 FT M.H. U.N.O., 15 FT MAST ARM, LUMINAIRE TO BE LED, HORIZONTAL MOUNT, OUTPUT DESIGNATION H (240 VAC LINE TO NEUTRAL) U.N.O.
¤ <del>- ∑</del>	PROPOSED IDOT LIGHTING UNIT MOUNTED ON PROPOSED PARAPET OR BARRIER FOUNDATION, 47.5 FT M.H. U.N.O., 10 FT MAST ARM, LUMINAIRE TO BE LED, HORIZONTAL MOUNT, OUTPUT DESIGNATION H (240 VAC LINE TO NEUTRAL) U.N.O.
¤ M	PROPOSED IDOT LIGHTING UNIT MOUNTED ON PROPOSED PARAPET OR BARRIER FOUNDATION, 35 FT M.H., 10 FT MAST ARM, LUMINAIRE TO BE LED, HORIZONTAL MOUNT, OUTPUT DESIGNATION H (240 VAC LINE TO NEUTRAL) U.N.O.
<b>∞</b> -¤	PROPOSED IDOT LIGHTING UNIT MOUNTED ON PROPOSED MEDIAN FOUNDATION, 47.5 FT M.H. U.N.O., 6 FT TWIN ARM, LUMINAIRE TO BE LED, HORIZONTAL MOUNT, OUTPUT DESIGNATION I (240 VAC LINE TO NEUTRAL) U.N.O.
<u> </u>	PROPOSED IDOT LIGHTING UNIT MOUNTED ON PROPOSED TRAFFIC SIGNAL POLE, 45 FT M.H. U.N.O., 15 FT MAST ARM, LUMINAIRE TO BE LED, HORIZONTAL MOUNT, OUTPUT DESIGNATION H (120 VAC) U.N.O.
<b>○</b> —────────	TEMPORARY LIGHTING UNIT, 60 FT WOOD POLE, 15 FT MAST ARM LED LUMINAIRE AT 50 FT MOUNTING HEIGHT, OUTPUT DESIGNATION H
<b>○</b> —Œ	EXISTING TEMPORARY LIGHTING UNIT FROM PREVIOUS STAGE
<b>⊶</b> ₩	TEMPORARY LIGHTING UNIT TO BE REMOVED
•	TEMPORARY WOOD POLE, CLASS 4, 60 FT
⊗	EXISTING TEMPORARY WOOD POLE, TYPE AND SIZE AS NOTED
J	PROPOSED JUNCTION BOX, SIZE AND TYPE AS NOTED
₩ <sub>E</sub>	EXISTING IDOT LIGHTING CONTROLLER TO REMAIN
$\bowtie$	EXISTING IDOT LIGHTING CONTROLLER TO BE REMOVED, NO SALVAGED
₩	PROPOSED IDOT LIGHTING CONTROLLER, TYPE AS NOTED
	EXISTING ELECTRIC UTILITY SERVICE TO BE REMOVED
<b>A</b>	PROPOSED ELECTRIC UTILITY SERVICE
<b>▲</b> ⊤	TEMPORARY ELECTRIC UTILITY SERVICE
<b>○</b> R	EXISTING UNDERPASS LUMINAIRE TO BE REMOVED, NO SALVAGE
	PROPOSED UNDERPASS LUMINAIRE, LED, OUTPUT DESIGNATION D (240 VAC) U.N.O.

	ABBREVIATIONS
ABBREVIATION	DESCRIPTION
AC	ALTERNATING CURRENT
A/C	AERIAL CABLE
ATS	ATTACHED TO STRUCTURE
B.O.C.	BACK OF CURB
CB CKT	CIRCUIT BREAKER CIRCUIT
CM	CENTIMETER
COMED	COMMONWEALTH EDISON COMPANY
CP	CONTROL PANEL CURRENT TRANSFORMER
CT DA	DAVIT ARM
DC	DIRECT CURRENT
DIA	DIAMETER
DP	DISTRIBUTION PANEL
E	EXISTING UNIT TO REMAIN
EX.	EXISTING
ECA EIS	ELECTRIC CABLE ASSEMBLY EMBEDDED IN STRUCTURE
E.O.P.	EDGE OF PAVEMENT
F.O.C.	FACE OF CURB
FT	FEET OR FOOT
FU	FUSE
GND	GROUND
HID	HIGH INTENSITY DISCHARGE
JB KVA	JUNCTION BOX KILOVOLT-AMPERE
KW	KILOWATTS
LED	LIGHT EMITTING DIODE
LP	LIGHT POLE
М	METER
MA	MASTARM
MC	MULTI-CONDUCTOR
MM M.H.	MILLIMETER MOUNTING HEIGHT
MW	MESSENGER WIRE
NESC	NATIONAL ELECRIC SAFETY CODE
NO.#	NUMBER
N.T.S.	NOT TO SCALE
P	PROPOSED
PB PNL	PUSH BUTTON PANEL
PVC	POLYVINYL CHLORIDE
PVCC RGC	PVC COATED RIGID GALVANIZED CONDUIT
PT	POTENTIAL TRANSFORMER
R	EXISTING UNIT TO BE REMOVED
	(OWNER SALVAGED U.N.O.)
RR	EXISTING UNIT TO BE REMOVED AND
RECP	REINSTALLED RECEPTACLE
RGC	RIGID GALVANIZED CONDUIT
SEL SW	SELECTOR SWITCH
SPARE	SPARE
SPACE	SPACE
SS	STAINLESS STEEL
STA	STATION TOP OF FOUNDATION
T/F UD	TOP OF FOUNDATION UNIT DUCT
U.N.O.	UNLESS NOTED OTHERWISE
UGC, GS	UNDERGROUND CONDUCT, GALVANIZED STEEL
VAC	VOLTS, ALTERNATING CURRENT
W	WATTS
WP	WOOD POLE
XFMR	TRANSFORMER
HPS LPS	HIGH PRESSURE SODIUM LOW PRESSURE SODIUM
LTFM	LIQUID TIGHT FLEXIBLE METALLIC

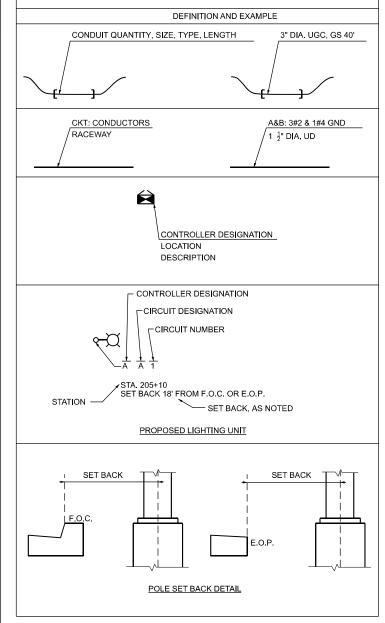

**CALL-OUT SAMPLE** 

LIGHTING	G AND ELECTRICAL LEGEND (CONT.)
SYMBOL	
- R	EXISTING UNDERGROUND UNIT DUCT TO BE ABANDONED IN PLACE
	TEMPORARY AERIAL CABLE TO BE REMOVED
	EXISTING CONDUIT ATTACHED TO STRUCTURE
	EXISTING UNIT DUCT
<del></del>	EXISTING UNIT DUCT IN EXISTING UNDERGROUND CONDUIT
A	EXISTING AERIAL CABLE
A	PROPOSED AERIAL CABLE, SIZE AND TYPE AS NOTED
	PROPOSED CABLE IN PVC CONDUIT SCHEDULE 40, EMBEDDED IN STRUCTURE, SIZE AS NOTED
	PROPOSED CONDUIT ATTACHED TO STRUCTURE, SIZE AND TYPE AS NOTED
	PROPOSED UNIT DUCT, SIZE AND TYPE AS NOTED
<del>-[</del>	PROPOSED UNIT DUCT IN UNDERGROUND 4" DIA. PVC SCHEDULE 80 CONDUIT.

SCALE:

## **GENERAL NOTES**

- THE ELECTRICAL WORK SHALL BE PERFORMED IN ACCORDANCE WITH THE LATEST CODES, STANDARDS AND THE IDOT STANDARD SPECIFICATIONS FOR ROAD AND BRIDGE CONSTRUCTION ADOPTED JANUARY 1, 2022, AND SUPPLEMENTAL SPECIFICATIONS AND RECURRING SPECIAL PROVISIONS.
- THE CONTRACTOR SHALL CONTACT MEADE ELECTRIC CO. DISTRICT ONE ELECTRICAL MAINTENANCE CONTRACTOR TO LOCATE IDOT ELECTRICAL EQUIPMENT AND UNDERGROUND CABLES 773-287-7672.
- THE CONTRACTOR SHALL CONTACT FOLLOWING COMED REPRESENTATIVE FOR ELECTRIC SERVICE COORDINATION: ARIEL.HUGHES@EXELONCORP.COM (779)231-0442
  PROPOSED IDOT CONTROLLER X (L0765):
- PAVEMENT OPEN TO TRAFFIC SHALL REMAIN ILLUMINATED UNTIL IT IS CLOSED. ROADWAYS SHALL BE ILLUMINATED PRIOR TO OPENING TO TRAFFIC.
- WHEN ARTIFICIAL LIGHTING IS USED IN NIGHT OPERATIONS THE CONTRACTOR SHALL EXERCISE THE UTMOST PRECAUTIONS IN PREVENTING ADVERSE VISIBILITY TO THE MOTORING PUBLIC, AIR TRAFFIC AND ADJOINING COMMERCIAL AREAS.
- 6. TEMPORARY AERIAL CABLES OVER THE ROADWAY SHALL HAVE A MINIMUM CLEARANCE OF 18 FEET.

## **IDOT-D1 STANDARDS:**

STANDARD NO	<u>. TITLE</u>
BE-206	LIGHTING CONTROLLER, BASE MOUNTED. 480VOLT, 200AMP (DUAL) RADIO SCADA - FIBER OPTIC PROVISION
BE-220	ELECTRIC SERVICE INSTALLATION AERIAL, REMOTE DISCONNECT
BE-240	COMBINATION LIGHTING, TRAFFIC SIGNAL SCHEMATIC
BE-301	LIGHT POLE FOUNDATION, 40' TO 47.5' M.H. 15" BOLT CIRCLE
BE-400	ALUMINUM LIGHT POLE 47'-6" (14.478 m) MOUNTING HEIGHT
BE-402	ALUMINUM LIGHT POLE 35'-0" (10.668 m) MOUNTING HEIGHT
BE-701	LUMINAIRE SAFETY CABLE ASSEMBLY
BE-702	MISC. ELECTRICAL DETAILS SHEET A
BE-703	MISC. ELECTRICAL DETAILS SHEET B
BE-800	TEMPORARY LIGHT POLE DETAILS
BE-801	TEMPORARY AERIAL CABLE INSTALLATION
BE-901	SUSPENDED MOUNT LED UNDERPASS LUMINAIRE INSTALLATION DETAILS

## I-80 CORRIDOR DETAILS:

24" (610 mm) DIA. LIGHT POLE FOUNDATION INTEGRAL WITH DOUBLE FACE BARRIER WALL

LIGHT POLE MOUNTED ON CONCRETE PARAPET WALL 15" (381 mm) BOLT CIRCLE

## **IDOT HIGHWAY STANDARDS:**

812001-01 RACEWAY EMBEDDED IN STRUCTURE

## PROJECT COMED REPRESENTATIVE:

ARIEL HUGHES - ARIEL.HUGHES@EXELONCORP.COM (779)231-0442

LT-01



SER NAME = VGURSKAS	DESIGNED - VG	REVISED -
	DRAWN - VN/MAG	REVISED -
LOT SCALE =	CHECKED - RP	REVISED -
LOT DATE = 6/9/2025	DATE - 4/25/2025	REVISED -

STATE OF ILLINOIS **DEPARTMENT OF TRANSPORTATION** 

LIGHTING	LEGEND	AND	GENERAL	NOTES
SHEET	OF	SHEETS	STA.	TO STA.

SECTION COUNTY 80 FAI 80 21 INTERCHANGE WILL 1209 532 CONTRACT NO. 62R22

S		N	G	H	
	CC	NSULTII	SSOCIAT NG ENG	ES, INC. NEERS	

USER NAME = VGURSKAS	DESIGNED - VG	REVISED -
	DRAWN - VN/MAG	REVISED -
PLOT SCALE = 0.167'/in.	CHECKED - RP	REVISED -
PLOT DATE = 6/9/2025	DATE - 4/25/2025	REVISED -

ELECTRIC SERVICE INSTALLATION

ELECTRIC UTILITY SERVICE CONNECTION

UNDERGROUND CONDUIT, PVC, 4" DIA.

UNDERGROUND CONDUIT, GALVANIZED STEEL, 3" DIA.

## STATE OF ILLINOIS **DEPARTMENT OF TRANSPORTATION**

0.000		SCHEDULE	OF QU	ANTITES
SHEET OF SHEETS STA.	SHEET	OF	SHEETS	STA.

TO STA.

SCALE:

TOTAL QUANT**I**TY

260

1,116

UNIT

EACH


L SUM

FOOT

FOOT


SHEET NO.
533
R22
_

INDERGROUND CONDUIT, PVC, 4" DIA.	FOOT	1,116
CONDUIT ATTACHED TO STRUCTURE, 1" DIA., PVC COATED GALVANIZED STEEL	FOOT	745
CONDUIT ATTACHED TO STRUCTURE, 3" DIA., PVC COATED GALVANIZED STEEL	FOOT	45
CONDUIT ATTACHED TO STRUCTURE, 2" DIA., STAINLESS STEEL	FOOT	40
ONDUIT EMBEDDED IN STRUCTURE, 2" DIA., PVC	FOOT	2,710
ONDUIT EMBEDDED IN STRUCTURE, 3" DIA., PVC	FOOT	30
ONDUIT EMBEDDED IN STRUCTURE, 4" DIA., PVC	FOOT	2,600
INCTION BOX, STAINLESS STEEL, ATTACHED TO STRUCTURE, 6" X 6" X 4"	EACH	14
INCTION BOX, STAINLESS STEEL, ATTACHED TO STRUCTURE, 12" X 10" X 6"	EACH	5
JNCTION BOX, STAINLESS STEEL, ATTACHED TO STRUCTURE, 18" X 12" X 6"	EACH	9
INCTION BOX, STAINLESS STEEL, ATTACHED TO STRUCTURE, 18" X 18" X 8"	EACH	3
NIT DUCT, 600V, 2-1C NO.2, 1/C NO.4 GROUND, (XLP-TYPE USE), 1 1/2" DIA. POLYETHYLENE	EACH	945
NIT DUCT, 600V, 3-1C NO.2, 1/C NO.4 GROUND, (XLP-TYPE USE), 1 1/2" DIA. POLYETHYLENE	FOOT	11,935
LECTRIC CABLE IN CONDUIT, 600V (XLP-TYPE USE) 1/C NO. 10	FOOT	2,825
ECTRIC CABLE IN CONDUIT, 600V (XLP-TYPE USE) 1/C NO. 4	FOOT	5,705
LECTRIC CABLE IN CONDUIT, 600V (XLP-TYPE USE) 1/C NO. 2	FOOT	17,115
LECTRIC CABLE IN CONDUIT, 600V (XLP-TYPE USE) 1/C 350MCM	FOOT	915
ERIAL CABLE, 2-1/C NO. 2 WITH MESSENGER WIRE	FOOT	1,044
ERIAL CABLE, 3-1/C NO. 2 WITH MESSENGER WIRE	FOOT	6,767
JMINAIRE, LED, ROADWAY, OUTPUT DESIGNATION H	EACH	52
JMINAIRE, LED, ROADWAY, OUTPUT DESIGNATION I	EACH	28
JMINAIRE, LED, UNDERPASS, SUSPENDED, OUTPUT DESIGNATION D	EACH	14
GHT POLE, ALUMINUM, 35 FT. M.H., 10 FT. MAST ARM	EACH	2
GHT POLE, ALUMINUM, 47.5 FT. M.H., 10 FT. MAST ARM	EACH	13
GHT POLE, ALUMINUM, 47.5 FT. M.H., 15 FT. MAST ARM	EACH	33
GHT POLE, ALUMINUM, 47.5 FT. M.H., 2-6 FT. MAST ARMS	EACH	14
GHT POLE, WOOD, 60 FOOT, CLASS 4, WITH 15FT MAST ARM	EACH	22
GHT POLE FOUNDATION, 24" DIAMETER	FOOT	297
REAKAWAY DEVICE, TRANSFORMER BASE, 15 INCH BOLT CIRCLE	EACH	33
EMOVAL OF TEMPORARY LIGHTING UNIT	EACH	22
EMOVAL OF LIGHTING UNIT, NO SALVAGE	EACH	64
EMOVAL OF POLE FOUNDATION	EACH	64
EMOVAL OF LIGHTING CONTROLLER	EACH	2
EMOVAL OF ELECTRIC SERVICE INSTALLATION		2
EMOVAL OF LIGHTING CONTROLLER FOUNDATION	EACH	2
EMOVAL OF LUMINAIRE, SALVAGE	EACH	
IGHTING CONTROLLER, BASE MOUNTED, 480VOLT, 200AMP (DUAL), RADIO SCADA, FIBER OPTIC	EACH	66
	EACH	1
EMPORARY LIGHTING CONTROLLER, POLE MOUNTED, 480 VOLT, 200 AMP  IAINTENANCE OF LIGHTING SYSTEM	EACH	1
EMPORARY ELECTRIC SERVICE INSTALLATION	CAL MO	24
JNCTION BOX, NON-METALLIC, EMBEDDED IN STRUCTURE, 20" X 13" X 12"	EACH	1
EMPORARY LUMINAIRE, LED, ROADWAY, OUTPUT DESIGNATION H	EACH	4
	EACH	22
OMBINATION LIGHTING CONTROLLER	EACH	2
EMOVE TEMPORARY WOOD POLE	EACH	8
EMPORARY WOOD POLE, 60 FT., CLASS 4	EACH	8
IGHT POLE FOUNDATION, INTEGRAL WITH BARRIER WALL	EACH	15
IGHT POLE FOUNDATION, INTEGRAL WITH BARRIER WALL, 24" DIAMETER	FOOT	126
EMOVAL OF UNDERPASS LIGHTING UNIT, NO SALVAGE	EACH	8
UMINAIRE SAFETY CABLE ASSEMBLY	EACH	82

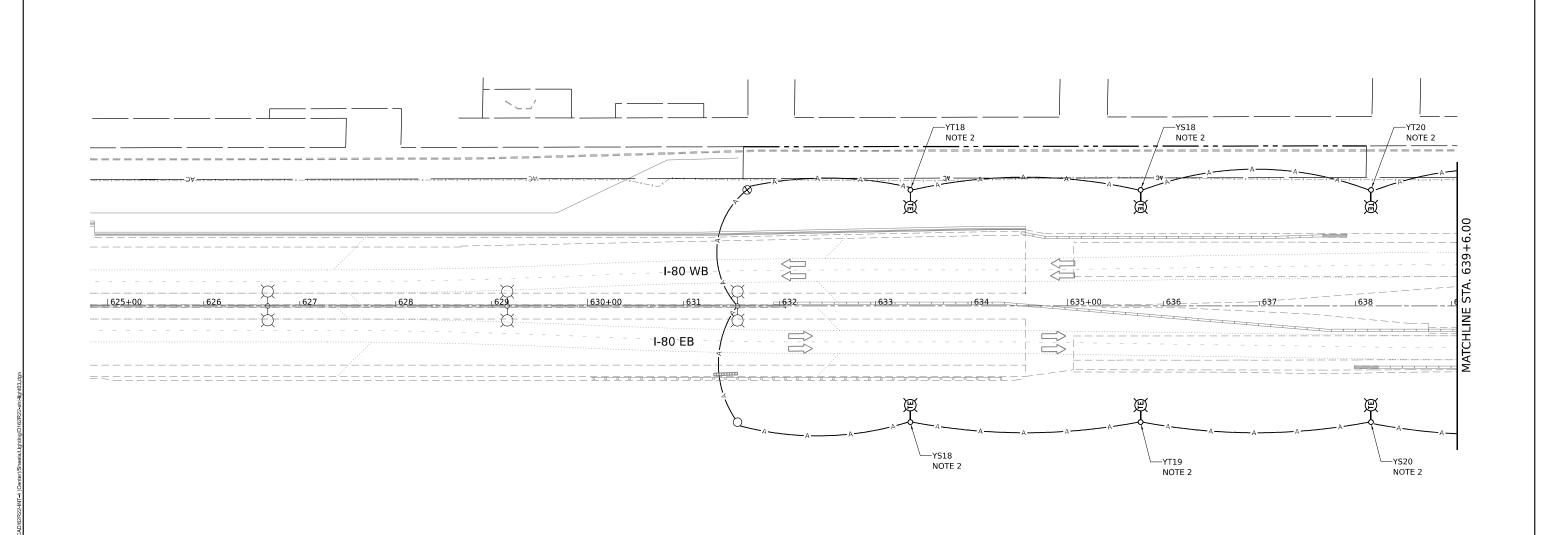

## NOTES:

- 1. SEE SHEET LT-01 FOR LEGEND, ABBREVIATIONS, AND GENERAL NOTES.
- TEMPORARY LIGHTING UNITS AND AERIAL CABLES INSTALLED UNDER CONTRACT 62R89 SHALL REMAIN OPERATIONAL DURING STAGE 2.

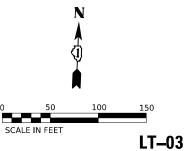


S	IN	G	H
	SINGH+	ASSOCIA'	

USER NAME = VGURSKAS	DESIGNED - VG	REVISED -
	DRAWN - VN/MAG	REVISED -
PLOT SCALE = 100.000 ' / in.	CHECKED - RP	REVISED -
PLOT DATE = 6/9/2025	DATE - 4/25/2025	REVISED -

STATE OF ILLINOIS DEPARTMENT OF TRANSPORTATION

REMOV	AL AND	TE	MPO	RAI	RY LIGH	ITING	PLAN – STAGE 2	
I-80 AT CENTER STREET								
SCALE: 1'=50"	SHEET	1	OF	6	SHEETS	STA.	TO STA.	

				L!-	U.
F.A.I. RTE	SECTION	COUNTY	TOTAL SHEETS	SH N	
80	FAI 80 21 INTERCHAN	WILL	1209	5	
			CONTRACT	NO. 62F	₹22
	ILLINOIS	FED. A	D PROJECT		

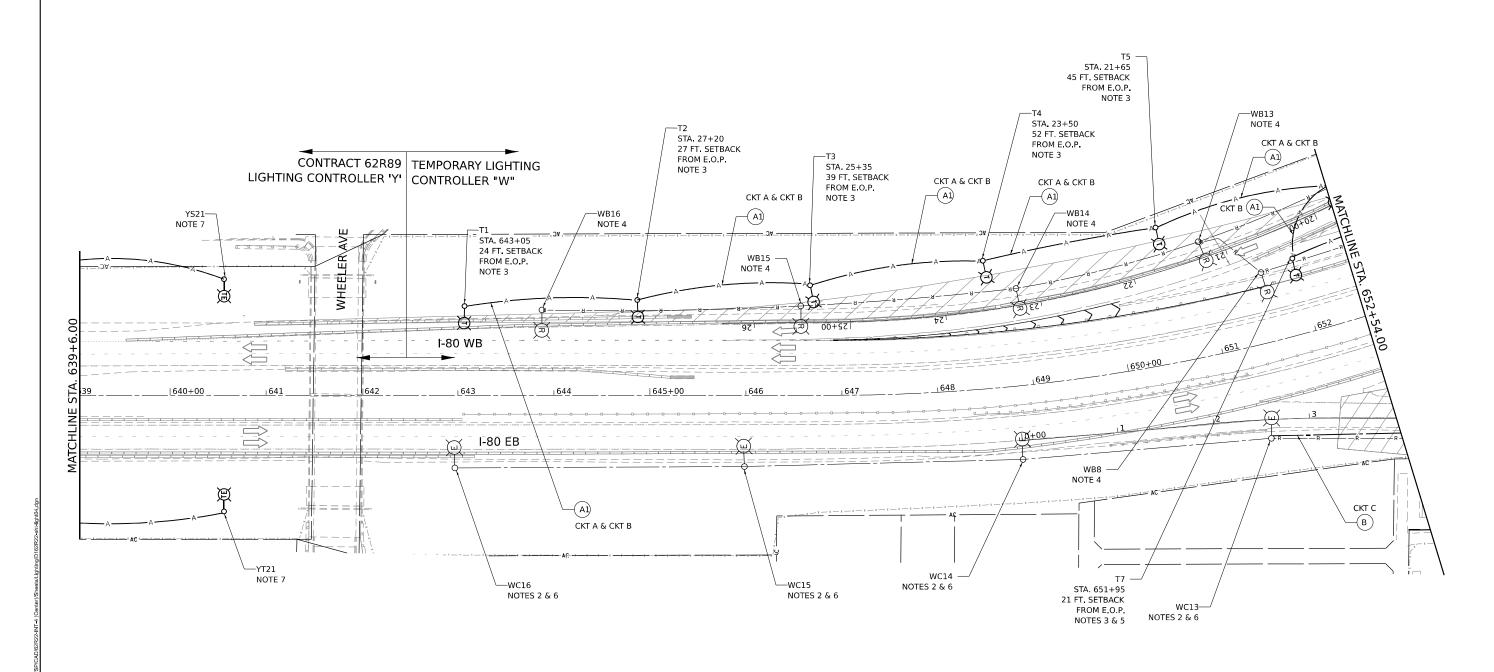


## LEGEND

- (A1) AERIAL CABLE, 3-1/C NO.2 WITH MESSENGER WIRE (240 LINE-NEUTRAL)
- B UNIT DUCT, 600V, 2-1/C NO. 2, 1/C NO. 4 GROUND, (XLP-TYPE USE). 1 1/2" DIA. POLYETHYLENE (480V LINE-LINE)
- (B1) UNIT DUCT, 600V, 3-1/C NO. 2, 1/C NO. 4 GROUND, (XLP-TYPE USE). 1 1/2" DIA, POLYETHYLENE (240V LINE-NEUTRAL)
- (C) UNDERGROUND CONDUIT, PVC SCHEDULE 80, 4" DIA.

### NOTES:

- 1. SEE SHEET LT-01 FOR LEGEND, ABBREVIATIONS, AND GENERAL NOTES.
- 2. EXISTING LIGHTING UNITS SHALL REMAIN OPERATIONAL DURING STAGE 2.
- 3. TEMPORARY LIGHTING UNITS AND TEMPORARY BRANCH CIRCUITS SHALL BE INSTALLED AND OPERATIONAL PRIOR TO START OF STAGE 2. TEMPORARY LUMINAIRES SHALL BE 240V LINE TO NEUTRAL.
- 4. EXISTING LIGHTING UNITS SHALL BE REMOVED AND DISCONNECTED. WIRE AND CONDUIT SHOWN TO BE REMOVED SHALL BE ABANDONED IN PLACE UNLESS OTHERWISE SPECIFIED. CONTRACTOR MAY CHOOSE TO REMOVE WIRES FROM ABANDONED CONDUIT AT OWN EXPENSE.
- 5. THE TEMPORARY WOOD POLE IN-GROUND DEPTH SHALL BE AT LEAST 12 FEET TO ACCOMMODATE THE EXCAVATION WORK DURING CONSTRUCTION STAGE 2.
- 6. THE CONTRACTOR SHALL ENSURE THAT HPS LUMINAIRES ARE CONNECTED TO A 2-POLE BREAKER IN THE TEMPORARY LIGHTING CABINET AND LUMINAIRES SHALL OPERATE AT 480V.
- 7. TEMPORARY LIGHTING UNITS AND AERIAL CABLES INSTALLED UNDER CONTRACT 62R89 SHALL REMAIN OPERATIONAL DURING STAGE 2.

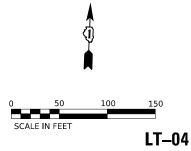


SINGH SINGH ASSOCIATES INC.


USER NAME = VGURSKAS	DESIGNED - VG	REVISED -
	DRAWN - VN/MAG	REVISED -
PLOT SCALE = 100.000 '/ in.	CHECKED - RP	REVISED -
PLOT DATE = 6/9/2025	DATE - 4/25/2025	REVISED -


STATE OF ILLINOIS DEPARTMENT OF TRANSPORTATION

REMOVAL AND TEMPORARY LIGHTING PLAN — STAGE 2 I—80 at center street									
	1 00 /11 0111111 0111111								
SCALE:	1'=50"	SHEET	2	OF	6	SHEETS	STA.	TO STA.	

.l. E.	SEC.	TION		COUNTY	TOTAL SHEETS	SHEET NO.
)	FAI 80 21 INT	ERCHAN	GE	WILL	1209	535
			CONTRACT	NO. 62F	₹22	
		RICHILL	EED A	D PPO IECT		

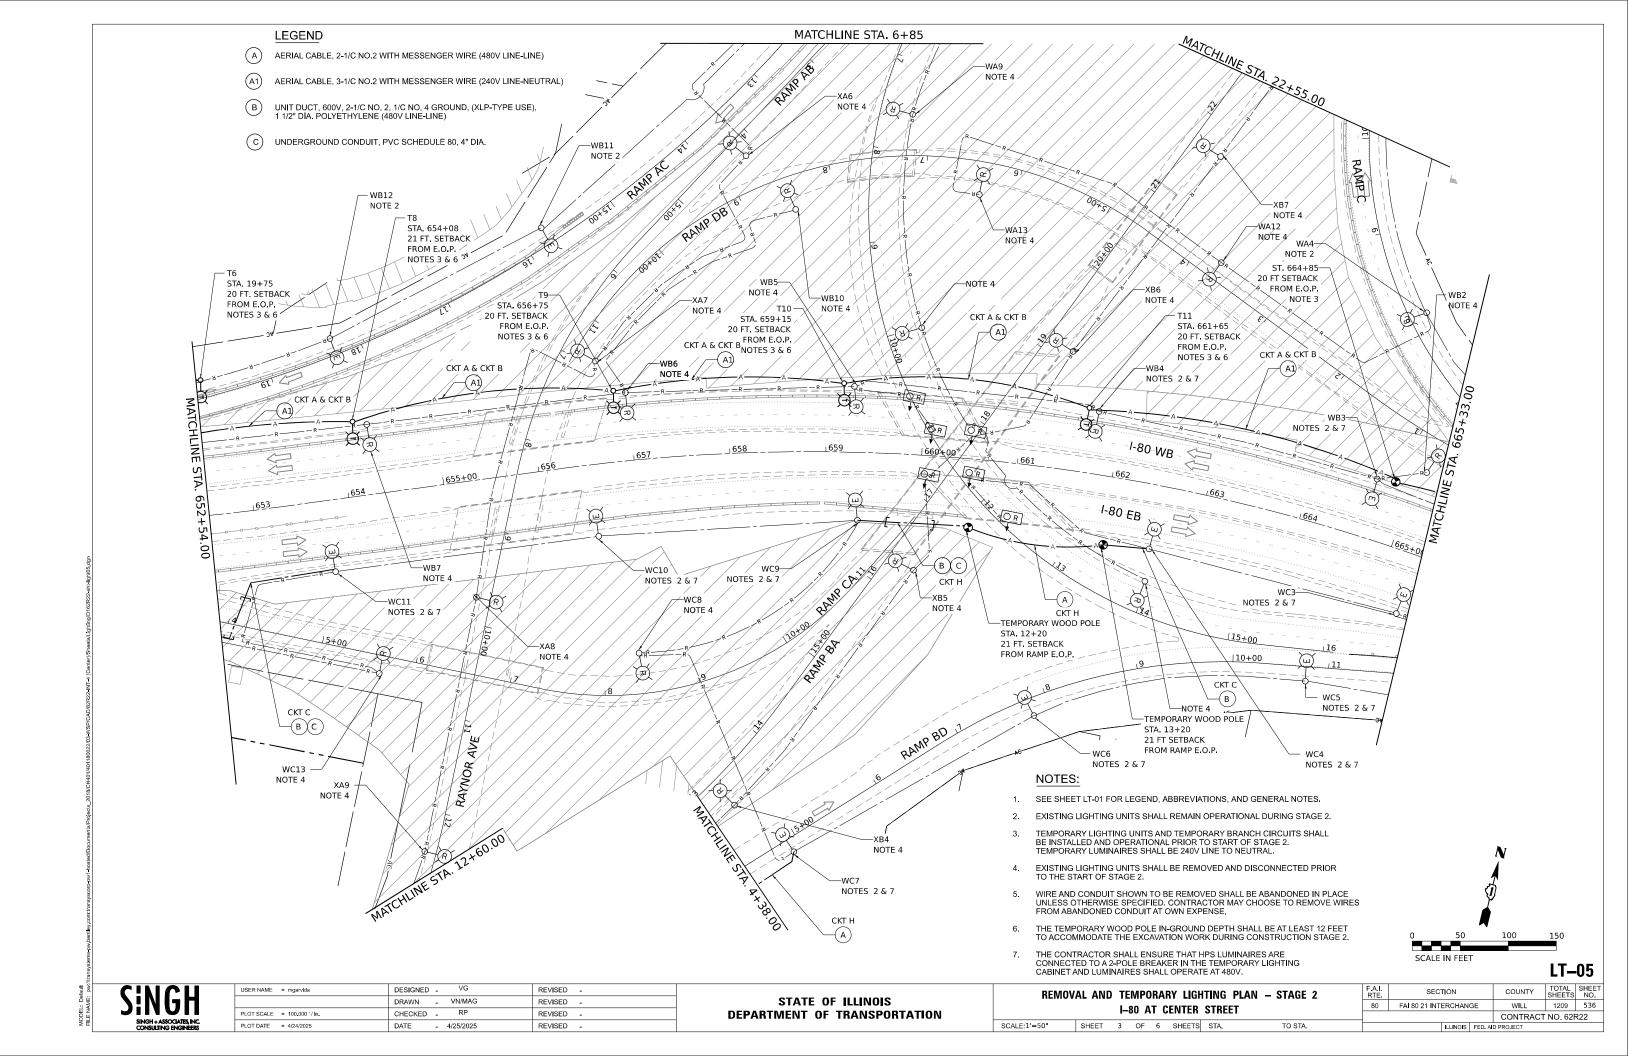

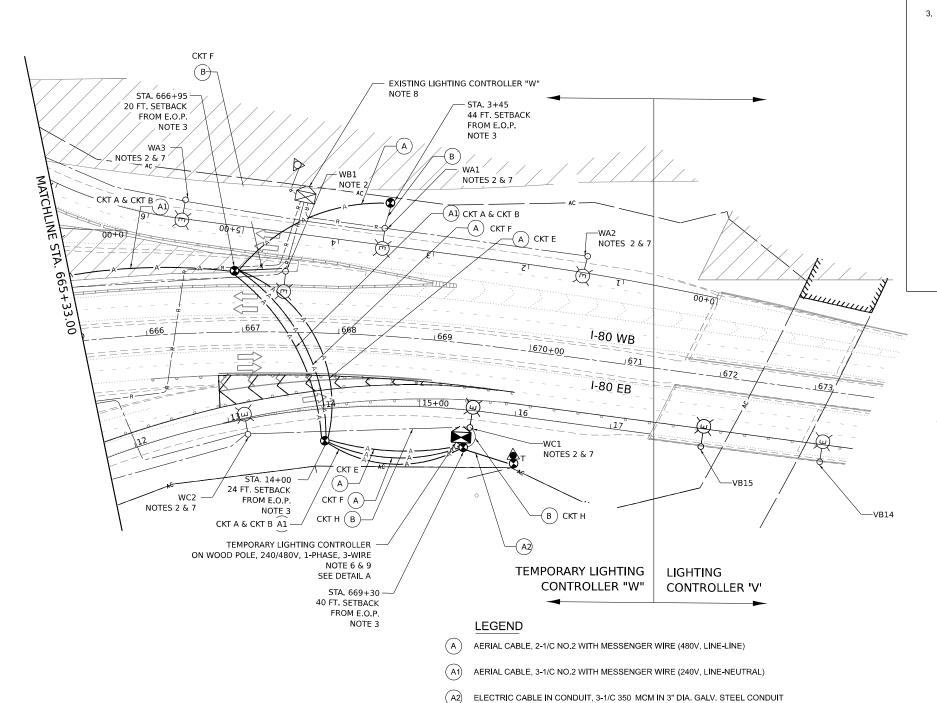


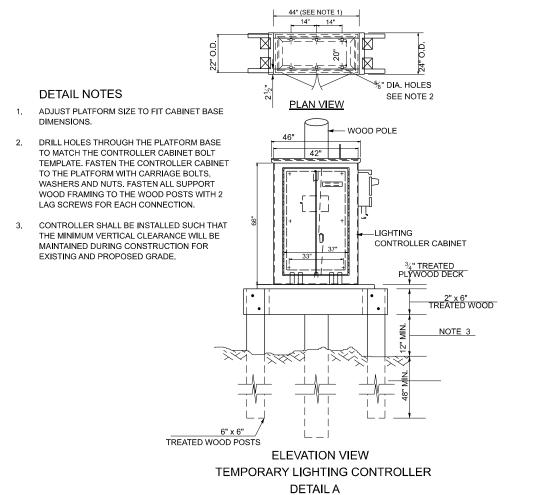

#### **NOTES:**

- SEE SHEET LT-01 FOR LEGEND, ABBREVIATIONS, AND GENERAL NOTES.
- EXISTING LIGHTING UNITS SHALL REMAIN OPERATIONAL DURING STAGE 2.
- TEMPORARY LIGHTING UNITS AND TEMPORARY BRANCH CIRCUITS SHALL BE INSTALLED AND OPERATIONAL PRIOR TO START OF STAGE 2.
- EXISTING LIGHTING UNITS SHALL BE REMOVED AND DISCONNECTED.
- WIRE AND CONDUIT SHOWN TO BE REMOVED SHALL BE ABANDONED IN PLACE UNLESS OTHERWISE SPECIFIED. CONTRACTOR MAY CHOOSE TO REMOVE WIRES FROM ABANDONED CONDUIT AT OWN EXPENSE.

- ALL NECESSARY WORK INCLUDING INSTALLATION OF TEMPORARY WOOD POLES, TEMPORARY SERVICE INSTALLATION, TEMPORARY BRANCH CIRCUITS, AND COORDINATION WITH COMED SHALL BE DONE PRIOR TO CONTROLLER REMOVAL. TEMPORARY LIGHTING SYSTEM SHALL BE MADE OPERATIONAL THE SAME DAY BEFORE DUSK. THERE SHALL BE NO GAP IN THE NIGHT TIME SERVICE OF THE EXISTING OR TEMPORARY LIGHTING SYSTEM.
- THE CONTRACTOR SHALL ENSURE THAT HPS LUMINAIRES ARE CONNECTED TO A 2-POLE BREAKER IN THE TEMPORARY LIGHTING CABINET AND LUMINAIRES SHALL OPERATE AT 480V.
- EXISTING LIGHTING CONTROLLER SHALL REMAIN OPERATIONAL UNTIL TEMPORARY LIGHTING CONTROLLER IS INSTALLED
- SEE SHEET LT-41 TO LT-44 FOR TEMPORARY LIGHTING CONTROLLER DETAILS. AS SHOWN IN THE STANDARD IDOT DEATILS, BOTH THE RIGHT-SIDE AND LEFT-SIDE PANEL BOARDS ARE INDICATED WITH THE 1-POLE BREAKERS. CONTRACTOR SHALL REVISE THE RIGHT-SIDE PANEL BOARD TO BE EQUIPPED WITH 2-POLE BREAKERS FOR THE EXISTING HPS LUMINAIRES. THE LEFT-SIDE PANEL BOARD SHALL REMAIN WITH 1-POLE BREAKERS FOR THE TRMPORARY LED LUMINAIRES, AS SHOWN IN THE DETAILS.

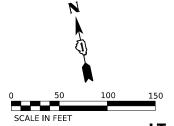

LT-06


USER NAME = mgarvida	DESIGNED - VG	REVISED -
	DRAWN - VN/MAG	REVISED -
PLOT SCALE = 100.000 ' / in.	CHECKED - RP	REVISED -
PLOT DATE = 4/24/2025	DATE - 4/25/2025	REVISED -

STATE OF ILLINOIS **DEPARTMENT OF TRANSPORTATION** 

UNIT DUCT, 600V, 2-1/C NO. 2, 1/C NO. 4 GROUND, (XLP-TYPE USE). 1 1/2" DIA. POLYETHYLENE

REMOV	AL AND	_			RY LIGH ENTER		PLAN – STAGE 2
SCALE:1'=50"	SHEET	4	OF	6	SHEETS	STA.	TO STA.

F.A.I. RTE.	SECTION		COUNTY	TOTAL SHEETS	SHEE NO.
80	FAI 80 21 INTERCHANG	WILL	1209	537	
		CONTRACT	NO. 62F	₹22	
	ILLINOIS	D PROJECT			

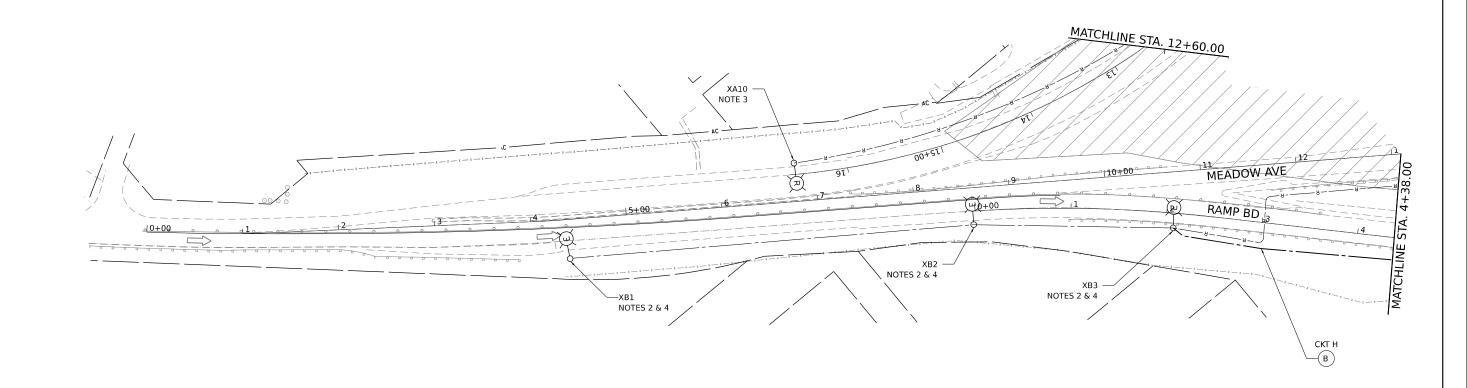


#### <u>LEGEND</u>

- A AERIAL CABLE, 2-1/C NO.2 WITH MESSENGER WIRE (480V, LINE-LINE)
- B UNIT DUCT, 600V, 2-1/C NO. 2, 1/C NO. 4 GROUND, (XLP-TYPE USE). 1 1/2" DIA. POLYETHYLENE (480V, LINE-LINE)
- C UNDERGROUND CONDUIT, PVC SCHEDULE 80, 4" DIA.

#### NOTES:

- 1. SEE SHEET LT-01 FOR LEGEND, ABBREVIATIONS, AND GENERAL NOTES.
- 2. EXISTING LIGHTING UNIT SHALL REMAIN OPERATIONAL DURING STAGE 2.
- 3. EXISTING LIGHTING UNITS SHALL BE REMOVED AND DISCONNECTED.
- 4. THE CONTRACTOR SHALL ENSURE THAT HPS LUMINAIRES ARE CONNECTED TO A 2-POLE BREAKER IN THE TEMPORARY LIGHTING CABINET AND LUMINAIRES SHALL OPERATE AT 480V.

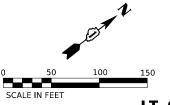


LT-07




USER NAME = mgarvida	DESIGNED - VG	REVISED -
	DRAWN - VN/MAG	REVISED -
PLOT SCALE = 100.000 / in.	CHECKED - RP	REVISED -
PLOT DATE = 4/24/2025	DATE - 4/25/2025	REVISED -

REMOV	AL AND	TE	EMPO	RAI	RY LIGH	ITING	PLAN	- STAGE 2
		I–	-80 A	T C	ENTER	STREE	ĒΤ	
SCALE:1'=50"	SHEET	5	OF	6	SHEETS	STA.		TO STA.

.A.I. RTE	SEC.	TION	COUNTY	TOTAL SHEETS	SHE	
80	FAI 80 21 INT	ERCHAN	GE	WILL	1209	53
				CONTRACT	NO. 62F	R22
		ILLINOIS	D PROJECT			

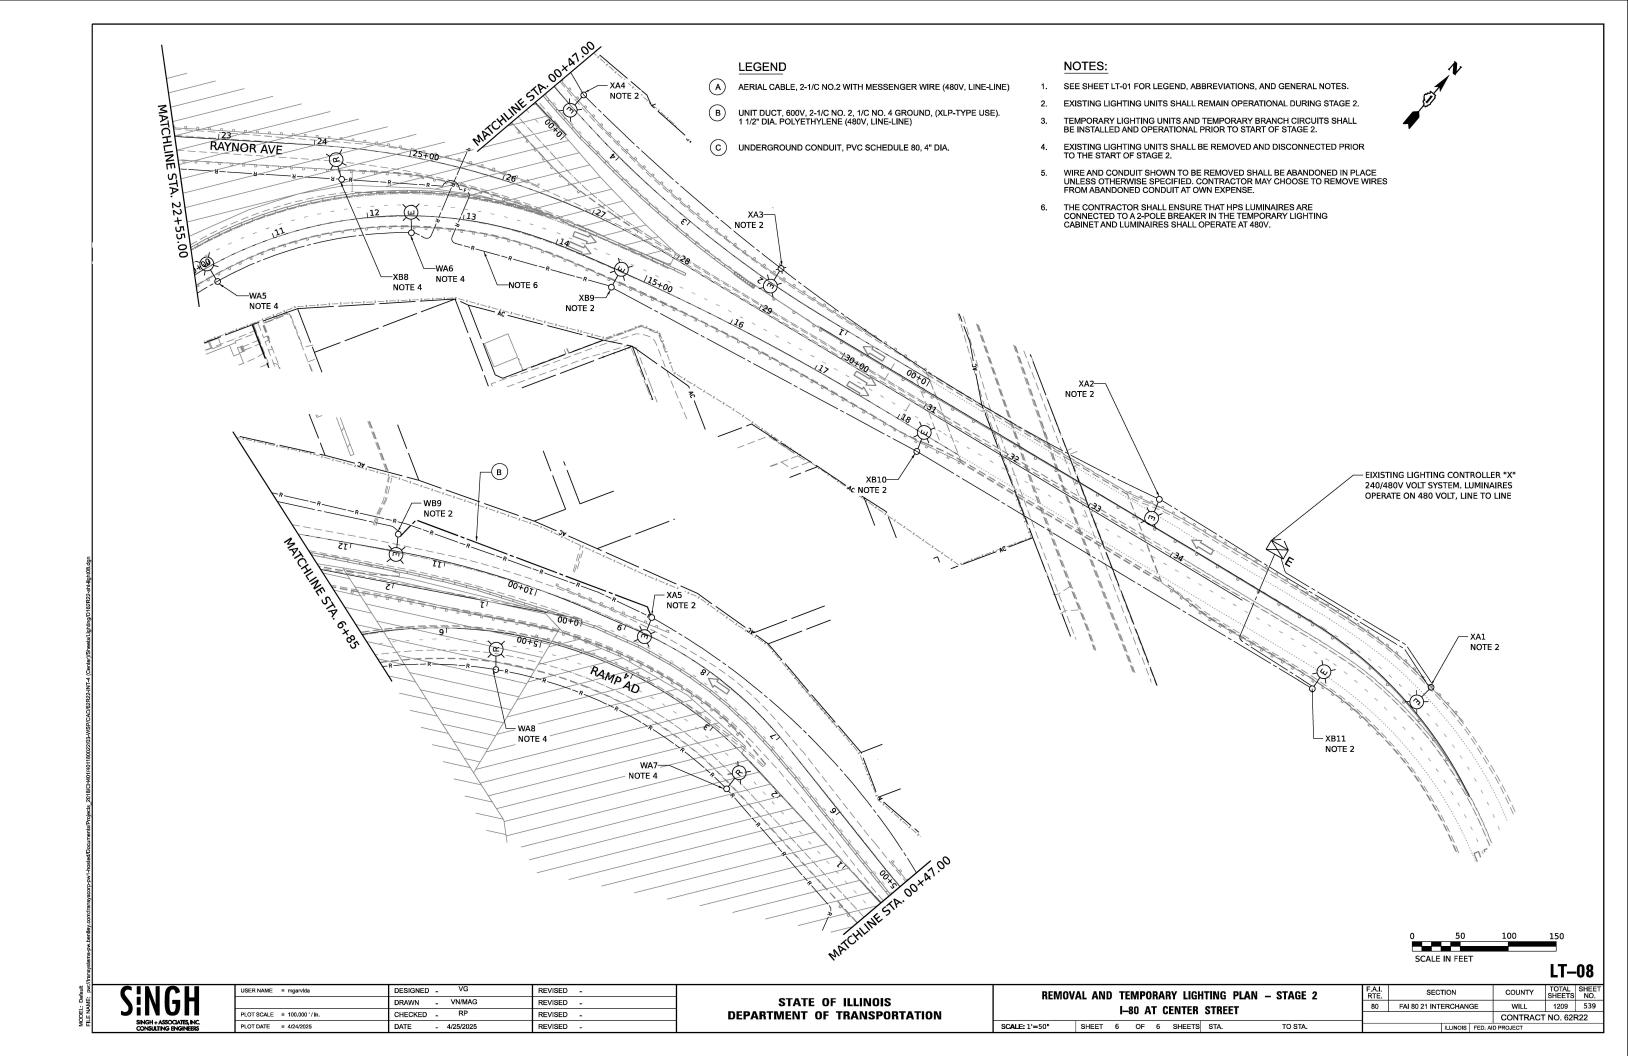

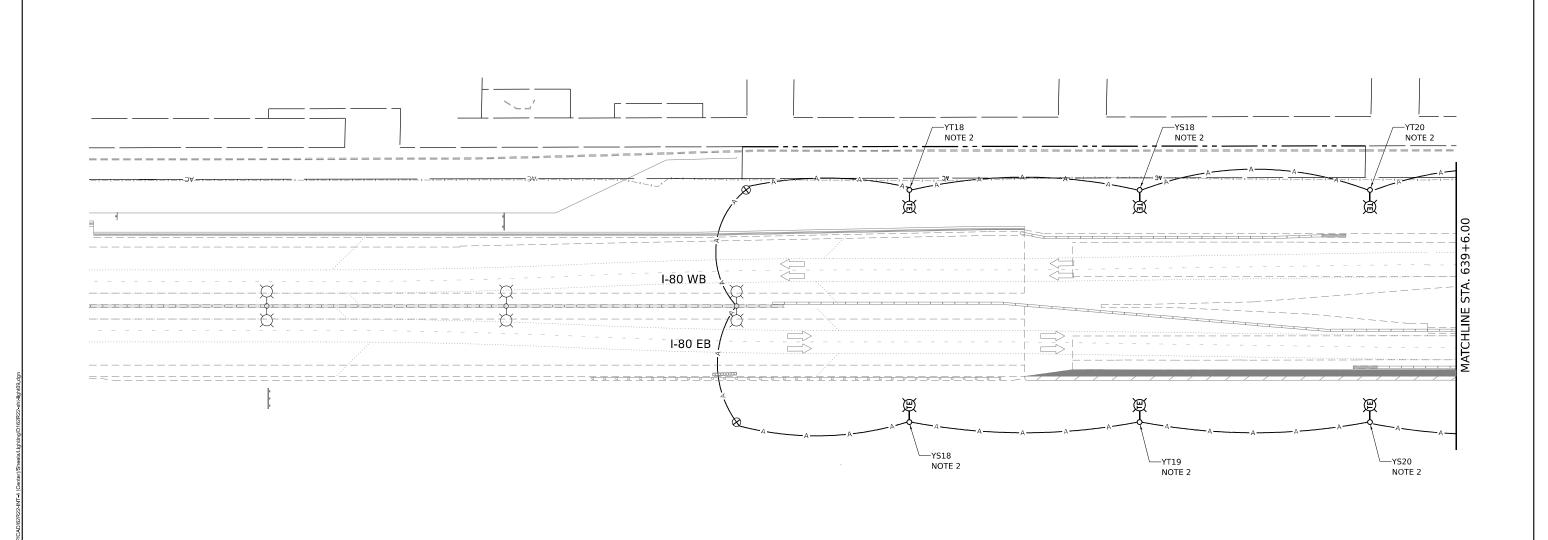


# **LEGEND**

- (A) AERIAL CABLE, 2-1/C NO.2 WITH MESSENGER WIRE (480V, LINE-LINE)
- B UNIT DUCT, 600V, 2-1/C NO. 2, 1/C NO. 4 GROUND, (XLP-TYPE USE). 1 1/2" DIA. POLYETHYLENE (480V, LINE-LNE)
- C UNDERGROUND CONDUIT, PVC SCHEDULE 80, 4" DIA.

# NOTES:

- 1. SEE SHEET LT-01 FOR LEGEND, ABBREVIATIONS, AND GENERAL NOTES.
- 2. TEMPORARY LIGHTING UNITS AND AERIAL CABLES INSTALLED UNDER CONTRACT 62R89 SHALL REMAIN OPERATIONAL DURING STAGE 3.

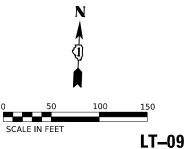

SINGH - ASSOCIATES, INC. CONSULTING ENGINEERS


USER NAME = VGURSKAS	DESIGNED - VG	REVISED -
	DRAWN - VN/MAG	REVISED -
PLOT SCALE = 100.000 ' / in.	CHECKED - RP	REVISED -
PLOT DATE = 6/9/2025	DATE - 4/25/2025	REVISED -

STATE OF ILLINOIS
DEPARTMENT OF TRANSPORTATION

REMOV	AL AND						PLAN – STAGE 3
		I-	8U A	ı	ENIEK	STREET	
SCALE: 1'=50"	SHEET	1	OF	6	SHEETS	STA.	TO STA.

F.A.I. RTE.	SECTION		COUNTY	TOTAL SHEETS	SHEE NO.
80	FAI 80 21 INTERCHAI	IGE	WILL	1209	540
		CONTRACT	NO. 62F	R22	
	ILLINOIS	D PROJECT			

FILE NAME: pw://tra

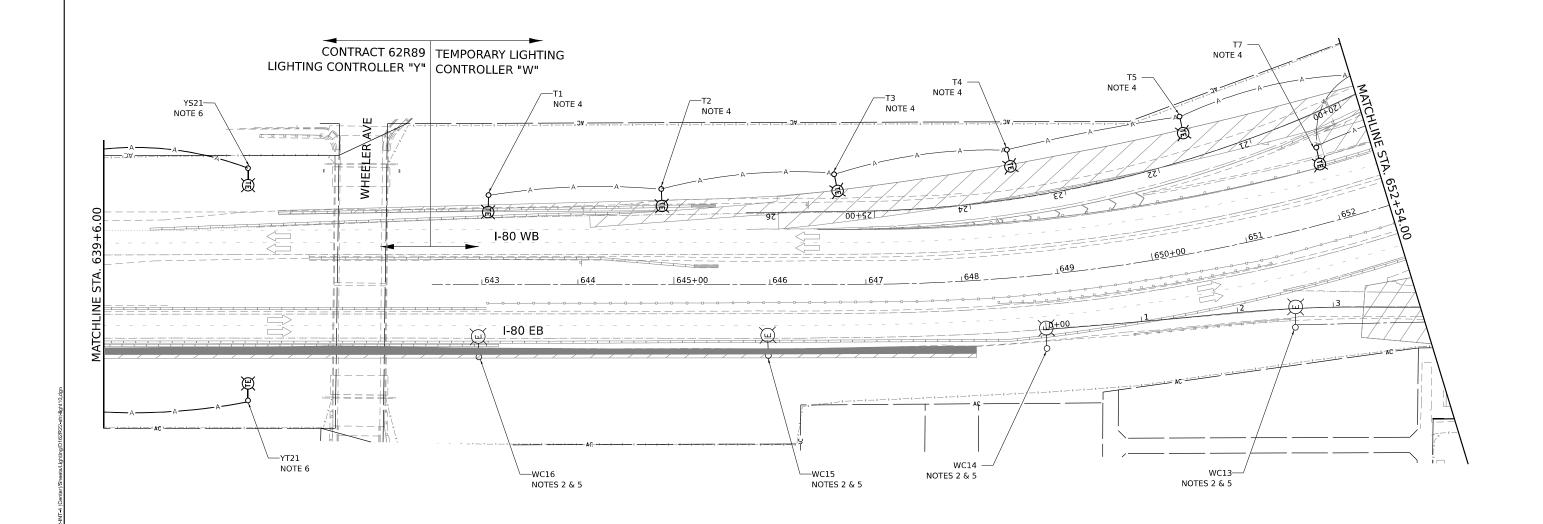


## LEGEND

- (A1) AERIAL CABLE, 3-1/C NO.2 WITH MESSENGER WIRE (240V, LINE-LINE)
- B UNIT DUCT, 600V, 2-1/C NO. 2, 1/C NO. 4 GROUND, (XLP-TYPE USE). 1 1/2" DIA. POLYETHYLENE (480V, LINE-LINE)
- C UNDERGROUND CONDUIT, PVC SCHEDULE 80, 4" DIA.

#### NOTES:

- 1. SEE SHEET LT-01 FOR LEGEND, ABBREVIATIONS, AND GENERAL NOTES.
- 2. EXISTING LIGHTING UNITS SHALL REMAIN OPERATIONAL DURING STAGE 3.
- 3. TEMPORARY LIGHTING UNITS AND TEMPORARY BRANCH CIRCUITS SHALL BE INSTALLED AND OPERATIONAL PRIOR TO START OF STAGE 3. TEMPORARY LUMINAIRES SHALL BE 240V LINE TO NEUTRAL.
- 4. EXISTING TEMPORARY LIGHTING UNITS AND TEMPORARY BRANCH CIRCUITS SHALL REMAIN OPERATIONAL DURING STAGE 3. TEMPORARY LUMINAIRES SHALL BE 240 VOLT LINE TO NEUTRAL.
- 5. THE CONTRACTOR SHALL ENSURE THAT HPS LUMINAIRES ARE CONNECTED TO A 2-POLE BREAKER IN THE TEMPORARY LIGHTING CABINET AND LUMINAIRES SHALL OPERATE AT 480V.
- 6. TEMPORARY LIGHTING UNITS AND AERIAL CABLES INSTALLED UNDER CONTRACT 62R89 SHALL REMAIN OPERATIONAL DURING STAGE 3.

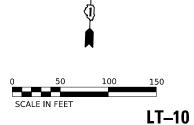

SINGH SINGH+ASSOCIATES, INC. CONSISTING ENGANEERS


USER NAME = VGURSKAS	DESIGNED - VG	REVISED -
	DRAWN - VN/MAG	REVISED -
PLOT SCALE = 100.000 / in.	CHECKED - RP	REVISED -
PLOT DATE = 6/9/2025	DATE - 4/25/2025	REVISED -
PEOT DATE = 6/9/2025	DATE - 4/25/2025	REVISED -


STATE OF ILLINOIS DEPARTMENT OF TRANSPORTATION

	REMOV	AL AND	T	EMP0	RA	RY LIGH	ITING PL	AN - STAGE 3
			ŀ	-80 A	T C	ENTER	STREET	
SCALE:	1'=50"	SHEET	2	OF	6	SHEETS	STA.	TO STA.

I.	SECTION	COUNTY	TOTAL SHEETS	SHEE NO.	
	FAI 80 21 INTERCHANG	3E	WILL	1209	541
		CONTRACT	NO. 62F	R22	
	II I INOIS	EED AU	D PRO IECT		

MODEL: Default FILE NAME: pw://transys

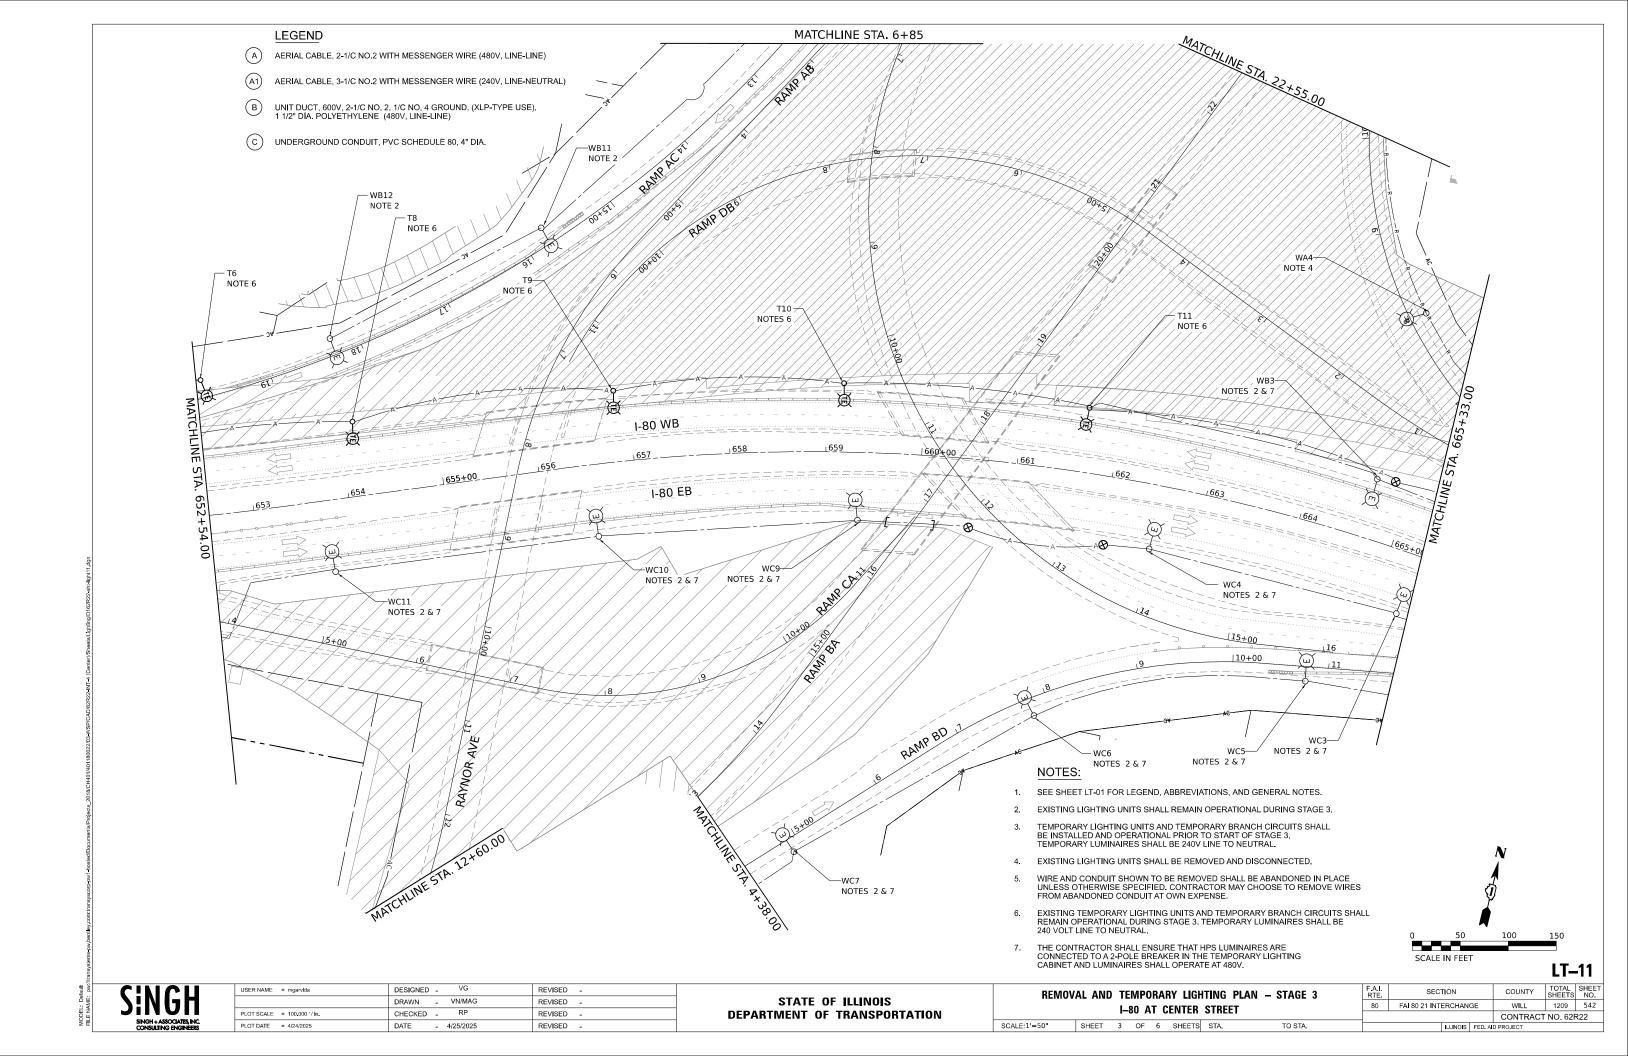

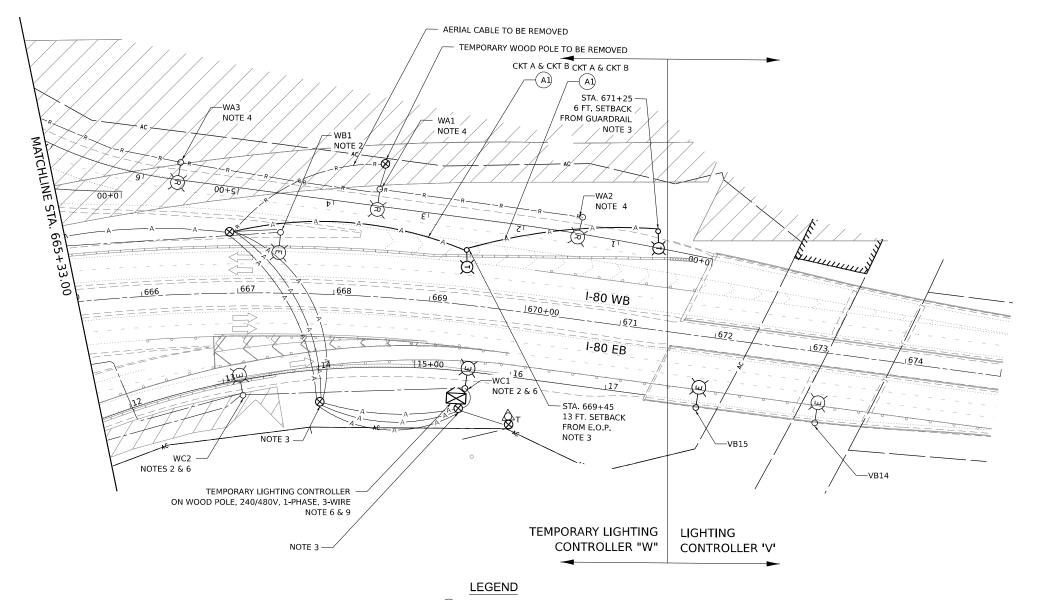

**NOTES** 

- I. SEE SHEET LT-01 FOR LEGEND, ABBREVIATIONS, AND GENERAL NOTES.
- 2. EXISTING LIGHTING UNITS SHALL REMAIN OPERATIONAL DURING STAGE 3.
- 3. TEMPORARY LIGHTING UNITS AND TEMPORARY BRANCH CIRCUITS SHALL BE INSTALLED AND OPERATIONAL PRIOR TO START OF STAGE 3.
- 4. EXISTING LIGHTING UNITS SHALL BE REMOVED AND DISCONNECTED.
- 5. WIRE AND CONDUIT SHOWN TO BE REMOVED SHALL BE ABANDONED IN PLACE UNLESS OTHERWISE SPECIFIED. CONTRACTOR MAY CHOOSE TO REMOVE WIRES FROM ABANDONED CONDUIT AT OWN EXPENSE.
- 6. THE CONTRACTOR SHALL ENSURE THAT HPS LUMINAIRES ARE CONNECTED TO A 2-POLE BREAKER IN THE TEMPORARY LIGHTING CABINET AND LUMINAIRES SHALL OPERATE AT 480V.



0 50 100 150 SCALE IN FEET

LT-12

SINGH SINGH + ASSOCIATES, INC. CONSULTING ENGINEERS

STATE OF ILLINOIS
DEPARTMENT OF TRANSPORTATION

AERIAL CABLE, 3-1/C NO.2 WITH MESSENGER WIRE (240V, LINE-NEUTRAL)


UNIT DUCT, 600V, 2-1/C NO. 2, 1/C NO. 4 GROUND, (XLP-TYPE USE). 1 1/2" DIA. POLYETHYLENE (480V, LINE-LINE)

REMOVAL AND TEMPORARY LIGHTING PLAN - STAGE 3

I-80 AT CENTER STREET

SCALE:1'=50" SHEET 4 OF 6 SHEETS STA. TO STA.

MODEL: Default

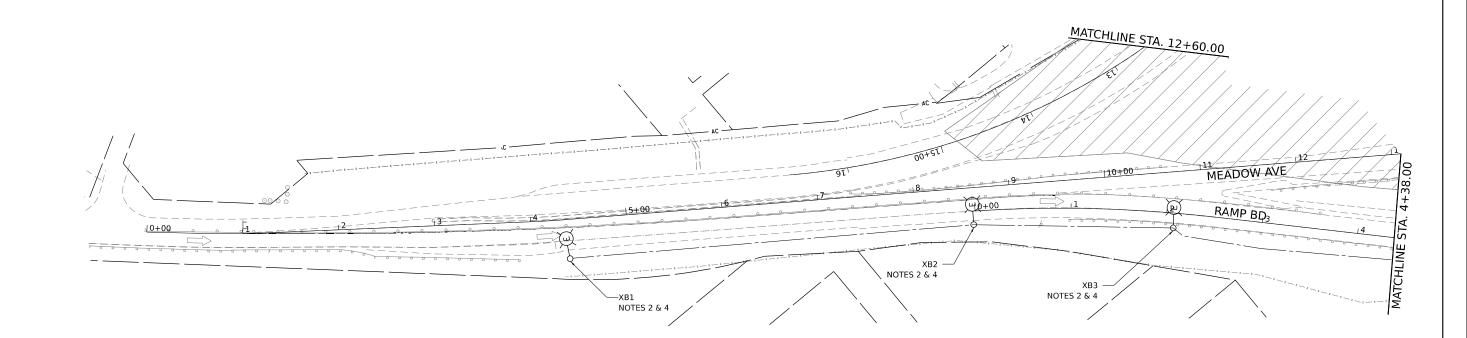


# LEGEND

- A AERIAL CABLE, 2-1/C NO.2 WITH MESSENGER WIRE (480V, LINE-LINE)
- B UNIT DUCT, 600V, 2-1/C NO. 2, 1/C NO. 4 GROUND, (XLP-TYPE USE). 1 1/2" DIA. POLYETHYLENE (480V, LINE-LINE)
- C UNDERGROUND CONDUIT, GALVANIZED STEEL, 3" DIA.

# NOTES:

- 1. SEE SHEET LT-01 FOR LEGEND, ABBREVIATIONS, AND GENERAL NOTES.
- 2. EXISTING LIGHTING UNIT SHALL REMAIN OPERATIONAL DURING STAGE 3
- 3. EXISTING LIGHTING UNITS SHALL BE REMOVED AND DISCONNECTED PRIOR TO THE START OF STAGE 3.
- THE CONTRACTOR SHALL ENSURE THAT HPS LUMINAIRES ARE CONNECTED TO A 2-POLE BREAKER IN THE TEMPORARY LIGHTING CABINET AND LUMINAIRES SHALL OPERATE AT 480V.

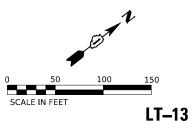



SINGH SINGH+ASSOCIATES, INC. CONSULTING BYGINERS


USER NAME = mgarvida	DESIGNED - VG	REVISED -
	DRAWN - VN/MAG	REVISED -
PLOT SCALE = 100.000 ' / in.	CHECKED - RP	REVISED -
PLOT DATE = 4/24/2025	DATE - 4/25/2025	REVISED -

REMOVAL AND TEMPORARY LIGHTING PLAN - STAGE 3 I-80 AT CENTER STREET							
SCALE:1'=50"	SHEET	5	OF	6	SHEETS	STA.	TO STA.

						•••
A.I. RTE	SEC.	ПОИ		COUNTY	TOTAL SHEETS	SHEE
80	FAI 80 21 INT	ERCHAN	GE	WILL	1209	544
			CONTRACT	NO. 62F	R22	
		ILLINOIS	FED. A	D PROJECT		

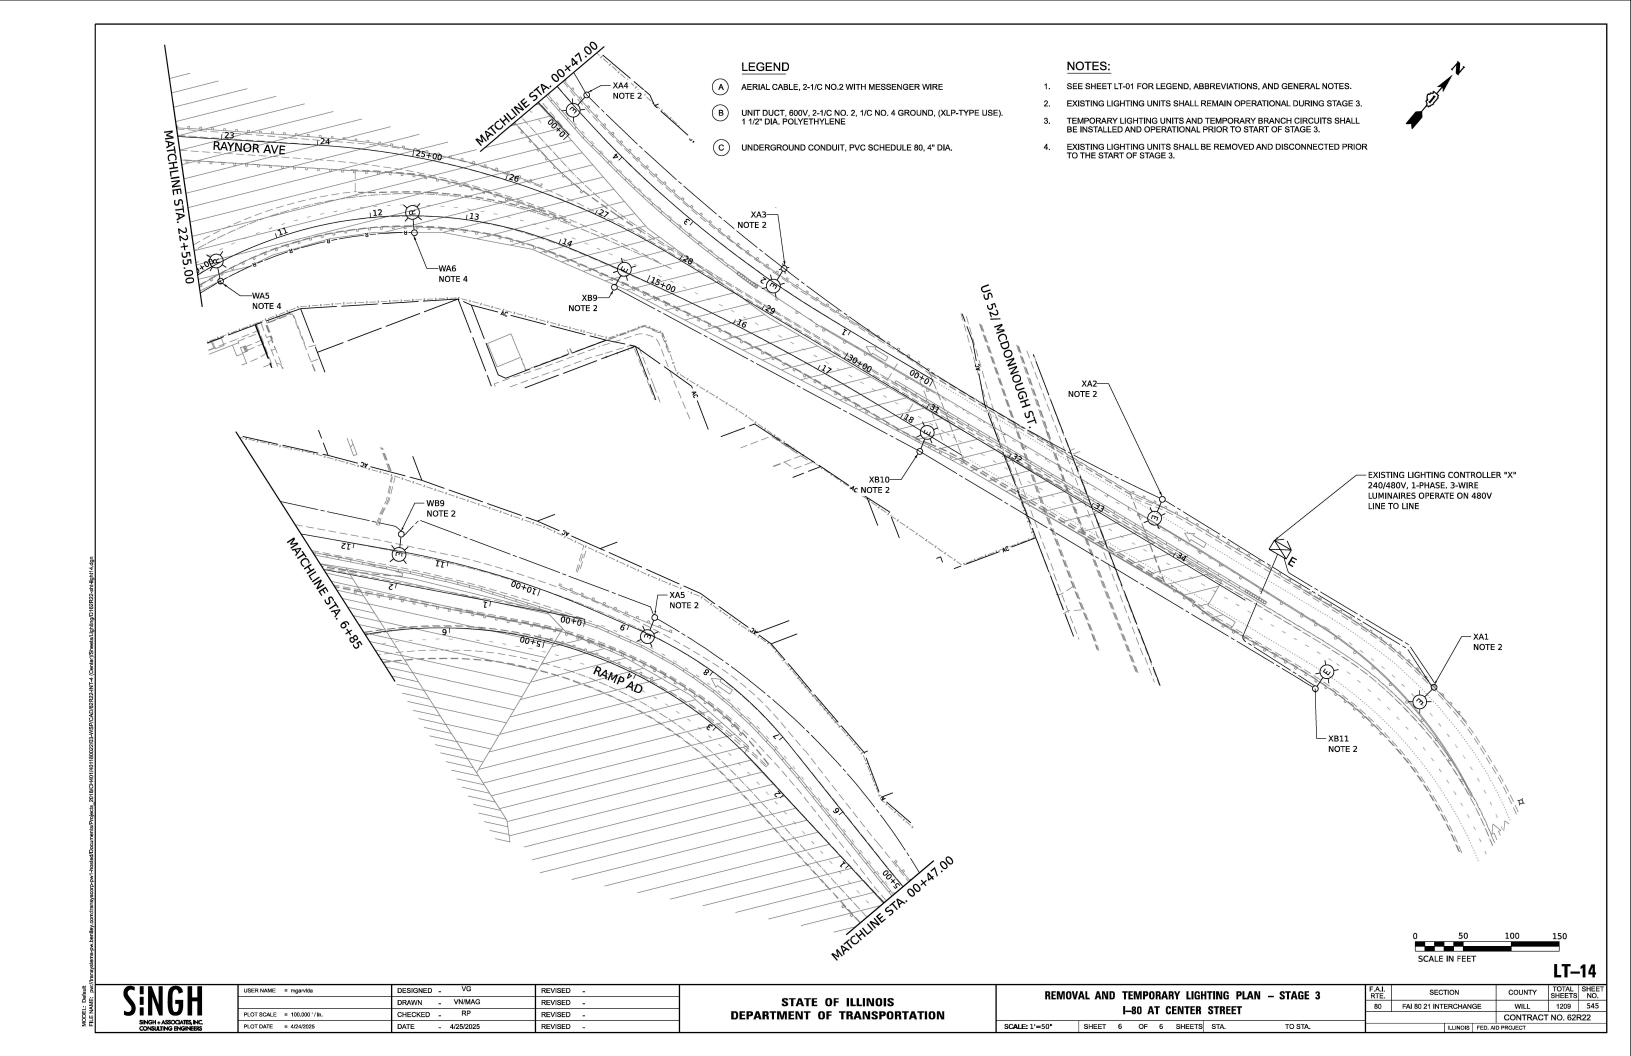

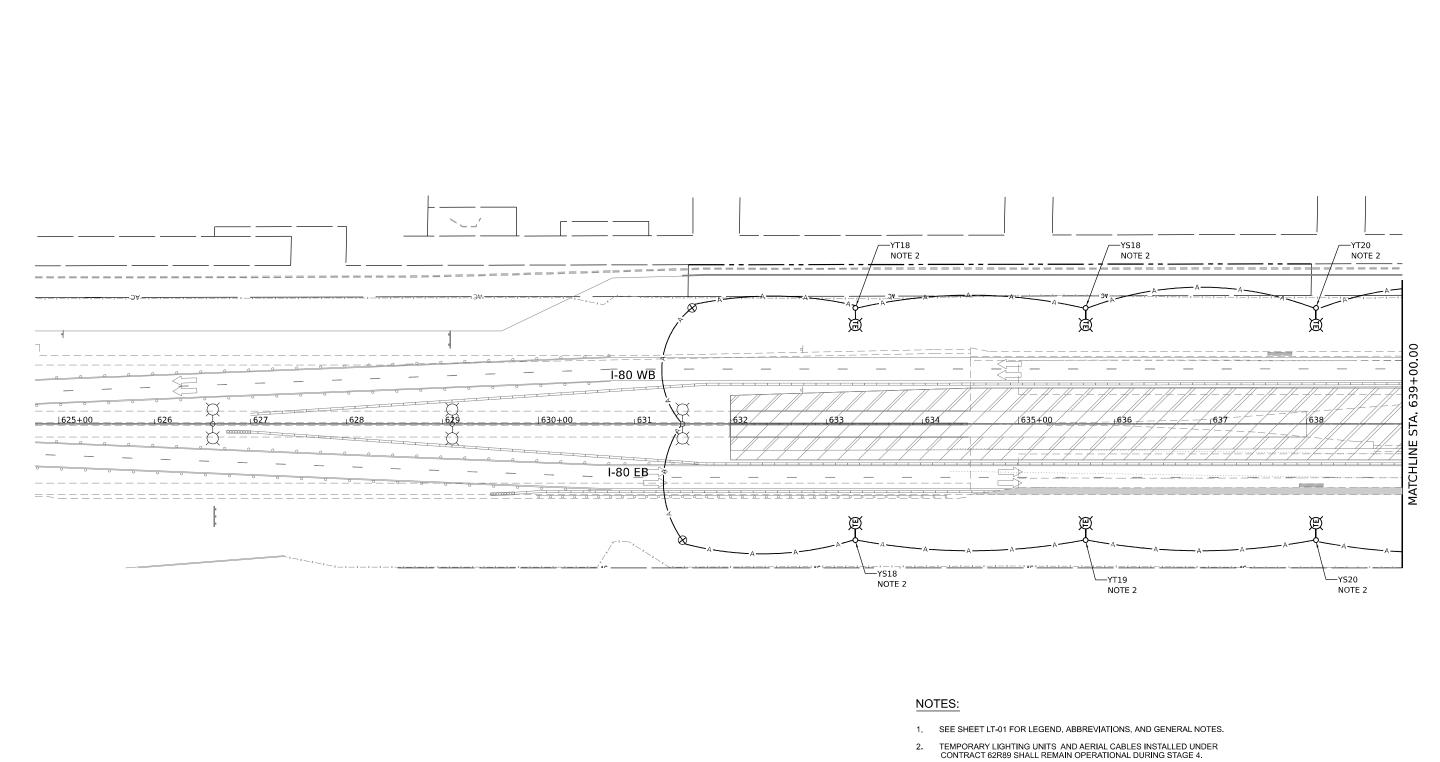

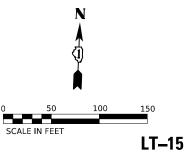


S	IN	G	H
	SINGH+.	ASSOCIA'	

USER NAME = VGURSKAS DESIGNED - VG	REVISED -
DRAWN - VN/MAG	REVISED -
PLOT SCALE = 100.000 / ln. CHECKED - RP	REVISED -
PLOT DATE = 6/9/2025 DATE - 4/25/2025	REVISED -

STAT	E 01	F ILLINOIS
DEPARTMENT	0F	TRANSPORTATION

REMOVAL AND TEMPORARY LIGHTING PLAN — STAGE 4 I—80 AT CENTER STREET							
SCALE: 1'=50"	SHEET	1	OF	6	SHEETS	STA.	TO STA.

				L!-	1,
F.A.I. RTE.	SECTION	COUNTY	TOTAL SHEETS	SH N	
80	FAI 80 21 INTERCHAN	WILL	1209	5	
		CONTRACT	NO. 62F	₹22	
	ILLINOIS	FED. Al	D PROJECT		

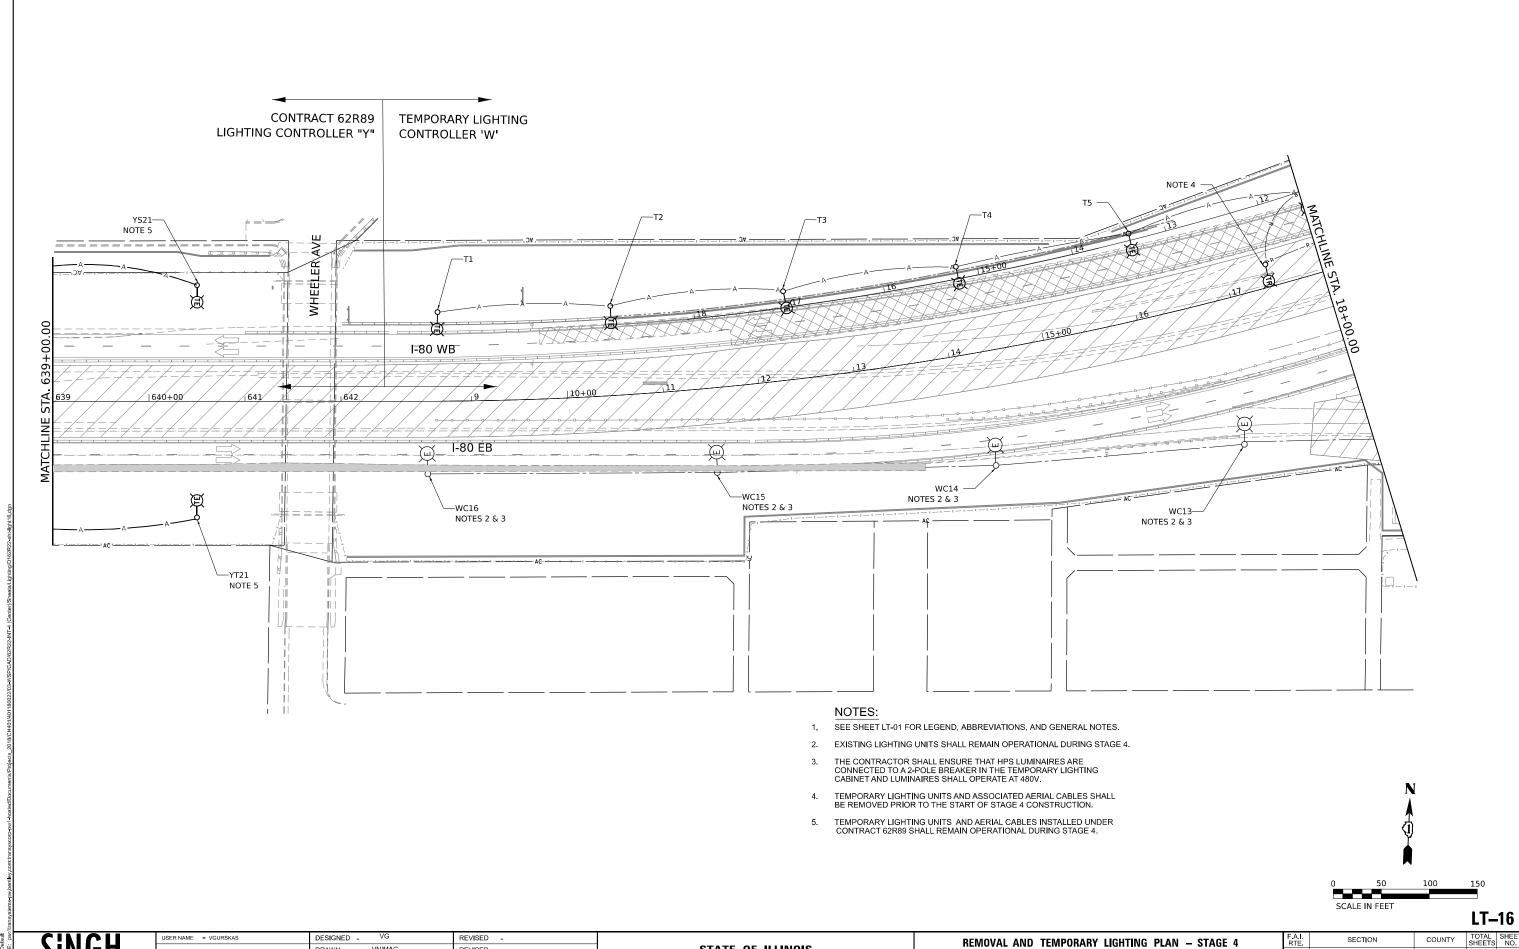


SINGH-ASSOCIATES, IN CONSULTING ENGINEE

STATE OF ILLINOIS
DEPARTMENT OF TRANSPORTATION

REMOVAL AND TEMPORARY LIGHTING PLAN - STAGE 4

I-80 AT CENTER STREET

SCALE: 1'=50" SHEET 2 OF 6 SHEETS STA. TO STA.

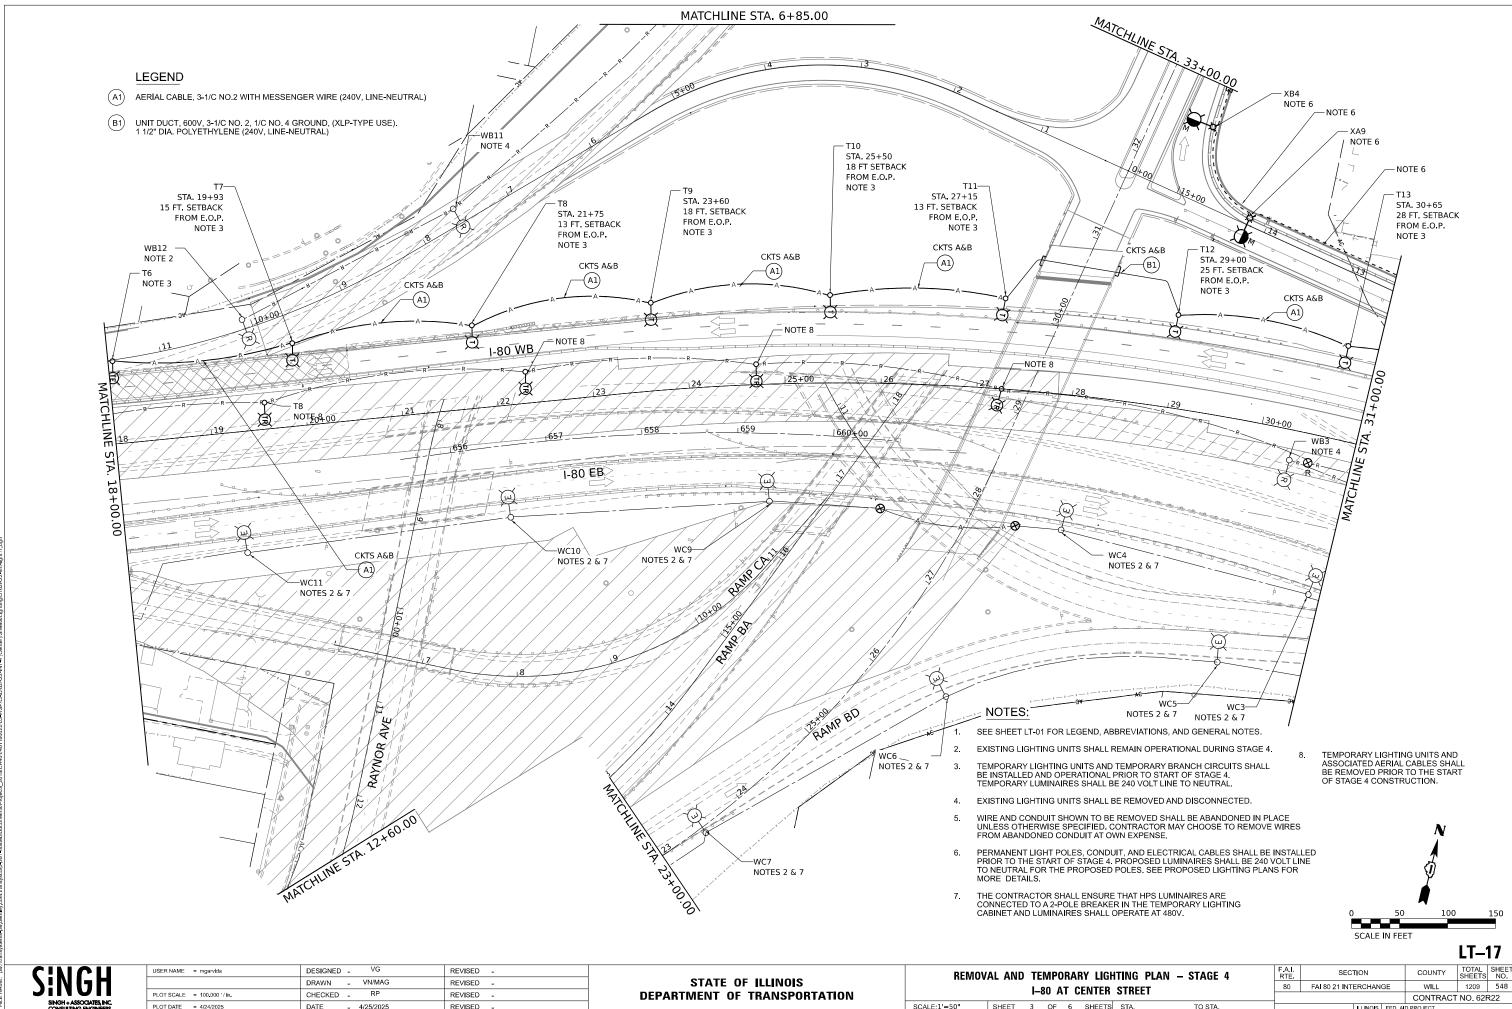



PLOT DATE = 4/24/2025 DATE REVISED - 4/25/2025

SHEET 3 OF 6 SHEETS STA. TO STA.

# **LEGEND**

- (A1) AERIAL CABLE, 3-1/C NO.2 WITH MESSENGER WIRE (240V, LINE-NEUTRAL)
- UNIT DUCT, 600V, 3-1/C NO. 2, 1/C NO. 4 GROUND, (XLP-TYPE USE). 1 1/2" DIA. POLYETHYLENE (240V, LINE-NEUTRAL)
- NOTES:
- 1. SEE SHEET LT-01 FOR LEGEND, ABBREVIATIONS, AND GENERAL NOTES.
- EXISTING LIGHTING UNITS SHALL REMAIN OPERATIONAL DURING STAGE 4.
- TEMPORARY LIGHTING UNITS AND TEMPORARY BRANCH CIRCUITS SHALL BE INSTALLED AND OPERATIONAL PRIOR TO START OF STAGE 4. TEMPORARY LUMINAIRES SHALL BE 240 VOLT LINE TO NEUTRAL.
- EXISTING LIGHTING UNITS SHALL BE REMOVED AND DISCONNECTED.
- WIRE AND CONDUIT SHOWN TO BE REMOVED SHALL BE ABANDONED IN PLACE UNLESS OTHERWISE SPECIFIED. CONTRACTOR MAY CHOOSE TO REMOVE WIRES FROM ABANDONED CONDUIT AT OWN EXPENSE.

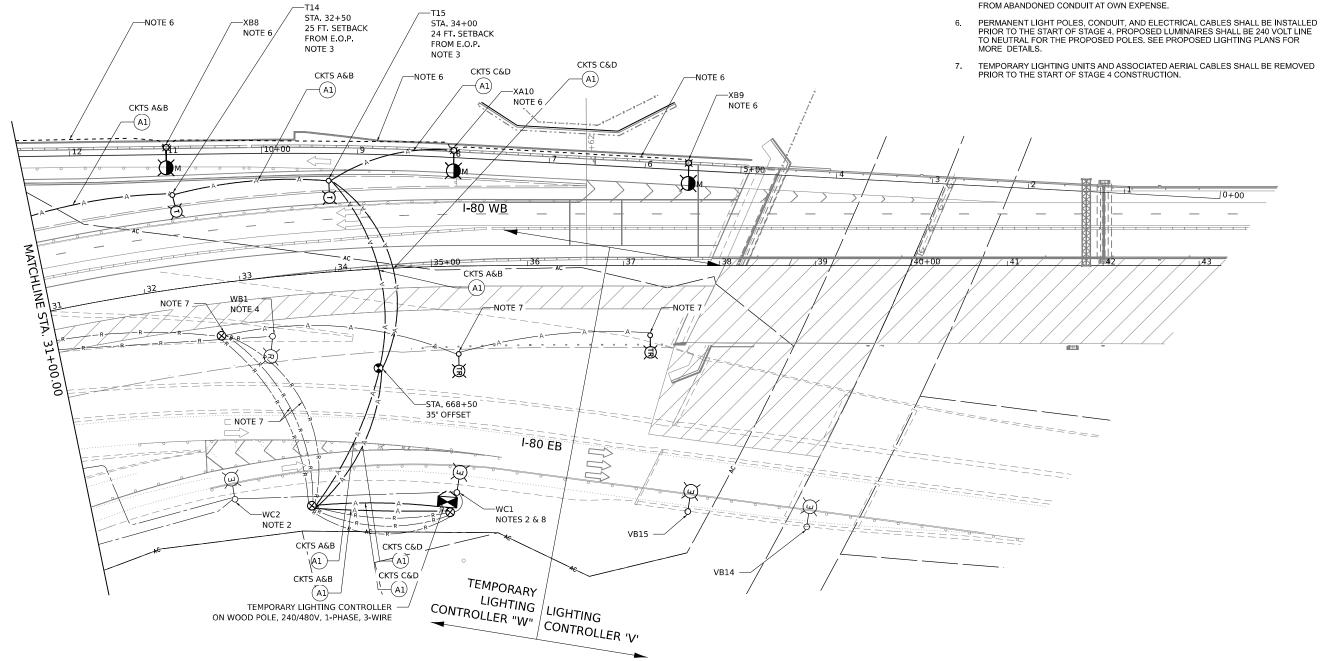

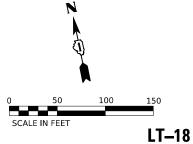


S	IN	G	H
	SINGH+	ASSOCIAT	

USER NAME = mgarvlda	DESIGNED - VG	REVISED -
	DRAWN - VN/MAG	REVISED -
PLOT SCALE = 100.000'/in.	CHECKED - RP	REVISED -
PLOT DATE = 4/24/2025	DATE - 4/25/2025	REVISED -

REMOV	AL AND	TE	MPO	RAR	Y LIGH	ITING	PLAN - STAGE 4
I-80 AT CENTER STREET							
SCALE:1'=50"	SHEET	4	OF	6	SHEETS	STA.	TO STA.


F.A.I. RTE	SECTION	COUNTY	TOTAL SHEETS	SHE
80	FAI 80 21 INTERCHANG	WILL	1209	54
		CONTRACT	NO. 62F	R22
	ILLINOIS	D PROJECT		

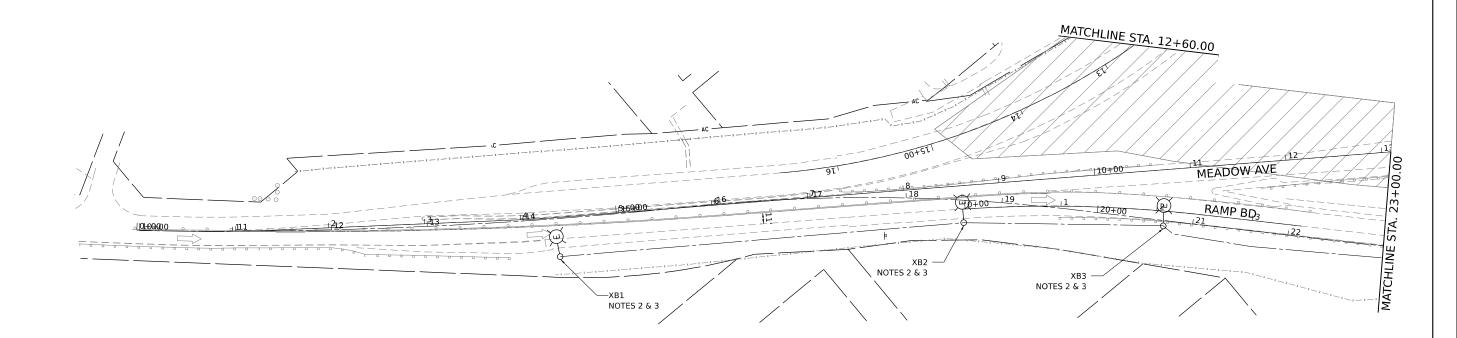

# NOTES:

- 1. SEE SHEET LT-01 FOR LEGEND, ABBREVIATIONS, AND GENERAL NOTES.
- 2. EXISTING LIGHTING UNITS SHALL REMAIN OPERATIONAL DURING STAGE 4.
- THE CONTRACTOR SHALL ENSURE THAT HPS LUMINAIRES ARE CONNECTED TO A 2-POLE BREAKER IN THE TEMPORARY LIGHTING CABINET AND LUMINAIRES SHALL OPERATE AT 480V.

  THE CONTRACTOR SHALL ENSURE THAT HPS LUMINAIRES ARE CONNECTED TO THE SHALL OPERATE AT 480V.

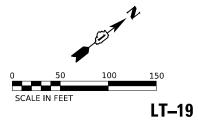



S	N	G	H
		SSOCIAT	

USER NAME = mgarvida	DESIGNED - VG	REVISED -
	DRAWN - VN/MAG	REVISED -
PLOT SCALE = 100.000 / in.	CHECKED - RP	REVISED -
PLOT DATE = 4/24/2025	DATE - 4/25/2025	REVISED -

REMOV	AL AND	-				ITING PI Street	LAN – STAGE 4
SCALE:1'=50"	SHEET	5	OF	6	SHEETS	STA.	TO STA.


F.A.I. RTE.	SEC <sup>-</sup>	TION		COUNTY	TOTAL SHEETS	SHEE NO.
80	FAI 80 21 INT	ERCHAN	GE	WILL	1209	550
				CONTRACT	NO. 62F	₹22
		ILLINOIS	FED. A	D PROJECT		

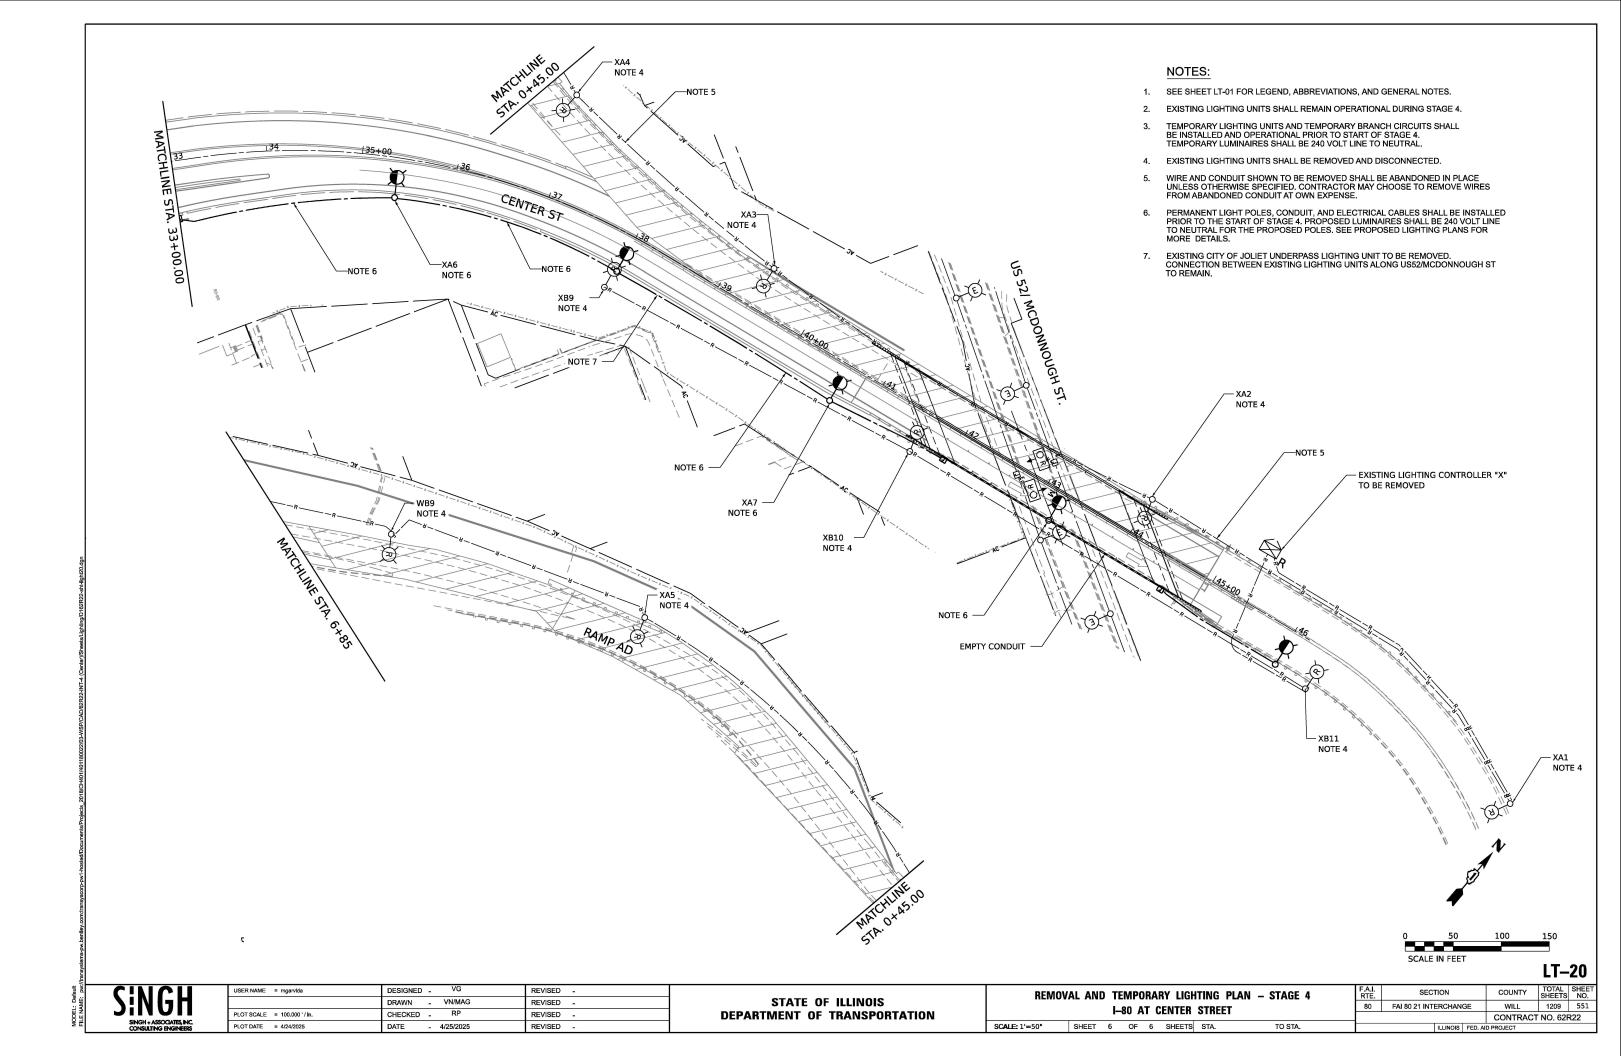

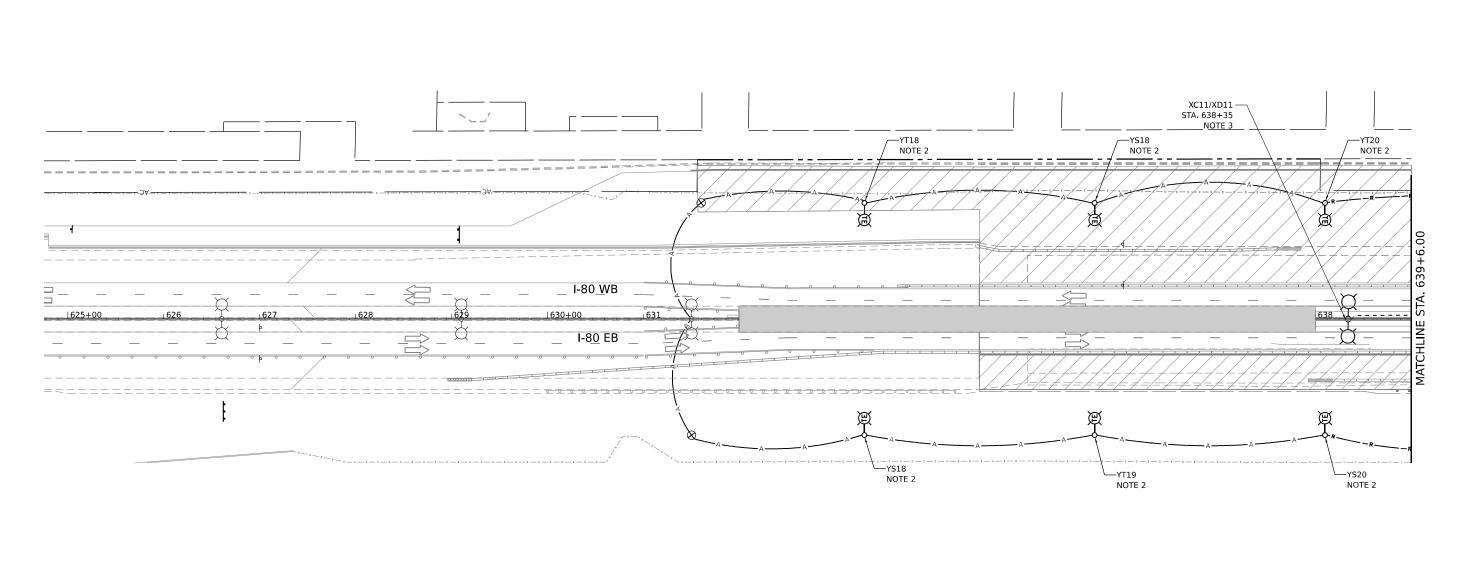

#### NOTES:

- 1. SEE SHEET LT-01 FOR LEGEND, ABBREVIATIONS, AND GENERAL NOTES.
- TEMPORARY LIGHTING UNITS AND AERIAL CABLES INSTALLED UNDER CONTRACT 62R89 SHALL REMAIN OPERATIONAL DURING STAGE 5.
- 3. PERMANENT LIGHT POLES SHALL BE OPERATIONAL AT THE START OF STAGE 5.

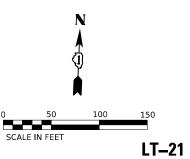


S		N	G	H
	SIL		SSOCIA	


USER NAME = VGURSKAS	DESIGNED - VG	REVISED -
	DRAWN - VN/MAG	REVISED -
PLOT SCALE = 100.000 ' / in.	CHECKED - RP	REVISED -
PLOT DATE = 6/9/2025	DATE - 4/25/2025	REVISED -

REMOVAL AND TEMPORARY LIGHTING PLAN — STAGE 5 I—80 AT CENTER STREET							
		I–	80 A	T C	ENTER	STREE	Г
SCALE: 1'=50"	SHEET	1	OF	6	SHEETS	STA.	TO STA.

F.A.I. RTE.	SECTION			COUNTY	TOTAL SHEETS	SHEE NO.
80	FAI 80 21 INTERCHANGE			WILL	1209	552
				CONTRACT	NO. 62F	₹22
ILLINOIS FED. AI			D PROJECT			

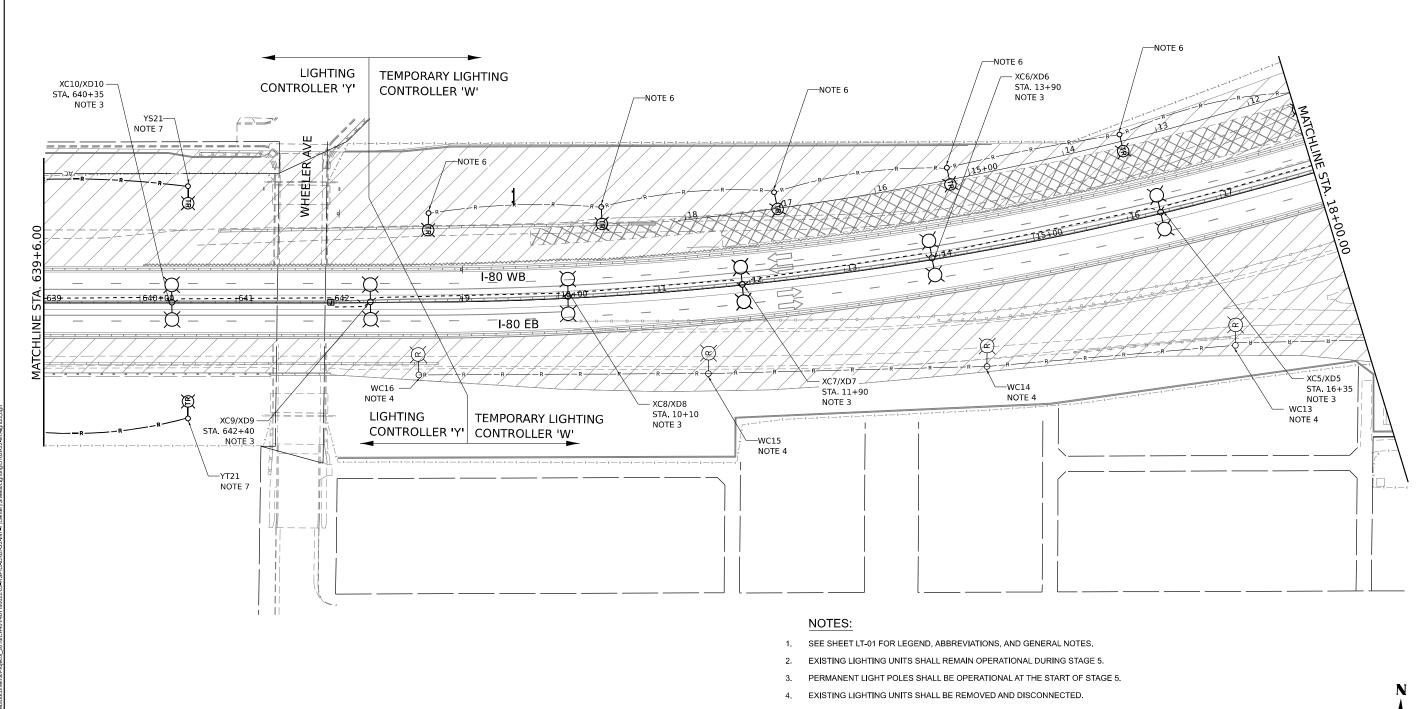

- 5. WIRE AND CONDUIT SHOWN TO BE REMOVED SHALL BE ABANDONED IN PLACE UNLESS OTHERWISE SPECIFIED. CONTRACTOR MAY CHOOSE TO REMOVE WIRES FROM ABANDONED CONDUIT AT OWN EXPENSE.
- 6. EXISTING TEMPORARY LIGHTING UNITS AND TEMPORARY BRANCH CIRCUITS SHALL BE REMOVED.
- 7. EXISTING TEMPORARY LIGHTING UNITS AND AERIAL CABLES INSTALLED UNDER CONTRACT 62R89 SHALL BE REMOVED.

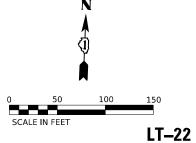



SINGH ASSOCIATES INC


USER NAME = VGURSKAS	DESIGNED - VG	REVISED -	
	DRAWN - VN/MAG	REVISED -	
PLOT SCALE = 100.000 ' / in.	CHECKED - RP	REVISED -	
PLOT DATE = 6/9/2025	DATE - 4/25/2025	REVISED -	

	REMOV	AL AND	_			RY LIGH ENTER		PLAN – STAGE 5 ET
SCALE:	1'=50"	SHEET	2	OF	6	SHEETS	STA.	TO STA.

F.A.I. RTE.	SECTION			COUNTY	TOTAL SHEETS	SHEE NO.
80	FAI 80 21 INTERCHANGE			WILL	1209	553
			CONTRACT	NO. 62F	R22	
ILLINOIS FED. A				D PROJECT		

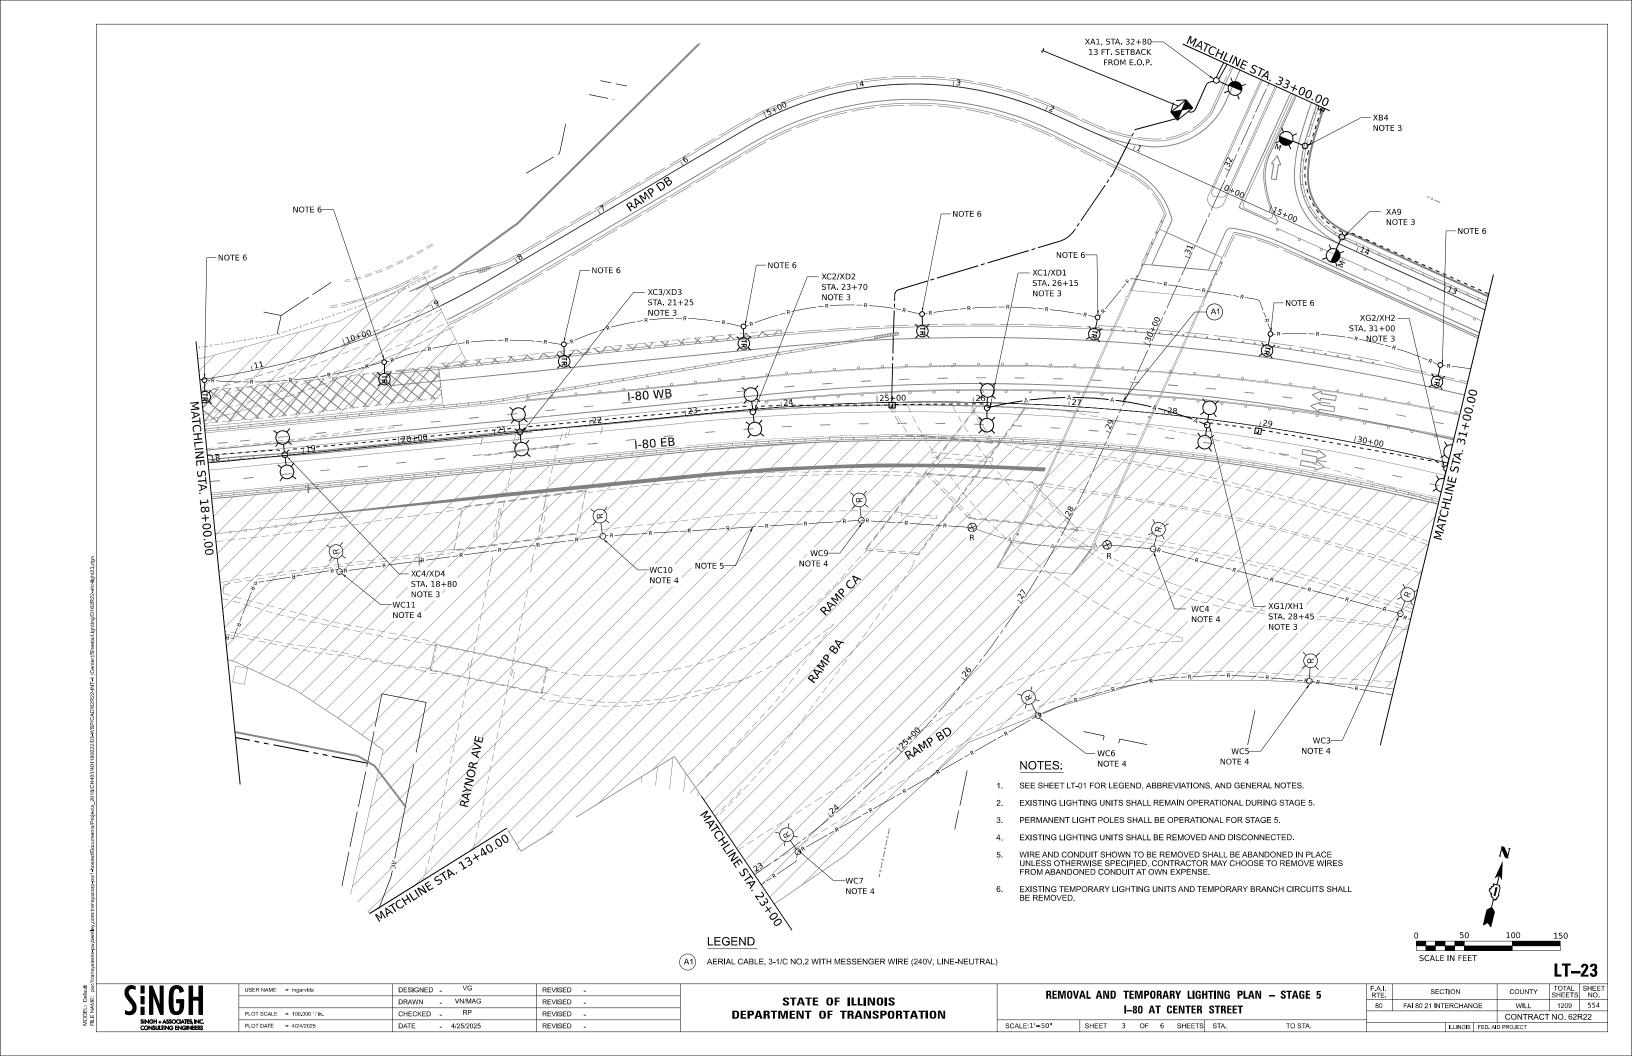

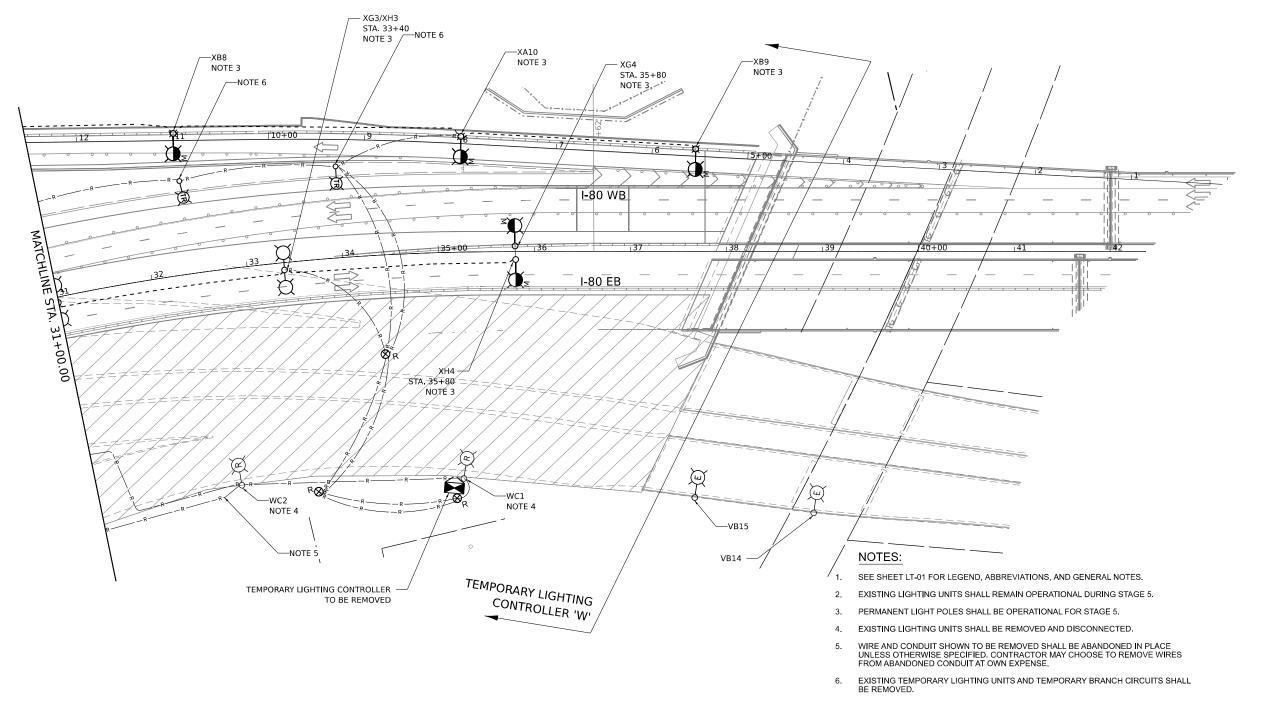

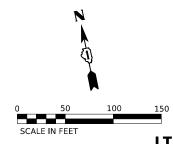


LT-24

SINGH ASSOCIATES, INC.

USER NAME = mgarvida	DESIGNED - VG	REVISED -
	DRAWN - VN/MAG	REVISED -
PLOT SCALE = 100.000 '/ in.	CHECKED - RP	REVISED -
PLOT DATE = 4/24/2025	DATE - 4/25/2025	REVISED -


REMOV	AL AND					ITING P Street	LAN – STAGE 5
SCALE:1'=50"	SHEET	4	OF	6	SHEETS	STA.	TO STA.

F.A.I. RTE	SECTION		COUNTY	TOTAL SHEETS	SHE	
80	FAI 80 21 INTERCHAN	WILL	1209	555		
		CONTRACT NO. 62R22				
	ILLINOIS	FED. All	D PROJECT			

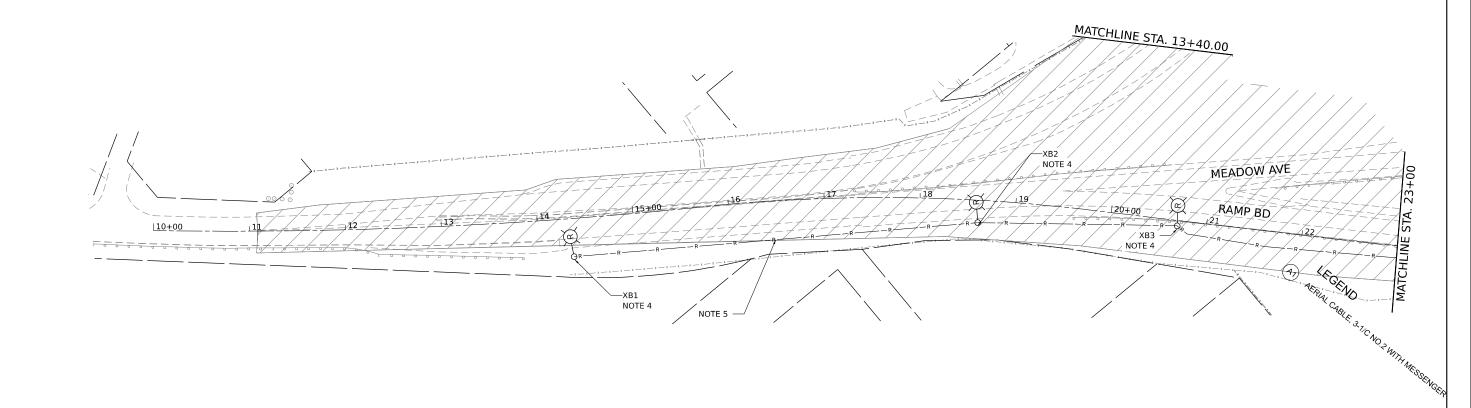

#### NOTES:

- 1. SEE SHEET LT-01 FOR LEGEND, ABBREVIATIONS, AND GENERAL NOTES.
- 2. EXISTING LIGHTING UNITS SHALL REMAIN OPERATIONAL DURING STAGE 5.
- 3. TEMPORARY LIGHTING UNITS AND TEMPORARY BRANCH CIRCUITS SHALL BE INSTALLED AND OPERATIONAL PRIOR TO START OF STAGE 5. TEMPORARY LUMINAIRES SHALL BE 240 VOLT LINE TO NEUTRAL.
- 4. EXISTING LIGHTING UNITS SHALL BE REMOVED AND DISCONNECTED PRIOR TO THE START OF STAGE 5.
- 5. WIRE AND CONDUIT SHOWN TO BE REMOVED SHALL BE ABANDONED IN PLACE UNLESS OTHERWISE SPECIFIED. CONTRACTOR MAY CHOOSE TO REMOVE WIRES FROM ABANDONED CONDUIT AT OWN EXPENSE.

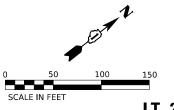


LT-25


SINGH SINGH ASSOCIATES, INC.

USER NAME = mgarvida	DESIGNED - VG	REVISED -
	DRAWN - VN/MAG	REVISED -
PLOT SCALE = 100.000 / in.	CHECKED - RP	REVISED -
PLOT DATE = 4/24/2025	DATE - 4/25/2025	REVISED -

REMOV	AL AND	TE	MPO	RAI	RY LIGH	ITING F	PLAN – STAGE 5			
I-80 AT CENTER STREET										
SCALE:1'=50"	SHEET	5	OF	6	SHEETS	STA.	TO STA.			


F.A.I. RTE	SECTION		COUNTY	TOTAL SHEETS	SHEE NO.
80	FAI 80 21 INTERCHA	NGE	WILL	1209	556
		CONTRACT	NO. 62F	R22	
	ILLINOI	D PROJECT			

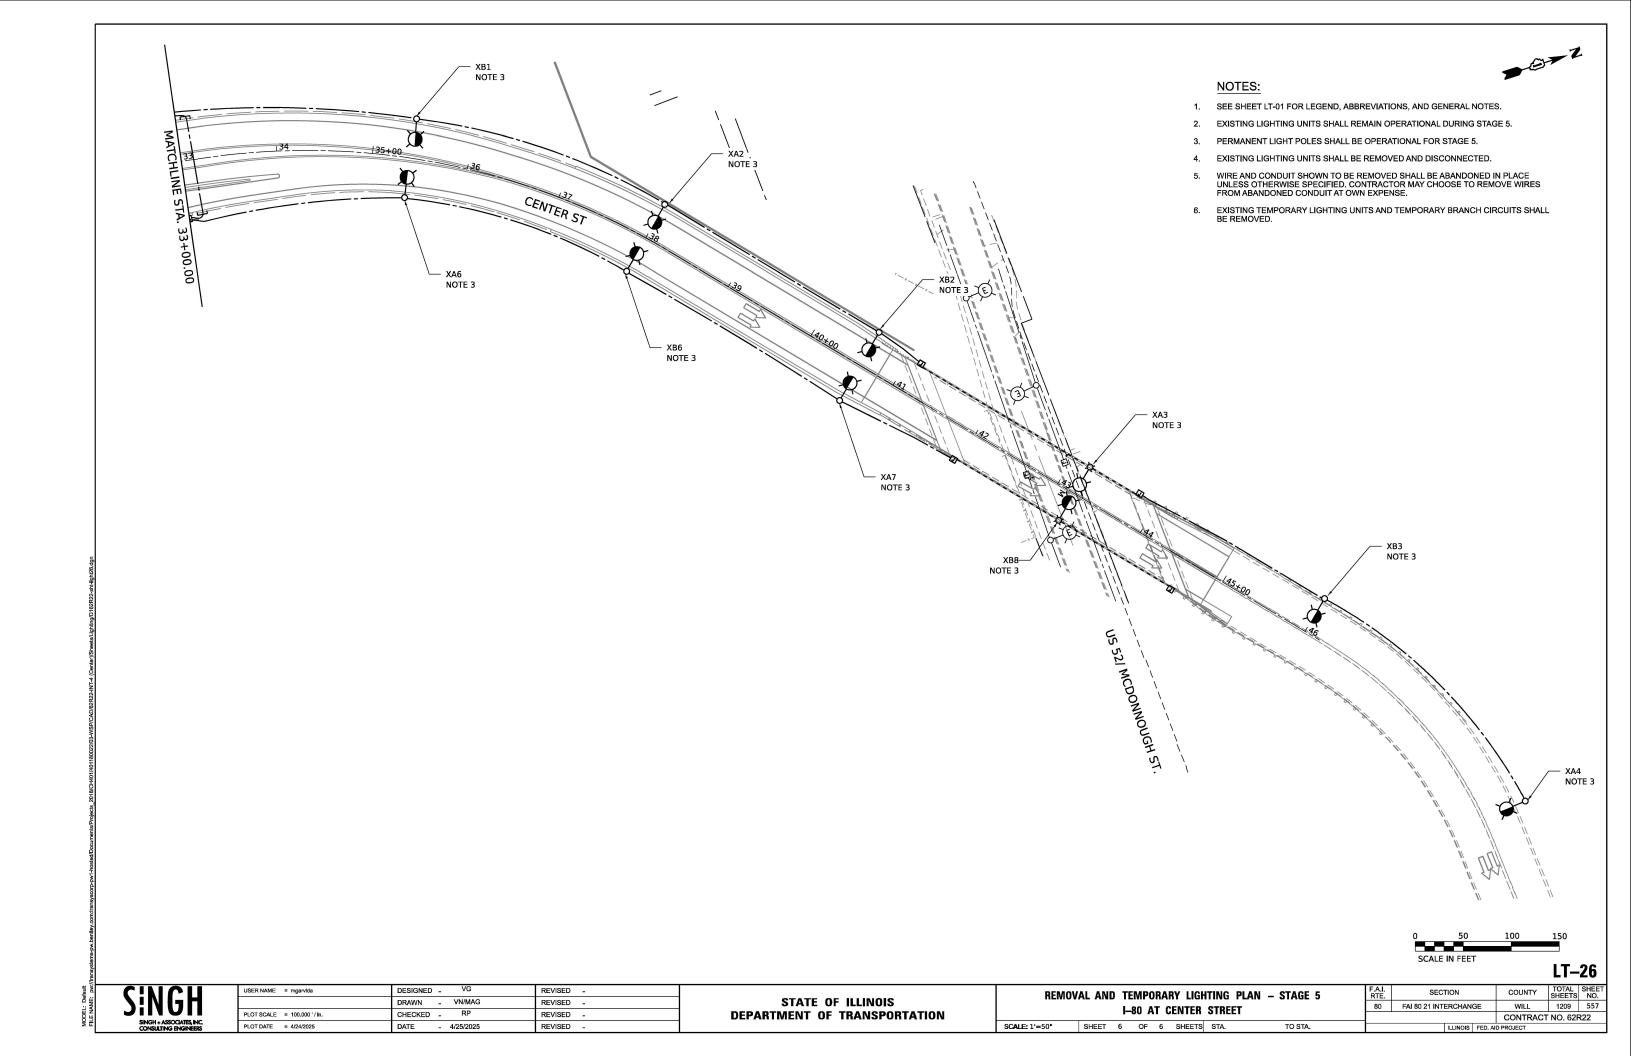

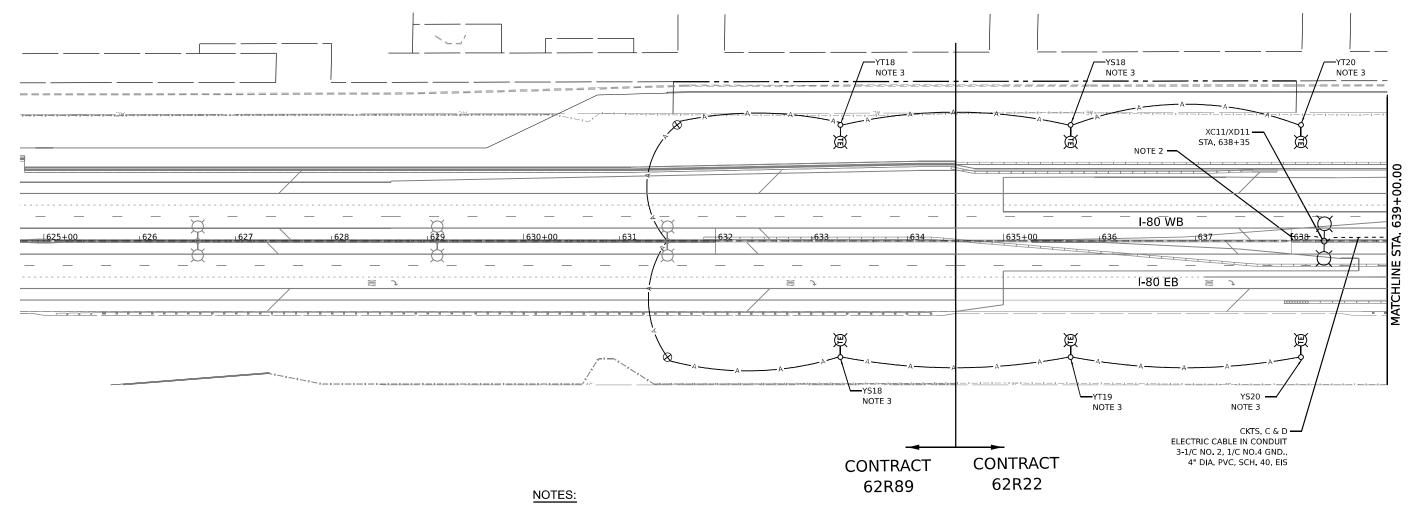

#### SEE SHEET LT-01 FOR LEGEND, ABBREVIATIONS, AND GENERAL NOTES.

- 2. CAP CONDUIT FOR FUTURE CONNECTION UNDER CONTRACT 62W95.
- TEMPORARY LIGHTING UNITS AND AERIAL CABLES INSTALLED UNDER CONTRACT 62R89 SHALL REMAIN OPERATIONAL AT THE END OF THE CONTRACT 62R22 AND SHALL NOT BE REMOVED.

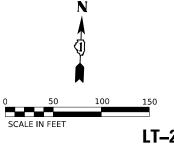


S		N	G	H
	SIL		SSOCIA	


USER NAME = VGURSKAS	DESIGNED - VG	REVISED -
	DRAWN - VN/MAG	REVISED -
PLOT SCALE = 100.000 / in.	CHECKED - RP	REVISED -
PLOT DATE = 6/9/2025	DATE - 4/25/2025	REVISED -


STATE OF ILLINOIS
DEPARTMENT OF TRANSPORTATION

										F.A.I. SECTION			COUNTY	TOTAL SHEETS	SHEET NO.
1			PK	0202	ΕD	LIGHTI	NG PLAN		80	80 FAI 80 21 INTERCHANGE		WILL	1209	558	
													CONTRACT	NO. 621	R22
SC	CALE: 1'=50"	SHEET	1	OF	6	SHEETS	STA.	TO STA.			ILLINOIS	FED. A	D PROJECT		

FILE NAME: pw://tran

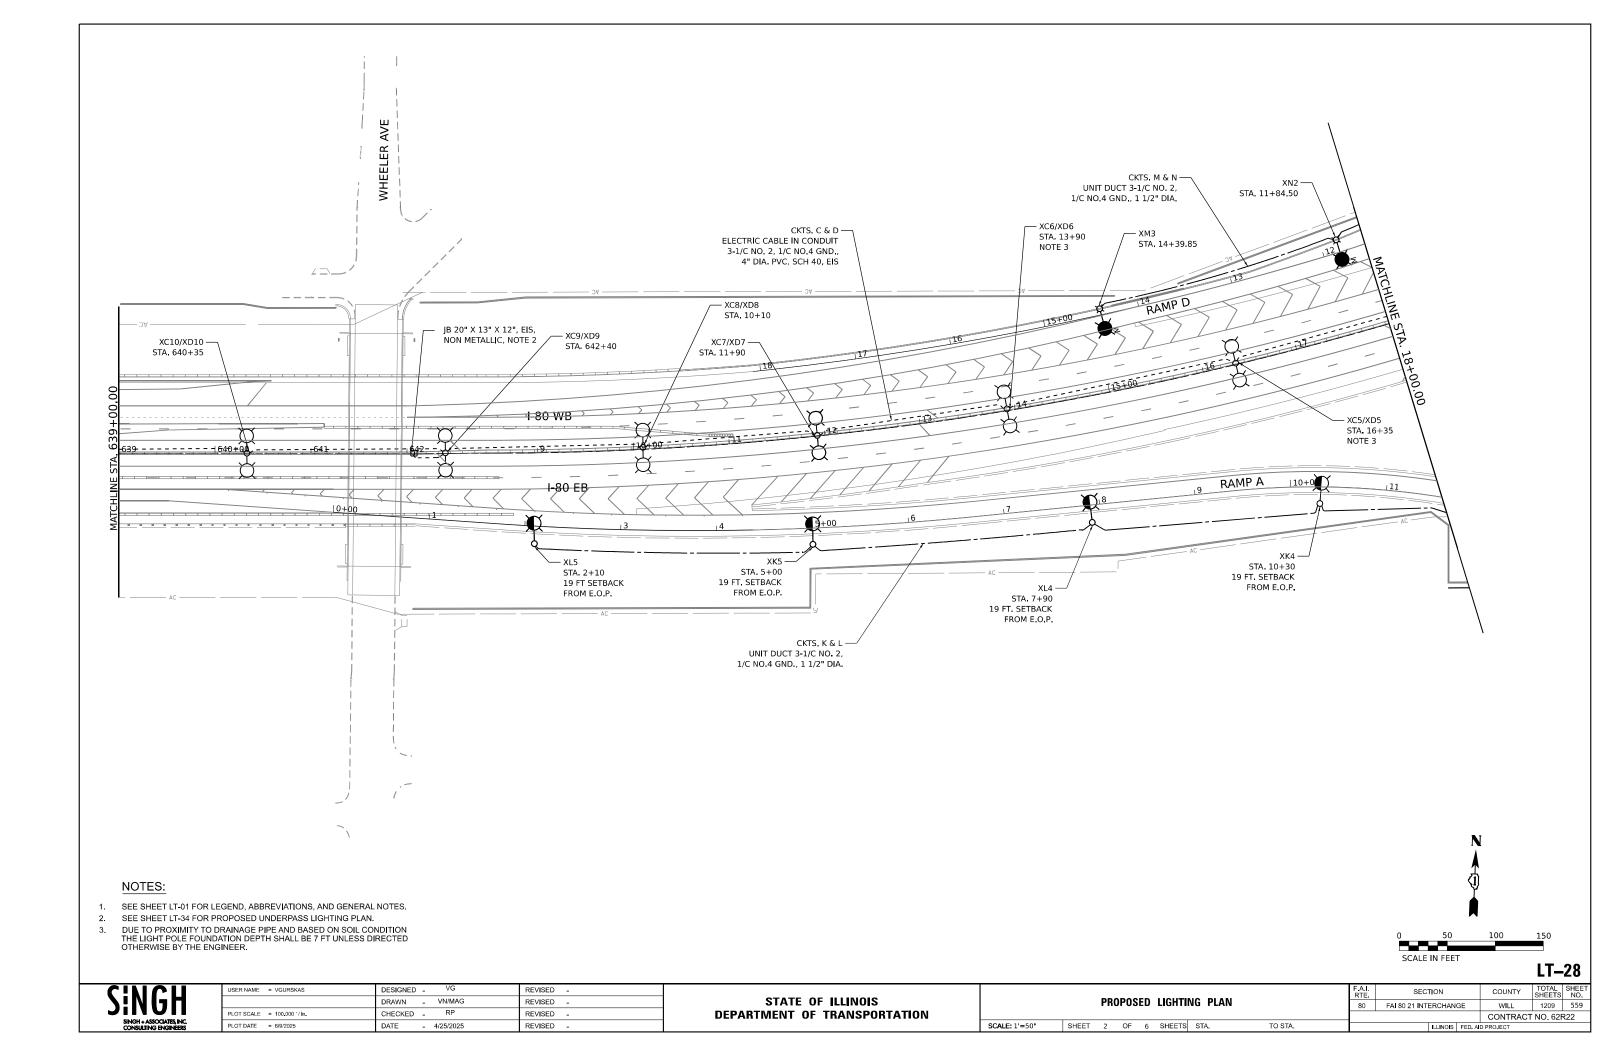

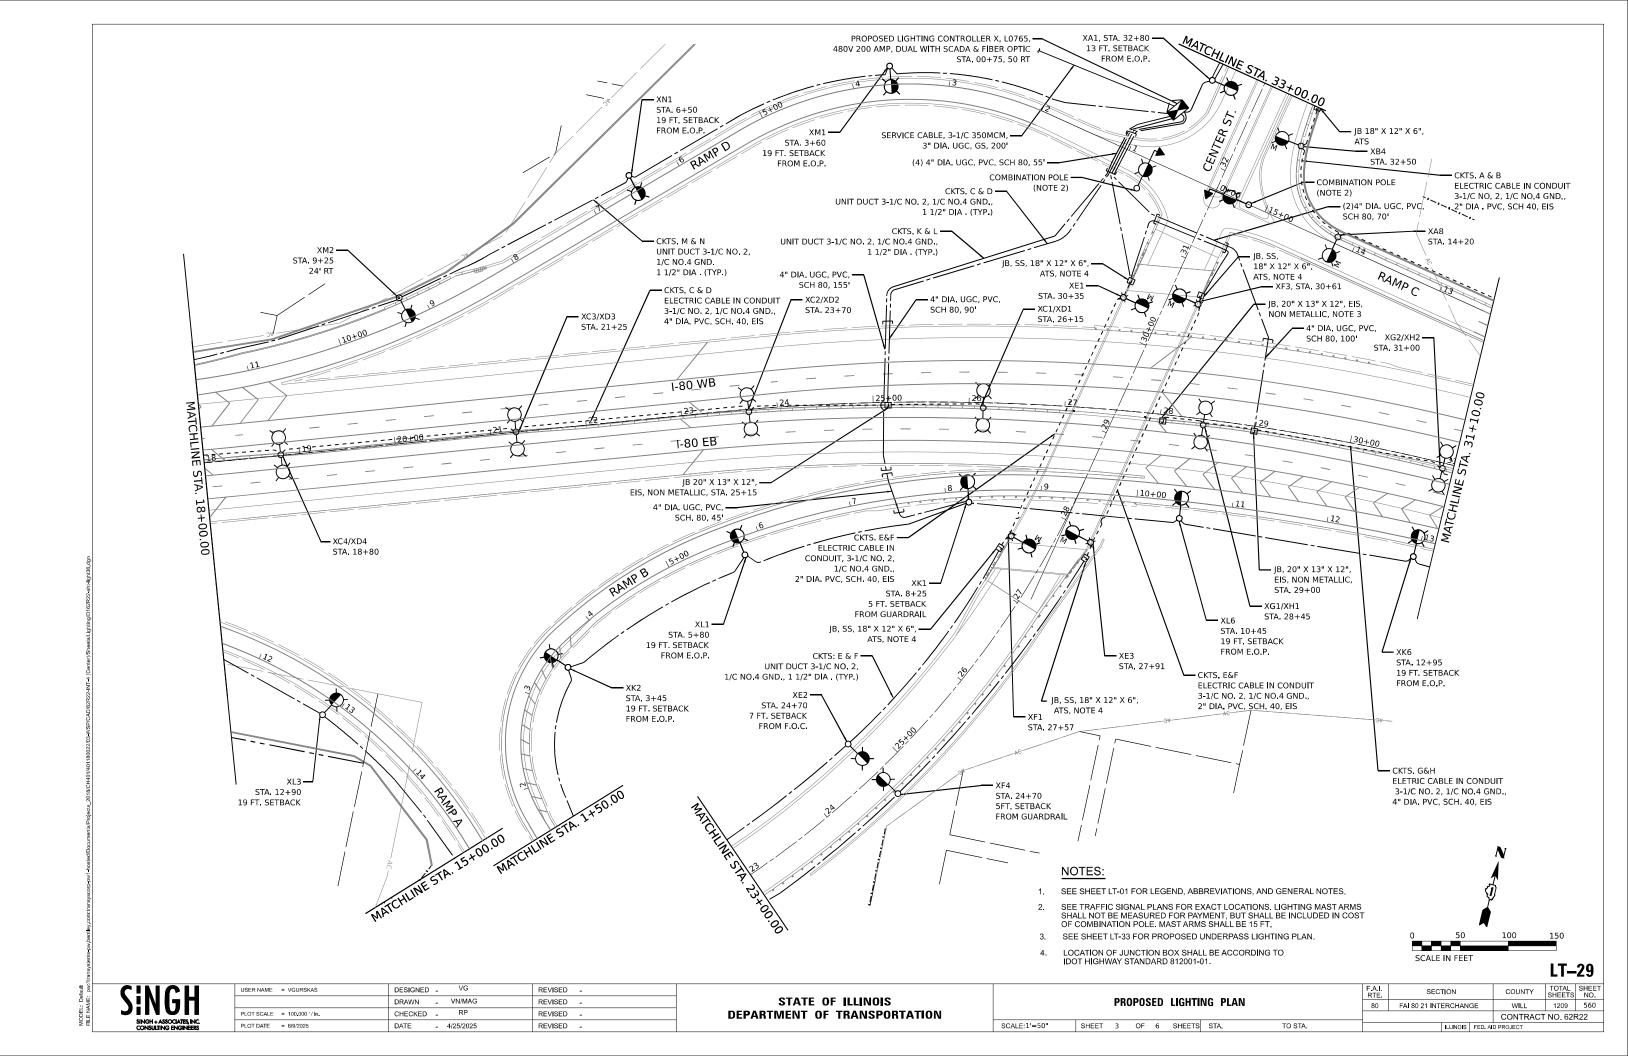

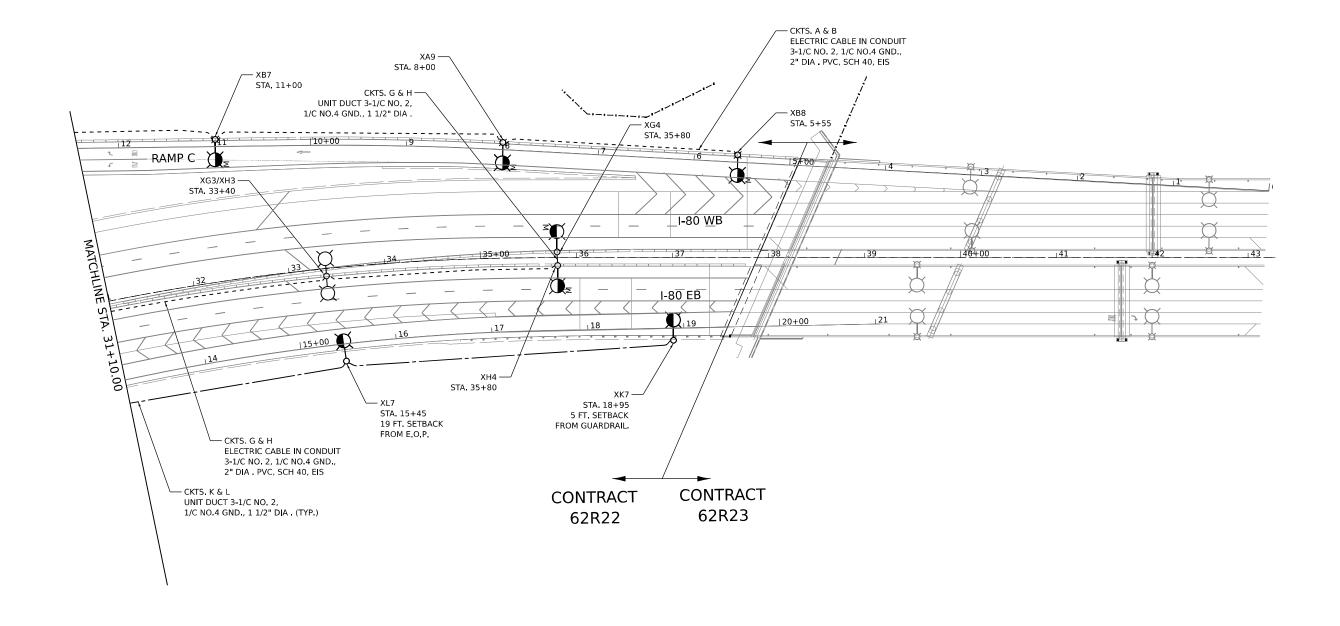

SCALE IN FEET LT-30

COUNTY


# NOTES:

1. SEE SHEET LT-01 FOR LEGEND, ABBREVIATIONS, AND GENERAL NOTES.

S	IN	GH	
		SSOCIATES, INC. NG ENGINEERS	

USER NAME = VGURSKAS	DESIGNED - VG	REVISED -
	DRAWN - VN/MAG	REVISED -
PLOT SCALE = 100.000 ' / in.	CHECKED - RP	REVISED -
PLOT DATE = 6/9/2025	DATE - 4/25/2025	REVISED -
PLOT DATE = 6/9/2025	DATE - 4/25/2025	REVISED -

		DD.	0000		LIGHTH			RTE	SECTION	COUNTY	SHEETS	
PROPOSED LIGHTING PLAN							80	FAI 80 21 INTERCHANGE	WILL	1209	561	
										CONTRACT	T NO. 62F	R22
SCALE:1'=50"	SHEET	4	OF	6	SHEETS	STA.	TO STA.		ILLINOIS FED. A	D PROJECT		

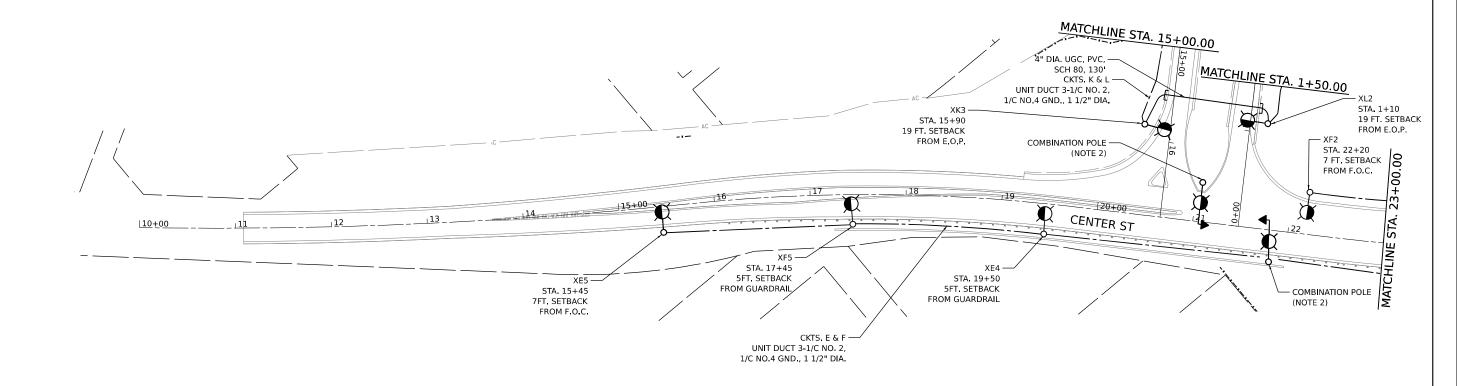

- SEE SHEET LT-01 FOR LEGEND, ABBREVIATIONS, AND GENERAL NOTES.
- SEE TRAFFIC SIGNAL PLANS FOR THE EXACT LOCATIONS. LIGHTING MAST ARMS SHALL NOT BE MEASURED FOR PAYMENT BUT SHALL BE INCLUDED IN COST OF COMBINATION POLE. MAST ARMS SHALL BE 15 FT.

		Day 1	ľ
0	50	100	150
SCAL	E IN FEET		LT-

COUNTY


WILL 1209 562

CONTRACT NO. 62R22

S	IN	GH	
		SSOCIATES, INC. NG ENGINEERS	


USER NAME = VGURSKAS	DESIGNED - VG	REVISED -
	DRAWN - VN/MAG	REVISED -
PLOT SCALE = 100.000 ' / in.	CHECKED - RP	REVISED -
PLOT DATE = 6/9/2025	DATE - 4/25/2025	REVISED -

									RTE	SECTION	COUNTY
	PROPOSED LIGHTING PLAN							80 FAI 80 21 INTERCHANGE		WILL	
										CONTRA	
	SCALE:1'=50"	SHEET	5	OF	6	SHEETS	STA.	TO STA.	ILLINOIS FED. AID		ID PROJECT

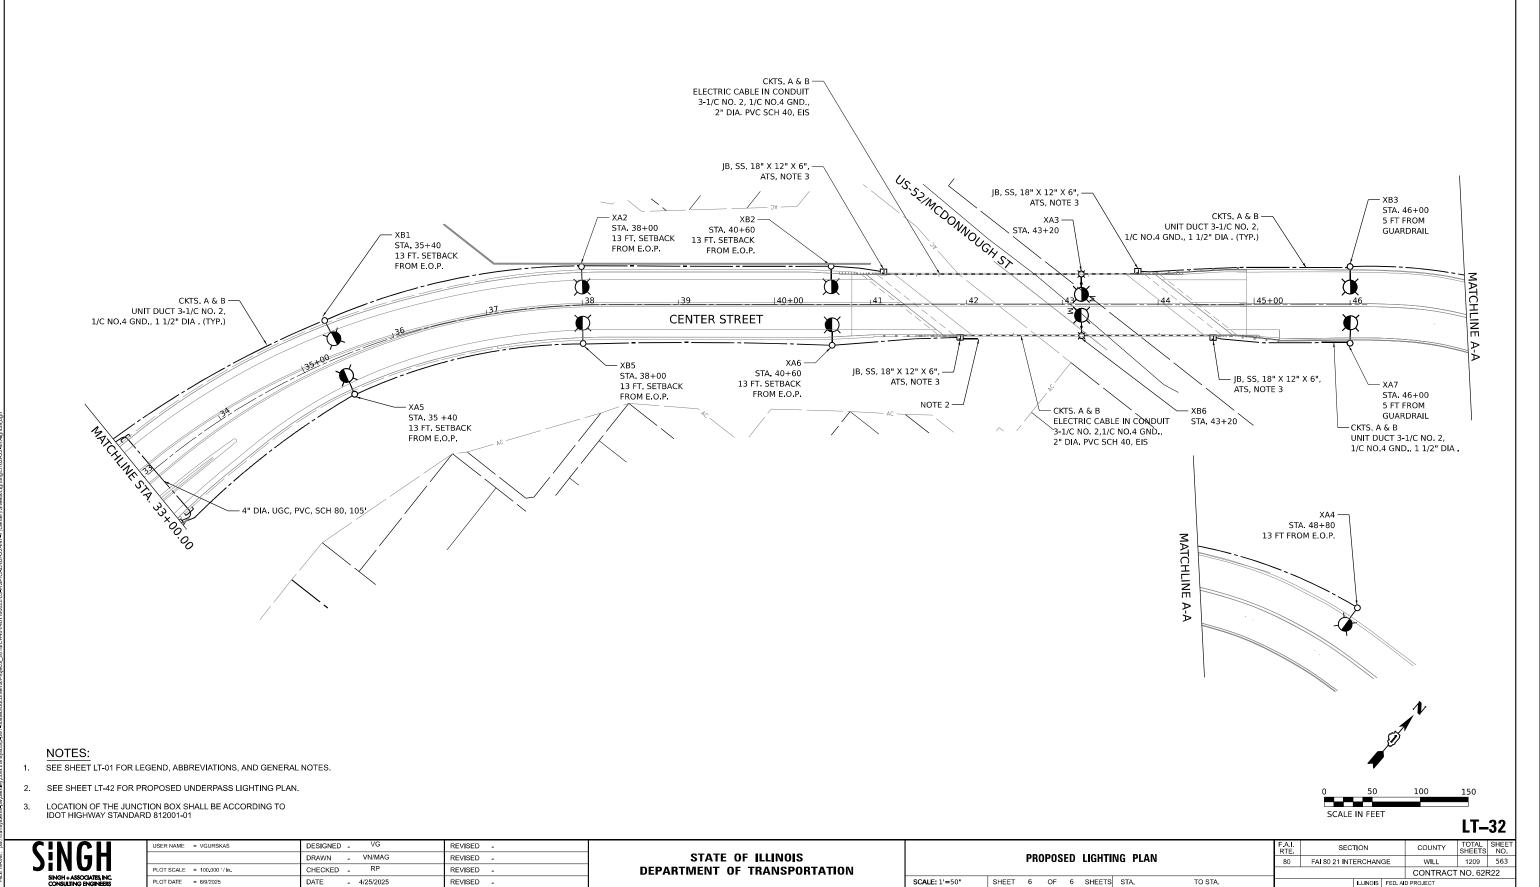

DATE - 4/25/2025

REVISED -

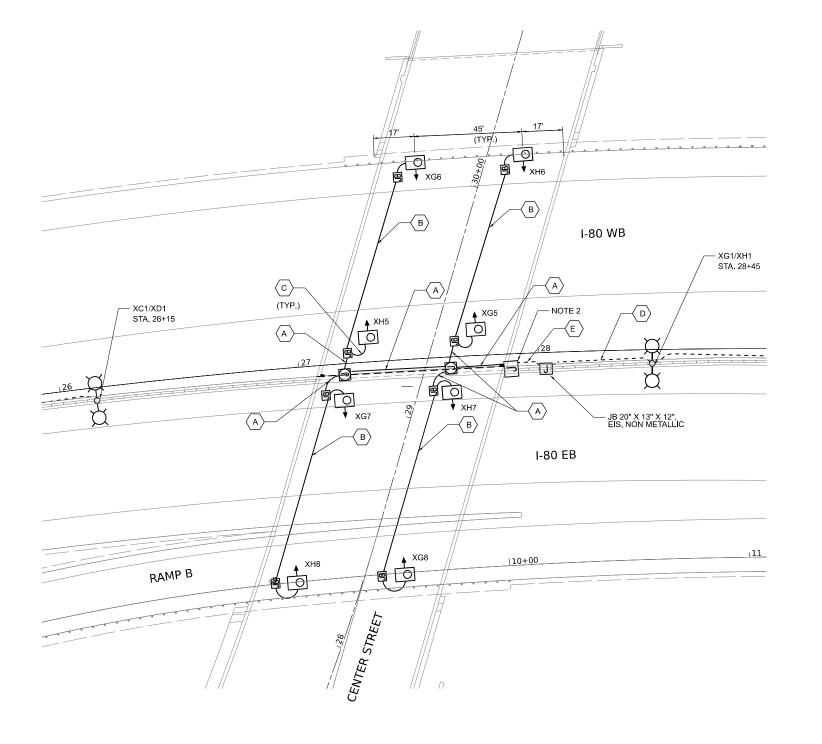

# SCALE IN FEET

## LEGEND

- 3-1/C NO.10 AND 1/C NO.10 GND IN 1" PVCC RGC
- 2-1/C NO.10 AND 1/C NO.10 GND IN 1"PVCC RGC
- 2-1/C NO.10 AND 1-1/C NO.10 GND IN 3/4" LIQUID-TIGHT FLEXIBLE CONDUIT
- ELECTRIC CABLE IN CONDUIT, 600V, 3-1/C NO.2, 1/C NO.4 GND, (XLP-TYPE USE), IN 4" PVC CONDUIT EMBEDDED IN BARRIER WALL
- ELECTRIC CABLE IN CONDUIT, 600V, 3-1/C NO.2, 1/C NO.4 GND, (XLP-TYPE USE), IN 3" PVC CONDUIT EMBEDDED IN BARRIER WALL (TRANSITIONS TO 3" PVCC RGC AT PIER)

- 1. SEE SHEET LT-01 FOR LEGEND, ABBREVIATIONS, AND GENERAL NOTES.
- INSTALL FUSEHOLDER WITH 30 AMP FUSES AND NEUTRAL SLUG INSIDE THE JUNCTION BOX
- PROPOSED UNDERPASS LUMINAIRE SUSPENDED FROM THE BRIDGE DECK, LUMINAIRE SHALL BE CENTERED IN THE BEAM SPACE AND SHALL BE POSITIONED AT THE SPECIFIED SETBACK FROM THE EDGE OF THE PAVEMENT.

LUMINAIRE, LED, UNDERPASS, SUSPENDED, OUTPUT DESIGNATION D (17FT M.H.) 12' SETBACK FROM EOP FOR I-80 WB, 2' SETBACK FROM EOP FOR I-80 EB

JUNCTION BOX, STAINLESS STEEL, ATTACHED TO STRUCTURE, 6" X 6" X 4"

JUNCTION BOX, STAINLESS STEEL, ATTACHED TO STRUCTURE, 12" X 10" X 6"


JUNCTION BOX, STAINLESS STEEL, ATTACHED TO STRUCTURE, 18" X 18" X 8"


LT-33

USER NAME = mgarvlda	DESIGNED - VG	REVISED -
	DRAWN - VN/MAG	REVISED -
PLOT SCALE = 40.000 '/in.	CHECKED - RP	REVISED -
PLOT DATE = 4/24/2025	DATE - 4/25/2025	REVISED -

STATE OF ILLINOIS **DEPARTMENT OF TRANSPORTATION**  I-80 AND CENTER STREET UNDERPASS LIGHTING PLANS OF SHEETS STA.

SECTION COUNTY 80 FAI 80 21 INTERCHANGE WILL 1209 564 CONTRACT NO. 62R22

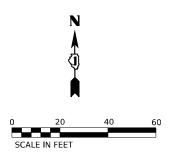

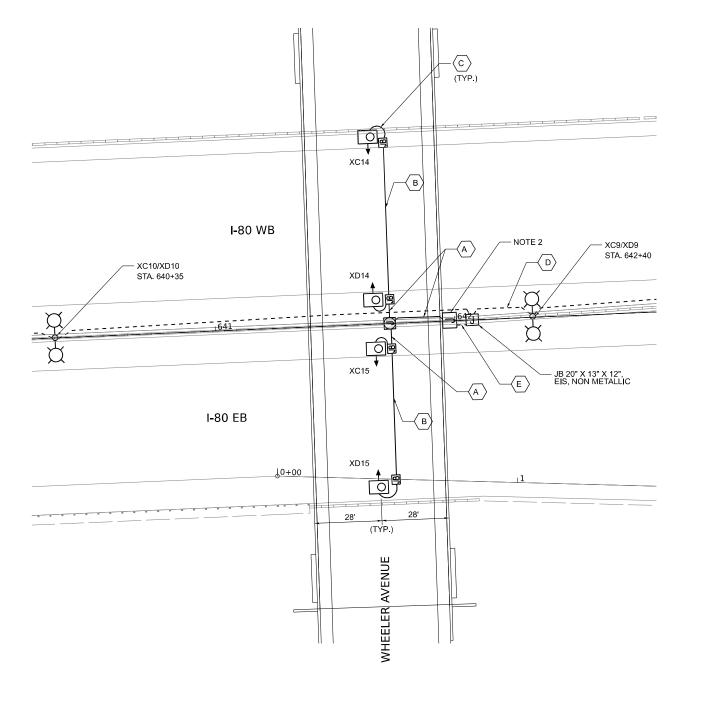

#### **NOTES**

- 1. SEE SHEET LT-01 FOR LEGEND, ABBREVIATIONS, AND GENERAL NOTES.
- 2. INSTALL FUSEHOLDER WITH 30 AMP FUSES AND NEUTRAL SLUG INSIDE THE JUNCTION BOX
- 3. PROPOSED UNDERPASS LUMINAIRE SUSPENDED FROM THE BRIDGE DECK, LUMINAIRE SHALL BE CENTERED IN THE BEAM SPACE AND SHALL BE POSITIONED AT THE SPECIFIED SETBACK FROM THE EDGE OF PAVEMENT.

#### LEGEND

- A 3-1/C NO.10 AND 1/C NO.10 GND IN 1" PVCC RGC
- B 2-1/C NO.10 AND 1/C NO.10 GND IN 1"PVCC RGC
- $\langle \mathbb{C} \rangle$  2-1/C NO.10 AND 1-1/C NO.10 GND IN 3/4" LIQUID-TIGHT FLEXIBLE CONDUIT
- D ELECTRIC CABLE IN CONDUIT, 600V, 3-1/C NO.2, 1/C NO.4 GND, (XLP-TYPE USE), IN 4" PVC CONDUIT EMBEDDED IN BARRIER WALL
- ELECTRIC CABLE IN CONDUIT, 600V, 3-1/C NO.2, 1/C NO.4 GND, (XLP-TYPE USE), IN 3" PVC CONDUIT EMBEDDED IN BARRIER WALL (TRANSITIONS TO 3" PVCC RGC AT PIER)
- LUMINAIRE, LED, UNDERPASS, SUSPENDED, OUTPUT DESIGNATION D (17FT M.H.)
  2' SETBACK FROM EOP
- JUNCTION BOX, STAINLESS STEEL, ATTACHED TO STRUCTURE, 6" X 6" X 4"
- JUNCTION BOX, STAINLESS STEEL, ATTACHED TO STRUCTURE, 12" X 10" X 6"
- JUNCTION BOX, STAINLESS STEEL, ATTACHED TO STRUCTURE, 18" X 18" X 8"


LT-34




USER NAME = mgarvida	DESIGNED - VG	REVISED -
	DRAWN - VN/MAG	REVISED -
PLOT SCALE = 40.000'/in.	CHECKED - RP	REVISED -
PLOT DATE = 4/24/2025	DATE - 4/25/2025	REVISED -

STATE OF ILLINOIS DEPARTMENT OF TRANSPORTATION

I-80 AND	WHEELER	AVENUE	UNDE	RPASS	LIGHTING PLANS	
SCALE:	SHEET	OF	SHEETS	STA.	TO STA.	

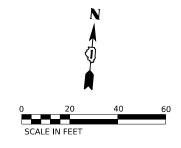

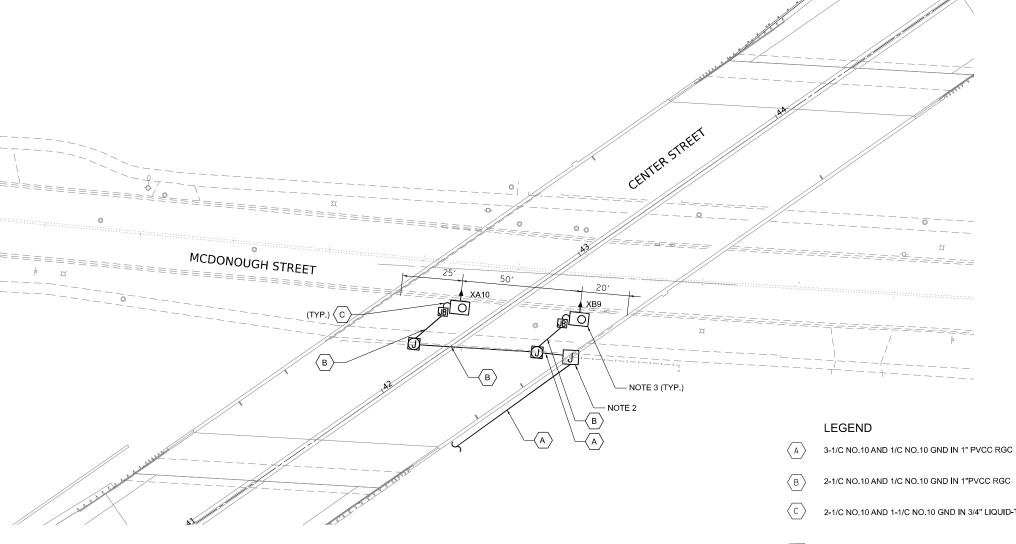

### NOTES


- 1. SEE SHEET LT-01 FOR LEGEND, ABBREVIATIONS, AND GENERAL NOTES.
- 2. INSTALL FUSEHOLDER WITH 30 AMP FUSES AND NEUTRAL SLUG INSIDE THE JUNCTION BOX
- PROPOSED UNDERPASS LUMINAIRE SUSPENDED FROM THE BRIDGE DECK, LUMINAIRE SHALL BE CENTERED IN THE BEAM SPACE AND SHALL BE POSITIONED AT THE SPECIFIED SETBACK FROM THE EDGE OF THE PAVEMENT.


- 2-1/C NO.10 AND 1-1/C NO.10 GND IN 3/4" LIQUID-TIGHT FLEXIBLE CONDUIT
- LUMINAIRE, LED, UNDERPASS, SUSPENDED, OUTPUT DESIGNATION D (17FT M.H.) 2' SETBACK FROM EOP
- JUNCTION BOX, STAINLESS STEEL, ATTACHED TO STRUCTURE, 6" X 6" X 4"  $\,$
- JUNCTION BOX, STAINLESS STEEL, ATTACHED TO STRUCTURE, 12" X 10" X 6"  $\,$
- JUNCTION BOX, STAINLESS STEEL, ATTACHED TO STRUCTURE, 18" X 18" X 8"


LT-35




USER NAME = VGURSKAS	DESIGNED - VG	REVISED -
	DRAWN - VN/MAG	REVISED -
PLOT SCALE = 40.000 '/in.	CHECKED - RP	REVISED -
PLOT DATE = 6/9/2025	DATE - 4/25/2025	REVISED -

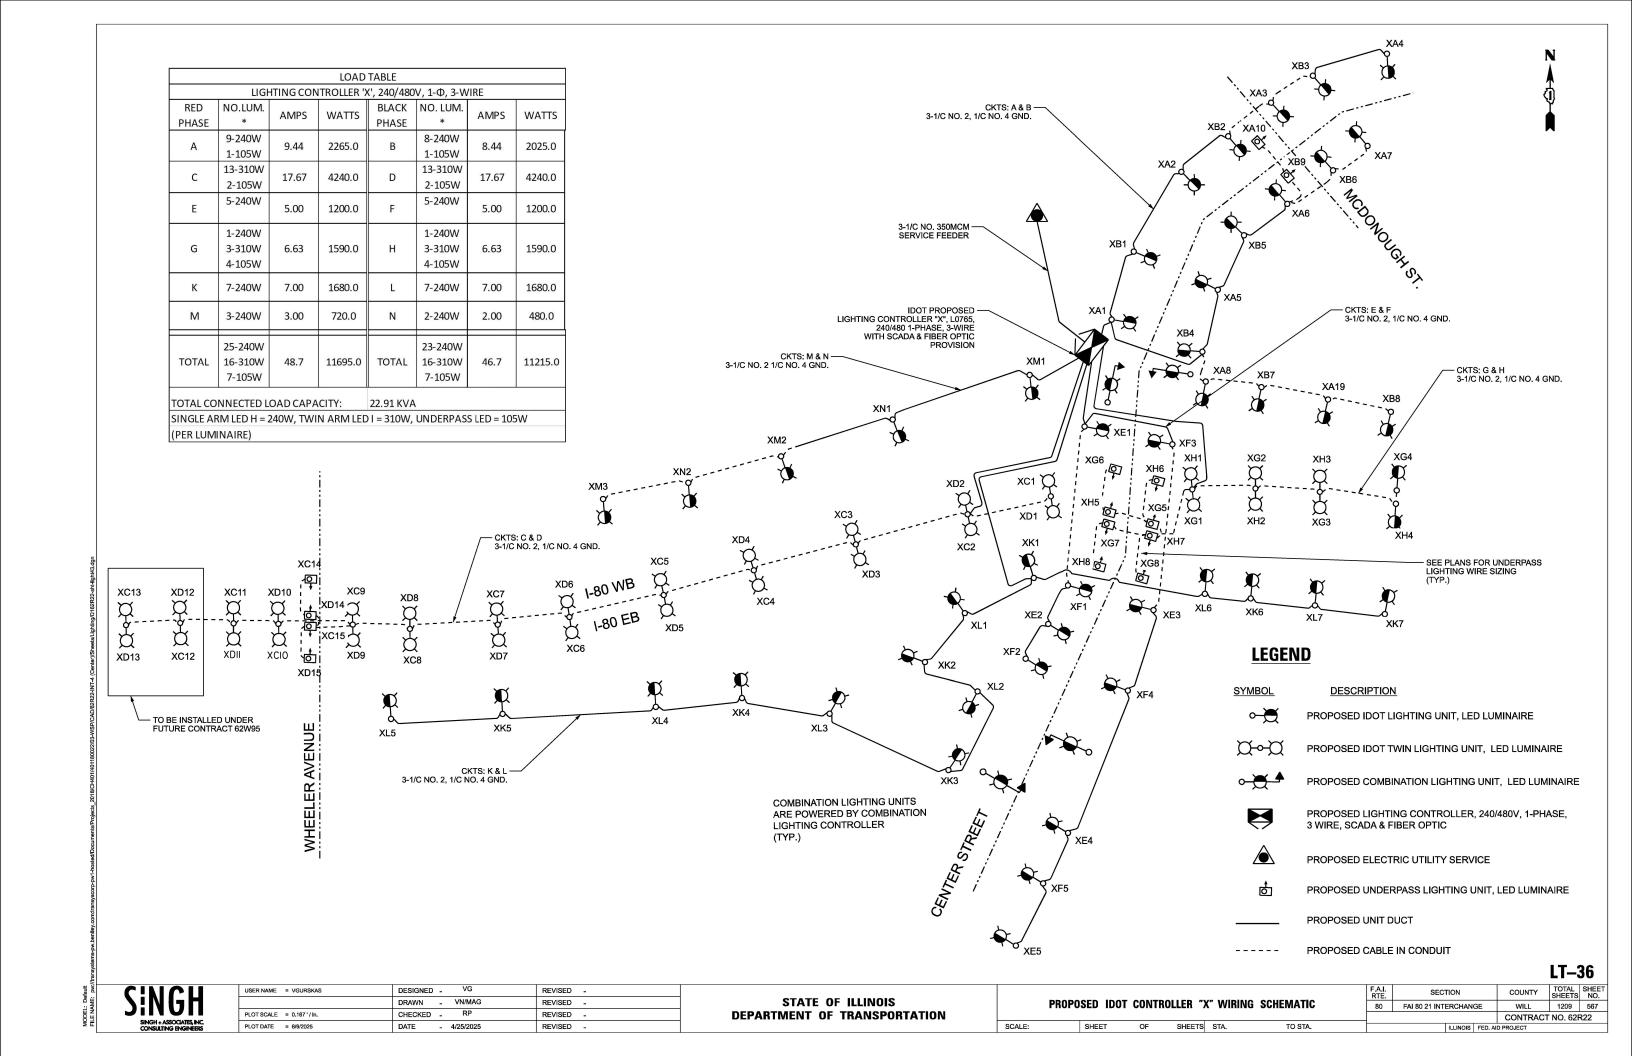

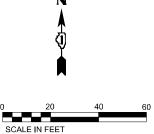

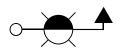


IDOT COMBINATION LIGHT POLE 45 FT LUMINAIRE MOUNTING HEIGHT 15 FT LUMINAIRE ARM LUMINAIRE, LED, OUTPUT DESIGNATION H, 120V, WITH 6 AMP FUSE & NEUTRAL SLUG

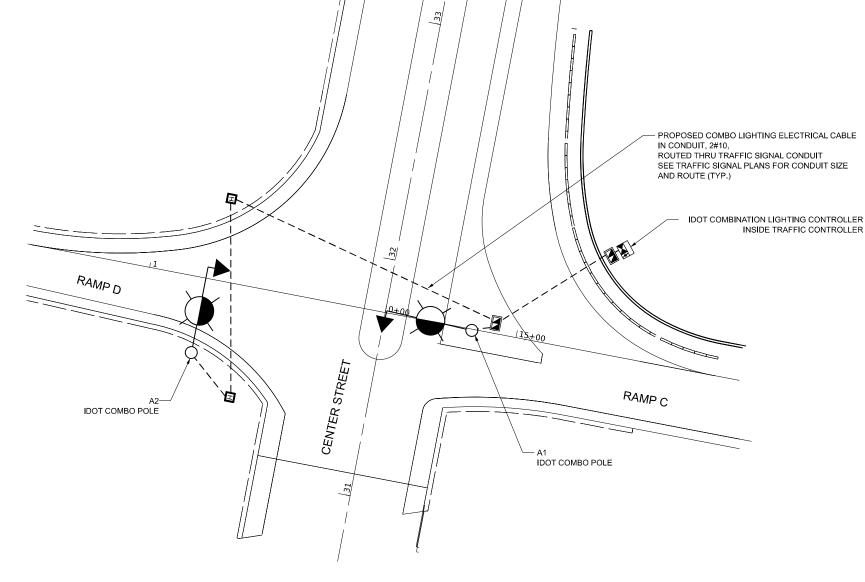


# NOTES:

- THE IDOT COMBO LIGHTING CIRCUITING SHALL NOT BE CONNECTED TO THE ROADWAY LIGHTING CIRCUITS.
- 2. LUMINAIRES ARE POWERED FROM IDOT TRAFFIC CONTROLLER, SEE DETAIL BE-240
- 3. THE COMBO LIGHTING CABLE AND SIGNAL CABLES WILL BE IN SHARED CONDUIT.
- 4. SEE TRAFFIC SIGNAL PLANS FOR LOCATION OF COMBO POLES, HANDHOLES AND CONDUIT.
- 5. CIRCUIT DECALS SHALL NOT BE INSTALLED ON COMBO POLES. CIRCUITING DECALS SHOWN ARE FOR GUIDANCE ONLY.

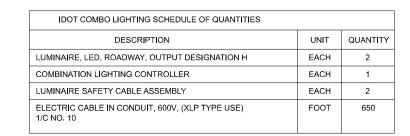

SCALE:

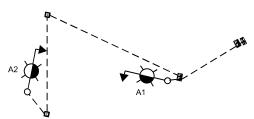

**ONE LINE DIAGRAM** 

LT-37



USER NAME = mgarvida	DESIGNED - VG	REVISED -
	DRAWN - VN/MAG	REVISED -
PLOT SCALE = 1.	CHECKED - RP	REVISED -
PLOT DATE = 4/24/2025	DATE - 4/25/2025	REVISED -

STATE OF ILLINOIS
DEPARTMENT OF TRANSPORTATION

			LIGHTING AMPS C/D	PLAN	
SHEET	OF	SHEETS	STA.	TO STA.	

F.A.I. SECTION COUNTY TOTAL SHEETS NO.

80 FAI 80 21 INTERCHANGE WILL 1209 568


CONTRACT NO. 62R22



IDOT COMBINATION LIGHT POLE 45 FT LUMINAIRE MOUNTING HEIGHT 15 FT LUMINAIRE ARM LUMINAIRE, LED, OUTPUT DESIGNATION H, 120V, WITH 6 AMP FUSE & NEUTRAL SLUG





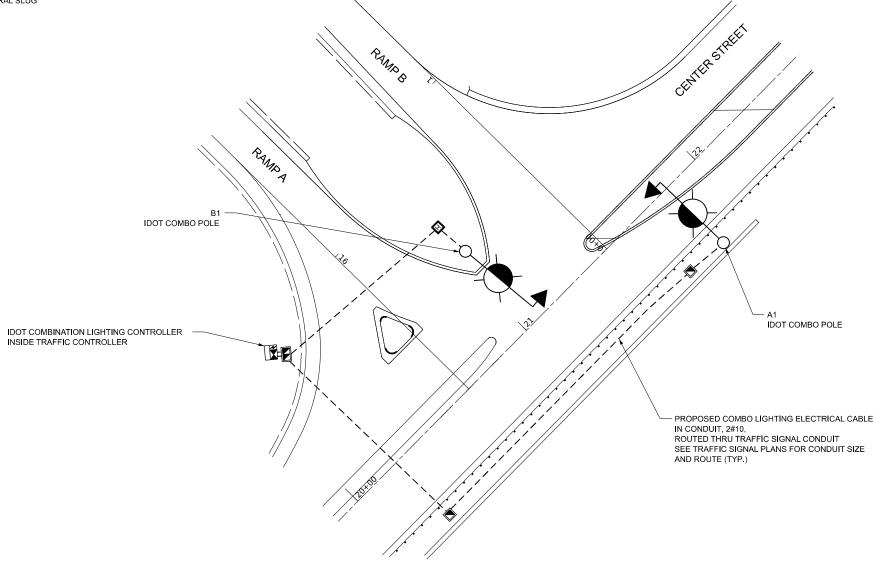

# NOTES:

- THE IDOT COMBO LIGHTING CIRCUITING SHALL NOT BE CONNECTED TO THE ROADWAY LIGHTING CIRCUITS.
- LUMINAIRES ARE POWERED FROM IDOT TRAFFIC CONTROLLER, SEE DETAIL BE-240
- THE COMBO LIGHTING CABLE AND SIGNAL CABLES WILL BE IN SHARED CONDUIT.
- SEE TRAFFIC SIGNAL PLANS FOR LOCATION OF COMBO POLES, HANDHOLES AND CONDUIT.
- CIRCUIT DECALS SHALL NOT BE INSTALLED ON COMBO POLES. CIRCUITING DECALS SHOWN ARE FOR GUIDANCE ONLY.

IDOT COMBO LIGHTING SCHEDULE OF QUANTITIES		
DESCRIPTION	UNIT	QUANTITY
LUMINAIRE, LED, ROADWAY, OUTPUT DESIGNATION H	EACH	2
COMBINATION LIGHTING CONTROLLER	EACH	1
LUMINAIRE SAFETY CABLE ASSEMBLY	EACH	2
ELECTRIC CABLE IN CONDUIT, 600V, (XLP TYPE USE) 1/C NO. 10	FOOT	740

SCALE:

SHEET




LT-38



USER NAME = mgarvlda	DESIGNED - VG	REVISED -
	DRAWN - VN/MAG	REVISED -
PLOT SCALE = 1.	CHECKED - RP	REVISED -
PLOT DATE = 4/24/2025	DATE - 4/25/2025	REVISED -

STATE OF ILLINOIS	
DEPARTMENT OF TRANSPORTATION	

PROPOSED COMBINATION LIGHTING PLAN						F.A.I. RTE	SECTION	COUNTY	TOTAL SHEETS	SHEE NO.
CENTER ST. AND RAMPS A/B					∆⁄R	80	FAI 80 21 INTERCHANGE	WILL	1209	569
					CONTRACT NO			NO. 62F	₹22	
	SHEET	OF	SHEETS	STA	TO STA	LI BIOR FED AID PROJECT				

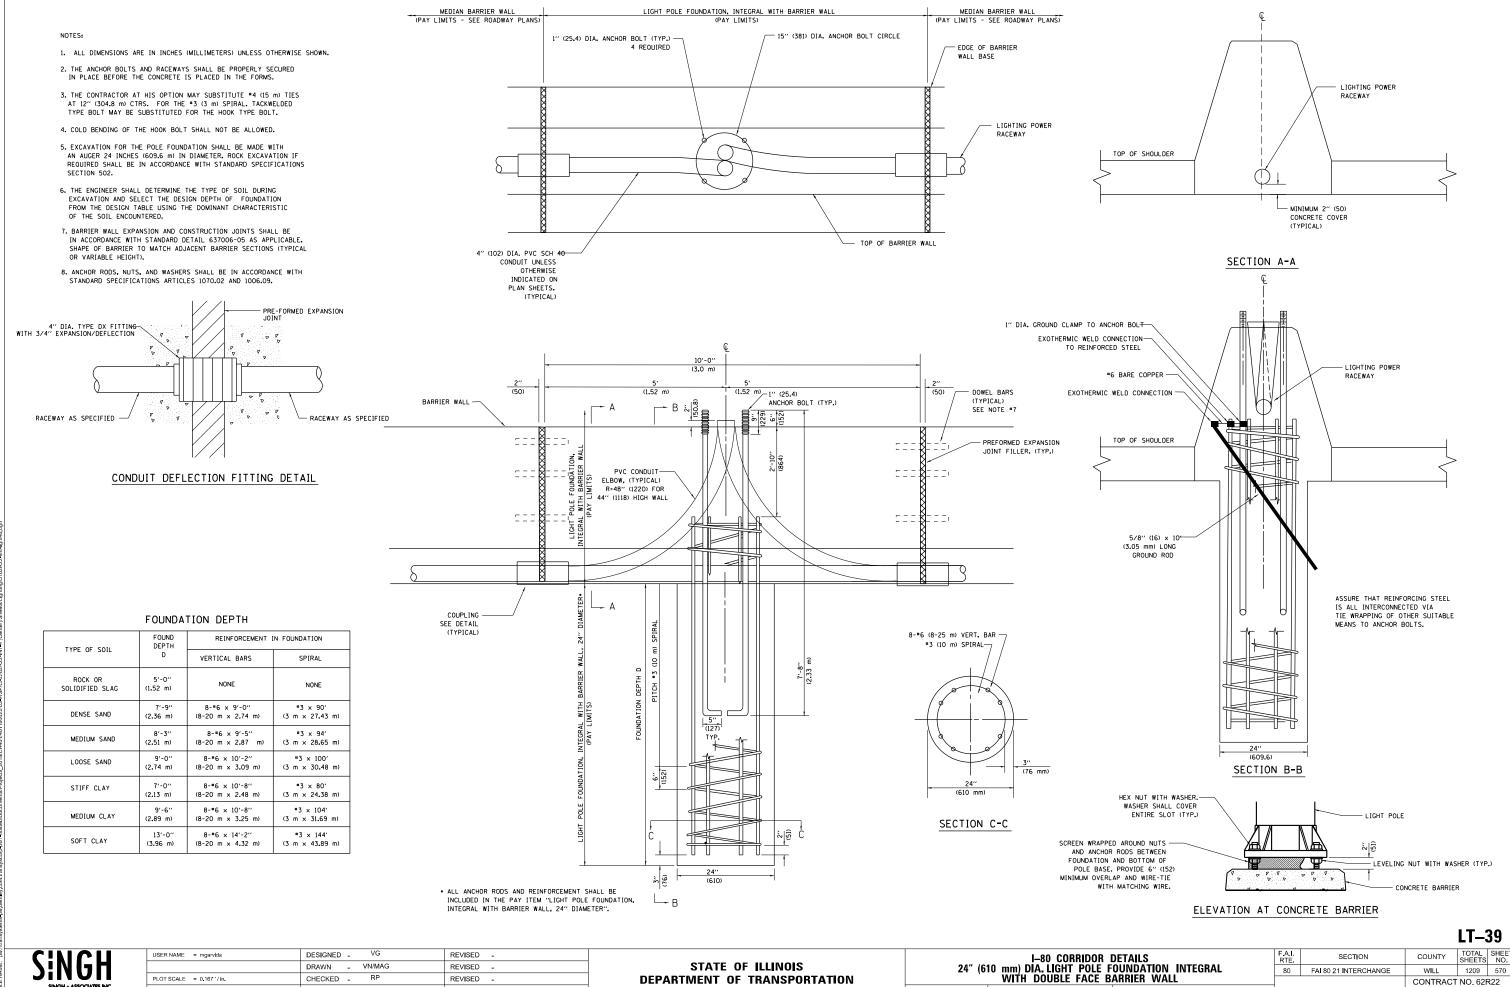

SCALE:

OF

SHEET

SHEETS STA.

ILLINOIS FED. AID PROJECT


MODEL: Default


PLOT DATE = 4/24/2025

DATE

- 4/25/2025

REVISED

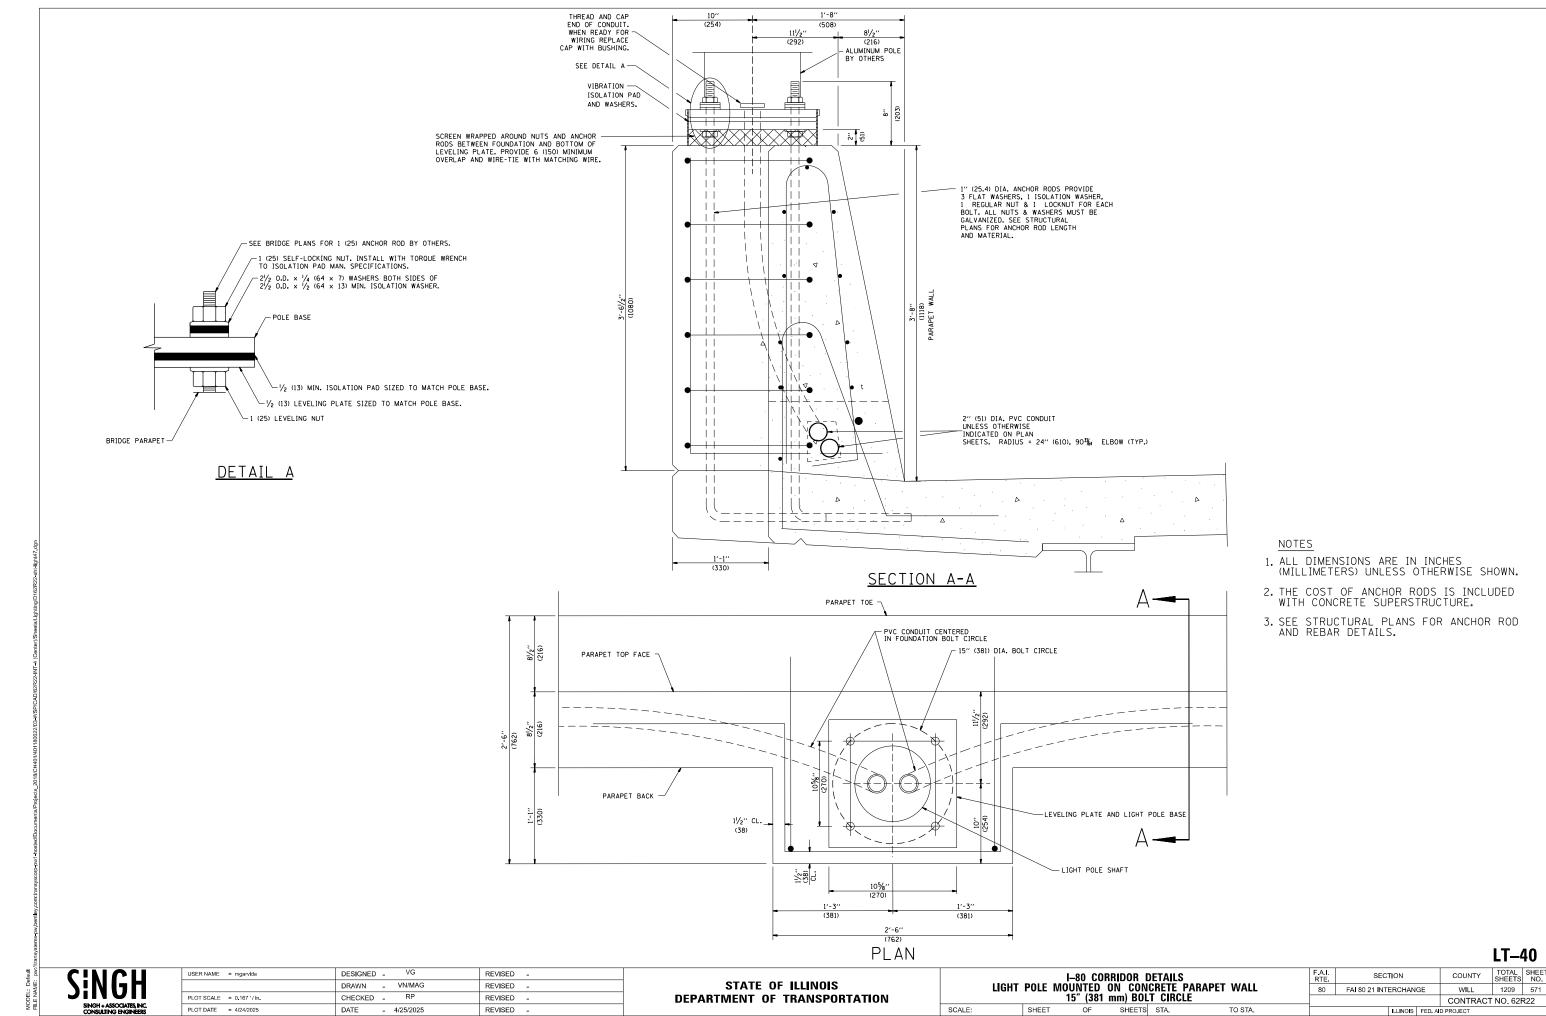

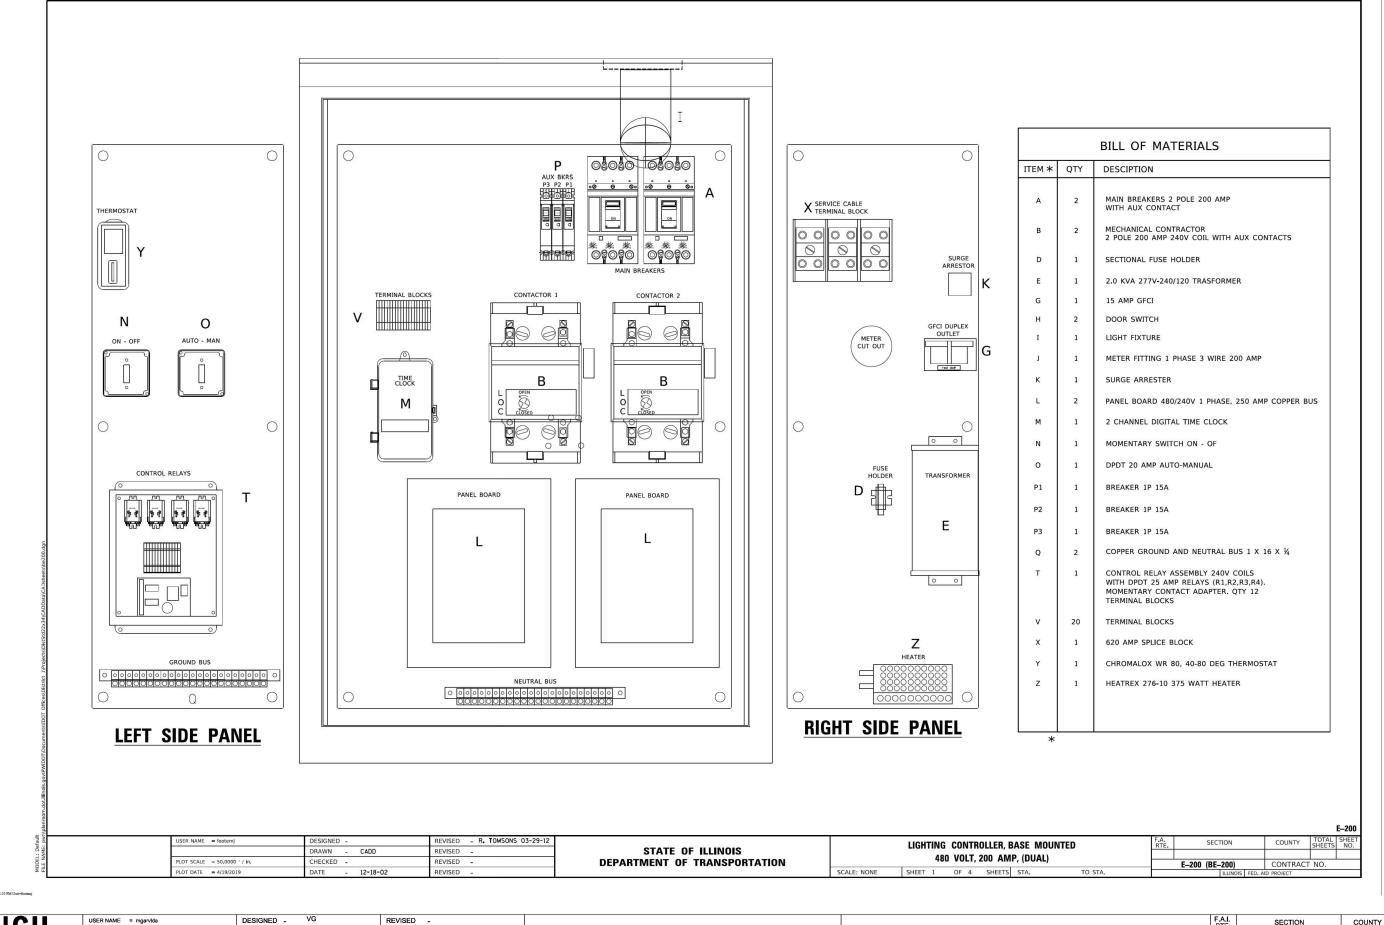

TIPE INCIME: DWD/III

DEP

DRAWN -

CHECKED -

DATE

PLOT SCALE = 0.167'/ln.

PLOT DATE = 4/24/2025

VN/MAG

RP

- 4/25/2025

REVISED -

REVISED -


REVISED

STATE OF ILLINOIS
DEPARTMENT OF TRANSPORTATION

SCALE:

IDOT D1 – TEMPORARY CONTROLLER DETAILS

SHEET OF SHEETS STA. TO STA.

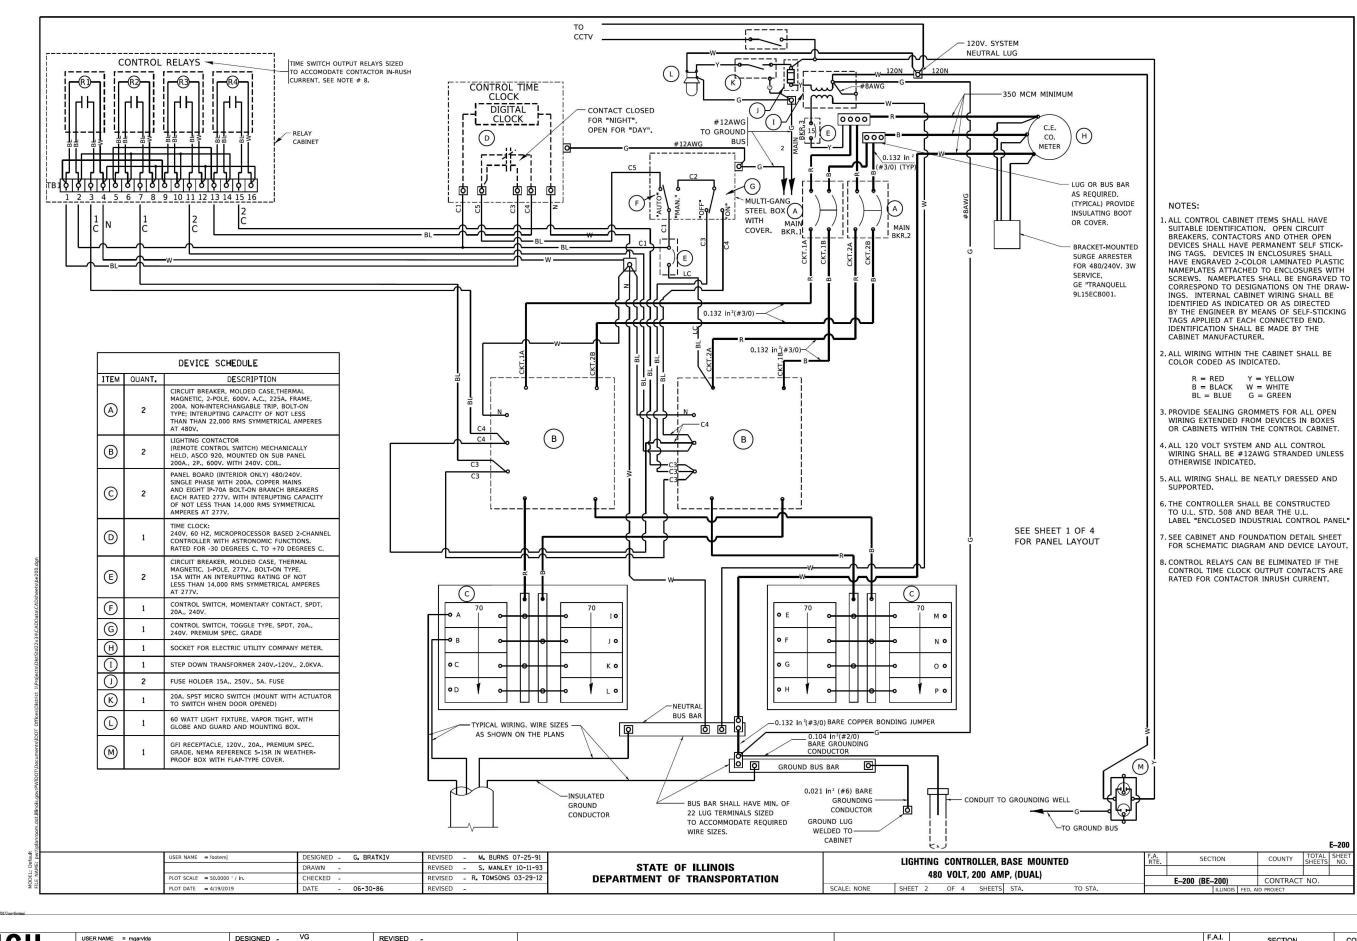


SINGH - ASSOCIATES, INC. CONSULTING BYGINERS

STATE OF ILLINOIS
DEPARTMENT OF TRANSPORTATION

SCALE:

IDOT D1 – TEMPORARY CONTROLLER DETAILS

SHEET OF SHEETS STA. TO STA.

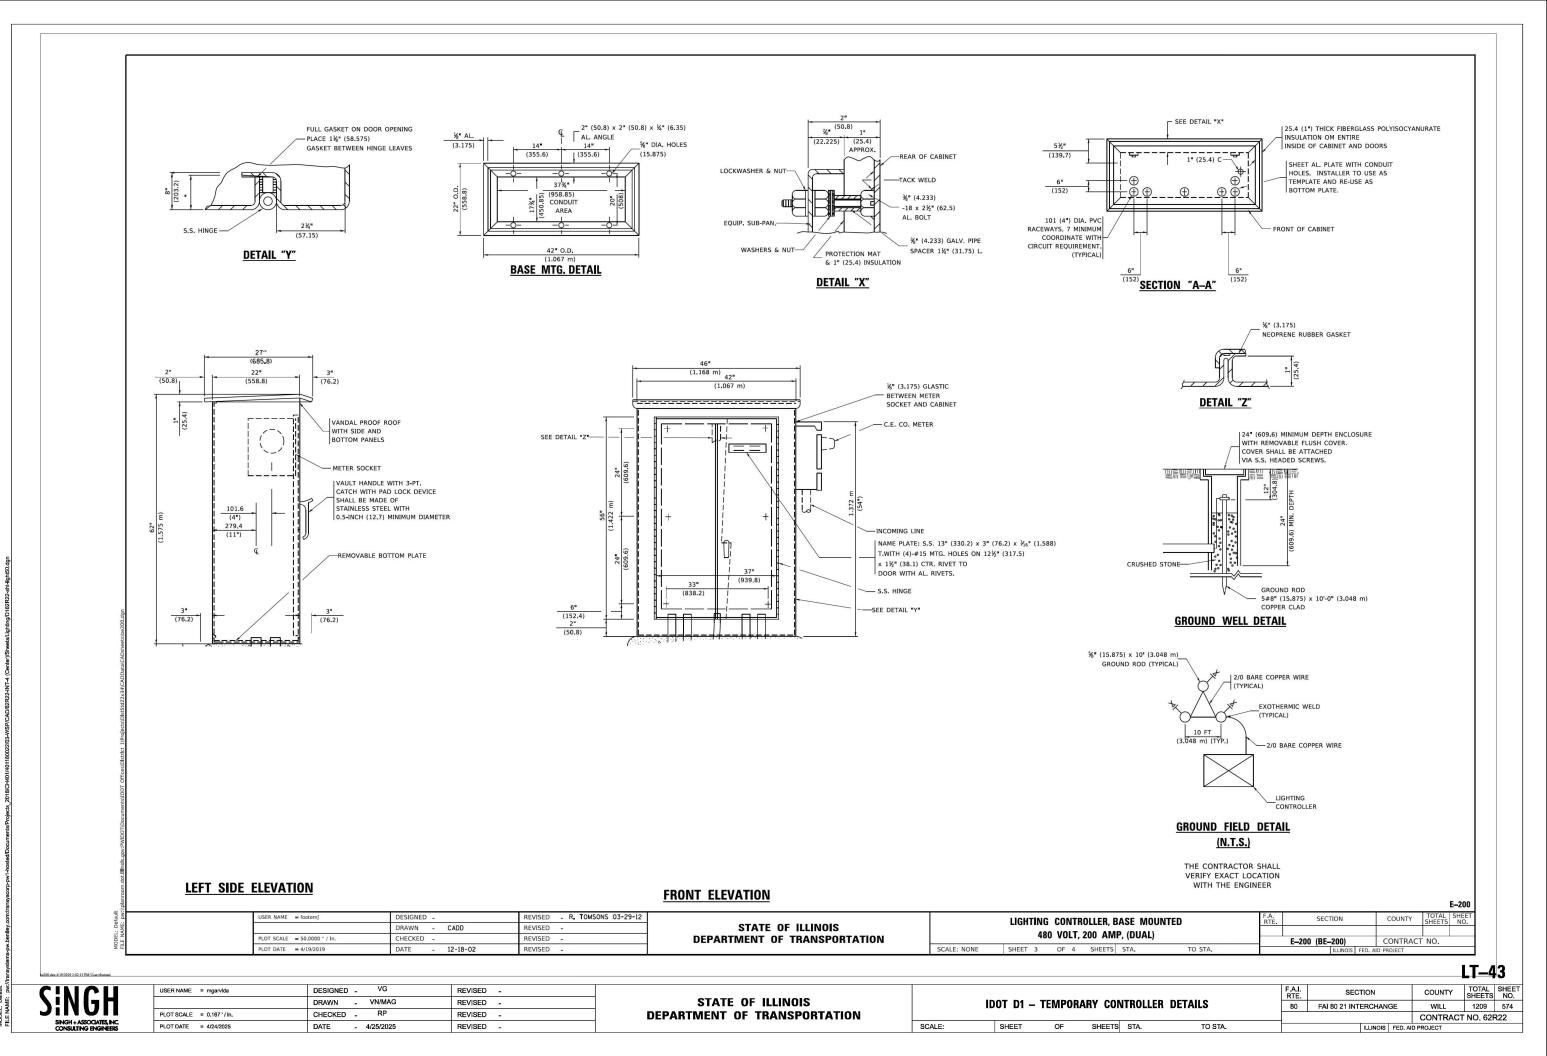

#### NOTES:

- 1. CABINET SHALL BE FABRICATED FROM 0.125-INCH (3.175) SHEET ALUMINUM #3003H14, FORMED AND ARC WELDED ASSEMBLY.
- 2. ALL SCREWS AND HARDWARE SHALL BE PLATED, GALVANIZED, OR MADE OF BRASS, ALUMINUM OR STAINLESS STEEL.
- 3. NAME PLATE SHALL HAVE ENGRAVED 0.75-INCH (19.05) HIGH LETTERS FILLED IN BLACK: "STATE OF ILLINOIS LIGHTING CONTROLS" UNLESS OTHERWISE SPECIFIED.
- 4. ONE INCH THICK POLYISOCYANURATE INSULATION SHALL BE INSTALL AND PERMANENTLY CEMENTED ON ALL SIDES OF THE CABINET AND DOORS.
- 5. CABINET SHALL BE PRIMED AND PAINTED AS SPECIFIED.
- 6. ELECTRIC UTILITY METER BOX SHALL BE MOUNTED ON THE SIDE OF CONTROL CABINET AS SHOWN ON THE PANEL LAYOUT DIAGRAM.
- 7. THE COMPLETED CONTROLLER SHALL BE U.L. LISTED AS AN INDUSTRIAL CONTROL PANEL
- 8. METAL MOUNTING PANEL SHALL BE #10 GAUGE GALVANIZED SHEET STEEL FLANGED BACK 0.75-INCHES I.D. ON 4 SIDES.
- 9. CIRCUIT BREAKERS AND CONTACTORS AND OTHER COMPONENTS SHALL BE MOUNTED ON 0.125-INCH (3.175) THICK GLASTIC INSULATION BACK PANEL.
- 10. ALL DEVICES SHALL BE FRONT REMOVABLE.
- 11. TIME CLOCK CHANNEL 1 N.O. CONTACT IS CLOSED NIGHT AND OPEN DAY.
- 12. SET "ON TIME" TO 30 MINUTES AFTER ASTRONOMICAL SUNSET.
- 13. BUS BAR SHALL HAVE 22 LUG TERMINALS SIZED TO ACCOMMODATE REQUIRED WIRE SIZES. NEUTRAL BUS SHALL BE PAINTED WHITE. GROUND BUS SHALL BE PAINTED GREEN.
- 14. ALL LUGS SHALL BE OF COPPER SCREWS AND CONNECTORS, SPRING HELD.
- 15. ALL WIRING TERMINATIONS SHALL BE RATED NOT LESS THAN 75 DEGREE CENTIGRADE.
- 16. ALL CONTROL WIRING SHALL BE 600V MACHINE TOOL WIRE TYPE MTW.
- 17. ALL POWER WIRING SHALL BE 600V TYPE RHH/RHW.
- 18. ALL WIRING WITHIN THE CABINET SHALL BE COLOR CODED AS INDICATED:

R - RED Y - YELLOW B - BLACK W - WHITE BL - BLUE G - GREEN

- 19. ALL DIMENSIONS ARE IN MILIMETERS (INCHES) UNLESS OTHERWISE INDICATED.
- 20. SCHEMATIC SHOWN WITH BREAKER OPEN, CONTACTOR OPEN, CABINET DOOR CLOSED, CLOCK NOT ACTIVE.
- 21. A LAMINATED COPY OF THE CIRCUIT SCHEMATIC AND SCADA I/O DIAGRAM SHALL BE ATTACHED TO THE INSIDE OF THE CONTROLLER.

USER NAME = footemj	DESIGNED	-		REVISED	- R.	TOMSONS 03-29-12
	DRAWN	-	CADD	REVISED	-	
PLOT SCALE = 50.0000 ' / in.	CHECKED	-		REVISED	-	
PLOT DATE = 4/19/2019	DATE	-	12-18-02	REVISED	-	

STATE OF ILLINOIS **DEPARTMENT OF TRANSPORTATION** 

LIGHTING CONTROLLER, BASE MOUNTED 480 VOLT, 200 AMP, (DUAL) SCALE: NONE SHEET 4 OF 4 SHEETS STA.

SCALE:


TOTAL SHEE SHEETS NO. SECTION COUNTY CONTRACT NO. E-200 (BE-200)

USER NAME = mgarvlda	DESIGNED - VG	REVISED -
	DRAWN - VN/MAG	REVISED -
PLOT SCALE = 0.167'/ln.	CHECKED - RP	REVISED -
PLOT DATE = 4/24/2025	DATE - 4/25/2025	REVISED -

STATE OF ILLINOIS **DEPARTMENT OF TRANSPORTATION** 

ID	OT D1 –	TEMPOR/	ARY CON	ITROLLER	DETAILS
	SHEET	OF	SHEETS	STA.	TO STA.

LT-44 COUNTY 80 FAI 80 21 INTERCHANGE WILL 1209 575 CONTRACT NO. 62R22

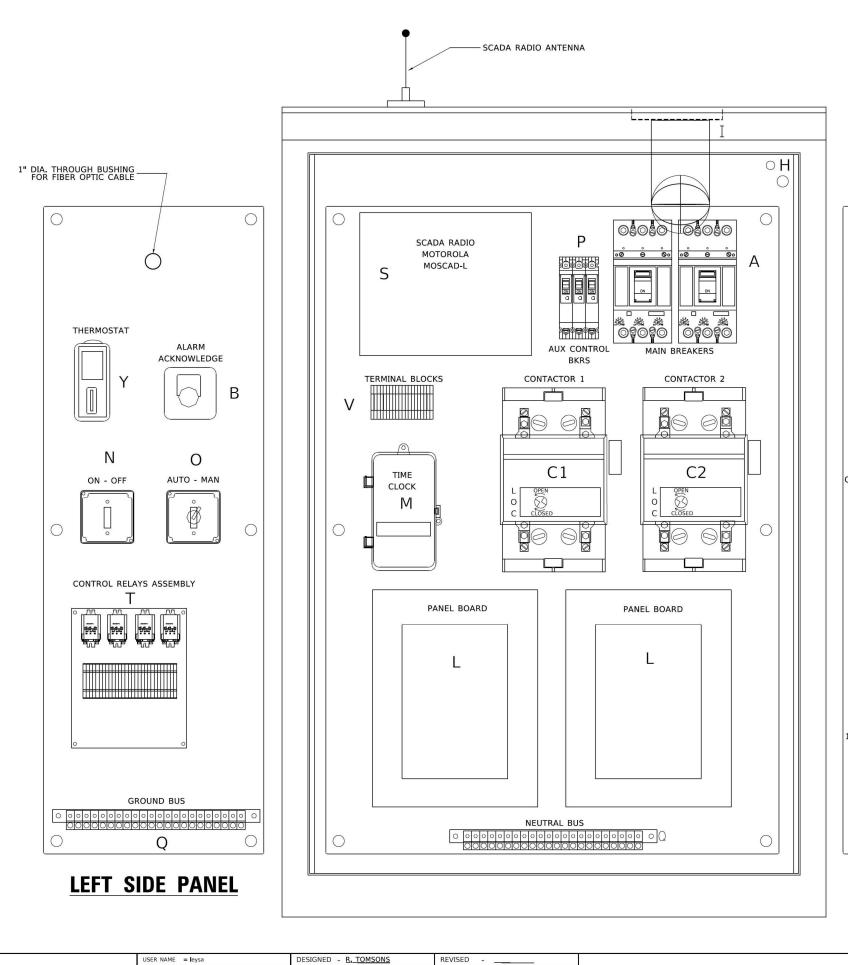

REVISED - \_\_\_


REVISED -

DRAWN

CHECKED -

DATE - <u>01-15-2020</u>

PLOT SCALE = 50.0000 ' / in.

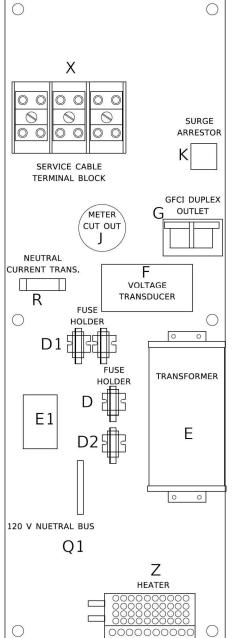

ITEM	QTY	DESCRIPTION
Α	2	MAIN CIRCUIT BREAKERS 2 POLE 200 AMP WITH AUX CONTACT
В	1	ACKNOWLEDGE SWITCH, PUSH BUTTON WITH YELLOW INSERT
C1, C2*	2	CONTACTOR 2 POLE 200 AMP 240V COIL WITH AUX CONTACTS
О	1	FINGERSAFE FUSE HOLDER WITH KTK - 20A FUSE
D1	2	FINGERSAFE FUSE HOLDER WITH KTK - ½ A FUSE
D2	1	FINGERSAFE FUSE HOLDER WITH KTK - 2A FUSE
Е	1	2.0 KVA 277V-240/120 TRANSFORMER
E1	1	0.25 KVA240/ 120 - 24 VAC TRANSFORMER
F	1	VOLTAGE TRANSDUCER WITH COVER TERMINALS
G	1	20 AMP GFCI DUPLEX OUTLET W/COVER
Н	2	DOOR SWITCH
I	1	LIGHT FIXTURE
ĵ	1	METER FITTING 1 PHASE 3 WIRE 200 AMP
K	1	SURGE ARRESTER
L	2	PANEL BOARD 480/ 240V 1 PHASE, 250 AMP COPPER BUS
М	1	2 CHANNEL DIGITAL TIME CLOCK
N	1	MOMENTARY SWITCH ON - OFF
0	1	SQUARE D, 9001KS11BH13, 2 POSITION SWITCH IN 9001KY1 ENCLOSURE OR APPROVED EQUAL
Р	2	BREAKER 1P 15A
Q	2	COPPER GROUND AND NEUTRAL BUS 1 X 16 X 1/4
Q1	1	COPPER NEUTRAL BUS WITH 1 #6 AND 8 #12 CONDUCTOR POINTS
R	1	CURRENT TRANSDUCER
S	1	MOTOROLA MOSCAD-L RADIO, 240 V
т*	1	CONTROL RELAY ASSEMBLY 240V COILS WITH 4 - 3PDT 25A RELAYS (W389ACX-15) (R1, R2, R3, R4). QTY 32 TERMINAL BLOCKS
٧	20	TERMINAL BLOCKS
х*	1	620 AMP SPLICE BLOCK
Y	1	40-80 DEGREE THERMOSTAT
Z	1	375 WATT HEATER

BILL OF MATERIALS

\* TERMINALS SHALL BE COVERED WITH CLEAR PLEXIGLASS SHEET

LT-45


## **RIGHT SIDE PANEL**


STATE OF ILLINOIS

**DEPARTMENT OF TRANSPORTATION** 

SECTION LIGHTING CONTROLLER, BASE MOUNTED, 80 FAI 80 21 INTERCHANGE

COUNTY <u>WILL 1209 576</u> 480VOLT, 200AMP (DUAL) RADIO SCADA - FIBER OPTIC PROVISION BE-206 CONTE CONTRACT NO. 62R22 SCALE; NONE SHEET 1 OF 4 SHEETS STA.

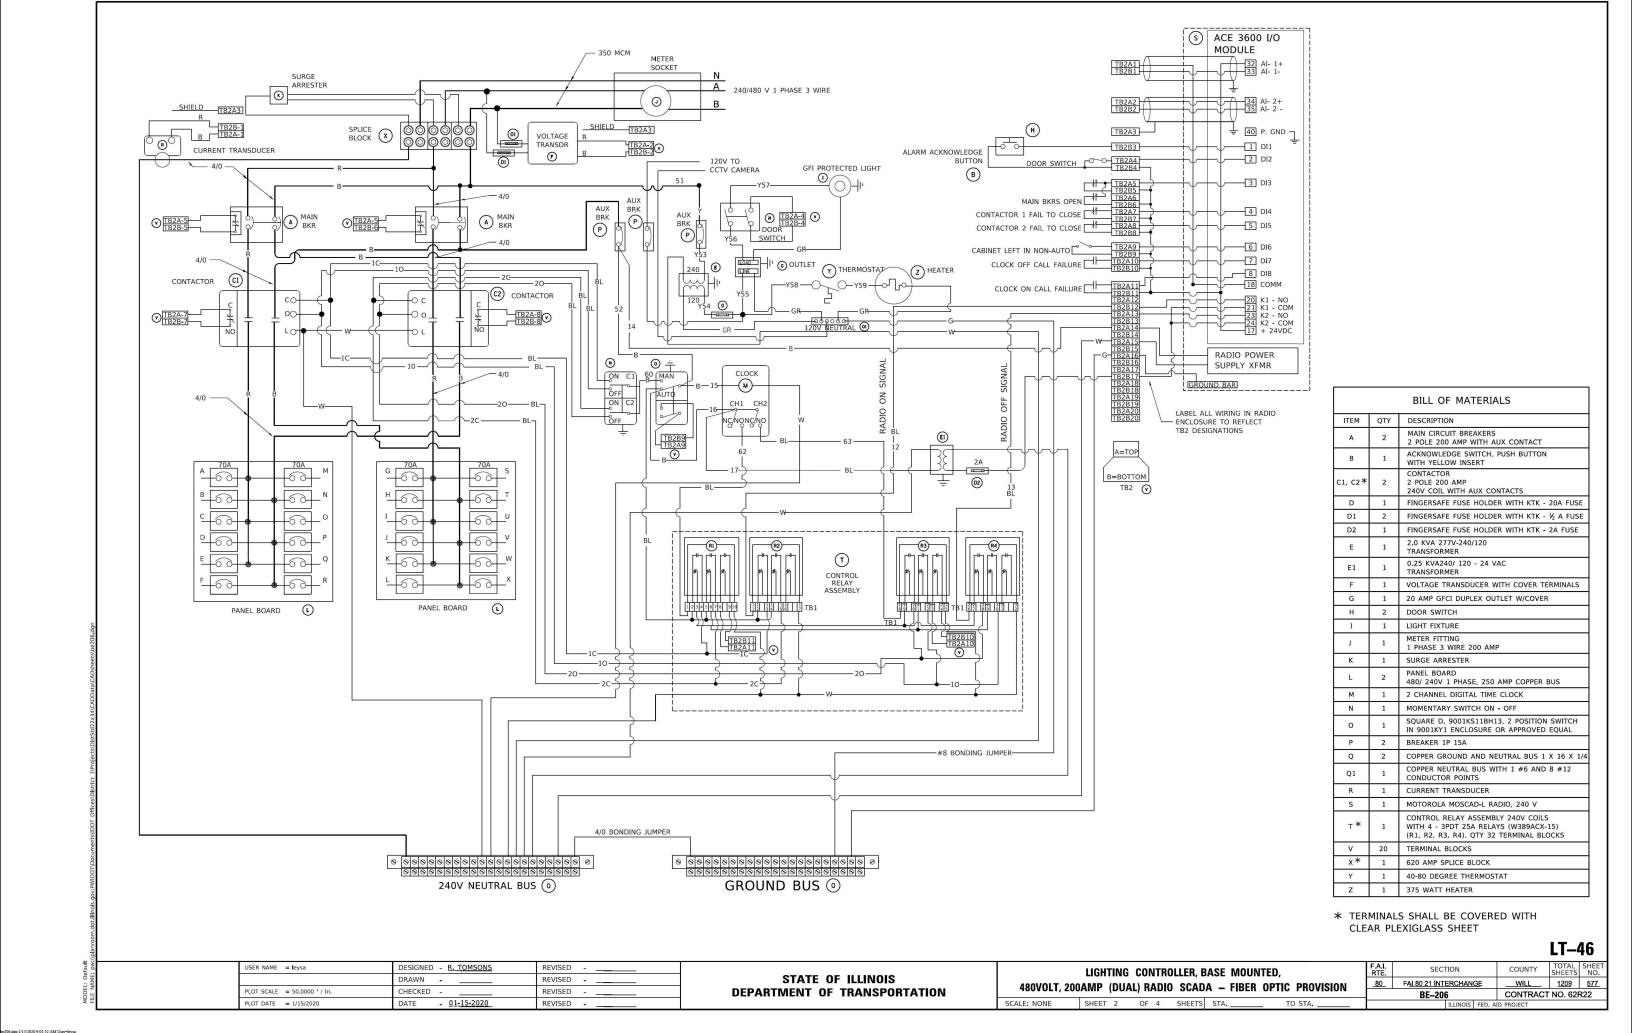

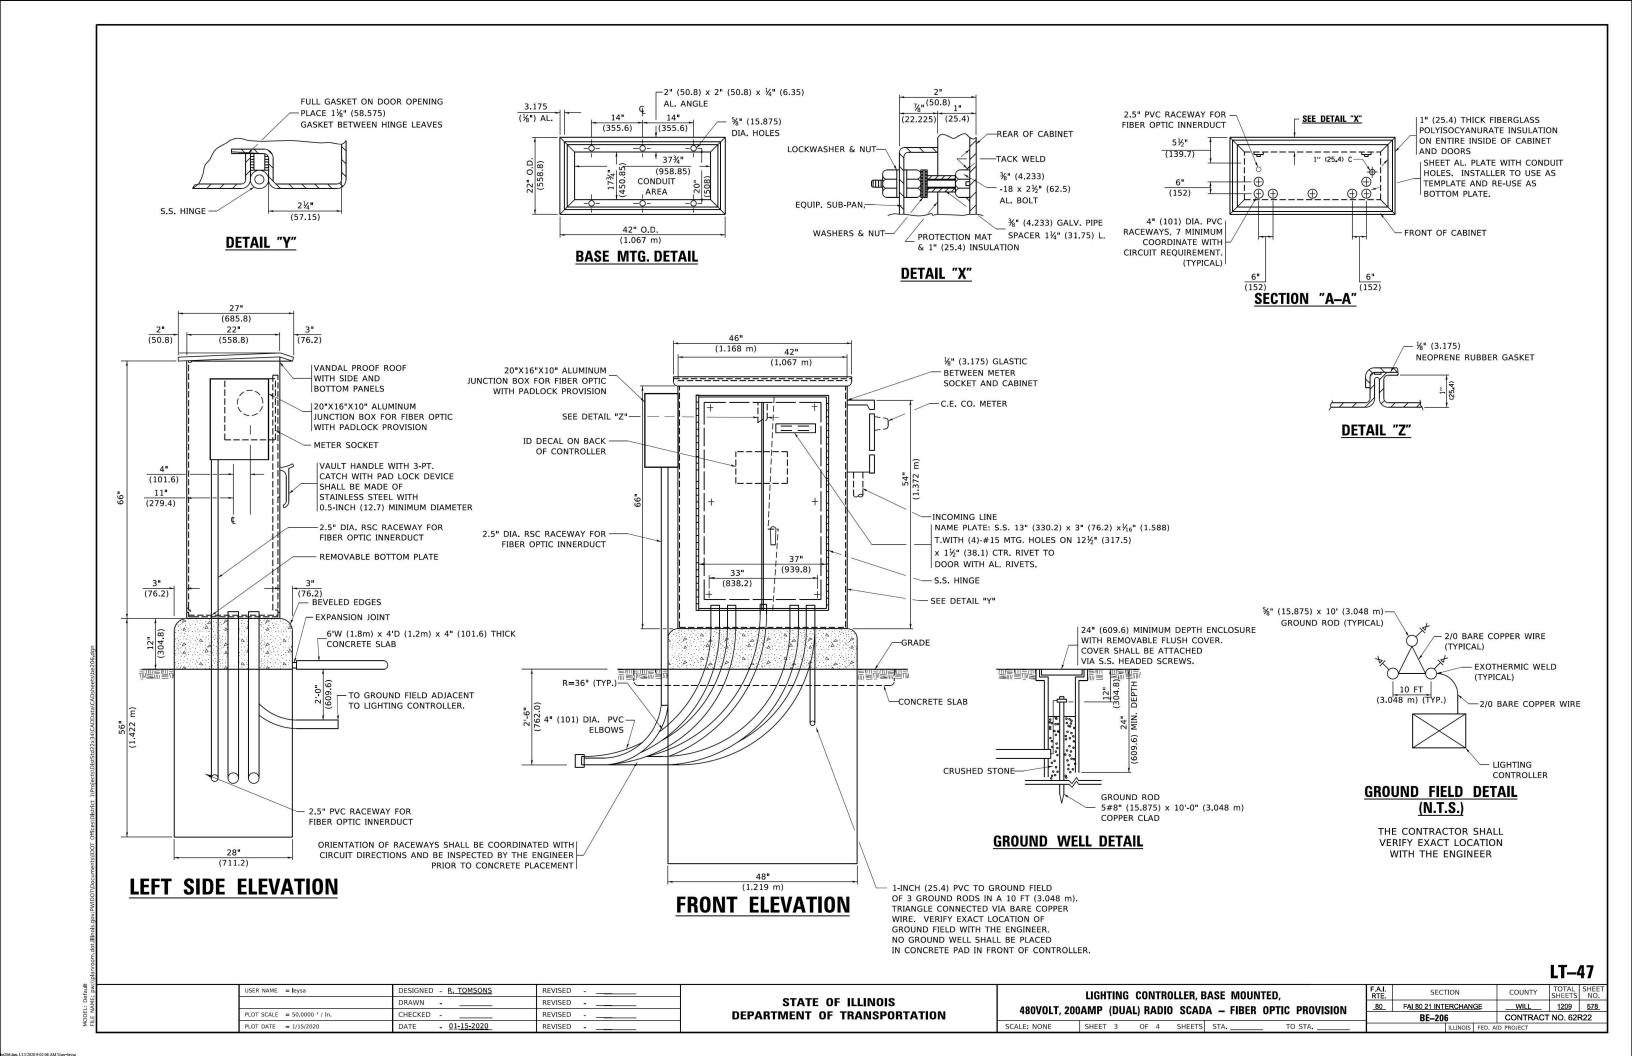


#### **NOTES**

- CABINET SHALL BE FABRICATED FROM 0.125-INCH (3.175) SHEET ALUMINUM #3003H14, FORMED AND ARC WELDED.
- ALL SCREWS AND HARDWARE SHALL BE PLATED, GALVANIZED, OR MADE OF BRASS, ALUMINUM OR STAINLESS STEEL, UNLESS OTHERWISE NOTED.
- NAME PLATE SHALL HAVE ENGRAVED 0.75-INCH (19.05) HIGH LETTERS FILLED IN BLACK: "STATE OF ILLINOIS LIGHTING CONTROLS" UNLESS OTHERWISE SPECIFIED.
- 4. ONE INCH THICK POLYISOCYANURATE INSULATION SHALL BE INSTALL AND PERMANENTLY CEMENTED ON ALL SIDES OF THE CABINET AND DOORS.
- 5. CABINET SHALL BE PRIMED AND PAINTED AS SPECIFIED.
- ELECTRIC UTILITY METER BOX SHALL BE MOUNTED ON THE SIDE OF CONTROL CABINET AS SHOWN ON THE PANEL LAYOUT DIAGRAM.
- THE COMPLETED CONTROLLER SHALL BE U.L. LISTED AS AN INDUSTRIAL CONTROL PANEL UNDER UL508.
- METAL MOUNTING PANEL SHALL BE FABRICATED FROM THE SAME MATERIAL AS THE CABINET AND SHALL BE FLANGED BACK 0.75-INCHES I.D. ON 4 SIDES.
- CIRCUIT BREAKERS AND CONTACTORS AND OTHER COMPONENTS SHALL BE MOUNTED ON 0.125-INCH (3.175) THICK GLASTIC INSULATION BACK PANEL.
- 10. ALL DEVICES SHALL BE FRONT REMOVABLE.
- 11. TIME CLOCK CHANNEL 1 N.O. CONTACT IS CLOSED NIGHT AND OPEN DAY (LIGHTS ON).
- 12. SET LATITUDE TO 42 DEGREES. SET CH.1 TO 23 MINUTES AFTER ASTRONOMICAL SUNSET, 50 MINUTES BEFORE ASTRONOMICAL SUNRISE. SET CH.2 TO 60 MINUTES AFTER ASTRONOMICAL SUNRISE (WITH A SIGNAL LENGTH OF 1 SECOND), +28 MINUTES AFTER ASTRONOMICAL SUNRISE (WITH A SIGNAL LENGTH OF 7 SECONDS.)
- 13. BUS BAR SHALL HAVE 22 LUG TERMINALS SIZED TO ACCOMMODATE REQUIRED WIRE SIZES. 240V NEUTRAL BUS SHALL BE PAINTED WHITE, GROUND BUS SHALL BE PAINTED GREEN, AND THE 120V NEUTRAL BUS SHALL BE PAINTED GREY.
- 14. ALL LUGS SHALL BE OF COPPER SCREWS AND CONNECTORS, SPRING HELD.
- 15. ALL WIRING TERMINATIONS SHALL BE RATED NOT LESS THAN 75 DEGREE CENTIGRADE.
- 16. ALL CONTROL WIRING SHALL BE 600V #12 TYPE MTW, SCADA WIRING SHALL BE #18.
- 17. ALL POWER WIRING SHALL BE 600V TYPE RHH/RHW.
- 18. ALL WIRING WITHIN THE CABINET SHALL BE COLOR CODED AS INDICATED:

R = RED Y = YELLOW
B = BLACK W = WHITE
BL = BLUE G = GREEN
G = GREY

- 19. MOSCAD I/O WIRING SHALL BE:
  DIGITAL INPUT (DI) WIRING SHALL BE #18 MTW PURPLE.
  ANALOG INPUT (AI) WIRING SHALL BE #18, 2/C SHIELDED.
  AI AND DI WIRING MAY BE BUNDLED TOGETHER, BUT SHALL NOT BE BUNDLED WITH OTHER WIRING.
- 20. ALL DIMENSIONS ARE IN INCHES (MILLIMETERS) UNLESS OTHERWISE INDICATED.
- 21. SCHEMATIC SHOWN WITH BREAKER OPEN, CONTACTOR OPEN, CABINET DOOR CLOSED, CLOCK NOT ACTIVE (DE-ENERGIZED STATE).
- 22. A LAMINATED COPY OF THE CIRCUIT SCHEMATIC AND SCADA I/O DIAGRAM (NO SMALLER THAN 11"x17" EACH) SHALL BE ATTACHED TO THE INSIDE OF THE CONTROLLER WITH STAINLESS STEEL SCREWS.

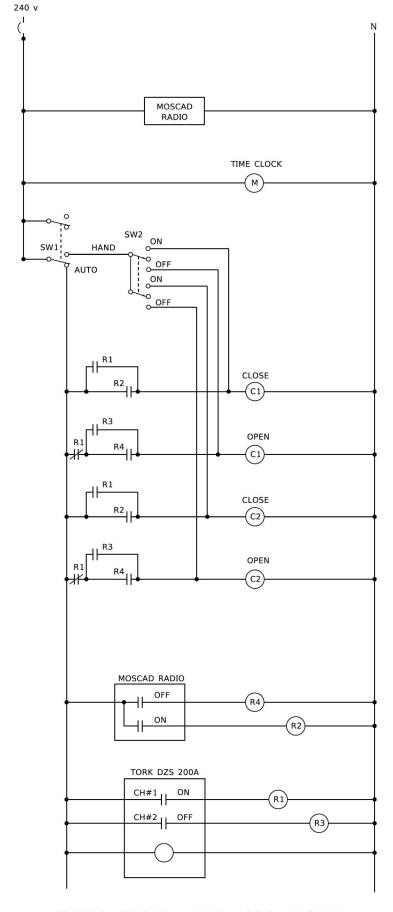

	MOSCAD I/O ASSIGNMENTS									
TERM	MOSCAD DESTINATION	DESCRIPTION OF INPUT								
1	DIGITAL INPUT 1	ALARM KNOWLEDGE								
2	DIGITAL INPUT 2	DOOR OPEN								
3	DIGITAL INPUT 3	MAIN(S) BREAKER OPEN								
4	DIGITAL INPUT 4	CONTACTOR 1 OPEN								
5	DIGITAL INPUT 5	CONTACTOR 2 OPEN								
6	DIGITAL INPUT 6	CABINET IN NON-AUTO								
7	DIGITAL INPUT 7	BACK-UP CLOCK OFF CALL								
8	DIGITAL INPUT 8	BACK-UP CLOCK ON CALL								
17	24 V+	24+VDC								
18	DI COMMON	COMMON								
21	K1 C	K1 COMMON								
22	K1 NO	LIGHTS ON CALL								
24	K2 C	K2 COMMON								
25	K2 NO	LIGHTS OFF CALL								
32	ANALOG INPUT 1 (+)	CABINET NEUTRAL CURRENT								
33	ANALOG INPUT 1 (-)	CABINET NEUTRAL CURRENT								
34	ANALOG INPUT 2 (+)	CABINET SERVICE VOLTAGE								
35	ANALOG INPUT 2 (-)	CABINET SERVICE VOLTAGE								
40	P. GROUND	GROUND								

ALL ANALOG INPUTS WILL BE 4-20 MA ONLY. DIGITAL OUTPUT RELAYS WILL BE ELECTRICALLY ENERGIZED AND MOMENTARILY HELD

MIXED I/O MODULE MODEL NUMBER V436

#### CONTROL CIRCUIT LADDER LOGIC DIAGRAM

LT-48

 USER NAME
 = leysa
 DESIGNED
 - R, TOMSONS
 REVISED

 DRAWN
 REVISED

 PLOT SCALE
 = 50.0000 '/ in.
 CHECKED
 REVISED

 PLOT DATE
 = 1/15/2020
 DATE
 - Q1-15-2020
 REVISED

STATE OF ILLINOIS DEPARTMENT OF TRANSPORTATION LIGHTING CONTROLLER, BASE MOUNTED,

480VOLT, 200AMP (DUAL) RADIO SCADA – FIBER OPTIC PROVISION


ALE: NONE SHEET 4 OF 4 SHEETS STA. \_\_\_\_\_\_ TO STA. \_\_\_\_\_

FAL. SECTION COUNTY TOTAL SHEET:

80 FAL80 21 INTERCHANGE WILL 1209 579

BE-206 CONTRACT NO. 62R22

| ILLINOIS | FED. AID PROJECT

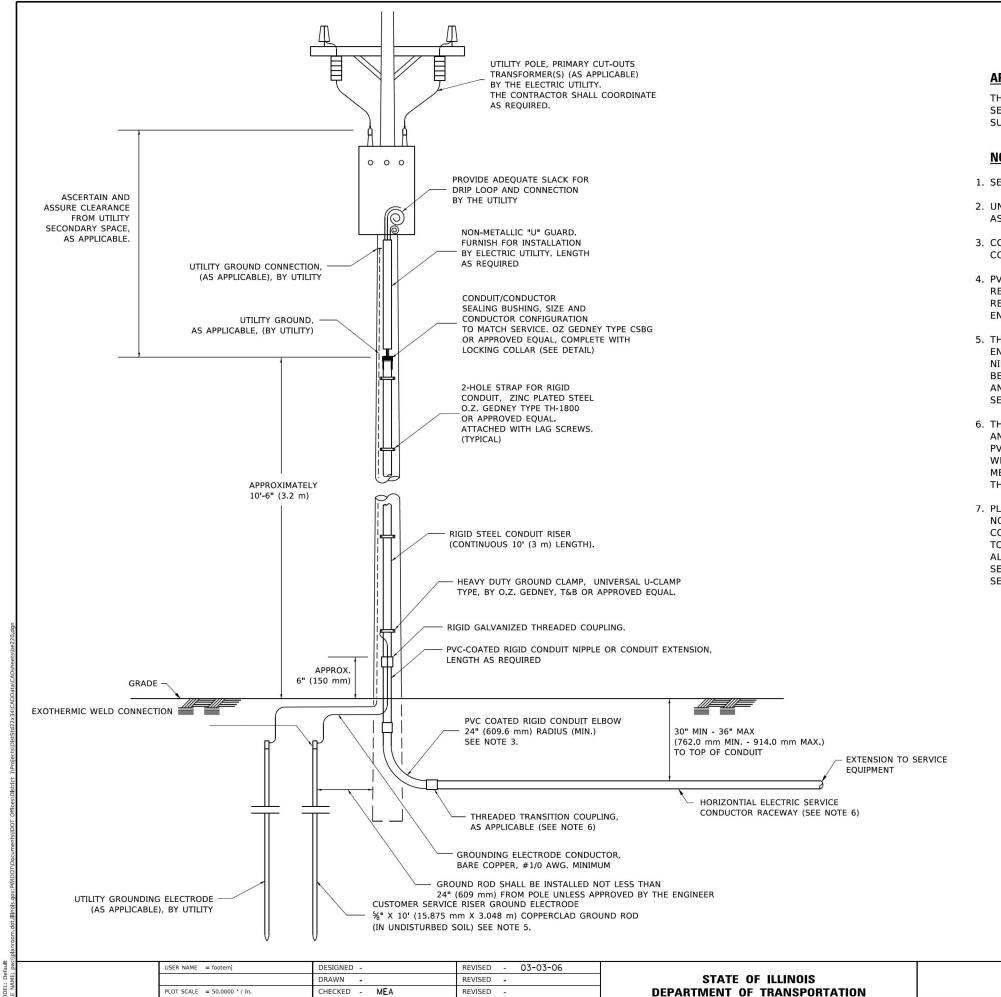


REVISED

#### **APPLICATION**

THIS DETAIL APPLIES FOR LOW VOLTAGE ELECTRIC SERVICE (660 V OR LESS) FROM AN OVERHEAD UTILITY SUPPLY TO SEPERATLY-MOUNTED SERVICE EQUIPMENT.

#### **NOTES**

- 1. SERVICE VOLTAGE SHALL BE AS INDICATED ELSEWHERE IN THE DRAWINGS.
- 2. UNLESS OTHERWISE INDICATED, ITEMS AND WORK SHALL BE INCLUDED AND PAID AS PART OF THE ELECTRIC UTILITY SERVICE INSTALLATION PAY ITEM.
- 3. CONDUIT AND CONNECTOR DIAMETER SHALL MATCH THE DIAMETER OF THE SERVICE CONDUCTOR RACEWAY AS INDICATED ON THE PLANS.
- 4. PVC COATED RACEWAYS AND ACCESSORIES SHALL BE CAREFULLY INSTALLED WITH MFR RECOMMENDED TOOLS AND PROCEDURES TO AVOID DAMAGE. ANY DAMAGE SHALL BE REPAIRED WITH COMPATIBLE PVC TOUCH-UP MATERIAL TO THE SATISFACTION OF THE ENGINEER OR THE DAMAGED MATERIAL SHALL BE REPLACED AT NO ADDITIONAL COST.
- 5. THE CONTRACTOR SHALL OBTAIN INSPECTION AND APPROVAL BY THE ENGINEER OF SERVICE RISER GROUND ELECTRODE, RISER ELBOW, NIPPLE AND CONNECTION TO SERVICE CONDUCTOR RACEWAY EXTENSION BEFORE BACKFILL AND SHALL ALSO OBTAIN INSPECTION OF SERVICE RISER AND SEALING BUSHING BEFORE UTILITY "U" GUARD INSTALLATION AND SERVICE CONNECTION.
- 6. THE HORIZONTAL ELECTRIC SERVICE CONDUCTOR RACEWAY SHALL BE AS INDICATED AND SHALL BE MEASURED SEPARATELY FOR PAYMENT. WHEN THE RACEWAY IS PVC-COATED RIGID GALVANIZED STEEL, THE COUPLING SHALL BE THE SAME. WHEN THE RACEWAY IS PVC CONDUIT (IN CONCRETE), THE COUPLING SHALL BE A METALIC TO NON METALIC ADAPTER. WHEN THE RACEWAY IS ENCASED IN CONCRETE, THE CONCRETE SHALL EXTEND TO COVER THE COUPLING.
- 7. PLANS AND DETAILS INDICATE THE GENERAL NATURE AND REQUIREMENTS. THEY DO NOT SHOW EVERY ACCESSORY AND ATTACHMENT, AND THEY DO NOT RELIEVE THE CONTRACTOR OF THE REQUIREMENTS OF THE SPECIFICATIONS AND SPECIAL PROVISIONS TO ASCERTAIN UTILITY REQUIREMENTS AND TO COORDINATE ACCORDINGLY, FURNISHING ALL ITEMS AND WORK NOT PROVIDED BY THE UTILITY, BUT NECESSARY FOR A COMPLETE SERVICE INSTALLATION IS REQUIRED AND SHALL BE INCLUDED IN THE ELECTRIC UTILITY SERVICE INSTALLATION PAY ITEM.

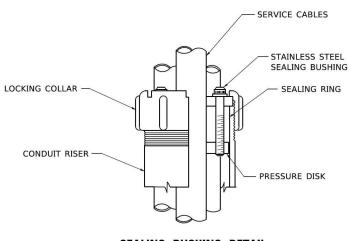

**SEALING BUSHING DETAIL** 

TO STA.

LT-49

SCALE: NONE SHEET 1 OF 1 SHEETS STA.

### SECTION COUNTY TOTAL SHEE SHEETS NO.

### COUNTY TOTAL SHEETS NO.

### SHEETS NO.

### COUNTY TOTAL SHEETS NO.

### SHEETS

....

PLOT DATE = 4/19/2019

USER NAME = demanchelt	DESIGNED	-	RT	REVISED	-	T.G. 4/12/2017
	DRAWN	-		REVISED	-	R. TOMSONS 3/2
PLOT SCALE = 100.0000 ' / in.	CHECKED	-	RT	REVISED	-	T.G. 8/03/2021
PLOT DATE = 5/5/2022	DATE	-	08/18/2014	REVISED	-	T.G. 5/05/2022

#### STATE OF ILLINOIS **DEPARTMENT OF TRANSPORTATION**


СОМВ	INATIO	V	LIGHT	INC	G, TRAFFI	C SIG	NAL SCHEMATIC	
CALE: NONE	SHEET :	1	OF	1	SHEETS	STA.	TO STA.	_

SECTION RTE. SECTION 80 FAI 80 21 INTERCHANGE WILL 1209 581 BE-240 CONTRACT NO. 62R22

LT-50

/22/18

**COMBINATION POLE WIRING DETAIL** (NOT TO SCALE)

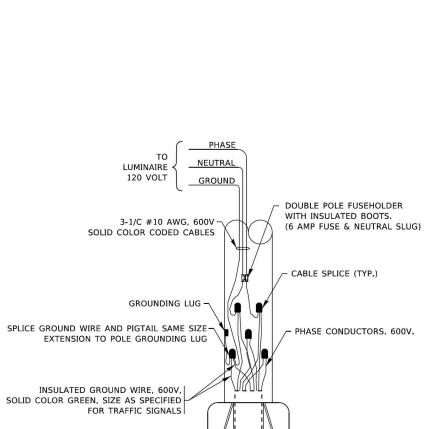

(BLACK, WHITE)

TYPICAL LIGHTING CIRCUIT (NOT TO SCALE)

- TRAFFIC SIGNAL HANDHOLE (TYP.)

CKT A 2C #10 (TYP.) (RED, WHITE) SEE NOTE 12

TRAFFIC SIGNAL CONTROLLER




- 2. TWO #10 (XLP-TYPE USE) CABLES TO BE USED FOR LIGHTING CIRCUITS.
- 3. ROUTE LIGHTING CIRCUITS IN TRAFFIC SIGNAL CONDUIT SYSTEM.
- 4. ALL SPLICES AND CONNECTIONS FOR ROADWAY LIGHTING SHALL BE AT POLE BASE ONLY.
- 5. FOR LIGHTING CIRCUITS, CONNECT TWO CIRCUIT BREAKERS TO AC SERVICE TERMINAL BLOCK.
- 6. ALL WIRING SHALL BE NEATLY DRESSED, IDENTIFIED BY TAGS, AND SUPPORTED. (UNDERGROUND SPLICING OF LIGHTING CONDUCTORS IS NOT PERMITTED).
- 7. THE H.O.A. SWITCH SHALL BE LABELED AS "LIGHTING CONTROL" WITH THE POSITIONS "AUTO", "OFF" AND "TEST" WITH ENGRAVED NAME PLATES.
- 8. LIGHTING CONNECTED TO UPS BYPASS CIRCUIT.
- 9. COMBINATION LIGHTING MUST BE INSTALLED PRIOR TO SIGNAL TURN ON.
- 10. LUMINAIRE VOLTAGE SHALL BE 120V
- 11. POLE WIRING & FUSE KITS ARE INCLUDED IN THE LUMINAIRE PAY ITEM.
- 12. THE UNDERGROUND EQUIPMENT GROUND WIRE IS SHOWN IN THE TRAFFIC SIGNAL PLANS AND IS INCLUDED IN THE SIGNAL PLANS. IT IS SHARED GROUND BETWEEN SIGNALS AND LIGHTING.


			PHOTOCE UNDER C	ELL MOUNTED ————————————————————————————————————	
			COMBINATION LIGHTING PANEL ASSEMBLY MOUNTED BY TRAFFIC SIGNAL CABINET MANUFACTURER	\\	TRAFFIC SIGNAL CONTROLLER
BLACK, WHITE,  GREEN  USE STANDARD 2 POLE			LUMINAIRE (TYP.)	HOA ON STAND-OFF	
LIGHTING FUSE KIT		CKT A	BLACK  ELECTRIC CABLE IN CONDUIT, 2C#10 —		30A #10
LUMINAIRES PER PLAN RED, WHITE, - GREEN	<b>□</b> 6A	[] 6A [] 6A	6A	30A-2P   CONTACTOR   CONTACTOR	AC SERVICE     TERMINAL BLOCK
	NOTES	B3	L		           

#### LIGHT POLE FOUNDATION DEPTH TABLE 40 FT. (12.192 m) TO 47.5 FT. (14.478 m) MOUNTING HEIGHT

AND	DESIGN DEPTH "D"	OF FOUNDATION			
SOIL CONDITIONS	SINGLE ARM POL				
SOFT CLAY Qu = 0.375 TON/SQ. FT.	13'-0" (3.96 m)	15'-0" (4.57 m)			
MEDIUM CLAY Qu = 0.75 TON/SQ.FT	9'-6" (2.09 m)	10'-9" (3.23 m)			
STIFF CLAY Qu = 1.50 TON/SQ. FT.	7'-0" (2.13 m)	8'-0 <b>"</b> (2.44 m)			
LOOSE SAND ∅ = 34°	9'-0" (2.74 m)	10'-0" (3.05 m)			
MEDIUM SAND $\emptyset = 37.5^{\circ}$	8'-3" (2.52 m)	9'-0 <b>"</b> (2.74 m)			
DENSE SAND  ∅ = 40°	7'-9" (2.36 m)	9 <b>'-</b> 0" (2.74 m)			

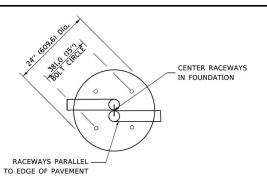


TOP VIEW

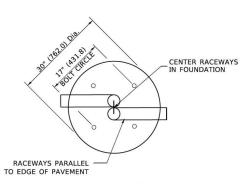

**TOP VIEW** 

ANCHOR ROD 4-1" Dia. X 5'-0" (4-25.4 Dia. X 1.524 m)

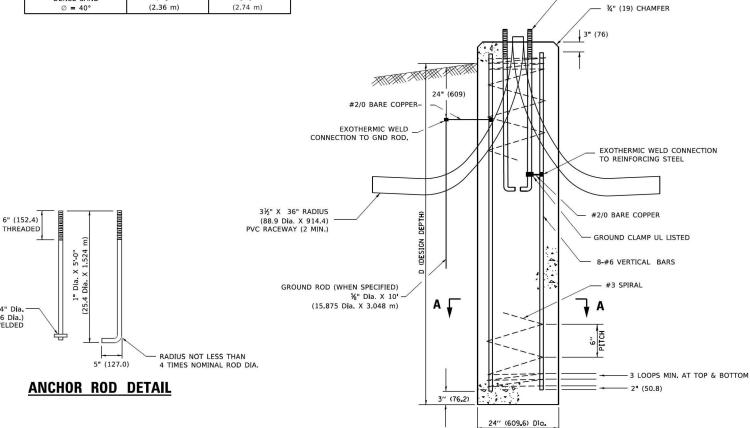


REVISED - 04-22-02

REVISED

REVISED

REVISED

### **FOUNDATION DETAIL**

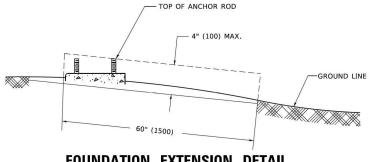

%" T. X 4" Dia.

(15.87 T. X 101.6 Dia.) WASHER, TACK WELDED



DESIGNED -


DRAWN

CHECKED


DATE

USER NAME = footemi

PLOT SCALE = 50,0000 ' / in.

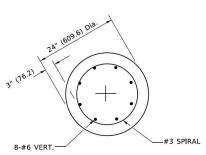

SECTION A-A

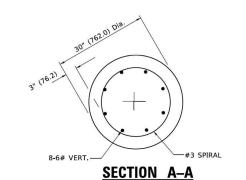

#### **NOTES**

- 1. ALL DIMENSIONS ARE IN INCHES (MILLIMETERS) UNLESS OTHERWISE SHOWN
- 2. THE ANCHOR RODS AND RACEWAYS SHALL BE PROPERLY SECURED IN PLACE BEFORE THE CONCRETE IN PLACED.
- 3. THE FOUNDATION SHALL NOT PROTRUDE MORE THAN 100MM (4 IN.) ABOVE THE FINISHED GRADE WITHIN A 60 IN. (1.5 m) CHORD ACROSS THE FOUNDATION, WITH ANCHOR RODS INCLUDED, IN ACCORDANCE WITH AASHTO GUIDELINES. IF THE FOUNDATION HEIGHT, INCLUDING ANCHOR RODS, EXTENDS BEYOND THESE SPECIFIED LIMITS, THE FOUNDATION SHALL BE REPLACED AT THE CONTRACTOR'S EXPENSE. SEE FOUNDATION EXTENSION DETAIL.
- THE HOLE FOR THE FOUNDATION SHALL BE MADE BY DRILLING WITH AN AUGER, OF THE SAME DIAMETER AS THE FOUNDATION. IF SOIL CONDITIONS REQUIRE THE USE OF A LINER TO FORM THE HOLE, THE LINER SHALL BE WITHDRAWN AS THE CONCRETE IS DEPOSITED.
- THE TOP OF THE FOUNDATION SHALL BE CONSTRUCTED LEVEL. A LINER OR FORM SHALL BE USED TO PRODUCE A UNIFORM SMOOTH SIDE TO THE TOP OF THE FOUNDATION. FOUNDATION TOP SHALL BE CHAMFERED 3#4-IN. (20 mm).
- THE CONCRETE SHALL BE CLASS SI. CONCRETE SHALL CURE ACCORDING TO ARTICLE 1020.13 BEFORE LIGHT POLES ARE INSTALLED.
- 7. THE ANCHOR ROD SHALL BE A HOOK ROD TYPE, COLD BENDING OF THE ANCHOR ROD WILL NOT BE ALLOWED. THE RADIUS OF THE HOOK BEND SHALL NOT BE LESS THAN 4 TIMES THE NOMINAL DIAMETER OF THE ANCHOR ROD. A TACK WELDED ANCHOR ROD MAY BE SUBSTITUTED WITH THE
- 8. THE ANCHOR RODS SHALL BE ACCORDING TO ASTM F1554 GRADE 725 (GRADE 105). NUTS SHALL BE HEXAGON NUTS ACCORDING TO ASTM A 194 2H OR ASTM A 563 DH, AND WASHERS SHALL BE ACCORDING TO ASTM F 436.
- 9 ANCHOR RODS, NUTS AND WASHERS SHALL BE COMPLETELY GALVANIZED BY EITHER THE HOT-DIPPED PROCESS CONFORMING WITH AASHTO M 232, THE MECHANICAL PLATING METHOD CONFORMING TO AASHTO M 298, CLASS 50 WITH A MAXIMUM COATING THICKNESS OF 150 UM(6 MILS) OR THE ELECTROLYTIC PROCESS ACCORDING TO ASTM F 1136.
- 10. THE ANCHOR RODS SHALL BE THREADED A MINIMUM OF 6 INCHES (150 mm) WITH A MINIMUM OF 3 INCHES (75 mm) OF THREADED ANCHOR ROD EMBEDDED IN THE FOUNDATION.
- 11. ANCHOR RODS SHALL PROJECT 23#4" (69.9 mm) ABOVE THE TOP OF THE FOUNDATION. IF BREAKAWAY COUPLINGS ARE SPECIFIED, THE CONTRACTOR SHALL CAREFULLY COORDINATE THE ANCHOR ROD PROJECTION WITH THE INSTALLATION REQUIREMENTS OF THE BREAKAWAY COUPLINGS.
- 12. THE CONTRACTOR SHALL USE A #3 SPIRAL AT 6" (152.4 mm) PITCH OR MAY SUBSTITUTE #3 TIES AT 12" (304.8 mm) O.C. WITH THE APPROVAL OF THE ENGINEER,
- 13. THE CABLE TRENCHES AND FOUNDATION SHALL BE BACK FILLED AND COMPACTED AS SPECIFIED BEFORE THE LIGHT POLE IS ERECTED.
- 14 THE RACEWAYS SHALL PROJECT 1" (25.4 mm) ABOVE THE TOP OF THE FOUNDATION.


SECTION LIGHT POLE FOUNDATION

STATE OF ILLINOIS **DEPARTMENT OF TRANSPORTATION** 

40' (12.192 m) TO 47 1/2' (14.478 m) M.H. 15" (381 mm) BOLT CIRCLE SCALE; NONE SHEET 1 OF 1 SHEETS STA.

80 FAI 80 21 INTERCHANGE 1209 582 CONTRACT NO. 62R22 BE-301

LT-51

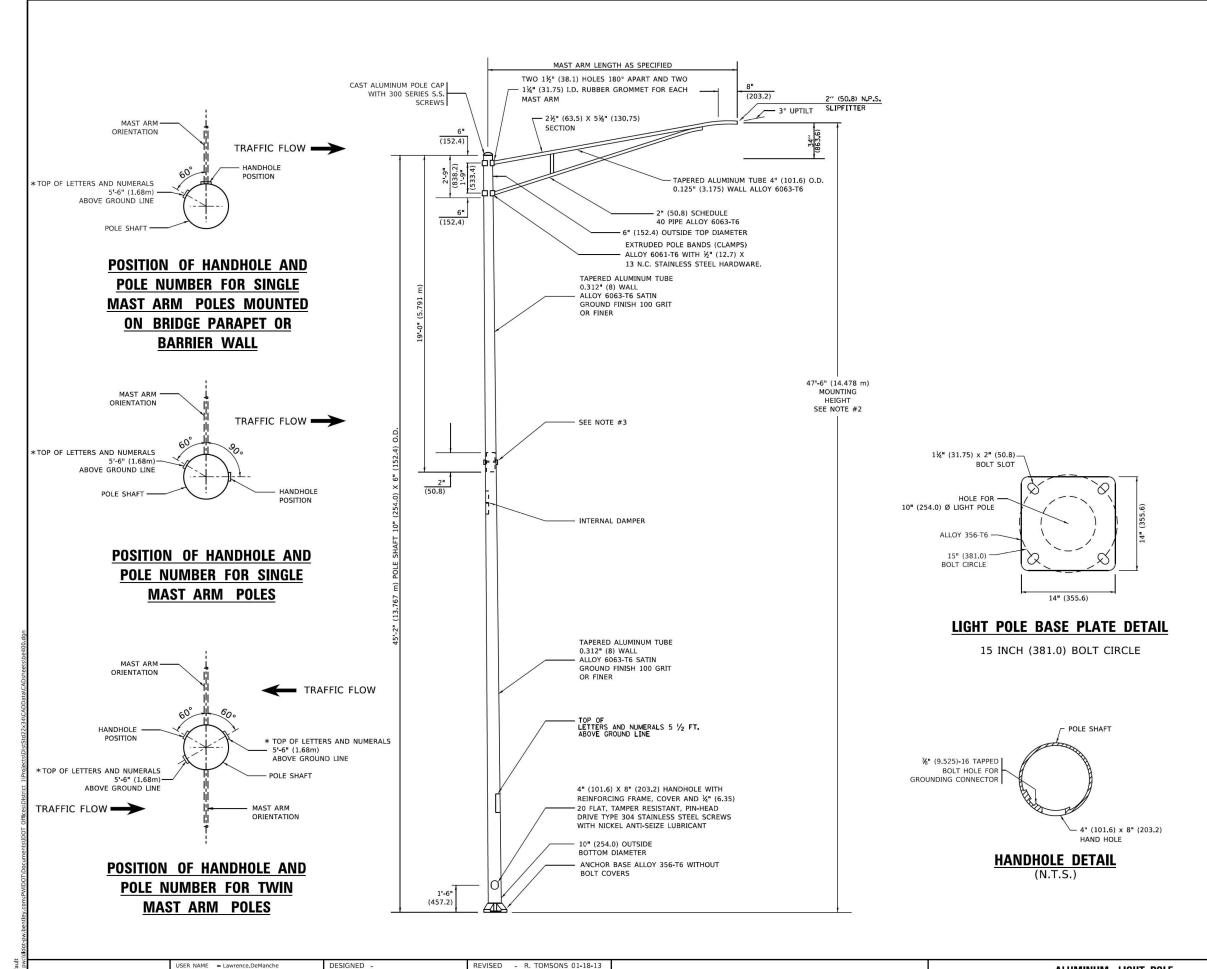

REVISED - R. TOMSONS 03-18-15

REVISED - R TOMSONS 12-19-23

REVISED - TG 06-13-22

DRAWN .

CHECKED

DATE


PLOT SCALE = 100.0000 ' / in.

PLOT DATE = 12/19/2023

#### **NOTES**

- 1. ALL DIMENSIONS ARE IN INCHES (MILLIMETERS) UNLESS OTHERWISE SHOWN.
- MOUNTING HEIGHT IS DEFINED AS THE DISTANCE FROM THE CENTERLINE OF THE TENON TO THE BOTTOM OF THE ANCHOR BASE.
- TWO PIECE SHAFT WILL BE MATCHED MARKED AND INTERCHANGEABLE BETWEEN DIFFERENT UNITS. FIELD DRILLING OF THE HOLES WILL NOT BE ALLOWED.
- 4. THE LIGHT POLE WILL MEET AASHTO DESIGN CRITERIA AS SPECIFIED.
- 5 THE INSTALLING CONTRACTOR WILL PROVIDE A UL LISTED GROUNDING CONNECTOR. BURNDY K2C23. T&B SP4DL OR APPROVED EQUAL.
- LIGHT POLES WILL NOT BE INSTALLED WITHOUT MAST ARMS AND LUMINAIRES.
- LIGHT POLES WILL BE SET PLUMB ON THE FOUNDATION WITHOUT THE USE OF LEVELING NUTS, WASHERS OR SHIMS.
- 8. LIGHTING UNIT IDENTIFICATION NUMBERS SHALL BE INSTALLED BEFORE THE LIGHTING UNIT IS ENERGIZED.

LT-52

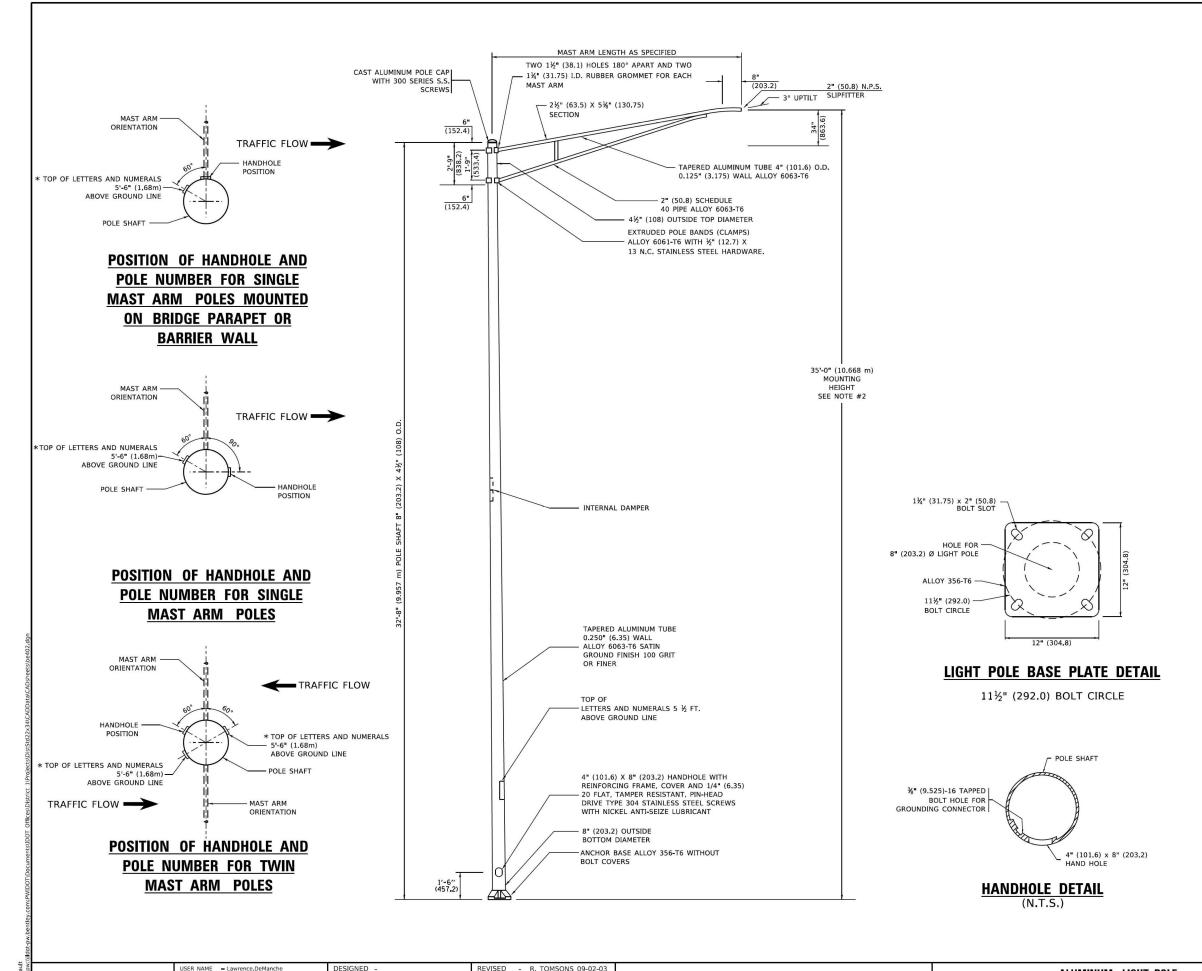

REVISED - R. TOMSONS 01-18-13

REVISED - R TOMSONS 12-19-23

REVISED - TG 06-13-22

DRAWN


CHECKED


DATE

PLOT SCALE = 100.0000 ' / in.

#### **NOTES**

- 1. ALL DIMENSIONS ARE IN INCHES (MILLIMETERS) UNLESS OTHERWISE SHOWN.
- MOUNTING HEIGHT IS DEFINED AS THE DISTANCE FROM THE CENTERLINE OF THE TENON TO THE BOTTOM OF THE ANCHOR BASE.
- 3. THE LIGHT POLE WILL MEET AASHTO DESIGN CRITERIA AS SPECIFIED.
- THE INSTALLING CONTRACTOR WILL PROVIDE A UL LISTED GROUNDING CONNECTOR. BURNDY K2C23, T&B SP4DL OR APPROVED EQUAL.
- 5. LIGHT POLES WILL NOT BE INSTALLED WITHOUT MAST ARMS AND LUMINAIRES.
- 6. LIGHT POLES WILL BE SET PLUMB ON THE FOUNDATION WITHOUT THE USE OF LEVELING NUTS, WASHERS OR SHIMS.
- 7. LIGHTING UNIT IDENTIFICATION NUMBERS SHALL BE INSTALLED BEFORE THE LIGHTING UNIT IS ENERGIZED.

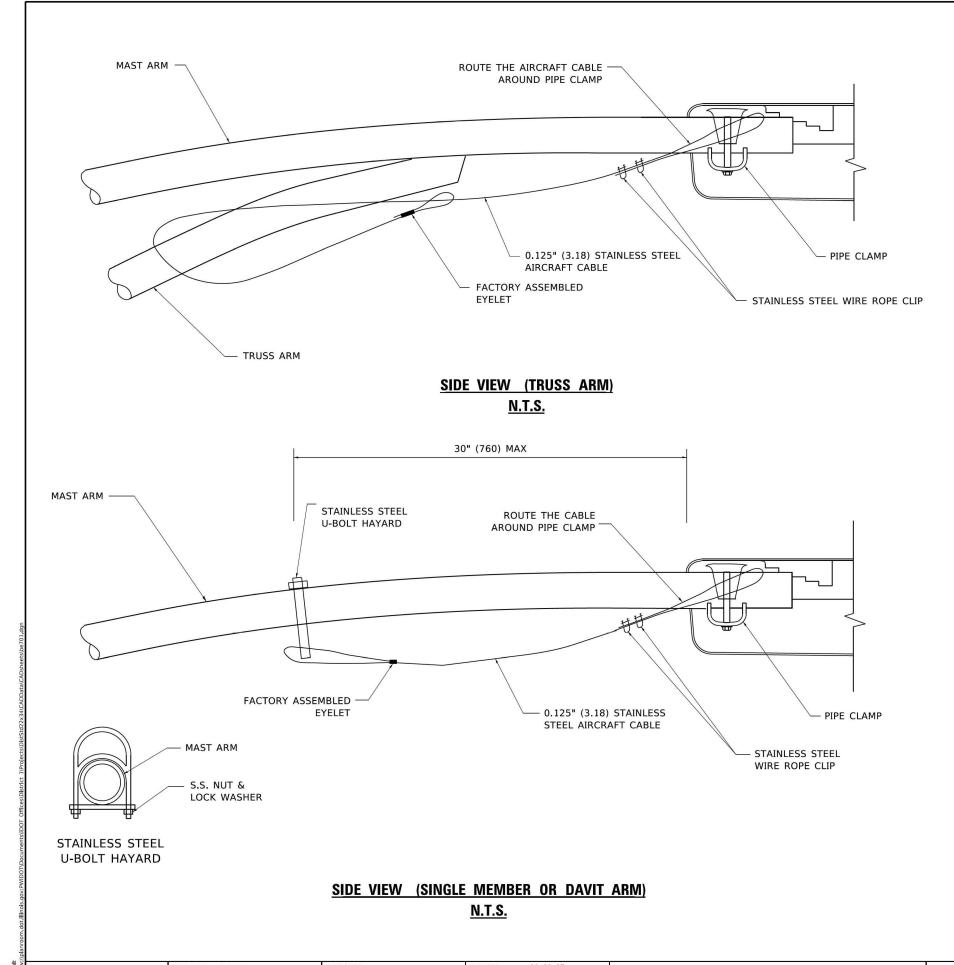

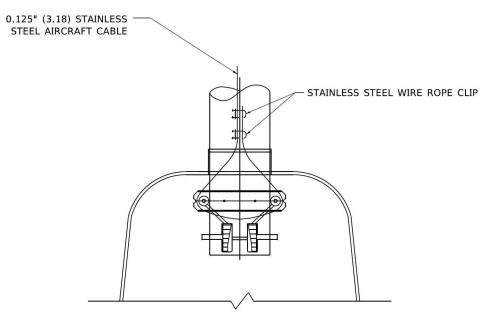


## BOTTOM VIEW N.T.S.

#### NOTES:


- 1. ALL DIMENSIONS ARE IN MILLIMETERS (INCHES) UNLESS OTHERWISE SHOWN.
- 2. CONTRACTOR SHALL ADJUST THE WIRE CLIP TO ELIMINATE ANY SLACK FROM THE WIRE ROPE.
- 3. THE 0.125" (3.18) STAINLESS STEEL AIRCRAFT CABLE SHALL REMAIN VISIBLE FROM THE GROUND LEVEL.
- 4. THE BREAKING STRENGTH OF THE CABLE SHALL BE 1700 LBS. MIN.

LT-54

USER NAME = footemj	DESIGNED -	REVISED - 08-08-03						P.A.I.	SECTION	COUNTY	SHEETS NO	1
	DRAWN -	REVISED -	STATE OF ILLINOIS		LUMINAIRE SAFETY CA	BLE ASSEMB	BLY	80	FAI 80 21 INTERCHANGE	WILL	1209 585	1
PLOT SCALE = 50,0000 ' / in.	CHECKED -	REVISED -	DEPARTMENT OF TRANSPORTATION						BE-701	CONTRACT		1
PLOT DATE = 4/19/2019	DATE -	REVISED -		SCALE: NONE	SHEET 1 OF 1 SHEETS	STA.	TO STA.		ILLINOIS FED. AI	ID PROJECT		1

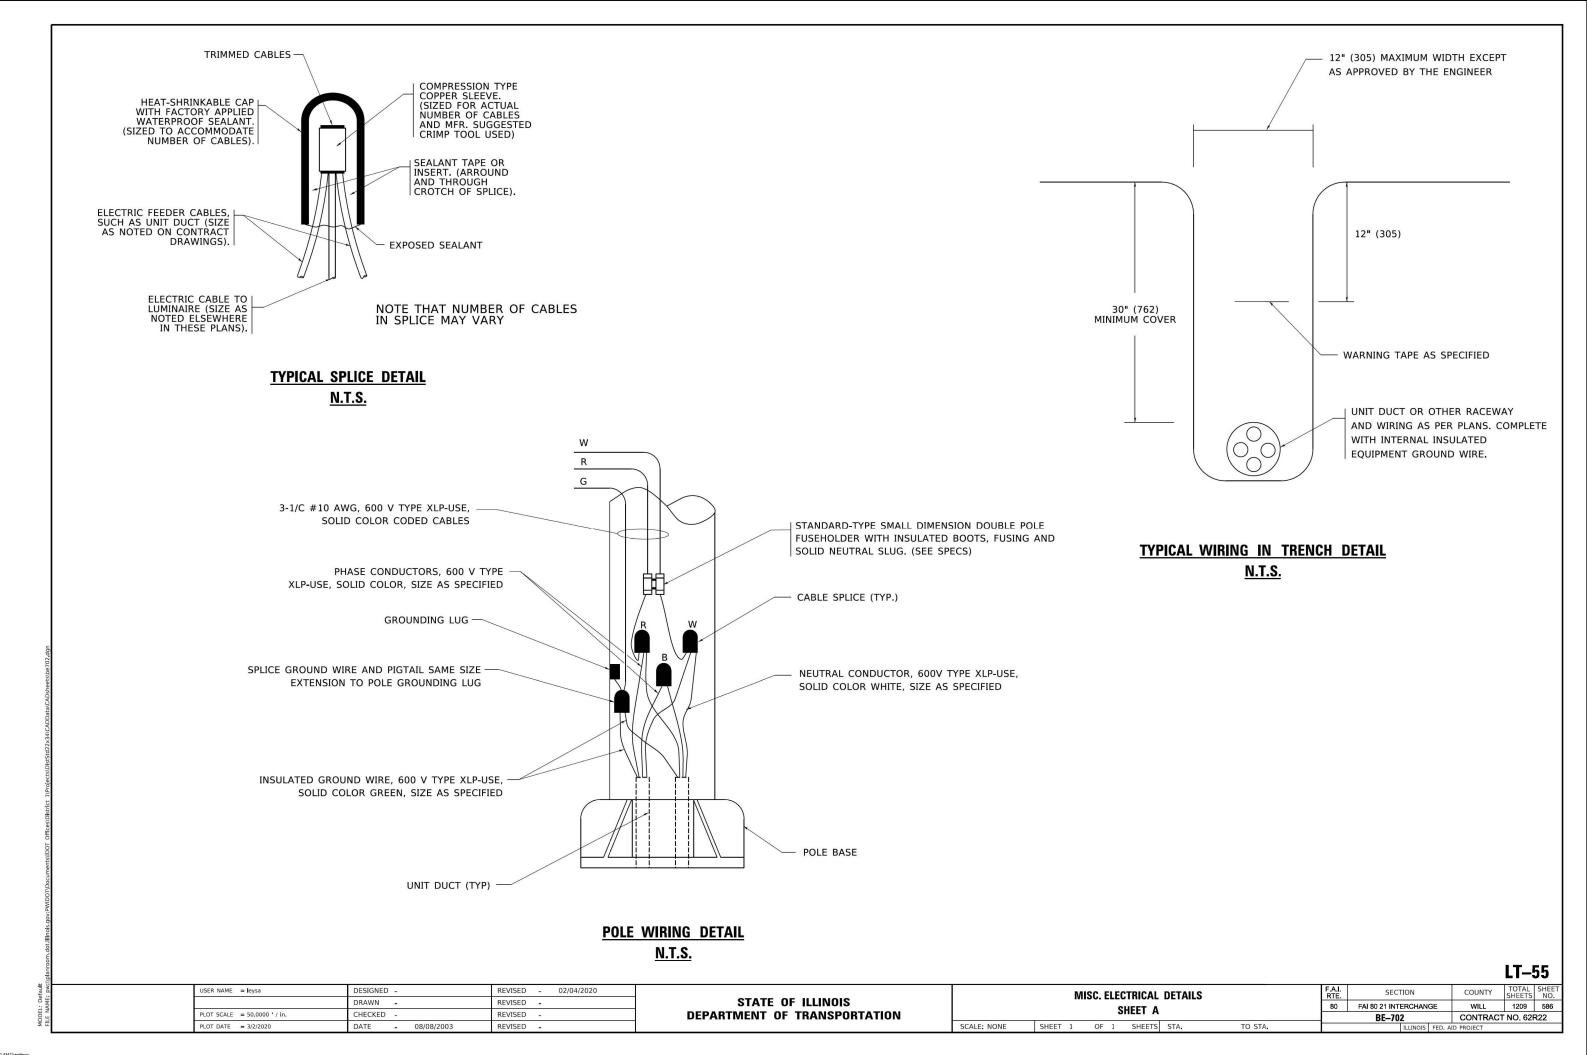


LT-56 MISCELLANEOUS ELECTRICAL DETAILS, SHEET B SECTION COUNTY J BOX EMBEDDED IN BARRIER WALL - INSTALLATION OF CONDUIT IN BRIDGE FAI 80 21 INTERCHANGE WILL 1209 587 PARAPET EXPANSION JOINT - ELECTRIC CONNECTION TO UNDERPASS LIGHTING BE-703 CONTRACT NO. 62R22 SHEET 1 OF 1 SHEETS STA.

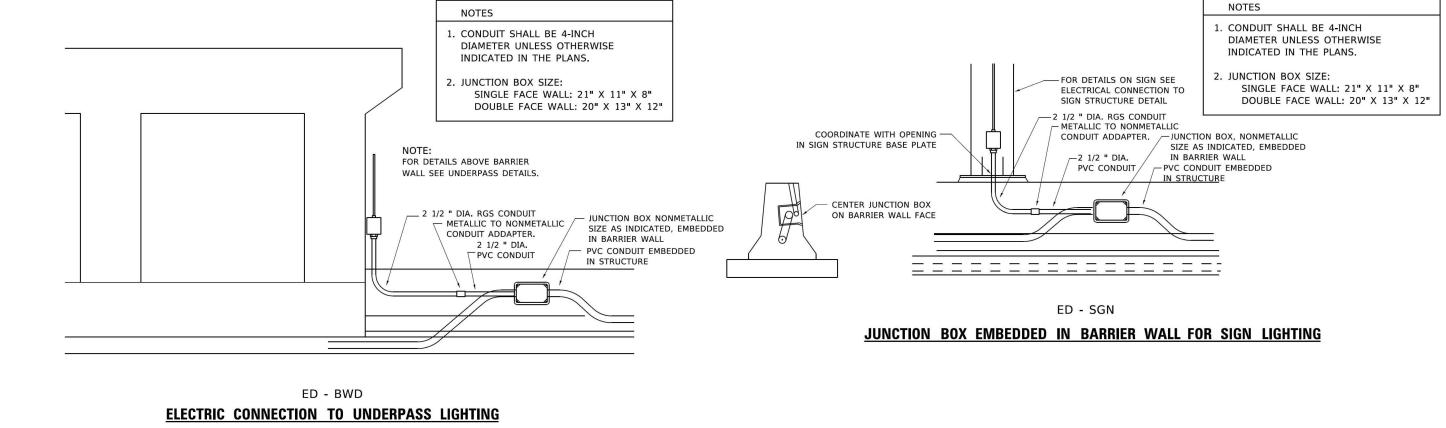

STATE OF ILLINOIS

**DEPARTMENT OF TRANSPORTATION** 

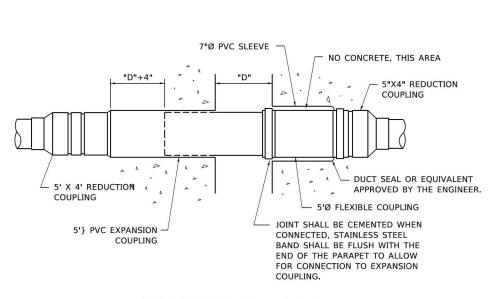

#### **INSTALLATION OF CONDUIT IN BRIDGE PARAPET EXPANSION JOINT**

- 01-20-2009

DESIGNED -

CHECKED

DRAWN

DATE

USER NAME = footemi

PLOT SCALE = 50,0000 ' / in.


(N.T.S.)

REVISED -


REVISED -

REVISED

REVISED -

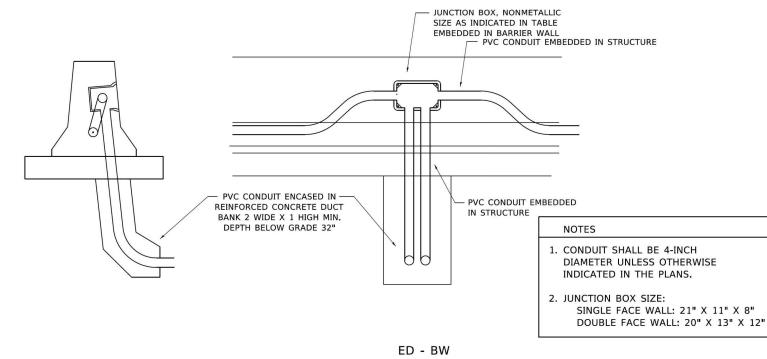

JUNCTION BOX EMBEDDED IN BARRIER WALL

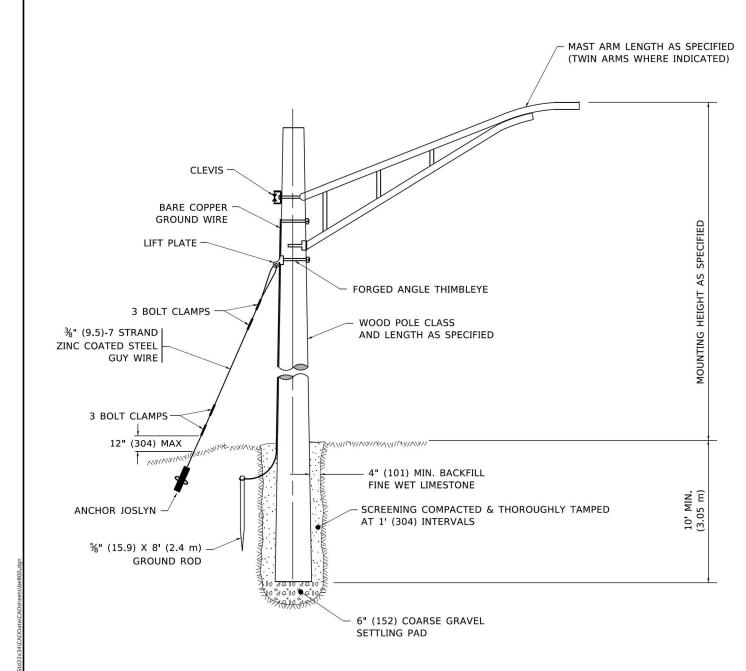

# **TEMPORARY LIGHT POLE ATTACHMENT DETAIL**

HEAVY DUTY INSULATED

- BARE COPPER GROUND WIRE EVERY THIRD POLE

PULLEY CLEVIS

TO LUMINAIRE

- NEUTRAL CONDUCTOR

PHASE CONDUCTOR

WATERPROOF FUSEHOLDER AND SOLID NEUTRAL SLUG

WATERPROOF FUSEHOLDER & FUSE

## **TEMPORARY LIGHT POLE DETAIL**

#### NOTE:

USER NAME = footemj

PLOT SCALE = 50.0010 ' / in.

- 1. ALL DIMENSIONS IN INCHES (MILLIMETERS) UNLESS OTHERWISE INDICATED.
- 2. MAST ARM SHALL BE RATED FOR THE SPECIFIED MOUNTING HEIGHT.

DESIGNED -

CHECKED -

REVISED

DRAWN

DATE

REVISED - 08-08-03 REVISED - R.T. 07-26-16 STATE OF ILLINOIS **TEMPORARY LIGHT POLE DETAILS** REVISED **DEPARTMENT OF TRANSPORTATION** SCALE: NONE

WOOD POLE -

GROUND CLAMP -

AWG BARE COPPER

WATERPROOF INSULATION

PIERCING TAP CONNECTOR

**GROUND WIRE** 


MESSENGER TIED TO INSULATOR -WITH FACTORY FORMED CABLE TIE

SHEET 1 OF 1 SHEETS STA.

F.A.I. SECTION

80 FAI 80 21 INTERCHANGE SECTION 1209 588 BE-800 CONTRACT NO. 62R22

LT-57

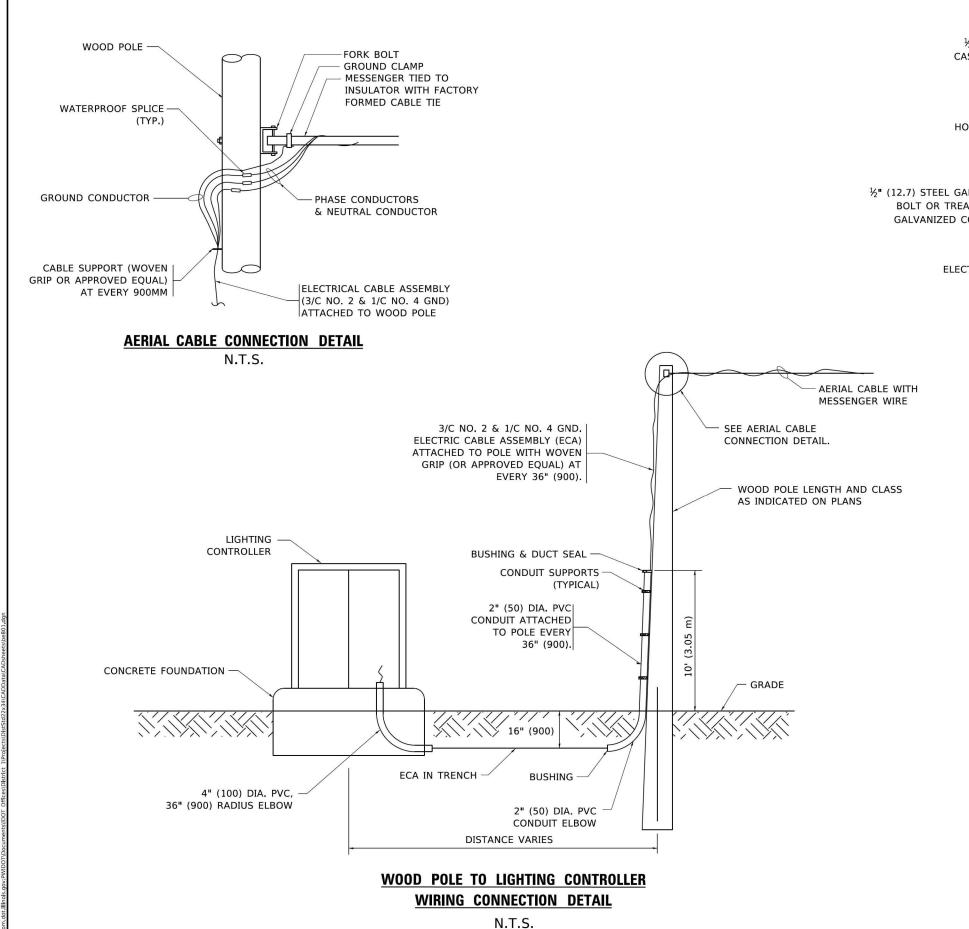


REVISED - 08-08-03

REVISED -

REVISED

REVISED -

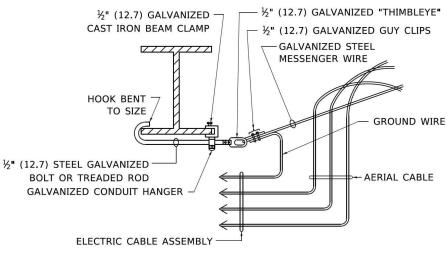

## AERIAL CABLE ATTACHED TO STRUCTURE

NOT TO SCALE

#### NOTES:

- 1. ALL DIMENSIONS IN INCHES (MILLIMETERS) UNLESS OTHERWISE INDICATED.
- 2. SEE PROPOSED LIGHTING PLAN FOR CONDUIT, CABLE AND ROUTING.
- 3. THE CONTRACTOR SHALL PROVIDE INTERMEDIATE SUPPORTS TO MAINTAIN MINIMUM CLEARANCES. REFER TO AERIAL AERIAL CABLE ATTACHED TO STRUCTURE DETAIL.
- 4. COST OF SPLICES AND MOUNTING HARDWARE SHALL BE INCLUDED IN THE UNIT PRICE FOR AERIAL CABLE.

LT-58

USER NAME = footemi

PLOT DATE = 4/19/2019


PLOT SCALE = 50,0000 ' / in.

DESIGNED -

DRAWN .

CHECKED -

DATE

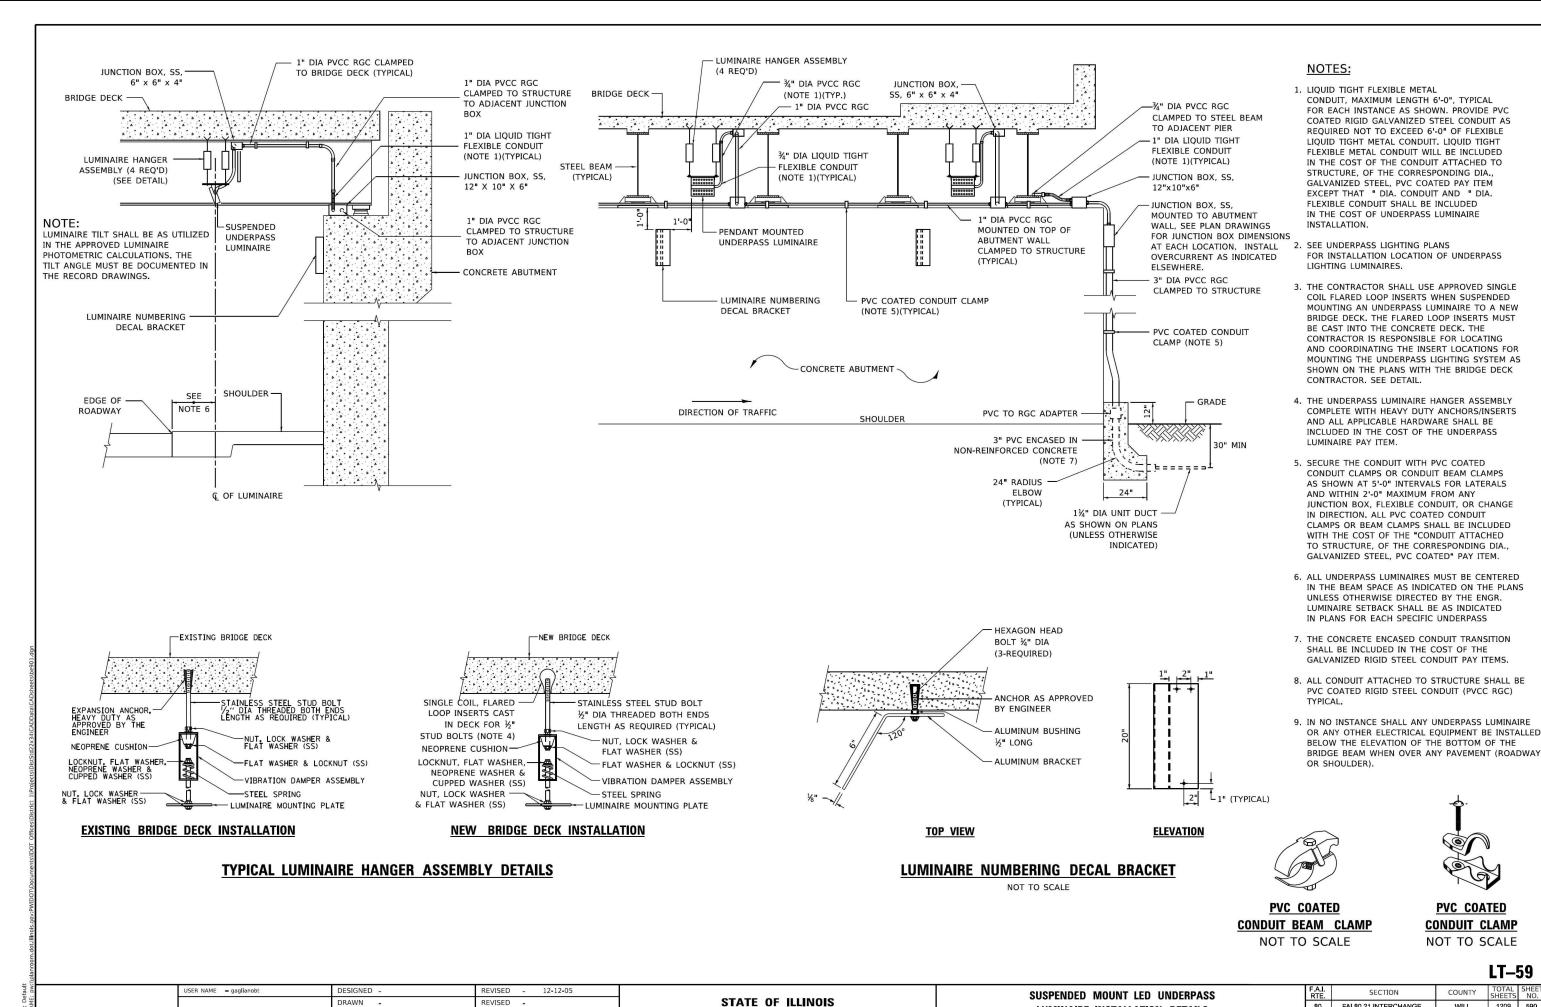

**DEPARTMENT OF TRANSPORTATION** 

CHECKED

DATE

PLOT SCALE = 100.0000 ' / in.

REVISED

REVISED

LT-59 1209 590

WILL

CONTRACT NO. 62R22

80 FAI 80 21 INTERCHANGE

BE-901

**LUMINAIRE INSTALLATION DETAILS** 

TO STA.

SHEET 1 OF 1 SHEETS STA.

SCALE: NONE


## TRAFFIC SIGNAL LEGEND

(NOT TO SCALE)


<u>ITEM</u>	EXISTING	PROPOSED	<u>ITEM</u>	EXISTING	PROPOSED	ITEM	<u>EXISTING</u>	PROPOSED
CONTROLLER CABINET			HANDHOLE -SQUARE			SIGNAL HEAD -(P) PROGRAMMABLE SIGNAL HEAD	R	R R Y
COMMUNICATION CABINET	ECC	CC	-ROUND				R > 0 + 0 + 0 + 0 + 0 + 0 + 0 + 0 + 0 + 0	G G 4Y 4Y 4G
MASTER CONTROLLER	EMC	MC	HEAVY DUTY HANDHOLE -SQUARE -ROUND		H H		P P	G G 4Y 4Y 4G P
MASTER MASTER CONTROLLER	EMMC	ммс	DOUBLE HANDHOLE			SIGNAL HEAD WITH BACKPLATE	(a) (a) (a)	
UNINTERRUPTABLE POWER SUPPLY	4	<b>9</b>	JUNCTION BOX		•	-(P) PROGRAMMABLE SIGNAL HEAD -(RB) RETROREFLECTIVE BACKPLATE		Y Y Y
SERVICE INSTALLATION -(P) POLE MOUNTED	- <u>-</u> -	- <b>-</b> P	RAILROAD CANTILEVER MAST ARM	$X \circ \overline{X} \longrightarrow X$	XXXX			4Y 4G 4G 4G 4G
SERVICE INSTALLATION			RAILROAD FLASHING SIGNAL	$X \rightarrow X$	X•X		P RB	P RB
-(G) GROUND MOUNTED -(GM) GROUND MOUNTED METERED	$\boxtimes^G \boxtimes^{GM}$	<b>⊠</b> <sup>G</sup> <b>⊠</b> <sup>GM</sup>	RAILROAD CROSSING GATE	<del>202</del> >	X•X	PEDESTRIAN SIGNAL HEAD	<b>(</b>	•
TELEPHONE CONNECTION	ET	Т	RAILROAD CROSSBUCK	否	*	AT RAILROAD INTERSECTIONS	K	*
STEEL MAST ARM ASSEMBLY AND POLE	O	•——	RAILROAD CONTROLLER CABINET		<b>▶</b> ∢	PEDESTRIAN SIGNAL HEAD WITH COUNTDOWN TIMER	© C	<b>₽</b> C
ALUMINUM MAST ARM ASSEMBLY AND POLE	0		UNDERGROUND CONDUIT (UC), GALVANIZED STEEL			WITH COUNTDOWN TIMEN		
STEEL COMBINATION MAST ARM ASSEMBLY AND POLE WITH LUMINAIRE	o-¤—	•*	TEMPORARY SPAN WIRE, TETHER WIRE, AND CABLE			ILLUMINATED SIGN "NO LEFT TURN"/"NO RIGHT TURN"		
SIGNAL POST -(BM) BARREL MOUNTED - TEMPORARY	0	● BM	SYSTEM ITEM	S	SP	NUMBER OF CONDUCTORS, ELECTRIC CABLE NO. 14, UNLESS NOTED OTHERWISE, ALL DETECTOR LOOP CABLE TO BE SHIELDED		
WOOD POLE	$\otimes$	•	INTERSECTION ITEM  REMOVE ITEM	1	IP B	GROUND CABLE IN CONDUIT,	1#6	1#6
GUY WIRE	>-	>-	RELOCATE ITEM		RL	NO. 6 SOLID COPPER (GREEN)	1#6	
SIGNAL HEAD	>		ABANDON ITEM		A	ELECTRIC CABLE IN CONDUIT, TRACER NO. 14 1/C		
SIGNAL HEAD WITH BACKPLATE	#>	+-	CONTROLLER CABINET AND		RCF	COAXIAL CABLE	— <u>c</u> —	—c—
SIGNAL HEAD OPTICALLY PROGRAMMED	$\rightarrow$ $\stackrel{P}{\rightarrow}$ $\stackrel{P}{\rightarrow}$	→ P + → P	FOUNDATION TO BE REMOVED		Kei	VENDOR CABLE		
FLASHER INSTALLATION -(FS) SOLAR POWERED	or or FS	•► FS	MAST ARM POLE AND FOUNDATION TO BE REMOVED		RMF			V
-(13) SOLAN POWENED	or⊳ to to to	FF FS FS	SIGNAL POST AND FOUNDATION TO BE REMOVED		RPF	COPPER INTERCONNECT CABLE, NO. 18, 3 PAIR TWISTED, SHIELDED	<del>(6#18)</del>	<u></u>
PEDESTRIAN SIGNAL HEAD	-0	-1	DETECTOR LOOP, TYPE I			FIBER OPTIC CABLE -NO. 62.5/125, MM12F		——————————————————————————————————————
PEDESTRIAN PUSH BUTTON -(APS) ACCESSIBLE PEDESTRIAN PUSH BUTTON			PREFORMED DETECTOR LOOP	PP	P	-NO. 62.5/125, MM12F SM12F -NO. 62.5/125, MM12F SM24F		
RADAR DETECTION SENSOR	R	R	SAMPLING (SYSTEM) DETECTOR	S	S S			—(36F)—
VIDEO DETECTION CAMERA	V	V	INTERSECTION AND SAMPLING (SYSTEM) DETECTOR	IS (IS)	IS (IS)			
RADAR/VIDEO DETECTION ZONE			QUEUE AND SAMPLING	os os	QS QS	GROUND ROD -(C) CONTROLLER -(M) MAST ARM	<u>≐</u> C <u>≐</u> M <u>÷</u> P <u>÷</u> S	$\stackrel{\dot{=}}{\overset{C}{}}$ $\stackrel{\dot{=}}{\overset{M}{}}$ $\stackrel{\dot{=}}{\overset{P}{}}$
PAN, TILT, ZOOM (PTZ) CAMERA	PTZ	PTZ	(SYSTEM) DETECTOR WIRELESS DETECTOR SENSOR	<u> </u>	<b>®</b>	-(P) POST -(S) SERVICE		
EMERGENCY VEHICLE LIGHT DETECTOR	$\bowtie$	<b>~</b>	WIRELESS ACCESS POINT					
CONFIMATION BEACON	<b>○</b> —()	<b>⊷</b> (	WAREELSS AGGESS TOWN		_			
WIRELESS INTERCONNECT	<b>⊶+</b>   }	• <del>••   </del>						
WIRELESS INTERCONNECT RADIO REPEATER	ERR	RR						
WIRELESS INTERCONNECT RADIO REPEATER	ERR	nn n						
USER NAME = footemj	DESIGNED -					DISTRICT ONE	F.A. SECTION	ON COUNTY TOTAL SHEETS I
PLOT SCALE = 50.0000 ' / i	DRAWN - CHECKED -			STATE OF ILLINOIS MENT OF TRANSPORTATION	STAI	NDARD TRAFFIC SIGNAL DESIGN DETAILS	80 FAI 80 21 INTER	
PLOT DATE = 3/4/2019		9/29/2016 REVISED -		or inductionality	SCALE: NONE SH	HEET 1 OF 7 SHEETS STA. TO STA.	TS-05	LINOIS FED. AID PROJECT

- 2. THE NUMBER OF LOOP TURNS SHALL BE AS RECOMMENDED BY THE AMPLIFIER MANUFACTURER. ALL ADJACENT SIDES OF THE LOOPS SHALL BE INSTALLED IN SUCH A WAY THAT THE CURRENT FLOW IS IN THE SAME DIRECTION TO REINFORCE ITS MAGNETIC FIELDS FOR SMALL VEHICLE DETECTION.
- 3. EACH LOOP LEAD-IN SHALL BE IDENTIFIED AND PERMANENTLY TAGGED IN THE HANDHOLE. EACH LEAD-IN CABLE TAG SHALL INDICATE THE LOCATION OF THE LOOP, LOOP ROTATION (CLOCKWISE/COUNTERCLOCKWISE), LOOP LEAD-IN DIRECTION (IN OR OUT), LOOP CABLE NUMBER AND LOCATION IN CABINET, AND NUMBER OF TURNS IN THE DETECTOR LOOPS IN WATER PROOF INK AS INDICATED ON THE DISTRICT 1 STANDARD TRAFFIC SIGNAL DESIGN DETAIL, THE CONTRACTOR SHALL MARK LOOP LOCATIONS ON RECORD DRAWINGS AND PRESENT TO THE ENGINEER AFTER FINAL INSPECTION. LOOPS SHALL BE MARKED BY LANE AND LOOP NUMBER. SEE DETAIL BELOW.
- 4. ALL LOOP CABLE SHALL BE FASTENED WITH PLASTIC TIE WRAP TO THE HANDHOLE HOOKS.
- 5. IN ASPHALT PAVEMENT, LOOPS SHOULD BE PLACED IN THE BINDER AND DIVEHOLES MARKED AT THE CURB WITH A SAW-CUT. THE SAW-CUT SHALL BE CUT IN ACCORDANCE WITH LOCAL AND E,P,A, DUST CONTROL REQUIREMENTS, DETECTOR LOOP(S) SHALL NOT BE INSTALLED IN WET CONDITIONS AND THE SAW-CUTS MUST BE FREE OF DEBRIS AND RESIDUE SUCH AS DUST AND WATER WHICH IS TO BE ACHIEVED BY THE USE OF COMPRESSED AIR, WIRE BRUSHING AND HEAT DRYING ACCORDING TO SEALANT MANUFACTURER REQUIREMENTS. THE DETECTOR WIRE SHALL BE HELD IN PLACE BY THE USE OF FORM WEDGES. WEDGES SHALL BE SPACED NO MORE THAN 18" (450 mm) APART.
- 6. LOOP SPLICES SHALL BE SOLDERED USING A SOLDERING IRON. BLOW TORCHES OR OTHER DEVICES WHICH OXIDIZE COPPER CABLE SHALL NOT BE ALLOWED FOR SOLDERING OPERATIONS. SEE DETAIL BELOW RIGHT.
- 7. PREFORMED DETECTOR LOOPS SHALL BE USED, AS SHOWN ON THE PLANS, WHERE NEW CONCRETE PAVEMENT IS PROPOSED, THE INSTALLATION OF PREFORMED LOOPS SHALL BE IN ACCORDANCE WITH THE DISTRICT 1 SPECIFICATIONS OR AS DIRECTED BY THE ENGINEER.

#### LOOP LEAD-IN CABLE TAG

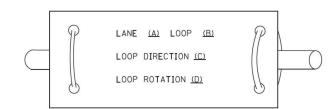



- A. LANE 1 IS THE LANE CLOSEST TO THE CENTERLINE OF THE ROADWAY
- B. LOOP #1 IS THE LOOP IN THE LANE CLOSEST TO THE INTERSECTION
- C. LABEL LOOP CABLE "IN" OR LOOP CABLE "OUT".
- D. LABEL LOOP CABLE CLOCKWISE OR LOOP CABLE COUNTERCLOCKWISE.

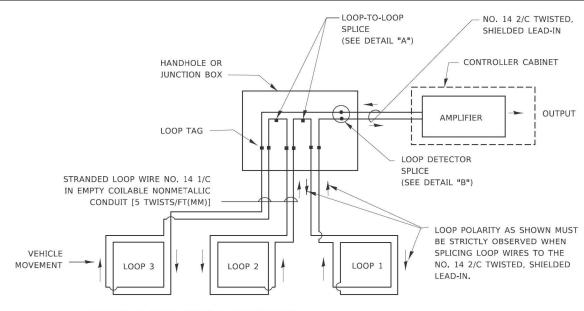

#### **DETECTOR LOOP WIRING SCHEMATIC**

- LOOPS SHALL BE SPLICED IN SERIES. SAW-CUTS SHALL BE A MINIMUM WIDTH OF 5/16" (8 mm).
- SAW-CUT DEPTHS SHALL BE 3" (75 mm). IF IN CONCRETE,
- THE SAW-CUT DEPTH SHALL BE TO THE TOP OF THE REINFORCEMENT.
- LOOP CORNERS SHALL BE DRILLED WITH A 2" (50 mm) DIAMETER CORE.

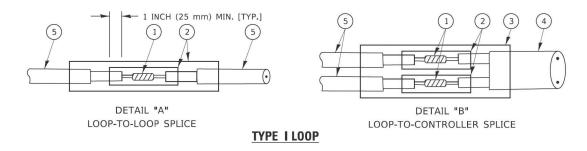

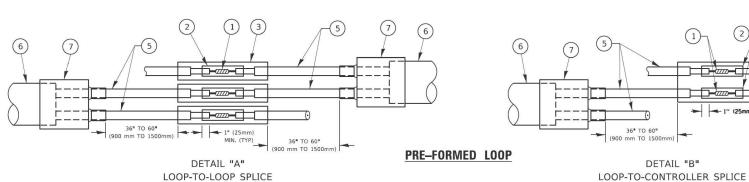

#### LOOP DETECTOR SPLICE

- 1) WESTERN UNION SPLICE SOLDERED WITH ROSIN CORE FLUX. ALL EXPOSED SURFACES OF THE SOLDER SHALL BE SMOOTH, THE WESTERN UNION SPLICES SHALL BE STAGGERED.
- (2) WCSMW 30/100 HEAT SHRINK TUBE, MINIMUM LENGTH 3" (75 mm), UNDERWATER GRADE
- (3) WCS 200/750 HEAT SHRINK TUBE, MINIMUM LENGHT 6" (150 mm), UNDERWATER GRADE.
- (4) NO. 14 2/C TWISTED, SHIELDED CABLE.

- 5 LOOP CONDUCTOR WITH FLEXIBLE PLASTIC TUBE. PRE-FORMED LOOP
- (6) XL POLYOLEFIN 2 CONDUCTOR
- (7) BREAKOUT SEALS. TYCO CBR-2 OR APPROVED EQUAL

JSER NAME = footemi DESIGNED REVISED DRAWN REVISED -CHECKED REVISED PLOT SCALE = 50.0000 ' / in. REVISED

STATE OF ILLINOIS **DEPARTMENT OF TRANSPORTATION** 

DISTRICT ONE STANDARD TRAFFIC SIGNAL DESIGN DETAILS SHEET 2 OF 7 SHEETS STA.

FAI 80 21 INTERCHANGE WILL 1209 592 CONTRACT NO.62R22 TS-05


1" (25mm) MIN. (TYP)

## ന 8 SHT S

#### TRAFFIC SIGNAL MAST ARM AND SIGNAL POST


MAST ARM MOUNTED SIGNALS IN EXISTING, PROPOSED OR FUTURE SIDEWALK/BICYCLE PATH AREA. INTERSECTION SHOWN WITH PEDESTRIAN SIGNALS AND

PEDESTRIAN PUSHBUTTON DETECTORS.

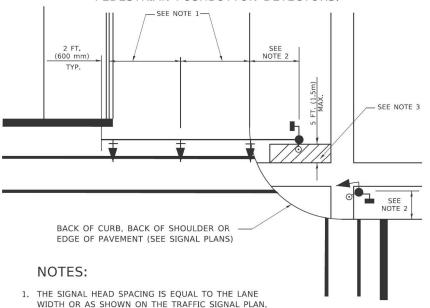


- 2. REFER TO THE TRAFFIC SIGNAL EQUIPMENT OFFSET TABLE.
- 3. PROVIDE A LEVEL ALL-WEATHER SURFACE (CONCRETE SIDEWALK, ASPHALT BICYCLE PATH SURFACE OR MATCHING MATERIAL TO THE ADJACENT SURFACE) UP TO THE MAST ARM SHAFT OR THE SIGNAL POST.
- 4. THE FACE OF THE PEDESTRIAN PUSHBUTTON SHALL BE PARALLEL TO THE CROSSWALK TO BE USED.
- 5. THE LOCATIONS AND INSTALLATION OF PEDESTRIAN SIGNAL HEADS AND PEDESTRIAN PUSHBUTTONS SHALL MEET THE REQUIREMENTS OF THE MUTCD AND INFORMATION FOUND IN THE "AMERICANS WITH DISABILITIES ACT ACCESSIBILITY GUIDELINES FOR BUILDINGS AND FACILITIES."

### PEDESTRIAN SIGNAL POST PEDESTRIAN PUSH BUTTON POST

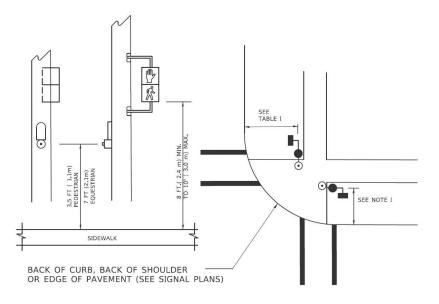

#### NOTES:

- 1. REFER TO THE TRAFFIC SIGNAL EQUIPMENT OFFSET TABLE.
- 2. PROVIDE A LEVEL ALL-WEATHER SURFACE (CONCRETE SIDEWALK, ASPHALT BICYCLE PATH SURFACE OR MATCHING MATERIAL TO THE ADJACENT SURFACE) UP TO THE PEDESTRIAN SIGNAL POST OR THE PEDESTRIAN PUSH BUTTON POST.
- 3. THE FACE OF THE PEDESTRIAN PUSHBUTTON SHALL BE PARALLEL TO THE CROSSWALK TO BE USED.
- 4. THE LOCATIONS AND INSTALLATION OF PEDESTRIAN SIGNAL HEADS AND PEDESTRIAN PUSHBUTTONS SHALL MEET THE REQUIREMENTS OF THE MUTCD AND INFORMATION FOUND IN THE "AMERICANS WITH DISABILITIES ACT ACCESSIBILITY GUIDELINES FOR BUILDINGS AND FACILITIES."

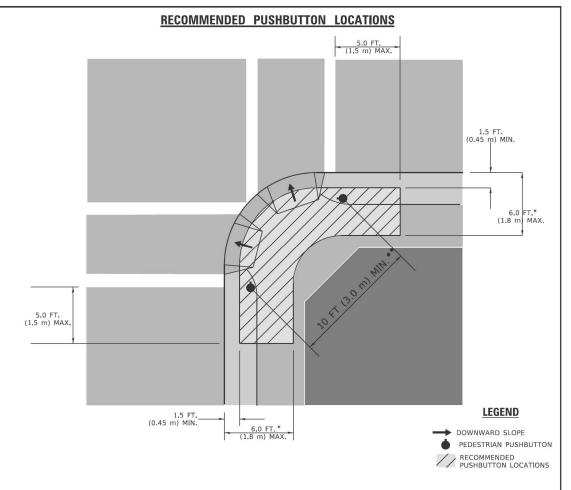

- \* WHERE THERE ARE CONSTRAINTS THAT MAKE IT IMPRACTICAL TO PLACE THE PEDESTRIAN PUSHBUTTON BETWEEN 1.5 FT (0.45 m) AND 6 FT ( 1.8 m) FROM THE EDGE OF THE CURB, SHOULDER, OR PAVEMENT, IT SHOULD NOT BE FURTHER THAN 10 FT (3 m) FROM THE EDGE OF CURB, SHOULDER, OR PAVEMENT,
- \*\* WHERE THERE ARE CONSTRAINTS ON A PARTICULAR CORNER THAT MAKE IT IMPRACTICAL TO PROVIDE THE 10 FT (3 m) SEPERATION BETWEEN THE TWO PEDESTRIAN PUSHBUTTONS, THE PUSHBUTTONS MAY BE PLACED CLOSER TOGETHER OR ON THE SAME POLE.

#### NOTES:

- 1. PEDESTRIAN SIGNAL HEADS SHALL BE MOUNTED WITH THE BOTTOM OF THE SIGNAL HOUSING INCLUDING BRACKETS NOT LESS THAN 8 FT (2.4 m) OR MORE THAN 10 FT (3 m) ABOVE SIDEWALK LEVEL, AND SHALL BE POSITIONED AND ADJUSTED TO PROVIDE MAXIMUM VISIBILITY AT THE BEGINNING OF THE CONTROLLED CROSSWALK.
- 2. THE BOTTOM OF THE SIGNAL HOUSING (INCLUDING BRACKETS) OF A VEHICULAR SIGNAL FACE THAT IS NOT LOCATED OVER A HIGHWAY SHALL BE AT LEAST 8 FT (2.4 m) BUT NOT MORE THAN 19 FT (5.8 m) ABOVE THE SIDEWALK OR, IF THERE IS NO SIDEWALK, ABOVE THE PAVEMENT GRADE AT THE CENTER OF THE ROADWAY.
- 3. THE BOTTOM OF THE SIGNAL HOUSING AND ANY RELATED ATTACHMENTS TO A SIGNAL FACE LOCATED OVER ANY PORTION OF A HIGHWAY SHALL BE ACCORDING TO CURRENT STATE STANDARDS 877001, 877002, 877006, 877011 AND 877012 WITH A MINIMUM OF 16 FT (5.0 m) AND A MAXIMUM OF 18 FT. (5.5 m) FROM THE HIGHEST POINT OF PAVEMENT.
- 4. THE BOTTOM OF THE TEMPORARY SPAN WIRE MOUNTED SIGNAL HOUSING AND ANY RELATED ATTACHMENTS TO A SIGNAL FACE LOCATED OVER ANY PORTION OF A HIGHWAY SHALL BE ACCORDING TO CURRENT STATE STANDARD 880001 WITH A MINIMUM OF 17 FT (5.18 m) FROM THE HIGHEST POINT OF PAVEMENT.
- THE TOP OF THE SIGNAL HOUSING OF A SIGNAL FACE LOCATED OVER ANY PORTION OF A HIGHWAY SHALL NOT BE MORE THAN 25.6 FT (7.8 m) ABOVE THE PAVEMENT.

#### TRAFFIC SIGNAL EQUIPMENT OFFSET

	The state of the s			
TRAFFIC SIGNAL EQUIPMENT	COMBINATION CONCRETE CURB AND GUTTER (MINIMUM DISTANCE FROM BACK OF CURB TO CENTERLINE OF FOUNDATION)	SHOULDER/NON-CURBED AREA (MINIMUM DISTANCE FROM EDGE OF PAVEMENT TO CENTERLINE OF FOUNDATION)		
TRAFFIC SIGNAL MAST ARM POLE	6 FT (1.8m)	SHOULDER WIDTH + 2 FT (0.6m), MINIMUM 10 FT (3.0m)		
TRAFFIC SIGNAL POST	4 FT (1.2m)	SHOULDER WIDTH + 2 FT (0.6m), MINIMUM 10 FT (3.0m)		
PEDESTRIAN SIGNAL POST	4 FT (1.2m)	SHOULDER WIDTH + 2 FT (0.6m), MINIMUM 10 FT (3.0m)		
PEDESTRIAN PUSHBUTTON POST	4 FT (1.2m)	SHOULDER WIDTH + 2 FT (0.6m), MINIMUM 10 FT (3.0m)		
TEMPORARY WOOD POLE	6 FT (1.8m)	SHOULDER WIDTH + 2 FT (0.6m), MINIMUM 10 FT (3.0m)		
CONTROLLER CABINET	6 FT (1.8m) MINIMUM DISTANCE SEE NOTE 2	SHOULDER WIDTH + 6 FT (1.8m), MINIMUM 16 FT (4.9m) SEE NOTE 3.		
SERVICE INSTALLATION, GROUND MOUNT	6 FT (1.8m) MINIMUM DISTANCE SEE NOTE 2	SHOULDER WIDTH + 6 FT (1.8m), MINIMUM 16 FT (4.9m) SEE NOTE 3.		

#### NOTES:

- 1. CONTACT THE "AREA TRAFFIC SIGNAL MAINTENANCE AND OPERATIONS ENGINEER" FOR ASSISTANCE IN LOCATING THE TRAFFIC SIGNAL EQUIPMENT WHEN THERE ARE CONFLICTS WITH DITCHES OR THE MINIMUM OFFSET DISTANCES CANNOT BE MET.
- 2. MINIMUM DISTANCE FROM THE BACK OF CURB TO THE ROADWAY SIDE OF THE FOUNDATION.
- 3. MINIMUM DISTANCE FROM THE EDGE OF PAVEMENT TOTHE ROADWAY SIDE OF THE FOUNDATION.
- 4. ANY CHANGES TO THE OFFSETS OF THE FOUNDATIONS, FROM THE MINIMUM DISTANCES LISTED IN THE "TRAFFIC SIGNAL EQUIPMENT OFFSET" CHART AND THE TRAFFIC SIGNAL INSTALLATION PLAN, COULD EFFECT THE PLACEMENT OF THE SIGNAL HEADS, PEDESTRIAN SIGNAL HEADS AND THE PEDESTRIAN PUSHBUTTONS. THE SIGNAL HEAD PLACEMENT ON THE MAST ARMS SHALL REMAIN AS PER THE TRAFFIC SIGNAL INSTALLATION PLAN AND THE "TRAFFIC SIGNAL MAST ARM AND SIGNAL POST" DETAIL ABOVE. THE PROPOSED MAST ARM LENGTHS MAY NEED TO BE REVISED TO MEET THE ABOVE REQUIREMENTS. THE PEDESTRIAN SIGNAL HEADS AND PEDESTRIAN PUSHBUTTONS MUST MEET THE REQUIREMENTS UNDER THE DETAILS ON THIS SHEET.

SCALE: NONE

USER NAME = footemj	DESIGNED -	REVISED -	
	DRAWN -	REVISED -	
PLOT SCALE = 50.0000 ' / in.	CHECKED -	REVISED -	
PLOT DATE = 3/4/2019	DATE -	REVISED -	

STATE OF ILLINOIS **DEPARTMENT OF TRANSPORTATION** 

SECTION DISTRICT ONE FAI 80 21 INTERCHANGE WILL 1209 593 STANDARD TRAFFIC SIGNAL DESIGN DETAILS CONTRACT NO.62R22 TS-05 SHEET 3 OF 7 SHEETS STA.

**DEPARTMENT OF TRANSPORTATION** 

CONTRACT NO.62R22

TS-05

SHEET 4 OF 7 SHEETS STA.


SH


S

CHECKED

PLOT SCALE = 50.0000 ' / in.

REVISED

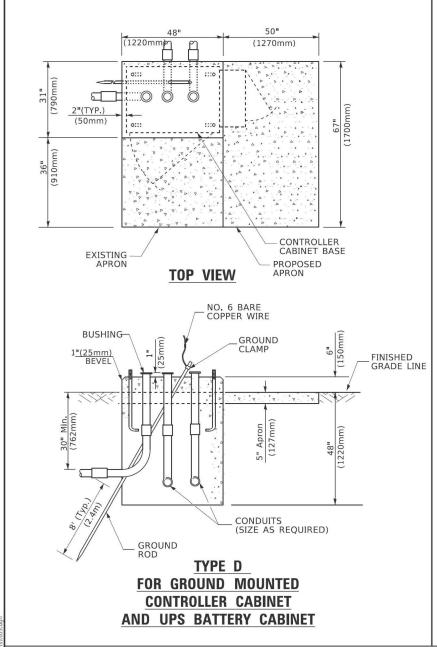

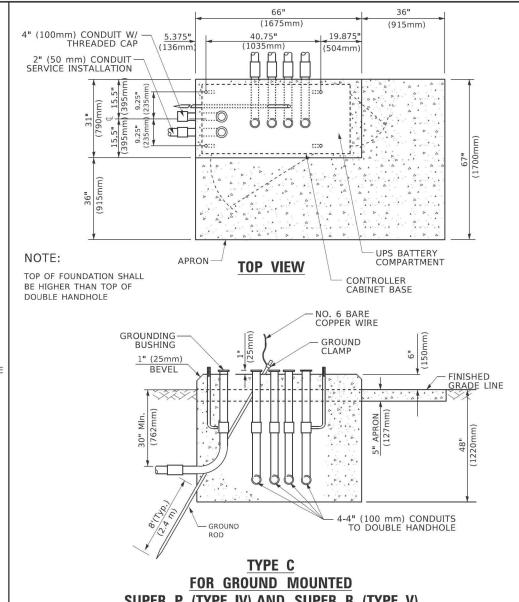

SUPER P (TYPE IV) AND SUPER R (TYPE V) **CONTROLLER CABINETS** 

65" (SEE NOTE 4) (1651mm)	
SEE NOTE 5- 49" (SEE NOTE 3)	
(1245mm)	
~\\\\\\\\\\\\\\\\\\\\\\\\\\\\\\\\\\\\\	
TE OE    1"    2017       //	
8 99 A 2311111)	
2" x 6" (51mm x 152mm WOOD FRAMING (TYP.	)
WOOD FRAMING (TYP.	)
TRAFFIC SIGNAL —>     '	
CONTROLLER CABINET	
UPS CABINET	
¾" (19mm) TREATED PHYWOOD DECK	
2" x 6" (51mm x 152mm) TREATED WOOD	
- <del> </del>   <del>                                </del>	
MIN HIS	
305mm) 305mm)	
<u>NIN.</u>	
48# MIN.	
4 5 1 1 1 1	
6" x 6" (152mm x 152mm)  NOTES: TREATED WOOD POSTS	
I. BASED ON CONTROLLER CABINET TYPE IV WITH BASE DIMENSIONS OF 26" x 44" (660mm x 1118mm).	

- I. BASED ON CONTROLLER CABINET TYPE IV WITH BASE DIMENSIONS OF 26"  $\times$  44" (660mm  $\times$  1118mm). ADJUST PLATFORM SIZE TO FIT CABINET BASE DIMENSIONS BEING SUPPLIED
- 2. BASED ON UNINTERRUPTIBLE POWER SUPPLY CABINET WITH BASE DIMENSIONS OF 16"  $\times$  25" (406mm  $\times$  635mm), ADJUST PLATFORM SIZE TO FIT CABINET BASE DIMENSIONS BEING SUPPLIED.
- $\ensuremath{\mathfrak{Z}_{\bullet}}$  PLATFORM SIZE FOR CONTROLLER CABINET TYPE IV.
- 4. PLATFORM SIZE FOR CONTROLLER CABINET TYPE IV AND UNINTERRUPTIBLE POWER SUPPLY CABINET.
- 5. DRILLED HOLES THROUGH THE PLATFORM BASE TO MATCH THE CONTROLLER CABINET BOLT TEMPLATE. FASTEN THE CONTROLLER CABINET TO THE PLATFORM WITH CARRIAGE BOLTS, WASHERS AND NUTS,
- 6. FASTEN ALL SUPPORT WOOD FRAMING TO THE WOOD POSTS WITH 2 LAG SCREWS FOR EACH CONNECTION.

#### TEMPORARY SIGNAL CONTROLLER WOOD SUPPORT PLATFORM

CABLE SLACK LENGTH	FEET	METER
HANDHOLE	6.5	2.0
DOUBLE HANDHOLE	13.0	4.0
SIGNAL POST	2.0	0.6
MAST ARM	2.0	0.6
CONTROLLER CABINET	1.5	0.5
FIBER OPTIC AT CABINET	13.0	4.0
ELECTRIC SERVICE AT (CABINET OR SERVICE LOCATION)	1.5	0.5
GROUND CABLE (SIGNAL POST, MAST ARM, CABINET)	1.5	0.5
GROUND CABLE (BETWEEN FRAME AND COVER)	5.0	1.6

VERTICAL CABLE LENGTH	FEET	METER
MAST ARM POLE ( MAST ARM MOUNTED SIGNAL HEAD)		
(L = MAST ARM LENGTH - DISTANCE TO SIGNAL HEAD FROM END OF ARM)	20.0+L	6.0+L
BRACKET MOUNTED (MAST ARM POLE OR SIGNAL POLE)	13.0	4.0
PEDESTRIAN PUSH BUTTON	6.0	2.0
SERVICE INSTALLATION POLE MOUNT TO SERVICE DROP	13.5	4.1
SERVICE INSTALLATION POLE MOUNT TO GROUND	13.5	4.1
SERVICE INSTALLATION GROUND MOUNT	6.0	2.0
FOUNDATION (SIGNAL POST, MAST ARM POLE, CONTROLLER CABINET, SERVICE-GROUND MOUNT)	3.0	1.0

#### **VERTICAL CABLE LENGTH**

**CABLE SLACK** 

FOUNDATION	DEPTH
TYPE A - Signal Post	4'-0" (1.2m)
TYPE C - CONTROLLER W/ UPS	4'-0" (1.2m)
TYPE D - CONTROLLER	4'-0" (1.2m)
SERVICE INSTALLATION, GROUND MOUNT, TYPE A - SQUARE	4'-0" (1.2m)

#### **DEPTH OF FOUNDATION**


<ol> <li>Foundation</li> <li>Depth</li> </ol>	Foundation Diameter	Spiral Diameter	Quantity of Rebars	Size of Rebars
10'-0" (3 <sub>-</sub> 0 m)	30" (750mm)	24" (600mm)	8	6(19)
13'-6" (4 <sub>4</sub> 1 m)	30" (750mm)	24" (600mm)	8	6(19)
11'-0'' (3 <sub>4</sub> m)	36" (900mm)	30" (750mm)	12	7(22)
13'-0'' (4 <sub>e</sub> 0 m)	36" (900mm)	30" (750mm)	12	7(22)
15'-0'' (4,6 m)	36" (900mm)	30" (750mm)	12	7(22)
21'-0'' (6.4 m)	42'' (1060mm)	36" (900mm)	16	8(25)
25'-0" (7 <sub>•</sub> 6 m)	42" (1060mm)	36" (900mm)	16	8(25)
	Depth 10'-0" (3.0 m) 13'-6" (4.1 m) 11'-0" (3.4 m) 13'-0" (4.0 m) 15'-0" (4.6 m) 21'-0" (6.4 m)	Depth Diameter  10'-0" (3.0 m) 30" (750mm)  13'-6" (4.1 m) 30" (750mm)  11'-0" (3.4 m) 36" (900mm)  13'-0" (4.0 m) 36" (900mm)  15'-0" (4.6 m) 36" (900mm)  21'-0" (6.4 m) 42" (1060mm)	Depth         Diameter         Diameter           10'-0" (3.0 m)         30" (750mm)         24" (600mm)           13'-6" (4.1 m)         30" (750mm)         24" (600mm)           11'-0" (3.4 m)         36" (900mm)         30" (750mm)           13'-0" (4.0 m)         36" (900mm)         30" (750mm)           15'-0" (4.6 m)         36" (900mm)         30" (750mm)           21'-0" (6.4 m)         42" (1060mm)         36" (900mm)	Depth         Diameter         Diameter         Rebars           10'-0" (3.0 m)         30" (750mm)         24" (600mm)         8           13'-6" (4.1 m)         30" (750mm)         24" (600mm)         8           11'-0" (3.4 m)         36" (900mm)         30" (750mm)         12           13'-0" (4.0 m)         36" (900mm)         30" (750mm)         12           15'-0" (4.6 m)         36" (900mm)         30" (750mm)         12           21'-0" (6.4 m)         42" (1060mm)         36" (900mm)         16

#### NOTES:

- 1. These foundation depths are for sites which have cohesive soils (clayey silt, sandy clay, etc.) along the length of the shaft, with an average Unconfined Compressive Strength (0u) > 1.0 tsf (100 kpa). This strength shall be verified by boring data prior to construction or with testing by the Engineer during foundation drilling. The Bureau of Bridges & structures should be contacted for a revised design if other conditions are encountered.
- 2. Combination most arm assemblies under 55 feet (16.8 m) shall use 36" (900 mm) diameter foundations.
- 3. Combination mast arm assemblies under 56 feet (16.8 m) through 75 feet (22.9 m) shall use 42" (1060 mm) diameter foundations
- 4. For mast arm assemblies with dual arms refer to state standard 878001...

#### DEPTH OF MAST ARM FOUNDATIONS, TYPE E


USER NAME = footemj	DESIGNED -	REVISED -		DISTRICT ONE STANDARD TRAFFIC SIGNAL DESIGN DETAILS		SECTION	COUNTY	TOTAL SHEET
	DRAWN -	REVISED -	STATE OF ILLINOIS			FAI 80 21 INTERCHANGE	WILL	1209 595
PLOT SCALE = 50.0000 ' / in.	CHECKED -	REVISED -	DEPARTMENT OF TRANSPORTATION			TS-05	CONTRACT	NO.62R22
PLOT DATE = 3/4/2019	DATE -	REVISED -		SCALE: NONE SHEET 5 OF 7 SHEETS STA. TO STA.		ILLINOIS FE	D. AID PROJECT	

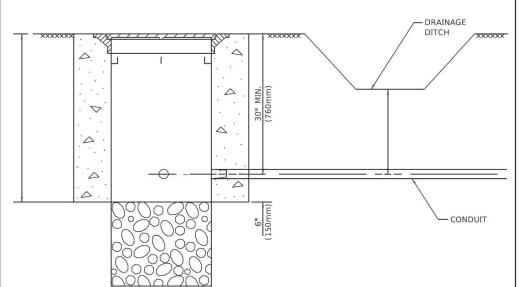

#### NOTES:


- CONDUIT DEPTH SHALL BE A MINIMUM OF 30" (760mm) BELOW THE BOTTOM OF THE DRAINAGE DITCH OR ANY SLOPING GROUND
- THE MINIMUM CONDUIT DEPTH APPLIES TO ALL CONDUIT PLACED UNDER ROADWAY PAVEMENT, MULTI-USE PATHS, SIDEWALKS AND SOIL SURFACES.
- 3. THE MINIMUM CONDUIT DEPTH APPLIES TO ALL HANDHOLES, HEAVY DUTY HANDHOLES AND DOUBLE HANDHOLES.

## HANDHOLE WITH MINIMUM CONDUIT DEPTH

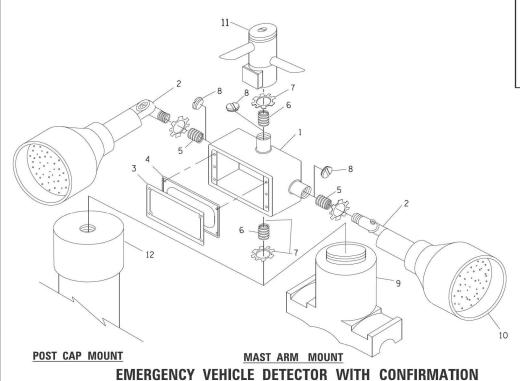

**BEACON MOUNTING DETAIL** 


DESIGNED -

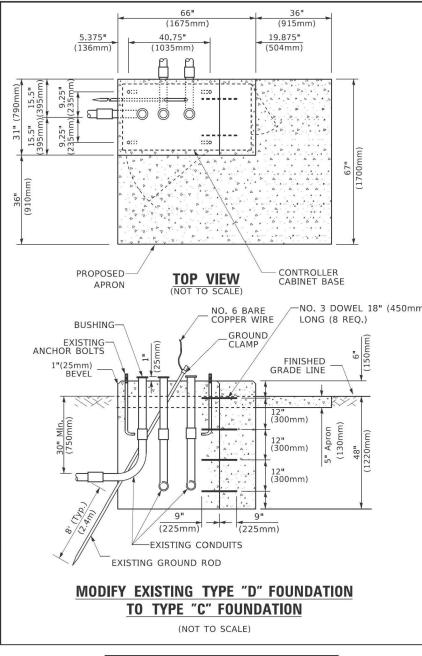

ITEM	NO. IDENTIFICATION
1	OUTLET BOX- GALV. 21 CU.IN. (0.000344 CU-M)
2	LAMP HOLDER AND COVER
3	OUTLET BOX COVER
4	RUBBER COVER GASKET
5	REDUCING BUSHING
6	¾"(19 mm) CLOSE NIPPLE
7	¾"(19 mm) LOCKNUT
8	¾"(19 mm) HOLE PLUG
9	SADDLE BRACKET - GALV.
10	6 WATT PAR 38 LED FLOOD LAMP
11	DETECTOR UNIT
12	POST CAP [18 FT. (5.4 m) POST MIN.]

#### NOTES:

- ALL ELECTRICAL ITEMS, EXCEPT ITEMS #2 AND #11 SHALL BE ALUMINUM OR GALVANIZED
- 2, ITEM #1- OZ/GEDNEY FSX-1-50 OR EQUIVALENT ITEM #2- MULBERRY CON-O-SHADE LAMP SHIELD OR EQUIVALENT ITEM #9- "BAND-IT" SADDLE BRACKET OR EQUIVALENT
- 3. WHEN POST MOUNTING IS SPECIFIED, ITEM #9 SHALL NOT BE REQUIRED. THE DETECTION UNIT SHALL BE MOUNTED DIRECTLY ON TOP OF THE CAP BY DRILLING AND TAPPING A 3/4 "(19 mm) HOLE WITH PIPE THREADS. THE POST CAP SHALL EITHER BE SCREWED TO THE TOP OF THE POST OR A MINIMUM OF 3 TIGHTENING SCREWS SHALL BE REQUIRED ON EACH CAP.

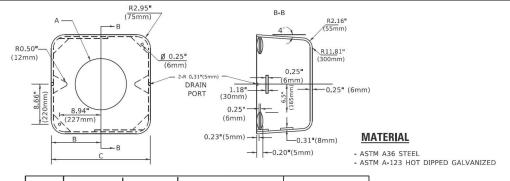



А	В	С	HEIGHT	WEIGHT
VARIES	9.5"(241mm)	19"(483mm)	7" (178mm) - 12" (300mm)	53 lbs (24kg)
VARIES	10.75"(273mm)	21.5"(546mm)	7" (178mm) - 12" (300mm)	68 lbs (31 kg)
VARIES	13,0"(330mm)	26"(660mm)	7" (178mm) - 12" (300mm)	81 lbs (37 kg)
VARIES	18.5"(470mm)	37"(940mm)	7" (178mm) - 12" (300mm)	126 lbs (57 kg)

#### **SHROUD**

#### NOTES:

- DIMENSION "A" IS EQUAL TO THE DIAMETER OF THE MAST ARM POLE AT THE TOP OF THE SHROUD.
  THE SHROUD SHALL BE TIGHT TO THE MAST ARM POLE.
- 2. THE SUPPLIER SHALL VERIFIED THE ABOVE DIMENSIONS BASED ON MAST ARM REQUIREMENTS.
- 3. THE HEIGHT OF THE SHROUD SHALL COVER THE ANCHOR BOLTS, NUTS AND MAST ARM POLE BASE.

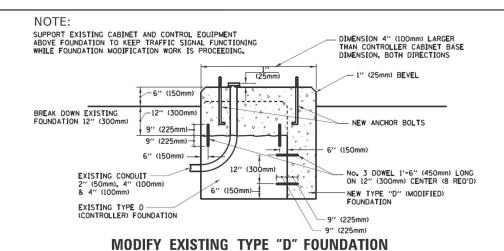

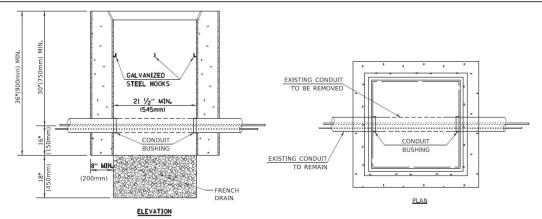

#### NOTES:

SCALE: NONE

- 1. HANDHOLE CONSTRUCTED PER STATE STANDARD 814001.
- 2. REMOVAL OF THE EXISTING CONDUIT FROM THE HANDHOLE AND THE INSTALLATION OF THE CONDUIT BUSHINGS SHALL BE INCLUDED WITH THE COST OF THE HANDHOLE.


#### HANDHOLE TO INTERCEPT EXISTING CONDUIT

		DIST	RICT OF	NE		F.A. RTE.	SECTION	COUNTY	TOTAL SHEETS	SHI
STANDARD TRAFFIC SIGNAL DESIGN DETAILS		80	FAI 80 21 INTERCHANGE	WILL	1209	59				
3	IANDAND	IIIAIIIU	SIGIVA	L DESIGN	DETAILS		TS-05	CONTRACT	NO,62F	₹22
	SHEET 6	OF 7	SHEETS	STA.	TO STA.		ILLINOIS FED. A	ID PROJECT		

DRAWN - REVISED 
PLOT SCALE = 50.0000 ' / in. CHECKED - REVISED 
PLOT DATE = 3/4/2019 DATE - REVISED -

REVISED

STATE OF ILLINOIS
DEPARTMENT OF TRANSPORTATION

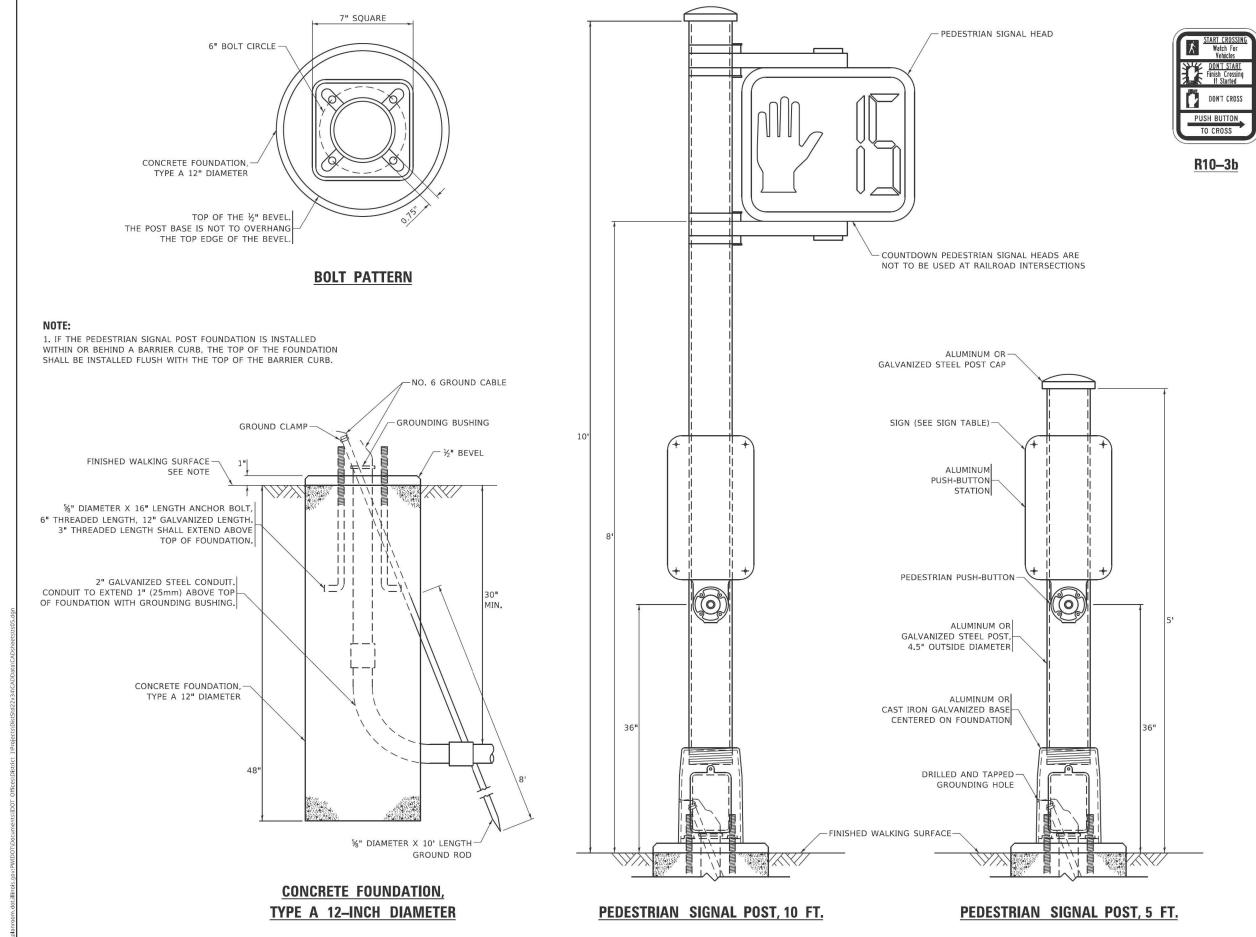

SIGN TABLE

DON'T CROSS

R10-3d

TIME REMAINING

DON'T CROSS

TO CROSS

R10-3e

SIGN	DIMENSIONS
R10-3b (RAILROAD ONLY)	9" X 12"
R10-3d (RAILROAD ONLY)	9" X 12"
R10-3e	9" X 12"

#### NOTE

- 1. THE SIGN PANELS SHALL BE TYPE AP SHEETING. 2. THE ARROW ON SIGNS FOR PUSH-BUTTONS SERVING
- THE ARROW ON SIGNS FOR PUSH-BUTTONS SERVIN TWO DIRECTIONS ON THE SAME PHASE SHALL BE BI-DIRECTIONAL.
- 3. THE SIGN FOR DUAL-CALL PUSH-BUTTONS SHALL HAVE NO ARROW.


USER NAME = gaglianobt	DESIGNED	-	IP	REVISED	=	10-15-2020
	DRAWN	-	IP	REVISED	-	
PLOT SCALE = 100,0000 ' / in.	CHECKED		LP	REVISED	-	
PLOT DATE = 11/23/2020	DATE	-	10-15-2018	REVISED	-	


STATE OF ILLINOIS
DEPARTMENT OF TRANSPORTATION


TS SHT NO.

IODEL: Default

#### SIGN PANEL - TYPE 1 OR TYPE 2

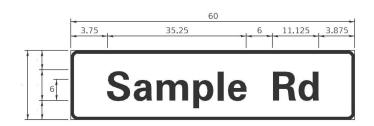

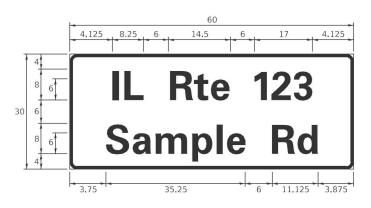

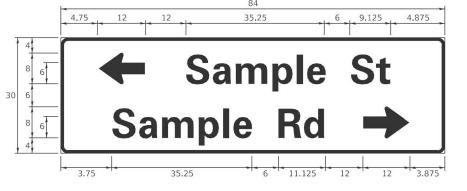

DESIGN	AREA	SIGN PANEL	SHEETING	QTY.
SERIES	(SQ FT)	TYPE	TYPE	REQUIRED
D OR C	-	1 OR 2	ZZ	-

#### **COMMON STREET NAME ABBREVIATIONS AND WIDTHS**

NAME	ABBREVATION	WIDTH (INCH)			
NAME	ABBREVALION	SERIES "C"	SERIES "D"		
AVENUE	Ave	15.000	18.250		
BOULEVARD	Blvd	17.125	20.000		
CIRCLE	Cir	11.125	13.000		
COURT	Ct	8. 250	9.625		
DRIVE	Dr	8.625	10.125		
HIGHWAY	Hwy	18.375	22.000		
ILLINOIS	ΙL	7. 000	8. 250		
LANE	Ln	9. 125	10.750		
PARKWAY	Pkwy	23. 375	27.375		
PLACE	PΙ	7. 125	7. 750		
ROAD	Rd	9.625	11.125		
ROUTE	Rte	12.625	14.500		
STREET	St	8.000	9.125		
TERRACE	Ter	12.625	14.625		
TRAIL	Tr	7. 750	9.125		
UNITED STATES	US	10.375	12.250		

#### **GENERAL NOTES**

- WHERE MAST ARM MOUNTED STREET NAME SIGNS ARE SPECIFIED, THE MAST ARM ASSEMBLY AND POLES SHALL BE DESIGNED TO SUPPORT THE LOADINGS CALLED FOR ON STANDARDS 877001, 877002, 877006, 877011 AND 877012, AS APPLICABLE, PLUS TWO (2) SIGN PANELS 2'-6" x 8'-0" MOUNTED AS SHOWN. THE DESIGN SHALL BE IN ACCORDANCE WITH THE REQUIREMENTS OF THE CURRENT "STANDARD SPECIFICATIONS FOR STRUCTURAL SUPPORTS FOR HIGHWAY SIGNS, LUMINAIRES, AND TRAFFIC SIGNALS" AS PUBLISHED BY THE AMERICAN ASSOCIATION OF STATE HIGHWAY AND TRANSPORTATION OFFICIALS FOR 80 M.P.H. WIND VELOCITY.
- 2. ALL SIGNS SHALL CONSIST OF A WHITE LEGEND AND BORDER (TYPE ZZ SHEETING) ON A GREEN BACKGROUND (TYPE ZZ SHEETING)
- 3. THE SIGN LENGTH SHALL BE IN 6-INCH INCREMENTS, BUT THE OVERALL LENGTH SHALL NOT EXCEED 8'-0". ALL BORDERS IF POSSIBLE, BUT MAY BE REDUCED TO 5" WHEN SPACING IS CRITICAL. A MINIMUM OF 2-1/2" SHALL BE INCLUDED BETWEEN THE WORD AND THE RIGHT AND LEFT EDGES OF THE SIGN.
- 4. A PREFERRED METHOD FOR THE SIGN DESIGN IS TO USE SERIES "D" LETTER ON A ONE-LINE SIGN 18" IN HEIGHT AND A MAXIMUM OF 8'-0" IN WIDTH, IF SERIES "D" DOES NOT FIT ON A 8"-0" SIGN, THEN SERIES "C" SHOULD BE TRIED. IF SERIES "C" DOES NOT FIT ON A 8'-0" SIGN, A 30" HIGH TWO-LINE SIGN CAN BE USED. THE CROSSROAD DESIGNATION AS TO STREET, AVENUE, ETC. SHOULD BE SPELLED OUT ON THE SECOND LINE, IF THE ABBREVIATION CANNOT FIT ON THE FIRST LINE.
- 5. LED ILLUMINATED STREET NAME SIGNS CAN BE USED IN PLACE OF REGULAR SIGN PANELS BUT ANY SPECIAL WORDING AND SYMBOLOGY MUST BE APPROVED BY THE DEPARTMENT. GENERAL DESIGN REQUIREMENT AS LISTED ABOVE (COLOR, FONT, SIZE, ETC.) MUST BE FOLLOWED.
- 6. SIGNFIX ALUMINUM CHANNEL FRAMING SYSTEM SHALL BE USED FOR ALL SIGNS ATTACHED TO SIGNAL POLES AND POSTS,

LOCAL SUPPLIERS: PARTS LISTING:

- J.O. HERBERT COMPANY, INC MIDLOTHIAN, VA

- WESTERN REMAC, INC.

WOODRIDGE, IL

SIGN CHANNEL SIGN SCREWS BRACKETS

PART #HPN053 (MED. CHANNEL) 1/4" x 14 x 1" H.W.H. #3 SELF TAPPING WITH NEOPRENE WASHER


PART #HPN034 (UNIVERSAL)

CHANNEL CLAMPS WITH STAINLESS STEEL STRAPPING


OTHER BRANDS OF MOUNTING HARDWARE ARE ACCEPTABLE, BASED UPON THE DEPARTMENT'S APPROVAL AND COMPATIBILITY WITH THE CHANNEL/BRACKET OF THE ABOVE PRODUCT.

#### **MOUNTING LOCATION**

ARM OR POLE MOUNTED

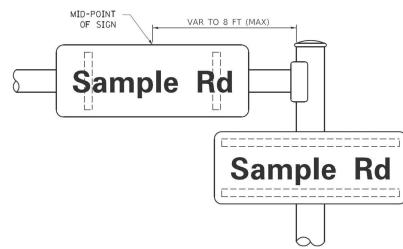

#### **SUPPORTING CHANNELS**

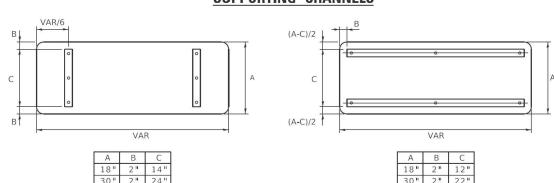

#### STANDARD ALPHABETS SPACING CHART

(8") UPPER CASE AND (6") LOWER CASE

	FHWA SEF	RIES "C"		FHWA SERIES "D"					
CHARACTER	LEFT SPACING (INCH)	WIDTH (INCH)	RIGHT SPACING (INCH)	CHARACTER	LEFT SPACING (INCH)	WIDTH (INCH)	RIGHT SPACING (INCH)		
Α	0.240	5.122	0.240	А	0.240	6.804	0.240		
В	0.880	4.482	0.480	В	0.960	5.446	0.400		
С	0.720	4.482	0.720	С	0.800	5.446	0.800		
D E	0.880 0.880	4.482	0.720 0.480	D E	0.960 0.960	5. 446 4. 962	0.800		
F	0.880	4.082	0.240	F	0.960	4. 962	0.240		
G	0.720	4.482	0.720	G	0.800	5.446	0.800		
H	0.880	4.482	0.880	Н	0.960	5.446	0.960		
I	0.880	1.120	0.880	I	0.960	1.280	0.960		
J	0.240	4.082	0.880	J	0.240	5. 122	0.960		
K	0.880	4.482	0.480	K	0.960	5.604	0.400		
L M	0.880 0.880	4.082 5.284	0.240 0.880	L M	0.960 0.960	4.962 6.244	0.240		
N	0.880	4. 482	0.880	N	0.960	5. 446	0.960		
0	0.720	4.722	0.720	0	0.800	5. 684	0.800		
Р	0.880	4.482	0.720	P	0.960	5.446	0.240		
Q	0.720	4.722	0.720	Q	0.800	5.684	0.800		
R	0.880	4.482	0.480	R	0.960	5.446	0.400		
S T	0.480	4. 482	0.480	S T	0.400	5.446 4.962	0.400		
U	0.240 0.880	4.082	0.240 0.880	U	0. 240	5. 446	0.240		
V	0.240	4. 962	0.240	V	0.240	6. 084	0. 240		
W	0.240	6.084	0.240	W	0.240	7. 124	0.240		
Χ	0.240	4.722	0.240	Х	0.400	5.446	0.400		
Υ	0.240	5.122	0.240	Υ	0.240	6.884	0.240		
Z	0.480	4.482	0.480	Z	0.400	5.446	0.400		
a	0. 320 0. 720	3.842 4.082	0.640	a b	0.400	4. 562 4. 802	0.720		
b C	0. 120	4.002	0.480	C	0.800 0.480	4. 722	0.480		
d	0.480	4.082	0.720	d	0,480	4.802	0,800		
е	0.480	4.082	0.320	е	0.480	4.722	0.320		
f	0.320	2.480	0.160	f	0.320	2.882	0.160		
g	0.480	4.082	0.720	g	0.480	4.802	0.800		
h	0.720	4.082	0.640	h i	0.800	4. 722	0.720		
i	0.720 0.000	1.120	0.720 0.720	ì	0.800	1. 280 2. 642	0.800		
k	0.720	4. 322	0.160	k	0.800	5. 122	0.160		
Î	0.720	1.120	0.720	ï	0.800	1. 280	0.800		
m	0.720	6.724	0.640	m	0.800	7.926	0.720		
n	0.720	4.082	0.640	n	0.800	4.722	0.720		
0	0.480	4.082	0.480	0	0.480	4.882	0.480		
р	0.720	4.082	0.480	р	0.800	4.802	0.480		
q r	0.480 0.720	4.082 2.642	0.720 0.160	q r	0.480	4. 802 3. 042	0.800		
s	0. 720	3. 362	0. 160	S	0.320	3. 762	0. 160		
+	0.080	2.882	0.080	t	0.080	3. 202	0.080		
u	0.640	4.082	0.720	u	0.720	4.722	0.800		
٧	0.160	4.722	0.160	V	0.160	5.684	0.160		
W	0.160	7.524	0.160	W	0.160	9.046	0.160		
×	0.000	5. 202	0.000	X	0.000	6. 244	0.000		
y z	0.160 0.240	4. 962 3. 362	0.160 0.240	y z	0.160 0.240	6.004 4.002	0.160		
1	0.720	1.680	0. 240	1	0. 800	2.000	0. 960		
2	0.480	4.482	0.480	2	0.800	5.446	0.800		
3	0.480	4.482	0.480	3	1.440	5.446	0.800		
4	0.240	4.962	0.720	4	0.160	6.004	0.960		
5	0.480	4.482	0.480	5	0.800	5.446	0.800		
6	0.720	4.482	0.720	6 7	0.800	5.446	0.800		
7 8	0. 240 0. 480	4.482	0.720 0.480	8	0.560 0.800	5. 446 5. 446	0.560		
9	0.480	4. 482	0.480	9	0.800	5. 446	0.800		
0	0.720	4. 722	0.720	0	0.800	5. 684	0.800		
- 19	0.240	2.802	0.240	-	0.240	2.802	0.240		

N 0. SHT TS

USER NAME = footemj	DESIGNED	-	LP/IP	REVISED	-	LP 07/01/2015
	DRAWN	ä	LP	REVISED	÷	
PLOT SCALE = 50.0000 ' / in.	CHECKED	-	IP	REVISED	-	
PLOT DATE = 3/4/2019	DATE	-	10/01/2014	REVISED	-	

STATE OF ILLINOIS **DEPARTMENT OF TRANSPORTATION** 

DISTRICT ONE MAST ARM MOUNTED STREET NAME SIGNS					F.A. RTE.	SECTION		
					80	FAI 80 21 INTERCHANGE		
					TS-02			
	SHEET	OF	SHEETS	STA.	TO STA		ILLINOIS FE	D AID P

