## STATE OF ILLINOIS DEPARTMENT OF TRANSPORTATION **DIVISION OF HIGHWAYS**

# PLANS FOR PROPOSED FEDERAL AID HIGHWAY

**CONGESTION MITIGATION** AND AIR QUALITY (CMAQ) **IMPROVEMENT PROGRAM** 

SECTION: 06-00087-00-PK


WOLF ROAD (FAU 2689)

**COMMUTER PARKING FACILITY EXPANSION** 

PROJECT: CMM-8003(751)

**VILLAGE OF WESTERN SPRINGS COOK COUNTY** 


C-91-144-07

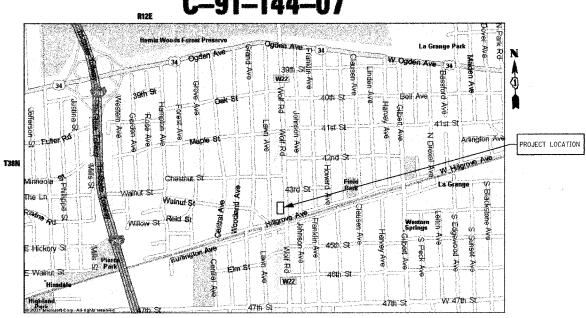

GROSS & NET LENGTH OF PROJECT: 108.00 FT. (0.019 MILES)

SECTION 2689 06-00087-00-PK COOK 18 1 FED. ROAD DIST. NO. | ILLINOIS | FED. AID PROJECT CONTRACT NO: 63057



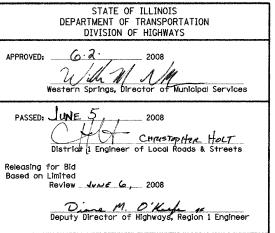

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**CONTRACT NO.** 63057

ON REDUCED PLANS. THE ABOVE SCALES MAY BE USED.

FOR INDEX OF SHEETS, SEE SHEET NO. 2

PROJECT LOCATED IN **VILLAGE OF WESTERN SPRINGS** 

ENGINEERING SCALES. REDUCED SIZED PLANS WILL NOT CONFORM TO STANDARD SCALES, IN MAKING MEASUREMENTS

JOINT UTILITY LOCATION INFORMATION FOR EXCAVATION

TRAFFIC DATA

SPEED LIMIT:

WOLF ROAD = 9700

WOLF ROAD = 35 MPH (POSTED)

**DESIGN DESIGNATION: COLLECTOR** 

40 MPH (DESIGN)

1-800-892-0123

COUNTY: COOK SECTION: 06-00087-00-PK

000001-05	LIST OF STATE STANDARDS STANDARD SYMBOLS, ABBREVIATIONS AND PATTERNS
280001-04	TEMPORARY EROSION CONTROL SYSTEMS
420001-07	PAVEMENT JOINTS
420101-04	7.2 m (24') JOINTED PCC PAVEMENT
420111-02	PCC PAVEMENT ROUNDOUTS
420701-02	PAVEMENT FABRIC
424001-05	CURB RAMPS FOR SIDEWALKS
442101-07	CLASS B PATCHES
602001	CATCH BASIN TYPE A
602301-01	INLET TYPE A
602401-01	MANHOLE TYPE A
60260101	PRECAST REINFORCED CONCRETE FLAT SLAB TOP
602701-01	CAST IRON STEPS
604001-02	FRAME AND LIDS TYPE 1
606001-03	CONCRETE CURB TYPE B AND COMBINATION CONCRETE CURB AND GUTTER
701301-02	LANE CLOSURE, 2L, 2W, SHORT TIME OPERATIONS
701501-04	URBAN LANE CLOSURE 2L, 2W UNDIVIDED
701801-03	LANE CLOSURE MULTILANE 1W OR 2W CROSSWALK OR SIDEWALK CLOSURE
701901	TRAFFIC CONTROL DEVICES
TC-10	TRAFFIC CONTROL AND PROTECTION FOR SIDE ROADS, INTERSECTIONS, AND DRIVEWAYS
TC-13	DISTRICT ONE TYPICAL PAVEMENT MARKINGS

### C.C.H.D. CONSTRUCTION NOTES

(FOR PLACEMENT OF P.C.C. PAVEMENT, MEDIAN, AND CURB AND GUTTER)

- 1. SAW CUT THE FULL DEPTH OF EXISTING PAVEMENT, MEDIAN, AND CURB AND GUTTER, AT THE LIMITS OF REMOVAL.
- 2. PAVEMENT AND TYPE 0 4 MEDIAN SHALL BE 10 INCH DEPTH P.C. CONCRETE, WITH PAVEMENT FABRIC, ON 6 INCH SUBBASE GRANULAR MATERIAL, TYPE B.
- 3. CONSTRUCT PAVEMENT FABRIC IN ACCORDANCE WITH LD.O.T. STANDARD NO. 420701, AND PROVIDE 3 1/2 INCHES OF CLEARANCE BETWEEN THE PAVEMENT SURFACE AND THE TOP OF THE FABRIC.
- DISREGARD ALL DETAILS AND NOTES REGARDING PAVEMENT BLOCKOUT ON LD.O.T. STANDARD NO. 420701, AND COMPLY WITH LD.O.T STANDARD NO. 420111 AT ALL DRAINAGE/UTILITY STRUCTURE LOCATIONS.
- 5. WHERE THE PROPOSED PAVEMENT OR TYPE C-4 MEDIAN ABUTS THE EXISTING PAVEMENT LONGITUDINALLY, PROVIDE A TIED LONGITUDINAL CONSTRUCTION JOINT IN ACCORDANCE WITH I.D.O.T. STANDARD 420001, USING 3/4 INCH DIAMETER TIE BARS AT 24 INCH CENTERS.
- WHERE THE PROPOSED PAVEMENT OR TYPE C 4 MEDIAN ABUTS THE EXISTING PAVEMENT OR TYPE C 4 MEDIAN TRANSVERSELY, PROVIDE A TRANSVERSE JOINT IN ACCORDANCE WITH I.D.O.T. STANDARD 442101, USING 1 1/2 INCH AMETER DOWEL BARS AT 12 INCH CENTERS.
- PROVIDE TRANSVERSE SAWED CONTRACTION JOINTS EVERY 40 FEET IN ACCORDANCE WITH LD.O.T, STANDARD NO. 420001, USING 1 1/2 INCH DIAMETER DOWEL BARS AT 12 INCH CENTERS, AND ALIGN PROPOSED JOINTS WITH EXISTING JOINTS. SAWED GROOVE AND JOINT SEAL SHALL BE CONSTRUCTED IN ACCORDANCE WITH C.C.H.D. DETAIL (DISREGARD SAWED CONTRACTION JOINT DETAIL SHOWN ON I.D.O.T. STANDARD.
- IF A PROPOSED TRANSVERSE SAW CUT IS LOCATED LESS THAN 10 FEET FROM AN EXISTING TRANSVERSE JOINT, THEN THE EXISTING PAVEMENT OR TYPE C 4 MEDIAN SHALL BE REMOVED AND REPLACED UP TO THE EXISTING TRANSVERSE JOINT.
- 9. PAVEMENT PATCHES SHALL BE CLASS B. CONSTRUCTED IN ACCORDANCE WITH LO.O.T. STANDARD NO. 442101, AND SHALL EXTEND THE FULL WIDTH OF THE EXISTING LANE(S). WHERE PATCHING MORE THAN ONE LANE WIDTH, PROVIDE A TIED LONGITUDINAL JOINT (CONSTRUCTION OR SAWED) BETWEEN LANES, IN ACCORDANCE WITH I.D.O.T. STANDARD NO. 420001. C.C.H.D. CONSTRUCTION NOTES NO. 1 THROUGH 8 SHALL APPLY TO THE CONSTRUCTION OF CLASS B PATCHES.
- CURB AND GUTTER SHALL BE CONSTRUCTED AND TIED INTO ABUTTING EXISTING OR PROPOSED P.C.C. PAVEMENT IN ACCORDANCE WITH I.D.O.T. STANDARD NOS. 606001 AND 420001, USING 3/4 INCH DIAMETER TIE BARS AT 24 INCH CENTERS.
- C.C.H.D. MEDIAN STANDARD
- 12. PLACEMENT OF CATCH BASINS WITHIN TYPE M=7 MEDIAN SHALL BE IN ACCORDANCE WITH THE C.C.H.D. "POLICY FOR DRAINING TYPE M=7 MEDIAN" STANDARD.
- 13. WHERE A MEDIAN OPENING IS PROVIDED, THE PAVEMENT SHALL BE CROWNED AT THE CENTERLINE USING A ONE PERCENT CROSS SLOPE.
- 14. INCLUDE APPLICABLE I.D.O.T. AND C.C.H.D. STANDARDS IN THE PLANS.
- 15. ALL TRENCHES WITHIN THE COUNTY RIGHT OF WAY SHALL BE BACKFILLED WITH FA-6 SAND IN ACCORDANCE WITH ARTICLE 550.07 OF THE LD.O.T. STANDARD SPECIFICATIONS THE BACKFILLING MUST EXTEND UP TO THE PROPOSED SUBBASE IN PAVEMENT SECTIONS

C.C.H.D. CONSTRUCTION NOTES APPLY TO AREA WITHIN COOK COUNTY RIGHT-OF-WAY
AT INTERSECTION OF BURLINGTON AVENUE AND WOLF ROAD

### GENERAL NOTES

- 1. ALL CONSTRUCTION SHALL BE DONE IN ACCORDANCE WITH THE LATEST VERSION OF THE I.D.O.T. STANDARD SPECIFICATIONS FOR ROAD AND BRIDGE CONSTRUCTION.
- 2. ACCESS TO LOCAL RESIDENCES AND BUSINESSES SHALL BE MAINTAINED DURING CONSTRUCTION.
- 3. THE CONTRACTOR SHALL GIVE THE MUNICIPALITY THREE (3) WORKING DAYS NOTICE PRIOR TO THE COMMENCEMENT OF WORK. (JAMES J. BENES AND ASSOCIATES, INC: (630) 719-7570)
- 4. ALL ELEVATIONS ARE ON U.S.G.S. DATUM
- 5. DO NOT SCALE PLANS FOR CONSTRUCTION DIMENSIONS.
- 6. NEITHER THE ENGINEER, NOR THE OWNER, SHALL ASSUME ANY OF THE RESPONSIBILITIES OF THE CONTRACTOR'S SUPERINTENDENT OR OF SUBCONTRACTORS. ADDITIONALLY, NEITHER THE ENGINEER, NOR THE OWNER, SHALL ADVISE ON, OR ISSUE DIRECTIONS CONCERNING, ASPECTS OF CONSTRUCTION MEANS, METHODS, TECHNIQUES, SEQUENCES OR PROCEDURES, OR SAFETY PRECAUTIONS AND/OR PROGRAMS IN CONNECTION WITH THE WORK.
- 7. THE LOCATIONS OF PUBLIC OR PRIVATE UTILITIES SHOWN ON THE PLANS ARE APPROXIMATE AND THEIR ACCURACY IS NOT GUARANTEED. THE CONTRACTOR SHALL VERIFY THE EXACT LOCATION AND ELEVATION OF ALL UTILITIES. SHALL REPORT ANY ENCOUNTERED DISCREPANCIES TO THE ENGINEER AT ONCE. THE CONTRACTOR SHALL TAKE DUE CARE IN ALL PHASES OF CONSTRUCTION TO PROTECT ANY UTILITIES WHICH MAY BE AFFECTED BY THE WORK.
- 8. THE CONTRACTOR SHALL KEEP THE CONSTRUCTION AREA FREE OF DEBRIS AND/OR OBJECTIONABLE MATERIALS DURING CONSTRUCTION. THE CONTRACTOR SHALL INSPECT THE SITE DAILY FOR DEBRIS ON THE ROADWAY SURFACE. THE RIGHT-OF-WAY SHALL BE RESTORED WITH TOPSOIL 4" AND SOD.
- 9. THE CONTRACTOR SHALL MAINTAIN ALL EXISTING DRAINAGE FACILITIES. DURING CONSTRUCTION AND SHALL REPAIR ANY DRAINAGE FACILITIES DAMAGED DURING CONSTRUCTION. THIS WORK SHALL BE CONSIDERED INCIDENTAL TO THE CONTRACT AND WILL NOT BE PAID FOR SEPARATELY.
- 10. THE CONTRACTOR SHALL VERIFY THE ELEVATIONS OF EXISTING STORM SEWERS PRIOR TO THE CONSTRUCTION OF PROPOSED STORM SEWER.
- 11. THE RELOCATION OF SIGNS WILL NOT BE PAID FOR SEPARATELY BUT SHALL BE INCLUDED IN THE COST OF THE CONTRACT.
- 12. BEFORE STARTING ANY EXCAVATION, THE CONTRACTOR SHALL CALL "J.U.L.I.E." AT (800) 892-0123 FOR FIELD LOCATIONS OF BURIED ELECTRIC, TELEPHONE, GAS, SEWERS AND WATER UTILITIES. (48 HOUR NOTIFICATION IS REQUIRED.)
- 13. THE CONTRACTOR SHALL COORDINATE ALL CONSTRUCTION ACTIVITIES WITH ALL
- 14. THE CONTRACTOR SHALL PROVIDE AND INSTALL TWO (2) WEIGHTED SAND BAGS FOR EACH TYPE I OR TYPE II BARRICADE USED, ONE WEIGHTED SAND BAG ACROSS EACH
- 15. SAW CUTTING OF PAVEMENT, SHOULDERS, CURB AND GUTTER, ETC. SHALL BE TO FULL DEPTH AND SHALL RESULT IN CLEAN, STRAIGHT EDGE ON THE PORTION REMAINING. ALL SAW CUTTING SHALL BE CONSIDERED INCLUDED IN THE COST OF
- 16. STATIONING FOR ALL DRAINAGE STRUCTURES ARE GIVEN TO THE CENTER OF THE DRAINAGE STRUCTURE. OFFSETS FOR CURB LINE INLETS AND CATCH BASINS ARE GIVEN TO THE EDGE OF PAVEMENT. OFFSETS FOR ALL OTHER DRAINAGE STRUCTURES ARE GIVEN TO THE CENTER OF THE STRUCTURE. THE CONTRACTOR SHALL TAKE CARE TO ENSURE THAT ALL CURB LINE DRAINAGE STRUCTURES ARE PROPERELY ALIGNED WITH THE PROPOSED CURB AND GUTTER.
- 17. TRANSVERSE PAVEMENT JOINTS SHALL BE SPACED AT A MAXIMUM OF 12 FEET.
- 18. ALL STRUCTURE (MANHOLE, CATCH BASIN AND INLET) CONNECTIONS SHALL MEET THE REQUIREMENTS FOR FOR FLEXIBLE WATER TIGHT CONNECTIONS PER ASTM C923.

INDEX OF DRAWINGS

SECTION

CONTRACT NO. 63057

STA.

2689 06-00087-00-PK COOK

COUNTY

TO STA. FED. ROAD DIST. NO. ILLINOIS FFD. AID PROJECT

18 2

- TITLE SHEET
- INDEX OF SHEETS, LIST OF STATE STANDARDS AND GENERAL NOTES
- SUMMARY OF QUANTITIES
- TYPICAL SECTIONS
- REMOVAL PLAN
- GEOMETRIC PLAN
- DRAINAGE AND UTILITY PLAN
- GRADING PLAN
- STRIPING PLAN
- 10 LANDSCAPE PLAN
- 11 EROSION CONTROL PLAN
- 12 CROSS SECTIONS
- 13 CONSTRUCTION DETAILS
- 14-15 LIGHTING DEAHS
- 16 LANDSCAPE DEAILS
- 17-18 DISTRICT DETAILS

REVISIONS ILLINOIS DEPARTMENT OF TRANSPORTATION F.A.U. 2689 WOLF ROAD COMMUTER PARKING FACILITY EXPANSION DATE INDEX OF DRAWINGS, GENERAL NOTES AND IDOT STANDARD DRAWINGS SCALE: NTS DRAWN BY SMP

CHECKED BY JDS


DATE:

F.A.U RTE.	SECTION	COUNTY	TOTAL SHEETS	SHEET NO.
2689	06-00087-00-PK	COOK	18	3
STA.		TO STA.		
	ILLIN	OIS FED. AID	PROJECT	
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ITEM CODE NUMBER	ITEM DESCRIPTION	UNIT	TOTAL QUANTITY J000
 20100110	TREE REMOVAL (6 TO 15 UNITS DIAMETER)	UNIT	37
 20100210	TREE REMOVAL (OVER 15 UNITS DIAMETER)	UNIT	41
 20201200	REMOVAL AND DISPOSAL OF UNSUITABLE MATERIAL	CU YD	941
 20700420	POROUS GRANULAR EMBANKMENT, SUBGRADE	CU YD	354
 20800150	TRENCH BACKFILL	CU YD	496
 21001000	GEOTECHNICAL FABRIC FOR GROUND STABILIZATION	SQ YD	1063
 21101615	TOPSOIL FURNISH AND PLACE, 4"	SQ YD	233
 21101665	TOPSOIL FURNISH AND PLACE, 18"	SQ YD	112
 25000400	NITROGEN FERTILIZER NUTRIENTS	POUND	7
25000500	PHOSPHORUS FERTILIZER NUTRIENTS	POUND	7
 25000600	POTASSIUM FERTILIZER NUTRIENTS	POUND	7
 25200110	SODDING, SALT TOLERANT	SQ YD	345
 25200200	SUPPLEMENTAL WATERING	UNIT	7
 28000400	PERIMETER EROSION BARRIER	FOOT	148
 28000510	INLET FILTERS	EACH	7
 31100300	SUB-BASE GRANULAR MATERIAL, TYPE A 4"	SQ YD	1445
 40201000	AGGREGATE FOR TEMPORARY ACCESS	TON	15
 42000200	PORTLAND CEMENT CONCRETE PAVEMENT 7"	SQ YD	1438
42001300	PROTECTIVE COAT	SQ YD	1573
 42400400	PORTLAND CEMENT CONCRETE SIDEWALK 7 INCH	SQ FT	210
 42400800	DETECTABLE WARNINGS	SQ FT	26
 44000200	DRIVEWAY PAVEMENT REMOVAL	SQ YD	105
 44000600	SIDEWALK REMOVAL	SQ FT	409
 44001700	COMBINATION CONCRETE CURB AND GUTTER REMOVAL AND REPLACEMENT	FOOT	64
 550A2420	STORM SEWERS, RUBBER GASKET, CLASS A, TYPE 1 48"	FOOT	516
 60107600	PIPE UNDERDRAINS 4"	FOOT	134
 60221100	MANHOLES, TYPE A, 5'-DIAMETER, TYPE 1 FRAME, CLOSED LID	EACH	1
 60243800	INLET, SPECIAL, WITH TYPE 1 FRAME, OPEN LID	EACH	3
 60600605	CONCRETE CURB TYPE B	FOOT	152

	ITEM CODE NUMBER	ITEM DESCRIPTION	UNIT	TOTAL QUANTITY J000-
	60603800	COMBINATION CONCRETE CURB AND GUTTER, TYPE B-6.12	FOOT	330
				44
	61141600	STORM SEWERS, SPECIAL 48"	FOOT	
	67100100	MOBILIZATION	L SUM	
1	70102620	TRAFFIC CONTROL AND PROTECTION STANDARD 701501	L SUM	1
	70102640	TRAFFIC CONTROL AND PROTECTION STANDARD 701801	L SUM	1
*	78008200	POLYUREA PAVEMENT MARKING TYPE I - LETTERS AND SYMBOLS	SQ FT	23
*	78008210	POLYUREA PAVEMENT MARKING TYPE I LINE 4"	FOOT	635
*	81000500	CONDUIT IN TRENCH, 1 1/2" DIA, GALVANIZED STEEL	FOOT	71
*	81603000	UNIT DUCT, 600V, 2-1C NO. 8, 1/C NO. 8 GROUND, (XLP-TYPE USE), 3/4" DIA. POLYETHYLENE	FOOT	120
*	81900200	TRENCH AND BACKFILL FOR ELECTRICAL WORK	FOOT	120
*	83600200	LIGHT POLE FOUNDATION, 24" DIAMETER	FOOT	16
*	A2000118	TREE, ACER X FREEMANII AUTUMN BLAZE (AUTUMN BLAZE FREEMAN MAPLE), 3" CALIPER, BALLED AND BURLAPPED	EACH	2
*	B2005720	TREE, PYRUS CALLERYANA CHANTICLEER (CHANTICLEER CALLERY PEAR), 2 1/2" CALIPER, TREE FORM, BALLED AND BURLAPPED	EACH	3
*	E20240Q1	VINE-POLYGONUM REYNOUTRIA (DWARF FLEECE FLOWER), 1-QUART POT	EACH	115
*	K0030450	PERENNIAL PLANTS, DAFFODIL BULBS	UNIT	7.6
	XX000882	WOOD FENCE	FOOT	212
*	XX001136	LIGHT POLE, SPECIAL	EACH	1
	XX001249	ORNAMENTAL FENCE	FOOT	62
		STORM SEWERS PVC (SDR 26), 12"	FOOT	32
	XX003360			
*	XX004051	LIGHT POLE, ORNAMENTAL	EACH	1
*	XX005178	HEMEROCALLIS 'CHICAGO APACHE' DAYLILY	EACH	96
	XX005656	INLET FILTER CLEANING	EACH	21
*	XX006002	GRASSES, PENSITUM ALOPECUROIDES 'HAMELN' (HAMELN DWARF FOUNTAIN GRASS) 3 GAL.	EACH	28
	XX006105	HEMEROCALLIS HAPPY RETURNS (HAPPY RETURNS DAYLILY) 1 GALLON	EACH	96
_	XX006937	GROUND ROD, 5/8" DIA., X 10 FT	EACH	2
	Z0007601	BUILDING REMOVAL NO. 1	L SUM	1
	Z0007602	BUILDING REMOVAL NO. 2	L SUM	. 1
	Z0007603	BUILDING REMOVAL NO. 3	L SUM	1
l			L JUW	1
	* DENOTES SPECIALT	YITEM		

	REVISIONS NAME DATE	• F.A.U.	NT OF TRANSPORTATION ROUTE 2689 PARKING FACILITY EXPANSION
		SUMMARY	OF QUANTITIES
JAMES J. BENES & ASSOCIATES, INC.			
950 Warrenville Road, Suite 101, Lisle, Illinois 60532		SCALE: NTS	DRAWN BY: BCD
Tel. (630) 719-7570 - Fax (630) 719-7589		DATE:	CHECKED BY: JDM



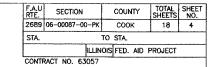

- 1) EXISTING SURFACE (WITH REMOVALS AS DETAILED ON REMOVAL PLAN)
- (2) EXISTING P.C.C. SIDEWALK
- (3) EXISTING CONCRETE CURB AND GUTTER, TYPE B-6.24
- (4) EXISTING P.C.C. PAVEMENT
- 5 LANDSCAPE RESTORATION (SEE LANDSCAPE PLAN)
- (6) TOPSOIL FURNISH AND PLACE 18"
- (6A) TOPSOIL FURNISH AND PLACE, 4"
- (7) CONCRETE CURB, TYPE B
- (8) 24" LONG DEFORMED EPOXY-COATED NO. 6 TIE BARS 24" CTRS, 24" LONG (COST INCLUDED IN CONCRETE CURB AND GUTTER)
- 9 P.C.C. PAVEMENT, 7"
- 10 SUB-BASE GRANULAR MATERIAL, TYPE B 4"
- POROUS GRANULAR EMBANKMENT, SUBGRADE (AT LOCATIONS DESIGNATED BY THE ENGINEER)
- (2) GEOTECHNICAL FABRIC FOR GROUND STABILIZATION (AT LOCATIONS DESIGNATED BY THE ENGINEER)
- (3) COMBINATION CONCRETE CURB AND GUTTER, TYPE B-6.12 (THICKNESS OF CURB FLAG SHALL BE EQUAL TO THE THICKNESS OF THE PROPOSED PAVEMENT)

# 150' VARIES 60' 14' 60' VARIES 30' 30' 30' 30' 30' 2% & VARIES 2% & VARIES 1'(TYP.) 13 8 9 10 11 8 13 6

150'

**EXISTING TYPICAL SECTION - COMMUTER PARKING FACILITY** 

### PROPOSED TYPICAL SECTION - COMMUTER PARKING FACILITY

### SOILS NOTE:

POROUS GRANULAR EMBANKMENT SUBGRADE (PGES) HAS BEEN PROVIDED AT THE LOCATIONS INDICATED FOR SOILS WHICH TEND TO BE UNSTABLE WHEN WET. THE ACTUAL NEED FOR REMOVAL AND REPLACEMENT WITH PGE WILL BE DETERMINED IN THE FIELD AT THE TIME OF CONSTRUCTION BY THE ENGINEER (BY USE OF A CONE PENETROMETER IN CONJUNCTION WITH THE IDOT SUBGRADE MANUAL). IF UNSTABLE SOILS ARE ENCOUNTERED, THE SOILS SHALL BE REMOVED AND REPLACED WITH PGES. IF UNSTABLE SOIL IS NOT ENCOUNTERED, THEN THE QUANTITY WILL BE DEDUCTED AND NO ADDITIONAL COMPENSATION WILL BE DUE THE CONTRACTOR.

REVISIONS	ILLINOIS DED	ARTMENT OF TRANSPORTATION
NAME DATE	LELINOIS DEF	F.A.U. 2689
	WOLF ROAD COM	MUTER PARKING FACILITY EXPANSION
		MOLENT EXPANSION
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	111	PICAL SECTIONS
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	SCALE: NTS	DRAWN BY: SMP
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<u> </u>	DATE:	CHECKED BY: JDS

SECTION COUNTY TOTAL SHEE SHEETS NO. 2689 06-00087-00-PK COOK TO STA. ILLINOIS FED. AID PROJECT **→**②→Z OTES:

1) RESIDENTIAL SANITARY AND WATER SERVICES
SHALL BE CUT AND CAPPED AT R.O.W. THE WORK
TO ABANDON SANITARY AND WATER SERVICES
SHALL BE INCLUDED IN THE COST OF BUILDING
REMOVAL (L SUM).

2) BASEMENTS SHALL BE BACKFILLED WITH CA-7
STONE. BACKFILLING OF BUILDING BASEMENTS
SHALL BE CONSIDERED AS INCLUDED IN THE COST
OF BUILDING REMOVAL. OF BUILDING REMOVAL.

ILLINOIS DEPARTMENT OF TRANSPORTATION
F.A.U. ROUTE 2689
WOLF ROAD COMMUTER PARKING FACILITY EXPANSION

REMOVAL PLAN

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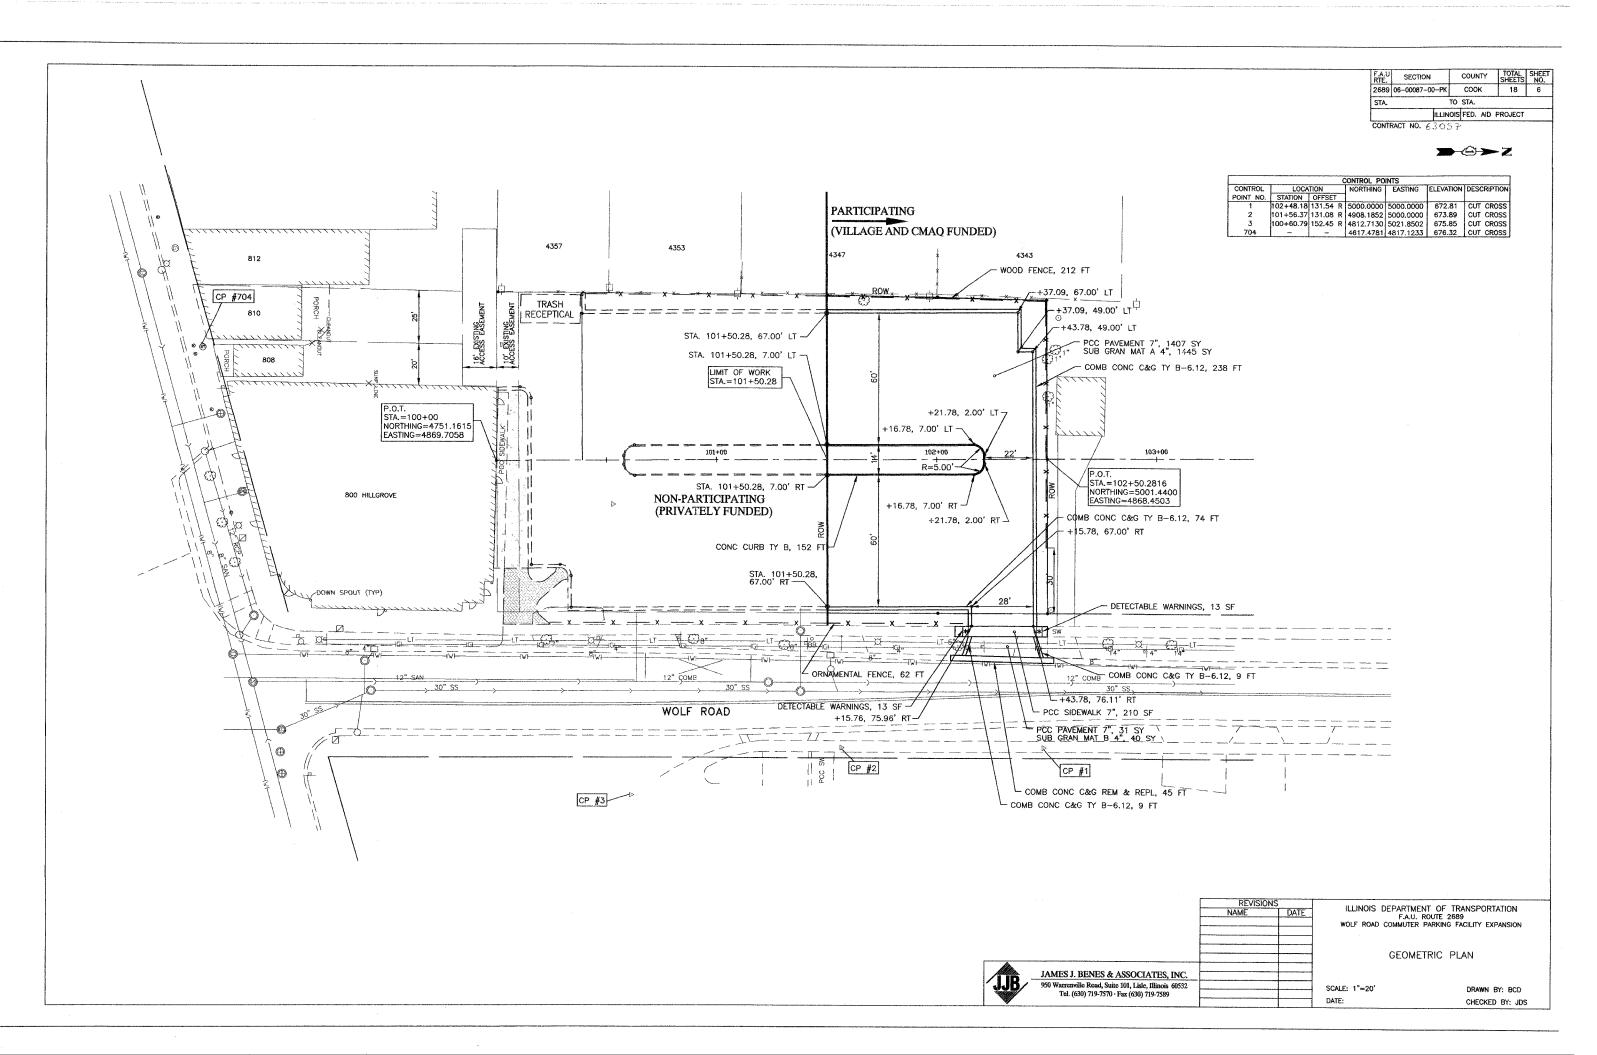
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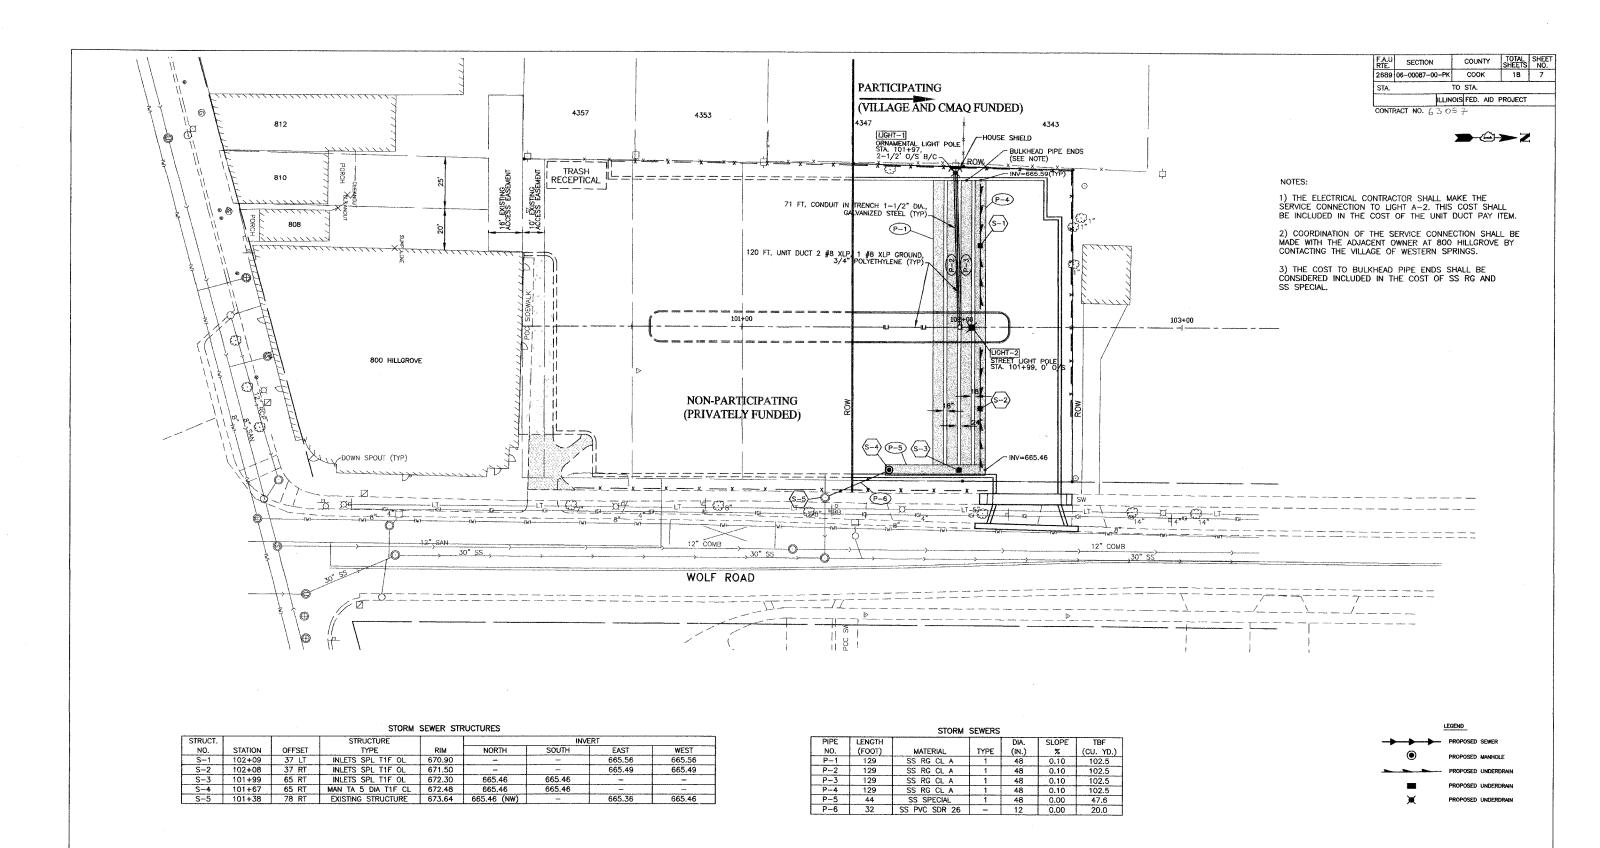
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DATE:

PARTICIPATING (VILLAGE AND CMAQ FUNDED) ⊕<sub>24"</sub> ⊙<sub>24"</sub> 4357 4343 812 *,,,,,,,,,,,,,* LANDSCAPING X 16' EXISTING ACCESS EASEMENT 810 BUILDING REMOVAL ູ 1, 1 L SUM - BUILDIN REMOVAL NO. 2, 1 L SUM BUILDING REMOVAL NO. 3, 1 L SUM × 0 <∄-102+00 💥 800 HILLGROVE 4348 WOLF ROAD NON-PARTICIPATING 4336 WOLF ROAD (PRIVATELY FUNDED) WOLF ROAD -SIDEWALK REMOVAL, 88 SF - DRIVEWAY PAVEMENT REMOVAL, 81 SY -SIDEWALK REMOVAL, 210 SF -DOWN SPOUT (TYP) - DRIVEWAY PAVEMENT REMOVAL, 15 SY - COMB C C&G REM & REPL, 45 FT -SIDEWALK REMOVAL, 111 SF WOLF ROAD - DRIVEWAY PAVEMENT REMOVAL, 9 SY \⊕

> JAMES J. BENES & ASSOCIATES, INC. 950 Warrenville Road, Suite 101, Lisle, Illinois 60532 Tel. (630) 719-7570 · Fax (630) 719-7589






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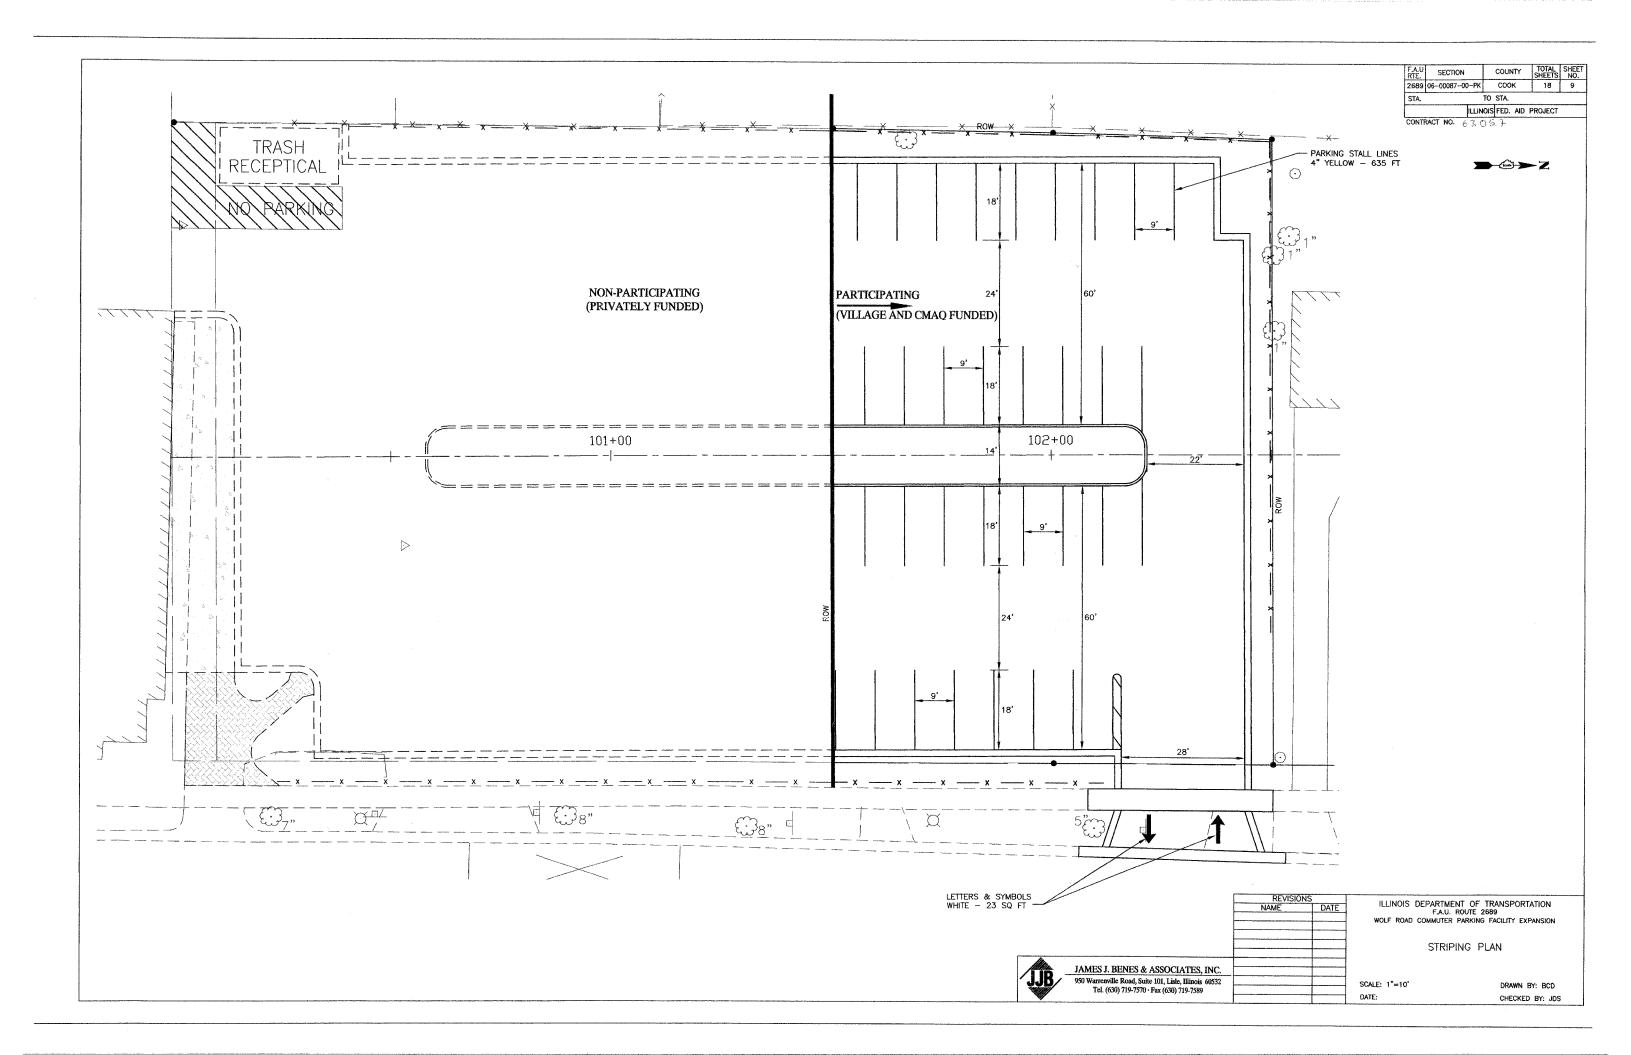
950 Warrenville Road, Suite 101, Lisle, Illinois 60532
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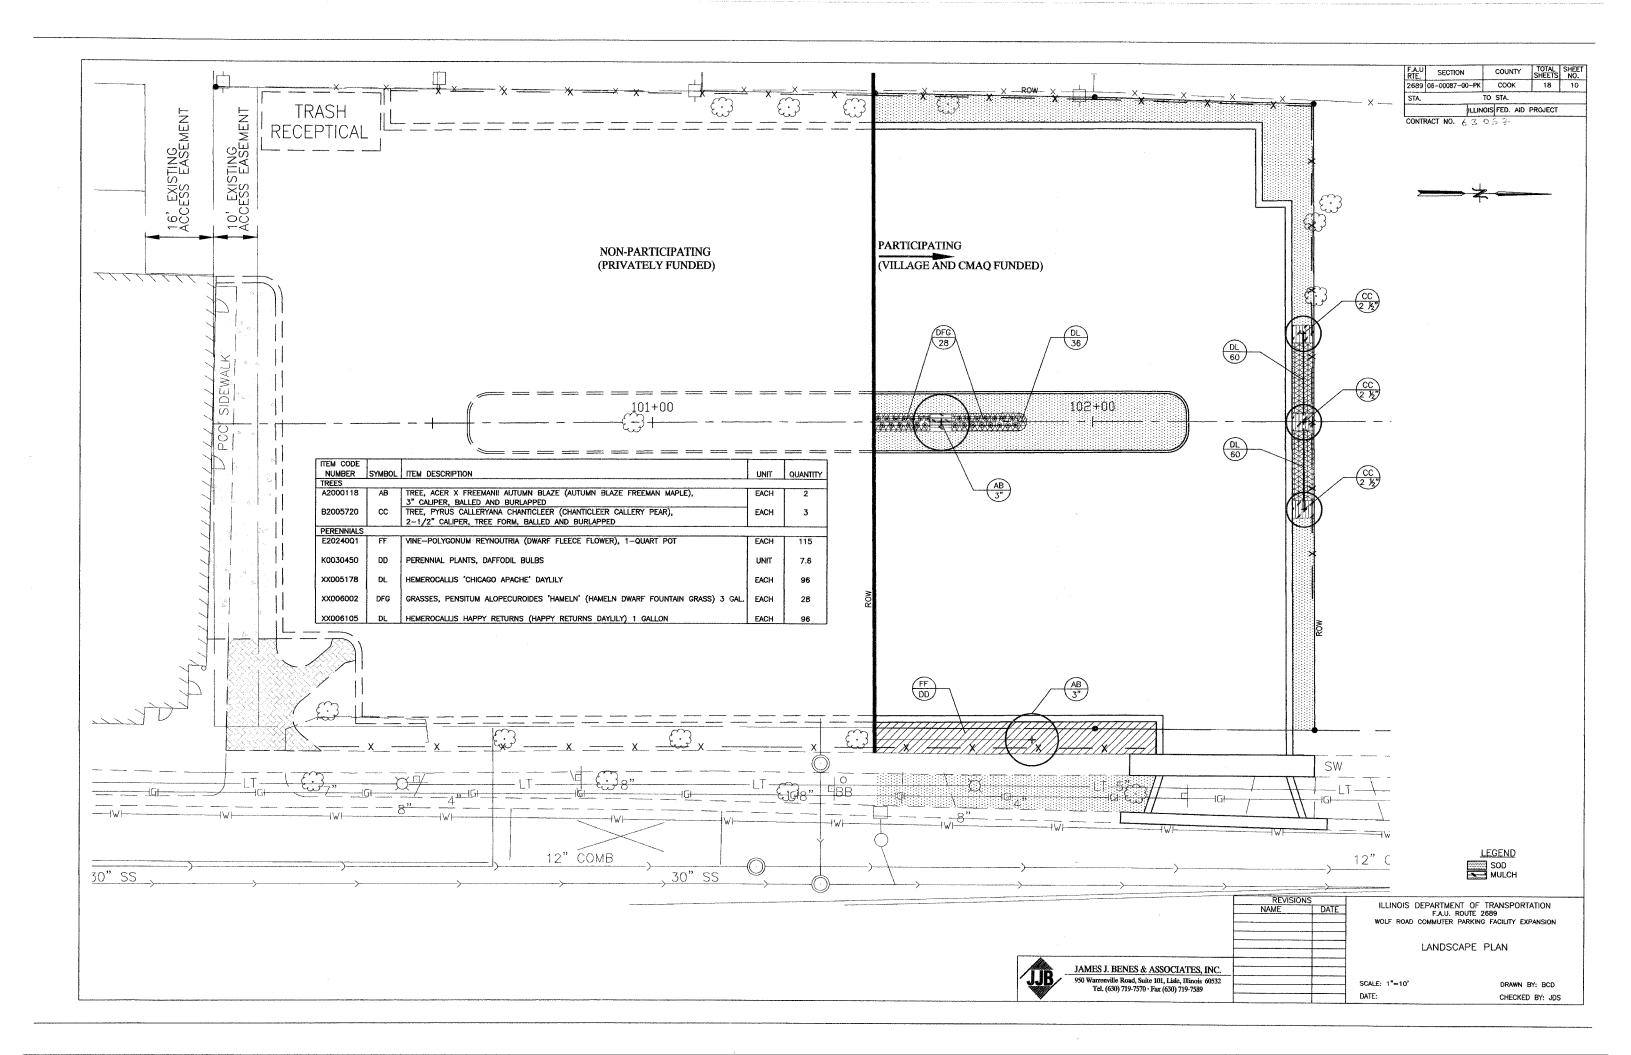
ILLINOIS DEPARTMENT OF TRANSPORTATION
F.A.U. ROUTE 2689
WOLF ROAD COMMUTER PARKING FACILITY EXPANSION


DRAINAGE AND UTILITY PLAN


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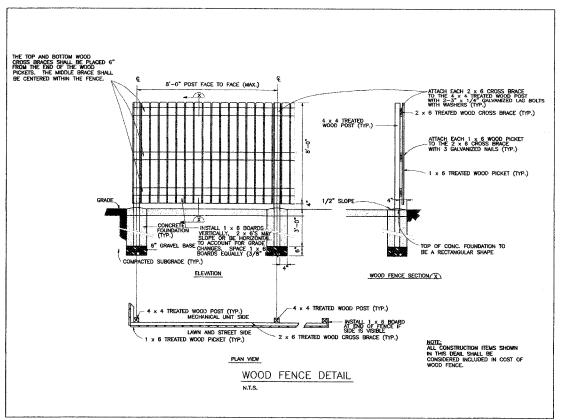







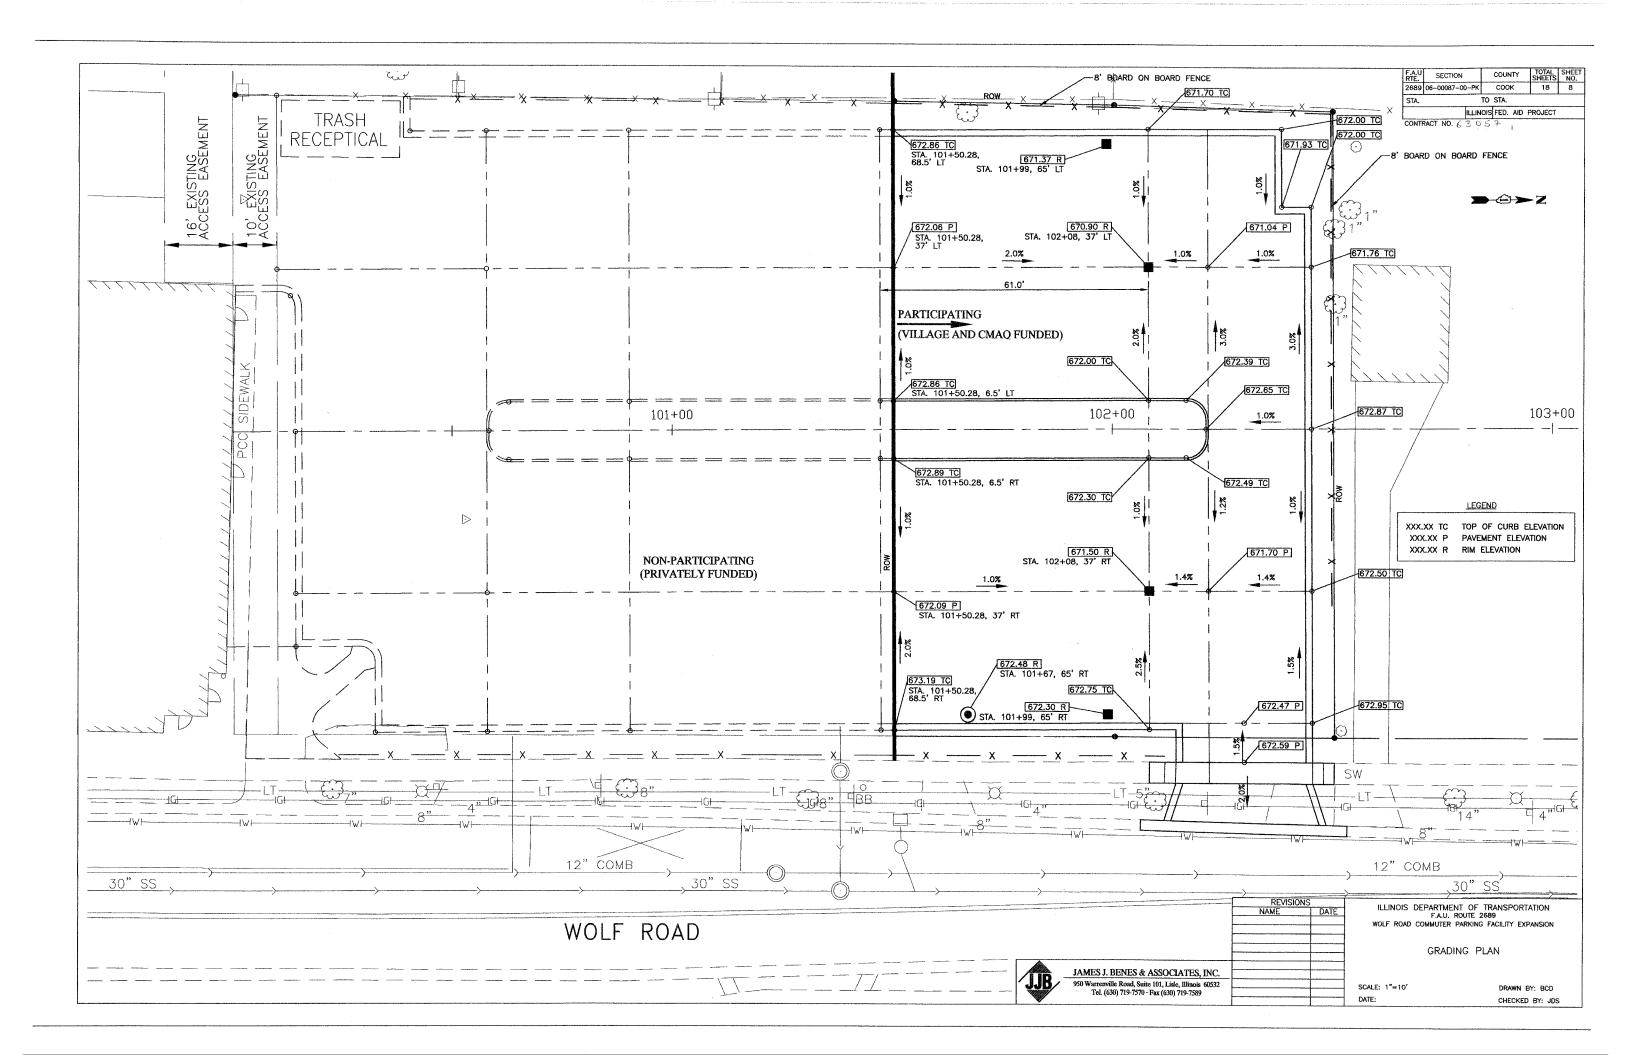


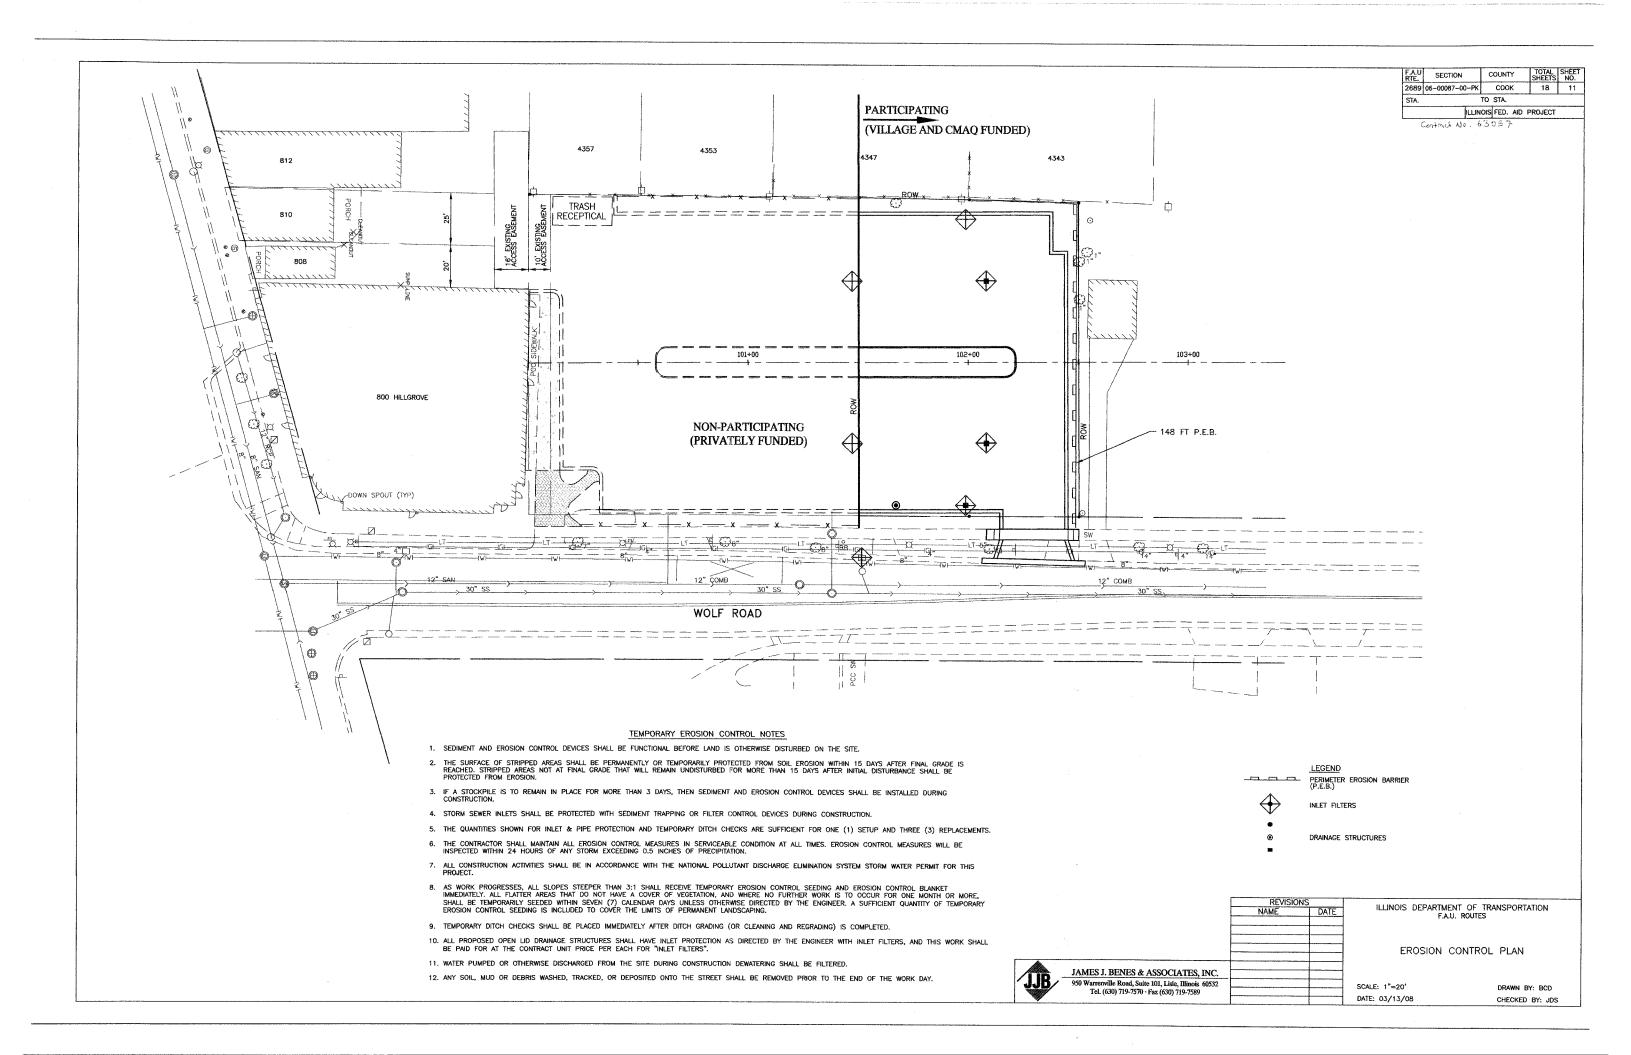


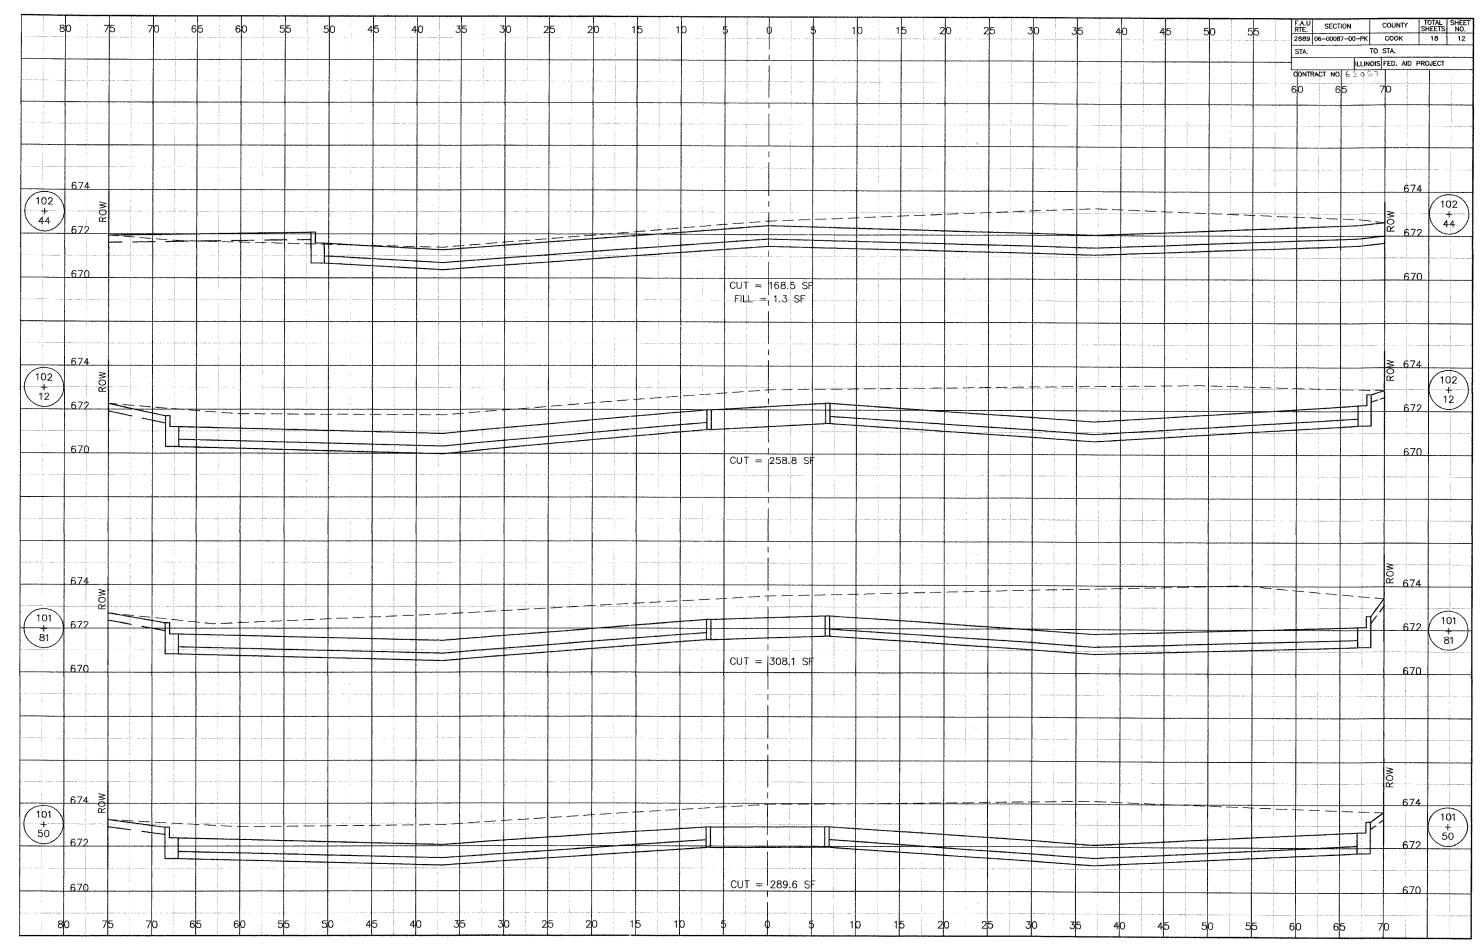

F.A.U RTE.	SECTION	COUNTY	TOTAL SHEETS	SHEET NO.
2689	06-00087-00-PK	COOK	18	13
STA.		TO STA.		
	ILLIN	OIS FED. AID	PROJECT	
CONT	RACT NO. 430	5.7.		

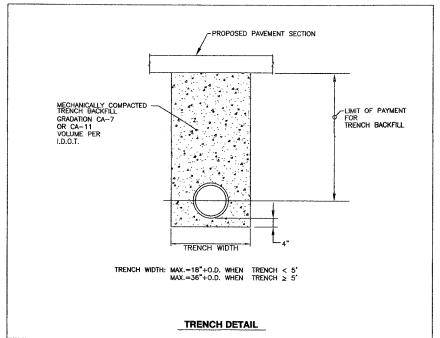

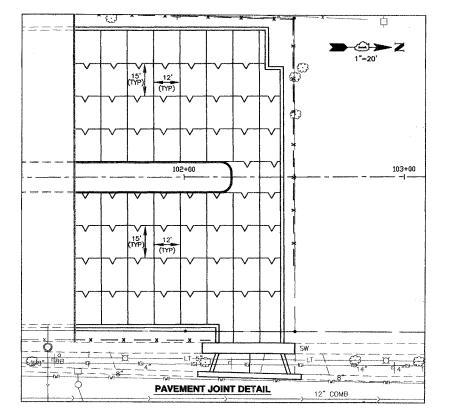

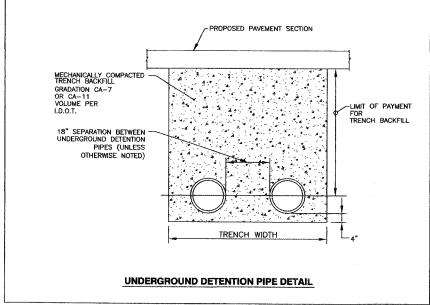


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950 Warrenville Road, Suite 101, Lisle, Illinois 60532 Tel. (630) 719-7570 · Fax (630) 719-7589	SCA
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ILLINOIS DEPARTMENT OF TRANSPORTATION
F.A.U. ROUTE 2689
WOLF ROAD COMMUTER PARKING FACILITY EXPANSION


CONSTRUCTION DETAILS

DRAWN BY: BCD CHECKED BY: JDM

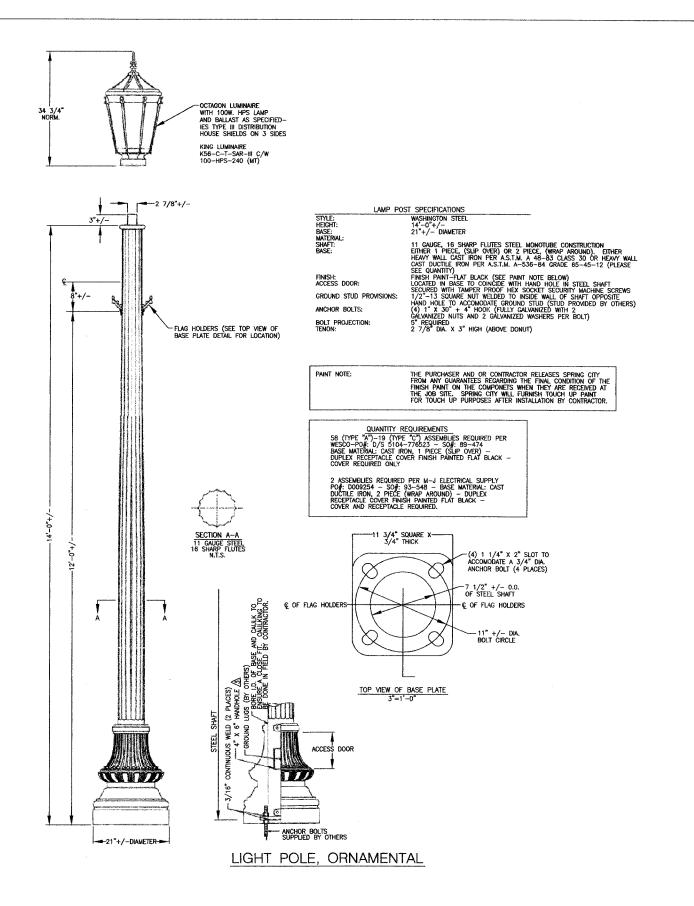

F.A.U RTE.	SECTION	COUNTY	TOTAL SHEETS	SHEET NO.
2689	06-00087-00-PK	COOK	18	14
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	ILLIN	OIS FED. AID	PROJECT	


CONTRACT NO. 63 457

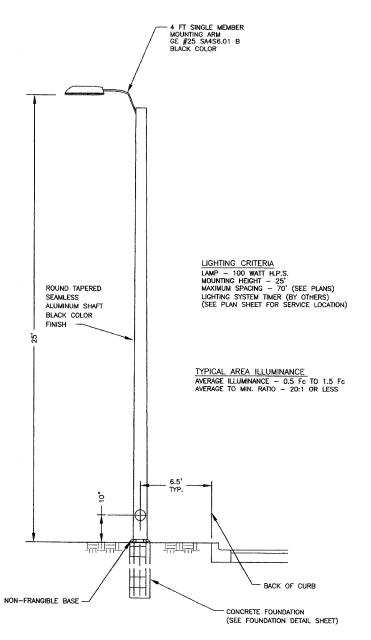

LIGHT POLE, SPECIAL

		REVISIONS NAME	DATE	F.A.U.	NT OF TRANSPORTATION ROUTE 2689 PARKING FACILITY EXPANSION
				LIGHTIN	IG DETAILS
JJB 950 Wa	ES J. BENES & ASSOCIATES, INC. trenville Road, Suite 101, Lisle, Illinois 60532 Fel. (630) 719-7570 · Fax (630) 719-7589			SCALE: 1"=20' DATE:	DRAWN BY: BCD CHECKED BY: JDM


	FOUNDATION SCHEDULE	
אַד	PE OF SOILS	
DESCRIPTION	STANDARDS	EMBEDMENT
SOFT CLAY	Qu = 0.25 to 0.50 tons/sq ft	9' - 8"
MEDIUM CLAY	Qu = 0.50 to 1.00 tons/sq ft	7' 0"
DENSE CLAY	Qu = 1.00 to 2.00 tons/sq ft	6' - 0"
LOOSE SAND	N = 4 TO 10	7' - 8"
MEDIUM SAND	N = 10 TO 30	6' 6"
DENSE SAND	N = 30 TO 50	6' - 0"

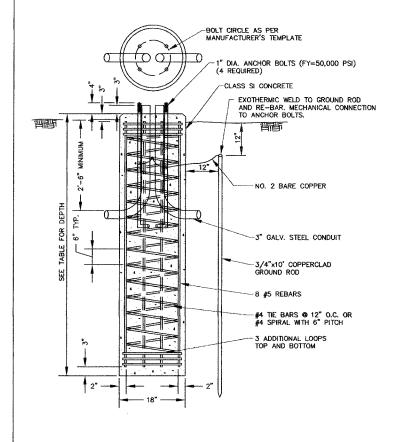


NOTES

- CONCRETE SHALL BE CLASS SI WITH A MINIMUM COMPRESSIVE STRENGTH OF 3500 PSI.
- REINFORCING BARS SHALL BE NEW BILLET STEEL (ASTM A615), FY=60,000 PSI, DEFORMED PER ASTM A307.
- 3. THE HOLE FOR THE FOUNDATION SHALL BE AUGERED.
- THE TOP 10" OF THE ANCHOR BOLTS SHALL BE GALVANIZED. EACH ANCHOR BOLT SHALL BE SUPPLIED WITH TWO FLAT GALVANIZED STEEL WASHERS.

LIGHT POLE FOUNDATION

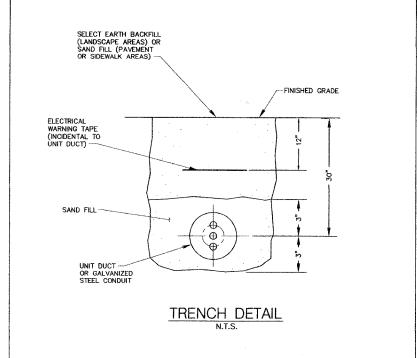

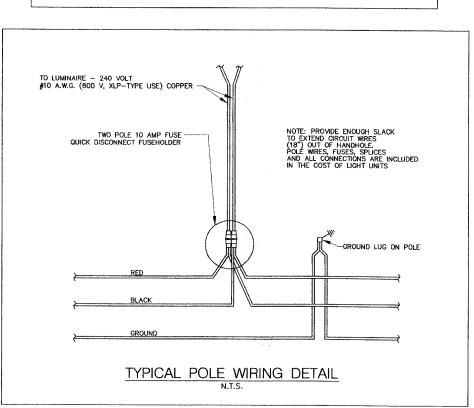

2689	06-00087-00-PK	COOK	18	15
STA.	L	TO STA.		·
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CONTRACT NO. 6305

		NAME	DATE
	JAMES J. BENES & ASSOCIATES, INC.		-
JJB	950 Warrenville Road, Suite 101, Lisle, Illinois 60532 Tel. (630) 719-7570 · Fax (630) 719-7589		
<u> </u>			

REVISIONS


ILLINOIS DEPARTMENT OF TRANSPORTATION
F.A.U. ROUTE 2689
WOLF ROAD COMMUTER PARKING FACILITY EXPANSION


LIGHTING DETAILS


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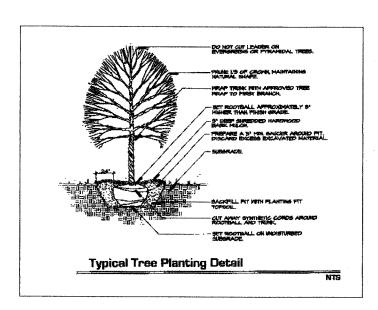
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CONTRACT NO. 63057





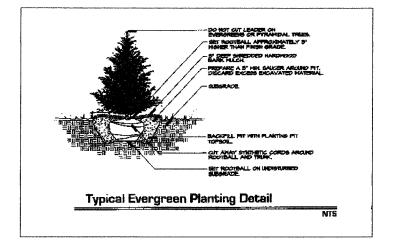

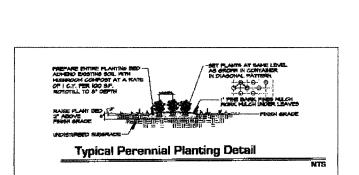
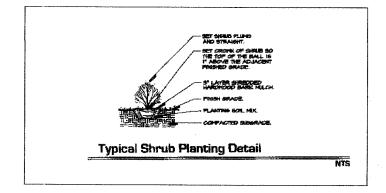
### GENERAL NOTES:

- Contractor shall verify underground utility lines and is responsible for any damage.
- The contractor shall avoid all existing utilities underground and overhead where applicable. Where underground utilities exist, field adjustments must be approved by the landscape architect prior to installation.
- Contractor shall verify all existing conditions in the field prior to construction and shall notify landscape architect of any variance.
- Material quantities shown are for contractor's convenience only. The contractor
  must verify all material and supply sufficient material to complete the job per
  plan.
- Work shall conform to American Standard for Nursery Stock, State of Illinois Horticultural Standards, and Local Municipal requirements.
- The landscape architect reserves the right to inspect trees and shrubs either at
  place of growth or at site before planting, for compliance with requirements of
  variety, size and quality.
- The landscape architect reserves the right to reject landscape material on site whether stock piled or installed in place.
- All plants shall be planted per the landscape pian and specifications. Planting not found to be in compliance shall be replanted correctly at no additional expense to the owner.
- Fine grade, fertilize and sod/seed all disturbed areas within the construction limits as shown. All areas shall drain completely and shall not pond or puddle.
- 10. Where planting beds meet turf areas, the contractor shall provide a cultivated edge. Mulch all shrub beds to the line shown.
- For trees planted in turf areas, provide a 3'-0" diameter mulch ring (remove existing turf) to a depth of 2" thick, with a cultivated edge.
- An approved pre-emergent herbicide shall be applied in all planting beds at a rate specified by manufacturer for each plant variety.
- Contractor shall secure and pay for all permits, fees, and inspections necessary for the proper execution of this work and comply with all codes applicable to this work
- 14. Parking lot island to have a minimum of 12" topsoil and a12" crown.

		-
JAMES J. BENES & ASSOCIATES, INC.		
950 Warrenville Road, Suite 101, Lisle, Illinois 60532 Tel. (630) 719-7570 · Fax (630) 719-7589		
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ILLINOIS DEPARTMENT OF TRANSPORTATION
F.A.U. ROUTE 2689
WOLF ROAD COMMUTER PARKING FACILITY EXPANSION

LANDSCAPE DETAILS

SCALE: 1"=10' DATE: DRAWN BY: BCD CHECKED BY: JDS

COUNTY TOTAL SHEET NO. F.A.U SECTION 2689 06-00087-00-PK COOK 18 TO STA. ILLINOIS FED. AID PROJECT TYPE III BARRICADES WITH TWO FLASHING AMBER LIGHTS ON EACH. CABHA TYPE I OR TYPE II BARRICADES WITH ONE FLASHING AMBER LIGHT ON EACH, OR TYPE III BARRICADES WITH TWO FLASHING 200'± (60 m±)-AMBER LIGHTS ON EACH. DRIVEWAY WORK AREA I 200'± (60 m±) 09) STREET; COLLECTOR LIMIT> 40 MPH W20-1(0) ROAD CONSTRUCTION SPEED M6-4(0)-2115 M6-1(0)-2115

### TRAFFIC CONTROL AND PROTECTION FOR SIDE ROADS, INTERSECTIONS, AND DRIVEWAYS

### NOTES:

- A. FOR NO LANE RESTRICTION ON THE SIDE ROAD OR DRIVEWAYS
- 1. SIDE ROAD WITH A SPEED LIMIT OF 40 MPH (60 km/h) OR LESS AS SHOWN ON THE DRAWING AND AS DIRECTED BY THE ENGINEER:
- Q) ONE ROAD CONSTRUCTION AHEAD SIGN 36 x 36 (900x900) WITH A FLASHER AND FLAG MOUNTED ON IT APPROXIMATELY 200 (60 m) IN ADVANCE OF THE MAIN ROUTE.
- b) THE CLOSED PORTION OF THE MAIN ROUTE SHALL BE PROTECTED BY BLOCKING WITH TYPE I, TYPE II OR TYPE III BARRICADES, 1/3 OF THE CROSS SECTION OF THE CLOSED PORTION.
- 2. SIDE ROAD WITH A SPEED LIMIT GREATER THAN 40 MPH (60 km/h) AS SHOWN ON THE DRAWING AND AS DIRECTED BY THE ENGINEER:
- a) ONE ROAD CONSTRUCTION AHEAD SIGN 48 × 48 (1.2 m × 1.2 m) WITH A FLASHER MOUNTED ON IT APPROXIMATELY 500' (150 m) IN ADVANCE OF THE MAIN ROUTE.
- b) THE CLOSED PORTION OF THE MAIN ROUTE SHALL BE PROTECTED BY BLOCKING WITH TYPE III BARRICADES, 1/2 OF THE CROSS SECTION OF THE CLOSED PORTION.
- 3. WHEN THE SIDE ROAD LIES BETWEEN THE BEGINNING OF THE MAINLINE SIGNING AND THE WORK ZONE, A SINGLE HEADED ARROW (MG-1) SHALL BE USED IN LIEU OF THE DOUBLE HEADED ARROW (MG-4).

- B. FOR A LANE CLOSURE ON A SIDE ROAD OR DRIVEWAY:
- USE APPLICABLE PORTIONS OF THE TYPICAL APPLICATION OF TRAFFIC CONTROL DEVICES (STD. 701501, STD. 701606 OR THE APPROPRIATE STANDARD).
  THE SPACING OF SIGNS AND BARRICADES SHALL BE ADJUSTED FOR FIELD
  CONDITIONS AS DIRECTED BY THE ENGINEER. THE DIRECTIONAL ARROW SHALL BE COVERED OR REMOVED WHEN NO LONGER CONSISTENT WITH THE SIDE ROAD LANE CLOSURE.
- C. ADVANCE WARNING SIGNS ARE TO BE OMITTED ON DRIVEWAY UNLESS OTHERWISE NOTED.
- D. THE TRAFFIC CONTROL AND PROTECTION FOR SIDE ROADS, INTERSECTIONS, AND DRIVEWAYS SHALL BE INCIDENTAL TO THE COST OF SPECIFIED TRAFFIC CONTROL STANDARDS OR ITEMS.

All dimensions are in millimeters (inches) unless otherwise shown.

REVISIO	NS	
NAME	DATE	
LHA	6/89	TF
T. RAMMACHER	09/08/94	
J. OBERLE	10/18/95	
A. HOUSEH	03/06/96	S
A. HOUSEH	10/15/96	3
T. RAMMACHER	01/06/00	
		SCA
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ILLINOIS DEPARTMENT OF TRANSPORTATION RAFFIC CONTROL AND PROTECTION FOR SIDE ROADS, INTERSECTIONS, AND DRIVEWAYS


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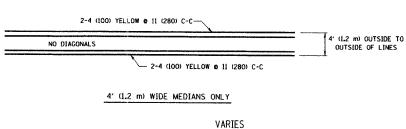
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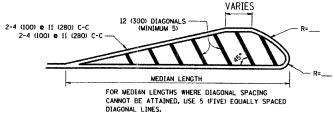
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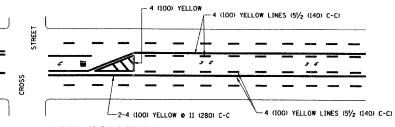







DIAGONAL LINE SPACING: 50' (15 m) C-C (LESS THAN 30MPH (50 km/h)) 75' (25 m) C-C 30MPH (50 km/h) TO 45MPH (70 km/h)) 150' (45 m) C-C (MORE THAN 45MPH (70 km/h))

### MEDIANS OVER 4' (1.2 m) WIDE

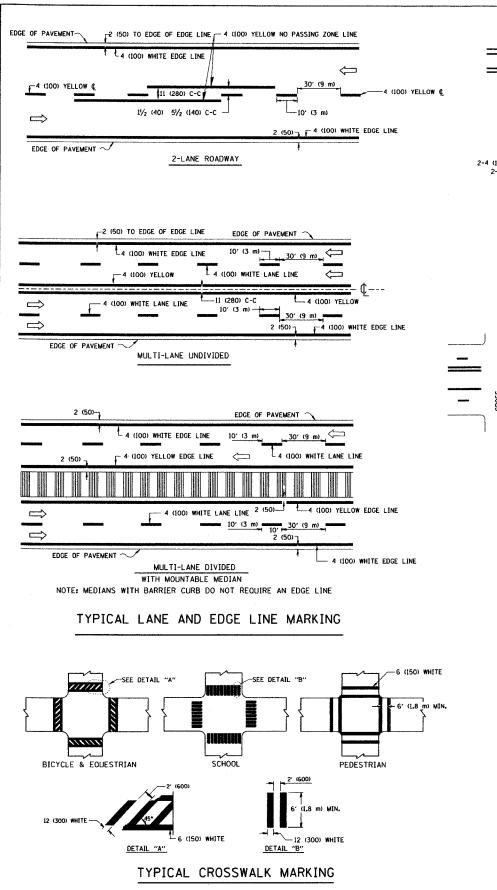


A MINIMUM OF TWO PAIRS OF TURN ARROWS SHALL BE USED, WHITE IN COLOR. ADDITIONAL PAIRS SHALL BE PLACED AT 200' (60 m) TO 300' (90 m) INTERVALS.

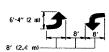

MEDIAN WITH TWO-WAY LEFT TURN LANE

### TYPICAL PAINTED MEDIAN MARKING

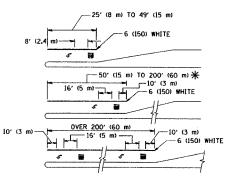


FULL SIZE LETTERS 8' (2.4 m) AND ARROWS SHALL BE USED.  $\P$  AREA = 15.6 SO. FT. (1.5 m<sup>2</sup>)  $\P$  AREA = 20.8 SQ. FT. (1.9 m<sup>2</sup>)

 $\divideontimes$  Turn lanes in excess of 400' (120 m) in length may have an additional set of arrow - "Only" installed midway between the other two sets of

TYPICAL LEFT (OR RIGHT) TURN LANE

### TYPICAL TURN LANE MARKING

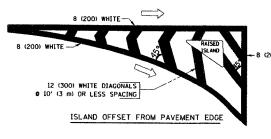

CONTRACT NO. COUNTY TOTAL SHEET NO. F.A.U SECTION 2689 06-00087-00-PK COOK 18 TO STA. ILLINOIS FED. AID PROJECT

8 (200) WHITE --- 2 (50) RAISED ISLAND ISLAND AT PAVEMENT EDGE

### TYPICAL ISLAND MARKING

TYPE OF MARKING	WIDTH OF LINE	PATTERN	COLOR	SPACING / REMARKS
CENTERLINE ON 2 LANE PAVEMENT	4 (100)	SKIP-DASH	YELLOW	10' (3 m) LINE WITH 30' (9 m) SPACE
CENTERLINE ON MULTI-LANE UNDIVEDED PAVEMENT	2 @ 4 (100)	SOLID	YELLOW	11 (280) C-C
NO PASSING ZONE LINES: FOR ONE DIRECTION FOR BOTH DIRECTIONS	4 (100) 2 @ 4 (100)	SOLID SOLID	YELLOW YELLOW	5½ (140) C-C FROM SKIP-DASH CENTERLINE 11 (280) C-C OMIT SKIP-DASH CENTERLINE BETWEEN
LANE LINES	4 (100) 5 (125) ON FREEWAYS	SKIP-DASH SKIP-DASH	WHITE WHITE	10' (3 m) LINE WITH 30' (9 m) SPACE
DOTTED LINES (EXTENSIONS OF CENTER, LANE OR TURN LANE MARKINGS)	SAME AS LINE BEING EXTENDED	SKIP-DASH	SAME AS LINE BEING EXTENDED	2' (600) LINE WITH 6' (1.8 m) SPACE
EDGE LINES	4 (100)	SOLID	YELLOW-LEFT WHITE-RIGHT	OUTLINE MOUNTABLE MEDIANS IN YELLOW: EDGE LINES ARE NOT USED NEXT TO BARRIER CURB
TURN LANE MARKINGS	6 (150) LINE; FULL SIZE LETTERS & SYMBOLS (8' (2.4m))	SOLID	WHITE	SEE TYPICAL TURN LANE MARKING DETAIL
TWO WAY LEFT TURN MARKING	2 e 4 (100) EACH DIRECTION	SKIP-DASH AND SOLID	YELLOW	10' (3 m) LINE WITH 30' (9 m) SPACE FOR SKIP-DASH; 5½ (140) C-C BETWEEN SOLID LINE AND SKIP-DASH LINE
	8' (2.4m) LEFT ARROW	IN PAIRS	WHITE	SEE TYPICAL TWO-WAY LEFT TURN MARKING DETAIL
CROSSWALK LINES (PEDESTRIAN) A. DIAGONALS (BIKE & EQUESTRIAN) B. LONGITUDINAL BARS (SCHOOL)	2 e 6 (150) 12 (300) e 45° 12 (300) e 90°	SOLID SOLID	WHITE WHITE WHITE	NOT LESS THAN 6' (1.8 m) APART 2' (500) APART 2' (500) APART SEE TYPICAL CROSSWALK MARKING DETAILS.
STOP LINES	24 (600)	SOLID	WHITE	PLACE 4' (1.2 m) IN ADVANCE OF AND PARALLEL TO (ROSSMALK, IF PRESENT. OTHERNISE, PLACE AT DESIRED STOPPING POINT. PARALLEL TO CROSSROAD CENTERLINE, WHERE POSSIBLE
PAINTED MEDIANS	2 @ 4 (100) WITH 12 (300) DIAGONALS	SOLID	YELLOW: TWO WAY TRAFFIC	11 (280) C-C FOR THE DOUBLE LINE
	0 45° NO DIAGONALS USED FOR 4' (1.2 m) WIDE MEDIANS		WHITE: ONE WAY TRAFFIC	SEE TYPICAL PAINTED MEDIAN MARKING.
GORE MARKING AND CHANNELIZING LINES	8 (200) WITH 12 (300) DIAGONALS @ 45°	SOLID	WHITE	DIAGONALS: 15' (4.5 m) C-C (LESS THAN 30MPH (50 km/h)) 20' (6 m) C-C 30MPH (50 km/h) TO 45MPH (70 km/h); 30' (9 m) C-C (0VER 45MPH (70 km/h))
RAILROAD CROSSING	24 (600) TRANSVERSE LINES: "RR" IS 6' (1.8 m) LETTERS: 16 (400) LINE FOR "X"	SOLID	WHITE	SEE STATE STANDARD 780001 AREA OF: "R"=3.6 SO. FT. (0.33 m <sup>2</sup> ) EACH "X"=54.0 SO. FT. (5.0 m <sup>2</sup> )
SHOULDER DIAGONALS	12 (300) <b>e</b> 45°	SOLID	WHITE - RIGHT YELLOW - LEFT	50' (15 m) C-C (LESS THAN 30MPH (50 km/h)) 75' (25 m) C-C (30 MPH (50 km/h) TO 45MPH (70 km/l) 1150' (45 m) C-C (0VER 45MPH (70 km/h))

FOR FURTHER DETAILS ON PAVEMENT MARKING REFER TO STANDARD SPECIFICATIONS FOR ROAD AND BRIDGE CONSTRUCTION AND STATE STANDARD 780001.

All dimensions are in inches (millimeters) unless otherwise shown.

REVISIO	
NAME	DATE
VERS	03-19-90
T. RAMMACHER	10-27-94
ALEX HOUSEH	10-09-96
ALEX HOUSEH	10-17-96
rammacher	01-06-00

DISTRICT ONE TYPICAL PAVEMENT MARKINGS

ILLINOIS DEPARTMENT OF TRANSPORTATION

DRAWN BY CADD CHECKED BY

TC-13

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