SHEET DESCRIPTION

COVER SHEET, INDEX, HIGHWAY STANDARDS

GENERAL NOTES

SUMMARY OF QUANTITIES

4-8 ALIGNMENT PLANS, SURVEY TIES AND CONTROL POINTS

3-10 MAINTENANCE OF TRAFFIC

11-14 EXISTING CONDITIONS AND UTILITIES PLAN

15-16 WATER SERVICE LINE PLAN

17-20 35TH ST. GATEWAY LANDSCAPE PLAN

21-22 35TH ST. GATEWAY LAYOUT

23 35TH ST. GATEWAY IRRIGATION PLAN 24 35TH ST. GATEWAY LANDSCAPE DETAILS

25 35TH ST. GATEWAY OVERALL PLANT LIST

26 EROSION CONTROL PLAN

27-30 CIVIL DETAILS

31-38 DISTRICT ONE DETAILS

# **IDOT HIGHWAY STANDARDS**

STANDARD

DESCRIPTION

000001-*05* 001006

STANDARD SYMBOLS, ABBREVIATIONS, AND PATTERNS
DECIMAL OF AN INCH AND OF A FOOT

606001-03

CONCRETE CURB TYPE B AND COMBINATION CONCRETE CURB AND GUTTER
'OFF-RD OPERATIONS, MULTILANE 45M (15') TO 600mm (24") FROM PAVEMENT EDGE'

701601*-05* 

URBAN LANE CLOSURE, MULTILANE, 1W OR 2W WITH NONTRAVERSABLE MEDIAN URBAN LANE CLOSURE. MULTILANE INTERSECTION

701701*-05* 701801*-03* 

701101-01

LANE CLOSURE MULTILANE 1W OR 2W CROSSWALK OR SIDEWALK CLOSURE

701901

TRAFFIC CONTROL DEVICES

# STATE OF ILLINOIS

DEPARTMENT OF TRANSPORTATION
DIVISION OF HIGHWAYS

# PLANS FOR PROPOSED FEDERAL AID HIGHWAY

F.A.I. ROUTE 90/94 (DAN RYAN EXPRESSWAY)
SECTION 2005-073 LS

PROJECT: IM-0005 (587)

**GATEWAY LANDSCAPING & IRRIGATION at 35TH STREET** 

C-91-109-06

# PROJECT LOCATED IN CITY OF CHICAGO

# **DESIGN DESIGNATION**


LA SALLE ST: 8275 (20) URBAN COLLECTOR

ADT DESIGN POSTED

FRONTAGE ROAD:

LA SALLE ST WENTWORTH AVE 15,000 15,000

000 30 2

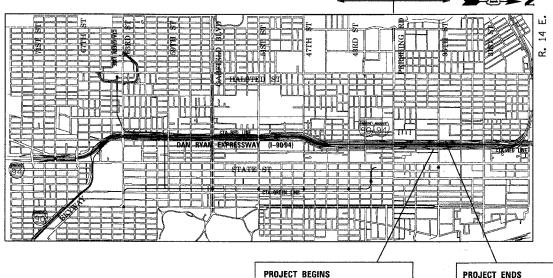

100' 200' 300' -- 1" = 100' 100' 20' 30' -- 1" = 100' 100' 10' 1" = 50' 100' 1" = 40' 100' 1" = 30' 100' 1" = 30' 100' 1" = 20'

ENGINEERING SCALES. REDUCED SIZED PLANS WILL NOT CONFORM TO STANDARD SCALES. IN MAKING MEASUREMENTS ON REDUCED PLANS, THE ABOVE SCALES MAY BE USED.

BEFORE EXCAVATING CALL: CHICAGO UTILITY ALERT NETWORK (312) 744–7000

CONTRACT NO. 60A79

LOCATION MAP

NB LA SALLE ST STA 420+35

SB WENTWORTH AVE STA 122+65

GROSS LENGTH OF PROJECT = 2,025 FT (0.384 MILES)

NET LENGTH OF PROJECT = 2,025 FT (0.384 MILES)

NB LA SALLE ST STA 430+50
SB WENTWORTH AVE STA 132+75

BOWMAN, BARRETT & ASSOCIATES INC.
CONSULTING ENGINEERS

Chicago, Illinois 312.228.0100 www.bbandainc.com

ALI SECTION COUNTY TOTAL SHEET NO. 10/94 2005-073 LS COOK 38 1 00A79



DIVISION OF HIGHWAYS

SUBMITTED MARCH 21, 20 08

DEPUTY DIRECTOR OF HIGHWAYS, REGION ENGINEER

May 9, 20 08

Eru & Har M.D

Jalam ENGINEER OF DESIGN AND ENVIRONMENT

STATE OF ILLINOIS
DEPARTMENT OF TRANSPORTATION

PRINTED BY THE AUTHORITY OF THE STATE OF ILLINOIS

\22F SHEETS\560 22FC0VER.dgn 3/14/2008 2: 06: 04 PM

F.A.I.	SECTIO	N	COUNTY		TOTAL SHEETS	SHEET NO.
94/90	*		соок		38	2
STA.		T	O STA.			
FED. RO	AD DIST. NO.	ILLINO	IS FED.	AID	PROJECT	
60A7	9			* 2	005-073	LS

\* 200

### **GENERAL NOTES:**

- 1. THE CONTRACTOR SHALL COORDINATE ALL ACTIVITIES WITH:

  CONTRACT 60A05 SB FENCE AND GATES FROM 47TH PLACE TO 31ST ST

  CONTRACT 60A04 NB FENCE AND GATES FROM 47TH PLACE TO 31ST ST.
  - CONTRACT 62992 NB KNEE WALLS (PERSHING RD TO 35TH ST)
  - CONTRACT 62998 SB KNEE WALLS (PERSHING RD TO 35TH ST) CONTRACT 62999 SB KNEE WALLS (35TH ST TO 33RD ST)
  - CONTRACT 62301 RECONSTRUCTION OF NORTHBOUND LOCAL LANES AND RAMPS
    BETWEEN GARFIELD BOULEVARD AND 31ST ST.
  - CONTRACT 62303 RECONSTRUCTION OF SOUTHBOUND LOCAL LANES AND RAMPS
    RETWEEN CARFIELD ROLLEFVARD AND 31ST ST
  - CONTRACT 62583 LIGHTING AND SURVEILLANCE 31ST ST TO I-57 INTERCHANGE
- 2. CONTRACTOR SHALL MATCH ALL WORK COMPLETED IN THE ABOVE CONTRACTS.
- 3. THE LOCATIONS OF EXISTING UTILITIES, AS SHOWN ON THE DRAWINGS, REPRESENT DATA RECEIVED FROM VARIOUS SOURCES. IT IS NOT GUARANTEED TO BE CORRECT OR ALL INCLUSIVE. THE CONTRACTOR MUST CONDUCT HIS OWN INVESTIGATIONS INTO THE LOCATION, SIZE, DEPTH, AND NATURE OF ANY AND ALL EXISTING UTILITIES WHICH MAY IMPACT THE WORK UNDER THIS CONTRACT. ANY EXISTING UTILITIES WHICH ARE TO REMAIN IN SERVICE MUST BE FULLY PROTECTED BY THE CONTRACTOR AND ANY DAMAGE CAUSED BY THE CONSTRUCTION MUST BE IMMEDIATELY REPAIRED AT THE CONTRACTOR'S EXPENSE TO THE SATISFACTION OF THE ENGINEER. THE CONTRACTOR WILL BE RESPONSIBLE FOR THE PROTECTION OF ANY AND ALL SURFACE AND UNDERGROUND UTILITIES, EVEN THOUGH THEY MAY NOT BE IDENTIFIED
- 4. THE CONTRACTOR MUST COORDINATE CONSTRUCTION ACTIVITIES WITH THE RESPECTIVE UTILITIES OF THE CITY OF CHICAGO, BEFORE STARTING ANY EXCAVATION, THE CONTRACTOR MUST CALL THE CHICAGO UTILITY ALERT NETWORK (C.U.A.N.) AT (312) 744-7000 OR 811 FOR FIELD LOCATIONS OF BURIED ELECTRICAL, TELEPHONE, CABLE, AND GAS FACILITIES (48 HOURS NOTIFICATION IS REQUIRED). THE CONTRACTOR MUST CONTACT THE CITY OF CHICAGO DEPARTMENT OF WATER MANAGEMENT, PERMIT SECTION AT (312) 747-7893 FOR WATER AND CITY SEWER LOCATIONS.
- 5. THE CONTRACTOR WILL NOT BE ALLOWED TO SET UP A YARD OR FIELD OFFICE ON STATE PROPERTY WITHOUT WRITTEN PERMISSION FROM IDOT.
- 6. WHEN ARTIFICIAL LIGHTING IS USED IN NIGHT OPERATIONS, THE CONTRACTOR MUST EXERCISE THE UTMOST PRECAUTIONS IN PREVENTING ADVERSE VISIBILITY TO THE MOTORING PUBLIC AND ADJOINING COMMERCIAL AND RESIDENTIAL AREAS.
- 7. USE NO. 6 EPOXY-COATED TIE BARS CONFORMING TO ARTICLE 1006.10(B)(2) OF THE STANDARD SPECIFICATIONS FOR TYING THE CURB AND GUTTER SECTIONS TO PAVEMENT AS SHOWN ON THE PLANS. THE TIE BARS WILL NOT BE PAID FOR SEPARATELY. TIE BARS USED WITH CURB AND GUTTER MUST BE INCLUDED IN THE COST OF THE COMBINATION CONCRETE CURB AND GUTTER OF THE TYPE SPECIFIED.
- 8. CHAIN LINK FENCE REMOVAL MUST BE CONSIDERED AS PART OF CLEARING.
- 9. IT MUST BE THE CONTRACTOR'S RESPONSIBILITY TO ENSURE THAT NO GAP REMAINS BETWEEN PROPOSED KNEE WALLS OR WHERE PROPOSED KNEE WALL TERMINATES AND EXISTING FENCE REMAINS IN PLACE.
- 10. THE CONTRACTOR MUST TAKE ALL NECESSARY SAFETY PRECAUTIONS TO PROTECT AND PROVIDE ACCESS TO ABUTTING PROPERTY, UTILITIES, PEDESTRIANS, AND VEHICULAR TRAFFIC.
- 11. WHERE SECTION OR SUBSECTION MONUMENTS ARE ENCOUNTERED, THE ENGINEER MUST BE NOTIFIED BEFORE SUCH MONUMENTS ARE REMOVED. THE CONTRACTOR MUST PROTECT AND CAREFULLY PRESERVE ALL PROPERTY MARKS AND MONUMENTS. THE ENGINEER OR AN AUTHORIZED SURVEYOR AGENT WILL WITNESS OR OTHERWISE REFERNCE AND RESET MONUMENTS AS NECESSARY. ALL PROPERTY CORNERS EXCEPT THOSE WITHIN AREAS WHERE THE SCHEDULE, IF PROVIDED, SHOWS PLACEMENT OF R.O.W. MARKERS MUST REMAIN LINDISTURBED.
- 12. ALL ELEVATIONS IN THIS PLAN SET ARE BASED ON THE CHICAGO CITY DATUM. THE CONVERSION EQUATION FROM CCD TO NAVD 88 IS: NAVD 88 ELEVATION = CCD + 579.19.

- 13 BARRICADES: THE CONTRACTOR MUST PROVIDE AND INSTALL TWO WEIGHTED SANDBAGS ON EACH TYPE I OR TYPE II BARRICADE USED ONE WEIGHTED SANDBAG ACROSS EACH BOTTOM RAIL, ALL TYPE III BARRICADES REQUIRE A MINIMUM OF FOUR SANDBAGS PER BARRICADE.
- 14. SUPERSTRUCTURE RATING COARSE AGGREGATE MUST BE USED IN THE CONCRETE BARRIER WALL CONCRETE MIXTURE.
- 15. LOCATIONS OF ACCESS CONTROL FENCING AS SHOWN ON THE PLANS MAY BE ADJUSTED AS DIRECTED BY THE ENGINEER TO BETTER FIT FIELD CONDITIONS.
- 16. THE LOCATION OF VARIOUS ITEMS SUCH AS PAVEMENT, BARRIER WALLS, ELECTRICAL SYSTEMS AND DRAINAGE STRUCTURES BUILT IN CONTRACTS UNDER CONSTRUCTION DURING THE PREPARATION OF THESE PLANS IS BASED ON THE PUBLISHED CONTRACT PLAN DRAWINGS AVAILABLE DURING DESIGN. THE CONTRACTOR MUST FIELD VERIFY LIMITS. LOCATIONS AND ELEVATIONS OF THESE PREVIOUSLY CONSTRUCTED ITEMS.
- 17. CRUSHING PLANT AND CONCRETE PLANT LOCATIONS REQUIRE CITY OF CHICAGO APPROVAL,
- 18. THE CONTRACTOR IS ALERTED THAT THERE ARE EXISTING CTA UTILITY FACILITIES WITHIN, ADJACENT TO, AND CROSSING UNDER THE EXPRESSWAY FROM THE FRONTAGE ROADS TO THE CTA OPERATING AREA. THE EXACT LOCATION OF THESE FACILITIES IS NOT KNOWN. THE CONTRACTOR MUST CONTACT THE CTA AT 312-681-3860 FOR LOCATIONS OF THESE FACILITIES BEFORE PROCEEDING WITH ANY WORK WITHIN OR ADJACENT TO THE CTA OPERATING AREA. FOR ADDITIONAL INFORMATION REGARDING BURIED CONDUITS, CONTACT MR. RICK STRAUBEL, MANAGER TECH SUPPORT. AT 312-922-0508.
- 19. THE CONTRACTOR MUST USE CARE IN GRADING OR EXCAVATING NEAR ANY AND ALL EXISTING ITEMS THAT WILL NOT BE REMOVED. ANY DAMAGE DONE TO EXISTING ITEMS BY THE CONTRACTOR MUST BE REPAIRED BY THE CONTRACTOR AT THE CONTRACTOR'S OWN EXPENSE.
- O. THE CONTRACTOR MUST MAINTAIN THE SURFACE DRAINAGE OF ALL ROADWAYS DURING CONSTRUCTION OF THIS PROJECT. WHEN EXISTING DRAINAGE FACILITIES ARE DISTURBED. THE CONTRACTOR MUST PROVIDE AND MAINTAIN TEMPORARY OUTLETS AND CONNECTIONS FOR ALL PRIVATE OR PUBLIC DRAINS, SEWERS, AND CATCH BASINS. THE CONTRACTOR MUST PROVIDE FACILITIES TO TAKE IN ALL STORM WATER WHICH WILL BE RECEIVED BY THESE DRAINS AND SEWERS AND DISCHARGE THE SAME. THE CONTRACTOR MUST PROVIDE AND MAINTAIN A TEMPORARY OUTLET AND BE PREPARED AT ALL TIMES TO DISPOSE OF THE WATER RECEIVED FROM THESE TEMPORARY CONNECTIONS UNTIL INSTALLATION IS COMPLETE INCLUDING PAVEMENT. THIS WORK MUST NOT BE PAID FOR SEPERATELY BUT MUST BE CONSIDERED INCLUDED IN THE COST OF THIS CONTRACT.
- 21. THE CONTRACTOR SHALL TAKE ALL NECESSARY PRECAUTIONS FOR THE PROTECTION OF EXISTING PLANT MATERIAL FOR WHICH THE CONTRACT DOES NOT PROVIDE REMOVAL. THE PROTECTION OF EXISTING PLANT MATERIAL AND THE REPAIR OR REPLACEMENT OF EXISTING PLANT MATERIAL DAMAGED BY THE CONTRACTOR SHALL BE DONE IN ACCORDANCE WITH THE REQUIREMENTS OF SECTION 201 OF THE STANDARD SPECIFICATIONS.
- 22. ALL RELOCATION OF EXISTING SIGNS IN CONFLICT WITH PROPOSED CONSTRUCTION SHALL CONFORM TO ARTICLE 107.25 OF THE STANDARD SPECIFICATIONS. EXISTING SIGNS TO BE RELOCATED IN PROPOSED CONCRETE MEDIAN SURFACE SHALL BE INSTALLED USING A SLEEVE OR BY CORING THE CONCRETE MEDIAN SURFACE. THE SLEEVE AND CORING OPERATIONS SHALL BE AS DIRECTED AND APPROVED BY THE ENGINEER. EXISTING SIGNS TO BE RELOCATED ONTO PROPOSED KNEE WALL FOOTINGS SHALL BE INSTALLED ACCORDING TO SECTIONS 728 AND 731 OF THE STANDARD SPECIFICATIONS. LABOR AND MATERIALS FOR RELOCATION OF EXISTING SIGNS WILL NOT BE MEASURED FOR PAYMENT, BUT SHALL BE INCLUDED IN THE COST OF THE FLUTED KNEE WALL.
- 23. THE INTENT OF THE CONTRACT DOCUMENTS IS TO CONSTRUCT THE FLUTED KNEE WALL BEHIND THE EXISTING CURB AND GUTTER. ANY DAMAGE TO THE EXISTING CURB AND GUTTER SHALL BE REPAIRED TO THE ORIGINAL CONDITION OF THE CURB AND GUTTER BY THE CONTRACTOR AT THE CONTRACTOR'S EXPENSE.
- 24. THE CONTRACTOR SHALL SHOW PROOF OF PROCUREMENT, SOURCES, QUANTITIES AND VARIETIES FOR ALL SHRUPS, TREES, GROUND COVERS, PERENNIAL AND ORNAMENTAL GRASSES WITHIN 21 DAYS FOLLOWING THE AWARD OF CONTRACT. TIMELY PROCUREMENT OF ALL PLANT MATERIAL IS ESSENTIAL TO THE SUCCESSFUL COMPLETION AND SUBSTANTIAL COMPLETION ACCEPTANCE OF THE OVERALL PROJECT.

#### GENERAL NOTES: CITY OF CHICAGO

- IN CASE OF DAMAGE TO CITY OF CHICAGO SEWERS, PRIVATE AND PUBLIC DRAINS, SEWER STRUCTURES AND/OR BENCH MONUMENTS, THE CONTRACTOR MUST IMMEDIATELY CONTACT THE DEPARTMENT OF WATER MANAGEMENT AT (312) 747-7892 OR (312) 747-7893.
- BENCH MONUMENT LOCATIONS WITHIN THE LIMITS OF THE IMPROVEMENT CAN BE OBTAINED FROM THE DEPARTMENT OF WATER MANAGEMENT AT 333 SOUTH STATE STREET, SUITE 410, CHICAGO, IL 60604. THE CONTRACTOR IS RESPONSIBLE FOR THE COST OF REPLACING ANY BENCH MONUMENT DAMAGED OR DESTROYED DURING CONSTRUCTION.
- 3. IN LOCATIONS WHERE THE MAIN SEWERS, DRAINAGE STRUCTURES, PUBLIC, AND PRIVATE DRAIN CONNECTIONS ARE DISTURBED OR DAMAGED DURING CONSTRUCTION BY THE CONTRACTOR, IT WILL BE THE CONTRACTOR'S RESPONSIBILITY TO RESTORE AND REPLACE THE DAMAGED FACILITIES AT HIS/HER OWN EXPENSE TO THE SATISFACTION OF THE DEPARTMENT OF WATER MANAGEMENT. THE SEWER FLOWS MUST BE MAINTAINED AT ALL TIMES.
- 4. EXTREME CAUTION IS TO BE TAKEN TO ENSURE THAT NO FACILITY OWNED AND MAINTAINED BY THE DEPARTMENT OF WATER MANAGEMENT IS DAMAGED DURING CONSTRUCTION. IF ANY DAMAGE OCCURS TO ANY FACILITIES, THE CONTRACTOR WILL BE HELD RESPONSIBLE FOR THE COST OF REPAIRING OR REPLACING THEM.
- 5. CITY OF CHICAGO WATER VALVE VAULTS AND SEWER STRUCTURES MUST NOT BE CLOSED, COVERED OR OTHERWISE OBSTRUCTED DURING CONSTRUCTION WITHOUT WRITTEN PERMISSION FROM THE CITY OF CHICAGO DEPARTMENT OF WATER MANAGEMENT.
- THE CHICAGO TRANSIT AUTHORITY (CTA) HAS BUS OPERATIONS ALONG WENTWORTH AVENUE/WELLS STREET. THE CONTRACTOR MUST INFORM THE CTA REPRESENTATIVE MS. CHARLENE RIFFER (GENERAL MANAGER CONSTRUCTION) OF THE ON-GOING PROJECT SCHEDULE STARTING 28 DAYS BEFORE THE START OF CONSTRUCTION AT (312) 681-3851.
- PAVEMENT REPLACEMENT AROUND FRAMES AND GRATES OR LIDS WHERE DRAINAGE, WATER MAIN OR ELECTRICAL STRUCTURES ARE ADJUSTED OR RECONSTRUCTED, MUST BE WITH CLASS SI CONCRETE.

#### SPECIAL COMMITMENTS

- THE CONTRACTOR AND THE ENGINEER SHALL SUBMIT THE IRRIGATION SHOP DRAWINGS FOR REVIEW AND APPROVAL BY THE CITY OF CHICAGO - STREETSCAPE UNIT, 4 WEEKS IN ADVANCE, PRIOR TO THE START OF THE IRRIGATION WORK.
- 2. THE CITY OF CHICAGO STREETSCAPE UNIT REPRESENTATIVES SHALL BE INVITED TO PARTICIPATE IN THE CONSTRUCTION PROGRESS MEETINGS. THE MEETINGS SCHEDULE SHALL BE PROVIDED TO THE
- 3. THE CITY OF CHICAGO STREETSCAPE UNIT REPRESENTATIVES SHALL BE AFFORDED THE OPPPORTUNITY TO OBSERVE ALL LANDSCAPE AND IRRIGATION WORK IN COORDINATION WITH AND CONCURRENCE OF THE ENGINEER.
- 4. THE CONTRACTOR AND THE ENGINEER, IN COORDINATION WITH IDOT'S LANDSCAPING REPRESENTATIVE, SHALL PROVIDE A WRITTEN DESCRIPTION OF THE TURN OVER PROCEDURE OF THE IIRIGATION WORK AT THE END OF THE PROJECT TO THE CITY OF CHICAGO STREETSCAPE UNIT.
- 5. THE CITY OF CHICAGO STREETSCAPE UNIT REPRESENTATIVES SHALL BE INVITED BY THE C'ONTRACTOR AND THE ENGINEER TO ATTEND AND PARTICIPATE IN THE FINAL PROJECT INSPECTION.

REVISIONS
NAME
DATE
F.A.I. 94/90 (DAN RYAN EXPRESSWAY)
GATEWAY LANDSCAPING & IRRIGATION @ 35TH

GENERAL NOTES

SCALE: NONE

DRAWN BY: JDC

CHECKED BY: RS

DATE: 03/13/07

BOWMAN, BARRETT & ASSOCIATES INC.
CONSULTING ENGINEERS
Chicago, Illinois
31.228.0100
www.bbandainc.com

F.A.I. SECTION 94/90 • COUNTY TOTAL SHEET NO. STA. TO STA. FED. ROAD DIST. NO. ILLINOIS FED. AID PROJECT

60A79

\* 2005-073 LS

SUMMARY OF QUANTITIES

			URBAN	90% FED 10% STATE		
CODE NO.	ITEM	UNIT	QUANTITY	Y003	Y083	
C2007010	SHRUB, ROSA RADRAZZ (KNOCKOUT ROSE), CONTAINER GROWN, 3-GALLON	EACH	623	623		
C2C03180	SHRUB, FORSYTHIA X INTERMEDIA HAPPY CENTENNIAL (HAPPY CENTENNIAL FORSYTHIA) 18" HEIGHT, CONTAINER	EACH	542	542		
A2005034	TREE, GYMNOCLADUS DIOICUS (KENTUCKY COFFEETREE), 10' HEIGHT, CLUMP FORM, BALLED AND BURLAPPED	EACH	10	10		
C2003353	SHRUB, HEPTACODIUM MICRONOIDES (SEVEN SON FLOWER), 8' HEIGHT, BALLED AND BURLAPPED	EACH	12	12		
C2G04738	SHRUB, PHYSOCARPUS OPULIFOLIUS SUMMER WINE (SUMMER WINE COMMON NINEBARK), 2-1/2' HEIGHT, CONTAINER	EACH	222	222		
A2008618	TREE, ULMUS MORTON GLOSSY (TRIUMPH ELM), 3" CALIPER, BALLED AND BURLAPPED	EACH	10	10		
C2006013	SHRUB, RHUS COPALLINA VAR. LATIFOLIA MORTON (PRAIRIE FLAME SHINING SUMAC), 3' HEIGHT, CONTAINER	EACH	968	968		
X0325962	PERENNIAL PLANTS, ALLIUM BULBS	UNIT	58	58		
25000210	SEEDING, CLASS 2A	ACRE	0.79	0.79		
25000400	NITROGEN FERTILIZER NUTRIENT	POUND	72	72		
25000500	PHOSPHORUS FERTILIZER NUTRIENT	POUND	72	72		
25000600	POTASSIUM FERTILIZER NUTRIENT	FOUND	72	72		
25000750	MOWING	ACRE	2.6	2.6		
25100630	EROSION CONTROL BLANKET	SQ YD	3,824	3,824		
28000510	INLET FILTERS	EACH	34	34		
42001300	PROTECTIVE COAT	SQ YD	297	$\sim$	29	
42400200	SIDEWALK 5 INCH	SQ FT	2476		247	
44000500	COMBINATION CURB AND GUTTER REMOVAL	FOOT	99		99	
44000600	SIDEWALK REMOVAL	SQ FT	2476		247	
56104600	WATER VALVES 2"	EACH	2		2	
56200900	WATER SERVICE LINE 2 1/2"	FOOT	380		380	
66400550	CHAIN LINK FENCE, 4' (SPECIAL)	FOOT	1,971	1,971		
67100100	MOBILIZATION	L ·SUM	1	0.8	0.2	
70101800	TRAFFIC CONTROL AND PROTECTION, (SPECIAL)	L SUM	1	0.6	0.2	
<b>7</b> 8008200	POLYUREA PAVEMENT MARKING TYPE I - LETTERS SYMBOLS	SQ FT	59		59	
78008240	POLYUREA PAVEMENT MARKING TYPE I - LINE 8"	FOOT	61		61	
78008250	POLYUREA PAVEMENT MARKING TYPE I - LINE 12"	FOOT	501		501	
78008270	POLYUREA PAVEMENT MARKING TYPE I - LINE 24"	FOOT	70		70	
B2006320	TREE, SYRINGA RETICULATA IVORY SILK (IVORY SILK JAPANESE TREE LILAC), 2-1/2" CALIPER, TREE FORM,	EACH	32	32		
	BALLED AND BURLAPPED					
B2006374	TREE, SYRINGA RETICULATA IVORY SILK (IVORY SILK JAPANESE TREE LILAC), 10' HEIGHT, CLUMP FORM,	EACH	20	20		
	BALLED AND BURLAPPED					

CODE NO.	ITEM	UNIT	URBAN QUANTITY	Y003	CITY YOOS
	VAR.				
2009001	VINE,—EUONYMUS FORTUNEI COLORATUS (PURPLE LEAF WINTERCREEPER), 1—QUART POT	EACH	2,150	2,150	
0030400	PERENNIAL PLANTS, DAYLILIES	UNIT	23	23	
0030450	PERENNIAL PLANTS, DAFFODIL BULBS	UNIT	86	86	
0030470	PERENNIAL PLANT, ORNAMENTAL GRASS TYPE	UNIT	58	58	 
0301407	PERENNIAL PLANTS, GALLON POT	UNIT	63	63	
0322256	TEMPORARY INFORMATION SIGNING	SQ FT	103	103	·····
0325 <b>9</b> 71	CAST-IN-PLACE DETECTABLE WARNING SURFACE	SQ FT	26		26
0325103	WATER METER IN VAULT, 2 INCH	EACH	2		2
0325104	WATER TAP, 2 INCH	EACH	2		2
0325105	IRRIGATION SYSTEM	SQ YD	46,875		46,87
0656300	PAVEMENT REMOVAL AND REPLACEMENT	SQ YD	(249		249
6065740	CONCRETE MEDIAN SURFACE, 5" (MODIFIED)	-SO-FI	-192	192	$\tilde{J}$
X000541	EXPLORATORY EXCAVATION	CU YD	18		18
X003710	BACKFLOW PREVENTER, 2"	EACH	2		2
X0325970	SOIL CONDITIONER 3"	SQ YD	6,825	6 <b>,</b> 825	
X006326	TYPE K COPPER PIPE 2"	-F00T-	<del>-425</del>		<del>-125</del>
(X104800	COMBINATION CONCRETE CURB AND GUTTER, TYPE B-V.12	FOOT	(99		99
0013798	CONSTRUCTION LAYOUT	L SUM	1		
0076600	TRAINEES	-HOUR-			
0325106	- SYSTEM IRRIGATION FALL SHUT-DOWN	EACH	2		2
0325107		EACH	2		2
1003460	LANDSCAPE MAINTENANCE	CAL MO	12	12	
202950	SHRUB, FORSYTHIA X INTERMEDIA COURTACOUR (GOLDILOCKS FORSYTHIA) 18" HEIGHT, CONTAINER	EACH	284	284	
2602949	SHRUB, FORSYTHIA X INTERMEDIA COURDIJAU (GOLDEN PEEP FORSYTHIA) 18" HEIGHT, CONTAINER	EACH	286	286	
325604	WEED CONTROL, PRE -EMERGENT HERBUDE	GALLON	2	2.	
1911015	TRAFFIC CONTROL AND PROTECTION (EXPRESSWAYS)	LSUM	/	,	
0048665	RAILROAD PROTECTIVE LIABILITY INSURANCE	L SUM	,		
	, 2				

BOWMAN, BARRETT & ASSOCIATES INC.
CONSULTING ENGINEERS
Chicago, Illinois
312.228.0100
www.bbandainc.com


ILLINOIS DEPARTMENT OF TRANSPORTATION F.A.I. 94/90 (DAN RYAN EXPRESSWAY) STATEMENT LANDSCAPING & IRRIGATION & 35TH SUMMARY OF QUANTITIES


SCALE: NONE


A Rev. 4-2-08


DATE: 03/13/07


DRAWN BY: JDC CHECKED BY: DDM

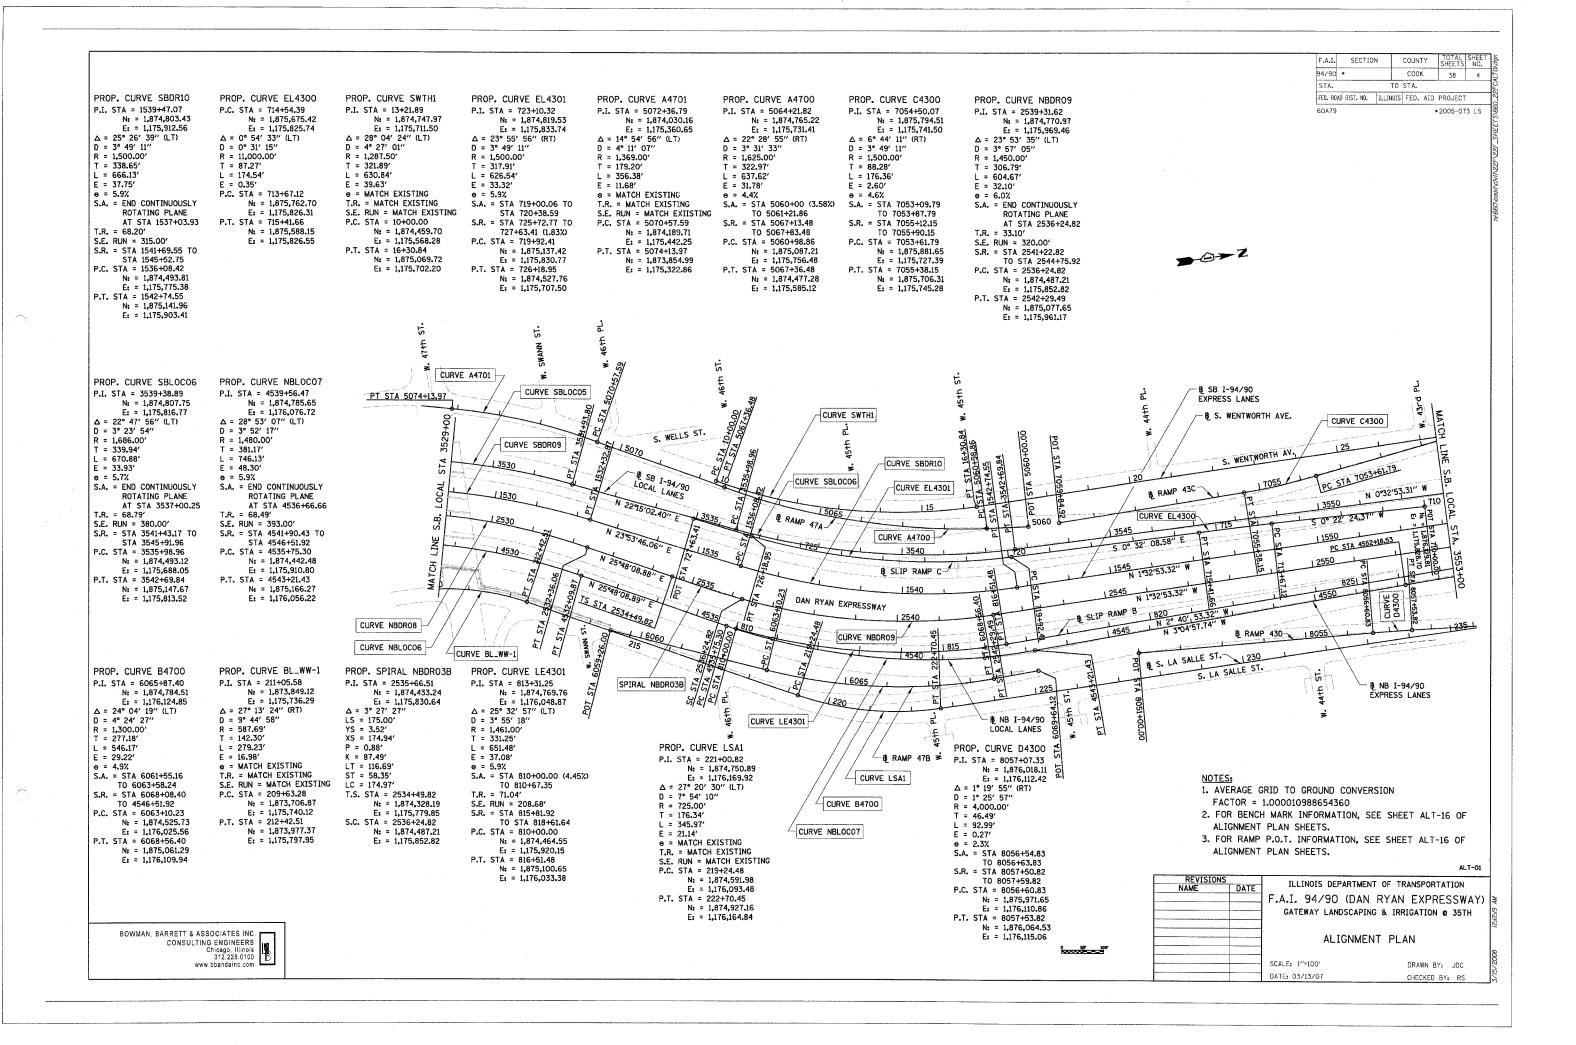


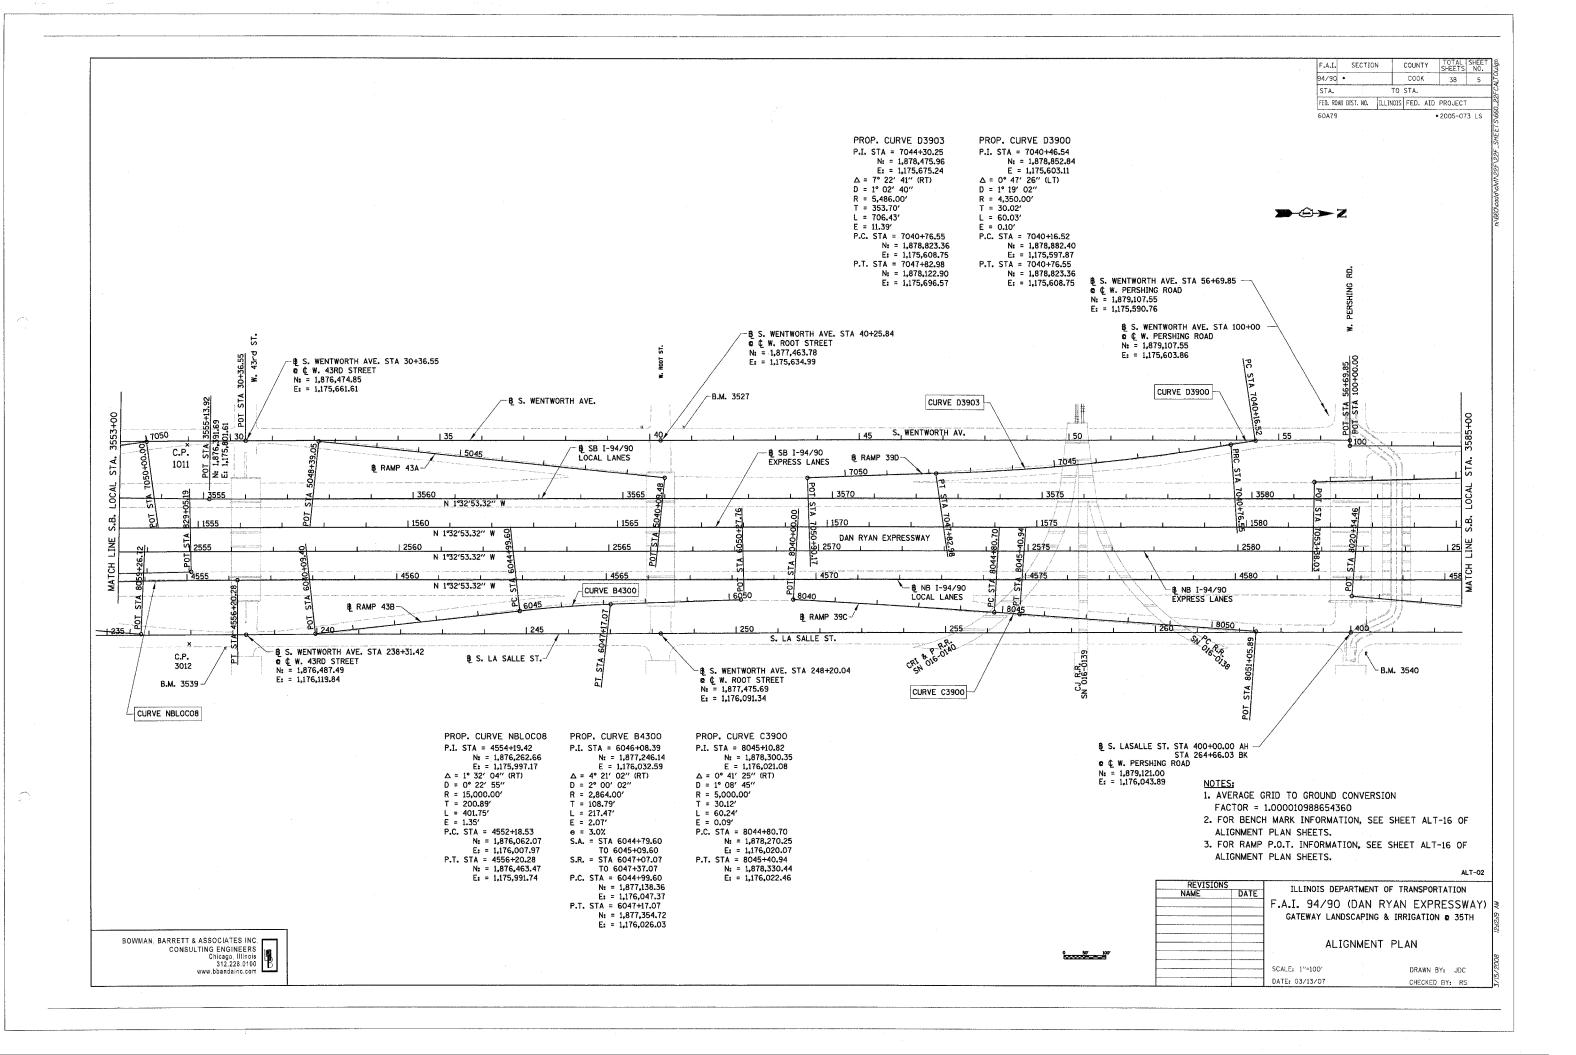


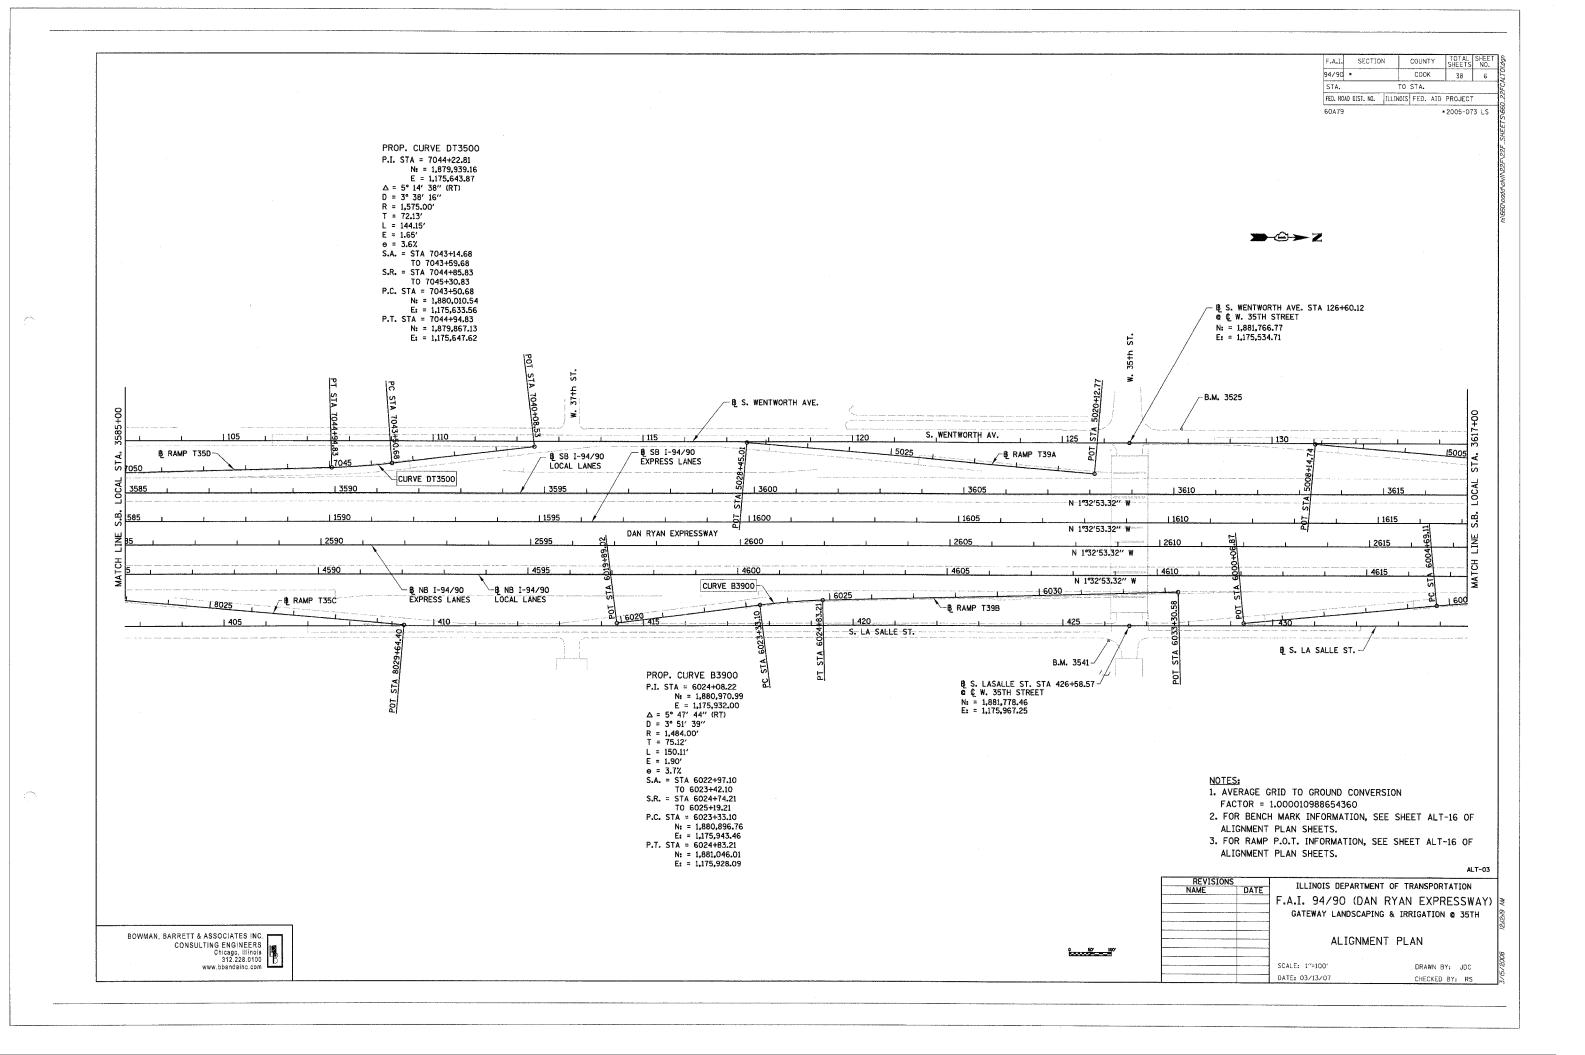


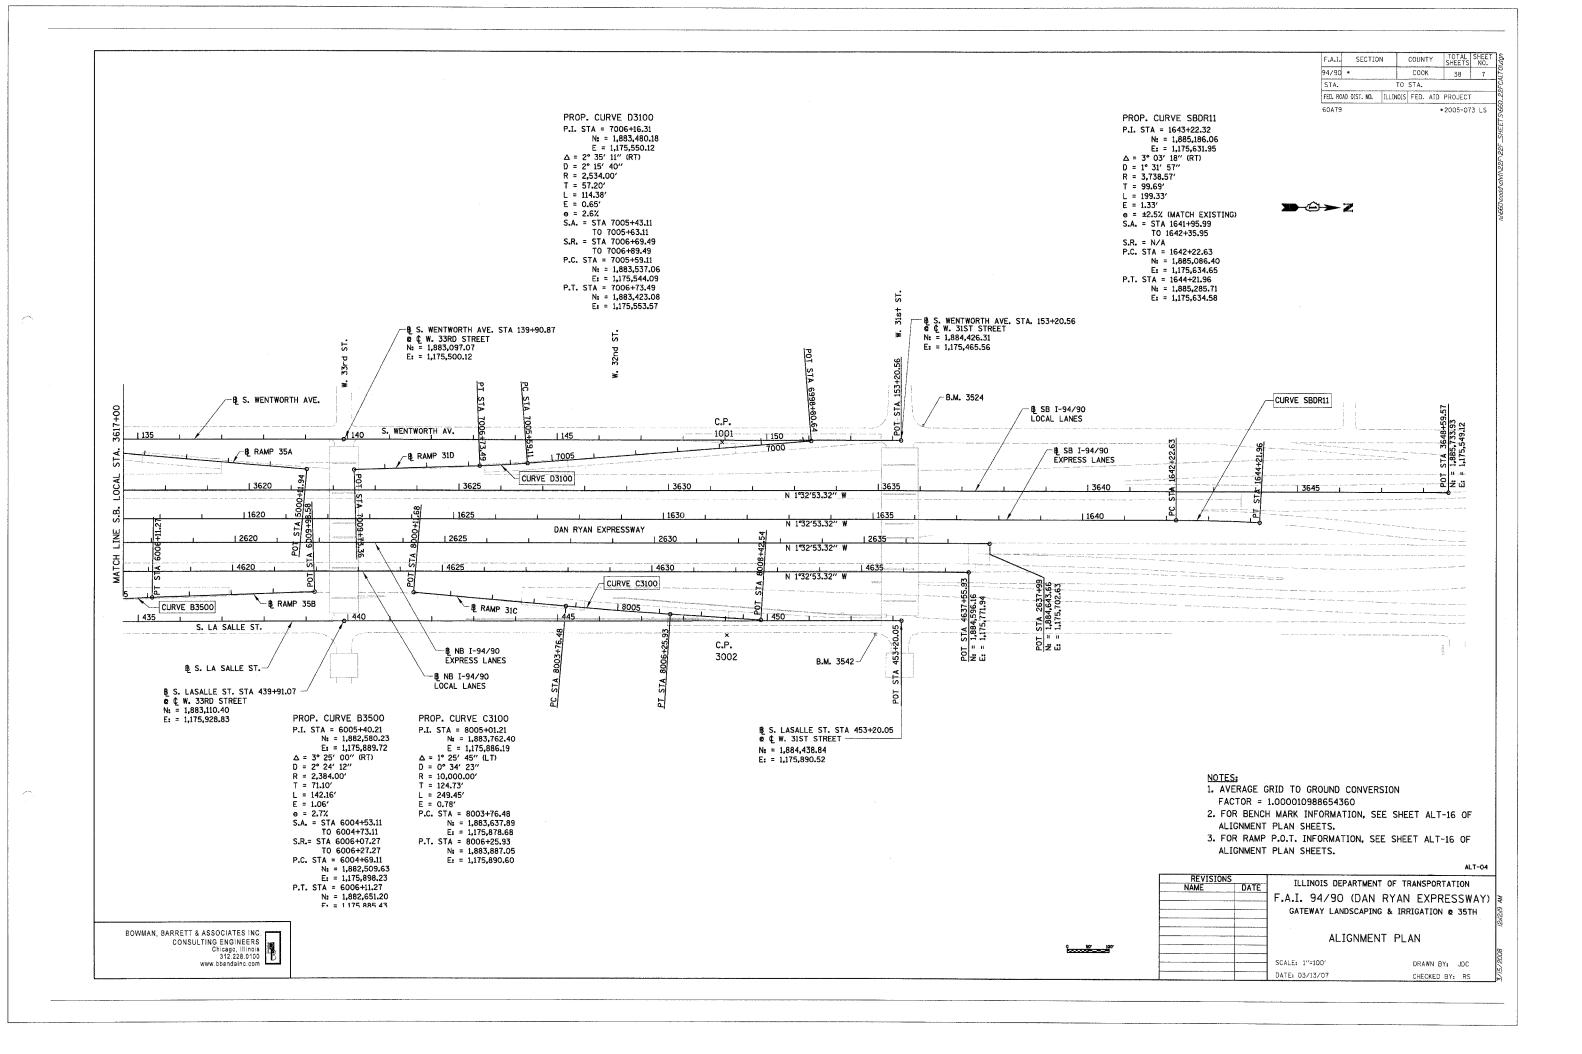


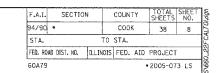

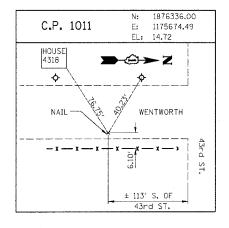

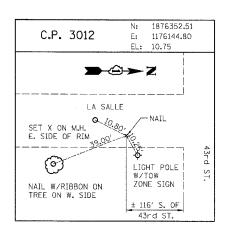

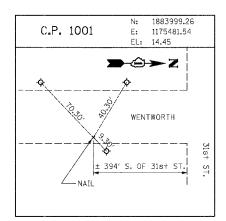

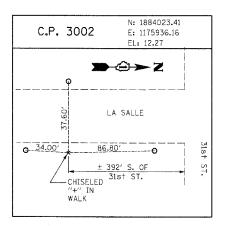

#### RAMP P.O.T. COORDINATE INFORMATION

POINT	DESCRIPTION	STATION	NORTH	EAST
BEGIN	RAMP 47A	5060+00.00	1.875.185.77	1,175,764.15
END	RAMP 47A	5074+13.97	1,873,854.99	1,175,322.86
BEGIN	RAMP 47B	6059+26.00	1,874,166.99	1,175,887.94
END	RAMP 47B	6069+64.12	1,875,168.85	1,176,104.15
BEGIN	RAMP 43C	7050+00.00	1,876,238.80	1,175,669.59
END	RAMP 43C	7059+84.92	1,875,259.95	1,175,764.44
BEGIN	RAMP 43D	8051+00.00	1,875,411.12	1,176,092.10
END	RAMP 43D	8059+26.72	1,876,237.16	1,176,124.86
BEGIN	RAMP 43A	5040+09.48	1,877,475.98	1,175,723.30
END	RAMP 43A	5048+39.05	1,876,648.91	1,175,658.90
BEGIN	RAMP 43B	6040+09.40	1,876,652.70	1,176,113.96
END	RAMP 43B	6050+27.76	1,877,664.85	1,176,007.29
BEGIN	RAMP 39D	7040+16.52	1,878,882.40	1,175,597.87
END	RAMP 39D	7050+90.17	1,877,816.27	1,175,715.09
BEGIN	RAMP 39C	8040+00.00	1,877,789.82	1,176,003.91
END	RAMP 39C	8051+05.89	1,878,894.81	1,176,048.24

POINT	DESCRIPTION	STATION	NORTH	EAST
BEGIN	RAMP T35D	7040+08,53	1,880,349,18	1,175,584.62
END	RAMP T35D	7053+38.03	1,879,025.07	1,175,691.43
BEGIN	RAMP T35C	8020+34.46	1,879,121,15	1,175,958.93
END	RAMP T35C	8029+64.40	1,880,049.40	1,176,014.92
BEGIN	RAMP T39A	5020+12.77	1,881,685.70	1,175,610.45
END	RAMP T39A	5028+45.01	1,880,854.96	1,175,560,34
BEGIN	RAMP T39B	6019+89.02	1,880,556.70	1,175,995,95
END	RAMP T39B	6033+30.58	1,881,892.23	1,175,884.04
BEGIN	RAMP 35A	5000+11.94	1,883,011.02	1,175,573.65
END	RAMP 35A	5008+14.74	1,882,209.69	1,175,525.14
BEGIN	RAMP 35B	6000+06.87	1,882,050.72	1,175,953.56
END	RAMP 35B	6009+98.58	1,883,037.81	1,175,862.08
BEGIN	RAMP 31D	6998+80.64	1.884.211.76	1,175,472.66
END	RAMP 31D	7009+73.36	1,883,123.75	1,175,571.65
BEGIN	RAMP 31C	8000+11.68	1,883,273,75	1.175.856.72
END	RAMP 31C	8008+42.54	1,884,103.52	1,175,898.24

BENCH MARK NO. 3524 ELEV. 15,17

DESCRIPTION:

CROSS CUT ON NORTH FLANGE BOLT OF FIRE HYDRANT AT THE NORTHWEST CORNER OF 31s+ ST. AND WENTWORTH AVE.

BENCH MARK NO. 3525 ELEV. 16.93

DESCRIPTION: CROSS CUT ON NORTHWEST FLANGE BOLT OF FIRE HYDRANT AT THE NORTHWEST CORNER, OF 35th ST. AND WENTWORTH AVE.

BENCH MARK NO. 3526 ELEV. 17.37

DESCRIPTION:

CROSS CUT ON NORTHWEST FLANGE BOLT OF FIRE HYDRANT AT THE WENTWORTH GARDEN OFFICE ALONG THE WEST SIDE OF WENTWORTH AVE.

BENCH MARK NO. 3527 ELEV. 15.63

DESCRIPTION:

CROSS CUT ON NORTHERLY FLANGE BOLT OF FIRE HYDRANT AT THE NORTHWEST CORNER OF ROOT ST. AND WENTWORTH AVE.

BENCH MARK NO. 3539 ELEV. 13.10

CROSS CUT ON EASTERLY BOLT OF LIGHT POLE BASE AT THE SOUTHEAST CORNER OF 43rd ST. AND LA SALLE ST.

BENCH MARK NO. 3540 ELEV. 12.33

DESCRIPTION: SQUARE CUT ON THE SOUTHWEST CORNER OF THE TRAFFIC CONTROL BOX AT THE NORTHEAST CORNER OF 39th ST. AND LA SALLE ST.

BENCH MARK NO. 3541 ELEV. 14.78

CROSS CUT ON THE SOUTHWEST BOLT OF LIGHT POLE BASE AT THE SOUTH EAST CORNER OF 35+h ST. AND LA SALLE ST.

BENCH MARK NO. 3542 ELEV. 13,57

DESCRIPTION:

CROSS CUT ON THE EASTERLY FLANGE BOLT OF THE FIRE HYDRANT AT THE INTERSECTION OF 31st ST. AND LA SALLE ST.

ILLINOIS DEPARTMENT OF TRANSPORTATION F.A.I. 94/90 (DAN RYAN EXPRESSWAY) GATEWAY LANDSCAPING & IRRIGATION @ 35TH

ALIGNMENT PLAN


SCALE: 1"=100" DATE: 03/13/07


DRAWN BY: JDC CHECKED BY: RS


ALT-05


BOWMAN, BARRETT & ASSOCIATES INC.
CONSULTING ENGINEERS
Chicago, Illinois
312 228,0100
www.bbandainc.com


94/90 \* COOK TO STA. STA. FED. ROAD DIST. NO. ILLINOIS FED. AID PROJECT & S. WENTWORTH AVE. S. WENTWORTH AVE. B S. WENTWORTH AVE. RAMP T39A RAMP T39A APPLIED IDOT STANDARD TC17 'TRAFFIC CONTROL DETAILS
FOR FREEWAY SHOULDER CLOSURES PARTIAL RAMP CLOSURES I-94/90 SB IOCAL LANES SB EXPRESS LANES CTA RED LINE APPLIED HIGHWAY STANDARD 701101-01 'OFF-RD OPERATIONS, MULTILANE 45m (15') TO 600mm (24") FROM PAVEMENT EDGE' FOR FREEWAY SHOULDER CLOSURES PARTIAL RAMP CLOSURES \_ 11-94/90 NB LOCAL LANES \_ 16025+00 B RAMP 35B B S. LA SALLE ST. S. LA SALLE ST. ST W20-1 W20-I110-48 APPLIED HIGHWAY STANDARD 701601-04 ILLINOIS DEPARTMENT OF TRANSPORTATION 'URBAN LANE CLOSURE, MULTILANE, 1W F.A.I. 94/90 (DAN RYAN EXPRESSWAY) OR 2W WITH NONTRAVERSABLE MEDIAN' GATEWAY LANDSCAPING & IRRIGATION @ 35TH MAINTENANCE OF TRAFFIC BOWMAN, BARRETT & ASSOCIATES INC.
CONSULTING ENGINEERS
Chicago, Illinois
312,228,0100
www.bbandainc.com SCALE: 1"=50 DATE: @3/13/07

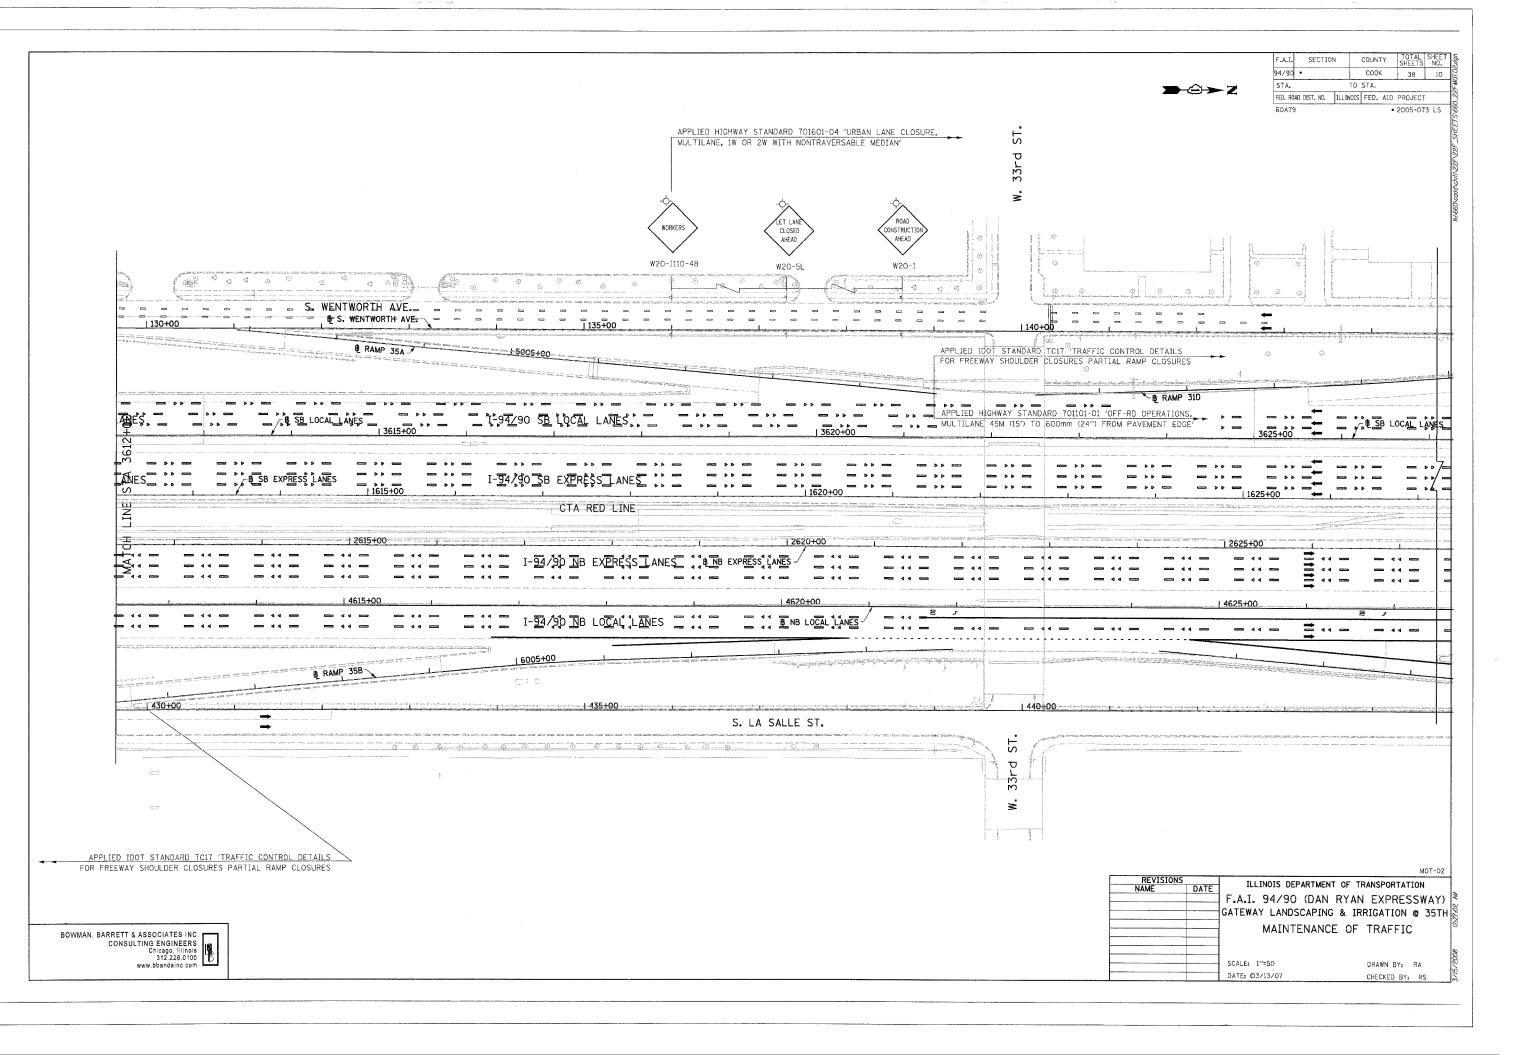


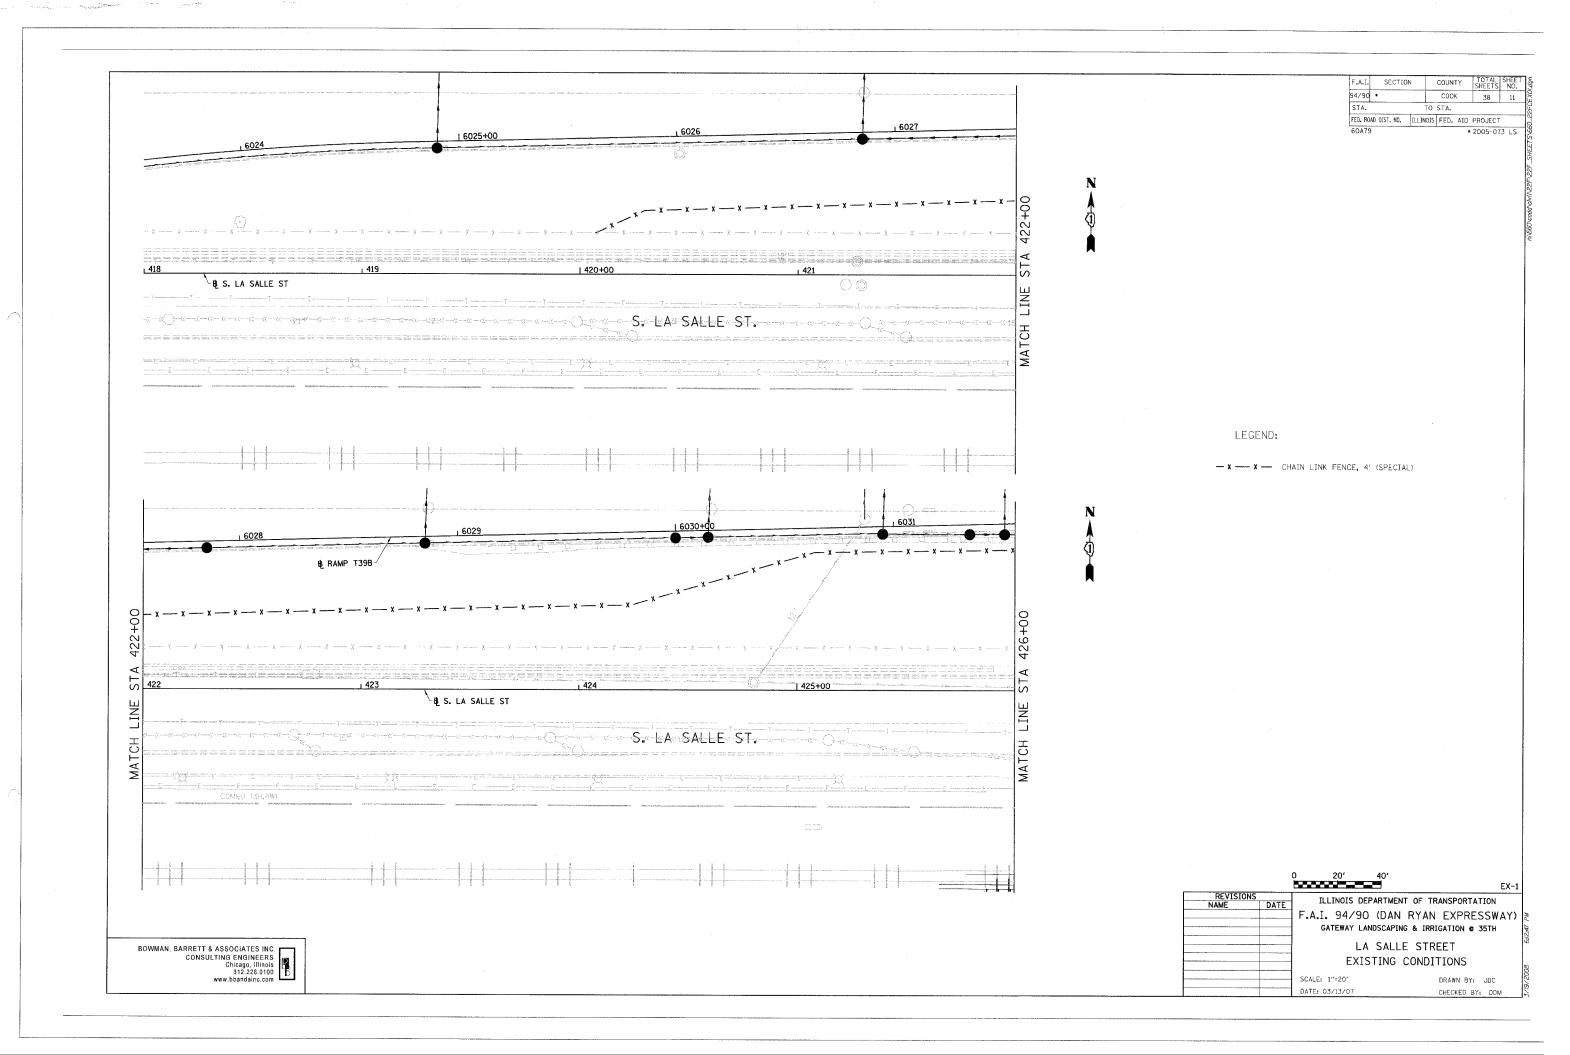


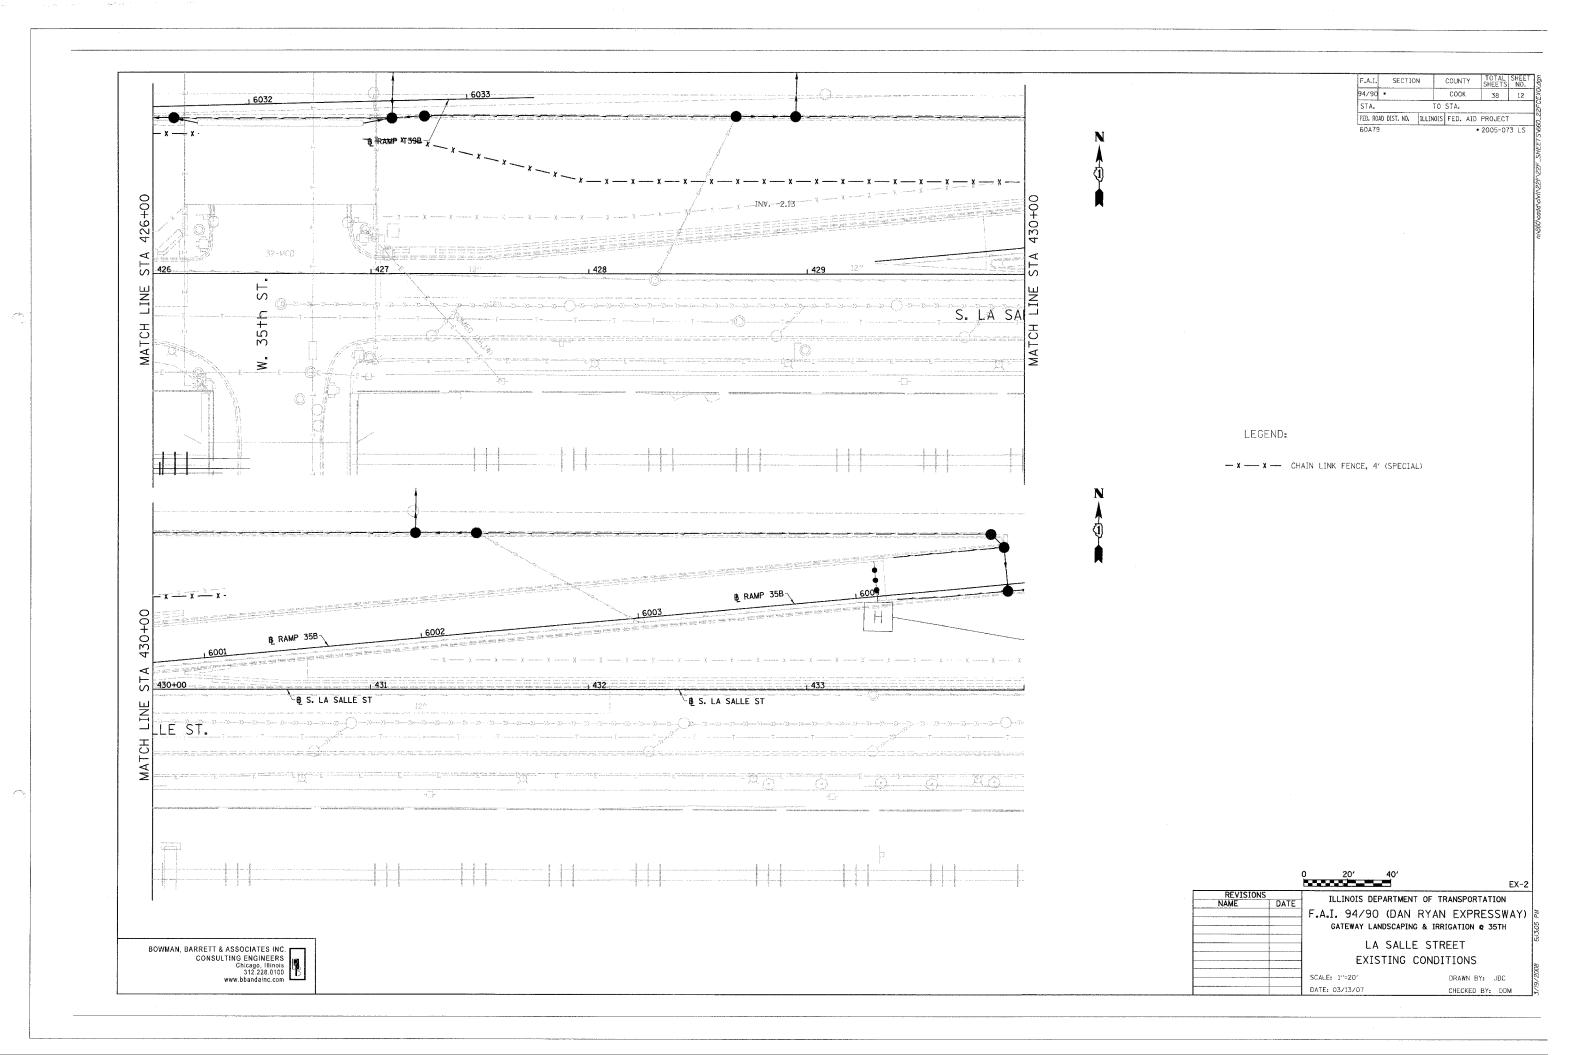


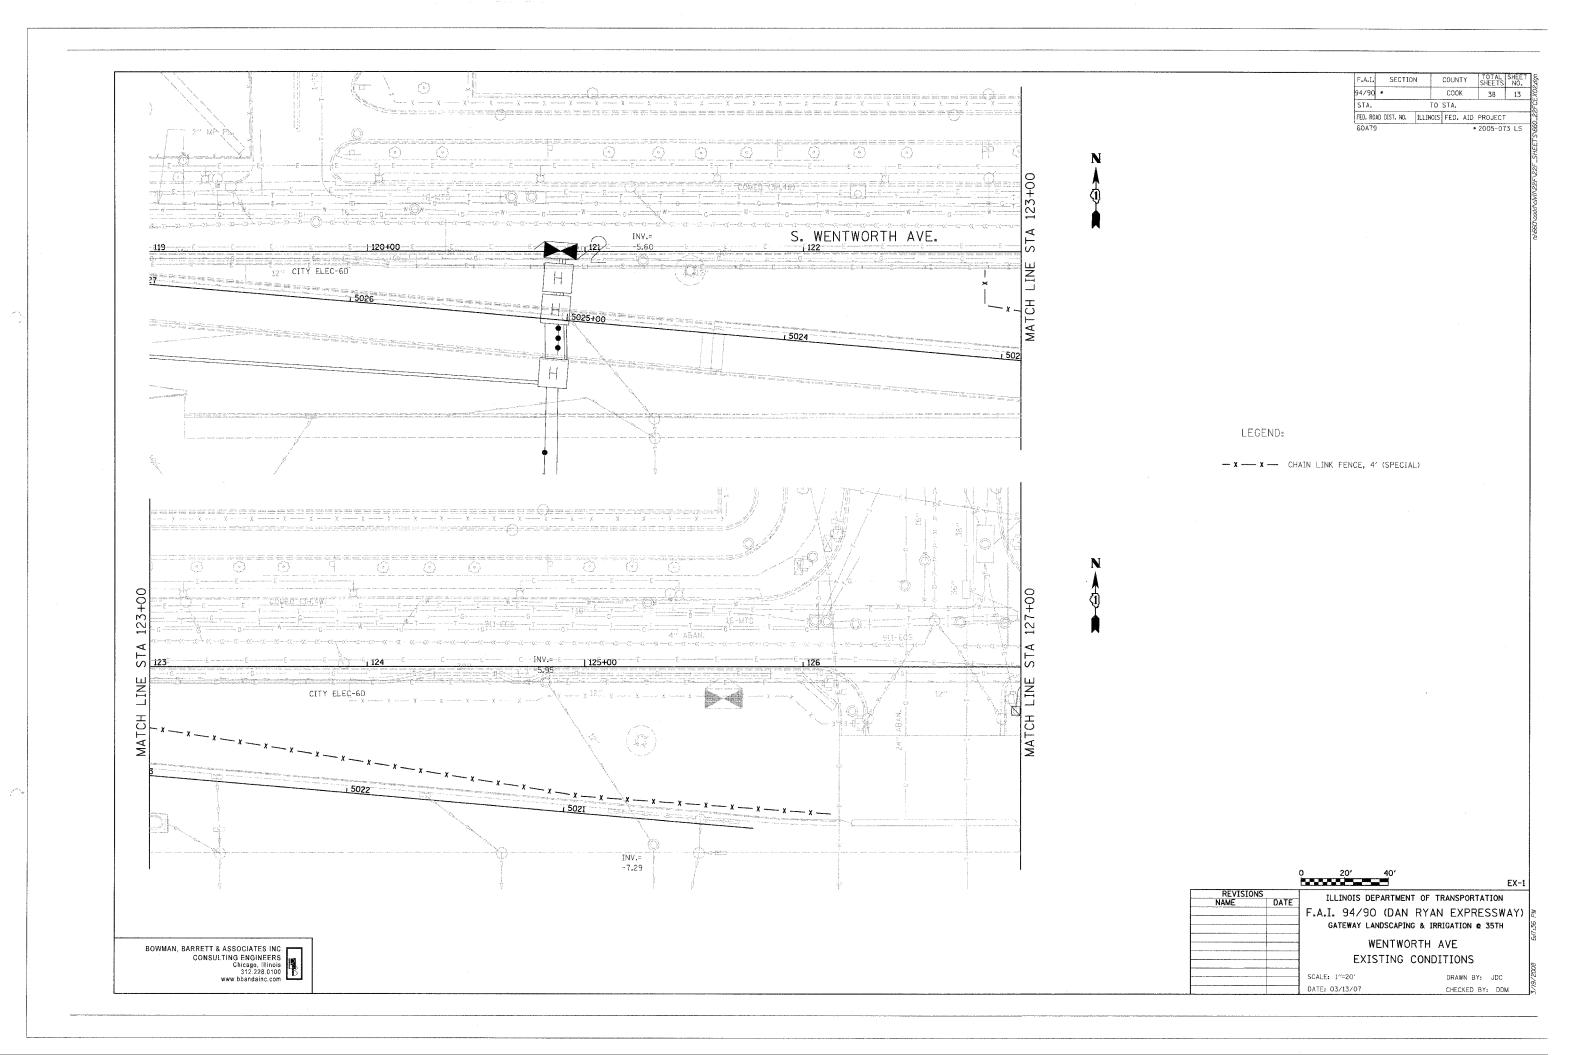

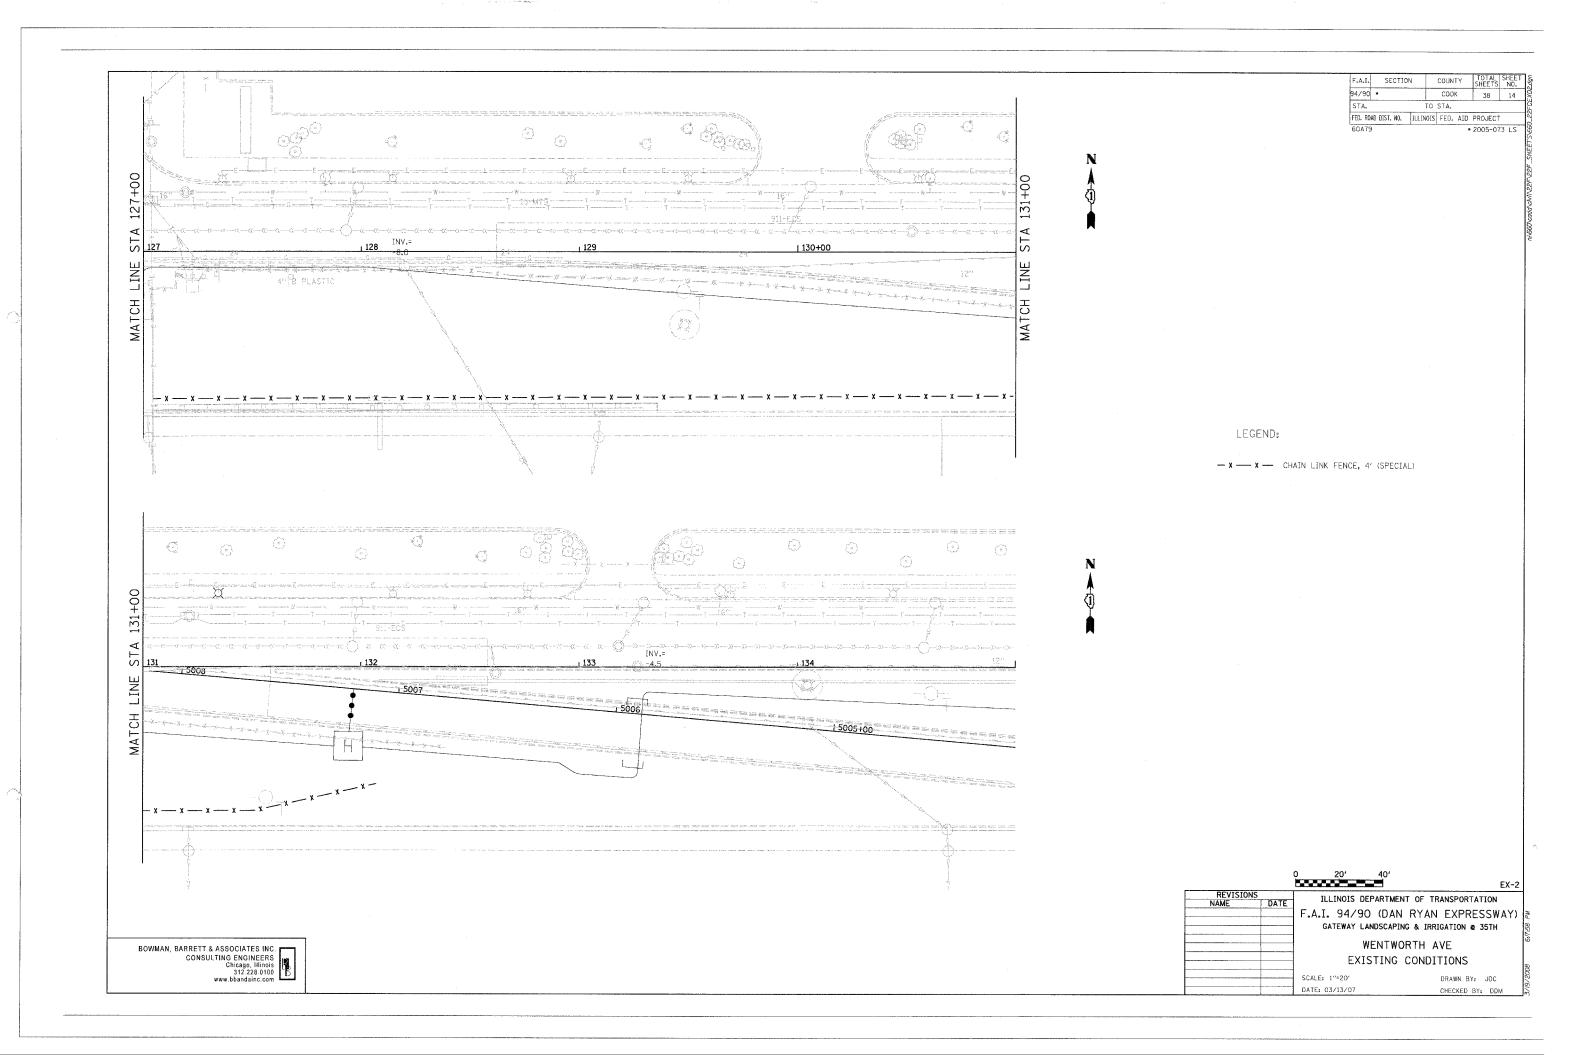

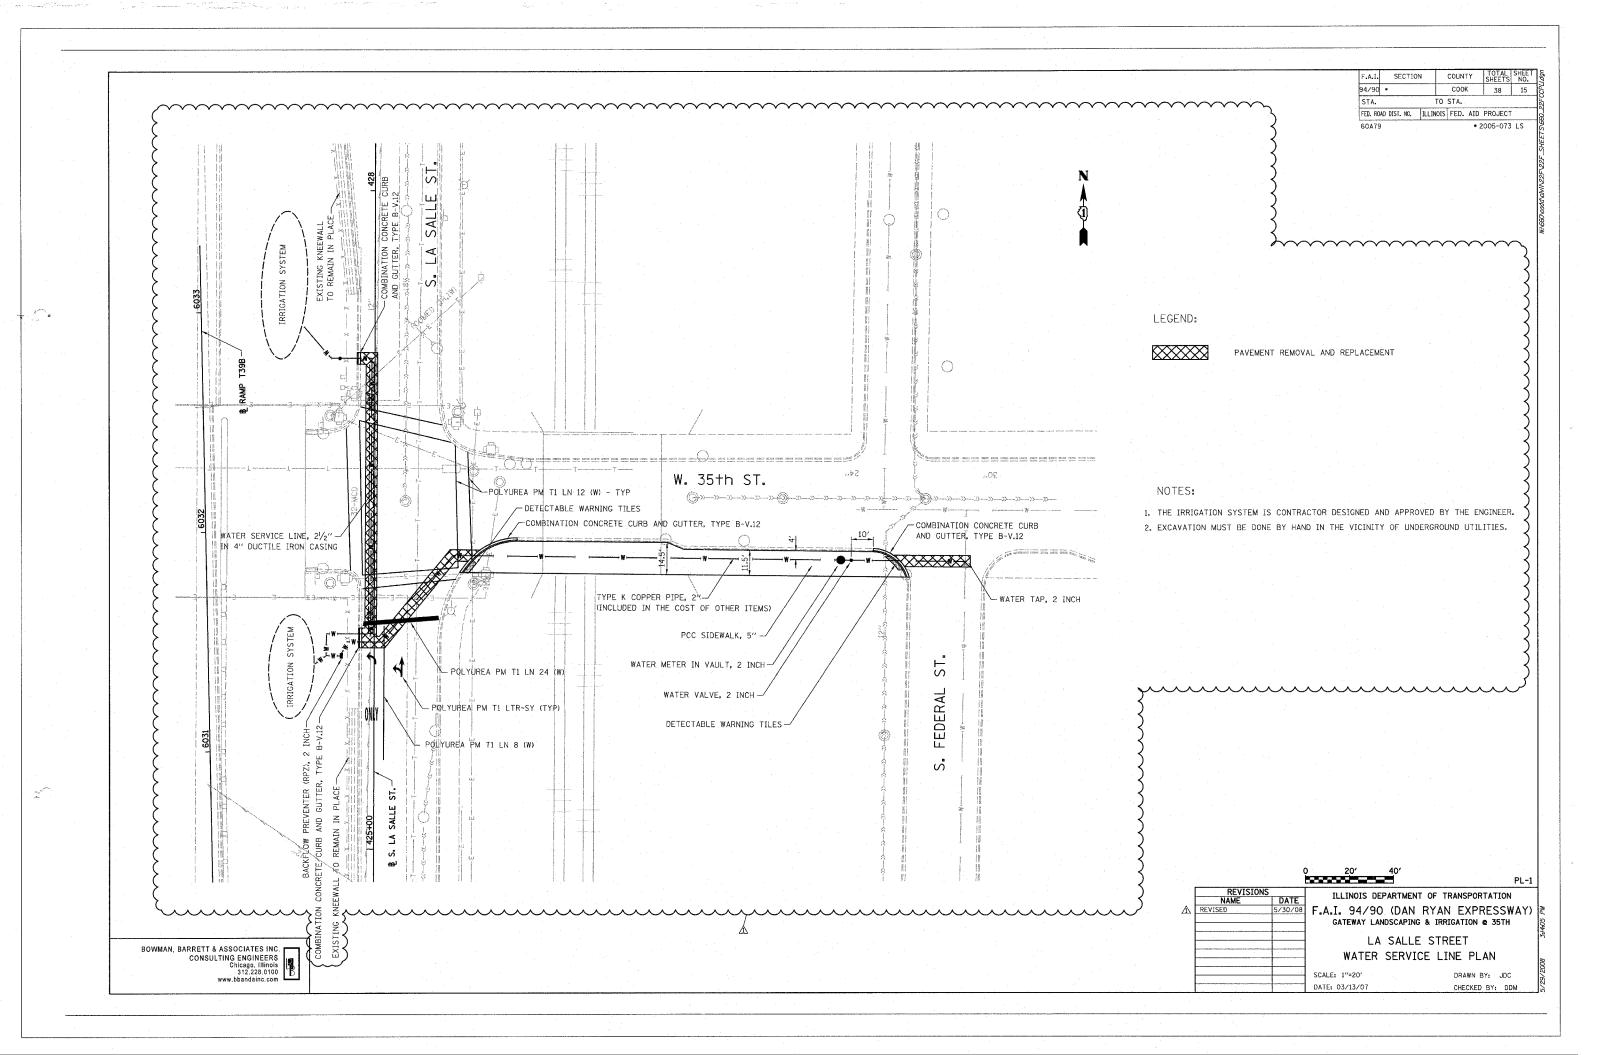

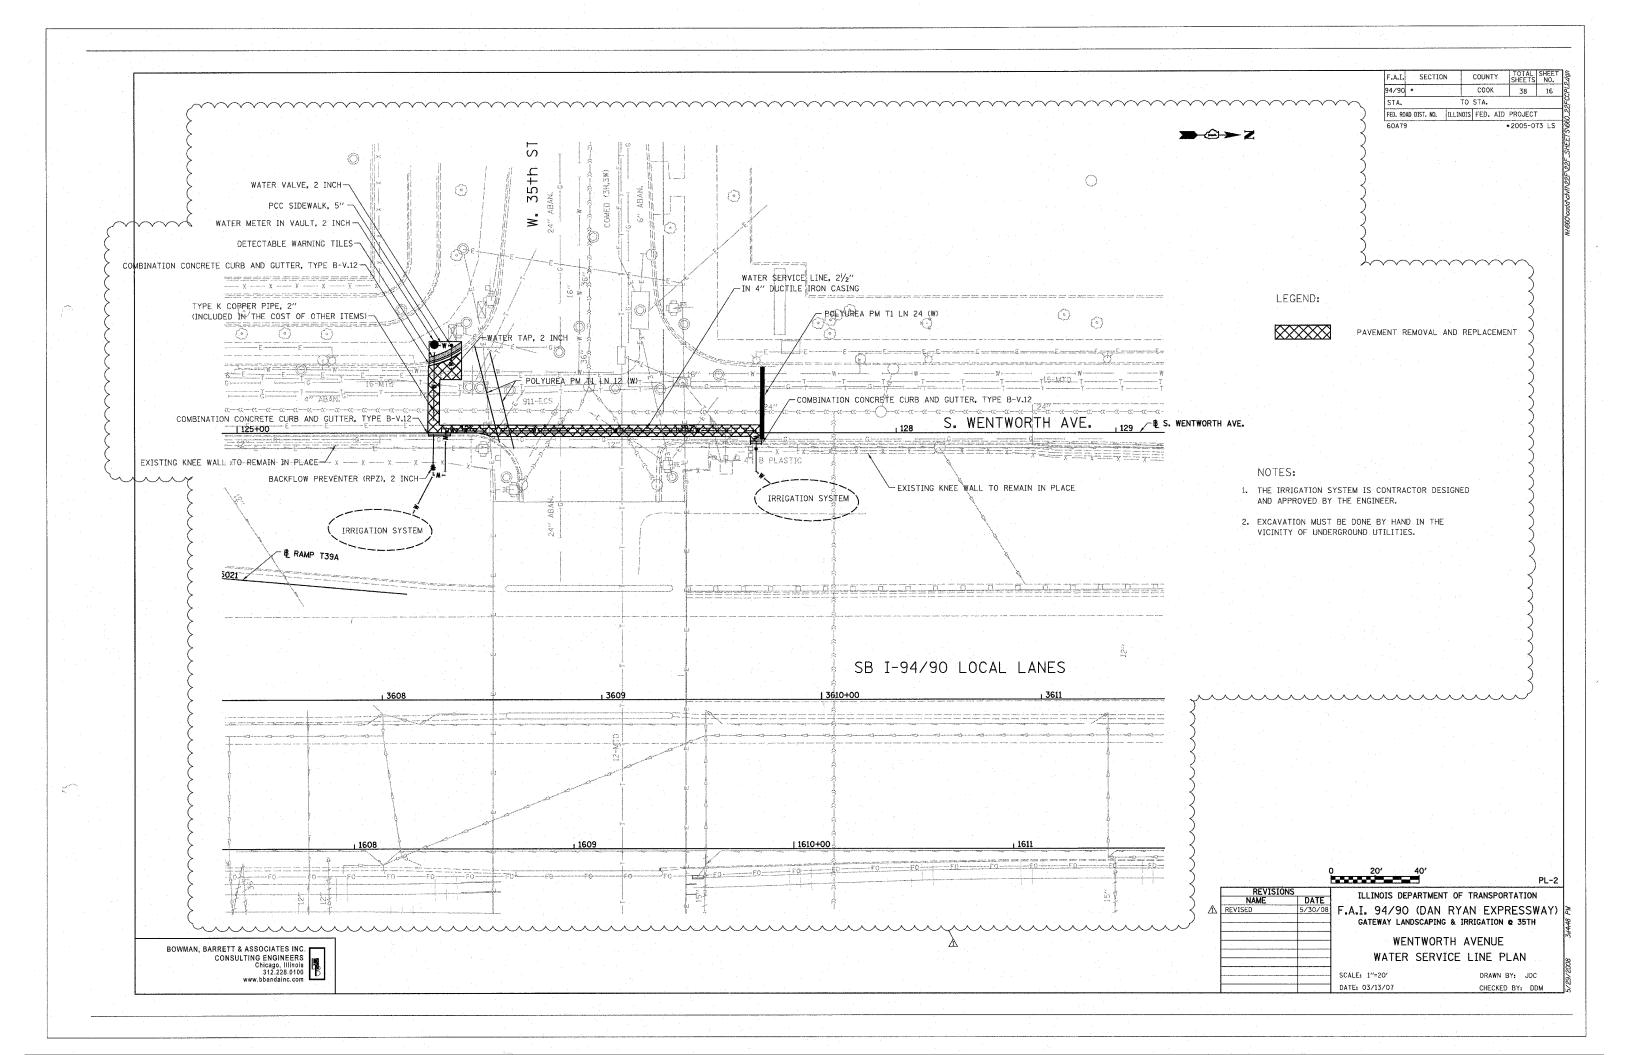

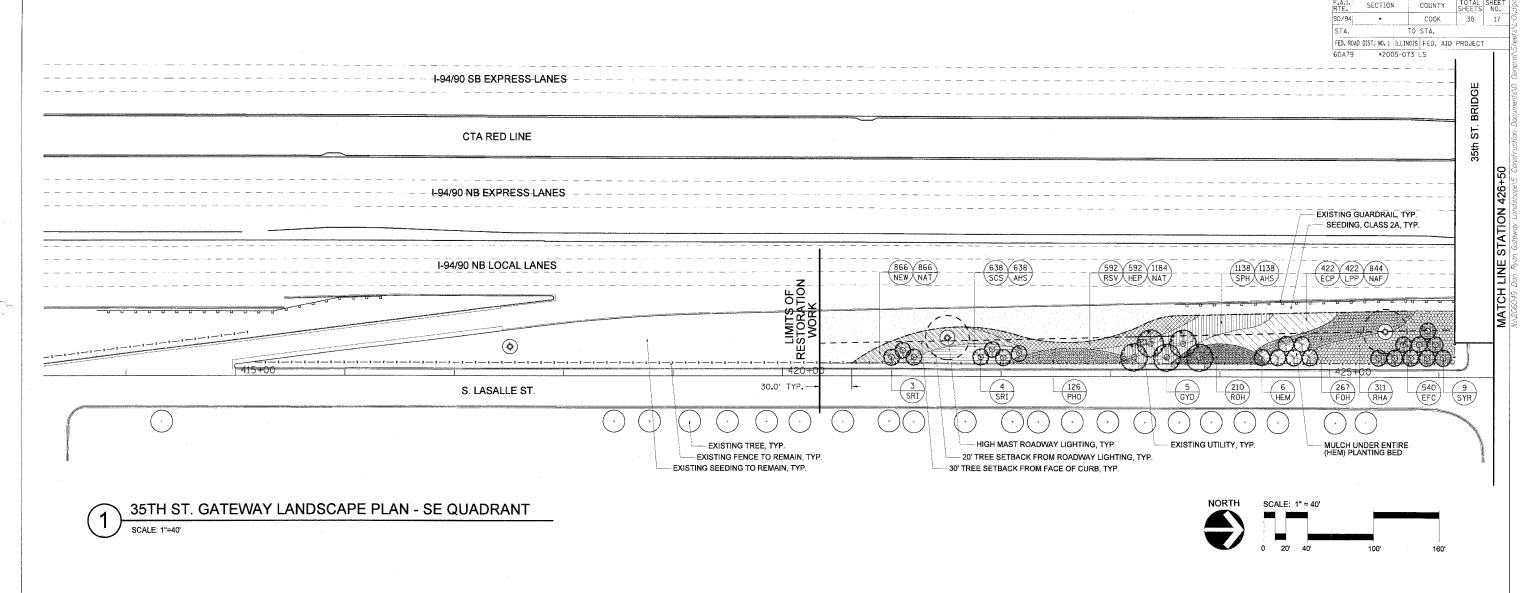

35th	ST	GAT		$\Delta \nabla I$	ΔΝΓ	1SCA	PE	$DI\Delta$	NT I	IST	SE	QUADRANT	
JULL	O I .		L V V /	<b>¬</b> 1 1		ノいつしょど	<b>\</b> F =	-	! W I I	1.31		UUMIJIMINI	

KEY	BOTANICAL NAME	COMMON NAME	SIZE	QUANTITY	SPACING	NOTES
SHADE TI	REES					
GYD	GYMNOCLADUS DIOICA	KENTUCKY COFFEE TREE	10' HT.	5	ON PLANS	CLUMP FORM B/B
ORNAME	NTAL TREES					
SRI	SYRINGA RETICULATA 'IVORY SILK'	JAPANESE TREE LILAC	10' HT.	7	ON PLANS	HEAVY CLUMP B/B
SYR	SYRINGA RETICULATA 'IVORY SILK'	JAPANESE TREE LILAC	2.5" CAL.	9	ON PLANS	B/B
SHRUBS						
FOH	FORSYTHIA X INTERMEDIA 'HAPPY CENTENNIAL'	HAPPY CENTENNIAL FORSYTHIA	18" HT. 5 GAL	267	36" O.C.	
HEM	HEPTACODIUM MICONIOIDES	SEVEN-SON FLOWER	8' HT.	6	ON PLANS	HEAVY CLUMP B/B
PHO	PHYSOCARPUS OPULIFOLIUS 'SUMMER WINE'	SUMMER WINE COMMON NINEBARK	2 1/2' HT. 5 GAL.	126	42" O.C.	112.001 020111 070
RHA	RHUS COPALLINA LATIFOLIA 'MORTON'	PRAIRIE FLAME SUMAC	3' HT. 5 GAL.	311	36" O.C.	
ROH	ROSA 'KNOCKOUT'	KNOCKOUT SHRUB ROSE	3 GAL.	210	30" O.C.	
	77.74					
er many a many a	NTAL GRASSES	777	Y		y	
SCS	SCHIZACHRIUM SCOPARIUM 'CAROUSEL'	CAROUSEL LITTLE BLUESTEM	1 GAL.	638	18" O.C.	
SPH	SPOROBOLUS HETEROLEPSIS	PRAIRIE DROPSEED	1 GAL.	1138	18" O.C.	
PERENNI	ΔIS					
ECP	ECHINACEA PURPUREA 'FATAL ATTRACTION'	FATAL ATTRACTION PURPLE CONEFLOWER	1 GAL.	422	18" O.C.	w
HEP	HEMEROCALLIS 'PARDON ME'	PARDON ME DAYLILY	1 GAL.	592	15" O.C.	
LPP	LIATRIS PYCNOSTACHYA	PRAIRIE BLAZING STAR	1 GAL.	422	18" O.C.	
NEW	NEPETA X FAASSENNII 'WALKER'S LOW'	WALKER'S LOW CATMINT	1 GAL.	866	18" O.C.	
RSV	RUDBECKIA SPECIOSA 'VIETTE'S LITTLE SUZY'	DWARF BLACK-EYED SUSAN	1 GAL.	592	15" O.C.	
GROUND	COVER					
EFC	EUONYMUS FORTUNEI 'COLORATUS'	PURPLE LEAF WINTERCREEPER	1 QT.	540	18" O.C.	
		A		an administrative and a second design		
			TOP SIZE	1776	INTERPLANTING CRACOES	
BULBS	ALL IUM HOLLANDICUM (CENCATION)	ODNIAMENTAL ONION		1//6	INTERPLANT W/ GRASSES	
AHS	ALLIUM HOLLANDICUM 'SENSATION'	ORNAMENTAL ONION			INTEGRICANT INVESTOR	
AHS NAF	NARCISSUS 'FORTISSIMO'	FORTISSIMO DAFFODIL	TOP SIZE	844	INTERPLANT W/ PER.	
AHS		The state of the s			INTERPLANT W/ PER. INTERPLANT W/ PER.	
AHS NAF NAT	NARCISSUS 'FORTISSIMO' NARCISSUS 'TETE A TETE'  NPE MATERIALS	FORTISSIMO DAFFODIL	TOP SIZE	844		
AHS NAF NAT	NARCISSUS 'FORTISSIMO' NARCISSUS 'TETE A TETE'	FORTISSIMO DAFFODIL	TOP SIZE	844		

# GENERAL NOTES:

- 1. SEE SHEET L-05 FOR LAYOUT PLAN.
- 2. SEE SHEET L-07 FOR IRRIGATION PLAN.
- 3. SEE SHEET L-08 FOR LANDSCAPE DETAILS.4. SEE SHEET L-09 FOR OVERALL PLANT LIST.
- 5. THE LOCATION OF ALL PLANT MATERIAL SHALL BE STAKED BY CONTRACTOR FOR APPROVAL BY ENGINEER IN FIELD, PRIOR TO INSTALLATION. INDIVIDUAL TREES SHALL BE STAKED WITH IDENTITIES WRITTEN ON STAKES. SHRUB BEDS SHALL BE OUTLINED WITH STAKES AND PAINTED LINES.
- 6. ALL ROADWAY, SEWER, ELECTRICAL AND OTHER UTILITY WORK (EXCEPT FOR IRRIGATION) SHALL BE CONSTRUCTED BY OTHERS. ADJUSTMENTS TO INSTALLED UTILITIES MAY HAVE BEEN MADE DURING CONSTRUCTION THAT ARE NOT INDICATED ON THESE PLANS. CONTRACTOR SHALL COORDINATE LANDSCAPE AND IRRIGATION WORK WITH WORK BY OTHER CONTRACTORS AND SHALL NOTIFY ENGINEER OF POTENTIAL CONFLICTS. CONTRACTOR SHALL PROTECT ALL UTILITIES AND OTHER FACILITIES, NEW AND EXISTING, DURING THE COURSE OF INSTALLATION OF THE LANDSCAPE AND IRRIGATION SYSTEMS. REPAIRS SHALL BE PERFORMED BY THE CONTRACTOR AT NO ADDITIONAL COST TO IDOT OR CDOT.
- 7. NO STOCK-PILING OR STAGING ALLOWED ON CHICAGO PARKWAYS.


L-01

CHECKED BY:

VIE.	DATE			
				5th ST. GATEWAY
			L	ANDSCAPE PLAN
				STA. 420+00 TO STA. 426+50
		SCALE:	1"=40"	DRAWN BY: RPS

ILLINOIS DEPARTMENT OF TRANSPORTATION

The Fine Arts Building
410 South Michigan Avenue
Chicago, Illinois 60605
312.322.0911 fax 312.322.5324

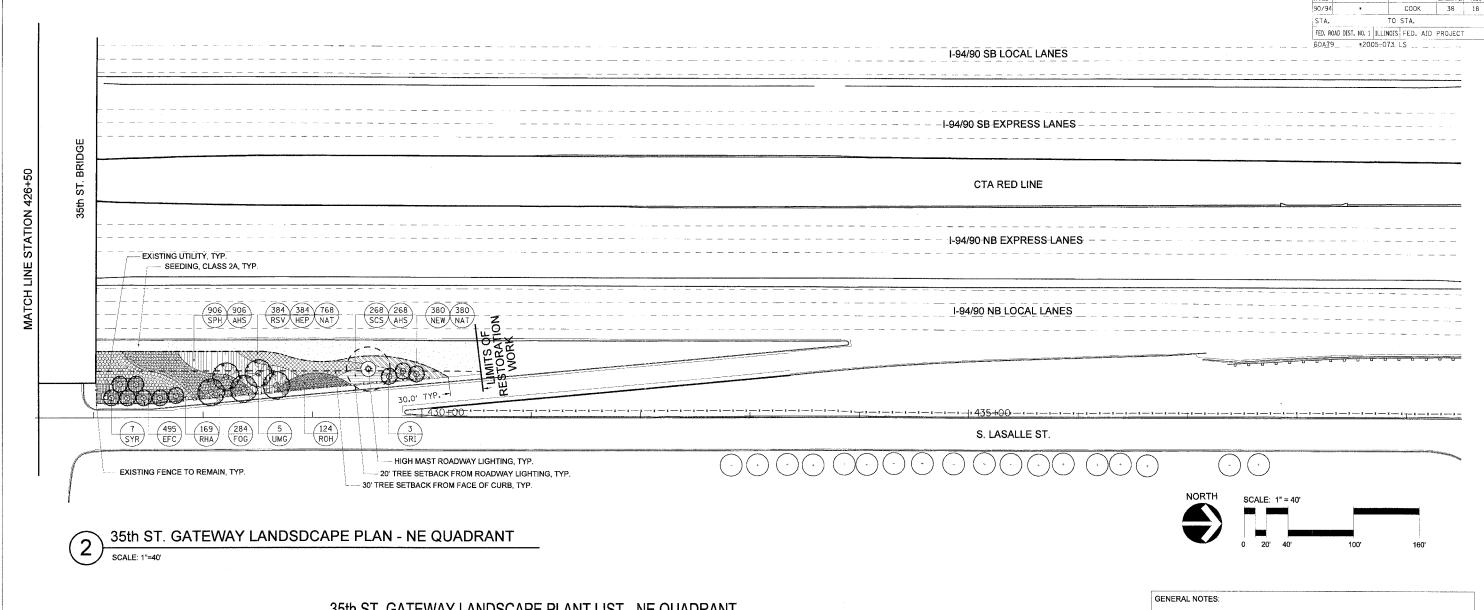

# 35th ST. GATEWAY LANDSCAPE PLANT LIST - NE QUADRANT

KEY	BOTANICAL NAME	COMMON NAME	SIZE	QUANTITY	SPACING	NOTES
SHADE TREES	S					
UMG	ULMUS J X W 'MORTON GLOSSY'	TRIUMPH ELM	3" CAL.	5	ON PLANS	B/B
ORNAMENTAL	I TDEEC					
	SYRINGA RETICULATA 'IVORY SILK'	JAPANESE TREE LILAC	10' HT.	3	ON PLANS	HEAVY CLUMP B/B
	SYRINGA RETICULATA 'IVORY SILK'	JAPANESE TREE LILAC	2.5" CAL.	7	ON PLANS	B/B
SHRUBS	PROFILE A A 111/2					
	FORSYTHIA X INTERMEDIA 'COURTACOUR'	GOLDILOCKS FORSYTHIA	18" HT. 5 GAL.	284	36" O.C.	
	RHUS COPALLINA LATIFOLIA 'MORTON'	PRAIRIE FLAME SUMAC	3' HT. 5 GAL.	169	36" O.C.	
ROH	ROSA 'KNOCKOUT'	KNOCKOUT SHRUB ROSE	3 GAL.	124	30" O.C.	
ORNAMENTAL	LOBACCE					
	SCHIZACHRIUM SCOPARIUM 'CAROUSEL'	CAROUSEL LITTLE BLUESTEM	1 GAL.	268	18" O.C.	- Fallen
	SPOROBOLUS HETEROLEPSIS	PRAIRIE DROPSEED	1 GAL.	906	18" O.C.	
	HEMEROCALLIS 'PARDON ME'	PARDON ME DAYLILY	1 GAL.	384	15" O.C.	
NEW	NEPETA X FAASSENNII 'WALKER'S LOW'	WALKER'S LOW CATMINT	1 GAL.	380	18" O.C.	
RSV	RUDBECKIA SPECIOSA 'VIETTE'S LITTLE SUSY'	DWARF BLACK-EYED SUSAN	1 GAL.	384	15" O.C.	
		DWARF BLACK-EYED SUSAN	1 GAL.	384	15" O.C.	
GROUNDCOVI		DWARF BLACK-EYED SUSAN  PURPLE LEAF WINTERCREEPER	1 GAL.	384	15" O.C.	
GROUNDCOVI EFC	ÆR					
GROUNDCOVI EFC BULBS	YER EUONYMUS FORTUNEI 'COLORATUS'	PURPLE LEAF WINTERCREEPER	1 QT.	495	18" O.C.	
GROUNDCOVI EFC BULBS AHS	/ER EUONYMUS FORTUNEI 'COLORATUS'  ALLIUM HOLLANDICUM 'SENSATION'	PURPLE LEAF WINTERCREEPER ORNAMENTAL ONION	1 QT. TOP SIZE	495	18" O.C. INTERPLANT W/ GRASSES	
GROUNDCOVI EFC BULBS AHS	YER EUONYMUS FORTUNEI 'COLORATUS'	PURPLE LEAF WINTERCREEPER	1 QT.	495	18" O.C.	
GROUNDCOVI EFC BULBS AHS NAT	PER EUONYMUS FORTUNE! 'COLORATUS'  ALLIUM HOLLANDICUM 'SENSATION' NARCISSUS 'TETE A TETE'	PURPLE LEAF WINTERCREEPER ORNAMENTAL ONION	1 QT. TOP SIZE	495	18" O.C. INTERPLANT W/ GRASSES	
GROUNDCOVI EFC BULBS AHS NAT	PER EUONYMUS FORTUNE! 'COLORATUS'  ALLIUM HOLLANDICUM 'SENSATION' NARCISSUS 'TETE A TETE'	PURPLE LEAF WINTERCREEPER ORNAMENTAL ONION	1 QT. TOP SIZE	495	18" O.C. INTERPLANT W/ GRASSES	

- 1. SEE SHEET L-05 FOR LAYOUT PLAN.
- 2. SEE SHEET L-07 FOR IRRIGATION PLAN.
- 3. SEE SHEET L-08 FOR LANDSCAPE DETAILS.
- 4. SEE SHEET L-09 FOR OVERALL PLANT LIST.
- 5. THE LOCATION OF ALL PLANT MATERIAL SHALL BE STAKED BY CONTRACTOR FOR APPROVAL BY ENGINEER IN FIELD, PRIOR TO INSTALLATION. INDIVIDUAL TREES SHALL BE STAKED WITH IDENTITIES WRITTEN ON STAKES. SHRUB BEDS SHALL BE OUTLINED WITH STAKES AND PAINTED LINES.

SECTION

- 6. ALL ROADWAY, SEWER, ELECTRICAL AND OTHER UTILITY WORK (EXCEPT FOR IRRIGATION) SHALL BE CONSTRUCTED BY OTHERS. ADJUSTMENTS TO INSTALLED UTILITIES MAY HAVE BEEN MADE DURING CONSTRUCTION THAT ARE NOT INDICATED ON THESE PLANS. CONTRACTOR SHALL COORDINATE LANDSCAPE AND IRRIGATION WORK WITH WORK BY OTHER CONTRACTORS AND SHALL NOTIFY ENGINEER OF POTENTIAL CONFLICTS. CONTRACTOR SHALL PROTECT ALL UTILITIES AND OTHER FACILITIES, NEW AND EXISTING, DURING THE COURSE OF INSTALLATION OF THE LANDSCAPE AND IRRIGATION SYSTEMS. REPAIRS SHALL BE PERFORMED BY THE CONTRACTOR AT NO ADDITIONAL COST TO IDOT OR CDOT.
- 7. NO STOCK-PILING OR STAGING ALLOWED ON CHICAGO PARKWAYS.


L-02


REVISIONS AME D	ATE	ILLINOIS DEPARTMENT OF TRANSPORTATION
		35th ST. GATEWAY LANDSCAPE PLAN
		STA. 426+50 TO STA. 430+50


410 South Michigan Avenue Chicago, Illinois 60605 312.322.0911 fax 312.322.5324


The Fine Arts Building

SCALE: 1"=40" DRAWN BY: RPS CHECKED BY:

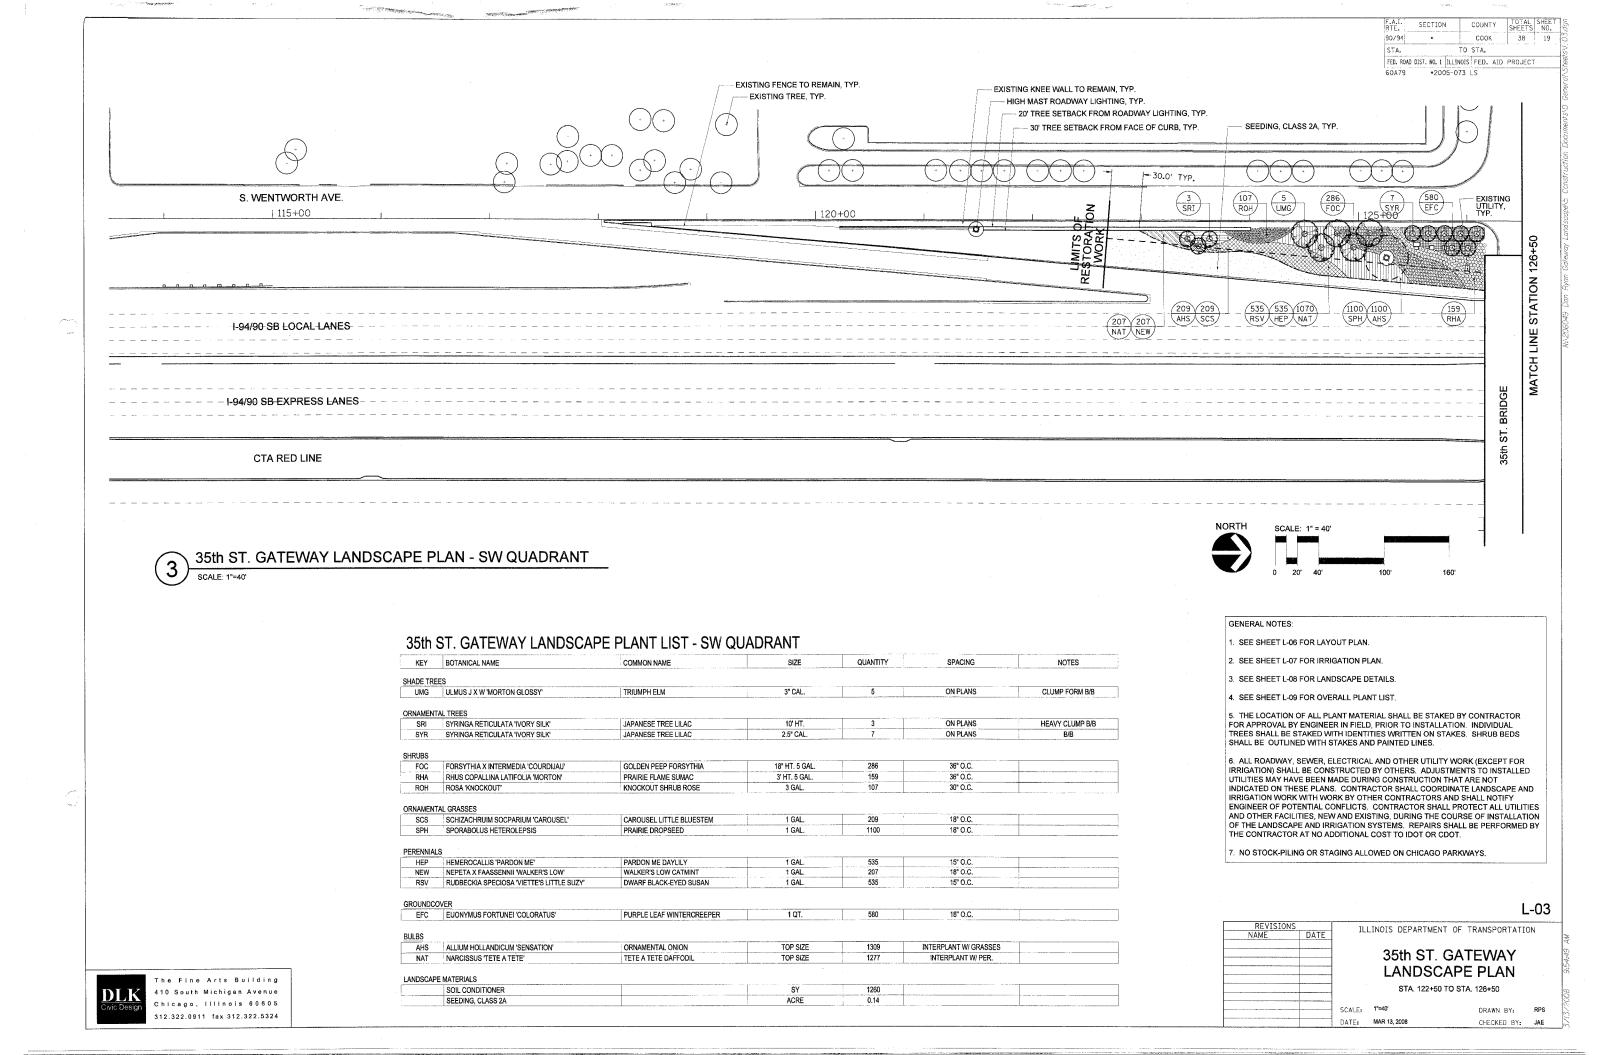

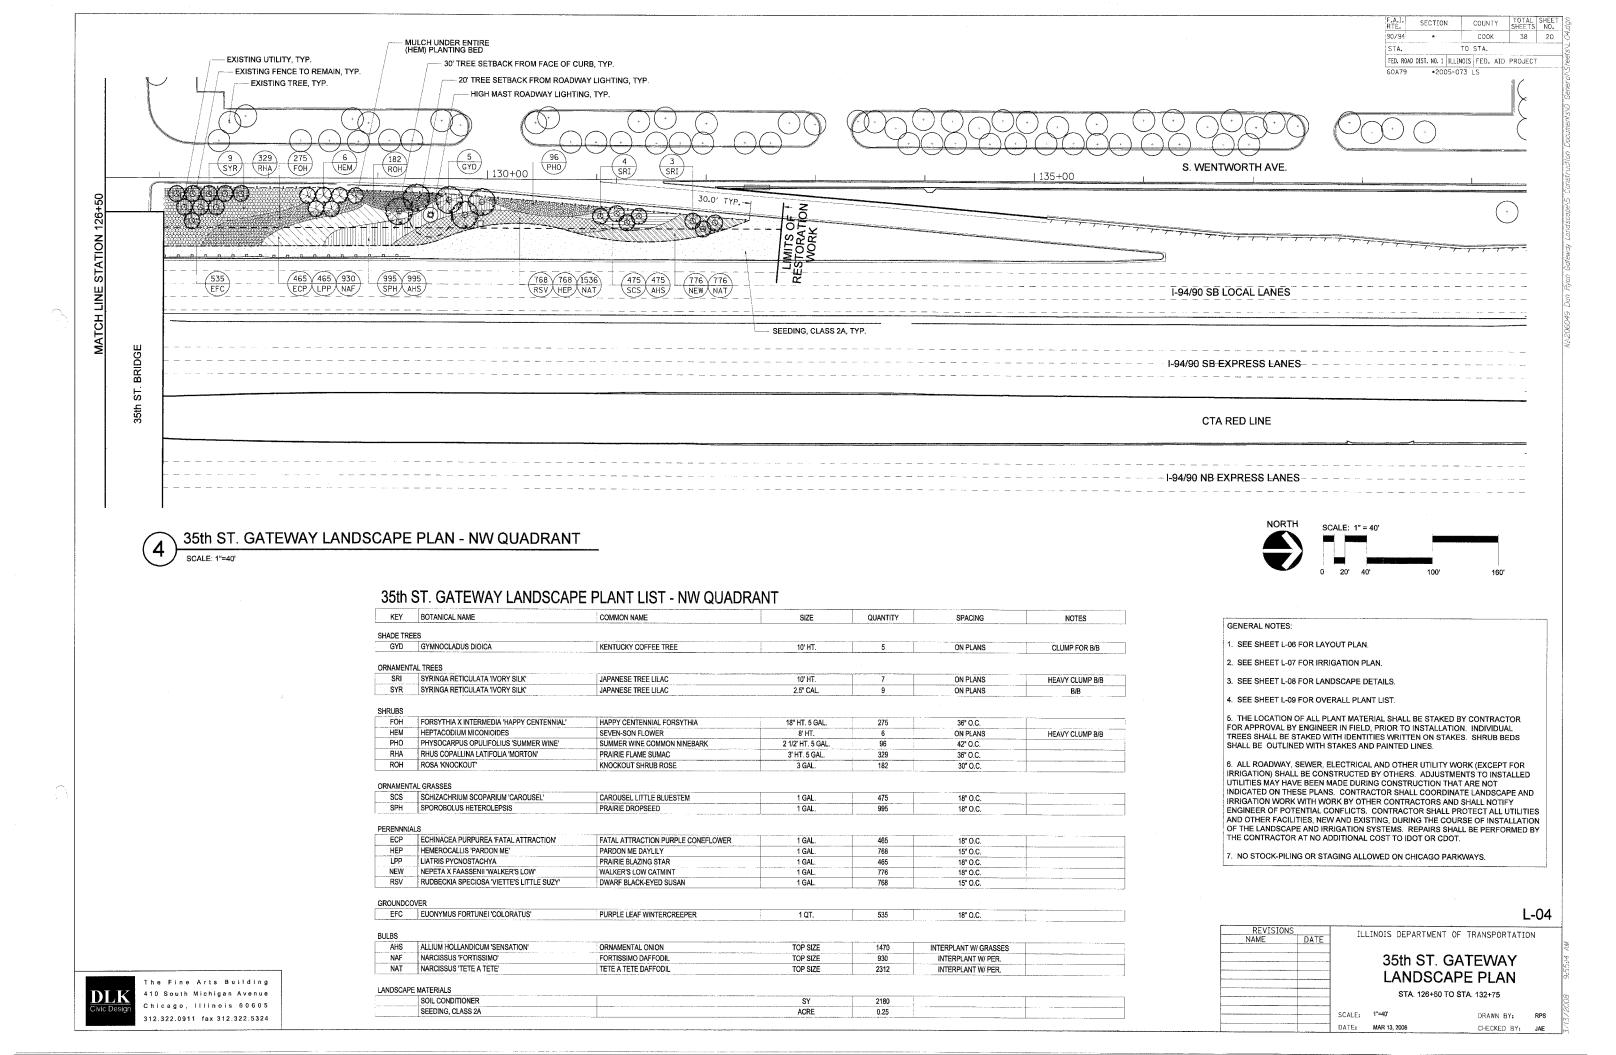

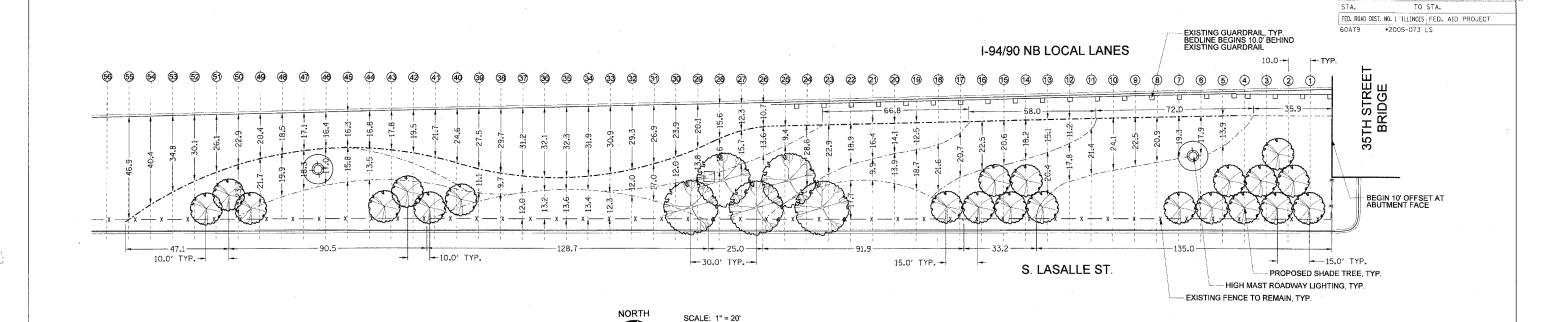

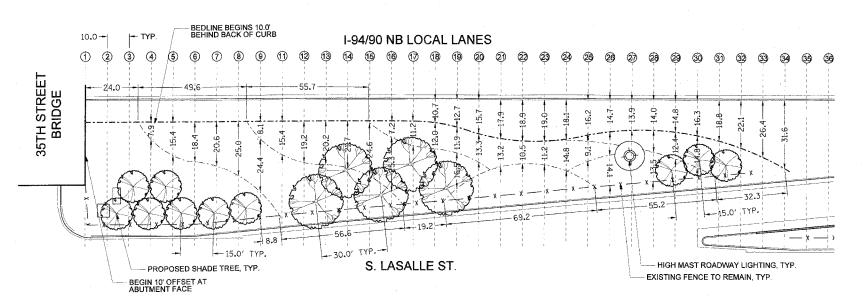

35th ST. GATEWAY LAYOUT PLAN - NE QUADRANT SCALE: 1"=20"

35th ST. GATEWAY LAYOUT PLAN - SE QUADRANT

SCALE: 1"=20'



GENERAL NOTES:

- 1. SEE SHEETS L-01 AND L-02 FOR LANDSCAPE PLANS.
- 2. SEE SHEET L-07 FOR IRRIGATION PLAN.
- 3. SEE SHEET L-08 FOR LANDSCAPE DETAILS.
- 4. SEE SHEET L-09 FOR OVERALL PLANT LIST.
- 5. THE LOCATION OF ALL PLANT MATERIAL SHALL BE STAKED BY CONTRACTOR FOR APPROVAL BY ENGINEER IN FIELD, PRIOR TO INSTALLATION. INDIVIDUAL TREES SHALL BE STAKED WITH IDENTITIES WRITTEN ON STAKES. SHRUB BEDS SHALL BE OUTLINED WITH STAKES AND PAINTED LINES.

SECTION

90/94

COUNTY

COOK

38


- 6. ALL ROADWAY, SEWER, ELECTRICAL AND OTHER UTILITY WORK (EXCEPT FOR IRRIGATION) SHALL BE CONSTRUCTED BY OTHERS. ADJUSTMENTS TO INSTALLED UTILITIES MAY HAVE BEEN MADE DURING CONSTRUCTION THAT ARE NOT INDICATED ON THESE PLANS. CONTRACTOR SHALL COORDINATE LANDSCAPE AND IRRIGATION WORK WITH WORK BY OTHER CONTRACTORS AND SHALL NOTIFY ENGINEER OF POTENTIAL CONFLICTS. CONTRACTOR SHALL PROTECT ALL UTILITIES AND OTHER FACILITIES, NEW AND EXISTING, DURING THE COURSE OF INSTALLATION OF THE LANDSCAPE AND IRRIGATION SYSTEMS. REPAIRS SHALL BE PERFORMED BY THE CONTRACTOR AT NO ADDITIONAL COST TO IDOT OR CDOT.
- 7. NO STOCK-PILING OR STAGING ALLOWED ON CHICAGO PARKWAYS.

L-05

UE 41210IA2		ILLINOIS DEPARTMENT OF TRANSPORTATION							
NAME	DATE	15	TINOTO DEL	ARTMENT	UF IF	KANSPURTATIL	JN		
EVISED	4,25.08								
			35th	ST. G	ITA	EWAY			
				LAYC					
			STA	4. 413+75 TC	STA.	426+50			
		SCALE:	1"=20"			DRAWN BY:	RPS		
		DATE:	MAR 13, 2008			CHECKED BY:	JAE		


The Fine Arts Building 410 South Michigan Avenue Chicago, Illinois 60605 312.322.0911 fax 312.322.5324



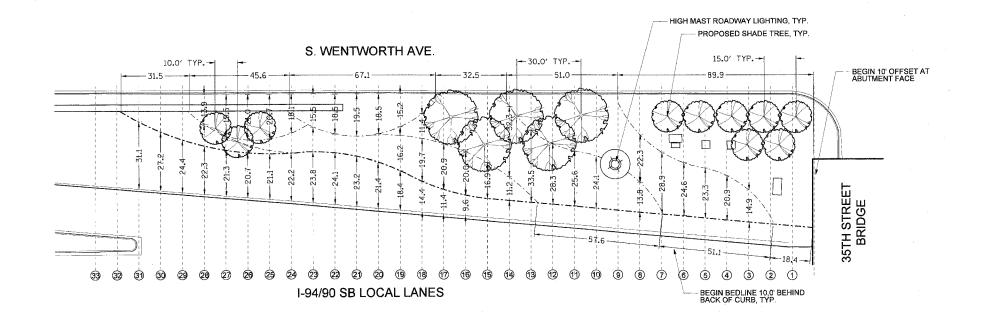

GENERAL NOTES:

- . SEE SHEETS L-03 AND L-04 FOR LANDSCAPE PLANS.
- 2. SEE SHEET L-07 FOR IRRIGATION PLAN.
- 3. SEE SHEET L-08 FOR LANDSCAPE DETAILS.
- 4. SEE SHEET L-09 FOR OVERALL PLANT LIST.
- 5. THE LOCATION OF ALL PLANT MATERIAL SHALL BE STAKED BY CONTRACTOR FOR APPROVAL BY ENGINEER IN FIELD, PRIOR TO INSTALLATION. INDIVIDUAL TREES SHALL BE STAKED WITH IDENTITIES WRITTEN ON STAKES. SHRUB BEDS SHALL BE OUTLINED WITH STAKES AND PAINTED LINES.
- 6. ALL ROADWAY, SEWER, ELECTRICAL AND OTHER UTILITY WORK (EXCEPT FOR IRRIGATION) SHALL BE CONSTRUCTED BY OTHERS. ADJUSTMENTS TO INSTALLED UTILITIES MAY HAVE BEEN MADE DURING CONSTRUCTION THAT ARE NOT INDICATED ON THESE PLANS. CONTRACTOR SHALL COORDINATE LANDSCAPE AND IRRIGATION WORK WITH WORK BY OTHER CONTRACTORS AND SHALL NOTIFY ENGINEER OF POTENTIAL CONFLICTS. CONTRACTOR SHALL PROTECT ALL UTILITIES AND OTHER FACILITIES, NEW AND EXISTING, DURING THE COURSE OF INSTALLATION OF THE LANDSCAPE AND IRRIGATION SYSTEMS. REPAIRS SHALL BE PERFORMED BY THE CONTRACTOR AT NO ADDITIONAL COST TO IDOT OR CDOT.
- 7. NO STOCK-PILING OR STAGING ALLOWED ON CHICAGO PARKWAYS.

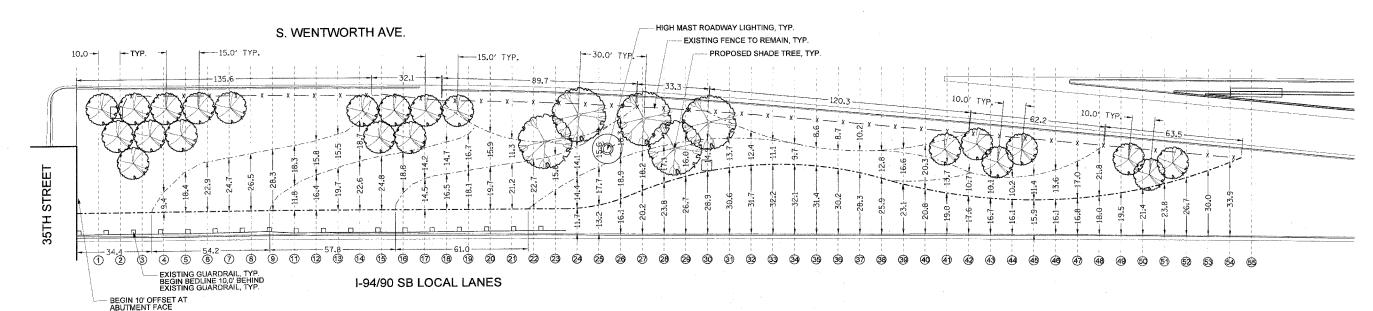

SCALE: 1" = 20'

35th ST. GATEWAY LAYOUT PLAN - NW QUADRANT SCALE: 1"=20'

35th ST. GATEWAY LAYOUT PLAN - SW QUADRANT


SCALE: 1"=20'




L-06

ILLINOIS DEPARTMENT OF TRANSPORTATION 35th ST. GATEWAY


The Fine Arts Building

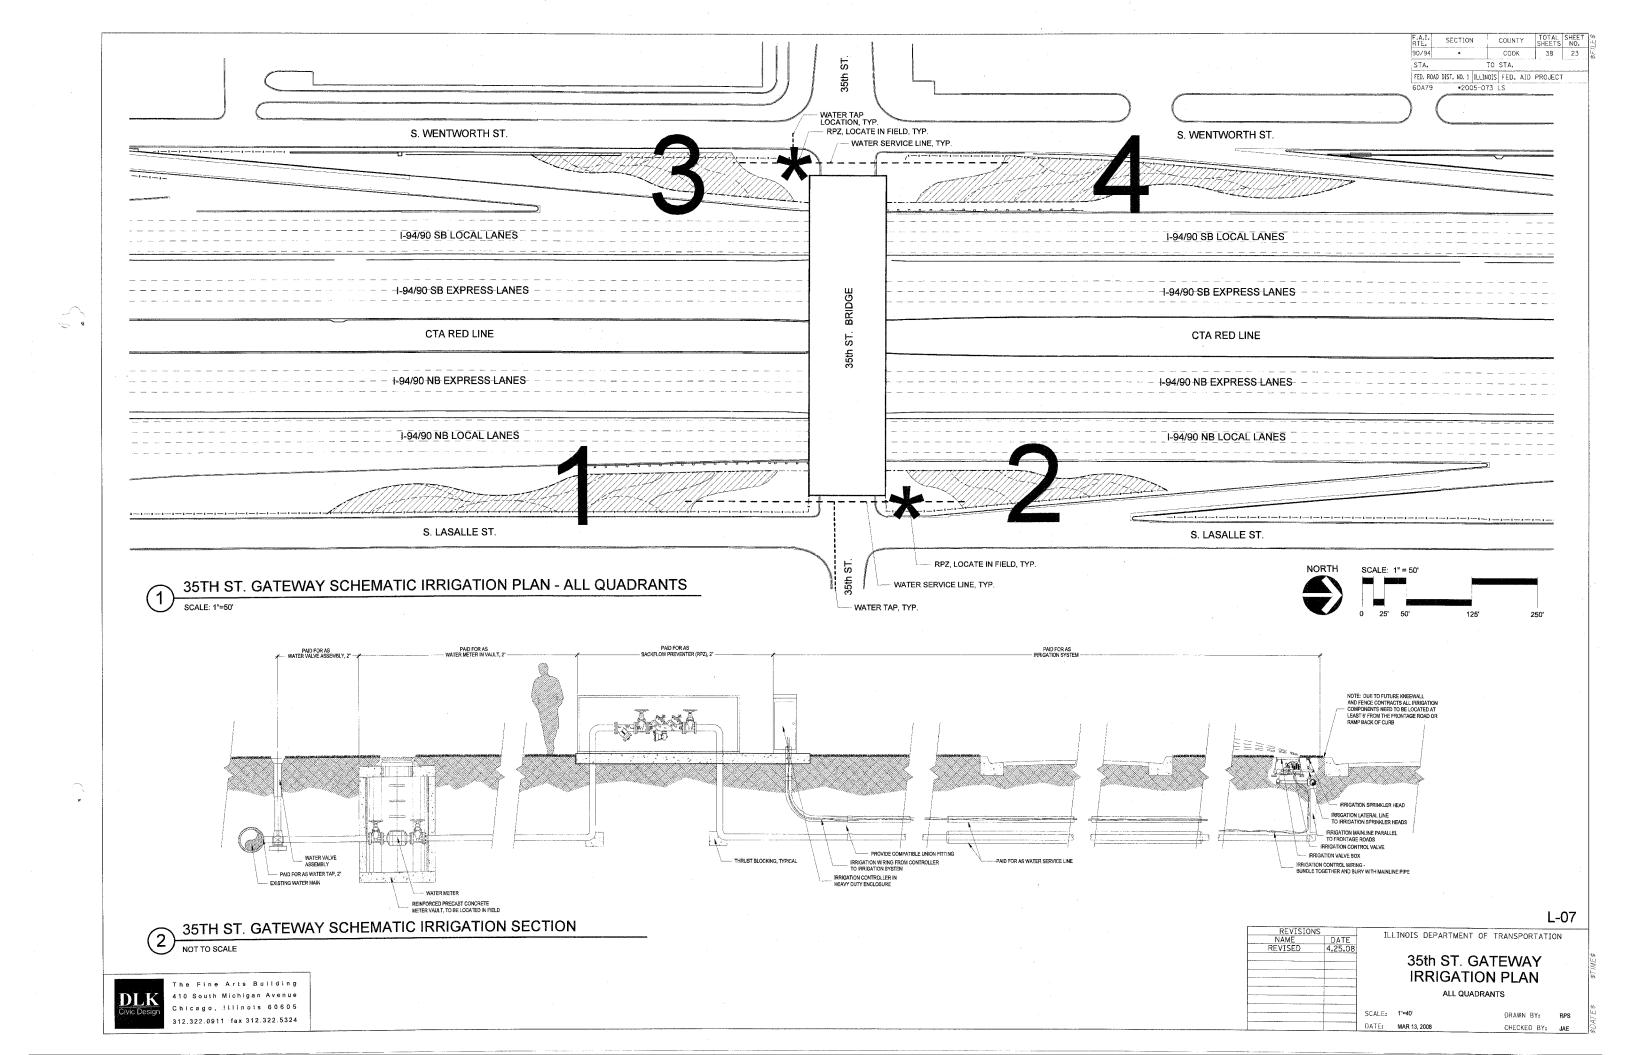

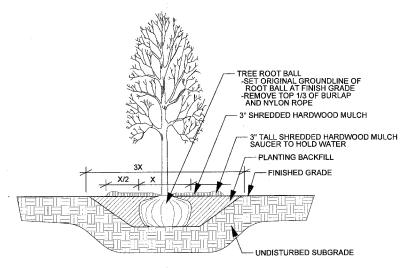


SHADE TREE PLANTING DETAIL

No Scale

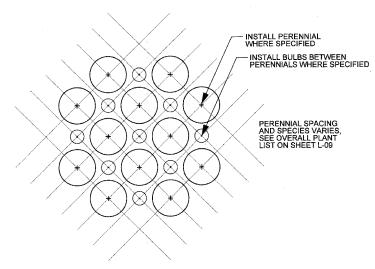


4 INTERPLANTING DETAIL

No Scale

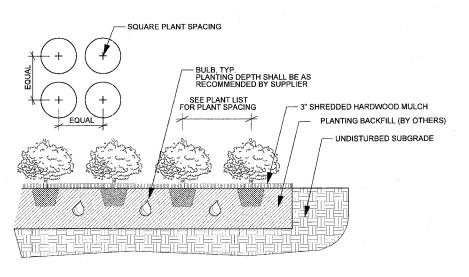


PERENNIAL AND BULB PLANTING DETAIL

No Scale

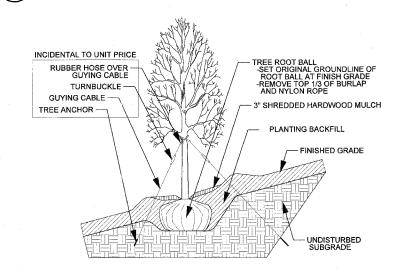

TREE PLANTING ON SLOPE DETAIL

No Scale

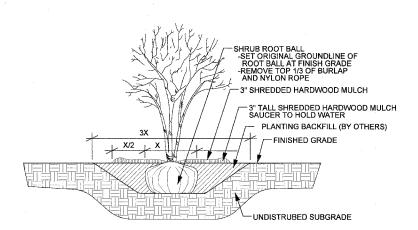

SECTION


STA.

COUNTY

TO STA.

FED. ROAD DIST. NO. 1 ILLINOIS FED. AID PROJECT 60A79 \*2005-073 LS

3 SHRUB PLANTING DETAIL
No Scale

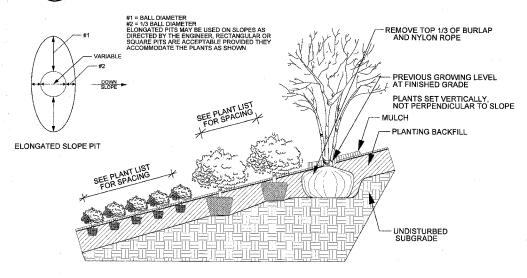

6 PERENNIAL AND SHRUB PLANTING ON SLOPE DETAIL

No Scale

3" ORGANIC MULCH, SEE SPECS
PLANTING BACKFILL
UNDISTURBED SUBGRADE

NCORPORATE TOGETHER BY ROTO-TILLING TO DEPTH OF 12"

SOIL AMENDMENT, ORGANIC

NOTE: ANY CLAY SOIL EXCAVATED FOR TREE OR SHRUB INSTALLATION SHALL BE REMOVED FROM SITE AND HOLE BACKFILLED WITH TOPSOIL FROM UPPER PORTION OF EXCAVATION.

L-08

REVISIONS		NOIS DEPARTMENT	F OF TRANSPORTATION	
NAME DA	TE TELL	MOTO DEL WILLIMEIA	OF TRANSPORTATION	
REVISED 4.2	5.08			
		35th ST. (	GATEWAY	
			· · · · · · · · · · · · · · · · · · ·	
		_ANDSCAF	PE DETAILS	
		411.011		
-		ALL QU	ADRANTS	

The Fine Arts Building
410 South Michigan Avenue
Chicago, Illinois 60605
312,322,0911 fax 312,322,5324

SCALE: NO SCALE
DATE: MAR 13, 2008

DRAWN BY: RPS
CHECKED BY: JAE

# 35th ST. GATEWAY LANDSCAPE - OVERALL PLANT LIST

KEY	BOTANICAL NAME	COMMON NAME	SIZE	QUANTITY	SPACING	NOTES	L-01	L-02	L-03	L-04
SHADE TR	EES						L			
GYD	GYMNOCLADUS DIOICA	KENTUCKY COFFEE TREE	10' HT.	10	ON PLANS	CLUMP FORM B/B	5		T	
UMG	ULMUS J X W 'MORTON GLOSSY'	TRIUMPH ELM	3" CAL.	10	ON PLANS	B/B		5	5	5
								·	J	!
RNAMEN	TAL TREES									
SRI	SYRINGA RETICULATA 'IVORY SILK'	JAPANESE TREE LILAC	10' HT.	20	ON PLANS	HEAVY CLUMP B/B	7	3	3	7
SYR	SYRINGA RETICULATA 'IVORY SILK'	JAPANESE TREE LILAC	2.5" CAL.	32	ON PLANS	B/B	9	7	7	9
						1			· · · · · · · · · · · · · · · · · · ·	
HRUBS										
FOC	FORSYTHIA X INTERMEDIA 'COURDIJAU'	GOLDEN PEEP FORSYTHIA	18" HT. 5 GAL.	286	36" O.C.			Ī —	286	T
FOG	FORSYTHIA X INTERMEDIA 'COURTACOUR'	GOLDILOCKS FORSYTHIA	18" HT. 5 GAL.	284	36" O.C.			284		
FOH	FORSYTHIA X INTERMEDIA 'HAPPY CENTENNIAL'	HAPPY CENTENNIAL FORSYTHIA	18" HT, 5 GAL.	542	36" O.C.		267			275
HEM	HEPTACODIUM MICONIOIDES	SEVEN-SON FLOWER	8' HT.	12	ON PLANS	HEAVY CLUMP B/B	6			6
PHO	PHYSOCARPUS OPULIFOLIUS 'SUMMER WINE'	SUMMER WINE COMMON NINEBARK	2 1/2' HT. 5 GAL.	222	42" O.C.		126	i		96
RHA	RHUS COPALLINA LATIFOLIA 'MORTON'	PRAIRIE FLAME SUMAC	3' HT. 5 GAL.	968	36" O.C.		311	169	159	329
ROH	ROSA 'KNOCKOUT'	KNOCKOUT SHRUB ROSE	3 GAL.	623	30" O.C.	The state of the s	210	124	107	182
	TAL GRASSES		1 - 10/4 = 10/4 = 1							
SCS	SCHIZACHRIUM SCOPARIUM 'CAROUSEL'	CAROUSEL LITTLE BLUESTEM	1 GAL.	1590	18" O.C.		638	268	209	475
SPH	SPOROBOLUS HETEROLEPSIS	PRAIRIE DROPSEED	1 GAL.	4139	18" O.C.		1138	906	1100	995
PERENNIA										
ECP	ECHINACEA PURPUREA 'FATAL ATTRACTION'	FATAL ATTRACTION PURPLE CONEFLOWER	1 GAL.	887	18" O.C.		422			465
HEP	HEMEROCALLIS 'PARDON ME'	PARDON ME DAYLILY	1 GAL.	2279	15" O.C.		592	384	535	768
LPP	LIATRIS PYCNOSTACHYA	PRAIRIE BLAZING STAR	1 GAL.	887	18" O.C.		422			465
NEW	NEPETA X FAASSENNII 'WALKER'S LOW'	WALKER'S LOW CATMINT	1 GAL.	2229	18" O.C.		866	380	207	776
RSV	RUDBECKIA SPECIOSA 'VIETTE'S LITTLE SUZY'	DWARF BLACK-EYED SUSAN	1 GAL.	2279	15" O.C.		592	384	535	768
										J
GROUNDC										
EFC	EUONYMUS FORTUNEI 'COLORATUS'	PURPLE LEAF WINTERCREEPER	1 QT.	2150	18" O.C.		540	495	580	535
BULBS										
AHS	ALLIUM HOLLANDICUM 'SENSATION'	ORNAMENTAL ONION	TOP SIZE	5729	INTERPLANT W/ GRASSES		1776	1174	1309	1470
NAF	NARCISSUS 'FORTISSIMO'	FORTISSIMO DAFFODIL	TOP SIZE	1774	INTERPLANT W/ PER.		844			930
NAT	NARCISSUS 'TETE A TETE'	TETE A TETE DAFFODIL	TOP SIZE	6787	INTERPLANT W/ PER.		2050	1148	1277	2312
ANDOOAT	DE MATERIAL C							- Van		
ANDSCAF	PE MATERIALS	1	0V	0005						
	SOIL CONDITIONER		SY	6825			2180	1205	1260	2180
	SEEDING, CLASS 2A		ACRE	0.79	i		0.27	0.13	0.14	0.25

L-09

REVISIONS
NAME DATE

ILLINOIS DEPARTMENT OF TRANSPORTATION

35th ST. GATEWAY

OVERALL PLANT LIST

ALL QUADRANTS

SCALE: NO SCALE
DATE: MAR 13, 2008

DRAWN BY: RPS
CHECKED BY: JAE


The Fine Arts Building
410 South Michigan Avenue
Chicago, Illinois 60605
312.322.0911 fax 312.322.5324

LEGEND:

INLET FILTER

扭

EROSION CONTROL BLANKET

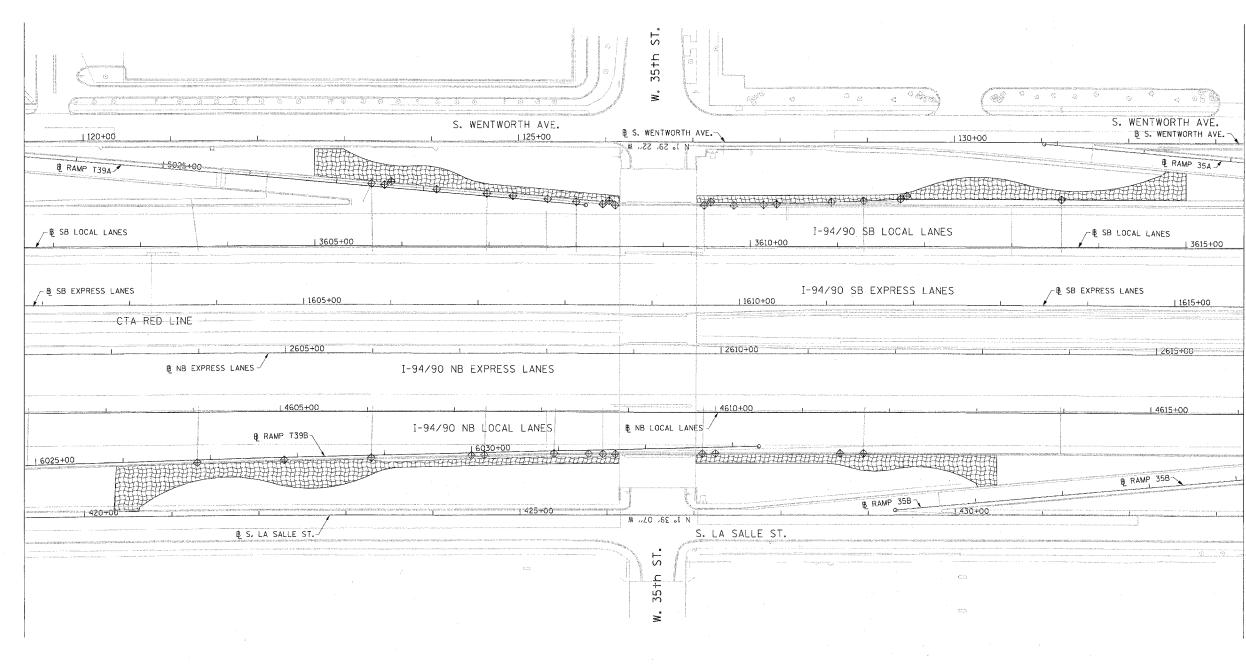

BOWMAN, BARRETT & ASSOCIATES INC.
CONSULTING ENGINEERS
CHICAGO ILLINOIS
312.22 . 0100
WWW.BBANDAINC.COM

REVISIONS ILLINOIS DEPARTMENT OF TRANSPORTATION


REVISED 4/25/0
F.A.I. 94/90 (DAN RYAN EXPRESSWAY)

GATEWAY LANDSCAPING & IRRIGATION @ 35TH


EROSION CONTROL PLAN


SCALE: 1"=50 DATE: 03/13/07

DRAWN BY: JMP CHECKED BY: RS

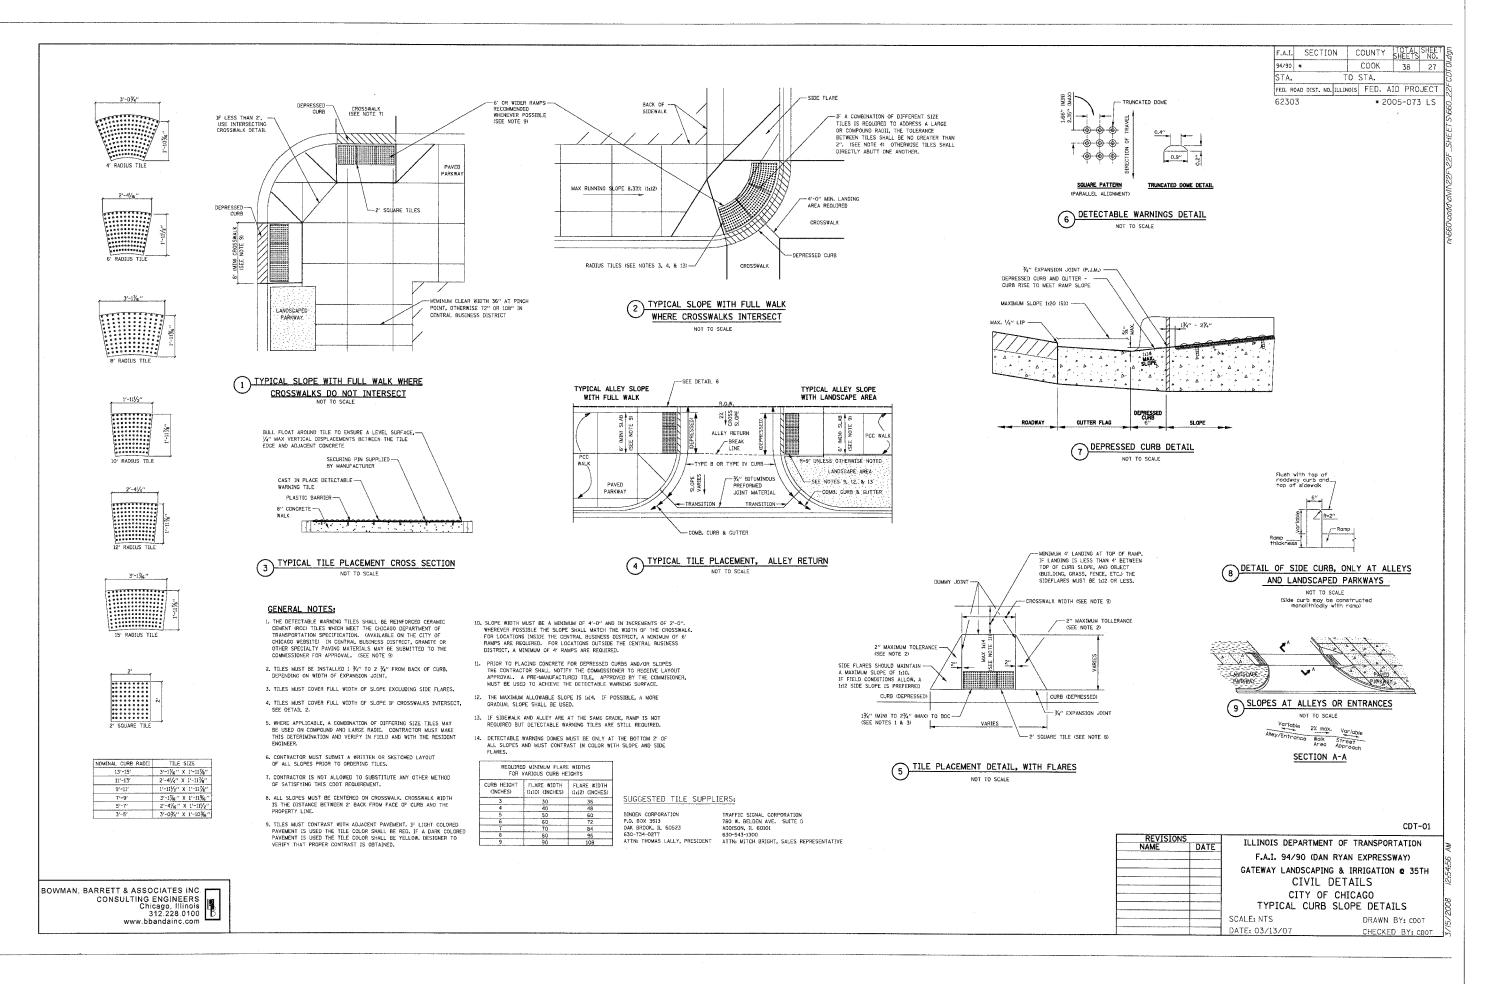


...\22F\_SHEETS\660\_22FC0T01.dgn 3/15/2008 12:54:56 AM

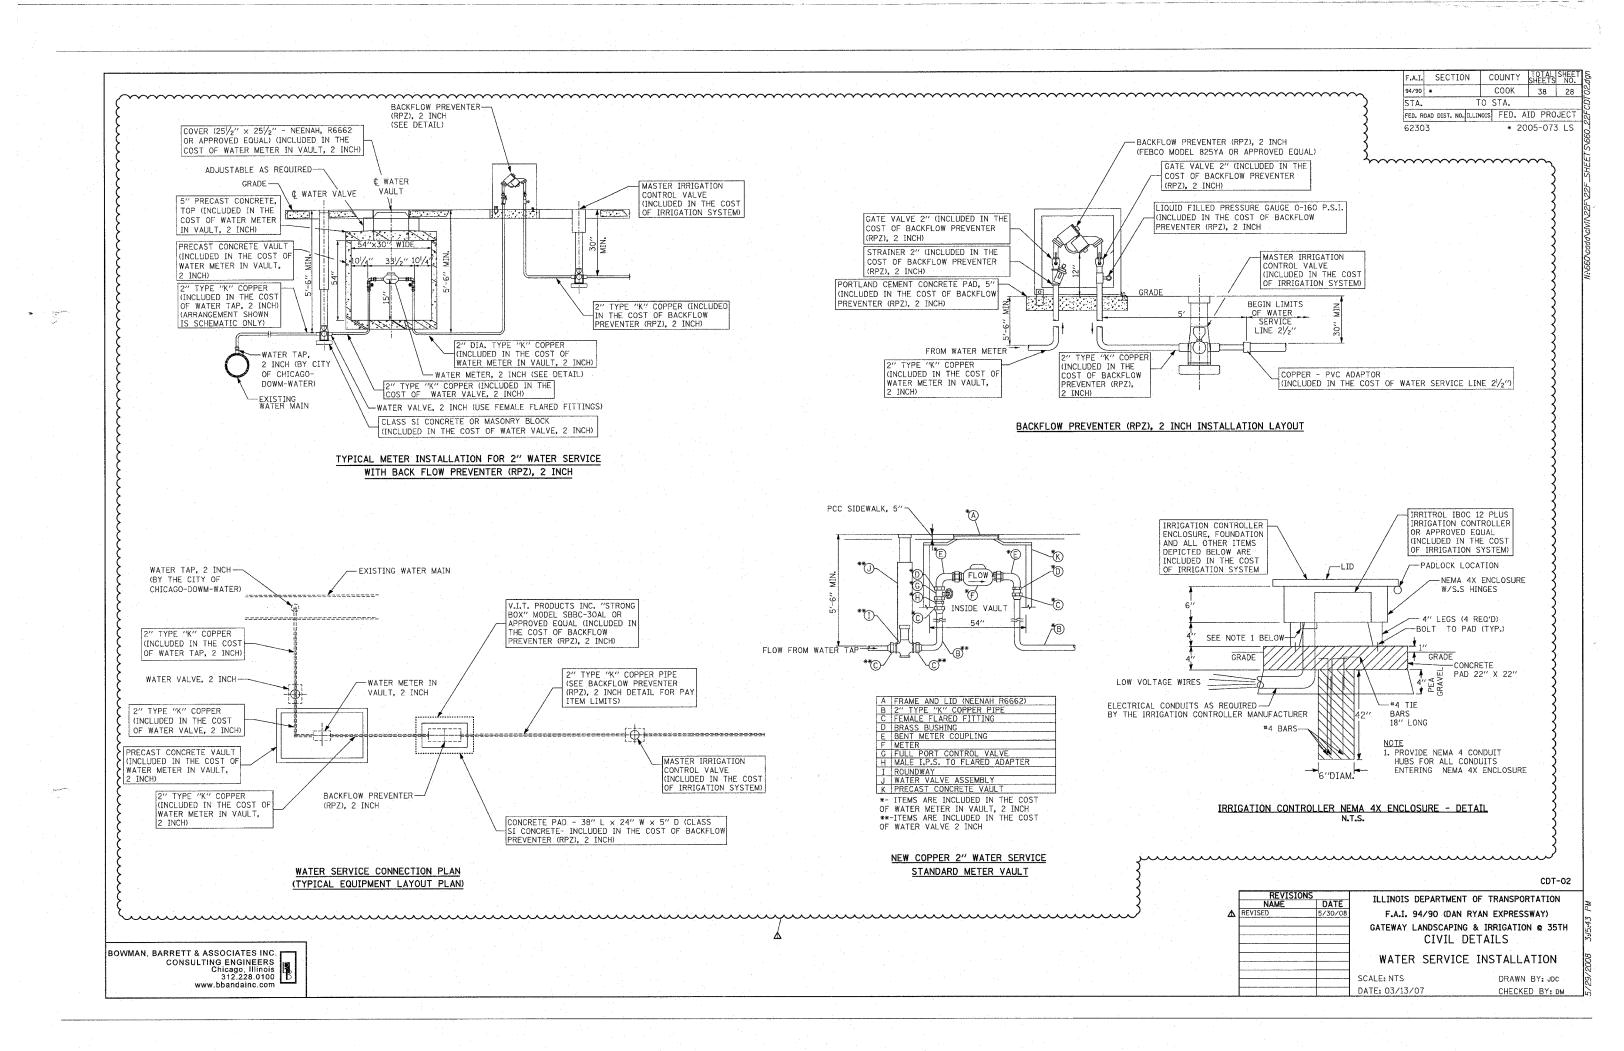


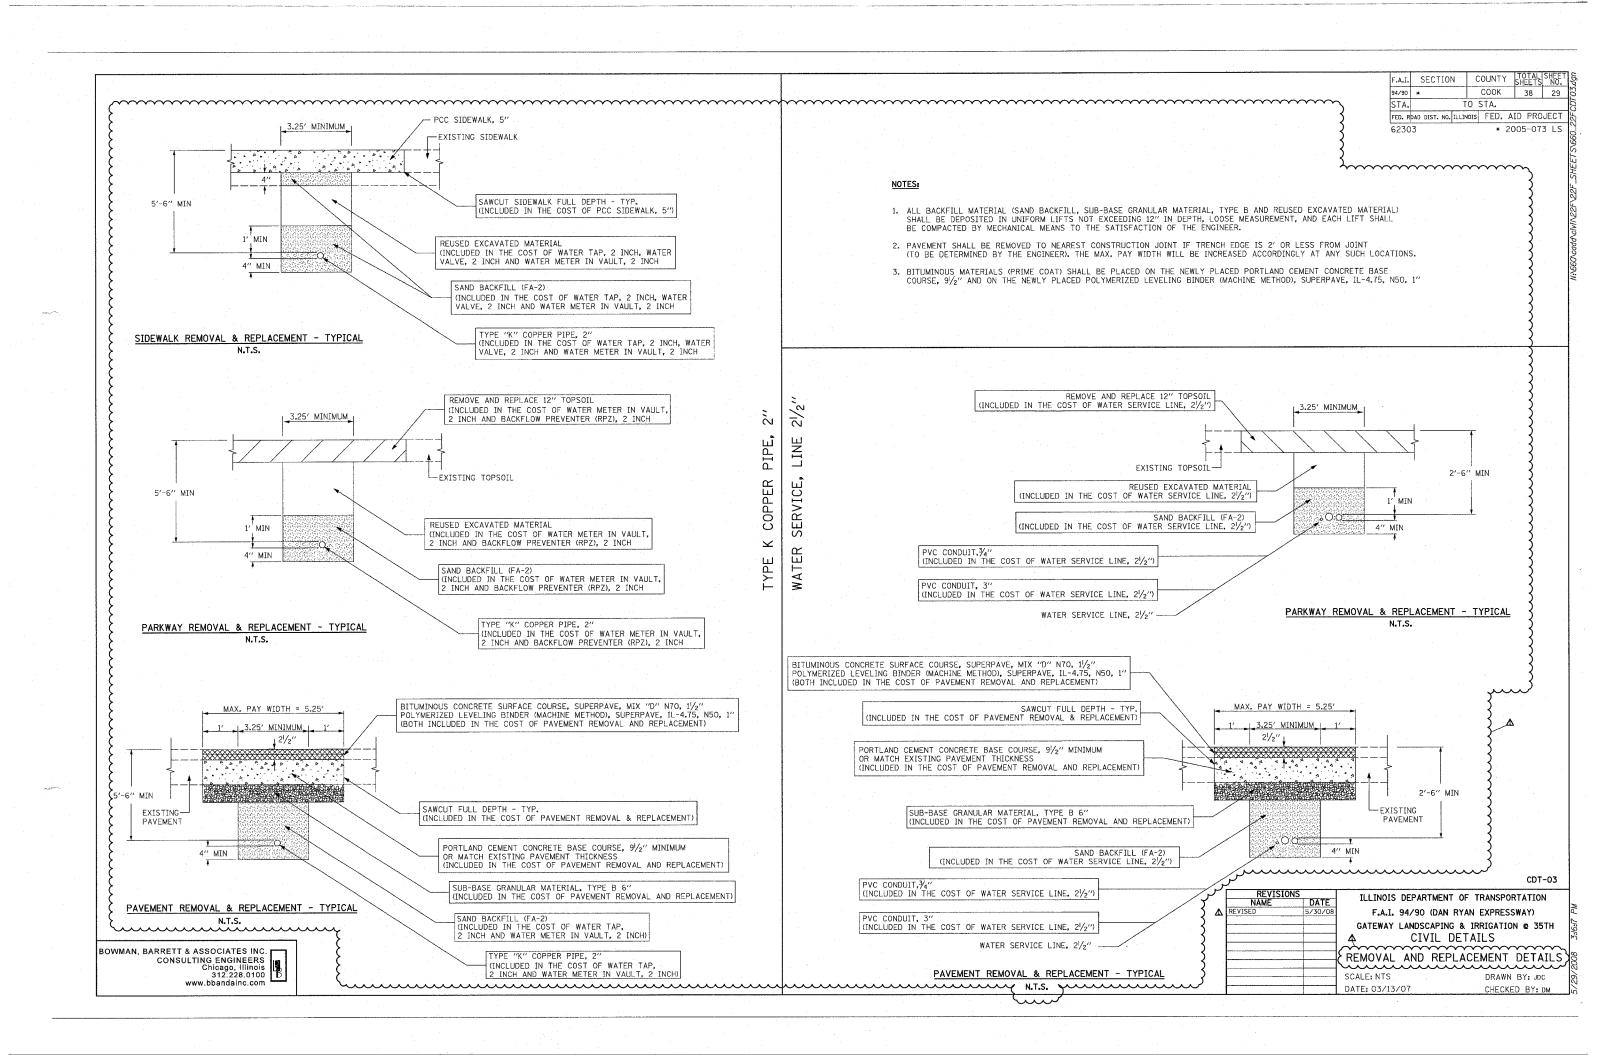

| F.A.I. | SECTION | COUNTY | TOTAL SHEET | SOUTH | SHEET | SOUTH | SHEET | SH PAGE INTENTIONALLY LEFT BLANK CDT-04 ILLINOIS DEPARTMENT OF TRANSPORTATION F.A.I. 94/90 (DAN RYAN EXPRESSWAY) GATEWAY LANDSCAPING & IRRIGATION @ 35TH BOWMAN, BARRETT & ASSOCIATES INC.
CONSULTING ENGINEERS
Chicago, Illinois
312.228.0100
www.bbandainc.com DRAWN BY: CDOT SCALE: NTS
DATE: 03/13/07 CHECKED BY: CDOT

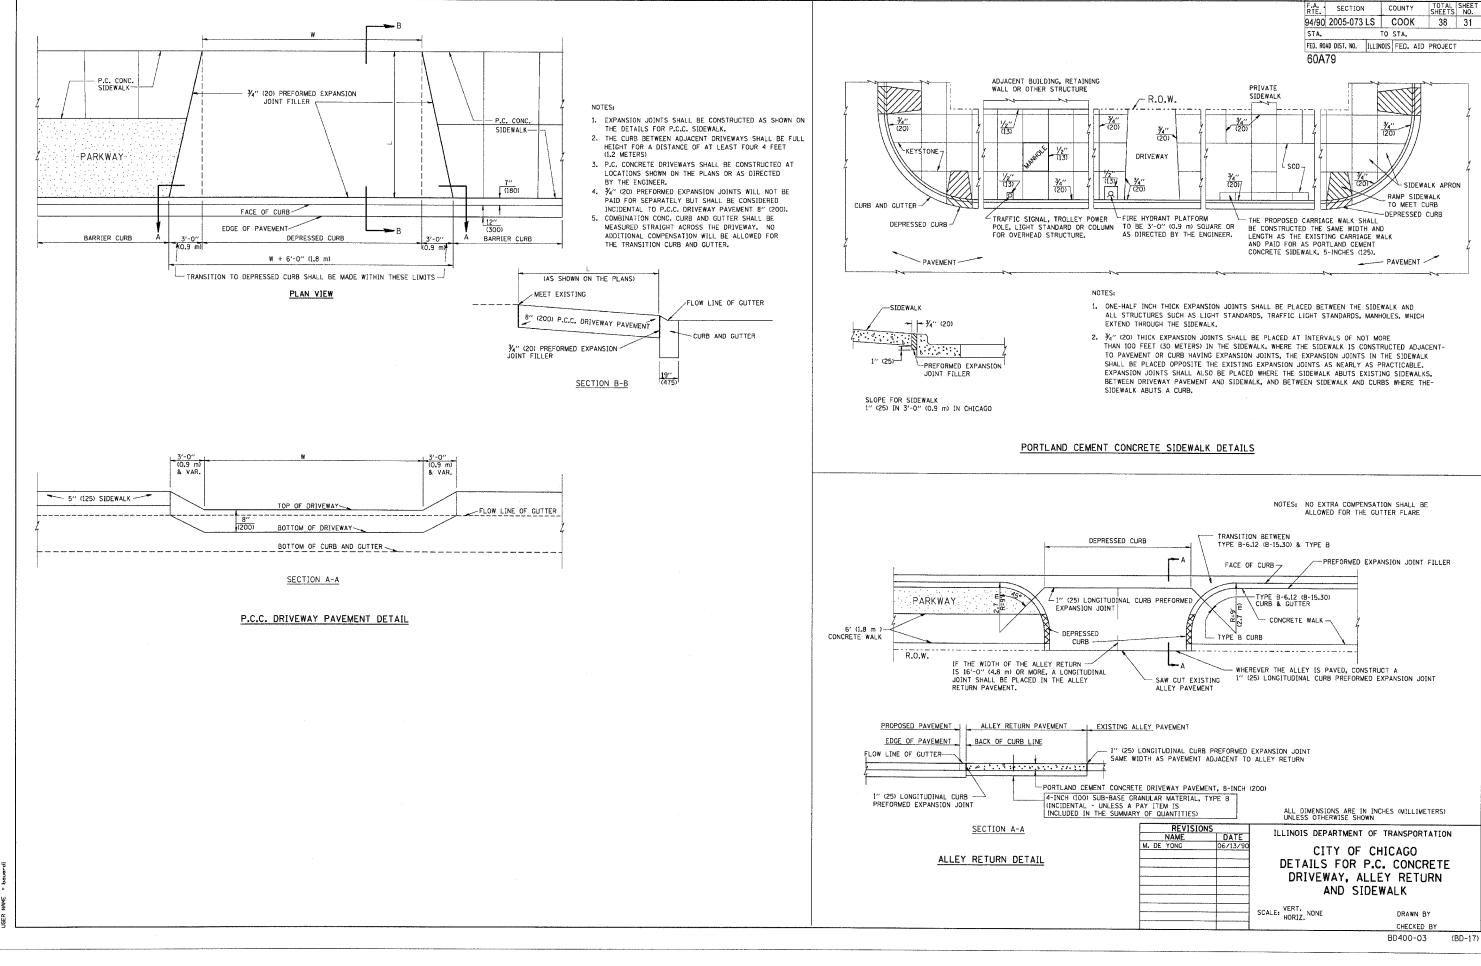

CONTRACT NO.

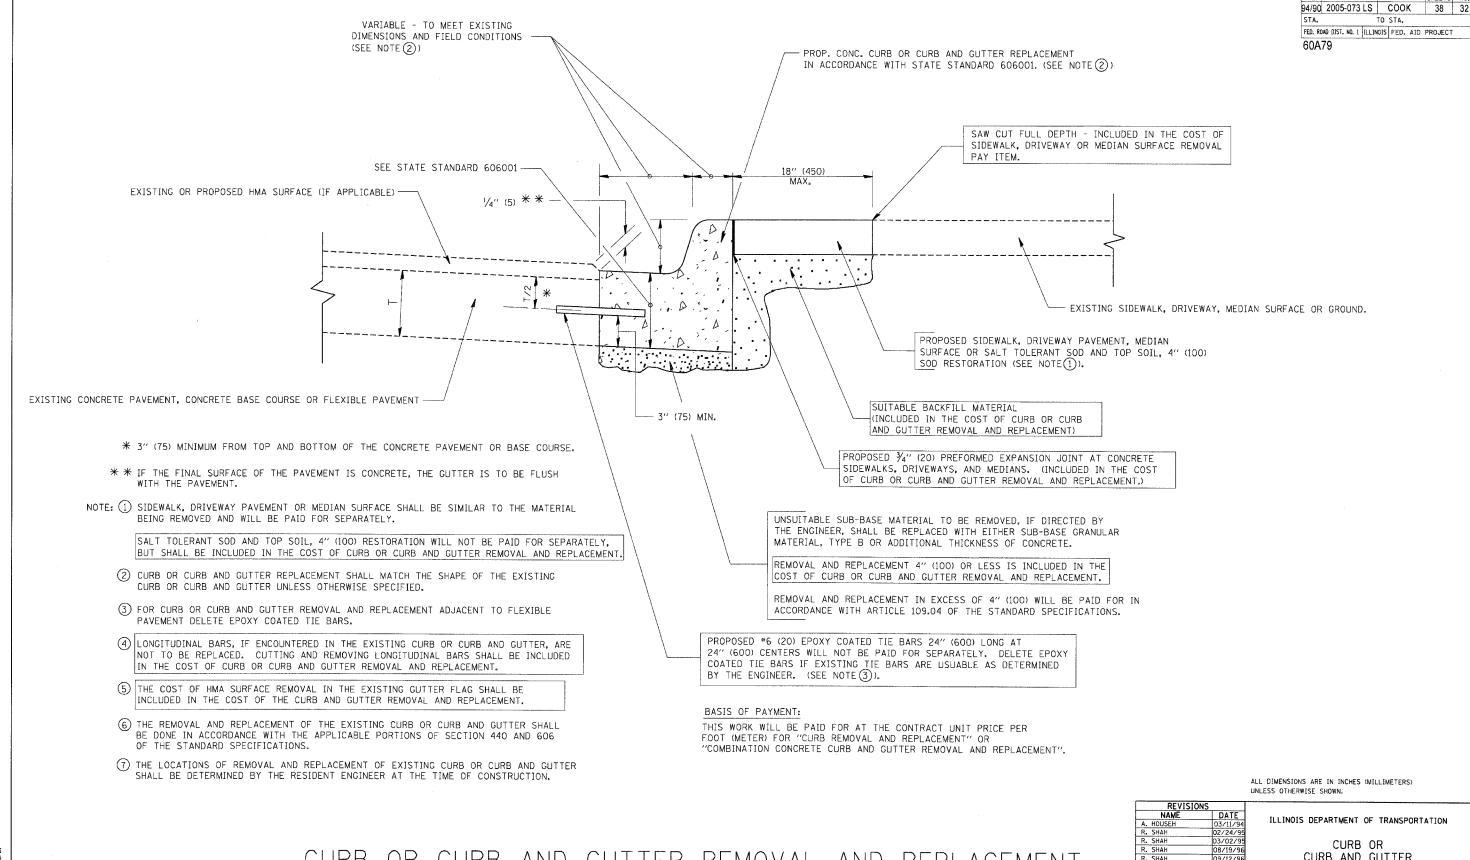

CURB OR CURB AND GUTTER REMOVAL AND REPLACEMENT

REVISIONS							
NAME	DATE						
A. HOUSEH	03/11/94						
R. SHAH	02/24/95						
R. SHAH	03/02/95						
R. SHAH	08/19/96						
R. SHAH	09/12/96						
R. SHAH	09/19/96						
R. SHAH	10/03/96						
A. ABBAS	03/21/97						
M. GOMEZ	01/22/01						
R. BORO	01/01/07						

CURB AND GUTTER REMOVAL AND REPLACEMENT

SCALE: VERT, NONE

DRAWN BY

CONTRACT NO.

RTE. SECTION COUNTY

CHECKED BY BD600-06 (BD-24)

RTE. SECTION COUNTY 94/90 2005-073 LS COOK 38 33 STA. TO STA. FED. ROAD DIST. NO. ILLINOIS FED. AID PROJECT 60A79 ROAD CONSTRUCTION AHEAD ROAD TYPE III BARRICADES WITH TWO FLASHING AMBER LIGHTS ON EACH. AHEAD TYPE I OR TYPE II BARRICADES WITH ONE FLASHING AMBER LIGHT ON EACH, OR 15 (380) <del>15</del> 21 (530) TYPE III BARRICADES WITH TWO FLASHING 200'± (60 m±)-AMBER LIGHTS ON EACH. DRIVEWAY 200'± (60 m±) STREET; COLLECTOR LIMIT> 40 MPH ( ROAD CONSTRUCTION W20-1(0) M6-4(0)-2115 AHEAD M6-1(0)-2115

# TRAFFIC CONTROL AND PROTECTION FOR SIDE ROADS, INTERSECTIONS, AND DRIVEWAYS

# NOTES:

- A. FOR NO LANE RESTRICTION ON THE SIDE ROAD OR DRIVEWAYS
- 1. SIDE ROAD WITH A SPEED LIMIT OF 40 MPH (60 km/h) OR LESS AS SHOWN ON THE DRAWING AND AS DIRECTED BY THE ENGINEER:
- d) ONE ROAD CONSTRUCTION AHEAD SIGN 36 x 36 (900x900) WITH A FLASHER AND FLAG MOUNTED ON IT APPROXIMATELY 200' (60 m) IN ADVANCE OF THE MAIN ROUTE.
- b) THE CLOSED PORTION OF THE MAIN ROUTE SHALL BE PROTECTED BY BLOCKING WITH TYPE I, TYPE II OR TYPE III BARRICADES, 1/3 OF THE CROSS SECTION OF THE CLOSED PORTION.
- 2. SIDE ROAD WITH A SPEED LIMIT GREATER THAN 40 MPH (60 km/h) AS SHOWN ON THE DRAWING AND AS DIRECTED BY THE ENGINEER:
- 0) ONE ROAD CONSTRUCTION AHEAD SIGN 48  $\times$  48 (1.2 m  $\times$  1.2 m) WITH A FLASHER MOUNTED ON IT APPROXIMATELY 500° (150 m) IN ADVANCE OF THE MAIN ROUTE.
- b) THE CLOSED PORTION OF THE MAIN ROUTE SHALL BE PROTECTED BY BLOCKING WITH TYPE III BARRICADES, 1/2 OF THE CROSS SECTION OF THE CLOSED PORTION.
- 3. WHEN THE SIDE ROAD LIES BETWEEN THE BEGINNING OF THE MAINLINE SIGNING AND THE WORK ZONE, A SINGLE HEADED ARROW (M6-1) SHALL BE USED IN LIEU OF THE DOUBLE HEADED ARROW (M6-4).


#### B. FOR A LANE CLOSURE ON A SIDE ROAD OR DRIVEWAY:

- USE APPLICABLE PORTIONS OF THE TYPICAL APPLICATION OF TRAFFIC CONTROL DEVICES (STD. 701501, STD. 701606 OR THE APPROPRIATE STANDARD). THE SPACING OF SIGNS AND BARRICADES SHALL BE ADJUSTED FOR FIELD CONDITIONS AS DIRECTED BY THE ENGINEER. THE DIRECTIONAL ARROW SHALL BE COVERED OR REMOVED WHEN NO LONGER CONSISTENT WITH THE SIDE ROAD LANE CLOSURE.
- C. ADVANCE WARNING SIGNS ARE TO BE OMITTED ON DRIVEWAY UNLESS OTHERWISE NOTED.
- D. THE TRAFFIC CONTROL AND PROTECTION FOR SIDE ROADS, INTERSECTIONS, AND DRIVEWAYS SHALL BE INCIDENTAL TO THE COST OF SPECIFIED TRAFFIC CONTROL STANDARDS OR ITEMS.

All dimensions are in millimeters (inches) unless otherwise shown.

REVISIONS		ILLINOIS DEPARTMENT OF TRANSPORTATION					
	NAME	DATE	ILLINOIS DEPAR	TIMENT OF TH	ANSPURTATION		
	LHA	6/89	TRAFFIC CON	TROI AND	PROTECTION		
	T. RAMMACHER	09/08/94	INALLIC CON		PROTECTION		
	J. OBERLE	10/18/95		FOR			
	A. HOUSEH	03/06/96	CIDE DOADS	THITCHOCK	CTIONIC AND		
	A. HOUSEH	10/15/96	SIDE ROADS,	INTERSE	CITONS, AND		
	T. RAMMACHER	01/06/00	[	ORIVEWAYS	;		
			_		•		
			SCALE: NONE		DRAWN BY		
				CHECKED BY			
-							
					TC-10		

CONTRACT NO.

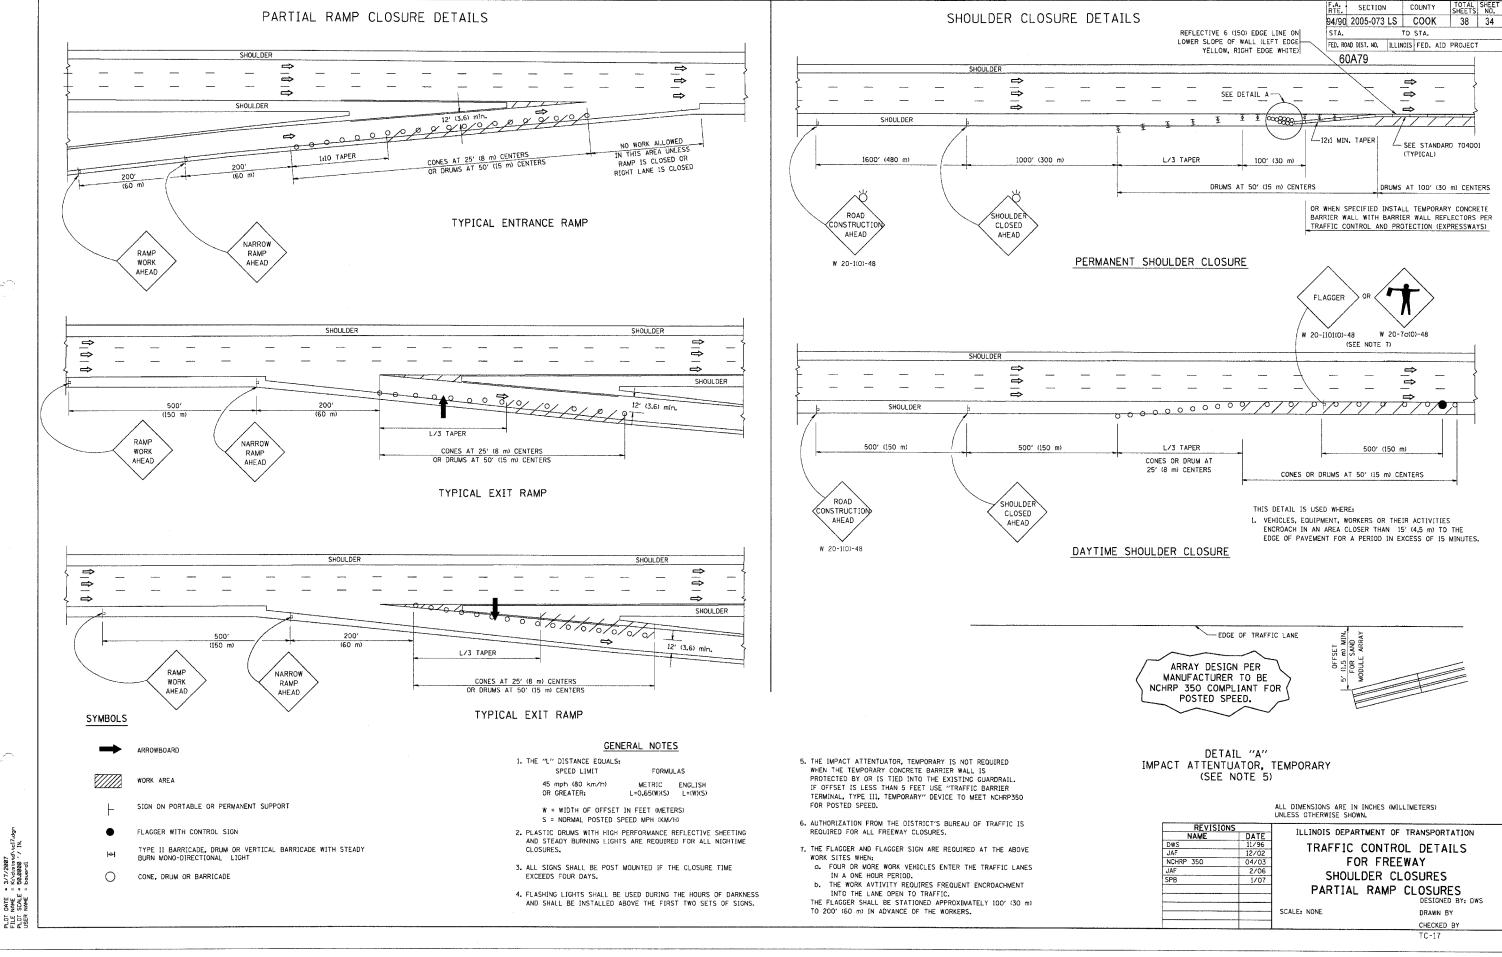



CONTRACT NO.

CREATED: 03-23-95

60A79

WORK ZONE EXIT OPENING

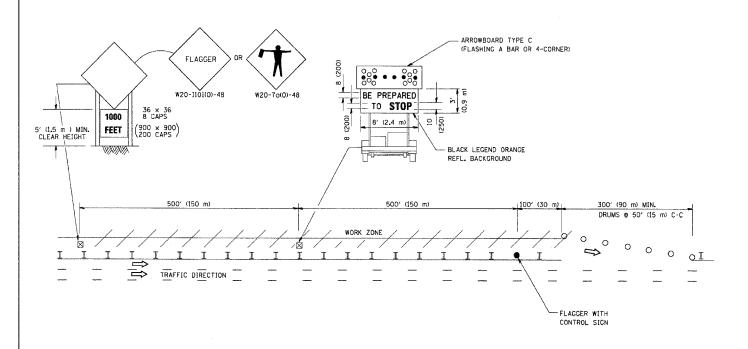

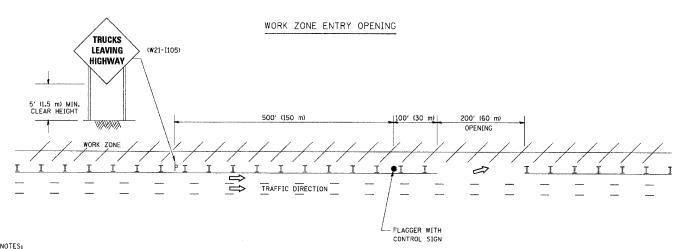

- 1. The Arrowboard, the Flagger Ahead trailer mounted sign, and the Trucks Leaving Highway sign shall be removed or turned away from traffic and the exit and entry openings shall be closed when the flagging operation ceases.
- 2. Work Zone Exit Openings should be a minimum of one half mile apart.
- 3. Exiting the work zone at any place other than at a Work Zone Exit Opening will be prohibited.
- 4. All vehicles shall enter the work zone at entry openings, using their turn signals to warn motorists


ALL DIMENSIONS ARE IN INCHES (MILLIMETERS)
UNLESS OTHERWISE SHOWN

REVISION	S	ILLINOIS DEPARTMENT OF TRANSPORTATION					
NAME	DATE	ILLINOIS DEPARTMENT OF TRANSPORTATION					
DWS	8/98						
JAF	4/03						
JAF	2/06	SIGNING FOR FLAGGING OPERATIONS					
SPB	1/07						
		AT WORK ZONE OPENINGS					
		SCALE: NONE DRAWN BY CADD					


DRAWN BY CADD CHECKED BY


TC~18

DATE = 3/7/2007
NAME = Ki\distat\tol8,d
SCALE = 50.000 ' IN,
NAME = boundl

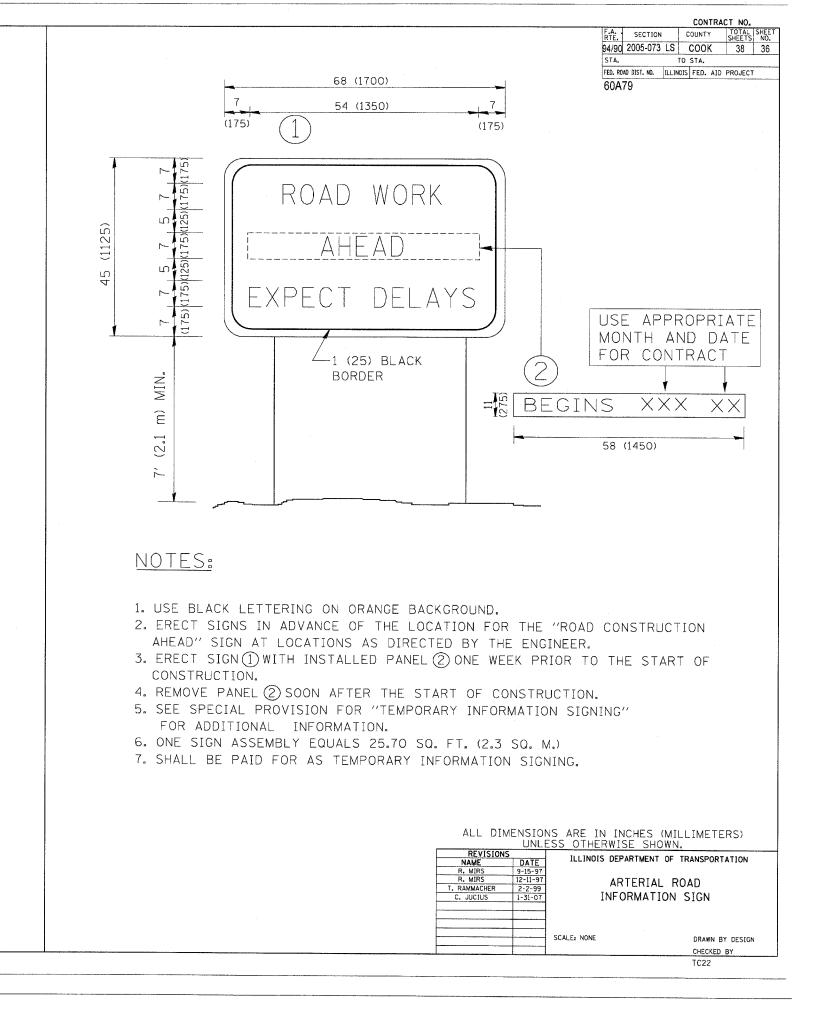

AME = Ki\diststd\to22.dgn SCALE = 56.888 '/ IN. IAME = bouerd!

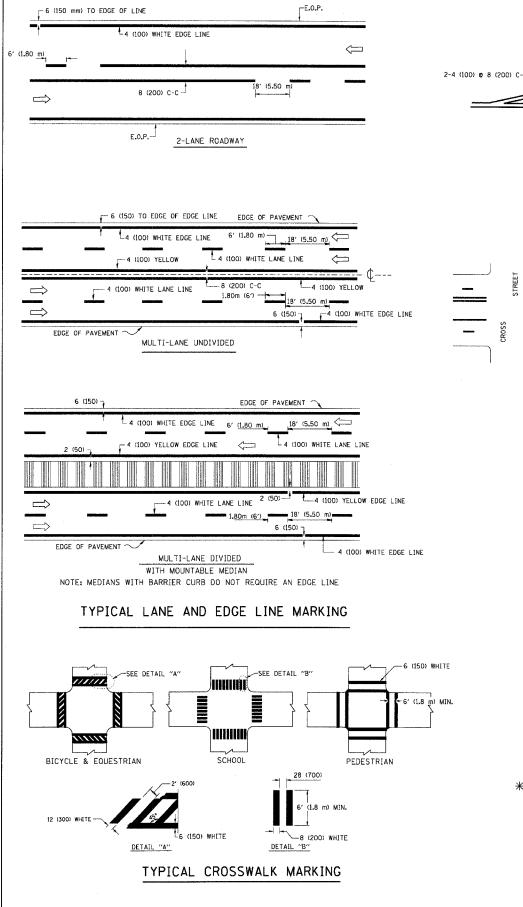


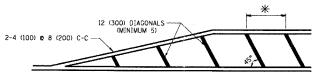


\*FOR MEDIAN LENGTHS WHERE DIAGONAL SPACING CANNOT BE ATTAINED, USE 5 (FIVE) EQUALLY SPACED

\* DIAGONAL LINE SPACING: 20' (6.1 m) C-C

### PAINTED MEDIANS

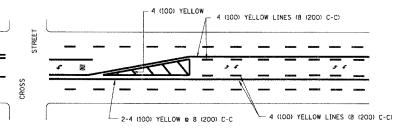


A MINIMUM OF TWO PAIRS OF TURN ARROWS SHALL BE USED, WHITE IN COLOR. ADDITIONAL PAIRS SHALL BE PLACED AT 200' (60 m) TO 300' (90 m) INTERVALS.

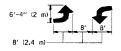

MEDIAN WITH TWO-WAY LEFT TURN LANE

## TYPICAL PAINTED MEDIAN MARKING

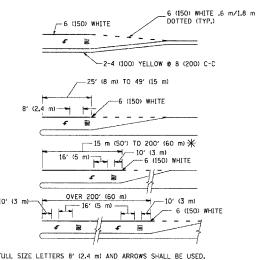

FULL SIZE LETTERS B' (2.4 m) AND ARROWS SHALL BE USED.  $\P$  AREA = 15.8 SO. FT. (1.47 m<sup>2</sup>)  $\P$  AREA = 22.9 SO. FT. (2.13 m<sup>2</sup>)

\* TURN LANES IN EXCESS OF 400' (120 m) IN LENGTH MAY HAVE AN ADDITIONAL SET OF ARROW - "ONLY" INSTALLED MIDWAY BETWEEN THE OTHER TWO SETS OF ARROW - "ONLY".

TYPICAL LEFT (OR RIGHT) TURN LANE

# TYPICAL TURN LANE MARKING

8 (200) WHITE -12 (300) WHITE DIAGONALS ISLAND OFFSET FROM PAVEMENT EDGE

CONTRACT NO. | F.A. | SECTION | COUNTY | TOTAL SHEETS | NO. |
| 94/90 | 2005-073 LS | COOK | 38 | 37 STA. TO STA. FED. ROAD DIST. NO. ILLINOIS FED. AID PROJECT 60A79

8 (200) WHITE -- 2 (50) 8 (200) WHITE ---ISLAND ISLAND AT PAVEMENT EDGE

# TYPICAL ISLAND MARKING

TYPE OF MARKING	WIDTH OF LINE	PATTERN	COLOR	SPACING / REMARKS
CENTERLINE ON 2 LANE PAVEMENT	4 (100)	SKIP-DASH	YELLOW	6' (1.80 m) LINE WITH 18' (5.50 m) SPACE
CENTERLINE ON MULTI-LANE UNDIVIDED PAVEMENT	2 2 4 (100)	SOLID	YELLOW	8 (200) C-C
NO PASSING ZONE LINES: FOR ONE DIRECTION FOR BOTH DIRECTIONS	4 (100) 2 <b>8</b> 4 (100)	SOLID SOLID	YELLOW YELLOW	8 (200) C-C
LANE LINES	4 (100) 5 (125) ON FREEWAYS	SKIP-DASH SKIP-DASH	WHITE WHITE	6' (1.80 m) LINE WITH 18' (5.50 m) SPACE
DOTTED LINES (EXTENSIONS OF CENTER, LANE OR TURN LANE MARKINGS)	SAME AS LINE BEING EXTENDED	SKIP-DASH	SAME AS LINE BEING EXTENDED	2' (600) LINE WITH 6' (1.8) SPACE
EDGE LINES	4 (100)	SOLID	YELLOW-LEFT WHITE-RICHT	OUTLINE MOUNTABLE MEDIANS IN YELLOW; EDGE LINES ARE NOT USED NEXT TO BARRIER CURB
TURN LANE MARKINGS	6 (150) LINE; FULL SIZE LETTERS & SYMBOLS (8' (2.4 m))	SOLID	WHITE	SEE TYPICAL TURN LANE MARKING DETAIL
TWO WAY LEFT TURN MARKING	2 @ 4 (100) EACH DIRECTION	SKIP-DASH AND SOLID	YELLOW	6' (1.8 m) LINE WITH 18' (5.50 m) SPACE FOR SKIP-DASH; 8 (200) C-C BETWEEN SOLID LINE AND SKIP-DASH LINE
	8' (2.4 m) LEFT ARROW	IN PAIRS	WHITE	SEE TYPICAL TWO-WAY LEFT TURN MARKING DETAIL
CROSSWALK LINES (PEDESTRIAN) A. DIAGONALS (BIKE & EQUESTRIAN) B. LONGITUDINAL BARS (SCHOOL)	2 & 6 (150) 12 (300) & 45° 8 (200) & 90°	SOLID SOLID SOLID	WHITE WHITE WHITE	NOT LESS THAN 6' (1.8 m) APART 2' (500) APART 2-4" (1700) APART SEE TYPICAL CROSSWALK MARKING DETAILS.
STOP LINES	24 (600)	SOLID	WHITE	PLACE 4' (1.2 m) IN ADVANCE OF AND PARALLEL TO CROSSMALK, IF PRESENT. OTHERWISE, PLACE AT DESIRED STOPPING POINT. PARALLEL TO CROSSROAD CENTERLINE, WHERE POSSIBLE
PAINTED MEDIANS	2 @ 4 (100) WITH 12 (300) DIAGONALS @ 45°	SOLID	YELLOW: TWO WAY TRAFFIC WHITE: ONE WAY TRAFFIC	8 (200) C-C FOR THE DOUBLE LINE SEE TYPICAL PAINTED MEDIAN MARKING.
GORE MARKING AND CHANNELIZING LINES	8 (200) WITH 12 (300) DIAGONALS @ 45°	SOLID	WHITE	DIAGONALS: 20' (6.1 m) (LESS THAN 30 MPH (50 km/h))
RAILROAD CROSSING	24 (600) TRANSVERSE LINES; "RR" IS 6' (1.8 m) LETTERS; 16 (400) LINE FOR "X"	SOLID	WHITE	SEE STATE STANDARD 780001 AREA OF: "R"=3.6 SO. FT. (0.33m <sup>2</sup> ) EACH "X"=54.0 SO. FT. (5.0 m <sup>2</sup> )


FOR FURTHER DETAILS ON PAVEMENT MARKING REFER TO STREET MARKING STANDARDS, PRINTED BY CITY OF CHICAGO, DEPARTMENT OF TRANSPORTATION, BUREAU OF TRAFFIC.


ALL DIMENSIONS ARE IN INCHES (MILLIMETERS)

UNLESS OTHERWISE SHOWN.

UNLESS OTHERWISE SHOWN.					1	OF	2
REVISION		THE INDIC DEPARTME	4 777	381			
NAME	DATE	ILLINOIS DEPARTMENT OF TRANSPOR				JN.	
RAMMACHER 12/07/00		CITY OF CHICAGO TYPICAL PAVEMENT MARKINGS					
A		SCALE: NONE		DRAWN BY		DD	

TC-24

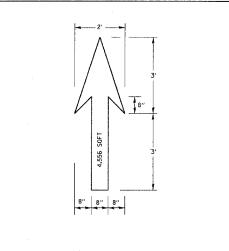

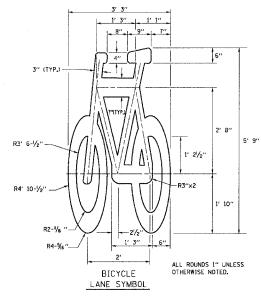


NOTE:


1.) FOR BIKE LANE SYMBOLS ONLY,
USE PRE-FORMED THERMOPLASTIC WITH A MINIMUM THICKNESS OF 90 MILS, MINIMUM SKID RESISTANCE VALUE OF 60 BPN, & A MINIMUM INDEX OF REFRACTION OF 1.50.


2.) THE RESIDENT ENGINEER SHALL CONTACT
MR. BEN GOMBERG AT 312-744-8093 AT
LEAST ONE CALENDAR WEEK PRIOR TO INSTALLING BIKE LANE SYMBOLS.

TYPICAL BIKE LANE SYMBOLS
DRAWING #28

DRAWING #29

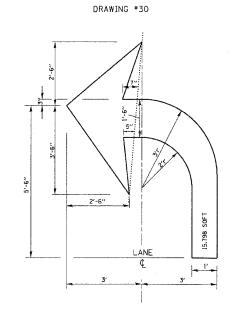

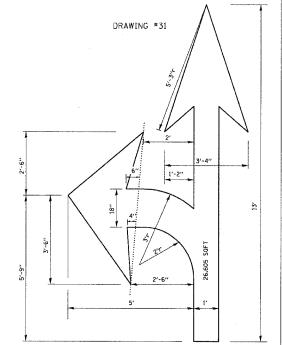

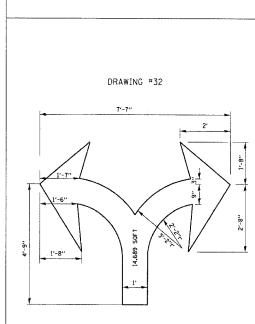


STA.


60A79


CONTRACT NO.

RTE. SECTION COUNTY TOTAL SHEETS NO. 94/90 2005-073 LS COOK 38 38

TO STA. FED. ROAD DIST. NO. ILLINOIS FED. AID PROJECT

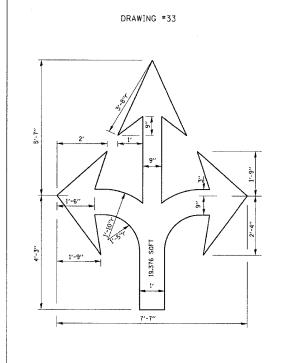

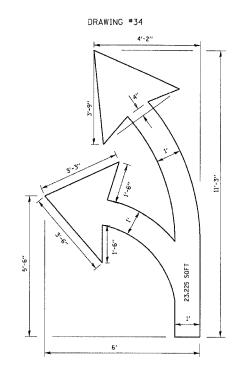

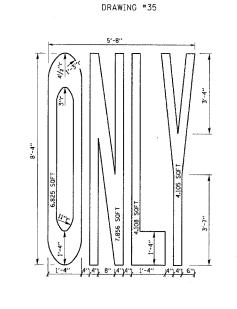

ALL MARKINGS SHALL BE SOLID WHITE UNLESS OTHERWISE NOTED IN THE PLANS

2 OF 2 ILLINOIS DEPARTMENT OF TRANSPORTATION

> CITY OF CHICAGO TYPICAL PAVEMENT MARKINGS

SCALE: NONE

DRAWN BY CHECKED BY

PLOT DATE = 3/7/2007 FILE NAME = KindistatAtc24.c PLOT SCALE = 56.200 / IN. USER NAME = bouerd

TC-24