INDEX OF SHEETS

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PROJECT LOCATED IN THE CITY OF CHICAGO

DAN RYAN EXPRESSWAY:	ADT (2020)	DESIGN SPEED	POSTED SPE
SB I-94 (DAN RYAN)	140,500	60 MPH	55 MPH
SB 79TH STREET C-D ENTRANCE RAMP	15,300	45 MPH	40 MPH
SB 79TH STREET C-D EXIT RAMP	7,300	45 MPH	40 MPH
NB I-94 (DAN RYAN)	151,800	60 MPH	55 MPH
NB 79TH STREET C-D EXIT RAMP	14,000	45 MPH	40 MPH
NB 79TH STREET C-D ENTRANCE RAMP	9,200	45 MPH	40 MPH

DESCRIPTION OF PROJECT


LANDSCAPING AND IRRIGATION OF GATEWAYS AND CORNER GARDENS LOCATED WITHIN THE PROJECT LIMITS, AND FLUTED KNEE WALL CONSTRUCTION IN THE SOUTHWEST QUADRANT.

STATE OF ILLINOIS DEPARTMENT OF TRANSPORTATION **DIVISION OF HIGHWAYS**

PROPOSED HIGHWAY PLANS

F.A.I. ROUTE 94 (DAN RYAN EXPRESSWAY) **SECTION 2005-070 LS GATEWAYS AND CORNER GARDENS** NE, SE, NW & SW QUADRANTS AT 79TH STREET

> **COOK COUNTY** C-91-106-06

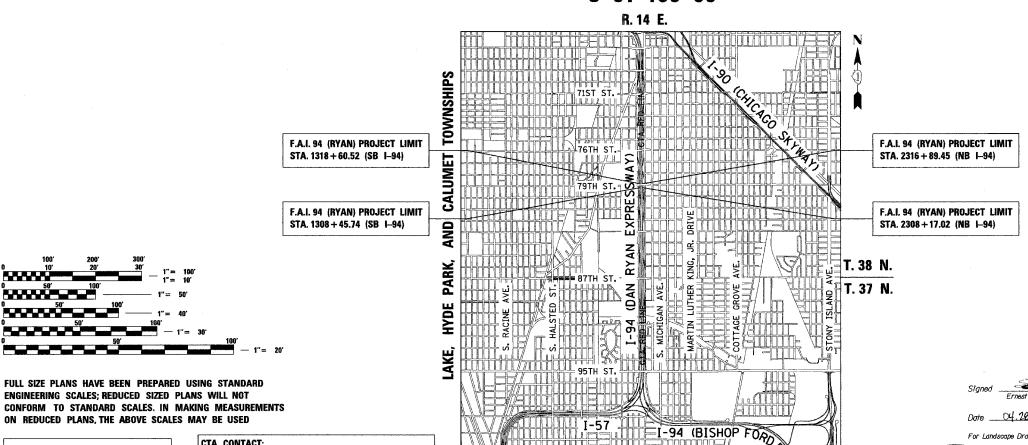

LOCATION MAP 1/2 MILE 1 MILE GROSS LENGTH OF PROJECT = 1,887.21 FT. = 0.36 MI. GROSS LENGTH OF PROJECT = 1,887.21 FT. = 0.36 MI.

DEPARTMENT OF TRANSPORTATION DIVISION OF HIGHWAYS SUBMITTED APRIL 29, 20 08 Deputy Director of Highways, region Engineer Eric E. Harn/18 Christine M. Reed 18 **CONTRACT 22E**

Signed Dean a Kiesling

04-28-08

TY:LIN INTERNATIONAL

CHICAGO UTILITY ALERT NETWORK (312) 744-7000

FULL SIZE PLANS HAVE BEEN PREPARED USING STANDARD ENGINEERING SCALES: REDUCED SIZED PLANS WILL NOT

ON REDUCED PLANS, THE ABOVE SCALES MAY BE USED

CTA CONTACT: MANAGER, CONSTRUCTION MANAGEMENT OVERSIGHT (312) 681-3862

CONTRACT NO. 60A76

65

60A76

94 2005-070 LS COOK

D-91-106-06

FED. ROAD DIST. NO. ILLINOIS FED. AID PROJECT

STATE OF ILLINOIS

PRINTED BY THE AUTHORITY OF THE STATE OF HUMOIS

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TYLININTERNATIONAL

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STANDARD NO.	TITLE
000001-05	STANDARD SYMBOLS, ABBREVIATIONS, AND PATTERNS
280001- <i>04</i>	TEMPORARY EROSION CONTROL SYSTEM
606001- <i>03</i>	CONCRETE CURB AND COMBINATION CONCRETE CURB AND GUTTER
701601- <i>05</i>	URBAN LANE CLOSURE, MULTILANE 1W OR 2W WITH NONTRAVERSABLE MEDIAN
701701- 05	URBAN LANE CLOSURE MULTILANE INTERSECTION
701801-03	LANE CLOSURE MULTILANE 1W OR 2W CROSSWALK OR SIDEWALK CLOSURE
701901	TRAFFIC CONTROL DEVICES
814001- <i>01</i>	HANDHOLES

GENERAL NOTES:

- THE CONTRACTOR SHALL NOT SET UP A YARD/FIELD OFFICE OR STOCKPILE MATERIALS ON IDOT PROPERTY WITHOUT WRITTEN PERMISSION FROM IDOT.
- 2. THE CONTRACTOR SHALL TAKE ALL NECESSARY SAFETY PRECAUTIONS TO PROTECT AND PROVIDE ACCESS TO ABUTTING PROPERTY, UTILITIES, PEDESTRIANS, AND VEHICULAR TRAFFIC.
- 3. NIGHT OPERATIONS: SHALL NOT BE ALLOWED.
- 4. ALL ELEVATIONS SHOWN ARE BASED ON THE CHICAGO CITY DATUM OF 0.00, WHICH IS 579.19 FEET ABOVE MEAN TIDE NEW YORK. (NAVD 88)
- 5. ANY DAMAGE DONE TO EXISTING ITEMS BY THE CONTRACTOR SHALL BE REPAIRED BY THE CONTRACTOR AT THE CONTRACTOR'S OWN EXPENSE
- 6. THE CONTRACTOR SHALL PROVIDE ALL NECESSARY TRAFFIC CONTROL DEVICES NEEDED TO COMPLETE THE WORK. THIS WORK SHALL BE INCLUDED IN THE COST OF TRAFFIC CONTROL AND PROTECTION (SPECIAL).
- 7. THE CONTRACTOR SHALL NOT MAINTAIN A PERMANENT PARTIAL RAMP OR SHOULDER CLOSURE ALONG THE MAINLINE I-94 (DAN RYAN) FOR THE DURATION OF THIS PROJECT, ONLY TEMPORARY PARTIAL RAMP OR SHOULDER CLOSURES SHALL BE PERMITTED.
- 8. PLANS FOR THE WATER SERVICE CONNECTIONS FOR IRRIGATION SYSTEMS SHALL BE SUBMITTED FOR REVIEW AND APPROVAL TO:

MR. JOHN FLYNN
DEPARTMENT OF CONSTRUCTION AND PERMITS
ROOM 906, CITY HALL
121 NORTH LASALLE STREET
CHICAGO, ILLINOIS 60602

- 9. THE CONTRACTOR SHALL OBTAIN ALL NECESSARY PERMITS FROM THE CITY OF CHICAGO AND THE STATE OF ILLINOIS PRIOR TO COMMENCING CONSTRUCTION. THE COSTS SHALL BE INCLUDED IN THE CONTRACT. THE COST SHALL BE INCLUDED IN THE COST OF MOBILIZATION.
- 10. PAYMENTS FOR ADJUSTMENTS TO WATER VALVE VAULTS SHALL NOT BE MADE TO THE CONTRACTOR UNTIL THIS WORK HAS BEEN INSPECTED AND APPROVED BY THE CITY OF CHICAGO DEPARTMENT OF WATER MANAGEMENT.
- 11. PERMITS FROM THE DEPARTMENT OF WATER MANAGEMENT ARE REQUIRED FOR ALL WORK INVOLVING ADJUSTMENT OF STRUCTURES. THE DEPARTMENT OF WATER MANAGEMENT'S PERMIT SHALL BE OBTAINED BY A LICENSED SEWER DRAIN LAYER PRIOR TO START OF CONSTRUCTION. THE LICENSED SEWER CONTRACTOR/SUBGONTRACTOR SHALL SUBMIT TWO SETS OF PLANS APPROVED BY THE DEPARTMENT OF WATER MANAGEMENT FOR THE ISSUANCE OF THE SEWER PERMIT TO: BUREAU OF ENGINEERING SERVICES-SEWER SECTION, JARDINE PURIFICATION PLANT, EL+51, ROOM 313, 1000 E. OHIO ST., CHICAGO, IL 60611. INSPECTION WILL BE PROVIDED BY THE DEPARTMENT OF WATER MANAGEMENT.
- 12. CITY OF CHICAGO WATER VALVE VAULTS AND SEWER STRUCTURES SHALL NOT BE CLOSED, COVERED, OR OTHERWISE OBSTRUCTED DURING CONSTRUCTION WITHOUT WRITTEN PERMISSION FROM THE CITY OF CHICAGO DEPARTMENT OF WATER MANAGEMENT.
- 13. THE RESIDENT ENGINEER AND THE CONTRACTOR SHALL FIELD VERIFY THE CITY'S EXISTING SEWER FACILITIES IN THE LIMITS OF THE REFERENCED PROJECT FOR ANY CONFLICTS DUE TO THE PROPOSED IMPROVEMENT. ANY CONFLICT SHALL BE RESOLVED WITH THE DEPARTMENT OF WATER MANAGEMENT PRIOR TO START OF CONSTRUCTION.
- 14. THE LOCATION OF THE ELECTRICAL EQUIPMENT AND CONDUIT, INSTALL BY CONTRACT 62583, SHOWN IN THE PLANS IS APPROXIMATE. THE RESIDENT ENGINEER AND THE CONTRACTOR SHALL FIELD VERIFY THE EXACT LOCATION OF ALL ELECTRICAL ITEMS WITHIN THE PROJECT LIMITS WITH THE IDOT ELECTRICAL REPRESENTATIVE PRIOR TO THE START OF CONSTRUCTION.
- 15. IT IS CALLED TO THE CONTRACTOR'S ATTENTION THAT HE/SHE WILL BE REQUIRED TO PAY FOR ANY INSPECTION OR PERMIT FEES TO THE VARIOUS DEPARTMENTS OF THE CITY OF CHICAGO. THE COST FOR THESE FEES WILL NOT BE PAID FOR SEPARATELY BUT SHALL BE CONSIDERED INCLUDED IN THE COST OF MOBILIZATION. PERMIT FEES MUST BE PAID PRIOR TO COMMENCING CONSTRUCTION.
- 16. A "BOXED" NOTE INDICATES AN ITEM OF WORK THAT IS NOT PAID FOR SEPARATELY, BUT IS PAID FOR AS PART OF ANOTHER ITEM LISTED IN THE SUMMARY OF QUANTITIES.
- 17. THE CONTRACTOR SHALL SHOW PROOF OF PROCUREMENT, SOURCES, QUANTITIES AND VARIETIES FOR ALL SHURBS, TREES, GROUND COVERS, PERENNIALS AND ORNAMENTAL GRASSES WITHIN 21 DAYS FOLLOWING THE AWARD OF CONTRACT. TIMELY PROCUREMENT OF ALL PLANT MATERIAL IS ESSENTIAL TO THE SUCCESSFUL COMPLETION AND SUBSTANTIAL COMPLETION ACCEPTANCE OF THE OVERALL PROJECT.

SPECIAL COMMITMENTS:

- THE CONTRACTOR AND THE ENGINEER SHALL SUBMIT THE IRRIGATION SHOP DRAWINGS FOR REVIEW AND APPROVAL BY THE CITY OF CHICAGO - STREETSCAPE UNIT, 4 WEEKS IN ADVANCE, PRIOR TO THE START OF THE IRRIGATION WORK.
- 2. THE CITY OF CHICAGO STREETSCAPE UNIT REPRESENTATIVES SHALL BE INVITED TO PARTICIPATE IN THE CONSTRUCTION PROGRESS MEETINGS. THE MEETING'S SCHEDULE SHALL BE PROVIDED TO THE CITY OF CHICAGO IN ADVANCE.
- 3. THE CITY OF CHICAGO STREETSCAPE UNIT REPRESENTATIVES SHALL BE AFFORDED THE OPPORTUNITY TO OBSERVE ALL LANDSCAPING AND IRRIGATION WORK IN COORDINATION WITH AND CONCURRENCE OF THE ENGINEER.
- 4. THE CONTRACTOR AND THE ENGINEER, IN COORDINATION WITH ILLINOIS DEPARTMENT OF TRANSPORTATION'S LANDSCAPING REPRESENTATIVE, SHALL PROVIDE A WRITTEN DESCRIPTION OF THE TURN OVER PROCEDURE OF THE IRRIGATION WORK AT THE END OF THE PROJECT TO THE CITY OF CHICAGO STREETSCAPE UNIT.
- 5. THE CITY OF CHICAGO STREETSCAPE UNIT SHALL BE INVITED BY THE CONTRACTOR AND THE ENGINEER TO ATTEND AND PARTICIPATE IN THE FINAL PROJECT INSPECTION.

REVISIONS
NAME
DATE
F.A.I. 94 (DAN RYAN EXPRESSWAY)
INDEX OF SHEETS, STATE STANDARDS,
GENERAL NOTES, AND SPECIAL COMMITMENTS

SCALE: NONE

DATE: MAY 1, 2008


DRAWN BY: JDF CHECKED BY: JPM

| FED. ROAD DIST. NO. | ILLINOIS | FED. AID PROJECT | FED. ROAD DIST. NO. | ILLINOIS | FED. AID PROJECT | FED. ROAD DIST. NO. | ILLINOIS | FED. AID PROJECT | FED. ROAD DIST. NO. | ILLINOIS | FED. AID PROJECT | FED. ROAD DIST. NO. | ILLINOIS | FED. AID PROJECT | FED. ROAD DIST. NO. | ILLINOIS | FED. AID PROJECT | FED. ROAD DIST. NO. | ILLINOIS | FED. AID PROJECT | FED. ROAD DIST. NO. | ILLINOIS | FED. AID PROJECT | FED. ROAD DIST. NO. | ILLINOIS | FED. AID PROJECT | FED. ROAD DIST. NO. | ILLINOIS | FED. AID PROJECT | FED. ROAD DIST. NO. | ILLINOIS | FED. AID PROJECT | FED. ROAD DIST. NO. | ILLINOIS | FED. AID PROJECT | FED. ROAD DIST. NO. | ILLINOIS | FED. AID PROJECT | FED. ROAD DIST. NO. | ILLINOIS | FED. AID PROJECT | FED. ROAD DIST. NO. | ILLINOIS | FED. ROAD DIST. NO. | ILLINOIS | FED. AID PROJECT | FED. ROAD DIST. NO. | ILLINOIS | FED. AID PROJECT | FED. ROAD DIST. NO. | ILLINOIS | FED. ROAD DIST. NO. | IL

CALENDAR OF CONSTRUCTION WORK

		.,		
		WORK	DATES	
PHASE	YEAR	FROM	ТО	CONSTRUCTION WORK
PHASE I	2009	APRIL 1	AUG. 15	INSTALLATION OF UTILITY SERVICE DROP DOWNS FOR THE SE QUADRANT AT THE CORNER GARDEN. EXCAVATION AND PLACEMENT OF POROUS GRANULAR MATERIAL, PLANTING MIX, AND GEOTECHNICAL FABRIC, (ALL CORNER GARDENS). INSTALLATION OF WATER SERVICE, IRRIGATION SYSTEMS AND ALL ASSOCIATED HARDSCAPE ITEMS FOR THE GATEWAYS AND CORNER GARDENS.
		MAY 1	SEPT. 15	INSTALLATION OF ALL WOODY PLANTS. WOODY PLANTS MUST BE CONTAINER OR DUG WHILE DORMANT AND MAINTAINED PROPERLY UNTIL PLANTED. ALL WOODY PLANTS MUST BE INSTALLED PRIOR TO PERENNIALS.
		AUG. 15	SEPT. 15	INSTALL PERENNIAL PLANTS AND MULCH AFTER ALL WOODY PLANTS HAVE BEEN INSTALLED.
		OCT. 1	OCT. 31	INSTALL BULBS.
PHASE I	OCT. 31 HA		. 31	CERTIFICATION TO THE BUREAU OF MAINTENANCE THAT ALL PLANTS HAVE BEEN INSTALLED AND ARE IN A LIVE HEALTHLY CONDITION AND ELIGIBLE FOR A APRIL 16 - APRIL 23, 2010 PERIOD OF ESTABLISHMENT INSPECTION.
		WORK	DATES	
PHASE	YEAR	FROM	то	CONSTRUCTION WORK
PHASE II	2010	MARCH 2	APRIL 16	PERIOD OF ESTABLISHMENT PLANT CARE REQUIRED FOR ALL PLANTS. (WEEDING, WATERING, OR OTHER WORK WHICH IS NECESSARY TO MAINTAIN HEALTH AND SATISFACTORY APPEARANCE OF THE PLANTING IS INCLUDED IN THE COST OF THE CONTRACT).
		APRIL 16	APRIL 23	PERIOD OF ESTABLISHMENT INSPECTION.
		APRIL 23	MAY 1	INSTALLATION OF ALL REQUIRED REPLACEMENT PLANTS, AND ALL
				REQUIRED CLEAN UP OF ALL PLANT BEDS SHALL BE COMPLETED BY THIS DATE.
PHASE II	2010	MA'	Y 1	COMPLETION DATE
- 1711/2000 2.2	2010	MAY		FINAL INSPECTION DATE

QUADRANT NOMENCLATURE

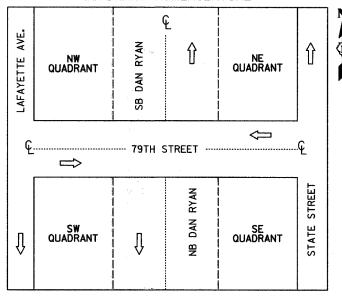

IDOT HOT-MIX ASPHALT MIXTURE REQUIREMENTS

ITEM	AC TYPE	AIR VOIDS
PAVEMENT REMOVAL AND REPLACEMENT		
HOT-MIX ASPHALT SURFACE COURSE, MIX "D", N 70 11/2"	PG 64-22	4%@70Gyr
LEVELING BINDER (MACHINE METHOD), N 70, 11/2"	PG 64-22/58-22	4% @ 70Gyr

THE UNIT WEIGHT USED TO CALCULATE ALL HMA SURFACE MIXTURE QUANTITIES IS 112/SQ YD/IN. USE 135 LB/SQ YD/IN. IF USING A SMA MIX.

ILLINOIS DEPARTMENT OF TRANSPORTATION F.A.I. 94 (DAN RYAN EXPRESSWAY) CALENDAR OF CONSTRUCTION, QUADRANT NOMENCLATURE, AND HOT-MIX ASPHALT MIXTURE REQUIREMENTS

SCALE: NONE

DRAWN BY: AMB CHECKED BY: TGB

TYLININTERNATIONAL

DATE: MAY 1, 2008

PROJECT: GATEWAYS AND CORNER GARDENS AT 79TH STREET COOK COUNTY / CITY OF CHICAGO

SUMMARY OF QUANTITIES

	SUMMANT OF CONTINUES				
CODE NUMBER	ITEM DESCRIPTION	UNIT	URBAN TOTAL	100% STATE	F 80
			TOTAL	DAN RYAN YOO3	11
20101000	TEMPORARY FENCE	FOOT	74	74	
20200100	EARTH EXCAVATION	CU YD	35	35	
20201200	REMOVAL AND DISPOSAL OF UNSUITABLE MATERIAL	CU YD	35	35	
20700220	POROUS GRANULAR EMBANKMENT	CU YD	10	10	
21101645	TOPSOIL FURNISH AND PLACE, 12"	SQ YD	85	85	
21101825	COMPOST FURNISH AND PLACE, 6"	SQ YD	85	85	
25000210	SEEDING, CLASS 2A	ACRE	0.75	0.75	
25000400	NITROGEN FERTILIZER NUTRIENT	POUND	115	115	
25000500	PHOSPHORUS FERTILIZER NUTRIENT	POUND	90	90	
25000600	POTASSIUM FERTILIZER NUTRIENT	POUND	78	78	
25100630	EROSION CONTROL BLANKET	SQ YD	2827	2827	
28000250	TEMPORARY EROSION CONTROL SEEDING	POUND	60	60	
28000510	INLET FILTERS	EACH	32	32	
40603340	HOT-MIX ASPHALT SURFACE COURSE, MIX "D", N70	TON	9	9	
	PROTECTIVE COAT				
42001300		SQ YD	136	136	
42400200	PORTLAND CEMENT CONCRETE SIDEWALK 5 INCH	SQ FT	788	788	4 - 17 - 17 - 17 - 17 - 17 - 17 - 17 - 1
44000155	HOT-MIX ASPHALT SURFACE REMOVAL, 1 1/2"	SQ YD	102	102	
44000300	CURB REMOVAL	F00T	30	30	
44000500	COMBINATION CURB AND GUTTER REMOVAL	FOOT	143	143	
44000600	SIDEWALK REMOVAL	SQ FT	786	786	
44003100	MEDIAN REMOVAL	SQ FT	16	16	
44004250	PAVED SHOULDER REMOVAL	SQ YD	3	3	·
48300700	PORTLAND CEMENT CONCRETE SHOULDERS 12"	SQ YD	3	3	
50200100	STRUCTURAL EXCAVATION	CU YD	33	33	
50300225	CONCRETE STRUCTURES	CU YD	9	9	
50300300	PROTECTIVE COAT	SQ YD	14	14	
50300510	RUSTICATION FINISH	SQ FT	28	28	
50800205	REINFORCEMENT BARS, EPOXY COATED	POUND	2600	2600	
56104600	WATER VALVES 2"	EACH	2	2	
56200700	WATER SERVICE LINE 2 1/2"	FOOT	395	395	
60250200	CATCH BASINS TO BE ADJUSTED	EACH	4	4	
60255500	MANHOLES TO BE ADJUSTED	EACH	5	5	
60600605	CONCRETE CURB, TYPE B	FOOT	50.0	50	
66410300	CHAIN LINK FENCE REMOVAL	FOOT	63.0	63.0	
67000400	ENGINEER'S FIELD OFFICE, TYPE A	CAL MO	16	16	
67100100	MOBILIZATION	L SUM	1	1	V 122
70101800	TRAFFIC CONTROL AND PROTECTION, (SPECIAL)	L SUM	1	1	<u> </u>

F.A.I. RTE.	SECTION	1	COUN	ITY	TOTAL	SHEE NO.
94	2005-070	LS	coc	K	65	4
STA.	2308+17 (NB 1308+46 (SB	1-9	TO S	TA. 23	16+90 (N 8+61 (SE	B 1-9 I-94
FED. RO	AD DIST. NO.	ILLIN	OIS FED.	. AID	PROJECT	•

REVISIONS
NAME
DATE
F.A.I. 94 (DAN RYAN EXPRESSWAY)

SUMMARY OF QUANTITIES
SHEET 1 OF 2

SCALE: NONE
DRAWN BY: JDF

CHECKED BY: JPM

DATE: MAY 1, 2008

* - SPECIALTY ITEM

TY:LININTERNATIONAL

PROJECT: GATEWAYS AND CORNER GARDENS AT 79TH STREET COOK COUNTY / CITY OF CHICAGO

SUMMARY OF QUANTITIES

	SUMMANT OF WORKTITES				
CODE NUMBER	ITEM DESCRIPTION	UNIT	URBAN TOTAL	100% STATE	
				DAN RYAN YOO3	14
78000100	THERMOPLASTIC PAVEMENT MARKING - LETTERS AND SYMBOLS	SQ FT	66	66	
78000200	THERMOPLASTIC PAVEMENT MARKING - LINE 4"	FOOT	23	23	
78000400	THERMOPLASTIC PAVEMENT MARKING - LINE 6"	FOOT	233	253	
78000600	THERMOPLASTIC PAVEMENT MARKING - LINE 12"	FOOT	28	28	
81400200	HEAVY-DUTY HANDHOLE	EACH	3	3	
X0326143	FLUTED KNEE WALL (SPECIAL)	FOOT	47	47	
K1003460	LANDSCAPE MAINTENANCE	CAL MO	12	12	
X0326144	TACTILE/DETECTABLE WARNING SURFACE	SQ FT	32	32	
A2012003	BALLED AND BURLAPPED, TREE, AESCULUS X CARNEA 'FORT MCNAIR' (FORT MCNAIR RED HORSECHESTNUT), 3" CALIPER, # MATCHING HEADS	EACH	21	21	
82004568	,	EACH	17	17	***************************************
	BALLED AND BURLAPPED,				
X0326145	WATER SERVICE LINE 3" (SPECIAL)	FOOT	15	15	
C2010930	SHRUB, SYRINGA MEYERI PALIBIN (DWARF KOREAN LILAC), 2-1/2' HEIGHT, BALLED AND BURLAPPED	EACH	883	883	
K0030400	PERENNIAL PLANTS, DAYLILIES	UNIT	25.01	25.01	
K0030470	PERENNIAL PLANT, ORNAMENTAL GRASS TYPE	UNIT	39.79	39.79	
X0301407	PERENNIAL PLANTS, GALLON POT	UNIT	39.94	39.94	
X0320870	BRACED EXCAVATION	CU YD	10	10	
X0322256	TEMPORARY INFORMATION SIGNING	SQ FT	103	103	1
X0325604	WEED CONTROL, PRE-EMERGENT HERBICIDE	GALLON	1	1	
X0323973	SEDIMENT CONTROL, SILT FENCE	FOOT	1032	1032	
X0323974	SEDIMENT CONTROL, SILT FENCE MAINTENANCE	FOOT	259	259	
X0324525	PLANTING MIX FURNISH AND PLACE 36"	SQ YD	15	15	
X0325102	INSPECTION PIPE 4 INCH	EACH	3	3	
X0325103	WATER METER IN VAULT, 2 INCH	EACH	2	2	
X0325104	WATER TAP, 2 INCH				
		EACH	2	2	
X0325105	IRRIGATION SYSTEM	SQ YD	1398	/398	
X0325106	IRRIGATION SYSTEMS FALL SHUTDOWN	EACH	2	2	
X0325107	IRRIGATION SYSTEMS SPRING STARTUP	EACH	2	2	
X0325108	BACKFLOW PREVENTER (RPZ), 2 INCH	EACH	2	2	
X0325109	POROUS GRANULAR MATERIAL	CU YD	6	٠	
X0656300	PAVEMENT REMOVAL AND REPLACEMENT	SQ YD	108	108	
X6065740	CONCRETE MEDIAN SURFACE, 5" (MODIFIED)	SQ FT	88	88	
X0325970	SOIL CONDITIONER 3"	SQ YD	3288	3288	
XX104800	COMBINATION CONCRETE CURB AND GUTTER, TYPE 8-V-12	FOOT	143.0	143.0	
Z0013798	CONSTRUCTION LAYOUT	L SUM	1	1	
Z0027800	GEOTECHNICAL FABRIC	SQ YD	28	28	
t	I		L	<u> </u>	

 F.A.I. RTE.	SECTION	4	(OUN.	ΤY	TOT. SHEE	AL TS	SHEE1
94	2005-070	LS		COO	(65		5
STA.	2308+17 (NB 1308+46 (SB	I-9	} T	o st	A-23	16+90 8+61	(NE (SB	I-94)
FED. RO	DAD DIST. NO.	ILLIN	ors	FED.	AID	PROJ	ECT	

AID PROJECT

REVISIONS
NAME DATE

F.A.I. 94 (DAN RYAN EXPRESSWAY)

SUMMARY OF QUANTITIES
SHEET 2 OF 2

SCALE: NONE DRAWN BY: JDF

* - SPECIALTY ITEM

TY:LININTERNATIONAL

F.A.I. RTE.	SECTION	1		COUNTY	TOTAL SHEETS	SHEET NO.
94	2005-070	LS		COOK	65	6
STA.			T	O STA.		
FED. ROA	DIST. NO.	ILLINO	IS	FED. AID	PROJECT	

60A76

Code	Item	Common Name	Size	Root	Remarks	Unit	Total
	SHADE TREES.						
AC	Aesculus x carnea 'Fort McNair'	Fort McNair Red Horsechestnut	3" caliper	B&B	matching heads, 20' o.c.	each	21
	INTERMEDIATETREES					dinamentalism	
MA	Malus 'Red Peacock'	Red Peacock Crabapple	2-1/2" caliper	B&B	matching heads, 12' o.c.	each	17
	SHRUBS						
SM	Syringa meyeri 'Palibin'	Dwarf Korean Lilac	24" height	B&B	24" o.c.	each	883
	PERENNIAL PLANTS, DAYLILIES					grands a	
HC	Hemerocallis 'Cherry Cheeks'	Cherry Cheeks Daylily	1 gallon	pot	18" o.c.	UNIT	6.36
HH	Hemerocallis 'Chicago Heirloom'	Chicago Heirloom Daylily	1 gallon	pot	15" o.c.	UNIT	9.26
HP	Hemerocallis 'Preppy Pink'	Preppy Pink Daylily	1 gallon	pot	15" o.c.	UNIT Total units:	9.39 25 .01
	PERENNIAL PLANTS, GALLON POT					TOTAL UNITS.	23.01
AS	Aster azureus	Sky Blue Aster	1 gallon	pot	15" o.c.	UNIT	9.03
LB	Liatris spicata 'Blazing Star'	Blazing Star Gayfeather	1 gallon	pot	15" o.c.	UNIT	9.39
LS	Liatris spicata 'Kolbold'	Kolbold Spike Gayfeather	1 gallon	pot	18" o.c.	UNIT	6.36
NF	Nepeta faassenii 'Walker's Low'	Walker's Low Faassen's Catmint	1 gallon	pot	18" o.c.	UNIT	6.13
PE	Perovskia atriplicifoia	Russian Sage	1 gallon	pot	15" o.c.	UNIT	9.03
	PERENNIAL PLANTS, ORNAMENTAL GRAS	STYPE				Total units:	39.94
вс	Bouteloria curtipendula	Side Oats Grama	1 gallon	pot	15" o.c.	UNIT	9.39
CA	Calamagrostis acutiflora 'Karl Foerster'	Karl Foerster Feather Reed Grass	1 gallon	pot	15" o.c.	UNIT	7.92
MG	Miscanthus sinensis 'Graziella'	Maiden Eulalia Grass	1 gallon	pot	15" o.c.	UNIT	1.63
MS	Miscanthus sinensis 'Silberfeder'	Silver Feather Eulalia Grass	1 gallon	pot	18" o.c.	UNIT	2.21
PN	Panicum virgatum 'Northwind'	Northwind Switch Grass	1 gallon	pot	15" o.c.	UNIT	3.08
	Panicum virgatum 'Rotstrahlbusch'	Rotstrahlbusch Switch Grass	1 gallon	pot	18" o.c.	UNIT	3.14
	Panicum virgatum 'Shenandoah'	Shenandoah Switch Grass	1 gallon	pot	18" o.c.	UNIT	6.77
SH	Sporobolus heterolepis	Prairie Dropseed	1 gallon	pot	18" o.c.	UNIT	5.65

Code	1.	Common Name	Size	Root	Remarks	Unit	Total
	SHADETREES		and the commence of the commen				
AC	Aesculus x carnea 'Fort McNair'	Fort McNair Red Horsechestnut	3" caliper	B&B	matching heads, 20' o.c.	each	3
	INTERMEDIATETIREES						
MA	Malus 'Red Peacock'	Red Peacock Crabapple	2-1/2" caliper	B&B	matching heads, 12' o.c.	each	5
93 60 sp	ŠHRUBS.						and the second
SM	Syringa meyeri 'Palibin'	Dwarf Korean Lilac	24" height	B&B	24" o.c.	each	167
	PERENNIA PLANTS DAYLILIES						
HC	Hemerocallis 'Cherry Cheeks'	Cherry Cheeks Daylily	1 gallon	pot	18" o.c.	UNIT	1.25
HH	Hemerocallis 'Chicago Heirloom'	Chicago Heirloom Daylily	1 gallon	pot	15" o.c.	UNIT	1.92
HP	Hemerocallis 'Preppy Pink'	Preppy Pink Daylily	1 gallon	pot	15" o.c.	UNIT	2.02
						Total units:	5.18
	PERENNIAL PLANTS, GALLON POT						Management of the
AS	Aster azureus	Sky Blue Aster	1 gallon	pot	15" o.c.	UNIT	1.92
LB	Liatris spicata 'Blazing Star'	Blazing Star Gayfeather	1 gallon	pot	15" o.c.	UNIT	2.02
LS	Liatris spicata 'Kolbold'	Kolbold Spike Gayfeather	1 gallon	pot	18" o.c.	UNIT	1.25
NF	Nepeta faassenii 'Walker's Low'	Walker's Low Faassen's Catmint	1 gallon	pot	18" o.c.	UNIT	1.25
PE	Perovskia atriplicifoia	Russian Sage	1 gallon	pot	15" o.c.	UNIT	1.92
						Total units:	8.3€
	PERENNIAL PLANTS, ORNAMENTAL GRA	SS TYPE					
	Bouteloria curtipendula	Side Oats Grama	1 gallon	pot	15" o.c.	UNIT	2.02
	Calamagrostis acutiflora 'Karl Foerster'	Karl Foerster Feather Reed Grass	1 gallon	pot	15" o.c.	UNIT	3.56
	Panicum virgatum 'Rotstrahlbusch'	Rotstrahlbusch Switch Grass	1 gallon	pot	18" o.c.	UNIT	1.16
PS	Panicum virgatum 'Shenandoah'	Shenandoah Switch Grass	1 gallon	pot	18" o.c.	UNIT	4.23
						Total units:	10.97

Code		LE OF LANDSCAPE ITEMS - 79TH Common Name	Size	Root	Remarks	Unit	Tota
	SHADE TREES				Kemake	O I III	note the second
ADDITION OF THE PARTY OF THE PA	Aesculus x carnea 'Fort McNair'	Fort McNair Red Horsechestnut	3" caliper	B&B	matching heads, 20' o.c.	each	3
	INTERMEDIATE TREES						
MA	Malus 'Red Peacock'	Red Peacock Crabapple	2-1/2" caliper	B&B	matching heads, 12' o.c.	each	3
	SHRUBS						
SM	Syringa meyeri 'Palibin'	Dwarf Korean Lilac	24" height	B&B	24" o.c.	each	134
	PERENNIAL PEANTS DAYS LES TO THE						i de la companione de l
	Hemerocallis 'Cherry Cheeks'	Cherry Cheeks Daylily	1 gallon	pot	18" o.c.	UNIT	1.48
	Hemerocallis 'Chicago Heirloom'	Chicago Heirloom Daylily	1 gallon	pot	15" o.c.	UNIT	1.95
HP	Hemerocallis 'Preppy Pink'	Preppy Pink Daylily	1 gallon	pot	15" o.c.	UNIT	2.3 5.73
	PERENNIAL PLANTS; GALLON POT					Total units:	5.78
AS	Aster azureus	Sky Blue Aster	1 gallon	pot	15" o.c.	UNIT	1.95
LB	Liatris spicata 'Blazing Star'	Blazing Star Gayfeather	1 gallon	pot	15" o.c.	UNIT	2.3
LS	Liatris spicata 'Kolbold'	Kolbold Spike Gayfeather	1 gallon	pot	18" o.c.	UNIT	1.48
NF	Nepeta faassenii 'Walker's Low'	Walker's Low Faassen's Catmint	1 gallon	pot	18" o.c.	UNIT	1.48
PE	Perovskia atriplicifola	Russian Sage	1 gallon	pot	15" o.c.	UNIT	1.95
	PERENNIAL PLANTS, ORNAMENTAL GRA					Total units:	9.16
	Bouteloria curtipendula	Side Oats Grama	A U	4	450		
	Calamagrostis acutiflora 'Karl Foerster'	Karl Foerster Feather Reed Grass	1 gallon	pot	15" o.c. 15" o.c.	UNIT	2.3
	Miscanthus sinensis 'Silberfeder'	Silver Feather Eulalia Grass	1 gallon 1 gallon	pot	15° o.c.	UNIT	4.36 2.21
	Panicum virgatum 'Shenandoah'	Shenandoah Switch Grass	1 gallon	pot	18" o.c.	UNIT	2.54
- 1 0	- anoan algatum ononardoan	Chomandoan Gwitch Grass	1 ganon	ροι		Total units:	

Code		Common Name	Size	Root	Remarks	Unit	Tota
	SHRUBS						
SM	Syringa meyeri 'Palibin'	Dwarf Korean Lilac	24" height	B&B	24" o.c.	each	(
	PERENNIAL PLANTS DAY LILES						
HC	Hemerocallis 'Cherry Cheeks'	Cherry Cheeks Daylily	1 gallon	pot	18" o.c.	T UNIT T	0.08
НН	Hemerocallis 'Chicago Heirloom'	Chicago Heirloom Daylily	1 gallon	pot	15" o.c.	UNIT	0.08
						Total units:	0.16
ika ling	PERENNIAL PLANTS, GALLON POT						
LS	Liatris spicata 'Kolbold'	Kolbold Spike Gayfeather	1 gallon	pot	18" o.c.	UNIT	0.08
						Total units:	0.08

SITE DESIGN GROUP

TYLININTERNATIONAL

REVISIONS
NAME DATE
ILLINOIS DEPARTMENT OF TRANSPORTATION
F.A.I. 94 (DAN RYAN EXPRESSWAY)

PLANT SCHEDULES
SUMMARY AT 79TH ST. - NB I-94
SE + NE QUADRANTS AT 79TH ST. - NB I-94
SCALE: NTS DRAWN BY: EM
DATE: May 1,2008 CHECKED BY: JO

FED. RO.	AD DIST, NO.	ILLINO	S FED. AID	PROJECT	
STA.			TO STA.		
94	2005-07	0 LS	соок	65	7
RTE.	SECTIO	DN	COUNTY	SHEETS	NO.

60A76

	SCHEDULE OF LANDSCAPE ITEMS - 79TH STREET GATEWAY - SOUTHWEST							
Code	Item	Common Name	Size	Root	Remarks	Unit	Total	
	SHADE TREES							
AC	Aesculus x carnea 'Fort McNair'	Fort McNair Red Horsechestnut	3" caliper	B&B	matching heads, 20' o.c.	each	8	
	INTERMEDIATE TREES							
MA	Malus 'Red Peacock'	Red Peacock Crabapple	2-1/2" caliper	B&B	matching heads, 12' o.c.	each	5	
	SHRUBS							
SM	Syringa meyeri 'Palibin'	Dwarf Korean Lilac	24" height	B&B	24" o.c.	each	276	
	PERENNIAL PLANTS, DAYLILIES							
HC	Hemerocallis 'Cherry Cheeks'	Cherry Cheeks Daylily	1 gallon	pot	18" o.c.	UNIT	1.98	
НН	Hemerocallis 'Chicago Heirloom'	Chicago Heirloom Daylily	1 gallon	pot	15" o.c.	UNIT	3.05	
HP	Hemerocallis 'Preppy Pink'	Preppy Pink Daylily	1 gallon	pot	15" o.c.	UNIT	2.63	
					eraniere en sidde en company	Total units:	7.66	
	PERENNIAL PLANTS, GALLON POT							
AS	Aster azureus	Sky Blue Aster	1 gallon	pot	15" o.c.	UNIT	3.05	
LB	Liatris spicata 'Blazing Star'	Blazing Star Gayfeather	1 gallon	pot	15" o.c.	UNIT	2.63	
LS	Liatris spicata 'Kolbold'	Kolbold Spike Gayfeather	1 gallon	pot	18" o.c.	UNIT	1.98	
NF	Nepeta faassenii 'Walker's Low'	Walker's Low Faassen's Catmint	1 gallon	pot	18" o.c.	UNIT	1.98	
PE	Perovskia atriplicifoia	Russian Sage	1 gallon	pot	15" o.c.	UNIT	3.05	
						Total units:	12.69	
	PERENNIAL PLANTS ORNAMENTAL GR	RASS TYPE					erdassatus edgastations	
ВС	Bouteloria curtipendula	Side Oats Grama	1 gallon	pot	15" o.c.	UNIT	2.63	
MG	Miscanthus sinensis 'Graziella'	Maiden Eulalia Grass	1 gallon	pot	15" o.c.	UNIT	1.63	
PN	Panicum virgatum 'Northwind'	Northwind Switch Grass	1 gallon	pot	15" o.c.	UNIT	1.25	
SH	Sporobolus heterolepis	Prairie Dropseed	1 gallon	pot	18" o.c.	UNIT	2	
						Total units:	7.51	

Code		Common Name	Size	Root	Remarks	Unit	Tota
30000	SHRUBS						
SM	Syringa meyeri 'Palibin'	Dwarf Korean Lilac	24" height	B&B	24" o.c.	each	(
	PERENNIAL PLANTS, DAYLILIES						
HC	Hemerocallis 'Cherry Cheeks'	Cherry Cheeks Daylily	1 gallon	pot	18" o.c.	UNIT	0.07
НН	Hemerocallis 'Chicago Heirloom'	Chicago Heirloom Daylily	1 gallon	pot	15" o.c.	UNIT	0.0
					Electric Commence	Total units:	0.14
	PERENNIAL PLANTS, GALLON POT						
LS	Liatris spicata 'Kolbold'	Kolbold Spike Gayfeather	1 gallon	pot	18" o.c.	UNIT	0.07
						Total units:	0.07

	SCHEDULE OF LANDSCAPE ITEMS - 79TH STREET GATEWAY - NORTHWEST							
Code	Item	Common Name	Size	Root	Remarks	Unit	Tota	
	SHADE TREES							
AC	Aesculus x carnea 'Fort McNair'	Fort McNair Red Horsechestnut	3" caliper	B&B	matching heads, 20' o.c.	each	7	
egalolidbilleng Sil seldeligeng Sil seldeligeng	INTERMEDIATETIRES TELEFORES	en en production de la company de la comp						
MA	Malus 'Red Peacock'	Red Peacock Crabapple	2-1/2" caliper	B&B	matching heads, 12' o.c.	each	4	
	SHRUBS							
SM	Syringa meyeri 'Palibin'	Dwarf Korean Lilac	24" height	B&B	24" o.c.	each	288	
THEODORIUMS THEODORIUMS	PERENNIAUP PANTS DAY LUES			NORTH STATE				
HC	Hemerocallis 'Cherry Cheeks'	Cherry Cheeks Daylily	1 gallon	pot	18" o.c.	UNIT	1.42	
HH	Hemerocallis 'Chicago Heirloom'	Chicago Heirloom Daylily	1 gallon	pot	15" o.c.	UNIT	2.11	
HP	Hemerocallis 'Preppy Pink'	Preppy Pink Daylily	1 gallon	pot	15" o.c.	UNIT	2.44	
						Total units:	5.97	
2010000	PERENNIAL PLANTS, GALLON POT							
AS	Aster azureus	Sky Blue Aster	1 gallon	pot	15" o.c.	UNIT	2.11	
LB	Liatris spicata 'Blazing Star'	Blazing Star Gayfeather	1 gallon	pot	15" o.c.	UNIT	2.44	
LS	Liatris spicata 'Kolbold'	Kolbold Spike Gayfeather	1 gallon	pot	18" o.c.	UNIT	1.42	
NF	Nepeta faassenii 'Walker's Low'	Walker's Low Faassen's Catmint	1 gallon	pot	18" o.c.	UNIT	1.42	
PE	Perovskia atriplicifoia	Russian Sage	1 gallon	pot	15" o.c.	UNIT	2.11	
						Total units:	9.5	
	PERENNIAL PLANTS, ORNAMENTAL GR	ASS TYPE						
BC	Bouteloria curtipendula	Side Oats Grama	1 gallon	pot	15" o.c.	UNIT	2.44	
PN	Panicum virgatum 'Northwind'	Northwind Switch Grass	1 gallon	pot	15" o.c.	UNIT	1.83	
PR	Panicum virgatum 'Rotstrahlbusch'	Rotstrahlbusch Switch Grass	1 gallon	pot	18" o.c.	UNIT	1.98	
SH	Sporobolus heterolepis	Prairie Dropseed	1 gallon	pot	18" o.c.	UNIT	3.65	
					un merakinik diperakan (III)	Total units:	9,9	

Code	Item	Common Name	Size	Root	Remarks	Unit	Tota
	SHRUBS			internessor sensor			
SM	Syringa meyeri 'Palibin'	Dwarf Korean Lilac	24" height	B&B	24" o.c.	each	
	PERENNIAL PLANTS, DAYLILIES						
HC	Hemerocallis 'Cherry Cheeks'	Cherry Cheeks Daylily	1 gallon	pot	18" o.c.	UNIT	0.08
НН	Hemerocallis 'Chicago Heirloom'	Chicago Heirloom Daylily	1 gallon	pot	15" o.c.	UNIT	0.08
						Total units:	0.16
	PERENNIAL PLANTS, GALLON POT				adem com a la libraria de la		ali de la companion de la comp
LS	Liatris spicata 'Kolbold'	Kolbold Spike Gayfeather	1 gallon	pot	18" o.c.	UNIT	80.0
						Total units:	0.08

SITE DESIGN GROUP

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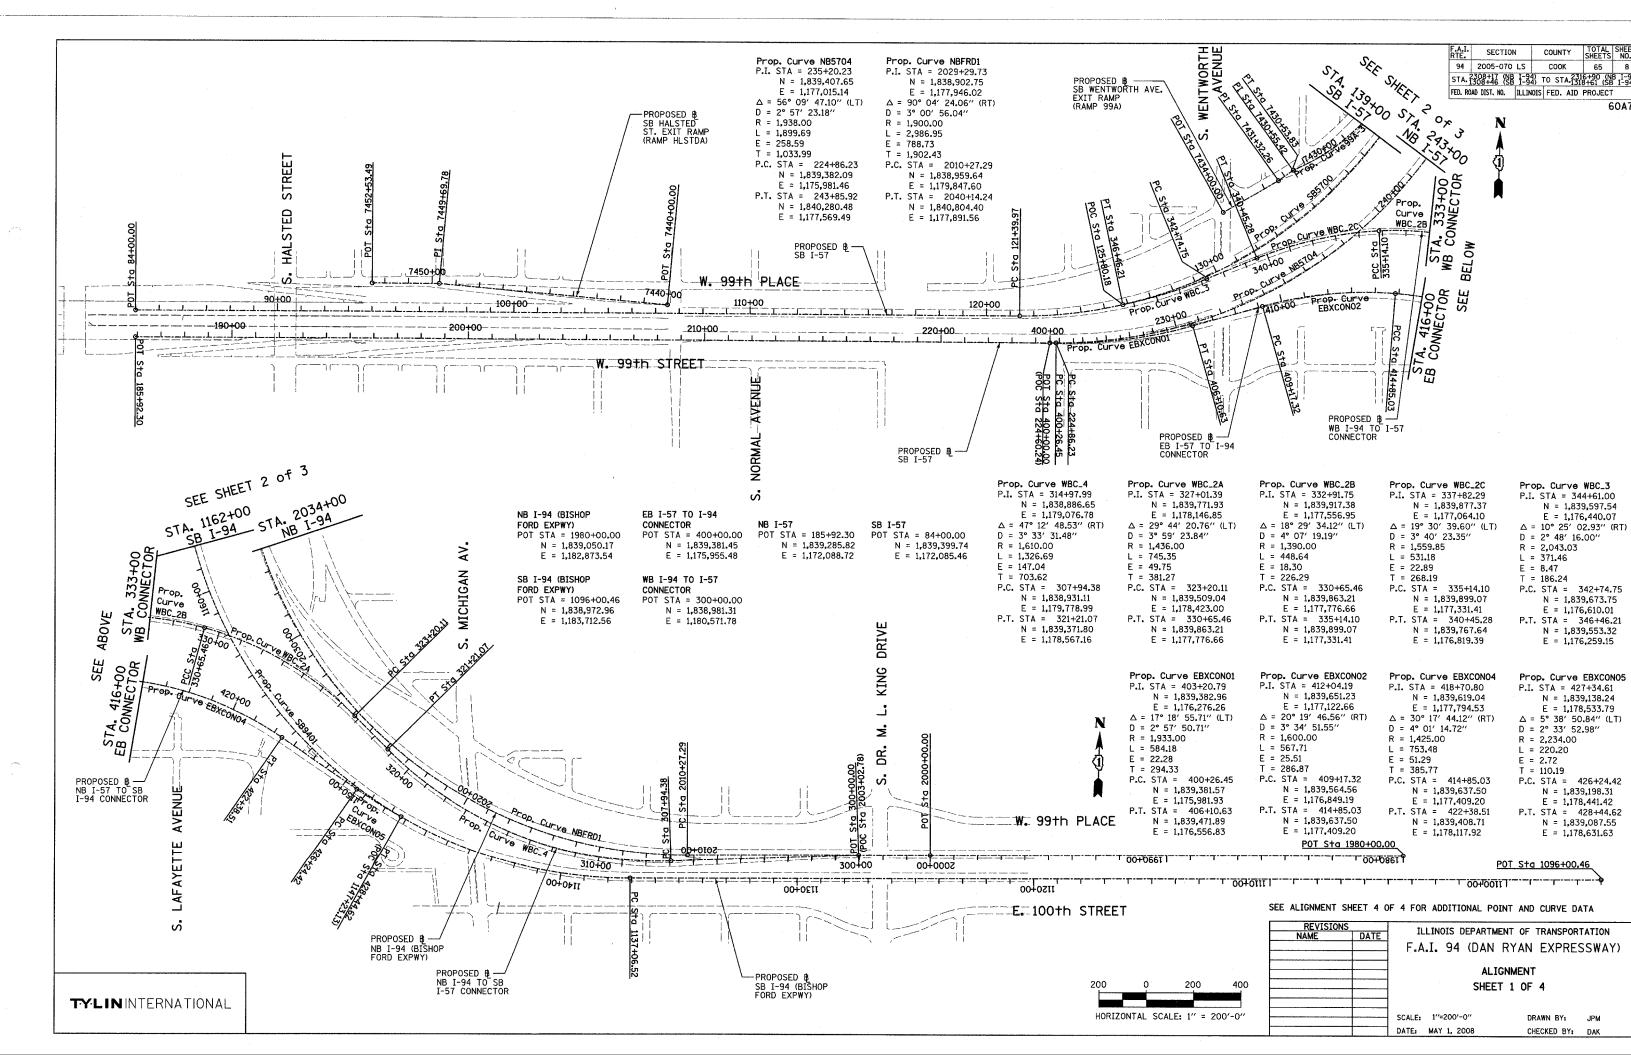
REVISIONS
NAME
DATE


F.A.I. 94 (DAN RYAN EXPRESSWAY)


PLANT SCHEDULES
SW + NW QUADRANTS AT 79TH ST. - NB I-94

SCALE: NTS
DATE: May I. 2008

CHECKED BY: JO



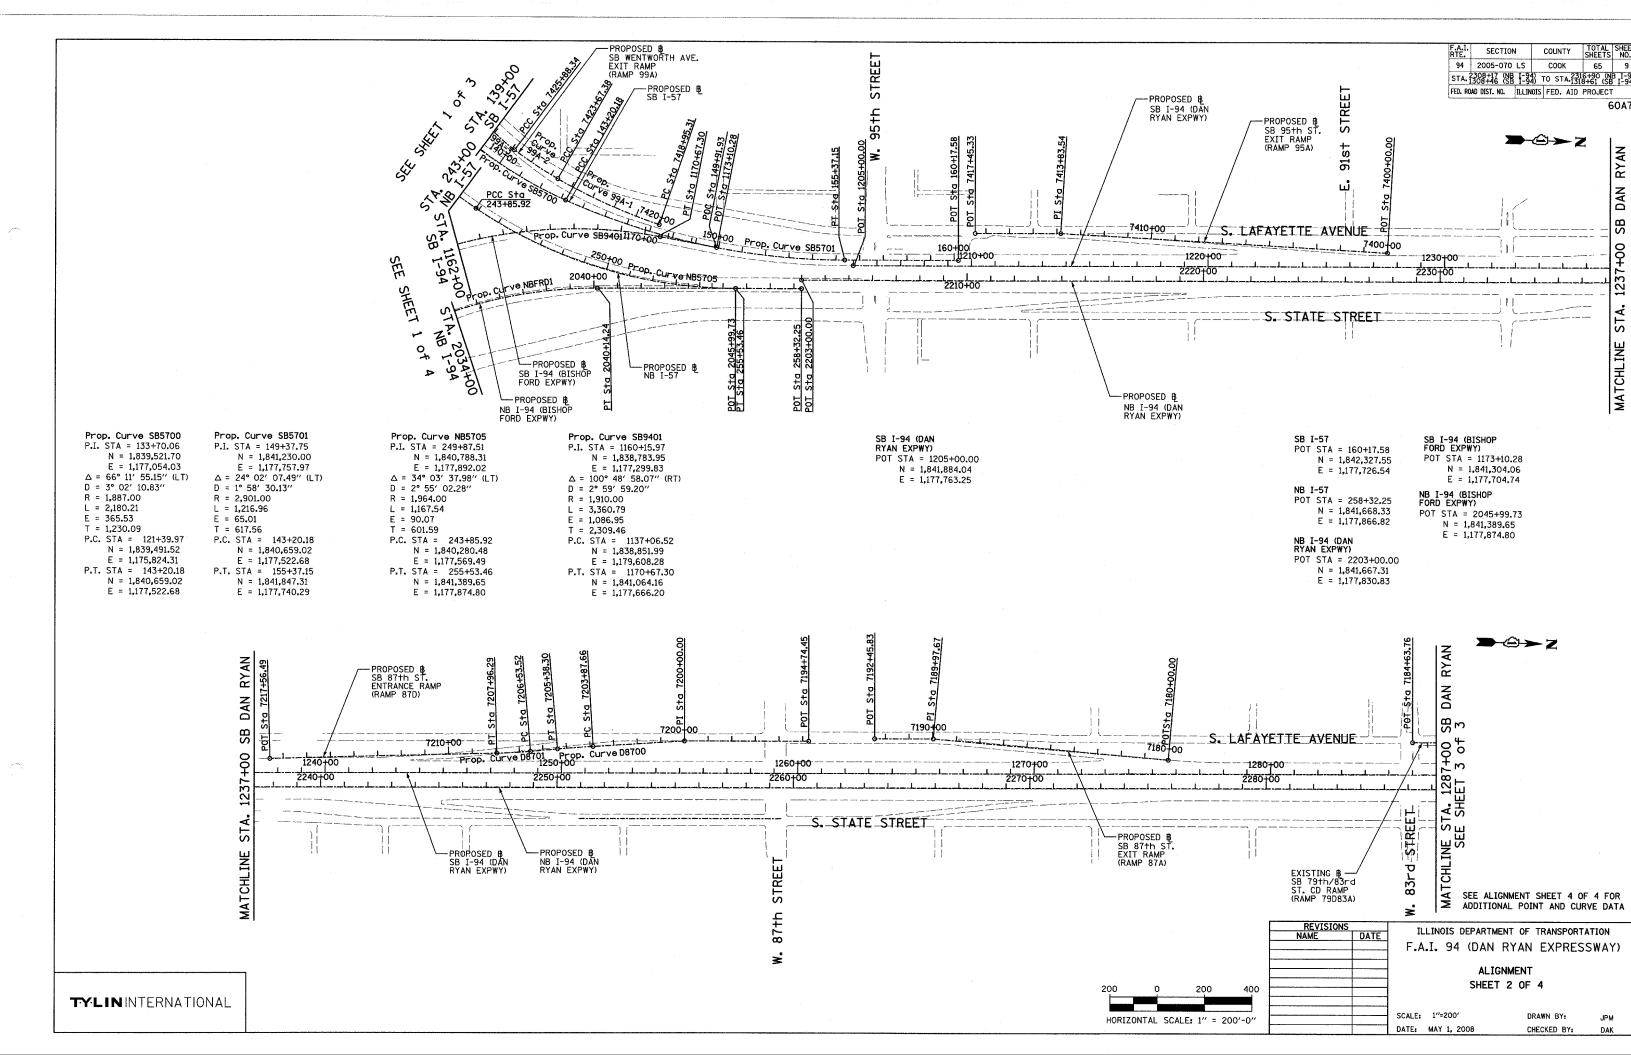

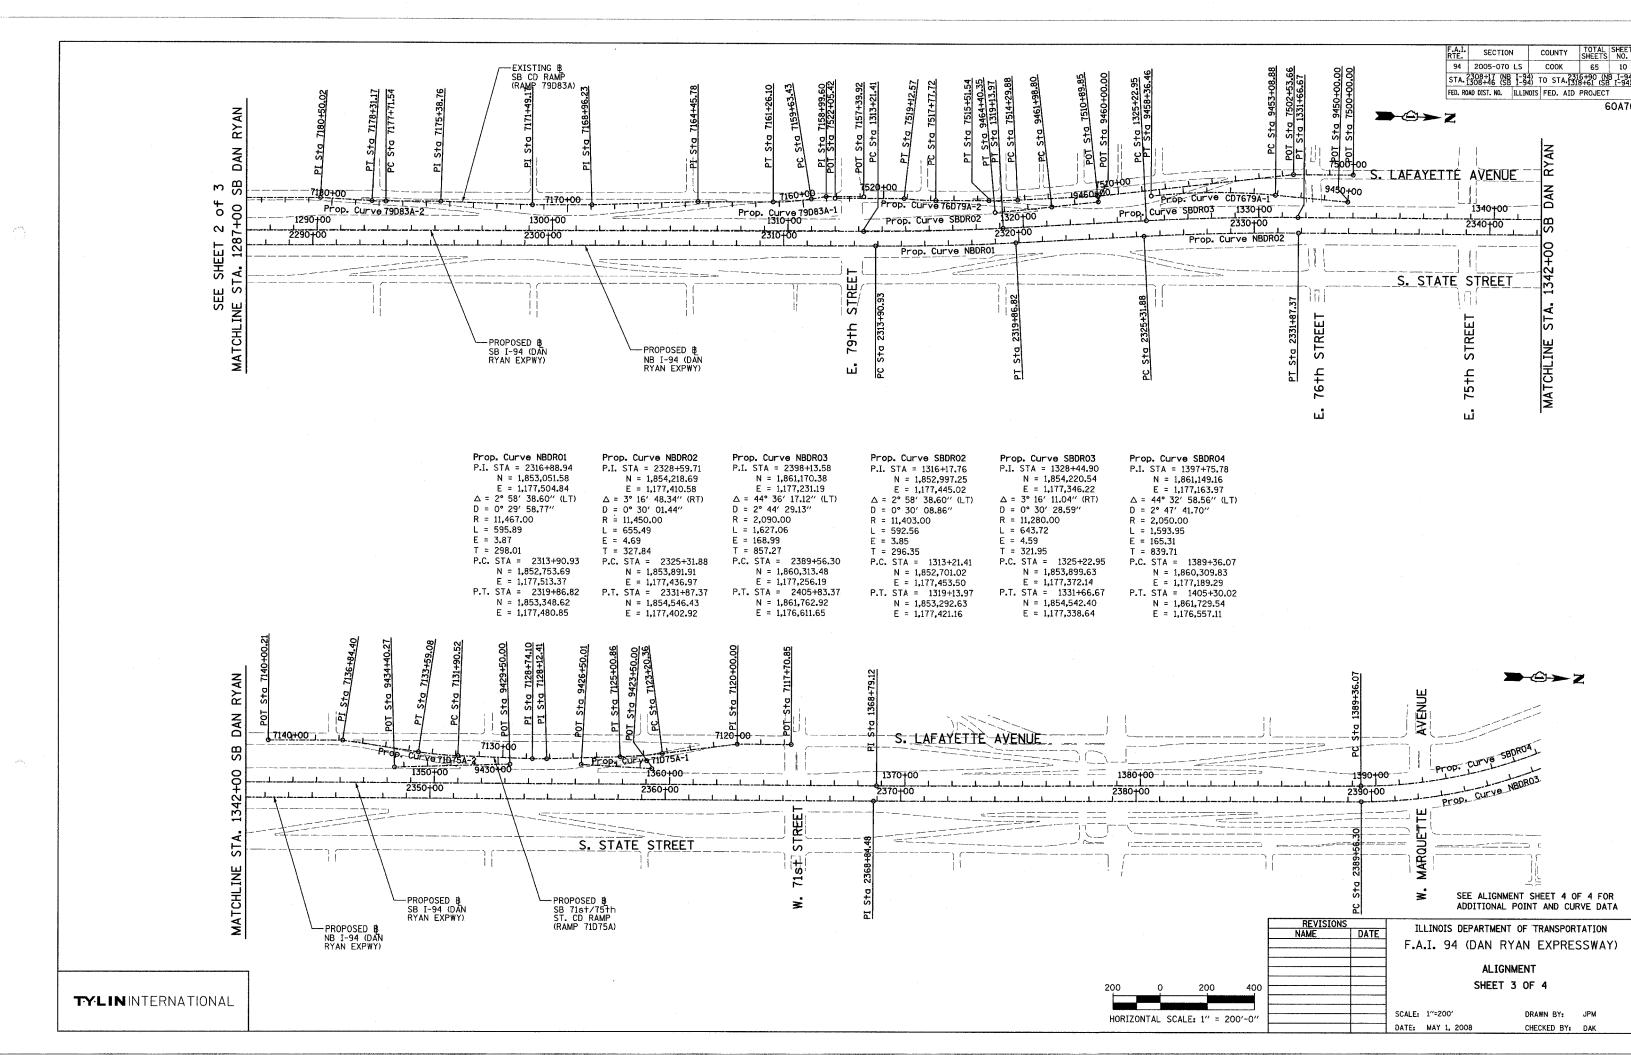

SB HALSTED ST. EXIT RAMP (RAMP HLSTDA)

POT STA = 7440+00.00 N = 1,839,490.94E = 1,174,333.70P.I. STA = 7449+69.78 N = 1,839,551.73E = 1,173,365.83POT STA = 7452+53.49 N = 1,839,544.76E = 1.173.082.20

SB WENTWORTH AVE.

POT STA = 7430+55.42 N = 1,840,141.17 E = 1,176,961.02POT STA = 7431+32,26 N = 1,840,094.48E = 1,176,899.99POT STA = 7434+00.00 N = 1,839,955.89E = 1,176,670.92

Prop. Curve 99A-1 P.I. STA = 7421+32.05N = 1,840,832.05E = 1,177,544.75

 $\Delta = 10^{\circ} 49' 08.53'' (RT)$ D = 2° 17′ 30.59″ R = 2,500.00L = 472.07T = 236.74P.C. STA = 7418+95.31

N = 1.841.058.12E = 1,177,615.03P.T. STA = 7423+67.38 N = 1,840,623.20E = 1.177.433.29

E = 3.60 $\Gamma = 110.64$ P.C. STA = 7423+67.38 N = 1,840,623.20 E = 1,177,433.29P.T. STA = 7425+88.34 N = 1,840,435.56E = 1,177,316.90

 $\Delta = 7^{\circ} 26' 49.68'' (RT)$

D = 3° 22′ 13.22″

R = 1,700.00

L = 220.96

Prop. Curve 99A-2 P.I. STA = 7424+78.02 Prop. Curve 99A-3 P.I. STA = 7428+26.42N = 1,840,525.59N = 1.840.241.82 E = 1.177.381.20

F = 1.177.178.53 $\Delta = 29^{\circ} 38' 02.27'' (RT)$ D = 6° 21′ 58.31″ R = 900.00L = 465.49 E = 30.96

T = 238.08P.C. STA = 7425+88.34 N = 1,840,435.56E = 1,177,316.90P.T. STA = 7430+53.83 N = 1.840.141.84

E = 1,176,962.46

SB 95th ST. EXIT RAMP (RAMP 95A)

POT STA = 7400+00.00N = 1,844,139.73 E = 1.177.638.63P.I. STA = 7413+83.54 N = 1,842,756.77E = 1,177,598.60POT STA = 7417+45.33 N = 1,842,395.13E = 1,177,608.95

SB 87th ST. ENTRANCE RAMP

(RAMP 87D) POT STA = 7194+74.45 N = 1.847,424.06E = 1,177,468.58P.I. STA = 7200+00.00 N = 1,846,898.74E = 1,177,484.09POT STA = 7217+56.49 N = 1,845,147.17E = 1,177,609.78

Prop. Curve D8700 P.I. STA = 7204+62.99

E = 1,177,524.69 $\Delta = 1^{\circ} 30' 03.72'' (LT)$ D = 0° 59′ 47.21″ R = 5.750.00L = 150.64E = 0.49

T = 75.32P.C. STA = 7203+87.66 N = 1,846,512.58E = 1,177,518.09

N = 1,846,362.71E = 1.177.533.26

Prop. Curve D8701 P.I. STA = 7207+24.93

N = 1.846.177.29E = 1,177,554.49 $\Delta = 3^{\circ} 27' 36.43'' (RT)$ D = 2° 25′ 25.25″ R = 2.364.00L = 142.76 E = 1.08

T = 71.40

SB 87th ST. EXIT RAMP (RAMP 87A)

POT STA = 7180+00-00 N = 1.848.946.30E = 1,177,501.00P.I. STA = 7189+97.67 N = 1,847,950.35E = 1,177,442.53POT STA = 7192+45.83 N = 1,847,702.29E = 1,177,449.63

N = 1.846.437.54

P.T. STA = 7205+38.30

P.C. STA = 7206+53.52 N = 1,846,248.23E = 1,177,546.37P.T. STA = 7207+96.29 N = 1,846,105.99E = 1,177,558.32

Prop. Curve 79D83A-1 P.I. STA = 7160+44 94

N = 1.852.394.55 E = 1.177.340.32 $\Delta = 9^{\circ} 19' 12.90'' (RT)$ D = 5° 43' 46.48" R = 1.000.00

L = 162.67E = 3.32T = 81.51

P.C. STA = 7159+63.43 N = 1,852,474.58E = 1,177,324.82P.T. STA = 7161+26.10

N = 1,852,313.07E = 1,177,342.65

Prop. Curve 79D83A-2 P.I. STA = 7178+01.36N = 1.850.638.94F = 1.177.390.59

 $\Delta = 3^{\circ} 24' 57.69'' (RT)$ D = 5° 43' 46.48" R = 1.000.00L = 59.62 E = 0.44

T = 29.82 P.C. STA = 7177+71.54 N = 1,850,668.74E = 1,177,389.73P.T. STA = 7178+31.17

N = 1,850,609.13E = 1,177,389,66

(RAMP 79D83A) POT STA = 7157+39.92 N = 1.852.696.86

SB C-D RAMP

E = 1,177,308.11P.I. STA = 7158+99.60 N = 1,852,537.24E = 1,177,312.68P.I. STA = 7164+45.78

N = 1,851,993.52E = 1,177,351.80P.I. STA = 7168+96.23 N = 1,851,543.85E = 1,177,378.34

P.I. STA = 7171+49.17 N = 1,851,291.02E = 1,177,385.58P.I. STA = 7175+38.76 N = 1.850.901.43E = 1,177,383.07

P.I. STA = 7180+50.02N = 1.850.390.38E = 1.177.382.88 POT STA = 7184+63.76 N = 1.849.976.81E = 1,177,394.72

SB 76th/79th ST. CD RAMP (RAMP 76D79A)

POT STA = 7500+00.00 N = 1.854.771.42E = 1.177.153.21 P.I. STA = 7502+53.66N = 1.854.517.84E = 1,177,159.17P.I. STA = 7510+89.85

N = 1,853,689.73E = 1,177,275.17POT STA = 7522+05.42

N = 1,852,575.71

SB 71st/75th ST. CD RAMP

POT STA = 7117+70.85

P.I. STA = 7120+00.00

P.I. STA = 7128+12.41

P.I. STA = 7128+74.10

P.I. STA = 7136+84.40

POT = 7140+00.21N = 1,855,665.56

N = 1,857,886.40

E = 1,177,086.26

N = 1,857,657.31

E = 1,177,091.65

N = 1.856.850.29

E = 1,177,177.64

N = 1.856.788.62

E = 1.177.179.10

N = 1,855,981.27

E = 1,177,124.75

E = 1,177,132.18

(RAMP 71D75A)

Prop. Curve 76D79A-1 P.I. STA = 7514+90.72N = 1.853.290.06

F = 1.177.306.25 $\Delta = 2^{\circ} 48' 22.72'' (RT)$ D = 2° 18' 23.74" R = 2,484.00L = 121.66

E = 0.75T = 60.84P.C. STA = 7514+29.88 N = 1,853,350.72

E = 1,177,301.54P.T. STA = 7515+51.54 N = 1,853,229.24E = 1,177,307.99

Prop. Curve 71D75A-1

N = 1,857,251.52

E = 1.177.154.81

 $\Delta = 5^{\circ} 35' 23.99'' (RT)$

P.C. STA = 7123+20.36

P.T. STA = 7125+00.86

N = 1,857,340.76

E = 1,177,140.92

N = 1,857,161.34

E = 1,177,159.94

 $D = 3^{\circ} 05' 49.45''$

 $R \approx 1.850.00$

1 = 180.49

E = 2.20

T = 90.32

P.I. STA = 7124+10.68

SB 76th/79th ST. CD EXIT CONNECTOR Prop. Curve 76D79A-2 P.I. STA = 7518+45.22(CD7679A) N = 1.852.935.69 POT STA = 9450+00.00 F = 1.177.316.40N = 1,854,751.70

 $\Delta = 6^{\circ} 31' 33.29'' (RT)$ $D = 4^{\circ} 50' 21.01''$ R = 1.184.00L = 134.86

E = 1.92T = 67.50P.C. STA = 7517+77.72 N = 1,853,003.16

E = 1,177,314.47P.T. STA = 7519+12.57 N = 1,852,868.44

N = 1,856,387.85

E = 1.177,175.17

 $\Delta = 6^{\circ} 30' 28.18'' (RT)$ D = 3° 51' 39.25''

P.C. STA = 7131+90.52

P.T. STA = 7133+59.08

N = 1,856,472,22

E = 1,177,176.00

N = 1,856,304.13

E = 1,177,164.79

R = 1.484.00

1 = 168.56

T = 84.37

E = 2.40

E = 1,177,310.65T = 264.70P.C. STA = 9453+08.88 N = 1,854,443.44

E = 1,177,247.69P.T. STA = 9458+36.46 N = 1,853,917.14E = 1,177,267.55

E = 1,177,267.37

Prop. Curve CD7679A-1

N = 1.854.179.28

E = 1,177,230.83

P.I. STA = 9455+73.58

 $\triangle = 11^{\circ} 37' 34.33'' (LT)$

D = 2° 12′ 13.26″

R = 2.600.00

L = 527.58

F = 13.44

Prop. Curve 71D75A-2 SB 71st/75th ST. CD EXIT CONNECTOR P.I. STA = 7132+74.89

(RAMP CD7175A) POT STA = 9423+50.00 N = 1,857,297.2866E = 1,177,207.4713POT STA = 9426+50-01 N = 1,856,997.4225E = 1,177,198.1891

CD ENTRANCE CONNECTOR (RAMP CD7175B) POT STA = 9429+50.00

E = 1,177,233.1786

N = 1,856,694.2083E = 1,177,205.3235POT STA = 9434+40.27 N = 1,856,204.7281

> ILLINOIS DEPARTMENT OF TRANSPORTATION F.A.I. 94 (DAN RYAN EXPRESSWAY)

SB 76th/79th ST. CD ENTRANCE CONNECTOR

POT STA = 9460+00.00

Prop. Curve CD7679B-1

P.I. STA = 9463+19.58

 $\Delta = 1^{\circ} 13' 13.54'' (RT)$

P.C. STA = 9461+98.80

P.T. STA = 9464+40.35

N = 1.853.496.18

E = 1.177.326.52

N = 1,853,256.63

E = 1,177,357.48

 $D = 0^{\circ} 30' 18.91''$

R = 11.340.00

L = 241.55

T = 120.78

F = 0.64

N = 1,853,693.06

E = 1,177,298.94

N = 1,853,376.57

E = 1,177,343.27


ALIGNMENT SHEET 4 OF 4

CHECKED BY: JPM

SCALE: NO SCALE DATE: MAY 1, 2008

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DRAWN BY: JPA

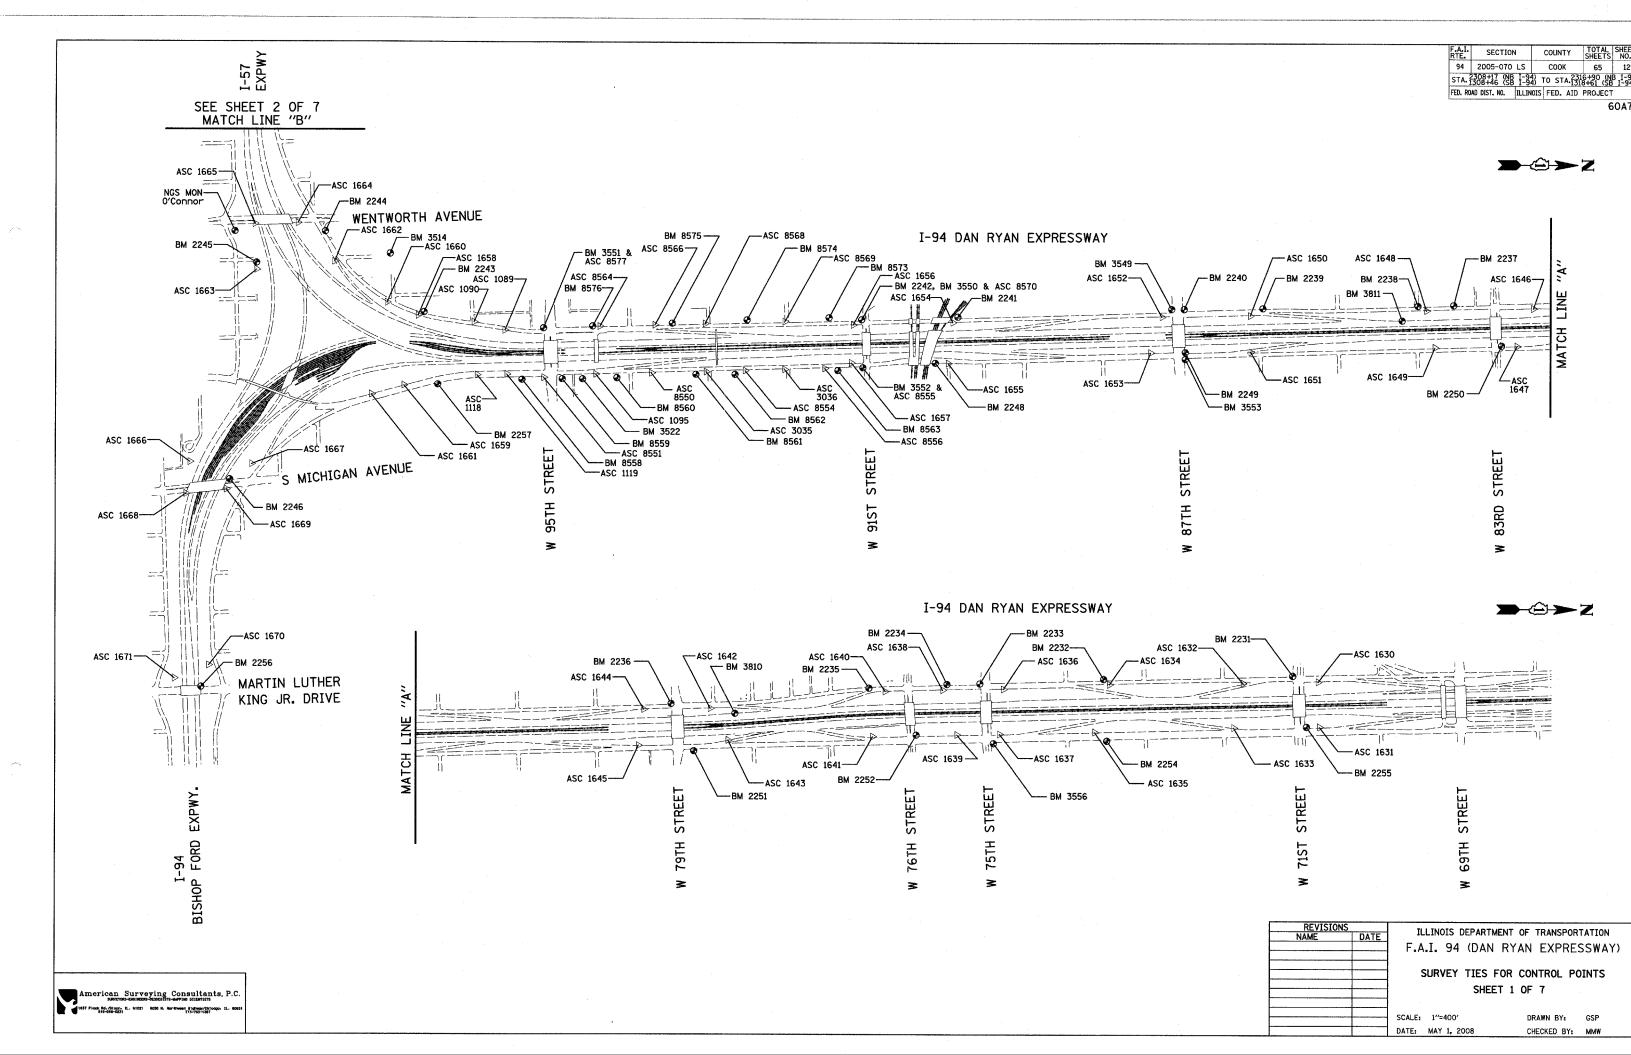

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REVISIONS
NAME DATE

F.A.I. 94 (DAN RYAN EXPRESSWAY)


SURVEY TIES FOR CONTROL POINTS
SHEET 2 OF 7

SCALE: 1"-400' DRAWN BY: GSP

DATE: MAY 1, 2008

CHECKED BY: MMW

American Surveying Consultants, P.C. surveying Scientists Scientists (1837 Pioce April 1980) 11. 1021 1035 M. Northwest Highwychioope, IL. 6085 M. Northwest Highwychioope, IL. 6085 173-60-773-60-773

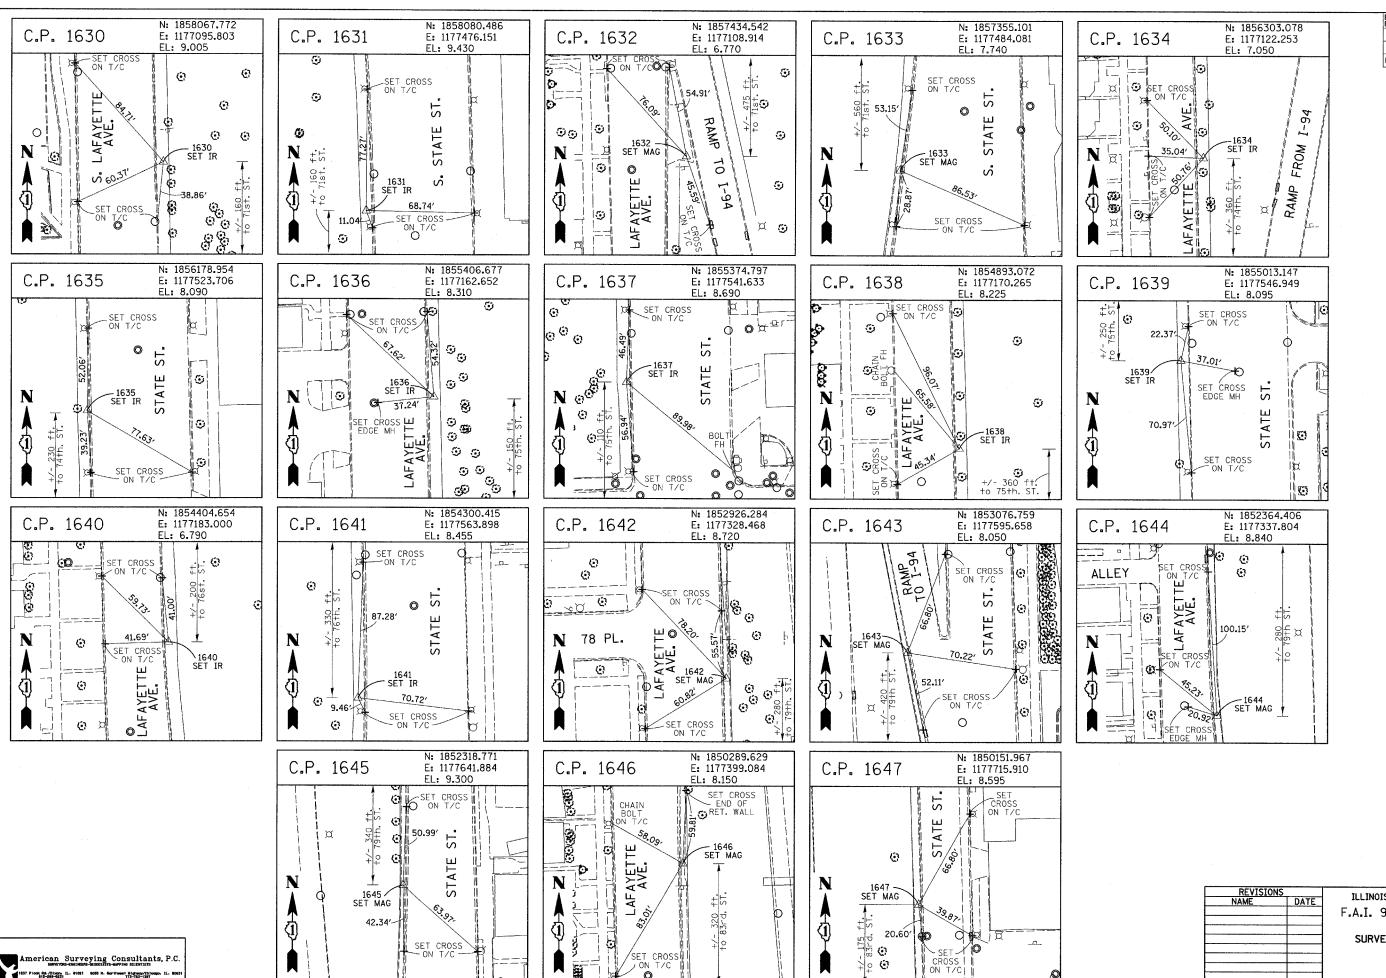


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SECTION COUNTY 94 2005-070 LS соок 65 14 STA. 2308+17 (NB 1-94) TO STA. 2316+90 (NB 1-94) TO STA. 1308+46 (SB 1-94) TO STA. 1318+61 (SB 1-94) FED. ROAD DIST. NO. ILLINOIS FED. AID PROJECT

ILLINOIS DEPARTMENT OF TRANSPORTATION F.A.I. 94 (DAN RYAN EXPRESSWAY)

SURVEY TIES FOR CONTROL POINTS SHEET 3 OF 7

SCALE: 1"=30" DATE: MAY 1, 2008 DRAWN BY: GSP CHECKED BY: MMW

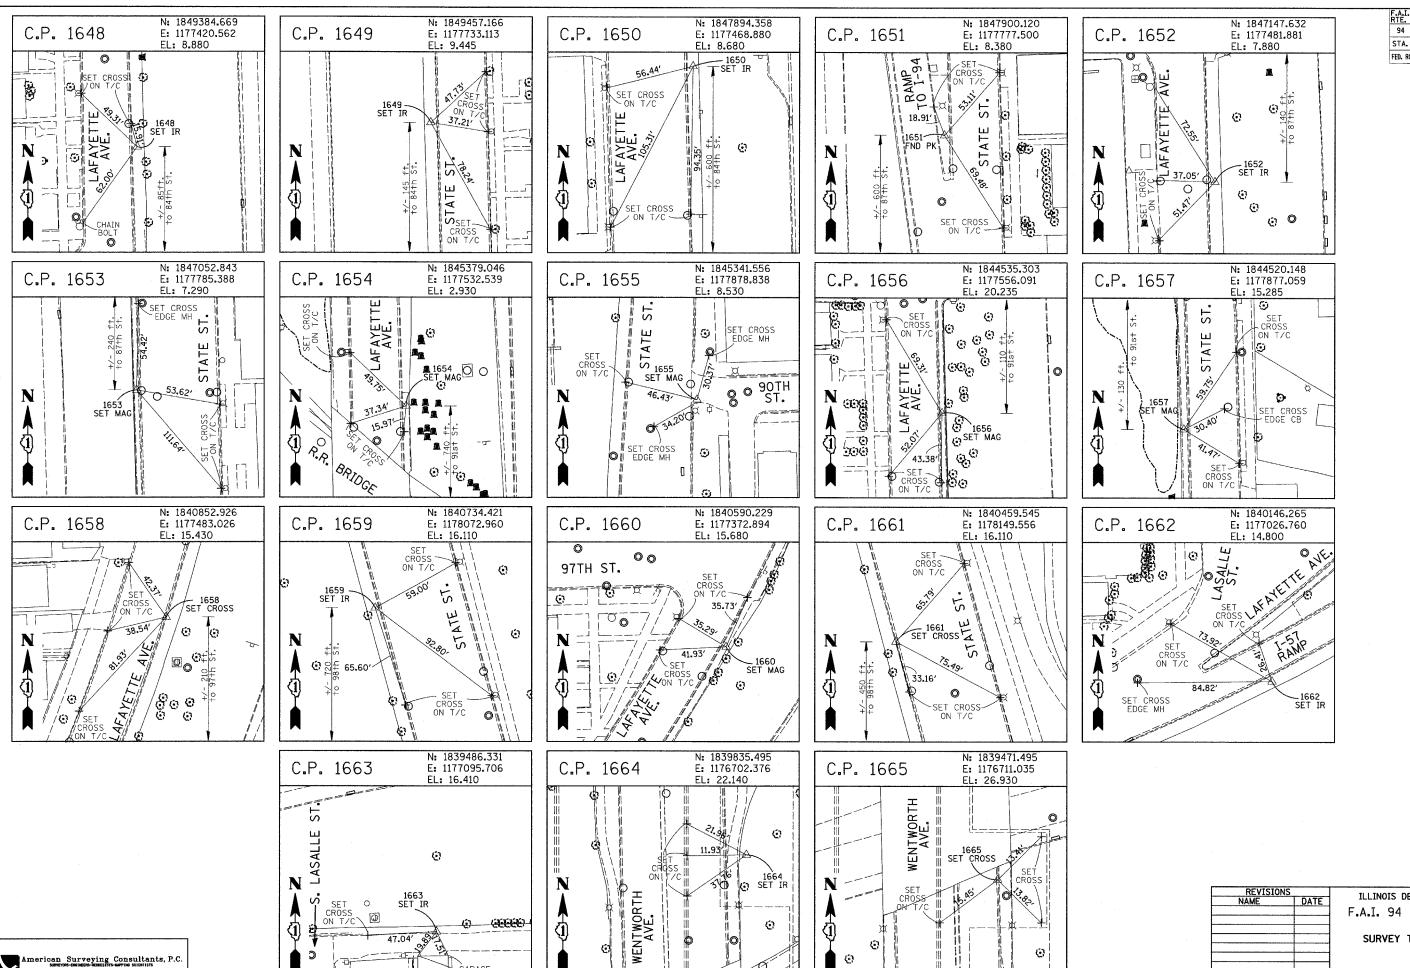

CORNERS

1637 Plock Rd./Dixon. IL. 61021 6035 N. Harthwest Highway/Chilosgo. IL. 606

94 2005-070 LS COOK 65 15

STA. 2308+17 (NB 1-94) TO STA. 2316+90 (NB 1-94)

FED. ROAD DIST. NO. | ILLINOIS | FED. AID | PROJECT

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SECTION

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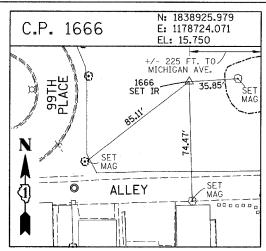
COUNTY TOTAL SHEE


ILLINOIS DEPARTMENT OF TRANSPORTATION F.A.I. 94 (DAN RYAN EXPRESSWAY)


SURVEY TIES FOR CONTROL POINTS
SHEET 4 OF 7


SCALE: 1"=30' DATE: MAY 1, 2008


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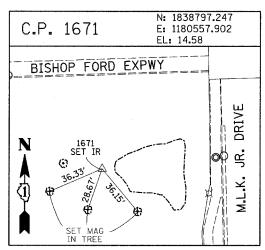




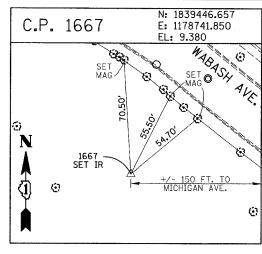

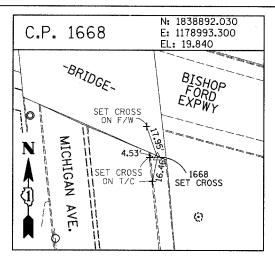F.A.I. RTE.	SECTION		COUN	ΓY	TOTAL SHEETS	SHEE'
94	2005-070	LS	COO	<	65	16
STA.	308+17 (NB 308+46 (SB	I-94)	TO ST	A.231	6+90 (N 3+61 (SE	B I-94
FED. RO	AD DIST. NO.	ILLINOIS	FED.	AID	PROJEC	Γ
					(50A7

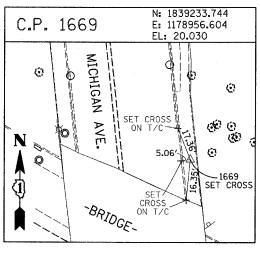PROJECT BENCHMARKS

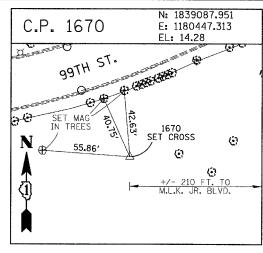

American Surveying Consultants, P.C 1637 Plock Rd./Dixon. IL. 61021 6035 H. Northweet Highway/Chicogo. IL. 6

BM 2231 ELEVATION= 10.24 FEET SET CROSS ON CHAIN BOLT OF FIRE HYDRANT ON THE SOUTHWEST CORNER OF 71ST STREET AND LAFAYETTE AVENUE.

BM 2232 ELEVATION= 8.46 FEET
SET CROSS ON CHAIN BOLT OF FIRST FIRE HYDRANT SOUTH OF 73RD STREET
ON THE WEST SIDE OF LAFAYETTE AVENUE. APPROXIMATELY 330 FEET
SOUTH OF 73RD STREET.

BM 2233 ELEVATION= 9.90 FEET SET CROSS ON NORTHWEST BOLT OF FIRE HYDRANT ON THE NORTHWEST CORNER OF 75TH STREET AND LAFAYETTE AVENUE.

BM 2234 ELEVATION= 9.56 FEET
SET CROSS ON CHAIN BOLT OF FIRST FIRE HYDRANT SOUTH OF 75TH STREET
ON THE WEST SIDE OF LAFAYETTE AVENUE, APPROXIMATELY 320 FEET SOUTH
OF 75TH STREET.

BM 2235 ELEVATION= 7.50 FEET
SET CROSS ON CHAIN BOLT OF FIRST FIRE HYDRANT SOUTH OF 76TH STREET
ON THE WEST SIDE OF LAFAYETTE. APPROXIMATELY 330 FEET SOUTH OF
76TH STREET.

BM 2236 ELEVATION= 10.41 FEET SET CROSS ON WEST BOLT OF FIRE HYDRANT ON THE SOUTHWEST CORNER OF 79TH STREET AND LAFAYETTE AVENUE.

BM 2237 ELEVATION= 9.20 FEET
SET CROSS ON CHAIN BOLT OF FIRST FIRE HYDRANT NORTH OF 83RD STREET
ON THE WEST SIDE OF LAFAYETTE AVENUE, APPROXIMATELY 350 FEET NORTH
OF 83RD STREET.

BM 2238 ELEVATION= 10.04 FEET SET CROSS ON CHAIN BOLT OF FIRE HYDRANT OF THE NORTHWEST CORNER OF 4TH STREET AND LAFAYETTE AVENUE.

BM 2239 ELEVATION= 9.59 FEET SET CROSS ON CHAIN BOLT OF SECOND FIRE HYDRANT NORTH OF 87TH STREET ON THE WEST SIDE OF LAFAYETTE AVENUE. APPROXIMATELY 720 FEET OF NORTH OF 87TH STREET.

BM 2240 ELEVATION= 9.49 FEET SET CROSS ON THE NORTHWEST BOLT OF FIRE HYDRANT ON THE SOUTHWEST CORNER OF 78TH STREET AND LAFAYETTE AVENUE.

BM 2241 ELEVATION= 3.63 FEET SUARE CUT ON TOP OF CURB NEXT TO LIGHT POLE ON THE NORTHWEST CORNER OF LAFAYETTE AVENUE AND RAILROAD BRIDGE. APPROXIMATELY 770 FEET NORTH OF 91ST STREET.

BM 2242 ELEVATION= 22.82 FEET
SET CROSS ON CHAIN BOLT OF FIRE HYDRANT ON THE SOUTHWEST CORNER OF 91ST STREET AND LAFAYETTE

BM 2243 ELEVATION= 15.68 FEET SQUARE CUT ON THE TOP OF CURB NEXT TO THIRD LIGHT POLE NORTH OF 97TH STREET ON THE WEST SIDE OF LAFAYETTE AVENUE. APPROXIMATELY 260 FEET NORTH OF 97TH STREET.

BM 2244 ELEVÁTION= 15.94 FEET
SET SQUARE CUT ON TOP OF CURB NEXT TO LIGHT POLE ON THE NORTH SIDE
OF 98TH STREET. APPROXIMATELY 120 FEET EAST OF WENTWORTH AVENUE.

BM 2245 ELEVATION= 16.35 FEET
SET SQUARE CUT ON THE EAST END OF CURB AT THE NORTHEAST CORNER OF
FIRST ALLEY NORTH OF 99TH STREET. APPROXIMATELY 35 FEET EAST OF LASALLE

BM 2246 ELEVATION= 20.00 FEET SET SQUARE CUT WITH CROSS ON TOP OF ABUTMENT WALL ON THE NORTHWEST CORNER OF STATE STREET BRIDGE OVER THE BISHOP FORD EXPRESSWAY. APPROXIMATELY 20 FEET NORTH OF THE NORTH EDGE OF THE BRIDGE.

BM 2248 ELEVATION= 9.77 FEET SET CROSS ON CHAIN BOLT OF FIRST FIRE HYDRANT NORTH OF RAILROAD BRIDGE ON THE EAST SIDE OF STATE STREET. APPROXIMATELY 110 FEET SOUTH OF 90TH STREET.

BM 2249 ELEVATION= 9.67 FEET SET CROSS ON CHAIN BOLT OF FIRE HYDRANT ON THE NORTHWEST CORNER OF 87TH AND STATE STREET.

BM 2250 ELEVATION= 10.03 FEET SET CROSS ON CHAIN BOLT OF FIRE HYDRANT ON THE NORTHWEST CORNER OF 83RD ST. AND STATE STREET.

BM 2251 ELEVATION= 10.95 FEET FOUND CROSS ON EAST BOLT OF FIRE HYDRANT ON THE EAST SIDE OF STATE STREET. APPROXIMATELY 135 FEET NORTH OF 79TH STREET.

BM 2252 ELEVATION= 10.02 FEET
SET CROSS ON WEST BOLT OF FIRE HYDRANT ON THE NORTHWEST CORNER OF
STATE STREET AND 76TH STREET.

BM 2254 ELEVATION= 9.17 FEET
SET CROSS ON CHAIN BOLT OF FIRST FIRE HYDRANT SOUTH OF 73RD STREET
ON THE EAST SIDE OF STATE STREET. APPROXIMATELY 330 FEET SOUTH OF
73RD STREET.


BM 2255 ELEVATION= 11.25 FEET SET CROSS ON CHAIN BOLT OF FIRE HYDRANT ON THE NORTHWEST CORNER OF 71ST STREET AND STATE STREET.

BM 2256 ELEVATION= 16.36 FEET
SET SQUARE CUT ON TOP OF ABUTMENT WALL ON THE NORTHWEST CORNER OF
MARTIN LUTHER KING DRIVE BRIDGE OVER THE BISHOP FORD EXPRESSWAY.
APPROXIMATELY 1 FOOT NORTH OF THE NORTH END OF THE BRIDGE.

BM 2257 ELEVATION= 18.25 FEET
SET CROSS ON NORTHEAST BOLT OF LIGHT POLE BASE ON THE EAST SIDE OF
STATE STREET. APPROXIMATELY 970 FEET SOUTH OF 95TH STREET.


BM 2258 ELEVATION= 10.53 FEET SET CROSS ON NORTHWEST BOLT OF LIGHT BASE ON NORTHWEST CORNER OF 71ST STREET AND LAFAYETTE AVENUE.

REVISIONS	ILLINOIS DEPARTMENT OF TRANSPORTATION
NAME DATE	ILLINOIS DEPARTMENT OF TRANSPORTATION
	F.A.I. 94 (DAN RYAN EXPRESSWA)
	SURVEY TIES FOR CONTROL POINTS
	SHEET 5 OF 7
	SHEET 5 OF 1

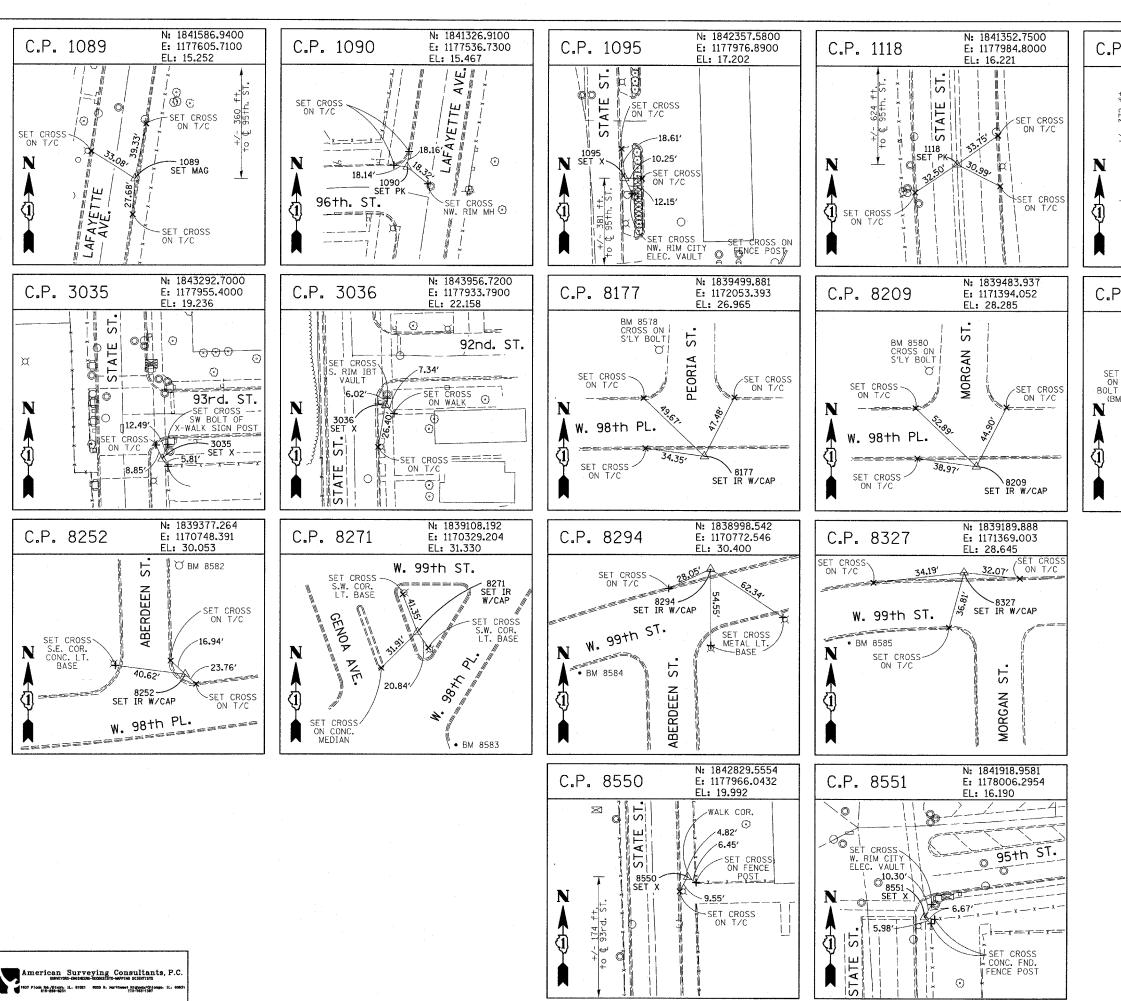

SECTION N: 1841604.2400 94 2005-070 LS C.P. 1119 E: 1177978.1000 STA. 2308+17 (NB I-94) TO STA 2316+90 (NB I-94) TO STA 1318+61 (SB I-94) EL: 16.188 FED. ROAD DIST. NO. ILLINOIS FED. AID PROJECT ST. STATE 0 -SET CROSS ON T/C 1119 PK SET 0

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SET CROSS ON T/C

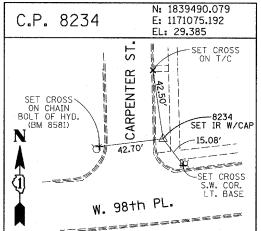ILLINOIS DEPARTMENT OF TRANSPORTATION F.A.I. 94 (DAN RYAN EXPRESSWAY)

> SURVEY TIES FOR CONTROL POINTS SHEET 6 OF 7

DATE: MAY 1, 2008

REVISIONS


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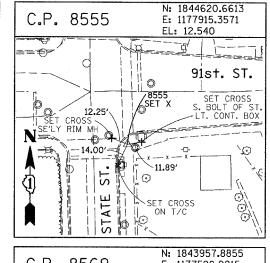
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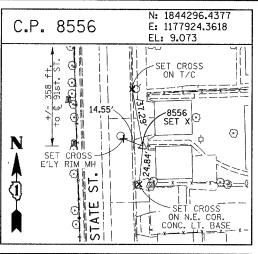
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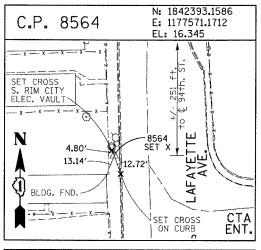
COUNTY


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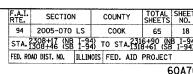








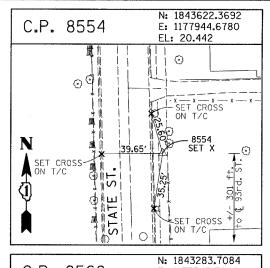

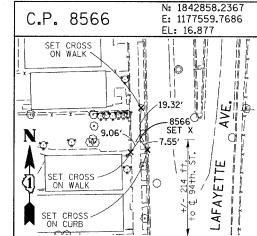


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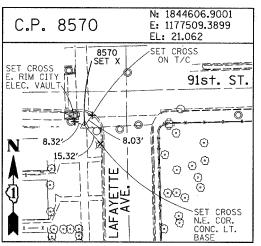
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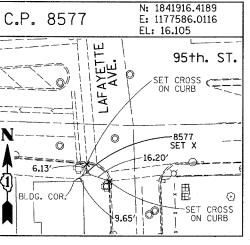
SET CROSS
E. RIM CITY
ELEC. VAULT

93rd. ST.

SET X





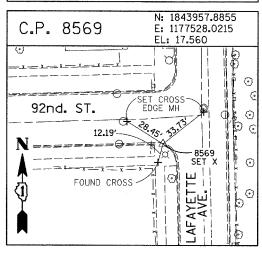

PROJECT BENCHMARKS

BM 101 ELEVATION= 24.89 FEET
SET SQUARE CUT ON SOUTHERLY CURB OF WEST 98TH PLACE. APPROXIMATELY
70 FEET EAST OF THE CENTERLINE OF GREEN STREET.

BM 102 ELEVATION= 27.36 FEET
SET CROSS ON SOUTHERLY FLANGE BOLT OF FIRE HYDRANT AT THE SOUTHWEST
CORNER OF WEST 99TH STREET AND GREEN STREET.

BM 8558 ELEVATION= 17.73 FEET
SET SQUARE CUT ON SOUTHEAST CORNER OF FOURTH LIGHT BASE SOUTH OF
95TH STREET, ON THE EAST SIDE OF STATE STREET.

BM 8559 ELEVATION= 17.10 FEET
SET SQUARE CUT ON SOUTHWEST CORNER OF CONCRETE SIGN BASE AT THE
NORTHWEST CORNER OF THE MOBIL GAS STATION PROPERTY AT THE NORTHEAST
CORNER OF 95TH STREET AND STATE STREET.

BM 8560 ELEVATION= 17.50 FEET ST SQUARE CUT ON SOUTHEAST CORNER OF CONCRETE BUS SLAB ON THE EAST SIDE OF STATE STREET. APPROXIMATELY 50 FEET SOUTH OF THE CENTERLINE OF 94TH STREET.

BM 8561 ELEVATION= 19.77 FEET
SET CROSS ON SOUTHEASTERLY FLANGE BOLT OF FIRST FIRE HYDRANT SOUTH OF
93RD STREET, ON THE EAST SIDE OF STATE STREET.

BM 8562 ELEVATION= 22.29 FEET
SET CROSS ON SOUTHEASTERLY FLANGE BOLT OF FIRST FIRE HYDRANT NORTH OF
93RD STREET, ON THE EAST SIDE OF STATE STREET.

BM 8563 ELEVATION= 20.47 FEET SET CROSS ON SOUTHEASTERLY FLANGE BOLT OF FIRST FIRE HYDRANT SOUTH OF 91ST STREET, ON THE EAST SIDE OF STATE STREET.

BM 8573 ELEVATION= 19.89 FEET
SET SQUARE CUT ON EAST SIDE OF SIDEWALK OPPOSITE TO THE SECOND FIRE
HYDRANT SOUTH OF 91ST STREET, ON THE WEST SIDE OF LAFAYETTE AVENUE.

BM 8574 ELEVATION= 18.90 FEET SET CROSS ON THE WESTERLY FLANGE BOLT OF FIRE HYDRANT APPROXIMATELY AT 9224 S. LAFAYETTE AVENUE, ON THE WEST SIDE OF LAFAYETTE AVENUE.

BM 8575 ELEVATION= 17.77 FEET SET CROSS ON THE WESTERLY FLANGE BOLT OF FIRE HYDRANT APPROXIMATELY AT 9326 S. LAFAYETTE AVENUE, ON THE WEST SIDE OF LAFAYETTE AVENUE.

BM 8576 ELEVATION= 17.43 FEET SET CROSS ON THE WESTERLY FLANGE BOLT OF FIRE HYDRANT AT THE VACANT LOT BETWEEN 9416 AND 9422 S. LAFAYETTE AVENUE, ON THE WEST SIDE OF LAFAYETTE AVENUE.

BM 8578 ELEVATION= 27.92 FEET SET CROSS ON SOUTHERLY FLANGE BOLT OF FIRE HYDRANT AT THE NORTHWEST CORNER OF WEST 98TH PLACE AND PEORIA STREET.

BM 8579 ELEVATION= 28.59 FEET
SET CROSS ON SOUTHERLY FLANGE BOLT OF FIRE HYDRANT AT THE NORTHWEST
CORNER OF WEST 98TH PLACE AND SANGAMON STREET.

BM 8580 ELEVATION= 29.24 FEET SET CROSS ON SOUTHERLY FLANGE BOLT OF FIRE HYDRANT AT THE NORTHWEST CORNER OF WEST 98TH PLACE AND MORGAN STREET.

BM 8581 ELEVATION= 30.82 FEET SET CROSS ON CHAIN BOLT OF FIRE HYDRANT ON THE NORTHWEST CORNER OF CARPENTER STREET AND WEST 98TH PLACE.

BM 8582 ELEVATION= 30.69 FEET SET CROSS ON CHAIN BOLT OF FIRST FIRE HYDRANT NORTH OF WEST 98TH PLACE, ON THE EAST SIDE OF ABERDEEN STREET.

BM 8583 ELEVATION= 33.14 FEET ST SQUARE CUT ON CONCRETE BRIDGE WALL AT THE SOUTHEASTERLY CORNER OF GENOA AVENUE AND 99TH STREET.

BM 8584 ELEVATION= 32.36 FEET SET CROSS ON CHAIN BOLT OF FIRST FIRE HYDRANT WEST OF ABERDEEN STREET, ON THE SOUTHERLY SIDE OF 99TH STREET.

BM 8585 ELEVATION= 30.28 FEET SET CROSS ON SOUTHERLY FLANGE BOLT OF FIRST FIRE HYDRANT WEST OF MORGAN STREET, ON THE SOUTH SIDE OF 99TH STREET.

BM 8586 ELEVATION= 28.75 FEET SET CROSS ON NORTHERLY FLANGE BOLT OF FIRE HYDRANT AT THE SOUTHWEST CORNER OF 99TH STREET AND SANGAMON STREET.

BM 8587 ELEVATION= 31.19 FEET SET CROSS ON SOUTHERLY FLANGE BOLT OF FIRE HYDRANT AT THE SOUTHWEST CORNER OF 99TH STREET AND CARPENTER STREET.

BM 3514 ELEVATION= 17.56 FEET SET CROSS ON CHAIN BOLT OF HYDRANT AT SOUTHTHWEST INTERSECTION OF LASALLE ST. AND 97TH ST.

BM 3522 ELEVATION= 18.06 FEET SET CROSS ON SOUTH SOUTHEAST FLANGE BOLT OF HYDRANT ± HALFWAY BETWEEN NORTH AND SOUTH ENTRANCE TO CITGO, EAST SIDE OF STATE STAND NORTH OF 95TH ST.

BM 3549 ELEVATION= 9.49 FEET SET CROSS WESTERLY FLANGE BOLT OF HYDRANT AT SOUTHWEST INTERSECTION OF 87TH ST. AND LAFAYETTE AVE.

BM 3550 ELEVATION= 22.88 FEET SET CROSS WESTERLY FLANGE BOLT OF HYDRANT AT SOUTHWEST INTERSECTION OF 91ST ST. AND LAFAYETTE AVE.

BM 3551 ELEVATION= 17.50 FEET SET CROSS NORTHERLY FLANGE BOLT OF HYDRANT AT SOUTHWEST INTERSECTION OF 95TH ST. AND LAFAYETTE AVE.

BM 3552 ELEVATION= 14.81 FEET
SET CROSS NORTHEAST BOLT OF TRAFFIC SIGNAL/LIGHT BASE AT
SOUTHEAST INTERSECTION OF 91ST ST. AND STATE ST.

BM 3553 ELEVATION= 8.47 FEET SET CROSS NORTHWEST BOLT OF TRAFFIC SIGNAL/LIGHT BASE AT NORTHEAST INTERSECTION OF 87TH ST. AND STATE ST.

BM 3556 ELEVATION= 9.06 FEET SET CROSS EASTERLY FLANGE BOLT OF HYDRANT AT NORTHEAST CORNER OF 75TH ST. AND STATE ST.

BM 3558 ELEVATION= 18.15 FEET SET CROSS SOUTHWESTERLY FLANGE BOLT OF HYDRANT AT NORTHWEST INTERSECTION OF NORMAL ST. AND 98TH PLACE.

BM 3810 ELEVATION= 0.29 FEET CUT SQUARE ON SOUTHERLY CORNER OF METAL BASE FOR OVERHEAD SIGN, ON THE WESTERLY SIDE OF SOUTHBOUND DAN RYAN, OPPOSITE OF WEST 77TH PLACE, APPROXIMATELY 1000 FEET NORTH OF 79TH STREET BRIDGE.

BM 3811 ELEVATION= 1.95 FEET CUT SQUARE ON SOUTHEASTERLY CORNER OF METAL BASE FOR OVERHEAD SIGN, ON THE WESTERLY SIDE OF SOUTHBOUND DAN RYAN APPROXIMATELY 840 FEET SOUTHERLY OF 83RD STREET.

SCALE: 1"=30"

DATE: MAY 1, 2008

REVISIONS NAME D	DATE	ILLINOIS DEPARTMENT OF TRANSPORTATION F.A.I. 94 (DAN RYAN EXPRESSWAY)
		SURVEY TIES FOR CONTROL POINTS SHEET 7 OF 7

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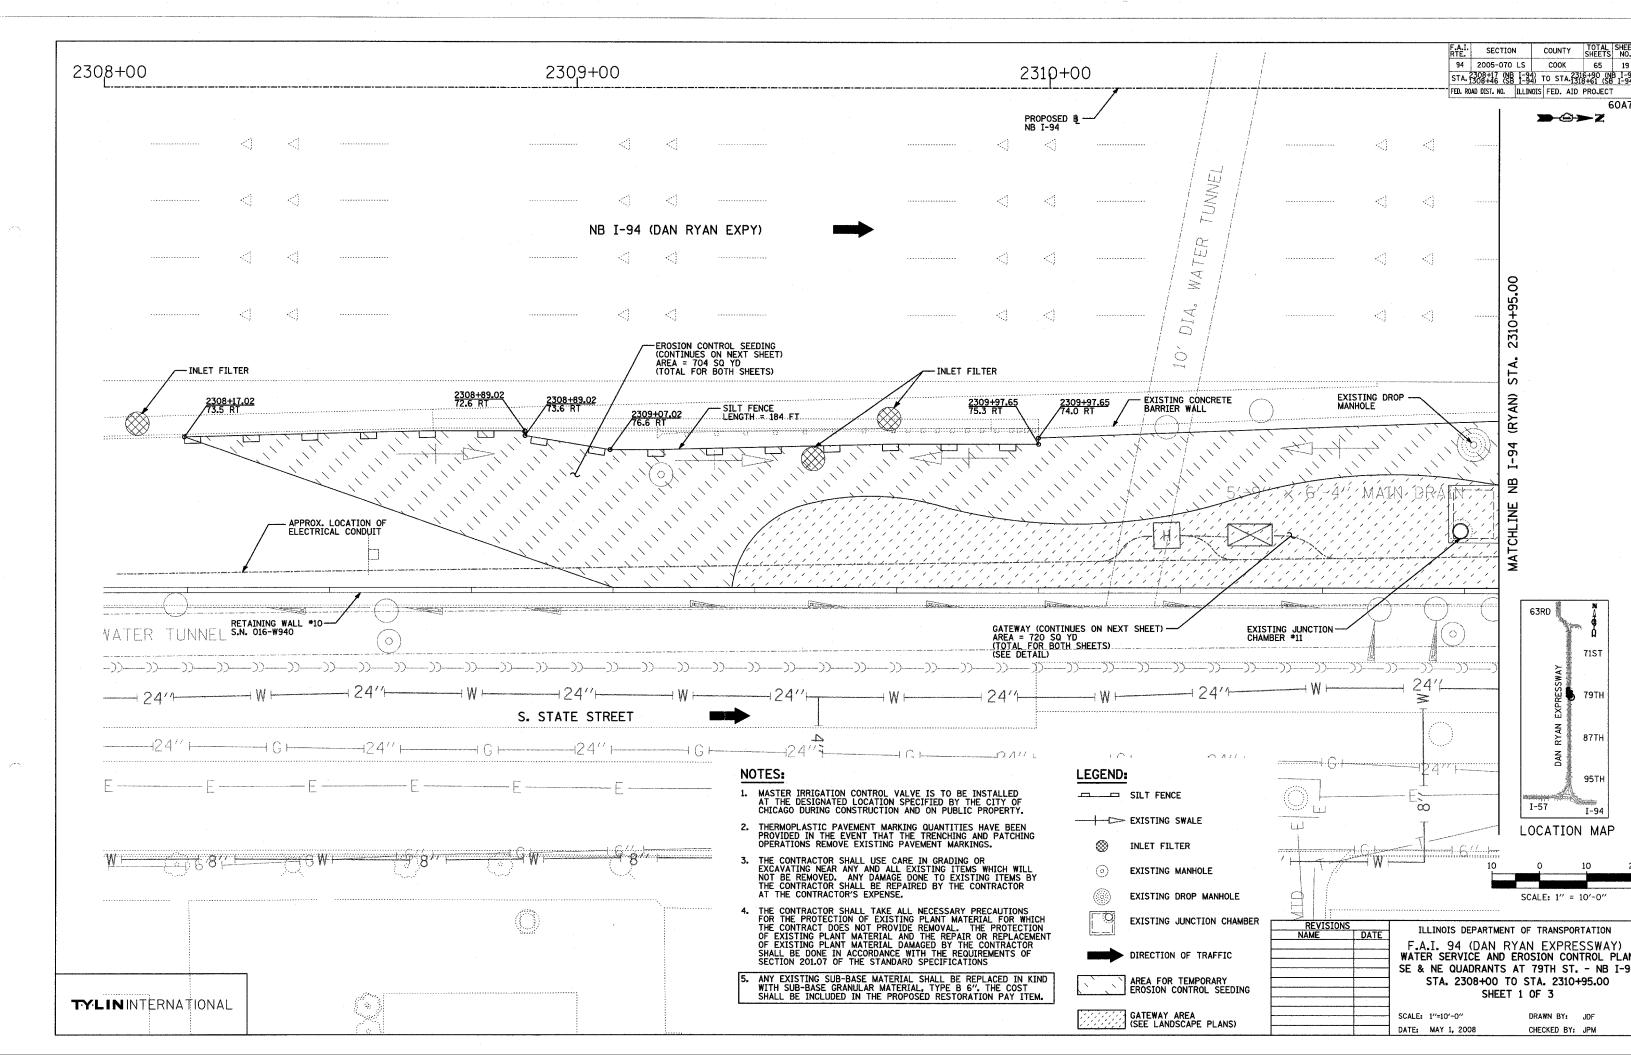
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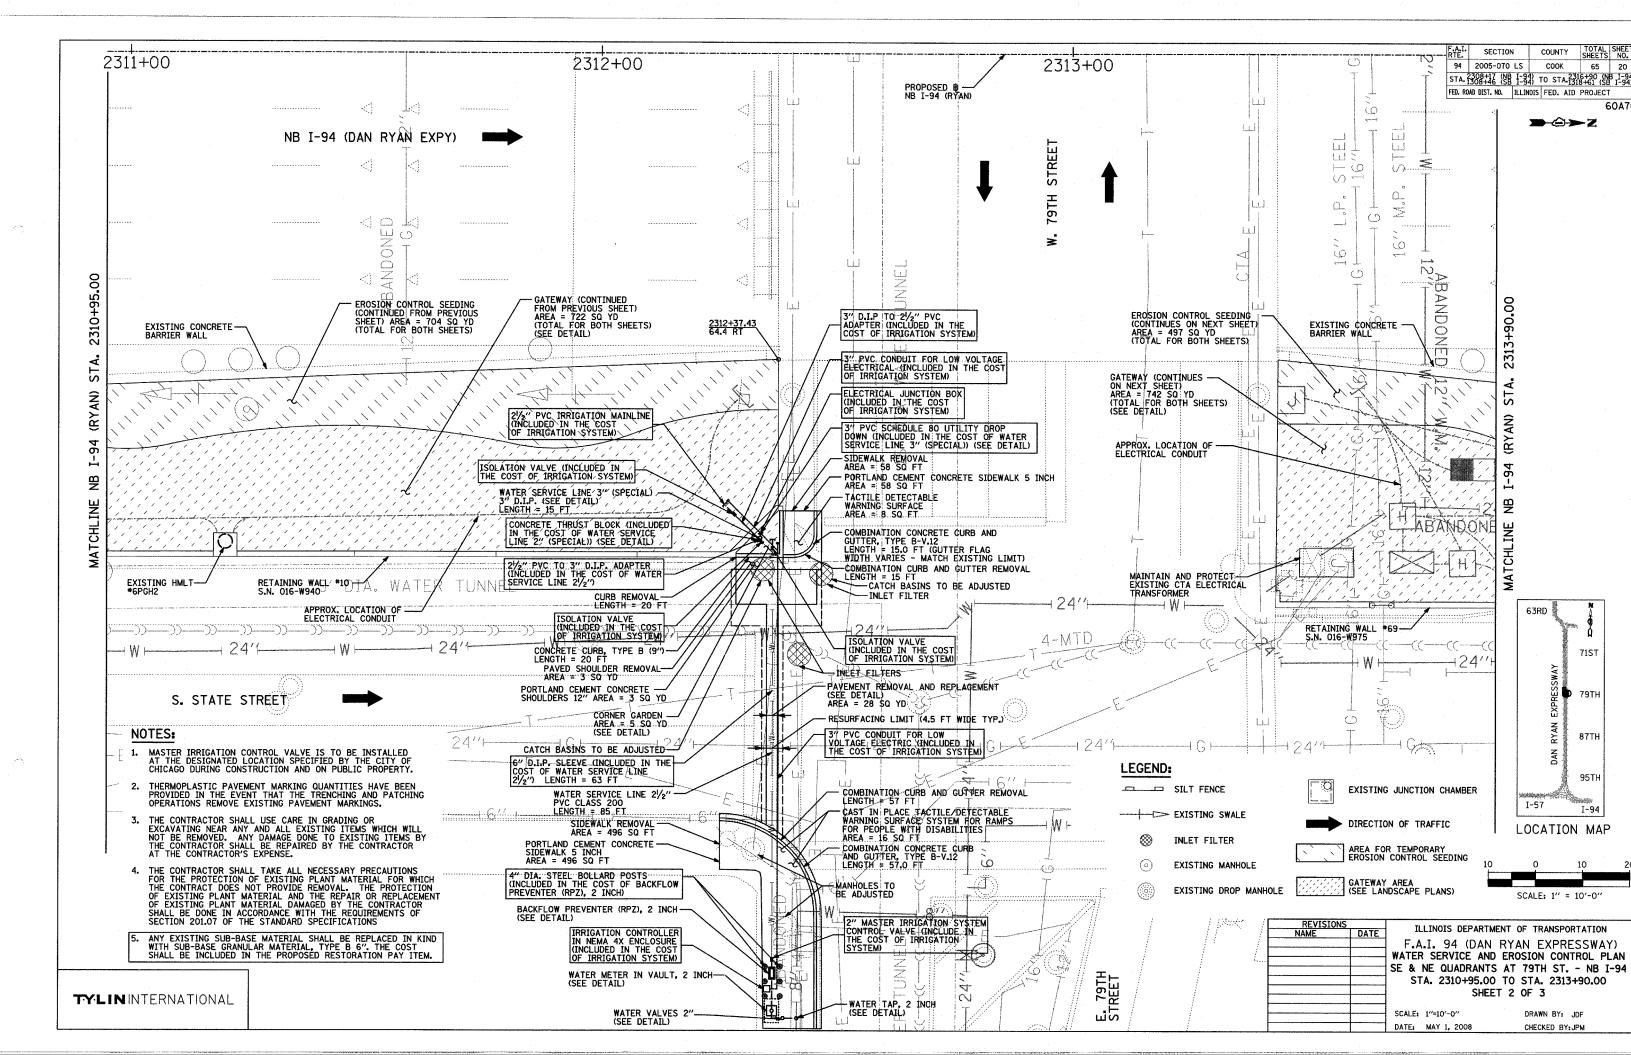
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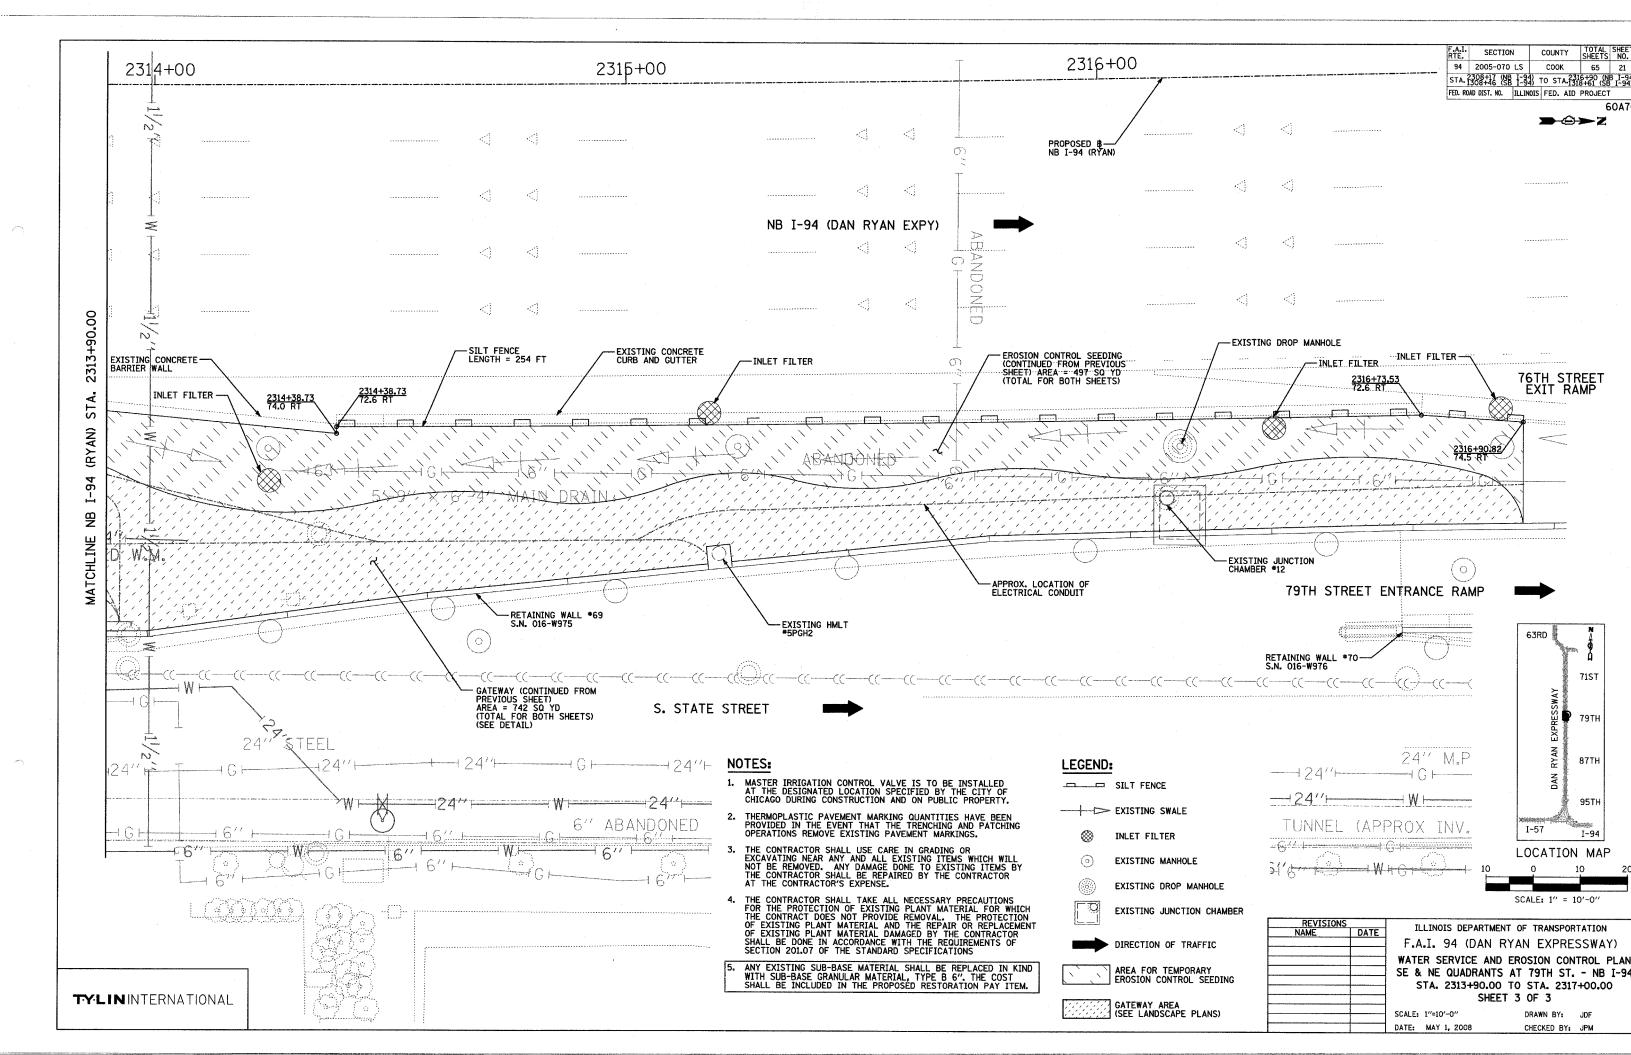
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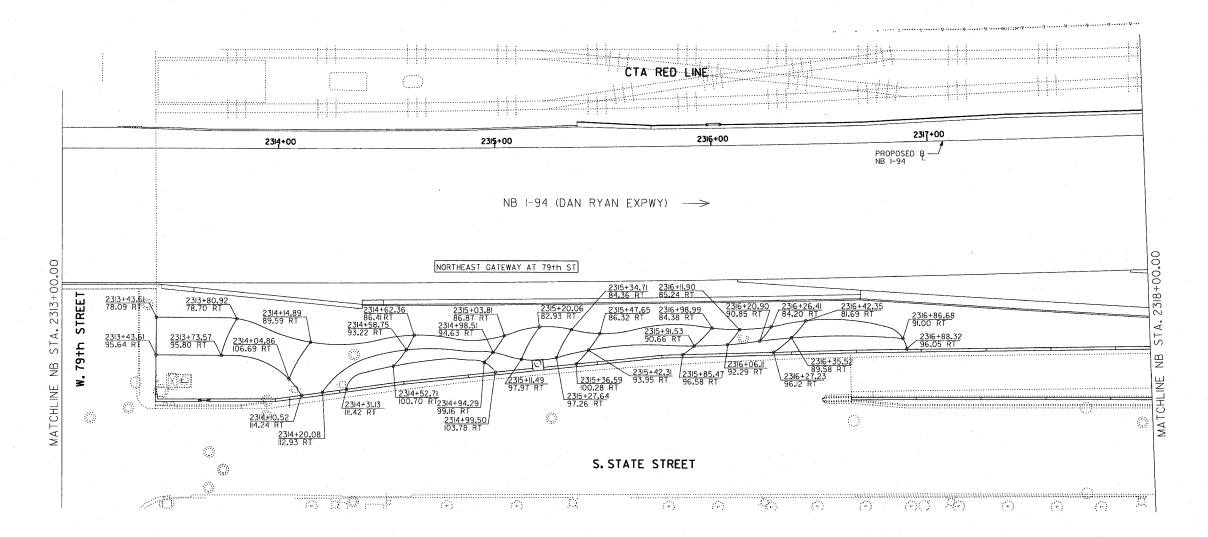
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STA. 2307+00 TO STA. 2313+00 FED. ROAD DIST. NO. | ILLINOIS | FED. AID PROJECT **→**©→Z 2309+00 2310+00 231(+00 2312+00 > 2 PROPOSED B---/ NB 1-94 NB 1-94 (DAN RYAN EXPY) -> 63RD 71ST 2310+61.85 2310+85.16 82.18 RT 82.34 RT 23|2+2|.39 76.59 R 75.48 RT 23II+9I.55 / 83.65 RT 2310+67.89 2310+87.51 94.97 RT 96.07 RT 2309+60.54 2309+88.31 2310+10.20 2310+57.21 97.07 RT 87.80 RT 2310+18.38 91.41 RT 91.41 RT 2309+40.51 2309+52.50 105.74 RT 99.60 RT NB W. 79†h 95TH MATCHL 2309+80.35 2309+89.95 100.42 RT 105.74 RT 23II+65.04 I05.74 RT 2310+42.10 / S. STATE STREET 2310+00.89 LOCATION MAP SOUTHEAST GATEWAY AT 79th ST $\langle \langle \hat{a}_{\lambda \gamma}^{(2)} \rangle$ SCALE: I" = 20'-0" ILLINOIS DEPARTMENT OF TRANSPORTATION F.A.I. 94 (DAN RYAN EXPRESSWAY) SITE DESIGN GROUP NOTE: THE LOCATION OF ALL PLANT MATERIAL SHALL BE STAKED BY THE CONTRACTOR FOR APPROVAL BY THE ENGINEER IN FIELD, PRIOR TO INSTALLATION, INDIVIDUAL TREES SHALL BE STAKED WITH IDENTITIES WRITTEN ON STAKES, SHRUB AND PERENNIAL BEDS SHALL BE OUTLINED WITH STAKES AND PAINTED LINES, 79TH STREET GATEWAY LANDSCAPING AND IRRIGATION PLANTING BED LAYOUT PLAN SE QUADRANT AT 79TH ST. - NB 1-94 **TYLIN**INTERNATIONAL DRAWN BY: EM DATE: May 1, 2008 CHECKED BY: JO



7IST
77ST
79TH
87TH
87TH
95TH
1-57
1-94

LOCATION MAP



CHECKED BY: JO

REVISIONS
NAME DATE

F.A.I. 94 (DAN RYAN EXPRESSWAY)


79TH STREET GATEWAY LANDSCAPING AND IRRIGATION
PLANTING BED LAYOUT PLAN
NE QUADRANT AT 79TH ST. - NB I-94


SCALET IF-20' DRAWN BY: EM


SITE DESIGN GROUP


TYLININTERNATIONAL


NOTE: THE LOCATION OF ALL PLANT MATERIAL SHALL BE STAKED BY THE CONTRACTOR FOR APPROVAL BY THE ENGINEER IN FIELD, PRIOR TO INSTALLATION, INDIVIDUAL TREES SHALL BE STAKED WITH IDENTITIES WRITTEN ON STAKES, SHRUB AND PERENNIAL BEDS SHALL BE OUTLINED WITH STAKES AND PAINTED LINES.

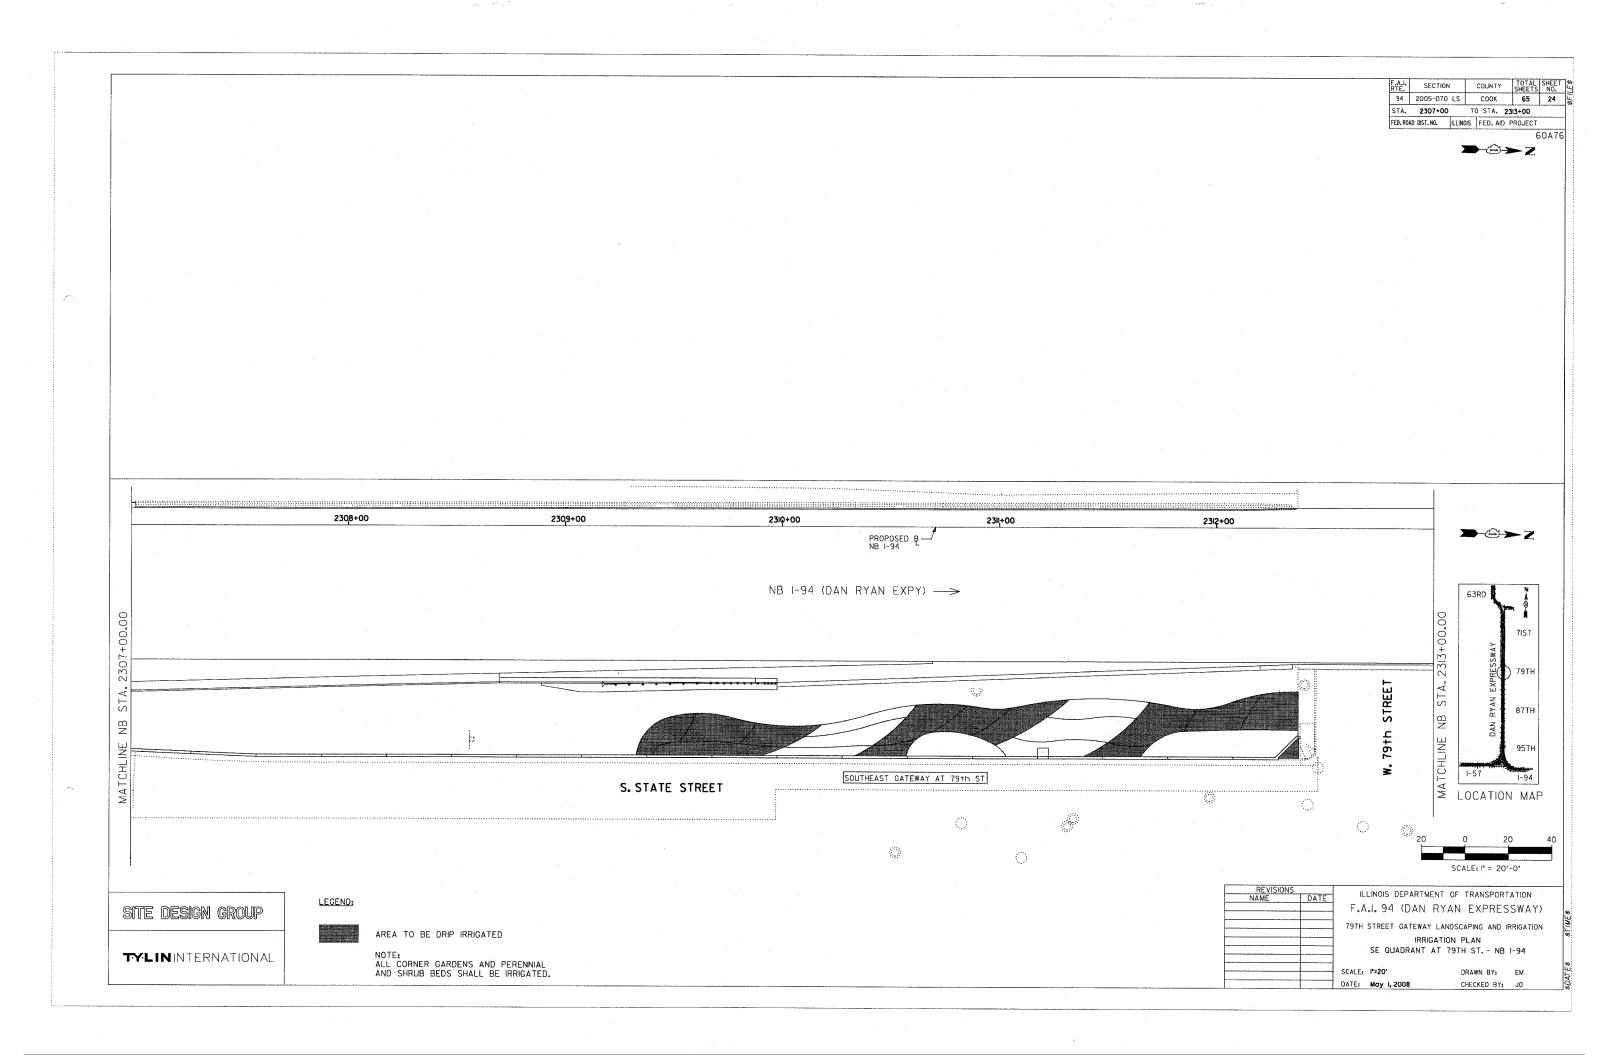

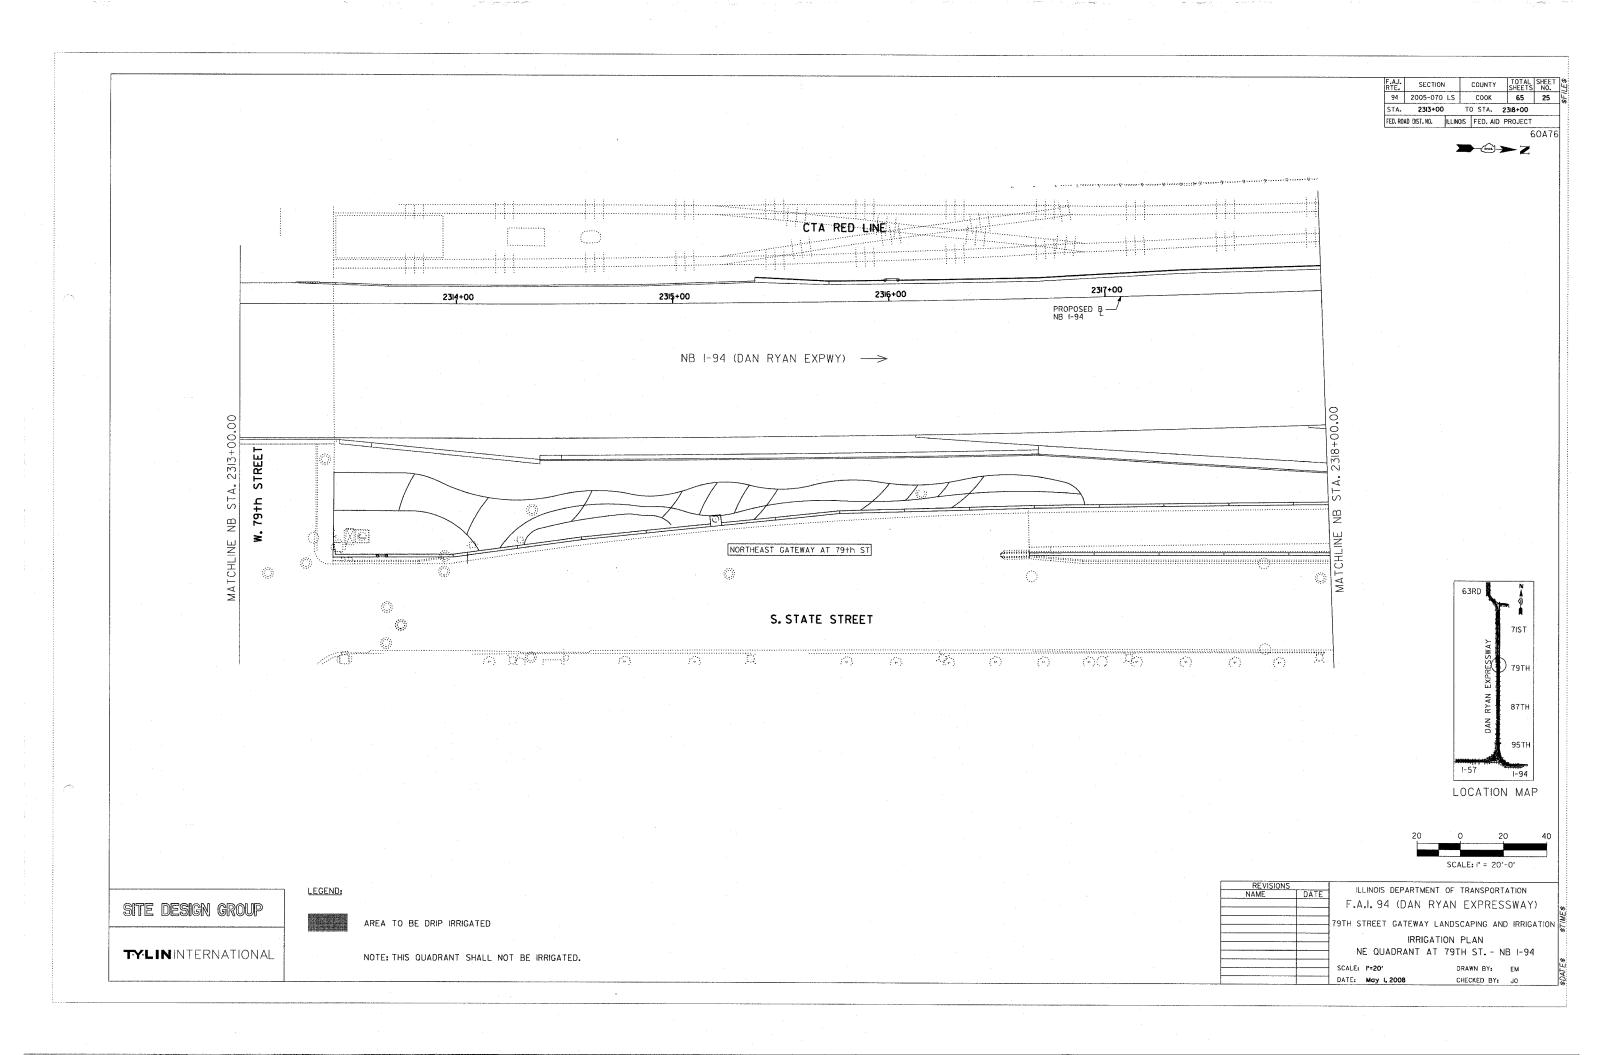


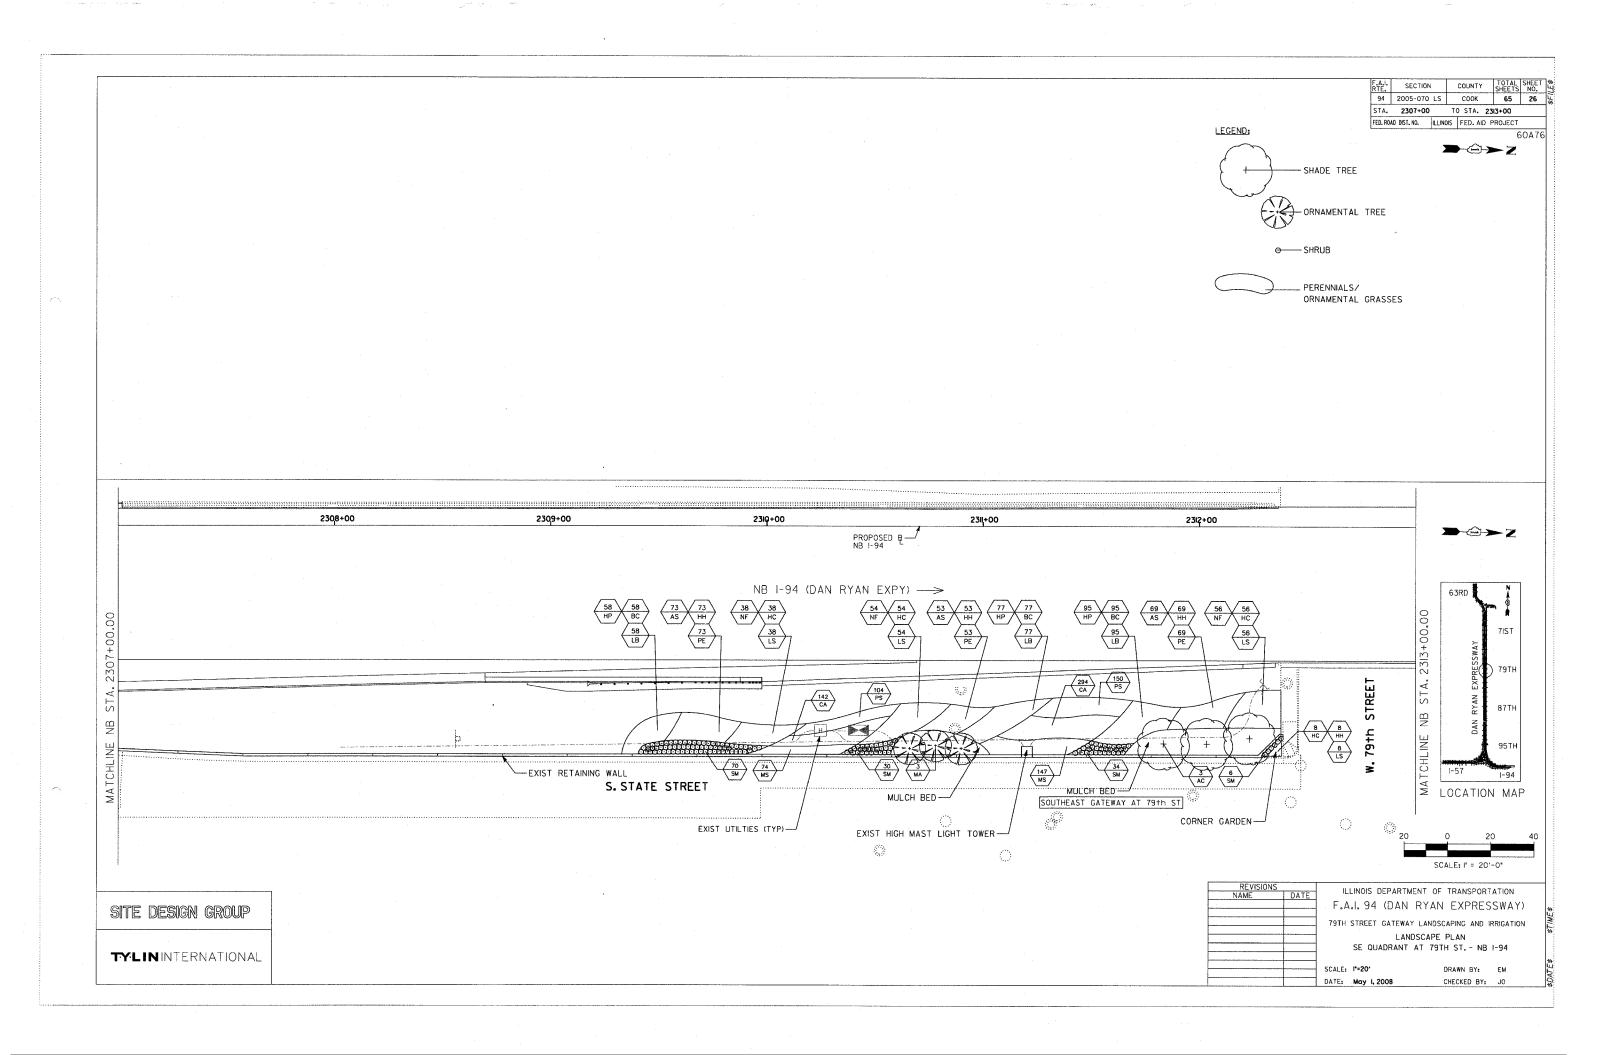


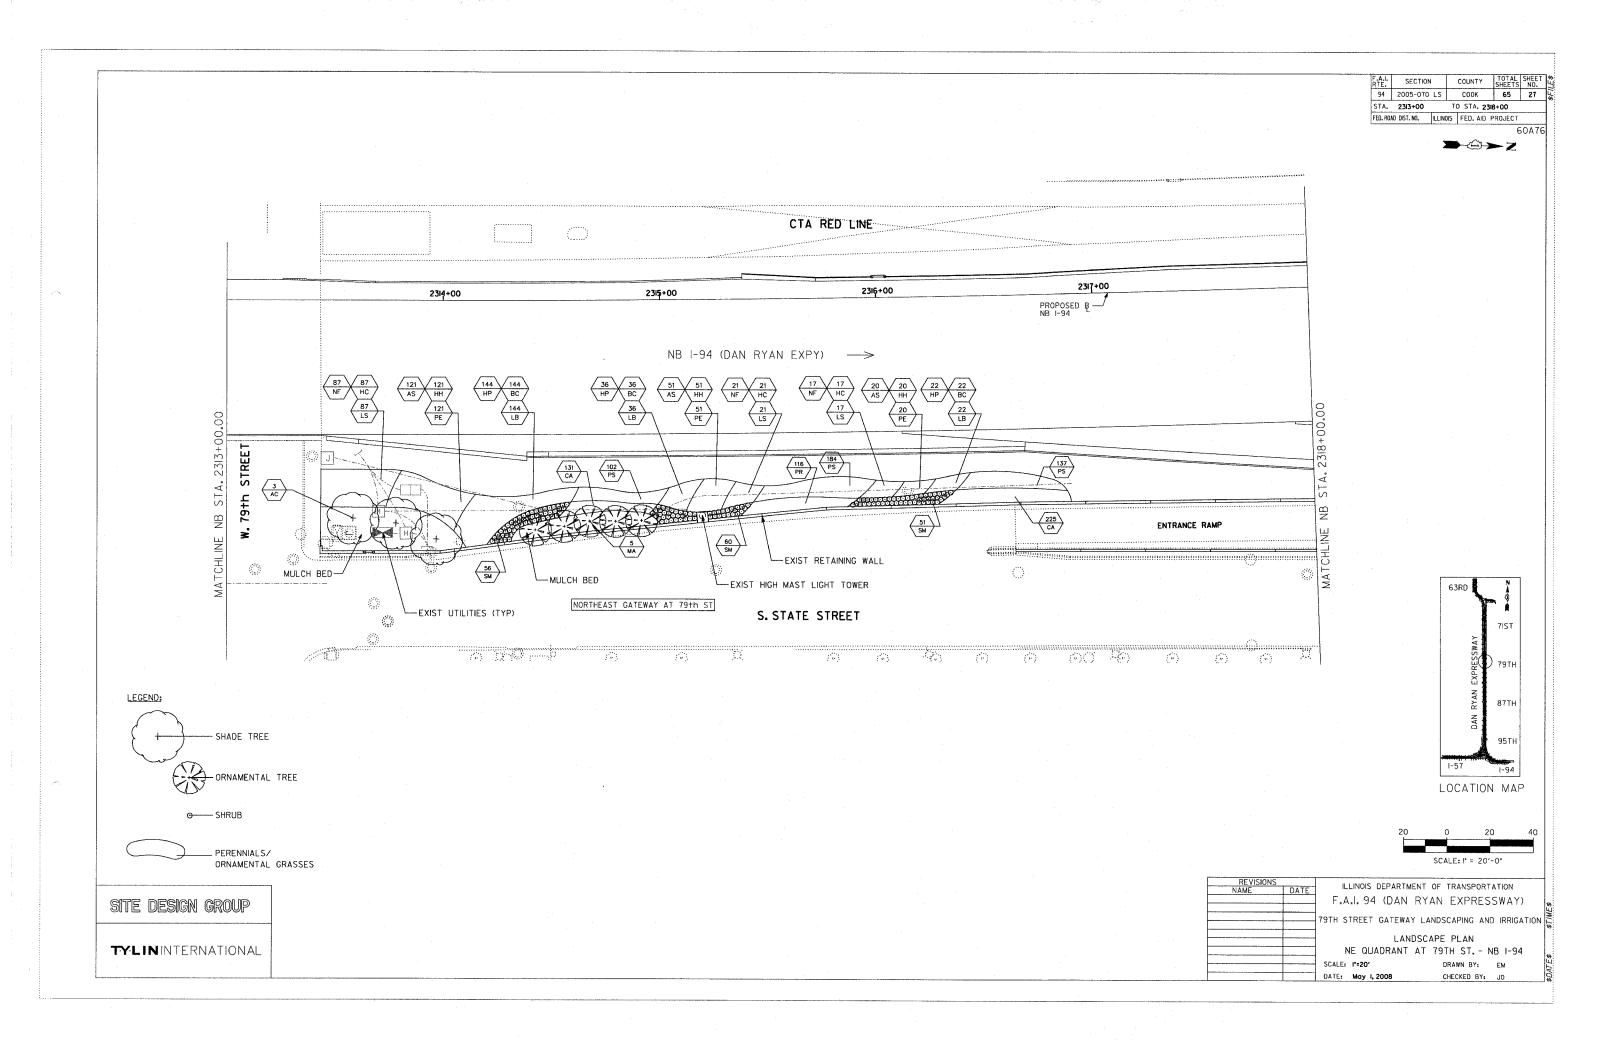


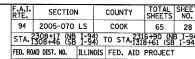


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DRAIN SLEEVE ELEVATION

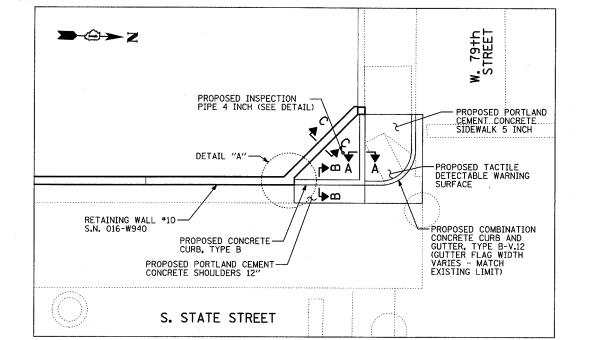SCALE: NOT TO SCALE

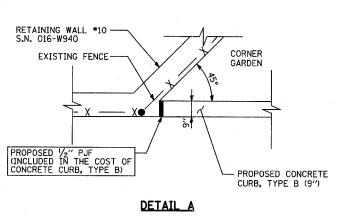DATE: MAY 1, 2008

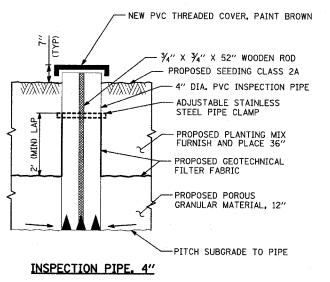
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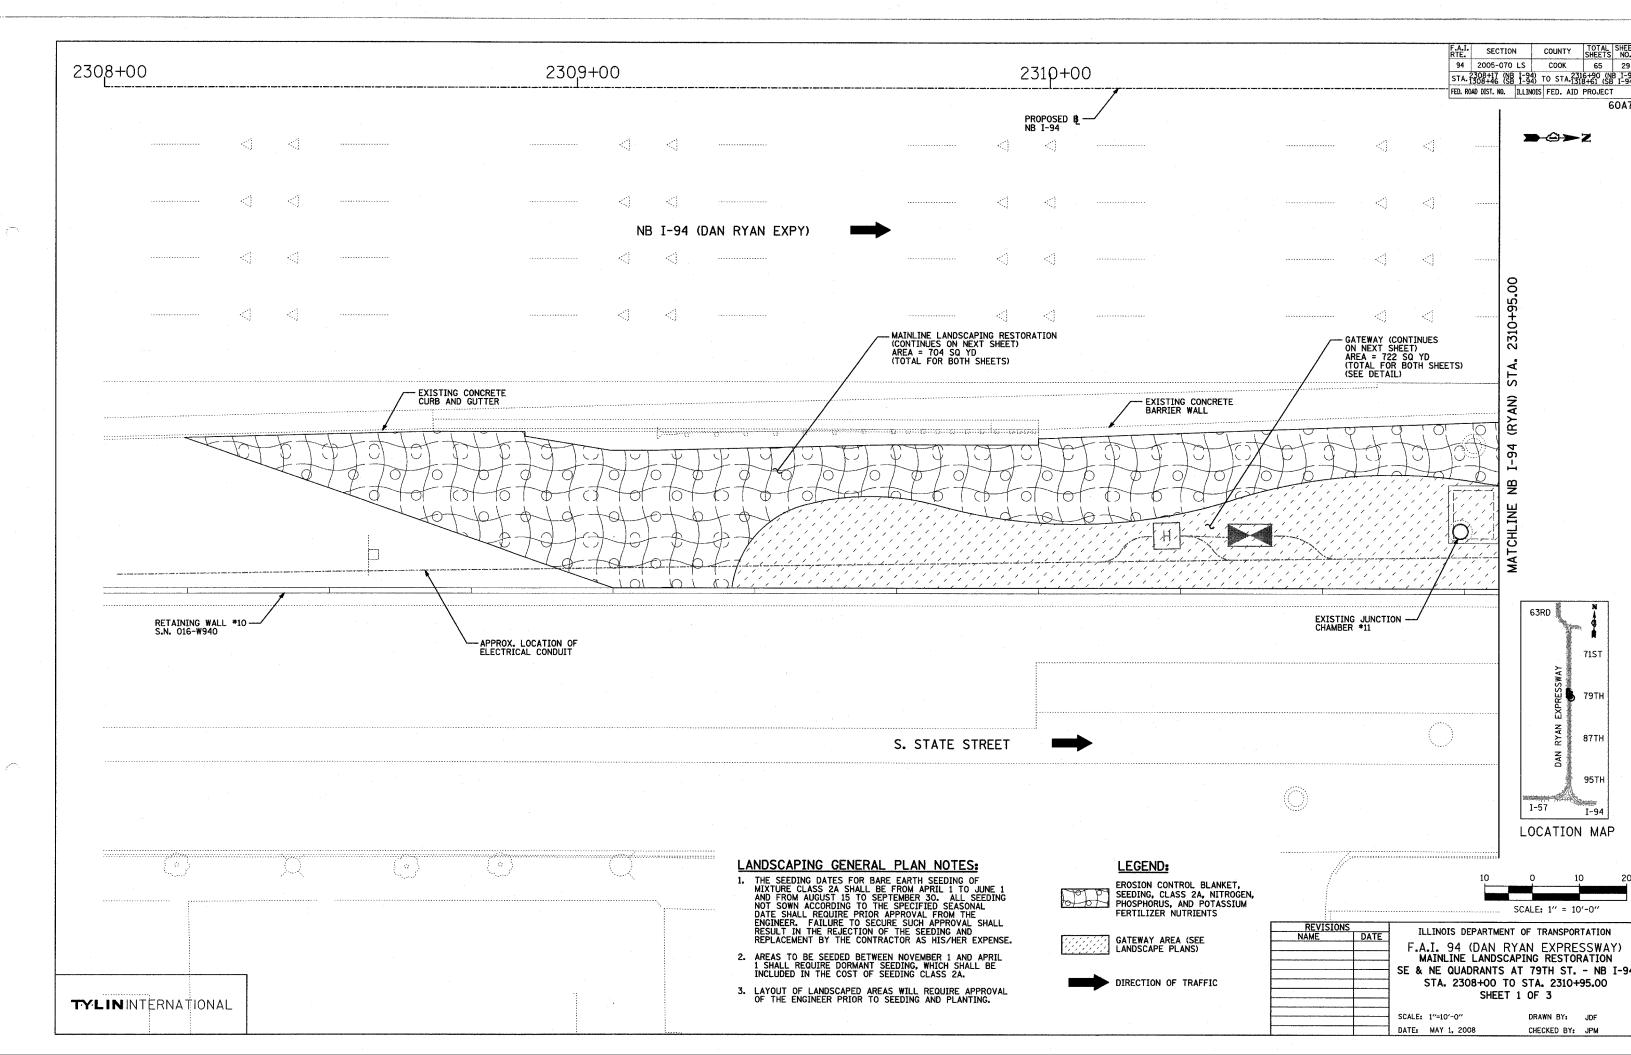
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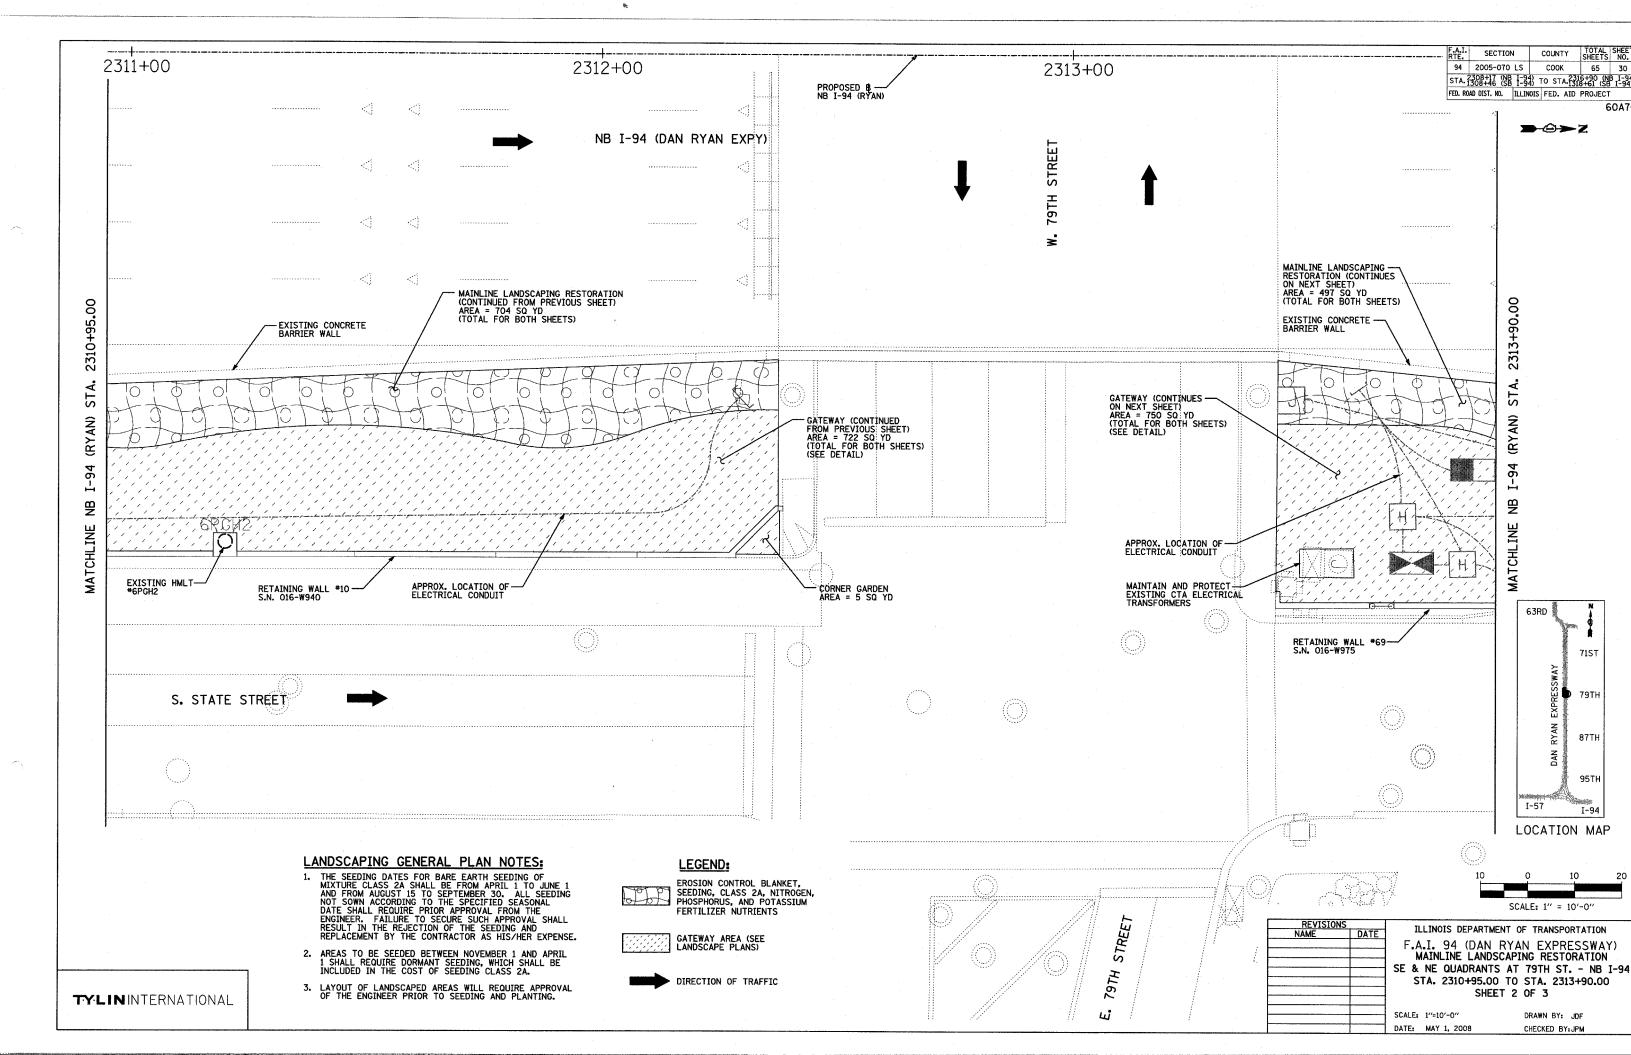
RTM

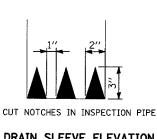
SE CORNER GARDEN AT 79TH STREET


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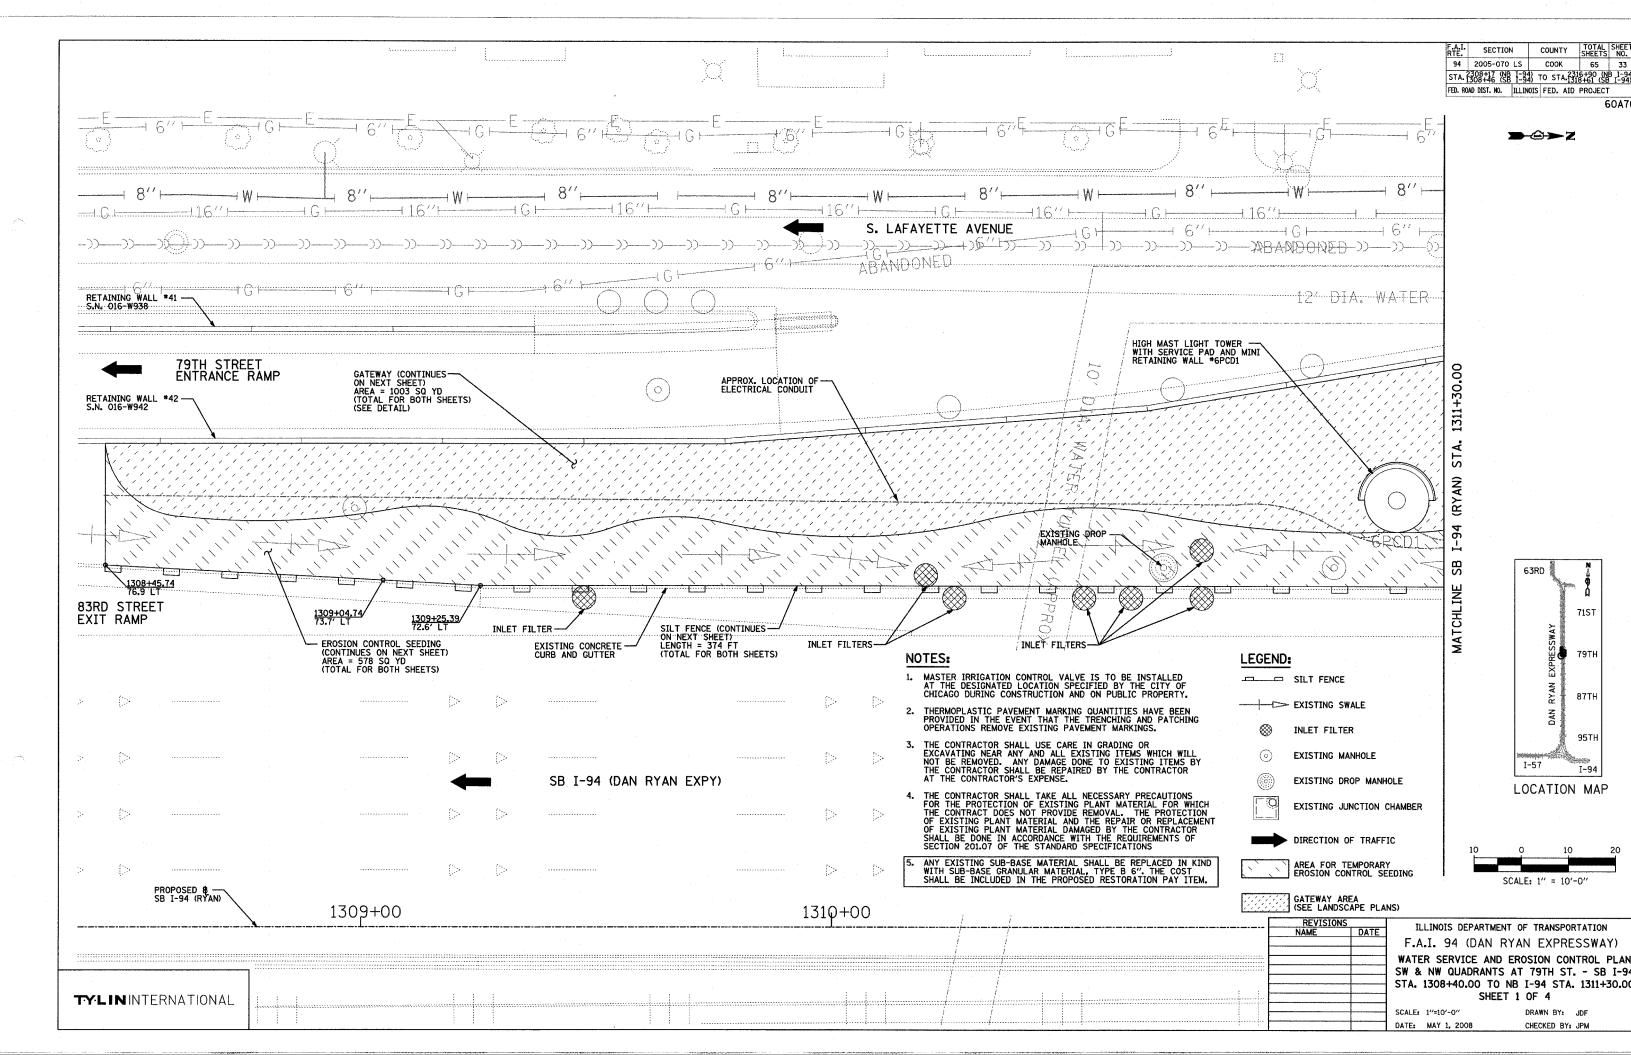








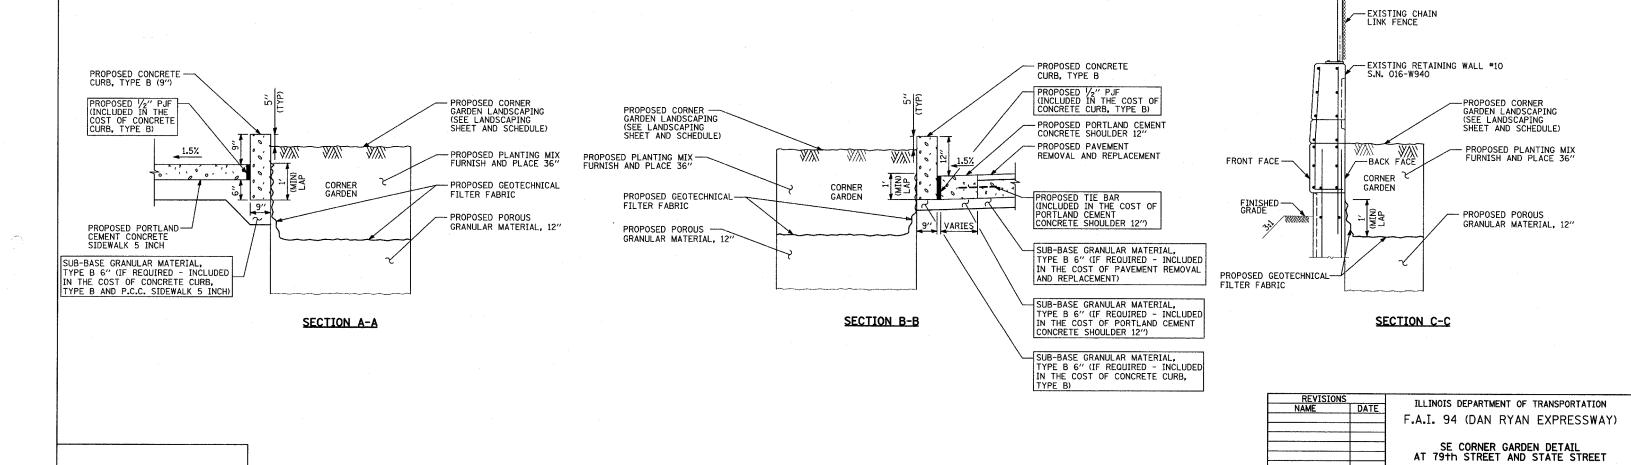


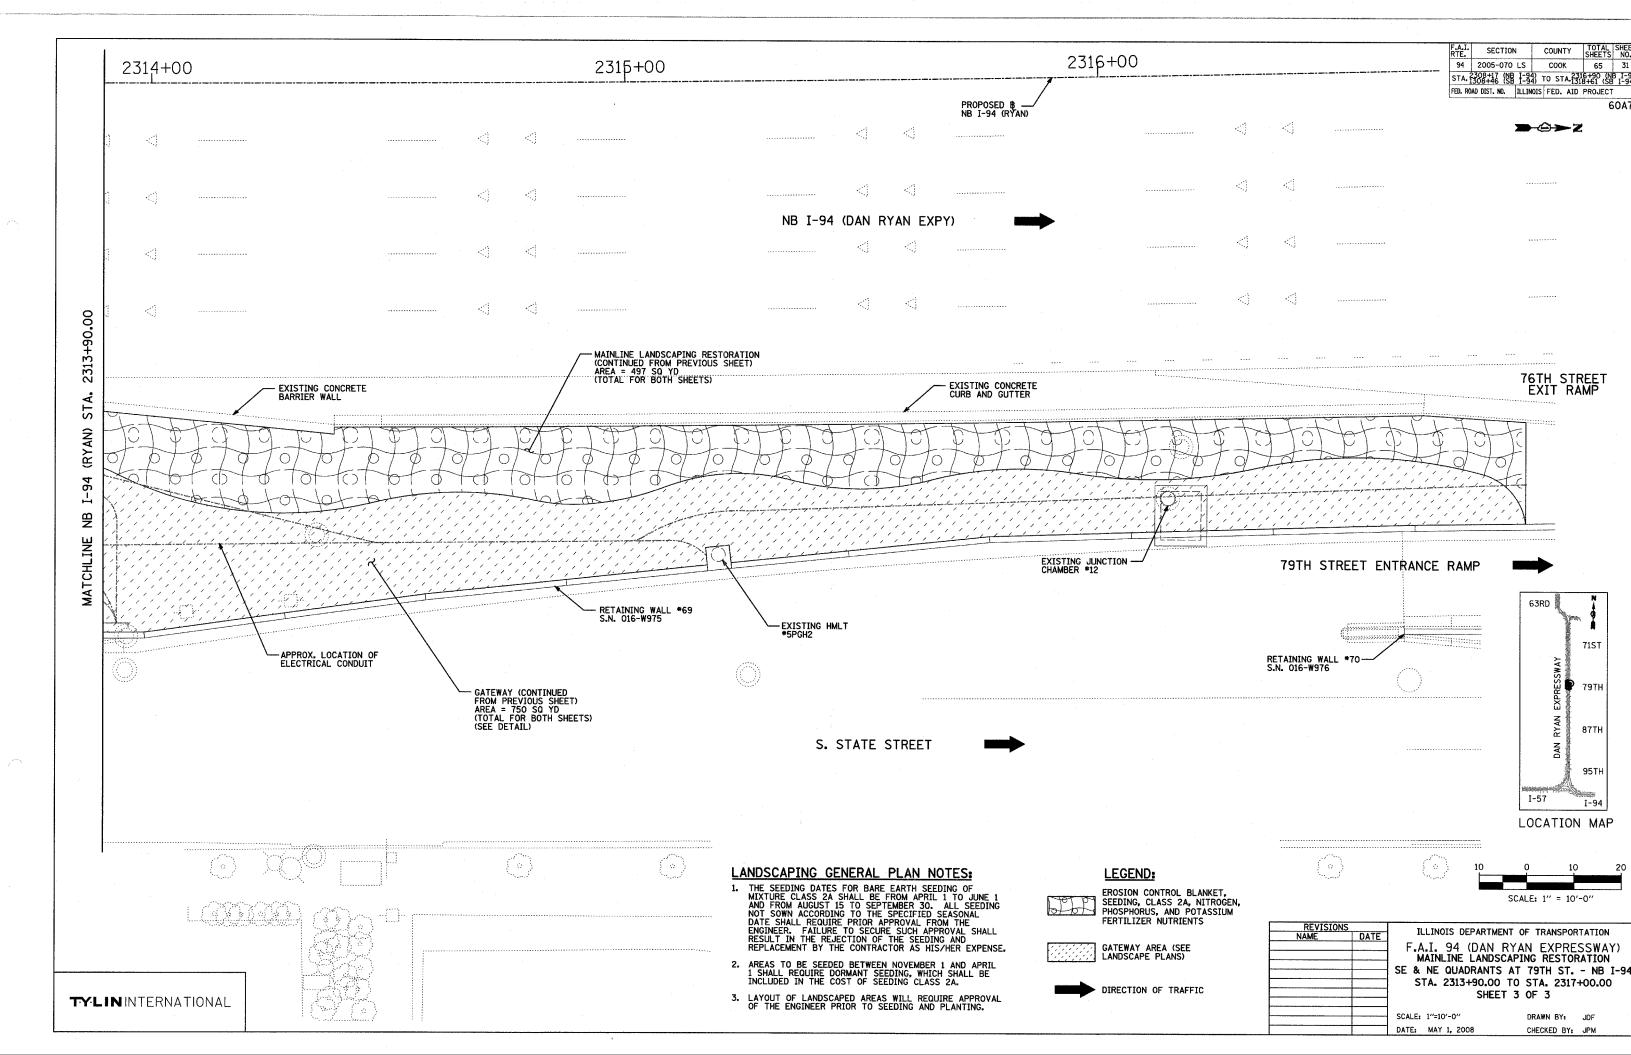


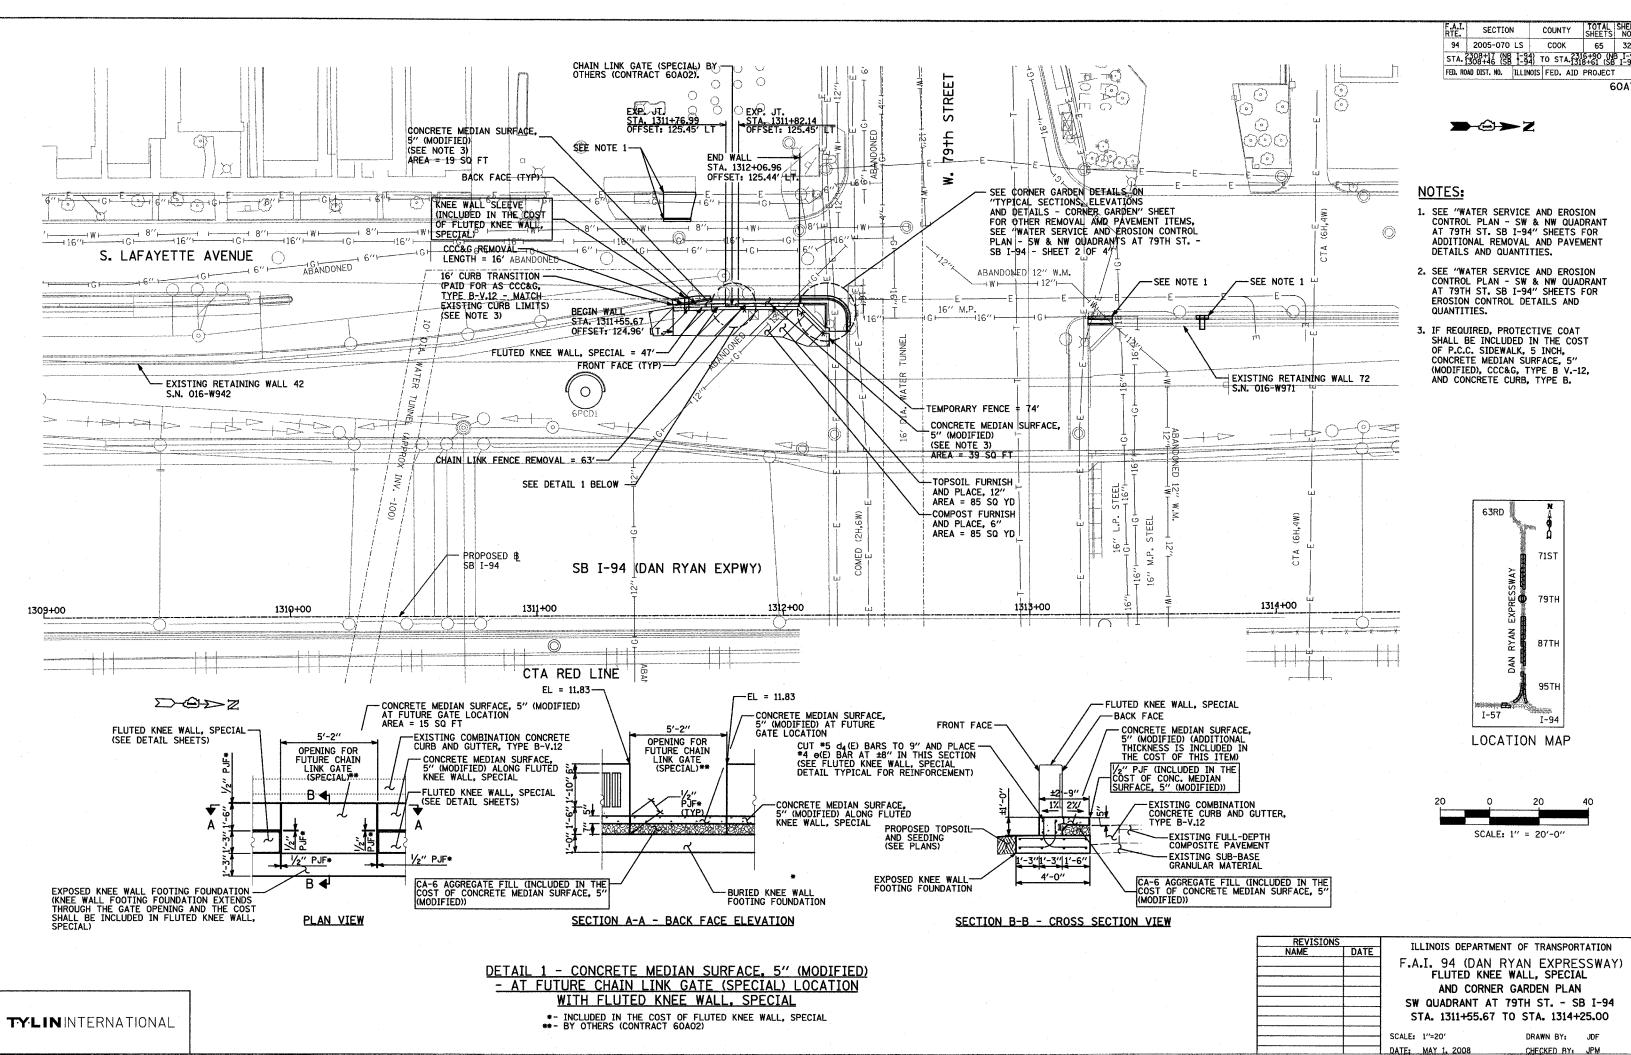


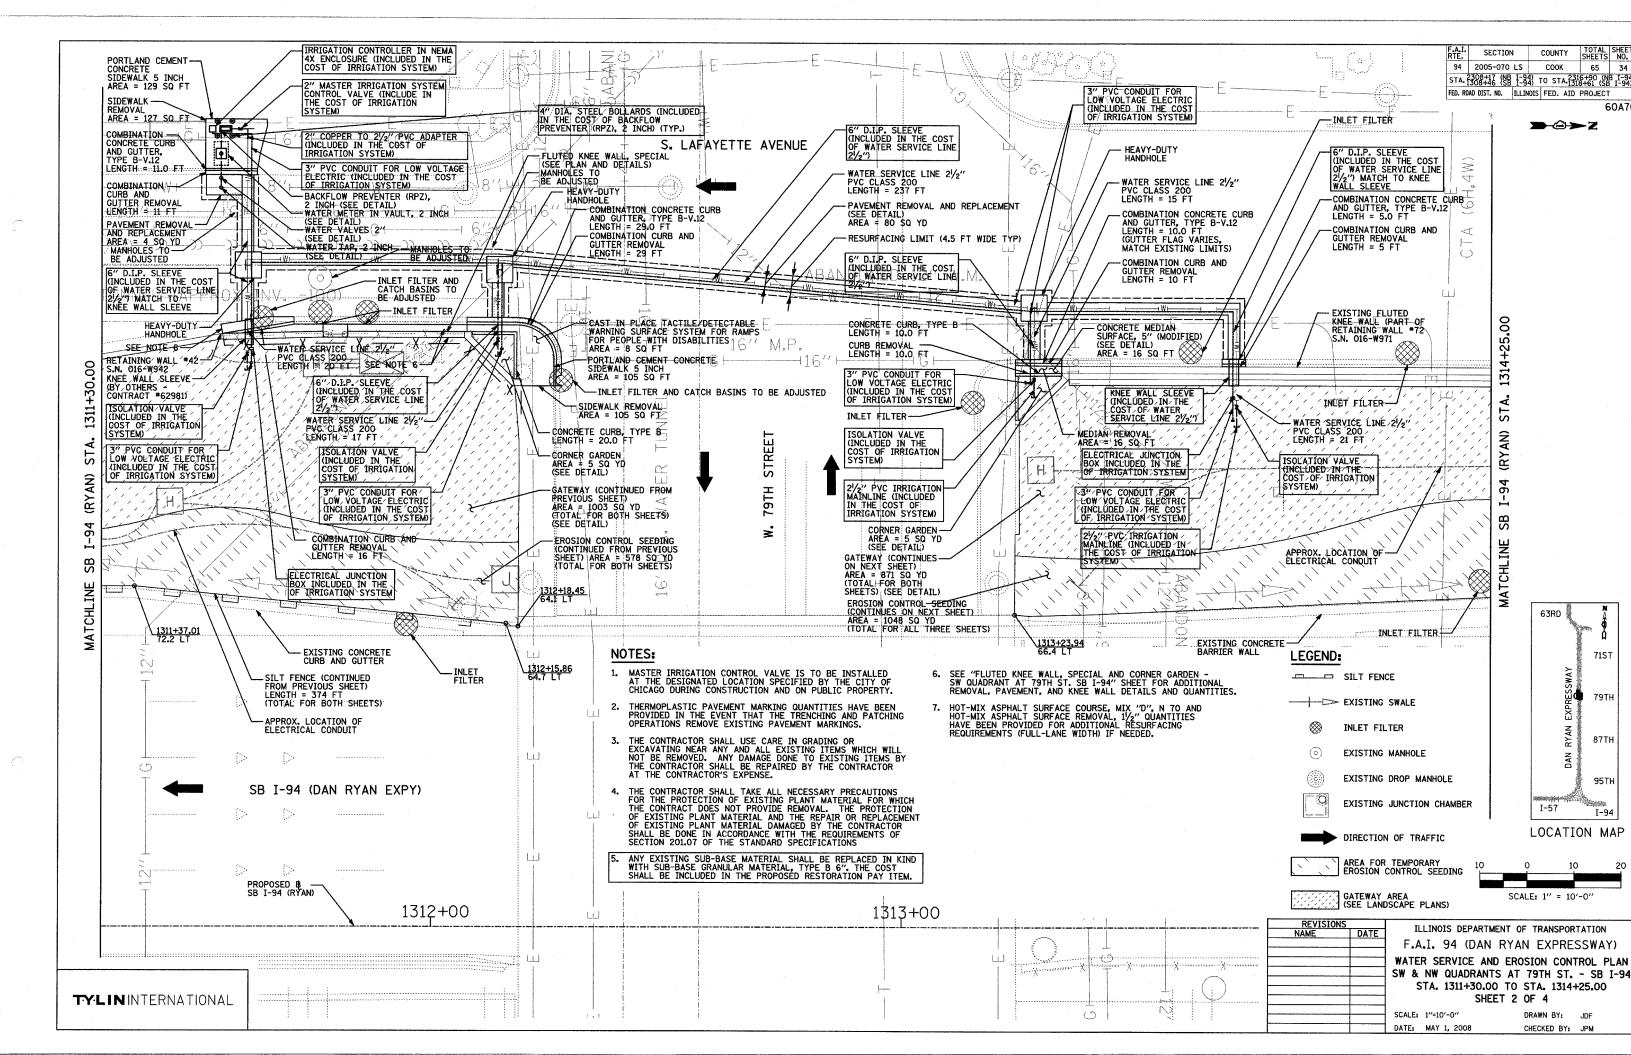


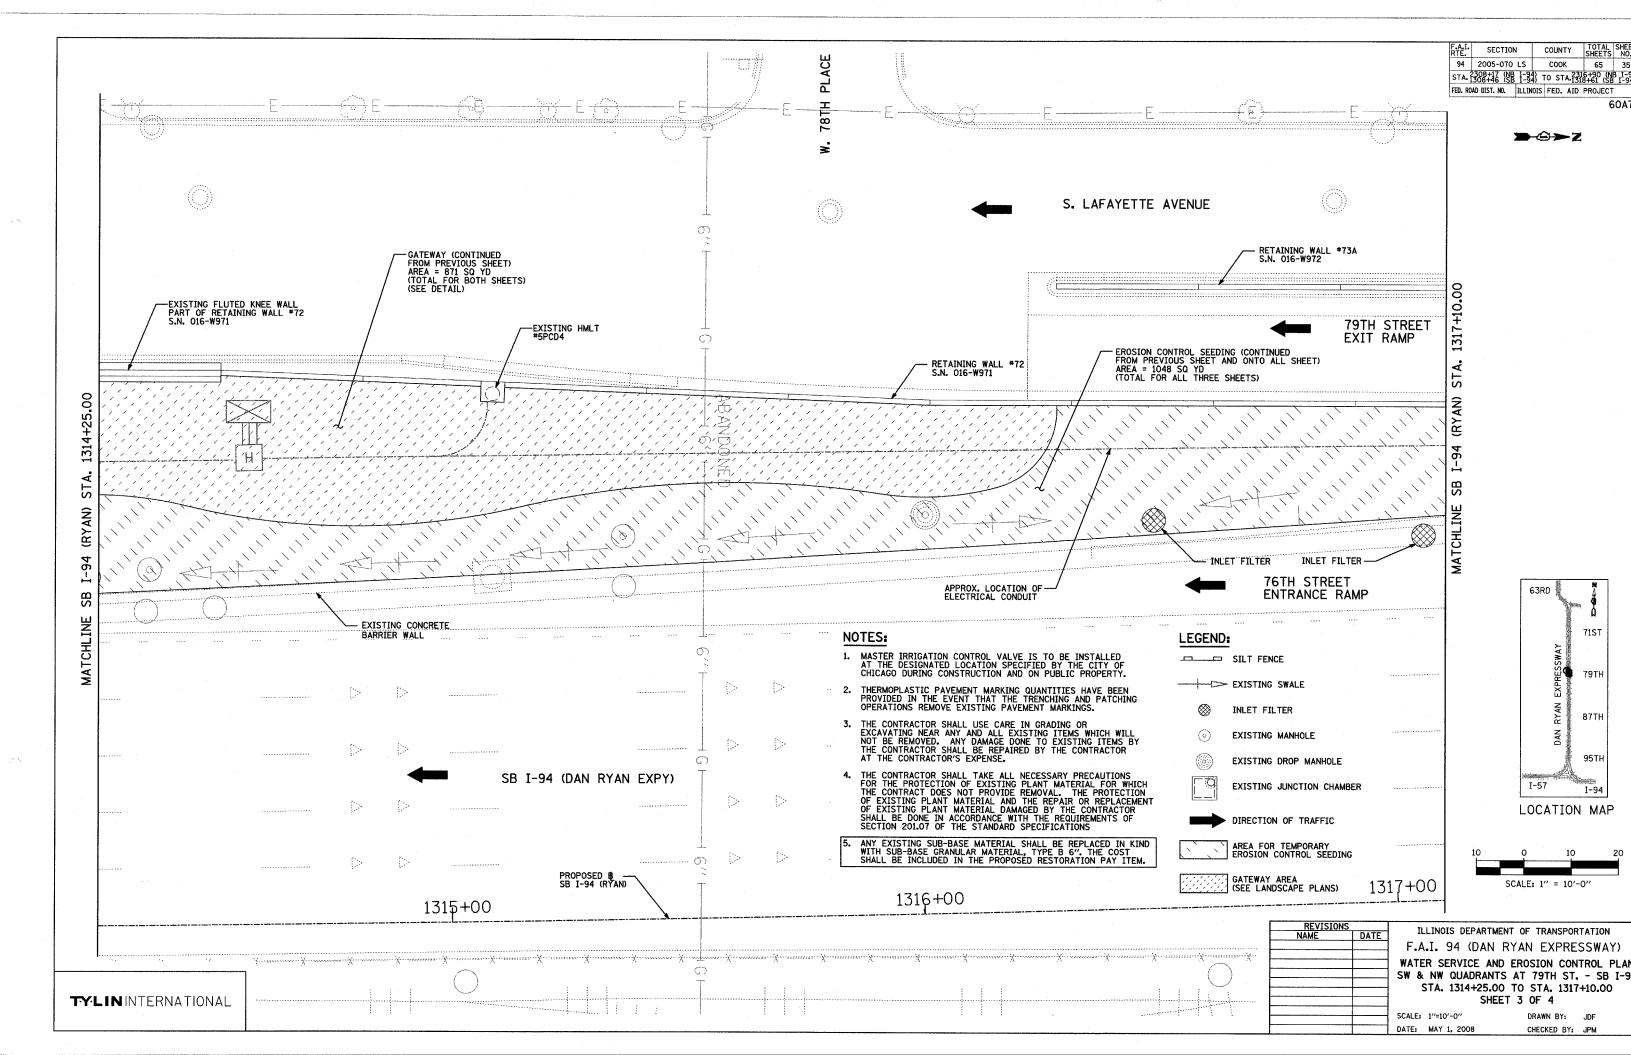


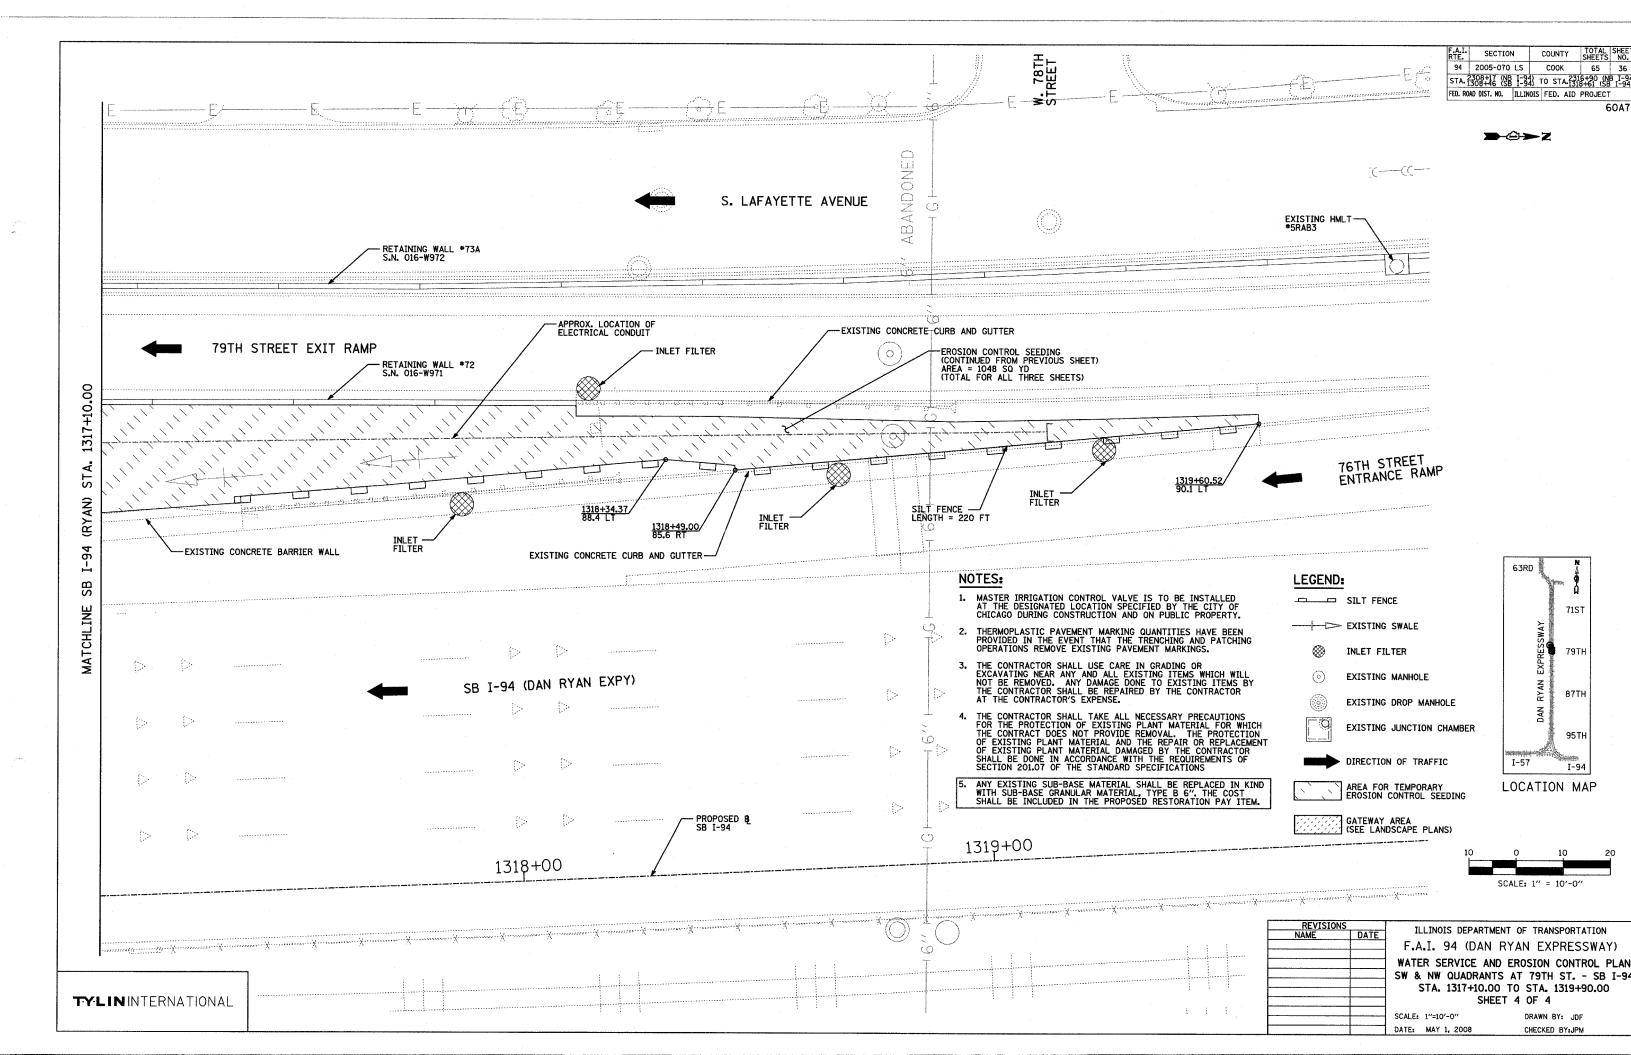


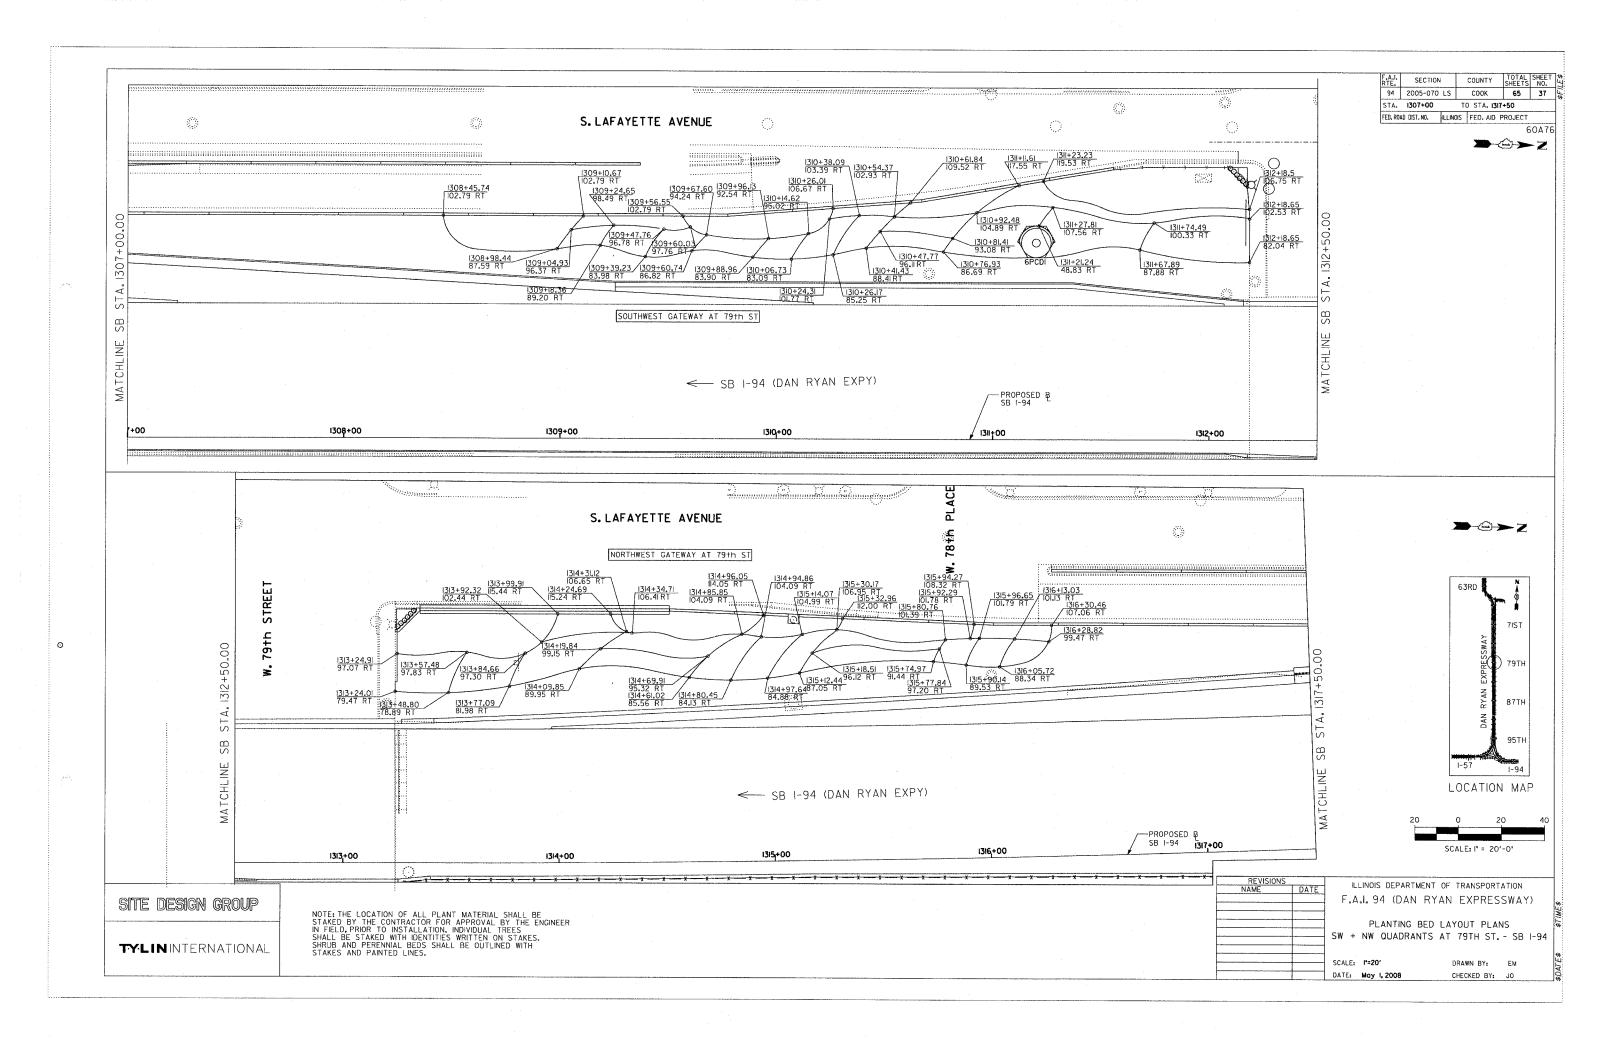


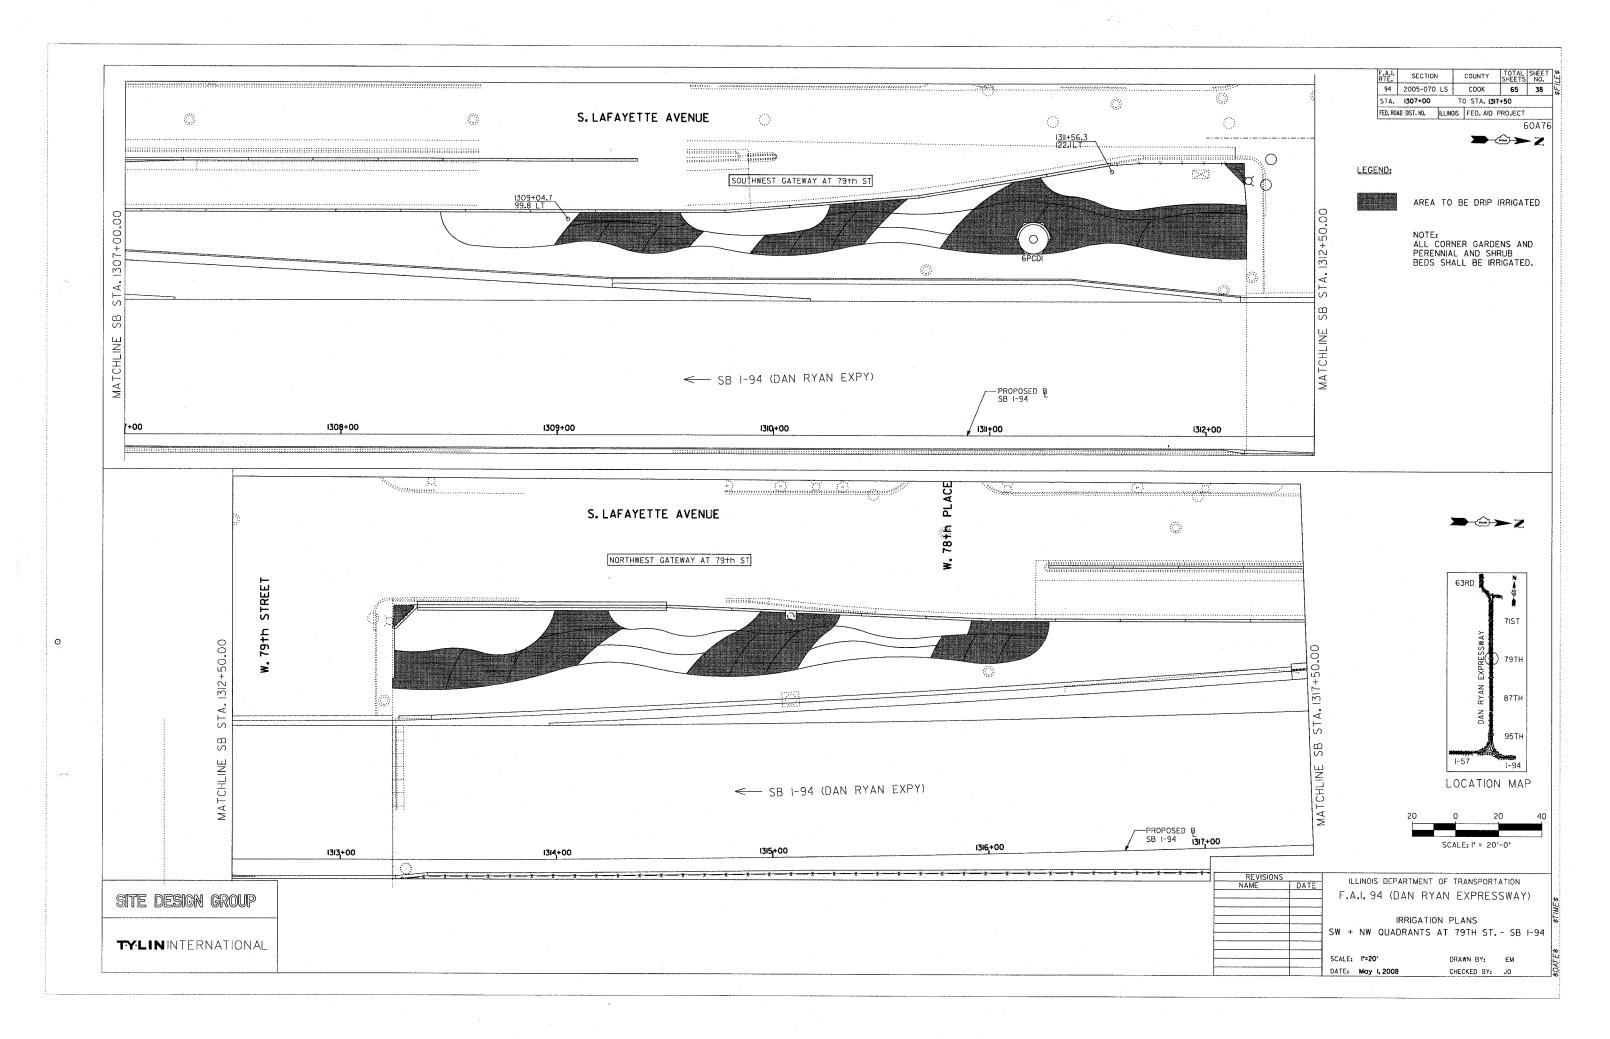


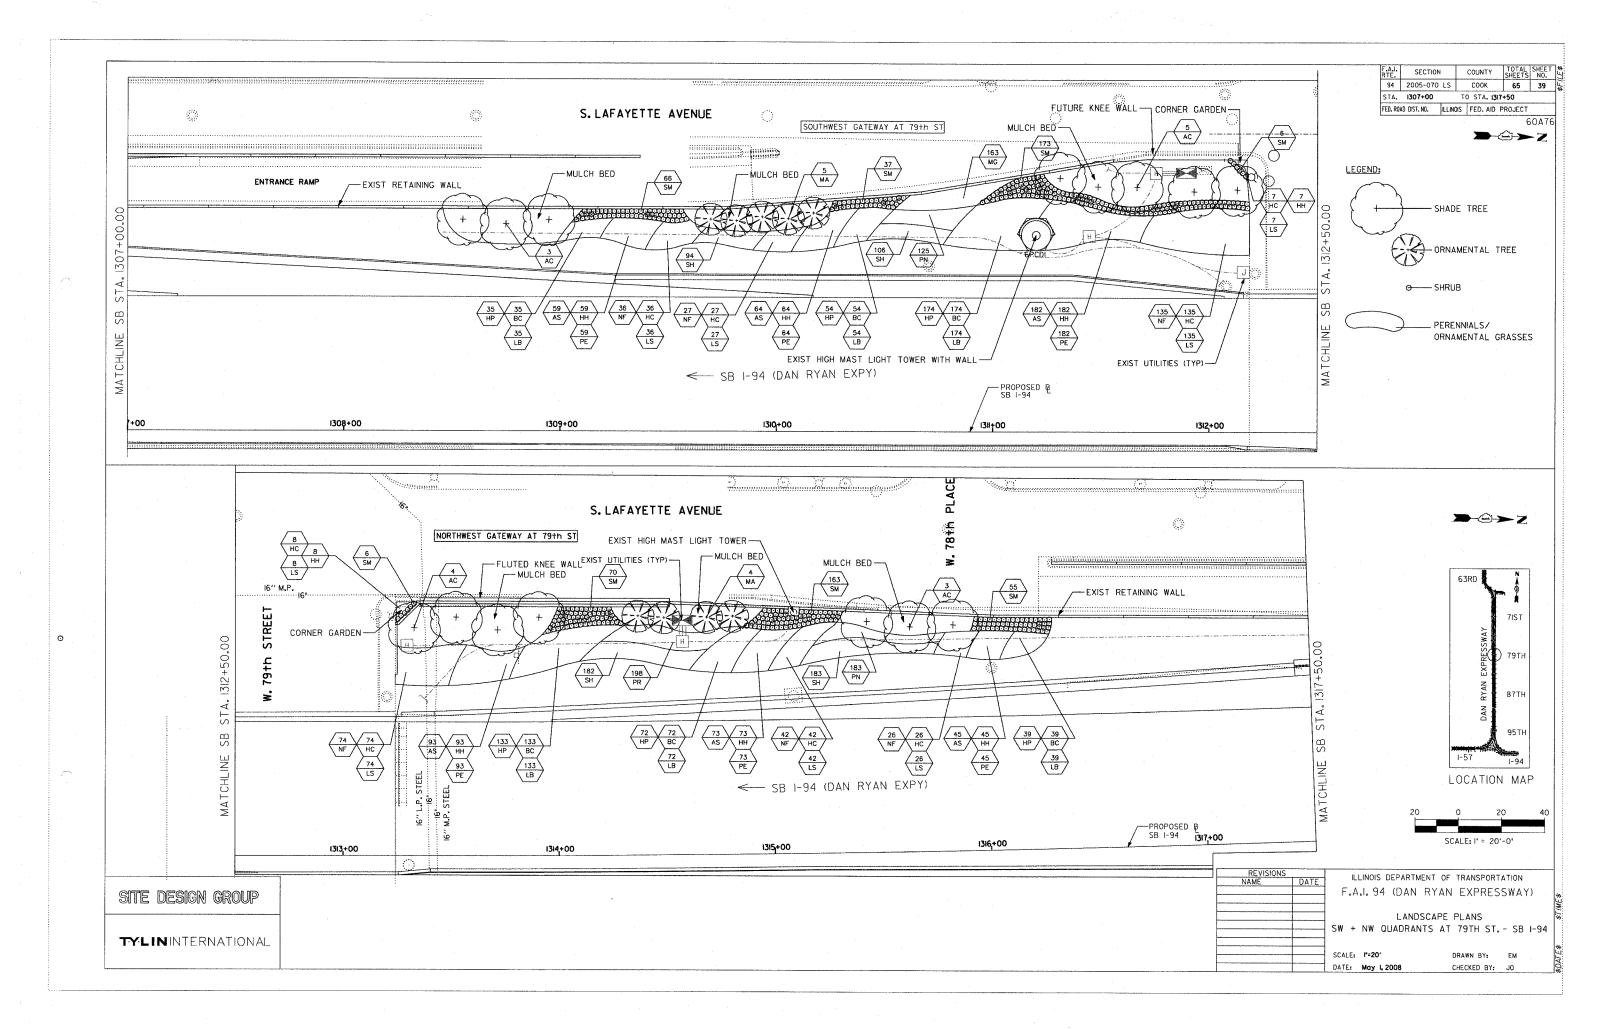


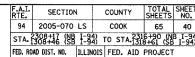

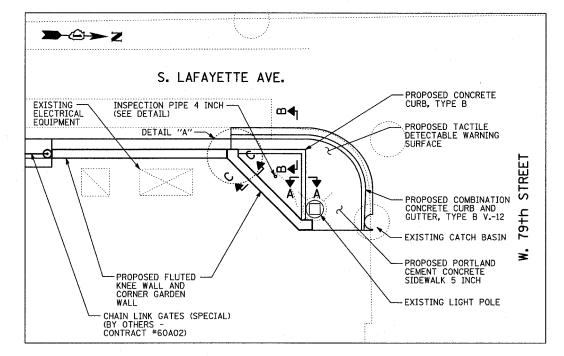

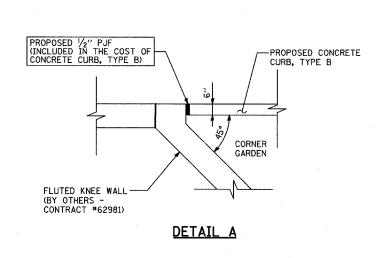


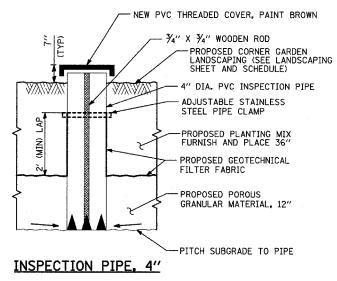


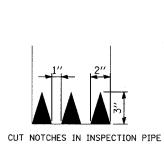



DRAIN SLEEVE ELEVATION


SW CORNER GARDEN AT 79TH STREET

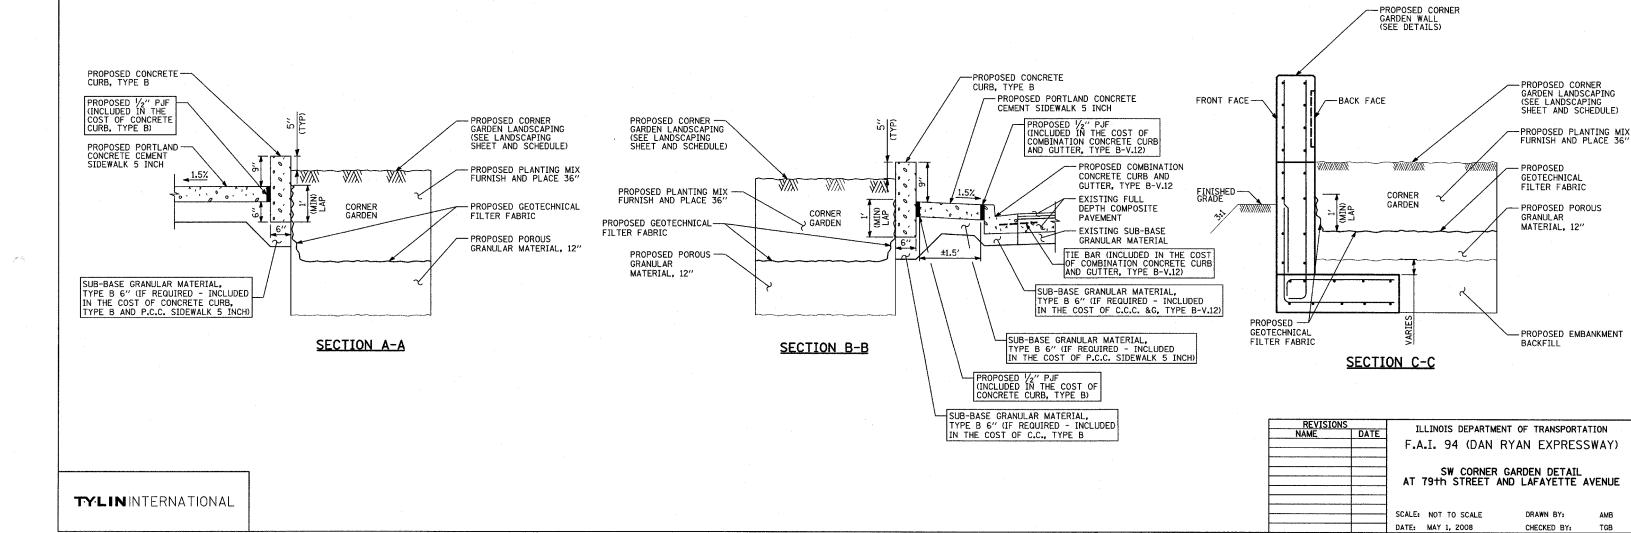


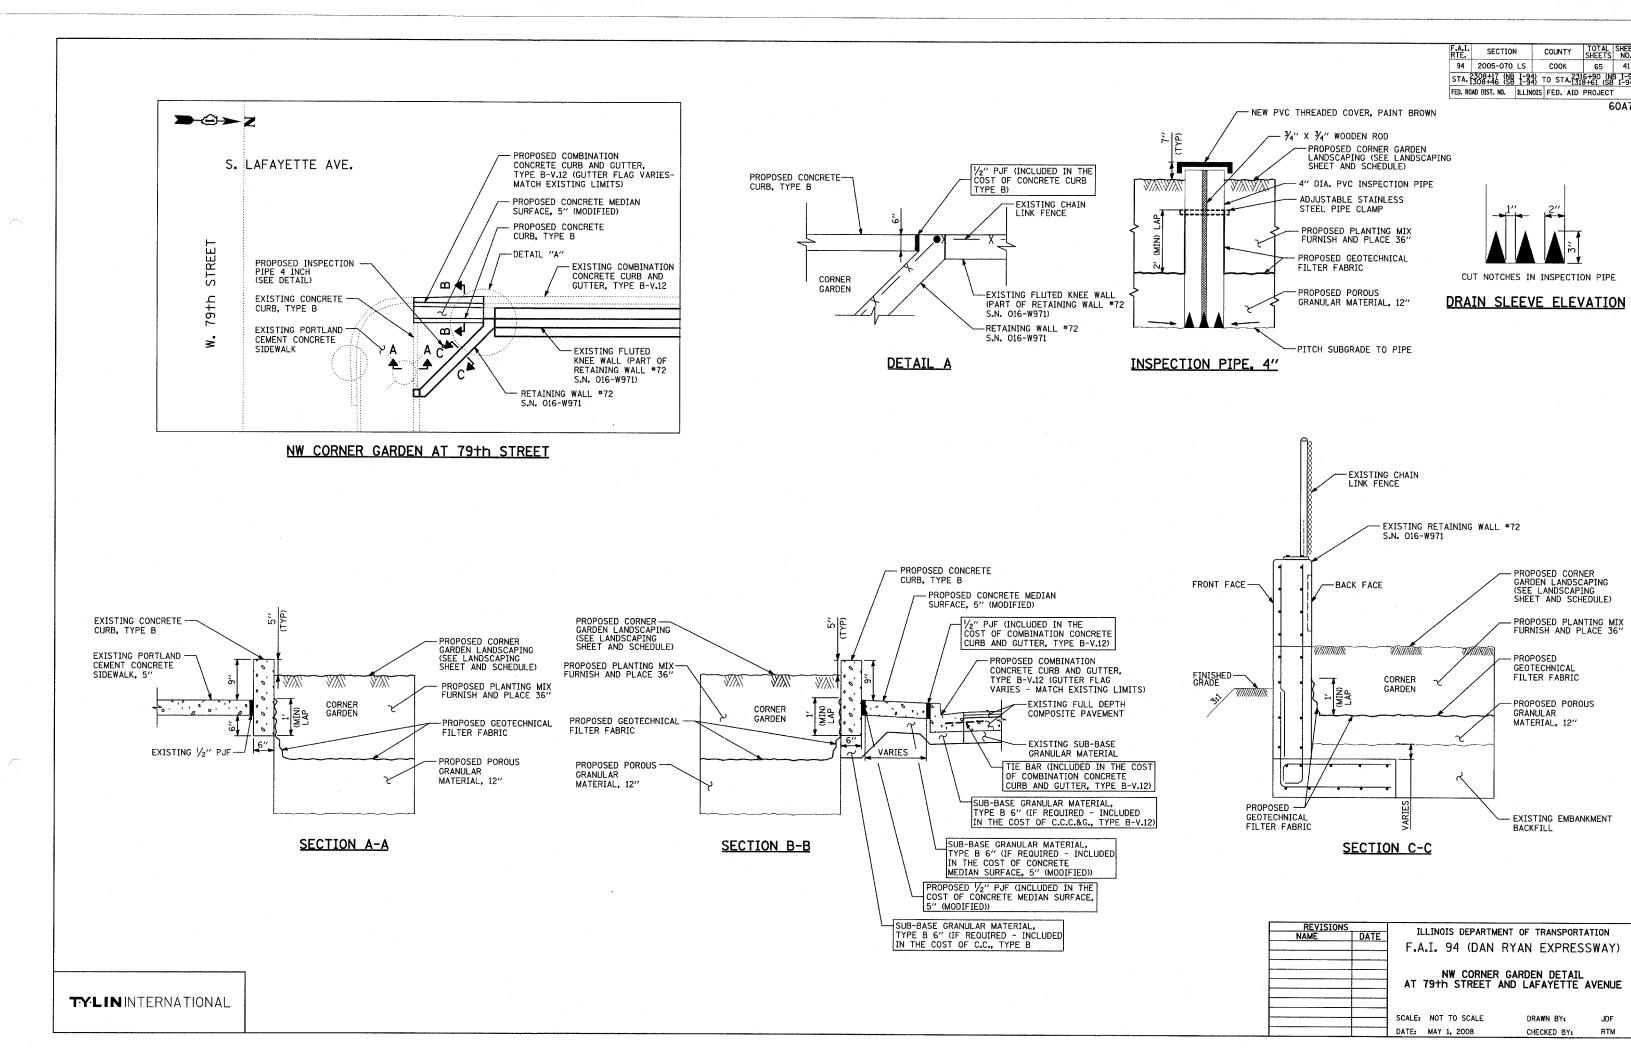


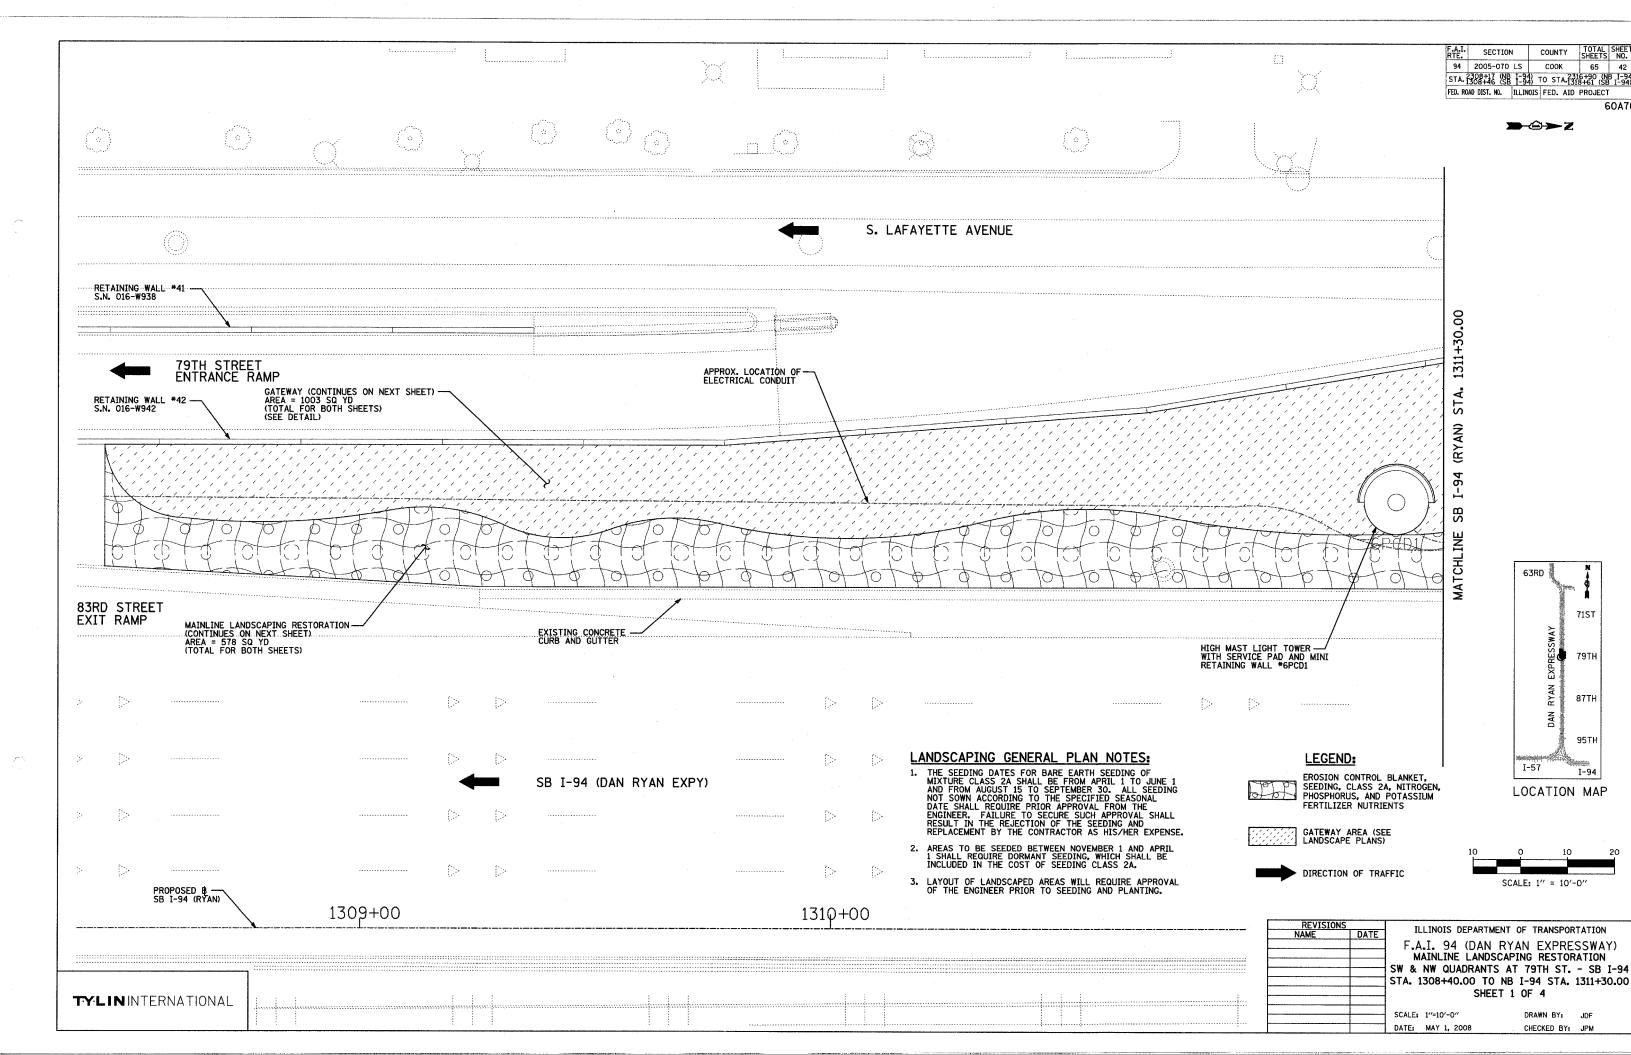


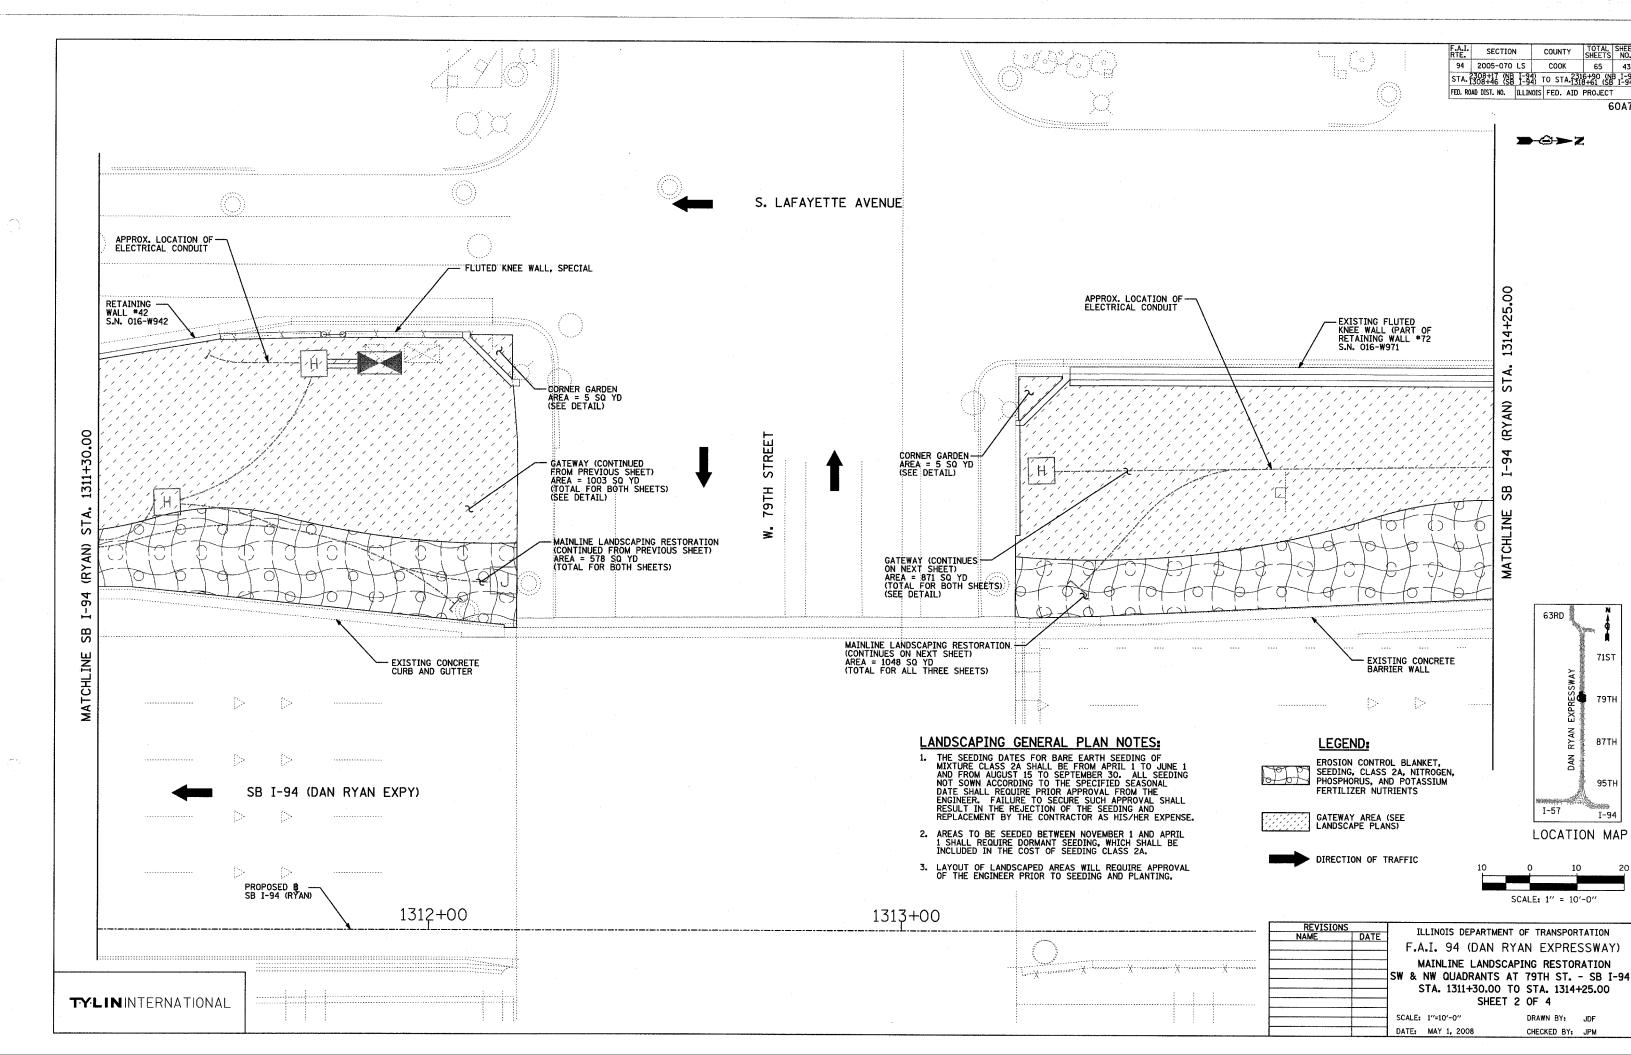

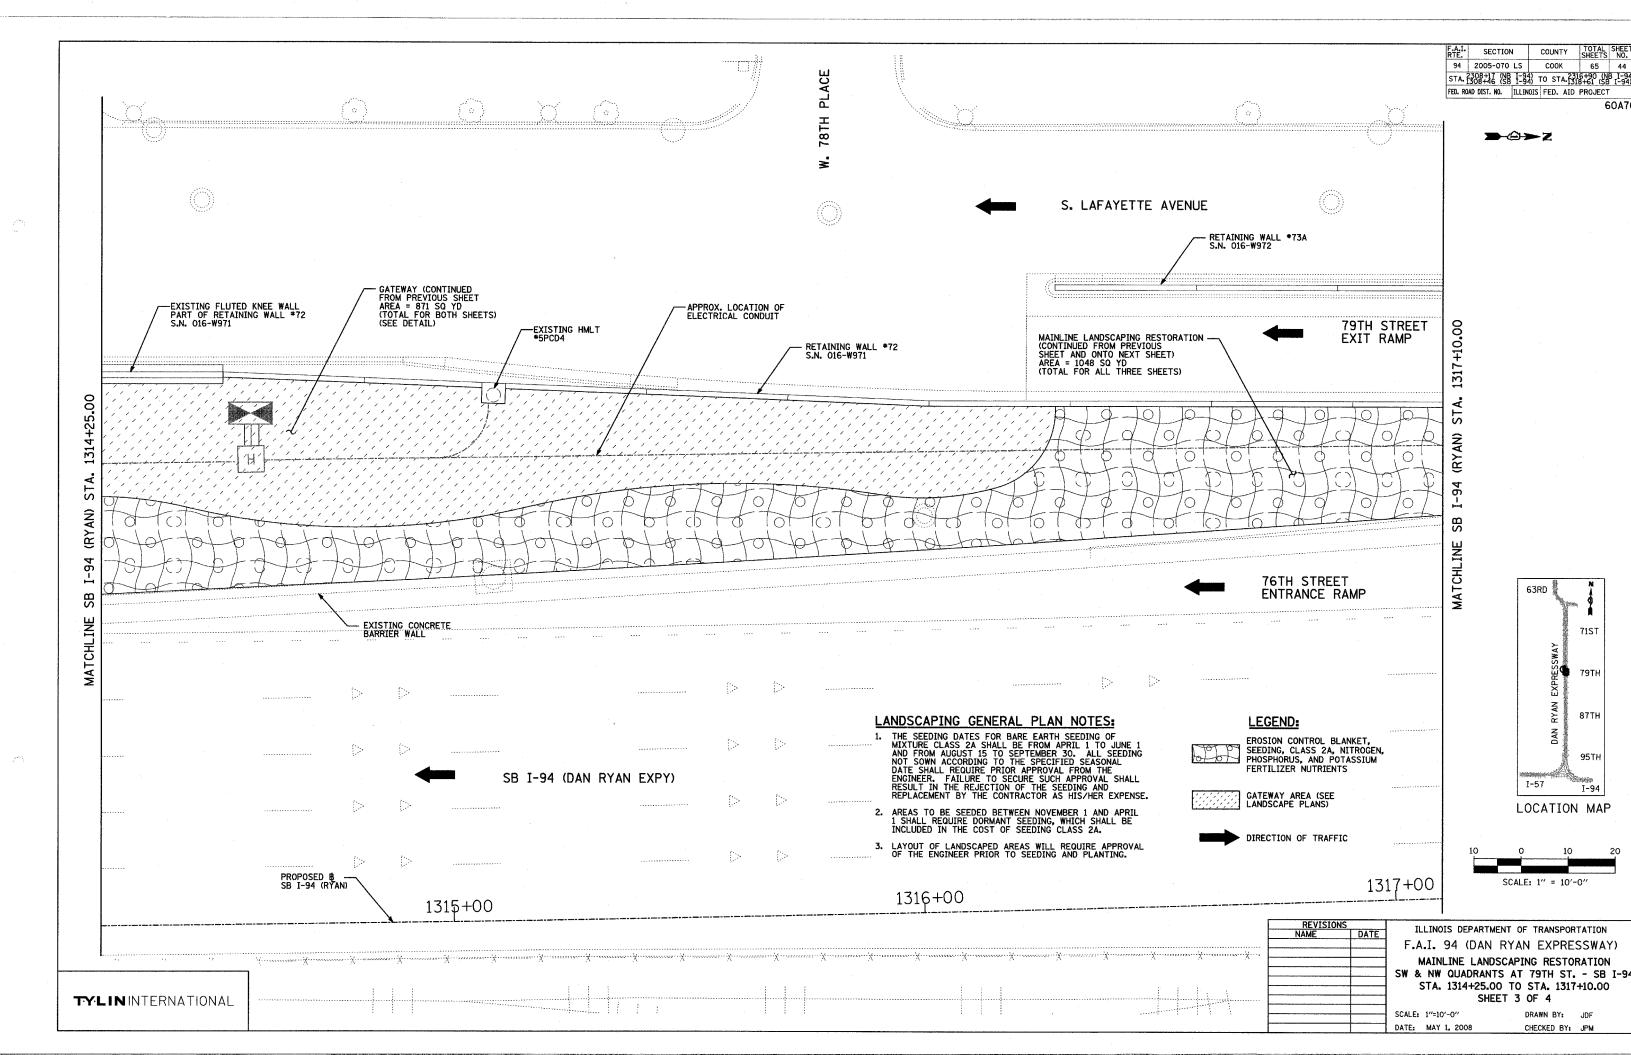

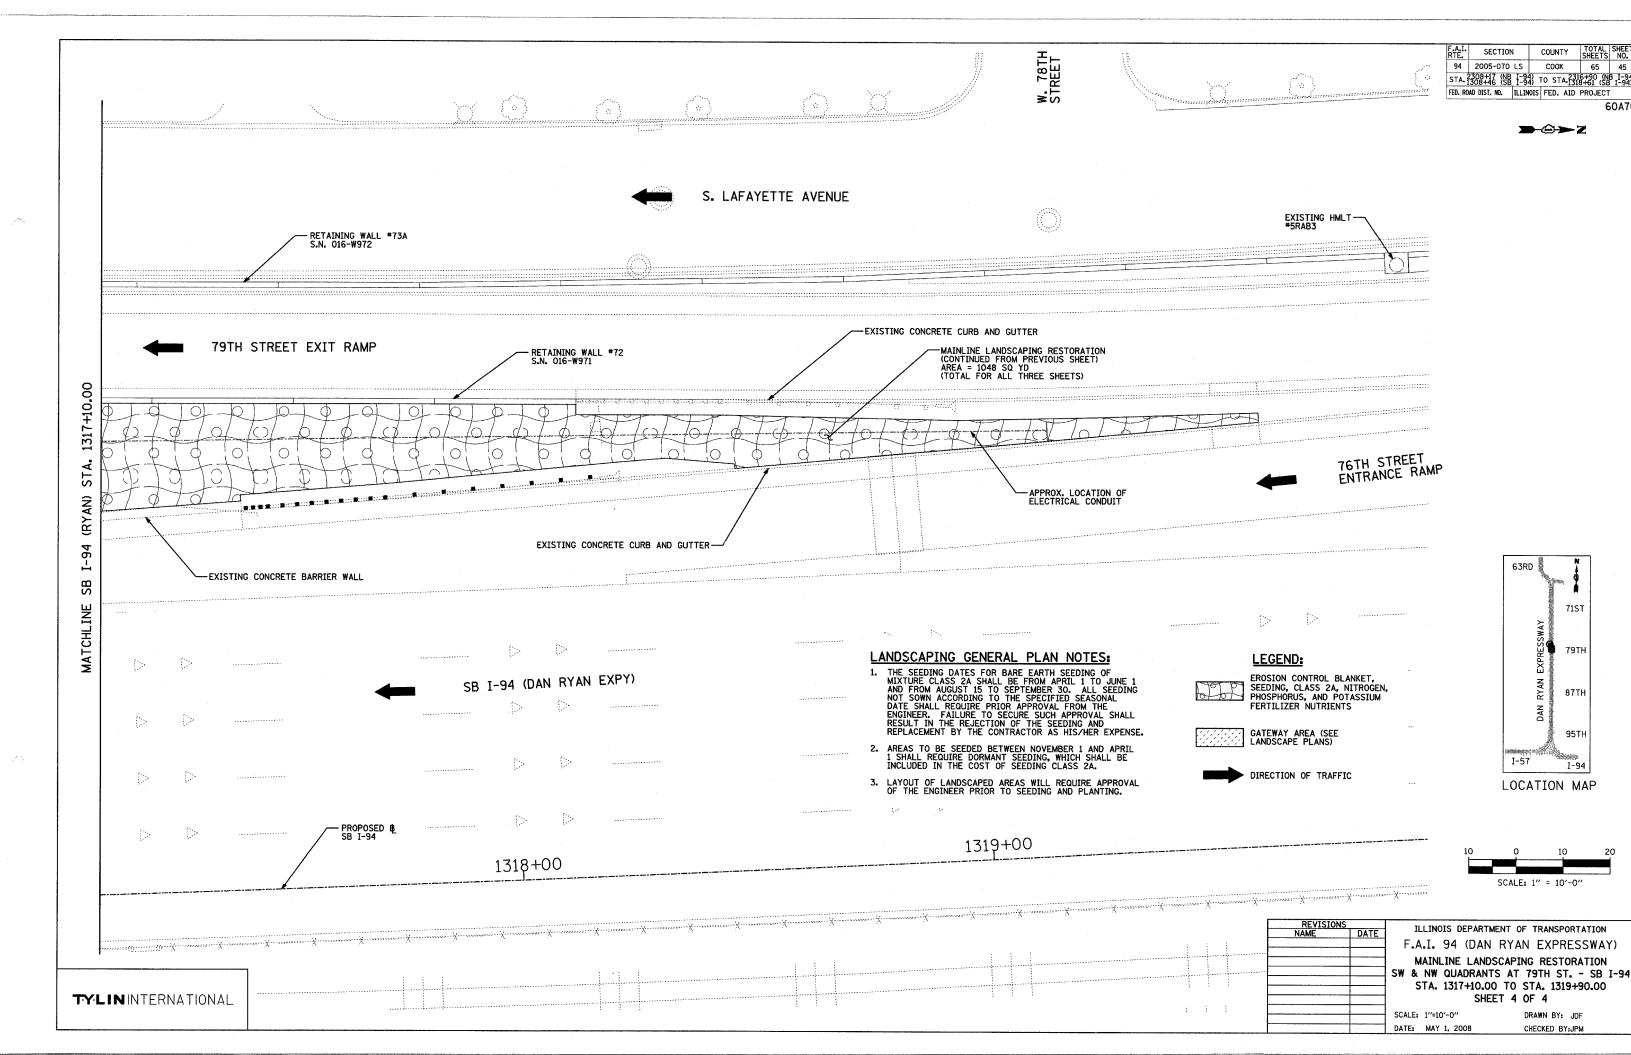

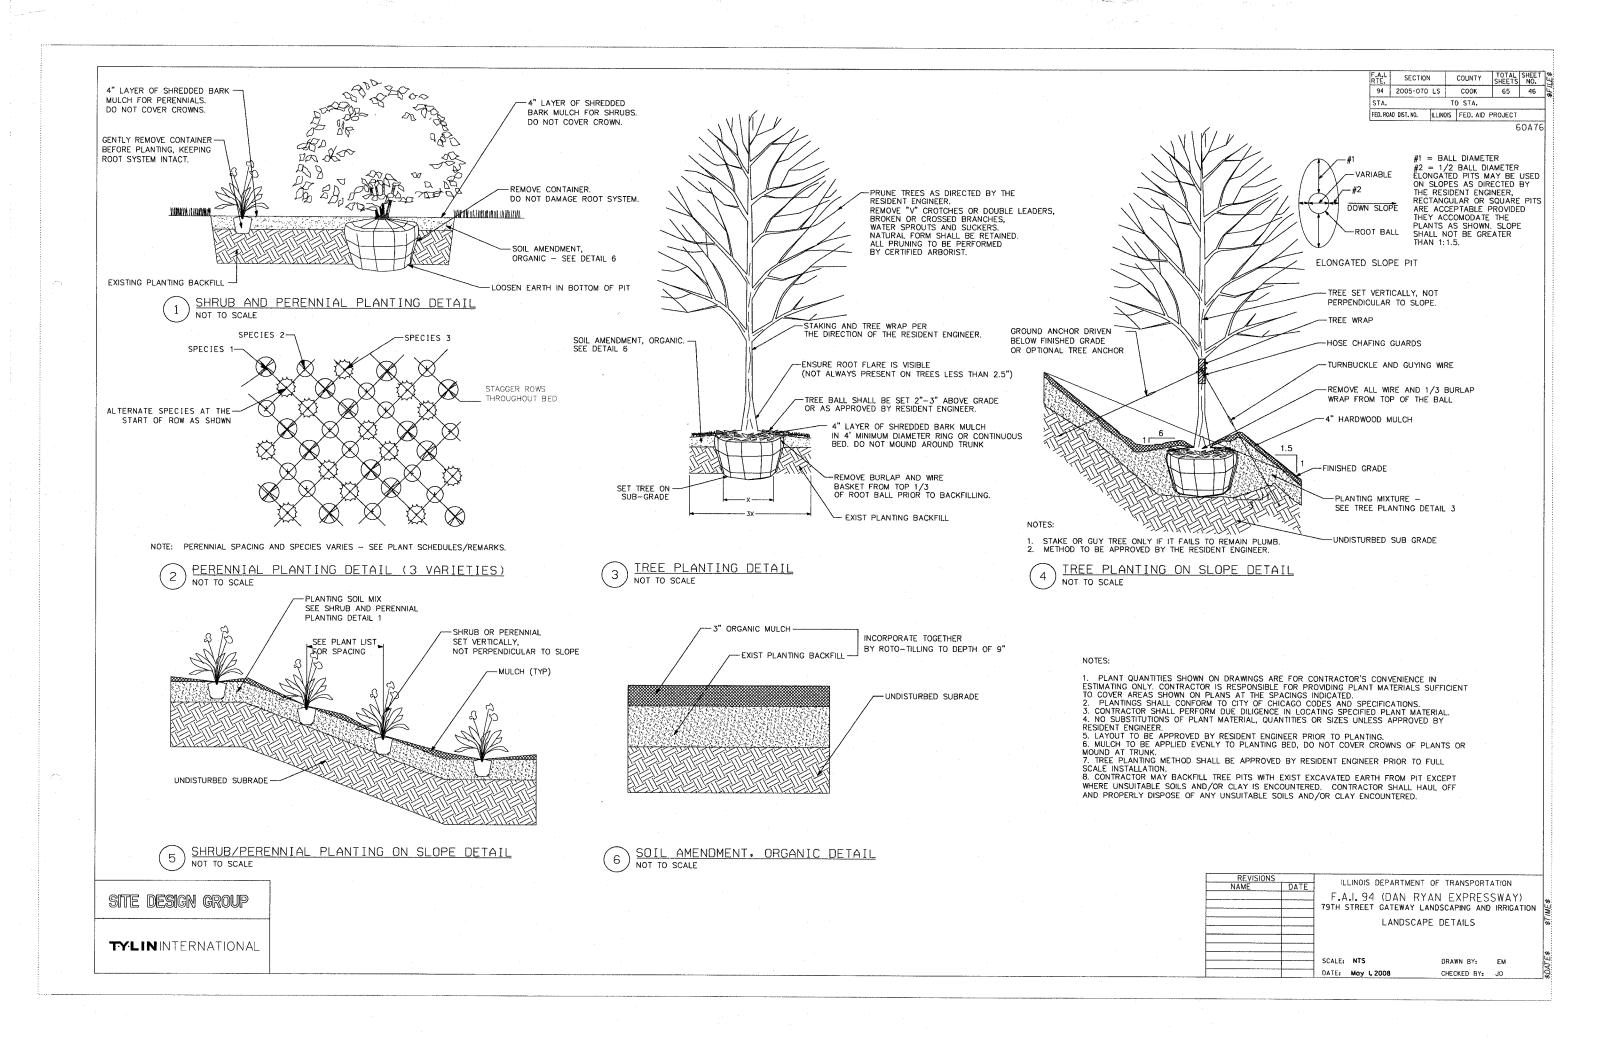

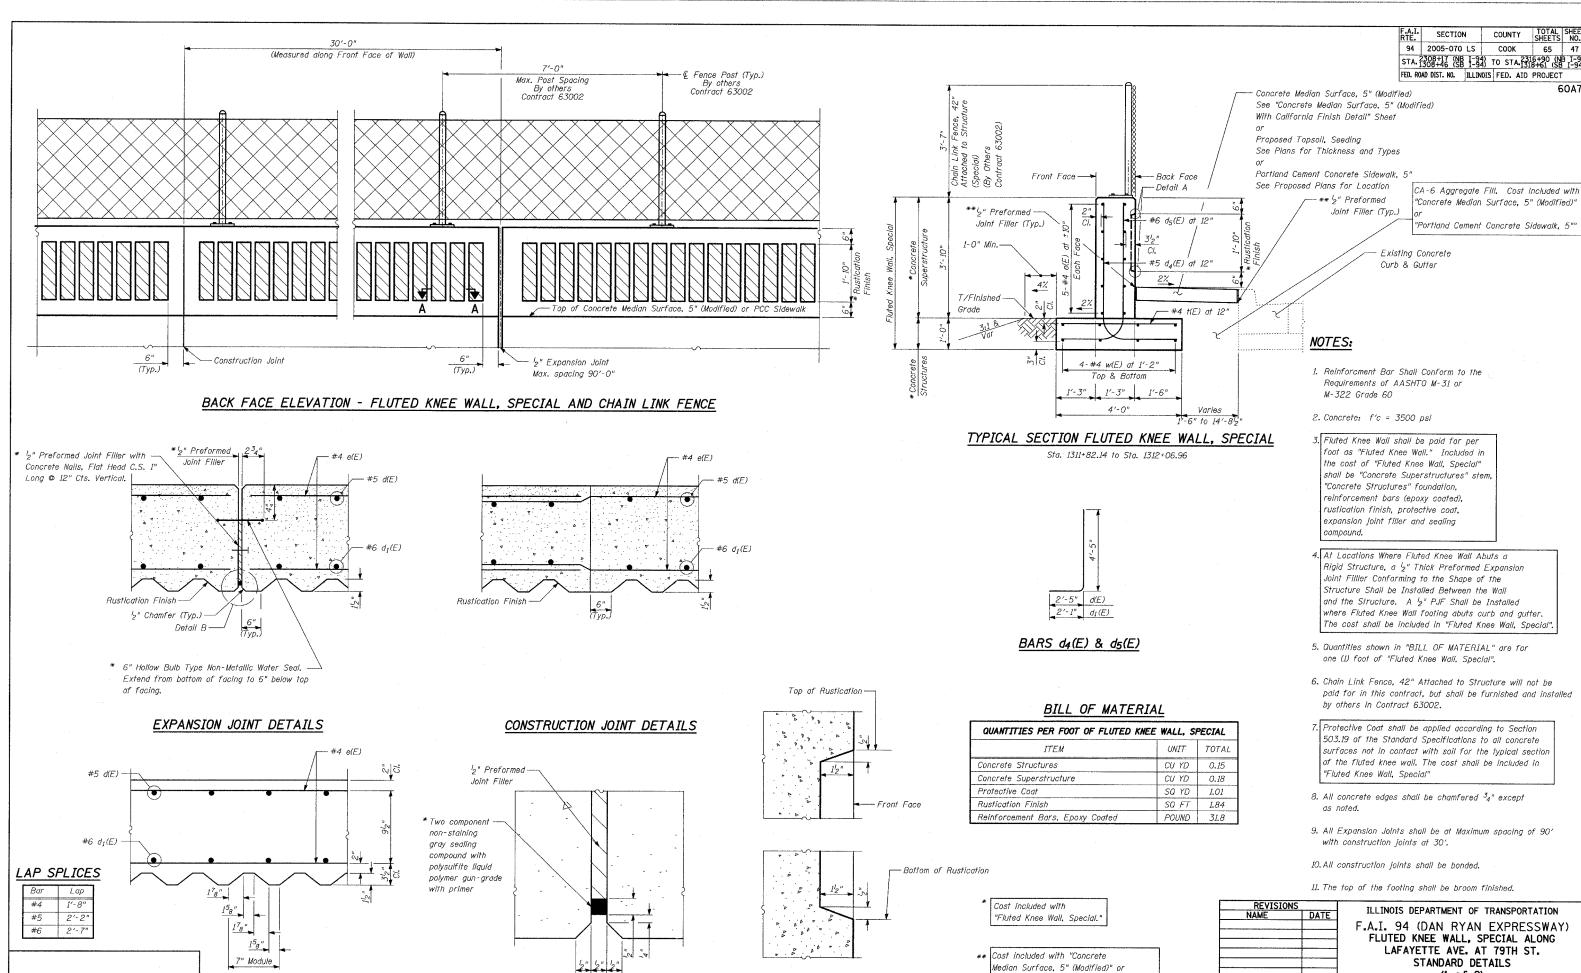

DETAIL A

DETAIL B

TY:LIN INTERNATIONAL


SECTION A-A


STANDARD DETAILS (1 of 2) DESIGNED BY: MAF


SCALE: N.T.S. DATE: MAY 1, 2008

"Portland Cement Concrete Sidewalk, 5""

DRAWN BY: MAF, TB CHECKED BY: MI

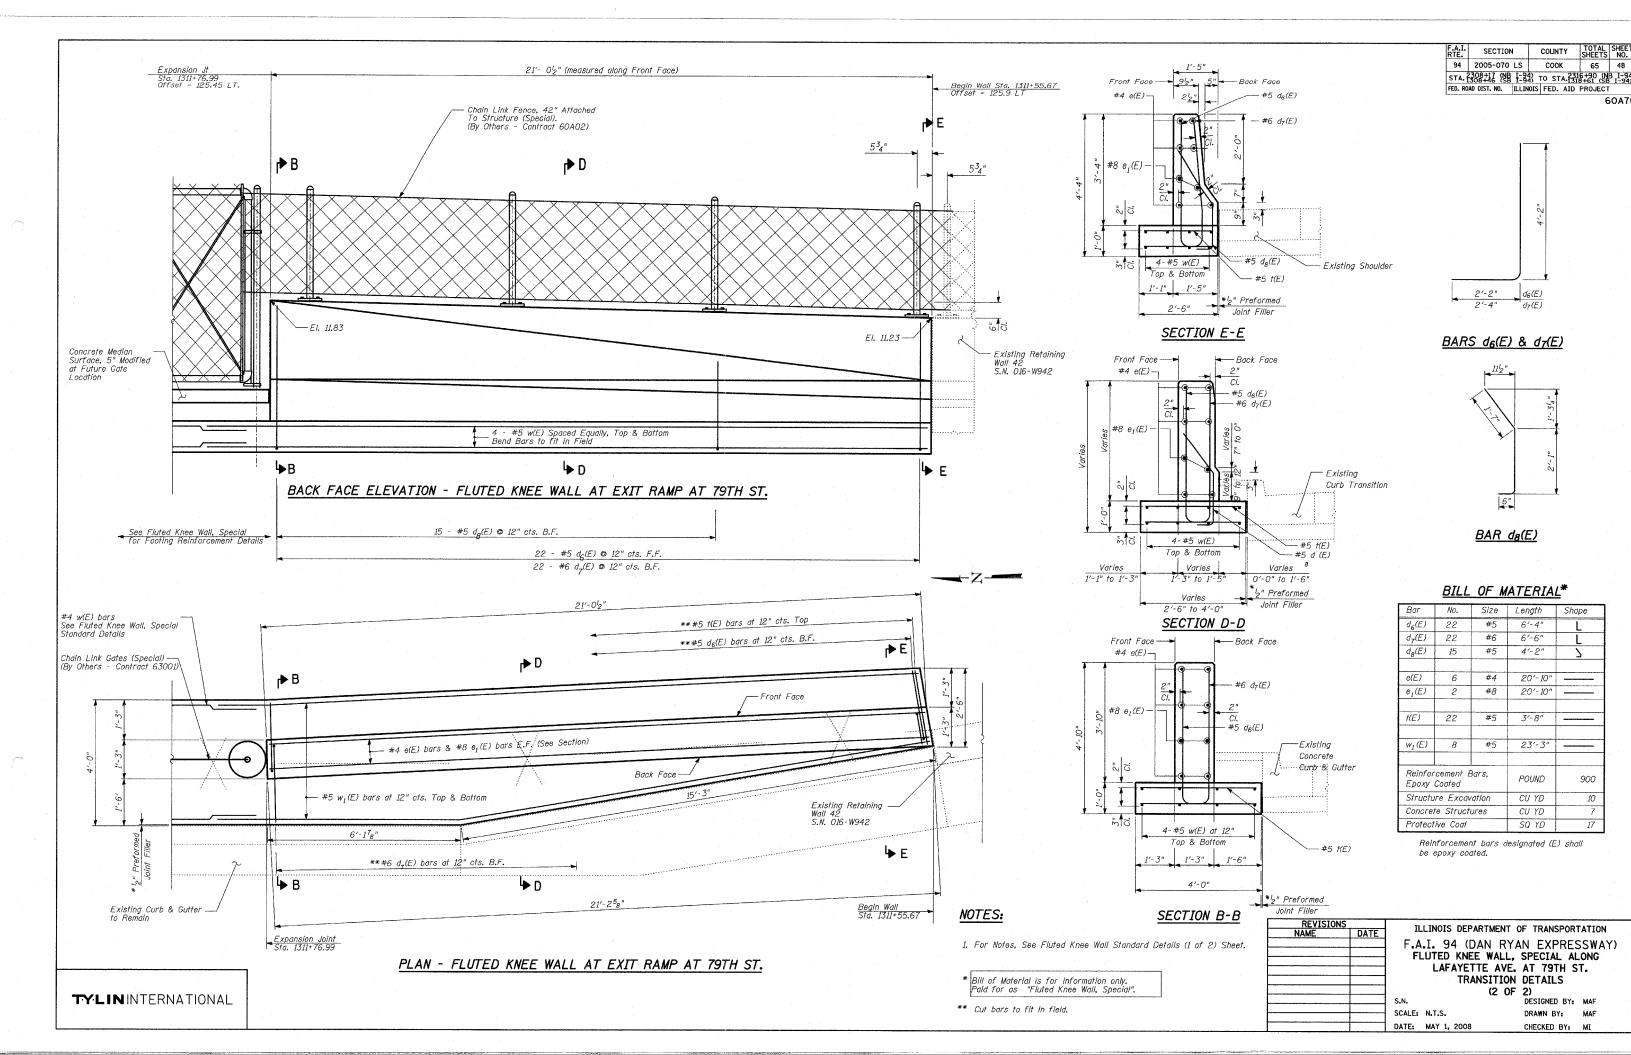

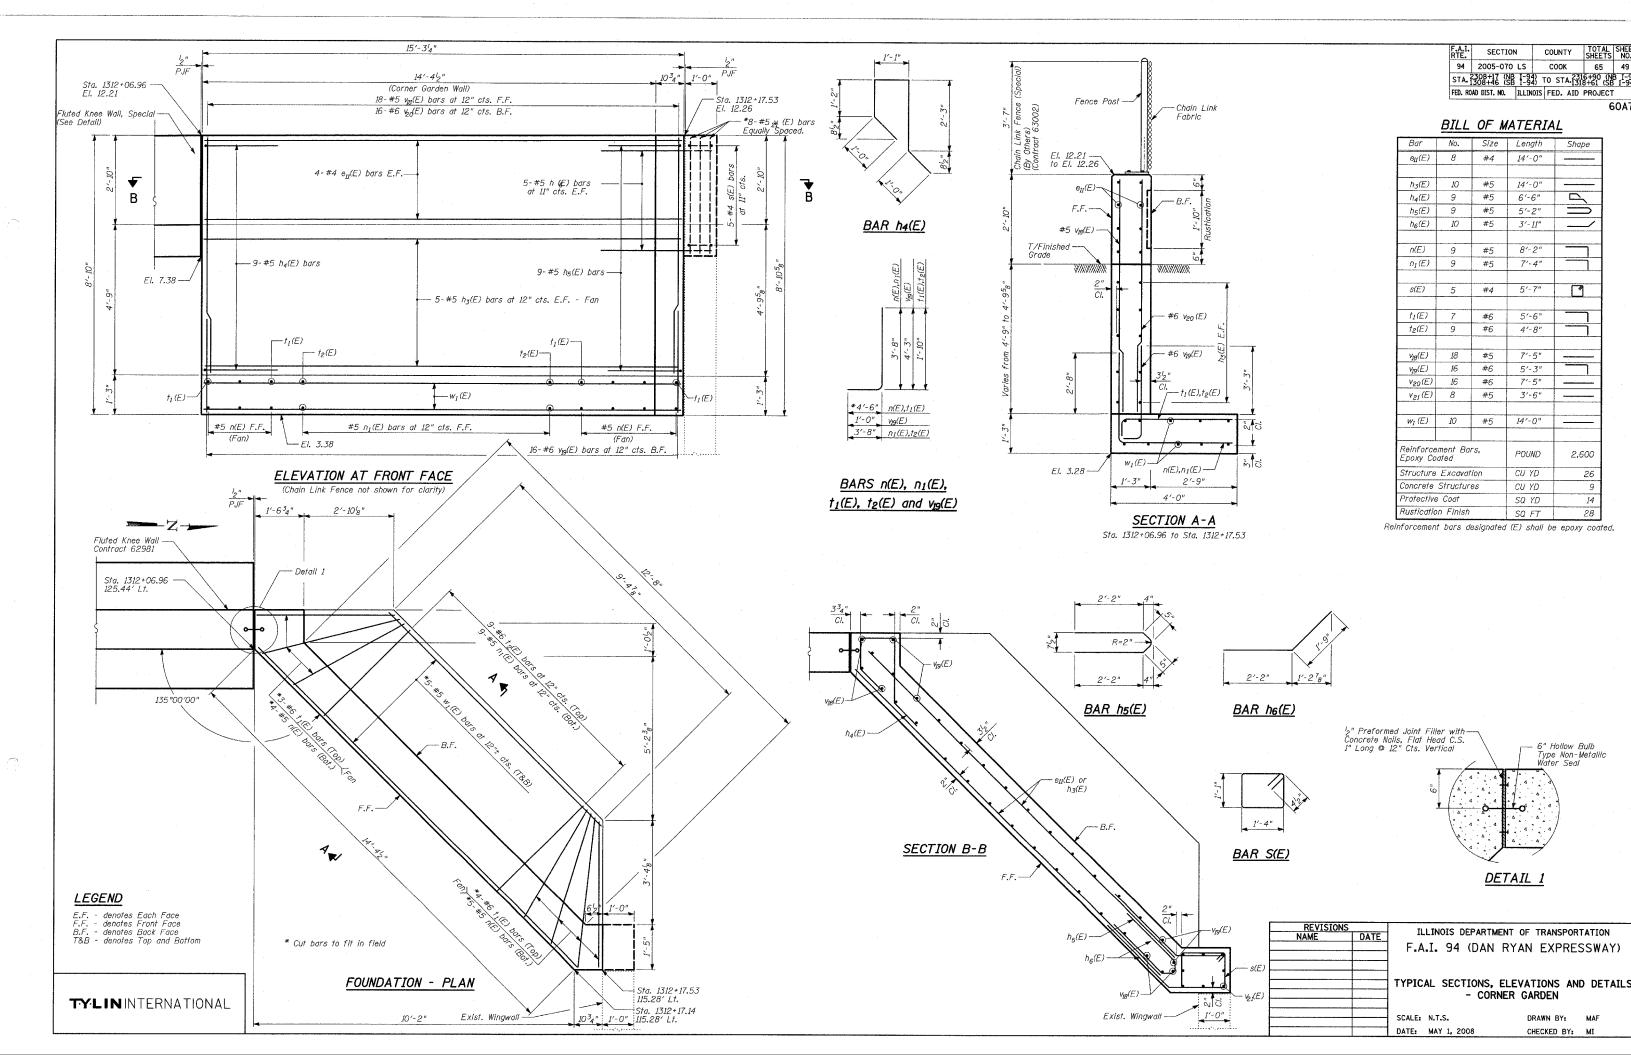


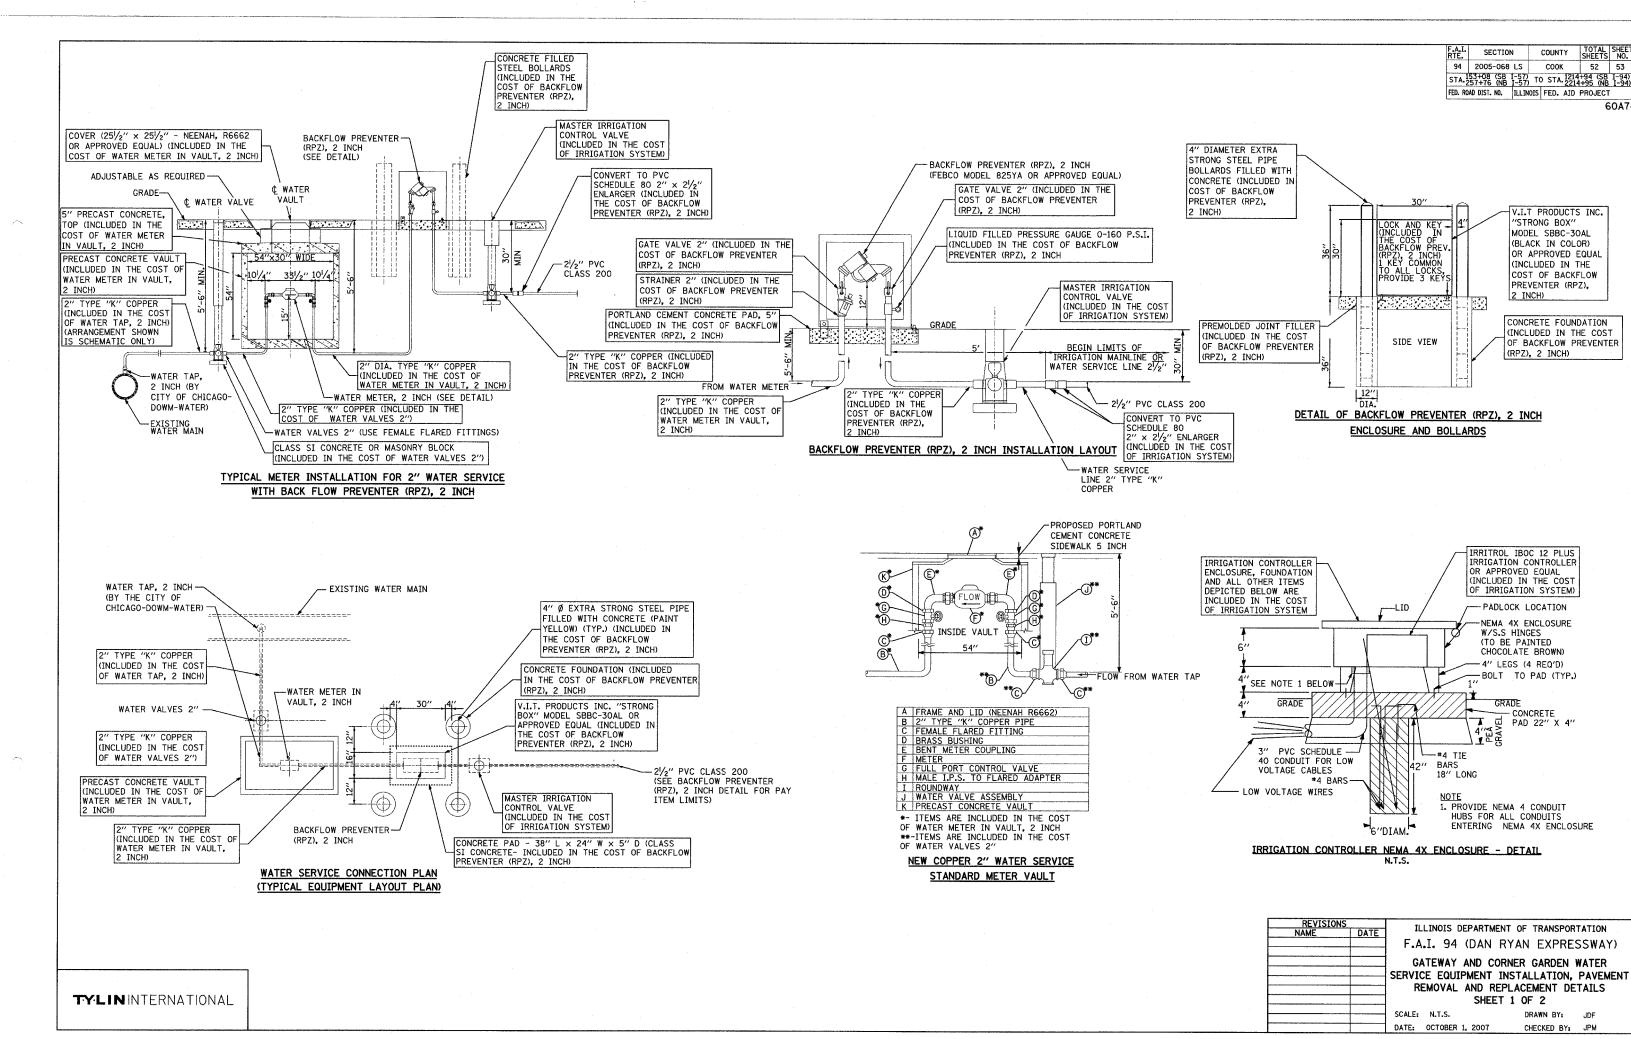


F.A.I. RTE. COUNTY TOTAL SHEE SHEETS NO. SECTION COOK 94 2005-070 LS 65 54 STA. 2308+17 (NB I-94) TO STA. 2316+90 (NB I-94) TO STA. 1318+61 (SB I-94) FED. ROAD DIST. NO. ILLINOIS FED. AID PROJECT

| 2'-6" MINIMUM | 5'-6" MIN SAND BACKFILL (FA-2) (INCLUDED IN THE COST OF WATER 1' MIN. 4' MAX. TAP, 2 INCH - NOTE 3) 2" TYPE "K" COPPER (INCLUDED IN THE 4" MIN COST OF WATER TAP, 2 INCH) TRACER WIRE I/C #14


2" TYPE "K" COPPER PIPE (INCLUDED IN THE COST OF WATER TAP, 2 INCH) - PAVEMENT SECTION

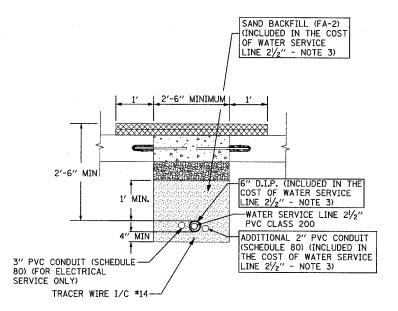


WATER SERVICE LINE 21/2" 21/2" PVC CLASS 200 - PAVEMENT SECTION N.T.S.

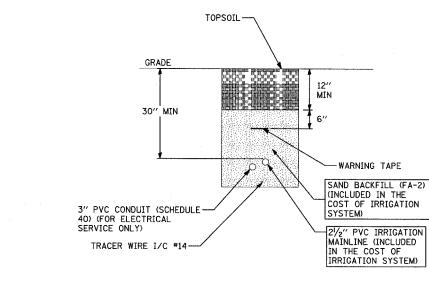

TYPICAL SECTION OF 21/2" IRRIGATION MAINLINE IN GATEWAY

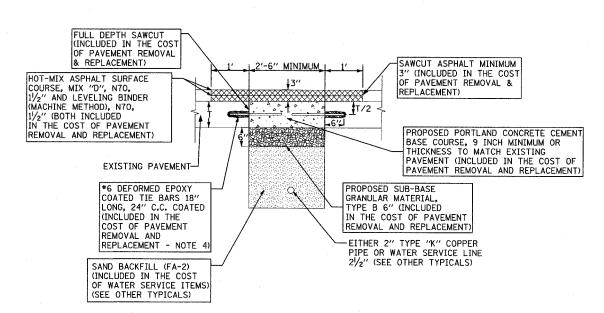

PAVEMENT REMOVAL & REPLACEMENT - TYPICAL

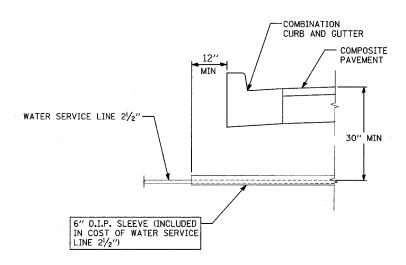

SLEEVING INSTALLATION REQUIREMENTS WITH CURB

- 1. ALL TIE BARS TO BE EPOXY COATED (INCLUDED IN THE COST OF PAVEMENT REMOVAL AND REPLACEMENT).
- 2. ADDITIONAL ONE FOOT (1') OF HOT-MIX ASPHALT SURFACE REMOVAL ON EITHER SIDE OF CONCRETE PATCH SHALL BE REMOVED PRIOR TO PLACING HOT-MIX ASPHALT SURFACE COURSE.
- 3. PIPE BEDDING, TAMPED IN PLACE 4" MINIMUM UNDER PIPE AND 1'-0" ABOVE TOP OF PIPE, SHALL BE WELL SPADED ON BOTH SIDES OF PIPE.
- 4. TIE BARS MAY BE DELETED SUBJECT TO APPROVAL BY THE ENGINEER.
- 5. ALL CONTROL WIRING MUST BE PLACED INSIDE 3" SCHEDULE 80 PVC PIPE FOR ALL PAVED AREA CROSSINGS. THIS WORK AND MATERIALS SHALL CONFORM TO
 THE NATIONAL ELECTRICAL CODE
 REQUIREMENTS. THE COST OF THIS WORK
 WILL BE INCLUDED IN COST OF IRRIGATION


REVISIONS		ILLINOIS DEPARTMENT OF TRANSPORTATION						
NAME	DATE	ILLINOIS DEFARIMENT OF TRANSPORTATION						
		F.A.I. 94 (DAN RYAN EXPRESSWAY)						
		GATEWAY AND CORNER GARDEN WATER						
		SERVICE EQUIPMENT INSTALLATION, PAVEMEN						
		REMOVAL AND REPLACEMENT DETAILS						
		SHEET 2 OF 2						

TY:LIN INTERNATIONAL

SCALE: N.T.S.

DRAWN BY: JDF CHECKED BY: JPM

SECTION 2005-070 LS соок 65 55 STA. 2308+17 (NB 1-94) TO STA. 2316+90 (NB 1-94) TO STA. 1308+46 (SB 1-94) FED. ROAD DIST. NO. ILLINOIS FED. AID PROJECT

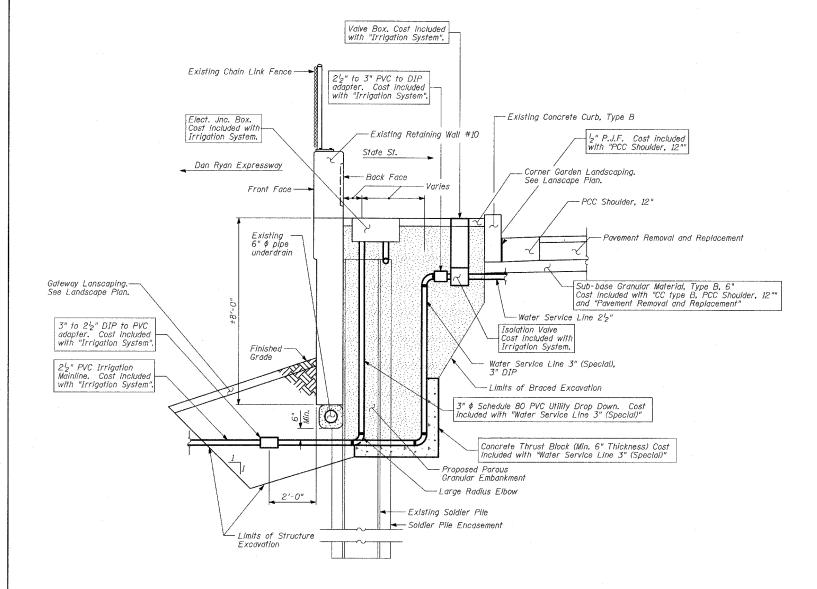

ELEVATION - WATER SERVICE & ELECTRICAL LINES AT SOLDIER PILE RETAINING WALL #10 (BETWEEN PILES)

BILL OF MATERIAL

<u> </u>	714/16	
ITEM	UNIT	TOTAL
Porous Granular Embankment	CU YD	10
Structure Excavation	CU YD	7
Braced Excavation	CU YD	10
Water Service Line 3" (Special)	FOOT	15

REVISIONS NAME ILLINOIS DEPARTMENT OF TRANSPORTATION F.A.I. 94 (DAN RYAN EXPRESSWAY)

GATEWAY AND CORNER GARDEN UTILITY DROP DOWN DETAILS

SCALE: N.T.S. DATE: MAY 1, 2008

Concrete Thrust Block (Min. 6" Thickness) Cost included with "Water Service Line 3" (Special)"

Existing Soldier Pile and Encasement

Front Face

Center between piles

3" ¢ Schedule 80 PVC Utility Drop Down. Cost included with"Water Service Line 3" (Special)"

-Back Face

-Limits of Structure Excavation (Typ.)

DRAWN BY: MAF CHECKED BY: DAK

LEGEND

Porous Granular Embankment

Portland Cement Concrete

TY:LIN INTERNATIONAL

Existing Concrete Curb, Type B


Water Service Line 3" (Special), 3" DIP.


Limits of Braced Excavation

±11′-0" PLAN - WATER SERVICE & ELECTRICAL

LINES AT SOLDIER PILE RETAINING WALL

5'-0"

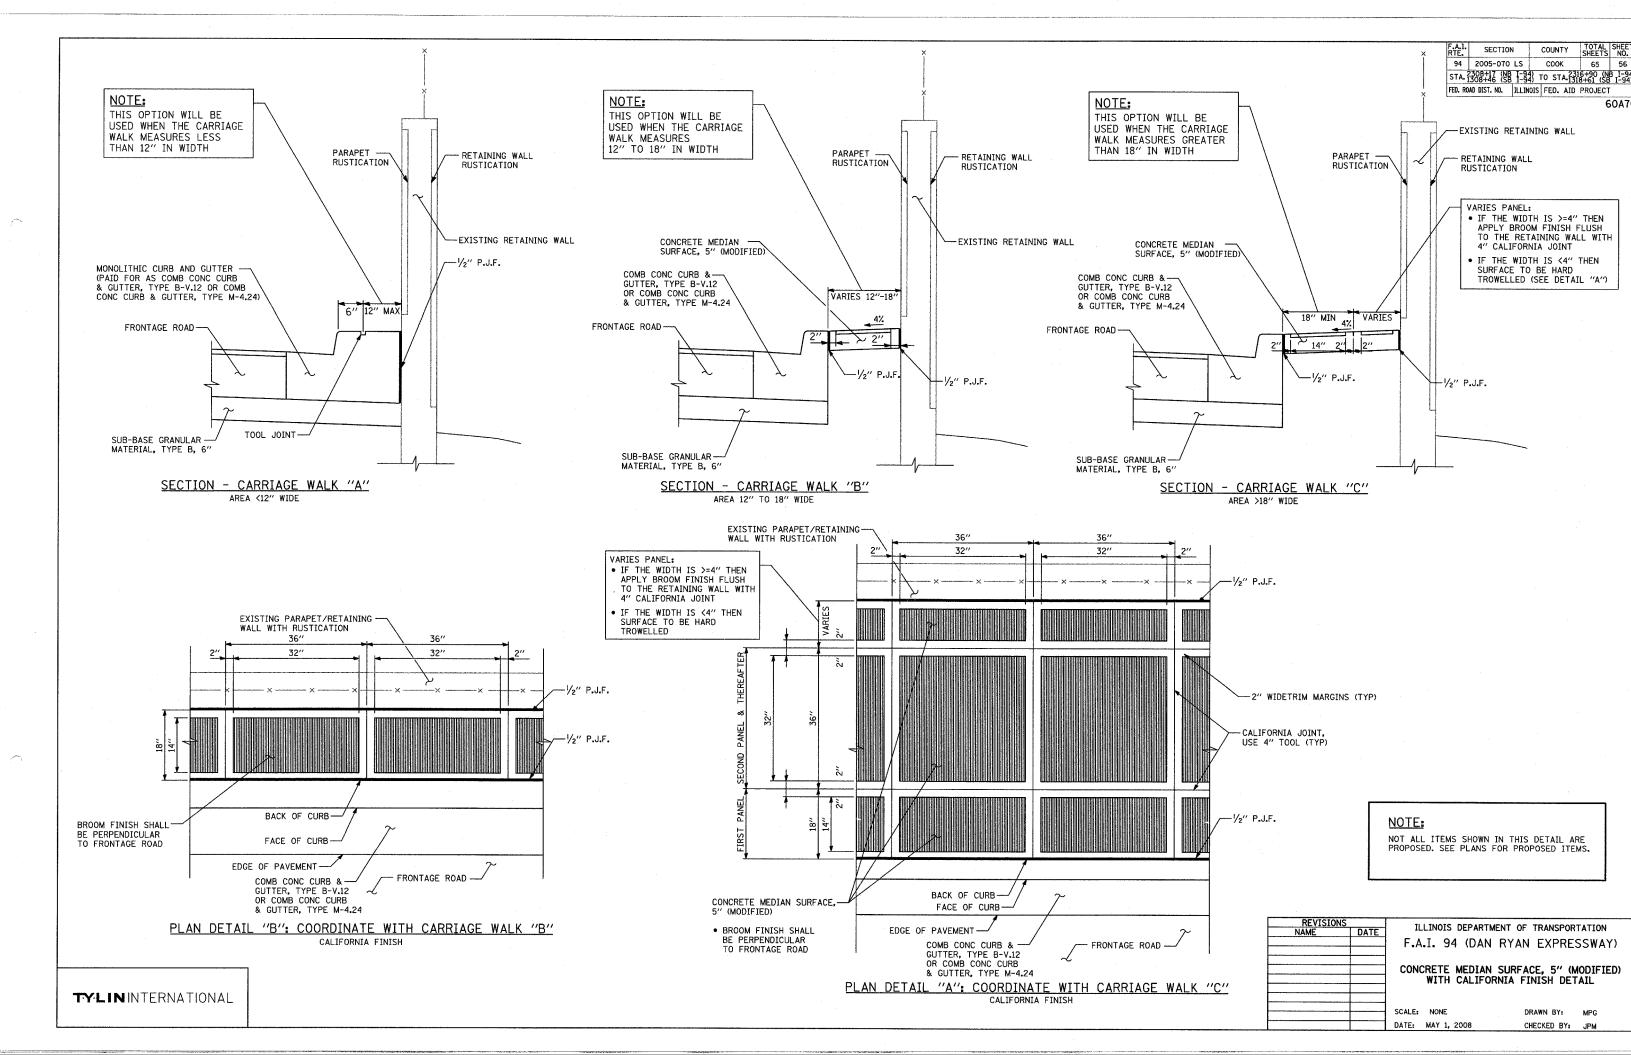

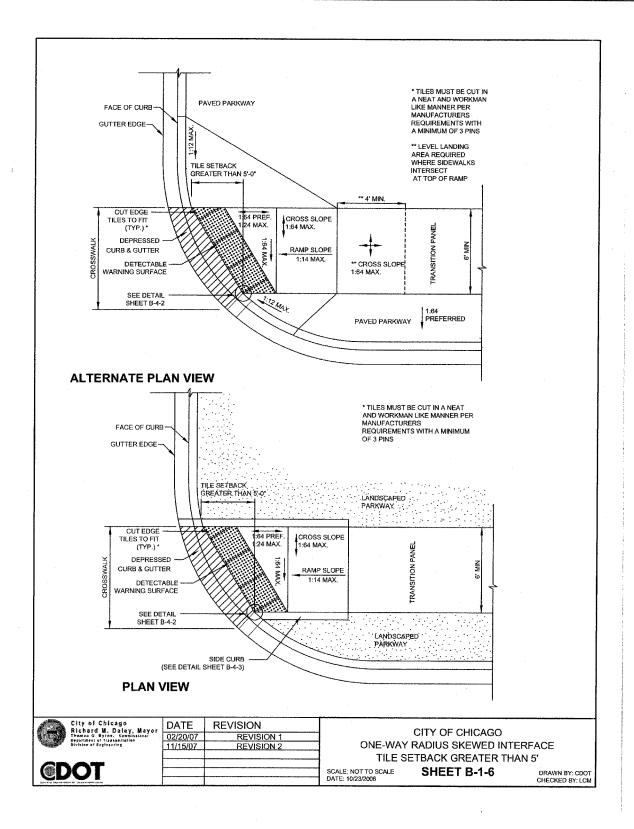

GENERAL NOTES

- 1. THE DETECTABLE WARNING TILES SHALL BE CERAMIC CEMENT OR COMPOSITE POLYMER CONCRETE (CRC) TILES WHICH MEET THE CHICAGO DEPARTMENT OF TRANSPORTATION SPECIFICATION (AVAILABLE ON THE CITY OF CHICAGO WEBSITE). IN THE CENTRAL BUSINESS DISTRICT, GRANITE OR OTHER SPECIALTY PAVING MATERIALS MAY BE SUBMITTED TO THE COMMISSIONER FOR APPROVAL.
- 2. TILES MUST BE INSTALLED A MAXIMUM OF 8" OR LESS FROM FACE OF CURB (SEE DETAIL SHEET B-4-2).
- 3. TILES MUST COVER FULL WIDTH OF RAMP EXCLUDING SIDE FLARES. WHERE SIDEWALK OR RAMP IS FLUSH WITH STREET (DEPRESSED CURB), TILES MUST BE PROVIDED.
- 4. WHERE APPLICABLE, A COMBINATION OF DIFFERING SIZE TILES MAY BE USED ON COMPOUND AND LARGE RADII. CONTRACTOR MUST MAKE THIS DETERMINATION AND VERIFY IN FIELD.
- 5. TILES MUST CONTRAST WITH ADJACENT PAVEMENT. IF LIGHT COLORED PAVEMENT IS USED THE TILE COLOR SHALL BE RED. IF A DARK COLORED PAVEMENT IS USED THE TILE COLOR SHALL BE YELLOW. CONTRACTOR TO VERIFY THAT PROPER CONTRAST IS OBTAINED.
- 6. RAMP WIDTH MUST BE A MINIMUM OF 6'-0" AND IN INCREMENTS OF 1'-0", EXCEPT WHEN USING THE PERPENDICULAR RAMP AT CORNER, WHICH HAS A MINIMUM WIDTH OF 4'-0".
- 7. PRIOR TO PLACING CONCRETE FOR DEPRESSED CURBS AND RAMPS THE CONTRACTOR SHALL NOTIFY THE COMMISSIONER TO RECEIVE LAYOUT APPROVAL. A PRE-MANUFACTURED TILE, APPROVED BY THE COMMISSIONER, MUST BE USED TO ACHIEVE THE DETECTABLE WARNING SURFACE.
- 8. THE MAXIMUM ALLOWABLE RAMP RUNNING SLOPE IS 1:14, MEASURED AT ANY PORTION OF THE RAMP. IF POSSIBLE, A MORE GRADUAL SLOPE SHALL BE USED. GRADE BREAKS AT THE TOP AND BOTTOM OF RAMPS SHALL BE PERPENDICULAR TO THE DIRECTION OF RAMP RUN.
- 9. THE MAXIMUM ALLOWABLE RAMP CROSS SLOPE IS 1:64, MEASURED AT ANY PORTION OF THE RAMP. IF POSSIBLE, A MORE GRADUAL SLOPE SHALL BE USED.
- 10. UTILITIES, SUCH AS LIGHT POLES, TRAFFIC POLES AND HYDRANTS, MAY BE LOCATED IN THE FLARE OF THE RAMP BUT ARE NOT ALLOWED ON THE RAMP SURFACE OR LANDING AREAS.
- 11. ALTERATIONS SHALL NOT DECREASE THE ACCESSIBILITY OF EXISTING FACILITIES
- 12. THE MINIMUM CROSSWALK WIDTH IS 6'-0". CROSSWALKS SHALL BE LOCATED AS SHOWN IN THE PLAN SHEETS DEPENDING ON THE TYPE OF CURB RAMP USED. BEYOND THE CURB FACE AT THE BASE OF CURB RAMPS, A CLEAR SPACE OF 4'-0" BY 4'-0" MINIMUM SHALL BE PROVIDED WITHIN THE WIDTH OF THE CROSSWALK.
- 13. IF SIDEWALK AND ALLEY ARE AT THE SAME GRADE, A RAMP IS NOT REQUIRED. IF SIDEWALK AND DRIVEWAY ARE AT THE SAME GRADE, A RAMP IS NOT REQUIRED BUT DETECTABLE WARNING TILES ARE STILL REQUIRED IF THE DRIVEWAY HAS TRAFFIC CONTROL DEVICES (I.E. TRAFFIC SIGNALS).
- 14. MAIN LINE SIDEWALK SHALL HAVE A MAXIMUM CROSS SLOPE NOT TO EXCEED 1:64 FOR THE FULL WIDTH OF WALK UNLESS OTHERWISE APPROVED BY THE COMMISSIONER.
- 15. MAIN LINE SIDEWALK RUNNING SLOPES SHALL NOT EXCEED 1:24 OR THE GENERAL GRADE ESTABLISHED FOR THE ADJACENT STREET, WHICH EVER IS HIGHER.
- 16. CURB RAMPS AND KEYSTONE TO BE CONSTRUCTED WITH 8" THICK CONCRETE AT ALL TRAFFIC SIGNALIZED INTERSECTIONS AND INDUSTRIAL STREET INTERSECTIONS. AT ALL OTHER LOCATIONS, 5" THICK CONCRETE TO BE USED
- 17. NO DEVIATIONS FROM THESE STANDARDS ARE ALLOWED WITHOUT WRITTEN APPROVAL FROM THE COMMISSIONER.
- 18. ALL CONSTRUCTION DOCUMENTS MUST BE STAMPED BY A LICENSED ARCHITECT/LANDSCAPE ARCHITECT/ENGINEER TO CERTIFY THAT THEY ARE IN ACCORDANCE WITH THE AMERICANS WITH DISABILITIES ACT (ADA) AND ALL CODES AND BUILDING ORDINANCES OF THE CITY OF CHICAGO AND STATE OF ILLINOIS.

	-468886	City of Chicago
		Richard M. Daley, Mayo
		Thomas G. Byrne, Commissions: Department of transportation
-		Division of Engineering
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_	DATE	REVISION	
	02/20/07	REVISION 1	
	11/15/07	REVISION 2	
			S

CITY OF CHICAGO GENERAL NOTES

SCALE: NOT TO SCALE SHEET B-3-2 DATE: 10/23/2006

DRAWN BY: CDOT CHECKED BY: LCM 94 2005-070 LS COOK SHEETS NO.
STA. 2308+17 (NB 1-94) TO STA. 2316+90 (NB 1-94)
FED. ROAD DIST. NO. IILLINOIS FED. AID PROJECT

COLINTY

SECTION

REVISIONS
NAME DATE

F.A.I. 94 (DAN RYAN EXPRESSWAY)

CITY OF CHICAGO STANDARD DETAILS
DETAILS OF CURB RAMPS FOR
PEOPLE WITH DISABILITIES
SHEET 1 OF 3

SCALE: NONE DRAWN BY: CDOT

CHECKED BY:

DATE: MAY 1, 2008

ADA COMPLIANCE AND TRANSITION GUIDELINES

POLICY STATEMENT: ANY ALTERATION OF THE PUBLIC WAY MUST BE RESTORED IN AN ADA COMPLIANT MANNER

I. STREET RESURFACING / RECONSTRUCTION *

FOR ANY RESURFACING/RECONSTRUCTION PROJECT WHERE, WITHIN THE PROJECT LIMITS, A CROSSWALK IS ENCOUNTERED OR WHERE THE PROJECT LIMITS TERMINATE WITHIN 4' OR LESS OF A CROSSWALK, THOSE CROSSWALKS AND THE ASSOCIATED CURB RAMPS MUST BE IMPROVED TO CURRENT ADA STANDARDS. WHERE RESURFACING/RECONSTRUCTION ENCOUNTERS LESS THAN 1/4 POINT OF THE STREET SURFACE (LONGITUDINAL CUT), IT IS ACCEPTABLE PRACTICE TO EXCLUDE IMPROVEMENTS TO THE ASSOCIATED CROSSWALKS AND CURB RAMPS.

WHEN A PROJECT SCOPE OF WORK CALLS FOR ONLY AN INTERSECTION TO BE REPAVED, THE INTERSECTION LIMITS AS DEFINED BY THE AREA OUTLINED BY OUTERMOST CROSSWALK LINES AND ADJACENT CURB FACES AND ALL ADJOINING CROSSWALKS AND CURB RAMPS MUST BE IMPROVED TO CURRENT ADA STANDARDS.

WHEN A PROJECT SCOPE OF WORK IS LIMITED TO A SINGLE CORNER OF AN INTERSECTION. THE CURB RAMP MUST BE IMPROVED TO CURRENT ADA STANDARDS AND THE ADJACENT PAVEMENT MUST BE RESURFACED, AS NECESSARY TO PROVIDE FOR A FLUSH TRANSITION.

FOR ANY RESURFACING / RECONSTRUCTION PROJECT WHERE, WHITHIN THE PROJECT LIMITS. AN ALLEY APRON IS INCLUDED, THE ASSOCIATED CURB RAMPS AND SIDEWALKS MUST BE IMPROVED TO CURRENT ADA STANDARDS

II. SIDEWALK INSTALLATION / REPAIRS / RECONSTRUCTION

THE LIMITS OF ANY MAINLINE SIDEWALK REPLACEMENT, GREATER THAN TEN FEET (10') IN LENGTH. THAT ABUT AN EXISTING RAMP LOCATION (INCLUDING THE FOUR FOOT (4') LANDING AREA AND/OR THE "KEYSTONE"), SHALL BE EXTENDED TO INCLUDE THE AFFECTED RAMPS ANDTHESE RAMPS SHALL BE RECONSTRUCTED TO CURRENT ADA STANDARDS. IN ADDITION, ALL NEWLY PLACED SIDEWALK TEN FEET (10') OR MORE IN LENGTH SHALL BE CONSTRUCTED IN ACCORDANCE WITH ALL CURRENT APPLICABLE STANDARDS WHICH INCLUDE PROVIDING A MINIMUM FOUR FEET (4') WIDTH ACCESSIBLE PATHWAY WITH A CROSS SLOPE NOT TO EXCEED 1:64.

III. GUIDELINES FOR TRANSITIONING TO EXISTING NON-COMPLIANT CONDITION

NEW SIDEWALK PLACEMENTS GREATER THAN TEN FEET IN CONTIGUOUS LENGTH: THE LIMITS OF ANY MAINLINE SIDEWALK REPLACEMENT, GREATER THAN TEN FEET (10') IN LENGTH, MUST BE EXTENDED FOR A MINIMUM FIVE ADDITIONAL FEET (5') EITHER SIDE IN ORDER TO PROVIDE A REASONABLE TRANSITION TO MATCH THE EXISTING SIDEWALK. THE LENGTH OF TRANSITION SHALL BE LENGTHENED AS NECESSARY TO ENSURE THAT THE RUNNING SLOPE OF THE TRANSITION DOES NOT EXCEED A SLOPE OF 1:24 (PREFERRED) OR 1:14 (MAXIMUM) AT ANY POINT.

NEW SIDEWALK REPLACEMENTS TEN FEET OR LESS IN CONTIGUOUS LENGTH (REPAIRS): IT IS ACCEPTABLE PRACTICE TO MATCH ADJACENT SIDEWALKS AT THE EXISTING SLOPE.


CURB RAMP REPLACEMENTS:

SIDEWALK REPLACEMENT BEYOND THE LIMITS OF THE LANDING AREA AND/OR THE "KEYSTONE" MUST BE EXTENDED A MINIMUM OF AN AN ADDITIONAL FIVE FEET (5') EITHER SIDE IN ORDER TO PROVIDE A REASONABLE TRANSITION TO MATCH THE EXISTING SIDEWALK. THE TRANSITION SHALL BE LENGTHENED AS NECESSARY TO ENSURE THAT THE RUNNING SLOPE OF THE TRANSITION DOES NOT EXCEED A SLOPE OF 1:24 (PREFERRED) OR 1:14 (MAXIMUM) AT ANY POINT.

NO EXCEPTIONS TO THE ABOVE WILL BE ALLOWED WITHOUT WRITTEN APPROVAL FROM THE COMMISSIONER.

* THE DECLUDEMENTS OF SECTION LISHAUL ADDLY ONLY TO CITY ACENCIES

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ı	City of Chicago	DATE	REVISION		CITY OF CUICAGO		
	Richard M. Daley, Mayor Thomas G. Byron. Commissioner Department of Francocrastion Division of Engineering	02/20/07	REVISION 1				
-	Division of Engineering	11/15/07	REVISION 2	ADA COMPLIAN	ICE AND TRANSITION G	UIDELINES	
	GDOT				CUEET D A A		
	EDO!			SCALE: NOT TO SCALE DATE: 10/23/2006	SHEET B-3-3	DRAWN BY: CDOT CHECKED BY: LCM	
	CHICAGE NEWS NINES AN INCOME PARTICIPA	l		L		OTILORED DT. EON	

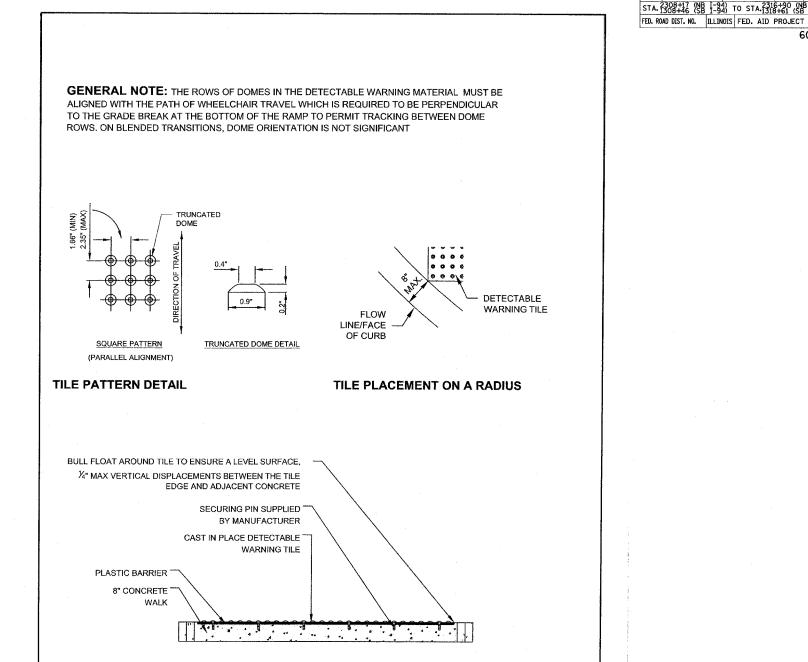

DETECTABLE TILE WARNING SECTION

©DOT

DATE

02/20/0

REVISION

REVISION 1

ILLINOIS DEPARTMENT OF TRANSPORTATION F.A.I. 94 (DAN RYAN EXPRESSWAY) CITY OF CHICAGO STANDARD DETAILS DETAILS OF CURB RAMPS FOR PEOPLE WITH DISABILITIES SHEET 2 OF 3 SCALE: NONE DRAWN BY: CDOT

CITY OF CHICAGO

DETECTABLE WARNING TILE DETAILS

SHEET B-4-2

SCALE: NOT TO SCALE

SECTION 94 2005-070 LS


COOK

STA. 2308+17 (NB I-94) TO STA. 2316+90 (NB I-94) TO STA. 1318+61 (SB I-94)

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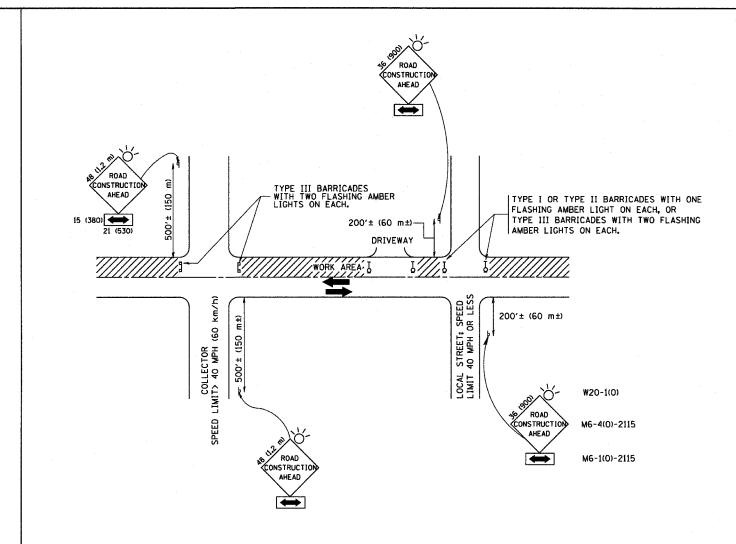
DATE: MAY 1, 2008

CHECKED BY:

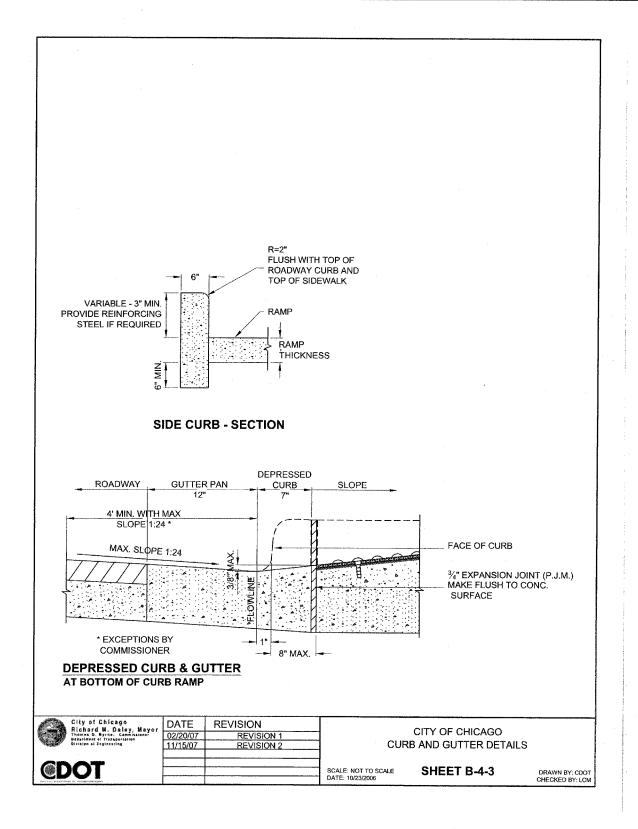

F.A.I. RTE.	SECTION		COUN	ΓY	TOTAL SHEETS	SHE
94	2005-070	LS	COOL	(65	5
STA.	2308+17 (NB 1308+46 (SB	I-94) I-94)	TO ST	A. 231	6+90 (N 3+61 (SE	B I-9
FED. RO	AD DIST. NO.	ILLINOIS	FED.	AID	PROJEC1	Γ

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TRAFFIC CONTROL AND PROTECTION FOR SIDE ROADS, INTERSECTIONS, AND DRIVEWAYS

NOTES:

- A. FOR NO LANE RESTRICTION ON THE SIDE ROAD OR DRIVEWAYS
- 1. SIDE ROAD WITH A SPEED LIMIT OF 40 MPH (60 km/h) OR LESS AS SHOWN ON THE DRAWING AND AS DIRECTED BY THE ENGINEER:
- O) ONE ROAD CONSTRUCTION AHEAD SIGN 36 x 36 (900x900) WITH A FLASHER AND FLAG MOUNTED ON IT APPROXIMATELY 200' (60 m) IN ADVANCE OF THE MAIN ROUTE.
- b) the closed portion of the main route shall be protected by blocking with type I, type II or type III barricades, 1/3 of the cross section of the closed portion.
- 2. SIDE ROAD WITH A SPEED LIMIT GREATER THAN 40 MPH (60 km/h) AS SHOWN ON THE DRAWING AND AS DIRECTED BY THE ENGINEER:
- O) ONE ROAD CONSTRUCTION AHEAD SIGN 48 x 48 (1.2 m x 1.2 m) WITH A FLASHER MOUNTED ON IT APPROXIMATELY 500' (150 m) IN ADVANCE OF THE MAIN ROUTE
- b) THE CLOSED PORTION OF THE MAIN ROUTE SHALL BE PROTECTED BY BLOCKING WITH TYPE III BARRICADES, 1/2 OF THE CROSS SECTION OF THE CLOSED PORTION.

SCALE: NONE

3. WHEN THE SIDE ROAD LIES BETWEEN THE BEGINNING OF THE MAINLINE SIGNING AND THE WORK ZONE, A SINGLE HEADED ARROW (M6-1) SHALL BE USED IN LIEU OF THE DOUBLE HEADED ARROW (M6-4).

B. FOR A LANE CLOSURE ON A SIDE ROAD OR DRIVEWAY:

USE APPLICABLE PORTIONS OF THE TYPICAL APPLICATION OF TRAFFIC CONTROL DEVICES (STD. 701501, STD. 701606 OR THE APPROPRIATE STANDARD). THE SPACING OF SIGNS AND BARRICADES SHALL BE ADJUSTED FOR FIELD CONDITIONS AS DIRECTED BY THE ENGINEER. THE DIRECTIONAL ARROW SHALL BE COVERED OR REMOVED WHEN NO LONGER CONSISTENT WITH THE SIDE ROAD LANE CLOSURE.


- C. ADVANCE WARNING SIGNS ARE TO BE OMITTED ON DRIVEWAY UNLESS OTHERWISE NOTED.
- D. THE TRAFFIC CONTROL AND PROTECTION FOR SIDE ROADS, INTERSECTIONS, AND DRIVEWAYS SHALL BE INCIDENTAL TO THE COST OF SPECIFIED TRAFFIC CONTROL STANDARDS OR ITEMS.


All dimensions are in millimeters (inches) unless otherwise shown.


ı	FILE NAME =	USER NAME = gaglianobt	DESIGNED ~ LHA	REVISED - J. OBERLE 10-18-95
	W:\diststd\22x34\tc10.dgn		DRAWN -	REVISED - A. HOUSEH 03-06-96
		PLOT SCALE = 50.000 '/ IN.	CHECKED -	REVISED - A. HOUSEH 10-15-96
	•	PLOT DATE = 1/4/2008	DATE - 06-89	REVISED -T. RAMMACHER 01-06-00

STATE OF ILLINOIS
DEPARTMENT OF TRANSPORTATION

TRA	AFFI	C	CON	TR	OL AND	PROTEC	TION	FOR		
SIDE	ROA	D:	s, IN	TEF	RSECTION	IS, AND	DRIV	EWAYS		
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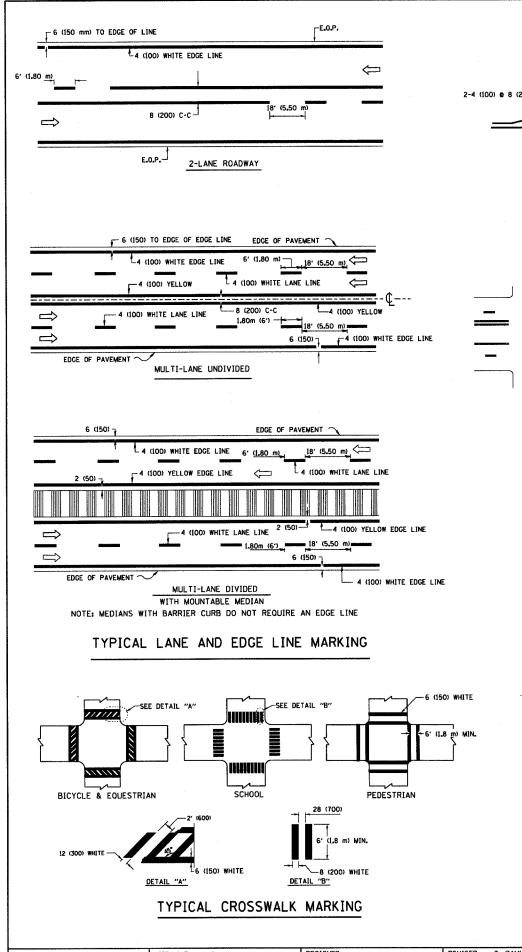


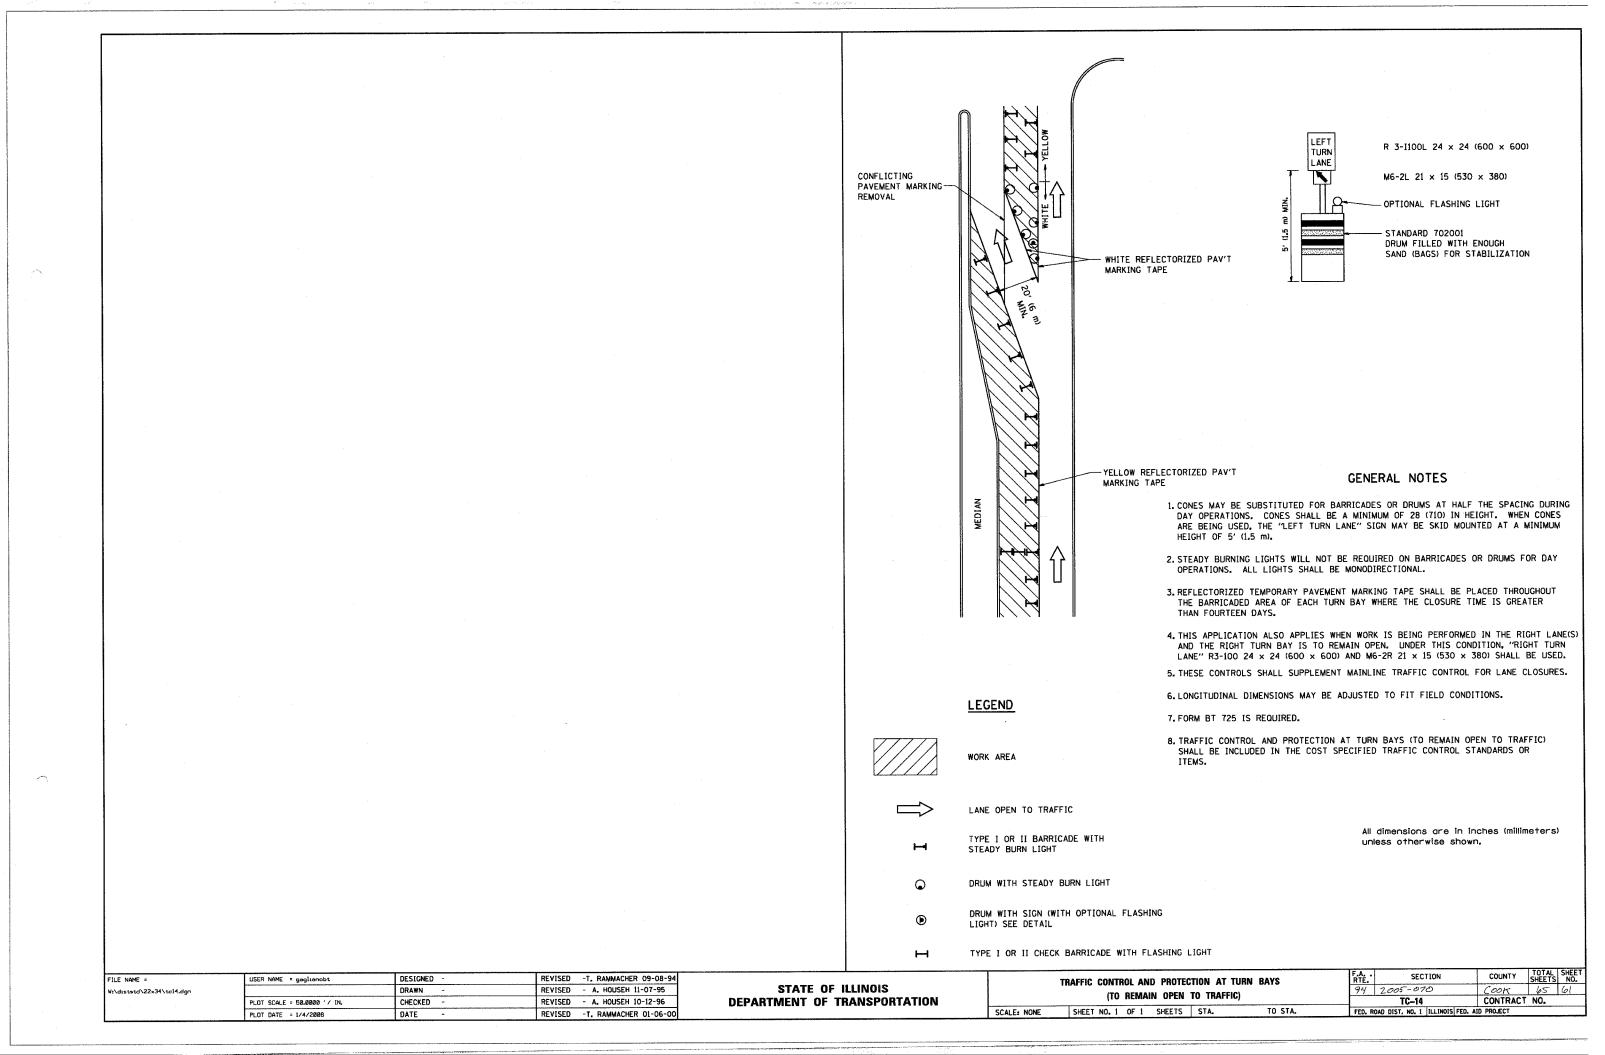
NOTES:

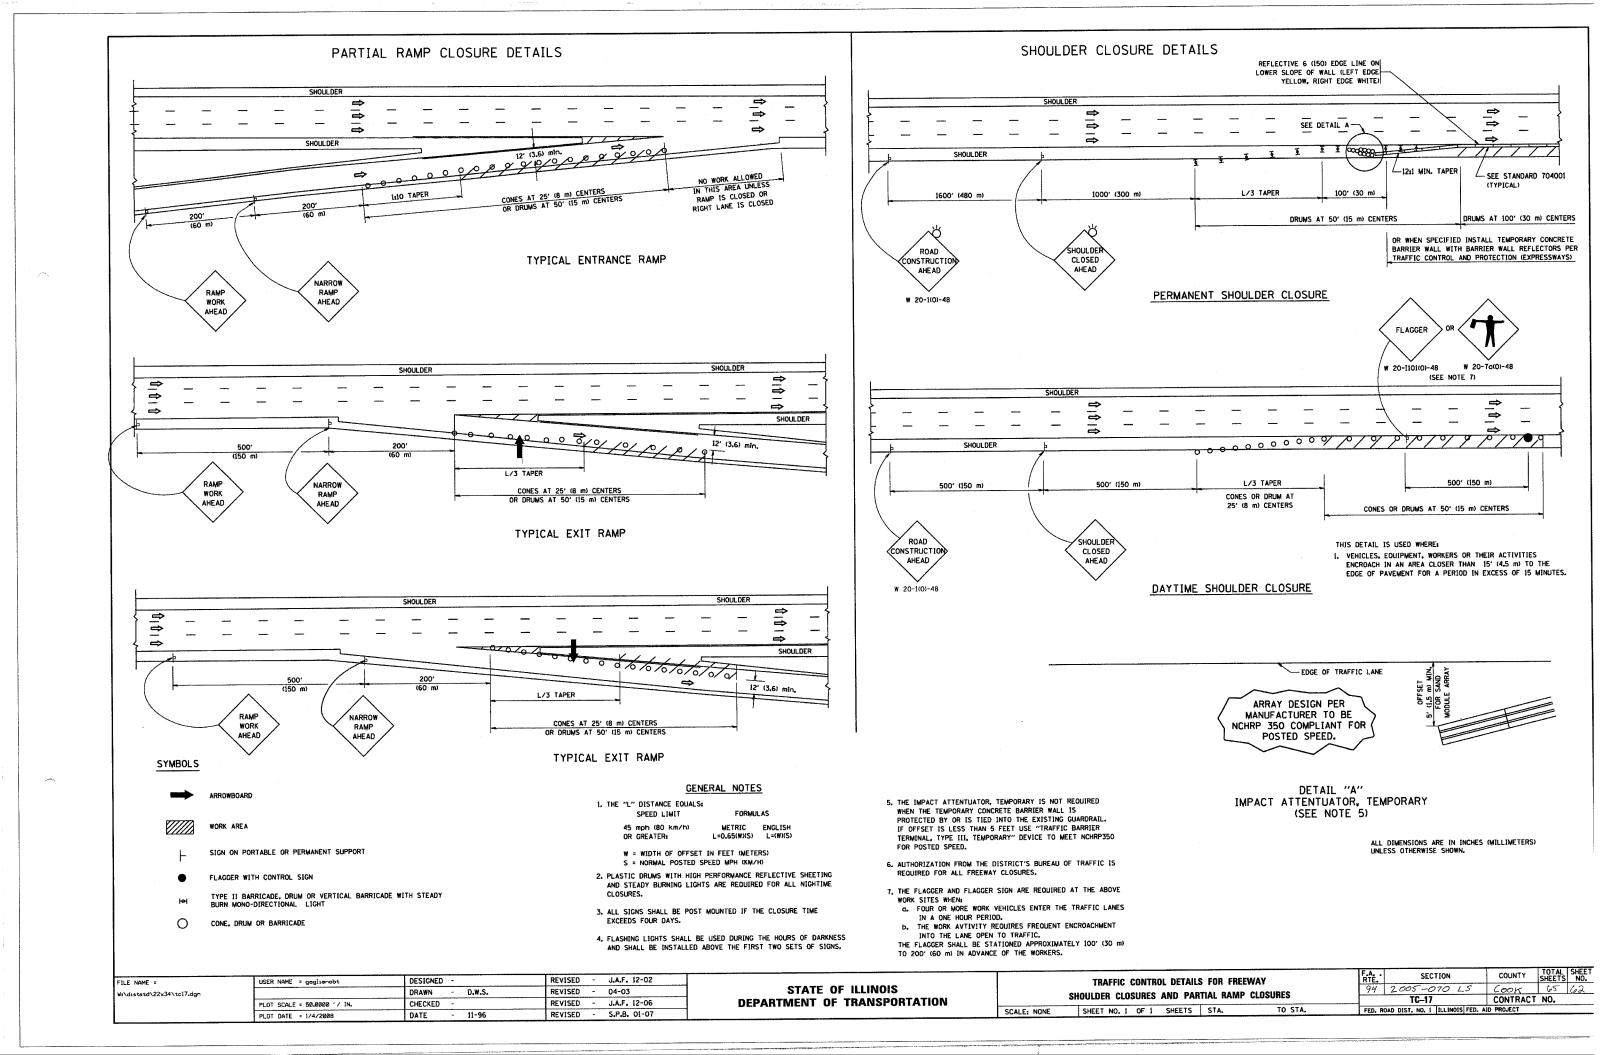- 1. USE BLACK LETTERING ON ORANGE BACKGROUND.
- 2. ERECT SIGNS IN ADVANCE OF THE LOCATION FOR THE "ROAD CONSTRUCTION AHEAD" SIGN AT LOCATIONS AS DIRECTED BY THE ENGINEER.
- 3. ERECT SIGN (1) WITH INSTALLED PANEL (2) ONE WEEK PRIOR TO THE START OF CONSTRUCTION.
- 4. REMOVE PANEL (2) SOON AFTER THE START OF CONSTRUCTION.
- 5. SEE SPECIAL PROVISION FOR "TEMPORARY INFORMATION SIGNING" FOR ADDITIONAL INFORMATION.
- 6. ONE SIGN ASSEMBLY EQUALS 25.70 SQ. FT. (2.3 SQ. M.)
- 7. SHALL BE PAID FOR AS TEMPORARY INFORMATION SIGNING.

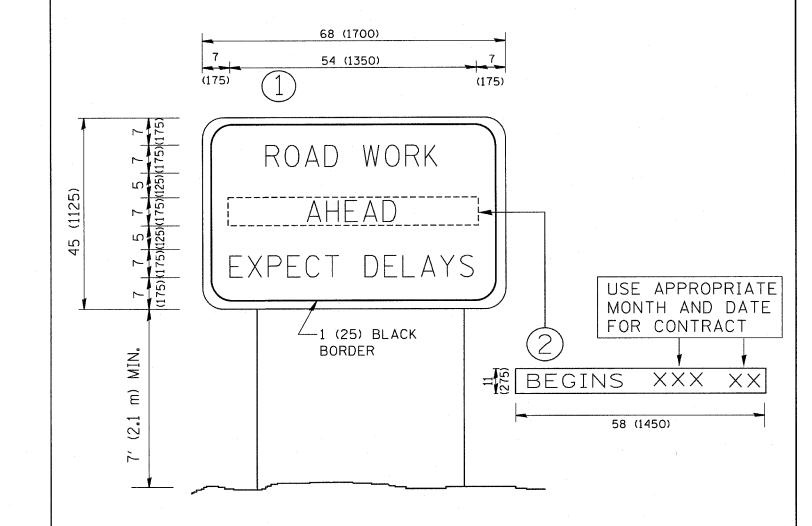ALL DIMENSIONS ARE IN INCHES (MILLIMETERS) UNLESS OTHERWISE SHOWN.

- !	FILE NAME =	USER NAME * gaglianobt	DESIGNED -	REVISED -	R. MIRS 09-15-97					RTERIAL I			RTÉ.	SECTION	COUNTY	SHEETS	NO.
	W:\diststd\22x34\tc22.dgn		DRAWN -	REVISED -	R. MIRS 12-11-97	STATE OF ILLINOIS							94	2005-070 LS	COOK	65 6	,3
		PLOT SCALE = 50.000 '/ IN.	CHECKED -	REVISED -T. F	RAMMACHER 02-02-99	DEPARTMENT OF TRANSPORTATION	INFORMATION SIGN	TC-22	CONTRAC	T NO.							
		PLOT DATE = 1/4/2008	DATE -	REVISED -	C. JUCIUS 01-31-07		SCALE: NONE	SHEET NO.	1 OF 1	SHEETS	STA.	TO STA.	FED. RO	DAD DIST. NO. 1 ILLINOIS FED. A	ID PROJECT		




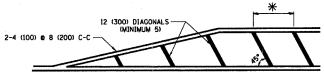


*FOR MEDIAN LENGTHS WHERE DIAGONAL SPACING
CANNOT BE ATTAINED, USE 5 (FIVE) EQUALLY SPACED
DIAGONAL LINES

* DIAGONAL LINE SPACING: 20' (6.1 m) C-C

PAINTED MEDIANS

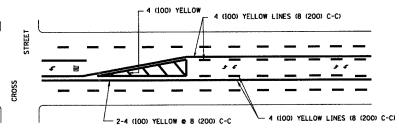


A MINIMUM OF TWO PAIRS OF TURN ARROWS SHALL BE USED, WHITE IN COLOR. ADDITIONAL PAIRS SHALL BE PLACED AT 200' (60 m) TO 300' (90 m) INTERVALS.

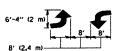

MEDIAN WITH TWO-WAY LEFT TURN LANE

TYPICAL PAINTED MEDIAN MARKING

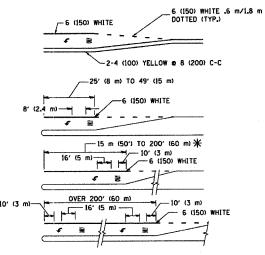


FULL SIZE LETTERS 8' (2.4 m) AND ARROWS SHALL BE USED. \P AREA = 15.8 SQ. FT. (1.47 m²) \P AREA = 22.9 SQ. FT. (2.13 m²)

* TURN LANES IN EXCESS OF 400' (120 m) IN LENGTH MAY HAVE AN ADDITIONAL SET OF ARROW - "ONLY" INSTALLED MIDWAY BETWEEN THE OTHER TWO SETS OF ARROW - "ONLY".

TYPICAL LEFT (OR RIGHT) TURN LANE

TYPICAL TURN LANE MARKING

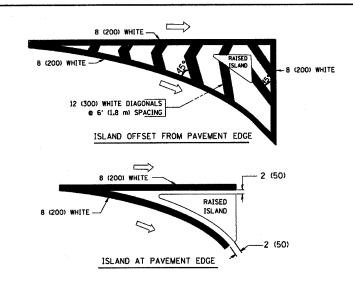

TYPICAL ISLAND MARKING

TYPE OF MARKING	WIDTH OF LINE	PATTERN	COLOR	SPACING / REMARKS
CENTERLINE ON 2 LANE PAVEMENT	4 (100)	SKIP-DASH	YELLOW	6' (1.80 m) LINE WITH 18' (5.50 m) SPACE
CENTERLINE ON MULTI-LANE UNDIVIDED PAVEMENT	2 @ 4 (100)	SOLID	YELLOW	8 (200) C-C
NO PASSING ZONE LINES: FOR ONE DIRECTION FOR BOTH DIRECTIONS	4 (100) 2 c 4 (100)	SOLID SOLID	YELLOW YELLOW	8 (200) C-C
LANE LINES	4 (100) 5 (125) ON FREEWAYS	SKIP-DASH SKIP-DASH	WHITE WHITE	6' (1.80 m) LINE WITH 18' (5.50 m) SPACE
DOTTED LINES (EXTENSIONS OF CENTER, LANE OR TURN LANE MARKINGS)	SAME AS LINE BEING EXTENDED	SKIP-DASH	SAME AS LINE BEING EXTENDED	2' (600) LINE WITH 6' (1.8) SPACE
EDGE LINES	4 (100)	SOLID	YELLOW-LEFT WHITE-RIGHT	OUTLINE MOUNTABLE MEDIANS IN YELLOW: EDGE LINES ARE NOT USED NEXT TO BARRIER CURB
TURN LANE MARKINGS	6 (150) LINE; FULL SIZE LETTERS & SYMBOLS (8' (2.4 m))	SOLID	WHITE	SEE TYPICAL TURN LANE MARKING DETAIL
TWO WAY LEFT TURN MARKING	2 @ 4 (100) EACH DIRECTION	SKIP-DASH AND SOLID	YELLOW	6' (1,8 m) LINE WITH 18' (5,50 m) SPACE FOR SKIP-DASH; 8 (200) C-C BETWEEN SOLID LINE AND SKIP-DASH LINE
	8' (2.4 m) LEFT ARROW	IN PAIRS	WHITE	SEE TYPICAL TWO-WAY LEFT TURN MARKING DETAIL
CROSSWALK LINES (PEDESTRIAN) A. DIAGONALS (BIKE & EQUESTRIAN) B. LONGITUDINAL BARS (SCHOOL)	2 e 6 (150) 12 (300) e 45° 8 (200) e 90°	SOLID SOLID SOLID	WHITE WHITE WHITE	NOT LESS THAN 6' (1.8 m) APART 2' (600) APART 2'-4" (700) APART SEE TYPICAL CROSSWALK MARKING DETAILS.
STOP LINES	24 (600)	SOLID	WHITE	PLACE 4' (1.2 m) IN ADVANCE OF AND PARALLEL TO CROSSWALK, IF PRESENT. OTHERWISE, PLACE AT DESIRED STOPPING POINT. PARALLEL TO CROSSROAD CENTERLINE, WHERE POSSIBLE
PAINTED MEDIANS	2 @ 4 (100) WITH 12 (300) DIAGONALS @ 45°	SOLID	YELLOW: TWO WAY TRAFFIC WHITE: ONE WAY TRAFFIC	8 (200) C-C FOR THE DOUBLE LINE SEE TYPICAL PAINTED WEDIAN WARKING.
CORE MARKING AND CHANNELIZING LINES	8 (200) WITH 12 (300) DIAGONALS & 45°	SOLID	WHITE	DIAGONALS; 20' (6.1 m) (LESS THAN 30 MPH (50 km/h))
RAILROAD CROSSING	24 (600) TRANSVERSE LINES: "RR" IS 6' (1.8 m) LETTERS: 16 (400) LINE FOR "X"	SOLID	WHITE	SEE STATE STANDARD 780001 AREA OF: "R"3.6 SO. FT. (0.33m ²) EACH "X"=54.0 SO. FT. (5.0 m ²)


FOR FURTHER DETAILS ON PAYEMENT MARKING REFER TO STREET MARKING STANDARDS, PRINTED BY CITY OF CHICAGO, DEPARTMENT OF TRANSPORTATION, BUREAU OF TRAFFIC.


ALL DIMENSIONS ARE IN INCHES (MILLIMETERS)
UNLESS OTHERWISE SHOWN.

FILE NAME =	USER NAME = gaglianobt	DESIGNED -	REVISED -T. RAMMACHER 12-07-00
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	PLOT SCALE = 50.000 '/ IN.	CHECKED -	REVISED -
	PLOT DATE = 1/4/2008	DATE -	REVISED -

STATE OF ILLINOIS DEPARTMENT OF TRANSPORTATION

CITY OF CHICAGO Typical pavement markings				F.A RTE.	SECTION	COUNTY	TOTAL	SHEET NO.
				94	2005-070 LS	COOK	65	64
					TC-24	CONTRACT NO.		
SCALE: NONE	SHEET NO. 1 OF 2 SHEETS	STAL	TO STA.	FED. ROAD DIST. NO. 1 ILLINOIS FED. AID PROJECT				

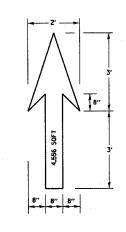


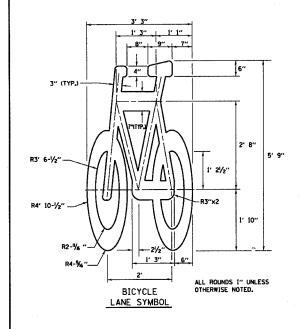

- NOTE:

 1.) FOR BIKE LANE SYMBOLS ONLY,
 USE PRE-FORMED THERMOPLASTIC WITH A MINIMUM THICKNESS OF 90 MILS. MINIMUM SKID RESISTANCE VALUE OF 60 BPN, & A MINIMUM INDEX OF REFRACTION OF 1.50.
- 2.) THE RESIDENT ENGINEER SHALL CONTACT MR. BEN GOMBERG AT 312-744-8093 AT LEAST ONE CALENDAR WEEK PRIOR TO INSTALLING BIKE LANE SYMBOLS.

TYPICAL BIKE LANE SYMBOLS
DRAWING *28

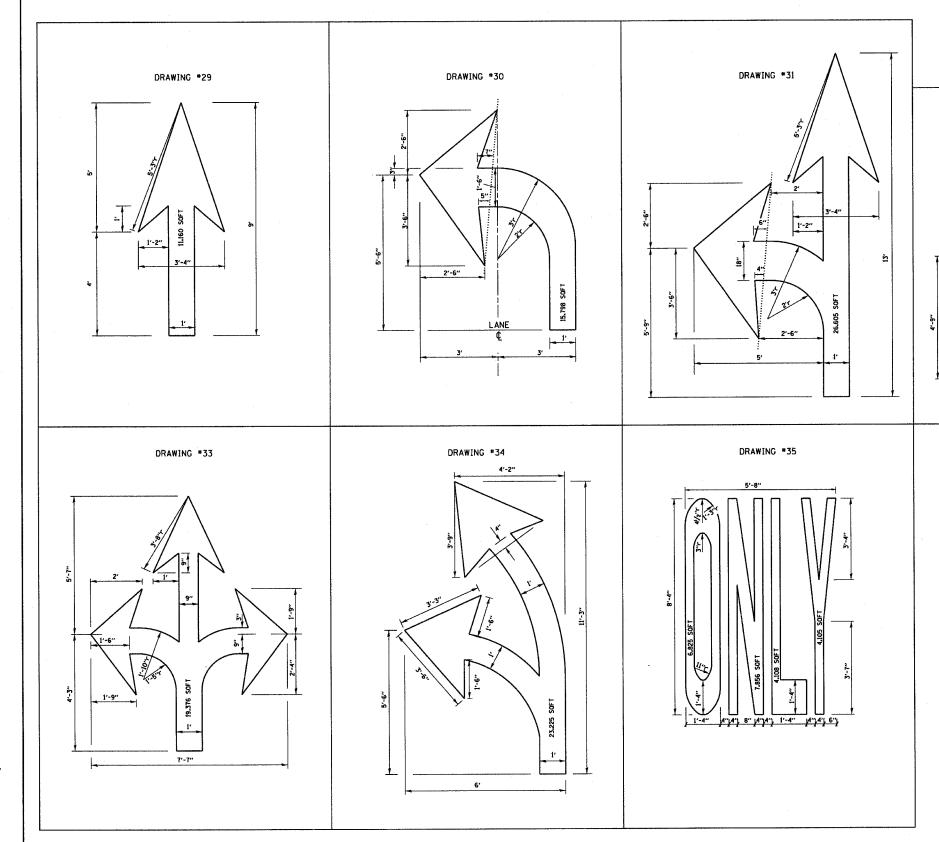

NOTE:

ALL MARKINGS SHALL BE SOLID WHITE UNLESS OTHERWISE NOTED IN THE

DRAWING #32

FILE NAME =	USER NAME = geglien
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	PLOT DATE = 1/4/2008	DATE -	REVISED -
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STATE OF ILLINOIS
DEPARTMENT OF TRANSPORTATION

	CITY OF CHICAGO			F.A RTE.	SECTION	COUNTY	TOTAL SHEETS	SHEET NO.		
	TYPICAL PAVEMENT MARKINGS				94	2005-070 LS	COOK	65	65	
					TC-24		CONTRACT NO.			
1	SCALE: NONE	SHEET NO. 2 OF 2	SHEETS	STA.	TO STA.	FED. ROAD DIST. NO. 1 ILLINOIS FED. AID PROJECT				