07-31-2015 LETTING ITEM 021

STATE OF ILLINOIS

DEPARTMENT OF TRANSPORTATION

DIVISION OF HIGHWAYS

FOR INDEX OF SHEETS, SEE SHEET NO. 2

PROJECT LOCATED IN THE CITY OF CHICAGO

PROPOSED HIGHWAY PLANS

HSB RTE 393: CHINATOWN FEEDER UNDER I-90 /94 (DAN RYAN EXPRESSWAY) **SECTION 2014-091I** MISCELLANEOUS, INSPECTION ACCESS **COOK COUNTY** C-91-201-15

TRAFFIC DATA POSTED SPEED: 45 MPH **FUNCTIONAL CLASSIFICATION:** T. 39 N. INTERSTATE ADT = 24,800 (2002)PROJECT LOCATION 27TH ST 28TH PL FULL SIZE PLANS HAVE BEEN PREPARED USING STANDARD ENGINEERING SCALES. REDUCED SIZED PLANS WILL NOT 29TH ST CONFORM TO STANDARD SCALES. IN MAKING MEASUREMENTS ON REDUCED PLANS, THE ABOVE SCALES MAY BE USED.

27TH ST LOCATION MAP

LOUIS VARRIGONY
LICENSED PROFESSIONAL ENGINEER
ILLINOIS NO. 052-046548 EXPIRES 11-30-15
SHEETS 1-7, 17-18

EMAB ELGAG LICENSED PROFESSIONAL ENGINEER

GROSS LENGTH = 450 FT. = 0.085 MILE NET LENGTH = 450 FT. = 0.085 MILE



D-91-201-15

2014-0911

COOK 21 1 ILLINOIS CONTRACT NO. 62448



STATE OF ILLINOIS DEPARTMENT OF TRANSPORTATION

PRINTED BY THE AUTHORITY OF THE STATE OF ILLINOIS

CHICAGO UTILITY ALERT NETWORK

CONTRACT NO. 62A48

PROJECT MANAGER: ISSAM RAYYAN, P.E. (847) 705-4178

PROJECT ENGINEER: ROBERT T. BORO, P.E. (847) 705-4237

1-312-744-7000

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INDEX OF SHEETS

SHEET NO.	DESCRIPTION
1	COVER SHEET
2	INDEX OF SHEETS, STATE STANDARDS AND GENERAL NOTES
3 - 5	SUMMARY OF QUANTITIES
6	TYPICAL SECTIONS
7	SCHEDULE OF QUANTITIES
8	PLAN SHEET
9	EXISTING LIGHTING DEMOLITION PLAN
10	PROPOSED LIGHTING RELOCATION PLAN & WIRING DIAGRAM
11	TEMPORARY LIGHTING SYSTEM PLAN
12	MISC. ELECTRICAL DETAILS. SHEET A (BE-702)
13	MISC. ELECTRICAL DETAILS, SHEET B (BE-703)
14	TEMPORARY LIGHT POLE DETAILS (BE-800)
15	ENTRANCE AND EXIT RAMP CLOSURE DETAILS (TC-08)
16	TRAFFIC CONTROL DETAILS FOR FREEWAY SINGLE & MULTI-LANE WEAVE (TC-D9)
17	TRAFFIC CONTROL DETAILS FOR FREEWAY SHOULDER CLOSURES AND PARTIAL RAMP CLOSURES (TC-17)
18	FREEWAY / EXPRESSWAY SIGNING FOR FLAGGING OPERATIONS AT WORK ZONE OPENINGS ON FREEWAYS / EXPRESSWAYS (TC-18)
19	TRAFFIC CONTROL DETAILS FOR FREEWAY CENTER LANE CLOSURE SHOULDER LANE (TC-25)
20 - 21	CROSS SECTIONS

STATE STANDARDS

001001-02	AREAS OF REINFORCEMENT BARS
280001-07	TEMPORARY EROSION CONTROL SYSTEMS
482001-02	HMA SHOULDER ADJACENT TO FLEXIBLE PAVEMENT
635011-02	REFLECTOR MARKER AND MOUNTING DETAILS
637006-03	CONCRETE BARRIER, DOUBLE FACE, 42 IN. HEIGHT
701101-04	OFF ROAD OPERATIONS, MULTILANE, 15' TO 24" FROM PAVEMENT EDGE
701106-02	OFF ROAD OPERATIONS. MULTILANE, MORE THAN 15' AWAY
701400-08	APPROACH TO LANE CLOSURE, FREEWAY / EXPRESSWAY
701401-09	LANE CLOSURE, FREEWAY / EXPRESSWAY
701406-09	LANE CLOSURE, FREEWAY / EXPRESSWAY, DAY OPERATIONS ONLY
701411-09	LANE CLOSURE, MULTILANE, AT ENTRANCE OR EXIT RAMP, FOR SPEEDS >= 45 MPH
701428	TRAFFIC CONTROL SETUP AND REMOVAL - FREEWAY / EXPRESSWAY
701446-06	TWO LANE CLOSURE - FREEWAY / EXPRESSWAY
701901-D4	TRAFFIC CONTROL DEVICES
704001-07	TEMPORARY CONCRETE BARRIER
821101-01	LUMINAIRE WIRING DIAGRAM
836011-01	LIGHT POLE FOUNDATION WITH 42 IN, CONCRETE MEDIAN BARRIER

OCCODI-OG STANDARD SYMBOLS, ABBREVIATIONS AND PATTERNS

GENERAL NOTES

- 1. BEFORE STARTING ANY EXCAVATION. THE CONTRACTOR SHALL CALL "DIGGER" AT (312) 744-7000 FOR FIELD LOCATIONS OF BURIED ELECTRIC, TELEPHONE AND GAS FACILITIES. 48-HOUR MINIMUM NOTIFICATION IS REQUIRED.
- 2. THE CONTRACTOR WILL NOT BE ALLOWED TO SET UP A YARD OR FIELD OFFICE ON STATE PROPERTY WITHOUT WRITTEN PERMISSION FROM THE DEPARTMENT.
- 3. ANY DAMAGE TO EXISTING PAVEMENT MARKINGS OR RAISED REFLECTIVE PAVEMENT MARKERS SHALL BE REPLACED AT THE CONTRACTOR'S EXPENSE.
- 4. IT SHALL BE THE CONTRACTOR'S RESPONSIBILITY TO VERIFY ALL DIMENSIONS AND CONDITIONS IN THE FIELD PRIOR TO CONSTRUCTION AND ORDERING OF MATERIALS.
- 5. DO NOT SCALE PLANS FOR CONSTRUCTION DIMENSIONS.
- 6. THE CONTRACTOR SHALL CONTACT THE DISTRICT ONE TRAFFIC CONTROL SUPERVISOR FOR EXPRESSWAYS AT (847) 705-4155 A MINIMUM OF 72 HOURS IN ADVANCE OF BEGINNING OF WORK.
- 7. ALL EXCAVATED SOILS FROM THE PROJECT SITE SHALL BE RE-USED AS FILL OR TOPSOIL AT THE PROJECT SITE. NO EXCAVATED SOILS FROM THE PROJECT SITE MAY BE DISPOSED OF AT ANY OFFSITE LOCATION.
- 8. THE CONTRACTOR SHALL COORDINATE CONSTRUCTION ACTIVITIES WITH UTILITY COMPANIES AND THE CITY OF CHICAGO.
- 9. ANY LOOSE MATERIAL DEPOSITED IN THE FLOW LINE OF DITCHES, GUTTERS DR OTHER DRAINAGE STRUCTURES SHALL BE REMOVED BY THE END OF EACH DAY BY THE CONTRACTOR AT THEIR EXPENSE.

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	DRAWN	^	KJC	REVISED	*	
OF SCALE + NTS	CHECKED	~	LVA	REVISED	*	
OT DATE 4 4/7/2015	DATE	-	04/07/2015	REVISED	-	

STATE OF ILLINOIS

-	HSB	RTE 393	: CHINA	TOWN	FEEDER UN	DER 1-90 /94
	INDEX O	F SHEETS	, STATE	STAN	DARDS AND	GENERAL NOTES
-	SCALE: NTS	SHEET	1 OF	l SHE	ETS STA.	TO STA.

COUNTY TOTAL SHEET NO. SECTION 2014-0911 CONTRACT NO. 62A48

Sheets/0162448-sht-590,dgn	
62-154-8671\Design\Civil\CA00	
FEEDER	

			URR	3AN 100% STAT
			4	ROADWAY
1 C	CODE NO.	ITEM		OTAL 0005 NTITY
2	0200100	EARTH EXCAVATION	CU YD 1	39 139
			2010	139
20	0201200	REMOVAL AND DISPOSAL OF UNSUITABLE MATERIAL	CU YD	14 14
21	8000510	INLET FILTERS	EACH	5 5
4(0200 4 00	AGGREGATE SURFACE COURSE. TYPE B	CHANG	
		NOONEDATE SONT NOT COOKSET. THE P	CU YD 2	70 270
40	0600275	BITUMINOUS MATERIALS (PRIME COAT)	POUND (55 65
42	2001300	PROTECTIVE COAT	SO YD 1	20 120
44	4001980	CONCRETE BARRIER REMOVAL	F00T 1	20 120
48	3203021	HOT-MIX ASPHALT SHOULDERS. 6"	SO YD S	95 95
60	255500	MANHOLES TO BE ADJUSTED	EACH	1 1
63	3700175	CÓNCRETE BARRIER, SINCLE FACE. 42 INCH HEIGHT	F00T 12	3. 5 123. 5
67	100100	MOBILIZATION	L SUM	1 1
-				
10	200100	NIGHTTIME WORK ZONE LIGHTING	L SUM	1
70	300240	TEMPORARY PAVEMENT MARKING - LINE 6"	F00T 13	7. 5 137. 5
70	301000	WORK ZONE PAVEMENT MARKING REMOVAL	SO FT 6	9 69



	USER NAME = KyloC	DESIGNED	-	KJC	REVISED	-
		DRAWN	-	KJĆ	REVISED	-
	PLOT SCALE . NTS	CHECKED	-	LVA	REVISED	-
,	PLOT DAY6 × 4/7/2015	DATE	-	04/07/2015	REVISED	*

HSB	RTE	393; CH	INAT	0W	N FEE	DER	UNDER	I-90 /9	4
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SCALE: NTS	SHEE	T 1	0F	3	SHEETS	STA.		TO ST	Α.

					100% STATE
					ROADWAY
				TOTAL	0005
SI	CODE NO.	ITEM	TINU	OUANTITY	
	70400100	TEMPORARY CONCRETE BARRIER	FOOT	137.5	137.5
	70600251	IMPACT ATTENUATORS, TEMPORARY (NON- REDIRECTIVE, NARROW), TEST LEVEL 3	EACH	l	
	78200530	BARRIER WALL MARKERS, TYPE C	EACH	4	4
*	80300100	LOCATING, UNDERGROUND CABLE	FOOT	50	50
*	81025300	CONDUIT ENCASED, REINFORCED CONCRETE, 2" DIA., PVC 2 WIDE X 1 HIGH	FOOT	5	5
*	81025600	CONDUIT ENCASED. REINFORCED CONCRETE, 4" DIA., PVC 2 WIDE X 1 HIGH	FOOT	5	5
×	81028200	UNDERGROUND CONDUIT, GALVANIZED STEEL, 2" DIA.	FOOT	20	20
*	81028240	UNDERGROUND CONDUIT, GALVANIZED STEEL. 4" DIA.	FOOT	15	15
*	81200230	CONDUIT EMBEDDED IN STRUCTURE. 2" DIA., PVC	FOOT	110	110
*	81702400	ELECTRIC CABLE IN CONDUIT, 600V (XLP-TYPE USE) 3-1/C ND. 2	FOOT	229	229
 -	K0029632	WEED CONTROL, NON-SELECTIVE AND NON-RESIDUAL	CALLON	0.5	0.5
	K0029634	WEED CONTROL. PRE-EMERGENT GRANULAR HERBICIDE	POUND	25	25
	X0326169	GRADING EXISTING INFIELD	S0 Y0	2175	2175
	V2011015	TRACCIC CONTROL AND RROTECTION ACCORDER			
	X7011015	TRAFFIC CONTROL AND PROTECTION (EXPRESSWAYS)	L SUM	1	1

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* SPECIALTY ITEM



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HSB RTE 393: CHINATOWN						EDER (JNDER	I-90 /	/94
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SCALE: NTS	SHEE	7 2	OF	3	SHEETS	ŞTA,		TO	STA.

	COUNTY	SHEETS	NO.
393 2014-0911	COOK	21	4
	CONTRACT	NO. 62	A48
licinois	FED. AID PROJECT		

URBAN

100% STATE

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					100% STATE
51	CODE NO.	ITEM	JALT	TOTAL OUANTITY	ROADWAY 0005
			recommendate to the state of th		
	x7040125	PINNING TEMPORARY CONCRETE BARRIER	EACH	27	27 .
×	X8100863	INTERCEPT EXISTING CONDUIT	EACH	3	3
			The state of the s		
¥	X8131168	JUNCTION BOX, NON-METALLIC. EMBEDDED IN STRUCTURE, 21" X 11" X 08"	EACH	3	3
¥	X8410102	TEMPORARY LIGHTING SYSTEM	L SUM	1	1
			annum para		
*	X8410103	REMOVE TEMPORARY LIGHTING SYSTEM	L SUM	1	1
	Z0015500	DEBRIS REMOVAL	L SUM	1	1
	Z0018500	DRAINAGE STRUCTURES TO BE CLEANED	EACH	5	5
*	Z0033028	MAINTENANCE OF LIGHTING SYSTEM	CAL MO	I	1
	2 0013798	CONSTRUCTION LAYOUT	L SLIM	/	1
			The state of the s		-
	44004250	PAVED SHOULDER REMOVAL	50 10	28	28

* SPECIALTY ITEM

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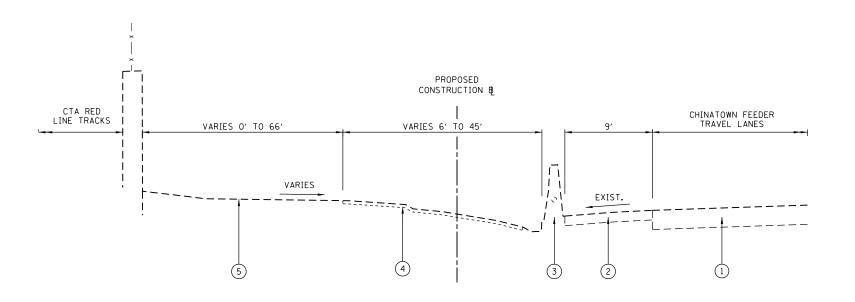
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	DRAWN	-	KJC	REVISED -
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PLOT DATE + 4/7/2015	DATE	-	04/07/2015	REVISED -

STATE OF ILLINOIS
DEPARTMENT OF TRANSPORTATION


HSB RTE 393; CHINATOWN FEEDER UNDER I-90 /94 SUMMARY OF QUANTITIES SCALE: NTS SHEET 3 OF 3 SHEETS STA. TO STA.

Rev.

| COUNTY | TOTAL SHEET |
| 14-091 | COOK | 21 | 5 |
| CONTRACT NO. 62A48 |
| | ILLINOIS|FEO. AIO PROJECT | SECTION 2014-0911



CHINATOWN FEEDER UNDER I-90/94 (DAN RYAN EXPY) EXISTING TYPICAL SECTION

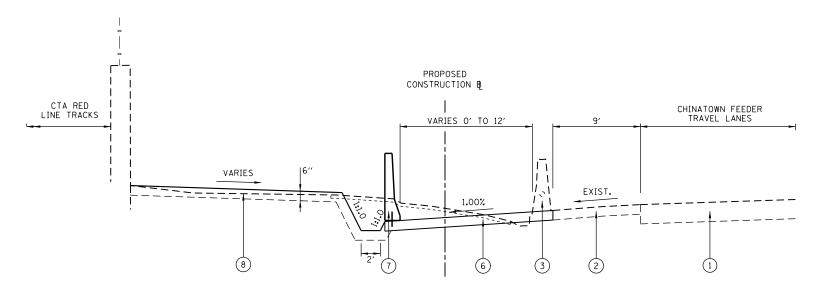

CHINATOWN FEEDER UNDER I-90/94 (DAN RYAN EXPY) PROPOSED TYPICAL SECTION

HOT-MIX ASPHALT MIXTURE REQUIREMENTS

MIXTURE TYPE	AIR VOIDS @ NDES	QUALITY MANAGMENT PROGRAM (QMP)
HOT-MIX ASPHALT SHOULDERS, 6" (HMA BINDER IL-19 MM)	4% @ 50 GYR	QC/QA
OMP DESIGNATION: QUALITY CONTROL/QUALITY		FP)

NOTES:

- 1. THE UNIT WEIGHT USED TO CALCULATE ALL HMA MIXTURE QUANTITIES IS 112 LBS/SQYD/IN.
- 2. QUALITY MANAGEMENT PROGRAM (QMP) IDENTIFIES THE PARTICULAR QUALITY CONTROL SPECIFICATION THAT APPLIES TO THE HMA MIXTURE.
- 3. FOR USE OF RECYCLED MATERIALS, SEE DISTRICT ONE SPECIAL PROVISIONS.
- 4. FOR NON-POLYMERIZED HMA, THE "AC TYPE" SHALL BE "PG 64-22" UNLESS MODIFIED BY DISTRICT ONE SPECIAL PROVISIONS.

LEGEND

- 1 EXISTING PAVEMENT
 2 EXISTING HMA SHOULDER
- 3 EXISTING CONCRETE BARRIER WALL WITH ELECTRICAL IN 2" PVC CONDUIT TO BE REMOVED
- 4 EXISTING INFIELD WITH 2" AGGREGATE SURFACE
- (5) EXISTING INFIELD
- 6 PROP. HOT-MIX ASPHALT SHOULDERS, 6"
- 7 PROP. CONCRETE BARRIER, SINGLE FACE, 42" HEIGHT TO BE ANCHORED TO PROPOSED HMA SHOULDER
- 8 AGGREGATE SURFACE COURSE, TYPE B (6" RIDING SURFACE)



USER NAME = KyleC	DESIGNED - KJC	REVISED -
	DRAWN - KJC	REVISED -
PLOT SCALE = NTS	CHECKED - LVA	REVISED -
PLOT DATE = 6/11/2015	DATE - 04/07/2015	REVISED -

STATE OF ILLINOIS **DEPARTMENT OF TRANSPORTATION**

нѕв	RTE 393: CHINATOWN FEE	DER UNDER 1-90 /94	H.S.B. RTE.	SECTION	COUNTY	TOTAL SHEETS	SHEET NO.
	TYPICAL SECTI	IONS	393	2014-0911	соок	21	6
	TIFICAL SECTI			CONTRACT	NO. 62	448	
SCALE: NTS	SHEET 1 OF 1 SHEETS	STA. TO STA.		ILLINOIS FED. A	D PROJECT		

CHINATOWN FEEDER ACCESS AREA EARTHWORK SCHEDULE

А	В	С	D	E	F	G	Н	I
		EARTH	UNSUITABLE	15% ADJUSTMENT	EARTH	EARTHWORK BALANCE	AGGREGATE	AGGREGATE
FROM STA	TO STA	EXCAVATION	MATERIAL	FOR SHRINKAGE	EMBANKMENT	WASTE(+) SHORTAGE(-)	EXCAVATION	SURFACE COURSE, TY B
		(CU YD)	(CU YD)	(CU YD)	(CU YD)	(CU YD)	(CU YD)	(CU YD)
0+00.00	0+50.00	5.46	0.55	4.18	67.50	-63.32	1.30	59.72
0+50.00	1+00.00	11.48	1.15	8.78	20.83	-12.05	2.50	55.28
1+00.00	1+50.00	17.87	1.79	13.67	13.89	-0.22	4.63	49.63
1+50.00	2+00.00	21.30	2.13	16.29	2.22	14.07	6.85	43.24
2+00.00	2+50.00	25.56	2.56	19.55	0.37	19.18	10.00	36.20
2+50.00	3+00.00	27.96	2.80	21.39	0.74	20.65	11.30	31.76
3+00.00	3+50.00	16.57	1.66	12.68	0.37	12.31	8.15	23.61
3+50.00	4+00.00	7.69	0.77	5.88		5.88	5.46	15.56
4+00.00	4+50.00	4.72	0.47	3.61		3.61	2.59	7.69
TOTAL		139	14	106	106	0	53	323

LEGEND

COLUMNS A AND B: LOCATION ON PLANS

COLUMN C: CUT QUANTITIES FROM CROSS SECTIONS

COLUMN D: = C X O.1

CUT MATERIAL THAT IS DETERMINED TO BE EITHER UNSTABLE OR UNSUITABLE FOR USE IN EMBANKMENT.
ASSUME 10% OF EARTH EXCAVATION.

COLUMN E: = (C - D) X 0.85

EARTH EXCAVATION THAT IS TO BE USED AS FILL MATERIAL IN THE EMBANKMENT.

A SHRINKAGE FACTOR OF 15% IS USED.

COLUMN F: FILL QUANTITIES FROM CROSS SECTIONS

COLUMN G: = E - F

POSITIVE QUANTITY = EXTRA EXCAVATION.

NEGATIVE QUANTITY = FURNISHED EXCAVATION NEEDED.

COLUMN H: AGGREGATE EXCAVATION THAT IS TO BE RE-USED IN AGGREGATE SURFACE COURSE

ASSUMED EXISTING AGGREGATE DEPTH OF 2" (TYP.) THROUGHOUT SITE

COLUMN I: PROPOSED AGGREGATE SURFACE COURSE, TYPE B (6" RESULTANT RIDING SURFACE)




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'	PLOT DATE = 6/11/2015	DATE	-	04/07/2015	REVISED -

HSB	RTE 39	93: C	HINA	\T0'	WN FEI	EDER UI	NDER I-90 /94	H.S.B. RTE.	SECTION
	393	2014-0911							
						ANTITIES			
SCALE: NTS	SHEET	1	OF	1	SHEETS	STA.	TO STA.		ILLINOIS

COUNTY TOTAL SHEETS NO.

COOK 21 7

CONTRACT NO. 62A48

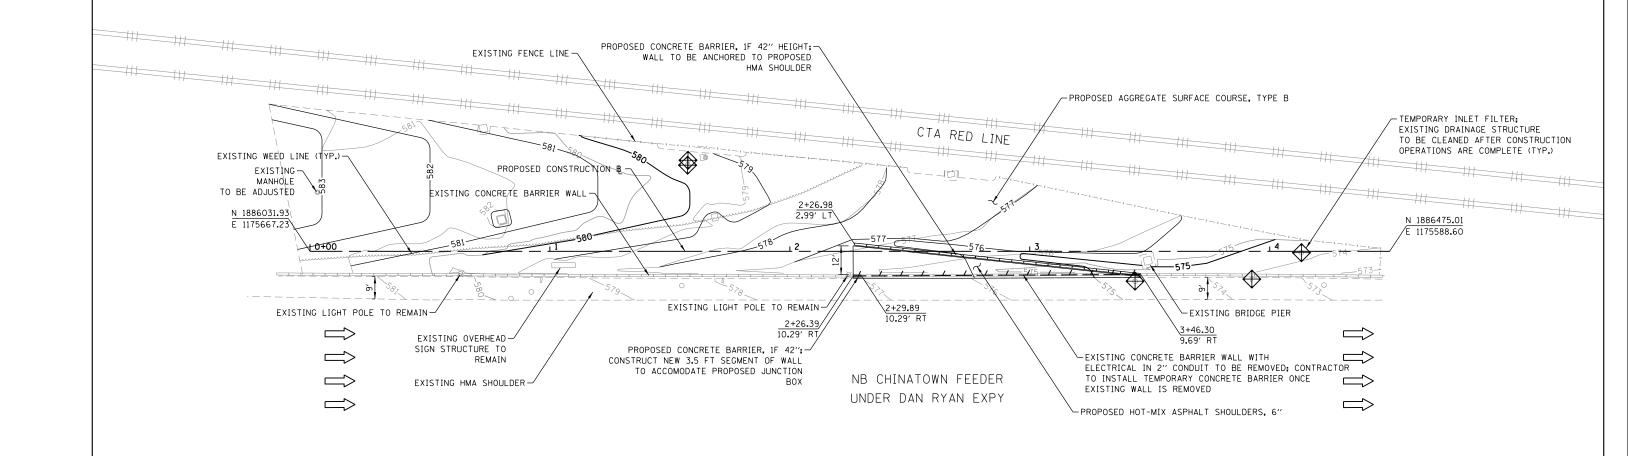

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٠.	PLOT DATE = 6/11/2015	DATE	-	04/07/2015	REVISED -	
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DEPARTMENT	OF TRANSPORTA	ΓΙΟΝ

HSB	RTE 39	93: 0	HINA	\TO	WN FE	EDER UI	NDER I-90 /94	H.S.B. RTE.	SEC
PLAN SHEET									2014
SCALE: 1" = 20"	SHEET	1	OF	1	SHEETS	STA.	TO STA.		

		IL	D PROJECT							
_			CONTRACT	NO.	62	A48				
	393	2014-0	91I		COOK	2	1	æ		
	H.S.B. RTE.	SECTION	ON		COUNTY	TO1 SHE	TOTAL SHEETS			

DEPARTMENT OF TRANSPORTATION

PLOT SCALE = 1" = 10"

ENGINEERING LTD.

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- 04/07/2015

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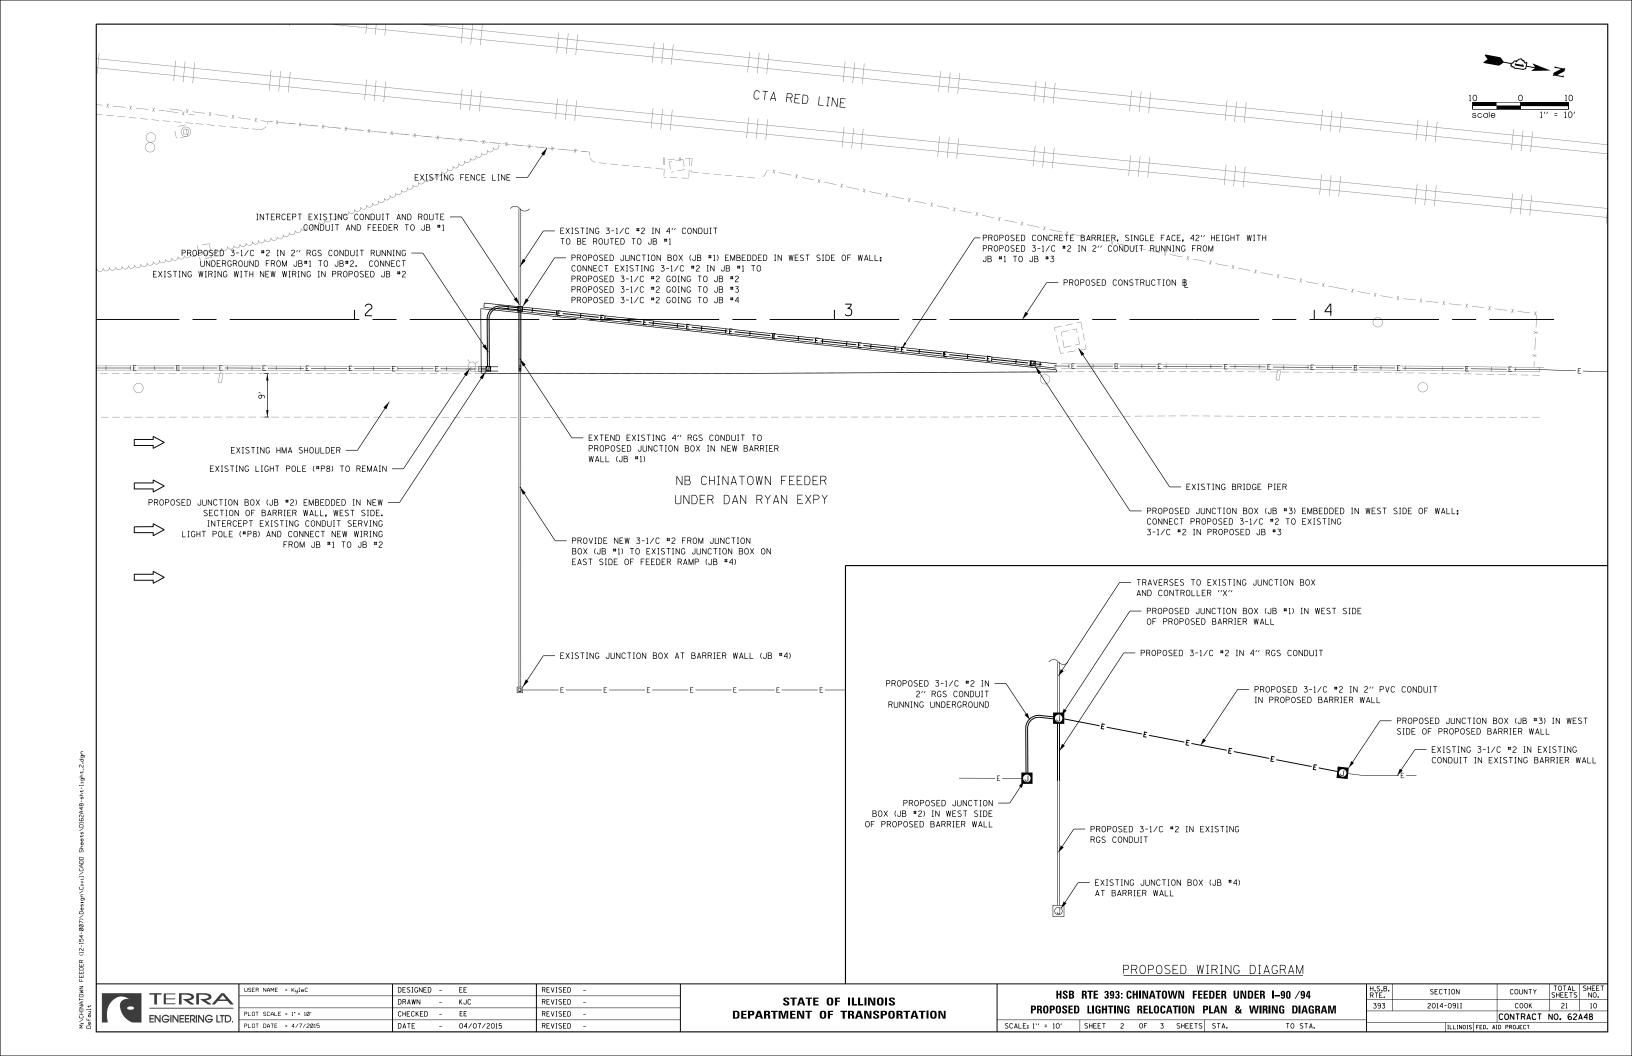
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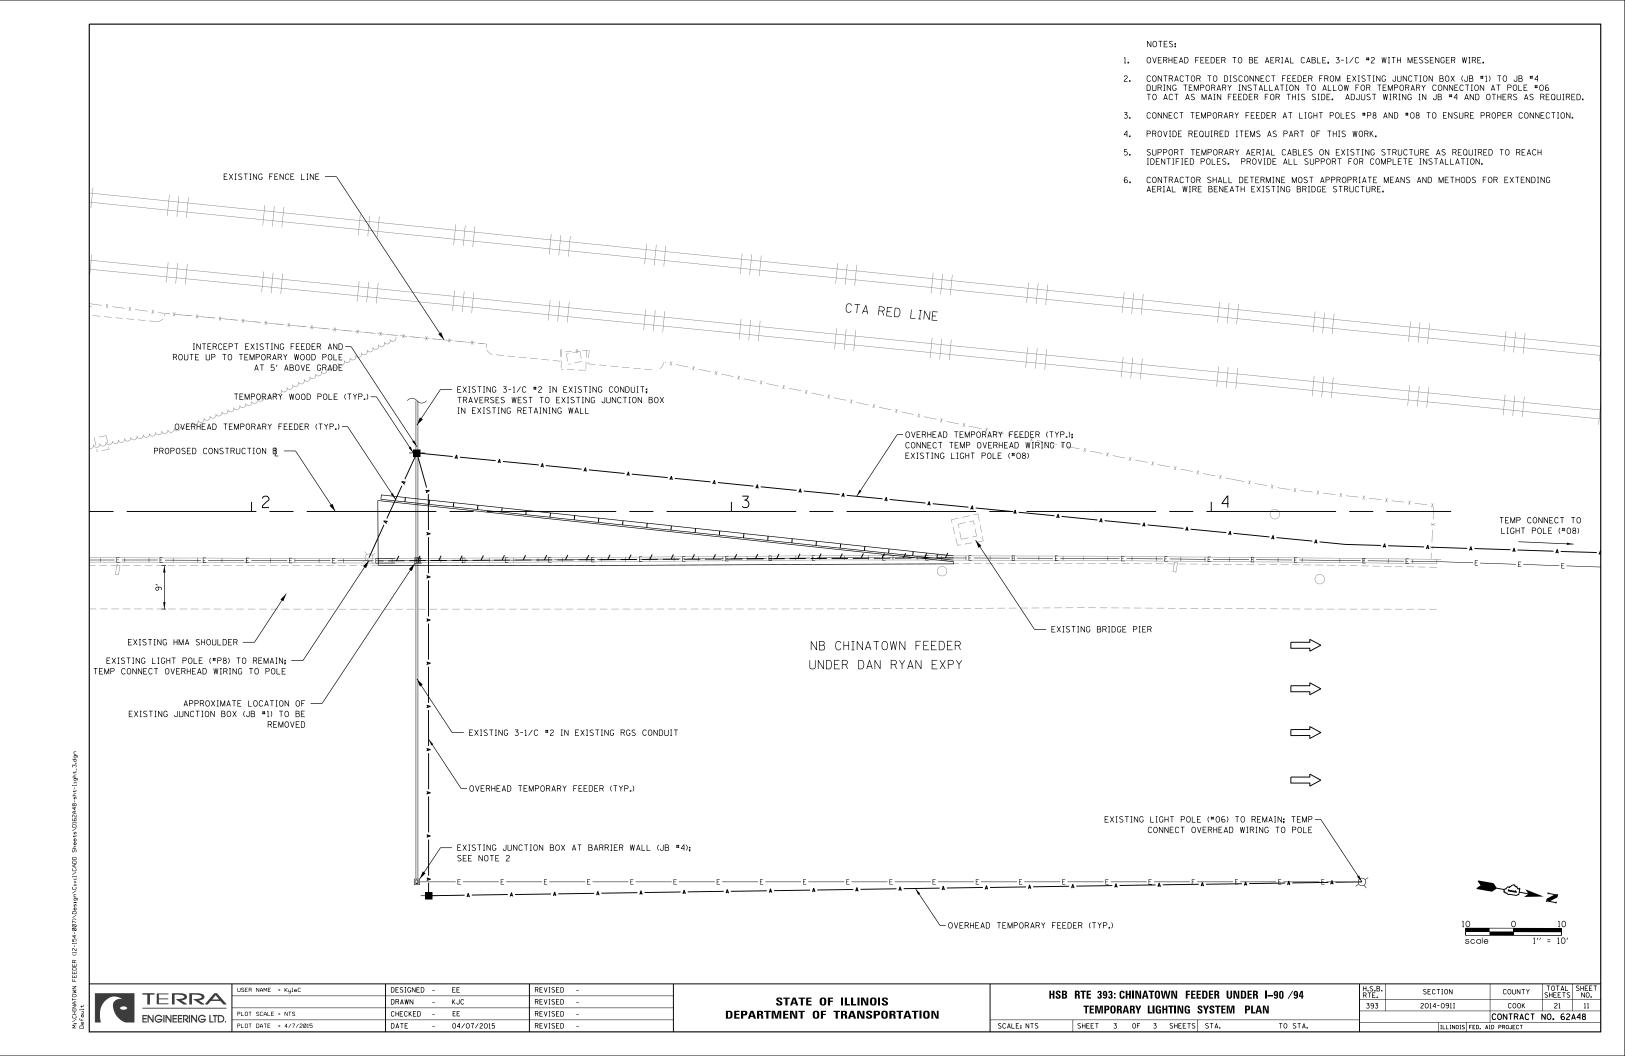
2014-0911


CONTRACT NO. 62A48


EXISTING LIGHTING DEMOLITION PLAN

SCALE: 1" = 10' SHEET 1 OF 3 SHEETS STA.






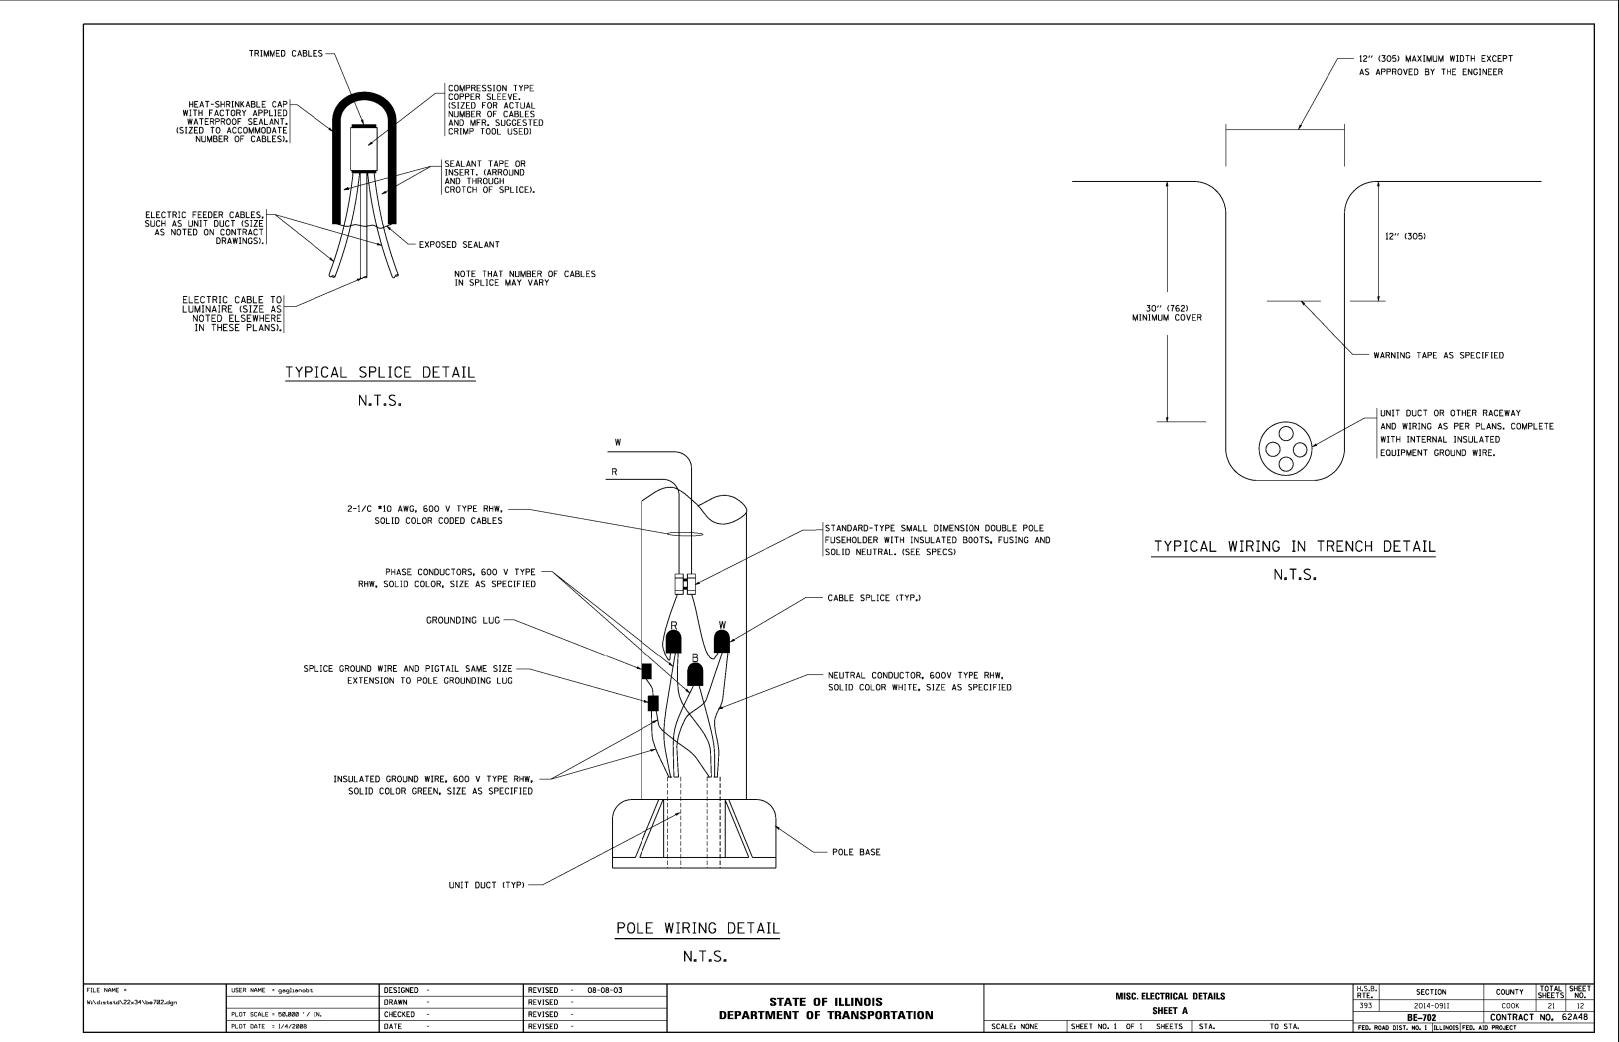


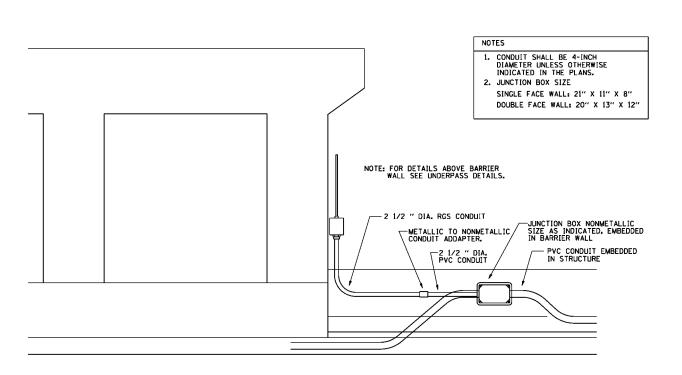


ED - BWD ELECTRIC CONNECTION TO UNDERPASS LIGHTING

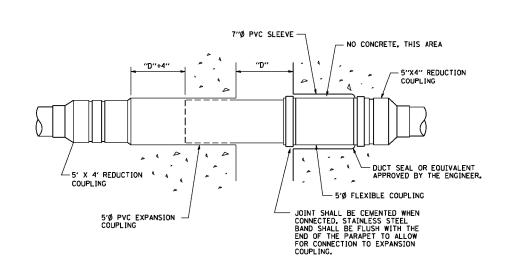

INSTALLATION OF CONDUIT IN BRIDGE PARAPET EXPANSION JOINT (N.T.S.)

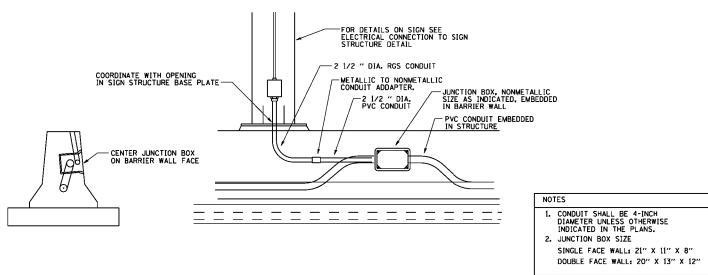

ED - SGN JUNCTION BOX EMBEDDED IN BARRIER WALL FOR SIGN LIGHTING

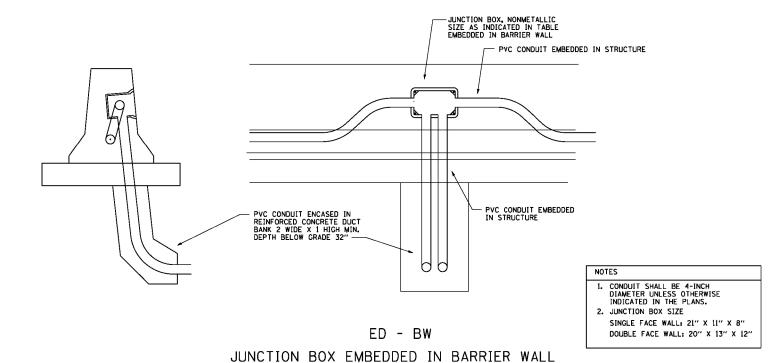


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be703.dgn		DRAWN -	REVISED -
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	PLOT DATE = 2/5/2009	DATE - 01-20-2009	REVISED -


STATE OF ILLINOIS **DEPARTMENT OF TRANSPORTATION**

MISCELLANEOUS ELECTRICAL DETAILS, SHEET B J BOX EMBEDDED IN BARRIER WALL - INSTALLATION OF CONDUIT IN BRIDGE PARAPET EXPANSION JOINT - ELECTRIC CONNECTION TO UNDERPASS LIGHTING SHEET NO. 1 OF 1 SHEETS STA. SCALE: NONE TO STA.

SECTION COUNTY 393 2014-0911 COOK CONTRACT NO. 62A48 BE-703

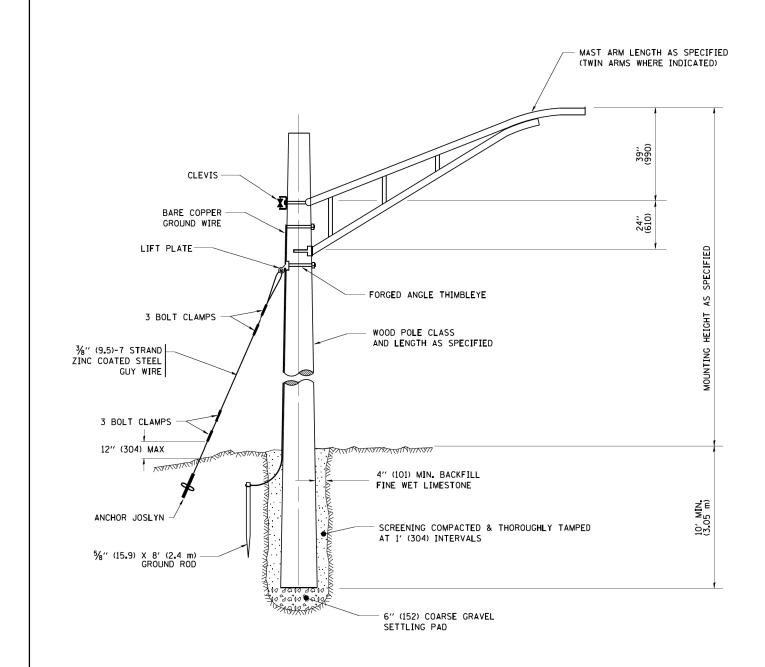



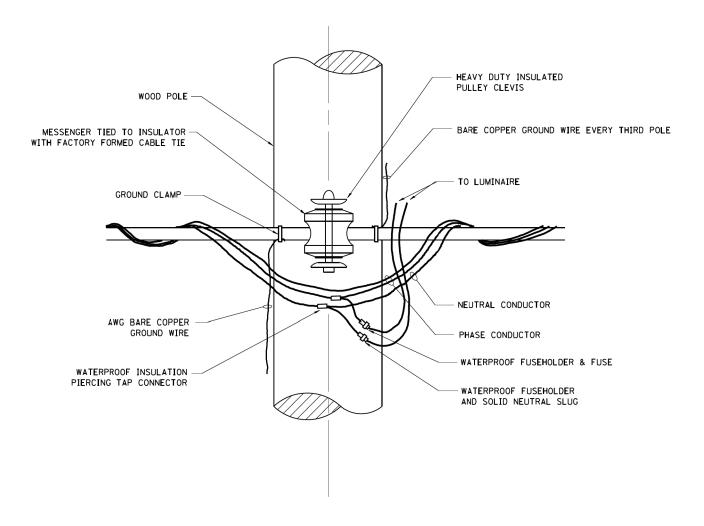



TEMPORARY LIGHT POLE ATTACHMENT DETAIL

NOTES


1. ALL DIMENSIONS IN INCHES (MILLIMETERS) UNLESS OTHERWISE INDICATED

FILE NAME =	USER NAME = gaglianobt	DESIGNED -	REVISED - 08-08-03		TEMPORARY LIGHT POLE DETAILS			H.S.B.	SECTION	COUNTY	TOTAL S	YEET.
W:\diststd\22x34\be800.dgn		DRAWN -	REVISED -	STATE OF ILLINOIS	TEMPORANT LIGHT FOLE DETAILS		393	2014-0911	соок	21	14	
	PLOT SCALE = 50.000 '/ IN.	CHECKED -	REVISED -	DEPARTMENT OF TRANSPORTATION					BE-800	CONTRACT	T NO. 62	448
	PLOT DATE = 1/4/2008	DATE -	REVISED -		SCALE: NONE	SHEET NO. 1 OF 1 SHEETS STA.	TO STA.	FED. ROA	D DIST. NO. 1 ILLINOIS FED.			

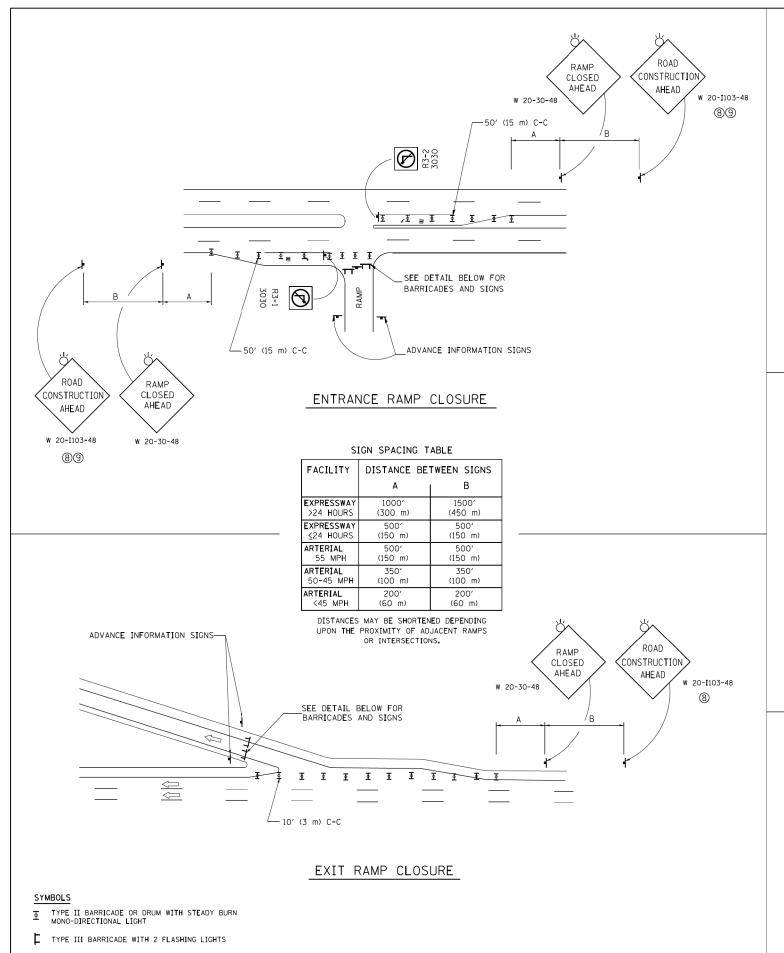

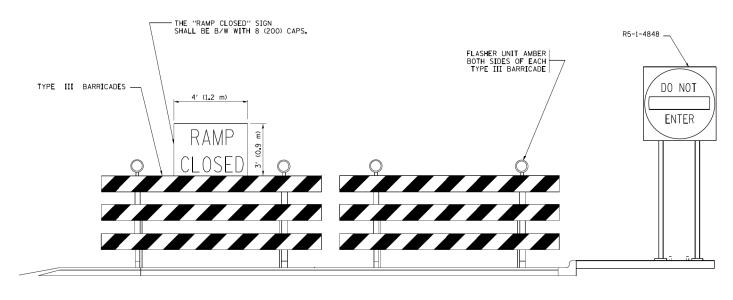


DETAIL FOR REQUIRED BARRICADES & SIGNS

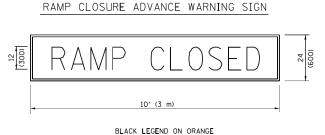

BACKGROUND MOUNTED DIAGONALLY E MOD FONT 1 (25) BORDER

THESE SIGNS ARE REQUIRED ON ALL THE EXIT GUIDE SIGNS FOR EXIT RAMPS THAT WILL BE CLOSED FOR MORE THAN FOUR (4) CONSECUTIVE DAYS.

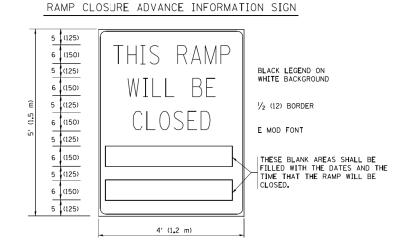

THESE SIGNS ARE REQUIRED ON BOTH SIDES OF THE RAMP, MINIMUM OF 1 WEEK IN ADVANCE OF THE CLOSURE.

THESE SIGNS SHALL BE FABRICATED AND PAID FOR ACCORDING TO THE TEMPORARY INFORMATION SIGNING SPECIAL PROVISION


GENERAL NOTES:


- CONES MAY BE SUBSTITUTED FOR DRUMS OR TYPE II 1 BARRICADES DURING DAY OPERATIONS. CONES SHALL BE A MINIMUM OF 28 (700) HIGH.
- 2) STEADY BURN LIGHTS WILL NOT BE REQUIRED FOR DAY OPERATIONS.
- 3 A FLAGGER SHALL BE POSITIONED AT EACH CLOSED RAMP THAT IS OPEN TO CONSTRUCTION VEHICLES, PRECEEDED BY A W20-7 FLAGGER WARNING SIGN.
- (4) ALL ROUTE MARKERS AND TRAILBLAZER ASSEMBLIES WHICH DIRECT MOTORISTS TO A CLOSED ENTRANCE RAMP SHALL BE COVERED WHEN THE RAMP IS CLOSED FOR MORE THAN FOUR (4) DAYS.
- (5) THE SIGNING AND BARRICADING WHICH IS REQUIRED BY THIS DETAIL SHALL BE INCLUDED IN THE COST OF TRAFFIC CONTROL AND PROTECTION (EXPRESSWAYS).

- 6 AUTHORIZATION FROM THE DISTRICT'S BUREAU OF TRAFFIC IS REQUIRED FOR ALL RAMP CLOSURES.
- 7 THE RAMP CLOSURE ADVANCE INFORMATION SIGNS SHALL BE ERECTED IF THE CLOSURE TIME EXCEEDS TWENTY-FOUR (24) HOURS. ADDITIONAL ADVANCE WARNING SIGNS ON EXIT GUIDE SIGNING WILL BE REQUIRED FOR EXIT RAMP CLOSURES THAT EXCEED FOUR (4) DAYS IN LENGTH
- (8) ROAD CONSTRUCTION AHEAD SIGNS MAY BE OMITTED WHEN THIS DETAIL IS USED IN CONJUNCTION WITH OTHER TRAFFIC CONTROL THAT ALREADY INCLUDES A ROAD CONSTRUCTION AHEAD SIGN.
- (3) ARTERIAL ROAD CONSTRUCTION AHEAD SIGNS SHALL BE INSTALLED ON THE LEFT SIDE OF TRAFFIC IF THE MEDIAN IS MORE THAN 10 FT WIDE.

ALL DIMENSIONS ARE IN INCHES (MILLIMETERS)
UNLESS OTHERWISE SHOWN.


	FILE NAME =	USER NAME = footemj	DESIGNED - DWS	REVISED - JAF 02-06			ENTRANCE AND EXI	T DAMD	H.S.B.	SECTION	COUNTY	TOTAL S	SHEET
	c:\pw_work\pwidot\footemj\d0108315\tc08.	dgn	DRAWN -	REVISED - SPB 01-07	STATE OF ILLINOIS				393	2014-0911	СООК	21	15
		PLOT SCALE = 50.000 ' / in.	CHECKED -	REVISED - SPB 12-09	DEPARTMENT OF TRANSPORTATION	CLOSURE DETAILS			TC-08	CONTRACT	NO. 6	2A48	
Į į		PLOT DATE = 7/8/2013	DATE - 02-83	REVISED - MD 06-13		SCALE: NONE	SHEET NO. 1 OF 1 SHEETS	STA. TO STA.	FED ROA		D PROJECT		-

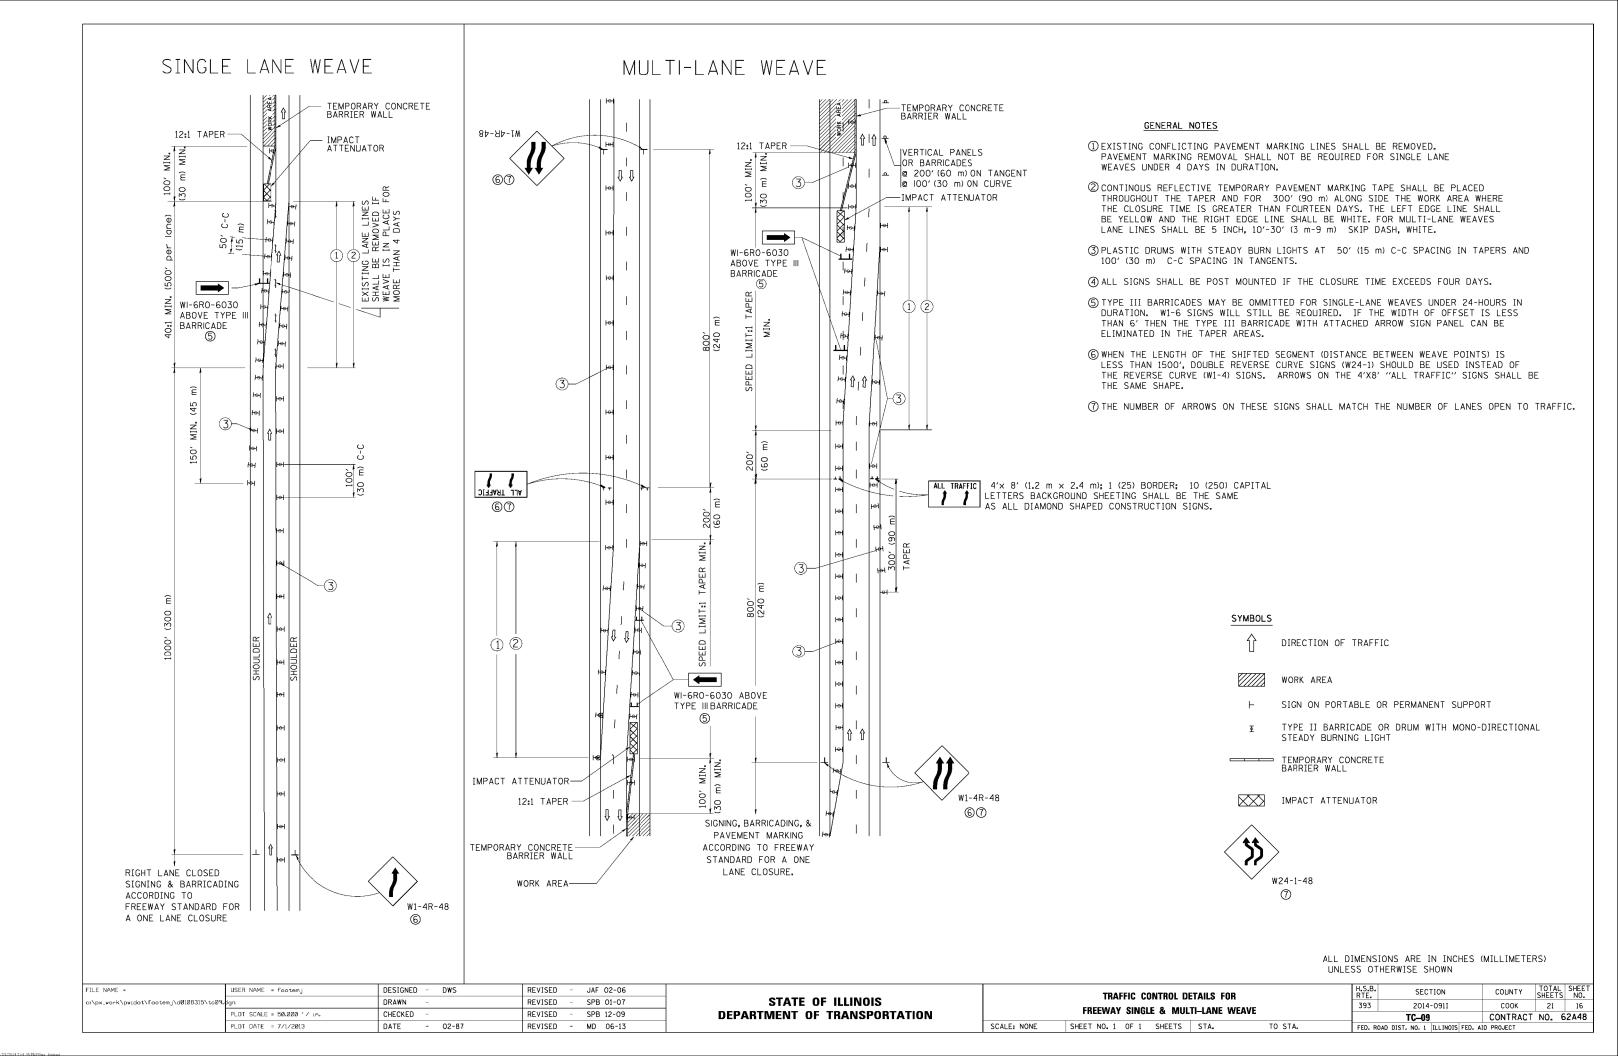

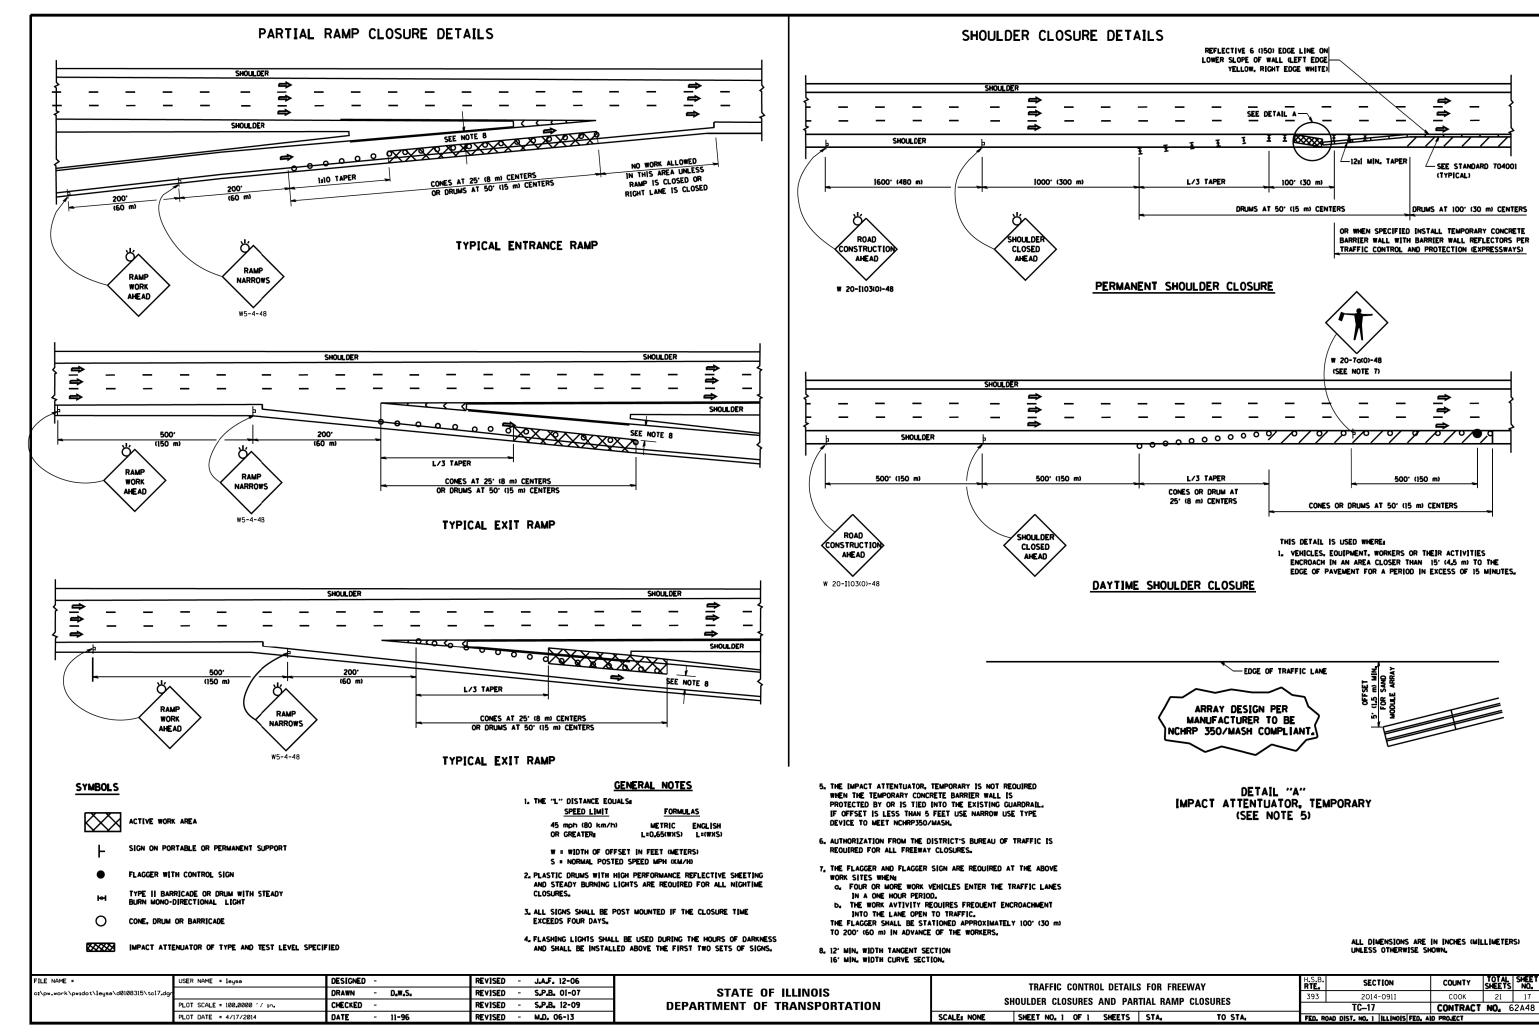


SIGNING FOR FLAGGING OPERATIONS AT WORK ZONE OPENINGS

WORK ZONE EXIT OPENING

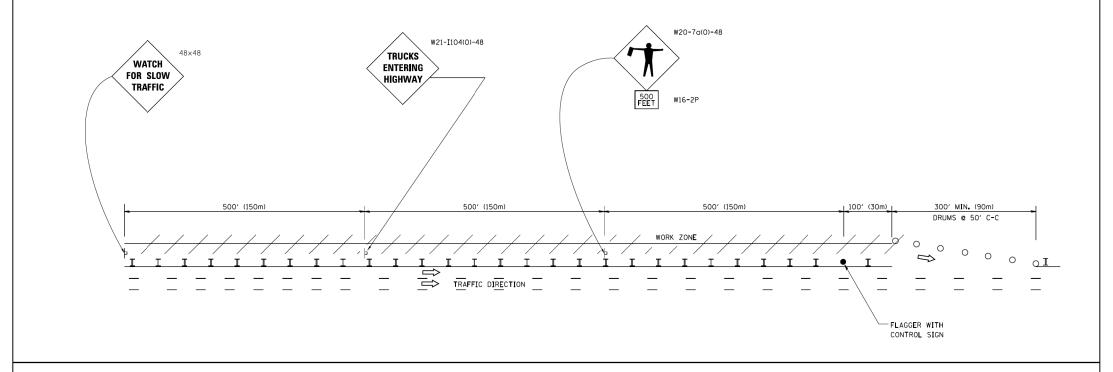

WORK ZONE ENTRY OPENING

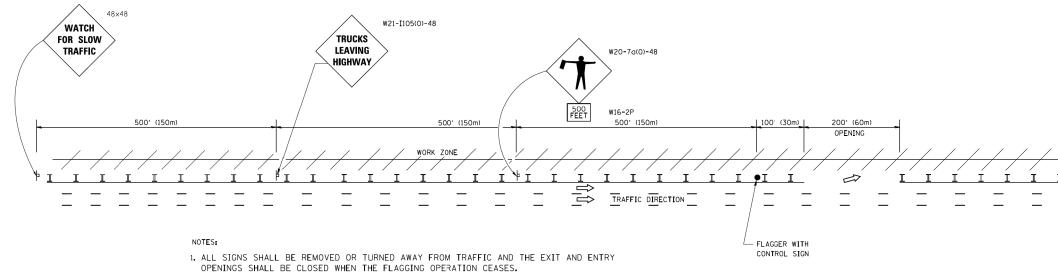

1. ALL SIGNS SHALL BE REMOVED OR TURNED AWAY FROM TRAFFIC AND THE EXIT AND ENTRY OPENINGS SHALL BE CLOSED WHEN THE FLAGGING OPERATION CEASES. NON OPERATING EQUIPMENT SHALL COMPLY WITH ARTICLE 701.11

- 2. WORK ZONE OPENINGS SHALL BE A MINIMUM OF ONE HALF MILE APART AND A MINIMUM OF ONE QUARTER MILE FROM ALL ENTRANCE AND EXIT RAMPS.
- 3. EXITING THE WORK ZONE AT ANY PLACE OTHER THAN AT A WORK ZONE EXIT OPENING WILL BE PROHIBITED.
- 4. ALL VEHICLES SHALL ENTER THE WORK ZONE AT ENTRY OPENINGS, USING THEIR TURN SIGNALS TO WARN MOTORISTS
- 5. FLAGGERS SHALL NOT STOP TRAFFIC OR DIRECT TRAFFIC INTO AN ADJACENT LANE.

ALL DIMENSIONS ARE IN INCHES (MILLIMETERS) UNLESS OTHERWISE SHOWN

FILE NAME =	USER NAME = footemj	DESIGNED -	REVISED - J.A.F. 02-06		EREE/	WAY/EXPRESSWAY SIGNING FOR	FLACCING OPERATIONS	RTF.	SECTION	COUN T Y	SHEETS	NO.
c:\pw_work\pwidot\footemj\d0108315\tc18.c	gn	DRAWN -	REVISED - S.P.B. 01-07	STATE OF ILLINOIS				393	2014-0911	соок	21	18
	PLOT SCALE = 50.000 '/ in.	CHECKED -	REVISED - S.P.B. 12-09	DEPARTMENT OF TRANSPORTATION	AT	WORK ZONE OPENINGS ON FRE	EEWAYS/EXPRESSWAYS	TC-18				2A48
	PLOT DATE = 7/8/2013	DATE -	REVISED - M.D. 06-13		SCALE: NONE	SHEET NO. 1 OF 1 SHEETS	STA. TO STA.	FED. ROAD		AID PROJECT		

CENTER LANE CLOSURE TYPE I CHECK BARRICADES-> DRUMS AT 50' (15 m) CENTERS AT 100' (30 m) CENTERS ARROW BOARD DISPLAYING-DOUBLE ARROW PATTERN CENTER LANE CLOSE W9-3-48 € W9-3a-48 SIGNING & BARRICADING ACCORDING TO FREEWAY STANDARD FOR A ONE LANE CLOSURE INSTALLATION SEQUENCE 1. CLOSE LANES 1&2 ACTIVE NOTES WORK AREA 1. DRUMS WITH STEADY BURN LIGHTS SHAL_ BE USED AT 50' (15 m) CENTERS ON ALL TAPERS AND TANGENTS IN 2. ERECT INSIDE LANE 2 TAPER ADVANCE OF WORK AREA. 2. CLOSURE SHALL BE USED ONLY FOR OPERATIONS LASTING 72 HOURS OR LESS. 3. OPEN LANE 2 BY RELOCATING FIRST TAPER 3. CENTER LANE CLOSURE CONFIGURATION NON-ACTIVE IS NOT TO BE USED WITH WORKERS WORK AREA PRESENT. 4. REMOVE CLOSURE IN REVERSE ORDER

DESIGNED

CHECKED

DRAWN

DATE

FILE NAME =


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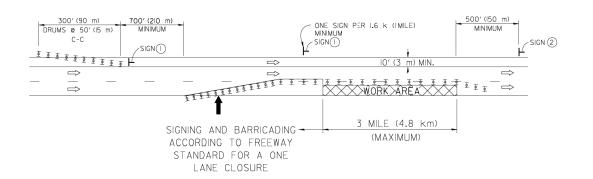
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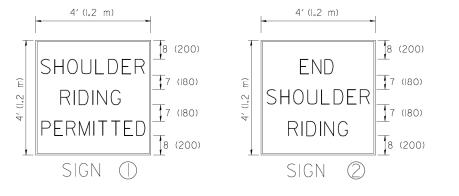
PLOT DATE = 1/26/2010

SHOULDER LANE

NOTE: CLOSURE SHALL BE USED ONLY FOR OPERATIONS LASTING 72 HOURS OR LESS.





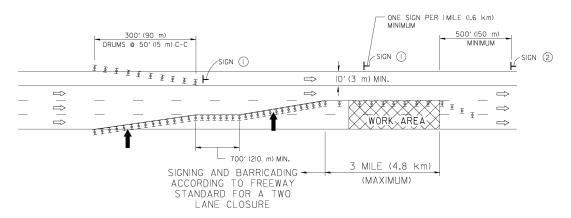

6 (150) SERIES "C' LEGEND BLACK LEGEND WHITE REFLECT. BACKGROUND I (25) BORDER

SYMBOLS

DIRECTION OF TRAFFIC

■ ARROWBOARD

ACTIVE WORK AREA

► SIGN ON PORTABLE OR PERMANENT SUPPORT *

SCALE: NONE

TYPE || BARRICADE, OR DRUM WITH MONO-DIRECTIONAL STEADY BURN LIGHT

ALL DIMENSIONS ARE IN INCHES (MILLIMETERS) UNLESS OTHERWISE SHOWN

* ALL SIGNS SHALL BE MOUNTED AT A MINIMUM HEIGHT OF 5' (1.5 m).

REVISED - J.A.F. 04-03

REVISED - S.P.B. 01-07

REVISED - S.P.B. 12-09

REVISED -

STATE OF ILLINOIS
DEPARTMENT OF TRANSPORTATION

TRAFFIC CONTROL DETAILS FOR FREEWAY

CENTER LANE CLOSURE SHOULDER LANE

SHEET NO. 1 OF 1 SHEETS STA. TO STA.

SHEET NO. 1 OF 1 SHEETS STA. TO STA.

H.S.B. SECTION COUNTY TOTAL SHEETS NO.

393 2014-0911 COOK 21 19

TC-25 CONTRACT NO. 62A48

