FOR INDEX OF SHEETS, SEE SHEET NO. 2

THESE IMPROVEMENTS ARE LOCATED WITHIN THE VILLAGE OF MOUNT PROSPECT

CENTRAL RD. MINOR ARTERIAL 21,600

FUNCTIONAL CLASS ADT

ENGINEERING SCALES. REDUCED SIZED PLANS WILL NOT

ON REDUCED PLANS, THE ABOVE SCALES MAY BE USED.

JOINT UTILITY LOCATION INFORMATION FOR EXCAVATION

CONFORM TO STANDARD SCALES. IN MAKING MEASUREMENTS

FOR LIST OF HIGHWAY STANDARDS, SEE SHEET NO. 2

STATE OF ILLINOIS DEPARTMENT OF TRANSPORTATION **DIVISION OF HIGHWAYS** 

# PLANS FOR PROPOSED FEDERAL AID PROJECT

FAU ROUTE 1300 (CENTRAL ROAD) AT WELLER LANE SAFE ROUTES TO SCHOOL SECTION 14-00162-00-SP PROJECT NO. SRTS-4009(323) PEDESTRIAN CROSSING IMPROVEMENTS **VILLAGE OF MOUNT PROSPECT COOK COUNTY** 

C-91-246-15

LOCATION MAP

CENTRAL ROAD AND-WELLER LANE BEGIN STA 112+83.70 END STA 114+32.20 MT PROSPECT LICENSED -GO GOR ENGINEER MILBURN MILBURN

GROSS LENGTH = NET LENGTH = 150 FT. = 0.03 MILE

ROBBIE DR

PENDLETON PL

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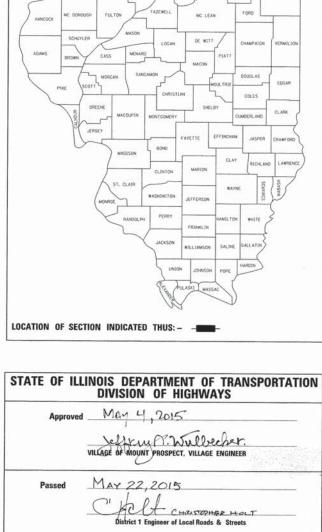
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1-800-892-0123 OR 811

CONTRACT NO. 61B72



SECTION

14-00162-00-SP

D-91-246-15

COUNTY

соок ILLINOIS CONTRACT NO. 61B72

16+1=17

John Joshon ann Gr

strict / Engineer of Highways, Region 1 Engineer

PRINTED BY THE AUTHORITY OF THE STATE OF ILLINOIS

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### STATE STANDARDS

000001-06	STANDARD	SYMBOLS.	<b>ABBREVIATIONS</b>	AND PATTERNS	

- 001001-02 AREAS OF REINFORCEMENT BARS
- 001006 DECIMAL OF AN INCH AND OF A FOOT
- 280001-07 TEMPORARY EROSION CONTROL SYSTEMS
- 420001-08 PAVEMENT JOINTS
- 424001-08 PERPENDICULAR CURB RAMPS FOR SIDEWALKS
- 424011-02 CORNER PARALLEL CURB RAMPS FOR SIDEWALKS
- 424016-02 · MID-BLOCK CURB RAMPS FOR SIDEWALKS
- 424021-03 DEPRESSED CORNER FOR SIDEWALKS
- 424031-01 MEDIAN PEDESTRIAN CORSSINGS
- 542011 CONCRETE END SECTIONS FOR ELLIPTICAL PIPE CULVERTS 15" (375 mm) THRU
  - 72" (1800 mm) EQUIVALENT DIAMETER
- 602301-04" INLET TYPE A
- 604091-03 FRAME AND GRATE, TYPE 24
- 606001-06 CONCRETE CURB TYPE B AND COMBINATION CONCRETE CURB AND GUTTER
- 606301-04 · PC CONCRETE ISLANDS AND MEDIANS
- 701101-04 OFF-RD OPERATIONS, MULTILANE, 15' (4.5 m) TO 24" (600 mm) FROM PAVEMENT EDGE
- 701427-03 LANE CLOSURE, MULTILANE, INTERMITTENT OR MOVING OPERATION, FOR SPEED <= 40 MPH
- 701602-07 · URBAN LANE CLOSURE, MULTILANE, 2W WITH BIDIRECTIONAL LEFT TURN LANE
- 701701-09 URBAN LANE CLOSURE, MULTILANE INTERSECTION
- 701801-05 LANE CLOSURE, MULTILANE 1W OR 2W CROSSWALK OR SIDEWALK CLOSURE
- 701901-04 · TRAFFIC CONTROL DEVICES
- 720006-04 · SIGN PANEL ERECTION DETAILS
- 720011-01 METAL POSTS FOR SIGNS, MARKERS & DELINEATORS
- 728001-01 . TELESCOPING STEEL SIGN SUPPORT
- 729001-01 . APPLICATIONS OF TYPES A & B METAL POSTS (FOR SIGNS & MARKERS)
- 731001-01 BASE FOR TELESCOPING STEEL SIGN SUPPORT
- 780001-05 . TYPICAL PAVEMENT MARKINGS
- 878001-10 CONCRETE FOUNDATION DETAILS

#### GENERAL NOTES

IT SHALL BE THE CONTRACTOR'S RESPONSIBILITY TO HAVE THE UTILITY COMPANIES FIELD-LOCATE ALL UTILITIES, ASCERTAIN THEIR STATUS AND ADJUST OR RELOCATE THESE UTILITIES, AS NECESSARY, PRIOR TO STARTING CONSTRUCTION. THIS WORK SHALL BE INCLUDED IN THE COST OF "MOBILIZATION." THE CONTRACTOR SHALL NOTIFY ALL PUBLIC AND PRIVATE UTILITIES BEFORE STARTING CONSTRUCTION, INCLUDING, BUT NOT LIMITED TO:

AT&T DISTRIBUTION - MS. KATE PETERS - 630-573-5759
AT&T - LNS - MR. BOBBY AKHTER - 630-719-1483
COMCAST - MR. THOMAS MUNAR - 630-600-6316
MWRD - MR. JOE SCHUESSLER - 312-751-3184
MCI/VERIZON - MR. DEAN BOYERS - 972-729-6322
NICOR GAS - MR. BRICE KOPPANG - 630-388-3046
VILLAGE OF MT. PROSPECT - MS. DONNA BROWN - 847-870-5640
WIDE OPEN WEST - MR. PAUL FINKOW - 630-536-3139

- DURING THE CONSTRUCTION OPERATION WHEN ANY LOOSE MATERIAL IS DEPOSITED IN THE FLOW LINE OF DITCHES, GUTTERS, OR DRAINAGE STRUCTURES SO THE NATURAL FLOW OF WATER IS OBSTRUCTED, THE MATERIAL SHALL BE REMOVED AT THE CLOSE OF EACH WORKING DAY. AT THE CONCLUSION OF THE CONSTRUCTION OPERATIONS ALL DRAINAGE STRUCTURES SHALL BE FREE FROM ALL DIRT AND DEBRIS. THIS WORK SHALL NOT BE PAID FOR SEPARATELY BUT SHALL BE INCLUDED IN THE COST OF "INLETS, TYPE A, TYPE 24 FRAME AND GRATE", "MANHOLES TO BE ADJUSTED", AND "INLETS TO BE ADJUSTED".
- IT IS THE CONTRACTOR'S RESPONSIBILITY TO ASCERTAIN EXISTING FIELD CONDITIONS PRIOR TO BIDDING ON THIS PROJECT. NO ADDITIONAL COMPENSATION WILL BE ALLOWED FOR FAILURE TO VERIFY EXISTING DIMENSIONS OR CONDITIONS.
- 4. THE CONTRACTOR SHALL LIMIT HIS CONSTRUCTION ACTIVITIES TO THE WORK AREAS DESIGNATED ON THE PLANS. ANY DAMAGE TO AREAS OUTSIDE OF THESE LIMITS SHALL BE REPAIRED BY THE CONTRACTOR AT HIS OWN EXPENSE TO THE SATISFACTION OF THE ENGINEER.
- THE CONTRACTOR SHALL CONTACT DISTRICT ONE TRAFFIC CONTROL SUPERVISOR AT (847) 705-4470 A MINIMUM OF 72 HOURS IN ADVANCE OF BEGINNING WORK.
- THE PROPOSED COMBINATION CONCRETE CURB AND GUTTER SHALL BE DEPRESSED AT CURB RAMPS AND/OR AS SPECIFIED BY THE ENGINEER.
- PROPER DRAINAGE SHALL BE MAINTAINED IN THE IMPROVEMENT AREA DURING CONSTRUCTION. THE COST OF THIS WORK SHALL BE INCLUDED IN THE COST OF GRADING AND SHAPING DITCHES.
- 8. THE CONTRACTOR SHALL OBTAIN AUTHORIZATION FROM THE ENGINEER BEFORE BEGINNING WORK ON ANY STREET.
- 9. IT IS THE RESPONSIBILITY OF THE CONTRACTOR TO PROTECT ALL PAVEMENT OPENINGS, OPEN HOLES, EQUIPMENT AND RUBBLE LEFT IN THE PUBLIC RIGHT-OF-WAY. THE CONTRACTOR SHALL MAINTAIN HIGH VISIBILITY OF ALL TEMPORARY HAZARDS TO PEDESTRIANS AND MOTORISTS.
- ALL REQUIRED SAW CUTS SHALL NOT BE PAID FOR SEPARATELY BUT SHALL BE INCLUDED IN THE PRICE OF THE RESPECTIVE PAY ITEM.
- ALL TREES SHALL BE PROTECTED AND CARED FOR DURING CONSTRUCTION.
  THE CONTRACTOR SHALL ADHERE TO ALL VILLAGE TREE PROTECTION
  ORDINANCES AND REQUIREMENTS.
- THE CONTRACTOR SHALL MAINTAIN ACCESS TO PRIVATE PROPERTIES AT ALL TIMES.
- 13. THE FOLLOWING ADDITIONAL QUANTITIES HAVE BEEN INCLUDED FOR USE ONLY AT THE DISCRETION OF THE ENGINEER AND SPECIAL PROVISIONS:

20101200

TREE ROOT PRUNING SUPPLEMENTAL WATERING 5 EACH 48 UNIT

#### GENERAL NOTES (CONT.)

- 14. THE CONTRACTOR SHALL TAKE APPROPRIATE MEASURES TO CONTROL DUST AT ALL TIMES ALONG THE ENTIRE PROJECT BY MEANS SUCH AS A MECHANICAL SWEEPER, WATER TRUCK, OR AS DIRECTED BY THE ENGINEER. THIS WORK SHALL BE INCLUDED IN THE COST OF "TRAFFIC CONTROL AND PROTECTION. STANDARD 701701.
- 15. LOCATIONS OF ALL PROPOSED DRAINAGE STRUCTURES ARE APPROXIMATE AND SHALL BE FIELD VERIFIED BY THE ENGINEER PRIOR TO FINAL INSTALLATION. THE CONTRACTOR SHALL VERIFY EXISTING INVERT INFORMATION BEFORE ORDERING EACH DRAINAGE STRUCTURE (INLET, CATCH BASIN, MANHOLE, ETC.) NO ADDITIONAL COMPENSATION WILL BE ALLOWED FOR FAILURE TO VERIFY EXISTING INVERT FOR THE CONNECTION OF EXISTING STORM SEWER.
- 16. ALL EXCAVATED MATERIAL SHALL REMAIN ON-SITE AND WITHIN THE RIGHT-OF-WAY OF ORIGIN. SURPLUS TOPSOIL SHALL REMAIN ON SITE BY INCREASING THE THICKNESS OF TOPSOIL PLACED, OR AS DIRECTED BY THE ENGINEER. THIS WORK WILL BE PAID FOR AT THE CONTRACT UNIT PRICE FOR "TOPSOIL EXCAVATION AND PLACEMENT".
- 17. THE CONTRACTOR SHALL BE REQUIRED TO MOVE ANY DECORATIVE ROCKS, PAVER BRICKS, OR LANDSCAPE ITEMS THAT INTERFERE WITH CONSTRUCTION. UPON COMPLETION OF THE CONSTRUCTION, THE CONTRACTOR SHALL MOVE THESE ITEMS BACK TO THEIR ORIGINAL LOCATION AND ORIGINAL CONDITION. THIS WORK SHALL BE INCLUDED IN THE COST OF THE REMOVAL ITEM.
- 18. THE CONTRACTOR SHALL BE PERMITTED TO WORK BETWEEN THE HOURS OF 7:00 AM AND 7:00 PM MONDAY THROUGH SATURDAY. LANE CLOSURES SHALL ONLY BE ALLOWED ON WORK DAYS BETWEEN THE HOURS OF 9:00 AM AND 3:00 PM.
- 19. TIE BARS FOR COMBINATION CONCRETE CURB AND GUTTER AND CONCRETE MEDIAN SHALL BE INCLUDED IN THE COST OF THE ITEM.
- 20. FOR ANY NICOR GAS VALVES TO BE ADJUSTED, THE CONTRACTOR SHALL CONTACT DAN STEFANECH, SHEDULER AT (815) 754-3488 A MINIMUM OF 2 WEEKS PRIOR TO FIELD WORK.

Inc.	USER NAME = jattanaseo	DESIGNED	-	JPA	REVISED	*	
IIIC.		DRAWN	-	MLD	REVISED	1-1	
uite 402	PLOT SCALE = 20.0000 ' / in.	CHECKED	-	DJO	REVISED		
75.4014	PLOT DATE = 5/4/2015	DATE	-	5/4/2015	REVISED		

	ITEM #	DESCRIPTION	UNIT	TOTAL	8 0% FEDERAL SAFETY 0021
	20101000	TEMPORARY FENCE	FOOT	570	570
*	20101200	TREE ROOT PRUNING	EACH	5	5
	20200100	EARTH EXCAVATION	CU YD	34	34
	20400800	FURNISHED EXCAVATION	CU YD	207	207
	28000500	INLET AND PIPE PROTECTION	EACH	1	1
	28000510	INLET FILTERS	EACH	2	2
	21101505	TOPSOIL EXCAVATION AND PLACEMENT	CU YD	53	53
	21101625	TOPSOIL FURNISH AND PLACE, 6"	SQ YD	474	474
	21400100	GRADING AND SHAPING DITCHES	FOOT	75	75
*	25000400	NITROGEN FERTILIZER NUTRIENT	POUND	9	9
*	25000500	PHOSPHORUS FERTILIZER NUTRIENT	POUND	9	9
*	25000600	POTASSIUM FERTILIZER NUTRIENT	POUND	9	9
*	25200110	SODDING, SALT TOLERANT	SQ YD	1,050	1,050
*	25200200	SUPPLEMENTAL WATERING	TINU	48	48
	35101400	AGGREGATE BASE COURSE, TYPE B	TON	136	136
	40603335	HOT-MIX ASPHALT SURFACE COURSE, MIX "D", N50	TON	56	56
	42400200	PORTLAND CEMENT CONCRETE SIDEWALK 5 INCH	SQ FT	1,579	1,579
	42400800	DETECTABLE WARNINGS	S0 FT	122	122
	44000100	PAVEMENT REMOVAL	SQ YD	314	314
	44000500	COMBINATION CURB AND GUTTER REMOVAL	FOOT	240	240
	144	CDECIAL TV. ITEM			PALSIT

*	SPECIALTY	ITEN

ITEM #	DESCRIPTION	UNIT	TOTAL	ROADWAY \$0% FEDERAL SAFETY 0021
44000600	SIDEWALK REMOVAL	SQ FT	1,691	1,691
50105220	PIPE CULVERT REMOVAL	FOOT	60	60
54214509	PRECAST REINFORCED CONCRETE FLARED END SECTIONS, EQUIVALENT ROUND SIZE 24"	EACH	2	2
542A5479	PIPE CULVERTS, CLASS A, TYPE 1 EQUIVALENT ROUND SIZE 24"	FOOT	62	62
55100700	STORM SEWER REMOVAL 15"	FOOT	5	5
60237470	INLETS, TYPE A, TYPE 24 FRAME AND GRATE	EACH	1	1
60255500	MANHOLES TO BE ADJUSTED	EACH	1	1
60260100	INLETS TO BE ADJUSTED	EACH	1	1
50500050	REMOVING CATCH BASINS	EACH	1	1
60605000	COMBINATION CONCRETE CURB AND GUTTER, TYPE B-6.24	FOOT	209	209
60608562	COMBINATION CONCRETE CURB AND GUTTER, TYPE M-4.12	FOOT	33	33
60619600	CONCRETE MEDIAN, TYPE SB-6.12	SQ FT	834	834
67100100	MOBILIZATION	L SUM	1	1
70102632	TRAFFIC CONTROL AND PROTECTION, STANDARD 701602	L SUM	1	1
70102635	TRAFFIC CONTROL AND PROTECTION, STANDARD 701701	L SUM	1	1
70102640	TRAFFIC CONTROL AND PROTECTION, STANDARD 701801	L SUM	1	1
70103815	TRAFFIC CONTROL SURVEILLANCE	CAL DA	10	10
72000100	SIGN PANEL - TYPE 1	S0 FT	70	70
2000200	SIGN PANEL - TYPE 2	SQ FT	25	25
72400100	REMOVE SIGN PANEL ASSEMBLY - TYPE A	EACH	6	6

90	Ciorba G	roup, Inc.	F
	CONSULTING ENGIN 5507 North Cumberla	IEERS nd Avenue, Suite 402	-
	Chicago, Illinois 6065 Tel. 773.775.4009	6 Fax 773.775.4014	r

USER NAME = jattanaseo	DESIGNED -	JPA	REVISED -
	DRAWN -	MLD	REVISED -
PLOT SCALE = 1.0000 ' / in.	CHECKED -	DJO	REVISED -
PLOT DATE = 5/4/2015	DATE -	5/4/2015	REVISED -

CENTRAL RD	AT WELLE	R LN	I PE	DESTRIA	AN CROSSIN	IG IMPROVEMENTS	F.A.U. RTE.	SECTION	COUNTY	TOTAL	SHEET NO.
	S	UMM	ARY	OF OU	ANTITIES		1300	14-00162-00-SP	СООК	16	3
	-		1000						CONTRACT	NO.	61B72
SCALE: NTS	SHEET 1	OF	2	SHEETS	STA.	TO STA.		ILLINOIS FED.	AID PROJECT		

	ITEM *	DESCRIPTION	UNIT	TOTAL	ROADWAY 20% FEDERAL SAFETY 0021
	72400310	REMOVE SIGN PANEL - TYPE 1	S0 FT	18	18
	72800100	TELESCOPING STEEL SIGN SUPPORT	FOOT	23	23
	72900100	METAL POST - TYPE A	FOOT	33	33
	73100100	BASE FOR TELESCOPING STEEL SIGN SUPPORT	EACH	2	2
*	78000200	THERMOPLASTIC PAVEMENT MARKING - LINE 4"	FOOT	737	737
*	78000400	THERMOPLASTIC PAVEMENT MARKING - LINE 6"	FOOT	94	94
*	78000600	THERMOPLASTIC PAVEMENT MARKING - LINE 12"	FOOT	383	383
*	78300100	PAVEMENT MARKING REMOVAL	SQ FT	572	572
*	87800100	CONCRETE FOUNDATION, TYPE A	FOOT	6	6
*	A2004720	TREE, GLEDITSIA TRIACANTHOS INERMIS SHADEMASTER (SHADEMASTER THORNLESS COMMON HONEYLOCUST), 2-1/2" CALIPER, BALLED AND	EACH	2	2
*	A2005040	TREE, GYMNOCLADUS DIOICUS ESPRESSO-JFS (ESPRESSO KENTUCKY COFFEETREE), 2-1/2" CALIPER, BALLED AND BURLAPPED	EACH	1	1
*		· ·	EACH	3	3
	Z0001110	GAS VALVE TO BE ADJUSTED	EACH	1	1
	Z0013798	CONSTRUCTION LAYOUT	L SUM	1	1
	Z0030850	TEMPORARY INFORMATION SIGNING	SO FT	52	52
*	XX007021	PEDESTRIAN ACTIVATED CROSSWALK WARNING SYSTEM	EACH	1	1

\* SPECIALTY ITEM

Ciorba Group, Inc.

CONSULTING ENGINEERS
5507 North Cumberland Avenue, Suite 402
Chicago, Illinois 60856
Tel. 773.775.4009
Fax 773.775.4014

PLOT DATE = 5/4/2015

VILLAGE OF MOUNT PROSPECT SAFE ROUTES TO SCHOOL


CENTRAL RD AT WELLER LN PEDESTRIAN CROSSING IMPROVEMENTS
SUMMARY OF QUANTITIES

SCALE: NTS SHEET 2 OF 2 SHEETS STA. TO STA.


SECTION COUNTY SHEETS NO. 14-00162-00-SP COOK 16 4

CONTRACT NO. 61B72

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EXISTING TYPICAL SECTION NORTH OF CENTRAL ROAD

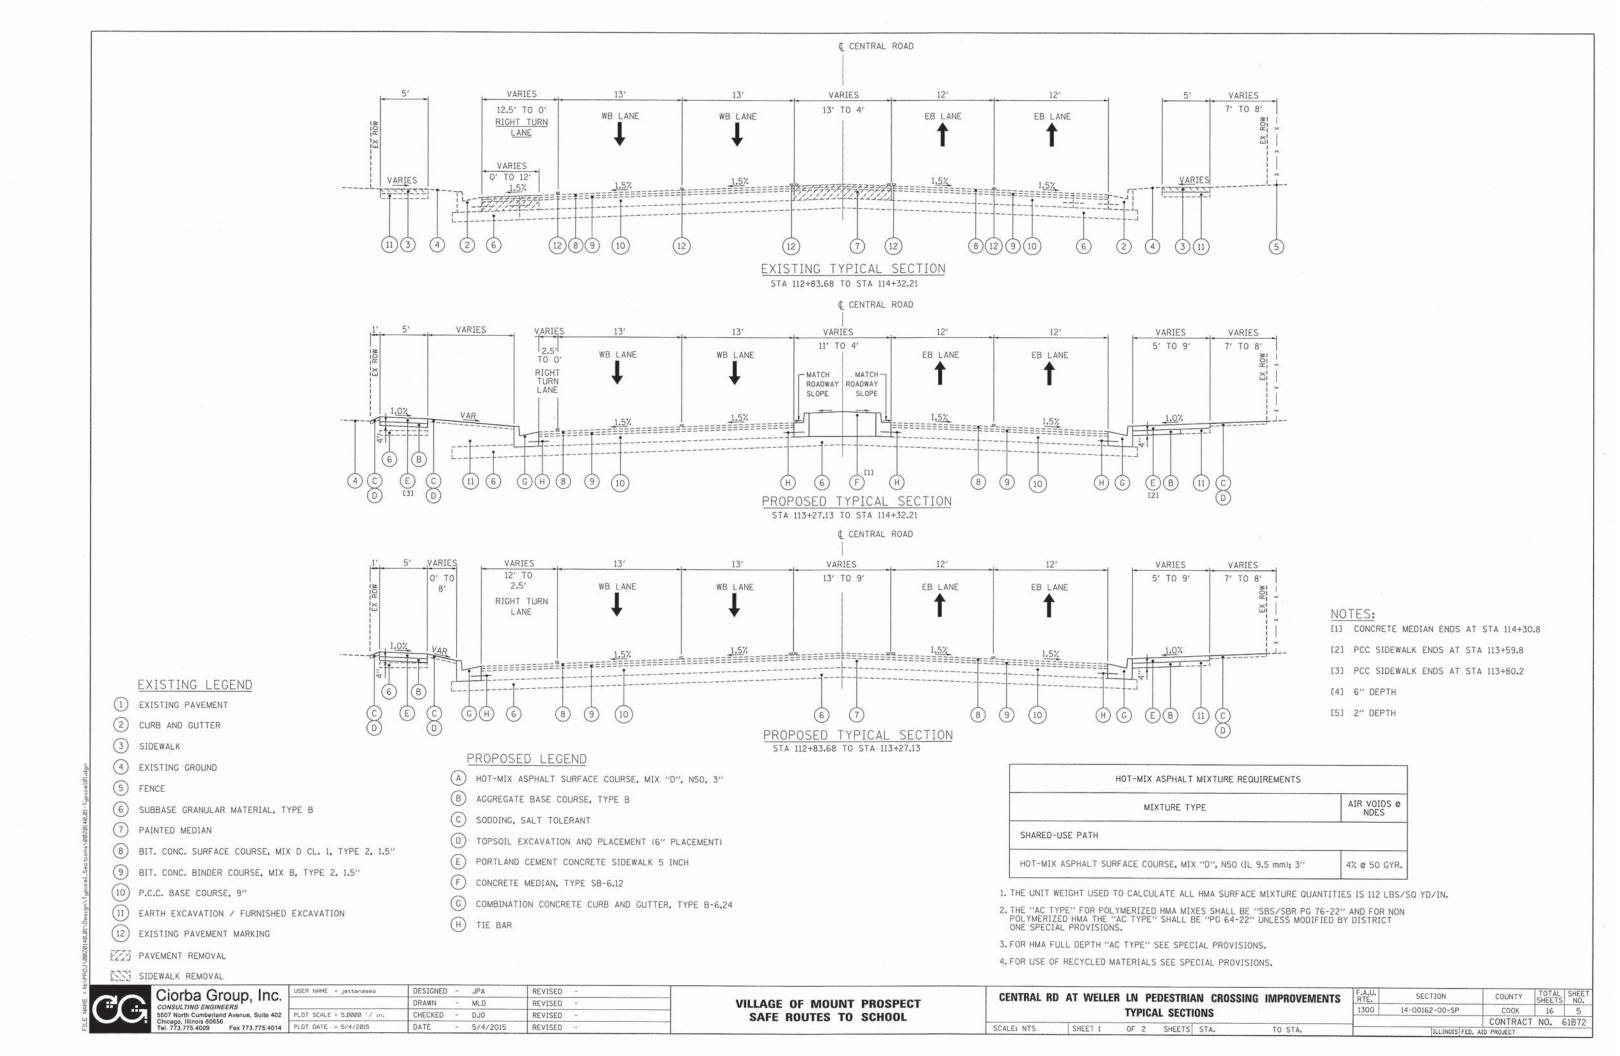


EXISTING LEGEND

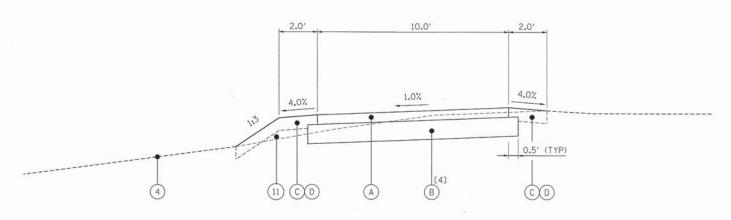PROPOSED TYPICAL SECTION NORTH OF CENTRAL ROAD (LOOKING NORTH)


- 1 EXISTING PAVEMENT (2) CURB AND GUTTER
- 3 SIDEWALK
- 4 EXISTING GROUND
- 5 FENCE
- 6 SUBBASE GRANULAR MATERIAL, TYPE B
- 7 PAINTED MEDIAN
- 8) BIT. CONC. SURFACE COURSE, MIX D CL. 1, TYPE 2, 1.5"
- 9) BIT. CONC. BINDER COURSE, MIX B, TYPE 2, 1.5"
- (10) P.C.C. BASE COURSE, 9"
- (11) EARTH EXCAVATION / FURNISHED EXCAVATION
- (12) EXISTING PAVEMENT MARKING
- PAVEMENT REMOVAL
- SIDEWALK REMOVAL

# PROPOSED LEGEND

- A) HOT-MIX ASPHALT SURFACE COURSE, MIX "D", N50, 3"
- (B) AGGREGATE BASE COURSE, TYPE B
- (C) SODDING, SALT TOLERANT
- D TOPSOIL EXCAVATION AND PLACEMENT; TOPSOIL, FURNISH AND PLACE, 6"
- E PORTLAND CEMENT CONCRETE SIDEWALK 5 INCH
- F CONCRETE MEDIAN, TYPE SB-6.12
- G COMBINATION CONCRETE CURB AND GUTTER, TYPE B-6.24
- H) TIE BAR

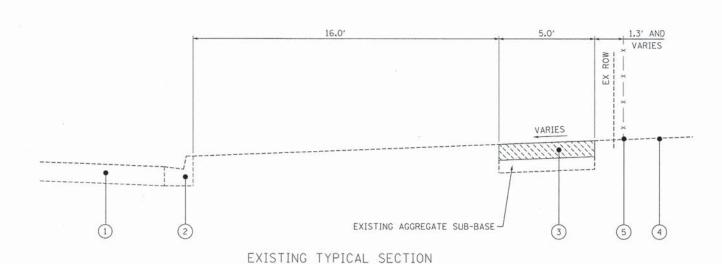

WELLER LANE

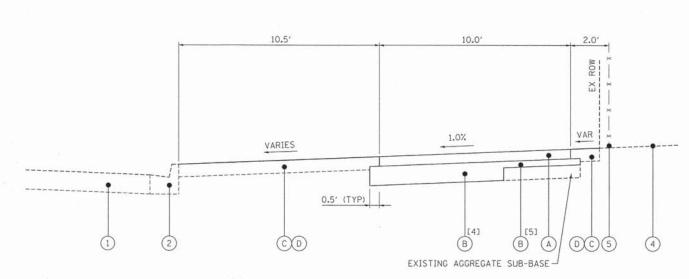

PROPOSED TYPICAL SECTION WELLER LANE

# NOTES:

- [1] CONCRETE MEDIAN ENDS AT STA 114+30.8
- [2] PCC SIDEWALK ENDS AT STA 113+59.8
- [3] PCC SIDEWALK ENDS AT STA 113+80.2
- [4] 6" DEPTH
- [5] 2" DEPTH

DESIGNED - JPA REVISED DRAWN REVISED


VILLAGE OF MOUNT PROSPECT SAFE ROUTES TO SCHOOL


CENTRAL RD AT WELLER LN PEDESTRIAN CROSSING IMPROVEMENTS 14-00162-00-SP COOK 16 6 TYPICAL SECTIONS CONTRACT NO. 61B72 SCALE: NTS SHEET 2 OF 2 SHEETS STA. TO STA.


Ciorba Group, Inc.


Fax 773.775.4014 PLOT DATE = 5/4/2015


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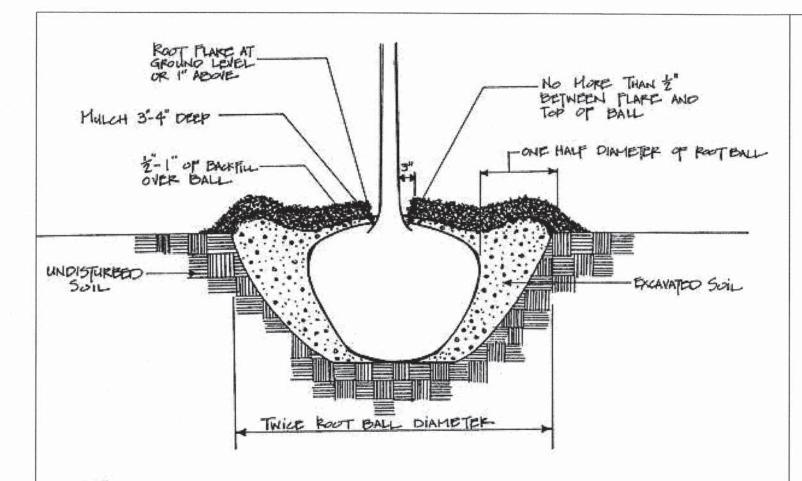


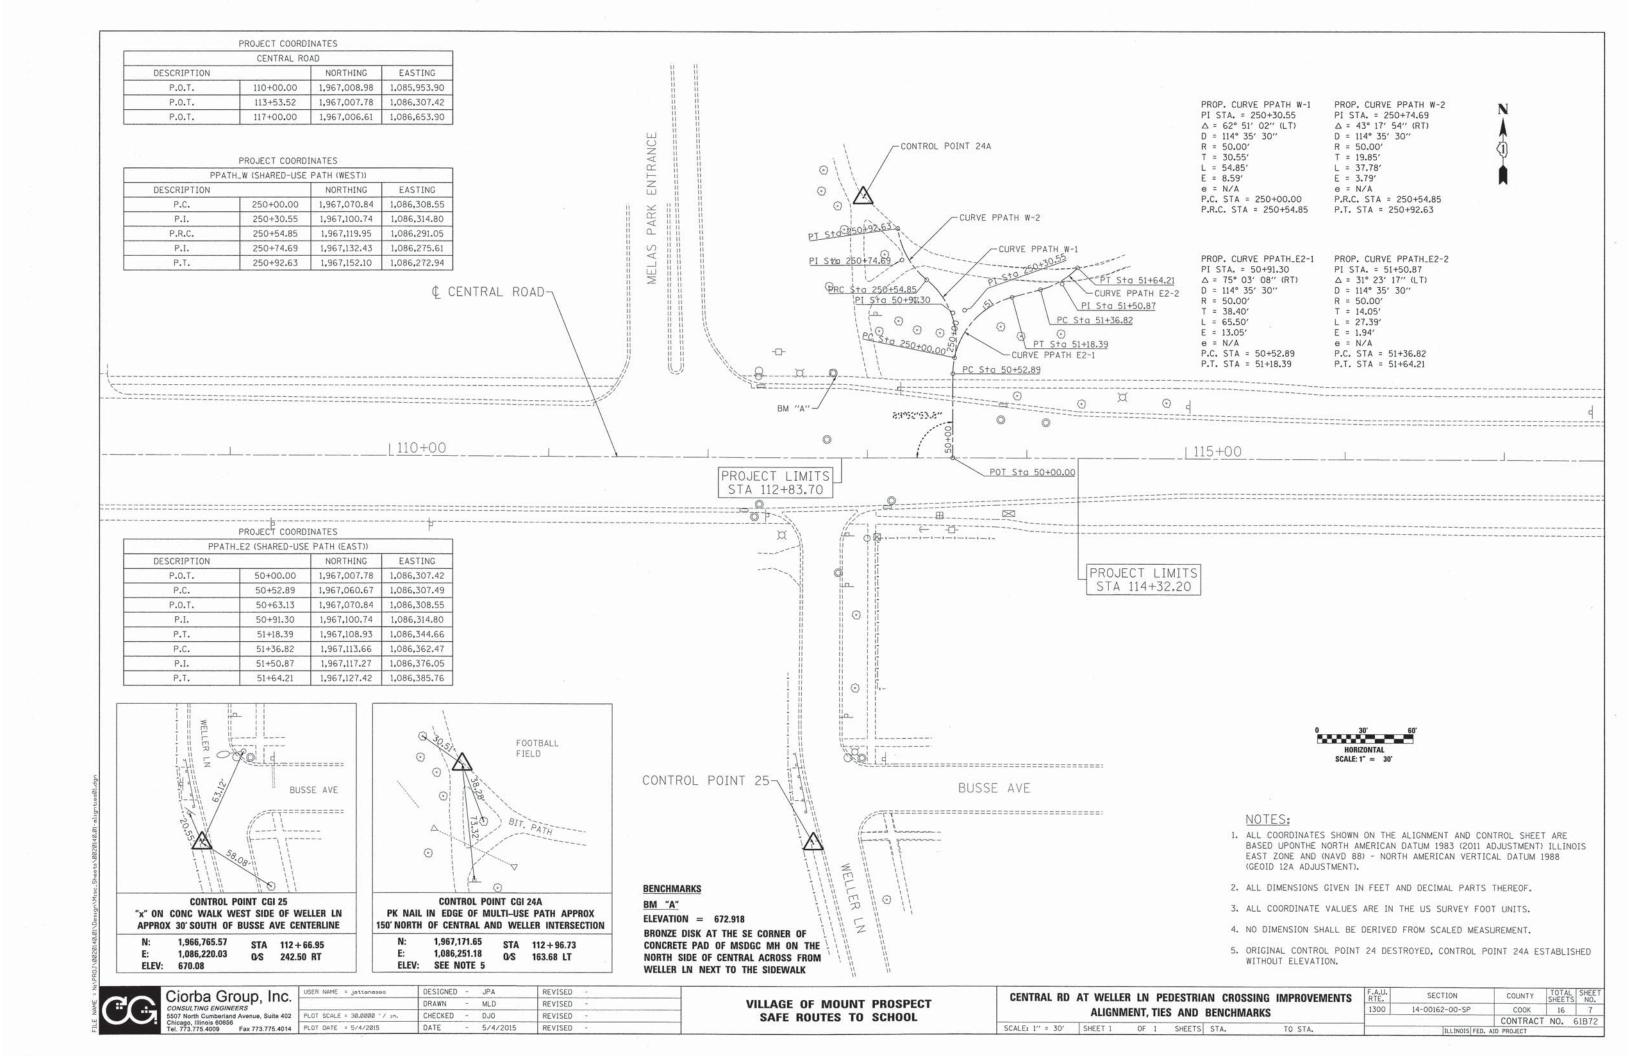

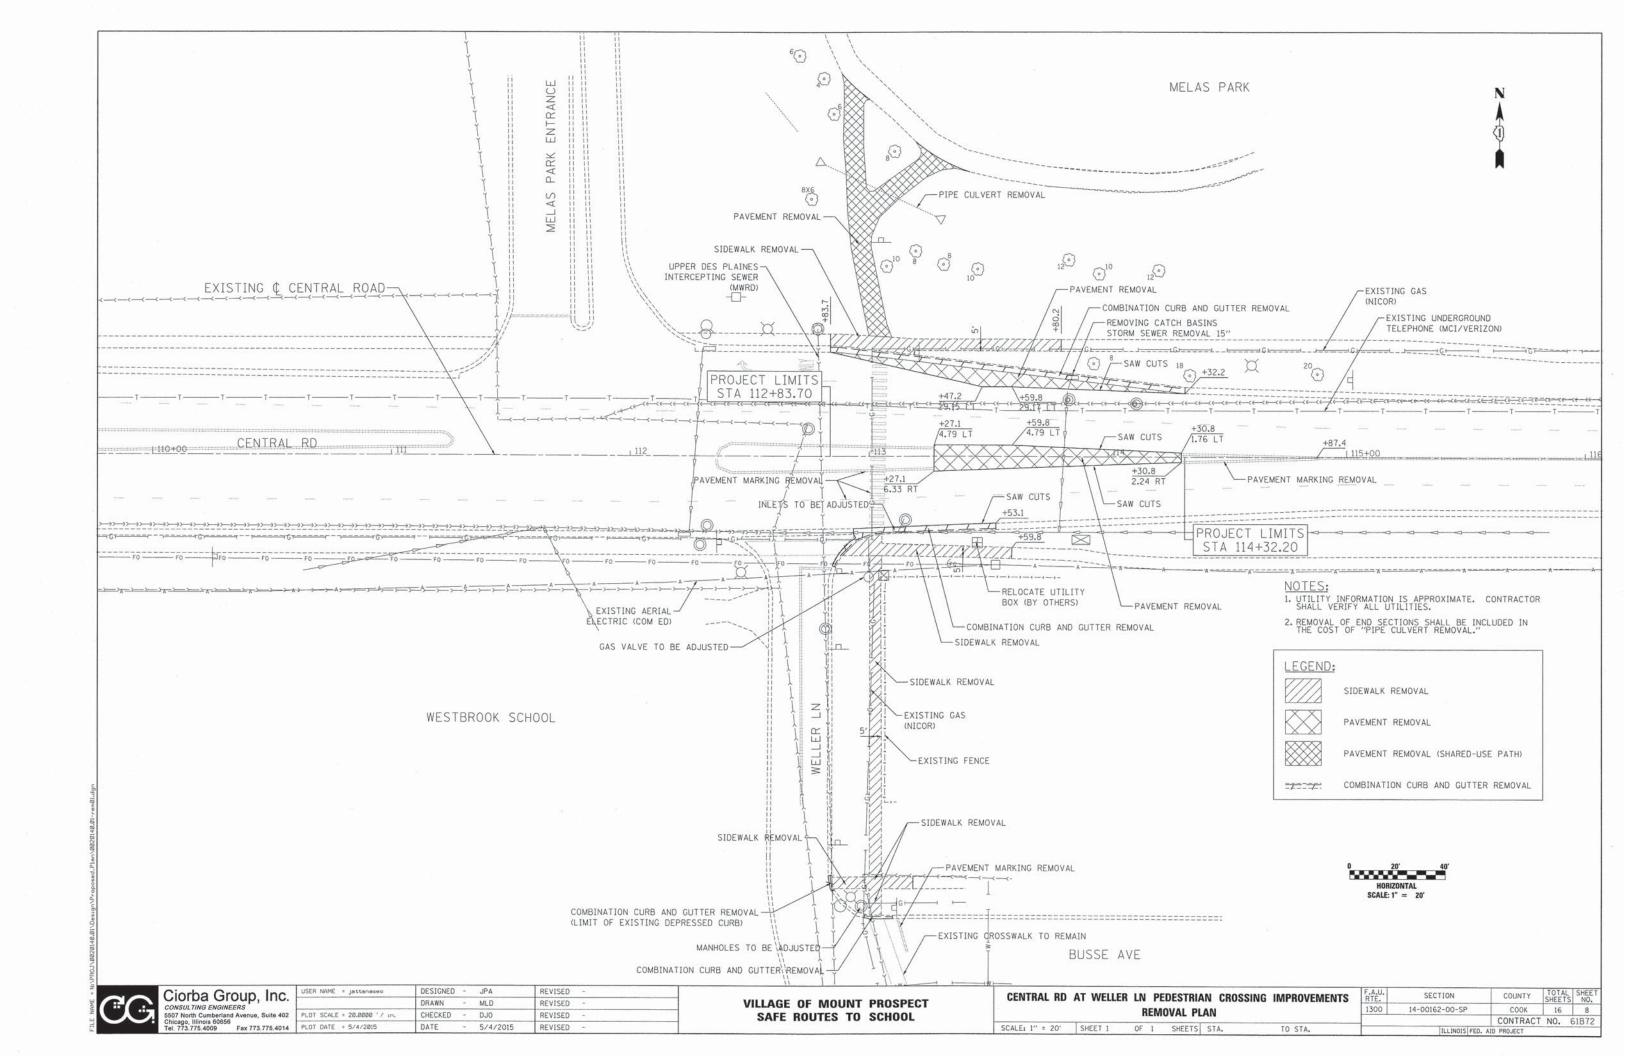

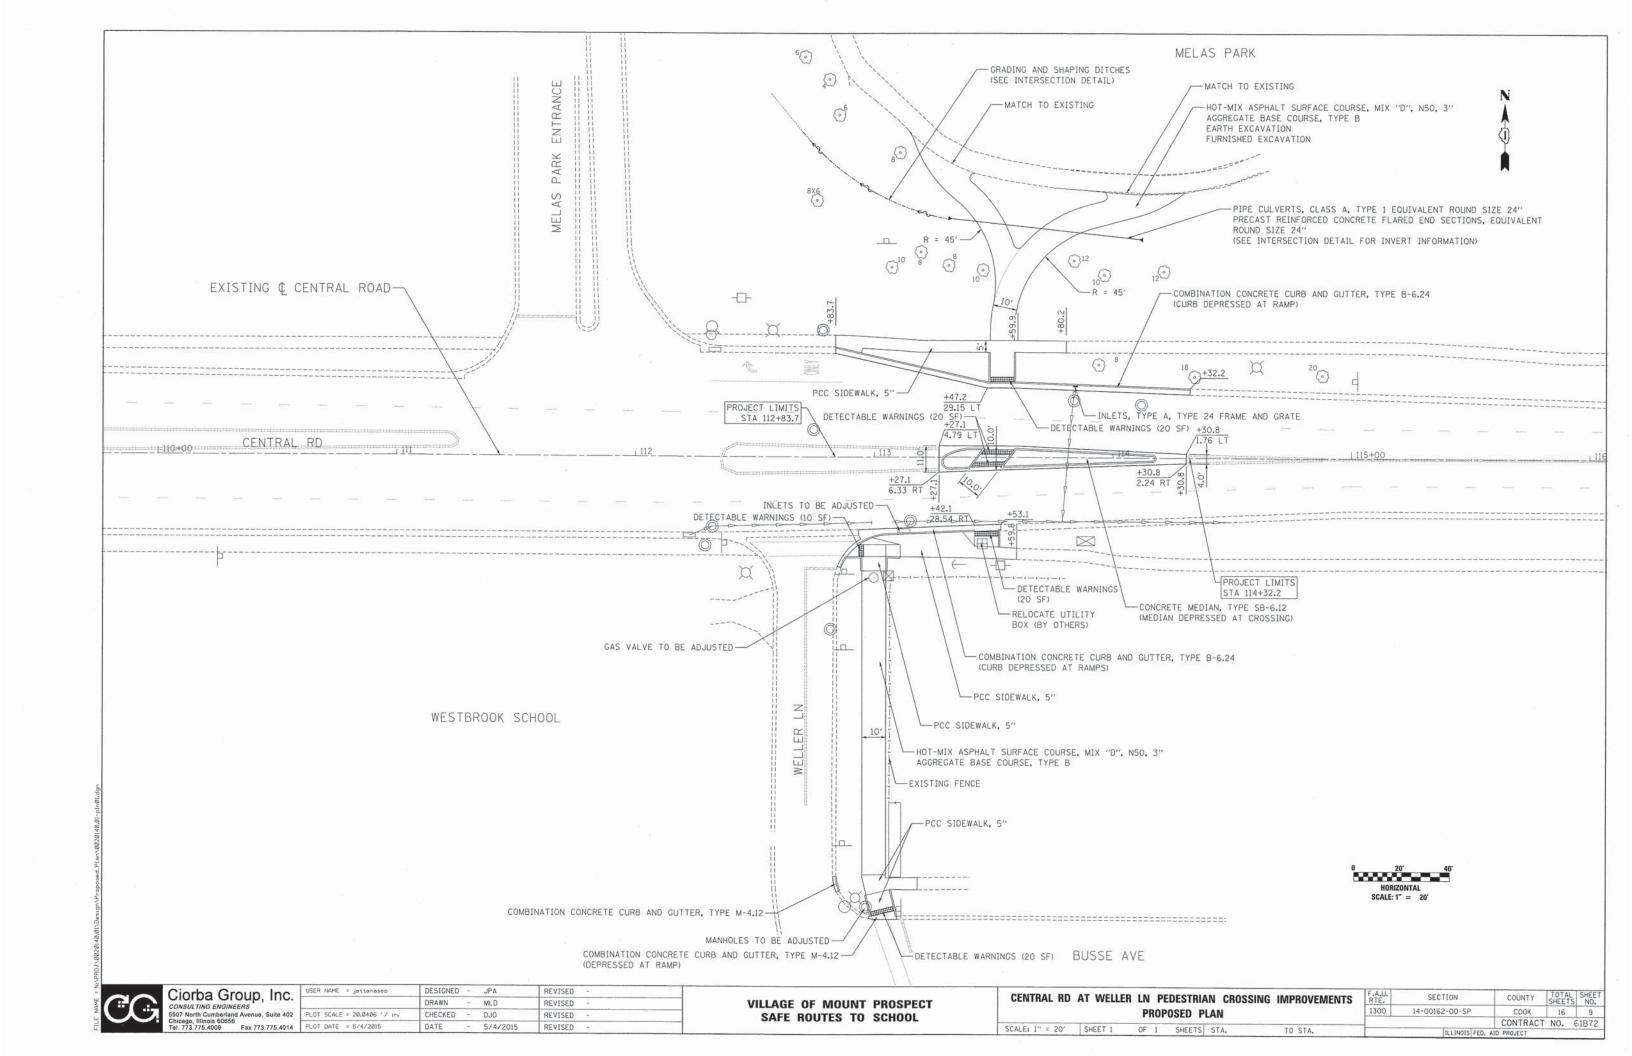

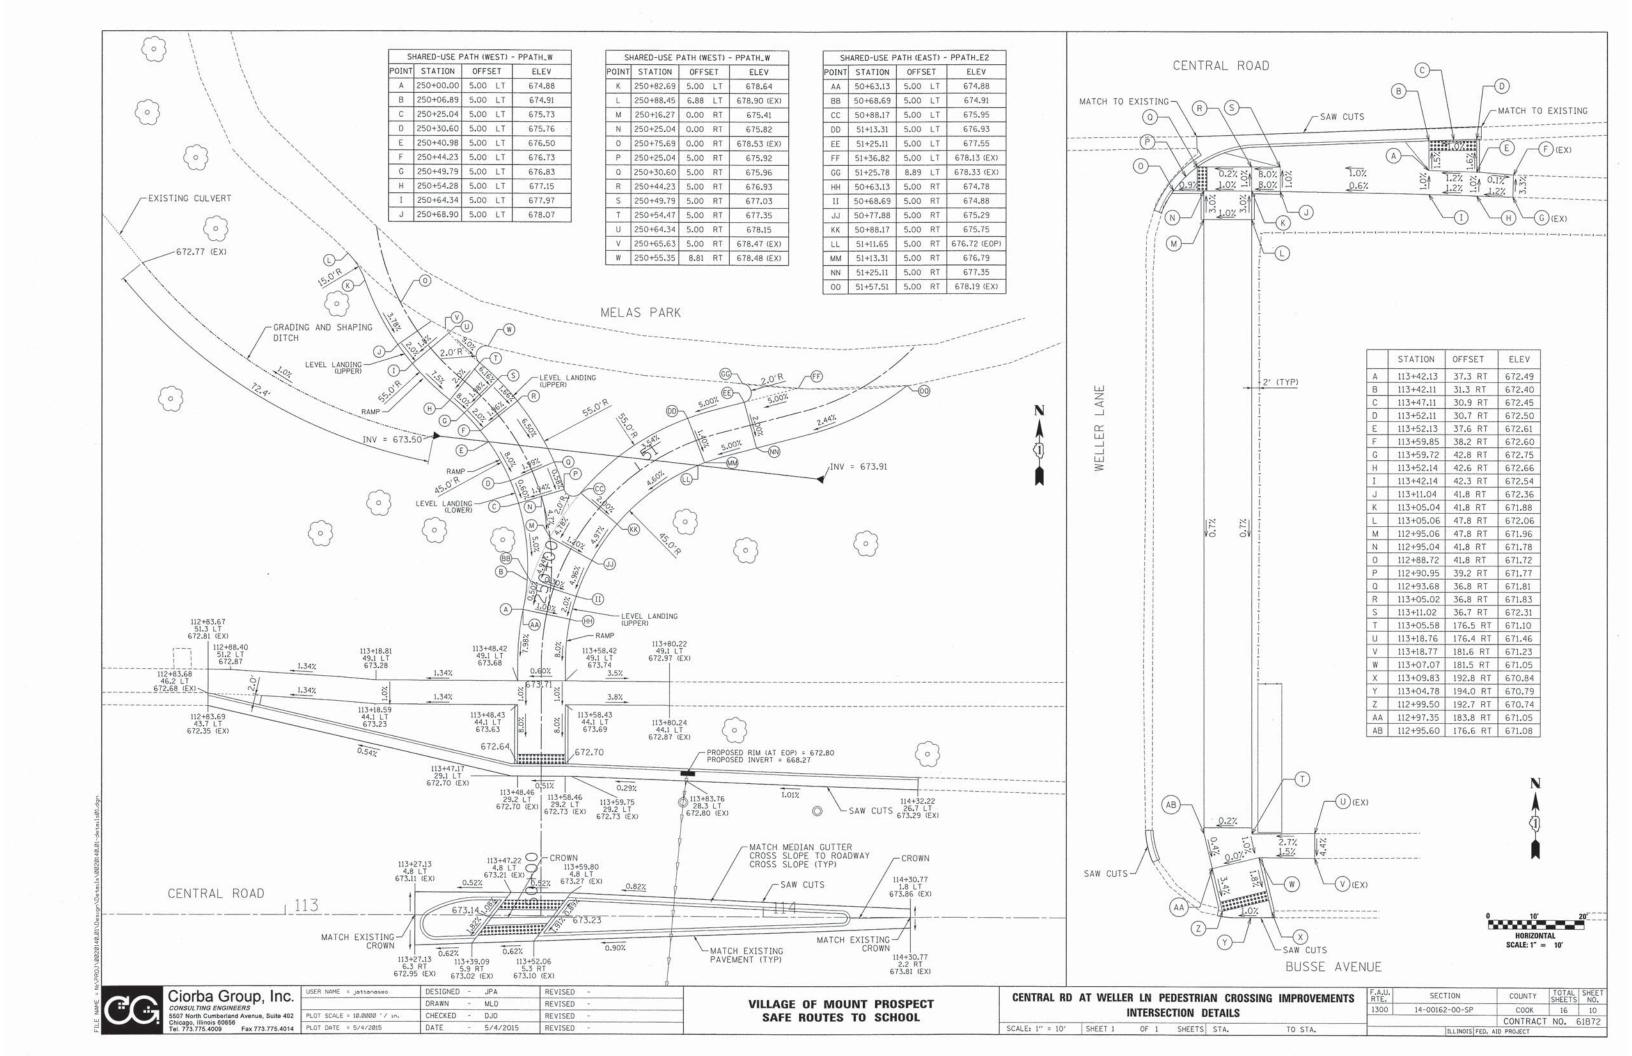

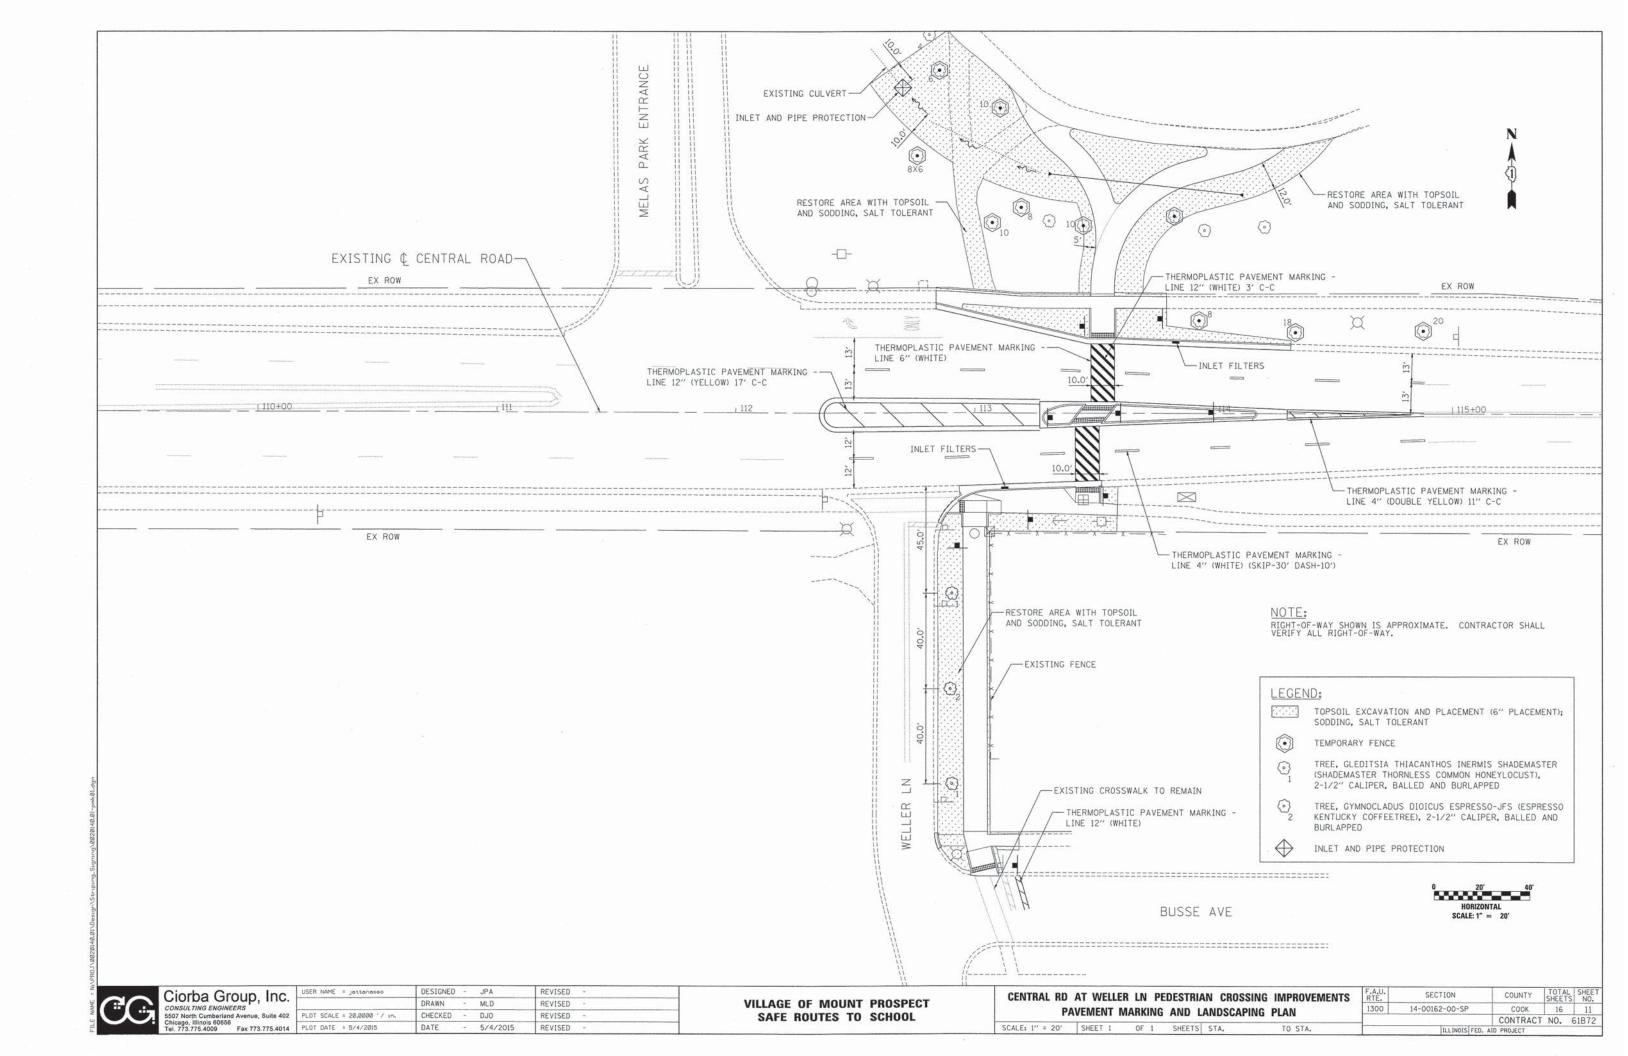

# TREE AND SHRUB PLANTING DETAIL

DIGGING PLANTING HOLE:

- 1. ALL PLANTING HOLES SHALL BE HAND-DUG AND CIRCULAR IN OUTLINE.
- 2. DEPTH OF HOLES SHALL BE SUCH THAT THE BOTTOM OF THE ROOT BALL WILL BE PLACED ON UNDISTURBED SUBGRADE, AND THE ROOT FLARE SHALL BE AT, OR WITHIN ONE INCH ABOVE, THE GRADE OF THE SURROUNDING SOIL.
- 3. WIDTH OF HOLES AT THE SOIL SURFACE SHALL BE TWICE THE DIAMETER OF THE ROOT BALL, WITH SIDES SLOPING INWARD TOWARDS THE BOTTOM OF THE ROOT BALL (SEE
- 4. EXCAVATED PLANT PITS THAT WILL BE LEFT OPEN WHEN WORK IS NOT IN PROGRESS OR POSE AN IMMEDIATE AND CONSIDERABLE HAZARD TO TRAFFIC SHALL BE ADEQUATELY BARRICADED WITH OUALIFIED WARNING DEVICES. NO PLANTING PIT MAY REMAIN OPEN IN EXCESS OF 24 HOURS.

PLACEMENT OF TREE / UNWRAPPING BALL

- IN MOST INSTANCES, THE BACKFILL AROUND THE BALL SHALL BE THE SAME SOIL THAT WAS REMOVED FROM THE HOLE. HOWEVER, IN CASES WHERE EXCESSIVE ROCKS, STONES, ETC. ARE ENCOUNTERED, TOPSOIL SHALL BE USED.
- 2. WHEN APPROXIMATELY TWO-THIRDS TO THREE-FOURTHS OF THE PLANTING PIT HAS BEEN BACKFILLED, THE HOLE SHALL BE WATERED SO AS TO SETTLE THE SOIL AROUND ALL OF THE ROOTS. AFTER THE WATER HAS BEEN ABSORBED, THE PLANTING PIT SHALL BE FILLED WITH THE PLANTING SOIL, TAMPED LIGHTLY TO GRADE, AND WATERED THOROUGHLY AGAIN. ANY FURTHER SETTLEMENT SHALL BE BROUGHT TO GRADE WITH ADDITIONAL PLANTING SOIL. CONTRACTOR SHALL SUPPLY ALL WATERING EQUIPMENT; WATER MAY BE OBTAINED AT NO CHARGE AT THE PUBLIC WORKS FACILITY AT 1700 W. CENTRAL ROAD.
- 3. A SHALLOW "SAUCER" OF SOIL, APPROXIMATELY 3-4" HIGH, SHALL BE FORMED JUST INSIDE THE EDGE OF EACH PLANTING HOLE TO SERVE AS A WATER RESERVOIR.
- 4. ANY EXCESS SOIL OR DEBRIS SHALL BE REMOVED FROM THE PLANTING SITE IMMEDIATELY UPON COMPLETION OF PLANTING EACH INDIVIDUAL TREE.

#### MULCHING

- 1. AFTER PLANTING, THE CONTRACTOR SHALL INSTALL A THREE TO FOUR INCH LAYER OF WOOD CHIPS OR OTHER APPROVED MULCH OVER THE ROOT BALL OUT TO THE OUTER EDGE OF THE SOIL
- 2. NO MULCH SHALL BE PLACED IN CONTACT WITH THE TRUNK OF THE TREE.
- THE VILLAGE WILL MAKE A SUPPLY OF WOOD CHIPS AVAILABLE TO THE CONTRACTOR AT THE PUBLIC WORKS FACILITY, AT NO CHARGE TO THE CONTRACTOR.

#### TRUNK WRAPPING


THE TRUNK OF THE TREE SHALL NOT BE WRAPPED. ANY EXISTING TRUNK WRAPPING MATERIALS SHALL BE REMOVED AND DISPOSED OF.

(NOTE, ABOVE DETAIL IS FOR STANDARD SITES.)

CENTRAL RD AT WELLER LN PEDESTRIAN CROSSING IMPROVEMENTS SECTION COUNTY VILLAGE OF MOUNT PROSPECT 14-00162-00-SP COOK 16 12 LANDSCAPING DETAIL 1300 SAFE ROUTES TO SCHOOL CONTRACT NO. 61B72 SCALE: N.T.S. SHEET 1 OF 1 SHEETS STA. ILLINOIS FED. AID PROJECT


Ciorba Group, Inc. CONSULTING ENGINEERS

DESIGNED JPA REVISED DRAWN -MLD REVISED | PLOT SCALE = 10.8000 '...
| Story North Cumberland Avenue, Suite 402 | PLOT SCALE = 10.8000 '...
| Chicago, Illinois 60656 | Tel. 773.775.4009 | Fax 773.775.4014 | PLOT DATE = 5/4/2815 | PLOT SCALE = 10.0000 ' / in. CHECKED -D.10 REVISED REVISED

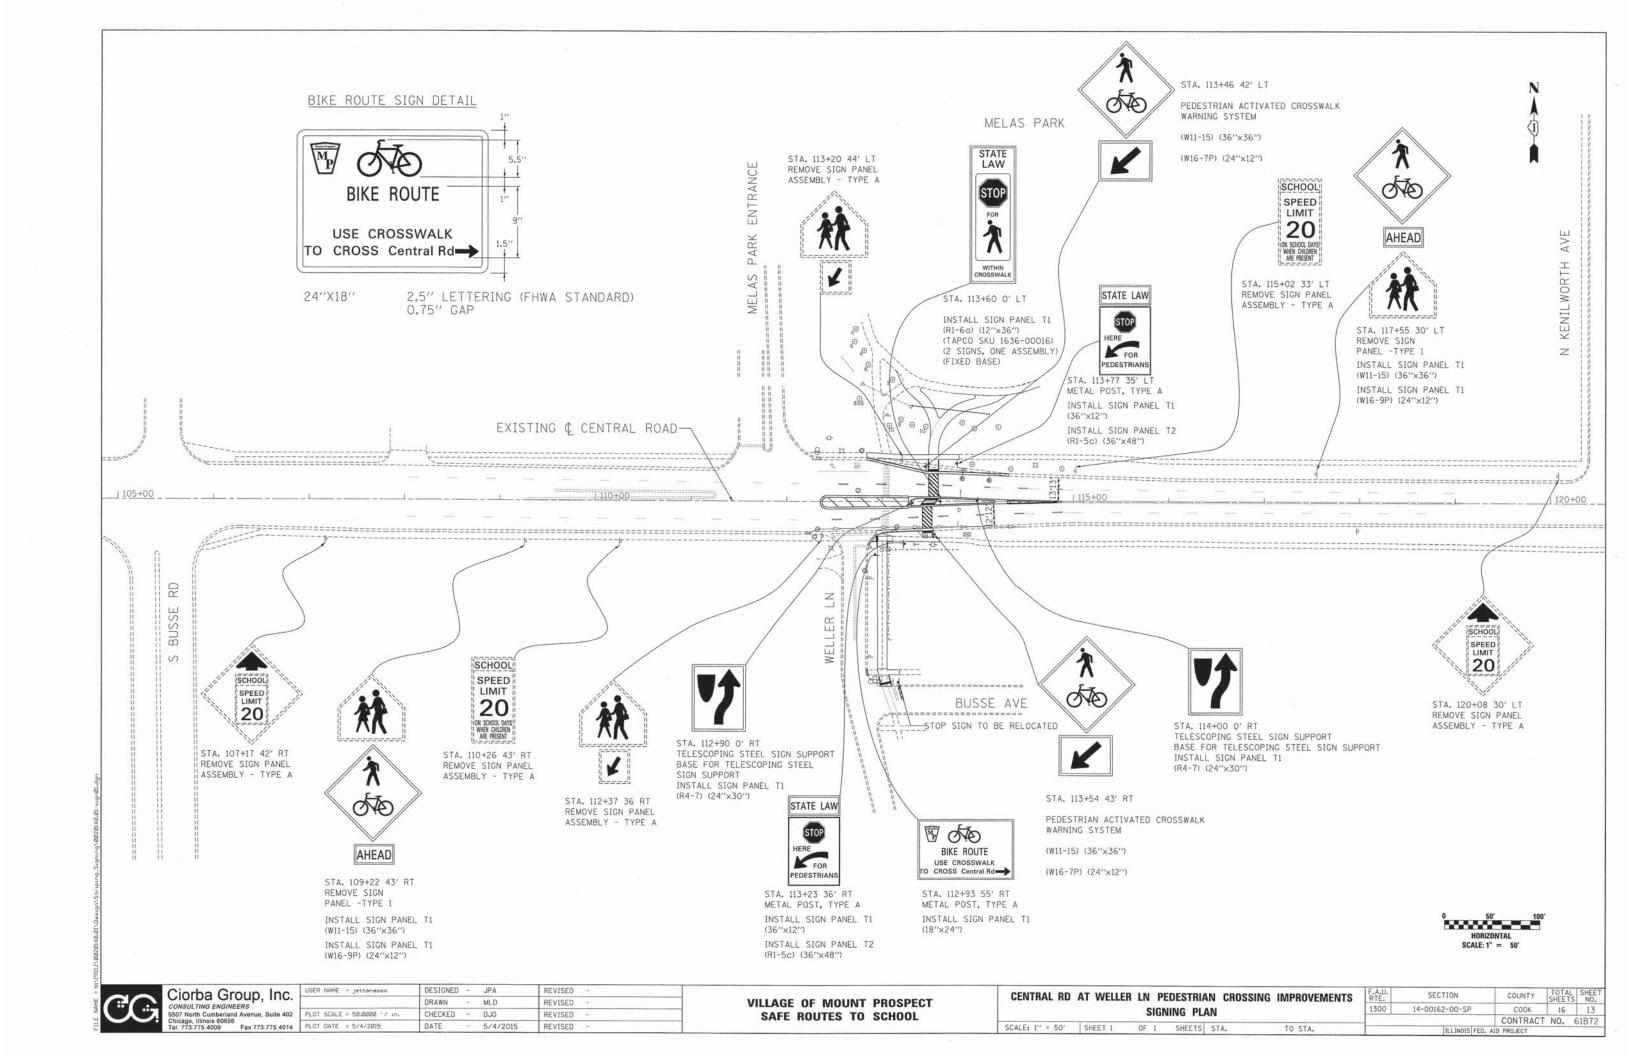



FRONT

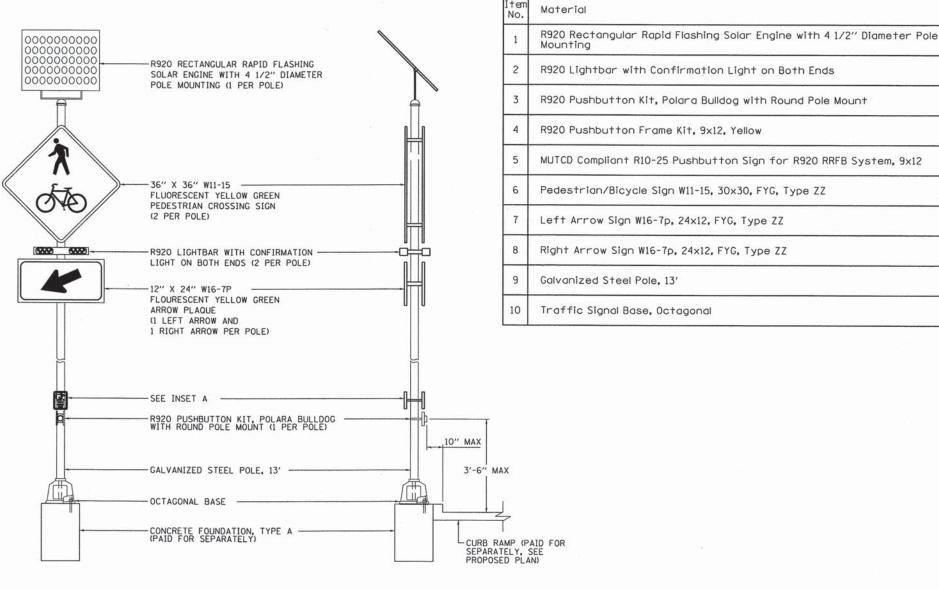

PEDESTRIAN ACTIVATED CROSSWALK WARNING SYSTEM

SIDE

(CARMANAH R920 RECTANGULAR RAPID FLASHING BEACON SYSTEM)
ACTUAL DIMENSIONS AND MOUNTING REQUIREMENTS PER
SPECIAL PROVISIONS AND MANUFACTURER RECOMMENDATIONS

UNLESS NOTED, ALL ITEMS SHOWN IN DETAIL ARE INCLUDED IN THE COST OF "PEDESTRIAN ACTIVATED CROSSWALK WARNING SYSTEM" (SEE BILL OF MATERIALS)

<u>ک</u> ت	Ciorba Gr		
بخات	CONSULTING ENGINE 5507 North Cumberlan Chicago, Illinois 60656 Tel 773 775 4009	d Avenue, Suite 402	

PUSH BUTTON TO

Turn on

Warning Lights

INSET A

USER NAME = jettaneseo	DESIGNED	-	JPA	REVISED -	
	DRAWN	-	MLD	REVISED -	1
PLOT SCALE = 10.0000 '/ in.	CHECKED	-	DJO	REVISED -	
PLOT DATE = 5/4/2015	DATE	-	5/4/2015	REVISED -	

CENTRAL RE	AT WELLER	LN	PE	DESTRIA	N CROSSING	IMPROVEMENTS	F.A.U. RTE.	SECTION	COUNTY	TOTAL	SHEET NO.
		S	IGNI	ING DET	ΔII		1300	14-00162-00-SP	соок	16	13A
	1								CONTRACT	NO.	61B72
SCALE: N.T.S.	SHEET 1	OF	1	SHEETS	STA.	TO STA.	ILLINOIS FED. AID PROJECT				

BILL OF MATERIALS - CARMANAH R920 RECTANGULAR RAPID FLASHING BEACON SYSTEM

Quantity

2

2

2

2


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2

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2

2



# TRAFFIC CONTROL AND PROTECTION FOR SIDE ROADS, INTERSECTIONS, AND DRIVEWAYS
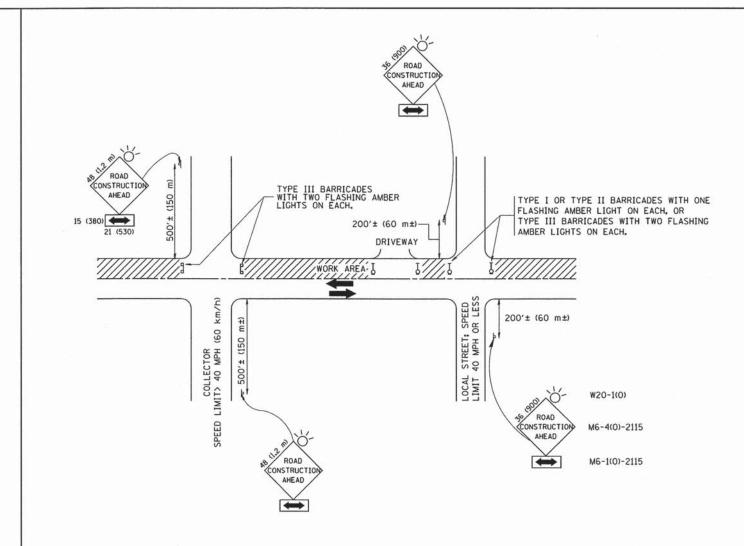
# NOTES:

- A. FOR NO LANE RESTRICTION ON THE SIDE ROAD OR DRIVEWAYS
- 1. SIDE ROAD WITH A SPEED LIMIT OF 40 MPH (60 km/h) OR LESS AS SHOWN ON THE DRAWING AND AS DIRECTED BY THE ENGINEER:
- O) ONE ROAD CONSTRUCTION AHEAD SIGN 36 x 36 (900x900) WITH A FLASHER AND FLAG MOUNTED ON IT APPROXIMATELY 200' (60 m) IN ADVANCE OF THE MAIN ROUTE.
- b) THE CLOSED PORTION OF THE MAIN ROUTE SHALL BE PROTECTED BY BLOCKING WITH TYPE I, TYPE II OR TYPE III BARRICADES, 1/3 OF THE CROSS SECTION OF THE CLOSED PORTION.
- 2. SIDE ROAD WITH A SPEED LIMIT GREATER THAN 40 MPH (60 km/h) AS SHOWN ON THE DRAWING AND AS DIRECTED BY THE ENGINEERs
- O) ONE ROAD CONSTRUCTION AHEAD SIGN 48 x 48 (1,2 m x 1,2 m) WITH A FLASHER MOUNTED ON IT APPROXIMATELY 500' (150 m) IN ADVANCE OF THE MAIN ROUTE.
- b) THE CLOSED PORTION OF THE MAIN ROUTE SHALL BE PROTECTED BY BLOCKING WITH TYPE III BARRICADES, 1/2 OF THE CROSS SECTION OF THE CLOSED PORTION.
- 3. WHEN THE SIDE ROAD LIES BETWEEN THE BEGINNING OF THE MAINLINE SIGNING AND THE WORK ZONE, A SINGLE HEADED ARROW (MG-1) SHALL BE USED IN LIEU OF THE DOUBLE HEADED ARROW (MG-4).

SCALE: NONE

#### B. FOR A LANE CLOSURE ON A SIDE ROAD OR DRIVEWAY:

USE APPLICABLE PORTIONS OF THE TYPICAL APPLICATION OF TRAFFIC CONTROL DEVICES (STD. 701501, STD. 701606 OR THE APPROPRIATE STANDARD). THE SPACING OF SIGNS AND BARRICADES SHALL BE ADJUSTED FOR FIELD CONDITIONS AS DIRECTED BY THE ENGINEER, THE DIRECTIONAL ARROW SHALL BE COVERED OR REMOVED WHEN NO LONGER CONSISTENT WITH THE SIDE ROAD LANE CLOSURE.

- C. ADVANCE WARNING SIGNS ARE TO BE OMITTED ON DRIVEWAY UNLESS OTHERWISE NOTED.
- D. THE TRAFFIC CONTROL AND PROTECTION FOR SIDE ROADS, INTERSECTIONS, AND DRIVEWAYS SHALL BE INCIDENTAL TO THE COST OF SPECIFIED TRAFFIC CONTROL STANDARDS OR ITEMS.

All dimensions are in millimeters (inches) unless otherwise shown.

FILE NAME = USER NAME = gaglianobt DESIGNED - LHA REVISED - J. OBERLE 10-18-95

Wildistatd\22x34\tcl0.dgn

DRAWN - REVISED - A. HOUSEH 03-06-96


PLOT SCALE = 50.000 '/ IN. CHECKED - REVISED - A. HOUSEH 10-15-96


PLOT DATE = 1/4/2008 DATE - 06-89 REVISED - T. RAMMACHER 01-06-00


STATE OF ILLINOIS DEPARTMENT OF TRANSPORTATION

TRAFFIC CONTROL AND PROTECTION FOR
SIDE ROADS, INTERSECTIONS, AND DRIVEWAYS


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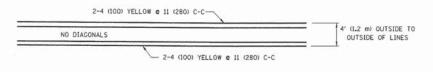


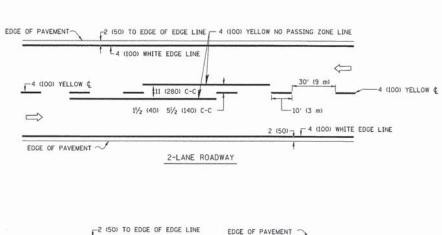

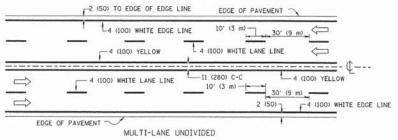
TYPICAL LANE AND EDGE LINE MARKING

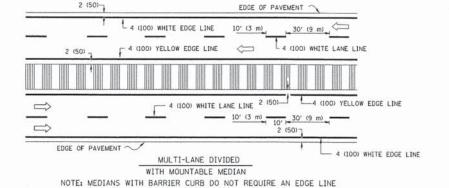

TYPICAL CROSSWALK MARKING

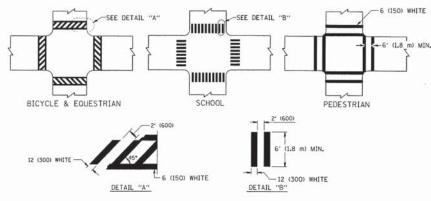


#### 4' (1.2 m) WIDE MEDIANS ONLY

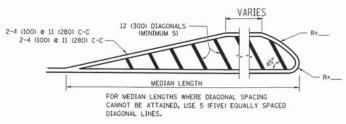


DIAGONAL LINE SPACING: 50' (15 m) C-C (LESS THAN 30MPH (50 km/h)) 75' (25 m) C-C 30MPH (50 km/h) TO 45MPH (70 km/h)) 150' (45 m) C-C (MORE THAN 45MPH (70 km/h))

### MEDIANS OVER 4' (1.2 m) WIDE

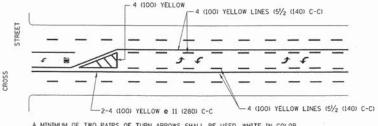


A MINIMUM OF TWO PAIRS OF TURN ARROWS SHALL BE USED, WHITE IN COLOR, ADDITIONAL PAIRS SHALL BE PLACED AT 200' (60 m) TO 300' (90 m) INTERVALS.

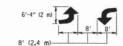

MEDIAN WITH TWO-WAY LEFT TURN LANE

### TYPICAL PAINTED MEDIAN MARKING

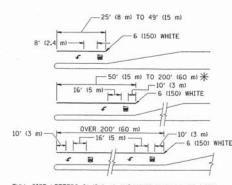


FULL SIZE LETTERS 8' (2.4 m) AND ARROWS SHALL BE USED.  $\P$  AREA = 15.6 SO. FT. (1.5 m²)  $\P$  AREA = 20.8 SO. FT. (1.9 m²)

\* TURN LANES IN EXCESS OF 400' (120 m) IN LENGTH MAY HAVE AN ADDITIONAL SET OF ARROW - "ONLY" INSTALLED MIDWAY BETWEEN THE OTHER TWO SETS OF ARROW - "ONLY".

TYPICAL LEFT (OR RIGHT) TURN LANE

## TYPICAL TURN LANE MARKING

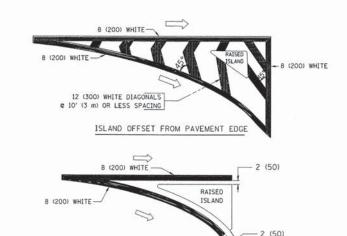

# TYPICAL ISLAND MARKING

ISLAND AT PAVEMENT EDGE

TYPE OF MARKING	WIDTH OF LINE	PATTERN	COLOR	SPACING / REMARKS		
CENTERLINE ON 2 LANE PAVEMENT	4 (100)	SKIP-DASH	YELLOW	10' (3 m) LINE WITH 30' (9 m) SPACE		
CENTERLINE ON MULTI-LANE UNDIVIDED PAVEMENT	2 @ 4 (100)	SOLID	YELLOW	11 (280) C-C		
NO PASSING ZONE LINES: FOR ONE DIRECTION FOR BOTH DIRECTIONS	4 (100) 2 @ 4 (100)	SOLID SOLID	YELLOW	5½ (140) C-C FROM SKIP-DASH CENTERLINE 11 (280) C-C OMIT SKIP-DASH CENTERLINE BETWEEN		
LANE LINES	4 (100) 5 (125) ON FREEWAYS	SKIP-DASH SKIP-DASH	WHITE WHITE	10' (3 m) LINE WITH 30' (9 m) SPACE		
DOTTED LINES (EXTENSIONS OF CENTER, LANE OR TURN LANE MARKINGS)	SAME AS LINE BEING EXTENDED	SKIP-DASH	SAME AS LINE BEING EXTENDED	2' (600) LINE WITH 6' (1.8 m) SPACE		
EDGE LINES	4 (100)	SOLID	YELLOW-LEFT WHITE-RIGHT	OUTLINE MOUNTABLE MEDIANS IN YELLOW: EDGE LINES ARE NOT USED NEXT TO BARRIER CURB		
TURN LANE MARKINGS	6 (150) LINE; FULL SIZE LETTERS & SYMBOLS (8' (2.4m))	SOLID	WHITE	SEE TYPICAL TURN LANE MARKING DETAIL		
TWO WAY LEFT TURN MARKING	2 @ 4 (100) EACH DIRECTION	SKIP-DASH AND SOLID	YELLOW	10' (3 m) LINE WITH 30' (9 m) SPACE FOR SKIP-DASH; 51/2 (140) C-C BETWEEN SOLID LINE AND SKIP-DASH LINE		
	8' (2.4m) LEFT ARROW	IN PAIRS	WHITE	SEE TYPICAL TWO-WAY LEFT TURN MARKING DETAIL		
CROSSWALK LINES (PEDESTRIAN) A. DIAGONALS (BIKE & EQUESTRIAN) B. LONGITUDINAL BARS (SCHOOL)	2 @ 6 (150) 12 (300) @ 45° 12 (300) @ 90°	SOLID SOLID	WHITE WHITE WHITE	NOT LESS THAN 6' (1.8 m) APART 2' (500) APART 2' (600) APART SEE TYPICAL CROSSWALK MARKING DETAILS.		
STOP LINES	24 (600)	SOLID	WHITE	PLACE 4' (1.2 m) IN ADVANCE OF AND PARALLEL TO CROSSWALK, IF PRESENT, OTHERWISE, PLACE AT DESIRED STOPPING POINT, PARALLEL TO CROSSROAD CENTERLINE, WHERE POSSIBLE		
PAINTED MEDIANS	2 @ 4 (100) WITH 12 (300) DIAGONALS @ 45° NO DIAGONALS USED FOR 4' (1.2 m) WIDE MEDIANS	SOLID	YELLOW: TWO WAY TRAFFIC WHITE: ONE WAY TRAFFIC	11 (280) C-C FOR THE DOUBLE LINE SEE TYPICAL PAINTED MEDIAN MARKING.		
ORE MARKING AND 8 (200) WITH 12 (300) HANNELIZING LINES DIAGONALS @ 45°		SOLID	WHITE	DIAGONALS: 15' (4,5 m) C-C (LESS THAN 30MPH (50 km/h)) 20' (6 m) C-C 30MPH (50 km/h) TO 45MPH (70 km/h)) 30' (9 m) C-C (OVER 45MPH (70 km/h))		
RAILROAD CROSSING	24 (600) TRANSVERSE LINES: "RR" IS 6' (1.8 m) LETTERS: 16 (400) LINE FOR "X"	SOLID	WHITE	SEE STATE STANDARD 780001 AREA OF: "R"=3.6 SO. FT. (0.33 m²) EACH "X"=54.0 SO. FT. (5.0 m²)		
SHOULDER DIAGONALS	12 (300) @ 45°	SOLID	WHITE - RIGHT YELLOW - LEFT	50' (15 m) C-C (LESS THAN 30MPH (50 km/h)) 75' (25 m) C-C (30 MPH (50 km/h) TO 45MPH (70 km/h)) 150' (45 m) C-C (0VER 45MPH (70 km/h))		


FOR FURTHER DETAILS ON PAVEMENT MARKING REFER TO STANDARD SPECIFICATIONS FOR ROAD AND BRIDGE CONSTRUCTION AND STATE STANDARD 780001.

All dimensions are in inches (millimeters) unless otherwise shown.

FILE NAME =	USER NAME = drivakosgn	DESIGNED	-	EVERS	REVISED	-T.	RAMMACHER	10-27-94
c:\pw_work\pwidot\drivakosgn\d0108315\tc	13.dgn	DRAWN	=		REVISED	-C.	JUCIUS	09-09-09
	PLOT SCALE = 50.000 ' / IN.	CHECKED	+		REVISED	-		
	PLOT DATE = 9/9/2009	DATE	4	03-19-90	REVISED	-		

# STATE OF ILLINOIS **DEPARTMENT OF TRANSPORTATION**

DISTRICT ONE TYPICAL PAVEMENT MARKINGS					F.A. SECTION		COUNTY TOT		TS SHEET
					1300	14-00162-00-SP	COOK 16		15
					TC-13	CONTRACT NO.			
SCALE: NONE	SHEET NO. 1 OF 1	SHEETS	STA.	TO STA.	FED. ROAD DIST. NO. 1   ILLINOIS   FED. AID PROJECT				

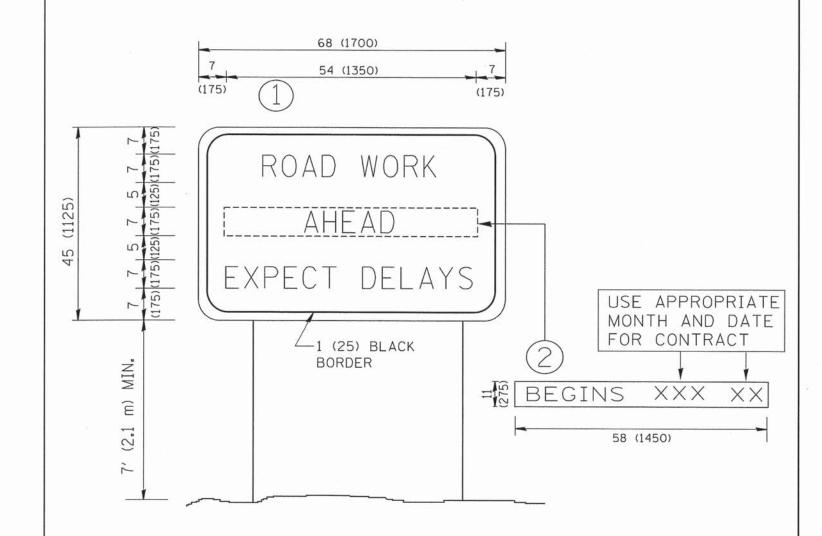

# NOTES:

- 1. USE BLACK LETTERING ON ORANGE BACKGROUND.
- 2. ERECT SIGNS IN ADVANCE OF THE LOCATION FOR THE "ROAD CONSTRUCTION AHEAD" SIGN AT LOCATIONS AS DIRECTED BY THE ENGINEER.
- 3. ERECT SIGN () WITH INSTALLED PANEL (2) ONE WEEK PRIOR TO THE START OF CONSTRUCTION.
- 4. REMOVE PANEL 2 SOON AFTER THE START OF CONSTRUCTION.
- 5. SEE SPECIAL PROVISION FOR "TEMPORARY INFORMATION SIGNING" FOR ADDITIONAL INFORMATION.
- 6. ONE SIGN ASSEMBLY EQUALS 25.70 SQ. FT. (2.3 SQ. M.)
- 7. SHALL BE PAID FOR AS TEMPORARY INFORMATION SIGNING.

ALL DIMENSIONS ARE IN INCHES (MILLIMETERS) UNLESS OTHERWISE SHOWN.

FILE NAME =	USER NAME = geglienobt	DESIGNED -	REVISED - R. MIRS 09-15-97
W:\diststd\22x34\to22.dgn		DRAWN -	REVISED - R. MIRS 12-11-97
Book Service College C	PLOT SCALE = 50.000 ' / IN.	CHECKED -	REVISED -T. RAMMACHER 02-02-99
	PLOT DATE = 1/4/2008	DATE -	REVISED - C. JUCIUS 01-31-07

STATI	E OF	FILLINOIS
DEPARTMENT	OF	TRANSPORTATION

ARTERIAL ROAD					F.A RTE.	SECTION	COUNTY	TOTAL	SHEET NO.	
		INFO	RMATION	SIGN		1300	14-00162-00-SP	соок	16	16
INFORMATION SIGN					TC-22		CONTRACT NO.			
CALE: NONE	SHEET NO. 1 O	F 1	SHEETS	STA.	TO STA.	FED, ROAD	FEO. ROAD DIST. NO. 1   ILLINOIS FED. AID PROJECT			