STATE OF ILLINOIS DEPARTMENT OF TRANSPORTATION DIVISION OF HIGHWAYS

PLANS FOR PROPOSED FEDERAL AID HIGHWAY

FOR INDEX OF SHEETS SEE SHEET NO. 2

MAPLE AVENUE RELIEF SEWER SECTION 08-00079-02-FP PROJECT NO. M-9003 (168) COOK COUNTY C-91-203-09

PROJECT STAGE 2

PROJECT LOCATED IN THE VILLAGE OF LA GRANGE

SECTION 4, TOWNSHIP 38N, RANGE 12E LYONS TOWNSHIP


0 100' 200' 300' 1"= 100' 0 10' 20' 30' 1"= 10' 0 50' 100' 1"= 50' 0 50' 100' 1"= 40' 0 50' 100' - 1"= 30' 0 50' 100' - 1"= 20'


FULL SIZE PLANS HAVE BEEN PREPARED USING STANDARD ENGINEERING SCALES; REDUCED SIZED PLANS WILL NOT CONFORM TO STANDARD SCALES. IN MAKING MEASUREMENTS ON REDUCED PLANS, THE ABOVE SCALES MAY BE USED.

FOR UTILITY INFORMATION CALL J.U.L.I.E. 1-800-892-0123

CONTRACT NO. 63149

GROSS LENGTH OF PROJECT = 1,872.00 LINEAL FEET = 0.35 MILES NET LENGTH OF PROJECT = 1,872.00 LINEAL FEET = 0.35 MILES

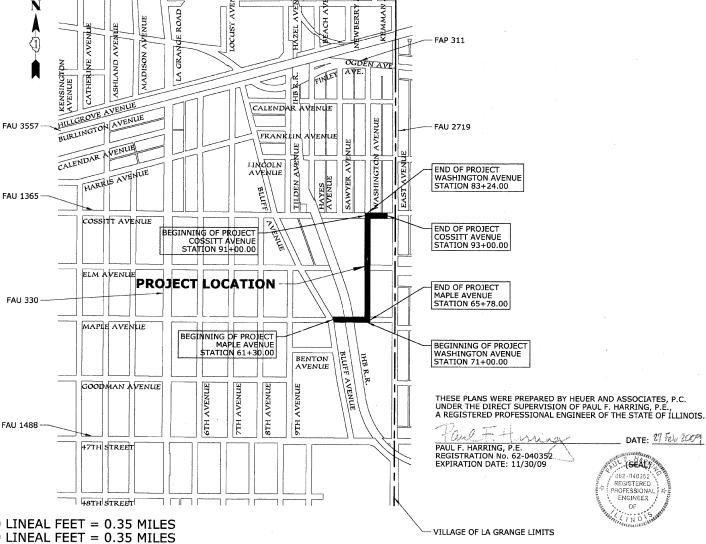

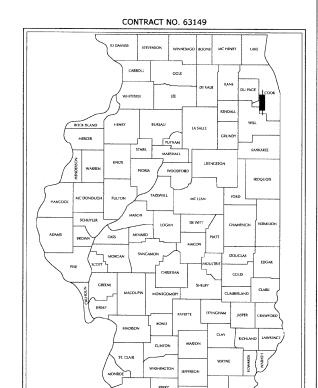

SECTION


1004 08-00079-02-FP

COUNTY

32

COOK

FED. ROAD DIST. NO. 1 ILLINOIS FED. AID PROJECT

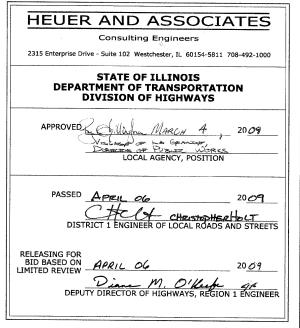

LOCATION OF SECTION INDICATED THUS:

PRINTED BY AUTHORITY OF THE STATE OF ILLINOIS

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		EXISTIN SYMBOL	G PROPOSED L SYMBOL	DESCRIPTION
		ස	0	DECIDUOUS TREE
			W. F.	EVERGREEN TREE
			2	HANDHOLE, TYPE A
		<u> </u>	× •—•	CONCRETE LIGHTPOLE - ARM TYPE
		×) (LIGHTPOLE - LA GRANGE RESIDENTIAL STANDARD
		ø		POWER POLE
HECKED		0	•	MANHOLE
TTED INMENT C 0F WAY		0	•	CATCHBASIN
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HECKED S NOTAT'NS CH'KD			-	SEWER SERVICE
18 0 M				WATER SERVICE
NOTE BOOK GRADE NO. STRUCT		MANHOLE RIM=704.9 INV=692.5 INV=692.5	STRUCTURE # RIM: 600.00 INV: 595.00	STRUCTURE RIM AND INVERTS
and an arrange				COMBINATION CURB AND GUTTER
			1 2 1 2 1	PROPOSED P.C.C. DRIVEWAY

PROPOSED P.C.C. SIDEWALK PROPOSED TRANSITION PATCH PROPOSED HMA SURFACE COURSE - BUTT JOINT

PROPOSED DETECTABLE WARNING PLATE

HH

HEUER AND ASSOCIATES
Consulting Engineers

FA.U. SECTION COUNTY TOTAL SHEETS NO.

1004 08-00079-02-FP COOK 32 2 Consulting Engineers
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2315 Enterprise Drive - Suite 102 Westchester, IL 60154-5811 708-492-1000
FED. ROAD DIST. NO. 1 ILLINOIS FED. AID PROJECT

CONTRACT No. 63149

	INDEX OF SHEETS
SHEET NUMBER	DRAWING TITLE
1 2 3 4 5 6 7 8 9 10-13 14-17 18-21 22-25 26-27 28-32	REMOVAL AND EROSION CONTROL PLAN PAVEMENT PLAN AND PROFILE DRAINAGE AND UTILITY IMPROVEMENTS SEWER OUTLET CROSS-SECTIONS

	STATE STANDARDS
STANDARD No.	DRAWING TITLE
280001-04 701501-05 701801-04 701901-01	TEMPORARY EROSION CONTROL SYSTEMS URBAN LANE CLOSURE, 2L, 2W UNDIVIDED SIDEWALK CLOSURE TRAFFIC CONTROL DEVICES
DISTRICT 1 STANDARDS BD 22 TC 10 TC 13	PAVEMENT PATCHING FOR HMA SURFACED PAVEMENT TRAFFIC CONTROL AND PROTECTION FOR SIDE ROADS, INTERSECTIONS AND DRIVEWAYS TYPICAL PAVEMENT MARKING

	REVISIONS		ULUNOS DEDADEUE	IT 05 TO 1115
	NAME	DATE	ILLINOIS DEPARTMEN	NT OF TRANSPORTATION
				IMPROVEMENTS AGE 2
			INDEX OF SHEETS	S, STATE STANDARDS LEGEND
-			SCALE:	DRAWN BY H&A
			DATE 02/27/2009	CHECKED BY PFH



GENERAL NOTES

- 1. ALL CONSTRUCTION SHALL BE COMPLETED IN ACCORDANCE WITH THE 1. ALL CONSTRUCTION SHALL BE COMPLETED IN ACCORDANCE WITH THE SPECIFICATIONS, GENERAL CONDITIONS, SPECIAL PROVISIONS, AND OTHER CONTRACT REQUIREMENTS OF THE OWNER; CODES, STANDARDS, AND ORDINANCES OF THE VILLAGE OF LA GRANGE; PLANS, DETAILS, AND SPECIFICATIONS ISSUED BY THE ENGINEER; THE APPLICABLE PROVISIONS OF THE 2007 EDITION OF THE "STANDARD SPECIFICATIONS FOR ROAD AND BRIDGE CONSTRUCTION"; THE 2013 EDITION OF THE "ILLINOIS MANUAL OF UNIFORM TRAFFIC CONTROL DEVICES FOR STREETS AND HIGHWAYS"; THE 1996 EDITION OF THE "STANDARD SPECIFICATIONS FOR WATER AND SEWER MAIN CONSTRUCTION IN ILLINOIS"; AND THE 1999 EDITION OF THE "MANUAL OF PROCEDURES FOR THE ADMINISTRATION OF A SEWER PERMIT ORDINANCE"; INCLUDING ALL APPLICABLE SUPPLEMENTAL SPECIFICATIONS AND REVISIONS. SUPPLEMENTAL SPECIFICATIONS AND REVISIONS.
- 2. THE CONTRACTOR SHALL BE RESPONSIBLE FOR DETERMINING THE LOCATION OF ALL UNDERGROUND UTILITIES AND SHALL CONTACT J.U.L.I.E. (1-800-892-0123), THE OWNER, AND EACH OF THE OTHER MUNICIPAL, GOVERNMENTAL AND/OR PRIVATE UTILITY COMPANIES, WHICH MAY HAVE THEIR FACILITIES LOCATED WITHIN THE LIMITS OF THE PROPOSED IMPROVEMENTS TO AID IN THE LOCATION OF FACILITIES. THE CONTRACTOR SHALL PROVIDE THE OWNER AND ALL PERMITTING AGENCIES AT LEAST TWO (2) WORKING DAYS OF UNDERGROUND THE COMPANIES OF THE CONTRACTOR SHALL PROVIDED THE OWNER AND ALL PERMITTING AGENCIES AT LEAST TWO (2) WORKING DAYS OF UNDERGROUND THE COMPANIES OF UNDERGROUND TO TRUTTIES. NOTICE PRIOR TO THE COMMENCEMENT OF CONSTRUCTION ACTIVITIES.
- 3. THE CONTRACTOR SHALL INDEMNIFY AND HOLD HARMLESS THE OWNER AND THE ENGINEER FROM AND AGAINST ALL CLAIMS, DAMAGES, LOSSES, AND EXPENSES, DIRECT, INDIRECT, OR CONSEQUENTIAL, ARISING OUT OF, OR FROM THE PERFORMANCE OF THE WORK.
- 4. ALL FENCES, BUILDINGS, WALKWAYS, TREES, LANDSCAPING, AND OTHER EXISTING FEATURES IN PRIVATE PROPERTY AREAS ADJACENT TO THE PROJECT LIMITS SHALL BE PROTECTED FROM DAMAGE DURING THE COURSE OCCUSTRUCTION, UNLESS OTHERWISE SPECIFIED BY THE OWNER. DAMAGED PROPERTY SHALL BE RESTORED BY THE CONTRACTOR TO THE SATISFACTION OF THE OWNER WITHOUT ADDITIONAL COMPENSATION.
- 5. ALL SAW CUTTING REQUIRED TO DEFINE PAVEMENT REMOVAL LIMITS OR TO CUT OTHER MATERIALS REQUIRED IN THE CONSTRUCTION OF THE PAVING IMPROVEMENTS SHALL BE CONSIDERED AS INCIDENTAL TO THE PAVING WORK.
- 6. THE CONTRACTOR SHALL PROTECT PAVEMENTS, WALKS, CURBS, BURIED STRUCTURES, AND OTHER SUCH FEATURES WITHIN AND ADJACENT TO THE PAVEMENT WORK ZONE NOT DESIGNATED FOR REMOVAL. DAMAGED MATERIALS SHALL BE REPLACED AT THE SOLE EXPENSE OF THE CONTRACTOR.
- 7. ALL TRENCHES SHALL BE EXCAVATED AT THE MINIMAL WIDTH REQUIRED TO INSTALL THE SEWER PIPE, AS INDICATED IN THE PLAN DETAILS. THE CONTRACTOR SHALL MAKE ALLOWANCES FOR ANY SHEETING, SHORING, BRACING, TRENCH BOXES, OR OTHER MEASURES REQUIRED TO INSTALL THE SEWER AND MAINTAIN MINIMAL TRENCH WIDTHS. THE CONTRACTOR SHALL MAKE PROVISIONS TO MANAGE GROUND WATER OR SEWER FLOW BY PUMPING OR FLUMING THROUGH THE WORK ZONE DURING THE COURSE OF CONSTRUCTION. ALL TRENCH SUPPORT OR WATER MANAGEMENT MEASURES REQUIRED SHALL BE CONSIDERED AS INCIDENTAL TO THE SEWER WORK INCIDENTAL TO THE SEWER WORK.
- 8. IT SHALL BE THE CONTRACTOR'S RESPONSIBILITY TO DESIGN AND CONSTRUCT ALL TEMPORARY EARTH RETENTION TO COMPLY WITH APPLICABLE SAFETY AND ENGINEERING STANDARDS. THE CONTRACTOR SHALL FURNISH TO THE OWNER AND TO THE ENGINEER CALCULATIONS AND DESIGN FILES PREPARED BY A LICENSED STRUCTURAL ENGINEER FOR APPROVAL PRIOR TO COMMENCING WITH THE EARTH RETENTION INSTALLATION.
- 9. THE CONTRACTOR SHALL MANAGE THE PLACEMENT AND HANDLING OF ALL NEW MATERIALS AND WASTE MATERIALS GENERATED BY THE CONSTRUCTION OPERATIONS. CONSTRUCTION ACCESS POINTS TO THE SITE SHALL BE PROTECTED IN SUCH A WAY AS TO PREVENT TRACKING OF SOIL AND AGGREGATE ONTO PUBLIC THOROUGHFARES. AT THE END OF EACH WORK DAY THE CONTRACTOR SHALL PERFORM SITE MAINTENANCE REMOVING AND/OR RELOCATING MATERIALS WHICH INTERFERE WITH PUBLIC USE OF AREAS ADJACENT TO THE WORK ZONE, KEEPING SIDEWALKS, ROADWAYS, AND OTHER PASSAGE-WAYS FREE OF ACCUMULATIONS OF WATER, MUD, SPOIL, AND OTHER CONSTRUCTION DEBRIS.
- 10. THE CONTRACTOR SHALL RECORD DIMENSIONS AND ELEVATIONS OF CONSTRUCTED UTILITIES AND MAINTAIN A COPY OF THE SUCH RECORDS ON MARKED DRAWINGS TO DOCUMENT CHANGES. THE RECORD DRAWINGS SHALL BE PROVIDED TO THE ENGINEER AT THE COMPLETION OF THE CONSTRUCTION WORK.

LANDSCAPING NOTES:

- 1. ALL DISTURBED AREAS SHALL BE RESTORED WITH TOPSOIL AND SALT TOLERANT SOD. LIMITS FOR RESTORATION SHALL BE UP TO THE RIGHT OF WAY LIMITS UNLESS OTHERWISE NOTED.
- 2 LINLESS SPECIFICALLY DIRECTED ON THE PLANS OR DIRECTED/ 2. UNLESS SPECIFICALLY DIRECTED ON THE PLANS OR DIRECTED/ APPROVED BY THE ENGINEER, PAYMENT FOR SOD RESTORATION SHALL BE LIMITED TO 3 FEET ALONG REPLACED CURB, SIDEWALK, OR DRIVEWAY APRON. SODDING SHALL BE PLACED IN ACCORDANCE OR DRIVEWAY ARKON. SODDING SHALL BE PLACED IN ACCORDANG WITH THE SEASONAL SCHEDULE AS OUTLINED IN ARTICLE 252.04 OF THE IDOT STANDARD SPECIFICATION. SEASONAL PLANTING SCHEDULE FOR SEEDING SHALL BE OUTLINED IN ACCORDANCE WITH ARTICLE 250.07 OF THE IDOT STANDARD SCHEDULE.
- 3. NUTRIENT ALLOWANCE FOR SODDING:

NITROGEN FERTILIZER NUTRIENTS
PHOSPHORUS FERTILIZER NUTRIENTS
POTASSIUM FERTILIZER NUTRIENTS
OF the second second

NUTRIENT ALLOWANCE FOR SEEDING:

NITROGEN FERTILIZER NUTRIENTS 90 LB/ACRE PHOSPHORUS FERTILIZER NUTRIENTS 90 LB/ACRE POTASSIUM FERTILIZER NUTRIENTS 90 LB/ACRE

- 4. ALL SODDING SHALL BE ROLLED AFTER PLACEMENT. SOD STAKING SHALL BE REQUIRED AT THE DISCRETION OF THE ENGINEER.
- 5. PROVISIONS SHALL BE MADE FOR WATERING AND MAINTENANCE UNTIL THE PLANTING MATERIALS HAVE BECOME ESTABLISHED AS IN ARTICLE 253 OF THE IDOT STANDARD SPECIFICATION.
- 6. ALL DISTURBED LANDSCAPE AREAS SHALL BE RESTORED WITH 6. ALL DISTURBED LANDSCAPE AREAS SHALL BE RESTORED WITH THE SPECIFIED LANDSCAPE MATERIALS IN ACCORDANCE WITH SEASONAL AND PROJECT PLANTING SCHEDULES. A MINIMUM OF FOUR INCHES OF TOPSOIL SHALL BE PLACED ON CLEAN PREPARED SOILS WHERE LANDSCAPE AREAS ARE TO BE ESTABLISHED. PROVISIONS SHALL BE MADE FOR WATERING AND MAINTENANCE UNTIL PLANTING MATERIALS HAVE BECOME ESTABLISHED AS OUT THE PROVISION OF OUTLINED IN SECTION 253 OF THE IDOT STANDARD SPECIFICATIONS.

PAVEMENT MARKING NOTES:

- LOCATION AND PLACEMENT OF ALL PAVEMENT MARKINGS SHALL 11. LOCATION AND PLACEMENT OF ALL PAVEMENT MARKINGS SHALL BE IN ACCORDANCE WITH THAT STIPULATED ON THE PLANS, AS OUTLINED IN THE MANUAL ON UNIFORM TRAFFIC CONTROL DEVICES (2003 EDITION, REVISION 1), OR AS INDICATED BY THE ENGINEER
- . THERMOPLASTIC PAVEMENT MARKING SHALL BE USED FOR
- ALL LINES TO BE WHITE UNLESS OTHERWISE NOTED.

MWRD GENERAL NOTES

- 1. THE METROPOLITAN WATER RECLAMATION DISTRICT OF GREATER CHICAGO (MWRDGC), LOCAL SEWER SYSTEMS SECTION, FIELD OFFICE SHALL BE NOTIFIED AT LEAST TWO (2) WORKING DAYS PRIOR TO THE COMMENCEMENT OF SEWER WORK TO COORDINATE INSPECTION SERVICES, (708-588-4055).
- 2. THE PLAN ELEVATIONS ARE BASED UPON A USGS DATUM ELEVATION. THE CITY OF CHICAGO STANDARD DATUM IS 579.48 FEET LOWER THAN THE PLAN
- 3. ALL FLOOR DRAINS SHALL DISCHARGE TO THE SANITARY SEWER SYSTEM.
- 4. ALL DOWNSPOUTS AND FOOTING DRAINS SHALL DISCHARGE TO THE GROUND SURFACE OR STORM WATER DRAINAGE SYSTEM.
- 5. ALL SANITARY SEWER PIPE MATERIALS AND JOINTS (AND STORM SEWER PIPE MATERIALS AND JOINTS IN COMBINED SEWER AREAS) SHALL CONFORM TO FOLLOWING LISTED SPECIFICATIONS:

MATERIAL: POLY VINYL CHLORIDE (PVC) CYLINDER SPECIFICATION: SDR 26, ASTM D-3034 JOINT SPECIFICATION: ASTM D-3212

MATERIAL: CEMENT LINED CAST DUCTILE IRON (DI) CYLINDER SPECIFICATION: CLASS 52, ANSI A-21.51 JOINT SPECIFICATION: ANSI A-21.11

MATERIAL: REINFORCED CONCRETE PIPE (RCP) CYLINDER SPECIFICATION: ASTM C-76 JOINT SPECIFICATION: ASTM C-443 OR ASTM D-=361

- 6. ALL SANITARY SEWER CONSTRUCTION, AND STORM SEWER CONSTRUCTION IN COMBINED SEWER AREAS, REQUIRES STONE BEDDING WITH A 1/4 INCH TO 1 INCH GRADATION WITH A MINIMUM BEDDING THICKNESS EQUAL TO ONE QUARTER OF THE OUTSIDE DIAMETER OF THE SEWER PIPE, BUT NOT LESS THAN 4 INCHES NOR MORE THAN 8 INCHES IN THICKNESS. THE BEDDING MATERIAL SHALL ALSO BEING PLACED TO A DEPTH OF AT LEAST 12 INCHES ABOVE THE TOP OF THE SEWER PIPE WHEN USING PVC SEWER MATERIAL. ALL BEDDING MATERIAL SHALL CONSIST OF CRUSHED LIMESTONE, CONFORMING TO IDOT GRADATION CA-11 OR CA-13 GRADATION CA-11 OR CA-13.
- 7. NON-SHEAR TYPE FLEXIBLE TYPE COUPLINGS, FERNCO, BAND-SEAL, OR EQUAL SHALL BE USED IN THE CONNECTION OF SEWER PIPES OF DISSIMILAR MATERIALS, AND TO JOIN NEW AND OLD PIPE OR SIMILAR COMPOSITION WHEN POINT REPAIRS
- 8. WHEN CONNECTING TO AN EXISTING SEWER MAIN BY MEANS OTHER THAN AN EXISTING WYE, TEE, OR MANHOLE, THE CONNECTION CAN BE MADE BY (A) INSTALLING A NEW MANHOLE TO ACCEPT THE PROPOSED BRANCH SEWER; OR (B) BY CIRCULAR SAW-CUTTING THE SEWER MAIN WITH A PROPER TAPPING MACHINE AND THE INSTALLATION OF AN APPROVED HUB WYE SADDLE OR HUB TEE SADDLE IN ACCORDANCE WITH MANUFACTURERS RECOMMENDATION; OR (C) BY REMOVING AN ENTIRE SECTION OF PIPE AND INSTALLING A MANUFACTURED WYE OR TEE FITTING. WHEN REMOVING THE PIPE SECTION A PIPE CUTTER, SHALL BE USED TO NEATLY AND ACCURATELY CUT OUT A DESIRED LENGTH OF PIPE FOR INSERTION OF THE PROPER FITTING. BAND-SEAL OR SIMILAR FLEXIBLE COUPLINGS ARE TO BE USED TO FASTEN AND SECURE THE INSERTED FITTING AND PIPE TO THE EXISTING SEWER.
- 9. WHEREVER A SANITARY OR COMBINED SEWER CROSSES UNDER A WATERMAIN, THE MINIMUM VERTICAL DISTANCE FROM THE TOP OF THE SEWER TO THE BOTTOM OF THE WATERMAIN SHALL BE 18 INCHES. FURTHERMORE, A MINIMUM HORIZONTAL DISTANCE OF 10 FEET BETWEEN THE SEWERS AND WATER MAINS SHALL BE MAINTAINED UNLESS THE SEWER IS LAID IN A SEPARATE TRENCH, KEEPING A MINIMUM OF 18 INCHES VERTICAL SEPARATION; OR THE SEWER IS LAID SO THAT THE WATERMAIN IS LOCATED IN THE SAME TRENCH ON A BENCH OF UNDISTURBED EARTH, KEEPING A MINIMUM 18 INCH VERTICAL SEPARATION. IF EITHER THE VERTICAL OR HORIZONTAL DISTANCES DESCRIBED ABOVE CANNOT BE MAINTAINED, OR THE SEWER CROSSES ABOVE THE WATERMAIN, THE SEWER SHALL BE CONSTRUCTED TO WATER MAIN STANDARDS.
- 10. ALL EXISTING SEPTIC TANKS SHALL BE ABANDONED. ABANDONED TANKS SHALL BE FILLED WITH GRANULAR MATERIAL OR REMOVED.
- 11. ALL SANITARY MANHOLES, AND ALSO STORM MANHOLES IN COMBINED SEWER AREAS, SHALL HAVE A MINIMUM INSIDE DIAMETER OF 48 INCHES AND SHALL BE CAST IN PLACE OR PRECAST REINFORCED CONCRETE. ALL SANITARY SEWER PIPE CONNECTIONS TO MANHOLES SHALL BE CONSTRUCTED USING RESILIENT CONNECTORS OR COUPLINGS CONFORMING TO ASTM C923 TO MAINTAIN A WATERTIGHT SEAL.
- 12. ALL SEWER CONSTRUCTION SHALL CONFORM TO THE PLANS, OR REVISED PLANS, AS APPROVED UNDER THE PERMIT ISSUED BY THE MWRDGC.
- 13. THE MAXIMUM ALLOWABLE RATE OF INFILTRATION FOR SANITARY SEWERS SHALL NOT EXCEED 100 HUNDRED GALLONS PER TWENTY-FOUR HOURS, PER MILE, PER INCH-DIAMETER OF PIPE.
- 14. ALL SANITARY SEWERS SHALL BE INSPECTED AND TESTED IN ACCORDANCE WITH THE REQUIREMENTS OF THE MWRD.
- 15. ABANDONED PIPES OR CONDUITS, SHALL BE REMOVED AND/OR SECURELY PLUGGED WITH CONCRETE EXTENDING A MINIUM LENGTH OF 2 FEET.

HEUER AND ASSOCIATES

Consulting Engineer:

1004 08-00079-02-FP COOK 32 TO STA. 2315 Enterprise Drive - Suite 102 Westchester, IL 60154-5811 708-492-1000 FED. ROAD DIST, NO. 1 ILLINOIS | FED. AID PROJECT

COUNTY

SECTION

CONTRACT No. 63149

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NAME	DATE	ILLINOIS DEPARTMEN	NI OF TRANSPORTATION
		BLUFF AVENUE	E IMPROVEMENTS
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		DATE 02/27/2009	CHECKED BY PFH

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HEUER AND ASSOCIATES

Consulting Engineers

2315 Enterprise Drive - Suite 102 Westchester, IL 60154-5811 708-492-100

F.A.U. RTE.	SECTION		COUNTY	TOTAL SHEETS	SHEET No.	
1004	08-00079-02	2-FP	соок	32	4	
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FED. RO	OAD DIST. NO. 1	ILLINOI	S FED.	AID PROJE	:CT	

CONTRACT No. 63149

#	CODE #	CONTRACT ITEM	QTY	UNIT	STU IOOO	NON- PART
1	20100110	TREE REMOVAL (6 TO 15 UNITS DIAMETER)	14	UNIT	14	
2	20101400	NITROGEN FERTILIZER NUTRIENT	18	POUND	18	
3	20101500	PHOSPHORUS FERTILIZER NUTRIENT	18	POUND	18	
1	20101600	POTASSIUM FERTILIZER NUTRIENT	18	POUND	18	
5	20101700	SUPPLEMENTAL WATERING	10	UNIT	10	
5	20200200	ROCK EXCAVATION	25		25	
7	21001000	GEOTECHNICAL FABRIC FOR GROUND STABILIZATION	805	SQ YD	805	
3	21101615	TOPSOIL FURNISH AND PLACE, 4"		SQ YD	1,467	
	25200650	SODDING, SALT TOLERANT (SPECIAL)	1,467	SQ YD	1,467	
0	28000510	INLET FILTERS	8	EACH	8	
1	31101000	SUB-BASE GRANULAR MATERIAL, TYPE B	210	TON	210	
2_	40201000	AGGREGATE FOR TEMPORARY ACCESS	50		50	
3	40600100	BITUMINOUS MATERIALS (PRIME COAT)	315	GALLON	315	
4	40600300	AGGREGATE (PRIME COAT)	1		1	
5	40600982	HOT-MIX ASPHALT SURFACE REMOVAL - BUTT JOINT		SQ YD	349	
6_	40701921	HOT-MIX ASPHALT PAVEMENT (FULL DEPTH), 12"		SQ YD	700	
7_	42001300	PROTECTIVE COAT		SQ YD	250	
8_	42400200	PORTLAND CEMENT CONCRETE SIDEWALK 5 INCH	The second second second	SQ FT	893	
9_	44001900	COMBINATION CURB AND GUTTER REMOVAL (SPECIAL)	585		585	
0	44004400	PAVEMENT REMOVAL (SPECIAL)	823		823	
1	44004700	SIDEWALK REMOVAL (SPECIAL)	921	SQ FT	921	
2_	55022800	STORM SEWERS, TYPE 2, REINFORCED CONCRETE CULVERT, STORM DRAIN, AND SEWER PIPE, CLASS II 60"	301	FOOT	301	
3_	550B0320	STORM SEWERS, CLASS B, TYPE 2 8"	28	FOOT	28	
4_	550B0340	STORM SEWERS, CLASS B, TYPE 2 12"	257	FOOT	257	
5_	60201330	CATCH BASINS, TYPE A, 4'-DIAMETER, TYPE 23 FRAME AND GRATE	1		1	
6	60218400	MANHOLES, TYPE A, 4'-DIAMETER, TYPE 1 FRAME, CLOSED LID	3		3	****
7_	60233500	PRECAST "T" MANHOLES FOR 60" DIAMETER STORM SEWER, TYPE 1 FRAME, CLOSED LID	3	EACH	3	
8	60500040	REMOVING MANHOLES	1	EACH	1	
9	60603800	COMBINATION CONCRETE CURB AND GUTTER, TYPE B-6.12	360	FOOT	360	
0	60604400	COMBINATION CONCRETE CURB AND GUTTER, TYPE B-6.18	195	FOOT	195	
1	66700095	PERMANENT SURVEY MARKERS	. 2	EACH	2	
2	67100100	MOBILIZATION	1	L SUM	1	
3	70101700	TRAFFIC CONTROL AND PROTECTION	1	L SUM	1	
4	70101900	TRAFFIC CONTROL AND PROTECTION (DETOUR 1)	1	L SUM	1	
5_	X0322917	PROPOSED STORM SEWER CONNECTION TO EXISTING MANHOLE	1	EACH	1	
6	X4420132	CLASS D PATCHES, SPECIAL		SQ YD	15	
7	XX000405	BUTT JOINTS, SPECIAL	349	SQ YD	349	
8	XX003160	CAST IRON VAPOR TRAPS	1		1	
9_	XX005314	BITUMINOUS DRIVEWAY REMOVAL		SQ YD	15	
0_	XX005595	TRENCH BACKFILL, CA-6		CU YD	2,242	
1		TREE PROTECTION AND PRESERVATION		EACH	7	
2_	XX007357	CLASS C PATCHES, SPECIAL		SQ YD	85	
	XX007729	DETECTABLE WARNING, SPECIAL		SQ FT	16	
4		TRENCH BACKFILL, CA-11		CU YD	446	
	Z0048665	RAILROAD PROTECTIVE LIABILITY INSURANCE		L SUM	1	
	Z0076600 Z			HOUR	500	
		SEWER IN STEEL CASING PIPE		FOOT	160	
		SEWER IN TUNNEL, 60"	1,275	FOOT	1,275	
9	XX00811Z *	SEWER PIPE BULKHEAD 120"	1	EACH	1	
0	XX008113 *	SEWER PIPE BULKHEAD 60"	1	EACH	1	
1_	X6325845 *	STEEL CASING PIPE, AUGERED, 24"	160	FOOT	160	
າ ົ	1xm8114 1	STORM SEWERS, CLASS B, TYPE 2 120"	167	FOOT	167	

* = DENOTES SPECIALTY ITEM \$\Delta\$ \(\forall 0 \) 80

	REVISIONS NAME	DATE	BLUFF AVENUE STA	IT OF TRANSPORTATION IMPROVEMENTS AGE 2 OF QUANTITIES
E			SCALE: DATE 02/27/2009	DRAWN BY H&A CHECKED BY PFH

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		1	PAY ITEM CODE		55080320 55080340 XX005595 XX007754								
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SHEET	UPSTREAM STRUCTURE # or (STATION)	UPSTREAM DEPTH	DOWNSTREAM STRUCTURE # or (STATION)	DOWNSTREAM DEPTH	AVERAGE DEPTH	8" PVC STORM	12" PVC COMBINATION	60" RCP IN TRENCH RELIEF	TRENCH BACKFILL CA-6, CY	TRENCH BACKFILL CA-11, CY	60" RCP IN TUNNEL RELIEF	120" RCP IN TRENCH RELIEF	12" PVC IN CASING PIPE COMBINATION
22	(6147)	8.80	6152	8.80	8.8		5		6.0	0.6			
22	6152	8.80	(6236)	9.20	9.0		84		100.5	9.2			
22	(6147)	16.00	6153	16.00	16.0			6	20.3	3.5			
22	6153	16.00	(6237)	16.00	16.0			85	288.1	50.0			
22	(6236)	0.00	(6396)	0.00	0.0				0.0	0.0			160
22	(6237)	0.00	(6397)	0.00	0.0				0.0	0.0	160		
22	(6396)	10.00	6479	8.10	9.1		83		96.6	9.1			
22	(6397)	15.80	6486	16.00	15.9			89	301.6	52.3			
22	6479	8.20	6558	6.90	7.6		80		75.1	8.8			
22	6486	16.00	(6519)	16.00	16.0			32	108.4	18.8			
22	(6519)	15.80	(7125)	16.00	15.9	<u> </u>		11	37.3	6.5			
22	6558	6.90	(6563)	6.90	6.9		5		4.7	0.6			
22 24	(7125) (7135)	15.80 0.00	(7135)	16.00 0.00	15.9 0.0	ļ		10	33.9	5.9	1115	ļ	
25	(8250)	16.00	(8250) 8257	16.00				 	0.0	0.0	1115	ļ	ļ
25	8257	16.00	(8271)	16.00	16.0			7	23.7	4.1			
25	(8271)	16.00	(82/1)	16.00	16.0 16.0	<u> </u>		14	47.4	8.2		 	ļ
25	(8271)	5.24	(8260)	5.52	5.4	28		47	159.3 18.1	27.6 2.2		 	
25	(9124)	19.00	(9291)	19.00	19.0	<u> </u>			711.4	237.8		167	
22			AND AUC			 		<u> </u>	210.0	0.0		10/	
			TALS			28	257	301	2,242	445	1,275	167	160

SCHE	DUL	E OF Q	UANT	ITIE	:S - S	STRU	JCTU	RES
					*	*	*	*
		PAY ITEM CODE			60201330	60218400	60233500	60500040
	STRI	JCTURE IN	IFO .			PAY	ITEM	
SHEET	STR. NO.	STATION	OFFSET	BASE LINE	CB TY A TY 23 F&G	MH TY A TY 1 F&CL	PRCST "T" MH FOR 60" F&CL	MH REMOVE
22	6152	61+52.00	10.80' L	6		1		
22	6153	61+52.00	20.00'L	6			1	
22	6479	64+79.30	8.20'L	6		1		
22	6486	64+86.00	17.70'L	6			1	
22	6489	64+89.00	4.50'R	6				1
22	6558	65+58.00	4.50'R	6		1		
25	8257	82+57.00	4.00'L	7			1	
25	9147	91+47.00	15.00'R	8	1			
	TC	TALS		7	1	3	3	1

HEUER AND ASSOCIATES

Consulting Engineers

| F.A.U. | SECTION | COUNTY | TOTAL SHEETS | No. | 1004 | 08-00079-02-FP | COOK | 32 | 5 | 2315 Enterprise Drive - Suite 102 Westchester, IL 60154-5811 708-492-1000 FED. ROAD DIST. NO. 1 ILLINOIS FED. AID PROJECT

CONTRACT No. 63149

· ·	SCI	HEDULE OF QUA	ANTITIES - RO	ADWAY REMO	OVAL		
	20100110	40600982	44001900	44004400	44004700	XX005314	
STATION	TREE REMOVAL (6 TO 15 UNITS DIAMETER)	HOT-MIX ASPHALT SURFACE REMOVAL - BUTT JOINT	COMBINATION CURB AND GUTTER REMOVAL (SPECIAL)	PAVEMENT REMOVAL (SPECIAL)	SIDEWALK REMOVAL (SPECIAL)	BITUMINOUS DRIVEWAY REMOVAL	
	UNIT	SQ YD	FOOT	SQ YD	SQ FT	SQ YD	
61+40.00 TO 66+00	0	205	335	601	0	15	
71+00 TO 76+50	0	0	0	0	0	0	
76+50 TO 82+50	0	0	0	0	0	0	
82+50 TO 93+00	14	144	250	222	921	0	
TOTAL	14	349	585	823	921	15	

	SCHE	DULE OF QUAN	NTITIES - BITU	IMINOUS PAVE	MENT		
	21001000	31101000	40600100	40600300	40701921	XX000405	
GEOTECHNIC FABRIC FO STATION GROUND STABILIZATI		SUB-BASE BITUMINOUS MATERIALS (PRIIMATERIAL, TYPE B COAT)		AGGREGATE (PRIME COAT)	HOT-MIX ASPHALT PAVEMENT (FULL DEPTH), 12"	BUTT JOINTS, SPECIAL	
	SQ YD	TON	GALLON	TON	SQ YD	SQ YD	
61+40.00 TO 66+00	644	168	252	1	560	205	
71+00 TO 76+50	0	0	0	0	0	00	
76+50 TO 82+50	0	0	0	0	0	0	
82+50 TO 93+00	161	42	63	0	140	144	
TOTAL	805	210	315	1	700	349	

SCHE	DULE OF QUAN	NTITIES - SIDE	WALKS AND	CURBS
	42400200	60603800	60604400	XX007729
STATION	PORTLAND CEMENT CONCRETE SIDEWALK 5 INCH	COMBINATION CONCRETE CURB AND GUTTER, TYPE B-6.12	COMBINATION CONCRETE CURB AND GUTTER, TYPE B-6.18	DETECTABLE WARNING, SPECIAL
	SQ FT	FOOT	FOOT	SQ FT
61+40.00 TO 66+00	0	325	0	0
71+00 TO 76+50	0	0	0	0
76+50 TO 82+50	0	0	0	0
82+50 TO 93+00	893	35	195	16
TOTAL	893	360	195	16

ALLEYS AND DRIVEWAYS							
the state of the s	XX007357	X4420132					
STATION	CLASS C PATCHES, SPECIAL	CLASS D PATCHES SPECIAL					
	SQ YD	SQ YD					
61+40.00 TO 66+00	0	15					
71+00 TO 76+50	0	0					
76+50 TO 82+50	0	0					
82+50 TO 93+00	85	0					
TOTAL	85	15					


ATF	ILLINOIS DEPARTMENT OF TRANSPORTATION
· · · · · ·	BLUFF AVENUE IMPROVEMENTS
	STAGE 2

SCHEDULE OF QUANTITIES

SCALE: * = DENOTES SPECIALTY ITEM

DATE 02/27/2009

DRAWN BY H&A

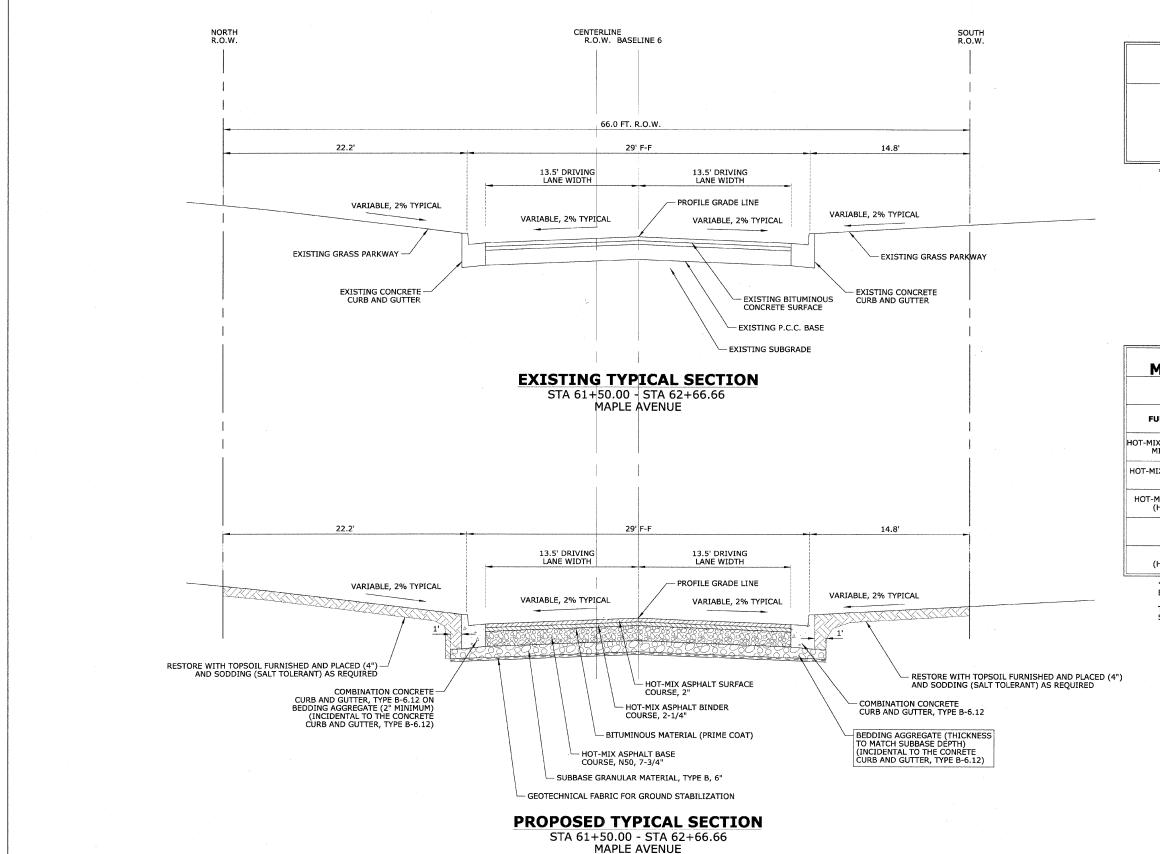

HEUER AND ASSOCIATES

2315 Enterprise Drive - Suite 102 Westchester, IL 60154-5811 708-492-1000

CONTRACT No. 63149

PAVEMENT DESIGN DATA*

CLASSIFICATION OF ROADWAY: CLASS II ROADWAY
DESIGN PERIOD: 20 YEARS
PROJECTED AVERAGE DAILY TRAFFIC: 4157
% OF PASSENGER VEHICLES (PV): 99%
% OF SINGLE UNIT TRUCKS (SU): 0.5%
% OF MULTI UNIT TRUCKS (MU): 0.5%
SUBGRADE SUPPORT RATING (SSR): FAIR


* UTILIZED ADJOINING ROADWAY FOR DESIGN CHARACTERISTICS

HOT-MIX ASPHALT MIXTURE REQUIREMENTS					
MIXTURE TYPE	AC TYPE	AIR VOIDS			
FULL DEPTH PAVEMENT;					
HOT-MIX ASPHALT SURFACE COURSE, MIX "C", N50 (IL 9.5mm)	PG 64-22	4% @ 50 GYR			
HOT-MIX ASPHALT BINDER COURSE, IL-9.0, N50	PG 64-22 *	4% @ 50 GYR			
HOT-MIX ASPHALT BASE COURSE, (HMA BINDER IL-19mm)	PG 64-22 *	4% @ 50 GYR			
PATCHING					
CLASS D PATCHES (HMA BINDER IL-19mm)	PG 64-22 *	4% @ 70 GYR			

* WHEN RAP EXCEEDS 20%, THE NEW ASPHALT BINDER IN THE MIX SHALL BE PG 58-22

THE UNIT WEIGHT USED TO CALCULATE ALL HMA SURFACE MIXTURE QUANTITIES IS 112 LBS/SQ YD/IN

REVISIONS		ILLINOIS DEDAS	THENT OF TRANSPORTATION
NAME	DATE		TMENT OF TRANSPORTATION
			NUE IMPROVEMENTS STAGE 2
		TYP	ICAL SECTIONS
		SCALE: NTS DATE 02/27/2009	DRAWN BY H&A CHECKED BY PEH

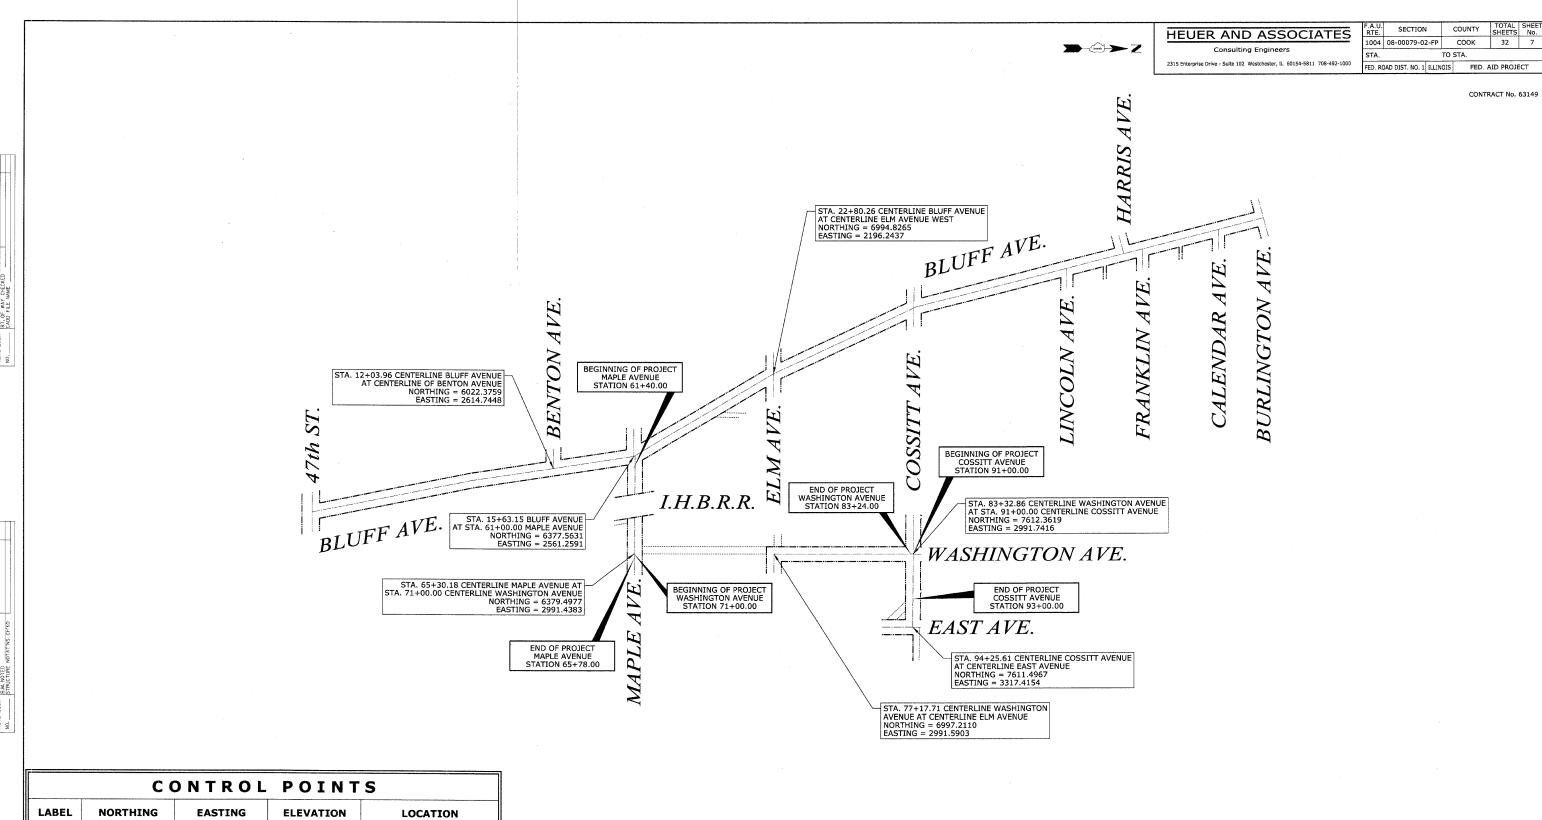


CONTROL POINTS							
LABEL	NORTHING	EASTING	ELEVATION	LOCATION			
7	6,353.7710	2,510.2540	632.46	SW "x" Maple and Bluff			
8	6,399.7290	2,493.5990	631.92	NW "x" Maple and Bluff			
9	6,973.3850	2,163.4410	632.60	SW "x" Elm and Bluff			
10	7,020.3450	2,145.5900	633.09	NW "x" Elm and Bluff			
11	7,595.3440	1,873.8940	632.23	SW "x" Cossitt and Bluff			
12	7,634.9600	1,932.4050	629.62	NE "x" Cossitt and Bluff			
21	6,361.5880	3,030.8250	628.24	SE "x" Maple cul-de-sac			
22	6,409.0340	3,032.2320	627.70	NE "x" Maple cul-de-sac			
23	6,964.0000	2,972.4010	628.01	SW "x" Elm and Washington			
24	6,969.1030	3,013.8260	626.91	SE "x" Elm and Washington			
25	7,631.9550	2,953.6290	625.58	NW "x" Cossitt and Washington			
26	7,634.7650	3,034.7800	625.56	NE "x" Cossitt and Washington			


ILLINOIS DEPARTMENT OF TRANSPORTATION **BLUFF AVENUE IMPROVEMENTS** STAGE 2

ALIGNMENT, TIES AND ELEVATION CONTROL

SCALE: NTS

DRAWN BY H&A DATE 02/27/2009 CHECKED BY PFH

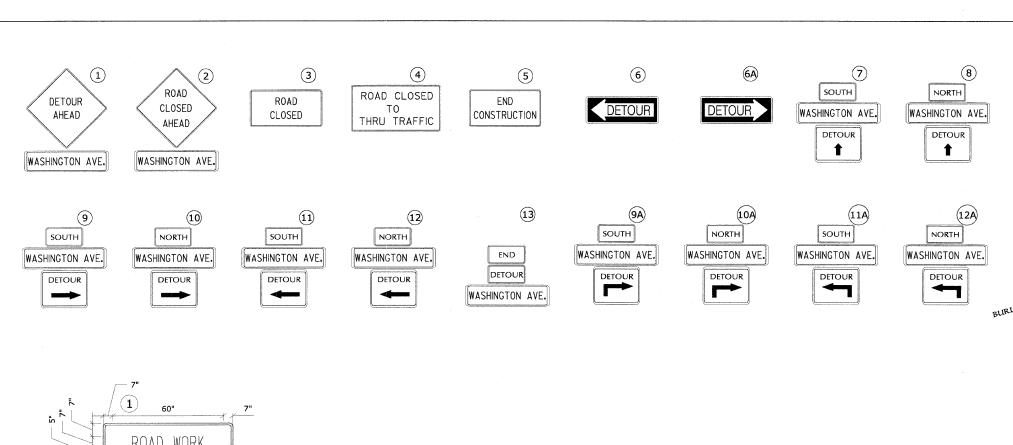

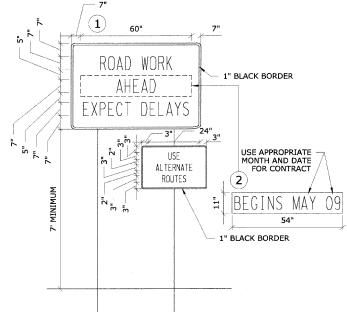

TEMPORARY INFORMATIONAL SIGNAGE NOTES:

- 1. USE BLACK LETTERING ON ORANGE BACKGROUND.
- 2. ERECT SIGNS IN ADVANCE OF THE LOCATION FOR THE "ROAD CONSTRUCTION AHEAD" SIGN AT LOCATIONS AS DIRECTED BY THE

ERECT SIGN 1 WITH INSTALLED PANEL 2 ONE WEEK PRIOR TO THE START OF CONSTRUCTION.

- 4. REMOVE PANEL 2 SOON AFTER THE START OF CONSTRUCTION.
- 5. ITEMS ON THIS PAGE SHALL BE PAID FOR UNDER ITEM 70101900 ENTITLED "TRAFFIC CONTROL AND PROTECTION DETOUR 1".

GENERAL NOTES FOR TRAFFIC CONTROL

ALL THE TRAFFIC CONTROL DEVICES SHALL CONFORM TO THE TRAFFIC CONTROL PLANS OR THE LATEST EDITION OF THE STATE OF ILLINOIS "MANUAL OF UNIFORM TRAFFIC CONTROL DEVICES FOR STREETS AND HIGHWAYS," AND SHALL BE IN PLACE BEFORE CONSTRUCTION IS STARTED. STOP SIGNS SHALL BE PLACED TO CONTROL SIDE STREET

THE TRAFFIC CONTROL PLANS SHALL SERVE AS A GUIDE FOR SAFE DIVERSION OF TRAFFIC DURING EXECUTION OF THIS CONTRACT. HOWEVER, THE CONTRACTOR MAY IMPROVE OR MODIFY THE TRAFFIC CONTROL PLANS FOR HIS CONSTRUCTION NEEDS BUT NOT AT THE EXPENSE OF PUBLIC SAFETY OR CONVENIENCE. ANY CONTRACTOR-PROPOSED TRAFFIC CONTROL PLANS SHALL BE SUBMITTED FOR THE WRITTEN APPROVAL OF THE ENGINEER.


THE EXACT NUMBER, LOCATION AND SPACING OF ALL SIGNS AND TRAFFIC CONTROL DEVICES MAY BE ADJUSTED TO FIT FIELD CONDITIONS AS DIRECTED BY THE ENGINEER.

REMOVE EXISTING PAVEMENT MARKING IF IN CONFLICT WITH THE TEMPORARY PAVEMENT MARKINGS FOR TRAFFIC CONTROL AND PROTECTION PLANS.

ALL TYPE III BARRICADES SHALL BE REFLECTORIZED ON BOTH SIDES AND SHALL BE EQUIPPED WITH TWO (2) HIGH INTENSITY FLASHING LIGHTS.

THE CONTRACTOR SHALL MAINTAIN EMERGENCY VEHICULAR ACCESS DURING ALL CONSTRUCTION ACTIVITIES.

THE MAINTENANCE OF TRAFFIC REQUIREMENTS CALLED FOR ON THIS PAGE SHALL BE PAID FOR UNDER LINE ITEM 70101900 ENTITLED TRAFFIC CONTROL AND PROTECTION DETOUR 1.

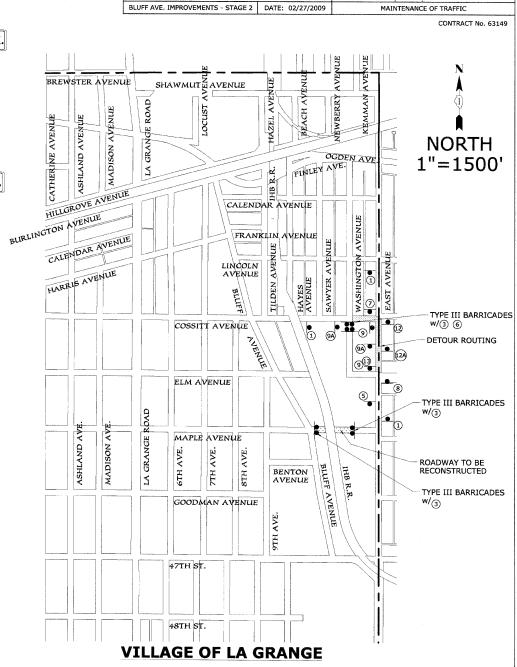

HEUER AND ASSOCIATES

2315 Enterprise Drive - Suite 102 Westchester, IL 60154-5811 708-492-1000

Consulting Engineers

SECTION

1004 08-00079-02-FP

FED. ROAD DIST. NO. 1 ILLINOIS

STA.

COUNTY


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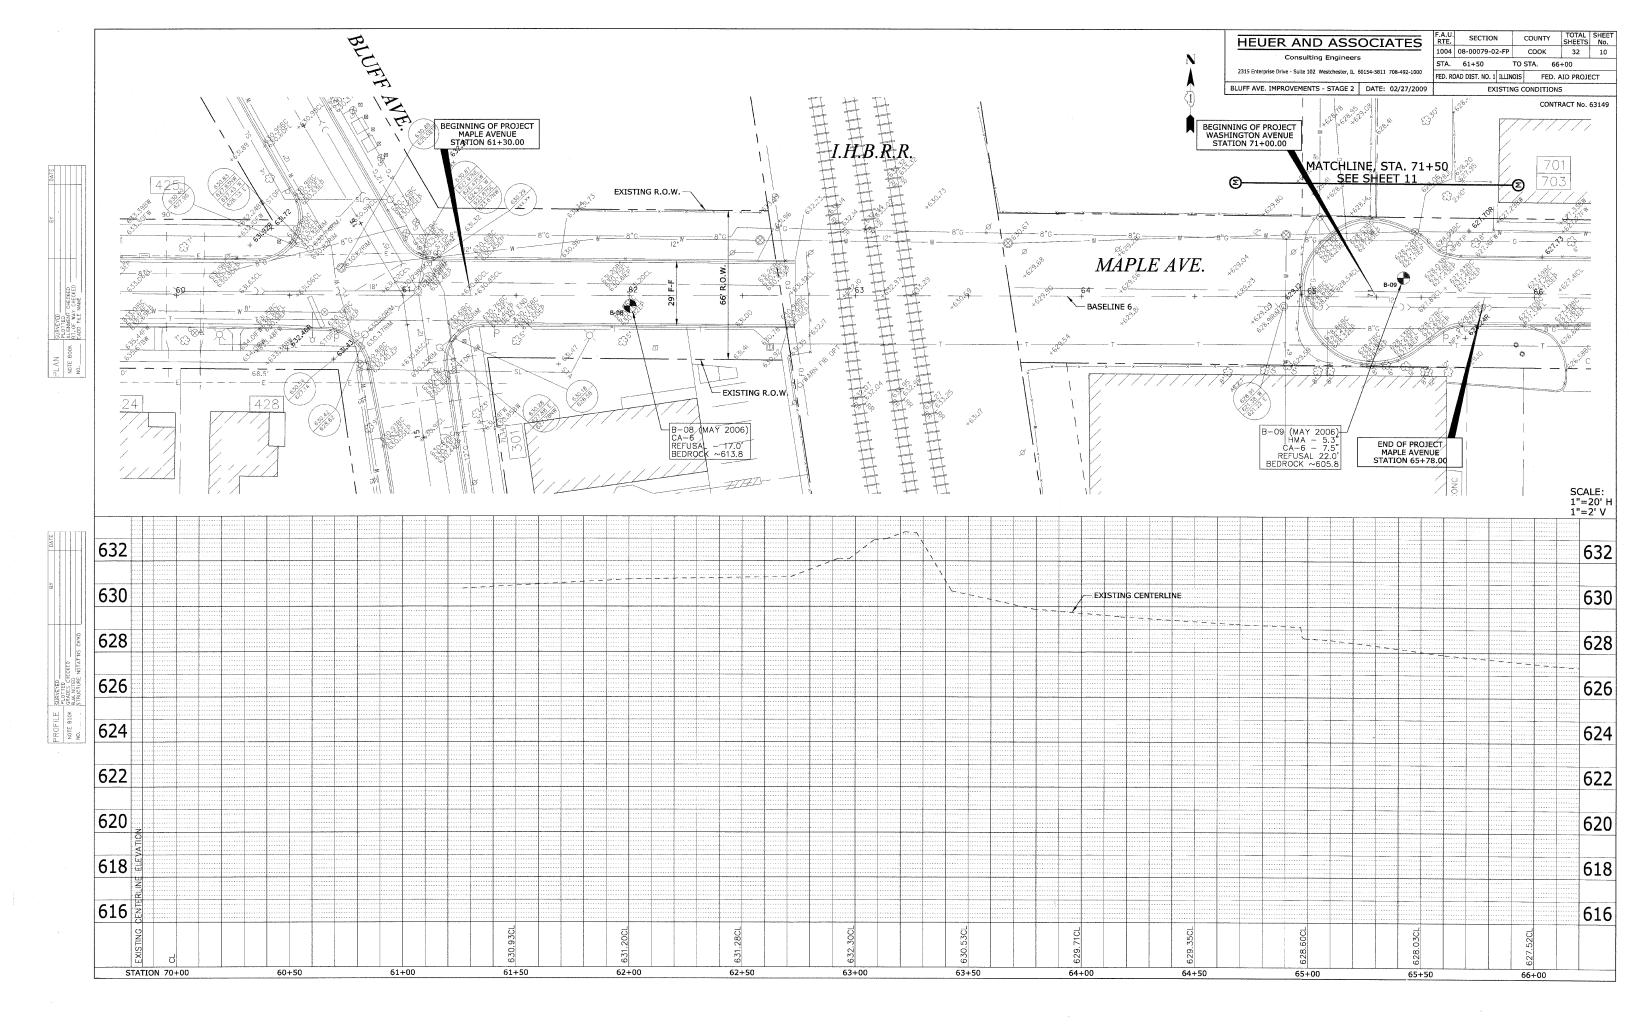
TO STA.


MAINTENANCE OF TRAFFIC


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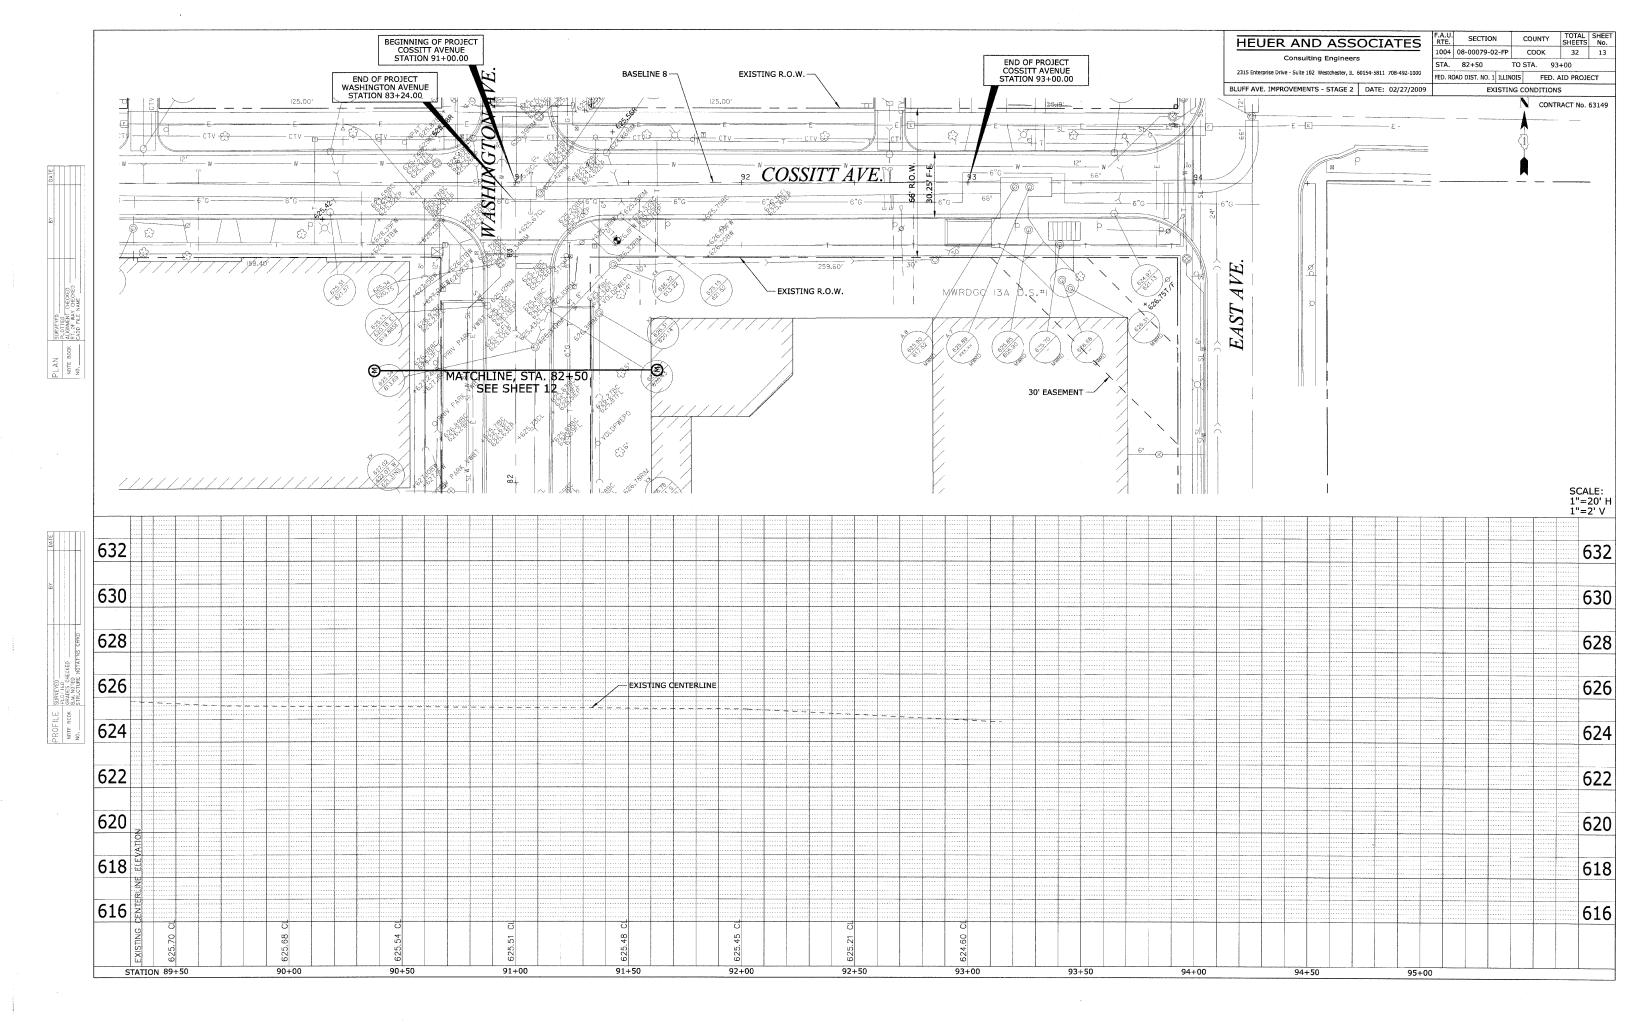
FED. AID PROJECT







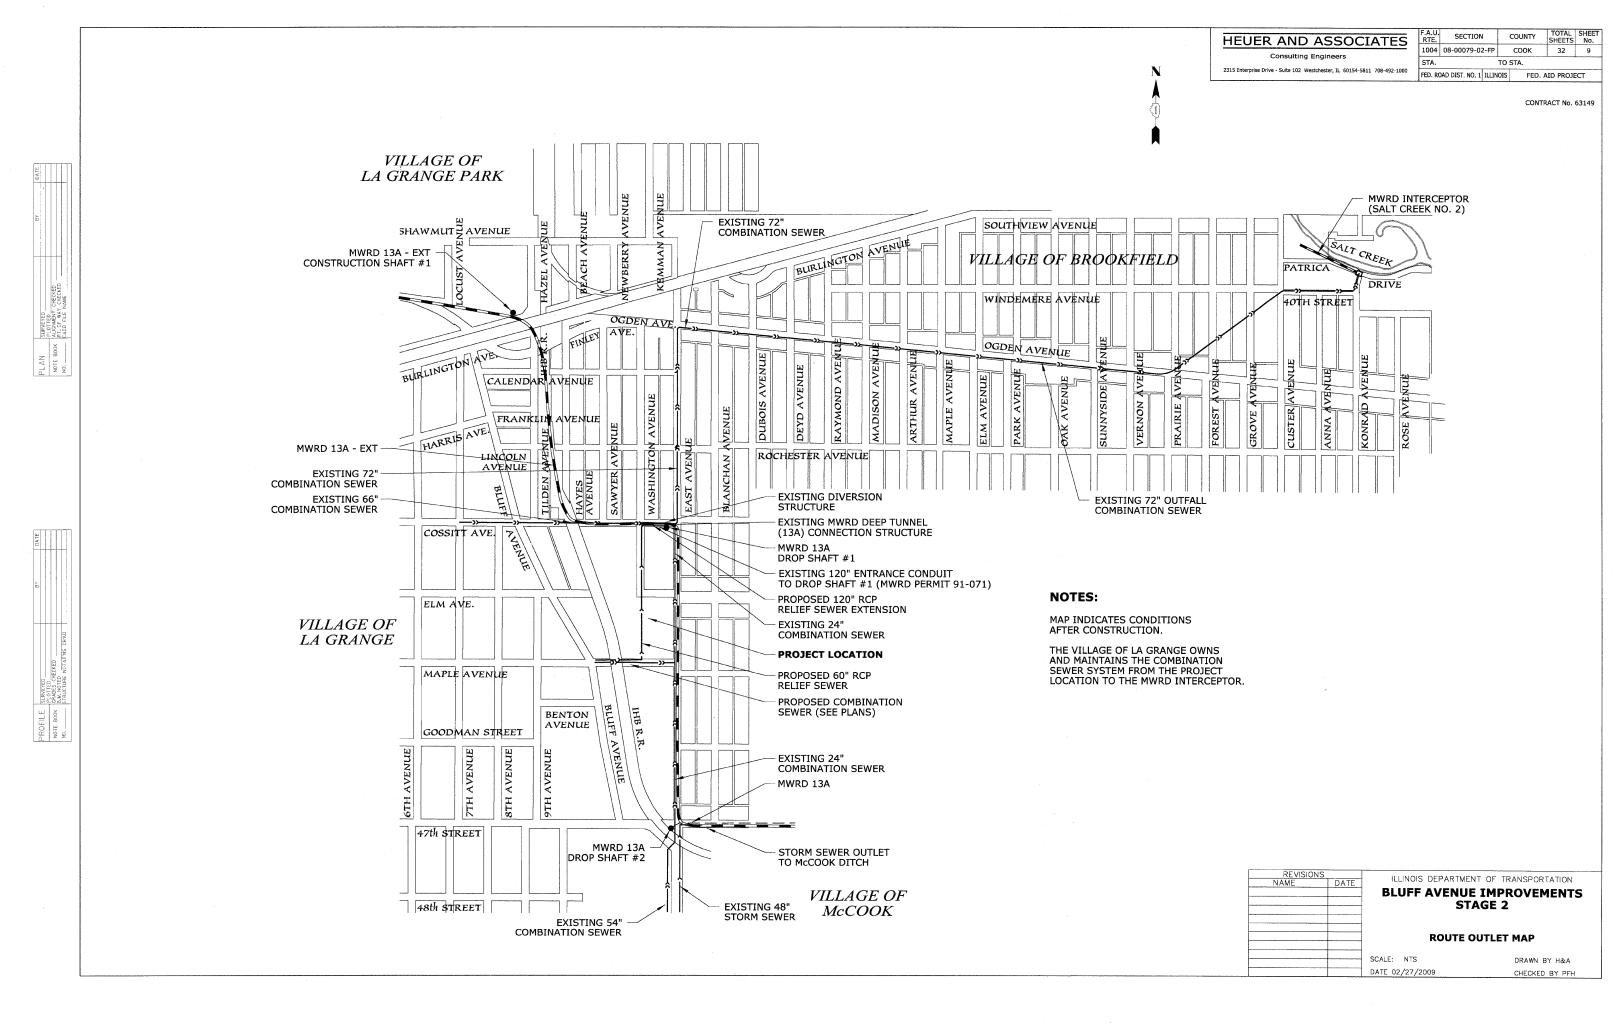


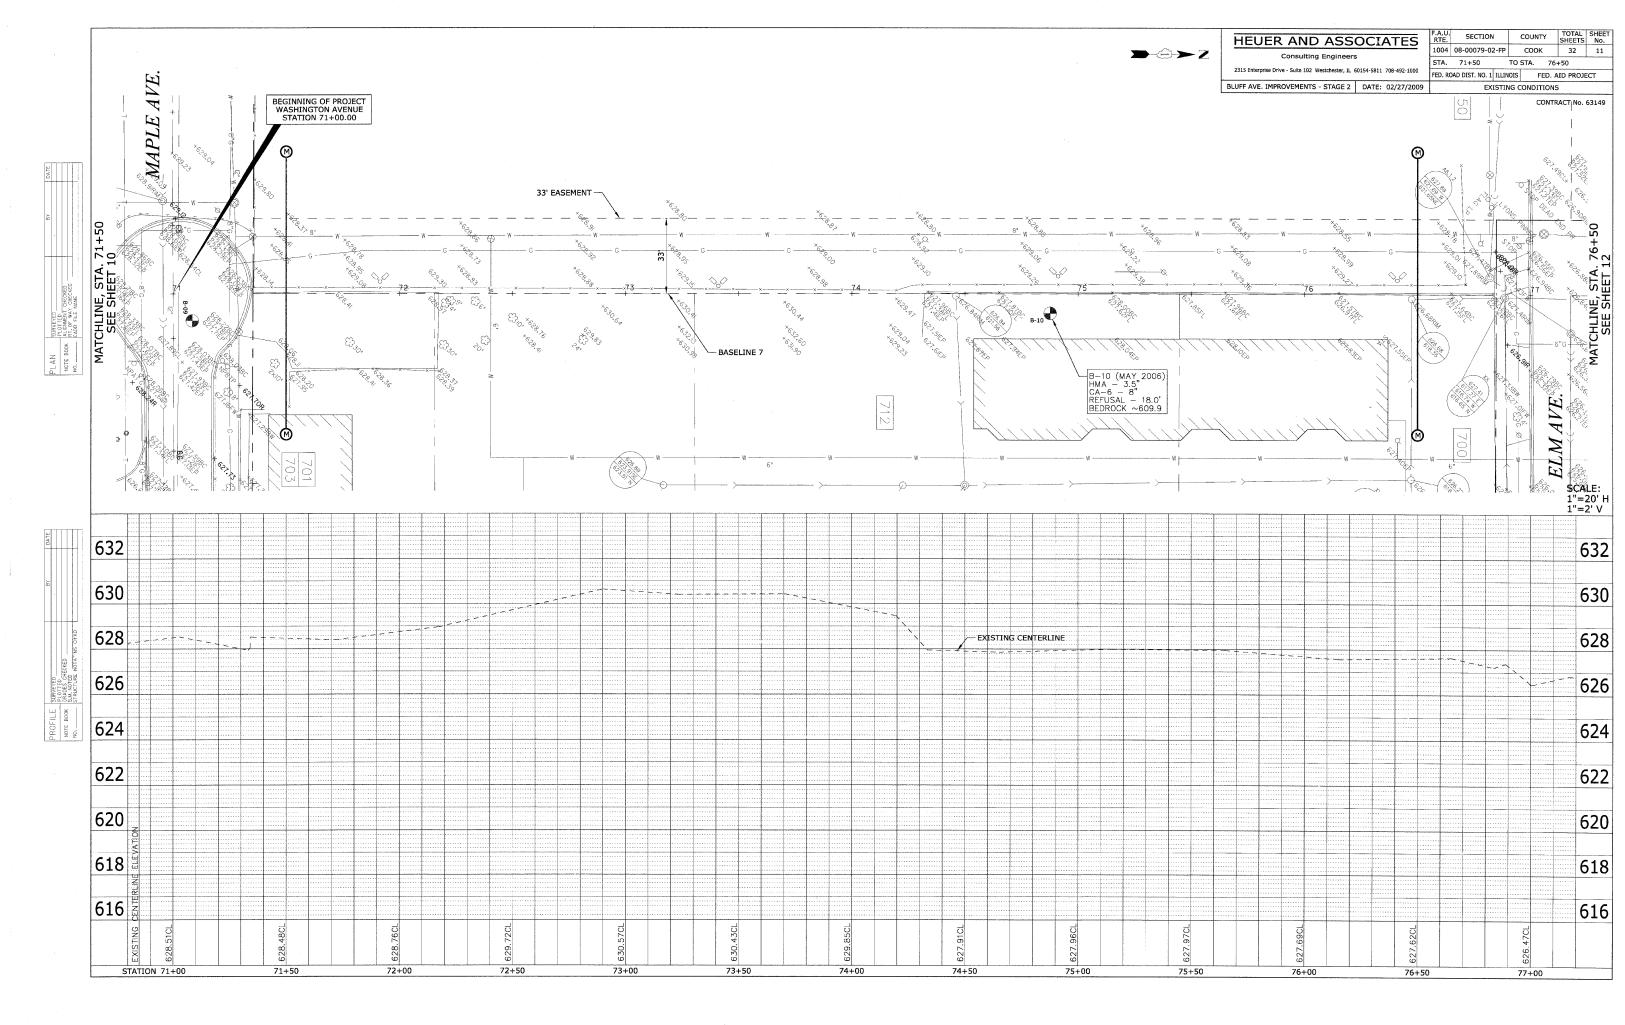


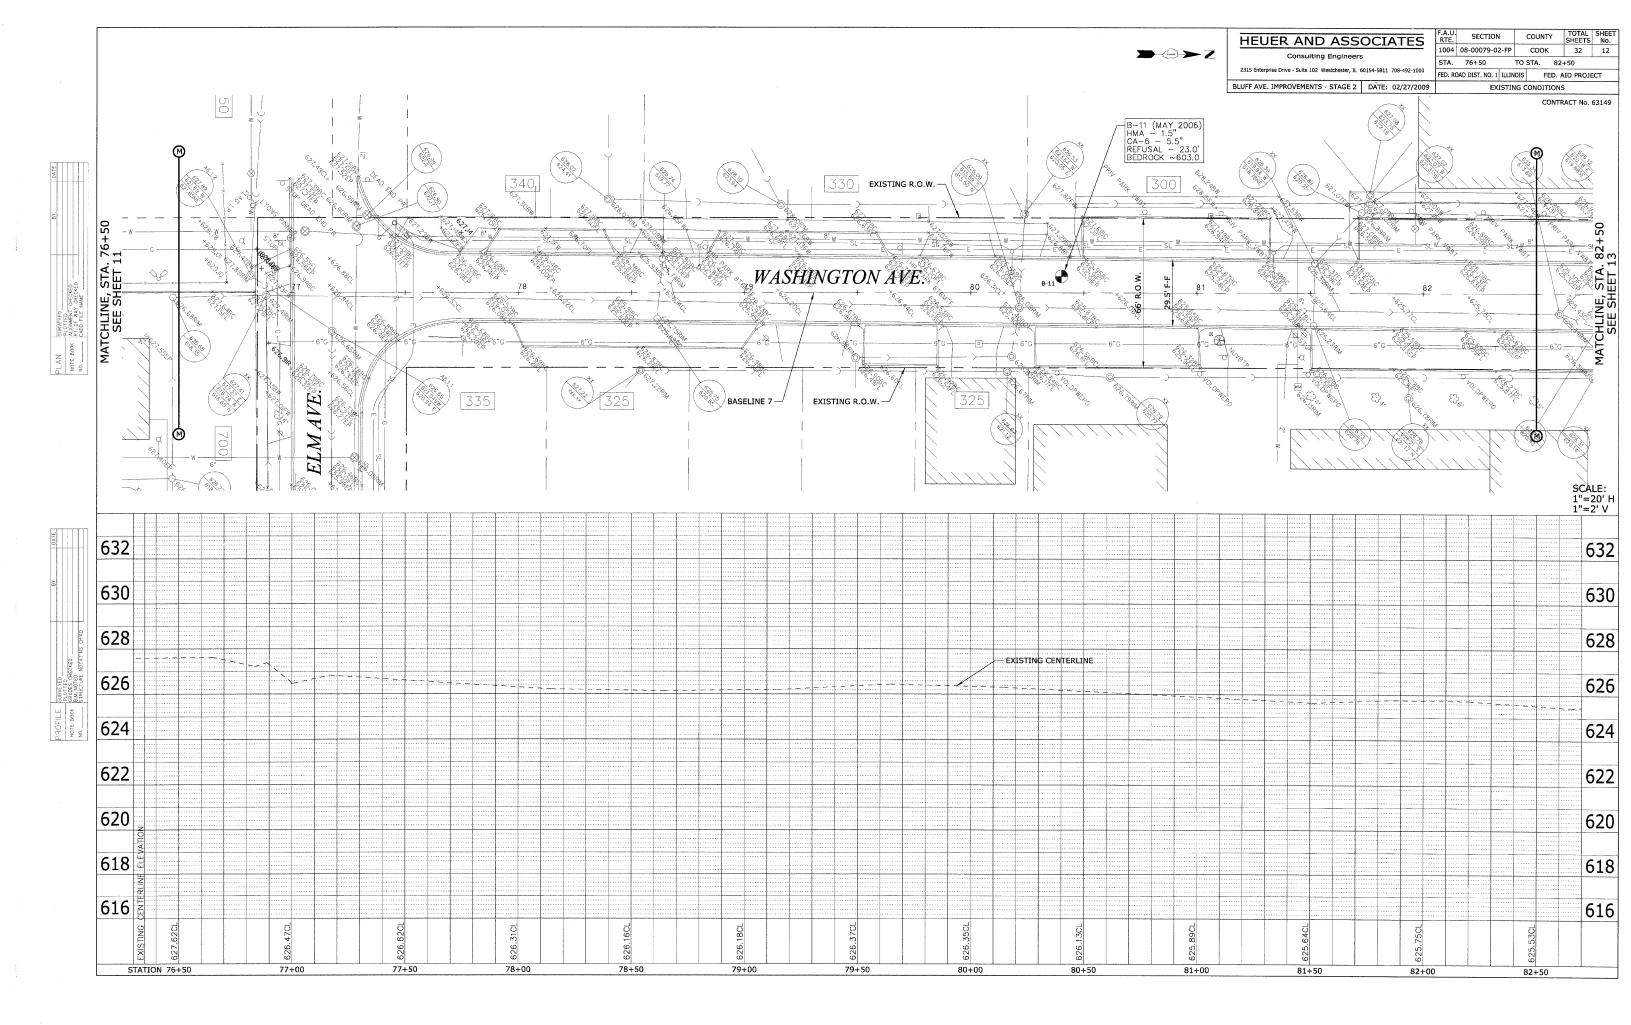


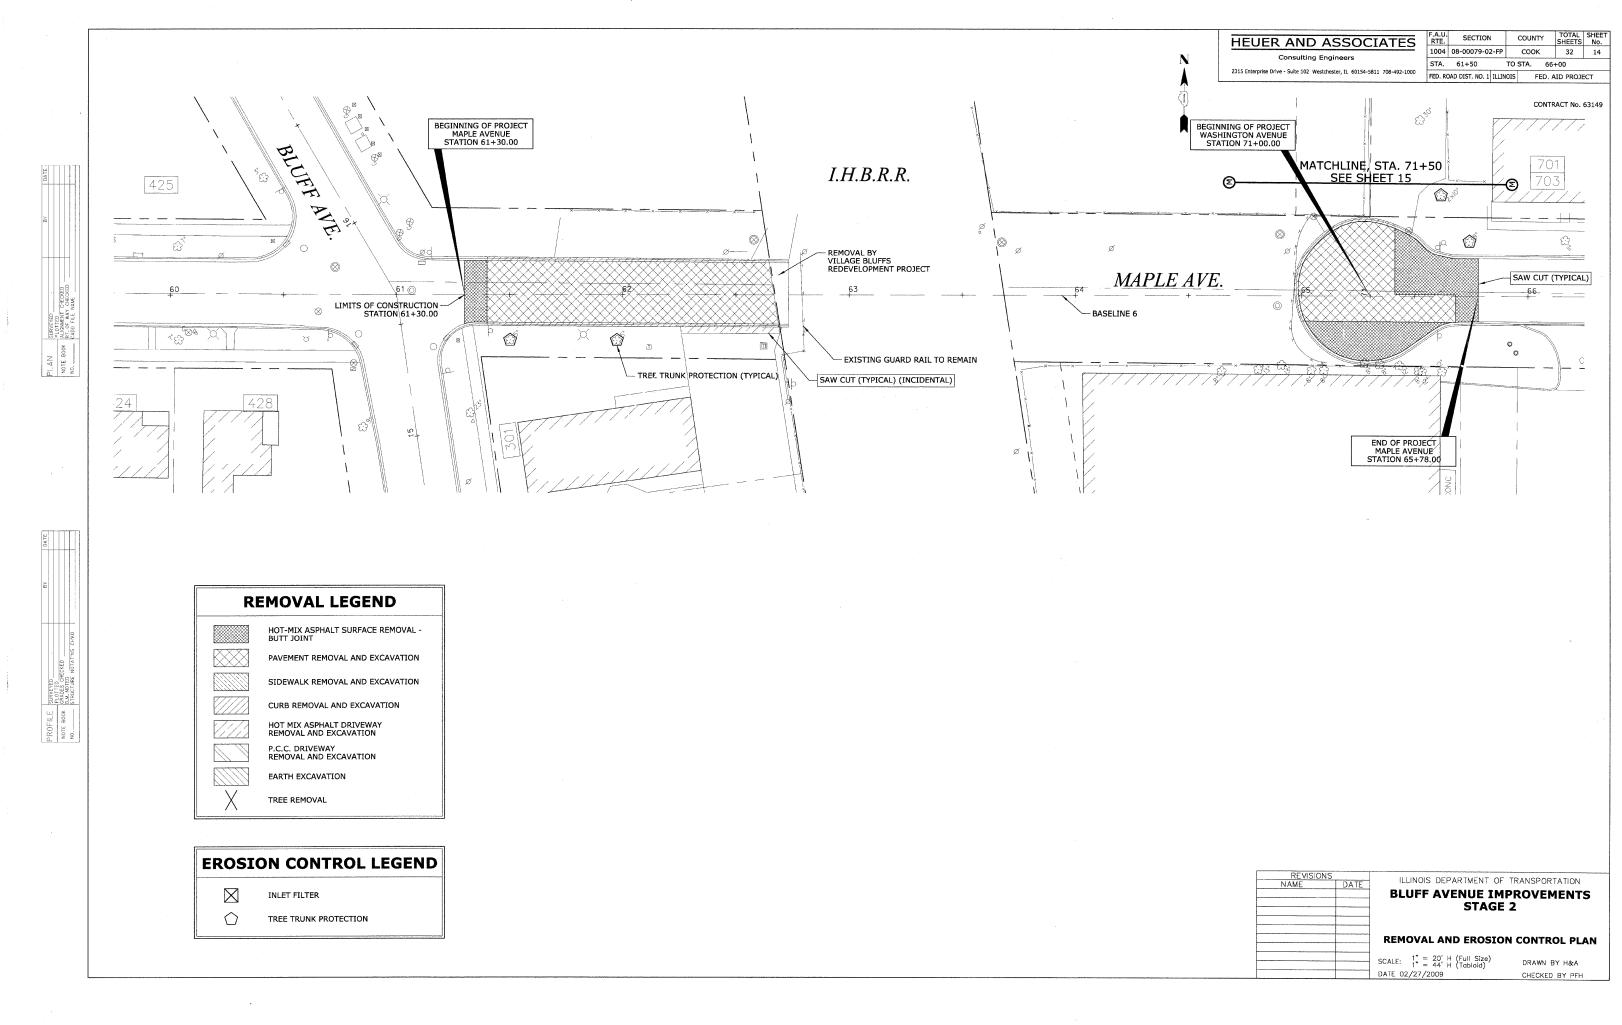


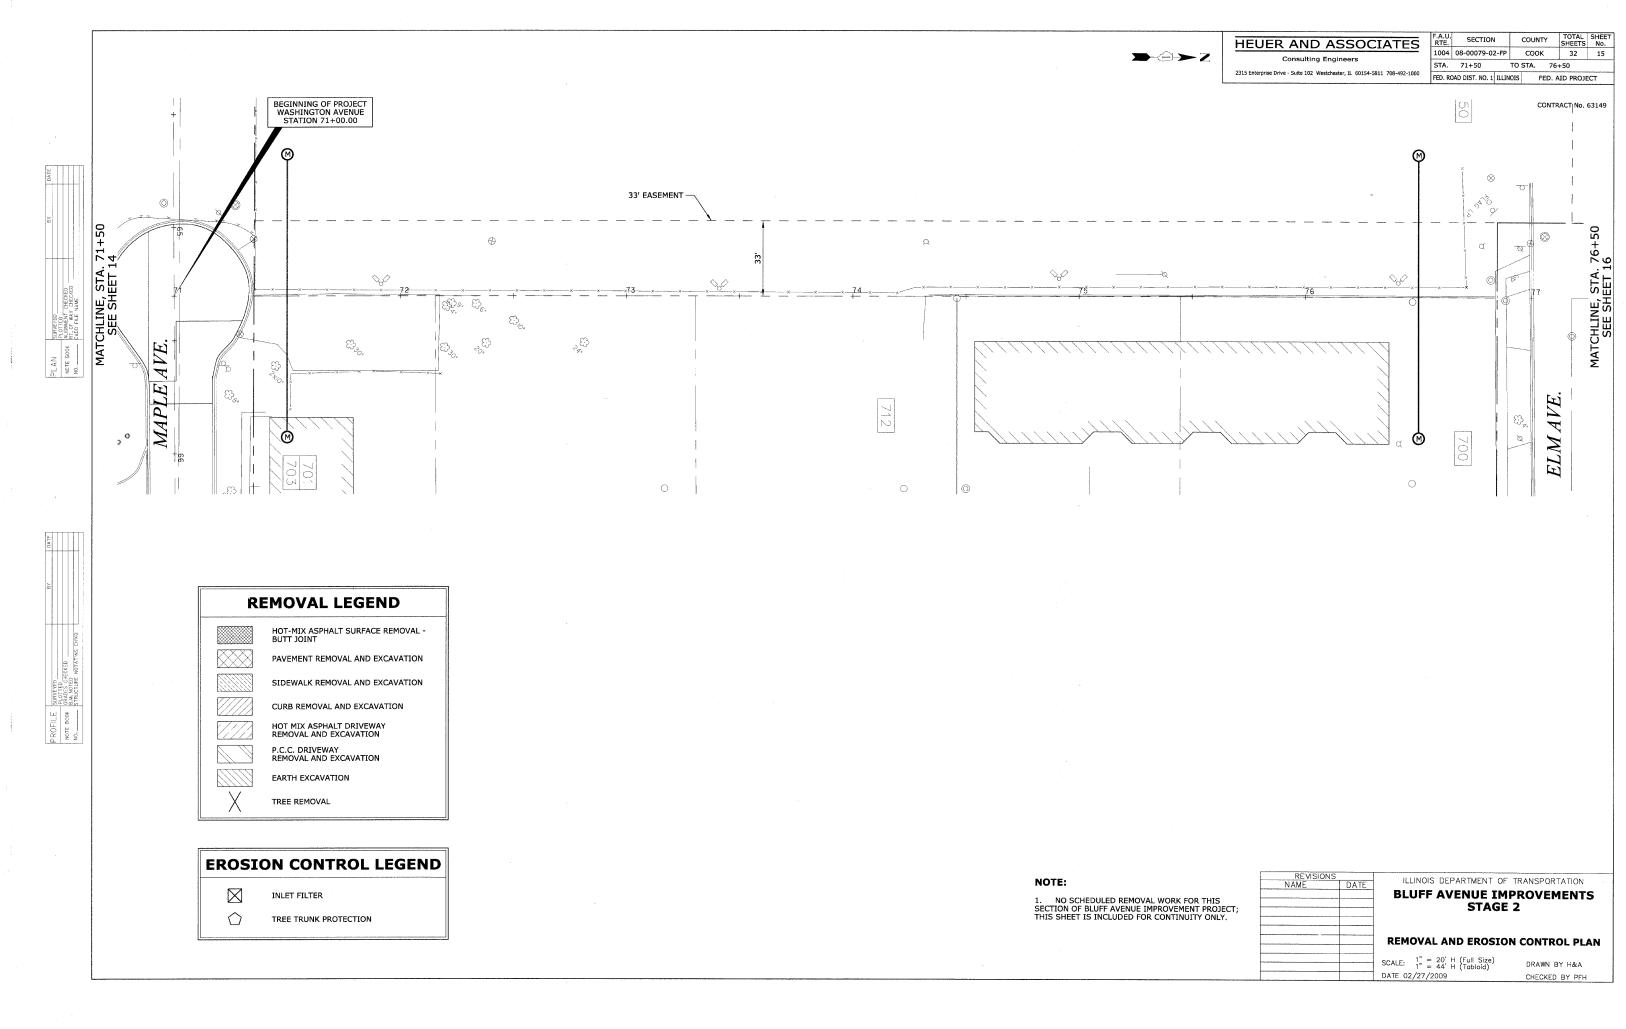


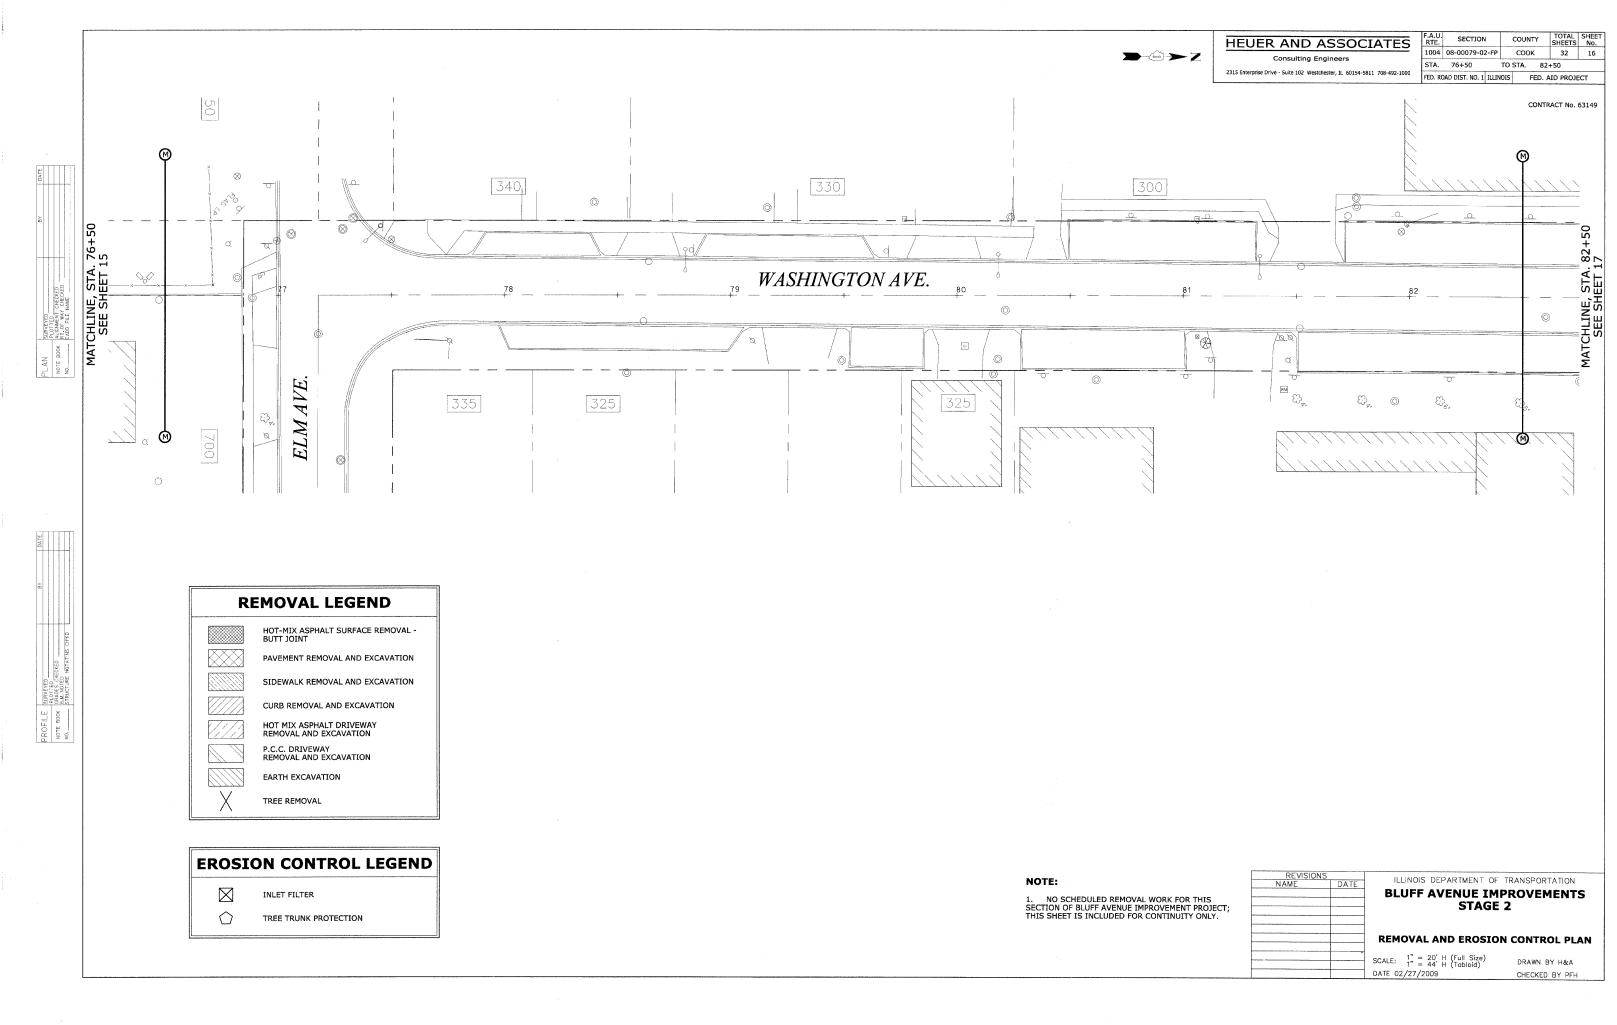


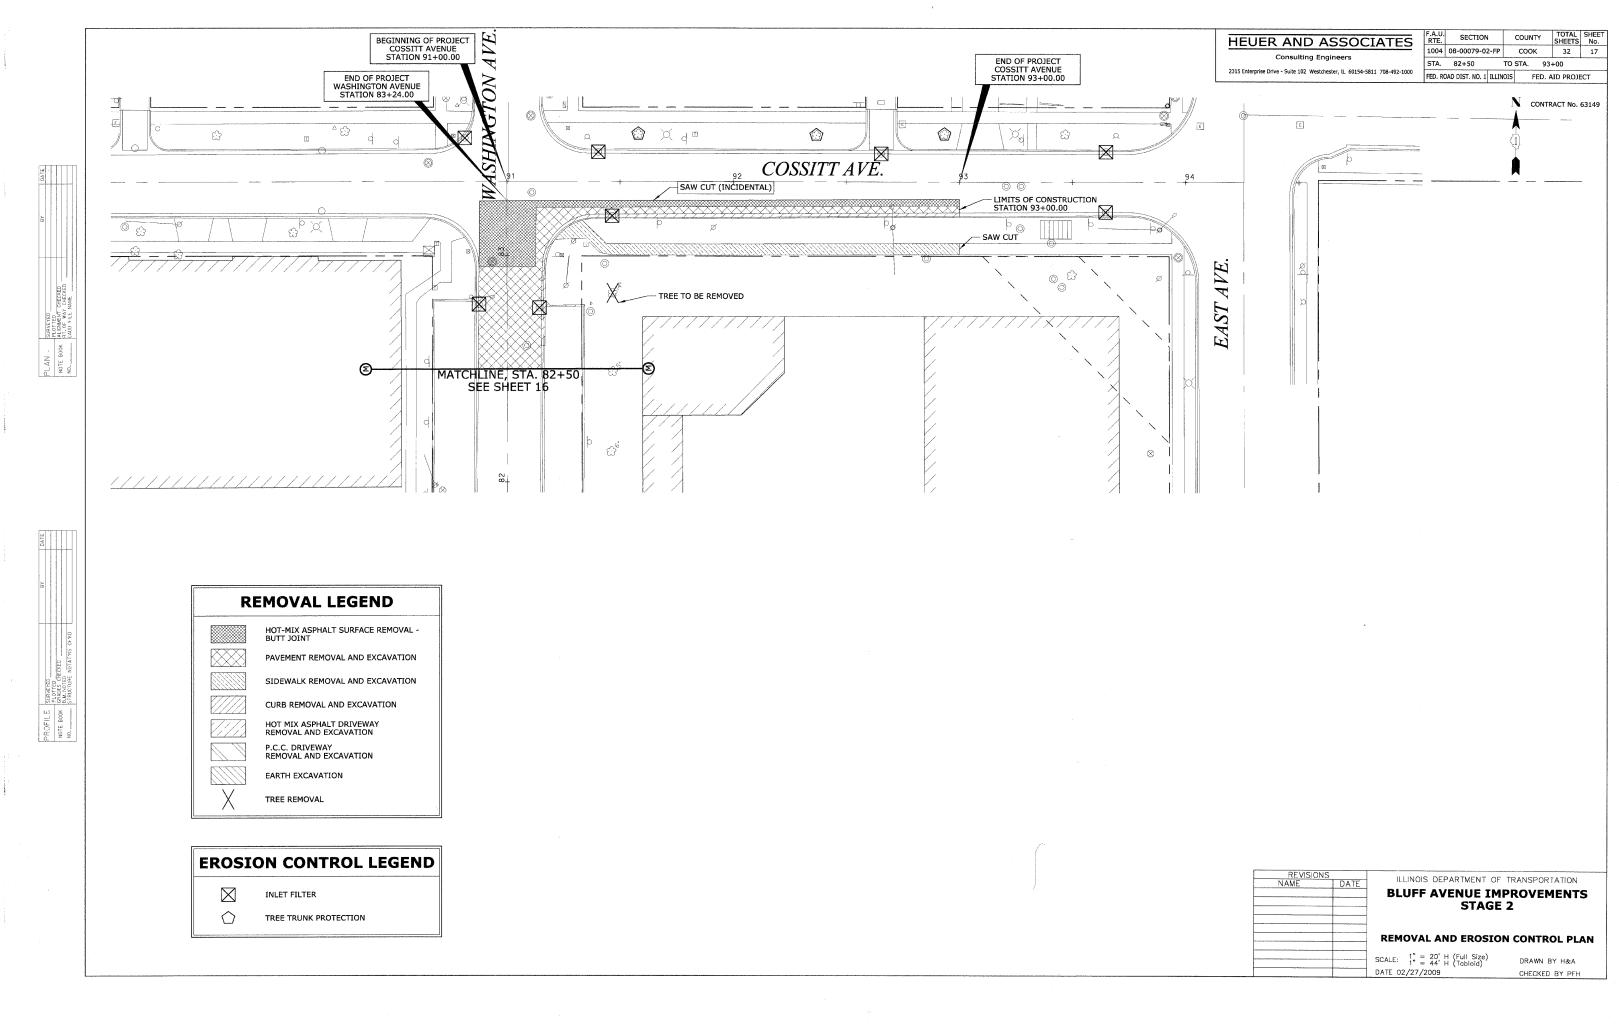


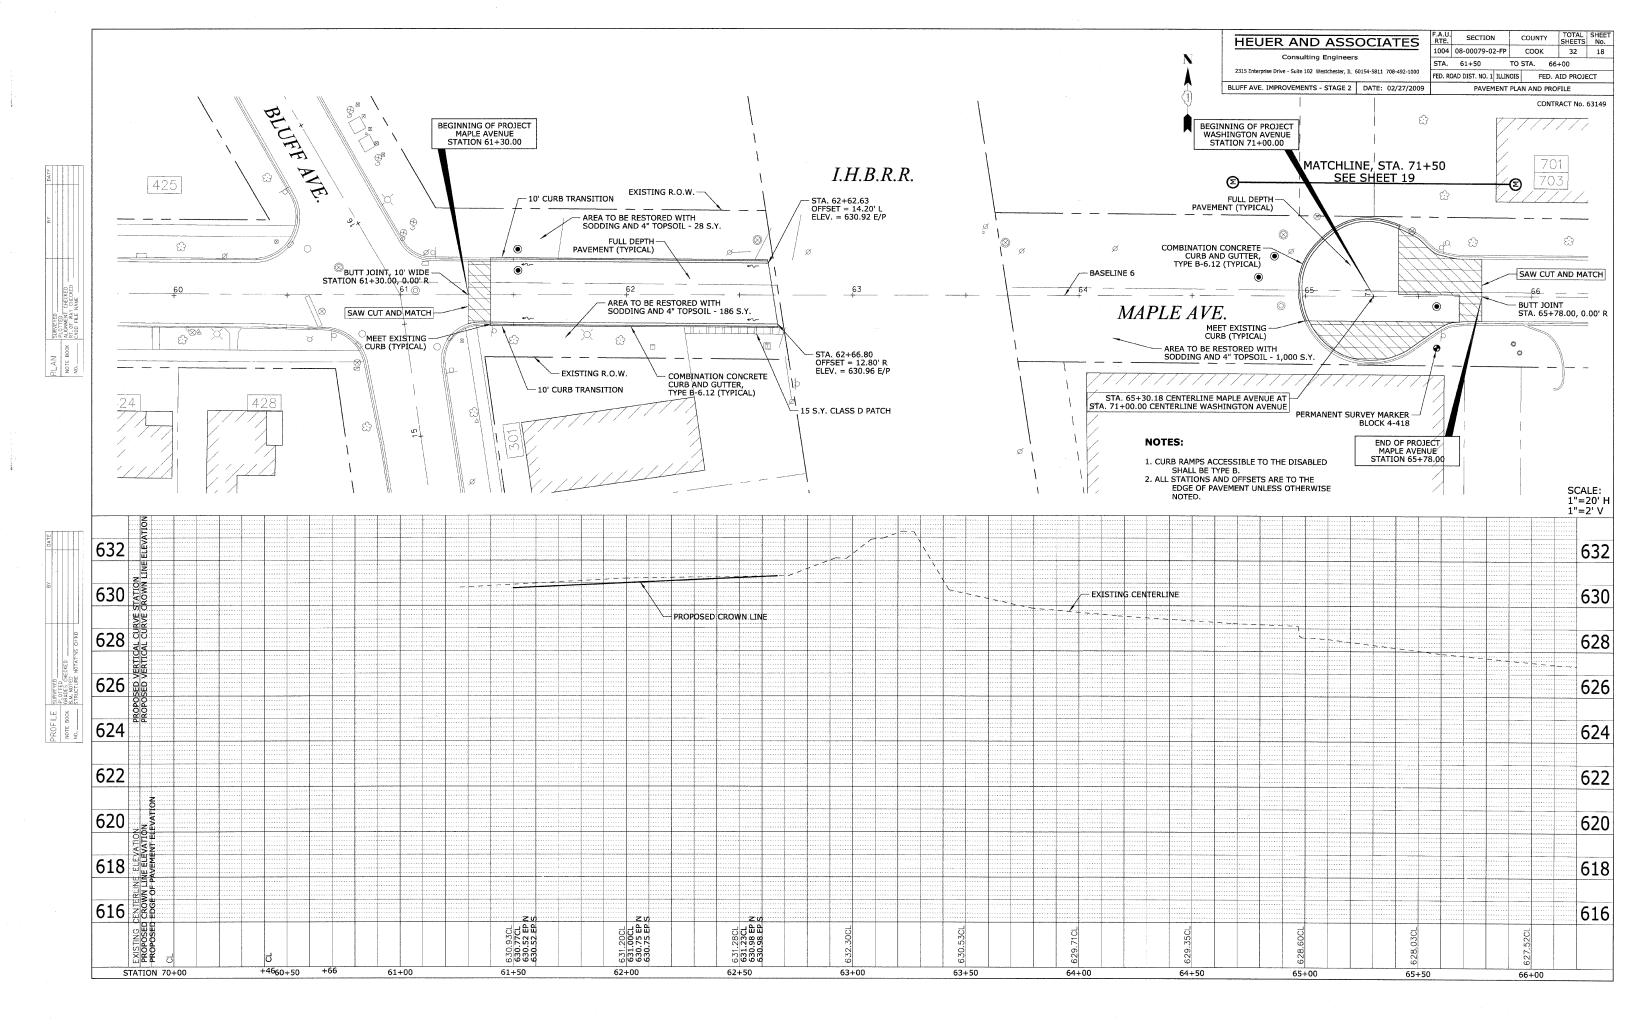


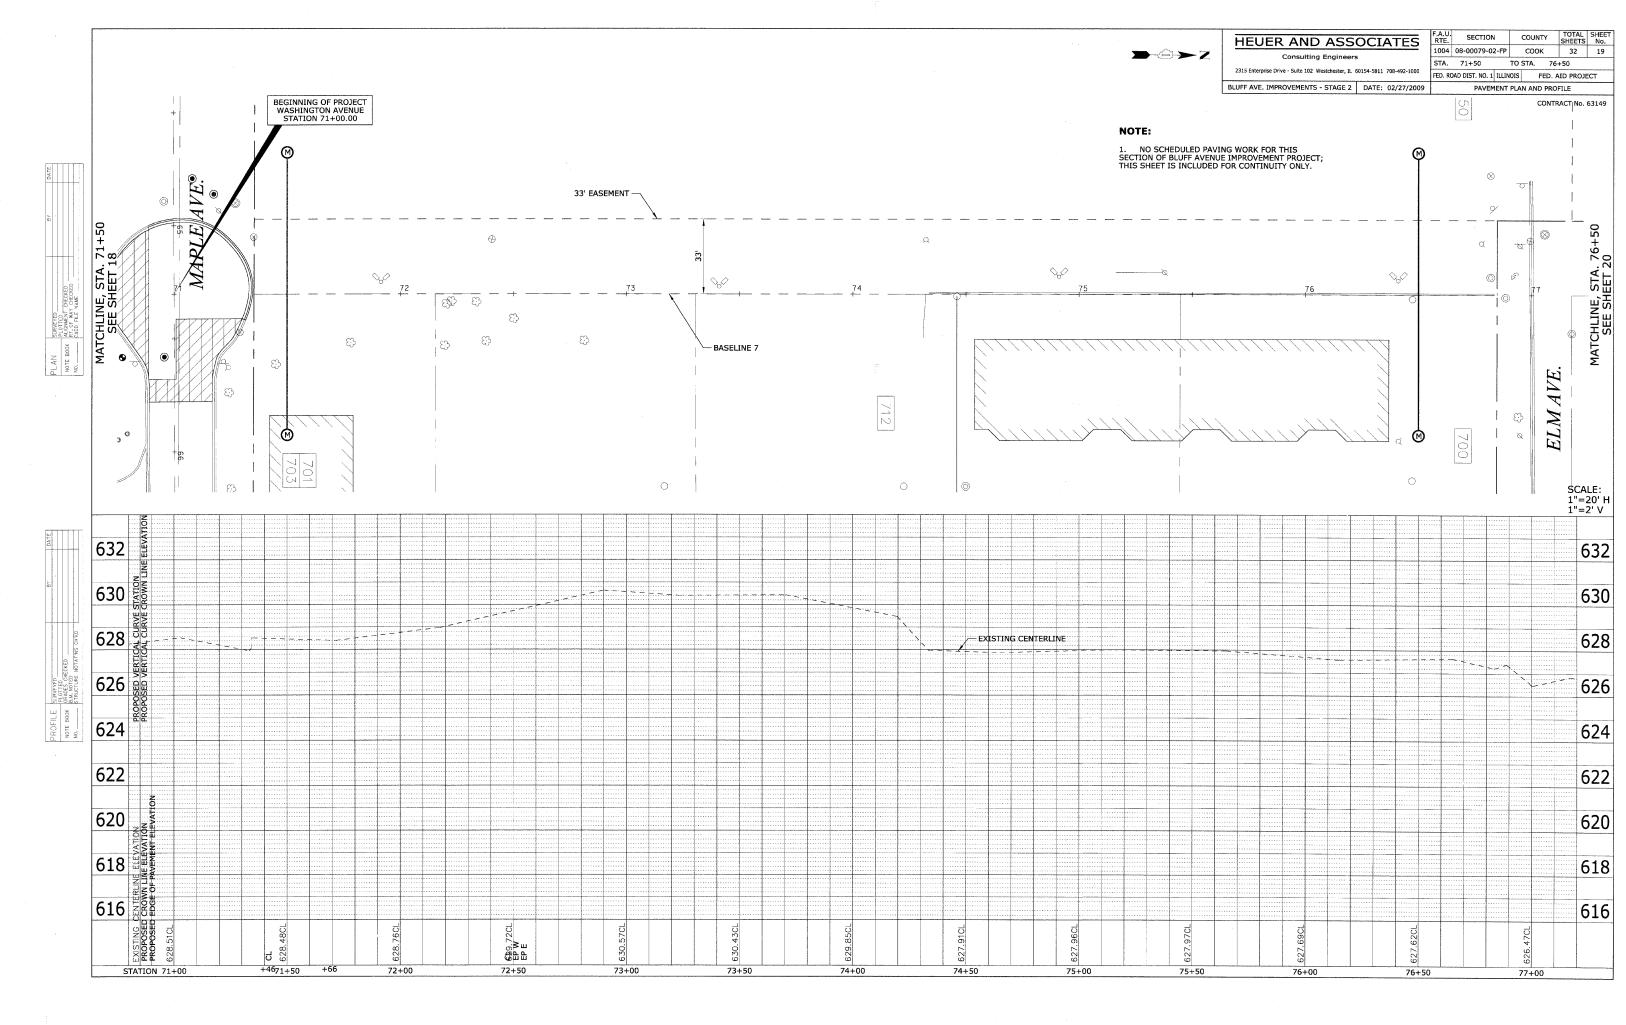


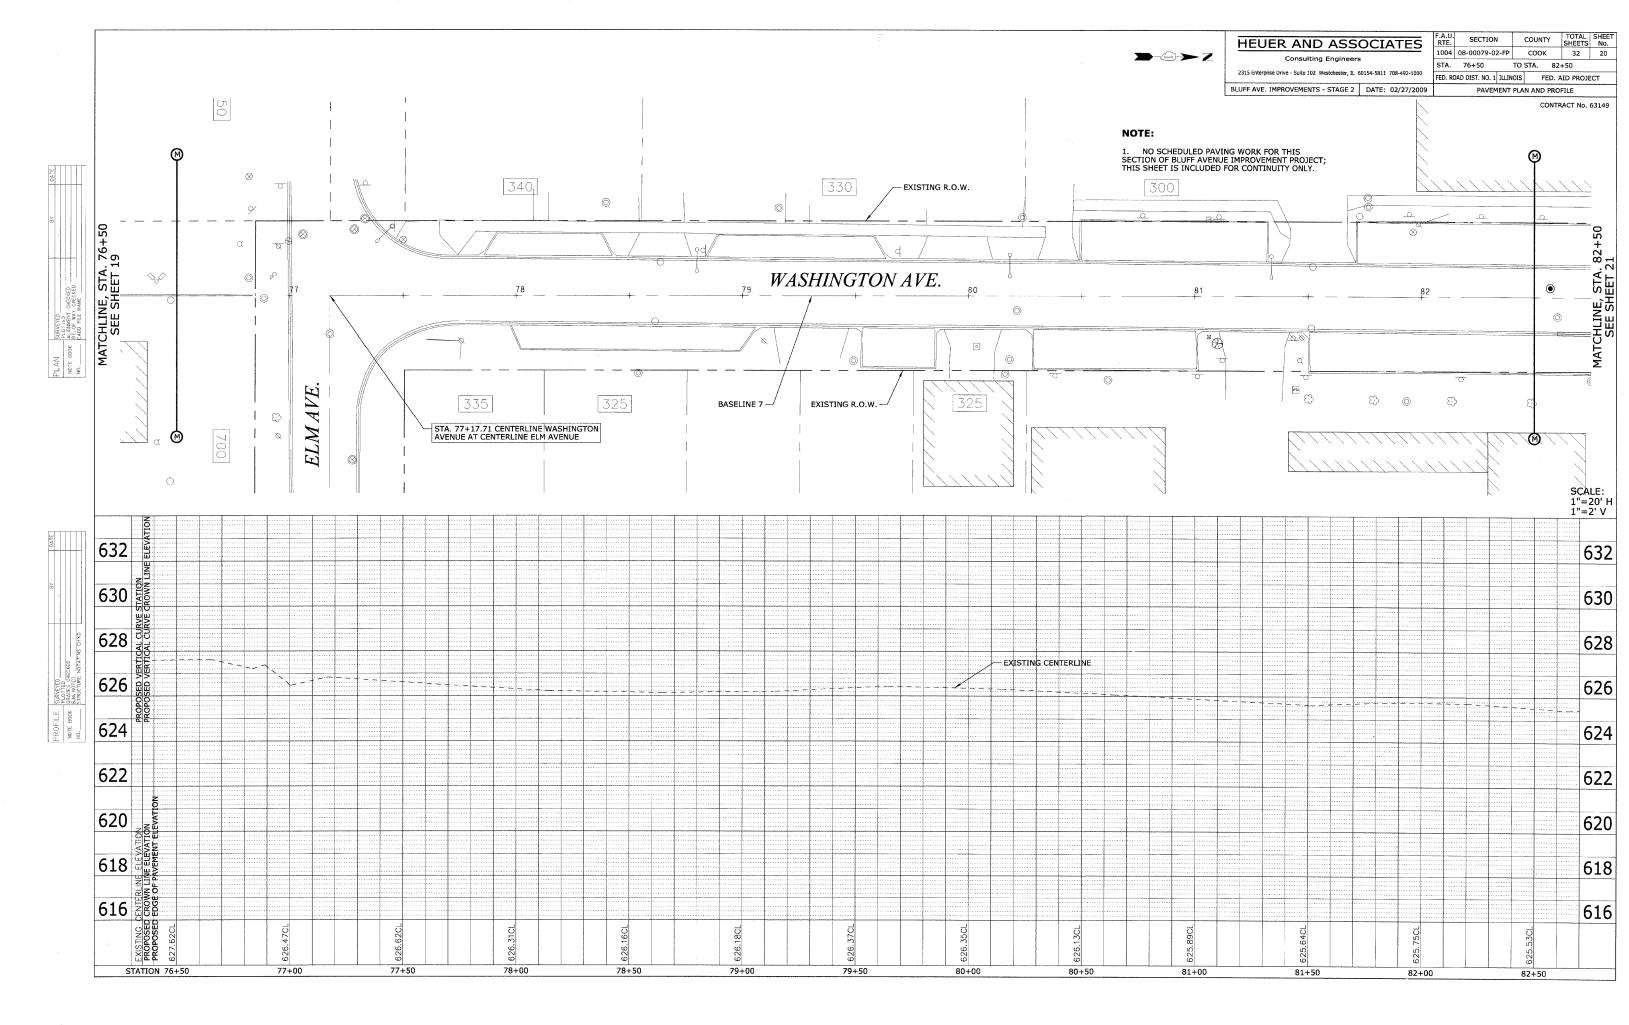


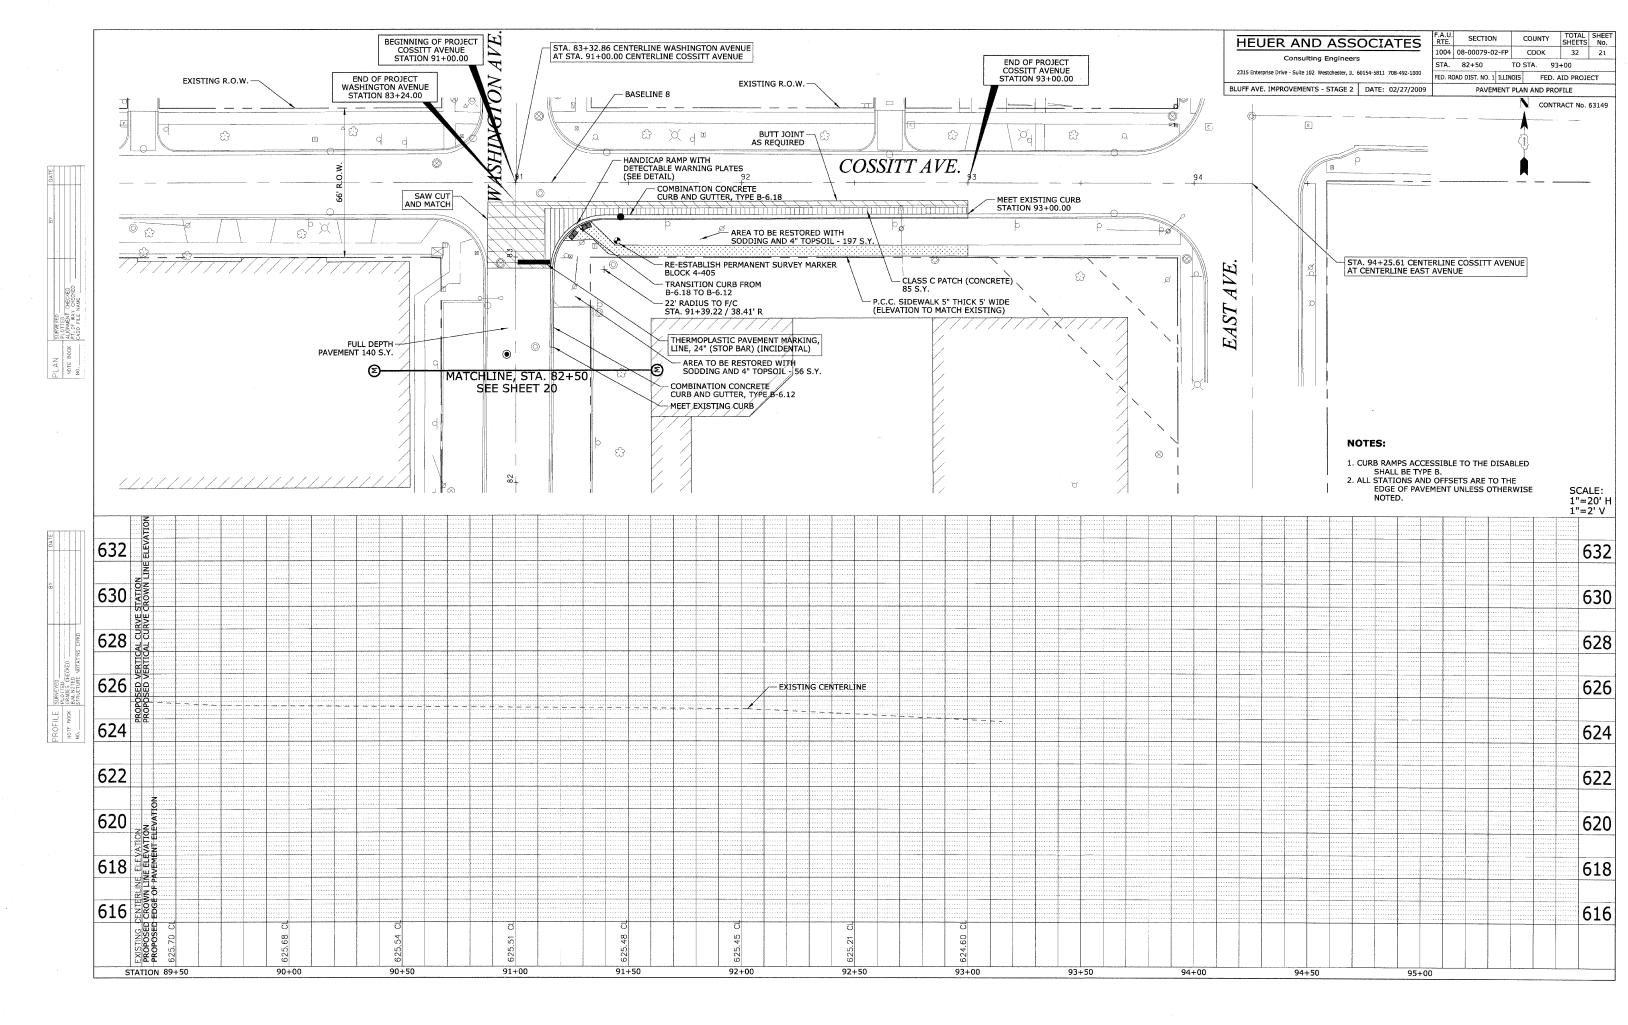

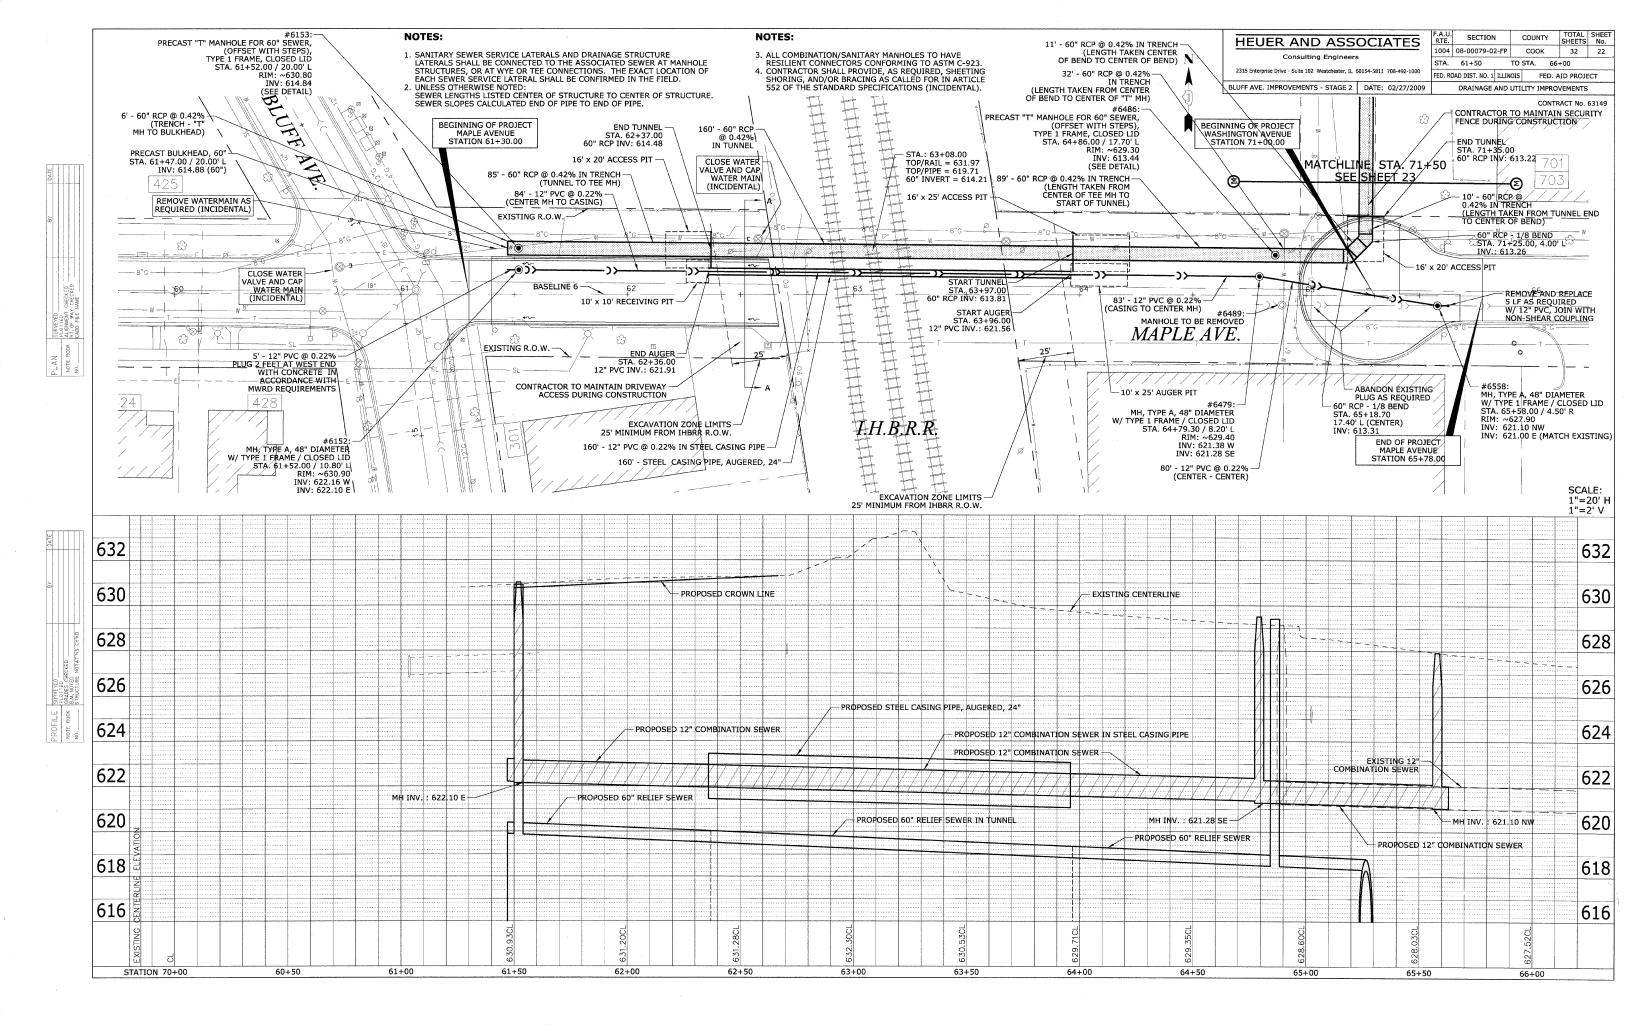


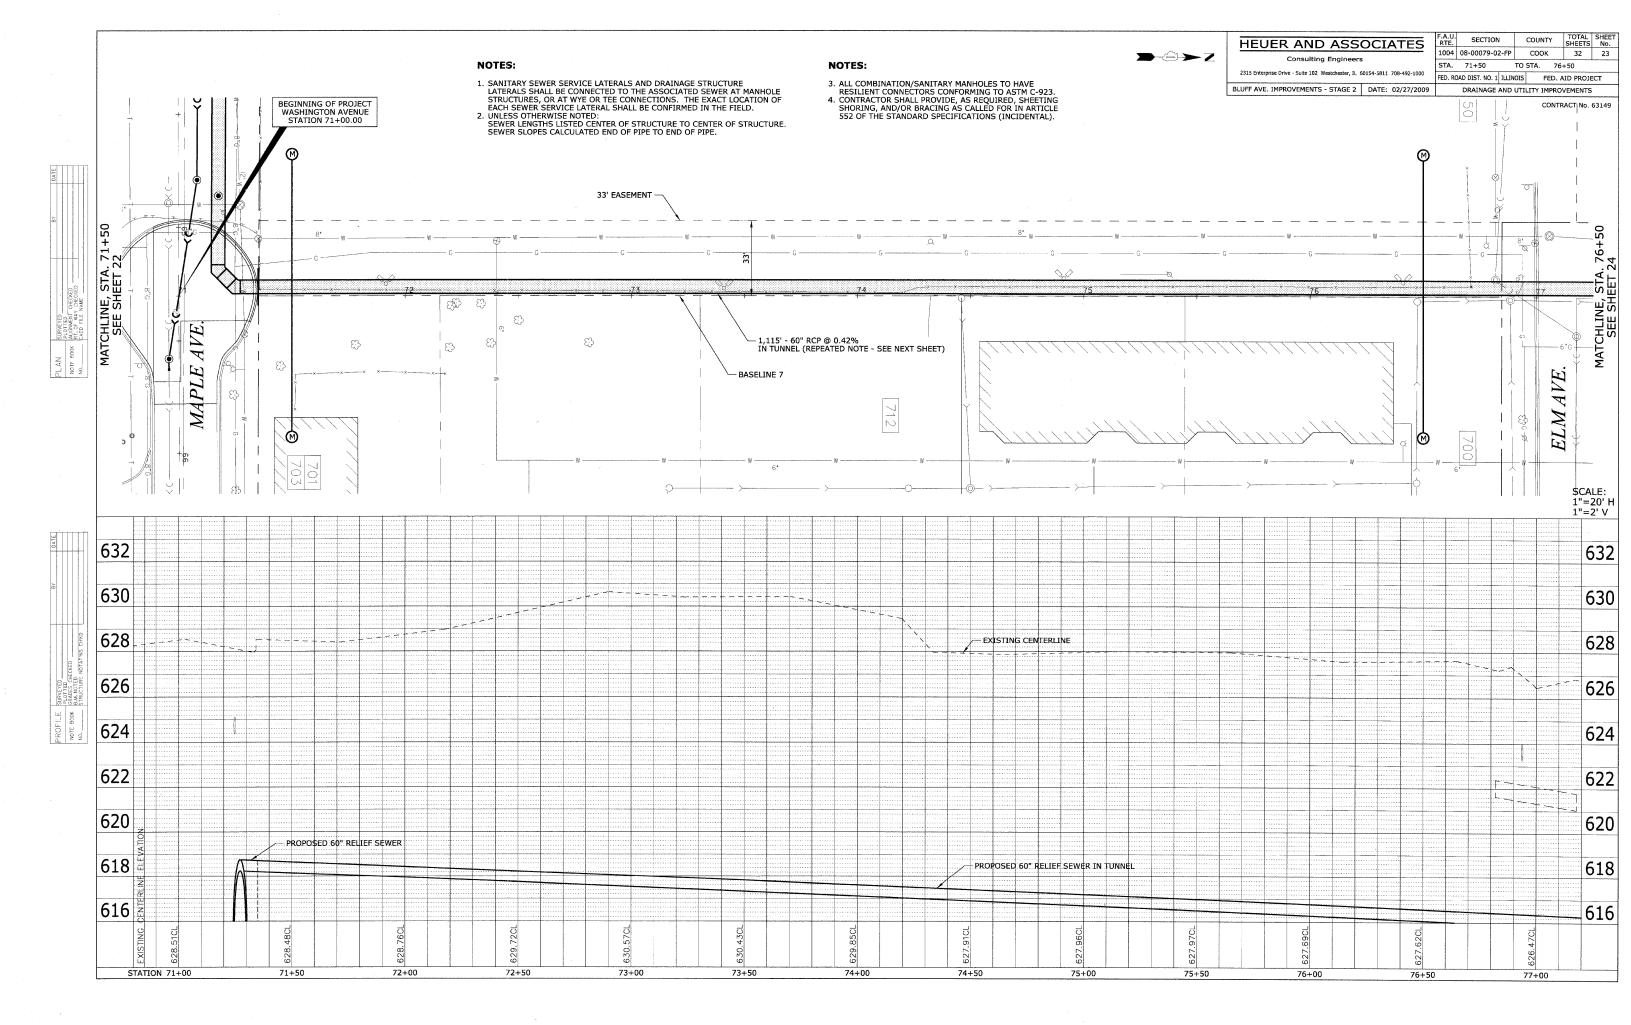

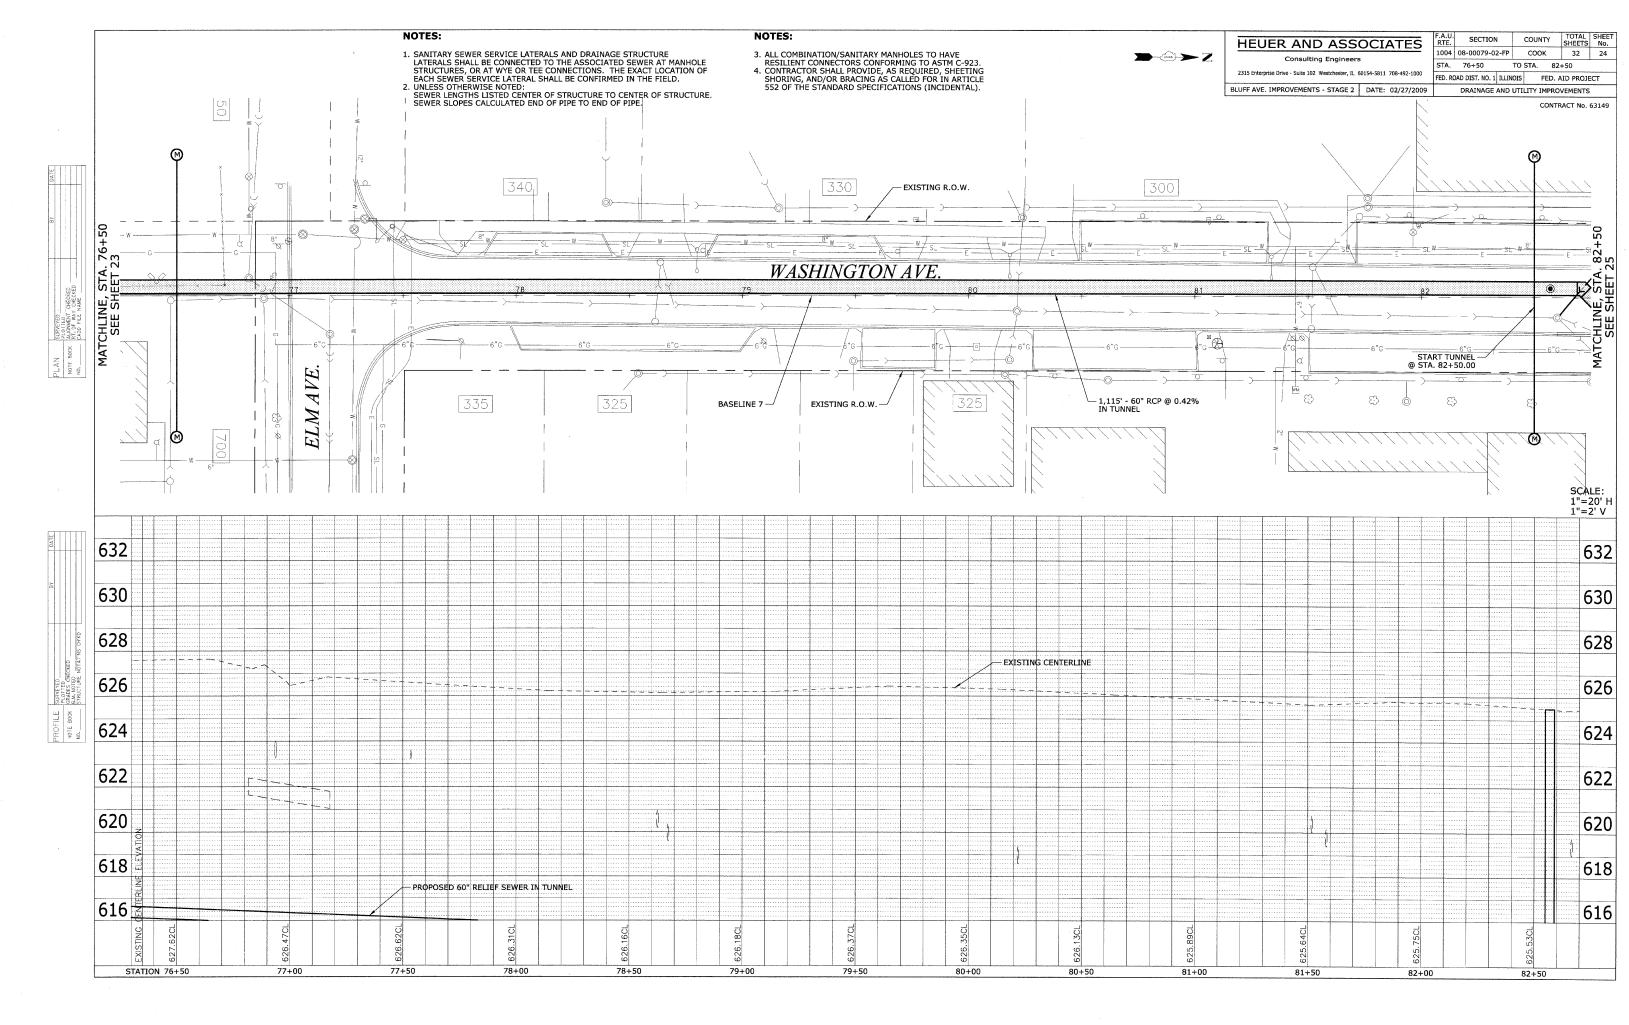

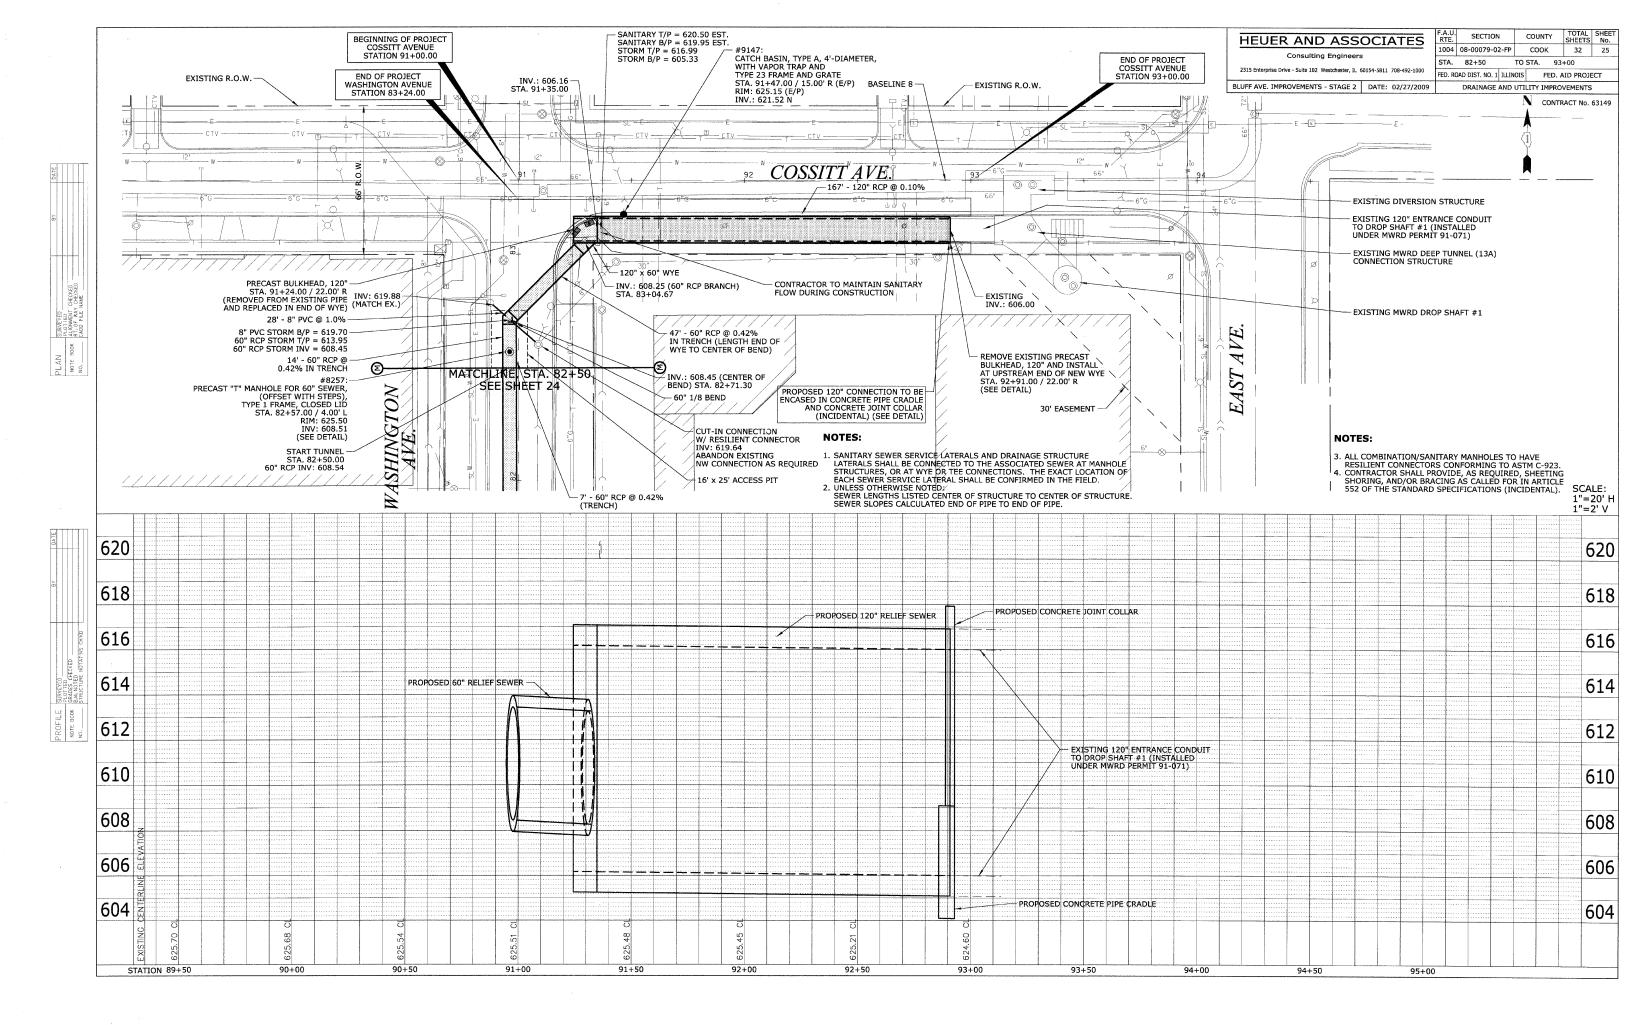



HEUER AND ASSOCIATES 1004 08-00079-02-FP COOK 32 26 Consulting Engineers STA. 61+50 TO STA. 72+00 2315 Enterprise Drive - Suite 102 Westchester, IL 60154-5811 708-492-1000 FED. ROAD DIST. NO. 1 ILLINOIS FED. AID PROJECT CONTRACT No. 63149 CENTERLINE OF MAPLE AVENUE R.O.W. CENTERLINE OF MAPLE AVENUE R.O.W. BASELINE 6 SOUTH R.O.W. SOUTH R.O.W. NORTH R.O.W. --NORTH R.O.W. --EXISTING 8" GAS MAIN -(ESTIMATED DEPTH) EXISTING 6" GAS MAIN -(ESTIMATED DEPTH) - 631.97 TOP OF RAIL PROPOSED 12" COMBINATION SEWER MAIN IN CASING INV @ CENTERLINE OF RAIL = 622.77 PROPOSED 12" COMBINATION SEWER MAIN INV = 622.24 FXIS EXISTING 12" WATER MAIN (ESTIMATED DEPTH) PROPOSED 12" WATER MAIN EXISTING TELEPHONE DUCT BANK (ESTIMATED DEPTH) EXISTING TELEPHONE DUCT BANK (ESTIMATED DEPTH) 620.55 T/P ========== 619.87 T/P-----PROPOSED 60" RCP STORM SEWER - PROPOSED 60" RCP STORM SEWER 614.0 (ESTIMATED BEDROCK) 613.5 (ESTIMATED BEDROCK) 610 **SECTION DETAIL 61+50 SECTION DETAIL 63+00** (LOOKING EAST) (LOOKING EAST) CENTERLINE OF MAPLE AVENUE R.O.W. BASELINE 6 SOUTH R.O.W. NORTH R.O.W. WEST EASEMENT LINE PROPERTY LINE AND EAST EASEMENT LINE EXISTING 8" GAS MAIN-(ESTIMATED DEPTH) EXISTING 12" COMBINATION SEWER MAIN INV = 621.40 EXISTING 12" WATER MAIN (ESTIMATED DEPTH) EXISTING 8" WATER MAIN (ESTIMATED DEPTH) EXISTING TELEPHONE DUCT BANK (ESTIMATED DEPTH) EXISTING 8" GAS MAIN (ESTIMATED DEPTH) 619.14 T/P ————— -- PROPOSED 12"
COMBINATION SEWER MAIN
INV = 621.40 618.60 T/P PROPOSED 60" RCP STORM SEWER 613.47 INV 612.93 INV PROPOSED 60" RCP STORM SEWER 610 609.0 (ESTIMATED BEDROCK) 607.0 (ESTIMATED BEDROCK) **SECTION DETAIL 64+80 SECTION DETAIL 72+00** (LOOKING EAST) (LOOKING NORTH) ILLINOIS DEPARTMENT OF TRANSPORTATION **BLUFF AVENUE IMPROVEMENTS** STAGE 2 **SEWER OUTLET CROSS-SECTIONS** SCALE: NTS DATE 02/27/2009

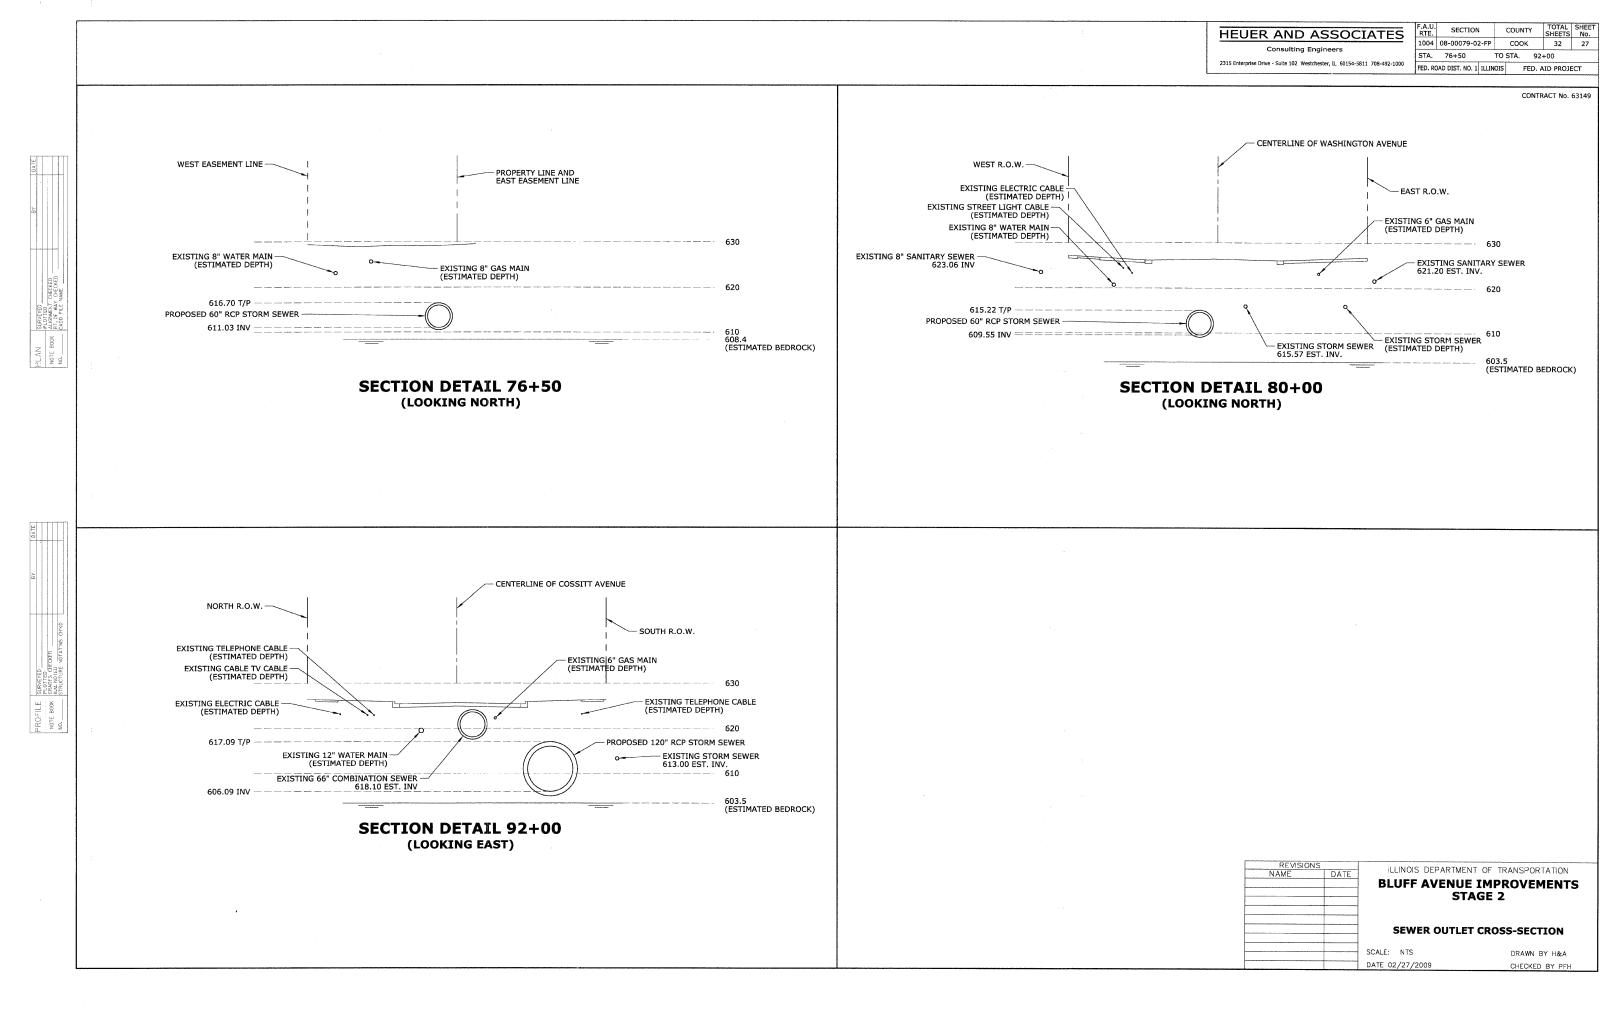





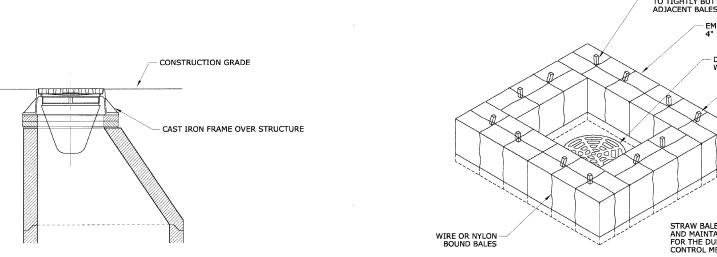

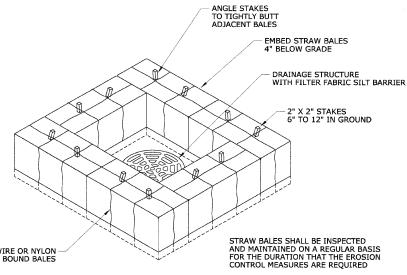

STRAW BALE SURROUND DETAIL




STABILIZATION TYPE	JAN	FEB	MAR	APR	MAY	JUN	JUL	AUG	SEP	ост	NOV	DEC
PERMANENT SEEDING			A			*	*		_			
DORMANT SEEDING	В		-								В	
TEMPORARY SEEDING			ç_			*	D*		_			
SODDING			E**						_			
MULCHING	F											_

- A. KENTUCKY BLUEGRASS 90 LBS/AC MIXED WITH PERENNIAL RYEGRASS
- B. KENTUCKY BLUEGRASS 135 LBS/AC MIXED WITH PERENNIAL RYEGRASS 45 LBS/AC + 2 TONS STRAW MULCH/AC
- C. SPRING OATS 100 LBS/AC
- D. WHEAT OR CEREAL RYE 150 LBS/AC
- F. STRAW MULCH 2 TONS/AC

E. SOD

- * IRRIGATION NEEDED DURING JUNE AND JULY
- ** IRRIGATION NEEDED FOR 2 TO 3 WEEKS AFTER APPLYING SOD

SOIL PROTECTION CHART

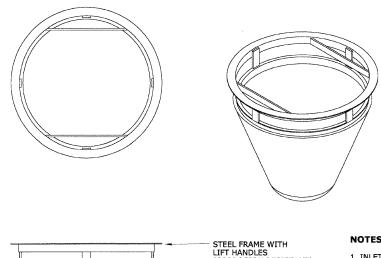


INLET FILTER INSTALLATION DETAIL

- 1. INLET FILTER ASSEMBLY SHALL MEET IDOT'S PROVISIONAL SPECIFICATIONS (ISP 04-11).
- 2. MAINTENANCE/CLEANING OF THE INLET FILTER ASSEMBLY SHALL BE IN STRICT ACCORDANCE WITH THE SPECIAL PROVISIONS AND THE MANUFACTURER'S RECOMMENDATIONS AND WRITTEN SPECIFICATIONS.
- 3. PRIOR TO ORDERING MATERIALS, THE CONTRACTOR SHALL DETERMINE THE SIZE AND SHAPE OF THE VARIOUS DRAINAGE STRUCTURES BEING PROTECTED.
- 4. MANUFACTURER SHALL FURNISH A CERTIFICATION WITH EACH SHIPMENT STATING COMPLIANCE WITH IDOT REQUIREMENTS.
- 5. ASSEMBLY SHALL BE AS MANUFACTURED BY INLET AND PIPE PROTECTION, INC., MARATHON MATERIALS, OR APPROVED EQUAL.

INLET FILTER ASSEMBLY DETAIL

OVERFLOW FEATURE

2 PIECE GEOTEXTILE FILTER (SEDIMENT) BAG

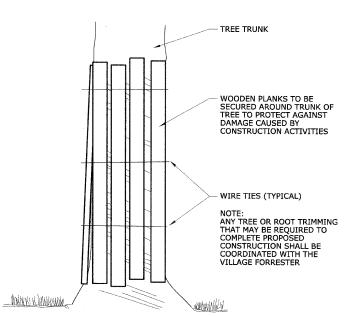

TREE T	RUNK	PROT	ECTION
--------	------	-------------	---------------

REVISION	NS	ILLINOIS DEPARTMENT OF TRANSPORTATION
NAME	DATE	ILLINOIS DEPARTMENT OF TRANSPORTATION
		BLUFF AVENUE IMPROVEMENTS
		STAGE 2
		STAGE Z


CONSTRUCTION DETAILS - SPECIAL

SCALE: NTS DATE 02/27/2009

CHECKED BY PFH



CONTRACT No. 63149

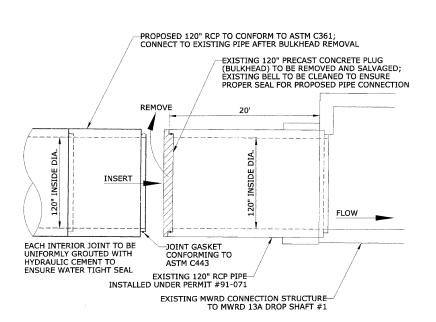

"SANITARY" CAST INTO COVER PATTERN
PRECAST CONCRETE GRADE RINGS
AS REQUIRED, 2" MINIMUM HEIGHT,
8" MAXIMUM HEIGHT

STEEL REINFORCED PLASTIC STEPS
INSTALLED 16" ON CENTERS
(PRESS-SEAL 14" 108.14850 OR EQUAL)

PRECAST CONCRETE STRUCTURE WITH 4" WALL
THICKNESS FABRICATED IN COMPLIANCE WITH
ASTM C478. TRANSITION COMPLIANCE WITH
ASTM C478. TRANSITION COMPLIANCE WITH
ASTM C478. TRANSITION REQUIRES USE
OF FLAT TOP SECTION. MANHOLS SECTIONS
TO BE ASSEMBLED AS REQUIRED TO MEET
DESIGN GRADES. PRECAST SECTION JOINTS
TO BE KEYED AND SEALED WITH BUTYL
RUBBER MASTIC MATERIAL.

PRECAST CONCRETE PIPE
TEE SECTION FABRICATED IN
ACCORDANCE WITH ASTM C-76

PIPE BEDDING AGGREGATE (CA-11)

22-3/4"

SURVEY MARKER DATA

SHEET NUMBER

BLOCK LOCATION


STAMPED REFERENCE NUMBER

19
4-418
4-405
43812-418
43812-405

PRECAST "T" MANHOLE FOR 60" SEWER WITH TYPE 1 FRAME AND CLOSED LID

TYPE B CLOSED LID

CAST IRON FRAME AND CLOSED LID, NEENAH R-1713 OR EQUAL WITH TYPE "F" CONCEALED PICKHOLE AND WORD

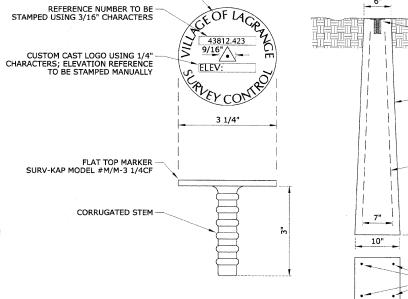

ANCHORING CEMENT (ROCKTITE HYDRAULIC CEMENT OR EQUAL)
TO SEAL MARKER TABLET IN PRECAST MARKER HOLE

PRECAST OR CAST IN-PLACE CONCRETE SURVEY MARKER

NO. 3 BARS 3'-6" LONG

GROUND SURFACE


BRASS TABLET

CONCRETE MARKER

PERMANENT SURVEY MARKER

REVISIOI NAME	NS DATE	BLUFF AVENU	ENT OF TRANSPORTATION LE IMPROVEMENTS LAGE 2
		CONSTRUCTION	N DETAILS - SPECIAL
		SCALE: NTS DATE 02/27/2009	DRAWN BY H&A CHECKED BY PFH

EXISTING PRECAST PLUG (BULKHEAD) REMOVAL AND 120" CONNECTION TO EXISTING 120" RCP

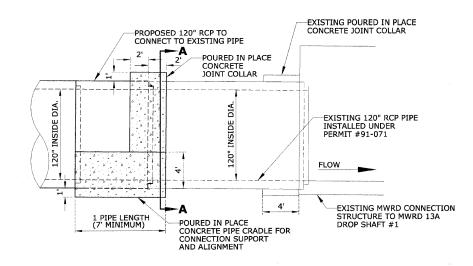


ELEVATION VIEW


120" CONNECTION TO EXISTING 120" RCP WITH PIPE CRADLE AND JOINT COLLAR

SECTION A - A


CONTRACT No. 63149

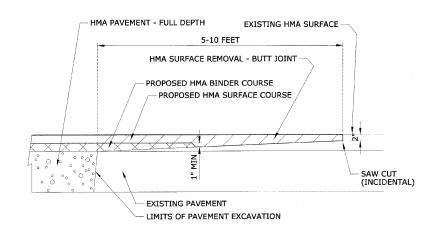


BUTT JOINT DETAIL

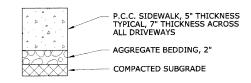


P.C.C. SIDEWALK

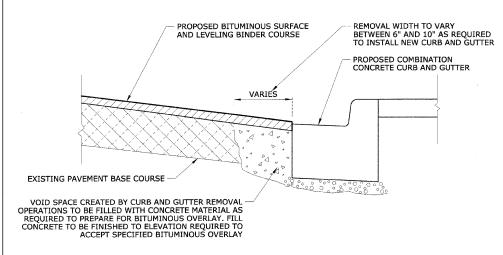


CONCRETE FILLET DETAIL

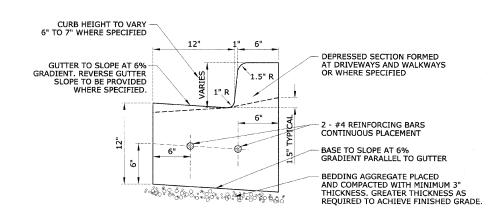

COMBINATION CONCRETE CURB AND GUTTER, TYPE B-6.12 WITH STANDARD GUTTER GRADIENT

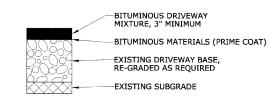


BITUMINOUS DRIVEWAY TRANSITION (CLASS C PATCH, 3" MINIMUM THICKNESS)

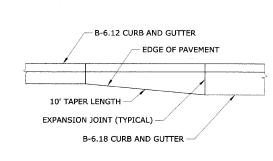


TRANSITION LENGTH FROM B-6.12 TO B-6.18 CURB AND GUTTER

THIS ITEM IS TO BE PAID FOR UNDER THE PAY ITEM FOR COMBINATION CONCRETE CURB AND GUTTER, TYPE B-6.18.

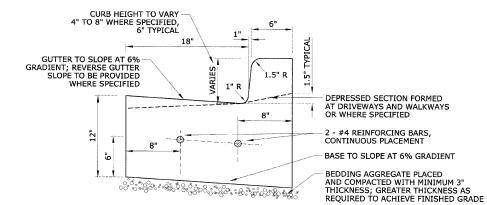


COMBINATION CONCRETE CURB AND GUTTER, TYPE B-6.18

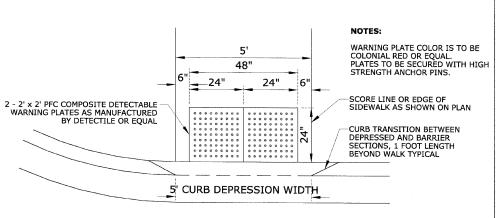


HANDICAP RAMP WITH DETECTABLE WARNINGS

REVISIO	NS I	# (WALCO DED . D.T.)		
NAME DATE		ILLINOIS DEPARTMENT OF TRANSPORTATION		
			E IMPROVEMENTS AGE 2	
		CONSTRUCTION	N DETAILS - SPECIAL	
		SCALE: NTS	DRAWN BY H&A	
		DATE 02/27/2009	CHECKED BY PFH	




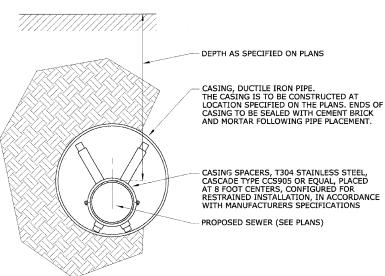


SEWER MAIN IN CASING PIPE

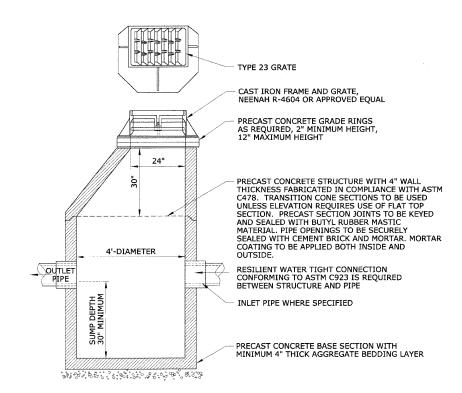


CATCH BASIN, TYPE A, 4'-DIAMETER WITH TYPE 23 FRAME AND GRATE

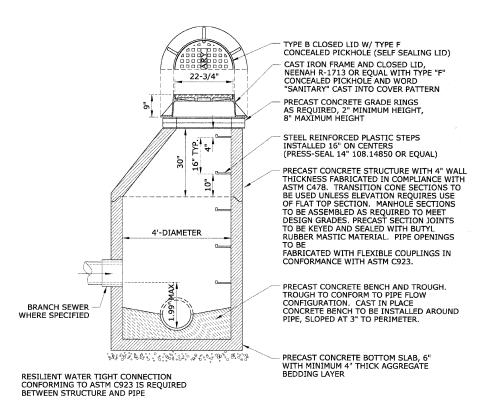

MANHOLE, TYPE A, 4'-DIAMETER WITH TYPE 1 FRAME AND CLOSED LID

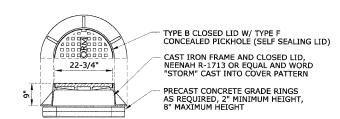

WITH TYPE 1 FRAME AND SELF SEALING CLOSED LID

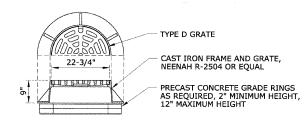


WITH TYPE 1 FRAME AND GRATE

ALTERNATIVE FRAMES AND GRATES/LIDS


HEUER AND ASSOCIATES

HEUER AND ASSOCIATES		SECTION	COUNTY	SHEETS	SHEET No.
Consulting Engineers		08-00079-02-FP	COOK	32	31
• •	STA. TO STA.				
2315 Enterprise Drive - Suite 102 Westchester, IL 60154-5811 708-492-1000		DAD DIST. NO. 1 ILLIN	OIS FED.	AID PROJE	СТ

CONTRACT No. 63149

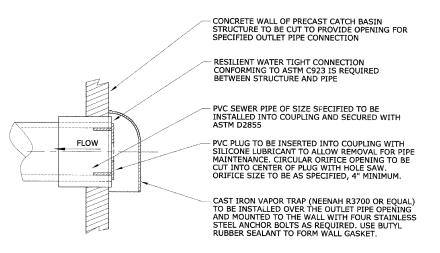


CAST IRON VAPOR TRAP WITH ORIFICE RESTRICTOR

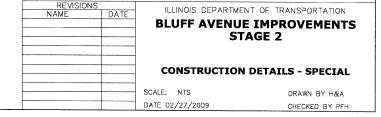




TOTAL SHEET SHEETS No. SECTION COUNTY соок STA. TO STA. 2315 Enterprise Drive - Suite 102 Westchester, IL 60154-5811 708-492-1000 FED. ROAD DIST. NO. 1 ILLINOIS FED. AID PROJECT


CONTRACT No. 63149

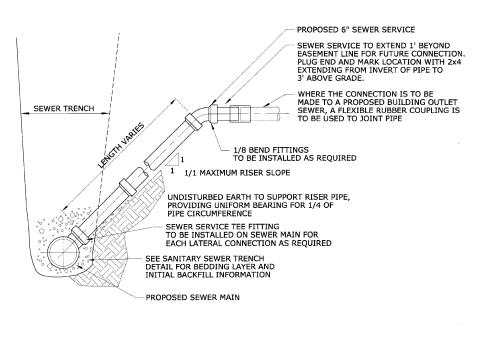

SEWER SERVICE TEE AND RISER

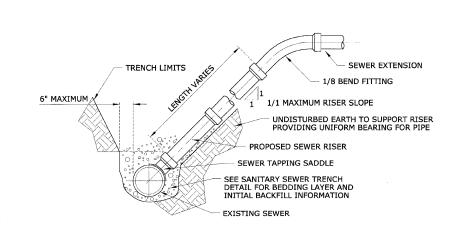

TAPPED SEWER SERVICE AND RISER

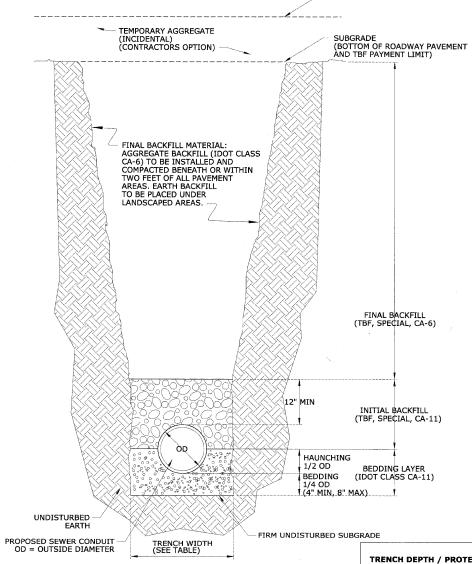

SEWER TRENCH DETAIL

SURFACE GRADE

MAXIMUM PAYMENT WIDTH TRENCH DEPTH / PROTECTION 5 FT AND LESS, W/O PROTECTION OD + 18" 5 FT AND LESS, W/ PROTECTION OD + 36" GREATER THAN 5 FT OD + 36"

MATERIAL AS SPECIFIED TRENCH LIMITS AS SPECIFIED EXISTING SEWER TO BE REPLACED ACROSS WATERMAIN TRENCH WITH DUCTILE IRON PIPE. A MINIMUM CLEARANCE OF 12" TO BE MAINTAINED BETWEEN THE WATERMAIN AND AND THE SEWER. SEWER REPLACEMENT TO EXTEND A MINIMUM OF 10 FEET EITHER SIDE OF THE WATERMAIN. FLEXIBLE COUPLINGS TO BE USED TO JOIN THE SEWER PIPE. CENTERLINE WATER MAIN 10' MIN FLEXIBLE COUPLINGS TO BE INSTALLED AS REQUIRED (INCIDENTAL) EXISTING SEWER PIPE DUCTILE IRON PIPE PROPOSED WATER MAIN COARSE AGGREGATE, IDOT CLASS CA-6, TO BE INSTALLED AS BACKFILL AT ALL SEWER CROSSINGS. PLACED MATERIAL TO BE TAMPED AND COMPACTED TO SUPPORT SEWER.

BACKFILL WITH EARTH OR AGGREGATE

SURFACE GRADE

SEWER CROSSING DETAIL

	BLU	JFF AV	/ENUE IMPROVEMENTS STAGE 2
	со	NSTRU	CTION DETAILS - SPECIAL
	SCALE:	NTS	DRAWN BY H&A

DATE 02/27/2009

ILLINOIS DEPARTMENT OF TRANSPORTATION

CHECKED BY PFH