INDEX OF SHEETS

MAJOR CROSS STREETS AND FRONTAGE ROADS:

75TH STREET

76TH STREET

S. LAFAYETTE AVENUE

FOR INDEX OF SHEETS, SEE SHEET NO. 2

DAN RYAN EXPRESSWAY:	ADT (2010)	DESIGN SPEED	POSTED SPE
SB 1-94 (DAN RYAN)	140,500	60 MPH	55 MPH
SB 75TH STREET C-D EXIT RAMP	8,000	45 MPH	40 MPH
SB 76TH STREET C-D ENTRANCE RAMP	8,000	45 MPH	40 MPH

17.700

12,000

POSTED SPEED

30 MPH 30 MPH

30 MPH

PROPOSED HIGHWAY PLANS

F.A.I. ROUTE 94 (DAN RYAN EXPRESSWAY) **SECTION 1818 I-9** CONSTRUCTION OF FLUTED KNEE WALL ALONG LAFAYETTE AVE. FROM 76TH STREET TO 74TH STREET **COOK COUNTY**

STATE OF ILLINOIS

DEPARTMENT OF TRANSPORTATION

DIVISION OF HIGHWAYS

DESCRIFTION OF PROJECT

CONSTRUCTION OF FLUTED KNEE WALLS LOCATED WITHIN THE PROJECT LIMITS

R. 14 E. F.A.I. 94 (RYAN) PROJECT LIMIT STA, 1347 + 21.51 (SB I-94) PROJECT LOCATED IN THE CITY OF CHICAGO T. 38 N. T. 37 N. FULL SIZE PLANS HAVE BEEN PREPARED USING STANDARD F.A.I. 94 (RYAN) PROJECT LIMIT ENGINEERING SCALES; REDUCED SIZED PLANS WILL NOT STA. 1329 + 49.25 (SB I-94) CONFORM TO STANDARD SCALES. IN MAKING MEASUREMENTS ON REDUCED PLANS, THE ABOVE SCALES MAY BE USED CTA CONTACT: DAVID HEARD, CHICAGO UTILITY ALERT NETWORK MANAGER, CONSTRUCTION (312) 744-7000 MANAGEMENT OVERSIGHT (312) 681-3862

D-91-239-05


94 1818 I-9 COOK 49 1 FED. ROAD DIST. NO. ILLINOIS FED. AID PROJECT

62981

DEPARTMENT OF TRANSPORTATION DIVISION OF HIGHWAYS SUBMITTED OCTOBER 9, 20 08 Diana M. O'Keefe June 26, 20 09 Christine M. Red D.
DIRECTOR OF HIGHWAYS, CHIEF ENGINEER

LOCATION OF SECTION INDICATED THUS: -

CONTRACT 26E

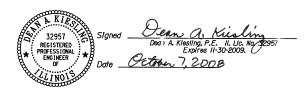

TY:LIN INTERNATIONAL PRINTED BY THE AUTHORITY OF THE STATE OF ILLINOIS

CONTRACT NO. 62981

C-91-239-05

INDEX OF SHEETS

SHEET NO.	TITLE
1	COVER SHEET
2	INDEX OF SHEETS, INDEX OF STATE STANDARDS, GENERAL NOTES, AND CONTRACTOR ACCESS ASSUMPTIONS
3	SUMMARY OF QUANTITIES AND SCHEDULE OF QUANTITIES
4 - 5	EXISTING AND PROPOSED TYPICAL SECTIONS
6 - 16	ALIGNMENT AND SURVEY TIES FOR CONTROL POINTS
17 - 24	REMOVAL AND PROPOSED PLANS
25	CONCRETE MEDIAN SURFACE , 5" (MODIFIED) - WITH CALIFORNIA FINISH DETAIL
26 - 28	CITY OF CHICAGO STANDARD DETAILS - DETAILS OF CURB RAMPS FOR PEOPLE WITH DISABILITIES
29 - 30	FLUTED KNEE WALL AND FLUTED KNEE WALL, SPECIAL STANDARD DETAILS
31 - 45	PROPOSED CROSS SECTIONS
46	TC-10 DIST 1, TRAFFIC CONTROL AND PROTECTION FOR SIDE ROADS, INTERSECTIONS, AND DRIVEWAYS
47	TC-17 DIST 1, TRAFFIC CONTROL DETAILS FOR FREEWAY SHOULDER CLOSURES AND PARTIAL RAMP CLOSURES
48	TC-18 DIST 1, SIGNING FOR FLAGGING OPERATIONS AT WORK ZONE OPENINGS
49	TC-22 DIST 1, ARTERIAL ROAD INFORMATION SIGN

INDEX OF STATE STANDARDS

STANDARD NO.	TITLE
000001-05	STANDARD SYMBOLS, ABBREVIATIONS, AND PATTERNS
001001-02	AREAS OF REINFORCEMENT BARS
001006	DECIMAL OF AN INCH AND OF A FOOT
606001 -04	CONCRETE CURB TYPE B AND COMBINATION CONCRETE CURB AND GUTTER
664001 -02	CHAIN LINK FENCE
701456	PARTIAL EXIT RAMP CLOSURE FREEWAY/EXPRESSWAY
701601 -06	URBAN LANE CLOSURE, MULTILANE 1W OR 2W WITH NONTRAVERSABLE MEDIAN
701701-06	URBAN LANE CLOSURE MULTILANE INTERSECTION
701801-04	LANE CLOSURE MULTILANE 1W OR 2W CROSSWALK OR SIDEWALK CLOSURE
701901 -01	TRAFFIC CONTROL DEVICES

GENERAL NOTES:

- ·1. UTILITY LOCATIONS SHOWN ON THESE PLANS MAY NOT BE CORRECT OR COMPLETE. THE CONTRACTOR SHALL COORDINATE CONSTRUCTION ACTIVITIES WITH THE RESPECTIVE UTILITIES OF THE CITY OF CHICAGO AND THOSE PRIVATELY OWNED. BEFORE STARTING ANY EXCAVATION, THE CONTRACTOR SHALL CALL THE CHICAGO UTILITY ALERT NETWORK AT (312) 744-7000 FOR FIELD LOCATIONS OF BURIED ELECTRIC, TELEPHONE, CABLE, AND GAS FACILITIES (48 HOURS NOTIFICATION IS REQUIRED). CONTACT THE CHICAGO DEPARTMENT OF WATER MANAGEMENT PERMIT SECTION AT (312) 747-7893 FOR WATER AND SEWER LOCATIONS.
- 2. WHERE SECTION OR SUBSECTION MONUMENTS ARE ENCOUNTERED, THE ENGINEER SHALL BE NOTIFIED BEFORE SUCH MONUMENTS ARE REMOVED. THE CONTRACTOR SHALL PROTECT AND CAREFULLY PRESERVE ALL PROPERTY MARKERS AND MONUMENTS. THE ENGINEER OR AN AUTHORIZED SURVEYOR AGENT WILL WITNESS OR OTHERWISE REFERENCE AND RESET MONUMENTS AS NECESSARY. ALL PROPERTY CORNERS EXCEPT THOSE WITHIN AREAS WHERE THE SCHEDULE, IF PROVIDED, SHOWS PLACEMENT OF R.O.W. MARKERS SHALL REMAIN UNDISTURBED.
- 3. THE CONTRACTOR SHALL NOT SET UP A YARD OR FIELD OFFICE ON IDOT PROPERTY WITHOUT WRITTEN PERMISSION FROM IDOT.
- 4. THE CONTRACTOR SHALL TAKE ALL NECESSARY SAFETY PRECAUTIONS TO PROTECT AND PROVIDE ACCESS TO ABUTTING PROPERTY, UTILITIES, PEDESTRIANS, AND VEHICULAR TRAFFIC.
- 5. ALL ELEVATIONS SHOWN ARE BASED ON THE CHICAGO CITY DATUM OF 0.00, WHICH IS 579.19 FEET ABOVE MEAN TIDE NEW YORK. (NAVD 88)
- 6. THE CONTRACTOR SHALL USE CARE IN GRADING OR EXCAVATING NEAR ANY AND ALL EXISTING ITEMS THAT WILL NOT BE REMOVED. ANY DAMAGE DONE TO EXISTING ITEMS BY THE CONTRACTOR SHALL BE REPAIRED BY THE CONTRACTOR AT THE CONTRACTOR'S OWN EXPENSE.
- 7. IT SHALL BE THE CONTRACTOR'S RESPONSIBILITY TO ENSURE THAT NO GAP REMAINS BETWEEN PROPOSED RELOCATED FENCING OR WHERE PROPOSED RELOCATED FENCING TERMINATES AND EXISTING FENCE REMAINS IN PLACE.
- 8. ALL EXISTING FENCE THAT IS REQUIRED TO BE REMOVED AND RE-ERECTED SHALL BE RELOCATED PRIOR TO THE START OF INSTALLATION OF THE PROPOSED KNEE WALL OR AS DIRECTED BY THE ENGINEER.
- 9. THE LOCATIONS OF VARIOUS ITEMS SUCH AS PAVEMENT, RETAINING WALLS, AND DRAINAGE STRUCTURES BUILT IN CONTRACTS UNDER CONSTRUCTION ARE BASED ON THE PUBLISHED CONTRACT PLAN DRAWINGS AVAILABLE DURING DESIGN. THE CONTRACTOR SHALL VERIFY AS-BUILT CONDITIONS.
- 10. THE CONTRACTOR SHALL TAKE ALL NECESSARY PRECAUTIONS FOR THE PROTECTION OF EXISTING PLANT MATERIAL FOR WHICH THE CONTRACT DOES NOT PROVIDE REMOVAL. THE PROTECTION OF EXISTING PLANT MATERIAL SHALL BE DONE IN ACCORDANCE WITH THE REQUIREMENTS OF SECTION 201 OF THE STANDARD SPECIFICATIONS.
- 11. THE INTENT OF THE CONTRACT DOCUMENTS IS TO CONSTRUCT THE FLUTED KNEE WALL BEHIND THE EXISTING CURB AND GUTTER. ANY DAMAGE TO THE EXISTING CURB AND GUTTER SHALL BE REPAIRED TO THE ORIGINAL CONDITION OF THE CURB AND GUTTER OR REPLACED AT THE CONTRACTOR'S OWN EXPENSE.
- 12. CONTRACTS #62979 (26C) AND #62980 (20D) SHALL BE ALLOWED ACCESS TO USE THE FIELD OFFICE PROVIDED FOR IN THIS CONTRACT.
- 13. THE CONTRACTOR SHALL PROVIDE ALL NECE SARY TRAFFIC CONTROL DEVICES NEEDED TO COMPLETE THE WORK. THIS WORK SHALL BE INCLUDED IN THE COST OF TRAFFIC CONTROL AND PROTECTION (SPECIAL).
- 14. THE CONTRACTOR SHALL NOT MAINTAIN A PERMANENT PARTIAL RAMP OR SHOULDER CLOSURE ALONG THE MAINLINE I-94 (DAN RYAN) FOR THE DURATION OF THIS PROJECT. ONLY TEMPORARY PARTIAL RAMP CLOSURES SHALL BE PERMITTED.
- 15. ALL CATCH BASINS IN THE CITY OF CHICAGO SHALL MEET THE CHICAGO DEPARTMENT OF WATER MANAGEMENT'S STANDARDS.
- 16. PERMITS FROM THE DEPARTMENT OF WATER MANAGEMENT ARE REQUIRED FOR ALL UNDERGROUND STORM, SANITARY AND COMBINED SEWER SYSTEM CONSTRUCTION, AND FOR ALL WORK INVOLVING ADJUSTMENT OF SEWER STRUCTURES. THE DEPARTMENT OF WATER MANAGEMENT'S PERMIT SHALL BE OBTAINED BY A LICENSED SEWER DRAIN LAYER PRIOR TO START OF CONSTRUCTION. THE LICENSED SEWER CONTRACTOR/SHALL SUBMIT TWO SETS OF PLANS APPROVED BY THE DEPARTMENT OF WATER MANAGEMENT FOR THE ISSUANCE OF THE SEWER PERMIT TO BUREAU OF ENGINEERING SERVICES-SEWER SECTION, JARDINE PURIFICATION PLANT, EL+51, ROOM 313, 1000 E. OHIO ST., CHICAGO, IL GOGII. INSPECTION WILL BE PROVIDED BY THE DEPARTMENT OF WATER MANAGEMENT.
- 17. THE RESIDENT ENGINEER AND THE CONTRACTOR SHALL FIELD VERIFY THE CITY'S EXISTING SEWER FACILITIES IN THE LIMITS OF THE REFERENCED PROJECT FOR ANY CONFLICTS DUE TO THE PROPOSED IMPROVEMENT. ANY CONFLICT SHALL BE RESOLVED WITH THE DEPARTMENT OF WATER MANAGEMENT PRIOR TO START OF CONSTRUCTION.
- 18. IN CASE OF DAMAGE TO CITY OF CHICAGO SEWERS, PRIVATE AND PUBLIC DRAINS, SEWER STRUCTURES AND/OR BENCH MONUMENTS, THE CONTRACTOR SHALL IMMEDIATELY CONTACT THE DEPARTMENT OF WATER MANAGEMENT AT (312) 744-0409 OR (312) 744-0408.
- 19. PERFORATED LIDS SHALL BE PLACED ON ALL SEWER MANHOLES AND CATCH BASINS.
- 20. NIGHT OPERATIONS SHALL NOT BE ALLOWED
- 21. LOCATION OF THE ELECTRICAL EQUIPMENT, INSTALLED BY CONTRACT 62583, IS APPROXIMATE. THE RESIDENT ENGINEER AND THE CONTRACTOR SHALL FIELD VERIFY THE EXACT LOCATION OF ALL ELECTRICAL ITEMS WITHIN THE PROJECT LIMITS WITH THE IDOT ELECTRICAL REPRESENTATIVE PRIOR TO THE START OF CONSTRUCTION. THE COST SHALL BE INCLUDED IN THE COST OF MOBILIZATION.

GENERAL NOTES (CONT.):

F.A.I. RTE.	SECTION	4	COUNTY	TOTAL	SHEET NO.
94	1818 I-9		COOK	49	2
STA.	1329+49.25	ТО	STA. 134	7+21.51	
FED. RO	DAD DIST. NO.	ILLINOIS	FED. AID	PROJECT	•

62981

22. CITY OF CHICAGO WATER VALVE VAULTS AND SEWER STRUCTURES SHALL NOT BE CLOSED, COVERED OR OTHERWISE OBSTRUCTED DURING CONSTRUCTION WITHOUT PRIOR WRITTEN PERMISSION FROM THE CITY OF CHICAGO DEPARTMENT OF WATER MANAGEMENT.

23. IN LOCATIONS WHERE THE MAIN SEWER IS NOT BEING REPLACED AND THE EXISTING DRAINAGE FACILITIES ARE DISTURBED OR DAMAGED DURING CONSTRUCTION BY THE CONTRACTOR, IT SHALL BE THE CONTRACTOR'S RESPONSIBILITY TO RESTORE AND REPLACE THE DAMAGED FACILITIES AT HIS/HER OWN EXPENSE TO THE SATISFACTION OF THE ENGINEER.

24. IT IS CALLED TO THE CONTRACTOR'S ATTENTION THAT HE/SHE SHALL BE REQUIRED TO OBTAIN AND PAY FOR ANY INSPECTION OR PERMIT FEES TO THE VARIOUS DEPARTMENTS OF THE CITY OF CHICAGO AND THE STATE OF ILLINOIS. THE COST FOR THESE FEES SHALL NOT BE PAID FOR SEPARATELY BUT SHALL BE CONSIDERED INCLUDED IN THE COST OF MOBILIZATION. PERMIT FEES SHALL BE PAID PRIOR TO COMMENCING CONSTRUCTION.

25. A PERMIT SHALL BE SECURED FROM THE BUREAU OF TRAFFIC PERMIT DIVISION, ROOM 804, CITY HALL AND BE INCLUDED IN THE COST OF MOBILIZATION. ADDITIONALLY, SEVEN (7) DAYS NOTICE SHALL BE GIVEN TO THE BUREAU OF TRAFFIC (312-744-0330) PRIOR TO STATING ANY WORK OR MAKING ANY CHANGES IN THE TRAFFIC PATTERNS. ANY LANE OR ROADWAY CLOSURE INCLUDING DETOUR SHALL BE REVIEWED AND APPROVED BY THE BUREAU OF TRAFFIC.

26. A "BOXED" NOTE INDICATES AN ITEM OF WORK THAT IS NOT PAID FOR SEPARATELY, BUT IS PAID FOR AS PART OF ANOTHER ITEM LISTED IN THE SUMMARY OF QUANTITIES.

27. THE REMOVED AND RE-ERECTED EXISTING FENCE SHALL REMAIN IN ITS RELOCATED POSITION, AS SHOWN ON PLANS, AT THE END OF THIS CONTRACT. FUTURE CONTRACT *60A02 SHALL INSTALL THE PERMANENT FENCING ON THE KNEE WALL AND THEN REMOVE THE FENCE LEFT IN PLACE BY THIS CONTRACT.

28. THE CONTRACTOR SHALL PROTECT ALL BLUNT ENDS OF THE KNEE WALL FOR TRAFFIC SAFETY.
ALL TEMPORARY PROTECTION DEVICES USED FOR THIS PURPOSE SHALL BE NCHRP 350 COMPLIANT
AND AS DIRECTED BY THE ENGINEER. THIS WORK SHALL BE INCLUDED IN THE COST OF TRAFFIC
CONTROL AND PROTECTION (SPECIAL).

CONTRACTOR ACCESS ASSUMPTION:

FOR THE FLUTED KNEE WALL CONSTRUCTION, ACCESS IS ASSUMED TO BE FROM THE FRONTAGE ROAD, 76TH STREET C-D ENTRANCE RAMP OR THE 75TH STREET C-D EXIT RAMP.

REVISIONS
NAME
DATE
F.A.I. 94 (DAN RYAN EXPRESSWAY)

INDEX OF SHEETS, INDEX OF STATE
STANDARDS, GENERAL NOTES AND
CONTRACTOR ACCESS ASSUMPTIONS

SCALE: NONE
DATE: OCTOBER 17, 2008

DRAWN BY: AMB, MAF
CHECKED BY: TGB, MI

TYLIN INTERNATIONAL

PROJECT: KNEE WALLS ALONG LAFAYETTE AVENUE FROM 76TH TO 74TH STREET, COOK COUNTY/CITY OF CHICAGO

SUMMARY OF QUANTITIES

CODE	VIEW DECODED VOLUME		URBAN	100% STATE
NUMBER	ITEM DESCRIPTION	UNIT	QUANTITY	SFTY-4A
20101000	TEMPORARY FENCE	F00T	168	168
20200100	EARTH EXCAVATION	CU YD	235	235
20201200	REMOVAL AND DISPOSAL OF UNSUITABLE MATERIAL	CU YD	315	315
21101615	TOPSOIL FURNISH AND PLACE, 4"	SQ YD	934	934
21101645	TOPSOIL FURNISH AND PLACE, 12"	SQ YD	154	154
21101825	COMPOST FURNISH AND PLACE, 6"	SQ YD	154	154
25000210	SEEDING, CLASS 2A	ACRE	0.25	0.25
25000400	NITROGEN FERTILIZER NUTRIENT	POUND	21	21
25000500	PHOSPHORUS FERTILIZER NUTRIENT	POUND	21	21
25000600	POTASSIUM FERTILIZER NUTRIENT	POUND	21	21
25100630	EROSION CONTROL BLANKET	SQ YD	1088	1088
25200200	SUPPLEMENTAL WATERING	UNIT	72	72
28000510	INLET FILTERS	EACH	17	17
42001300	PROTECTIVE COAT	SQ YD	132	132
42400200	PORTLAND CEMENT CONCRETE SIDEWALK 5 INCH	SQ FT	549	549
44000500	COMBINATION CURB AND GUTTER REMOVAL	FOOT	138	138
44000600	SIDEWALK REMOVAL	SQ FT	382	382
44003100	MEDIAN REMOVAL	SQ FT	13	13
60255500	MANHOLES TO BE ADJUSTED	EACH	4	4
66410300	CHAIN LINK FENCE REMOVAL	F00T	80	80
66410400	CHAIN LINK FENCE TO BE REMOVED AND RE-ERECTED	FOOT	572	572
67000400	ENGINEER'S FIELD OFFICE, TYPE A	CAL MO	12	12
67100100	MOBILIZATION	L SUM	1	1
70101800	TRAFFIC CONTROL AND PROTECTION, (SPECIAL)	L SUM	1	1
X0326/43	FLUTED KNEE WALL (SPECIAL)	F00T	465	465
X0326311	RELOCATE EXISTING SIGN PANEL (SPECIAL)	EACH	4	4
X0326144	TACTILE/DETECTABLE WARNING SURFACE	SQ FT	32	32
X0321750	REMOVE TEMPORARY CONCRETE BARRIER, STATE OWNED	FOOT	50	50
X0322256	TEMPORARY INFORMATION SIGNING	SQ FT	78	78
X0324640	FLUTED KNEE WALL	FOOT	1172	1172
X6065740	CONCRETE MEDIAN SURFACE, 5" (MODIFIED)	SQ FT	376	376
XX104800	COMBINATION CONCRETE CURB AND GUTTER, TYPE B-V.12	FOOT	138.0	138.0
Z0013798	CONSTRUCTION LAYOUT	L SUM	1	

F.A.I. RTE.	SECTION	1	COUNTY	TOTAL SHEETS	SHEET NO.
94	1818 I-9)	COOK	49	3
STA.	1329+49.25	ТО	STA. 1347	+21.51	
FED. RO	AD DIST. NO.	ILLINOIS	FED. AID	PROJECT	•

62981


EARTHWORK SCHEDULE

LOCA	TION		EARTH	REM. & DISP	
ALIGNMENT	STATION TO STATION		EXCAVATION (CU YD)	UNSUITABLE (CU YD)	
SB I-94 (DAN RYAN EXPY)	1329+54.98	1331+89.82	35.0	70.0	
SB I-94 (DAN RYAN EXPY)	1332+70.93	1338+38.23	105.0	125.0	
SB I-94 (DAN RYAN EXPY)	1339+31.23	1347+13.99	95.0	120.0	
		TOTAL	235.0	315.0	


REVISIONS
NAME
DATE
F.A.I. 94 (DAN RYAN EXPRESSWAY)

SUMMARY OF QUANTITIES
AND SCHEDULE OF QUANTITIES


SCALE: NONE
DATE: OCTOBER 17, 2008 CHECKED BY: TGB, MI

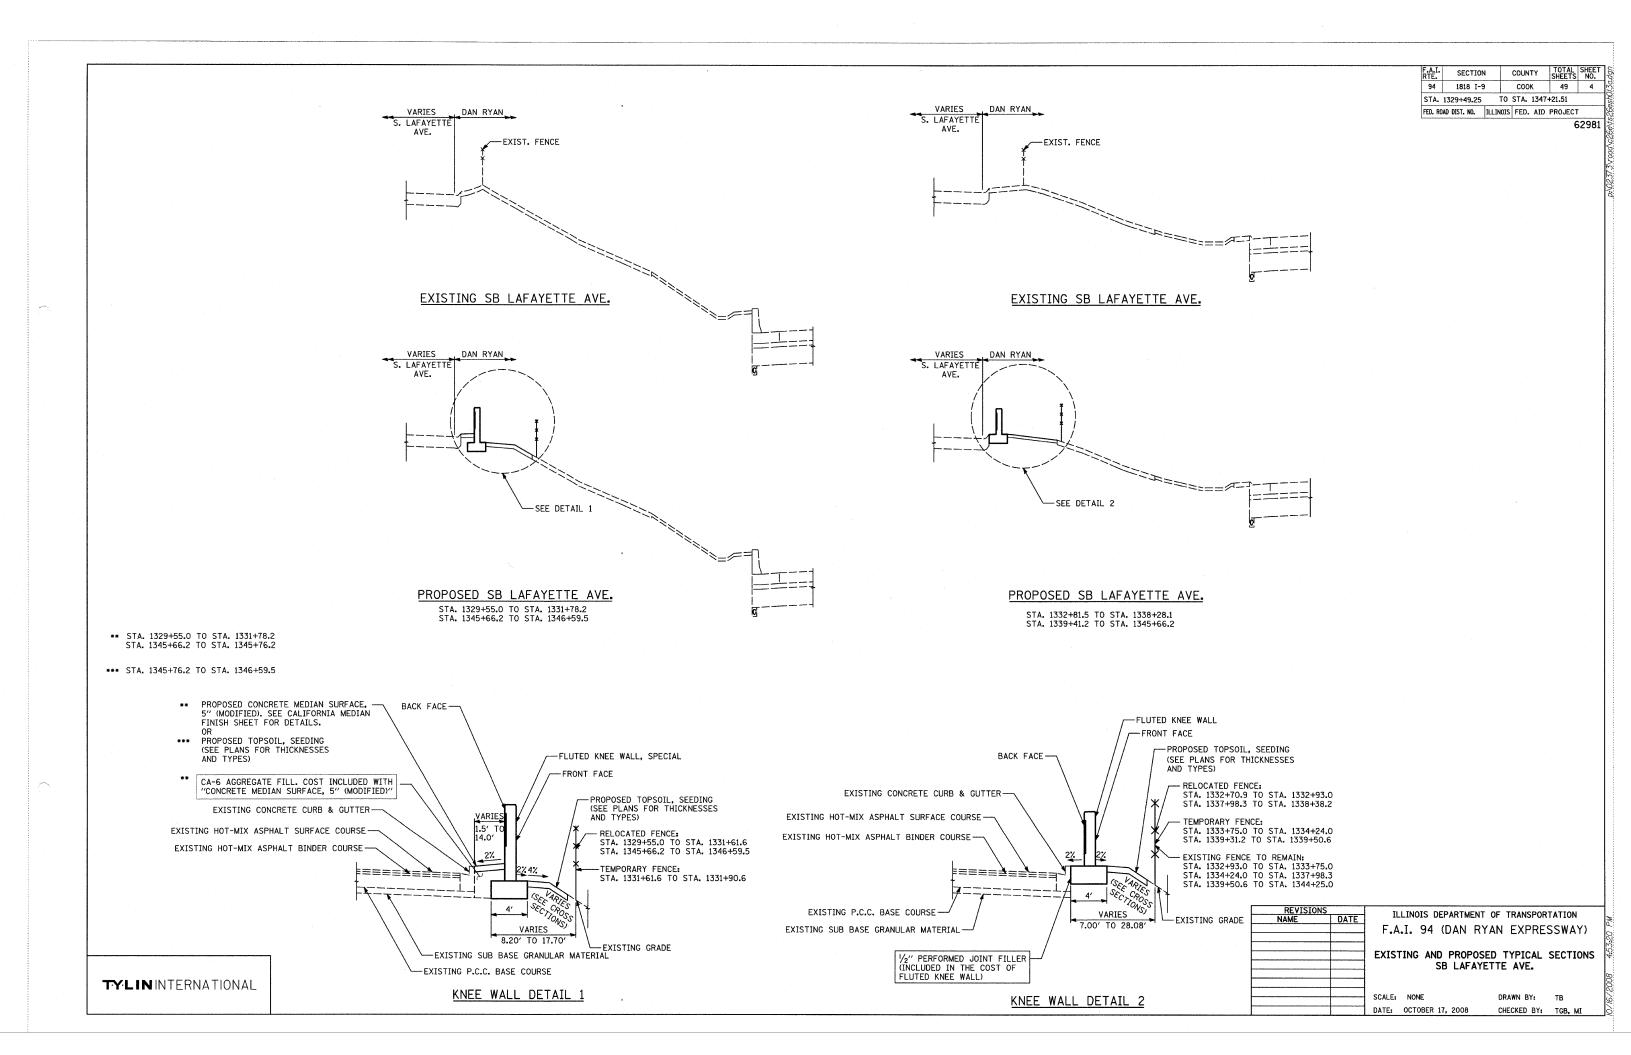


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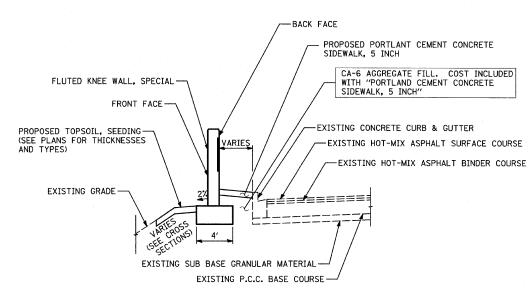


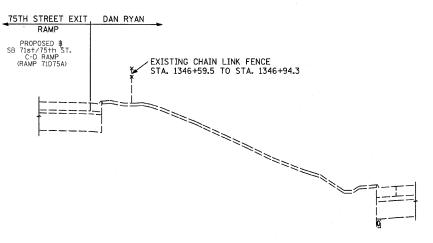EXISTING SB LAFAYETTE AVE.

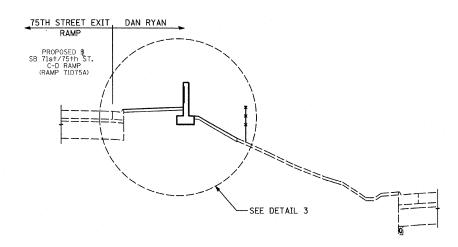

PROPOSED SB LAFAYETTE AVE. STA. 1346+59.5 TO STA. 1347+14.0



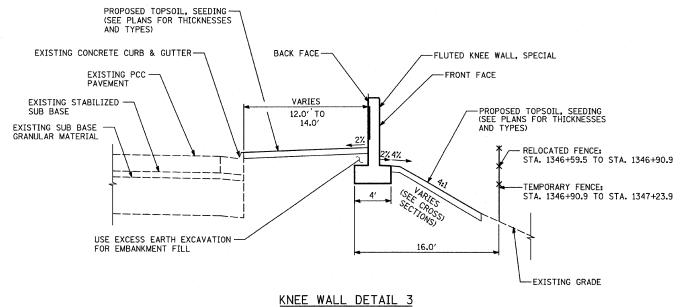


FLUTED KNEE WALL TYPICAL SECTION AT SIDEWALK


REVISIONS NAME	DATE	F.A	LINOIS DEPARTMENT I. 94 (DAN RY) ING AND PROPOSE SB LAFAYE	AN EXPRE	SSWAY)
		SCALE:	NONE	DRAWN BY:	TB


DATE: OCTOBER 17, 2008

CHECKED BY: TGB, MI

TYLIN INTERNATIONAL

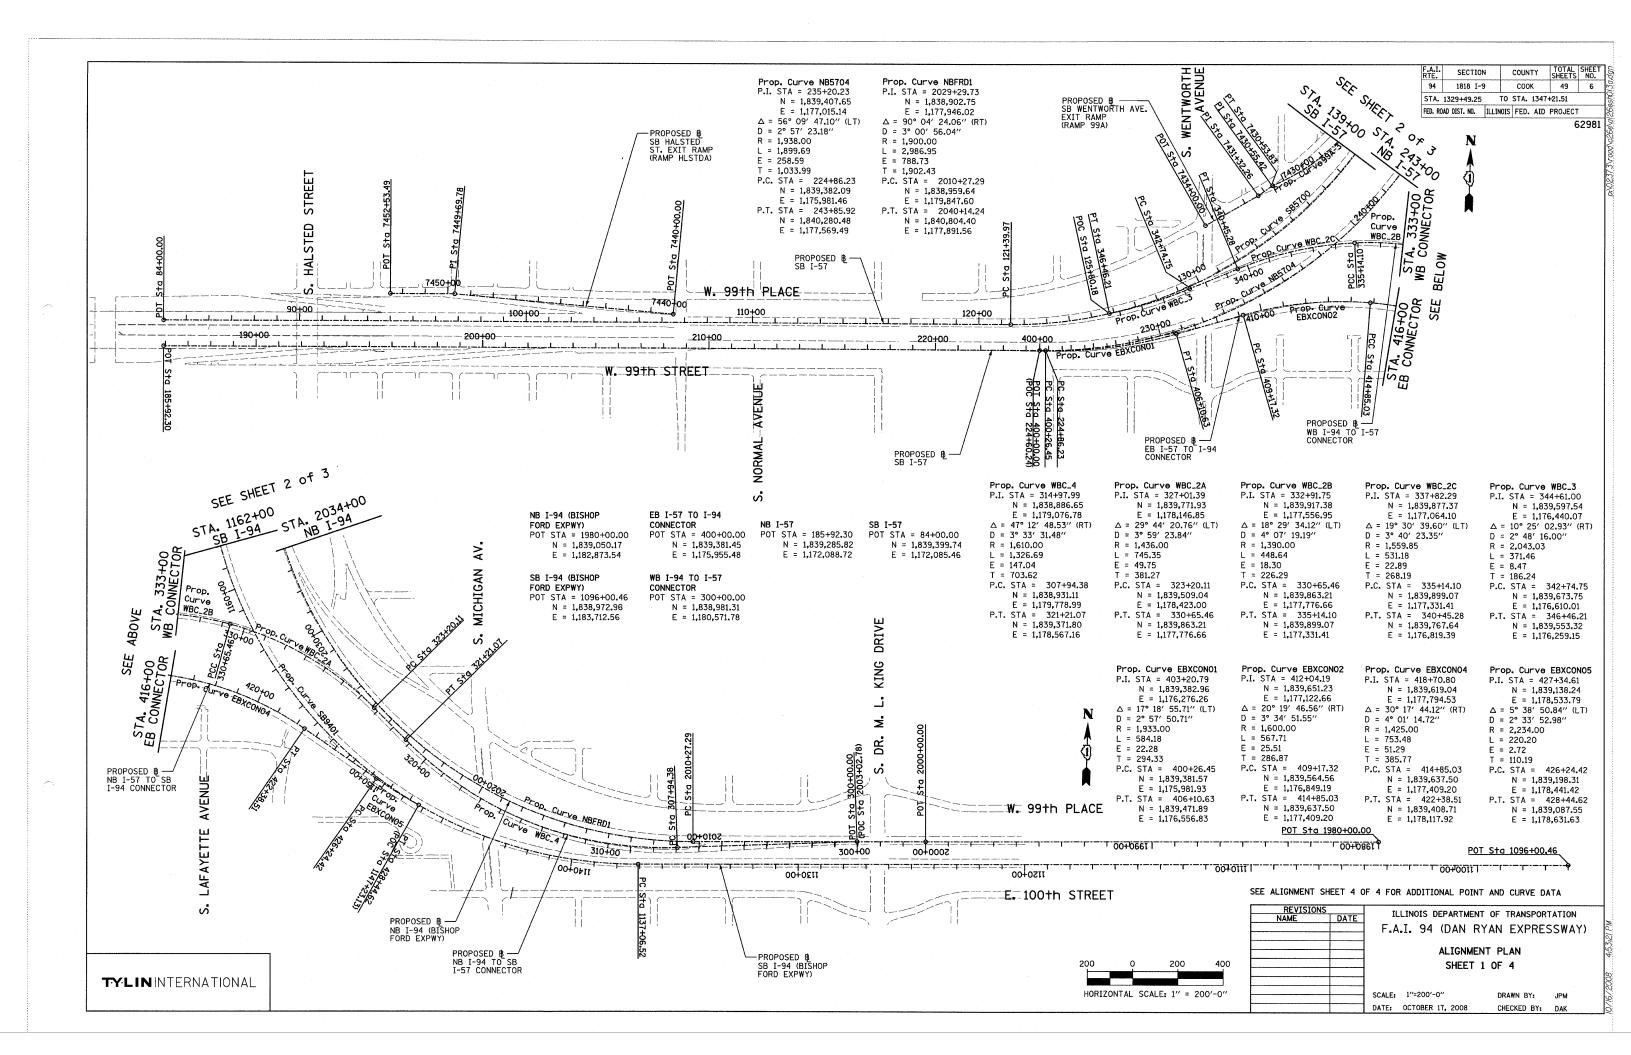

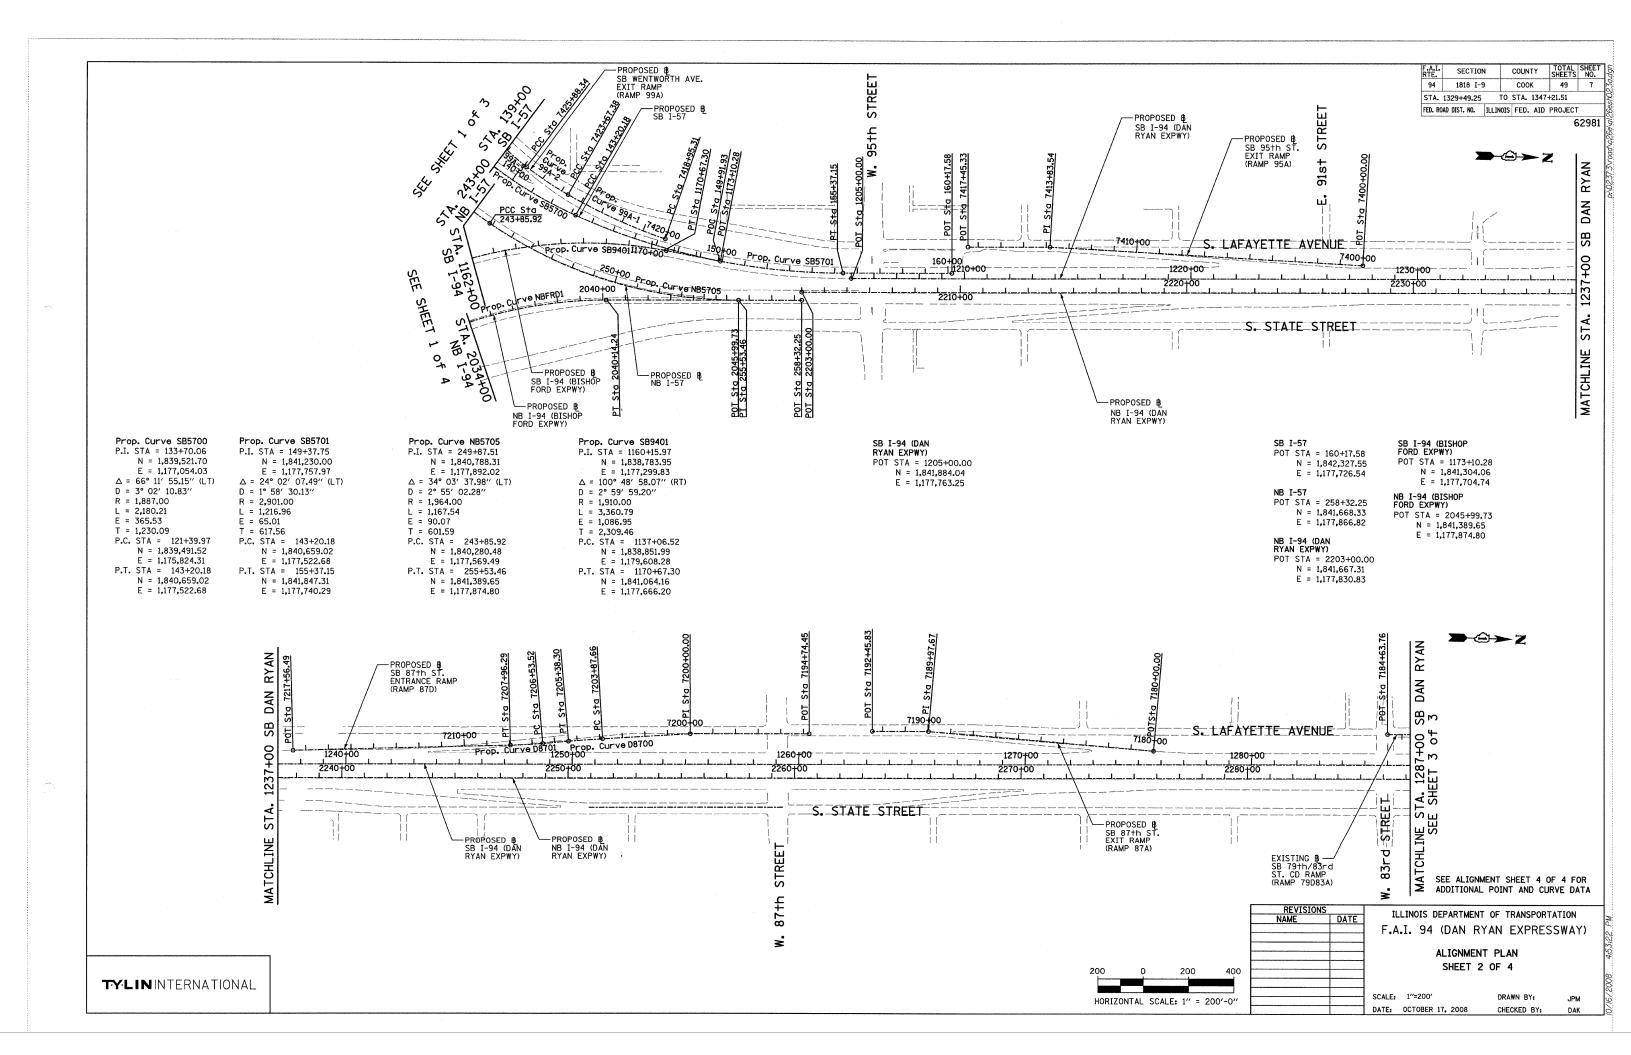

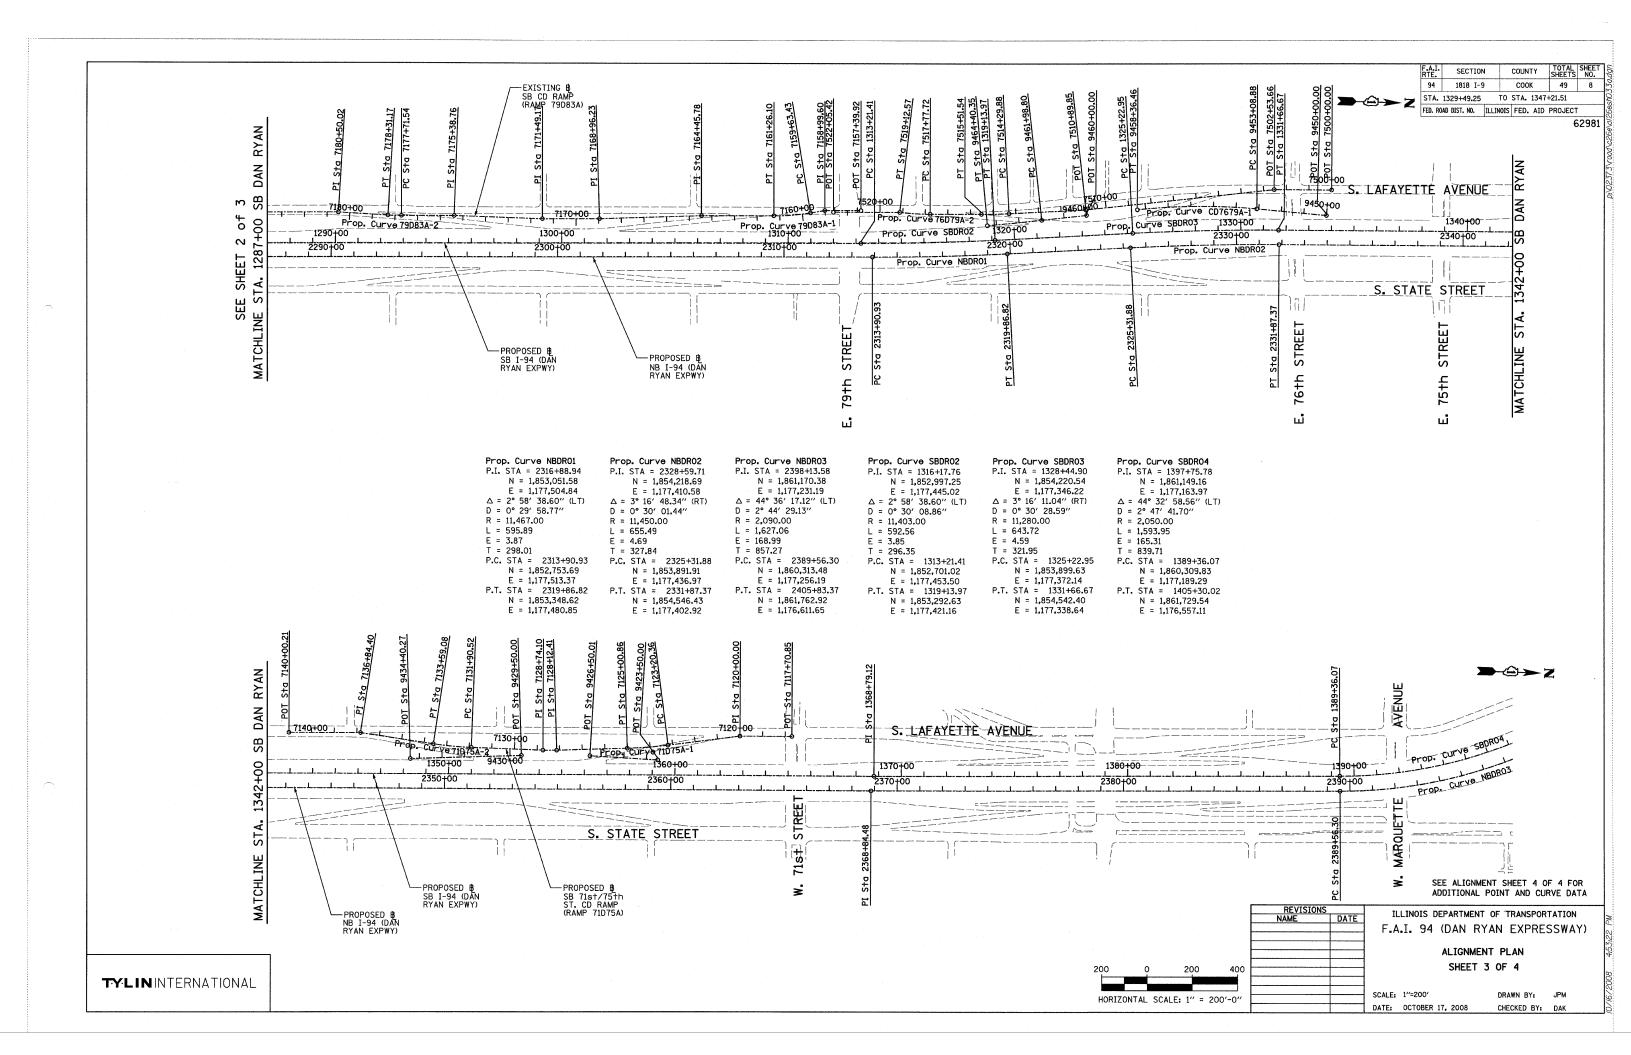

E = 1,177,124.75

POT = 7140+00.21N = 1,855,665.56E = 1,177,132.18

SB HALSTED ST. EXIT RAMP (RAMP HLSTDA) POT STA = 7440+00.00 N = 1,839,490.94E = 1,174,333.70P.I. STA = 7449+69.78 N = 1.839.551.73E = 1.173.365.83POT STA = 7452+53.49 N = 1,839,544.76 E = 1.173.082.20SB WENTWORTH AVE. EXIT RAMP (RAMP 99A) Prop. Curve 99A-1 Prop. Curve 99A-2 Prop. Curve 99A-3 P.I. STA = 7421+32.05P.I. STA = 7424+78.02P.I. STA = 7428+26.42N = 1.840.832.05N = 1.840.525.59N = 1.840.241.82POT STA = 7430+55.42 E = 1,177,544.75 E = 1,177,381.20E = 1.177.178.53 N = 1,840,141.17 $\Delta = 10^{\circ} 49' 08.53'' (RT)$ $\Delta = 7^{\circ} 26' 49.68'' (RT)$ $\Delta = 29^{\circ} 38' 02.27'' (RT)$ E = 1,176,961.02 D = 2° 17′ 30.59″ $D = 3^{\circ} 22' 13.22''$ D = 6° 21′ 58.31″ POT STA = 7431+32.26 R = 2.500.00R = 1.700.00R = 900.00N = 1.840.094.48L = 472.07L = 220.961 = 465.49E = 1,176,899.99 POT STA = 7434+00.00 E = 11.18E = 3.60F = 30.96T = 236.74T = 110.64T = 238.08N = 1,839,955.89P.C. STA = 7418+95.31 P.C. STA = 7423+67.38 P.C. STA = 7425+88.34 E = 1,176,670.92N = 1,841,058.12N = 1,840,623.20 N = 1,840,435.56E = 1.177.615.03E = 1,177,433.29E = 1,177,316.90P.T. STA = 7423+67.38 P.T. STA = 7425+88.34 P.T. STA = 7430+53.83 N = 1.840.141.84 N = 1,840,623.20N = 1,840,435.56E = 1,177,433.29E = 1,177,316.90E = 1,176,962.46 SB 95th ST. EXIT RAMP (RAMP 95A) POT STA = 7400+00.00 N = 1,844,139.73E = 1,177,638.63P.I. STA = 7413+83.54 N = 1.842.756.77E = 1,177,598.60 POT STA = 7417+45.33 N = 1.842.395.13E = 1,177,608.95Prop. Curve D8700 SB 87th ST. ENTRANCE RAMP Prop. Curve D8701 P.I. STA = 7204+62.99 P.I. STA = 7207+24.93(RAMP 87D) POT STA = 7194+74.45 N = 1.846.437.54N = 1,846,177.29E = 1.177,554.49 E = 1.177.524.69 N = 1,847,424.06 $\Delta = 1^{\circ} 30' 03.72'' (LT)$ $\Delta = 3^{\circ} 27' 36.43'' (RT)$ E = 1,177,468.58D = 0° 59′ 47.21″ D = 2° 25′ 25.25″ P.I. STA = 7200+00.00 R = 5,750.00R = 2,364.00N = 1.846.898.74L = 150.64L = 142.76E = 1,177,484.09 F = 0.49F = 1.08POT STA = 7217+56,49 T = 75.32T = 71.40

P.C. STA = 7206+53.52

P.T. STA = 7207+96.29

N = 1,846,248.23

E = 1,177,546.37

N = 1.846.105.99

E = 1.177.558.32

REVISIONS NAME

ILLINOIS DEPARTMENT OF TRANSPORTATION F.A.I. 94 (DAN RYAN EXPRESSWAY)

> ALIGNMENT PLAN SHEET 4 OF 4

SCALE: NO SCALE DATE: OCTOBER 17, 2008

TYLININTERNATIONAL

N = 1,845,147.17

E = 1,177,609.78

SB 87th ST. EXIT RAMP (RAMP 87A)

POT STA = 7192+45.83

N = 1,847,702.29

E = 1.177.449.63

N = 1,848,946.30E = 1,177,501.00P.I. STA = 7189+97.67N = 1.847.950.35E = 1,177,442.53

P.C. STA = 7203+87.66

P.T. STA = 7205+38.30

N = 1,846,512.58

E = 1,177,518.09

N = 1,846,362.71 E = 1,177,533.26

DRAWN BY: JPA CHECKED BY: JPM

TOTAL SHEET NO.

49 9

62981

POT STA = 9460+00.00 N = 1,853,693.06 E = 1,177,298.94Prop. Curve CD7679B-1

N = 1.853.376.57

SECTION

1818 I-9

STA. 1329+49.25 TO STA. 1347+21.51

FED. ROAD DIST. NO. ILLINOIS FED. AID PROJECT

COUNTY


COOK

E = 1,177,343,27 $\Delta = 1^{\circ} 13' 13.54'' (RT)$ D = 0° 30′ 18.91″ R = 11,340.00L = 241.55


T = 120.78P.C. STA = 9461+98.80 N = 1,853,496.18 E = 1,177,326.52P.T. STA = 9464+40.35

N = 1.853.256.63E = 1,177,357.48

N = 1,856,204.7281 E = 1,177,233,1786

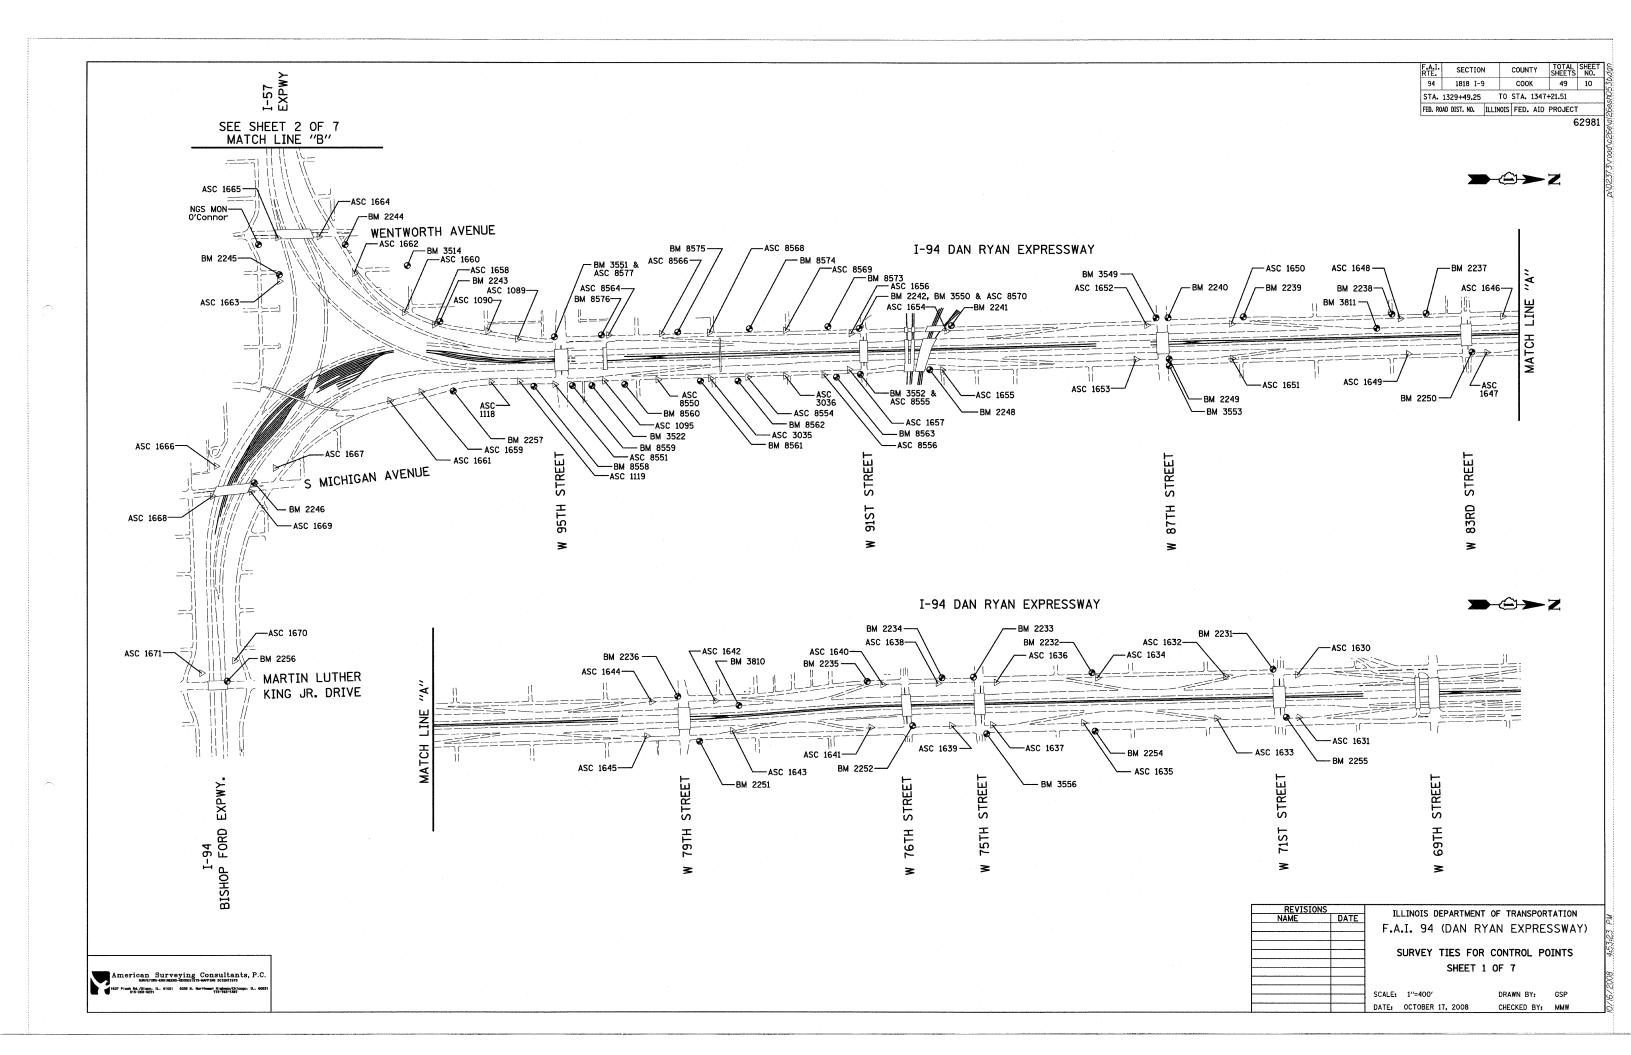

F.A.I. RTE.	SECTION	V	COUN	TY	TOTAL	SHEET NO.
94	1818 I-9	9	C00	K	49	11
STA.	1329+49.25	TO	STA.	1347-	+21.51	
FED. R	OAD DIST. NO.	ILLINOIS	FED.	AID	PROJECT	۲,
					(2981

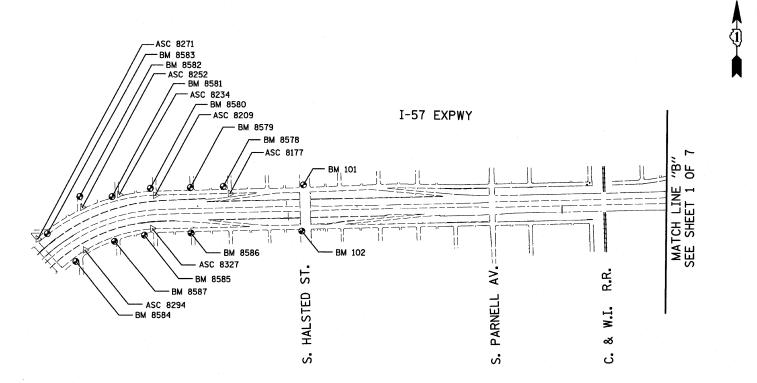

REVISIONS
NAME DATE

F.A.I. 94 (DAN RYAN EXPRESSWAY)

SURVEY TIES FOR CONTROL POINTS

SURVEY TIES FOR CONTROL POINTS
SHEET 2 OF 7


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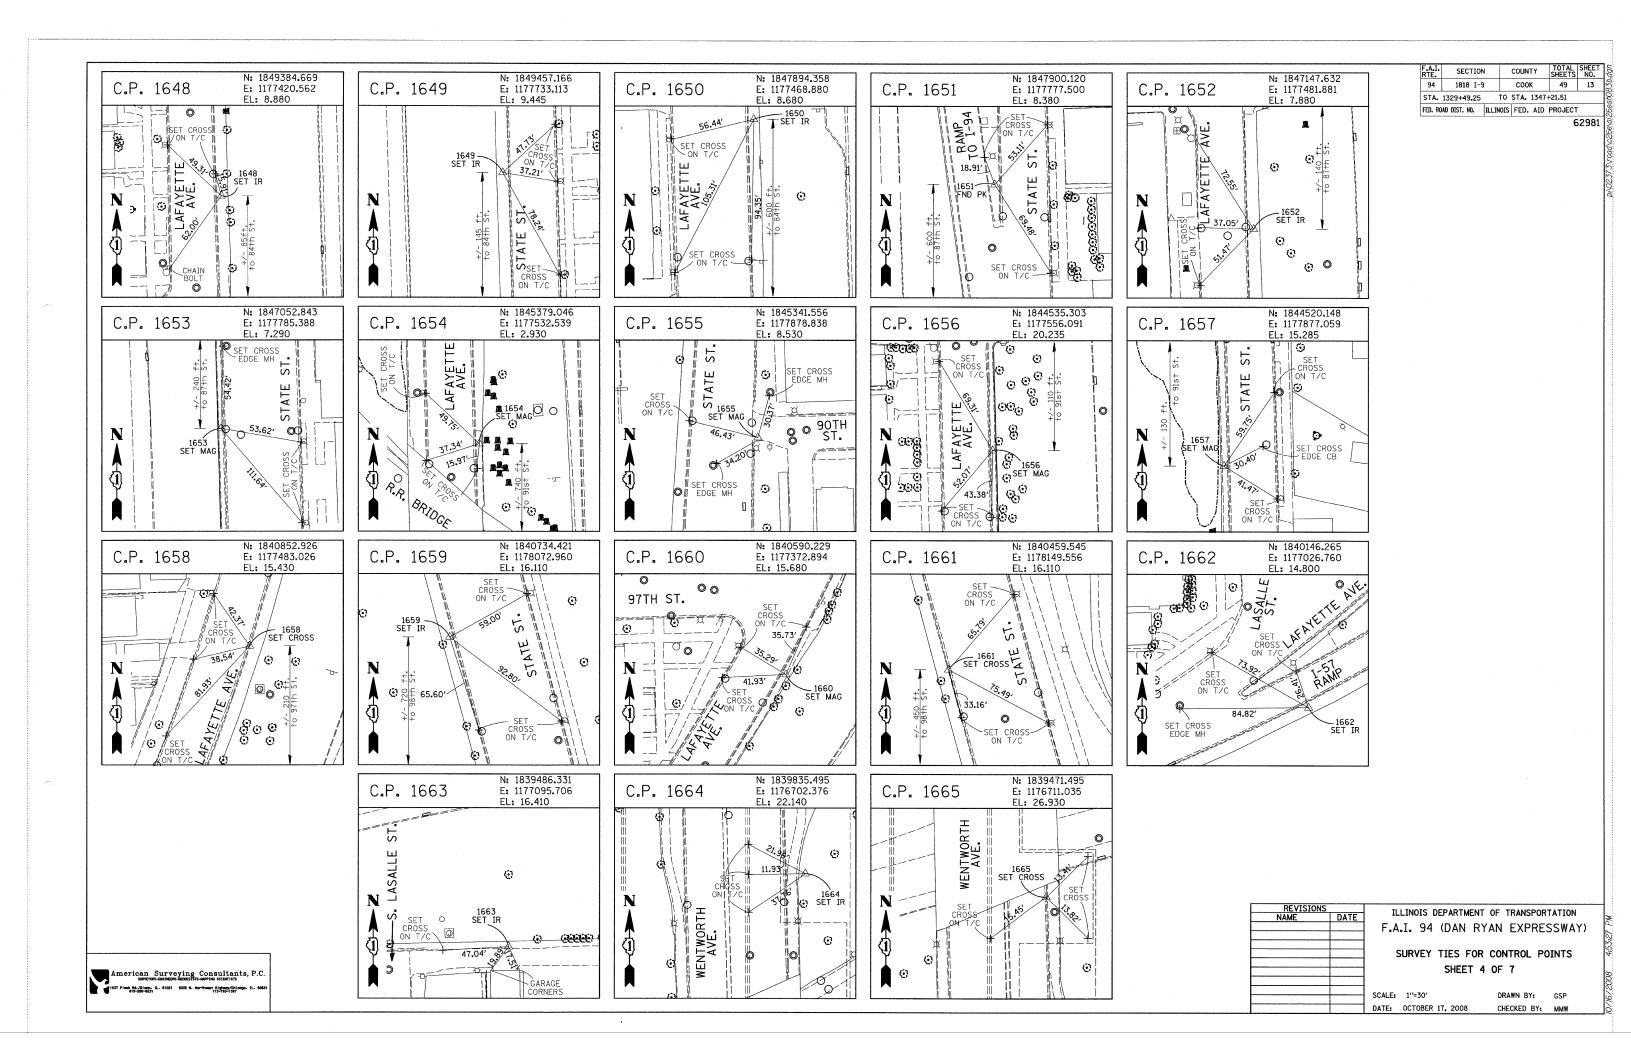
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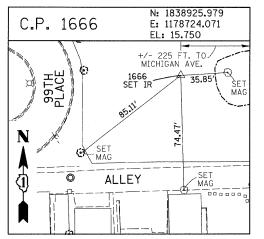
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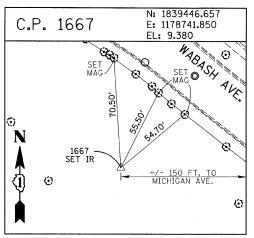
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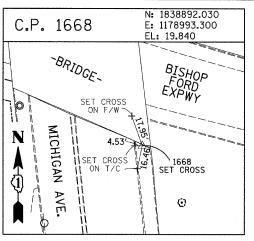
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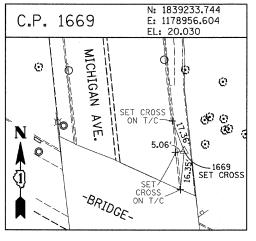












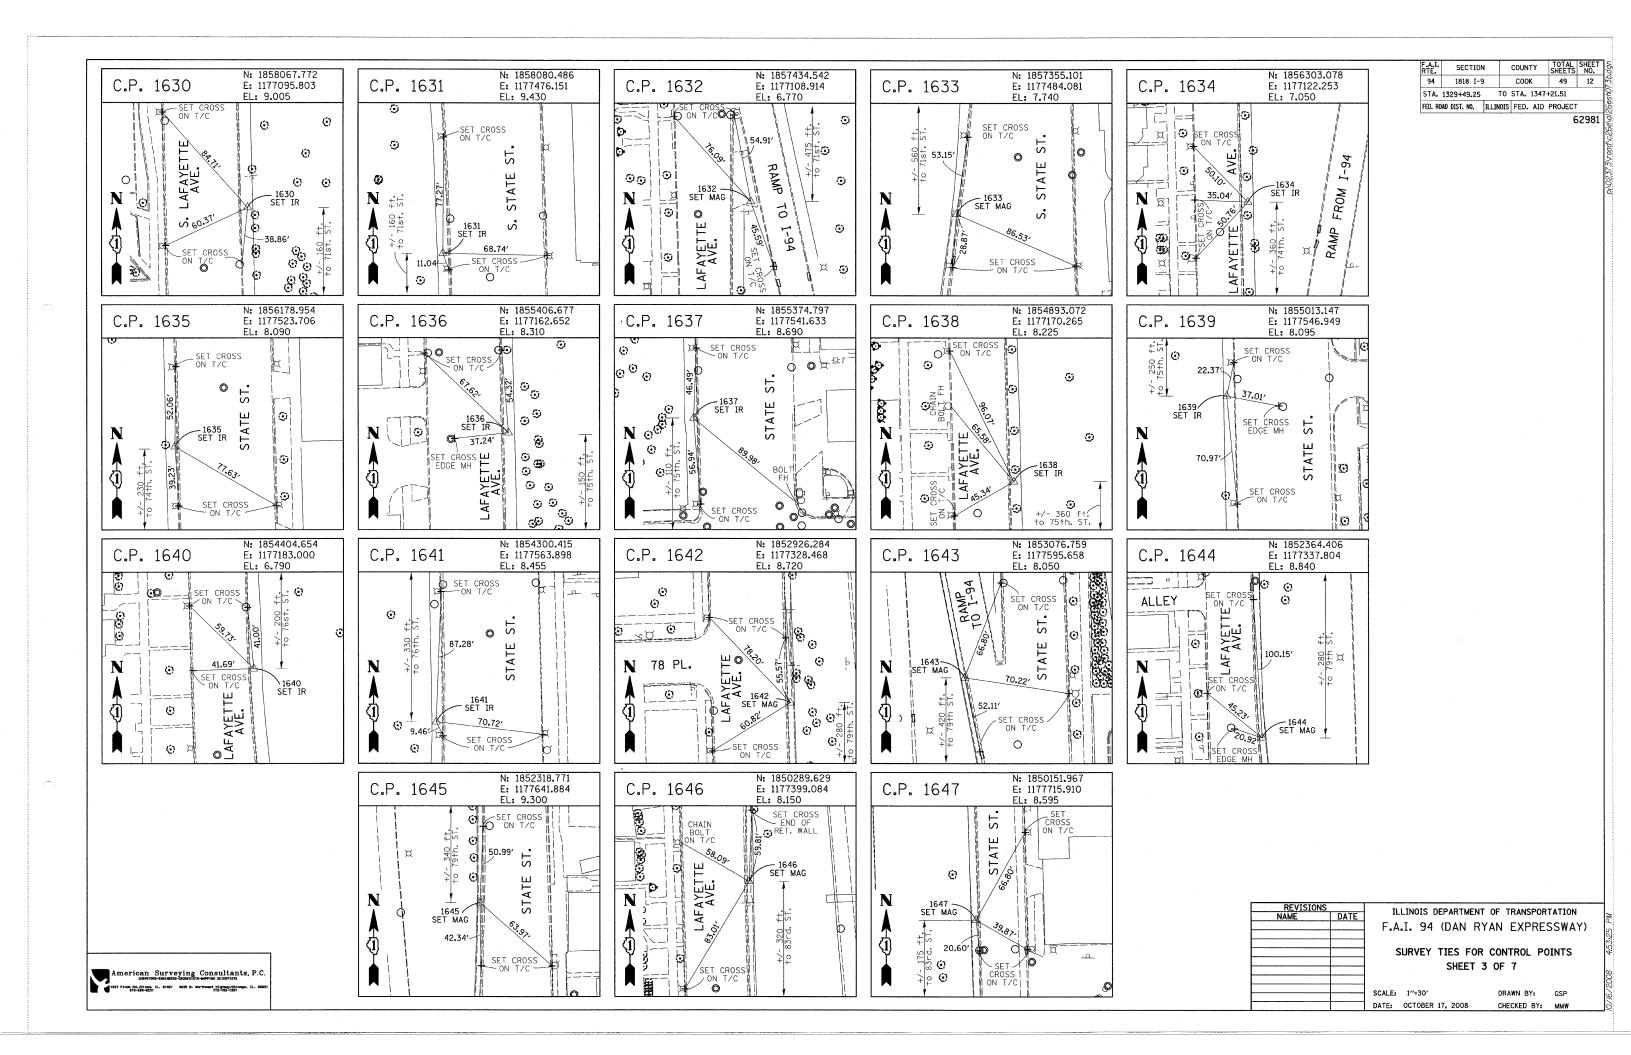

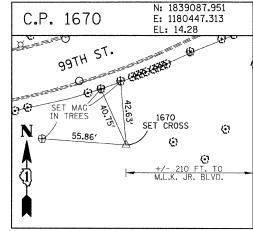

F.A.I. RTE.	SECTION	ı	COUN	TY	TOTAL	SHEET NO.
94	1818 I-9		C00	K	49	14
STA.	1329+49.25	ТО	STA.	1347	+21.51	
FED. RO	AD DIST. NO.	ILLINOIS	FED.	AID	PROJECT	•

62981

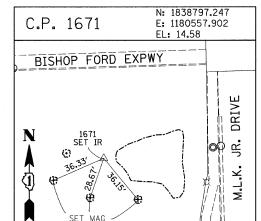

PROJECT BENCHMARKS

BM 2231 ELEVATION= 10.24 FEET SET CROSS ON CHAIN BOLT OF FIRE HYDRANT ON THE SOUTHWEST CORNER OF 71ST STREET AND LAFAYETTE AVENUE.

BM 2232 ELEVATION= 8.46 FEET SET CROSS ON CHAIN BOLT OF FIRST FIRE HYDRANT SOUTH OF 73RD STREET ON THE WEST SIDE OF LAFAYETTE AVENUE, APPROXIMATELY 330 FEET SOUTH OF 73RD STREET.

BM 2233 ELEVATION= 9.90 FEET SET CROSS ON NORTHWEST BOLT OF FIRE HYDRANT ON THE NORTHWEST CORNER OF 75TH STREET AND LAFAYETTE AVENUE.

BM 2234 ELEVATION= 9.56 FEET SET CROSS ON CHAIN BOLT OF FIRST FIRE HYDRANT SOUTH OF 75TH STREET ON THE WEST SIDE OF LAFAYETTE AVENUE. APPROXIMATELY 320 FEET SOUTH OF 75TH STREET.

BM 2235 ELEVATION= 7.50 FEET SET CROSS ON CHAIN BOLT OF FIRST FIRE HYDRANT SOUTH OF 76TH STREET ON THE WEST SIDE OF LAFAYETTE. APPROXIMATELY 330 FEET SOUTH OF 76TH STREET.

BM 2236 ELEVATION= 10.41 FEET SET CROSS ON WEST BOLT OF FIRE HYDRANT ON THE SOUTHWEST CORNER OF 79TH STREET AND LAFAYETTE AVENUE.

BM 2237 ELEVATION= 9.20 FEET
SET CROSS ON CHAIN BOLT OF FIRST FIRE HYDRANT NORTH OF 83RD STREET
ON THE WEST SIDE OF LAFAYETTE AVENUE. APPROXIMATELY 350 FEET NORTH
OF 83RD STREET.

BM 2238 ELEVATION= 10.04 FEET SET CROSS ON CHAIN BOLT OF FIRE HYDRANT OF THE NORTHWEST CORNER OF 4TH STREET AND LAFAYETTE AVENUE.

BM 2239 ELEVATION= 9.59 FEET
SET CROSS ON CHAIN BOLT OF SECOND FIRE HYDRANT NORTH OF 87TH STREET
ON THE WEST SIDE OF LAFAYETTE AVENUE. APPROXIMATELY 720 FEET OF
NORTH OF 87TH STREET.

BM 2240 ELEVATION= 9.49 FEET SET CROSS ON THE NORTHWEST BOLT OF FIRE HYDRANT ON THE SOUTHWEST CORNER OF 78TH STREET AND LAFAYETTE AVENUE.

BM 2241 ELEVATION= 3.63 FEET SUARE CUT ON TOP OF CURB NEXT TO LIGHT POLE ON THE NORTHWEST CORNER OF LAFAYETTE AVENUE AND RAILROAD BRIDGE. APPROXIMATELY 770 FEET NORTH OF 91ST STREET.

BM 2242 ELEVATION= 22.82 FEET SET CROSS ON CHAIN BOLT OF FIRE HYDRANT ON THE SOUTHWEST CORNER OF 91ST STREET AND LAFAYETTE AVENUE.

BM 2243 ELEVATION= 15.68 FEET SET SQUARE CUT ON THE TOP OF CURB NEXT TO THIRD LIGHT POLE NORTH OF 97TH STREET ON THE WEST SIDE OF LAFAYETTE AVENUE. APPROXIMATELY 260 FEET NORTH OF 97TH STREET.

BM 2244 ELEVATION= 15.94 FEET
SET SQUARE CUT ON TOP OF CURB NEXT TO LIGHT POLE ON THE NORTH SIDE
OF 98TH STREET. APPROXIMATELY 120 FEET EAST OF WENTWORTH AVENUE.

BM 2245 ELEVATION= 16.35 FEET SET SQUARE CUT ON THE EAST END OF CURB AT THE NORTHEAST CORNER OF FIRST ALLEY NORTH OF 99TH STREET, APPROXIMATELY 35 FEET EAST OF LASALLE STREET.

BM 2246 ELEVATION= 20.00 FEET SUARE CUT WITH CROSS ON TOP OF ABUTMENT WALL ON THE NORTHWEST CORNER OF STATE STREET BRIDGE OVER THE BISHOP FORD EXPRESSWAY. APPROXIMATELY 20 FEET NORTH OF THE NORTH EDGE OF THE BRIDGE.

BM 2248 ELEVATION= 9.77 FEET
SET CROSS ON CHAIN BOLT OF FIRST FIRE HYDRANT NORTH OF RAILROAD BRIDGE
ON THE EAST SIDE OF STATE STREET. APPROXIMATELY 110 FEET SOUTH OF
90TH STREET.

BM 2249 ELEVATION= 9.67 FEET SET CROSS ON CHAIN BOLT OF FIRE HYDRANT ON THE NORTHWEST CORNER OF 87TH AND STATE STREET.

BM 2250 ELEVATION= 10.03 FEET SET CROSS ON CHAIN BOLT OF FIRE HYDRANT ON THE NORTHWEST CORNER OF 83RD ST. AND STATE STREET.

BM 2251 ELEVATION= 10.95 FEET FOUND CROSS ON EAST BOLT OF FIRE HYDRANT ON THE EAST SIDE OF STATE STREET. APPROXIMATELY 135 FEET NORTH OF 79TH STREET.

BM 2252 ELEVATION= 10.02 FEET SET CROSS ON WEST BOLT OF FIRE HYDRANT ON THE NORTHWEST CORNER OF STATE STREET AND 76TH STREET.

BM 2254 ELEVATION= 9.17 FEET SET CROSS ON CHAIN BOLT OF FIRST FIRE HYDRANT SOUTH OF 73RD STREET ON THE EAST SIDE OF STATE STREET. APPROXIMATELY 330 FEET SOUTH OF 73RD STREET.

BM 2255 ELEVATION= 11.25 FEET SET CROSS ON CHAIN BOLT OF FIRE HYDRANT ON THE NORTHWEST CORNER OF 71ST STREET AND STATE STREET.

BM 2256 ELEVATION= 16.36 FEET SET SQUARE CUT ON TOP OF ABUTMENT WALL ON THE NORTHWEST CORNER OF MARTIN LUTHER KING DRIVE BRIDGE OVER THE BISHOP FORD EXPRESSWAY. APPROXIMATELY 1 FOOT NORTH OF THE NORTH END OF THE BRIDGE.


BM 2257 ELEVATION= 18.25 FEET SET CROSS ON NORTHEAST BOLT OF LIGHT POLE BASE ON THE EAST SIDE OF STATE STREET. APPROXIMATELY 970 FEET SOUTH OF 95TH STREET.


BM 2258 ELEVATION= 10.53 FEET SET CROSS ON NORTHWEST BOLT OF LIGHT BASE ON NORTHWEST CORNER OF 71ST STREET AND LAFAYETTE AVENUE.


REVISIONS NAME DAT	ILLINOIS DEPARTMENT OF TRANSPORTATION F.A.I. 94 (DAN RYAN EXPRESSWAY) SURVEY TIES FOR CONTROL POINTS
	SHEET 5 OF 7
	SCALE: 1"=30" DRAWN BY: GSP


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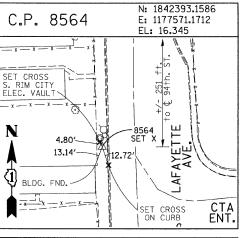
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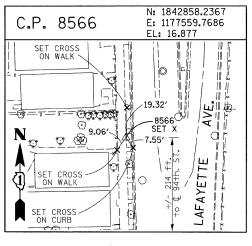




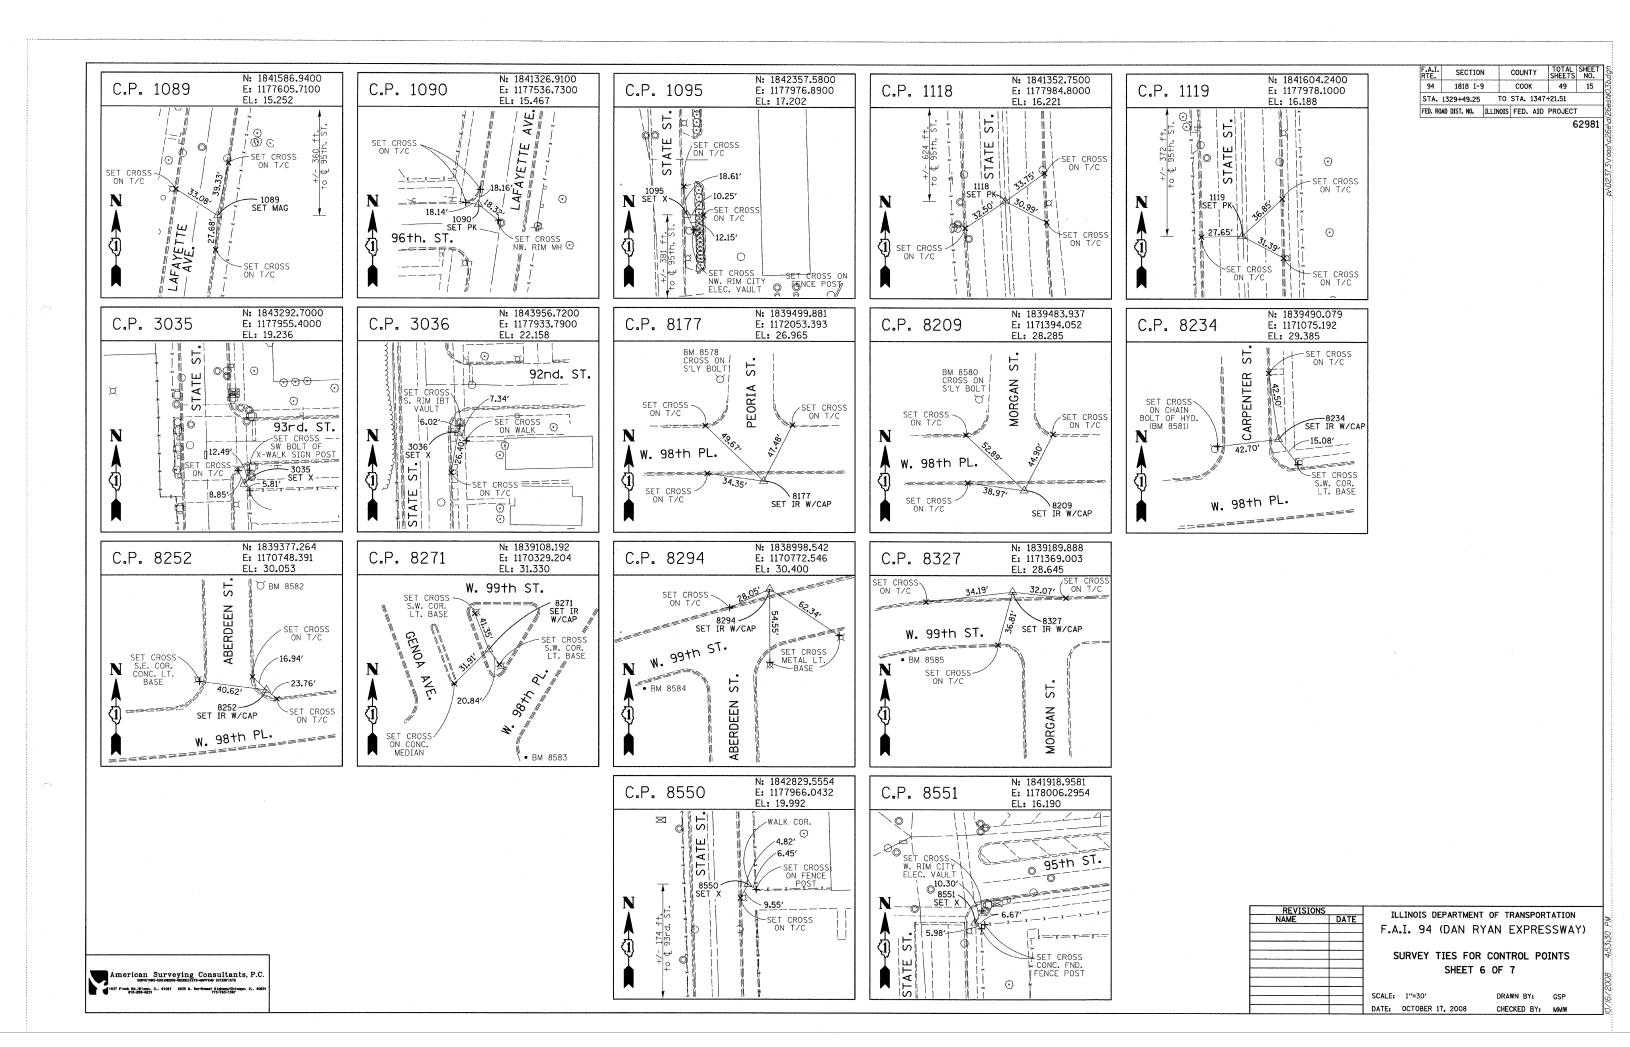

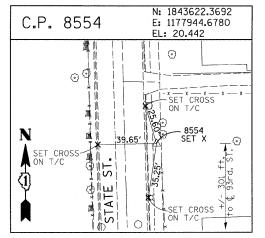


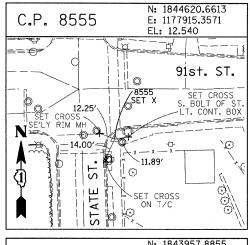


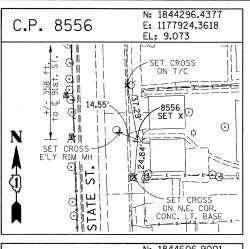





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PROJECT BENCHMARKS

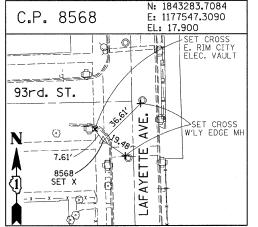BM 101 ELEVATION= 24.89 FEET SET SQUARE CUT ON SOUTHERLY CURB OF WEST 98TH PLACE, APPROXIMATELY 70 FEET EAST OF THE CENTERLINE OF GREEN STREET.

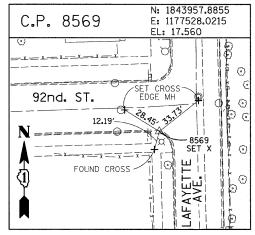BM 102 ELEVATION= 27.36 FEET
SET CROSS ON SOUTHERLY FLANGE BOLT OF FIRE HYDRANT AT THE SOUTHWEST
CORNER OF WEST 99TH STREET AND GREEN STREET.

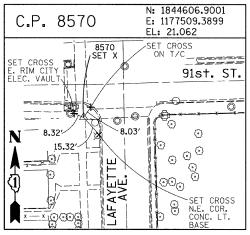BM 8558 ELEVATION= 17.73 FEET SET SQUARE CUT ON SQUTHEAST CORNER OF FOURTH LIGHT BASE SOUTH OF 95TH STREET, ON THE EAST SIDE OF STATE STREET.

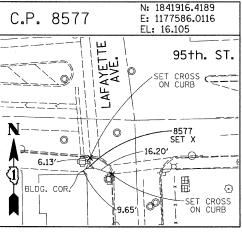BM 8559 ELEVATION= 17.10 FEET
SET SQUARE CUT ON SOUTHWEST CORNER OF CONCRETE SIGN BASE AT THE
NORTHWEST CORNER OF THE MOBIL GAS STATION PROPERTY AT THE NORTHEAST
CORNER OF 95TH STREET AND STATE STREET.

BM 8560 ELEVATION= 17.50 FEET SET SOUARE CUT ON SOUTHEAST CORNER OF CONCRETE BUS SLAB ON THE EAST SIDE OF STATE STREET. APPROXIMATELY 50 FEET SOUTH OF THE CENTERLINE OF 94TH STREET.

BM 8561 ELEVATION= 19.77 FEET SET CROSS ON SOUTHEASTERLY FLANGE BOLT OF FIRST FIRE HYDRANT SOUTH OF 93RD STREET, ON THE EAST SIDE OF STATE STREET.

BM 8562 ELEVATION= 22.29 FEET SET CROSS ON SOUTHEASTERLY FLANGE BOLT OF FIRST FIRE HYDRANT NORTH OF 93RD STREET, ON THE EAST SIDE OF STATE STREET.

BM 8563 ELEVATION= 20.47 FEET
SET CROSS ON SOUTHEASTERLY FLANGE BOLT OF FIRST FIRE HYDRANT SOUTH OF
91ST STREET, ON THE EAST SIDE OF STATE STREET.

BM 8573 ELEVATION= 19.89 FEET
SET SQUARE CUT ON EAST SIDE OF SIDEWALK OPPOSITE TO THE SECOND FIRE HYDRANT SOUTH OF 91ST STREET, ON THE WEST SIDE OF LAFAYETTE AVENUE.

BM 8574 ELEVATION= 18.90 FEET
SET CROSS ON THE WESTERLY FLANGE BOLT OF FIRE HYDRANT APPROXIMATELY
AT 9224 S. LAFAYETTE AVENUE, ON THE WEST SIDE OF LAFAYETTE AVENUE.

BM 8575 ELEVATION= 17.77 FEET
SET CROSS ON THE WESTERLY FLANGE BOLT OF FIRE HYDRANT APPROXIMATELY
AT 9326 S. LAFAYETTE AVENUE, ON THE WEST SIDE OF LAFAYETTE AVENUE.

BM 8576 ELEVATION= 17.43 FEET
SET CROSS ON THE WESTERLY FLANGE BOLT OF FIRE HYDRANT AT THE VACANT
LOT BETWEEN 9416 AND 9422 S. LAFAYETTE AVENUE, ON THE WEST SIDE OF
LAFAYETTE AVENUE.

BM 8578 ELEVATION= 27.92 FEET
SET CROSS ON SOUTHERLY FLANGE BOLT OF FIRE HYDRANT AT THE NORTHWEST
CORNER OF WEST 98TH PLACE AND PEORIA STREET.

BM 8579 ELEVATION= 28.59 FEET SET CROSS ON SOUTHERLY FLANGE BOLT OF FIRE HYDRANT AT THE NORTHWEST CORNER OF WEST 98TH PLACE AND SANGAMON STREET.

BM 8580 ELEVATION= 29.24 FEET SET CROSS ON SOUTHERLY FLANGE BOLT OF FIRE HYDRANT AT THE NORTHWEST CORNER OF WEST 98TH PLACE AND MORGAN STREET.

BM 8581 ELEVATION= 30.82 FEET SET CROSS ON CHAIN BOLT OF FIRE HYDRANT ON THE NORTHWEST CORNER OF CARPENTER STREET AND WEST 98TH PLACE.

BM 8582 ELEVATION= 30.69 FEET SET CROSS ON CHAIN BOLT OF FIRST FIRE HYDRANT NORTH OF WEST 98TH PLACE, ON THE EAST SIDE OF ABERDEEN STREET.

BM 8583 ELEVATION= 33.14 FEET SET SQUARE CUT ON CONCRETE BRIDGE WALL AT THE SOUTHEASTERLY CORNER OF GENOA AVENUE AND 99TH STREET.

BM 8584 ELEVATION= 32.36 FEET SET CROSS ON CHAIN BOLT OF FIRST FIRE HYDRANT WEST OF ABERDEEN STREET, ON THE SOUTHERLY SIDE OF 99TH STREET.

BM 8585 ELEVATION= 30.28 FEET SET CROSS ON SOUTHERLY FLANGE BOLT OF FIRST FIRE HYDRANT WEST OF MORGAN STREET, ON THE SOUTH SIDE OF 99TH STREET.

BM 8586 ELEVATION= 28.75 FEET SET CROSS ON NORTHERLY FLANGE BOLT OF FIRE HYDRANT AT THE SOUTHWEST CORNER OF 99TH STREET AND SANGAMON STREET.

BM 8587 ELEVATION= 31.19 FEET
SET CROSS ON SOUTHERLY FLANCE BOLT OF FIRE HYDRANT AT THE SOUTHWEST
CORNER OF 99TH STREET AND CARPENTER STREET.

BM 3514 ELEVATION= 17.56 FEET SET CROSS ON CHAIN BOLT OF HYDRANT AT SOUTHTHWEST INTERSECTION OF LASALLE ST. AND 97TH ST.

BM 3522 ELEVATION= 18.06 FEET SET CROSS ON SOUTH SOUTHEAST FLANGE BOLT OF HYDRANT ± HALFWAY BETWEEN NORTH AND SOUTH ENTRANCE TO CITGO, EAST SIDE OF STATE ST. AND NORTH OF 95TH ST.

BM 3549 ELEVATION= 9.49 FEET SET CROSS WESTERLY FLANGE BOLT OF HYDRANT AT SOUTHWEST INTERSECTION OF 87TH ST. AND LAFAYETTE AVE.

BM 3550 ELEVATION= 22.88 FEET SET CROSS WESTERLY FLANGE BOLT OF HYDRANT AT SOUTHWEST INTERSECTION OF 91ST ST. AND LAFAYETTE AVE.

BM 3551 ELEVATION= 17.50 FEET SET CROSS NORTHERLY FLANGE BOLT OF HYDRANT AT SOUTHWEST INTERSECTION OF 95TH ST. AND LAFAYETTE AVE.

BM 3552 ELEVATION= 14.81 FEET SET CROSS NORTHEAST BOLT OF TRAFFIC SIGNAL/LIGHT BASE AT SOUTHEAST INTERSECTION OF 91ST ST. AND STATE ST.

BM 3553 ELEVATION= 8.47 FEET SET CROSS NORTHWEST BOLT OF TRAFFIC SIGNAL/LIGHT BASE AT NORTHEAST INTERSECTION OF 87TH ST. AND STATE ST.

BM 3556 ELEVATION= 9.06 FEET SET CROSS EASTERLY FLANGE BOLT OF HYDRANT AT NORTHEAST CORNER OF 75TH ST. AND STATE ST.

BM 3558 ELEVATION= 18.15 FEET SET CROSS SOUTHWESTERLY FLANGE BOLT OF HYDRANT AT NORTHWEST INTERSECTION OF NORMAL ST. AND 98TH PLACE.

BM 3810 ELEVATION= 0.29 FEET
CUT SQUARE ON SOUTHERLY CORNER OF METAL BASE FOR OVERHEAD
SIGN, ON THE WESTERLY SIDE OF SOUTHBOUND DAN RYAN, OPPOSITE
OF WEST 77TH PLACE, APPROXIMATELY 1000 FEET NORTH OF 79TH
STREET BRIDGE.

BM 3811 ELEVATION= 1.95 FEET CUT SQUARE ON SOUTHEASTERLY CORNER OF METAL BASE FOR OVERHEAD SIGN, ON THE WESTERLY SIDE OF SOUTHBOUND DAN RYAN APPROXIMATELY 840 FEET SOUTHERLY OF 83RD STREET.

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		F.A.I.	94	(DAN	RYAN	EXPR	ESSWAY))
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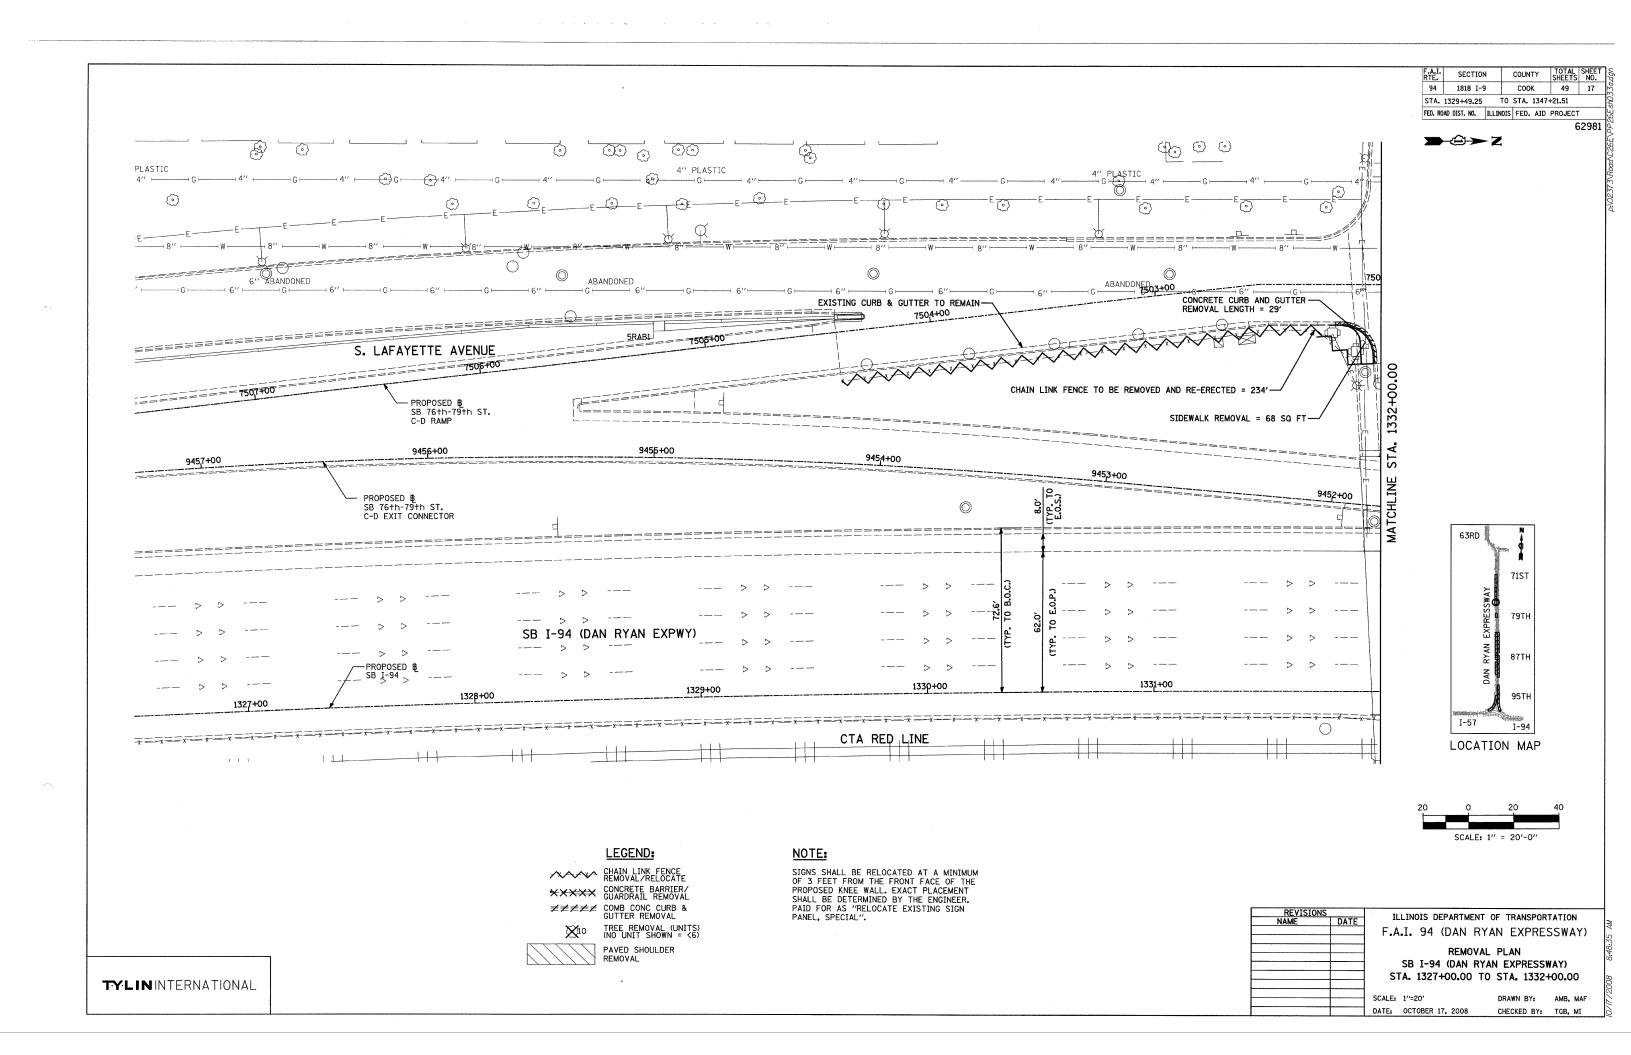
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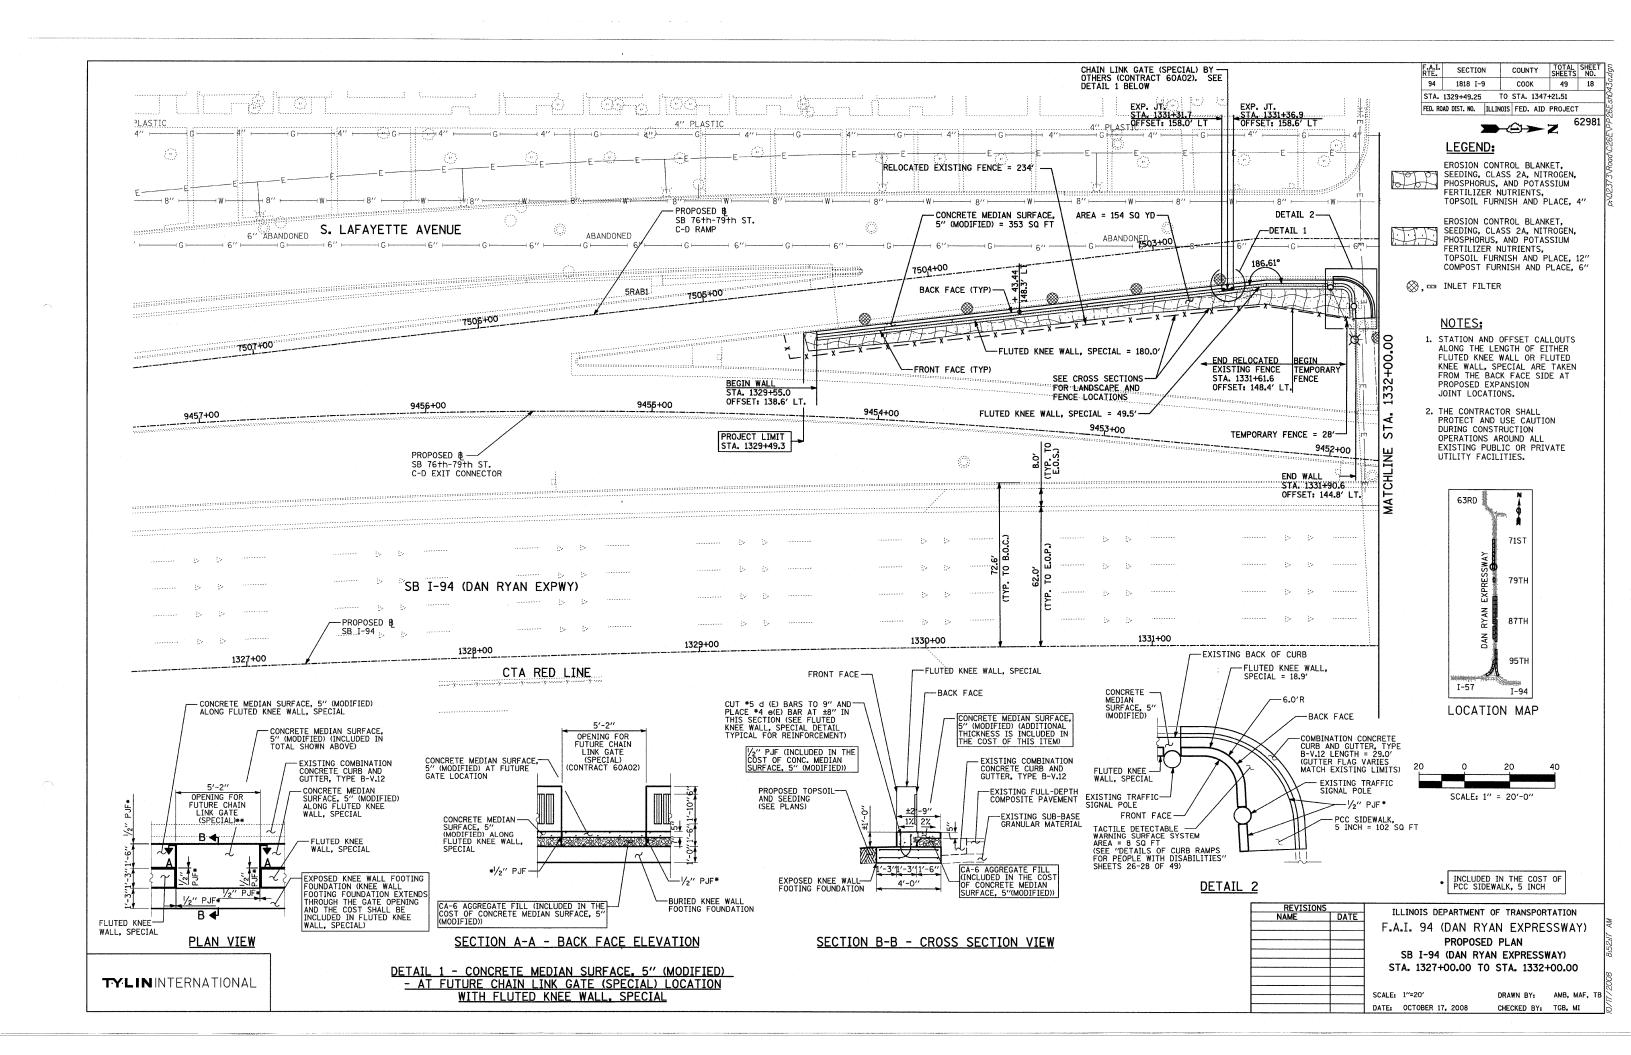
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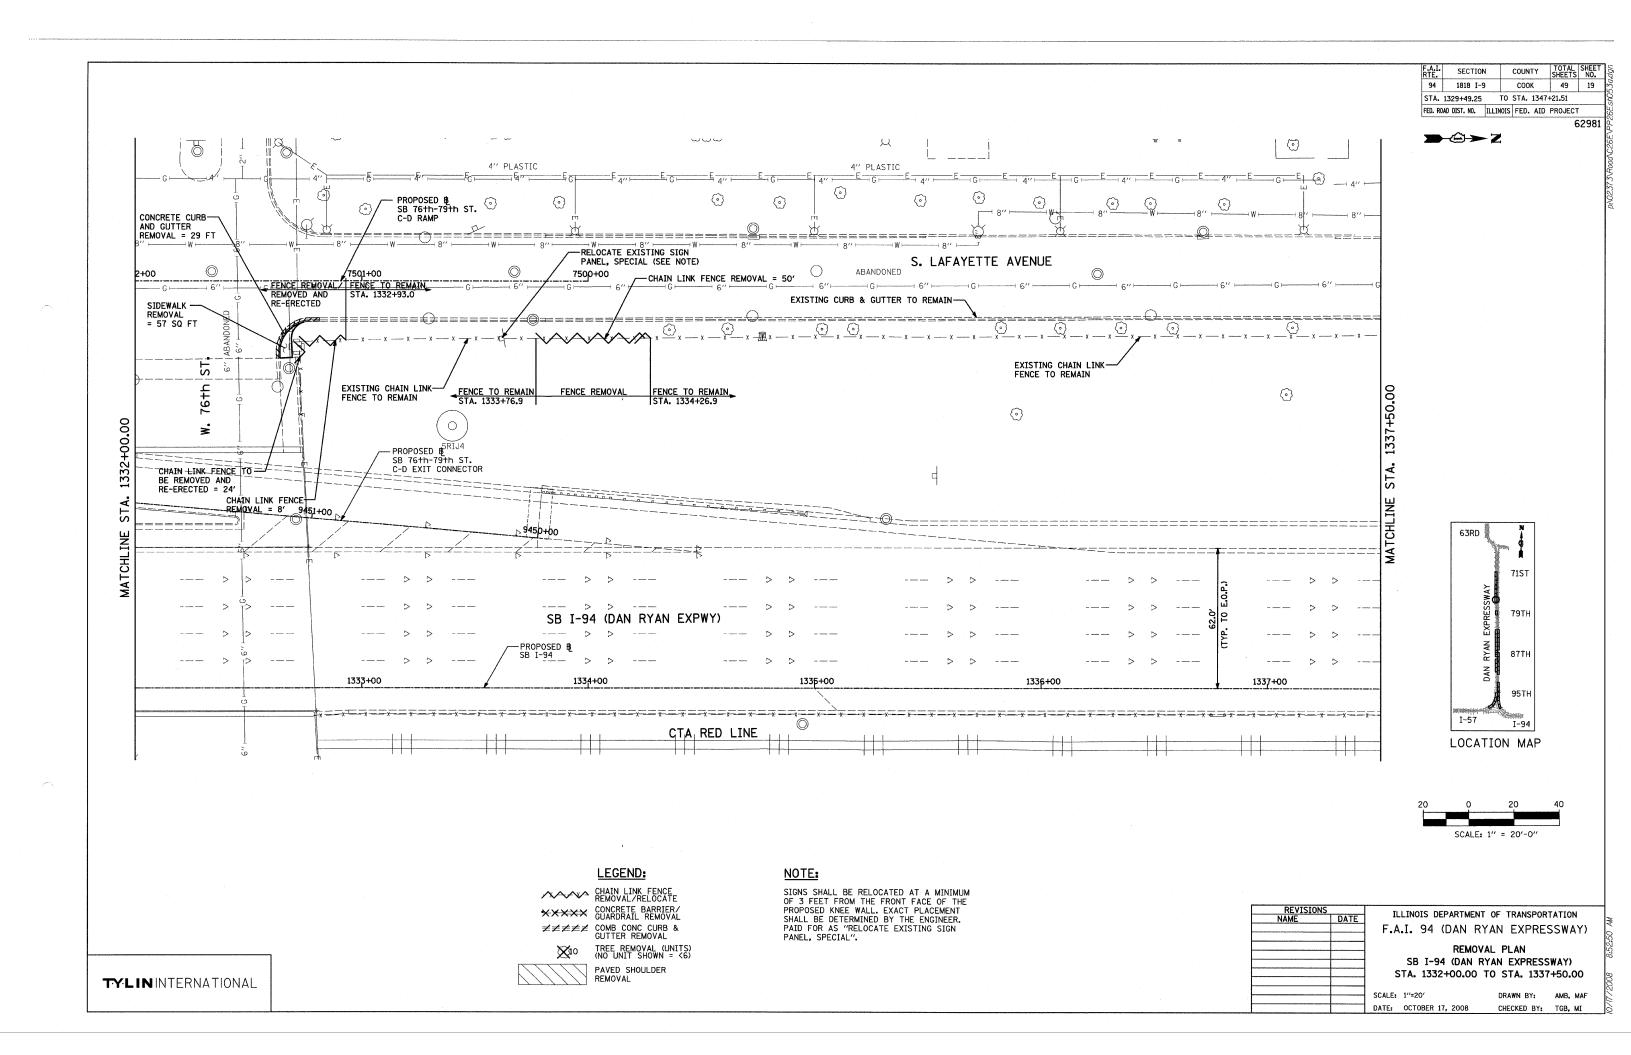
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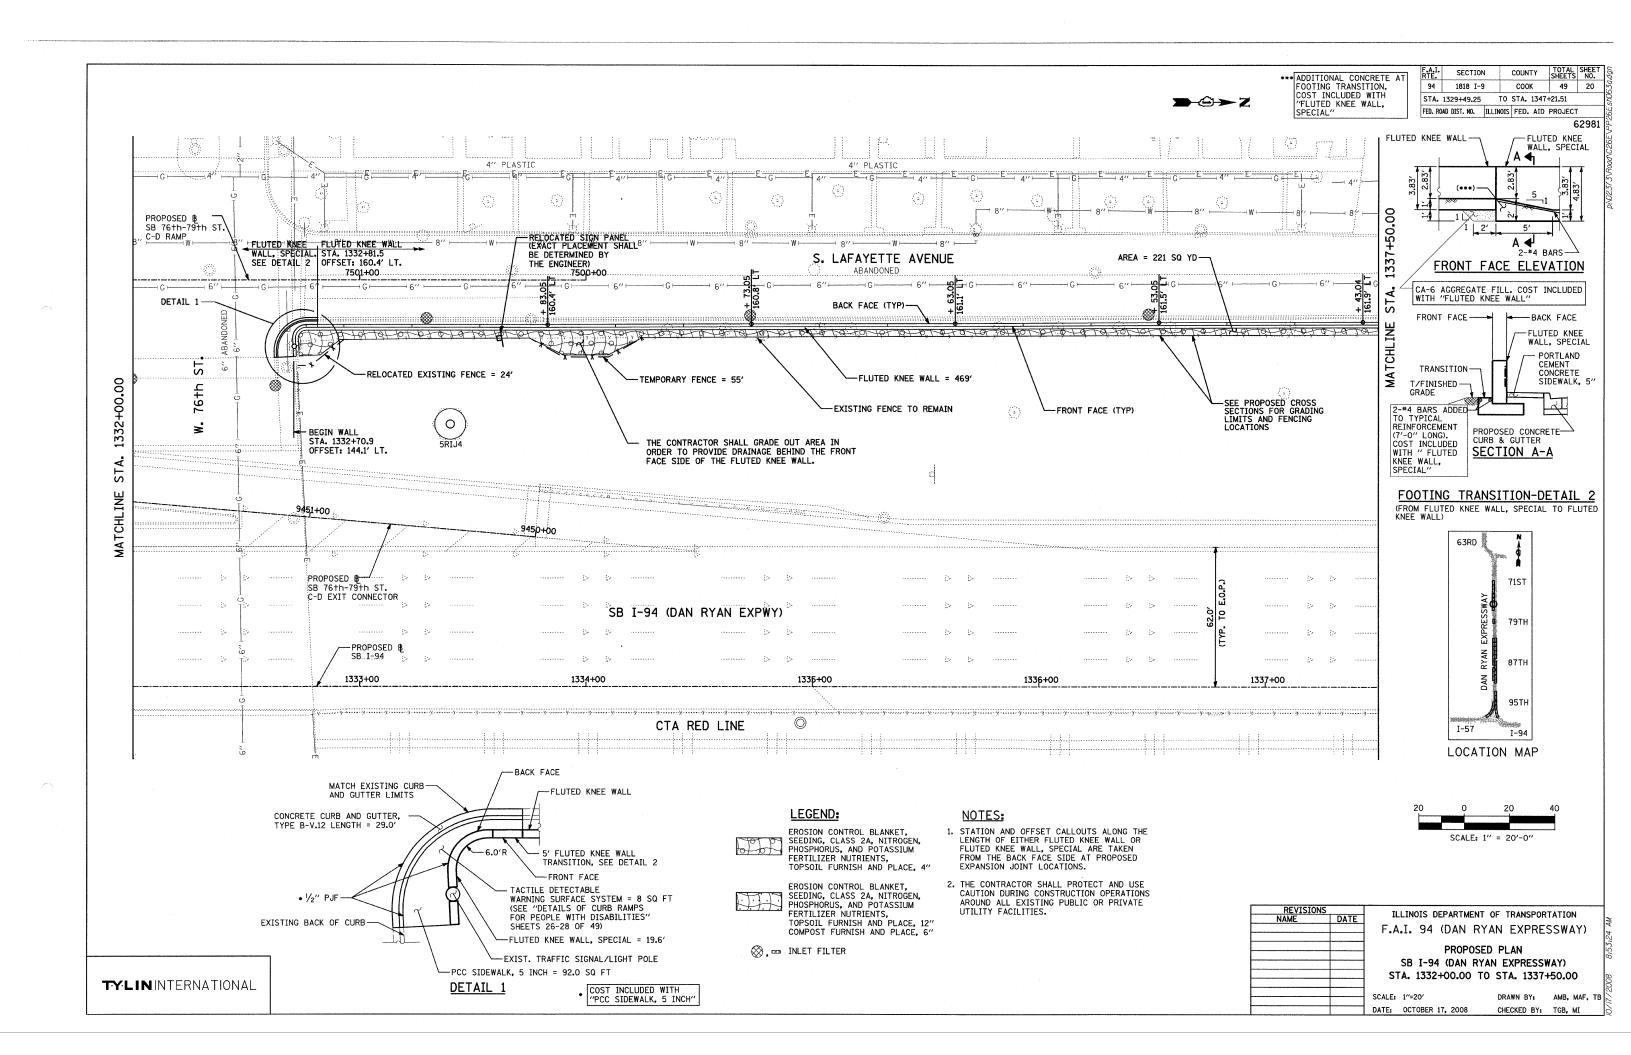
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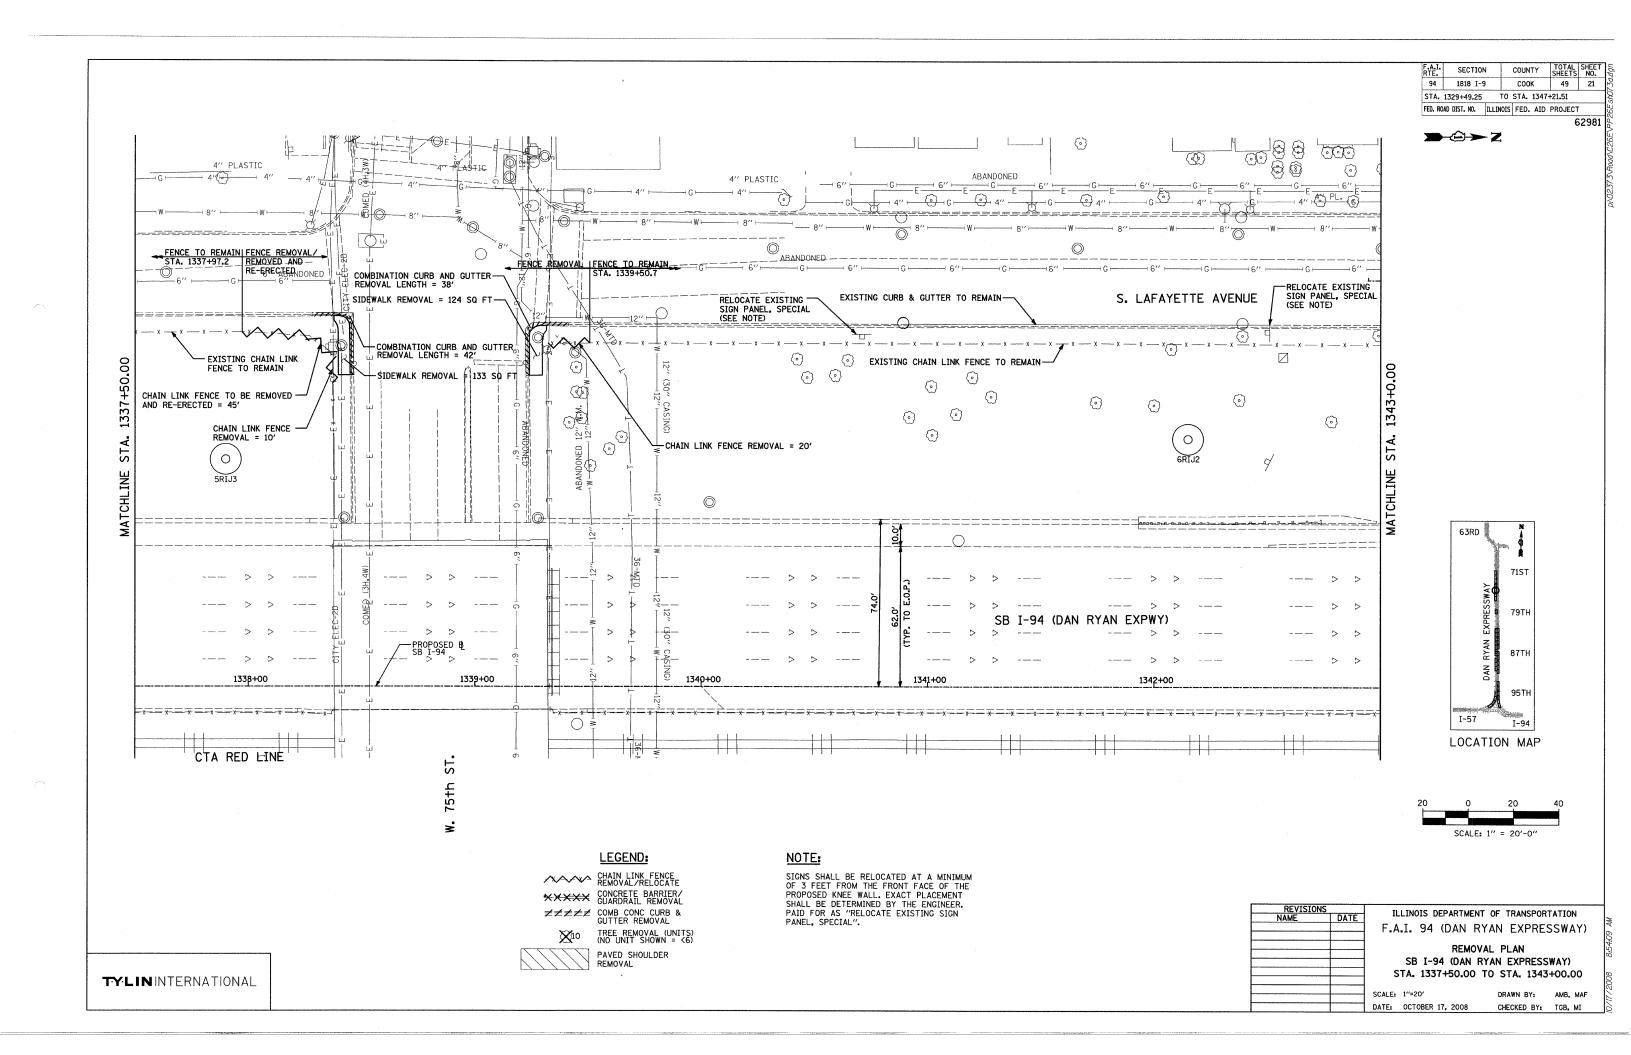
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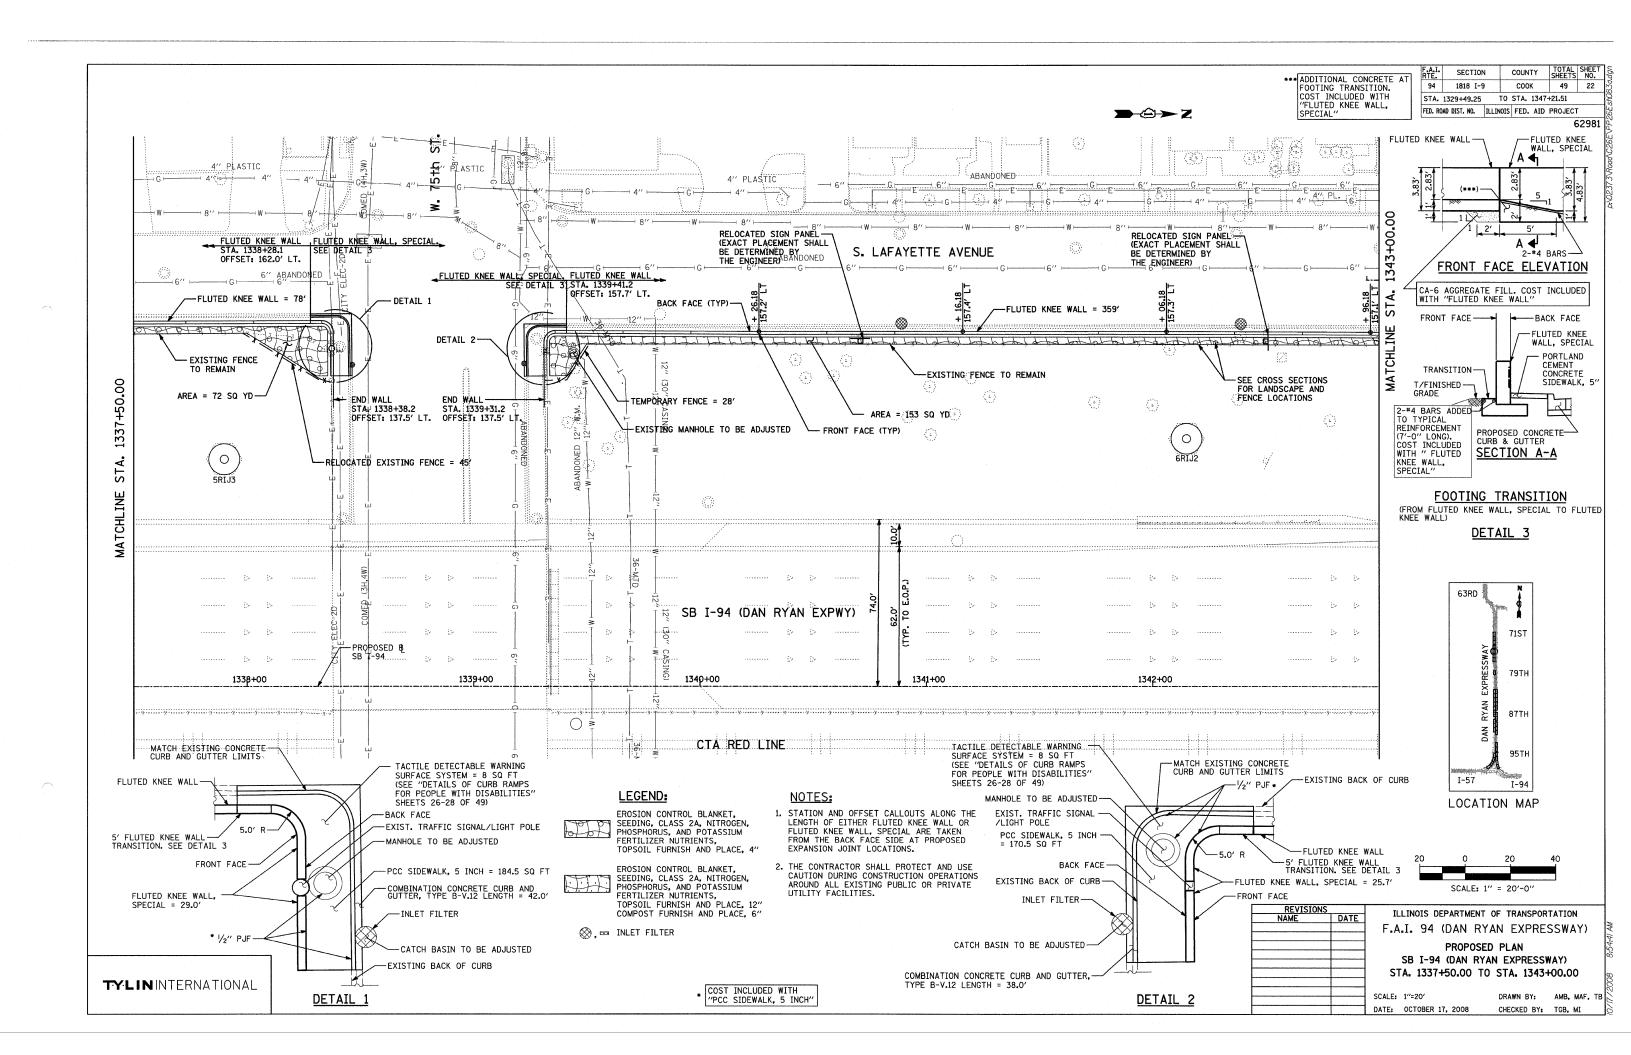
















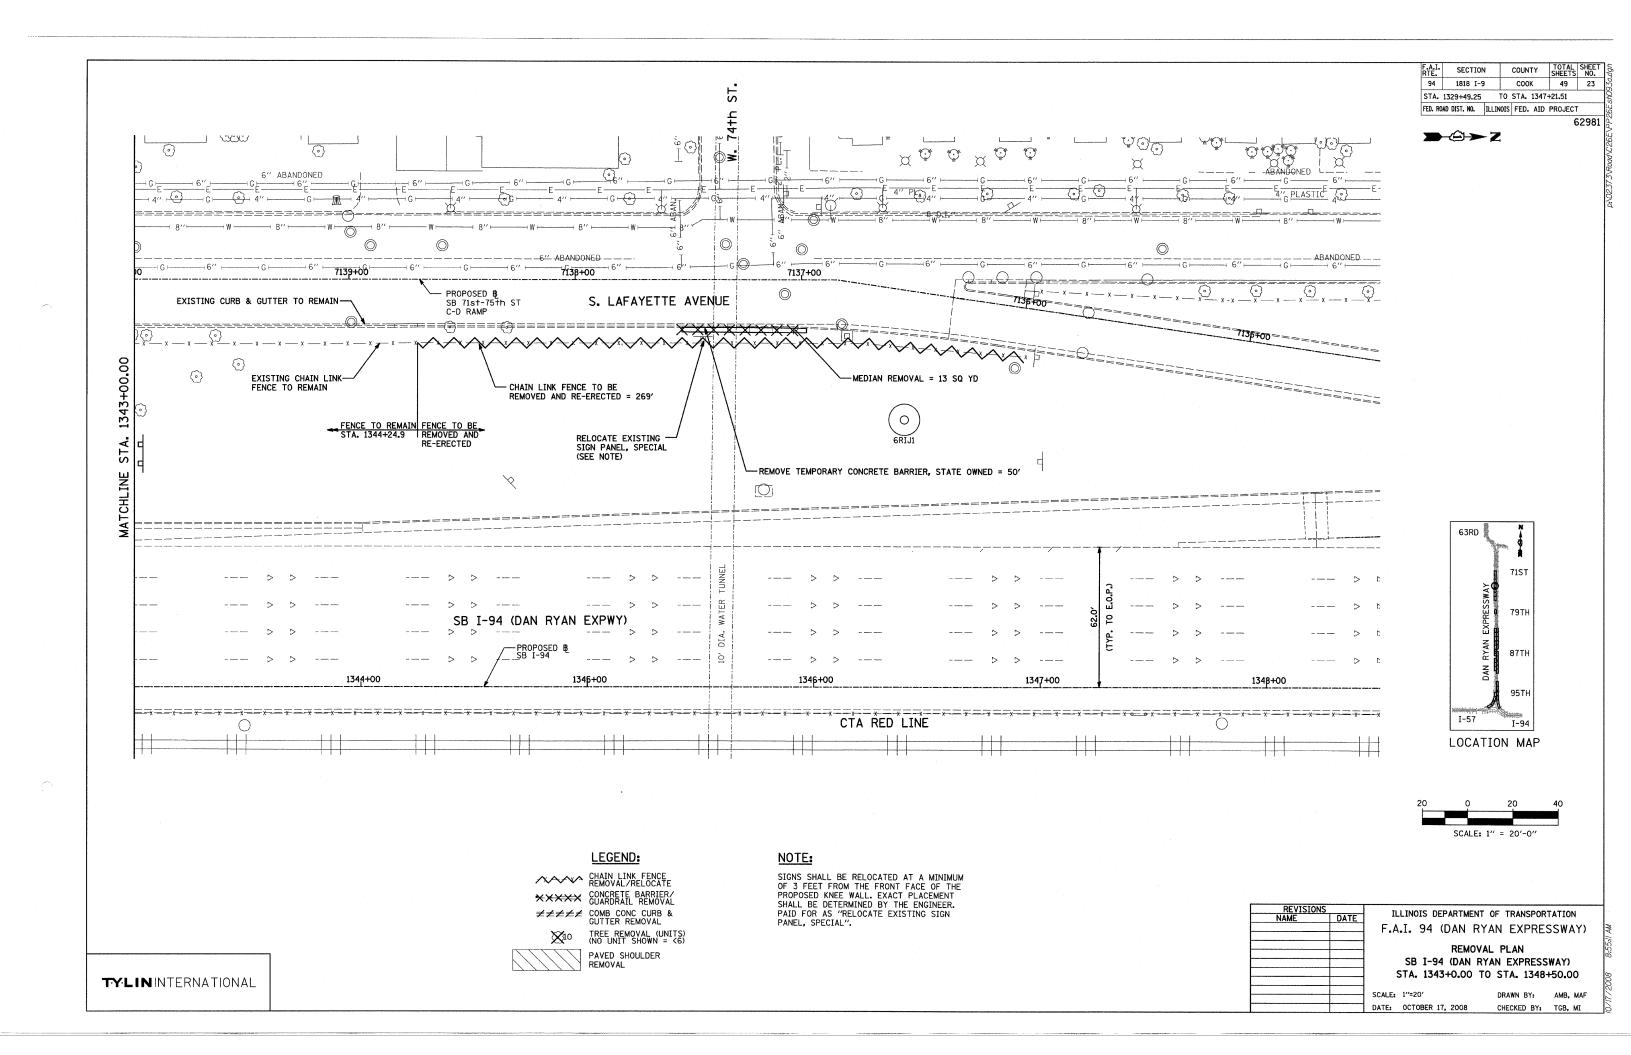

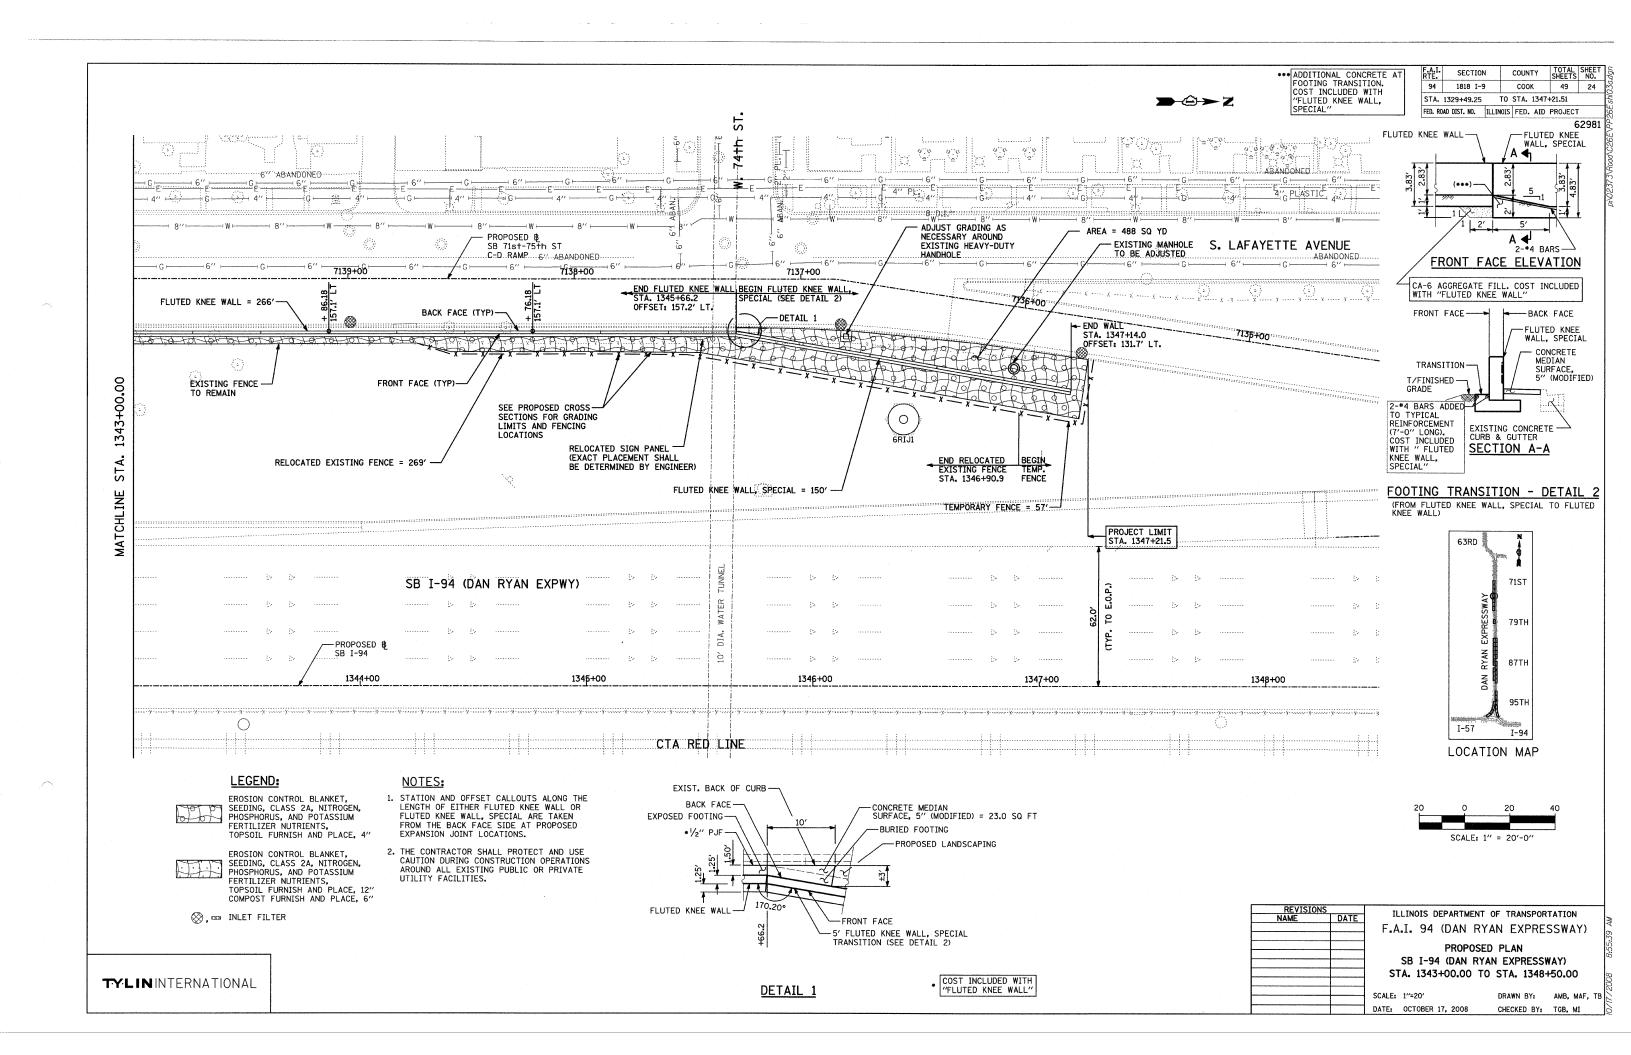

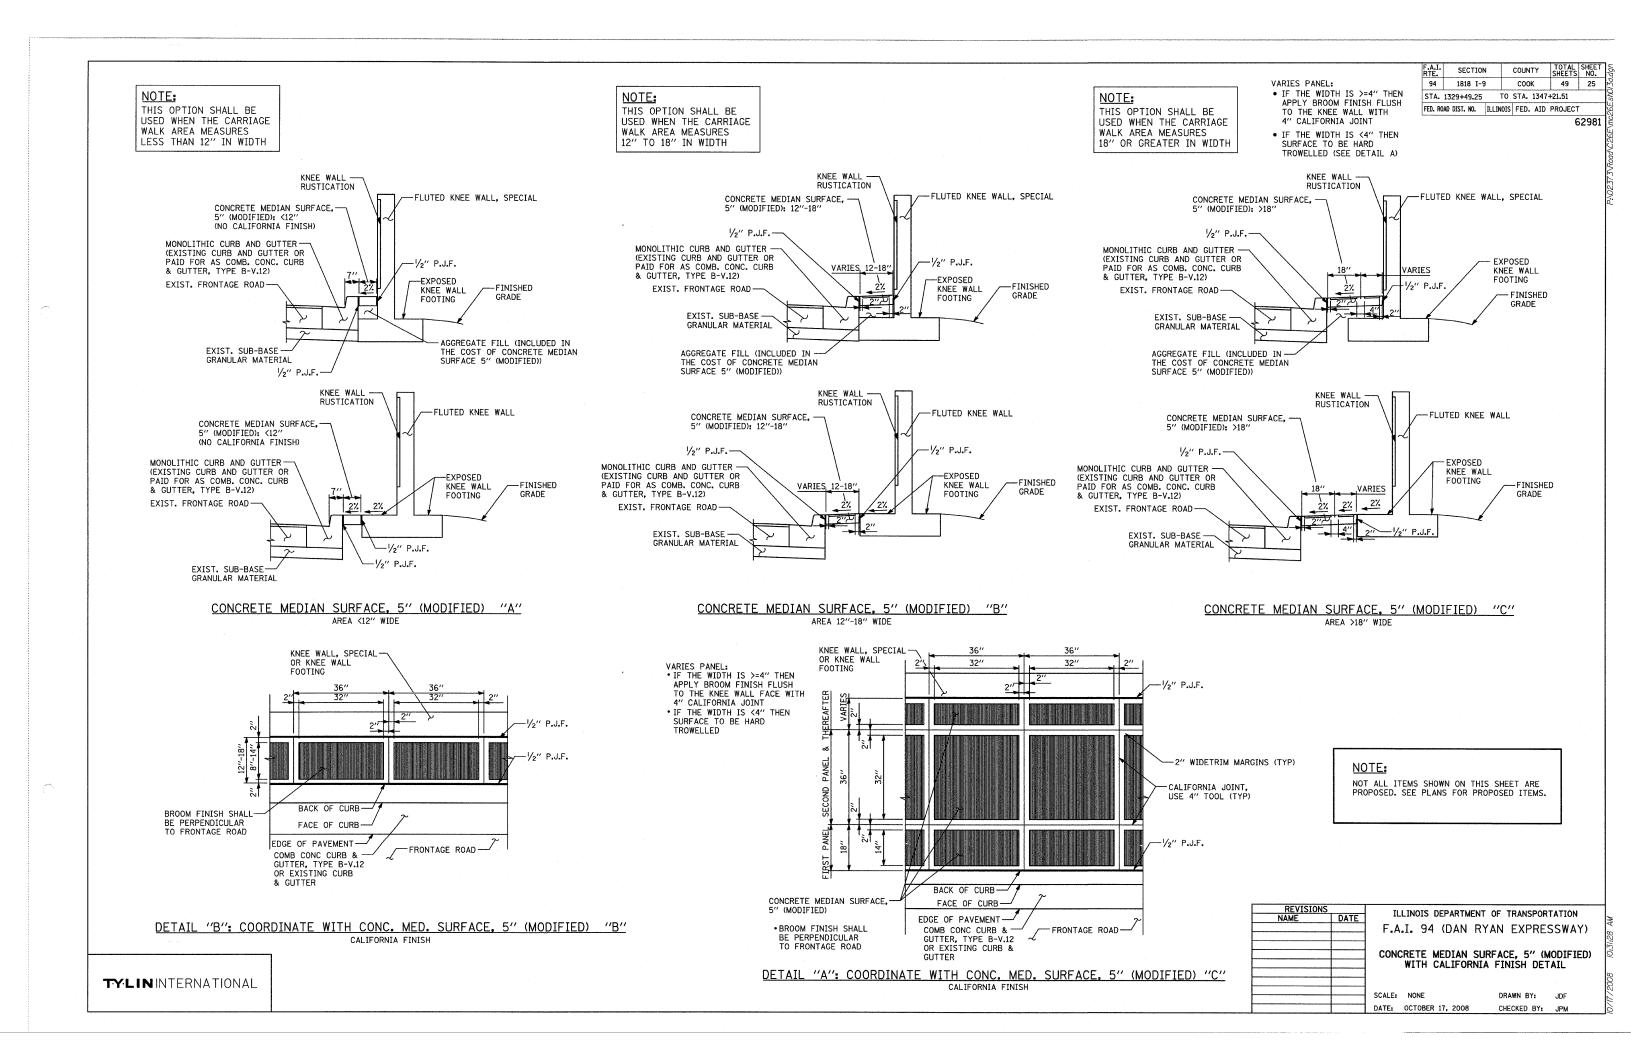

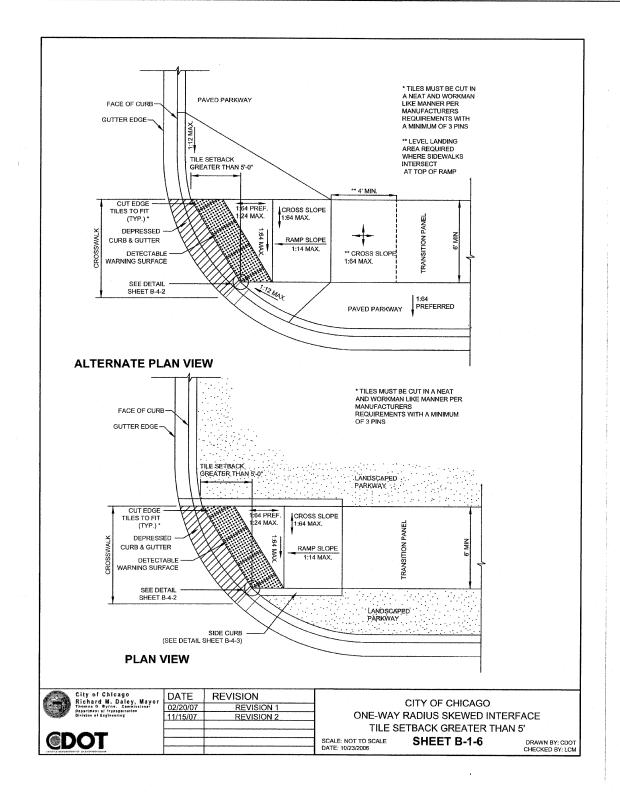

1. THE DETECTABLE WARNING TILES SHALL BE CERAMIC CEMENT OR COMPOSITE POLYMER CONCRETE (CRC) TILES WHICH MEET THE CHICAGO DEPARTMENT OF TRANSPORTATION SPECIFICATION (AVAILABLE ON THE CITY OF CHICAGO WEBSITE). IN THE CENTRAL BUSINESS DISTRICT, GRANITE OR OTHER SPECIALTY PAVING MATERIALS MAY BE SUBMITTED TO THE COMMISSIONER FOR APPROVAL.

- 2. TILES MUST BE INSTALLED A MAXIMUM OF 8" OR LESS FROM FACE OF CURB (SEE DETAIL SHEET B-4-2).
- 3. TILES MUST COVER FULL WIDTH OF RAMP EXCLUDING SIDE FLARES. WHERE SIDEWALK OR RAMP IS FLUSH WITH STREET (DEPRESSED CURB), TILES MUST BE PROVIDED.
- 4. WHERE APPLICABLE, A COMBINATION OF DIFFERING SIZE TILES MAY BE USED ON COMPOUND AND LARGE RADII. CONTRACTOR MUST MAKE THIS DETERMINATION AND VERIFY IN FIELD.
- 5. TILES MUST CONTRAST WITH ADJACENT PAVEMENT. IF LIGHT COLORED PAVEMENT IS USED THE TILE COLOR SHALL BE RED. IF A DARK COLORED PAVEMENT IS USED THE TILE COLOR SHALL BE YELLOW. CONTRACTOR TO VERIFY THAT PROPER CONTRAST IS OBTAINED.
- 6. RAMP WIDTH MUST BE A MINIMUM OF 6'-0" AND IN INCREMENTS OF 1'-0", EXCEPT WHEN USING THE PERPENDICULAR RAMP AT CORNER, WHICH HAS A MINIMUM WIDTH OF 4'-0".
- 7. PRIOR TO PLACING CONCRETE FOR DEPRESSED CURBS AND RAMPS. THE CONTRACTOR SHALL NOTIFY THE COMMISSIONER TO RECEIVE LAYOUT APPROVAL. A PRE-MANUFACTURED TILE, APPROVED BY THE COMMISIONER, MUST BE USED TO ACHIEVE THE DETECTABLE WARNING SURFACE.
- 8. THE MAXIMUM ALLOWABLE RAMP RUNNING SLOPE IS 1:14, MEASURED AT ANY PORTION OF THE RAMP. IF POSSIBLE, A MORE GRADUAL SLOPE SHALL BE USED. GRADE BREAKS AT THE TOP AND BOTTOM OF RAMPS SHALL BE PERPENDICULAR TO THE DIRECTION OF RAMP RUN.
- 9. THE MAXIMUM ALLOWABLE RAMP CROSS SLOPE IS 1:64, MEASURED AT ANY PORTION OF THE RAMP. IF POSSIBLE, A MORE GRADUAL SLOPE SHALL BE USED.
- 10. UTILITIES, SUCH AS LIGHT POLES, TRAFFIC POLES AND HYDRANTS, MAY BE LOCATED IN THE FLARE OF THE RAMP BUT ARE NOT ALLOWED ON THE RAMP SURFACE OR LANDING AREAS.
- 11. ALTERATIONS SHALL NOT DECREASE THE ACCESSIBILITY OF EXISTING FACILITIES
- 12. THE MINIMUM CROSSWALK WIDTH IS 6'-0". CROSSWALKS SHALL BE LOCATED AS SHOWN IN THE PLAN SHEETS DEPENDING ON THE TYPE OF CURB RAMP USED. BEYOND THE CURB FACE AT THE BASE OF CURB RAMPS, A CLEAR SPACE OF 4'-0" BY 4'-0" MINIMUM SHALL BE PROVIDED WITHIN THE WIDTH OF THE
- 13. IF SIDEWALK AND ALLEY ARE AT THE SAME GRADE, A RAMP IS NOT REQUIRED. IF SIDEWALK AND DRIVEWAY ARE AT THE SAME GRADE, A RAMP IS NOT REQUIRED BUT DETECTABLE WARNING TILES ARE STILL REQUIRED IF THE DRIVEWAY HAS TRAFFIC CONTROL DEVICES (I.E. TRAFFIC SIGNALS).
- 14. MAIN LINE SIDEWALK SHALL HAVE A MAXIMUM CROSS SLOPE NOT TO EXCEED 1:64 FOR THE FULL WIDTH OF WALK UNLESS OTHERWISE APPROVED BY THE COMMISSIONER
- 15. MAIN LINE SIDEWALK RUNNING SLOPES SHALL NOT EXCEED 1:24 OR THE GENERAL GRADE ESTABLISHED FOR THE ADJACENT STREET, WHICH EVER IS HIGHER.
- 16. CURB RAMPS AND KEYSTONE TO BE CONSTRUCTED WITH 8" THICK CONCRETE AT ALL TRAFFIC SIGNALIZED INTERSECTIONS AND INDUSTRIAL STREET INTERSECTIONS. AT ALL OTHER LOCATIONS, 5" THICK CONCRETE TO BE USED
- 17. NO DEVIATIONS FROM THESE STANDARDS ARE ALLOWED WITHOUT WRITTEN APPROVAL FROM THE COMMISSIONER.
- 18. ALL CONSTRUCTION DOCUMENTS MUST BE STAMPED BY A LICENSED ARCHITECT/LANDSCAPE ARCHITECT/ENGINEER TO CERTIFY THAT THEY ARE IN ACCORDANCE WITH THE AMERICANS WITH DISABILITIES ACT (ADA) AND ALL CODES AND BUILDING ORDINANCES OF THE CITY OF CHICAGO AND STATE

	City of Chicago Richard M. Datey, Mayor Thomas G. Byrne. Cemelsations: Department of Kanapersation Division of Engineering
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@DOT

DATE REVISION 02/20/07 11/15/07

CITY OF CHICAGO **GENERAL NOTES**

SHEET B-3-2 SCALE: NOT TO SCALE

SEE THE CITY OF CHICAGO'S WEBSITE @ WWW.CITYOFCHICAGO.ORG FOR MOST CURRENT STANDARDS

SECTION COUNTY 1818 I-9 COOK 49 26 STA. 1329+49.25 TO STA. 1347+21.51 FED. ROAD DIST. NO. ILLINOIS FED. AID PROJECT

62981

REVISIONS		TI I TNI	TC DEDAD	MENT OF	TRANSPOR	TATION
NAME	DATE	ILLINOIS DEPARTMENT OF TRANSPORTATION				
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		PEOPLE WITH DISABILITIES				
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DATE: OCTOBER 17, 2008

CHECKED BY:

ADA COMPLIANCE AND TRANSITION GUIDELINES

POLICY STATEMENT: ANY ALTERATION OF THE PUBLIC WAY MUST BE RESTORED IN AN ADA COMPLIANT MANNER

I. STREET RESURFACING / RECONSTRUCTION *

FOR ANY RESURFACING/RECONSTRUCTION PROJECT WHERE, WITHIN THE PROJECT LIMITS, A CROSSWALK IS ENCOUNTERED OR WHERE THE PROJECT LIMITS TERMINATE WITHIN 4" OR LESS OF A CROSSWALK, THOSE CROSSWALKS AND THE ASSOCIATED CURB RAMPS MUST BE IMPROVED TO CURRENT ADA STANDARDS. WHERE RESURFACING/RECONSTRUCTION ENCOUNTERS LESS THAN 1/4 POINT OF THE STREET SURFACE (LONGITUDINAL CUT), IT IS ACCEPTABLE PRACTICE TO EXCLUDE IMPROVEMENTS TO THE ASSOCIATED CROSSWALKS AND CURB RAMPS.

WHEN A PROJECT SCOPE OF WORK CALLS FOR ONLY AN INTERSECTION TO BE REPAYED. THE INTERSECTION LIMITS AS DEFINED BY THE AREA OUTLINED BY OUTERMOST CROSSWALK LINES AND ADJACENT CURB FACES AND ALL ADJOINING CROSSWALKS AND CURB RAMPS MUST BE IMPROVED TO CURRENT ADA STANDARDS.

WHEN A PROJECT SCOPE OF WORK IS LIMITED TO A SINGLE CORNER OF AN INTERSECTION, THE CURB RAMP MUST BE IMPROVED TO CURRENT ADA STANDARDS AND THE ADJACENT PAVEMENT MUST BE RESURFACED, AS NECESSARY TO PROVIDE FOR A FLUSH TRANSITION.

FOR ANY RESURFACING / RECONSTRUCTION PROJECT WHERE, WHITHIN THE PROJECT LIMITS. AN ALLEY APRON IS INCLUDED, THE ASSOCIATED CURB RAMPS AND SIDEWALKS MUST BE IMPROVED TO **CURRENT ADA STANDARDS**

II. SIDEWALK INSTALLATION / REPAIRS / RECONSTRUCTION

THE LIMITS OF ANY MAINLINE SIDEWALK REPLACEMENT, GREATER THAN TEN FEET (10') IN LENGTH, THAT ABUT AN EXISTING RAMP LOCATION (INCLUDING THE FOUR FOOT (4') LANDING AREA AND/OR THE "KEYSTONE"), SHALL BE EXTENDED TO INCLUDE THE AFFECTED RAMPS ANDTHESE RAMPS SHALL BE RECONSTRUCTED TO CURRENT ADA STANDARDS. IN ADDITION, ALL NEWLY PLACED SIDEWALK TEN FEET (10') OR MORE IN LENGTH SHALL BE CONSTRUCTED IN ACCORDANCE WITH ALL CURRENT APPLICABLE STANDARDS WHICH INCLUDE PROVIDING A MINIMUM FOUR FEET (4') WIDTH ACCESSIBLE PATHWAY WITH A CROSS SLOPE NOT TO EXCEED 1:64.

III. GUIDELINES FOR TRANSITIONING TO EXISTING NON-COMPLIANT CONDITION

NEW SIDEWALK PLACEMENTS GREATER THAN TEN FEET IN CONTIGUOUS LENGTH: THE LIMITS OF ANY MAINLINE SIDEWALK REPLACEMENT, GREATER THAN TEN FEET (10') IN LENGTH, MUST BE EXTENDED FOR A MINIMUM FIVE ADDITIONAL FEET (5') EITHER SIDE IN ORDER TO PROVIDE A REASONABLE TRANSITION TO MATCH THE EXISTING SIDEWALK. THE LENGTH OF TRANSITION SHALL BE LENGTHENED AS NECESSARY TO ENSURE THAT THE RUNNING SLOPE OF THE TRANSITION DOES NOT EXCEED A SLOPE OF 1:24 (PREFERRED) OR 1:14 (MAXIMUM) AT ANY POINT.

NEW SIDEWALK REPLACEMENTS TEN FEET OR LESS IN CONTIGUOUS LENGTH (REPAIRS): IT IS ACCEPTABLE PRACTICE TO MATCH ADJACENT SIDEWALKS AT THE EXISTING SLOPE.

CURB RAMP REPLACEMENTS:

SIDEWALK REPLACEMENT BEYOND THE LIMITS OF THE LANDING AREA AND/OR THE "KEYSTONE" MUST BE EXTENDED A MINIMUM OF AN AN ADDITIONAL FIVE FEET (5') EITHER SIDE IN ORDER TO PROVIDE A REASONABLE TRANSITION TO MATCH THE EXISTING SIDEWALK. THE TRANSITION SHALL BE LENGTHENED AS NECESSARY TO ENSURE THAT THE RUNNING SLOPE OF THE TRANSITION DOES NOT EXCEED A SLOPE OF 1:24 (PREFERRED) OR 1:14 (MAXIMUM) AT ANY POINT.

NO EXCEPTIONS TO THE ABOVE WILL BE ALLOWED WITHOUT WRITTEN APPROVAL FROM THE

THE REQUIREMENTS OF SECTION I. SHALL APPLY ONLY TO CITY AGENCIES

City of Chicago Richard M. Daley, Mayor Richard S. Byran. Cesaristican Desarrent of Transpariation District of Engineering	DATE 02/20/07 11/15/07	REVISION REVISION 1 REVISION 2		CHICAGO TRANSITION GUIDELINES
EDOT			SCALE: NOT TO SCALE SHEE	ET B-3-3 DRAWN BY: CDOT CHECKED BY: LCM

GENERAL NOTE: THE ROWS OF DOMES IN THE DETECTABLE WARNING MATERIAL MUST BE ALIGNED WITH THE PATH OF WHEELCHAIR TRAVEL WHICH IS REQUIRED TO BE PERPENDICULAR TO THE GRADE BREAK AT THE BOTTOM OF THE RAMP TO PERMIT TRACKING BETWEEN DOME ROWS. ON BLENDED TRANSITIONS, DOME ORIENTATION IS NOT SIGNIFICANT **DETECTABLE** WARNING TILE FLOW LINE/FACE OF CURB SQUARE PATTERN TRUNCATED DOME DETAIL (PARALLEL ALIGNMENT) **TILE PATTERN DETAIL TILE PLACEMENT ON A RADIUS** BULL FLOAT AROUND TILE TO ENSURE A LEVEL SURFACE, 1/4" MAX VERTICAL DISPLACEMENTS BETWEEN THE TILE EDGE AND ADJACENT CONCRETE SECURING PIN SUPPLIED BY MANUFACTURER CAST IN PLACE DETECTABLE WARNING TILE PLASTIC BARRIER 8" CONCRETE WALK XIII. **DETECTABLE TILE WARNING SECTION** City of Chicago Richard M. Daley, Mayo DATE REVISION CITY OF CHICAGO **DETECTABLE WARNING TILE DETAILS** REVISION 2 **@DOT** SCALE: NOT TO SCALE DATE: 10/23/2006 SHEET B-4-2

SEE THE CITY OF CHICAGO'S WEBSITE @ WWW.CITYOFCHICAGO.ORG FOR MOST CURRENT STANDARDS

REVISIONS		ILLINOIS DEPARTMENT OF TRANSPORTATION				
NAME	DATE	ILLINOIS DEPARTMENT OF TRANSPORTATION				
		F.A.I. 94 (DAN RYAN EXPRESSWAY)				
		CITY OF CHICAGO STANDARD DETAILS				
		DETAILS OF CURB RAMPS FOR				
		PEOPLE WITH DISABILITIES				
		SHEET 2 OF 3				

CHECKED BY: LCM

SCALE: NONE DRAWN BY: DATE: OCTOBER 17, 2008 CHECKED BY:

SECTION

1818 I-9


STA. 1329+49.25 TO STA. 1347+21.51

FED. ROAD DIST. NO. ILLINOIS FED. AID PROJECT

COUNTY

COOK

62981

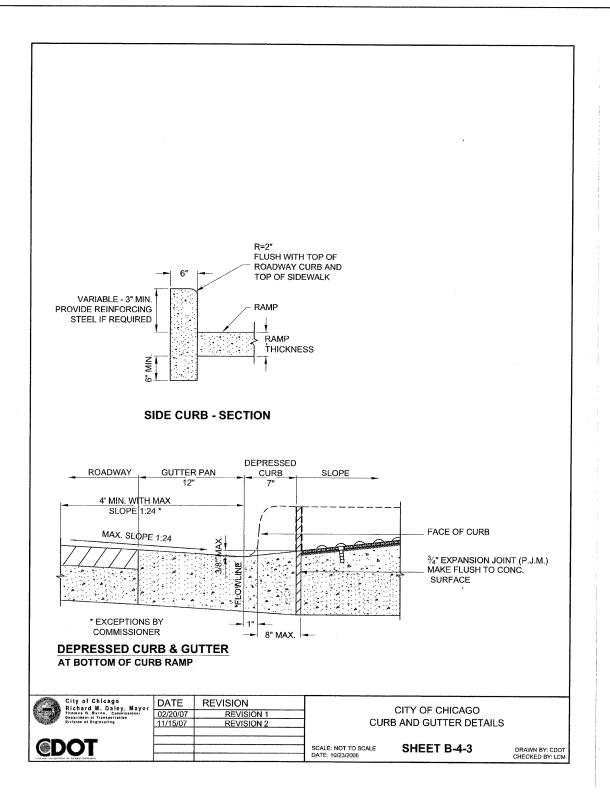

| F.A.I. | SECTION | COUNTY | TOTAL | SHEET | SWITCH | SHEET | SWITCH | SWI


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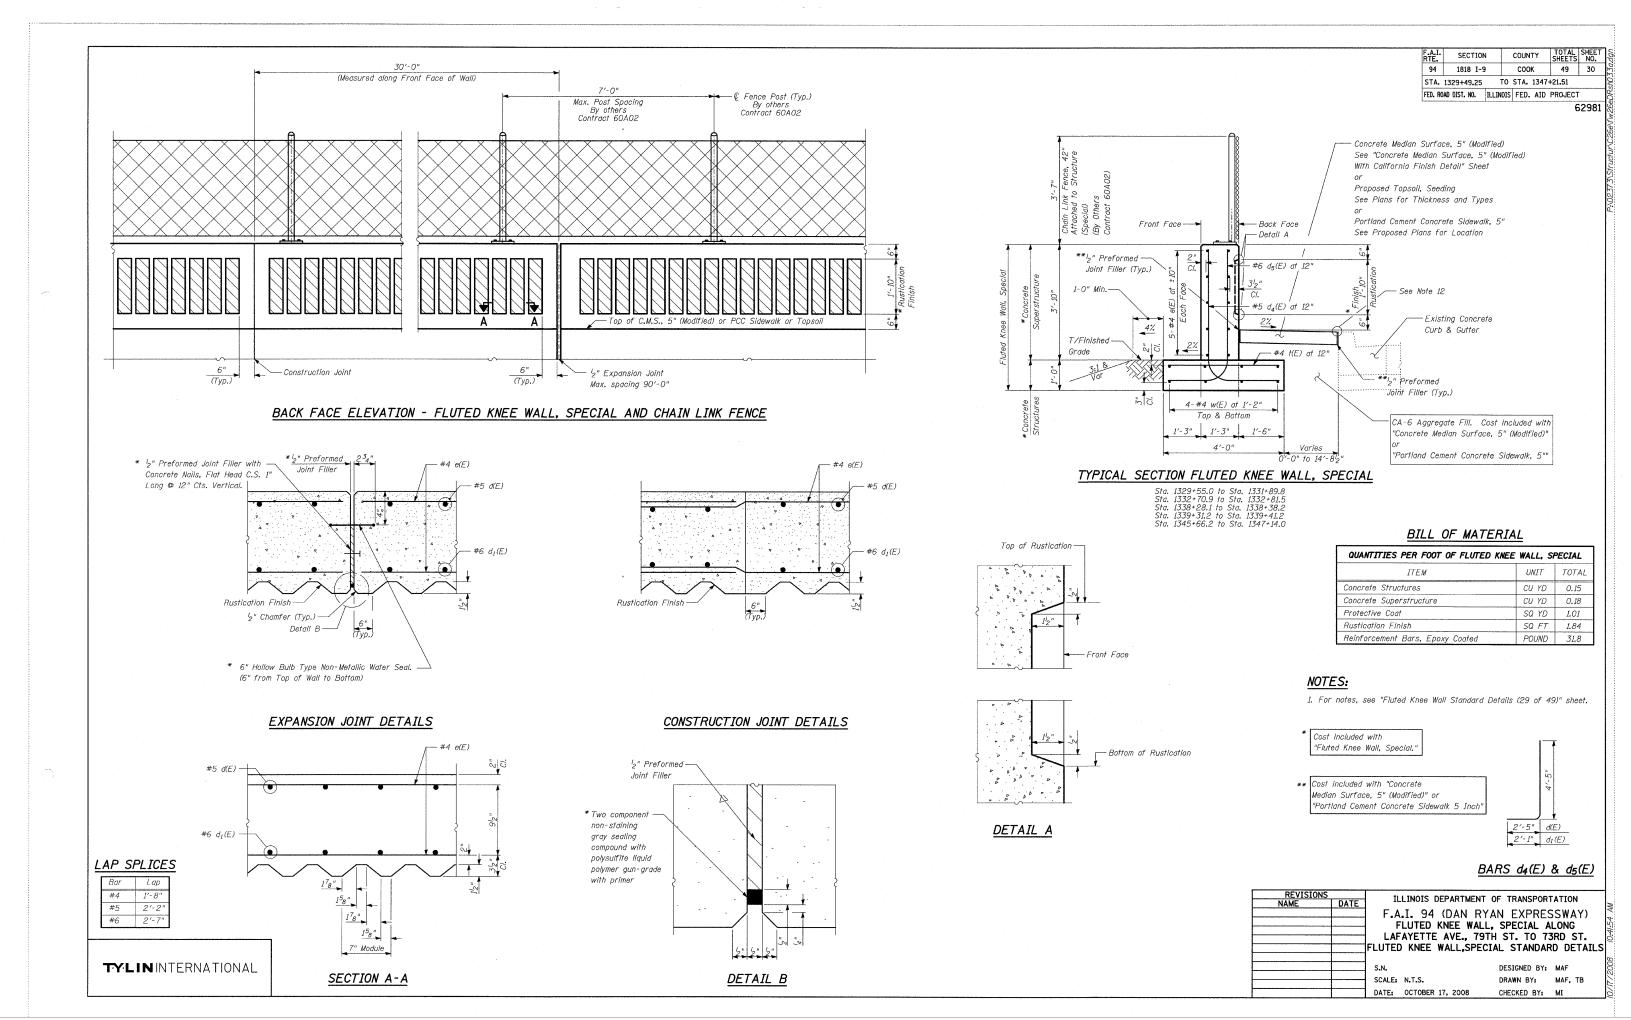
SEE THE CITY OF CHICAGO'S
WEBSITE @ WWW.CITYOFCHICAGO.ORG
FOR MOST CURRENT STANDARDS


REVISION		ILLINOIS DEPARTMENT OF TRANSPORTATION	•
NAME	DATE	TELINOIS DEPARTMENT OF TRANSPORTATION	
		F.A.I. 94 (DAN RYAN EXPRESSWAY)	
		CITY OF CHICAGO STANDARD DETAILS	
		DETAILS OF CURB RAMPS FOR	
		PEOPLE WITH DISABILITIES	
		SHEET 3 OF 3	
		SHEET 3 OF 3	
		SCALE: NONE DRAWN BY: CDOT	


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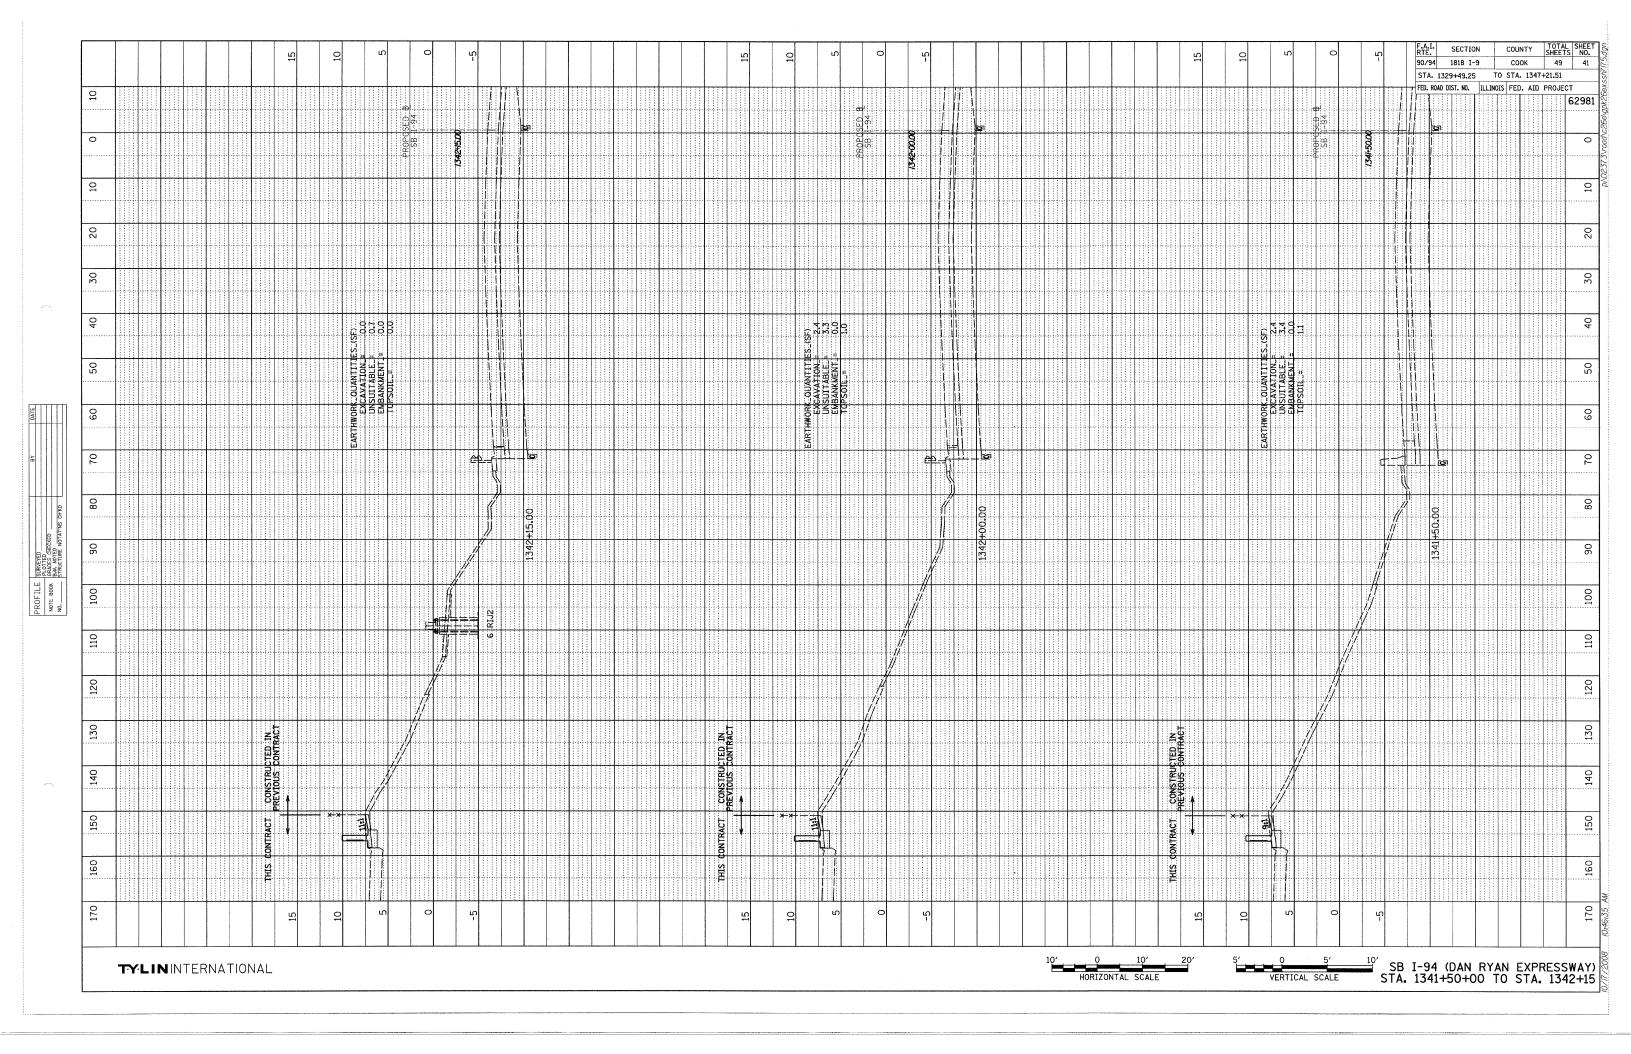
DATE: OCTOBER 17, 2008







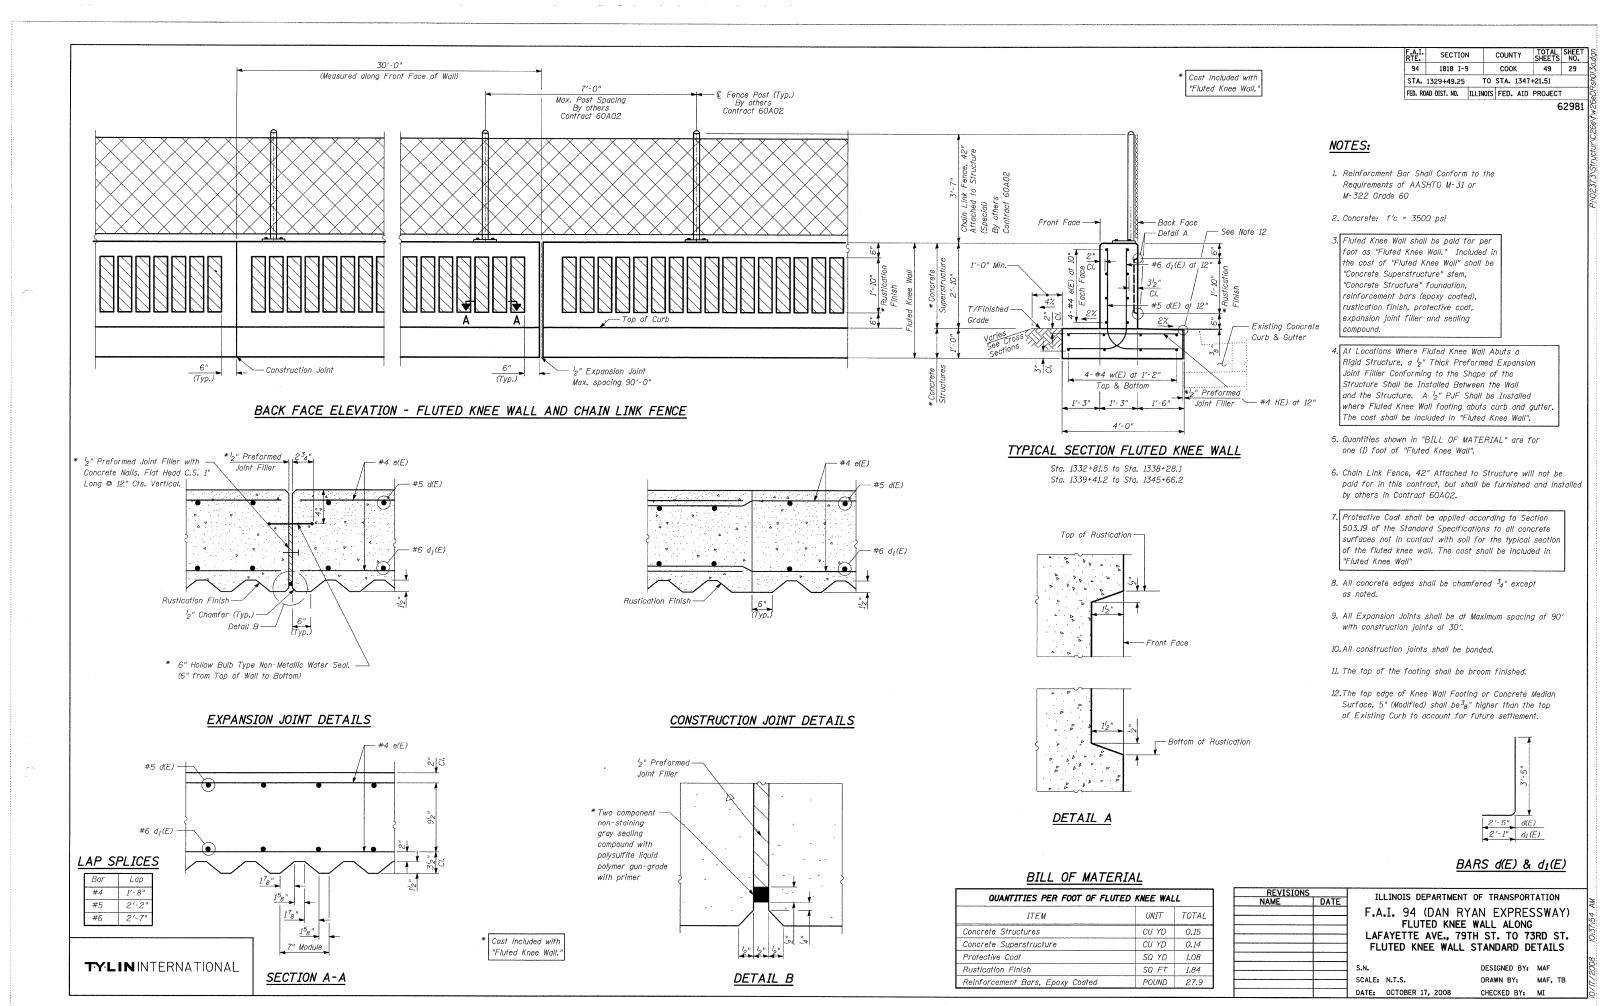

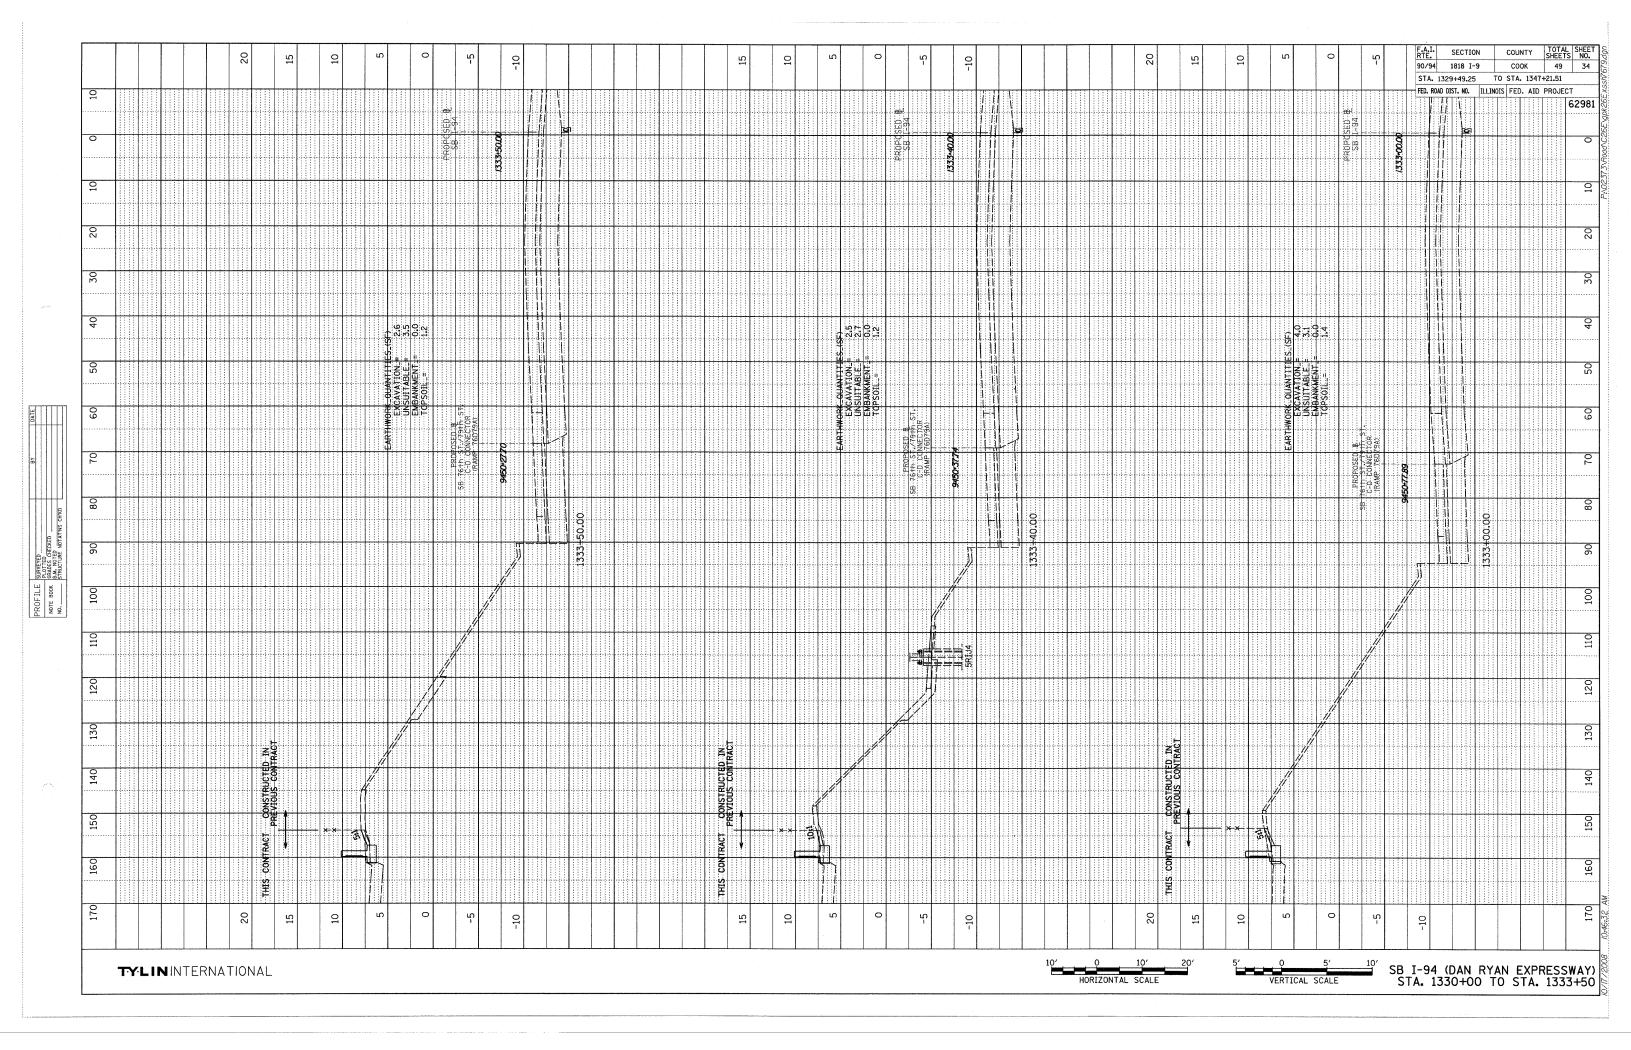

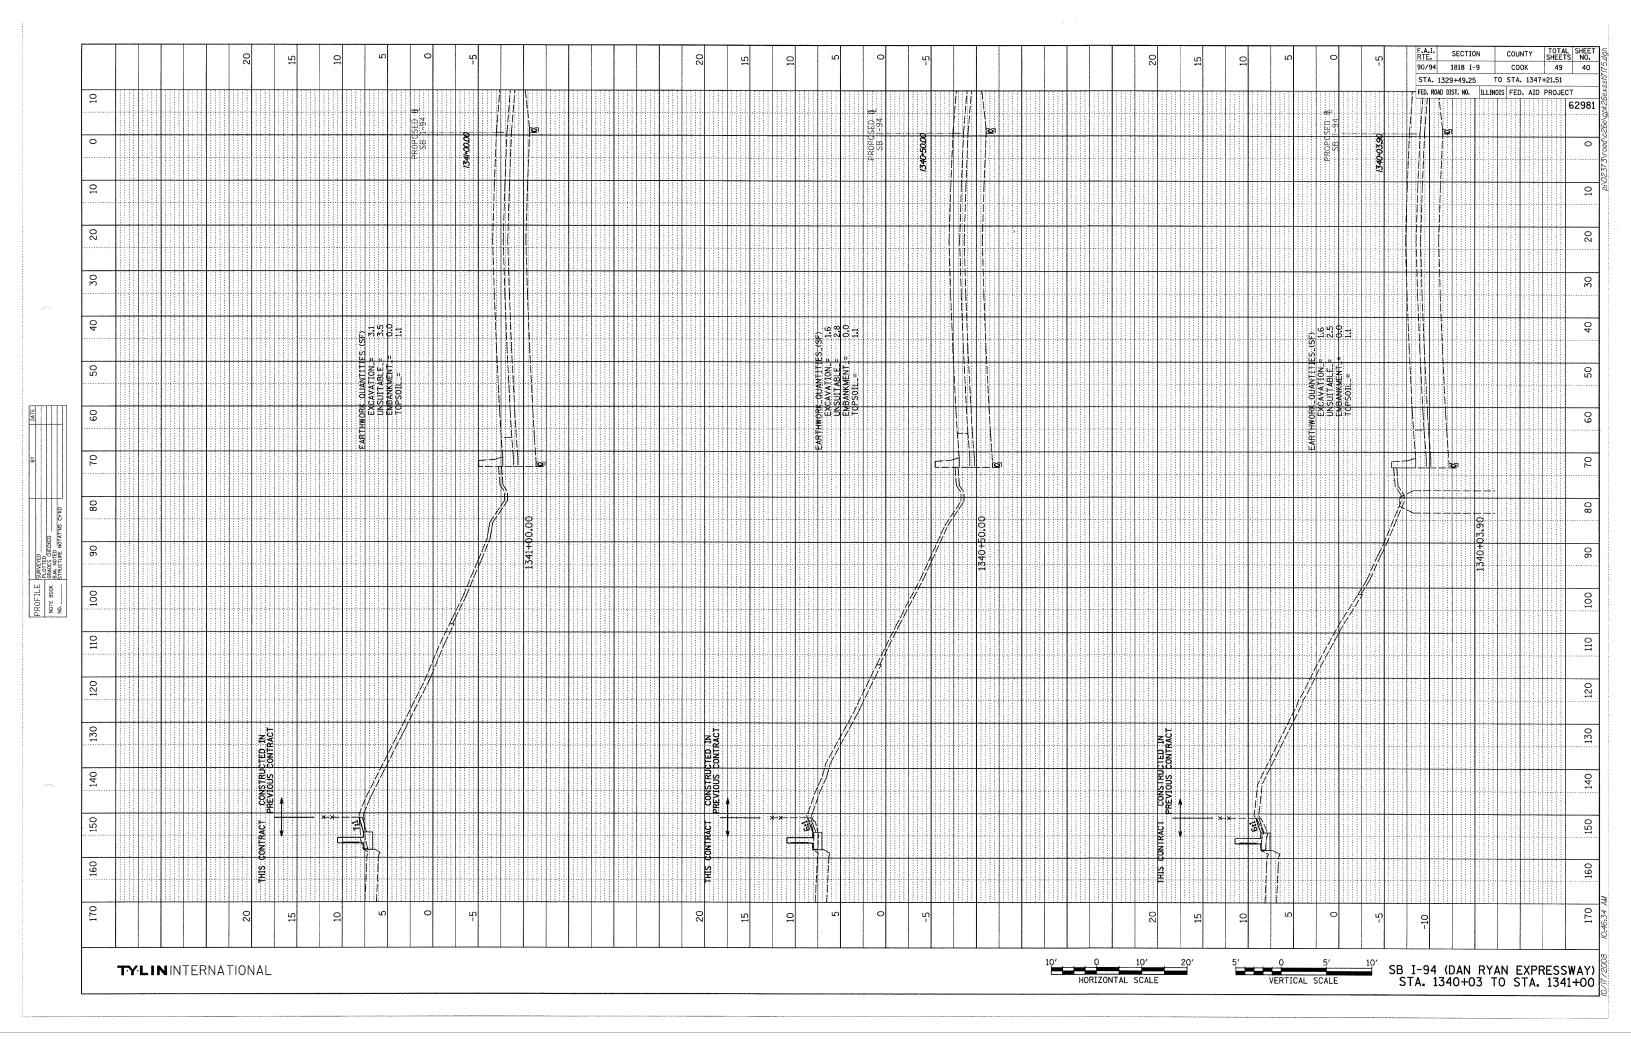

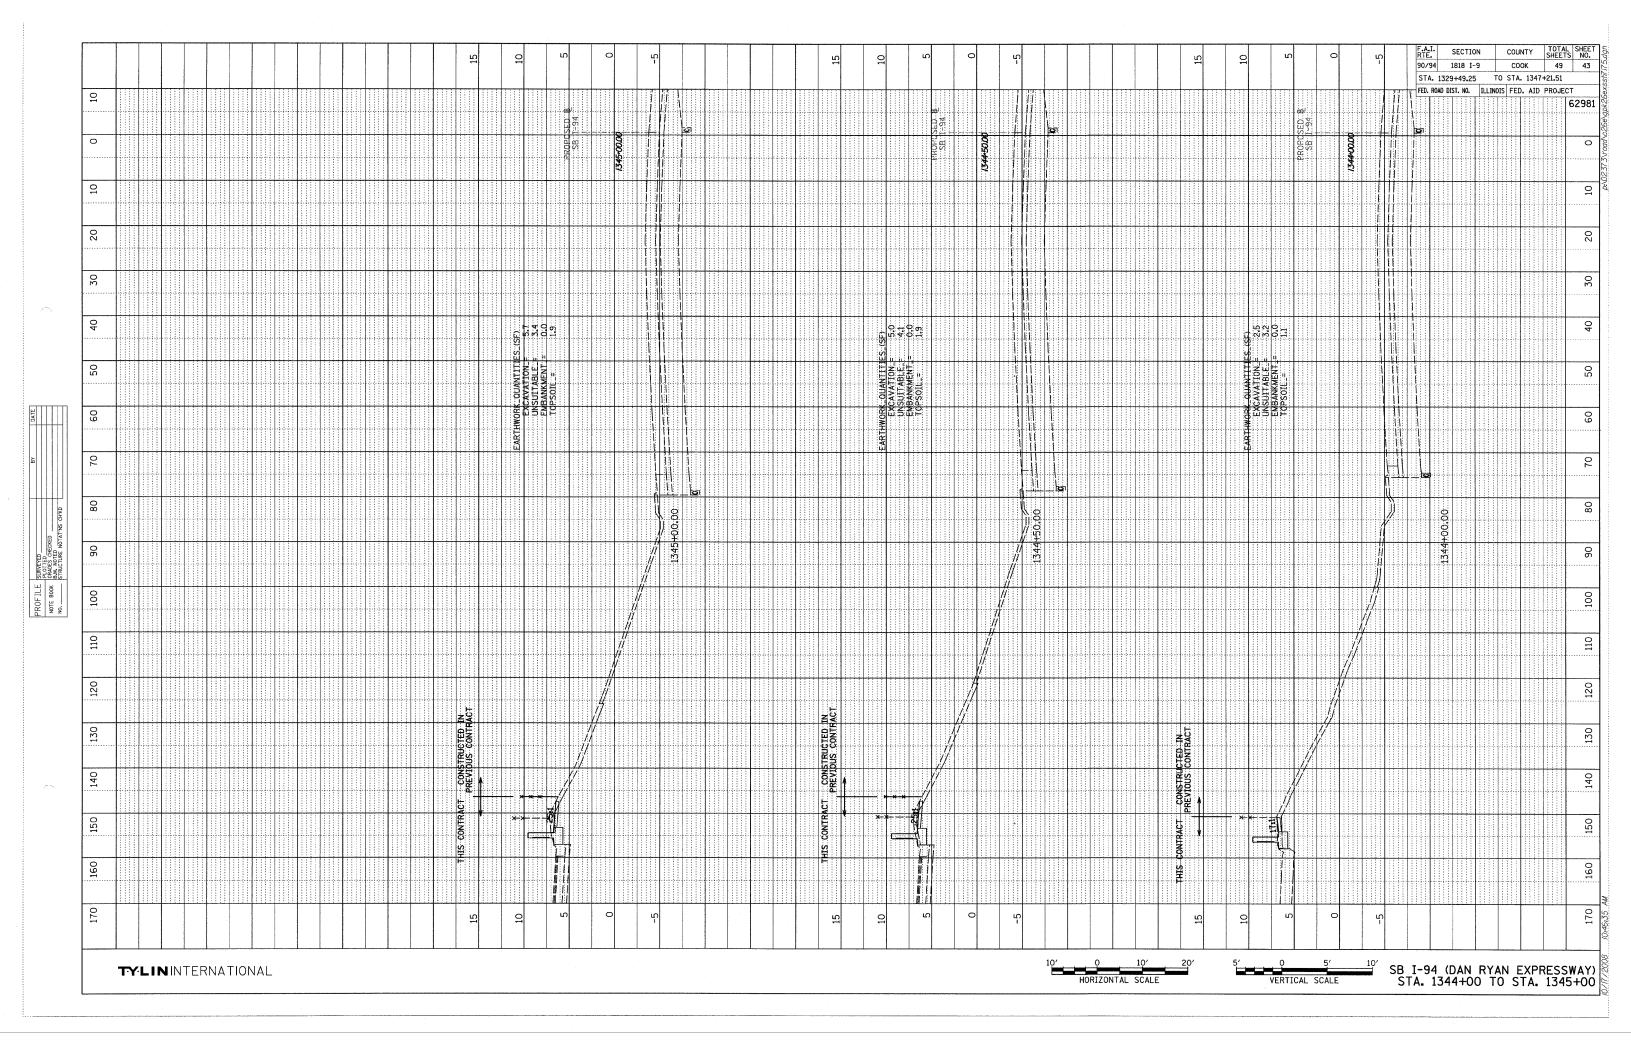

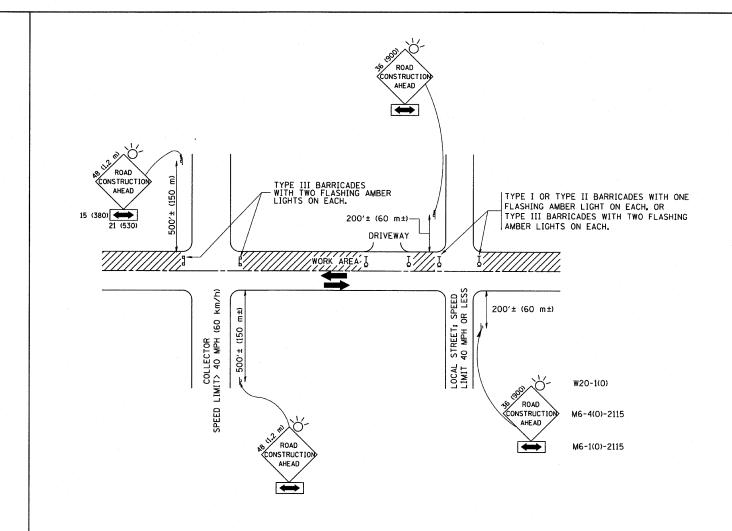

TRAFFIC CONTROL AND PROTECTION FOR SIDE ROADS, INTERSECTIONS, AND DRIVEWAYS

NOTES:

- A. FOR NO LANE RESTRICTION ON THE SIDE ROAD OR DRIVEWAYS
- 1. SIDE ROAD WITH A SPEED LIMIT OF 40 MPH (60 km/h) OR LESS AS SHOWN ON THE DRAWING AND AS DIRECTED BY THE ENGINEER:
- O) ONE ROAD CONSTRUCTION AHEAD SIGN 36 x 36 (900x900) WITH A FLASHER AND FLAG MOUNTED ON IT APPROXIMATELY 200' (60 m) IN ADVANCE OF THE MAIN POLITY
- b) THE CLOSED PORTION OF THE MAIN ROUTE SHALL BE PROTECTED BY BLOCKING WITH TYPE I, TYPE II OR TYPE II BARRICADES, 1/3 OF THE CROSS SECTION OF THE CLOSED PORTION.
- 2. SIDE ROAD WITH A SPEED LIMIT GREATER THAN 40 MPH (60 km/h)
 AS SHOWN ON THE DRAWING AND AS DIRECTED BY THE ENGINEER:
- O) ONE ROAD CONSTRUCTION AHEAD SIGN 48 x 48 (1.2 m x 1.2 m) WITH A FLASHER MOUNTED ON 1T APPROXIMATELY 500' (150 m) IN ADVANCE OF THE MAIN ROUTE.
- b) THE CLOSED PORTION OF THE MAIN ROUTE SHALL BE PROTECTED BY BLOCKING WITH TYPE III BARRICADES, 1/2 OF THE CROSS SECTION
- 3. WHEN THE SIDE ROAD LIES BETWEEN THE BEGINNING OF THE MAINLINE SIGNING AND THE WORK ZONE, A SINGLE HEADED ARROW (MG-1) SHALL BE USED IN LIEU OF THE DOUBLE HEADED ARROW (MG-4).

SCALE: NONE

B. FOR A LANE CLOSURE ON A SIDE ROAD OR DRIVEWAY:

- USE APPLICABLE PORTIONS OF THE TYPICAL APPLICATION OF TRAFFIC CONTROL DEVICES (STD. 701501, STD. 701606 OR THE APPROPRIATE STANDARD). THE SPACING OF SIGNS AND BARRICADES SHALL BE ADJUSTED FOR FIELD CONDITIONS AS DIRECTED BY THE ENGINEER. THE DIRECTIONAL ARROW SHALL BE COVERED OR REMOVED WHEN NO LONGER CONSISTENT WITH THE SIDE ROAD LANE CLOSURE.
- C. ADVANCE WARNING SIGNS ARE TO BE OMITTED ON DRIVEWAY LINLESS OTHERWISE NOTED.
- D. THE TRAFFIC CONTROL AND PROTECTION FOR SIDE ROADS, INTERSECTIONS, AND DRIVEWAYS SHALL BE INCIDENTAL TO THE COST OF SPECIFIED TRAFFIC CONTROL STANDARDS OR ITEMS.

All dimensions are in millimeters (inches) unless otherwise shown.


FILE NAME = USER NAME = goglianobt DESIGNED - LHA REVISED - J. OBERLE 10-18-95
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| DRAWN - REVISED - A. HOUSEH 03-06-96
| PLOT SCALE = 58.808 '/ IN. CHECKED - REVISED - A. HOUSEH 10-15-96
| PLOT DATE = 1/4/288 | DATE - 06-89 | REVISED - T. RAMMACHER 01-06-06

STATE OF ILLINOIS
DEPARTMENT OF TRANSPORTATION


TRAFFIC CONTROL AND PROTECTION FOR
SIDE ROADS, INTERSECTIONS, AND DRIVEWAYS


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SIGNING FOR FLAGGING OPERATIONS AT WORK ZONE OPENINGS

WORK ZONE EXIT OPENING

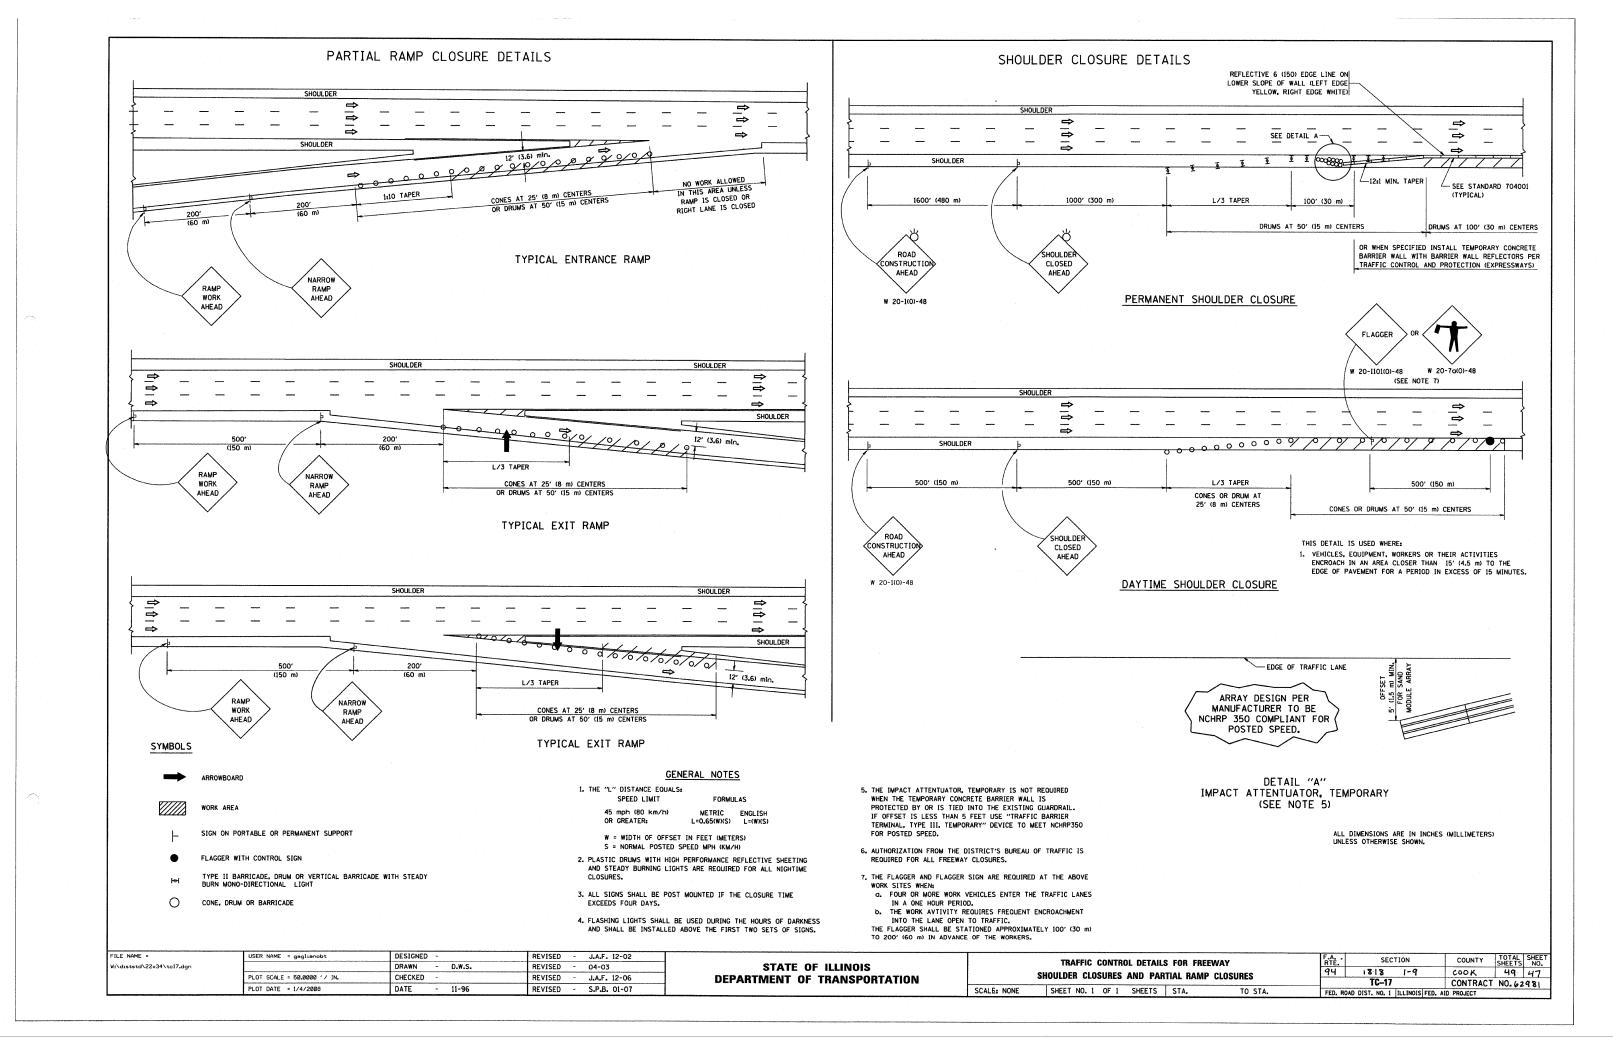

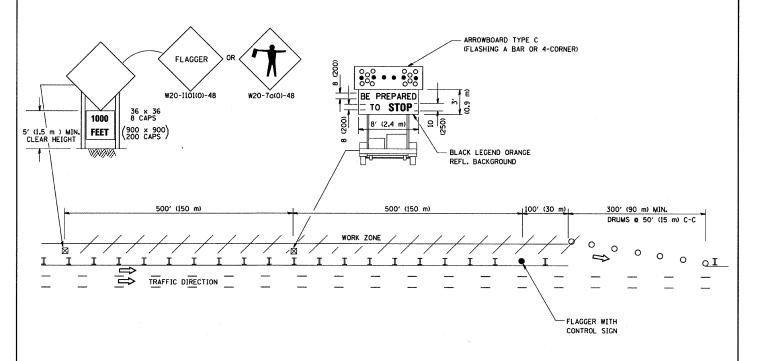


NOTES

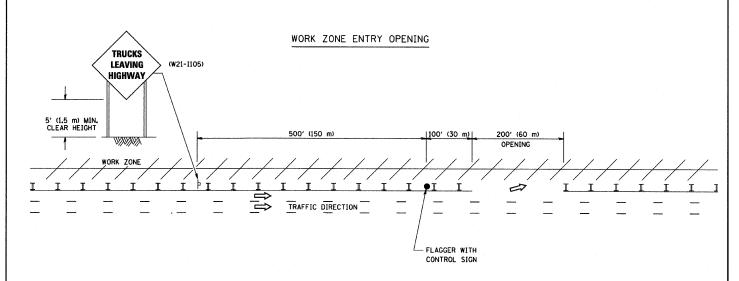- The Arrowboard, the Flagger Ahead trailer mounted sign, and the Trucks Leaving Highway sign shall be removed or turned away from traffic and the exit and entry openings shall be closed when the flagging operation ceases.
- 2. Work Zone Exit Openings should be a minimum of one half mile apart.
- Exiting the work zone at any place other than at a Work Zone Exit Opening will be prohibited.
- 4. All vehicles shall enter the work zone at entry openings, using their turn signals to warn motorists

ALL DIMENSIONS ARE IN INCHES (MILLIMETERS) UNLESS OTHERWISE SHOWN

FILE NAME =	USER NAME = gaglianobt	DESIGNED -	REVISED - D.W.S. 08-98		CIONINO POR FLACORIO OPERATIONO	F.A SECTION	COUNTY TOTAL SHEET
W:\diststd\22x34\tc18.dgn		DRAWN -	REVISED - J.A.F. 04-03	STATE OF ILLINOIS	SIGNING FOR FLAGGING OPERATIONS	RIE. SECTION	SHEETS NO.
	PLOT SCALE = 50.000 '/ IN.	CHECKED -	REVISED - J.A.F. 02-06	DEPARTMENT OF TRANSPORTATION	AT WORK ZONE OPENINGS	94 1818 1-9	COOK 49 48
	PLOT DATE = 1/4/2008	DATE -	REVISED - S.P.B. 01-07	DEFAITMENT OF THATOLOGICAL	SCALE: NONE SHEET NO. 1 OF 1 SHEETS STA. TO STA.	FED. ROAD DIST. NO. 1 ILLINOIS F	CONTRACT NO. 62981

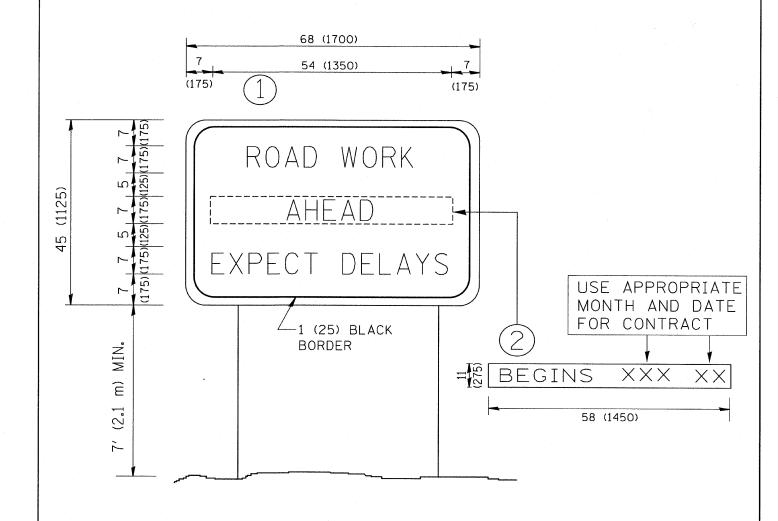

NOTES:

- 1. USE BLACK LETTERING ON ORANGE BACKGROUND.
- 2. ERECT SIGNS IN ADVANCE OF THE LOCATION FOR THE "ROAD CONSTRUCTION AHEAD" SIGN AT LOCATIONS AS DIRECTED BY THE ENGINEER.
- 3. ERECT SIGN (1) WITH INSTALLED PANEL (2) ONE WEEK PRIOR TO THE START OF CONSTRUCTION.
- 4. REMOVE PANEL 2 SOON AFTER THE START OF CONSTRUCTION.
- 5. SEE SPECIAL PROVISION FOR "TEMPORARY INFORMATION SIGNING" FOR ADDITIONAL INFORMATION.
- 6. ONE SIGN ASSEMBLY EQUALS 25.70 SQ. FT. (2.3 SQ. M.)
- 7. SHALL BE PAID FOR AS TEMPORARY INFORMATION SIGNING.

ALL DIMENSIONS ARE IN INCHES (MILLIMETERS) UNLESS OTHERWISE SHOWN.

FILE NAME =	USER NAME = gaglianobt	DESIGNED -	REVISED - R. MIRS 09-15-97
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	PLOT SCALE = 50.000 '/ IN.	CHECKED -	REVISED -T. RAMMACHER 02-02-99
	PLOT DATE = 1/4/2008	DATE ~	REVISED - C. JUCIUS 01-31-07

STATE OF ILLINOIS DEPARTMENT OF TRANSPORTATION

					AR	TERIAL RO	AD	
				H	NF	DRMATION	SIGN	
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	F.A. RTE.	SECTION	COUNTY	TOTAL SHEETS	SHEET NO.	
	94	1818 1-6	COOK	49	49	
_		TC-22	CONTRACT	CONTRACT NO. 62981		
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