FOR INDEX OF SHEETS, SEE SHEET NO. 2

STATE OF ILLINOIS **DEPARTMENT OF TRANSPORTATION DIVISION OF HIGHWAYS**

DAN RYAN EXPRESSWAY: ADT (2010) DESIGN SPEED POSTED SPEED 140.500 60 MPH 55 MPH SB 83RD STREET C-D EXIT RAMP 6,800 45 MPH 40 MPH 45 MPH 40 MPH

PROPOSED HIGHWAY PLANS

MAJOR CROSS STREETS **AND FRONTAGE ROADS:**

83RD STREET SOUTH LAFAYETTE AVENUE

SB 87TH STREET EXIT RAMP

SB I-94 (DAN RYAN)

POSTED SPEED ADT 13.700 30 MPH 6.400 30 MPH

F.A.I. ROUTE 94 (DAN RYAN EXPRESSWAY) **SECTION 1717 I-9** CONSTRUCTION OF FLUTED KNEE WALL ALONG LAFAYETTE AVE. FROM 85TH STREET TO 83RD STREET

COOK COUNTY

DESCRIPTION OF PROJECT

CONSTRUCTION OF FLUTED KNEE WALLS LOCATED WITHIN THE PROJECT LIMITS

C-91-238-05 F.A.I. 94 (RYAN) PROJECT LIMIT STA. 1289 + 11.91 (SB I-94) R. 14 E. PROJECT LOCATED IN THE CITY OF CHICAGO F.A.I. 94 (RYAN) PROJECT LIMIT

STA. 1273 + 74.31 (SB I-94)

FULL SIZE PLANS HAVE BEEN PREPARED USING STANDARD ENGINEERING SCALES; REDUCED SIZED PLANS WILL NOT CONFORM TO STANDARD SCALES. IN MAKING MEASUREMENTS ON REDUCED PLANS, THE ABOVE SCALES MAY BE USED

CHICAGO UTILITY ALERT NETWORK (312) 744-7000

CTA CONTACT: DAVID HEARD. MANAGER, CONSTRUCTION MANAGEMENT OVERSIGHT (312) 681-3862

CONTRACT NO. 62980

LOCATION MAP 1/2 MILE 1 MILE GROSS LENGTH OF PROJECT = 1537.60 FT. = 0.29 MI. MAP SCALE: 1" = 1/2 MILE NET LENGTH OF PROJECT = 1537.60 FT. = 0.29 MI.

T. 38 N.

T. 37 N.


LOCATION OF SECTION INDICATED THUS: --

94 1717 I-9 COOK

D-91-238-05

FED. ROAD DIST. NO. ILLINOIS FED. AID PROJECT

62980

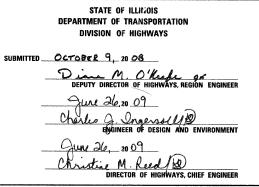

CONTRACT 26D



TY:LIN INTERNATIONAL PRINTED BY THE AUTHORITY OF THE STATE OF ILLINOIS

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5	EXISTING AND PROPOSED TYPICAL SECTIONS
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24 - 26	CITY OF CHICAGO STANDARD DETAILS - DETAILS OF CURB RAMPS FOR PEOPLE WITH DISABILITIES
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30	FLUTED KNEE WALL, SPECIAL STANDARD DETAILS
31 - 43	PROPOSED CROSS SECTIONS
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45	TC-10 DIST 1, TRAFFIC CONTROL AND PROTECTION FOR SIDE ROADS, INTERSECTIONS, AND DRIVEWAYS
46	TC-17 DIST 1, TRAFFIC CONTROL DETAILS FOR FREEWAY SHOULDER CLOSURES AND PARTIAL RAMP CLOSURES
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000001- <i>05</i>	STANDARD SYMBOLS, ABBREVIATIONS, AND PATTERNS
001001- <i>0</i> 2	AREAS OF REINFORCEMENT BARS
001006	DECIMAL OF AN INCH AND OF A FOOT
606001- 04	CONCRETE CURB AND COMBINATION CONCRETE CURB AND GUTTER
664001- <i>02</i>	CHAIN LINK FENCE
701456	PARTIAL EXIT RAMP CLOSURE FREEWAY/EXPRESSWAY
701601- <i>06</i>	URBAN LANE CLOSURE, MULTILANE, 1W OR 2W WITH NONTRAVERSABLE MEDIAN
701701- 06	URBAN LANE CLOSURE MULTILANE INTERSECTION
701801 - 04	LANE CLOSURE MULTILANE 1W OR 2W CROSSWALK OR SIDEWALK CLOSURE
701901 - 01	TRAFFIC CONTROL DEVICES

GENERAL NOTES:

- UTILITY LOCATIONS SHOWN ON THESE PLANS MAY NOT BE CORRECT OR COMPLETE. THE CONTRACTOR SHALL COORDINATE CONSTRUCTION ACTIVITIES WITH THE RESPECTIVE UTILITIES OF THE CITY OF CHICAGO AND THOSE PRIVATELY OWNED. BEFORE STARTING ANY EXCAVATION, THE CONTRACTOR SHALL CALL THE CHICAGO UTILITY ALERT NETWORK AT (312) 744-7000 FOR FIELD LOCATIONS OF BURIED ELECTRIC, TELEPHONE, CABLE, AND GAS FACILITIES (48 HOURS NOTIFICATION IS REQUIRED). CONTACT THE CHICAGO DEPARTMENT OF WATER MANAGEMENT PERMIT SECTION AT (312) 747-7893 FOR WATER AND SEWED LOCATIONS PERMIT SECTION AT (312) 747-7893 FOR WATER AND SEWER LOCATIONS.
- 2. WHERE SECTION OR SUBSECTION MONUMENTS ARE ENCOUNTERED, THE ENGINEER SHALL BE NOTIFIED BEFORE SUCH MONUMENTS ARE REMOVED. THE CONTRACTOR SHALL PROTECT AND CAREFULLY PRESERVE ALL PROPERTY MARKERS AND MONUMENTS. THE ENGINEER OR AN AUTHORIZED SURVEYOR AGENT WILL WITNESS OR OTHERWISE REFERENCE AND RESET MONUMENTS AS NECESSARY. ALL PROPERTY CORNERS EXCEPT THOSE WITHIN AREAS WHERE THE SCHEDULE, IF PROVIDED, SHOWS PLACEMENT OF R.O.W. MARKERS SHALL REMAIN UNDISTURBED.
- 3. THE CONTRACTOR SHALL NOT SET UP A YARD OR FIELD OFFICE ON IDOT PROPERTY WITHOUT WRITTEN PERMISSION FROM IDOT.
- 4. THE CONTRACTOR SHALL TAKE ALL NECESSARY SAFETY PRECAUTIONS TO PROTECT AND PROVIDE ACCESS TO ABUTTING PROPERTY, UTILITIES, PEDESTRIANS, AND VEHICULAR TRAFFIC.
- 5. ALL ELEVATIONS SHOWN ARE BASED ON THE CHICAGO CITY DATUM OF 0.00, WHICH IS 579.19 FEET ABOVE MEAN TIDE NEW YORK. (NAVD 88)
- THE CONTRACTOR SHALL USE CARE IN GRADING OR EXCAVATING NEAR ANY AND ALL EXISTING ITEMS THAT WILL NOT BE REMOVED. ANY DAMAGE DONE TO EXISTING ITEMS BY THE CONTRACTOR SHALL BE REPAIRED BY THE CONTRACTOR AT THE CONTRACTOR'S OWN EXPENSE.
- 7. IT SHALL BE THE CONTRACTOR'S RESPONSIBILITY TO ENSURE THAT NO GAP REMAINS BETWEEN PROPOSED RELOCATED FENCING OR WHERE PROPOSED RELOCATED FENCING TERMINATES AND EXISTING FENCE REMAINS IN PLACE.
- 8. ALL EXISTING FENCE THAT IS REQUIRED TO BE REMOVED AND RE-ERECTED SHALL BE RELOCATED PRIOR TO THE START OF INSTALLATION OF THE PROPOSED KNEE WALL OR AS DIRECTED BY THE ENGINEER.
- THE LOCATIONS OF VARIOUS ITEMS SUCH AS PAVEMENT, RETAINING WALLS, AND DRAINAGE STRUCTURES BUILT IN CONTRACTS UNDER CONSTRUCTION ARE BASED ON THE PUBLISHED CONTRACT PLAN DRAWINGS AVAILABLE DURING DESIGN. THE CONTRACTOR SHALL VERIFY AS-BUILT CONDITIONS.
- 10. THE CONTRACTOR SHALL TAKE ALL NECESSARY PRECAUTIONS FOR THE PROTECTION OF EXISTING PLANT MATERIAL FOR WHICH THE CONTRACT DOES NOT PROVIDE REMOVAL. THE PROTECTION OF EXISTING PLANT MATERIAL SHALL BE DONE IN ACCORDANCE WITH THE REQUIREMENTS OF SECTION 201 OF THE STANDARD SPECIFICATIONS.
- 11. THE INTENT OF THE CONTRACT DOCUMENTS IS TO CONSTRUCT THE FLUTED KNEE WALL BEHIND THE EXISTING CURB AND GUTTER. ANY DAMAGE TO THE EXISTING CURB AND GUTTER SHALL BE REPAIRED TO THE ORIGINAL CONDITION OF THE CURB AND GUTTER OR REPLACED AT THE CONTRACTOR'S OWN EXPENSE.
- 12. THE ENGINEER SHALL BE ALLOWED ACCESS TO THE FIELD OFFICE IN USE FOR CONTRACT
- 13. THE CONTRACTOR SHALL PROVIDE ALL NECESSARY TRAFFIC CONTROL DEVICES NEEDED TO COMPLETE THE WORK. THIS WORK SHALL BE INCLUDED IN THE COST OF TRAFFIC CONTROL AND PROTECTION (SPECIAL).
- 14. THE CONTRACTOR SHALL NOT MAINTAIN A PERMANENT PARTIAL RAMP OR SHOULDER CLOSURE ALONG THE MAINLINE I-94 (DAN RYAN) FOR THE DURATION OF THIS PROJECT. ONLY TEMPORARY PARTIAL RAMP CLOSURES SHALL BE PERMITTED.
- 15. ALL CATCH BASINS IN THE CITY OF CHICAGO SHALL MEET THE CHICAGO DEPARTMENT OF WATER MANAGEMENT'S STANDARDS.
- 16. PERMITS FROM THE DEPARTMENT OF WATER MANAGEMENT ARE REQUIRED FOR ALL UNDERGROUND STORM, SANITARY AND COMBINED SEWER SYSTEM CONSTRUCTION, AND FOR ALL WORK INVOLVING ADJUSTMENT OF SEWER STRUCTURES. THE DEPARTMENT OF WATER MANAGEMENT'S PERMIT SHALL BE OBTAINED BY A LICENSED SEWER DRAIN LAYER PRIOR TO START OF CONSTRUCTION. THE LICENSED SEWER CONTRACTOR/SUBCONTRACTOR SHALL SUBMIT TWO SETS OF PLANS APPROVED BY THE DEPARTMENT OF WATER MANAGEMENT FOR THE ISSULANCE OF THE SEWER PERMIT TO BURBALU OF ENGINEERING SERVICES-SEWER SECTION, JARDINE PURIFICATION PLANT, EL+51, ROOM 313, 1000 E. OHIO ST., CHICAGO, IL GOGII. INSPECTION WILL BE PROVIDED BY THE DEPARTMENT OF WATER MANAGEMENT.
- 17. THE RESIDENT ENGINEER AND THE CONTRACTOR SHALL FIELD VERIFY THE CITY'S EXISTING SEWER FACILITIES IN THE LIMITS OF THE REFERENCED PROJECT FOR ANY CONFLICTS DUE TO THE PROPOSED IMPROVEMENT. ANY CONFLICT SHALL BE RESOLVED WITH THE DEPARTMENT OF WATER MANAGEMENT PRIOR TO START OF CONSTRUCTION.
- 18. IN CASE OF DAMAGE TO CITY OF CHICAGO SEWERS, PRIVATE AND PUBLIC DRAINS, SEWER STRUCTURES AND/OR BENCH MONUMENTS, THE CONTRACTOR SHALL IMMEDIATELY CONTACT THE DEPARTMENT OF WATER MANAGEMENT AT (312) 744-0409 OR (312) 744-0408.
- 19. PERFORATED LIDS SHALL BE PLACED ON ALL SEWER MANHOLES AND CATCH BASINS.
- 20. NIGHT OPERATIONS SHALL NOT BE ALLOWED
- 21. LOCATION OF THE ELECTRICAL EQUIPMENT, INSTALLED BY CONTRACT 62583, IS APPROXIMATE.
 THE RESIDENT ENGINEER AND THE CONTRACTOR SHALL FIELD VERIFY THE EXACT LOCATION OF
 ALL ELECTRICAL ITEMS WITHIN THE PROJECT LIMITS WITH THE IDOT ELECTRICAL REPRESENTATIVE
 PRIOR TO THE START OF CONSTRUCTION. THE COST SHALL BE INCLUDED IN THE COST OF MOBILIZATION,

GENERAL NOTES (CONT.):

F.A.I. RTE.	SECTION	COUNTY	TOTAL SHEETS	SHEET NO.
94	.717 I-9	соок	48	2
STA	1273+74.31	TO STA. 1289	+11.91	L
FED. ROA	D DIST. NO.	ILLINOIS FED. AID	PROJECT	•

62980

22. CITY OF CHICAGO WATER VALVE VAULTS AND SEWER STRUCTURES SHALL NOT BE CLOSED, COVERED OR OTHERWISE OBSTRUCTED DURING CONSTRUCTION WITHOUT PRIOR WRITTEN PERMISSION FROM THE CITY OF CHICAGO DEPARTMENT OF WATER MANAGEMENT.

23. IN LOCATIONS WHERE THE MAIN SEWER IS NOT BEING REPLACED AND THE EXISTING DRAINAGE FACILITIES ARE DISTURBED OR DAMAGED DURING CONSTRUCTION BY THE CONTRACTOR. IT SHALL BE THE CONTRACTOR'S RESPONSIBILITY TO RESTORE AND REPLACE THE DAMAGED FACILITIES AT HIS/HER OWN EXPENSE TO THE SATISFACTION OF THE ENGINEER.

24. IT IS CALLED TO THE CONTRACTOR'S ATTENTION THAT HE/SHE SHALL BE REQUIRED TO OBTAIN AND PAY FOR ANY INSPECTION OR PERMIT FEES TO THE VARIOUS DEPARTMENTS OF THE CITY OF CHICAGO AND THE STATE OF ILLINOIS. THE COST FOR THESE FEES SHALL NOT BE PAID FOR SEPARATELY BUT SHALL BE CONSIDERED INCLUDED IN THE COST OF MOBILIZATION. PERMIT FEES SHALL BE PAID PRIOR TO COMMENCING CONSTRUCTION.

25. A PERMIT SHALL BE SECURED FROM THE BUREAU OF TRAFFIC PERMIT DIVISION, ROOM 804, CITY HALL AND BE INCLUDED IN THE COST OF MOBILIZATION, ADDITIONALLY, SEVEN (7) DAYS NOTICE SHALL BE GIVEN TO THE BUREAU OF TRAFFIC (312-744-0330) PRIOR TO STARTING ANY WORK OR MAKING ANY CHANGES IN THE TRAFFIC PATTERNS, ANY LANE OR ROADWAY CLOSURE INCLUDING DETOUR SHALL BE REVIEWED AND APPROVED BY THE BUREAU OF TRAFFIC.

26. A "BOXED" NOTE INDICATES AN ITEM OF WORK THAT IS NOT PAID FOR SEPARATELY, BUT IS PAID FOR AS PART OF ANOTHER ITEM LISTED IN THE SUMMARY OF QUANTITIES.

27. THE REMOVED AND RE-ERECTED EXISTING FENCE SHALL REMAIN IN ITS RELOCATED POSITION, AS SHOWN ON PLANS, AT THE END OF THIS CONTRACT. FUTURE CONTRACT *60A02 SHALL INSTALL THE PERMANENT FENCING ON THE KNEE WALL AND THEN REMOVE THE FENCE LEFT IN PLACE BY THIS CONTRACT.

28. THE CONTRACTOR SHALL PROTECT ALL BLUNT ENDS OF THE KNEE WALL FOR TRAFFIC SAFETY.
ALL TEMPORARY PROTECTION DEVICES USED FOR THIS PURPOSE SHALL BE NCHRP 350 COMPLIANT
AND AS DIRECTED BY THE ENGINEER.
THIS WORK SHALL BE INCLUDED IN THE COST OF TRAFFIC

CONTRACTOR ACCESS ASSUMPTIONS:

FOR FLUTED KNEE WALL CONSTRUCTION, ACCESS IS ASSUMED TO BE FROM THE FRONTAGE ROAD OR THE 83RD STREET C-D EXIT RAMP.

HOT-MIX ASPHALT MIXTURE REQUIREMENTS

ITEM	AC TYPE	VOIDS	RAP %
HMA REPLACEMENT OVER PATCHES (HMA BINDER IL-19 mm)	PG 64-22/ 58-22	4%@70 Gyr	15/25

THE UNIT WEIGHT USED TO CALCULATE ALL HMA SURFACE MIXTURE QUANTITIES IS 112/SQ YD/IN. USE 135 LB/SQ YD/IN. IF USING A SMA MIX.

WHEN RAP EXCEEDS 20%, THE NEW ASPHALT BINDER IN THE MIX SHALL BE PG 58-22.

REVISIONS ILLINOIS DEPARTMENT OF TRANSPORTATION DATE F.A.I. 94 (DAN RYAN EXPRESSWAY) INDEX OF SHEETS, INDEX OF STATE STANDARDS, GENERAL NOTES, CONTRACTOR ACCESS ASSUMPTIONS, AND HOT-MIX ASPHALT MIXTURE REQUIREMENTS

SCALE: NONE

DRAWN BY: JDF

TYLININTERNATIONAL

DATE: OCTOBER 17, 2008

CHECKED BY: JPM

PROJECT: KNEE WALLS ALONG LAFAYETTE AVENUE FROM 85TH STREET TO 83RD STREET COOK COUNTY/CITY OF CHICAGO

6298

SUMMARY OF QUANTITIES

CODE NUMBER	ITEM DESCRIPTION	UNIT	URBAN QUANTITY	100% STATE SFTY-4A
20100110	TREE REMOVAL (6 TO 15 UNITS DIAMETER)	UNIT	58	58
20100210	TREE REMOVAL (15 UNITS DIAMETER)	UNIT	96	96
20101000	TEMPORARY FENCE	FOOT	56	56
20200100	EARTH EXCAVATION	CU YD	300	300
20201200	REMOVAL AND DISPOSAL OF UNSUITABLE MATERIAL	CU YD	340	340
21101615	TOPSOIL FURNISH AND PLACE, 4"	SQ YD	439	439
21101645	TOPSOIL FURNISH AND PLACE, 12"	SQ YD	669	669
21101825	COMPOST FURNISH AND PLACE, 6"	SQ YD	669	669
25000210	SEEDING, CLASS 2A	ACRE	0.25	0.25
25000400	NITROGEN FERTILIZER NUTRIENT	POUND	10	10
25000500	PHOSPHORUS FERTILIZER NUTRIENT	POUND	10	10
25000600	POTASSIUM FERTILIZER NUTRIENT	POUND	10	10
25001800	SEEDING, CLASS 4 (MODIFIED)	ACRE	0.25	0.25
25100630	EROSION CONTROL BLANKET	SQ YD	1108	1108
25200200	SUPPLEMENTAL WATERING	UNIT	72	72
28000510	INLET FILTERS	EACH	12	12
40601005	HOT-MIX ASPHALT REPLACEMENT OVER PATCHES	TON	8	8
42001300	PROTECTIVE COAT	SQ YD	40	40
42400200	PORTLAND CEMENT CONCRETE SIDEWALK 5 INCH	SQ FT	151	151
44000500	COMBINATION CURB AND GUTTER REMOVAL	FOOT		
44000600	SIDEWALK REMOVAL		52	52
44002212	HOT-MIX ASPHALT REMOVAL OVER PATCHES, 3"	SQ FT	104	104
44004250		SQ YD	42	42
	PAVED SHOULDER REMOVAL	SQ YD	95	95
44201345	CLASS C PATCHES, TYPE III, 9 INCH	SQ YD	33	33
50200100	STRUCTURE EXCAVATION	CU YD	17	17
	CONCRETE STRUCTURES	CU YD	8	8
50300300	PROTECTIVE COAT	SQ YD	28	28
50800205	REINFORCEMENT BARS, EPOXY COATED	POUND	1140	1140
60202505	CATCH BASINS, TYPE A, 4'-DIAMETER, TYPE 1 FRAME, OPEN LID (CITY OF CHICAGO)	EACH	2	2
60255500	MANHOLES TO BE ADJUSTED	EACH	1	1

REVISIONS DATE	ILLINOIS DEPARTMENT OF TRANSPORTATION F.A.I. 94 (DAN RYAN EXPRESSWAY) SUMMARY OF QUANTITIES
	SCALE: NONE DRAWN BY: JDF DATE: OCTOBER 17, 2008 CHECKED BY: JPM

PROJECT: KNEE WALLS ALONG LAFAYETTE AVENUE FROM 85TH STREET TO 83RD STREET COOK COUNTY/CITY OF CHICAGO

SUMMARY OF QUANTITIES

CODE NUMBER	ITEM DESCRIPTION	UNIT	URBAN QUANTITY	100% STATE SFTY-4A
60500050	REMOVING CATCH BASINS	EACH	2	2
60500060	REMOVING INLETS	EACH	2	2
60600605	CONCRETE CURB, TYPE B	FOOT	13	13
63200310	GUARDRAIL REMOVAL	FOOT	57	57
66410400	CHAIN LINK FENCE TO BE REMOVED AND RE-ERECTED	FOOT	1436	1436
67100100	MOBILIZATION	L SUM	1	1
70101800	TRAFFIC CONTROL AND PROTECTION (SPECIAL)	L SUM	1	1
X0326/43	FLUTED KNEE WALL (SPECIAL)	FOOT	48	48
X0326311	RELOCATE EXISTING SIGN PANEL (SPECIAL)	EACH	3	3
X0326/44	TACTILE/DETECTABLE WARNING SURFACE	SQ FT	8	8
X0322256	TEMPORARY INFORMATION SIGNING	SQ FT	52	52
X0324640	FLUTED KNEE WALL	FOOT	1356	1356
X0324864	DRAIN CONNECTIONS	FOOT	20	20
X2500322	SEEDING, CLASS 5A (MODIFIED)	ACRE	0.25	0.25
X6065740	CONCRETE MEDIAN SURFACE, 5" (MODIFIED)	SQ FT	94	94
XX104800	COMBINATION CONCRETE CURB AND GUTTER, TYPE B-V.12	FOOT	52.0	52.0
Z0013798	CONSTRUCTION LAYOUT	L SUM	1	1

F.A.I. RTE.	SECTION	i	COUNTY	TOTAL SHEETS	SHEET NO.
94	1717 I-9	•	COOK	48	4
STA.	1273+74.31	TO	STA. 1289	+11.91	L
FED. RO	DAD DIST. NO	ILLINOIS	FED. AID	PROJECT	

62980

EARTHWORK SCHEDULE

LOCA	EARTH	REM. & DISP.			
ALIGNMENT	STATION	TO STATION	EXCAVATION (CU YD)	UNSUITABLE (CU YD)	
SB I-94 (DAN RYAN EXPY)	1273+74.3	1285+42.8	265.0	265.0	
SB I-94 (DAN RYAN EXPY)	1286+40.4	1289+02.0	35.0	75.0	
, ,		TOTALS	300.0	340.0	


TREE REMOVAL (6 TO 15 UNITS)


		TREE REMOV					
	AL	IGN	MENT		STATION	OFFSET	6-15 (UNIT)
SB	I-94 (DAN	RYAN	EXPY)	1279+06.07	123.1′ LT	10
SB	I-94 (DAN	RYAN	EXPY)	1279+89.69	122.1′ LT	12
SB	I-94 (DAN	RYAN	EXPY)	1280+50.96	122.8′ LT	6
SB	I-94 (DAN	RYAN	EXPY)	1280+50.96	122.8′ LT	6
SB	I-94 (DAN	RYAN	EXPY)	1281+16.29	122 .4 ′ LT	8
SB	I-94 (DAN	RYAN	EXPY)	1282+44.54	124.0′ LT	10
SB	I-94 (DAN	RYAN	EXPY)	1282+64.20	124.0' LT	6
						TOTAL	58


TREE REMOVAL (>15 UNITS)


LOCAT	TREE REMOV		
ALIGNMENT	STATION	OFFSET	(UNIT)
SB I-94 (DAN RYAN EXPY)	1279+59.11	122.0' LT	30
SB I-94 (DAN RYAN EXPY)	1279+97.77	122.5′ LT	17
SB I-94 (DAN RYAN EXPY)	1280+21.92	123.8' LT	19
SB I-94 (DAN RYAN EXPY)	1281+68.53	122.6' LT	30
		TOTAL	96

REVISIONS NAME DATE	1	NT OF TRANSPORTATION	
	F.A.I. 94 (DAN RYAN EXPRESSWA SUMMARY OF QUANTITIES AND		
	SCHEDULE C	OF QUANTITIES	
	SCALE: NONE	DRAWN BY: JDF	
	DATE: OCTOBER 17, 2008	CHECKED BY: JPM	

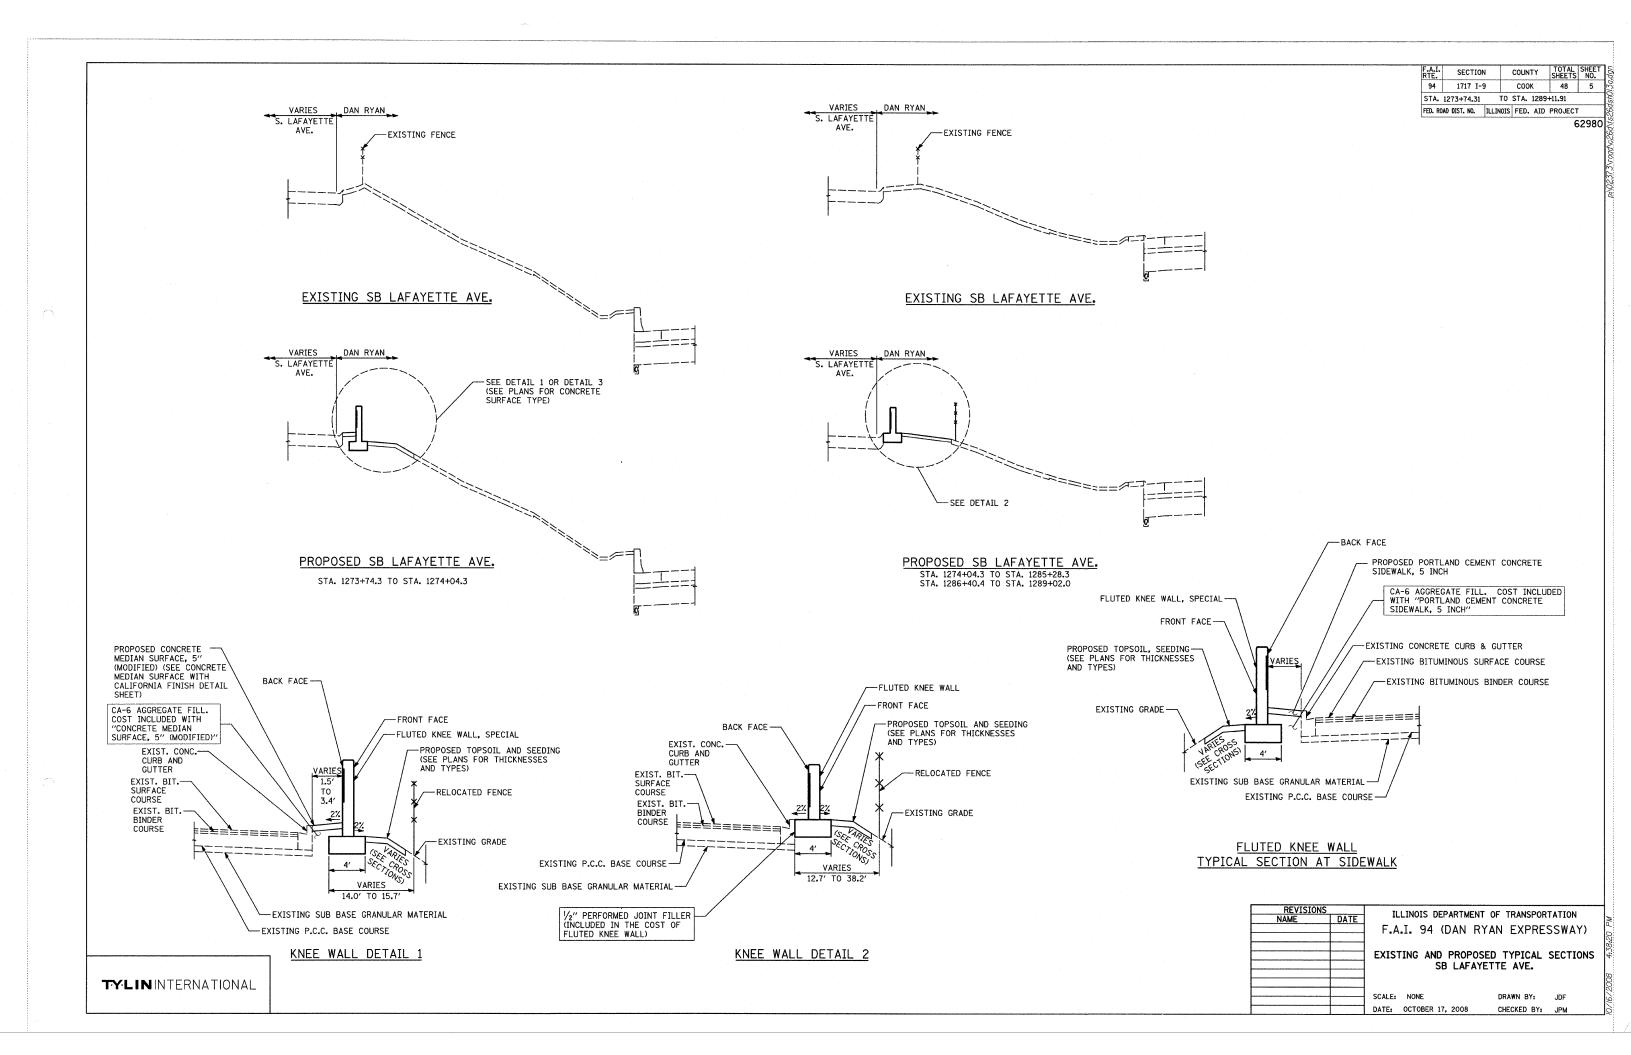

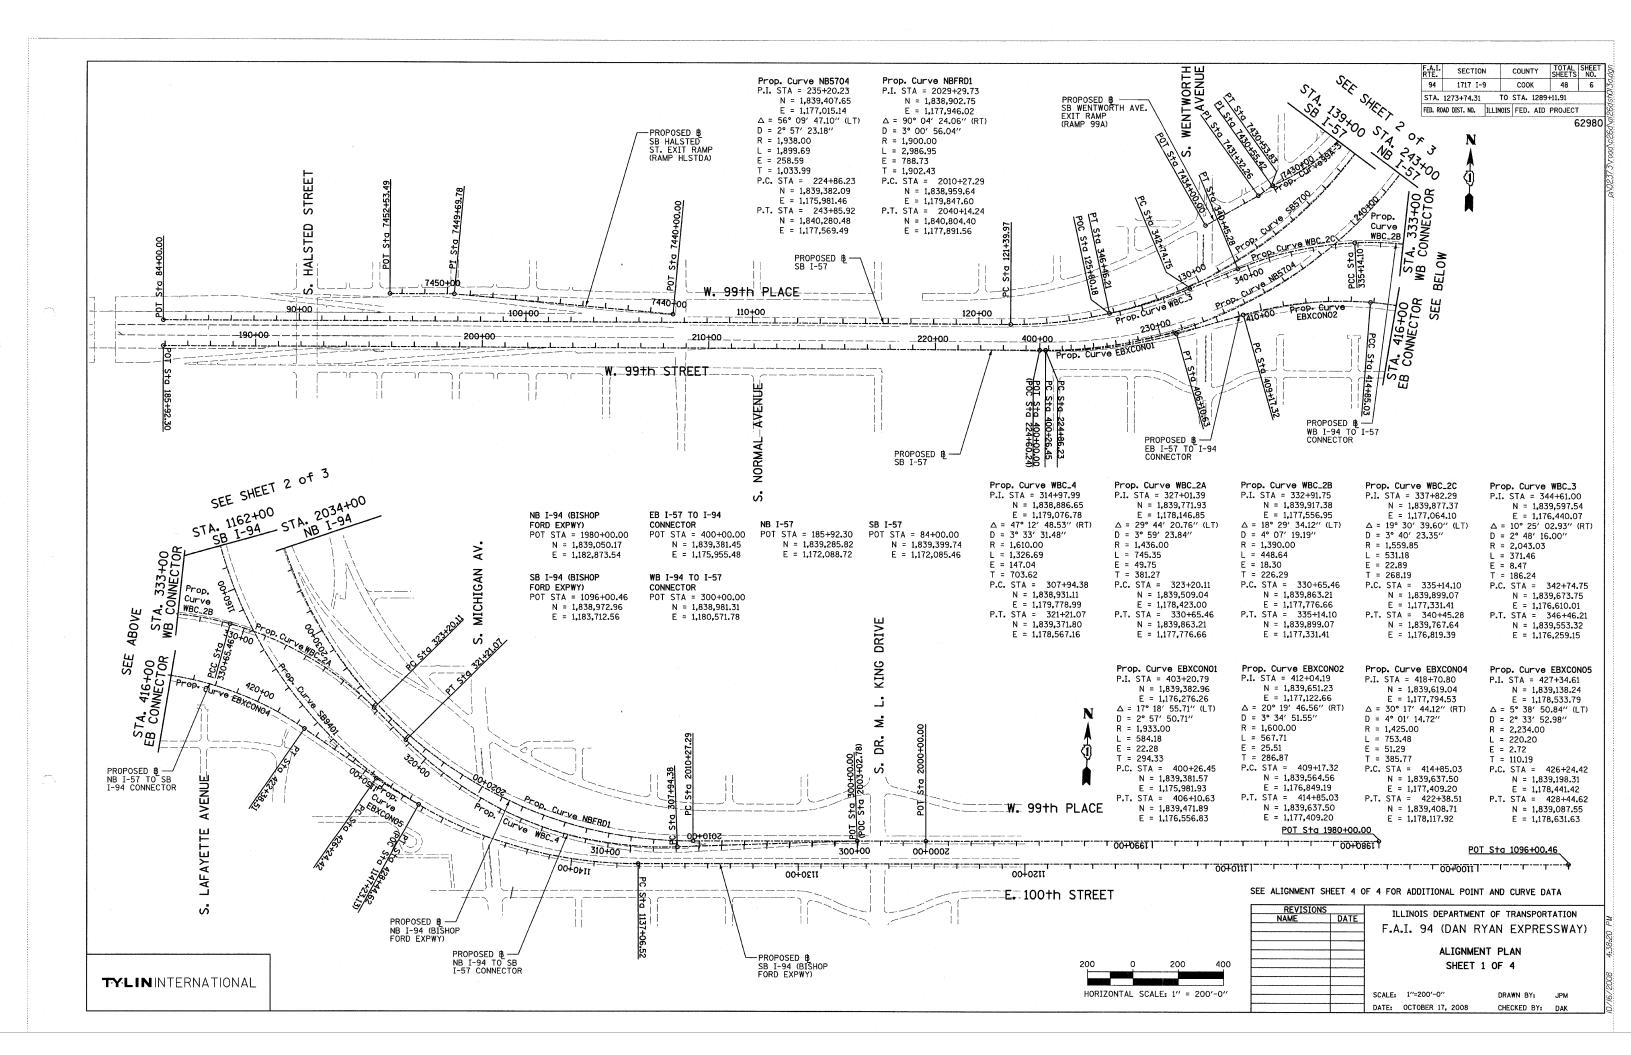

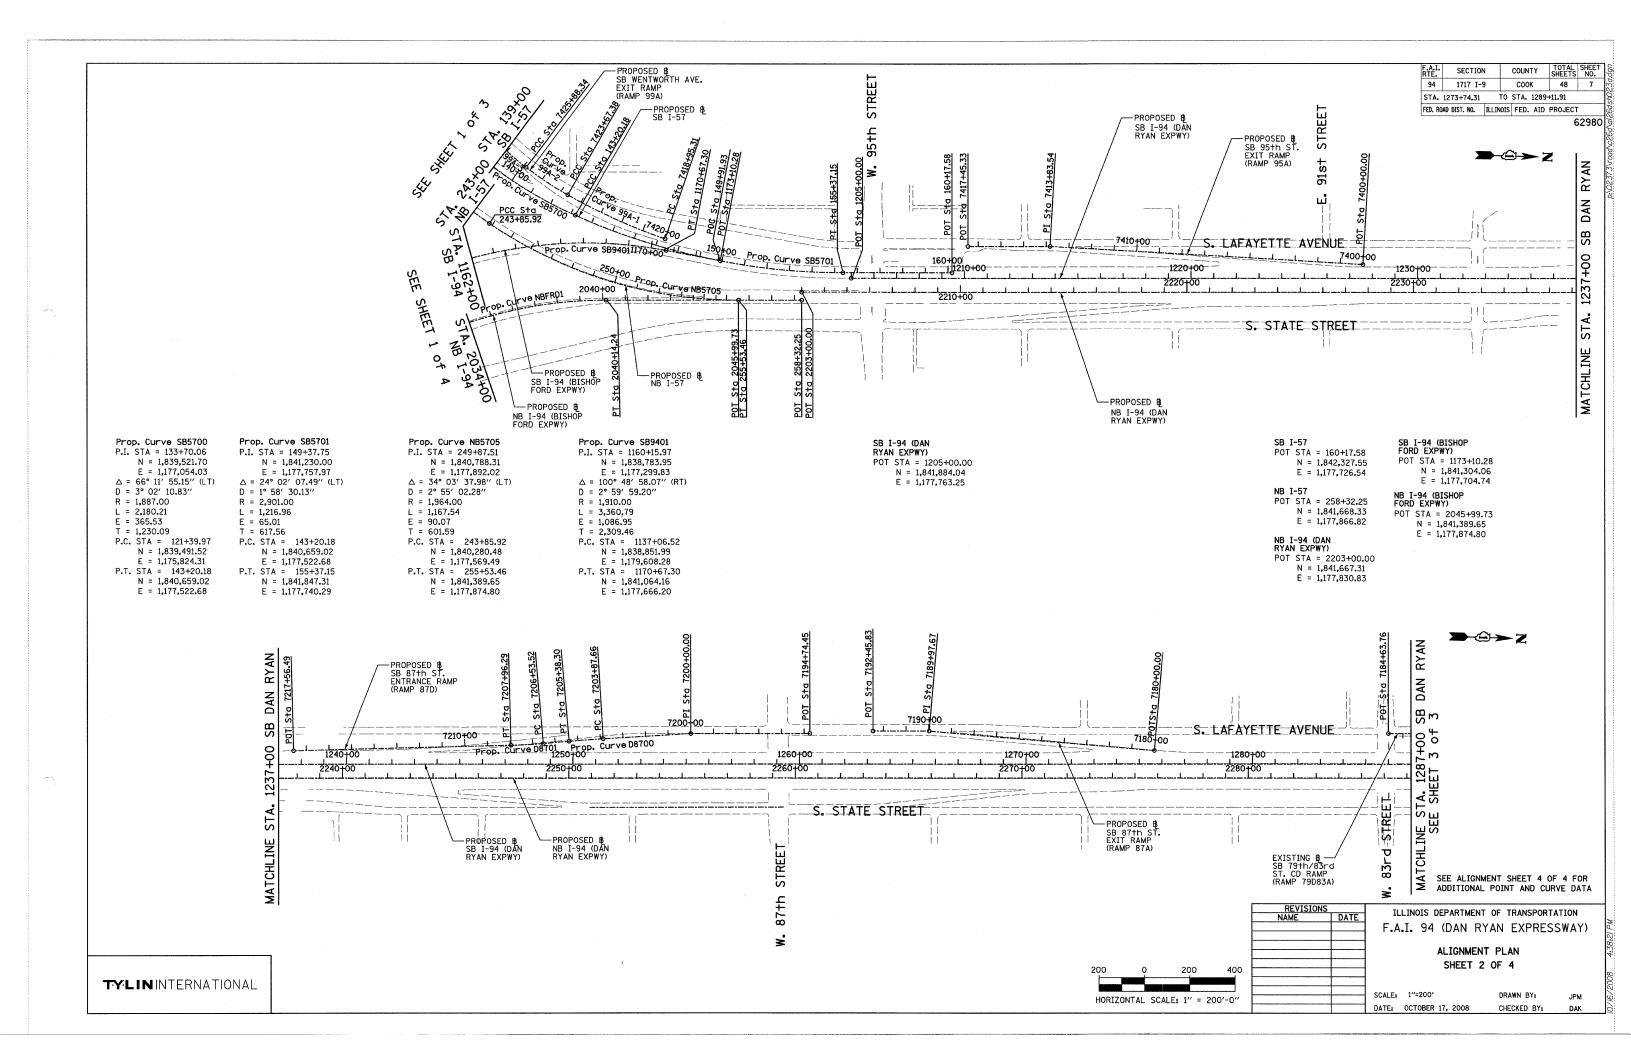

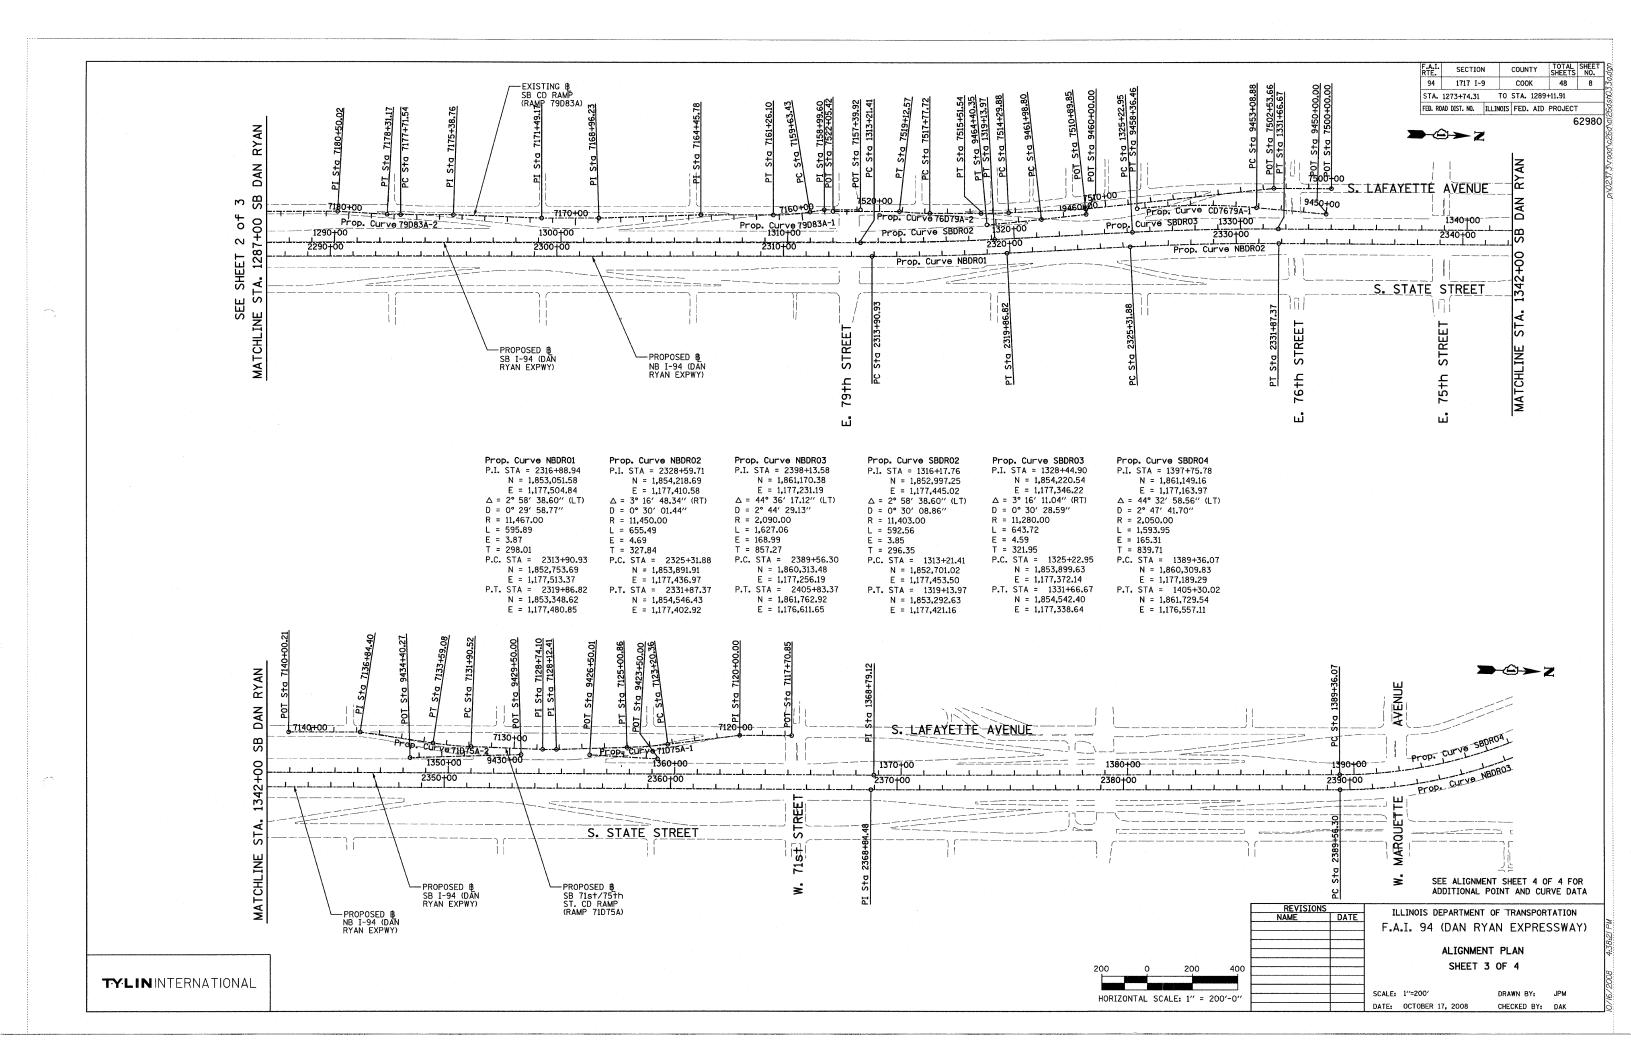

SB C-D RAMP (RAMP 79D83A) Prop. Curve 79D83A-1 Prop. Curve 79D83A-2 P.I. STA = 7160+44.94 P.I. STA = 7178+01.36N = 1.852.394.55N = 1.850.638.94POT STA = 7157 + 39.92N = 1,852,696.86E = 1.177.390.59E = 1.177.340.32E = 1,177,308.11 $\Delta = 9^{\circ} 19' 12.90'' (RT)$ $\Delta = 3^{\circ} 24' 57.69'' (RT)$ D = 5° 43′ 46.48″ P.I. STA = 7158+99.60 R = 1,000.00N = 1,852,537.24L = 59.62E = 1.177.312.68P.I. STA = 7164+45.78 F = 0.44N = 1,851,993.52T = 29.82 $\Xi = 1,177,351.80$ P.C. STA = 7159+63.43 P.C. STA = 7177+71.54 N = 1,852,474.58N = 1,850,668.74P.I. STA = 7168+96.23 E = 1,177,324.82E = 1,177,389.73N = 1.851.543.85P.T. STA = 7161+26.10 P.T. STA = 7178+31.17 E = 1,177,378,34 N = 1.852.313.07 N = 1.850.609.13 P.I. STA = 7171+49.17N = 1.851.291.02 E = 1.177.342.65 E = 1.177.389.66 E = 1,177,385.58P.I. STA = 7175+38.76 N = 1,850,901.43E = 1,177,383.07 P.I. STA = 7180+50.02 N = 1.850.390.38E = 1,177,382.88 POT STA = 7184+63.76 N = 1,849,976.81E = 1,177,394.72Prop. Curve 76D79A-2 SB 76th/79th ST. CD EXIT CONNECTOR (CD7679A) Prop. Curve 76D79A-1 P.I. STA = 7514+90.72P.I. STA = 7518+45.22 N = 1,853,290.06N = 1,852,935.69POT STA = 7500+00.00 POT STA = 9450+00-00 E = 1,177,306.25E = 1,177,316.40N = 1.854.771.42N = 1.854.751.70 $\Delta = 2^{\circ} 48' 22.72'' (RT)$ $\Delta = 6^{\circ} 31' 33.29'' (RT)$

 $D = 4^{\circ} 50' 21.01''$

P.C. STA = 7517+77.72

P.T. STA = 7519+12.57

N = 1.853.003.16

E = 1.177.314.47

N = 1,852,868.44

E = 1,177,310.65

E = 1,177,164.79

R = 1.184.00

L = 134.86

T = 67.50

E = 1.92

 $D = 2^{\circ} 18' 23.74''$

P.C. STA = 7514+29.88

P.T. STA = 7515+51.54

N = 1.853.350.72

E = 1,177,301.54

N = 1,853,229.24

E = 1,177,307.99

E = 1,177,159.94

R = 2.484.00

L = 121.66

T = 60.84

POT STA = 9460+00.00 N = 1.853.693.06E = 1,177,298.94 E = 1,177,267.37Prop. Curve CD7679A-1 Prop. Curve CD7679B-1 P.I. STA = 9455+73.58P.I. STA = 9463+19.58 N = 1,854,179.28N = 1,853,376.57 F = 1.177.230.83 E = 1,177,343.27 $\Delta = 11^{\circ} 37' 34.33'' \text{ (LT)}$ $\Delta = 1^{\circ} 13' 13.54'' (RT)$ D = 2° 12′ 13.26″ D = 0° 30′ 18.91″ R = 2,600.00R = 11,340.00 L = 241.55E = 0.64T = 120.78P.C. STA = 9453+08.88 P.C. STA = 9461+98.80 N = 1,854,443.44N = 1,853,496.18 E = 1,177,247.69E = 1,177,326.52P.T. STA = 9458+36.46 P.T. STA = 9464+40.35 N = 1,853,917.14 E = 1,177,267.55 N = 1,853,256.63

(CD7679B)

SB 76th/79th ST. CD ENTRANCE CONNECTOR

SB 71st/75th ST. CD RAMP (RAMP 71D75A)

POT STA = 7117+70-85 N = 1.857.886.40 E = 1,177,086.26P.I. STA = 7120+00.00 N = 1,857,657.31E = 1,177,091.65P.I. STA = 7128+12.41 N = 1.856.850.29E = 1.177.177.64 P.I. STA = 7128+74.10 N = 1,856,788.62E = 1,177,179.10P.I. STA = 7136+84.40

N = 1.855.981.27

E = 1,177,124.75

E = 1.177.132.18

POT = 7140+00.21 N = 1,855,665.56

Prop. Curve 71D75A-1 Prop. Curve 71D75A-2 P.I. STA = 7124+10.68 P.I. STA = 7132+74.89N = 1.857.251.52 N = 1.856.387.85E = 1,177,154.81E = 1.177.175.17 $\Delta = 5^{\circ} 35' 23.99'' (RT)$ $\Delta = 6^{\circ} 30' 28.18'' (RT)$ D = 3° 05′ 49.45″ D = 3° 51′ 39.25″ R = 1.850.00R = 1,484.001 = 180.491 = 168.56 E = 2.20E = 2.40T = 90.32T = 84.37P.C. STA = 7123+20.36 P.C. STA = .7131+90.52N = 1,857,340.76N = 1,856,472.22E = 1,177,140.92E = 1,177,176.00P.T. STA = 7125+00.86P.T. STA = 7133+59.08 N = 1,857,161.34N = 1,856,304.13

SB 71st/75th ST. CD EXIT CONNECTOR (RAMP CD7175A)

L = 527.58

T = 264.70

E = 13.44

POT STA = 9423+50.00 N = 1,857,297.2866E = 1.177.207.4713 POT STA = 9426+50.0 N = 1,856,997.4225E = 1,177,198.1891

CD ENTRANCE CONNECTOR (RAMP CD7175B)
POT STA = 9429+50.00 N = 1.856.694.2083

E = 1,177,205.3235POT STA = 9434+40.27 N = 1,856,204.7281E = 1,177,233.1786

SB 87th ST. EXIT RAMP (RAMP 87A)

SB HALSTED ST. EXIT RAMP

(RAMP HLSTDA)

POT STA = 7440+00.00

N = 1,839,490.94

E = 1,174,333.70

N = 1.839.551.73

E = 1,173,365.83

N = 1,839,544.76

E = 1,173,082.20

Prop. Curve 99A-1

D = 2° 17′ 30.59″

R = 2,500.00

1 = 472.07

T = 236.74

F = 11.18

P.I. STA = 7421+32.05

N = 1.840.832.05

E = 1,177,544.75

D = 3° 22′ 13.22″

D = 2° 25′ 25.25″

N = 1,846,248.23

E = 1,177,546.37

N = 1,846,105.99

E = 1.177.558.32

P.T. STA = 7207+96.29

R = 2,364.00

L = 142.76

T = 71.40

E = 1.08

R = 1,700.00

L = 220.96

T = 110.64

F = 3.60

 $\Delta = 10^{\circ} 49' 08.53'' (RT)$

P.C. STA = 7418+95.31

N = 1,841,058.12

E = 1,177,615.03

N = 1.840.623.20

E = 1,177,433.29

P.T. STA = 7423+67.38

Prop. Curve D8700

P.I. STA = 7204+62.99

 $\Delta = 1^{\circ} 30' 03.72'' (LT)$

P.C. STA = 7203+87.66

P.T. STA = 7205+38.30

N = 1,846,512.58

E = 1.177.518.09

N = 1,846,362.71

E = 1.177.533.26

 $D = 0^{\circ} 59' 47.21''$

R = 5,750.00

= 150.64

E = 0.49

T = 75.32

N = 1.846.437.54

F = 1.177.524.69

POT STA = 7452+53.49

SB WENTWORTH AVE. EXIT RAMP (RAMP 99A)

POT STA = 7430+55.42

POT STA = 7431+32.26

E = 1,176,899.99 POT STA = 7434+00.00

SB 95th ST. EXIT RAMP (RAMP 95A)

POT STA = 7400+00.00

N = 1,844,139.73

E = 1,177,638.63

N = 1.842.756.77

N = 1.842.395.13

E = 1,177,608.95

P.I. STA = 7413+83.54

E = 1,177,598.60 POT STA = 7417+45.33

SB 87+h ST. ENTRANCE RAMP (RAMP 87D) POT STA = 7194+74.45

N = 1,847,424.06

E = 1,177,468.58

N = 1.846.898.74

E = 1,177,484.09

N = 1,845,147.17

E = 1,177,609.78

P.I. STA = 7200+00.00

POT STA = 7217+56.49

N = 1,840,141.17

E = 1,176,961.02

N = 1.840.094.48

N = 1,839,955.89

E = 1,176,670.92

P.I. STA = 7449+69.78

POT STA = 7180+00.00 N = 1,848,946.30E = 1,177,501.00P.I. STA = 7189+97.67 N = 1.847.950.35

E = 1.177.442.53POT STA = 7192+45.83 N = 1,847,702.29

E = 1,177,449.63

ILLINOIS DEPARTMENT OF TRANSPORTATION DATE F.A.I. 94 (DAN RYAN EXPRESSWAY)

ALIGNMENT PLAN SHEET 4 OF 4

DRAWN BY: JPA DATE: OCTOBER 17, 2008

TYLIN INTERNATIONAL

E = 1,177,357.48

SCALE: NO SCALE

CHECKED BY: JPM

TOTAL SHEET SHEETS NO.

62980

48

COUNTY

COOK


TO STA, 1289+11.91

SECTION

1717 I-9


FED. ROAD DIST. NO. ILLINOIS FED. AID PROJECT

STA. 1273+74.31

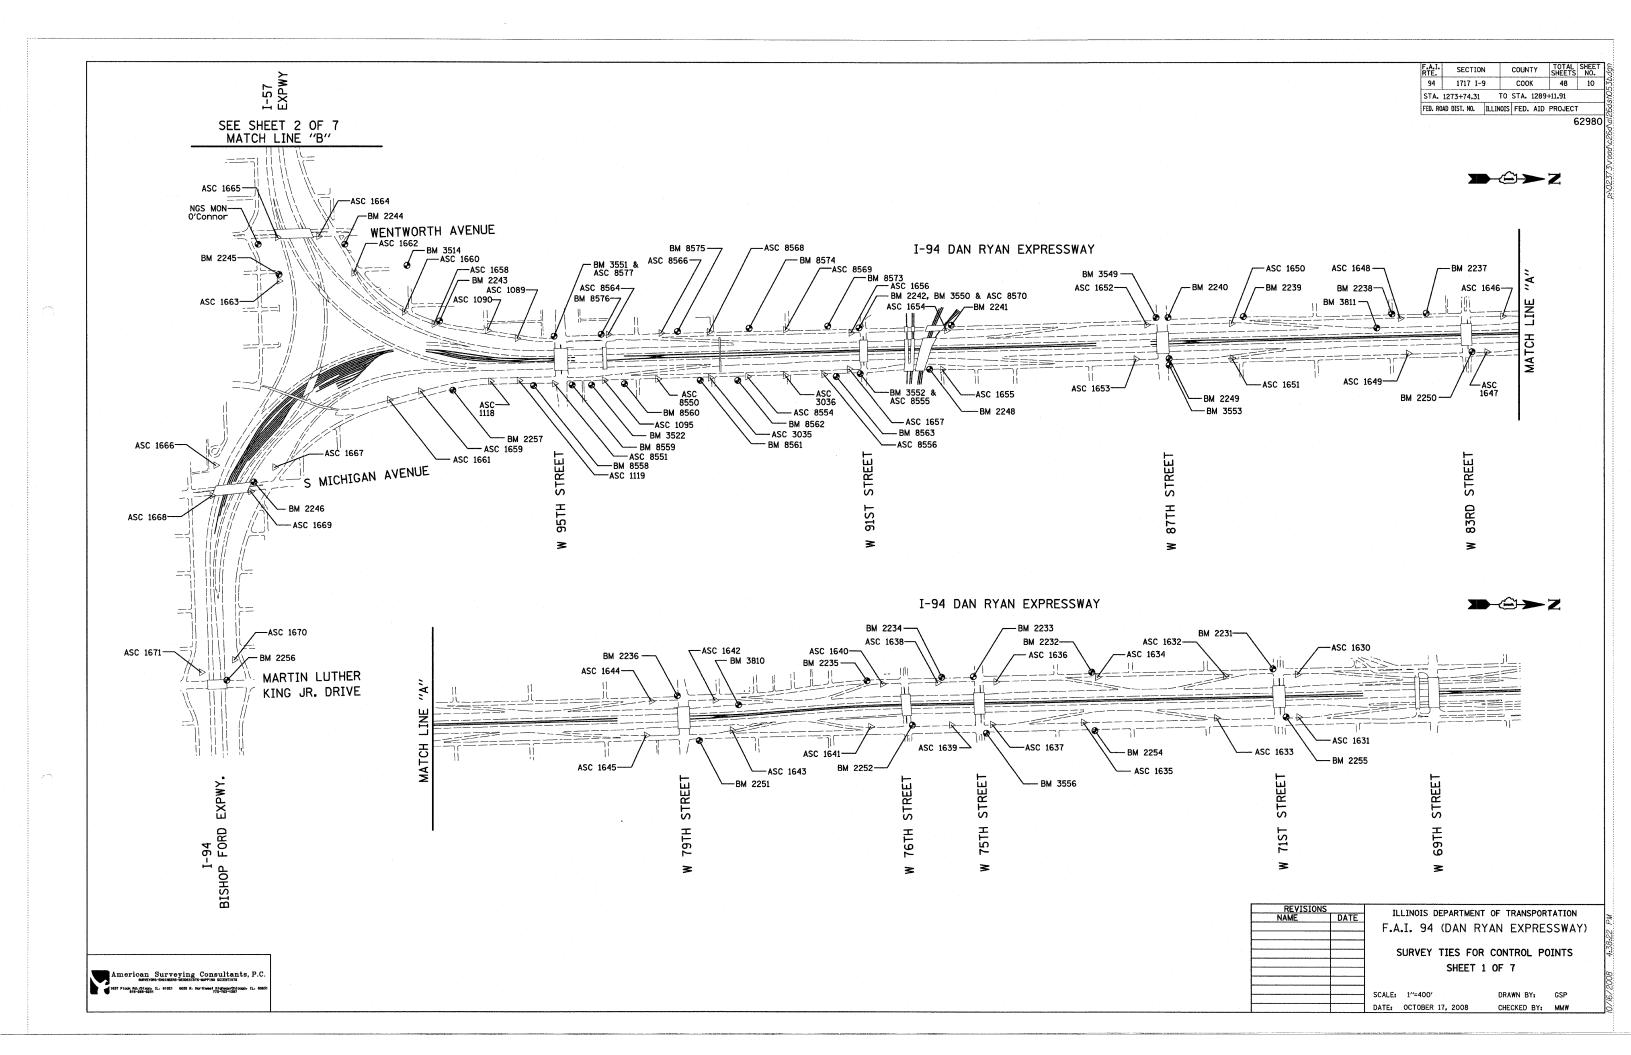


F.A.I. RTE.	SECTION	COUNTY	TOTAL SHEETS	SHEET NO.			
94	1717 I-9	COOK	48	11			
STA.	STA. 1273+74.31 TO STA. 1289+11.91						
FED. R	DAD DIST. NO. ILLII	NOIS FED. AID	PROJECT				


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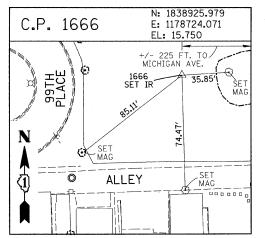


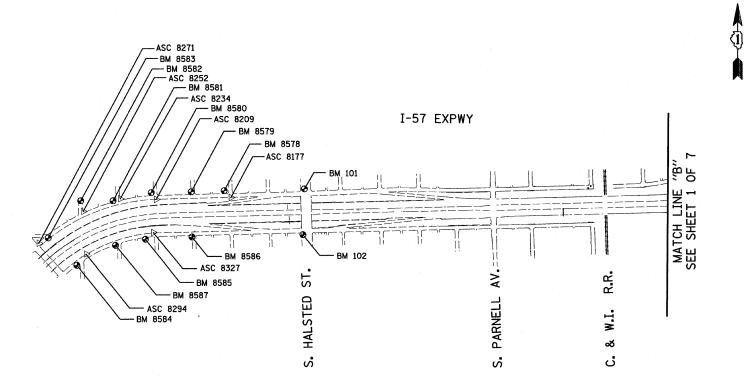
REVISIONS	THE THOSE DEPARTMENT	OF TRANSPORTATION		
NAME DATE	ILLINOIS DEPARTMENT OF TRANSPORTATION			
	F.A.I. 94 (DAN R)	YAN EXPRESSWAY)		
	CUDVEY TIES FOR	CONTROL POINTS		
	SURVEY ITES FOR	CONTROL POINTS		
	SHEET 2	2 OF 7		
	SHEET (Z OF I		
	SCALF: 1"=400"	DRAWN BY: GSP		
] SCALE: 1 -400	DRAWN DIE GSF		
	DATE: OCTOBER 17, 2008	CHECKED BY: MMW		


American Surveying Consultants, P.C.
SANCTORS-DESIGNES-EXCEDITES AMERICAN SCIENTISTS
11ST Flood, Br. (Floure, IL. 101St 1 903 S. Herthweet, Bighway/Chicago. II. Advan




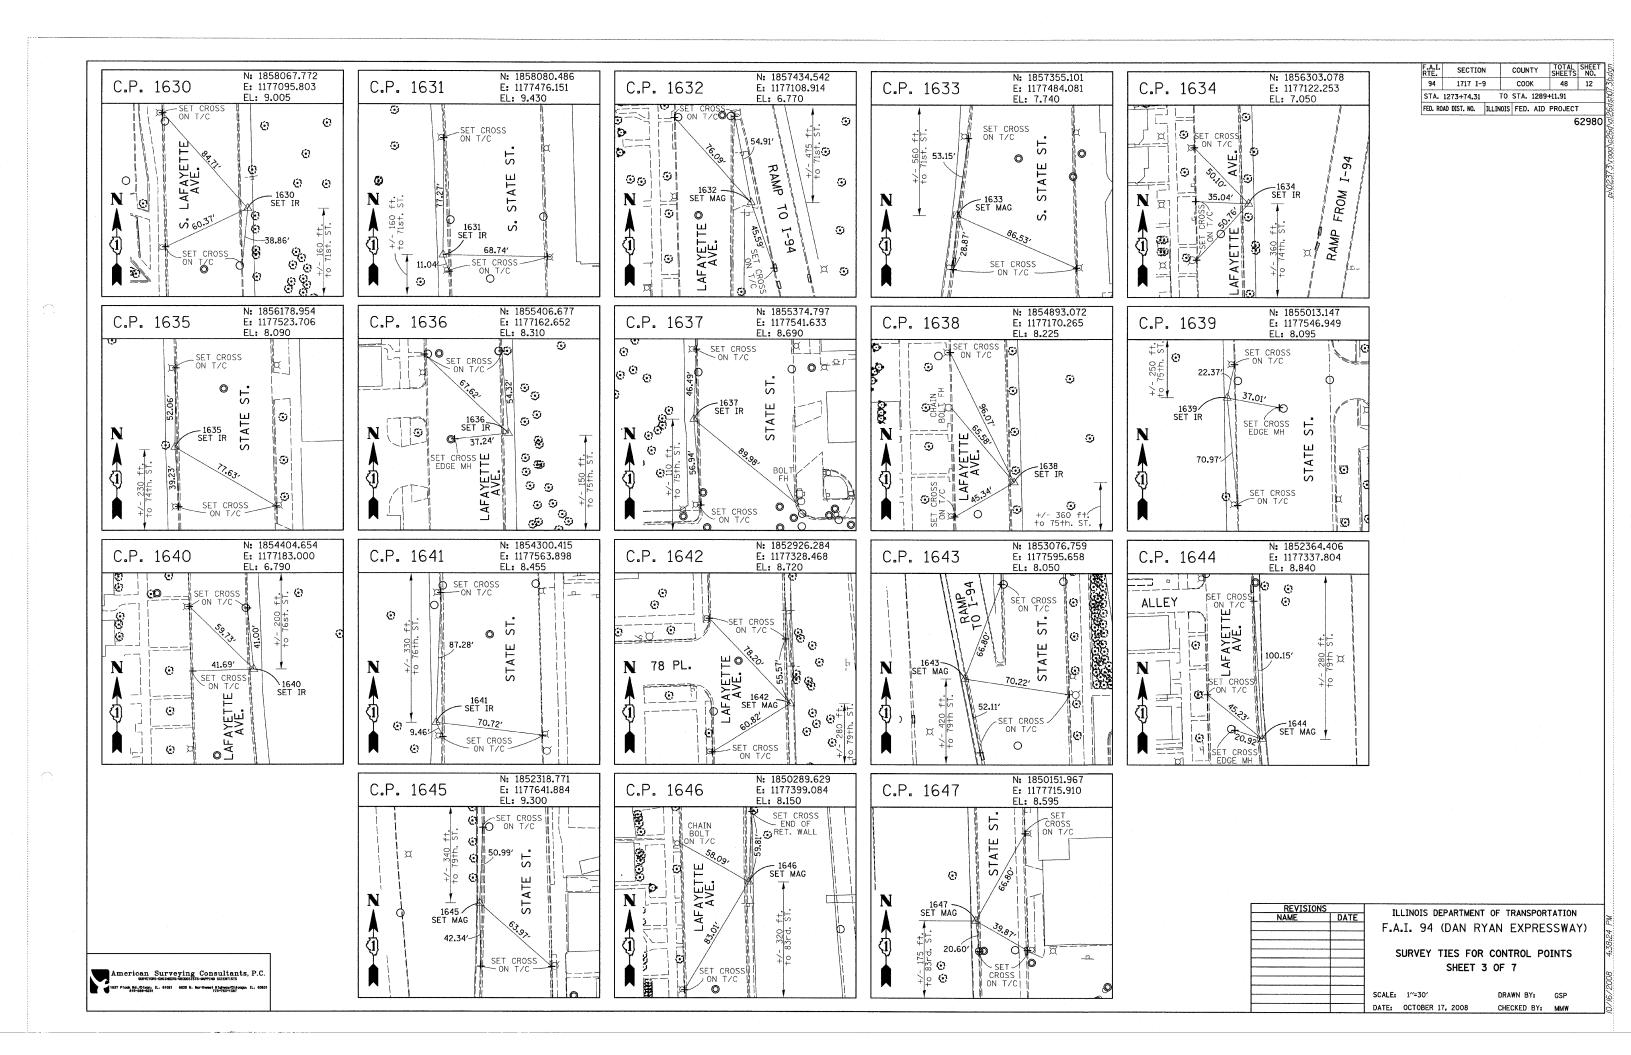


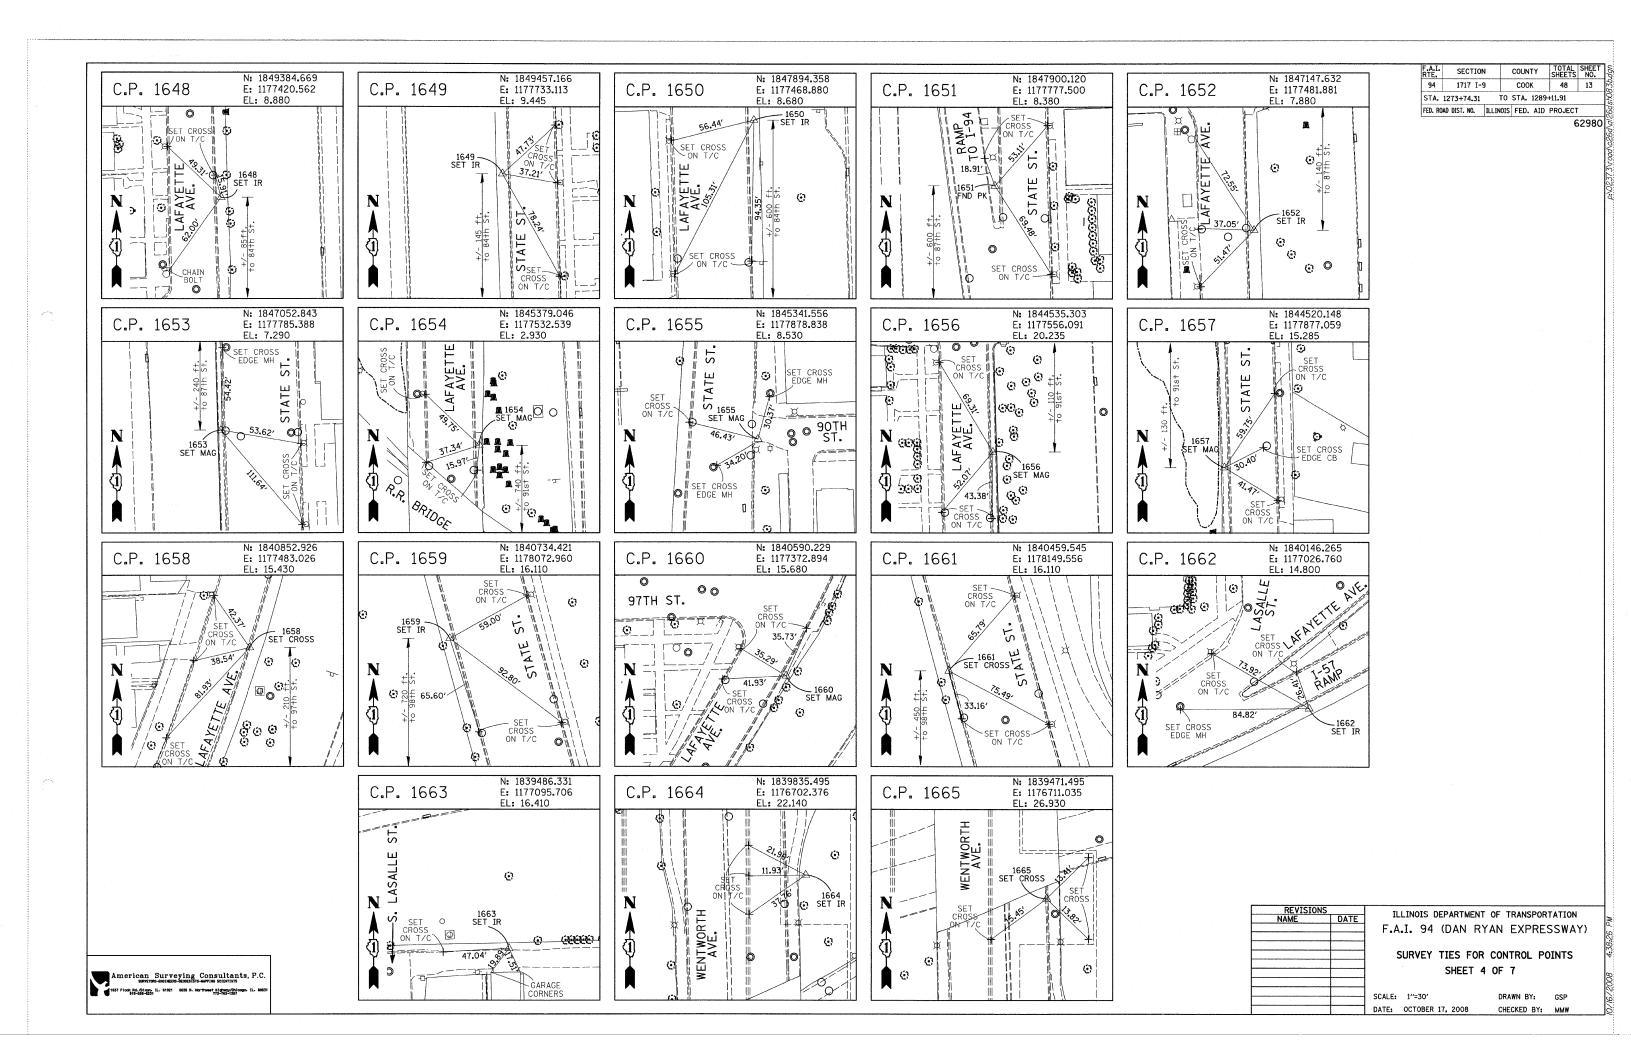

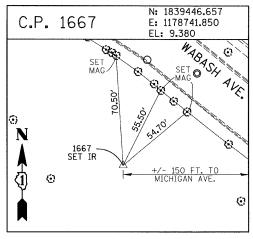

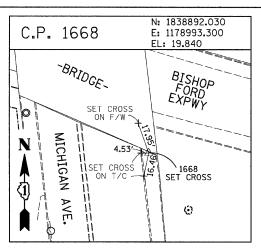


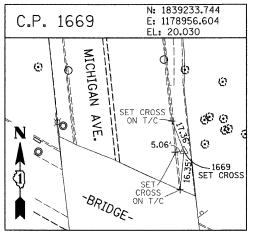

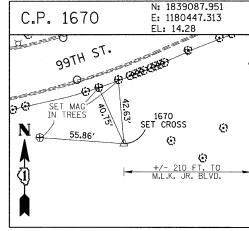

F.A.I. RTE.	SECTION	4	COUNT	Υ	TOTAL SHEETS	SHEET NO.
94	1717 I-9	9	COOK		48	14
STA.	1273+74.31	TO	STA. 1	289	+11.91	
FED. RO	DAD DIST. NO.	ILLINOIS	FED.	AID	PROJECT	

62980

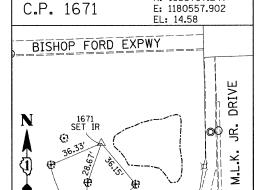

SET MAG

N: 1838797.247

PROJECT BENCHMARKS

BM 2231 ELEVATION= 10.24 FEET SET CROSS ON CHAIN BOLT OF FIRE HYDRANT ON THE SOUTHWEST CORNER OF 71ST STREET AND LAFAYETTE AVENUE.

BM 2232 ELEVATION= 8.46 FEET SET CROSS ON CHAIN BOLT OF FIRST FIRE HYDRANT SOUTH OF 73RD STREET ON THE WEST SIDE OF LAFAYETTE AVENUE. APPROXIMATELY 330 FEET SOUTH OF 73RD STREET.

BM 2233 ELEVATION= 9.90 FEET SET CROSS ON NORTHWEST BOLT OF FIRE HYDRANT ON THE NORTHWEST CORNER OF 75TH STREET AND LAFAYETTE AVENUE.

BM 2234 ELEVATION= 9.56 FEET SET CROSS ON CHAIN BOLT OF FIRST FIRE HYDRANT SOUTH OF 75TH STREET ON THE WEST SIDE OF LAFAYETTE AVENUE. APPROXIMATELY 320 FEET SOUTH OF 75TH STREET.

BM 2235 ELEVATION= 7.50 FEET SET CROSS ON CHAIN BOLT OF FIRST FIRE HYDRANT SOUTH OF 76TH STREET ON THE WEST SIDE OF LAFAYETTE, APPROXIMATELY 330 FEET SOUTH OF 76TH STREET.

BM 2236 ELEVATION= 10.41 FEET SET CROSS ON WEST BOLT OF FIRE HYDRANT ON THE SOUTHWEST CORNER OF 79TH STREET AND LAFAYETTE AVENUE.

BM 2237 ELEVATION= 9.20 FEET
SET CROSS ON CHAIN BOLT OF FIRST FIRE HYDRANT NORTH OF 83RD STREET
ON THE WEST SIDE OF LAFAYETTE AVENUE, APPROXIMATELY 350 FEET NORTH
OF 83RD STREET.

BM 2238 ELEVATION= 10.04 FEET SET CROSS ON CHAIN BOLT OF FIRE HYDRANT OF THE NORTHWEST CORNER OF 4TH STREET AND LAFAYETTE AVENUE.

BM 2239 ELEVATION= 9.59 FEET SET CROSS ON CHAIN BOLT OF SECOND FIRE HYDRANT NORTH OF 87TH STREET ON THE WEST SIDE OF LAFAYETTE AVENUE. APPROXIMATELY 720 FEET OF NORTH OF 87TH STREET.

BM 2240 ELEVATION= 9.49 FEET SET CROSS ON THE NORTHWEST BOLT OF FIRE HYDRANT ON THE SOUTHWEST CORNER OF 78TH STREET AND LAFAYETTE AVENUE.

BM 2241 ELEVATION= 3.63 FEET SET SQUARE CUT ON TOP OF CURB NEXT TO LIGHT POLE ON THE NORTHWEST CORNER OF LAFAYETTE AVENUE AND RAILROAD BRIDGE. APPROXIMATELY 770 FEET NORTH OF 91ST STREET.

BM 2242 ELEVATION= 22.82 FEET SET CROSS ON CHAIN BOLT OF FIRE HYDRANT ON THE SOUTHWEST CORNER OF 91ST STREET AND LAFAYETTE AVENUE.

BM 2243 ELEVATION= 15.68 FEET SQUARE CUT ON THE TOP OF CURB NEXT TO THIRD LIGHT POLE NORTH OF 97TH STREET ON THE WEST SIDE OF LAFAYETTE AVENUE, APPROXIMATELY 260 FEET NORTH OF 97TH STREET.

BM 2244 ELEVATION= 15.94 FEET
SET SQUARE CUT ON TOP OF CURB NEXT TO LIGHT POLE ON THE NORTH SIDE
OF 98TH STREET. APPROXIMATELY 120 FEET EAST OF WENTWORTH AVENUE.

BM 2245 ELEVATION= 16.35 FEET
SET SQUARE CUT ON THE EAST END OF CURB AT THE NORTHEAST CORNER OF
FIRST ALLEY NORTH OF 99TH STREET. APPROXIMATELY 35 FEET EAST OF LASALLE
STREET.

BM 2246 ELEVATION= 20.00 FEET STATE SOLARE CUT WITH CROSS ON TOP OF ABUTMENT WALL ON THE NORTHWEST CORNER OF STATE STREET BRIDGE OVER THE BISHOP FORD EXPRESSWAY. APPROXIMATELY 20 FEET NORTH OF THE NORTH EDGE OF THE BRIDGE.

BM 2248 ELEVATION= 9.77 FEET SET CROSS ON CHAIN BOLT OF FIRST FIRE HYDRANT NORTH OF RAILROAD BRIDGE ON THE EAST SIDE OF STATE STREET. APPROXIMATELY 110 FEET SOUTH OF 90TH STREET.

BM 2249 ELEVATION= 9.67 FEET SET CROSS ON CHAIN BOLT OF FIRE HYDRANT ON THE NORTHWEST CORNER OF 87TH AND STATE STREET.

BM 2250 ELEVATION= 10.03 FEET SET CROSS ON CHAIN BOLT OF FIRE HYDRANT ON THE NORTHWEST CORNER OF 83RD ST. AND STATE STREET.

BM 2251 ELEVATION= 10.95 FEET FOUND CROSS ON EAST BOLT OF FIRE HYDRANT ON THE EAST SIDE OF STATE STREET. APPROXIMATELY 135 FEET NORTH OF 79TH STREET.

BM 2252 ELEVATION= 10.02 FEET SET CROSS ON WEST BOLT OF FIRE HYDRANT ON THE NORTHWEST CORNER OF STATE STREET AND 76TH STREET.

BM 2254 ELEVATION= 9.17 FEET
SET CROSS ON CHAIN BOLT OF FIRST FIRE HYDRANT SOUTH OF 73RD STREET
ON THE EAST SIDE OF STATE STREET. APPROXIMATELY 330 FEET SOUTH OF
73RD STREET.

BM 2255 ELEVATION= 11.25 FEET
SET CROSS ON CHAIN BOLT OF FIRE HYDRANT ON THE NORTHWEST CORNER OF 71ST STREET AND STATE STREET.

BM 2256 ELEVATION= 16.36 FEET SET SQUARE CUT ON TOP OF ABUTMENT WALL ON THE NORTHWEST CORNER OF MARTIN LUTHER KING DRIVE BRIDGE OVER THE BISHOP FORD EXPRESSWAY. APPROXIMATELY 1 FOOT NORTH OF THE NORTH END OF THE BRIDGE.

BM 2257 ELEVATION= 18.25 FEET
SET CROSS ON NORTHEAST BOLT OF LIGHT POLE BASE ON THE EAST SIDE OF
STATE STREET. APPROXIMATELY 970 FEET SOUTH OF 95TH STREET.

BM 2258 ELEVATION= 10.53 FEET SET CROSS ON NORTHWEST BOLT OF LIGHT BASE ON NORTHWEST CORNER OF 71ST STREET AND LAFAYETTE AVENUE.


REVISIONS NAME	DATE	ILLINOIS DEPARTMENT OF TRANSPORTATION F.A.I. 94 (DAN RYAN EXPRESSWAY)
		SURVEY TIES FOR CONTROL POINTS

SHEET 5 OF 7

SCALE: 1"=30'
DATE: OCTOBER 17, 2008

DRAWN BY: GSP
CHECKED BY: MMW

American Surveying Consultants, P.C.
SANCTURE-DOS INSTITUTES OF STREET, STREET

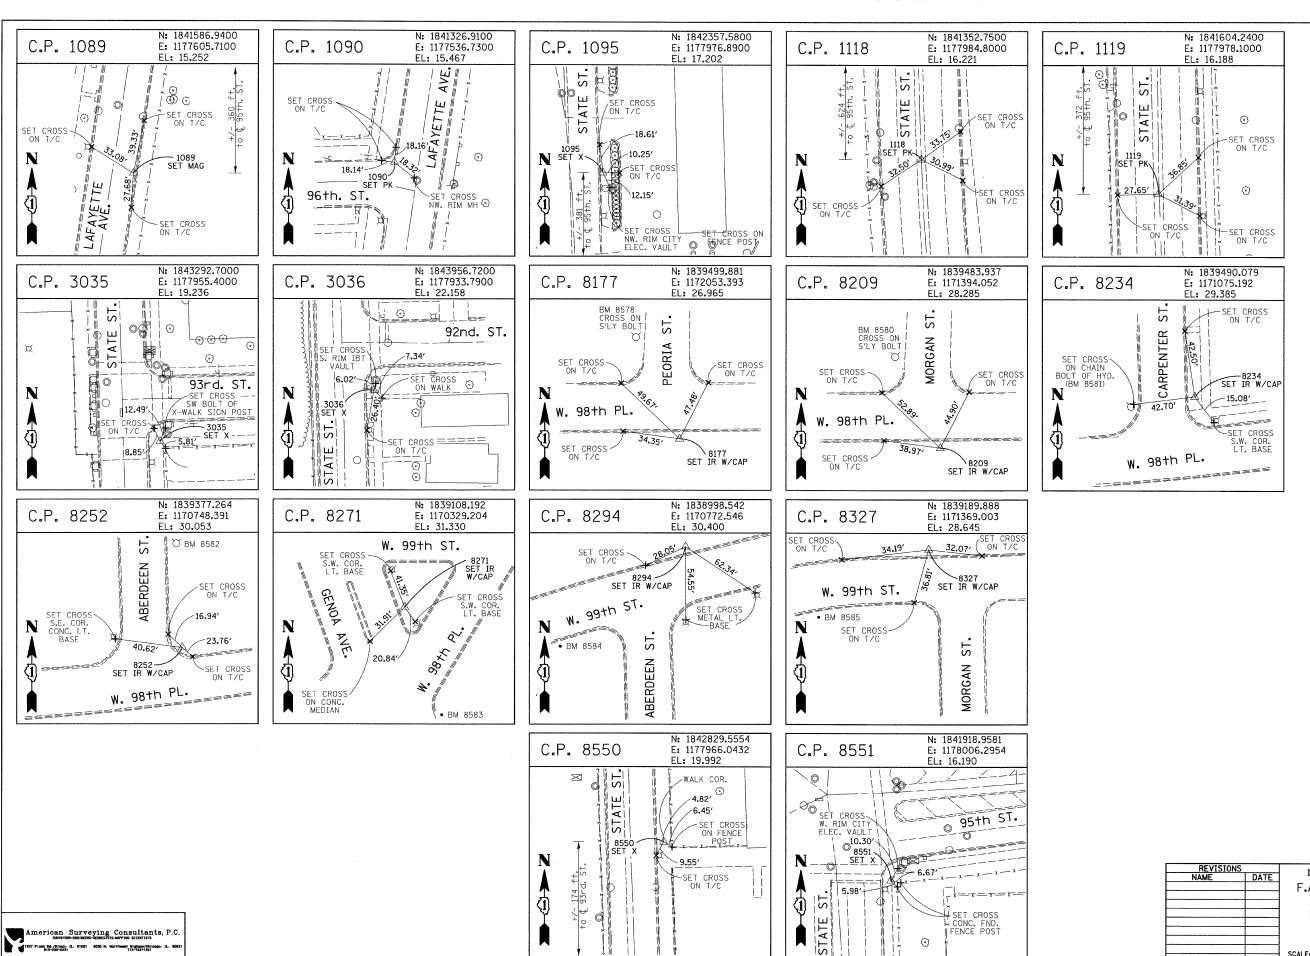

ILLINOIS DEPARTMENT OF TRANSPORTATION F.A.I. 94 (DAN RYAN EXPRESSWAY) SURVEY TIES FOR CONTROL POINTS SHEET 6 OF 7 SCALE: 1"=30" DRAWN BY:

DATE: OCTOBER 17, 2008 CHECKED BY: MMW

SECTION

1717 I-9

FED. ROAD DIST. NO. ILLINOIS FED. AID PROJECT

STA. 1273+74.31

COUNTY


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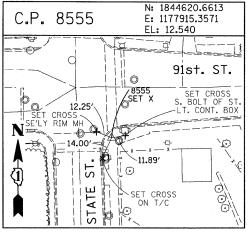
TO STA. 1289+11.91


TOTAL SHEET SHEETS NO.


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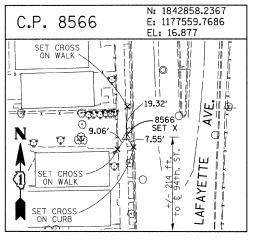
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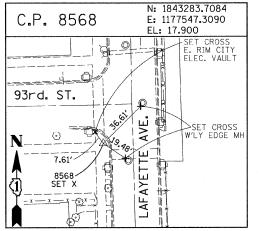








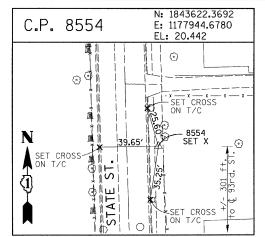

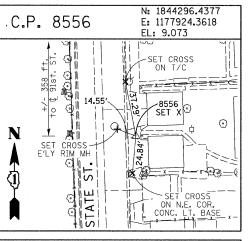
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PROJECT BENCHMARKS

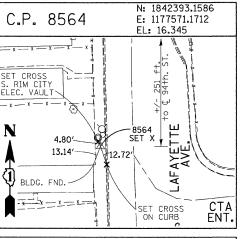BM 101 ELEVATION= 24.89 FEET
SET SQUARE CUT ON SOUTHERLY CURB OF WEST 98TH PLACE. APPROXIMATELY
70 FEET EAST OF THE CENTERLINE OF GREEN STREET.

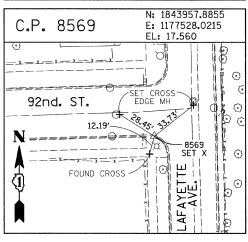BM 102 ELEVATION= 27.36 FEET SET CROSS ON SOUTHERLY FLANGE BOLT OF FIRE HYDRANT AT THE SOUTHWEST CORNER OF WEST 99TH STREET AND GREEN STREET.

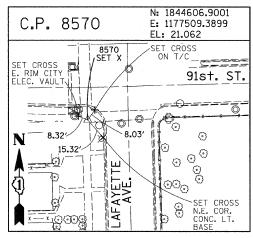BM 8558 ELEVATION= 17.73 FEET SET SQUARE CUT ON SOUTHEAST CORNER OF FOURTH LIGHT BASE SOUTH OF 95TH STREET, ON THE EAST SIDE OF STATE STREET.

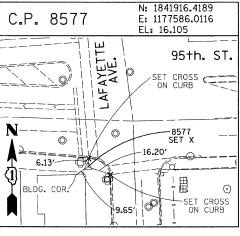BM 8559 ELEVATION= 17.10 FEET
SET SQUARE CUT ON SOUTHWEST CORNER OF CONCRETE SIGN BASE AT THE
NORTHWEST CORNER OF THE MOBIL GAS STATION PROPERTY AT THE NORTHEAST
CORNER OF 95TH STREET AND STATE STREET.

BM 8560 ELEVATION= 17.50 FEET
SET SOUARE CUT ON SOUTHEAST CORNER OF CONCRETE BUS SLAB ON THE EAST
SIDE OF STATE STREET. APPROXIMATELY 50 FEET SOUTH OF THE CENTERLINE OF
94TH STREET.

BM 8561 ELEVATION= 19.77 FEET SET CROSS ON SOUTHEASTERLY FLANGE BOLT OF FIRST FIRE HYDRANT SOUTH OF 93RD STREET, ON THE EAST SIDE OF STATE STREET.

BM 8562 ELEVATION= 22.29 FEET SET CROSS ON SOUTHEASTERLY FLANGE BOLT OF FIRST FIRE HYDRANT NORTH OF 93RD STREET, ON THE EAST SIDE OF STATE STREET.

BM 8563 ELEVATION= 20.47 FEET SET CROSS ON SOUTHEASTERLY FLANGE BOLT OF FIRST FIRE HYDRANT SOUTH OF 91ST STREET, ON THE EAST SIDE OF STATE STREET.

BM 8573 ELEVATION= 19.89 FEET SUDARE CUT ON EAST SIDE OF SIDEWALK OPPOSITE TO THE SECOND FIRE HYDRANT SOUTH OF 91ST STREET, ON THE WEST SIDE OF LAFAYETTE AVENUE.

BM 8574 ELEVATION= 18.90 FEET SET CROSS ON THE WESTERLY FLANGE BOLT OF FIRE HYDRANT APPROXIMATELY AT 9224 S. LAFAYETTE AVENUE, ON THE WEST SIDE OF LAFAYETTE AVENUE.

BM 8575 ELEVATION= 17.77 FEET
SET CROSS ON THE WESTERLY FLANGE BOLT OF FIRE HYDRANT APPROXIMATELY
AT 9326 S. LAFAYETTE AVENUE, ON THE WEST SIDE OF LAFAYETTE AVENUE.

BM 8576 ELEVATION= 17.43 FEET SET CROSS ON THE WESTERLY FLANGE BOLT OF FIRE HYDRANT AT THE VACANT LOT BETWEEN 9416 AND 9422 S. LAFAYETTE AVENUE, ON THE WEST SIDE OF LAFAYETTE AVENUE.

BM 8578 ELEVATION= 27.92 FEET SET CROSS ON SOUTHERLY FLANGE BOLT OF FIRE HYDRANT AT THE NORTHWEST CORNER OF WEST 98TH PLACE AND PEORIA STREET.

BM 8579 ELEVATION= 28.59 FEET
SET CROSS ON SOUTHERLY FLANGE BOLT OF FIRE HYDRANT AT THE NORTHWEST
CORNER OF WEST 98TH PLACE AND SANGAMON STREET.

BM 8580 ELEVATION= 29.24 FEET SET CROSS ON SOUTHERLY FLANGE BOLT OF FIRE HYDRANT AT THE NORTHWEST CORNER OF WEST 98TH PLACE AND MORGAN STREET.

BM 8581 ELEVATION= 30.82 FEET SET CROSS ON CHAIN BOLT OF FIRE HYDRANT ON THE NORTHWEST CORNER OF CARPENTER STREET AND WEST 98TH PLACE.

BM 8582 ELEVATION= 30.69 FEET SET CROSS ON CHAIN BOLT OF FIRST FIRE HYDRANT NORTH OF WEST 98TH PLACE, ON THE EAST SIDE OF ABERDEEN STREET.

BM 8583 ELEVATION= 33.14 FEET SET SQUARE CUT ON CONCRETE BRIDGE WALL AT THE SOUTHEASTERLY CORNER OF GENOA AVENUE AND 99TH STREET.

BM 8584 ELEVATION= 32.36 FEET SET CROSS ON CHAIN BOLT OF FIRST FIRE HYDRANT WEST OF ABERDEEN STREET, ON THE SOUTHERLY SIDE OF 99TH STREET.

BM 8585 ELEVATION= 30.28 FEET SET CROSS ON SOUTHERLY FLANGE BOLT OF FIRST FIRE HYDRANT WEST OF MORGAN STREET, ON THE SOUTH SIDE OF 99TH STREET.

BM 8586 ELEVATION= 28.75 FEET SET CROSS ON NORTHERLY FLANGE BOLT OF FIRE HYDRANT AT THE SOUTHWEST CORNER OF 99TH STREET AND SANGAMON STREET.

BM 8587 ELEVATION= 31.19 FEET
SET CROSS ON SOUTHERLY FLANGE BOLT OF FIRE HYDRANT AT THE SOUTHWEST
CORNER OF 99TH STREET AND CARPENTER STREET.

BM 3514 ELEVATION= 17.56 FEET SET CROSS ON CHAIN BOLT OF HYDRANT AT SOUTHTHWEST INTERSECTION OF LASALLE ST. AND 97TH ST.

BM 3522 ELEVATION= 18.06 FEET
SET CROSS ON SOUTH SOUTHEAST FLANGE BOLT OF HYDRANT ± HALFWAY
BETWEEN NORTH AND SOUTH ENTRANCE TO CITGO, EAST SIDE OF STATE
ST. AND NORTH OF 95TH ST.

BM 3549 ELEVATION= 9.49 FEET SET CROSS WESTERLY FLANGE BOLT OF HYDRANT AT SOUTHWEST INTERSECTION OF 87TH ST. AND LAFAYETTE AVE.

BM 3550 ELEVATION= 22.88 FEET SET CROSS WESTERLY FLANGE BOLT OF HYDRANT AT SOUTHWEST INTERSECTION OF 91ST ST. AND LAFAYETTE AVE.

BM 3551 ELEVATION= 17.50 FEET SET CROSS NORTHERLY FLANGE BOLT OF HYDRANT AT SOUTHWEST INTERSECTION OF 95TH ST. AND LAFAYETTE AVE.

BM 3552 ELEVATION= 14.81 FEET SET CROSS NORTHEAST BOLT OF TRAFFIC SIGNAL/LIGHT BASE AT SOUTHEAST INTERSECTION OF 91ST ST. AND STATE ST.

BM 3553 ELEVATION= 8.47 FEET SET CROSS NORTHWEST BOLT OF TRAFFIC SIGNAL/LIGHT BASE AT NORTHEAST INTERSECTION OF 87TH ST. AND STATE ST.

BM 3556 ELEVATION= 9.06 FEET SET CROSS EASTERLY FLANGE BOLT OF HYDRANT AT NORTHEAST CORNER OF 75TH ST. AND STATE ST.

BM 3558 ELEVATION= 18.15 FEET SET CROSS SOUTHWESTERLY FLANGE BOLT OF HYDRANT AT NORTHWEST INTERSECTION OF NORMAL ST. AND 98TH PLACE.

BM 3810 ELEVATION= 0.29 FEET
CUT SQUARE ON SOUTHERLY CORNER OF METAL BASE FOR OVERHEAD
SIGN, ON THE WESTERLY SIDE OF SOUTHBOUND DAN RYAN, OPPOSITE
OF WEST 77TH PLACE, APPROXIMATELY 1000 FEET NORTH OF 79TH
STREET BRIDGE.

BM 3811 ELEVATION= 1.95 FEET CUT SQUARE ON SQUTHEASTERLY CORNER OF METAL BASE FOR OVERHEAD SIGN, ON THE WESTERLY SIDE OF SOUTHBOUND DAN RYAN APPROXIMATELY 840 FEET SOUTHERLY OF 83RD STREET.


REVISIONS NAME	DATE	ILLINOIS DEPARTMENT OF TRANSPORTATION F.A.I. 94 (DAN RYAN EXPRESSWAY)			
		SURV		OR CONTROL P	OINTS
		SCALE: 1"="	30'	DRAWN BY	920


DATE: OCTOBER 17, 2008


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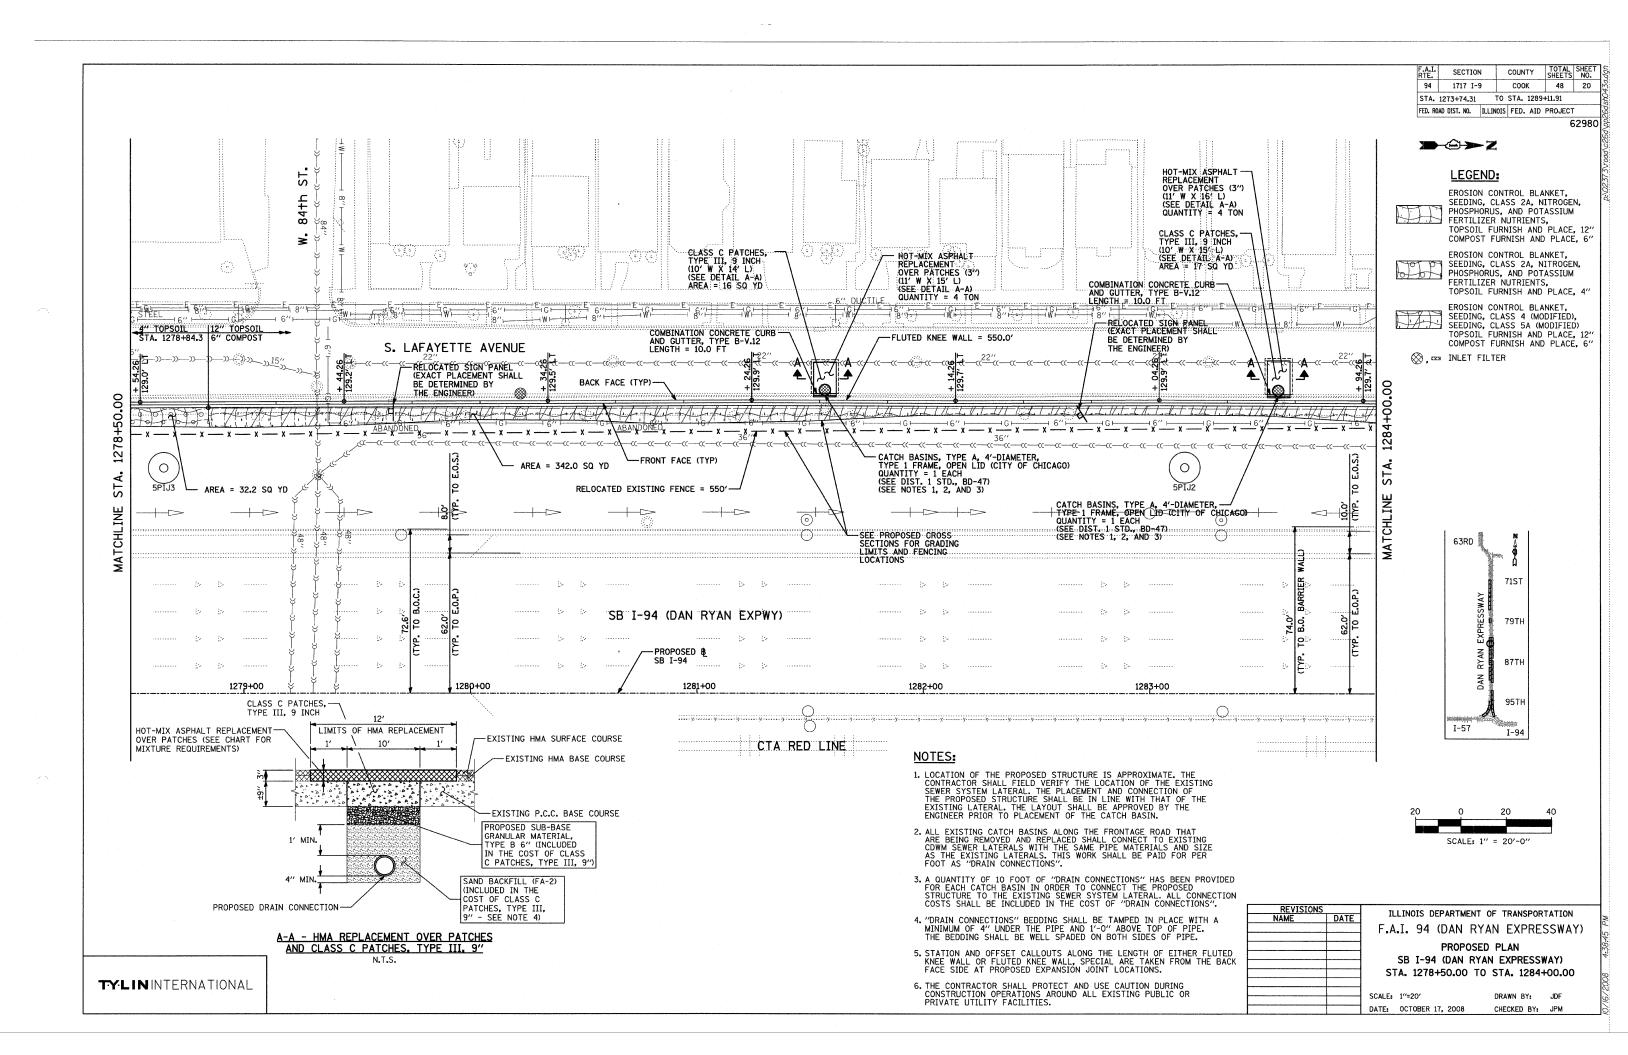
American Surveying Consultants, P.C.


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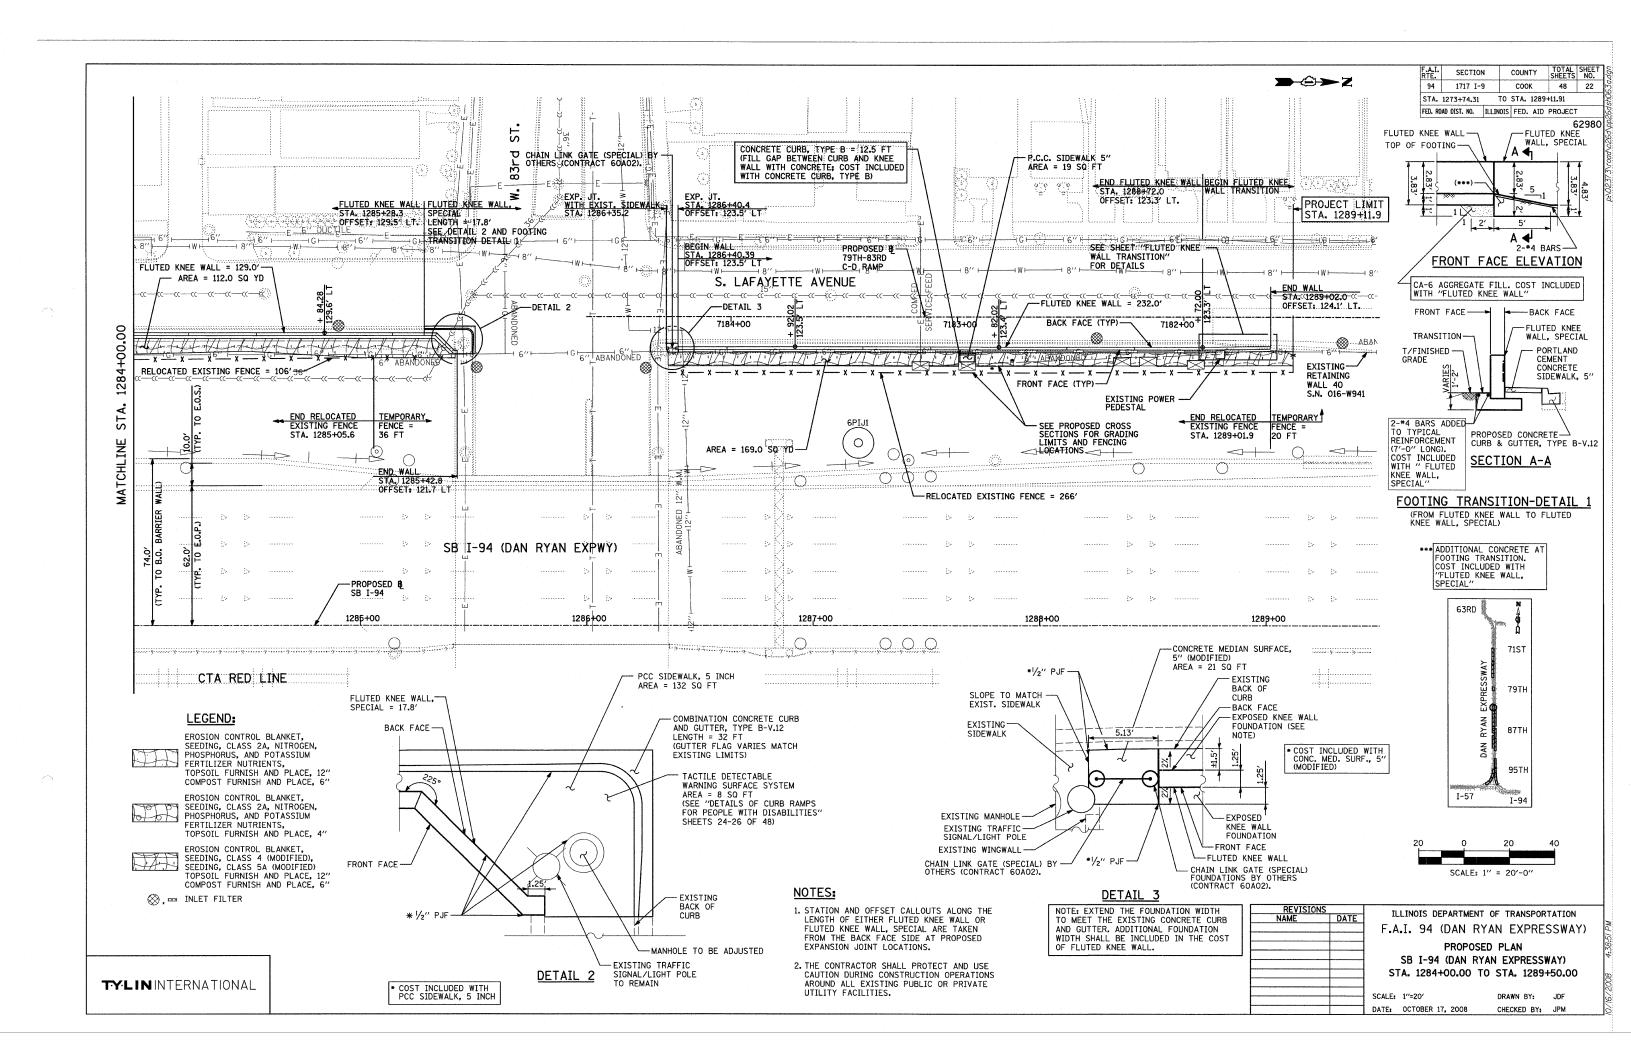





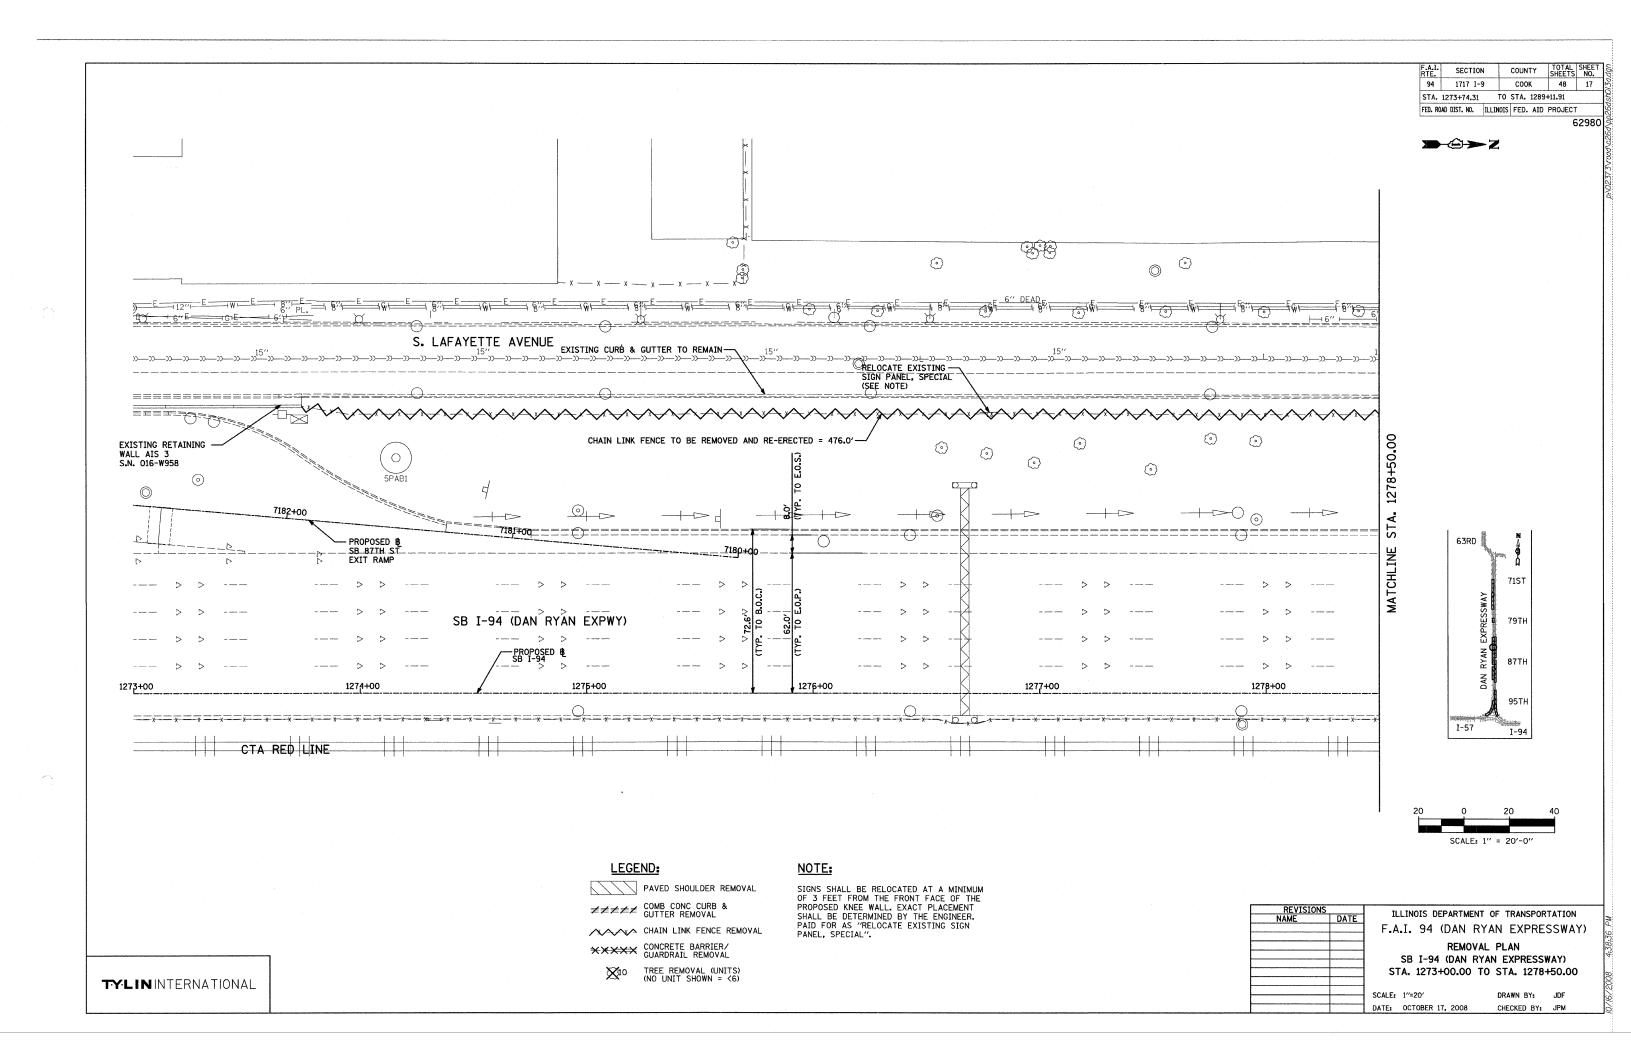


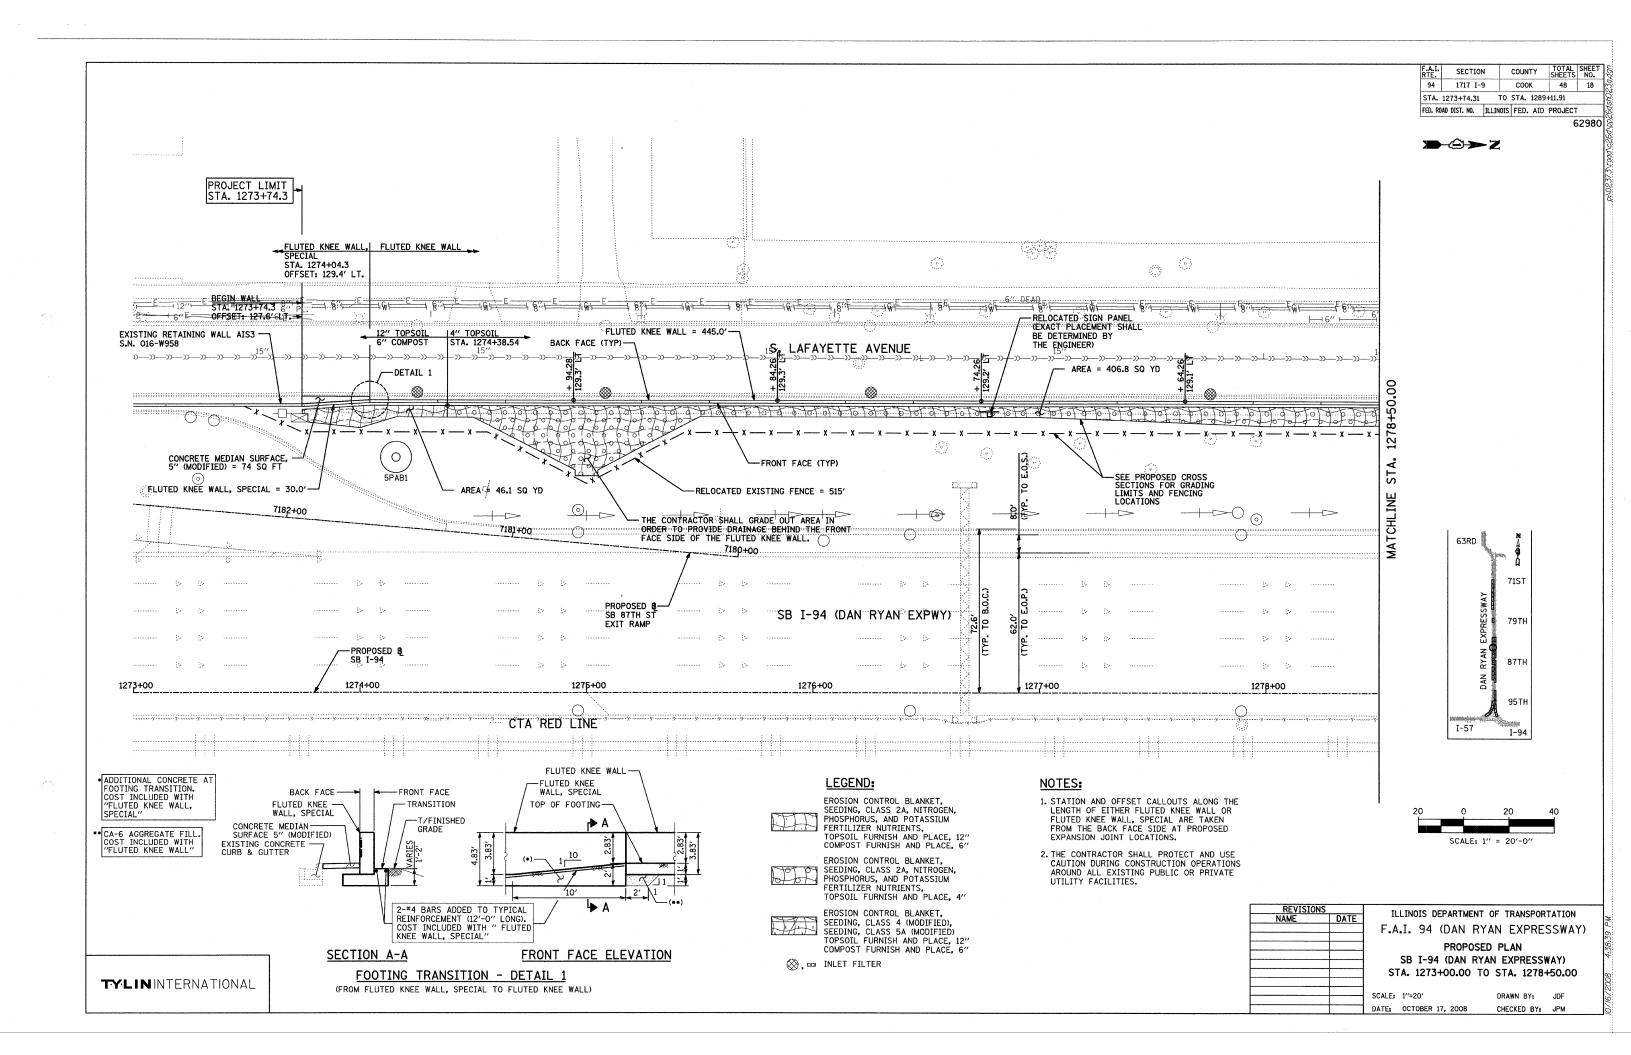

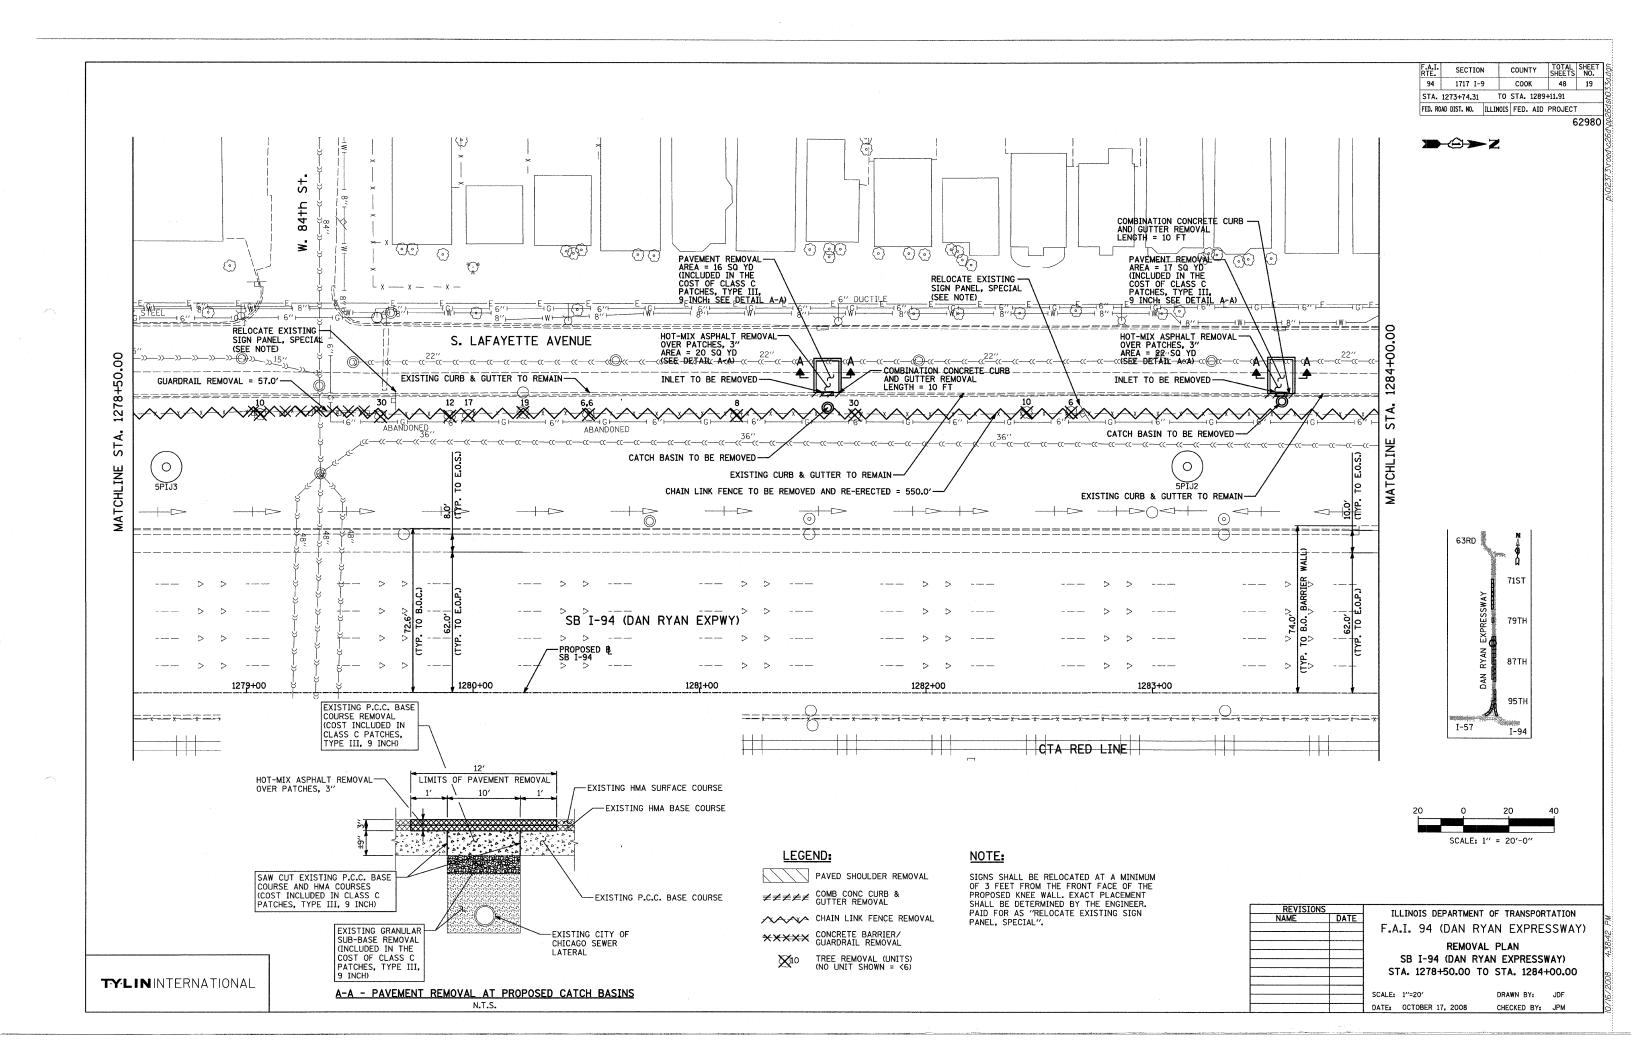

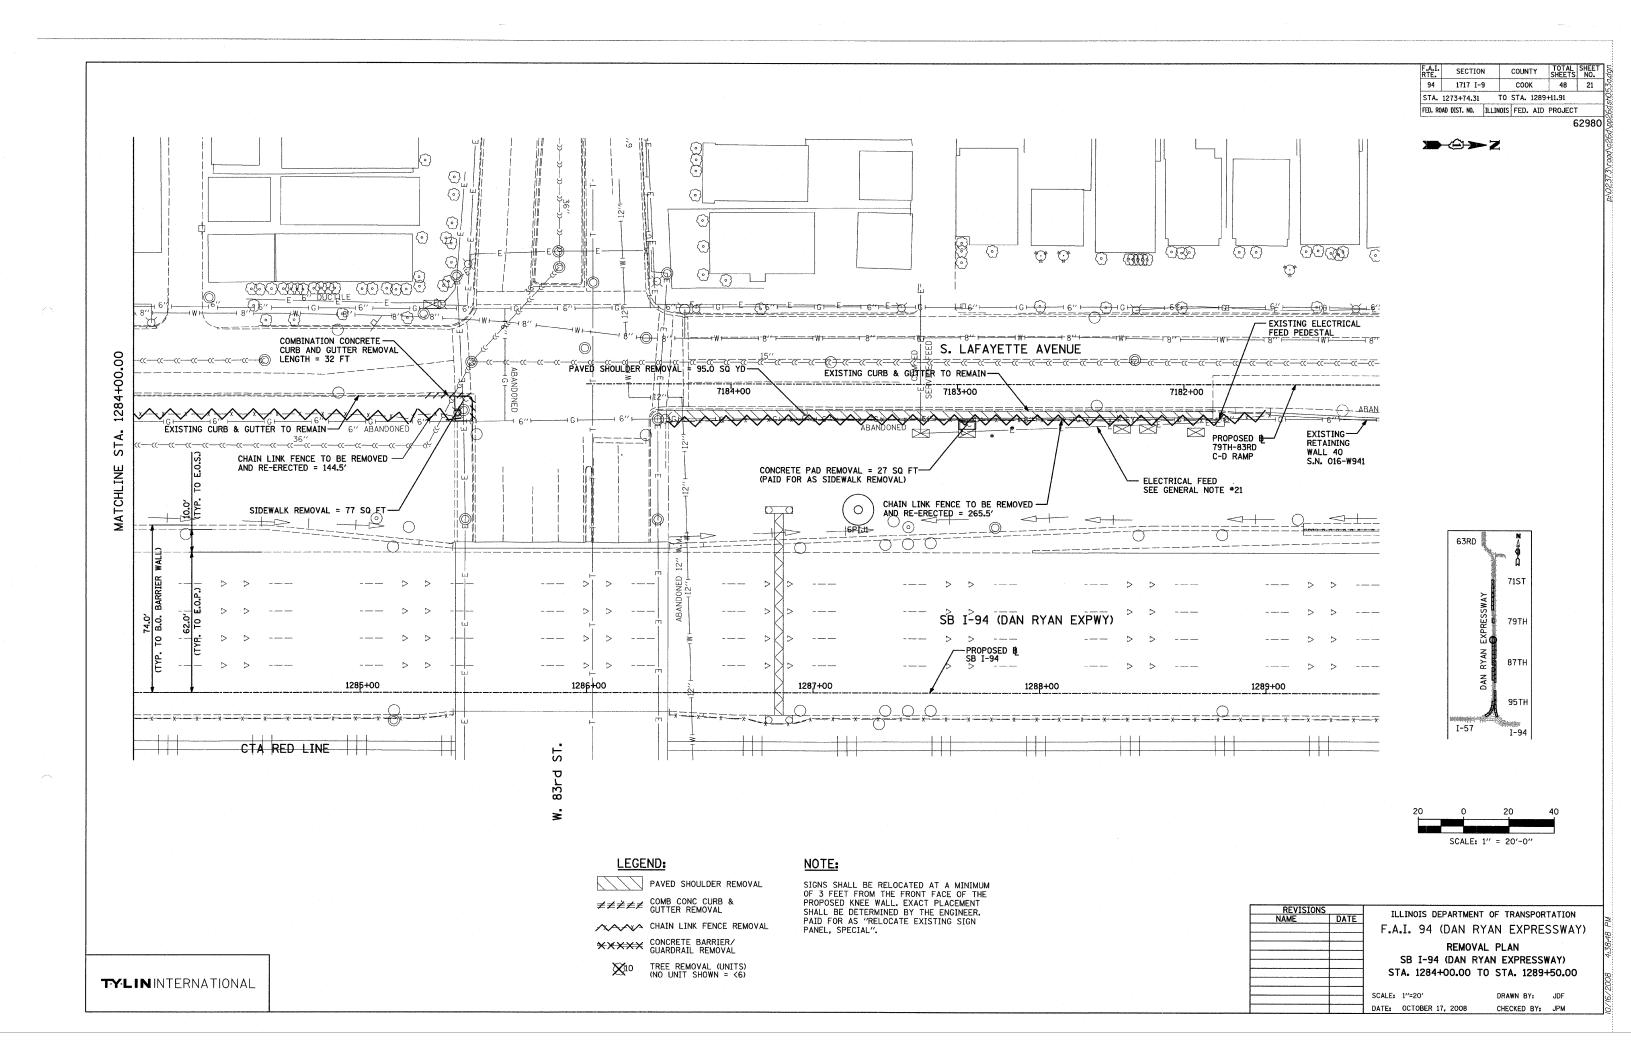

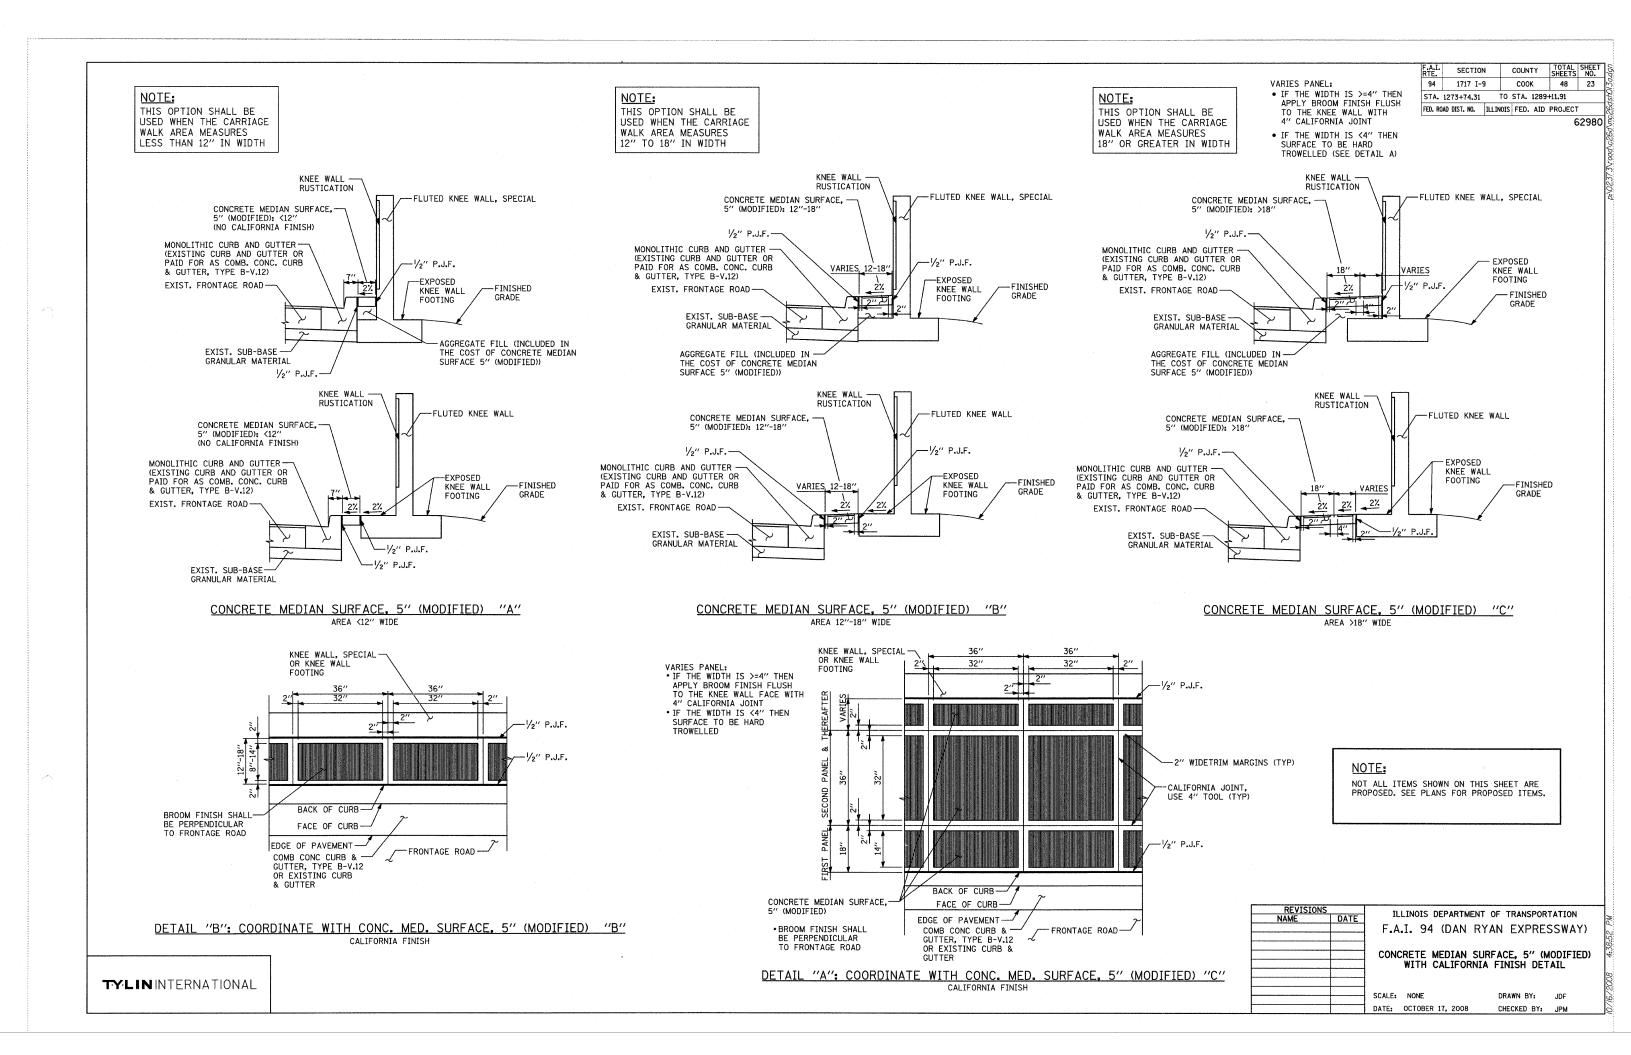

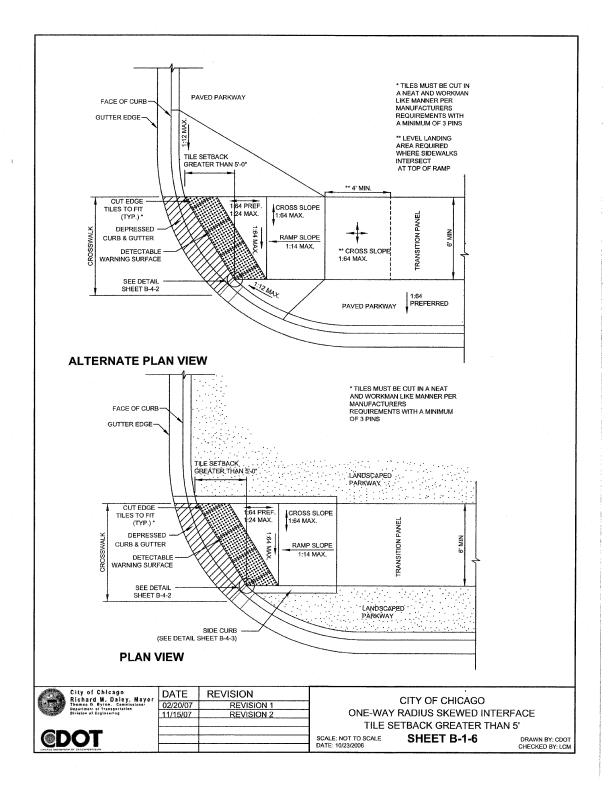

GENERAL NOTES

1. THE DETECTABLE WARNING TILES SHALL BE CERAMIC CEMENT OR COMPOSITE POLYMER CONCRETE (CRC) TILES WHICH MEET THE CHICAGO DEPARTMENT OF TRANSPORTATION SPECIFICATION (AVAILABLE ON THE CITY OF CHICAGO WEBSITE). IN THE CENTRAL BUSINESS DISTRICT, GRANITE OR OTHER SPECIALTY PAVING MATERIALS MAY BE SUBMITTED TO THE COMMISSIONER FOR APPROVAL.

- 2. TILES MUST BE INSTALLED A MAXIMUM OF 8" OR LESS FROM FACE OF CURB (SEE DETAIL SHEET B-4-2).
- 3. TILES MUST COVER FULL WIDTH OF RAMP EXCLUDING SIDE FLARES. WHERE SIDEWALK OR RAMP IS FLUSH WITH STREET (DEPRESSED CURB), TILES MUST BE PROVIDED.
- 4. WHERE APPLICABLE, A COMBINATION OF DIFFERING SIZE TILES MAY BE USED ON COMPOUND AND LARGE RADII. CONTRACTOR MUST MAKE THIS DETERMINATION AND VERIFY IN FIELD.
- 5. TILES MUST CONTRAST WITH ADJACENT PAVEMENT. IF LIGHT COLORED PAVEMENT IS USED THE TILE COLOR SHALL BE RED. IF A DARK COLORED PAVEMENT IS USED THE TILE COLOR SHALL BE YELLOW. CONTRACTOR TO VERIFY THAT PROPER CONTRAST IS OBTAINED.
- 6. RAMP WIDTH MUST BE A MINIMUM OF 6'-0" AND IN INCREMENTS OF 1'-0", EXCEPT WHEN USING THE PERPENDICULAR RAMP AT CORNER, WHICH HAS A MINIMUM WIDTH OF 4'-0".
- 7. PRIOR TO PLACING CONCRETE FOR DEPRESSED CURBS AND RAMPS THE CONTRACTOR SHALL NOTIFY THE COMMISSIONER TO RECEIVE LAYOUT APPROVAL. A PRE-MANUFACTURED TILE, APPROVED BY THE COMMISIONER, MUST BE USED TO ACHIEVE THE DETECTABLE WARNING SURFACE.
- 8. THE MAXIMUM ALLOWABLE RAMP RUNNING SLOPE IS 1:14, MEASURED AT ANY PORTION OF THE RAMP. IF POSSIBLE, A MORE GRADUAL SLOPE SHALL BE USED. GRADE BREAKS AT THE TOP AND BOTTOM OF RAMPS SHALL BE PERPENDICULAR TO THE DIRECTION OF RAMP RUN.
- 9. THE MAXIMUM ALLOWABLE RAMP CROSS SLOPE IS 1:64, MEASURED AT ANY PORTION OF THE RAMP. IF POSSIBLE, A MORE GRADUAL SLOPE SHALL BE USED.
- 10. UTILITIES, SUCH AS LIGHT POLES, TRAFFIC POLES AND HYDRANTS, MAY BE LOCATED IN THE FLARE OF THE RAMP BUT ARE NOT ALLOWED ON THE RAMP SURFACE OR LANDING AREAS.
- 11. ALTERATIONS SHALL NOT DECREASE THE ACCESSIBILITY OF EXISTING FACILITIES
- 12. THE MINIMUM CROSSWALK WIDTH IS 6'-0". CROSSWALKS SHALL BE LOCATED AS SHOWN IN THE PLAN SHEETS DEPENDING ON THE TYPE OF CURB RAMP USED. BEYOND THE CURB FACE AT THE BASE OF CURB RAMPS, A CLEAR SPACE OF 4'-0" BY 4'-0" MINIMUM SHALL BE PROVIDED WITHIN THE WIDTH OF THE
- 13. IF SIDEWALK AND ALLEY ARE AT THE SAME GRADE, A RAMP IS NOT REQUIRED. IF SIDEWALK AND DRIVEWAY ARE AT THE SAME GRADE, A RAMP IS NOT REQUIRED BUT DETECTABLE WARNING TILES ARE STILL REQUIRED IF THE DRIVEWAY HAS TRAFFIC CONTROL DEVICES (I.E. TRAFFIC SIGNALS).
- 14. MAIN LINE SIDEWALK SHALL HAVE A MAXIMUM CROSS SLOPE NOT TO EXCEED 1:64 FOR THE FULL WIDTH OF WALK UNLESS OTHERWISE APPROVED BY THE COMMISSIONER.
- 15. MAIN LINE SIDEWALK RUNNING SLOPES SHALL NOT EXCEED 1:24 OR THE GENERAL GRADE ESTABLISHED FOR THE ADJACENT STREET, WHICH EVER IS HIGHER,
- 16. CURB RAMPS AND KEYSTONE TO BE CONSTRUCTED WITH 8" THICK CONCRETE AT ALL TRAFFIC SIGNALIZED INTERSECTIONS AND INDUSTRIAL STREET INTERSECTIONS. AT ALL OTHER LOCATIONS, 5" THICK CONCRETE TO BE USED
- 17. NO DEVIATIONS FROM THESE STANDARDS ARE ALLOWED WITHOUT WRITTEN APPROVAL FROM THE
- 18. ALL CONSTRUCTION DOCUMENTS MUST BE STAMPED BY A LICENSED ARCHITECT/LANDSCAPE ARCHITECT/ENGINEER TO CERTIFY THAT THEY ARE IN ACCORDANCE WITH THE AMERICANS WITH DISABILITIES ACT (ADA) AND ALL CODES AND BUILDING ORDINANCES OF THE CITY OF CHICAGO AND STATE OF ILLINOIS

City of Chicago Richard M. Daley, Mayor **@DOT**

DATE REVISION 02/20/0 REVISION 2

CITY OF CHICAGO **GENERAL NOTES**

SCALE: NOT TO SCALE DATE: 10/23/2006 SHEET B-3-2 CHECKED BY: LCN

SEE CITYOFCHICAGO.ORG FOR MOST CURRENT **STANDARDS**

94	1717 1-	9	C00	K	48		24
STA.	1273+74.31	ТО	STA.	1289	+11.91		
FED. RO	DAD DIST. NO.	ILLINOIS	FED.	AID	PROJEC	T	
			*************			62	980

COUNTY

SECTION

ILLINOIS DEPARTMENT OF TRANSPORTATION F.A.I. 94 (DAN RYAN EXPRESSWAY) CITY OF CHICAGO STANDARD DETAILS DETAILS OF CURB RAMPS FOR PEOPLE WITH DISABILITIES

SHEET 1 OF 3 DATE: OCTOBER 17, 2008

CHECKED BY:

ADA COMPLIANCE AND TRANSITION GUIDELINES

POLICY STATEMENT: ANY ALTERATION OF THE PUBLIC WAY MUST BE RESTORED IN AN ADA COMPLIANT MANNER

I. STREET RESURFACING / RECONSTRUCTION *

FOR ANY RESURFACING/RECONSTRUCTION PROJECT WHERE, WITHIN THE PROJECT LIMITS, A CROSSWALK IS ENCOUNTERED OR WHERE THE PROJECT LIMITS TERMINATE WITHIN 4' OR LESS OF A CROSSWALK, THOSE CROSSWALKS AND THE ASSOCIATED CURB RAMPS MUST BE IMPROVED TO CURRENT ADA STANDARDS. WHERE RESURFACING/RECONSTRUCTION ENCOUNTERS LESS THAN 1/4 POINT OF THE STREET SURFACE (LONGITUDINAL CUT), IT IS ACCEPTABLE PRACTICE TO EXCLUDE IMPROVEMENTS TO THE ASSOCIATED CROSSWALKS AND CURB RAMPS.

WHEN A PROJECT SCOPE OF WORK CALLS FOR ONLY AN INTERSECTION TO BE REPAYED. THE INTERSECTION LIMITS AS DEFINED BY THE AREA OUTLINED BY OUTERMOST CROSSWALK LINES AND ADJACENT CURB FACES AND ALL ADJOINING CROSSWALKS AND CURB RAMPS MUST BE IMPROVED TO CURRENT ADA STANDARDS.

WHEN A PROJECT SCOPE OF WORK IS LIMITED TO A SINGLE CORNER OF AN INTERSECTION, THE CURB RAMP MUST BE IMPROVED TO CURRENT ADA STANDARDS AND THE ADJACENT PAVEMENT MUST BE RESURFACED, AS NECESSARY TO PROVIDE FOR A FLUSH TRANSITION.

FOR ANY RESURFACING / RECONSTRUCTION PROJECT WHERE, WHITHIN THE PROJECT LIMITS, AN ALLEY APRON IS INCLUDED, THE ASSOCIATED CURB RAMPS AND SIDEWALKS MUST BE IMPROVED TO CURRENT ADA STANDARDS

II. SIDEWALK INSTALLATION / REPAIRS / RECONSTRUCTION

THE LIMITS OF ANY MAINLINE SIDEWALK REPLACEMENT, GREATER THAN TEN FEET (10') IN LENGTH, THAT ABUT AN EXISTING RAMP LOCATION (INCLUDING THE FOUR FOOT (4') LANDING AREA AND/OR THE "KEYSTONE"), SHALL BE EXTENDED TO INCLUDE THE AFFECTED RAMPS ANDTHESE RAMPS SHALL BE RECONSTRUCTED TO CURRENT ADA STANDARDS. IN ADDITION, ALL NEWLY PLACED SIDEWALK TEN FEET (10') OR MORE IN LENGTH SHALL BE CONSTRUCTED IN ACCORDANCE WITH ALL CURRENT APPLICABLE STANDARDS WHICH INCLUDE PROVIDING A MINIMUM FOUR FEET (4') WIDTH ACCESSIBLE PATHWAY WITH A CROSS SLOPE NOT TO EXCEED 1:64.

III. GUIDELINES FOR TRANSITIONING TO EXISTING NON-COMPLIANT CONDITION

NEW SIDEWALK PLACEMENTS GREATER THAN TEN FEET IN CONTIGUOUS LENGTH: THE LIMITS OF ANY MAINLINE SIDEWALK REPLACEMENT, GREATER THAN TEN FEET (10') IN LENGTH, MUST BE EXTENDED FOR A MINIMUM FIVE ADDITIONAL FEET (5') EITHER SIDE IN ORDER TO PROVIDE A REASONABLE TRANSITION TO MATCH THE EXISTING SIDEWALK. THE LENGTH OF TRANSITION SHALL BE LENGTHENED AS NECESSARY TO ENSURE THAT THE RUNNING SLOPE OF THE TRANSITION DOES NOT EXCEED A SLOPE OF 1:24 (PREFERRED) OR 1:14 (MAXIMUM) AT ANY POINT.

NEW SIDEWALK REPLACEMENTS TEN FEET OR LESS IN CONTIGUOUS LENGTH (REPAIRS): IT IS ACCEPTABLE PRACTICE TO MATCH ADJACENT SIDEWALKS AT THE EXISTING SLOPE.

CURB RAMP REPLACEMENTS:

SIDEWALK REPLACEMENT BEYOND THE LIMITS OF THE LANDING AREA AND/OR THE "KEYSTONE" MUST BE EXTENDED A MINIMUM OF AN AN ADDITIONAL FIVE FEET (5') EITHER SIDE IN ORDER TO PROVIDE A REASONABLE TRANSITION TO MATCH THE EXISTING SIDEWALK. THE TRANSITION SHALL BE LENGTHENED AS NECESSARY TO ENSURE THAT THE RUNNING SLOPE OF THE TRANSITION DOES NOT EXCEED A SLOPE OF 1:24 (PREFERRED) OR 1:14 (MAXIMUM) AT ANY POINT.

NO EXCEPTIONS TO THE ABOVE WILL BE ALLOWED WITHOUT WRITTEN APPROVAL FROM THE COMMISSIONER.

THE REQUIREMENTS OF SECTION I. SHALL APPLY ONLY TO CITY AGENCIES

City of Chicago

DATE 2/20/0 REVISION **REVISION 2**

REVISION

ADA COMPLIANCE AND TRANSITION GUIDELINES SCALE: NOT TO SCALE DATE: 10/23/2006

SHEET B-3-3

CITY OF CHICAGO

GENERAL NOTE: THE ROWS OF DOMES IN THE DETECTABLE WARNING MATERIAL MUST BE ALIGNED WITH THE PATH OF WHEELCHAIR TRAVEL WHICH IS REQUIRED TO BE PERPENDICULAR TO THE GRADE BREAK AT THE BOTTOM OF THE RAMP TO PERMIT TRACKING BETWEEN DOME ROWS. ON BLENDED TRANSITIONS, DOME ORIENTATION IS NOT SIGNIFICANT DETECTABLE WARNING TILE FLOW. LINE/FACE OF CURB SQUARE PATTERN TRUNCATED DOME DETAIL (PARALLEL ALIGNMENT) **TILE PATTERN DETAIL TILE PLACEMENT ON A RADIUS** BULL FLOAT AROUND TILE TO ENSURE A LEVEL SURFACE, ¼" MAX VERTICAL DISPLACEMENTS BETWEEN THE TILE EDGE AND ADJACENT CONCRETE SECURING PIN SUPPLIED BY MANUFACTURER CAST IN PLACE DETECTABLE WARNING TILE PLASTIC BARRIER 8" CONCRETE WALK **DETECTABLE TILE WARNING SECTION** City of Chicago Richard M. Daley, Mayo DATE REVISION CITY OF CHICAGO **DETECTABLE WARNING TILE DETAILS** REVISION 2 **@DOT** SCALE: NOT TO SCALE SHEET B-4-2

SEE CITYOFCHICAGO.ORG FOR MOST CURRENT STANDARDS

REVISIONS NAME DATE	ILLINOIS DEPARTMENT OF TRANSPORTATION
	F.A.I. 94 (DAN RYAN EXPRESSWAY
	CITY OF CHICAGO STANDARD DETAILS
	DETAILS OF CURB RAMPS FOR PEOPLE WITH DISABILITIES
	SHEET 2 OF 3
	SCALE: NONE DRAWN BY: COOT

DATE: OCTOBER 17, 2008 CHECKED BY:

SECTION

1717 I-9


STA. 1273+74.31 TO STA. 1289+11.91

FED. ROAD DIST. NO. ILLINOIS FED. AID PROJECT

COUNTY

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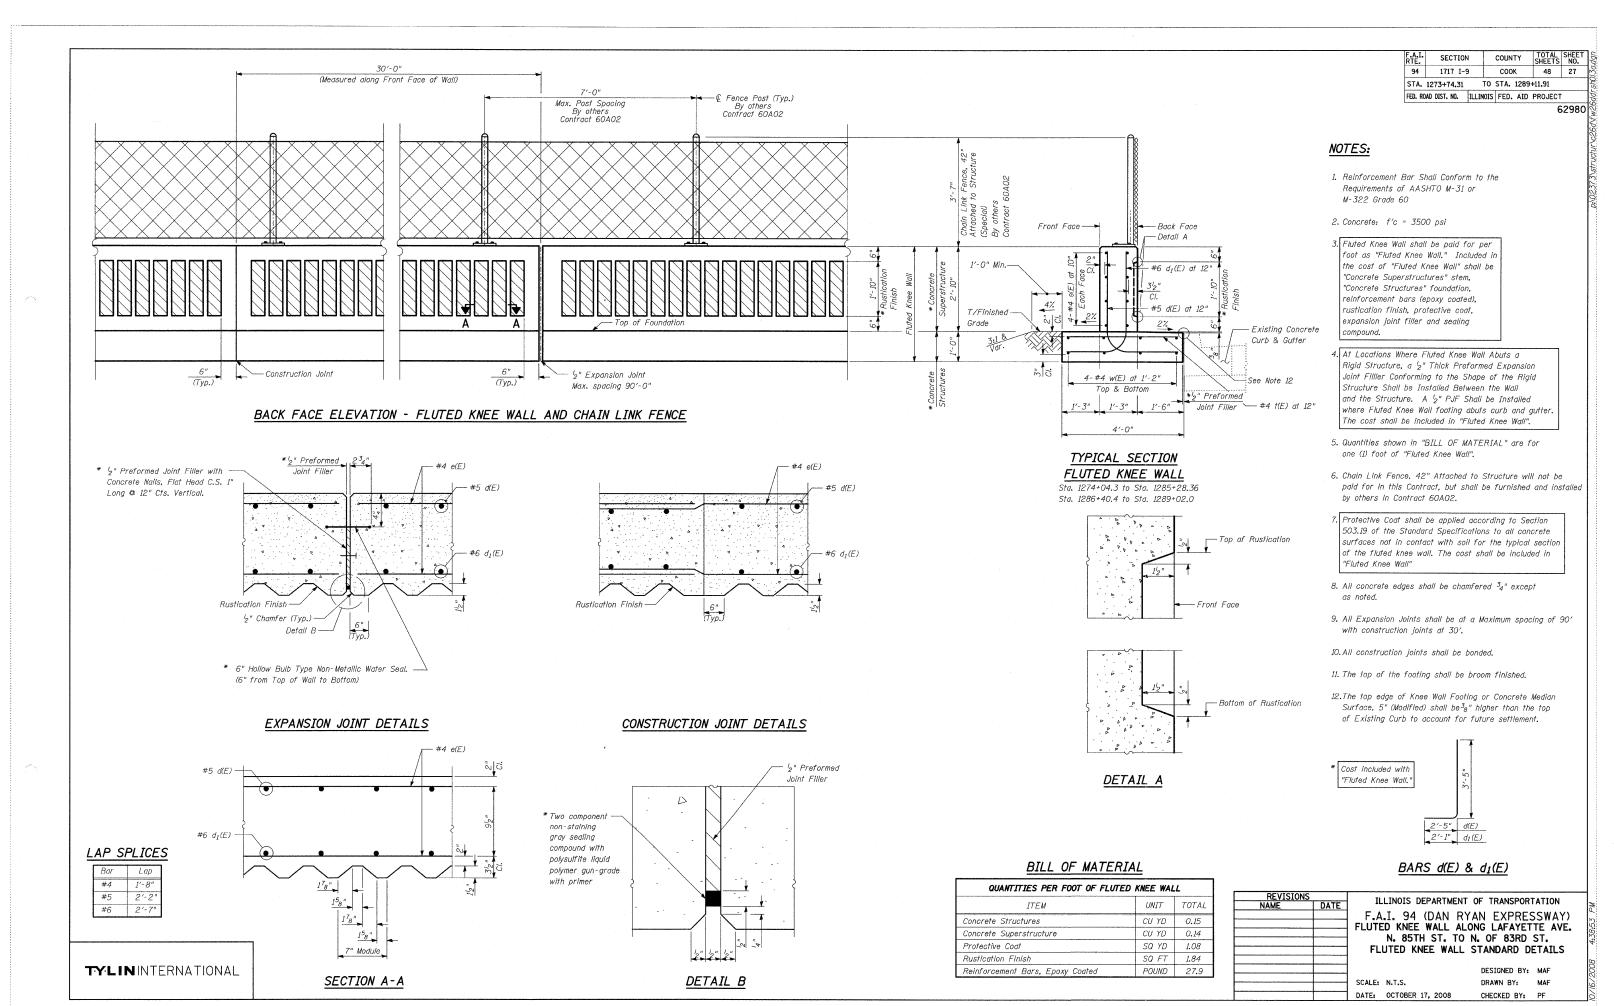
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FED. ROAD DIST. NO. | ILLINOIS | FED. AID | PROJECT


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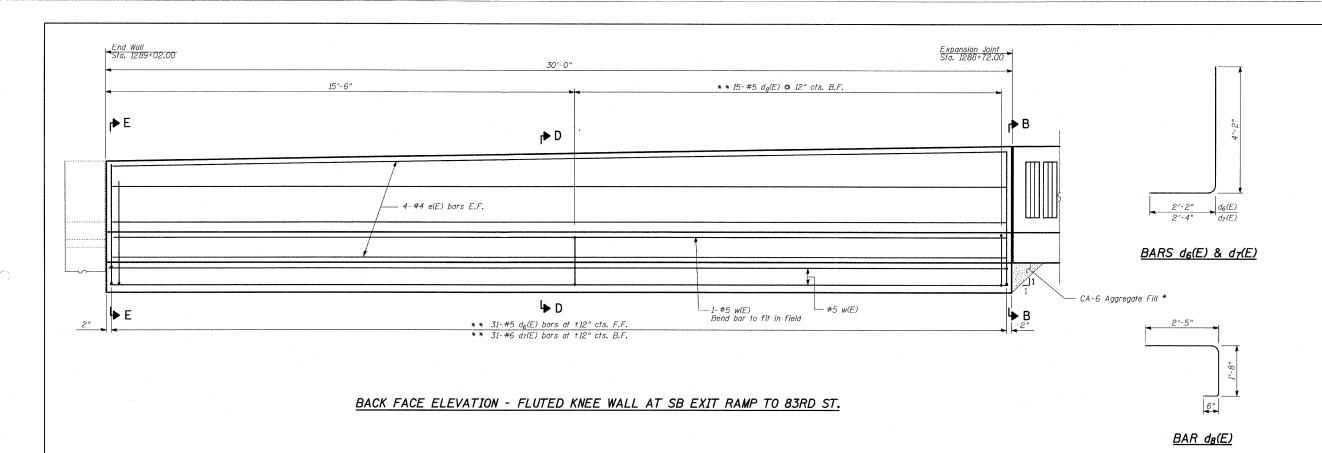
SEE CITYOFCHICAGO.ORG FOR MOST CURRENT STANDARDS

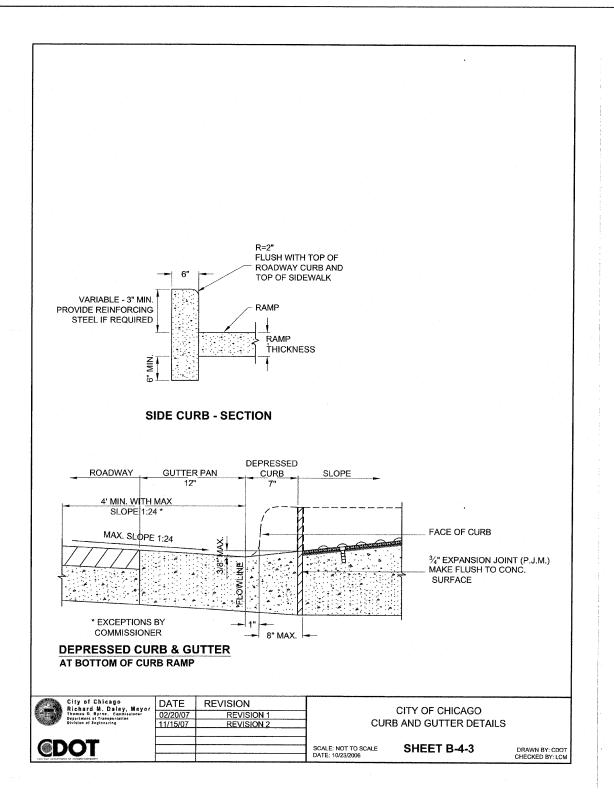REVISIONS		ILLINOIS DEPARTMENT OF TRANSPORTATION
NAME	DATE	ILLINOIS DEPARTMENT OF TRANSPORTATION
		F.A.I. 94 (DAN RYAN EXPRESSWAY)
		CITY OF CHICAGO STANDARD DETAILS
		DETAILS OF CURB RAMPS FOR
		PEOPLE WITH DISABILITIES
		SHEET 3 OF 3
,		SCALE: NONE DRAWN BY: CDOT

DATE: OCTOBER 17, 2008





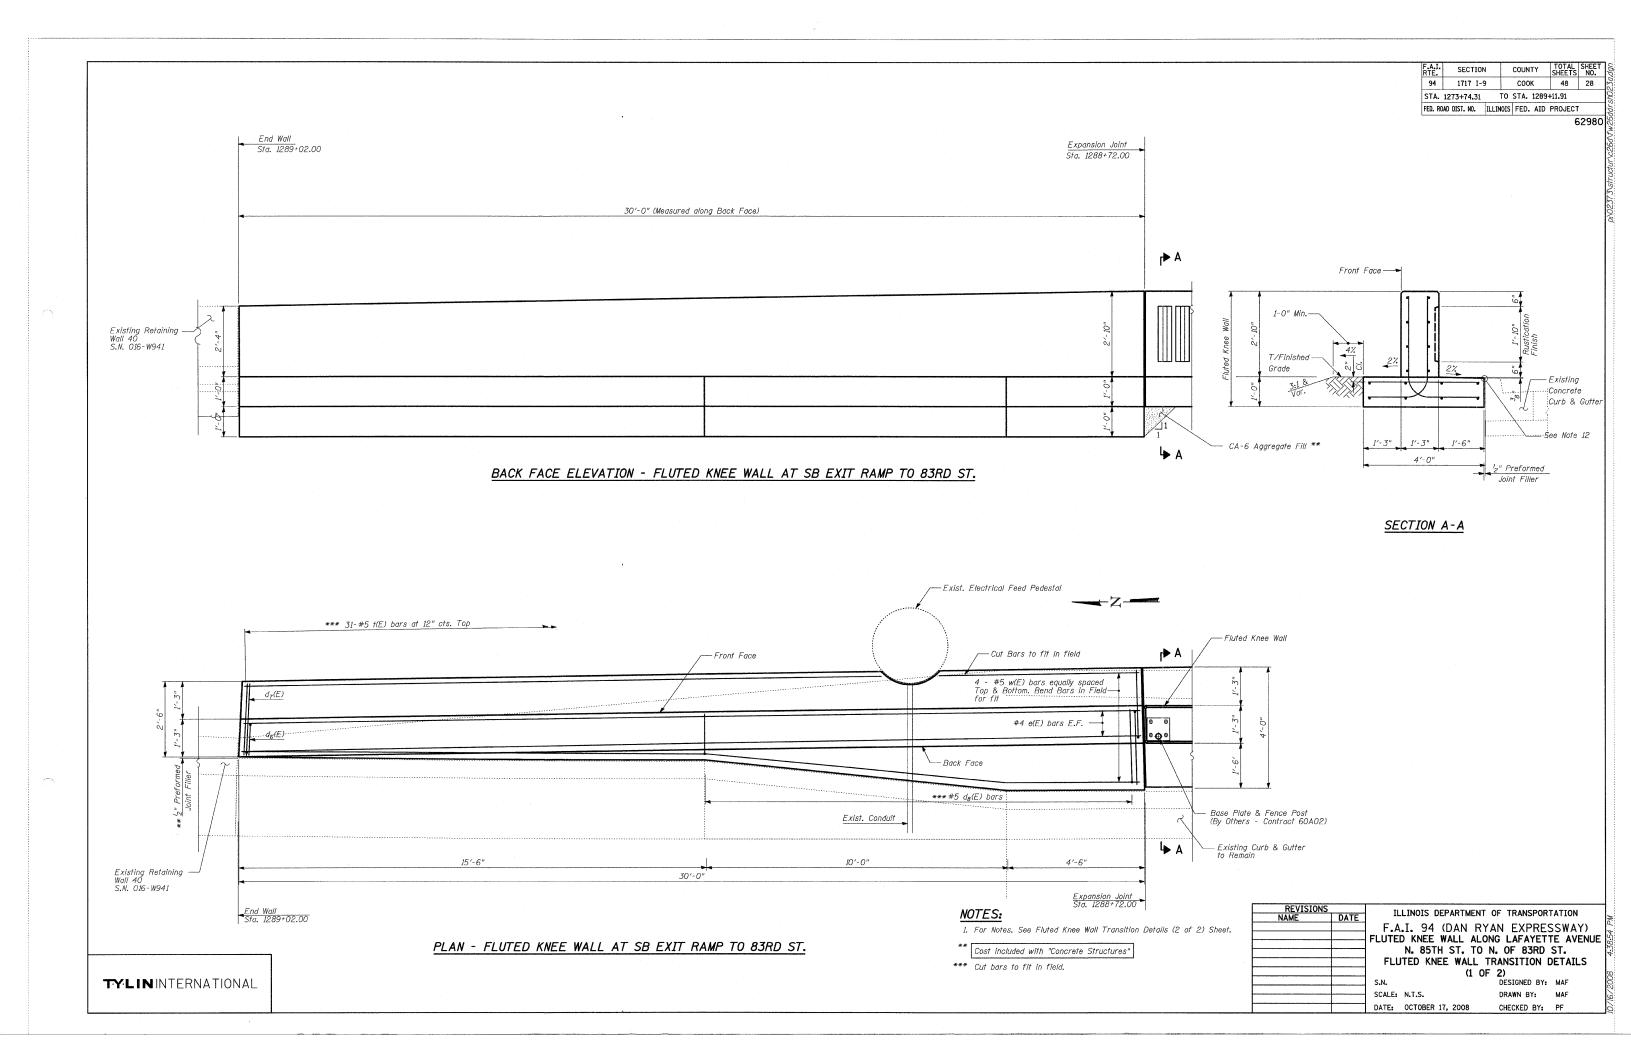


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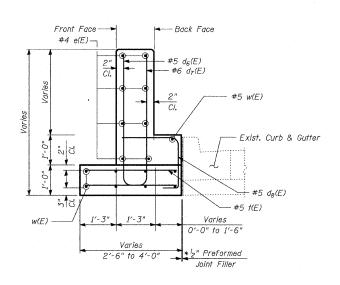
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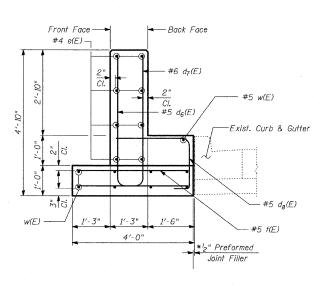
BILL OF MATERIAL

DIEL OF MINICIAL						
Bar	No.	Size	Length	Shape		
d ₆ (E)	31	#5	6'-4"	L		
d ₇ (E)	31	#6	6'-6"	L		
d ₈ (E)	15	#5	4'-7"	ר		
e(E)	8	#4	29'-8"			
G(L)	0	11-4	23-0			
t(E)	31	#5	3′-8"			
w(E)	9	#5	29'-8"			
Reinforcement Bars, Epoxy Coated			POUND	1,140		
Structure Excavation			CU YD	17		
Concrete Structures			CU YD	8		
Protective Coat			SQ YD	28		

Reinforcement bars designated (E) shall be epoxy coated.





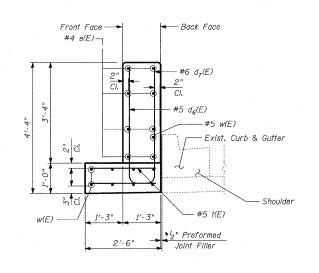

SECTION E-E

SECTION D-D

SECTION B-B

GENERAL NOTES:

- 1. Reinforcement bars shall conform to the requirements of AASHTO M31 or M322 Grade 60.
- 2. Concrete: f'c = 3500 psi
- 3. Plan dimensions and details relative to existing structures have been taken from existing plans and are subject to nominal construction variations. It shall be the Contractor's responsibility to verify such dimensions and details in the field and make necessary approved adjustments prior to construction or ordering of materials. Such variations shall not be cause for additional compensation for a change in the scope of the work. However, the Contractor will be paid for the quantity actually furnished at the unit price bid for the work.
- 4. All exposed concrete edges shall be chamfered ${}^3\!4$ " except as noted.
- Protective Coat shall be applied according to Section 503.19 of the Standard Specifications to all concrete surfaces not in contact with soil for the typical section of the Fluted Knee Wall and Fluted Knee Wall, Special.

- 6. The exposed top of the footing shall be broom finished.
- 7. As built Documents indicate that existing electrical conduit was constructed at 36" Depth. If necessary, the Contractor shall adjust reinforcement and/or provide an opening in the wall to accommodate the existing conduit. Such work shall be included in the cost of "Concrete Structures"
- 8. All construction joints shall be bonded.

* Cost included with "Concrete Structures",


* * Cut bars to fit in field


ILLINOIS DEPARTMENT OF TRANSPORTATION DATE F.A.I. 94 (DAN RYAN EXPRESSWAY) FLUTED KNEE WALL ALONG LAFAYETTE AVENUE N. 85TH ST. TO N. OF 83RD ST. FLUTED KNEE WALL TRANSITION DETAILS (2 OF 2) DESIGNED BY: MAF


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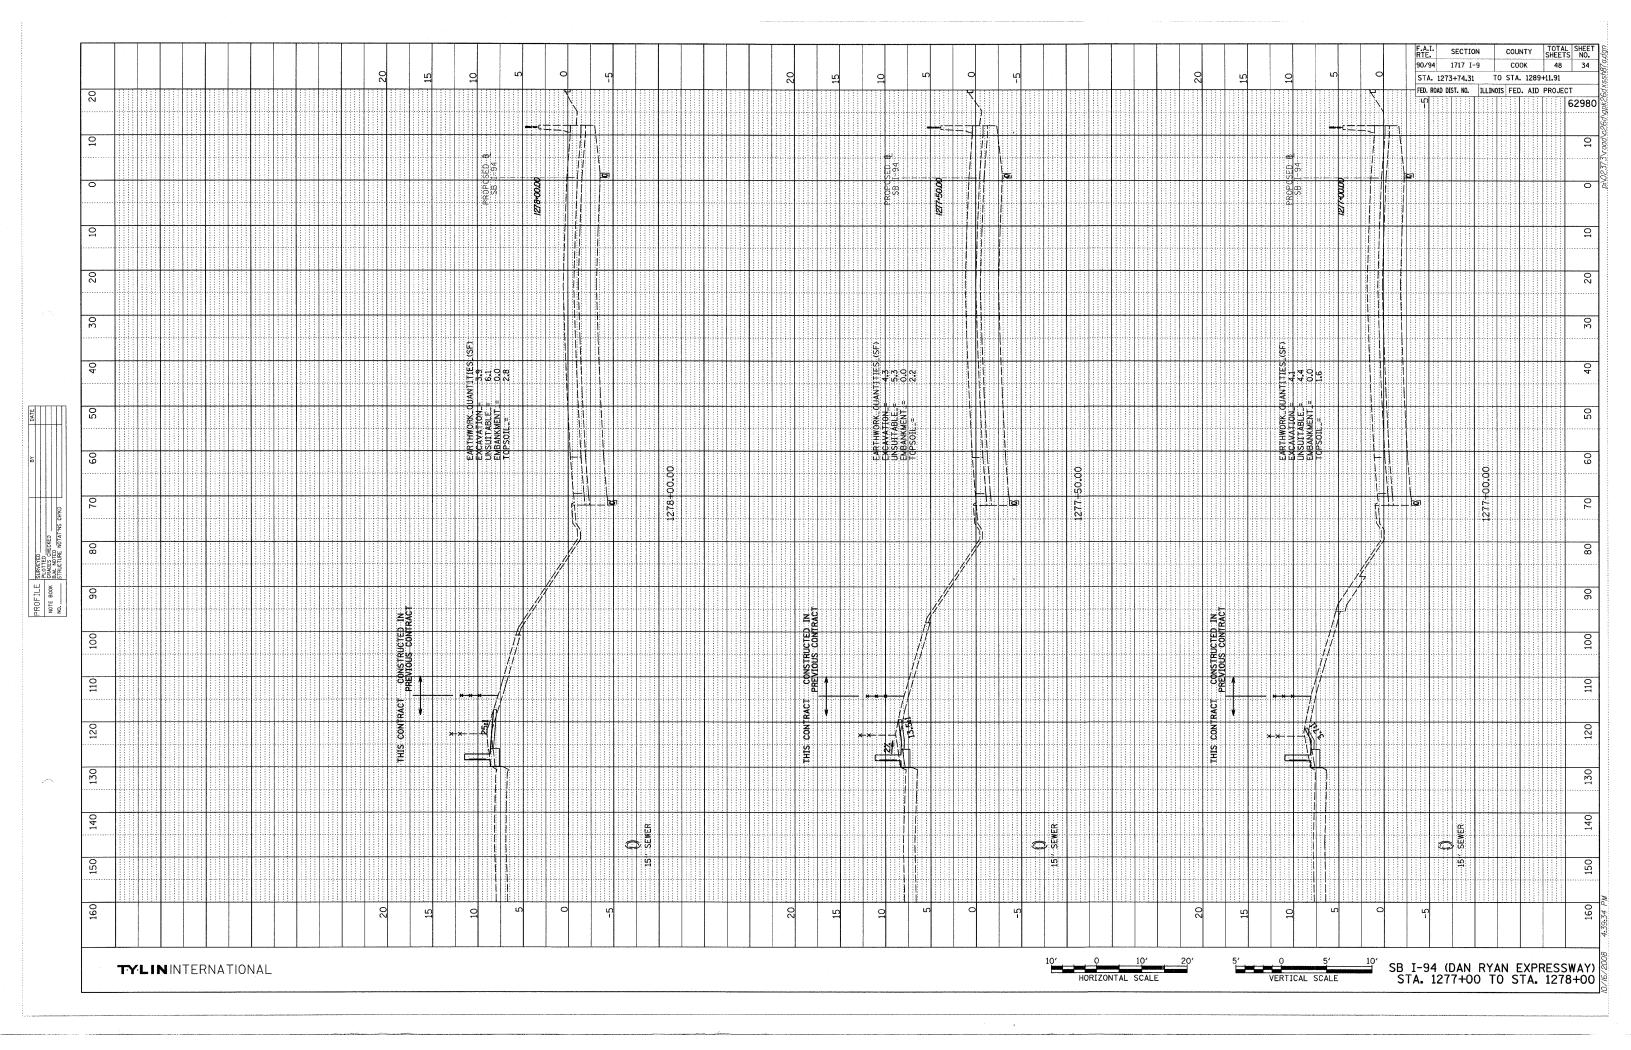
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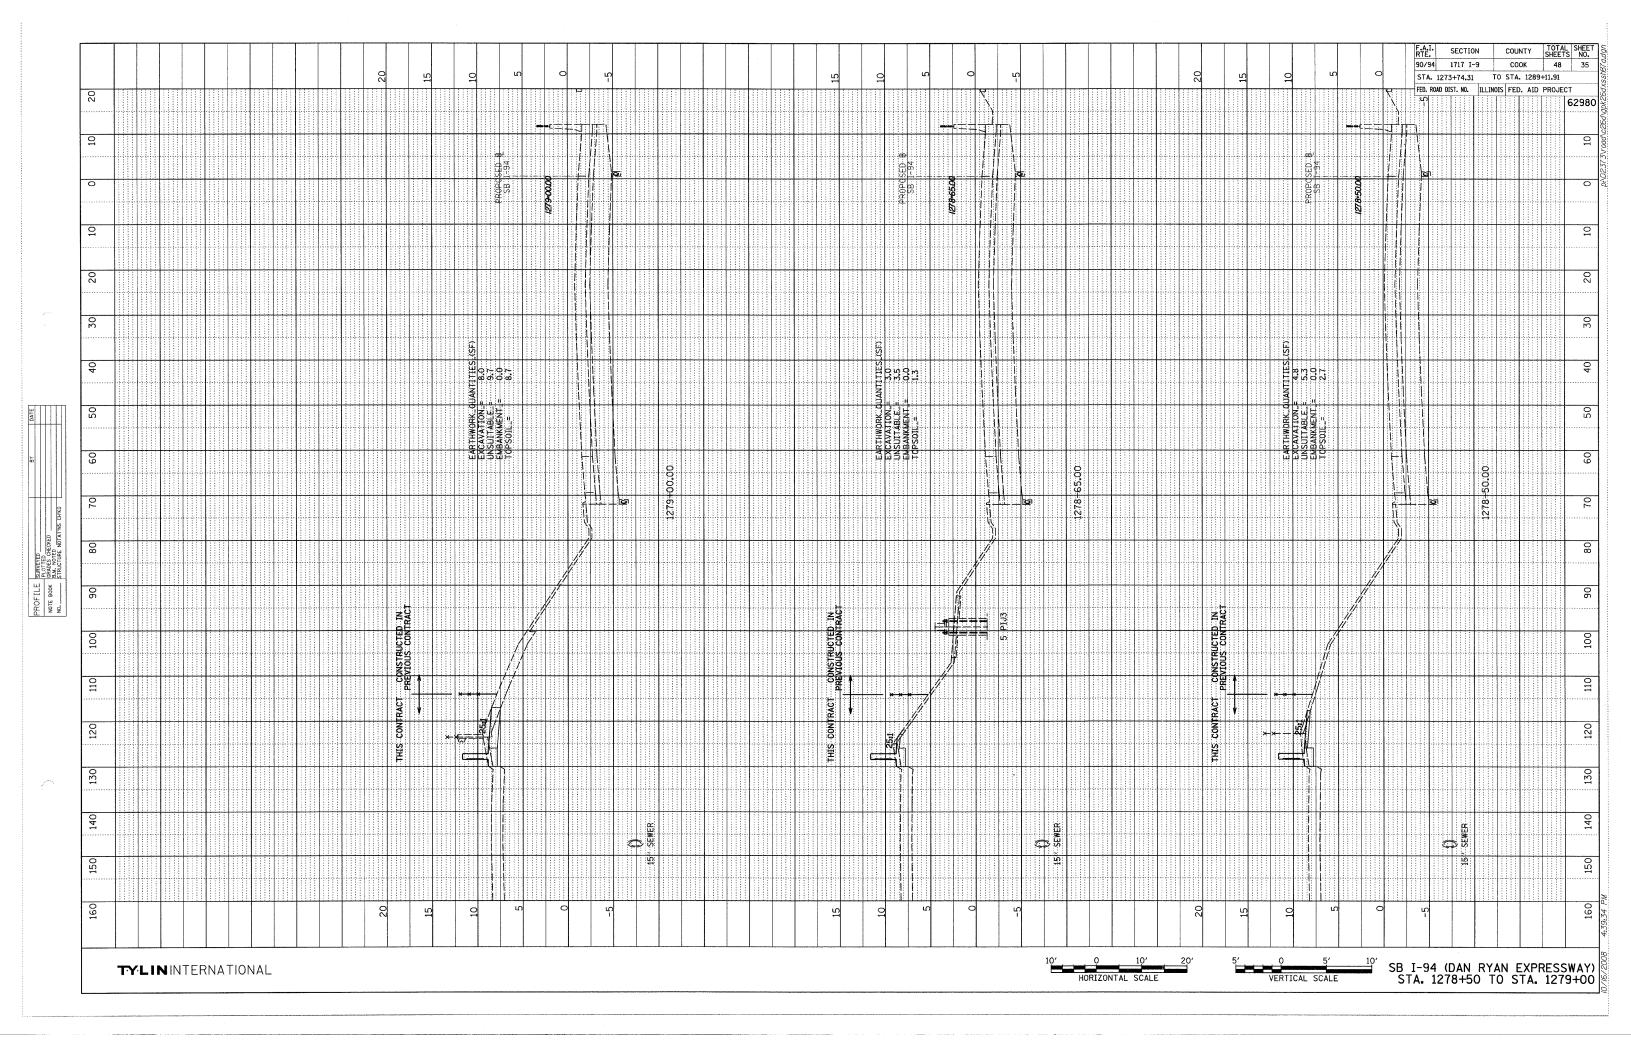
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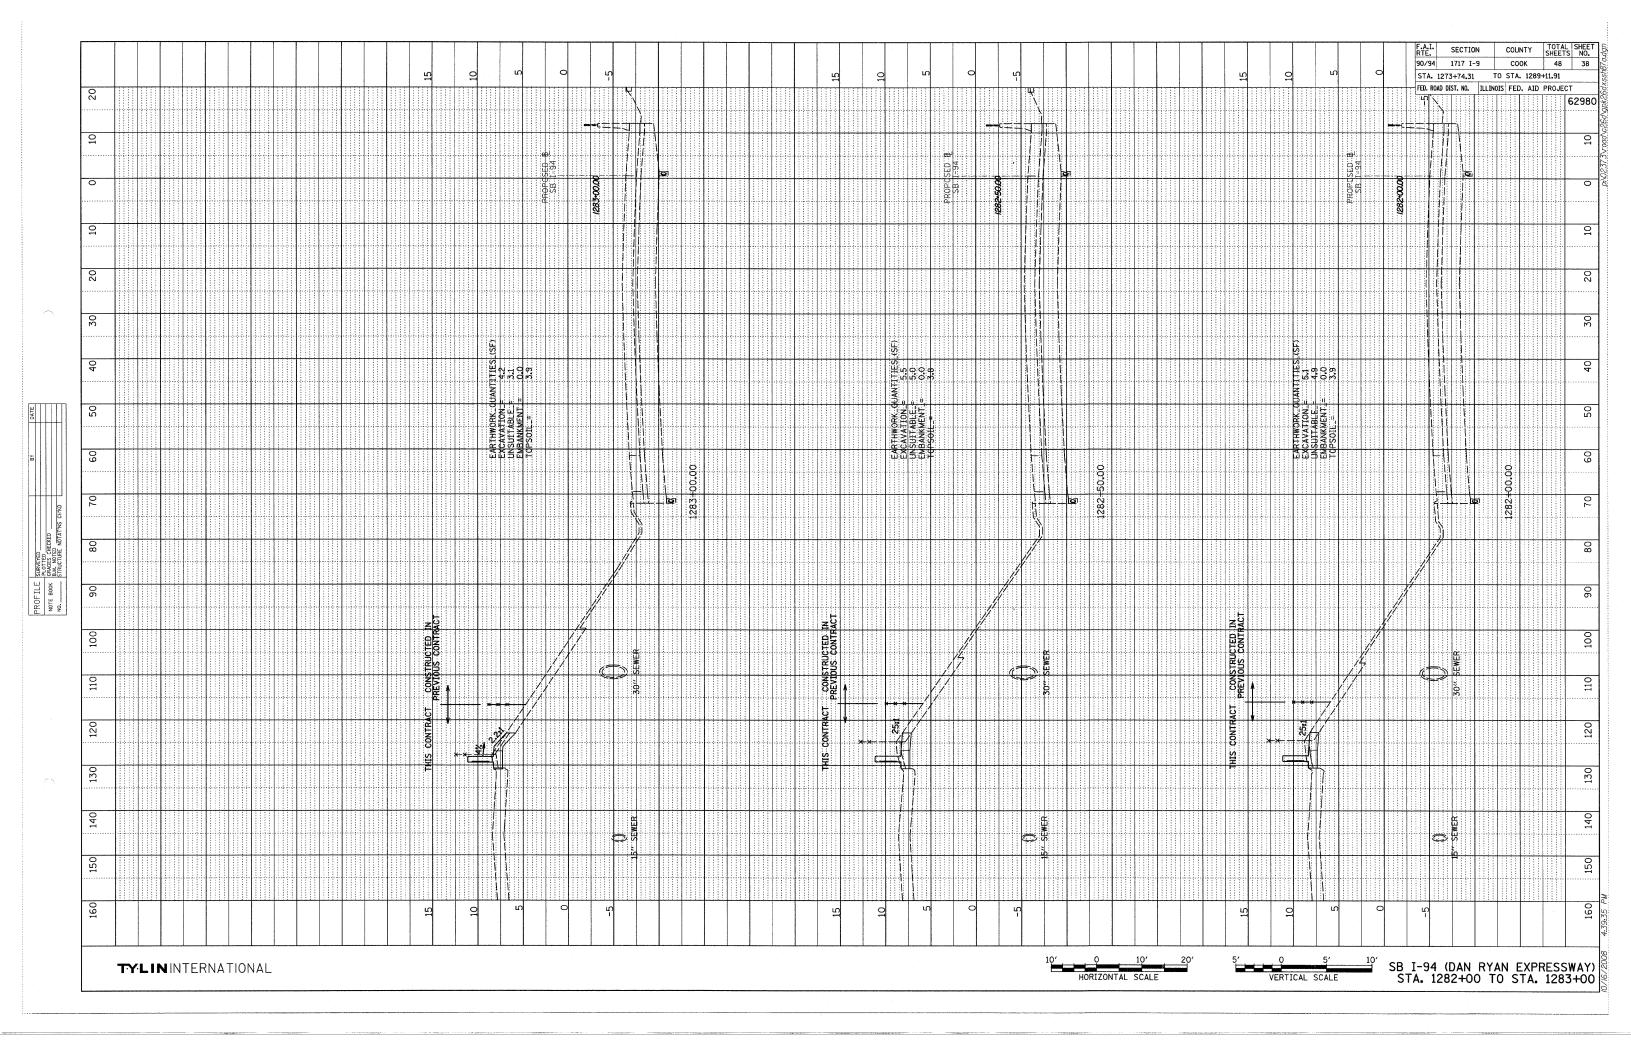








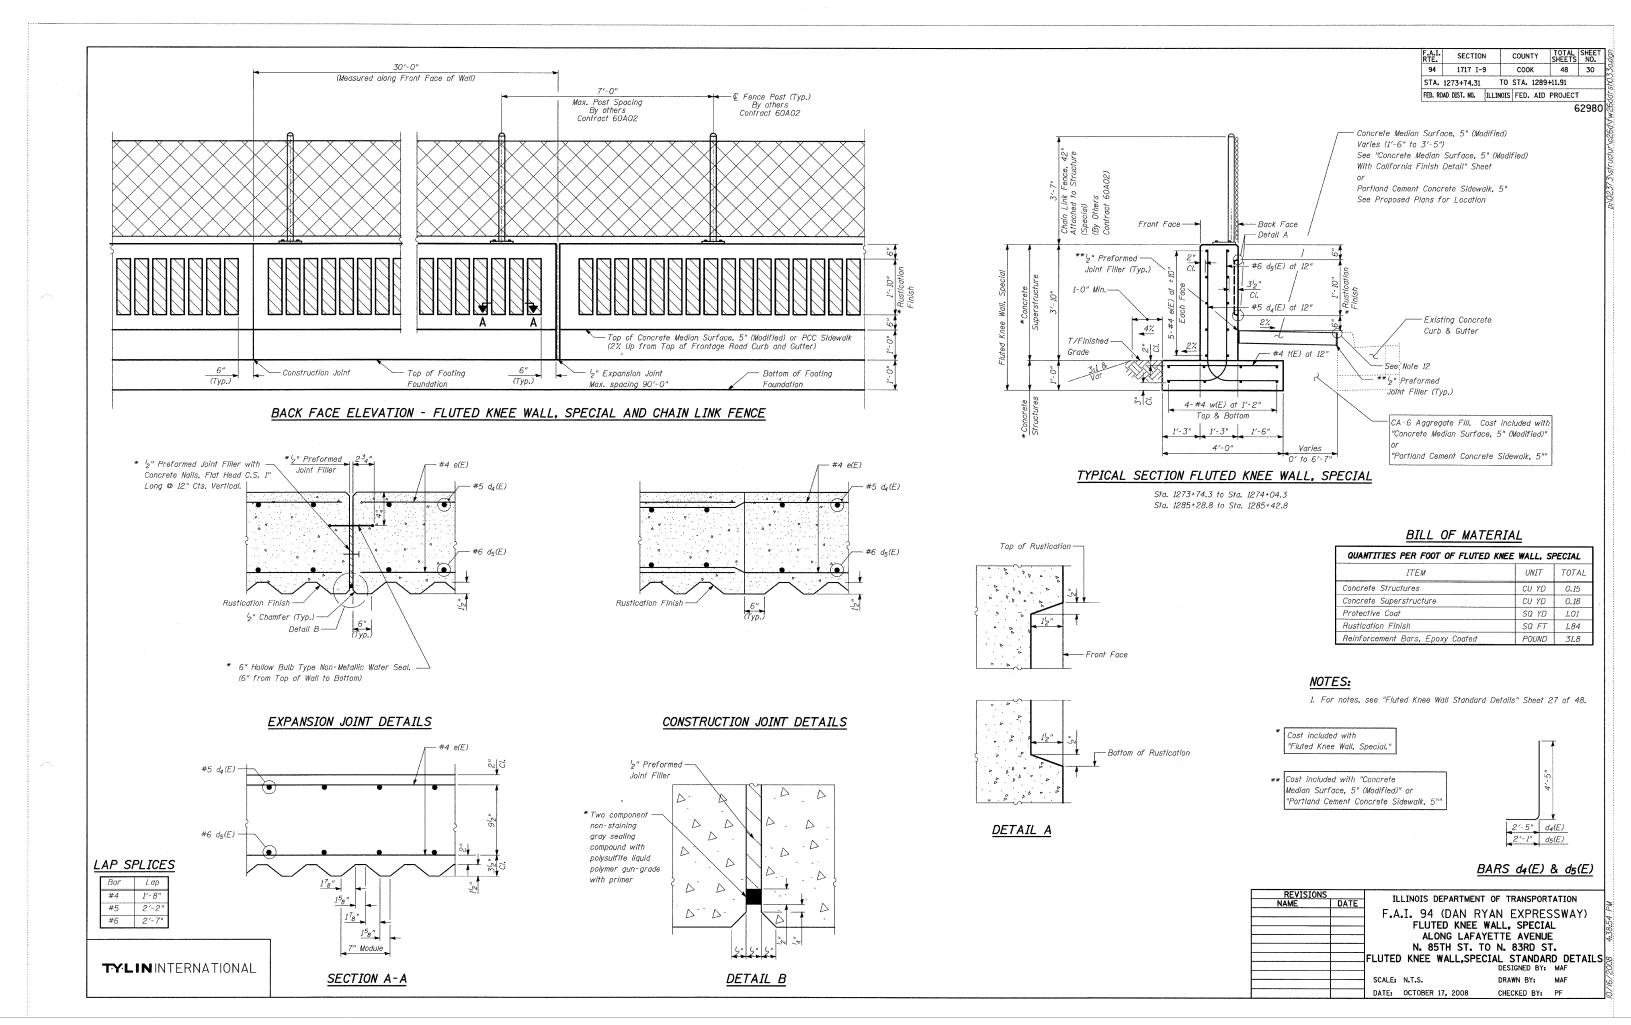


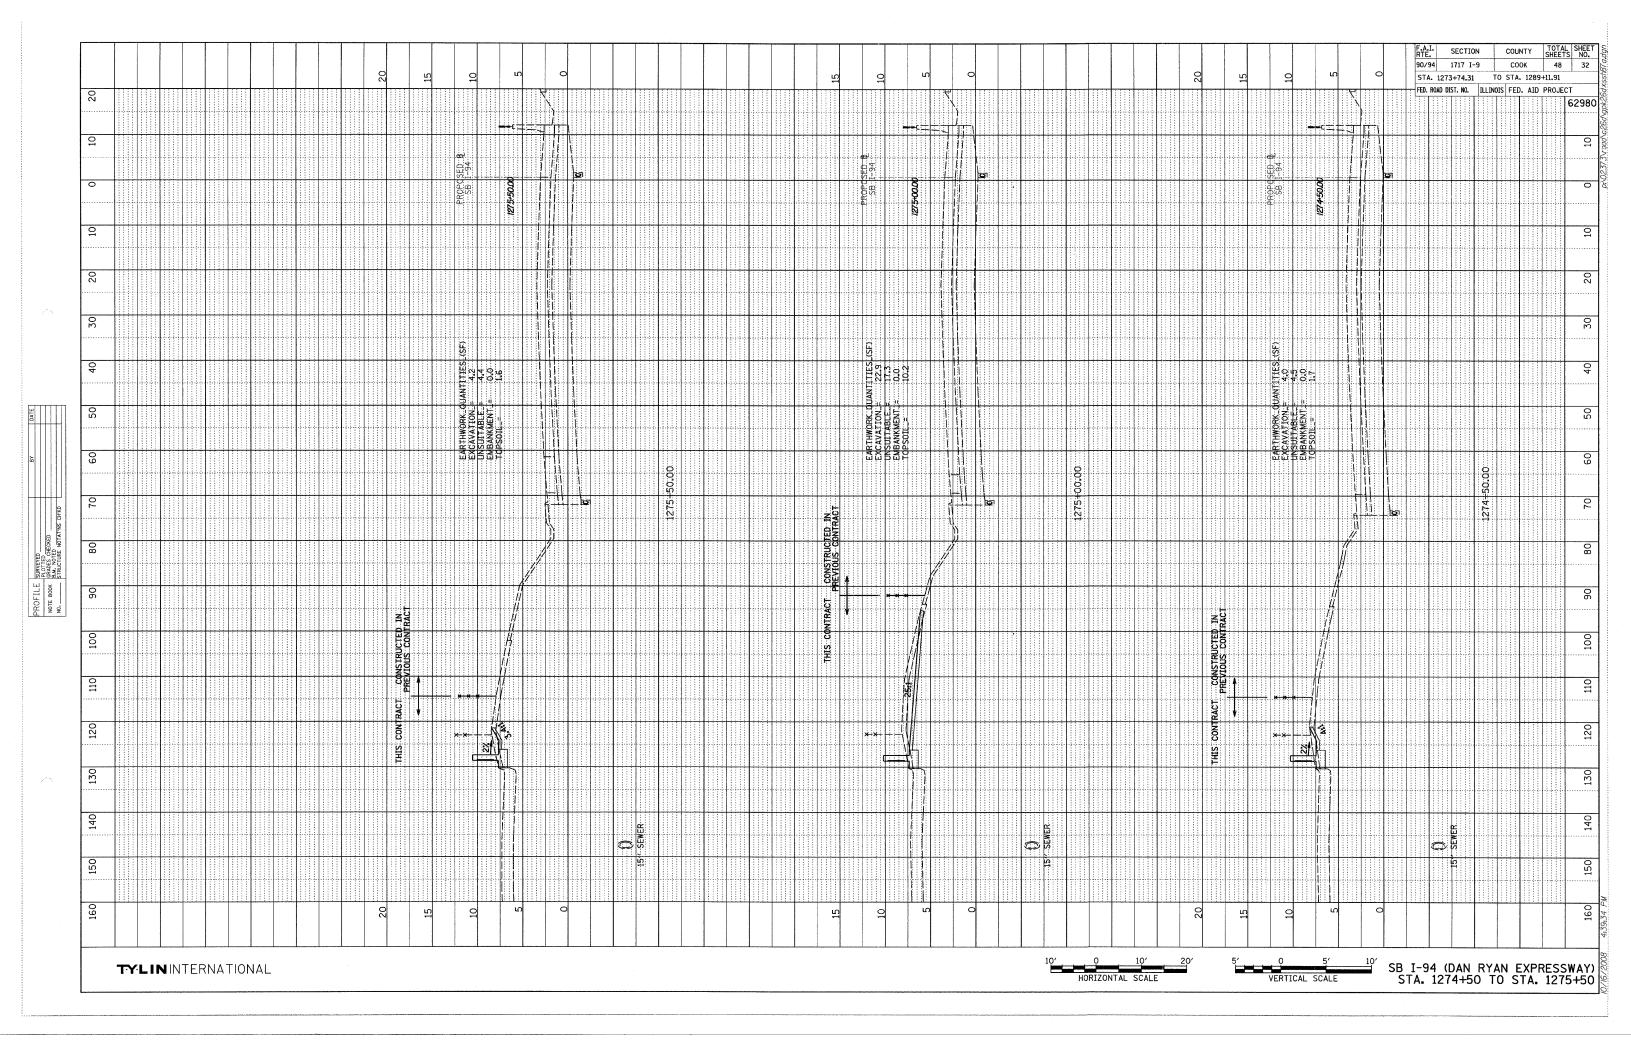


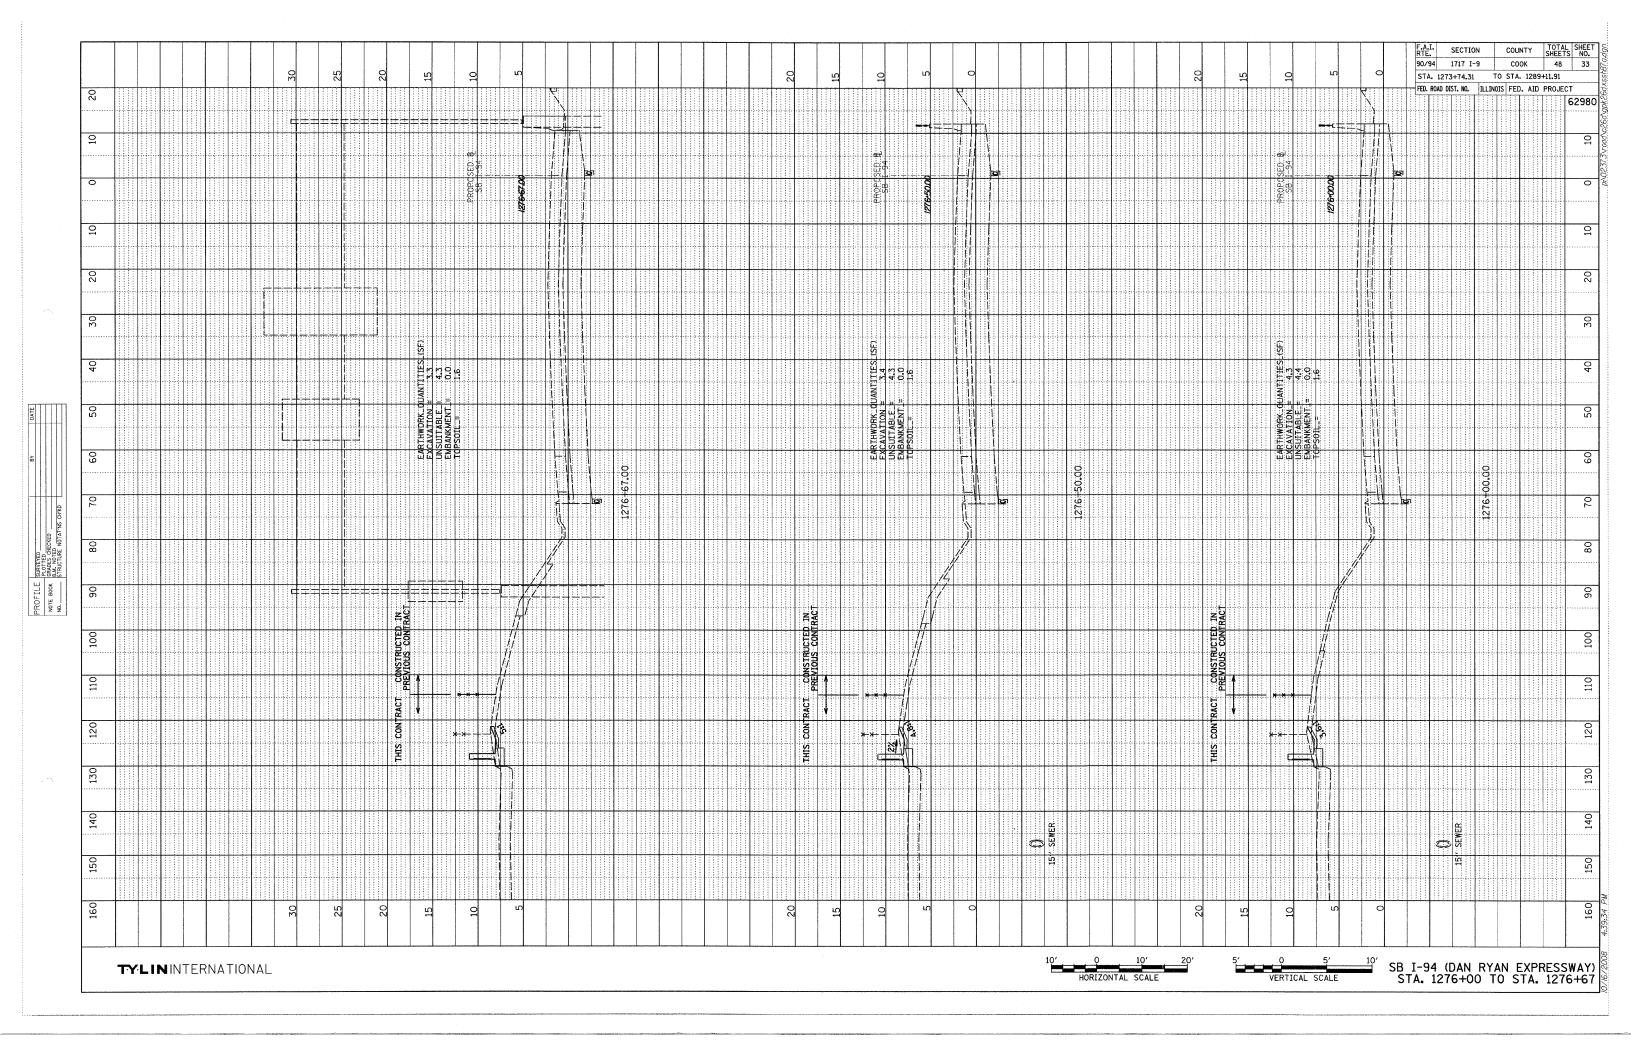


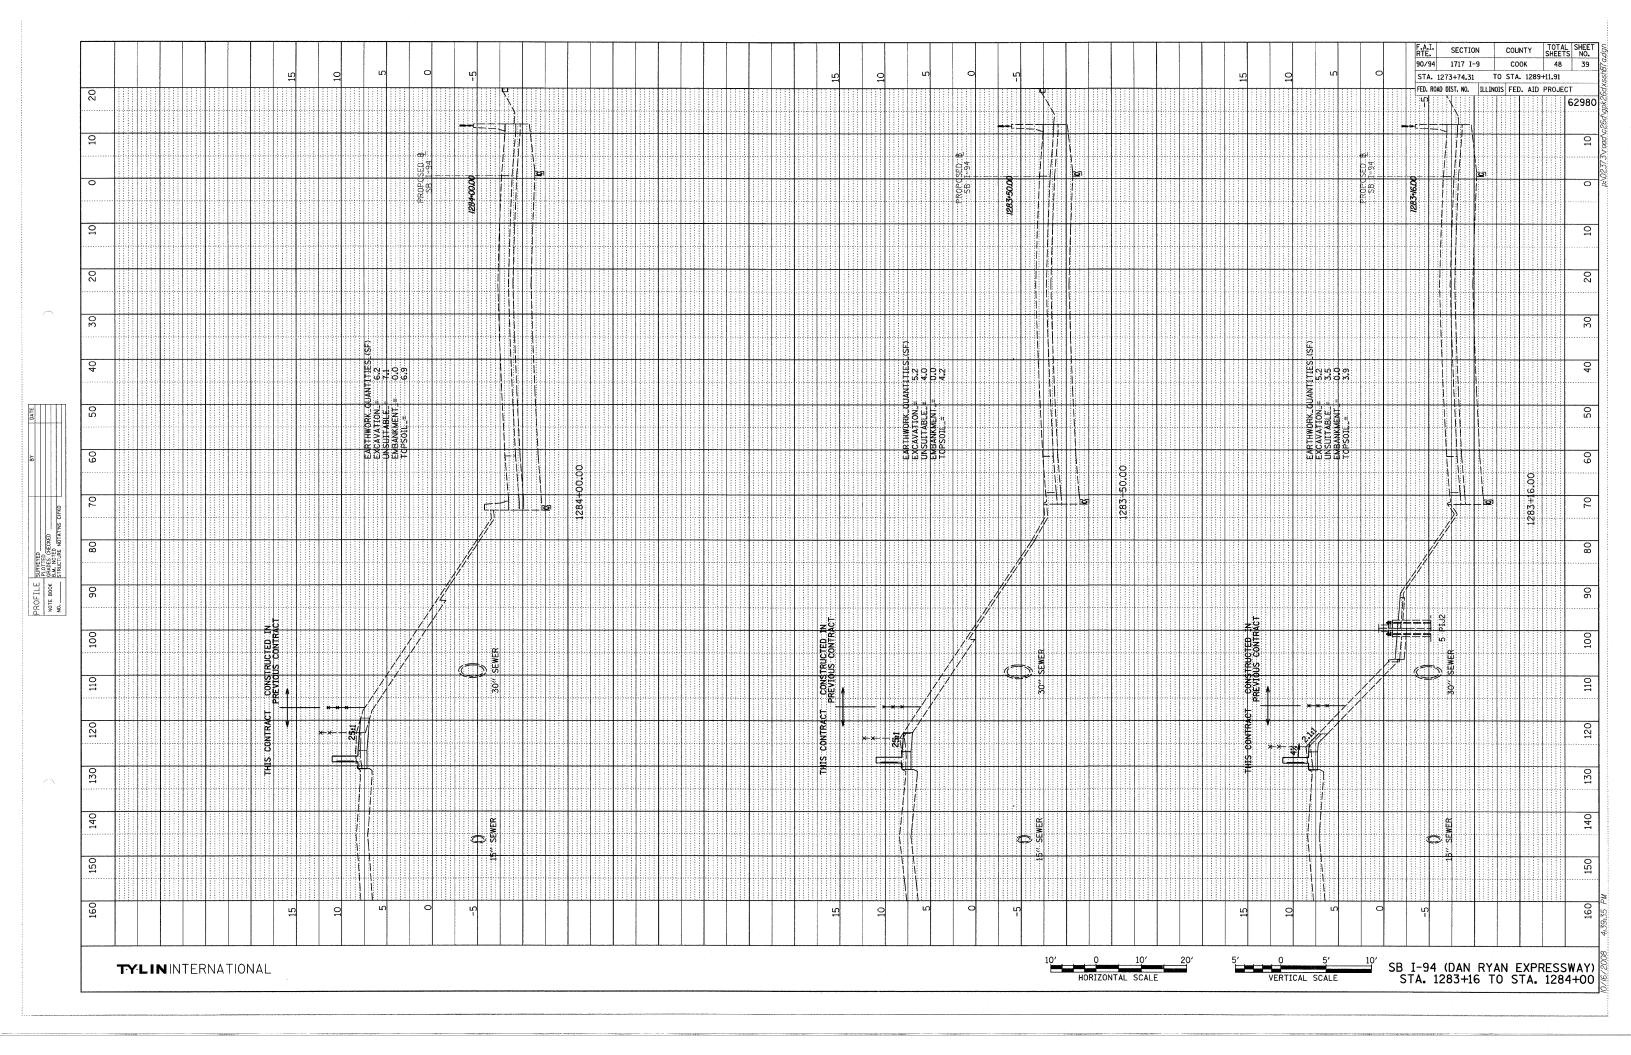

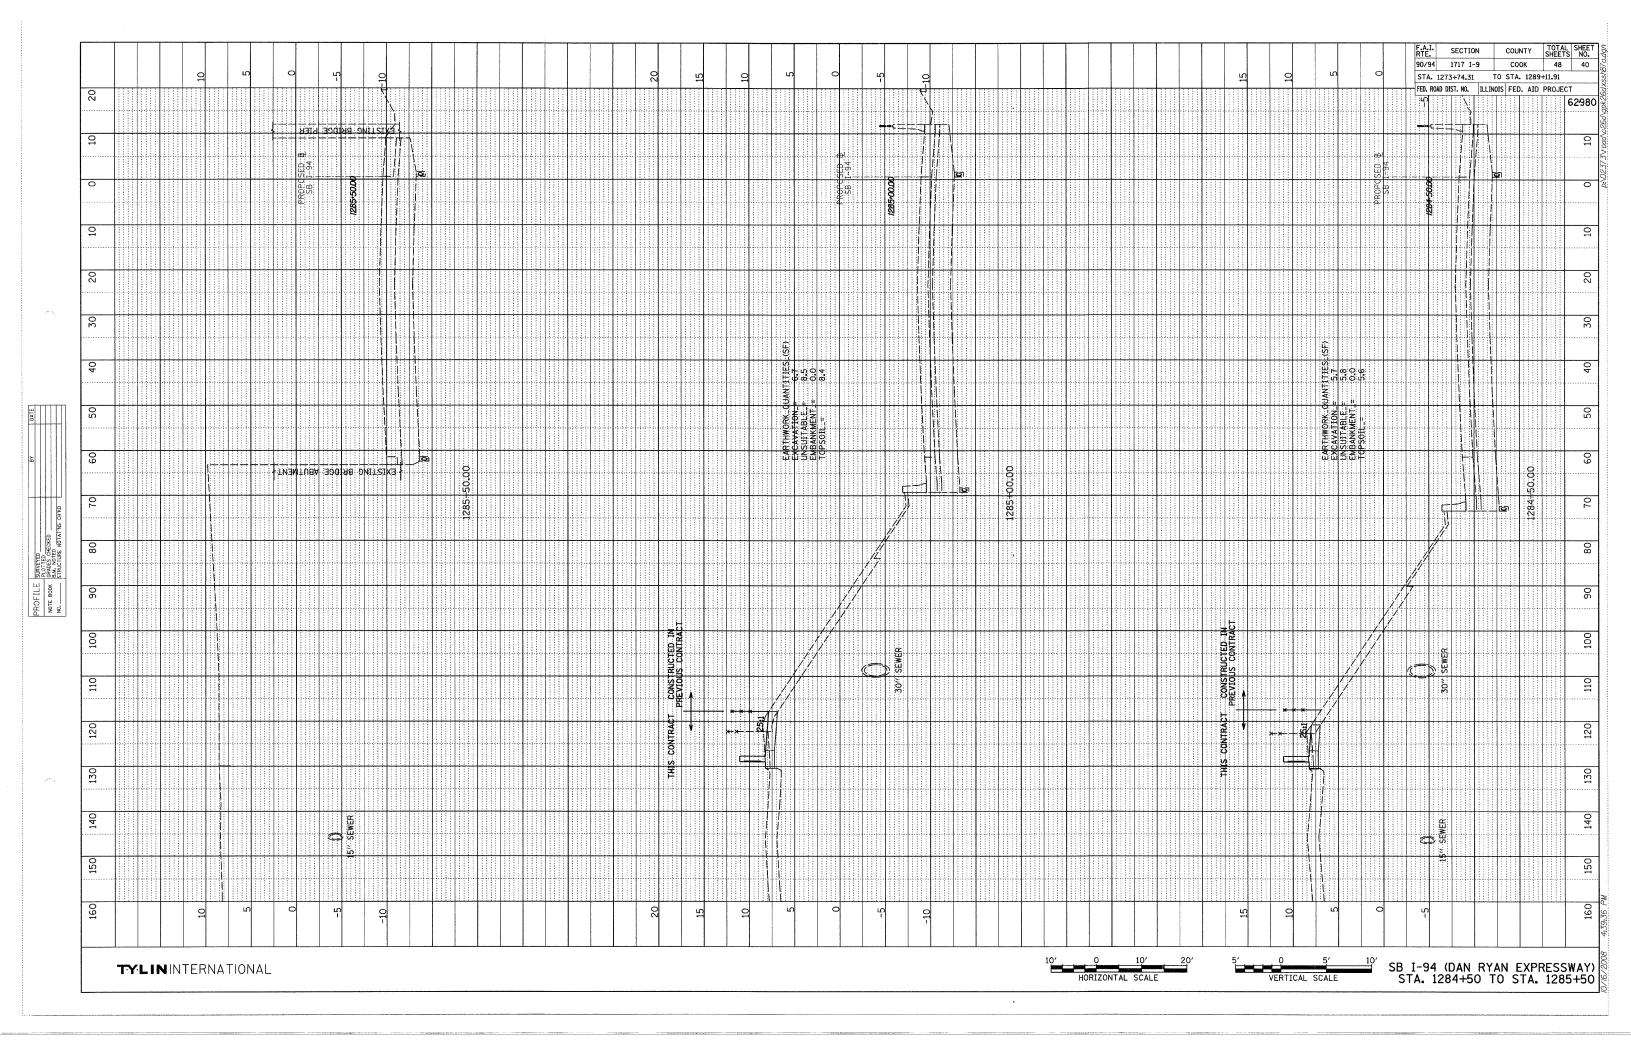

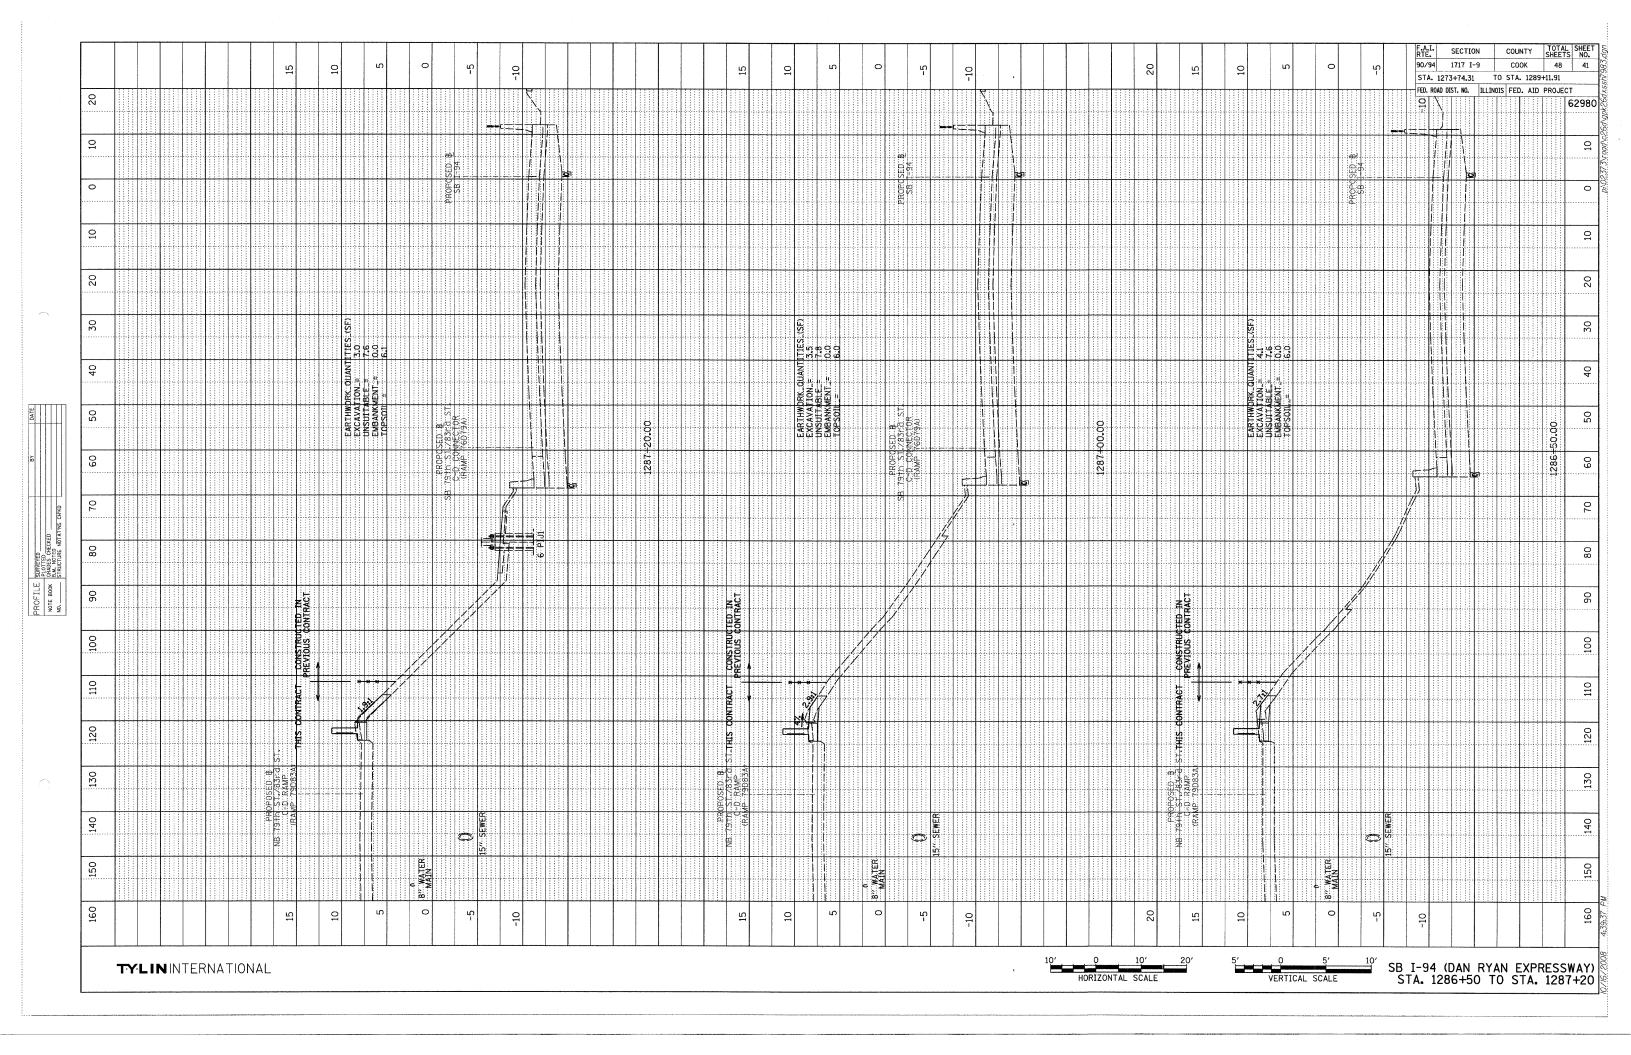

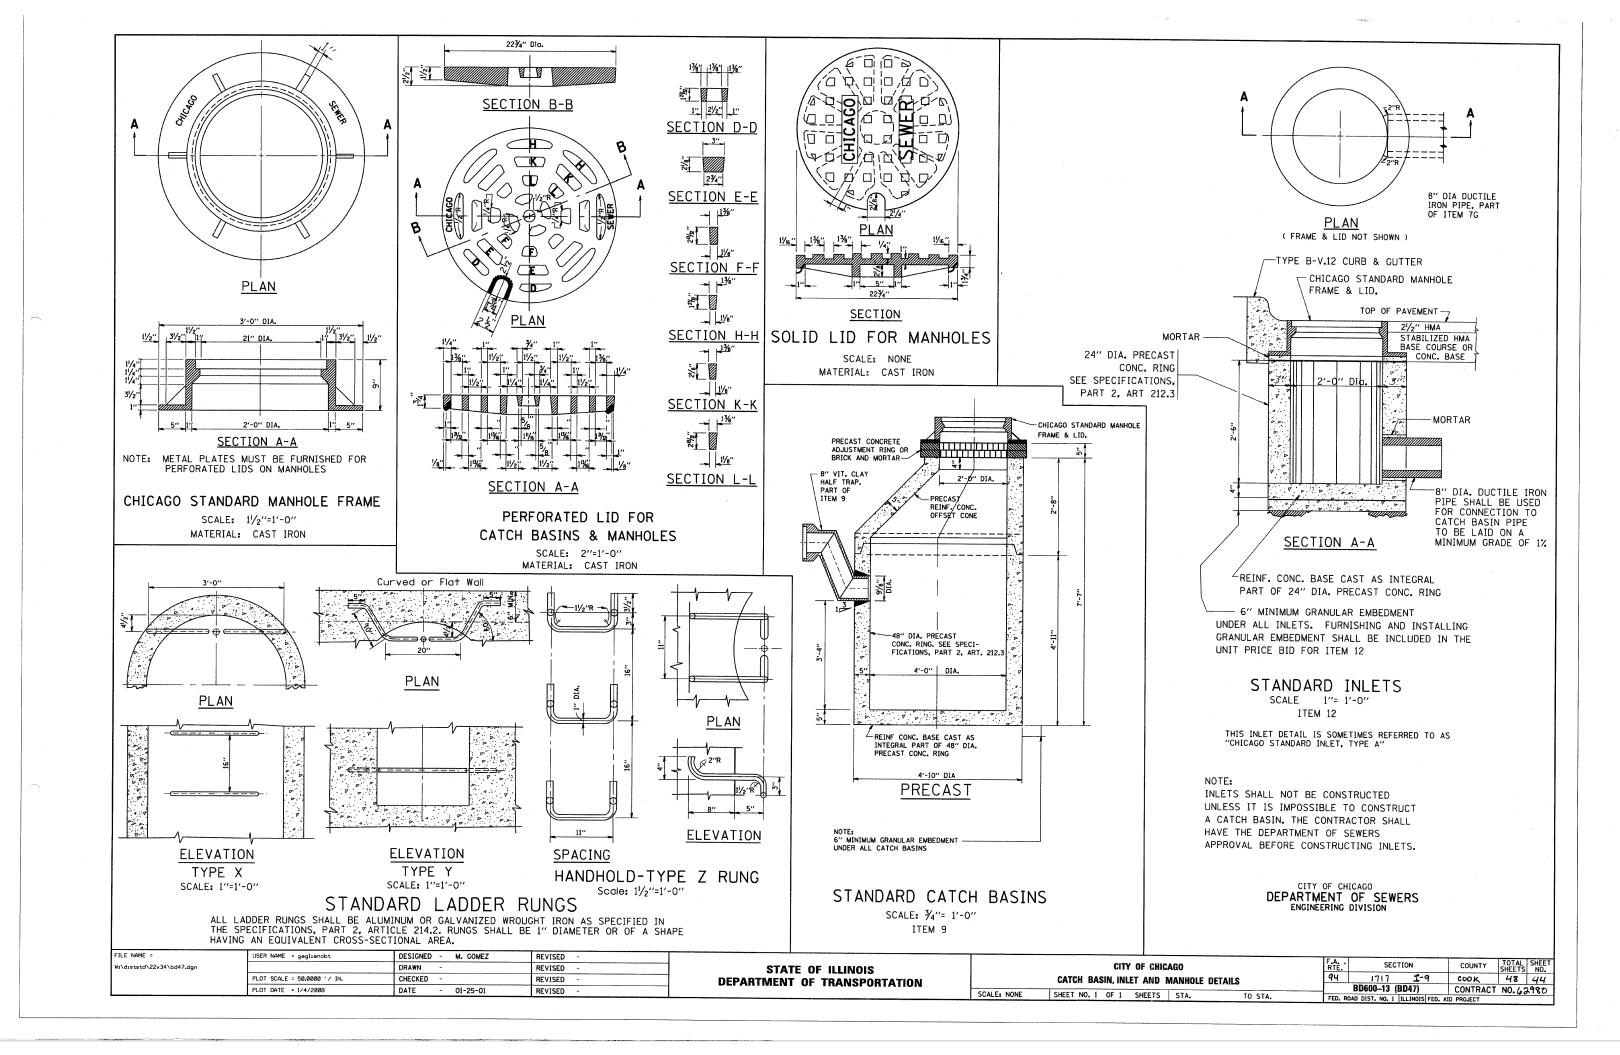

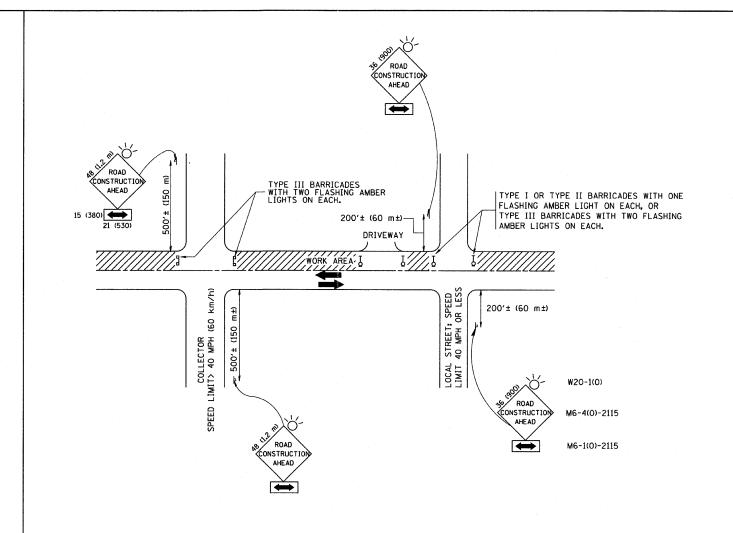

TRAFFIC CONTROL AND PROTECTION FOR SIDE ROADS, INTERSECTIONS, AND DRIVEWAYS

NOTES:

- A. FOR NO LANE RESTRICTION ON THE SIDE ROAD OR DRIVEWAYS
- 1. SIDE ROAD WITH A SPEED LIMIT OF 40 MPH (60 km/h) OR LESS AS SHOWN ON THE DRAWING AND AS DIRECTED BY THE ENGINEER:
- Q) ONE ROAD CONSTRUCTION AHEAD SIGN 36 x 36 (900x900) WITH A FLASHER AND FLAG MOUNTED ON 11 APPROXIMATELY 200' (60 m) IN ADVANCE OF THE MAIN ROUTE.
- b) THE CLOSED PORTION OF THE MAIN ROUTE SHALL BE PROTECTED BY BLOCKING WITH TYPE I, TYPE II OR TYPE III BARRICADES, 1/3 OF THE CROSS SECTION OF THE CLOSED PORTION,
- 2. SIDE ROAD WITH A SPEED LIMIT GREATER THAN 40 MPH (60 km/h) AS SHOWN ON THE DRAWING AND AS DIRECTED BY THE ENGINEER:
- a) ONE ROAD CONSTRUCTION AHEAD SIGN 48 x 48 (1.2 m x 1.2 m) WITH A FLASHER MOUNTED ON IT APPROXIMATELY 500' (150 m) IN ADVANCE OF THE MAIN ROLLE.
- b) THE CLOSED PORTION OF THE MAIN ROUTE SHALL BE PROTECTED BY BLOCKING WITH TYPE III BARRICADES, 1/2 OF THE CROSS SECTION OF THE CLOSED PORTION.
- WHEN THE SIDE ROAD LIES BETWEEN THE BEGINNING OF THE MAINLINE SIGNING AND THE WORK ZONE, A SINGLE HEADED ARROW (M6-1) SHALL BE USED IN LIEU OF THE DOUBLE HEADED ARROW (M6-4).

SCALE: NONE


- B. FOR A LANE CLOSURE ON A SIDE ROAD OR DRIVEWAY:
- USE APPLICABLE PORTIONS OF THE TYPICAL APPLICATION OF TRAFFIC CONTROL DEVICES (STD. 701501, STD. 701606 OR THE APPROPRIATE STANDARD). THE SPACING OF SIGNS AND BARRICADES SHALL BE ADJUSTED FOR FIELD CONDITIONS AS DIRECTED BY THE ENGINEER. THE DIRECTIONAL ARROW SHALL BE COVERED OR REMOVED WHEN NO LONGER CONSISTENT WITH THE SIDE ROAD LANE CLOSURE.
- C. ADVANCE WARNING SIGNS ARE TO BE OMITTED ON DRIVEWAY UNLESS OTHERWISE NOTED.
- D. THE TRAFFIC CONTROL AND PROTECTION FOR SIDE ROADS, INTERSECTIONS, AND DRIVEWAYS SHALL BE INCIDENTAL TO THE COST OF SPECIFIED TRAFFIC CONTROL STANDARDS OR ITEMS.

All dimensions are in millimeters (inches) unless otherwise shown.

FILE NAME =	USER NAME = gaglianobt	DESIGNED - LHA	REVISED - J. OBERLE 10-18-95						
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	PLOT DATE = 1/4/2008	DATE - 06-89	REVISED -T. RAMMACHER 01-06-0						


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DEPARTMENT	OF	TRANSPORTATION


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TRAFFIC CONTROL AND PROTECTION FOR SIDE ROADS, INTERSECTIONS, AND DRIVEWAYS			F.A RTE.	A. SECTION		COUNTY	TOTAL SHEETS	SHEET NO.
			94	1717	7-9	COOK	48	45
				TC-10)	CONTRACT	NO. 62	980
SHEET NO. 1 OF 1 SHEETS	STA. TO	STA.	FED. RC	DAD DIST. NO. 1	ILLINOIS FED. A	ID PROJECT		

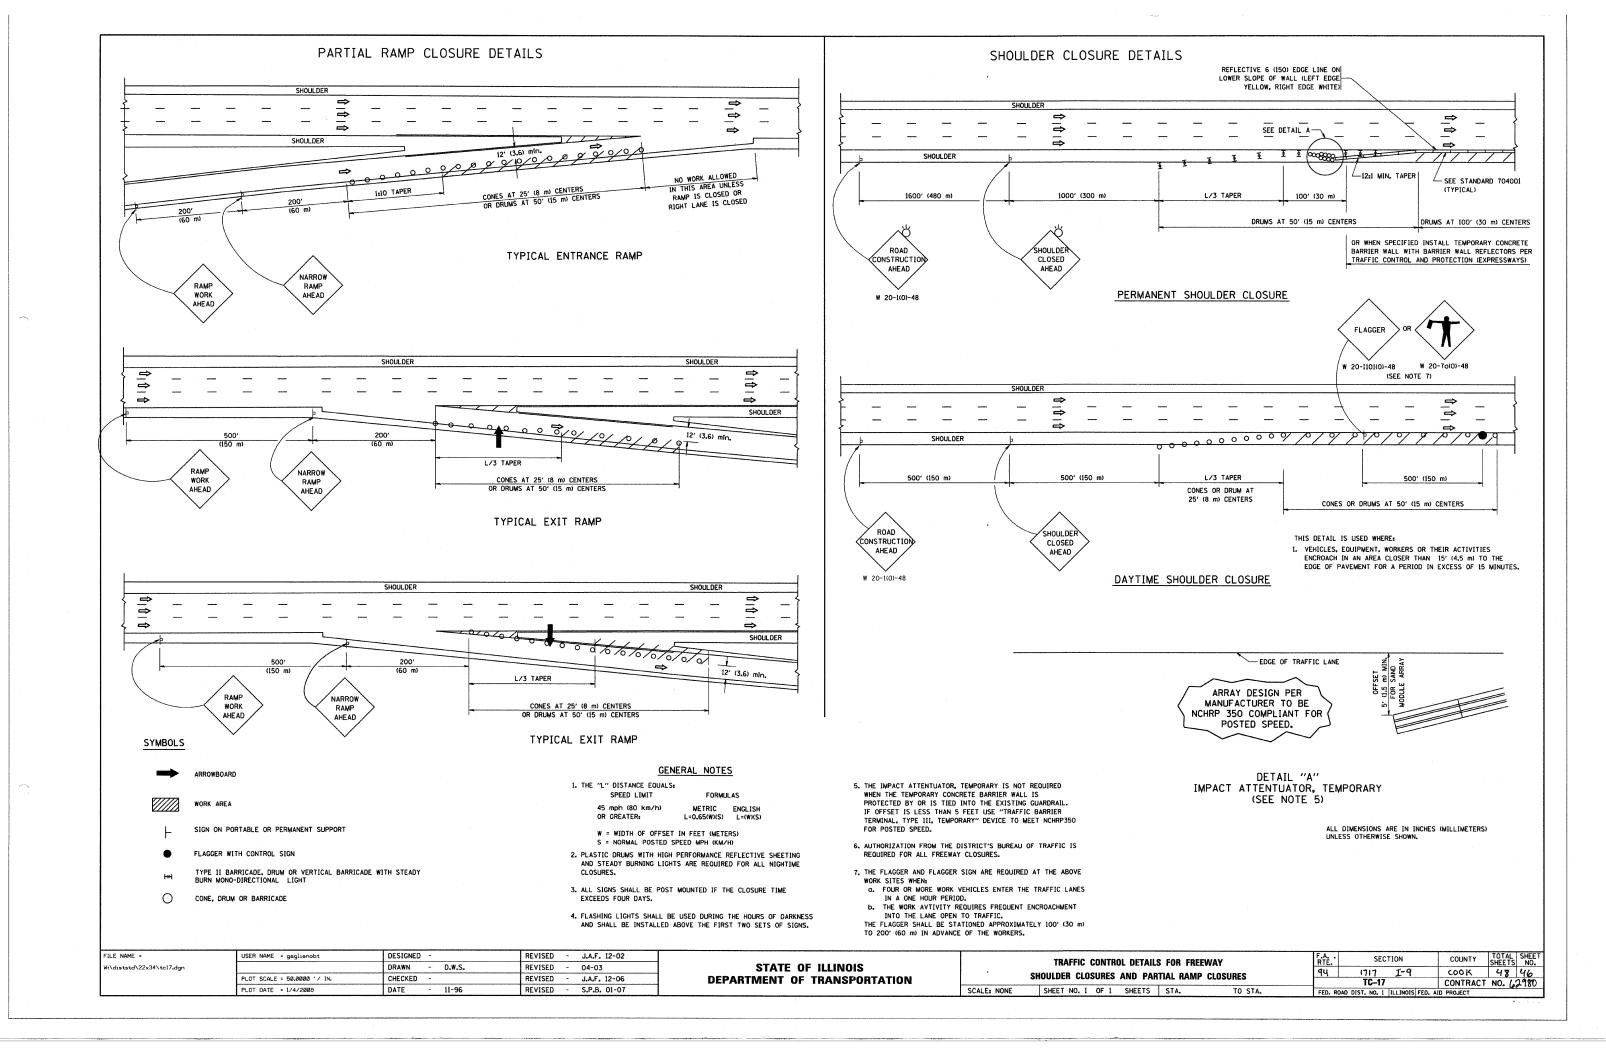

SIGNING FOR FLAGGING OPERATIONS AT WORK ZONE OPENINGS

WORK ZONE EXIT OPENING

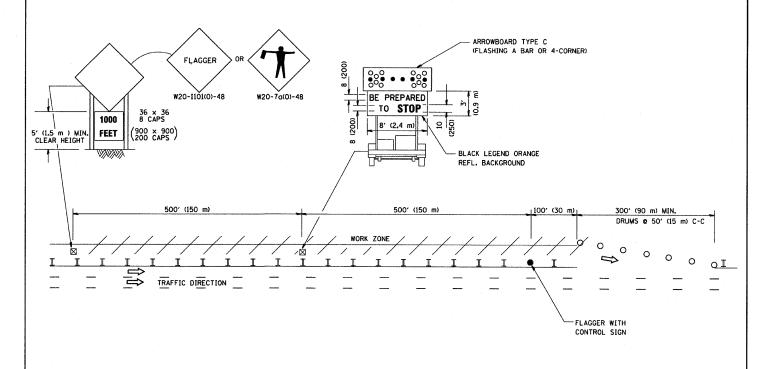

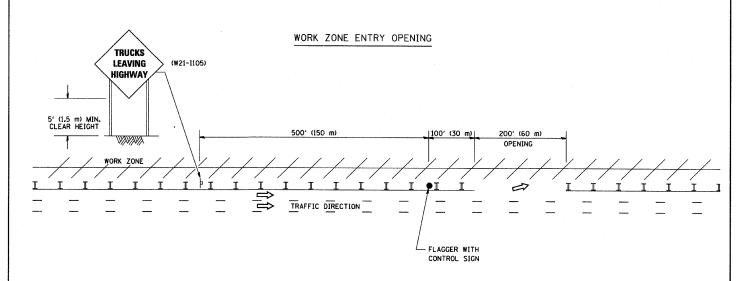


NOTES

- The Arrowboard, the Flagger Ahead trailer mounted sign, and the Trucks Leaving Highway sign shall be removed or turned away from traffic and the exit and entry openings shall be closed when the flagging operation ceases.
- 2. Work Zone Exit Openings should be a minimum of one half mile apart.
- Exiting the work zone at any place other than at a Work Zone Exit Opening will be prohibited.
- All vehicles shall enter the work zone at entry openings, using their turn signals to warn motorists

ALL DIMENSIONS ARE IN INCHES (MILLIMETERS) UNLESS OTHERWISE SHOWN

	FILE NAME =	USER NAME = gaglianobt	DESIGNED	REVISED - D.W.S. 08-98		AIGNING SOF THE ANNUA ANTI-LINE	F.A. SECTION	COUNTY TOTAL SHEET
	W:\diststd\22x34\tc18.dgn		DRAWN -	REVISED - J.A.F. 04-03	STATE OF ILLINOIS	SIGNING FOR FLAGGING OPERATIONS	() (Let	SHEETS NU.
ı	ľ	PLOT SCALE = 50.000 '/ IN.	CHECKED -	REVISED - J.A.F. 02-06	DEPARTMENT OF TRANSPORTATION	AT WORK ZONE OPENINGS	99 1111 23	COOK 48 47
L		PLOT DATE = 1/4/2008	DATE -	REVISED - S.P.B. 01-07		SCALE: NONE SHEET NO. 1 OF 1 SHEETS STA. TO STA.	FED. ROAD DIST. NO. 1 ILLINOIS FED. AI	CONTRACT NO. 62980

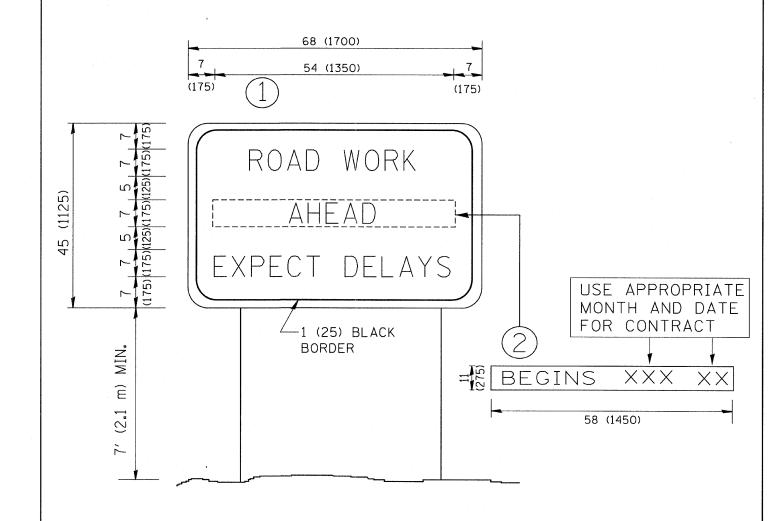

NOTES:

- 1. USE BLACK LETTERING ON ORANGE BACKGROUND.
- 2. ERECT SIGNS IN ADVANCE OF THE LOCATION FOR THE "ROAD CONSTRUCTION AHEAD" SIGN AT LOCATIONS AS DIRECTED BY THE ENGINEER.
- 3. ERECT SIGN (1) WITH INSTALLED PANEL (2) ONE WEEK PRIOR TO THE START OF CONSTRUCTION.
- 4. REMOVE PANEL (2) SOON AFTER THE START OF CONSTRUCTION.
- 5. SEE SPECIAL PROVISION FOR "TEMPORARY INFORMATION SIGNING" FOR ADDITIONAL INFORMATION.
- 6. ONE SIGN ASSEMBLY EQUALS 25.70 SQ. FT. (2.3 SQ. M.)
- 7. SHALL BE PAID FOR AS TEMPORARY INFORMATION SIGNING.

ALL DIMENSIONS ARE IN INCHES (MILLIMETERS) UNLESS OTHERWISE SHOWN.

FILE NAME =	USER NAME = gaglianobt	DESIGNED -	REVISED - R. MIRS 09-15-97			ANTENIAL DOAD		F.A.I.	SECTION	COUNTY	TOTAL	SH
W:\diststd\22x34\tc22.dgn		DRAWN -	REVISED - R. MIRS 12-11-97	DEPARTMENT OF TRANSPORTATION	ARTERIAL ROAD			RIE.	520.1011		SHEETS	1
	PLOT SCALE = 50.000 ' / IN.	CHECKED -	REVISED -T. RAMMACHER 02-02-99		INFORMATION SIGN			44	TC 22	CONTRAC	48	10
	PLOT DATE = 1/4/2008	DATE -	REVISED - C. JUCIUS 01-31-07		SCALE: NONE	SHEET NO. 1 OF 1 SHEETS ST	. TO STA.	FED. ROAD DIST			I NU. G	
										2		_