

STATE OF ILLINOIS  
DEPARTMENT OF TRANSPORTATION

DIVISION OF HIGHWAYS

**PROPOSED  
HIGHWAY PLANS**

FAS ROUTE 1388 (IL ROUTE 8)  
SECTION (Z-1VB)BR-2  
PROJECT STP-GLGM (789)  
STRUCTURE REPLACEMENT  
PEORIA COUNTY

C-94-056-08

FOR INDEX OF SHEETS, SEE SHEET NO. 2

**TRAFFIC DATA:**

IL ROUTE 8  
2015 ADT=2250 (ACTUAL)  
2017 ADT=2250 (ESTIMATED)  
2037 ADT=2745 (ESTIMATED)  
SU= 5.9% MU= 1.9%

**FUNCTIONAL CLASSIFICATION:**

2745 (2037) MAJOR COLLECTOR

F.A.S. RITE	SECTION	COUNTY	TOTAL SHEETS	SHEET NO.
1388	(Z-1VB)BR-2	PEORIA	235*	1
		ILLINOIS	CONTRACT NO. 68799	

\* 235 + 7 = 242 TOTAL SHEETS

D-94-037-08



LOCATION OF SECTION INDICATED THUS: -

**PLANS PREPARED BY:**



STATE OF ILLINOIS  
DEPARTMENT OF TRANSPORTATION

SUBMITTED May 06 20 21  
Kennel A. Darnett, P.E.  
REGIONAL ENGINEER

June 25 2021  
Scott A. Elk  
ENGINEER OF DESIGN AND ENVIRONMENT


June 25 20 21  
James J. Gunn  
DIRECTOR OF HIGHWAYS PROJECT IMPLEMENTATION

**PRINTED BY THE AUTHORITY  
OF THE STATE OF ILLINOIS**

BEGIN SECTION  
(Z-1VB)BR-2  
STA 125+00

SECTION (Z-1VB)BR-2  
INCLUDES REMOVAL OF  
THE EXISTING EIGHT SPAN  
BRIDGE AND REPLACE WITH  
A NEW THREE SPAN  
STRUCTURE 353'- 5 1/2"  
BACK TO BACK  
ABUTMENTS. THE NEW  
STRUCTURE CONSISTS OF  
PLATE GIRDERS WITH A  
COMPOSITE CONCRETE  
DECK ON REINFORCED  
CONCRETE COLUMNS  
PIERS AND INTEGRAL  
ABUTMENTS STA 142+72.94


END SECTION  
(Z-1VB)BR-2  
STA 160+70

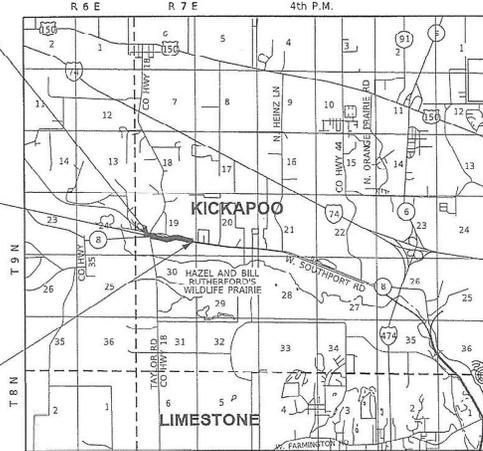

**LOCATION MAP**  
KICKAPOO TOWNSHIP



GROSS LENGTH = 3,570.00 FEET. = 0.676 MILES  
NET LENGTH = 3,570.00 FEET. = 0.676 MILES

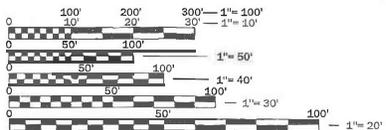

FULL SIZE PLANS HAVE BEEN PREPARED USING STANDARD  
ENGINEERING SCALES. REDUCED SIZED PLANS WILL NOT  
CONFORM TO STANDARD SCALES. IN MAKING MEASUREMENTS  
ON REDUCED PLANS, THE ABOVE SCALES MAY BE USED.

J.U.L.I.E.  
JOINT UTILITY LOCATION INFORMATION FOR EXCAVATION  
1-800-892-0123  
OR 811

PROJECT ENGINEER KEVIN HORST (309-671-3472)  
PROJECT MANAGER RICHARD DOTSON (309-671-3455)

CONTRACT NO. 68799

BY: William J. Coombe DATE: 8-22-19

EXPIRES 11-30-2020  
APPLIES TO PLAN SHEETS:  
62-95

CONSULTING ENGINEERS



BY: Matthew D. Duffley DATE: 8-22-19

EXPIRES 11-30-2019  
APPLIES TO PLAN SHEETS:  
29, 50-58

CONSULTING ENGINEERS



BY: Elizabeth S. Witt DATE: 8-22-19

EXPIRES 11-30-2019  
APPLIES TO PLAN SHEETS:  
1-28, 30-49, 59-61, 65-64, 119-235

CONSULTING ENGINEERS









Status of Utilities

AT&T

Route FAS 1388 (IL 8)
Section (Z-1VB)BR-2
County Peoria
Contract No. 68799
Catalog No. 033801-00D

Table with 6 columns: Route, Offset, Location - Measured Off Existing Centerline, Type of Utility, Type of Conflict, Disposition. Lists utility locations and proposed actions for AT&T.



Status of Utilities

Ameren Gas

Route FAS 1388 (IL 8)
Section (Z-1VB)BR-2
County Peoria
Contract No. 68799
Catalog No. 033801-00D

Table with 6 columns: Route, Offset, Location, Type of Utility, Type of Conflict, Disposition. Lists utility locations and proposed actions for Ameren Gas.



Status of Utilities

Ameren Illinois - Electric

Route FAS 1388 (IL 8)
Section (Z-1VB)BR-2
County Peoria
Contract No. 68799
Catalog No. 033801-00D

Table with 6 columns: Route, Offset, Location, Type of Utility, Type of Conflict, Disposition. Lists utility locations and proposed actions for Ameren Illinois - Electric.



Status of Utilities

TelStar

Route FAS 1388 (IL 8)
Section (Z-1VB)BR-2
County Peoria
Contract No. 68799
Catalog No. 033801-00D

Table with 6 columns: Route, Offset, Location, Type of Utility, Type of Conflict, Disposition. Lists utility locations and proposed actions for TelStar.

FILE NAME: D:\PROJECTS\UNIVERSITY\STATE\AS\AS\031118\_0 over BRISF at Eisenhower\Plan revision\DOT\_post\_Look\_Final\_Submittal\_E\_End with Mail\0468799-whg-gmsa-bag



USER NAME: horstg
MODEL NAME: Gen-03
PLOT SCALE: 0.1667 / in.
PLOT DATE: 4/27/2021

DESIGNED: JLS
DRAWN: PDB
CHECKED: ESW
DATE: 01-17-18

REVISED: KH (0001) 04/27/21
REVISED:
REVISED:
REVISED:

STATE OF ILLINOIS
DEPARTMENT OF TRANSPORTATION

STATUS OF UTILITIES
IL ROUTE 8

Table with 4 columns: F.A.S. RTE, SECTION, COUNTY, TOTAL SHEETS. Values: 1388, (Z-1VB)BR-2, PEORIA, 235 4.

SCALE: NONE SHEET 1 OF 1 SHEETS

ILLINOIS FED. AID PROJECT CONTRACT NO. 68799





**SUMMARY OF QUANTITIES**

CODE NO.	ITEM	UNIT	TOTAL QUANTITY	CONSTRUCTION CODE		
				80% FED 20% STATE		
				ROADWAY	BRIDGE	
				0004	0010	
				RURAL	RURAL	
40201000	AGGREGATE FOR TEMPORARY ACCESS	TON	190	190		
40600275	BITUMINOUS MATERIALS (PRIME COAT)	POUND	39490	39490		
40600295	POLYMERIZED BITUMINOUS MATERIALS (TACK COAT)	POUND	25348	25348		
40600990	TEMPORARY RAMP	SQ YD	13	13		
40701801	HOT-MIX ASPHALT PAVEMENT (FULL-DEPTH), 6"	SQ YD	2916	2916		
40701886	HOT-MIX ASPHALT PAVEMENT (FULL-DEPTH), 10 1/4"	SQ YD	8559	8559		
42000080	PAVEMENT CONNECTOR (PCC) FOR BRIDGE APPROACH SLAB	SQ YD	268	268		
42001300	PROTECTIVE COAT	SQ YD	246	246		
42300200	PORTLAND CEMENT CONCRETE DRIVEWAY PAVEMENT, 6 INCH	SQ YD	95	95		
44000100	PAVEMENT REMOVAL	SQ YD	9643	9643		
44000200	DRIVEWAY PAVEMENT REMOVAL	SQ YD	240	240		
44000400	GUTTER REMOVAL	FOOT	1464	1464		
48102100	AGGREGATE WEDGE SHOULDER, TYPE B	TON	595	595		
48203029	HOT-MIX ASPHALT SHOULDERS, 8"	SQ YD	5392	5392		

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USER NAME : diazza  
 MODEL NAME : SOQ-03  
 PLOT SCALE : 0.7667 / in.  
 PLOT DATE : 5/6/2021

DESIGNED - JLS  
 DRAWN - PDB  
 CHECKED - ESW  
 DATE - 01-17-18

REVISED - AAD (IDOT) 05/04/21  
 REVISED -  
 REVISED -  
 REVISED -

**STATE OF ILLINOIS  
 DEPARTMENT OF TRANSPORTATION**

**SUMMARY OF QUANTITIES  
 IL ROUTE 8**

SCALE: NONE    SHEET 3 OF 10 SHEETS

F.A.S. SITE	SECTION	COUNTY	TOTAL SHEETS	SHEET NO.
1388	(Z-1V)BJR-2	PEORIA	235	7
ILLINOIS FED. AID PROJECT			CONTRACT NO. 68799	



**SUMMARY OF QUANTITIES**

CODE NO.	ITEM	UNIT	TOTAL QUANTITY	CONSTRUCTION CODE		
				ROADWAY	BRIDGE	
				0004 RURAL	0010 RURAL	
				80% FED 20% STATE		
51203900	TEST PILE STEEL HP14X89	EACH	1		1	
51204650	PILE SHOES	EACH	72		72	
51500100	NAME PLATES	EACH	1		1	
52000110	PREFORMED JOINT STRIP SEAL	FOOT	118		118	
52100520	ANCHOR BOLTS, 1"	EACH	24		24	
52100530	ANCHOR BOLTS, 1 1/4"	EACH	24		24	
52200020	TEMPORARY SOIL RETENTION SYSTEM	SQ FT	1696		1696	
52200105	FURNISHING SOLDIER PILES (W SECTION)	FOOT	477	477		
52200200	DRILLING AND SETTING SOLDIER PILES (IN SOIL)	CU FT	1898	1898		
52200205	DRILLING AND SETTING SOLDIER PILES (IN ROCK)	CU FT	442	442		
52200250	UNTREATED TIMBER LAGGING	SQ FT	508	508		
54213681	PRECAST REINFORCED CONCRETE FLARED END SECTIONS 36"	EACH	2	2		
54213693	PRECAST REINFORCED CONCRETE FLARED END SECTIONS 48"	EACH	1	1		
54215448	CAST-IN-PLACE REINFORCED CONCRETE END SECTIONS 48"	EACH	2	2		

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USER NAME	• diazza
MODEL NAME	• SOQ-05
PLOT SCALE	• 0.7667 / in.
PLOT DATE	• 5/6/2021

DESIGNED	- JLS
DRAWN	- PDB
CHECKED	- ESW
DATE	- 01-17-18

REVISED	- AAD (IDOT) 05/04/21
REVISED	-
REVISED	-
REVISED	-

**STATE OF ILLINOIS  
DEPARTMENT OF TRANSPORTATION**

**SUMMARY OF QUANTITIES  
IL ROUTE 8**

SCALE: NONE    SHEET 5 OF 10 SHEETS

F.A.S. SITE	SECTION	COUNTY	TOTAL SHEETS	SHEET NO.
1388	(Z-1V)BJR-2	PEORIA	235	9
CONTRACT NO. 68799				
ILLINOIS FED. AID PROJECT				

**SUMMARY OF QUANTITIES**

CODE NO.	ITEM	UNIT	TOTAL QUANTITY	CONSTRUCTION CODE		
				80% FED 20% STATE		
				ROADWAY	BRIDGE	
				0004	0010	
				RURAL	RURAL	
54260842	SLOPED METAL END SECTION, STANDARD 542416, 42", 1:4	EACH	2	2		
54262724	METAL FLARED END SECTIONS 24"	EACH	2	2		
54262748	METAL FLARED END SECTIONS 48"	EACH	1	1		
542A1081	PIPE CULVERTS, CLASS A, TYPE 2 36"	FOOT	112	112		
542A2773	PIPE CULVERTS, CLASS A, TYPE 4 48"	FOOT	154	154		
542A4033	PIPE CULVERTS, CLASS A, TYPE 6 48"	FOOT	276	276		
542D0229	PIPE CULVERTS, CLASS D, TYPE 1 24"	FOOT	47	47		
542D0253	PIPE CULVERTS, CLASS D, TYPE 1 48"	FOOT	13	13		
542D5497	PIPE CULVERTS, CLASS D, TYPE 1 EQUIVALENT ROUND-SIZE 42"	FOOT	116	116		
58600101	GRANULAR BACKFILL FOR STRUCTURES	CU YD	285		285	
59100100	GEOCOMPOSITE WALL DRAIN	SQ YD	180	37	143	
60224446	MANHOLES, TYPE A, 7' DIAMETER, TYPE 1 FRAME, CLOSED LID	EACH	1	1		
60500060	REMOVING INLETS	EACH	2	2		
60605000	COMBINATION CONCRETE CURB AND GUTTER, TYPE B-6.24	FOOT	223.5	223.5		

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USER NAME : diazza  
 MODEL NAME : SOQ-08  
 PLOT SCALE : 0.7667 / in.  
 PLOT DATE : 5/9/2021

DESIGNED - JLS  
 DRAWN - PDB  
 CHECKED - ESW  
 DATE - 01-17-18

REVISED - AAD (IDOT) 05/04/21  
 REVISED -  
 REVISED -  
 REVISED -

**STATE OF ILLINOIS  
 DEPARTMENT OF TRANSPORTATION**

**SUMMARY OF QUANTITIES  
 IL ROUTE 8**

SCALE: NONE SHEET 6 OF 10 SHEETS

F.A.S. SITE	SECTION	COUNTY	TOTAL SHEETS	SHEET NO.
1388	(Z-1V)BJR-2	PEORIA	235	10
ILLINOIS FED. AID PROJECT			CONTRACT NO. 68799	

**SUMMARY OF QUANTITIES**

CODE NO.	ITEM	UNIT	TOTAL QUANTITY	CONSTRUCTION CODE		
				80% FED 20% STATE		
				ROADWAY	BRIDGE	
				0004	0010	
				RURAL	RURAL	
* 63000001	STEEL PLATE BEAM GUARDRAIL, TYPE A, 6 FOOT POSTS	FOOT	825	825		
* 63100085	TRAFFIC BARRIER TERMINAL, TYPE 6	EACH	4	4		
* 63100167	TRAFFIC BARRIER TERMINAL, TYPE 1 (SPECIAL) TANGENT	EACH	4	4		
* 63100169	TRAFFIC BARRIER TERMINAL, TYPE 1 (SPECIAL) FLARED	EACH	4	4		
63200310	GUARDRAIL REMOVAL	FOOT	1563	1563		
66600105	FURNISHING AND ERECTING RIGHT OF WAY MARKERS	EACH	31	31		
* 66700205	PERMANENT SURVEY MARKERS, TYPE I	EACH	17	17		
* 66900200	NON-SPECIAL WASTE DISPOSAL	CU YD	3750	3750		
* 66900530	SOIL DISPOSAL ANALYSIS	EACH	1	1		
* 66901001	REGULATED SUBSTANCES PRE-CONSTRUCTION PLAN	L SUM	1	1		
* 66901006	REGULATED SUBSTANCES MONITORING	CAL DA	20	20		
* 66901003	REGULATED SUBSTANCES FINAL CONSTRUCTION REPORT	L SUM	1	1		
67000400	ENGINEER'S FIELD OFFICE, TYPE A	CAL MO	24	24		
67000600	ENGINEER'S FIELD LABORATORY	CAL MO	24	24		

\* = SPECIALTY ITEM

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USER NAME • diazza  
 MODEL NAME • SOQ-67  
 PLOT SCALE • 0.7687 / in.  
 PLOT DATE • 5/4/2021

DESIGNED - JLS  
 DRAWN - PDB  
 CHECKED - ESW  
 DATE - 01-17-18

REVISED - AAD (IDOT) 05/04/21  
 REVISED -  
 REVISED -  
 REVISED -

**STATE OF ILLINOIS  
 DEPARTMENT OF TRANSPORTATION**

**SUMMARY OF QUANTITIES  
 IL ROUTE 8**

SCALE: NONE    SHEET 7 OF 10 SHEETS

F.A.S. SITE	SECTION	COUNTY	TOTAL SHEETS	SHEET NO.
1388	(Z-1V)BJR-2	PEORIA	235	11
ILLINOIS FED. AID PROJECT			CONTRACT NO. 68799	

**SUMMARY OF QUANTITIES**

CODE NO.	ITEM	UNIT	TOTAL QUANTITY	CONSTRUCTION CODE		
				80% FED 20% STATE		
				ROADWAY	BRIDGE	
				0004	0010	
				RURAL	RURAL	
67100100	MOBILIZATION	L SUM	1	1		
67201000	SEALING ABANDONED WATER WELLS	EACH	3	3		
70107025	CHANGEABLE MESSAGE SIGN	CAL DA	84	84		
* 72000100	SIGN PANEL - TYPE 1	SQ FT	157	157		
* 72000200	SIGN PANEL - TYPE 2	SO FT	12	12		
* 72400100	REMOVE SIGN PANEL ASSEMBLY - TYPE A	EACH	11	11		
* 72400200	REMOVE SIGN PANEL ASSEMBLY - TYPE B	EACH	4	4		
* 72400500	RELOCATE SIGN PANEL ASSEMBLY - TYPE A	EACH	2	2		
* 72400600	RELOCATE SIGN PANEL ASSEMBLY - TYPE B	EACH	3	3		
* 72501000	TERMINAL MARKER - DIRECT APPLIED	EACH	8	8		
72800100	TELESCOPING STEEL SIGN SUPPORT	FOOT	461	461		
73000100	WOOD SIGN SUPPORT	FOOT	78	78		
* 78009004	MODIFIED URETHANE PAVEMENT MARKING - LINE 4"	FOOT	17110	17110		
* 78009012	MODIFIED URETHANE PAVEMENT MARKING - LINE 12"	FOOT	47	47		
* 78009024	MODIFIED URETHANE PAVEMENT MARKING - LINE 24"	FOOT	33	33		

\*= SPECIALTY ITEM

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USER NAME : d1a2za  
 MODEL NAME : SOQ-08  
 PLOT SCALE : 0.7667 / in.  
 PLOT DATE : 5/4/2021

DESIGNED - JLS  
 DRAWN - PDB  
 CHECKED - ESW  
 DATE - 01-17-18

REVISED - AAD (IDOT) 05/04/21  
 REVISED -  
 REVISED -  
 REVISED -

**STATE OF ILLINOIS  
 DEPARTMENT OF TRANSPORTATION**

**SUMMARY OF QUANTITIES  
 IL ROUTE 8**

SCALE: NONE SHEET 8 OF 10 SHEETS

F.A.S. SITE	SECTION	COUNTY	TOTAL SHEETS	SHEET NO.
1388	(Z-1V)BJR-2	PEORIA	235	12
ILLINOIS FED. AID PROJECT			CONTRACT NO. 68799	



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CODE NO.	ITEM	UNIT	TOTAL QUANTITY	CONSTRUCTION CODE		
				80% FED 20% STATE		
				ROADWAY	BRIDGE	
				0004	0010	
				RURAL	RURAL	
Z0004542	HOT-MIX ASPHALT REMOVAL (SPECIAL)	SQ YD	450	450		
Z0004552	APPROACH SLAB REMOVAL	SQ YD	178	178		
Z0007601	BUILDING REMOVAL NO. 1	L SUM	1	1		
Z0007602	BUILDING REMOVAL NO. 2	L SUM	1	1		
Z0007603	BUILDING REMOVAL NO. 3	L SUM	1	1		
Z0013798	CONSTRUCTION LAYOUT	L SUM	1	1		
Z0018002	DRAINAGE SCUPPERS, DS-11	EACH	4		4	
Z0034105	MATERIAL TRANSFER DEVICE	TON	5893	5893		
Z0040000	PIEZOMETERS	EACH	4	4		
Z0046304	PIPE UNDERDRAINS FOR STRUCTURES 4"	FOOT	222		222	
Z0048665	RAILROAD PROTECTIVE LIABILITY INSURANCE	L SUM	1	1		
* Z0054400	ROCK FILL	CU YD	351	351		
∅ Z0076600	TRAINEES	hour	2,000	2,000		
Z0056100	SAND DRAINAGE BLANKET	CU YD	17,986	17,986		
∅ Z0076604	TRAINEES - TRAINING PROGRAM GRADUATE	hour	2,000	2,000		
Z0065100	SETTLEMENT PLATFORMS	EACH	4	4		

\* = SPECIALTY ITEM ∅ 0042



USER NAME : dhaizer  
 MODEL NAME : SC0-10  
 PLOT SCALE : 0.1667 / in  
 PLOT DATE : 5/4/21

DESIGNED - JLS  
 DRAWN - PDB  
 CHECKED - ESW  
 DATE - 01-17-19

REVISED - AAD (007) 05/04/21  
 REVISED -  
 REVISED -  
 REVISED -

STATE OF ILLINOIS  
 DEPARTMENT OF TRANSPORTATION


SUMMARY OF QUANTITIES  
 IL ROUTE 8

SCALE: NONE SHEET 10 OF 10 SHEETS


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1389	(Z-1V8)BR-2	PEORIA	235	14
CONTRACT NO. 68799			ILLINOIS FED. AID PROJECT	

**LEGEND**

- ① EXISTING PORTLAND CEMENT CONCRETE PAVEMENT
- ② EXISTING ASPHALT RESURFACING, 6" AND VARIES
- ③ EXISTING BITUMINOUS WIDENING, 9"
- ④ EXISTING BITUMINOUS SHOULDER, 9"
- ⑤ EXISTING GUTTER
- ⑥ EXISTING AGGREGATE BASE
- ⑦ EXISTING OIL AND CHIP SURFACE

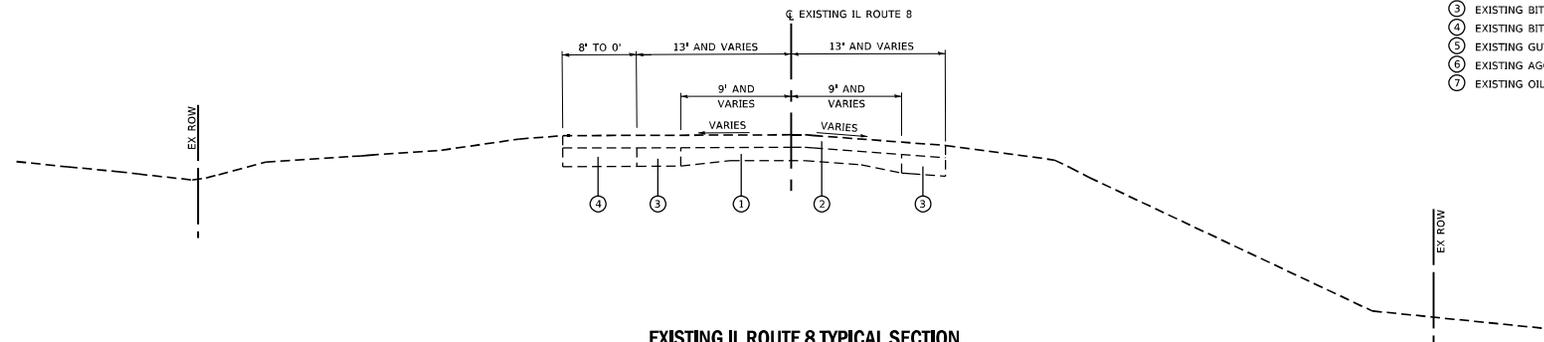

**EXISTING IL ROUTE 8 TYPICAL SECTION**  
STA 125+00.00 TO STA 127+27.00

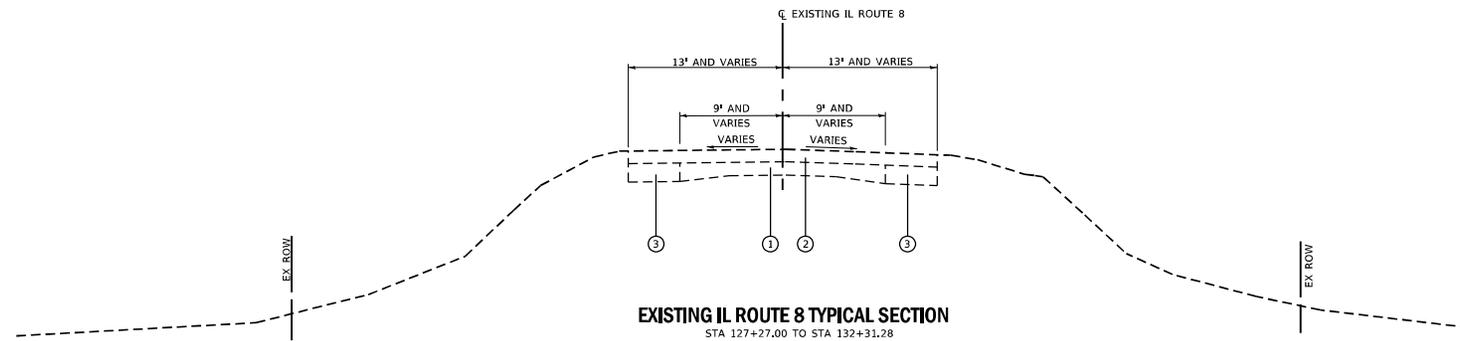

**EXISTING IL ROUTE 8 TYPICAL SECTION**  
STA 127+27.00 TO STA 132+31.28  
STA 156+66.78 TO STA 160+70.00

FILE NAME: S:\Projects\188-024-001\_IL\_8\_sar\_BNSF\_Peoria\_IL\Output\000 Sheets\046\Typical\typical\_watdgn



USER NAME	• Bshy
MODEL NAME	• Typ01
PLOT SCALE	• 10.0000" = 1'
PLOT DATE	• 8/22/2019

DESIGNED	- JLS
DRAWN	- PDB
CHECKED	- ESW
DATE	-

REVISED	-

**STATE OF ILLINOIS  
DEPARTMENT OF TRANSPORTATION**


**EXISTING TYPICAL SECTIONS  
IL ROUTE 8**

SCALE: 1"=5'      SHEET 1 OF 4 SHEETS

F.A.S. SITE	SECTION	COUNTY	TOTAL SHEETS	SHEET NO.
1388	(2-1VB)BR-2	PEORIA	235	15
CONTRACT NO. 68799				
ILLINOIS FED. AID PROJECT				


**LEGEND**

- ① EXISTING PORTLAND CEMENT CONCRETE PAVEMENT
- ② EXISTING ASPHALT RESURFACING, 6" AND VARIES
- ③ EXISTING BITUMINOUS WIDENING, 9"
- ④ EXISTING BITUMINOUS SHOULDER, 9"
- ⑤ EXISTING GUTTER
- ⑥ EXISTING AGGREGATE BASE
- ⑦ EXISTING OIL AND CHIP SURFACE

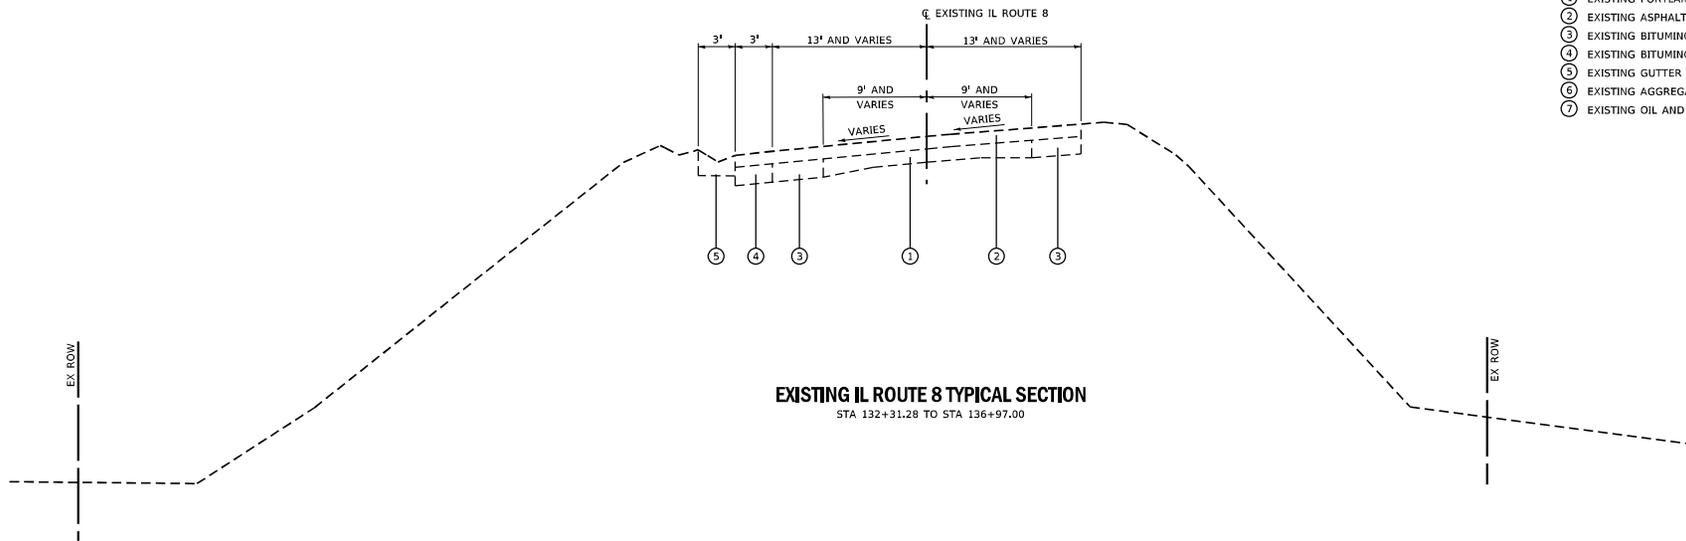

**EXISTING IL ROUTE 8 TYPICAL SECTION**  
STA 132+31.28 TO STA 136+97.00

BRIDGE OMISSION STA 136+97.00 TO STA 141+32.00

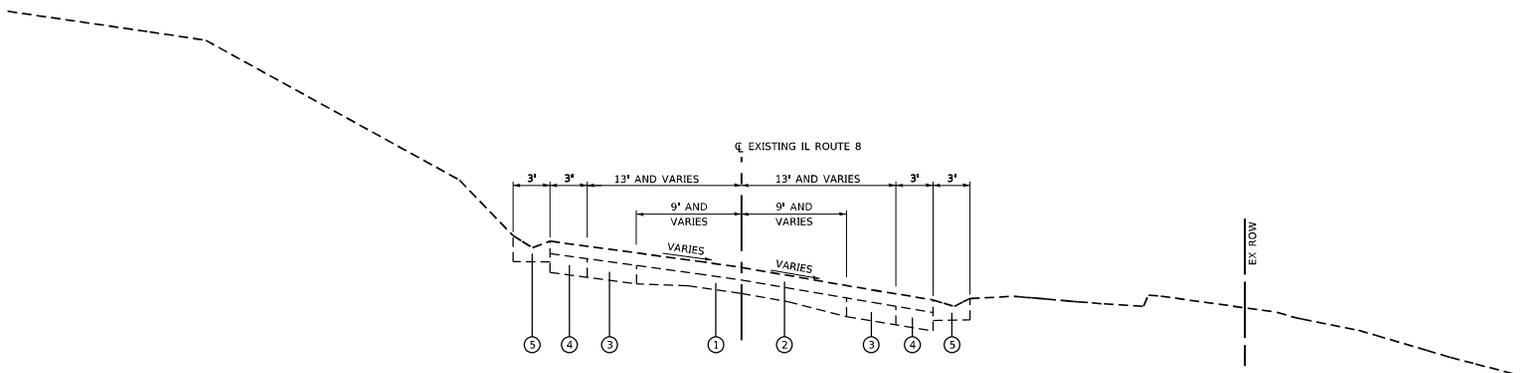

**EXISTING IL ROUTE 8 TYPICAL SECTION**  
STA 141+32.00 TO STA 147+44.00

FILE NAME: S:\Projects\1188-024-001\_IL\_8\_ssr\_BNSF\_Phase II\Output\000 Sheets\046\718-024-001-Typical-section.dwg



USER NAME	• Bkly	DESIGNED	- JLS	REVISED	-
MODEL NAME	• Typ02	DRAWN	- PDB	REVISED	-
PLOT SCALE	• 10.0000" = 1'	CHECKED	- ESW	REVISED	-
PLOT DATE	• 8/22/2019	DATE	-	REVISED	-

STATE OF ILLINOIS
DEPARTMENT OF TRANSPORTATION



SCALE: 1"=5'	SHEET 2 OF 4 SHEETS
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<b>EXISTING TYPICAL SECTIONS</b>	
<b>IL ROUTE 8</b>	

F.A.S. SITE	SECTION	COUNTY	TOTAL SHEETS	SHEET NO.
1388	(Z-1V)BR-2	PEORIA	235	16
CONTRACT NO. 68799				
ILLINOIS FED. AID PROJECT				

**LEGEND**

- ① EXISTING PORTLAND CEMENT CONCRETE PAVEMENT
- ② EXISTING ASPHALT RESURFACING, 6" AND VARIES
- ③ EXISTING BITUMINOUS WIDENING, 9"
- ④ EXISTING BITUMINOUS SHOULDER, 9"
- ⑤ EXISTING GUTTER
- ⑥ EXISTING AGGREGATE BASE
- ⑦ EXISTING OIL AND CHIP SURFACE

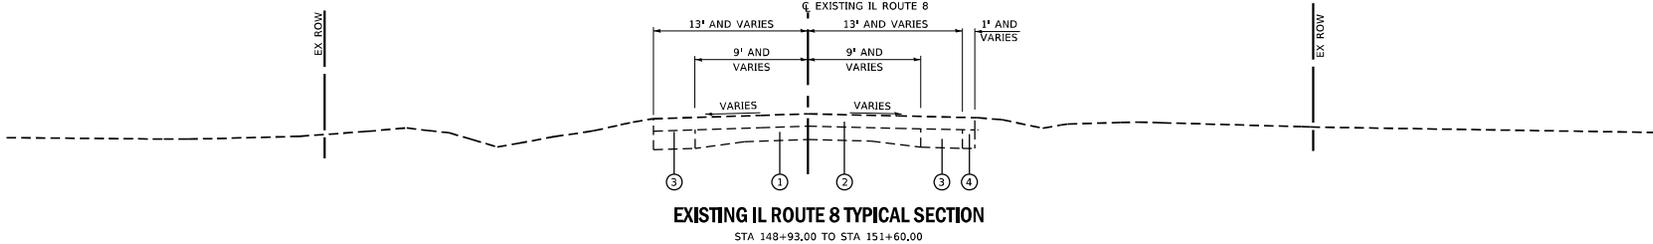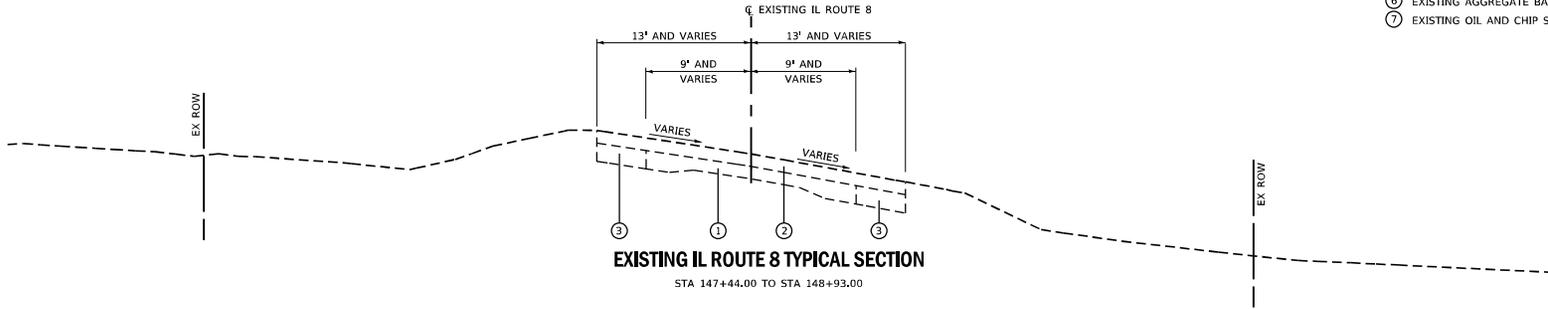

FILE NAME: S:\Projects\188-024-001\_IL\_8\_ssr\_BNSF\_Phase II\Output\000 Sheets\046\776\tr\original.dwg



USER NAME	• Brlty
MODEL NAME	• Typ03
PLOT SCALE	• 10.0000" = 1'
PLOT DATE	• 8/22/2019

DESIGNED	- JLS
DRAWN	- PDB
CHECKED	- ESW
DATE	-

REVISED	-

**STATE OF ILLINOIS  
DEPARTMENT OF TRANSPORTATION**


**EXISTING TYPICAL SECTIONS  
IL ROUTE 8**

SCALE: 1"=5'      SHEET 3 OF 4 SHEETS

F.A.S. SITE	SECTION	COUNTY	TOTAL SHEETS	SHEET NO.
1388	(2-1VB)BR-2	PEORIA	235	17
CONTRACT NO. 68799				
ILLINOIS    FED. AID PROJECT				


**LEGEND**

- ① EXISTING PORTLAND CEMENT CONCRETE PAVEMENT
- ② EXISTING ASPHALT RESURFACING, 6" AND VARIES
- ③ EXISTING BITUMINOUS WIDENING, 9"
- ④ EXISTING BITUMINOUS SHOULDER, 9"
- ⑤ EXISTING GUTTER
- ⑥ EXISTING AGGREGATE BASE
- ⑦ EXISTING OIL AND CHIP SURFACE

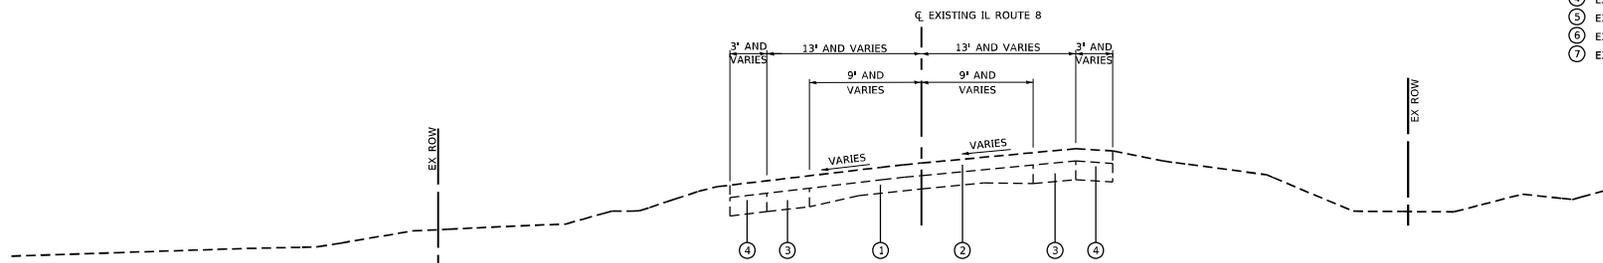

**EXISTING IL ROUTE 8 TYPICAL SECTION**

STA 151+60.00 TO STA 156+66.78

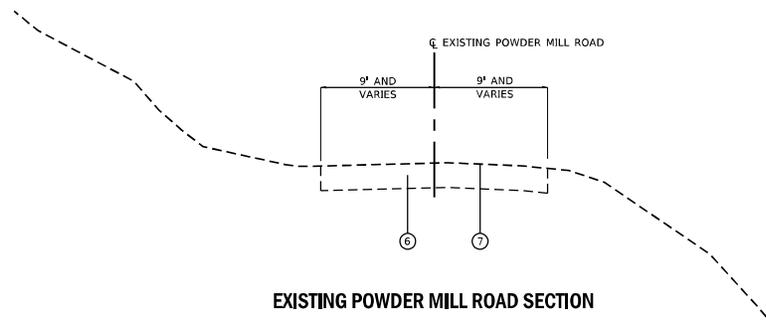

**EXISTING POWDER MILL ROAD SECTION**

FILE NAME: S:\Projects\188-024-001\_IL\_8\_ssr\_BNSF\_Phase II\Output\AAD Sheets\068798\tr\typical\_wastign



USER NAME	• Bhty	DESIGNED	- JLS	REVISED	-
MODEL NAME	• Typ04	DRAWN	- PDB	REVISED	-
PLOT SCALE	• 10.0000" = 1'	CHECKED	- ESW	REVISED	-
PLOT DATE	• 8/22/2019	DATE	-	REVISED	-



**STATE OF ILLINOIS  
DEPARTMENT OF TRANSPORTATION**

**EXISTING TYPICAL SECTIONS  
IL ROUTE 8**

SCALE: 1"=5' SHEET 4 OF 4 SHEETS

F.A.S. SITE	SECTION	COUNTY	TOTAL SHEETS	SHEET NO.
1388	(Z-1V)BR-2	PEORIA	235	18
				CONTRACT NO. 68799
ILLINOIS FED. AID PROJECT				

- LEGEND**
- ① PROPOSED AGGREGATE SUBGRADE IMPROVEMENT (12" AND VARIES)
  - ② PROPOSED HOT-MIX ASPHALT PAVEMENT (FULL DEPTH), 10 1/4"
  - ③ PROPOSED HOT-MIX ASPHALT PAVEMENT (FULL DEPTH), 6"
  - ④ PROPOSED HOT-MIX ASPHALT SHOULDERS, 8"
  - ⑤ PROPOSED AGGREGATE WEDGE SHOULDER, TYPE B
  - ⑥ PROPOSED TOPSOIL FURNISH AND PLACE, 4"
  - ⑦ PROPOSED PAVEMENT CONNECTOR (HMA) FOR BRIDGE APPROACH SLAB
  - ⑧ PROPOSED GUARDRAIL AGGREGATE EROSION CONTROL
  - ⑨ PROPOSED COMBINATION CONCRETE CURB AND GUTTER, TYPE B-6.24
  - ⑩ PROPOSED CONCRETE GUTTER, TYPE A (SPECIAL)
  - ⑪ PROPOSED GEOTECHNICAL FABRIC FOR GROUND STABILIZATION

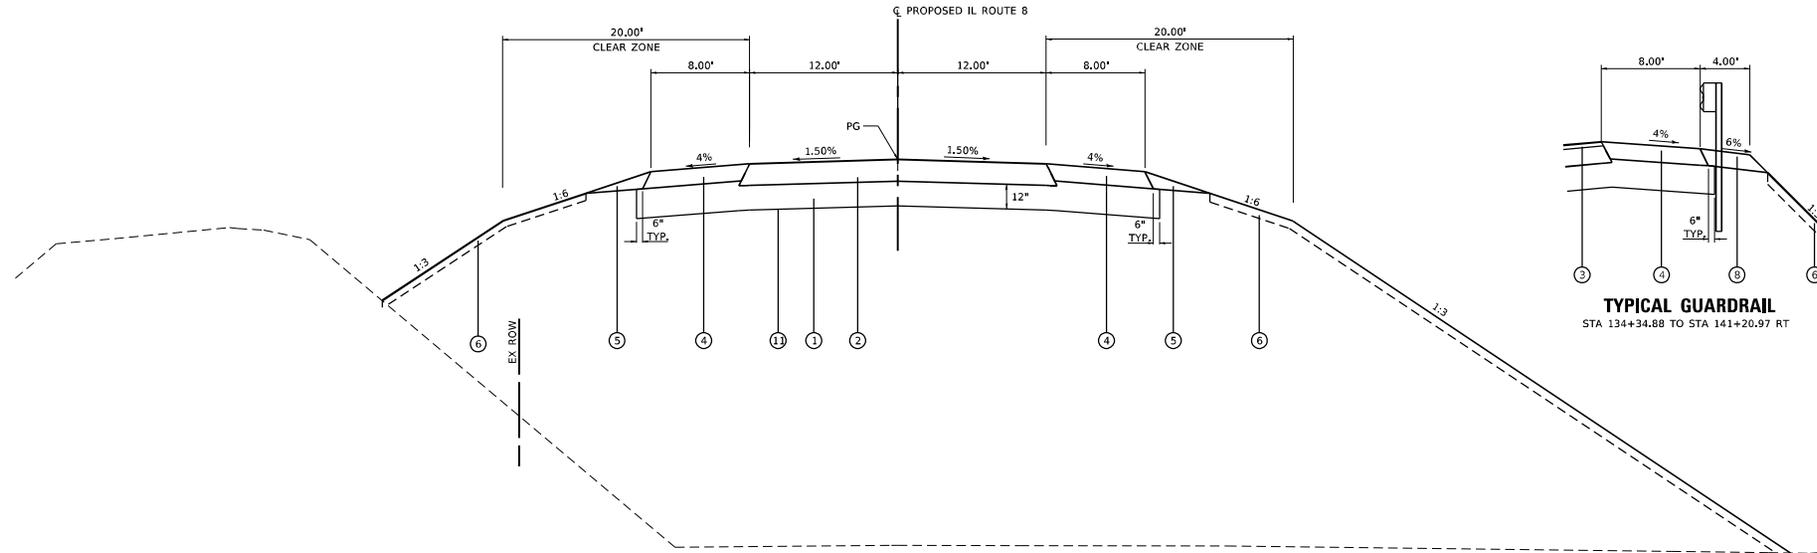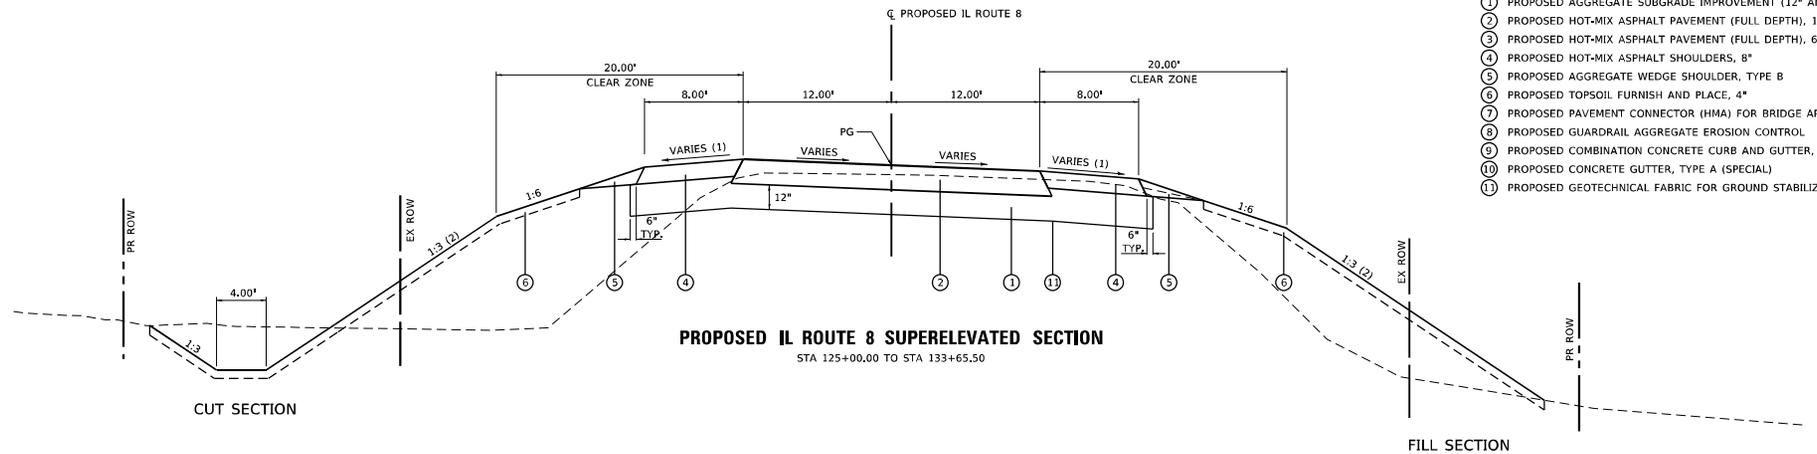

- (1) IF SUPER ELEVATION SLOPE EXCEEDS 4% THEN THE SHOULDER SLOPE SHALL BE ADJUSTED AS FOLLOWS:  
HIGH SIDE: VARY THE SHOULDER SLOPE TO MAINTAIN A MAXIMUM 8% SLOPE BREAKOVER,  
LOW SIDE: SHOULDER SLOPE SHALL MATCH SUPERELEVATION SLOPE.
- (2) SEE PLAN AND PROFILE SHEETS FOR DITCH PROFILE.
- (3) CLEAR ZONE ON OUTSIDE OF CURVE IS 30'.
- (4) SEE CROSS SECTIONS FOR DITCH WIDTH.

FILE NAME: S:\Pro\2011\1188-1024-101 IL B over BNSF Phase II\Output\CAD Sheets\0168799\1188-1024-101.dgn



USER NAME	• Betsy
MODEL NAME	• Typ01
PLOT SCALE	• 10.0000" = 1'-0"
PLOT DATE	• 8/22/2019

DESIGNED	- JLS
DRAWN	- PDB
CHECKED	- ESW
DATE	-



REVISED	-

**STATE OF ILLINOIS  
DEPARTMENT OF TRANSPORTATION**

<b>PROPOSED TYPICAL SECTIONS IL ROUTE 8</b>	
SCALE:	1"=5'
SHEET	1 OF 5 SHEETS

F.A.S. SITE:	SECTION:	COUNTY:	TOTAL SHEETS:	SHEET NO.:
1388	(2-1VB)BR-2	PEORIA	235	19
CONTRACT NO. 68799				
ILLINOIS		FED. AID PROJECT		

- LEGEND**
- ① PROPOSED AGGREGATE SUBGRADE IMPROVEMENT (12" AND VARIES)
  - ② PROPOSED HOT-MIX ASPHALT PAVEMENT (FULL DEPTH), 10 1/4"
  - ③ PROPOSED HOT-MIX ASPHALT PAVEMENT (FULL DEPTH), 6"
  - ④ PROPOSED HOT-MIX ASPHALT SHOULDERS, 8"
  - ⑤ PROPOSED AGGREGATE WEDGE SHOULDER, TYPE B
  - ⑥ PROPOSED TOPSOIL FURNISH AND PLACE, 4"
  - ⑦ PROPOSED PAVEMENT CONNECTOR (HMA) FOR BRIDGE APPROACH SLAB
  - ⑧ PROPOSED GUARDRAIL AGGREGATE EROSION CONTROL
  - ⑨ PROPOSED COMBINATION CONCRETE CURB AND GUTTER, TYPE B-6.24
  - ⑩ PROPOSED CONCRETE GUTTER, TYPE A (SPECIAL)
  - ⑪ PROPOSED GEOTECHNICAL FABRIC FOR GROUND STABILIZATION

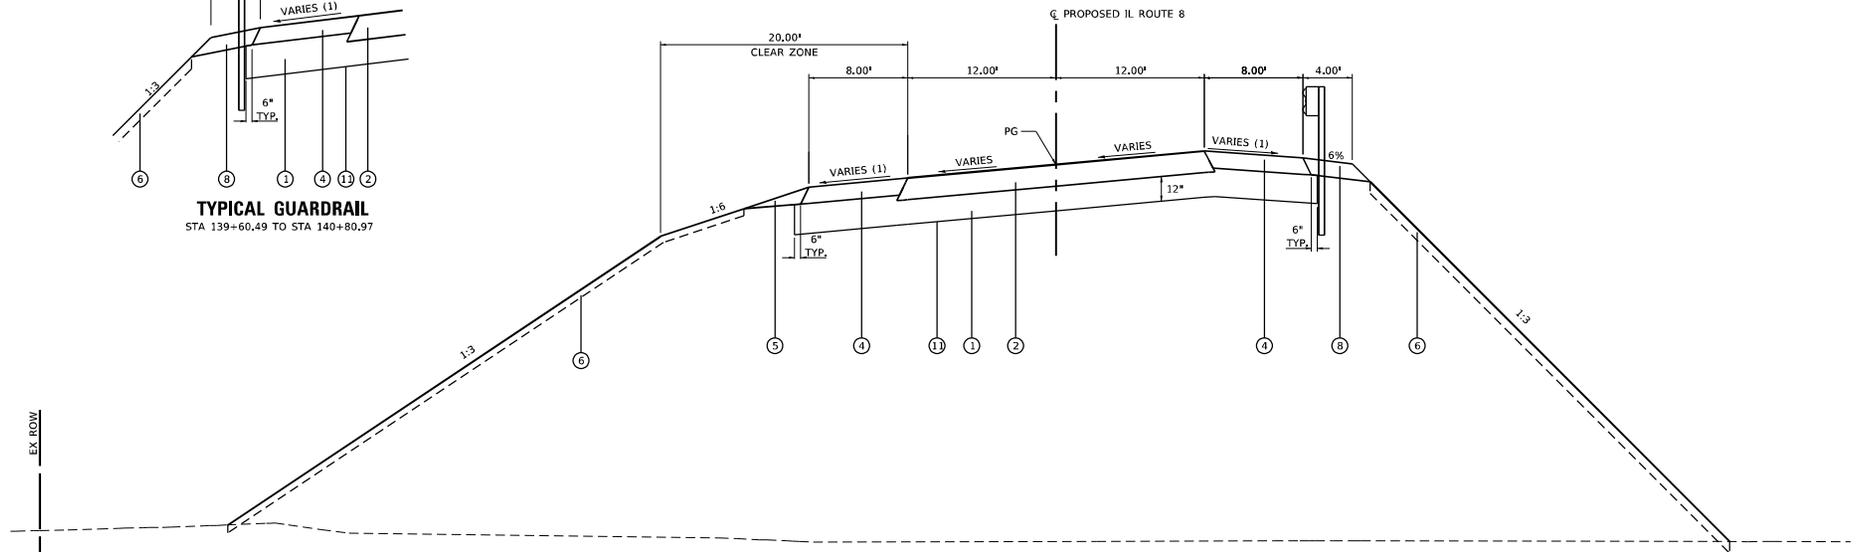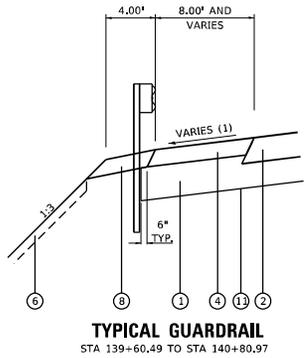

- (1) IF SUPER ELEVATION SLOPE EXCEEDS 4% THEN THE SHOULDER SLOPE SHALL BE ADJUSTED AS FOLLOWS:  
HIGH SIDE: VARY THE SHOULDER SLOPE TO MAINTAIN A MAXIMUM 8% SLOPE BREAKOVER.  
LOW SIDE: SHOULDER SLOPE SHALL MATCH SUPERELEVATION SLOPE.
- (2) SEE PLAN AND PROFILE SHEETS FOR DITCH PROFILE.
- (3) CLEAR ZONE ON OUTSIDE OF CURVE IS 30'.
- (4) SEE CROSS SECTIONS FOR DITCH WIDTH.

FILE NAME: S:\Projects\1188-024-001\_IL\_8\_ssr\_BNSF\_Phase II\Output\CAD Sheets\0469798-1188-024-001.dgn




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MODEL NAME	• Typ02	DRAWN	- PDB	REVISED	-
PLOT SCALE	• 10.0000" = 1'-0"	CHECKED	- ESW	REVISED	-
PLOT DATE	• 8/22/2019	DATE	-	REVISED	-

**STATE OF ILLINOIS  
DEPARTMENT OF TRANSPORTATION**

<b>PROPOSED TYPICAL SECTIONS IL ROUTE 8</b>	
SCALE: 1"=5'	SHEET 2 OF 5 SHEETS

F.A.S. SITE:	SECTION:	COUNTY:	TOTAL SHEETS:	SHEET NO.:
1388	(2-1VB)BR-2	PEORIA	235	20
CONTRACT NO. 68799				
ILLINOIS FED. AID PROJECT				

- LEGEND**
- ① PROPOSED AGGREGATE SUBGRADE IMPROVEMENT (12" AND VARIES)
  - ② PROPOSED HOT-MIX ASPHALT PAVEMENT (FULL DEPTH), 10 1/4"
  - ③ PROPOSED HOT-MIX ASPHALT PAVEMENT (FULL DEPTH), 6"
  - ④ PROPOSED HOT-MIX ASPHALT SHOULDERS, 8"
  - ⑤ PROPOSED AGGREGATE WEDGE SHOULDER, TYPE B
  - ⑥ PROPOSED TOPSOIL FURNISH AND PLACE, 4"
  - ⑦ PROPOSED PAVEMENT CONNECTOR (HMA) FOR BRIDGE APPROACH SLAB
  - ⑧ PROPOSED GUARDRAIL AGGREGATE EROSION CONTROL
  - ⑨ PROPOSED COMBINATION CONCRETE CURB AND GUTTER, TYPE B-6.24
  - ⑩ PROPOSED CONCRETE GUTTER, TYPE A (SPECIAL)
  - ⑪ PROPOSED GEOTECHNICAL FABRIC FOR GROUND STABILIZATION

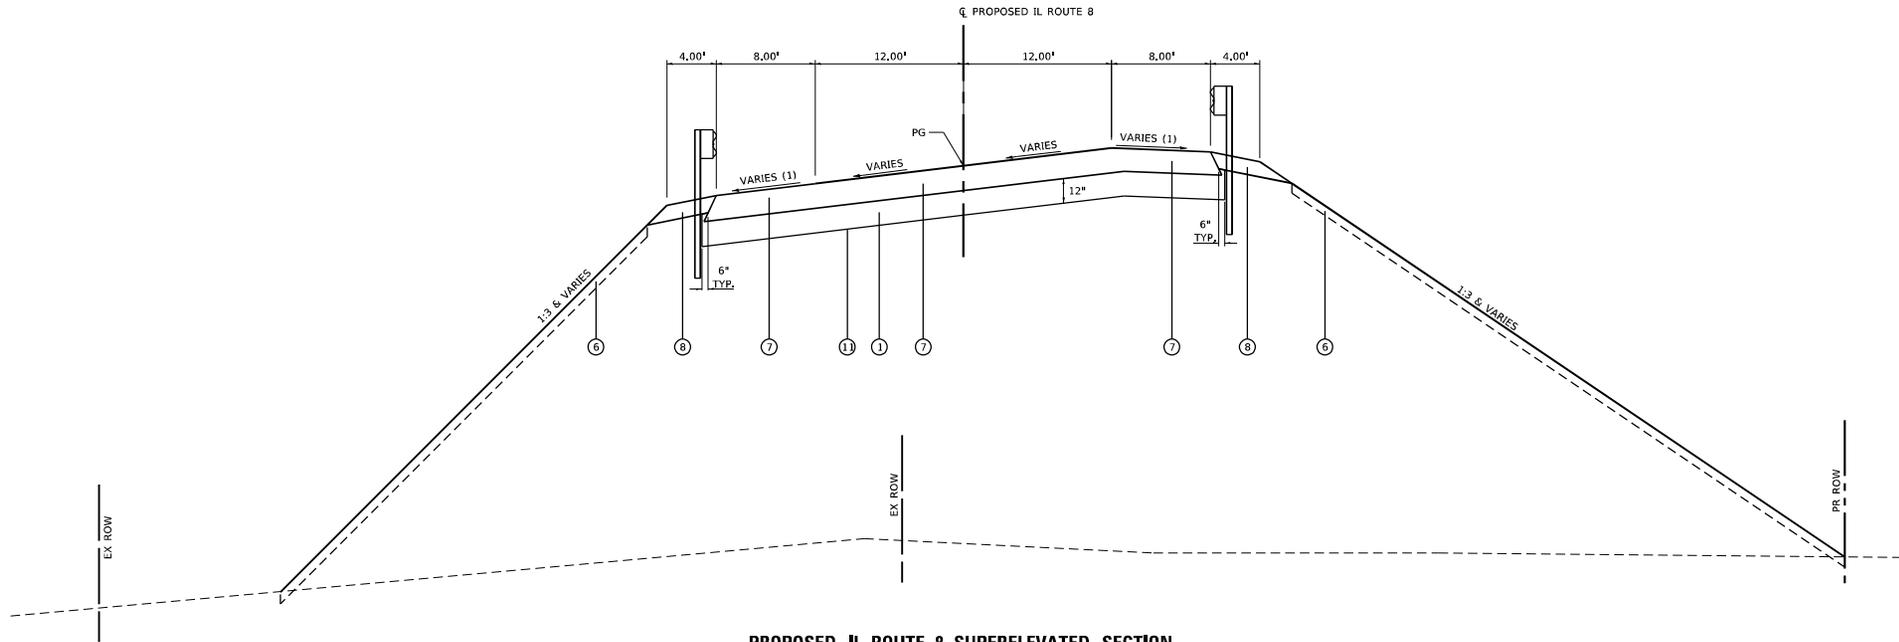

**PROPOSED IL ROUTE 8 SUPERELEVATED SECTION**

STA 140+55.02 TO STA 140+85.02  
 BRIDGE OMISSION STA 140+85.02 TO STA 144+95.67  
 STA 144+95.67 TO STA 145+25.67

- (1) IF SUPER ELEVATION SLOPE EXCEEDS 4% THEN THE SHOULDER SLOPE SHALL BE ADJUSTED AS FOLLOWS:  
 HIGH SIDE: VARY THE SHOULDER SLOPE TO MAINTAIN A MAXIMUM 8% SLOPE BREAKOVER.  
 LOW SIDE: SHOULDER SLOPE SHALL MATCH SUPERELEVATION SLOPE.
- (2) SEE PLAN AND PROFILE SHEETS FOR DITCH PROFILE.
- (3) CLEAR ZONE ON OUTSIDE OF CURVE IS 30'.
- (4) SEE CROSS SECTIONS FOR DITCH WIDTH.

FILE NAME: S:\Projects\1188-024-001\_IL\_8\_surr\_BNSF\_Phase II\Output\CAD Sheets\01687716.dwg



USER NAME: Brlty  
 MODEL NAME: Typ03  
 PLOT SCALE: 10.0000"=1'-0"  
 PLOT DATE: 8/22/2019

DESIGNED: JLS  
 DRAWN: PDB  
 CHECKED: ESW  
 DATE: -

REVISED: -  
 REVISED: -  
 REVISED: -  
 REVISED: -


STATE OF ILLINOIS  
 DEPARTMENT OF TRANSPORTATION

PROPOSED TYPICAL SECTIONS  
 IL ROUTE 8

SCALE: 1"=5' SHEET 3 OF 5 SHEETS


F.A.S. SITE	SECTION	COUNTY	TOTAL SHEETS	SHEET NO.
1388	(2-1VB)BR-2	PEORIA	235	21
				CONTRACT NO. 68799
ILLINOIS FED. AID PROJECT				



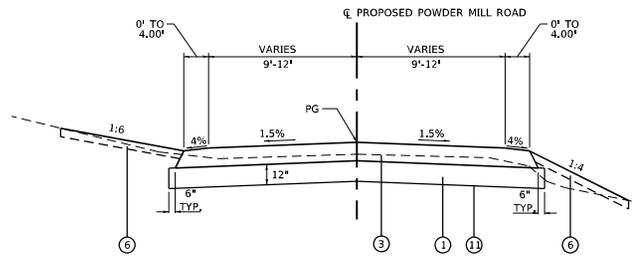


**PROPOSED POWDER MILL ROAD TYPICAL SECTION**  
STA 4+45.00 TO STA 5+55.46


- LEGEND**
- ① PROPOSED AGGREGATE SUBGRADE IMPROVEMENT (12" AND VARIES)
  - ② PROPOSED HOT-MIX ASPHALT PAVEMENT (FULL DEPTH), 10 1/4"
  - ③ PROPOSED HOT-MIX ASPHALT PAVEMENT (FULL DEPTH), 6"
  - ④ PROPOSED HOT-MIX ASPHALT SHOULDERS, 8"
  - ⑤ PROPOSED AGGREGATE WEDGE SHOULDER, TYPE B
  - ⑥ PROPOSED TOPSOIL FURNISH AND PLACE, 4"
  - ⑦ PROPOSED PAVEMENT CONNECTOR (HMA) FOR BRIDGE APPROACH SLAB
  - ⑧ PROPOSED GUARDRAIL AGGREGATE EROSION CONTROL
  - ⑨ PROPOSED COMBINATION CONCRETE CURB AND GUTTER, TYPE B-6.24
  - ⑩ PROPOSED CONCRETE GUTTER, TYPE A (SPECIAL)
  - ⑪ PROPOSED GEOTECHNICAL FABRIC FOR GROUND STABILIZATION

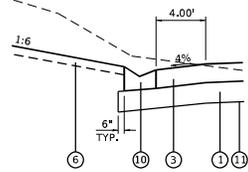

**DETAIL A**  
STA 7+78.94 TO STA 9+19.43

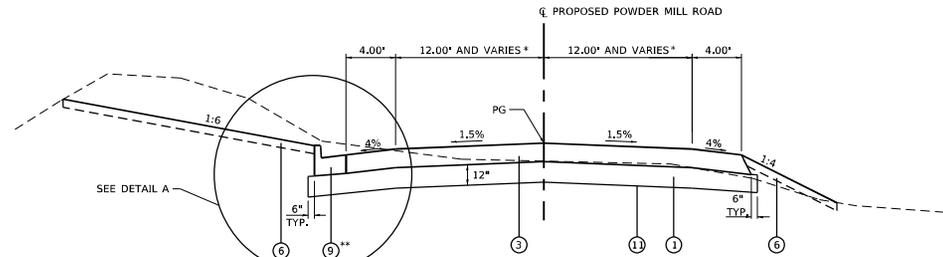

**PROPOSED POWDER MILL ROAD TYPICAL SECTION**  
STA 5+55.46 TO STA 10+00.00  
\* LANE WIDTH VARIES FROM 12' TO 14.5'  
STA 8+68.35 TO STA 9+43.35  
\*\* FROM STA 7+53.94 TO STA 7+78.94  
CONCRETE CURB AND GUTTER TYPE B-6.24  
TRANSITION TO CONCRETE GUTTER, TYPE A (SPECIAL)

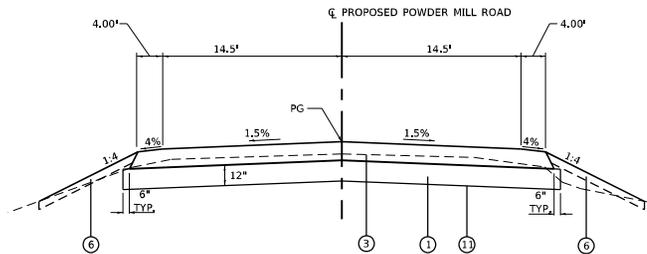

**PROPOSED POWDER MILL ROAD TYPICAL SECTION**  
STA 10+00.00 TO STA 11+48.12

- (1) IF SUPER ELEVATION SLOPE EXCEEDS 4% THEN THE SHOULDER SLOPE SHALL BE ADJUSTED AS FOLLOWS:  
HIGH SIDE: VARY THE SHOULDER SLOPE TO MAINTAIN A MAXIMUM 8% SLOPE BREAKOVER.  
LOW SIDE: SHOULDER SLOPE SHALL MATCH SUPERELEVATION SLOPE.
- (2) SEE PLAN AND PROFILE SHEETS FOR DITCH PROFILE.
- (3) CLEAR ZONE ON OUTSIDE OF CURVE IS 30'.
- (4) SEE CROSS SECTIONS FOR DITCH WIDTH.

FILE NAME: S:\Projects\18B-024-001\_IL\_8\_ssr\_BNSF\_Phase II\Output\CAD Sheets\0469798-11-original.dgn



USER NAME	• Betsy	DESIGNED	- JLS	REVISED	-
MODEL NAME	• Typ 05	DRAWN	- PDB	REVISED	-
PLOT SCALE	• 10.0000" = 1'	CHECKED	- ESW	REVISED	-
PLOT DATE	• 8/22/2019	DATE	-	REVISED	-

STATE OF ILLINOIS  
DEPARTMENT OF TRANSPORTATION

PROPOSED TYPICAL SECTIONS  
IL ROUTE 8

SCALE: 1"=5' SHEET 5 OF 6 SHEETS

P.A.S. SITE	SECTION	COUNTY	TOTAL SHEETS	SHEET NO.
1388	(2-1VB)BR-2	PEORIA	235	23
				CONTRACT NO. 68799
				ILLINOIS   FED. AID PROJECT

**EARTHWORK SCHEDULE**

LOCATION		EARTH EXCAVATION (CU YD)	FOR INFORMATION ONLY			FURNISHED EXCAVATION (CU YD)	REMARKS
			EARTH EXCAVATION ADJUSTED FOR SHRINKAGE (CU YD)	EMBANKMENT (CU YD)	EARTHWORK BALANCE WASTE (+) OR SHORTAGE (-) (CU YD)		
STATION TO STATION	ROADWAY	(CU YD)	(CU YD)	(CU YD)	(CU YD)	(CU YD)	
STAGE 1	IL 8	6519	4889	131750	-126861	126861	
STAGE 2	IL 8	19071	14303	47851	-33548	28245	OBTAIN 5303 CY FROM POWDER MILL
POWDER MILL	POWDER MILL	8295	6222	919	5303	0	PLACE EXCESS AS EMBANKMENT; 5303 CY ON IL 8 STAGE 2
SUBTOTAL		33885	25414	180520	-155106	155106	
PAY TOTAL		33885	25414	180520	-155106	155106	

**MOWING SCHEDULE**

LOCATION			MOWING
STATION TO STATION	SIDE	ROADWAY	(ACRE)
125+00 TO 160+51	LT/RT	EX IL 8	1.95
125+00 TO 160+70	LT/RT	PR IL 8	1.88
4+45 TO 11+25	LT/RT	POWDER MILL	0.40
SUBTOTAL			4.23
PAY TOTAL			4.25

**TREE REMOVAL SCHEDULE**

LOCATION			TREE REMOVAL (6 TO 15 UNITS DIAMETER) (UNIT)	TREE REMOVAL ACRES (ACRE)
STATION	SIDE	ROADWAY	(UNIT)	(ACRE)
126+45 TO 142+95	RT	IL 8 (PR)		6.00
127+30 TO 139+50	LT	IL 8 (PR)		1.25
141+75 TO 146+30	RT	IL 8 (PR)		0.75
147+95	LT	IL 8 (PR)	8	
148+29	LT	IL 8 (PR)	6	
148+53	LT	IL 8 (PR)	8	
4+33 TO 5+60	RT	POWDER MILL (PR)		0.25
8+15 TO 10+95	LT	POWDER MILL (PR)		0.50
SUBTOTAL			22	8.75
PAY TOTAL			22	8.75

**TEMPORARY FENCE SCHEDULE**

LOCATION			TEMPORARY FENCE (FOOT)
STATION TO STATION	SIDE	ROADWAY	(FOOT)
128+80 TO 139+20	LT	IL 8 (PR)	1000
124+95 TO 142+00	RT	IL 8 (PR)	1800
156+97 TO 158+40	LT	IL 8 (PR)	143
SUBTOTAL			2943
PAY TOTAL			2943

**PROPOSED TREE SCHEDULE**

LOCATION			TREE, RTULIA NIGRA (RIVER BIRCH), CONTAINER GROWN, 3-GALLON (EACH)	TRFF, SYRINGA RETICULATA (JAPANESE TREE LILAC), CONTAINER GROWN, 5-GALLON (EACH)	SEEDLINGS (UNIT)
STATION	SIDE	ROADWAY	(EACH)	(EACH)	(UNIT)
125+19	LT	IL 8 (PR)		1	
125+44	LT	IL 8 (PR)		1	
125+69	LT	IL 8 (PR)		1	
125+93	LT	IL 8 (PR)		1	
126+18	LT	IL 8 (PR)		1	
140+00 TO 142+30	RT	IL 8 (PR)			1
144+51	LT	IL 8 (PR)	1		
144+88	LT	IL 8 (PR)	1		
145+26	LT	IL 8 (PR)	1		
145+62	LT	IL 8 (PR)	1		
146+00	LT	IL 8 (PR)	1		
146+00 TO 147+05	RT	IL 8 (PR)			1
147+06 TO 149+70	LT	IL 8 (PR)			3
147+40 TO 153+50	RT	IL 8 (PR)			2
SUBTOTAL			5	5	7
PAY TOTAL			5	5	7

**SEEDING SCHEDULE**

LOCATION			TOPSOIL FURNISH AND PLACE, 4"	SEEDING, CLASS 3 (ACRE)	SEEDING, CLASS 5B (ACRE)	NITROGEN FERTILIZER NUTRIENT (POUND)	PHOSPHORUS FERTILIZER NUTRIENT (POUND)	POTASSIUM FERTILIZER NUTRIENT (POUND)	MULCH, METHOD 2 (ACRE)
STATION TO STATION	SIDE	ROADWAY	(SQ YD)	(ACRE)	(ACRE)	(POUND)	(POUND)	(POUND)	(ACRE)
125+00 TO 160+70	LT	IL 8	45383.60	11.30	0.88	1017	1017	1017	11.30
4+45 TO 11+60	RT	POWDER MILL	4591.90	1.1		100	100	100	1.1
AREA DISTURBED DURING STAGING									6.0
SUBTOTAL			49975.50	12.40	0.88	1117	1117	1117	18.40
PAY TOTAL			49976	12.50	1.00	1125	1125	1125	18.50

FILE NAME: D:\PROJECTS\UNIVERSITY\STATE\ILLINOIS\B OVER BNSF AT EMBANKMENT\PLAN REVISONS\DOT\post\Locat\_Final\_Submittal\1.E End with Mail\16468799-ahr-act-mch-16-16.dgn



USER NAME - hnsrhj  
 MODEL NAME - 504-01  
 PLOT SCALE - 0.1667 / in.  
 PLOT DATE - 6/9/2021

DESIGNED - JLS  
 DRAWN - PDB  
 CHECKED - ESW  
 DATE - 01-17-18

REVISED - AAD (DDT) 05/04/21  
 REVISED - KH (DDT) 06/09/21  
 REVISED -  
 REVISED -

**STATE OF ILLINOIS  
 DEPARTMENT OF TRANSPORTATION**

**SCHEDULE OF QUANTITIES  
 IL ROUTE 8**

SCALE: NONE SHEET 1 OF 5 SHEETS

F.A.S. RTE.	SECTION	COUNTY	TOTAL SHEETS	SHEET NO.
1388	(Z-1V)BR-2	PEORIA	235	24

CONTRACT NO. 68799  
 ILLINOIS FED. AID PROJECT



**GUARDRAIL SCHEDULE**

LOCATION			GUARDRAIL REMOVAL	STEEL PLATE BEAM GUARDRAIL, TYPE A, 6 FOOT POSTS	TRAFFIC BARRIER TERMINAL, TYPE 1 (SPECIAL) TANGENT	TRAFFIC BARRIER TERMINAL, TYPE 1 (SPECIAL) FLARED	TRAFFIC BARRIER TERMINAL, TYPE 6	GUARDRAIL AGGREGATE EROSION CONTROL	TERMINAL MARKER - DIRECT APPLIED	GUARDRAIL REFLECTORS, TYPE A
STATION TO STATION	SIDE	ROADWAY	(FOOT)	(FOOT)	(EACH)	(EACH)	(EACH)	(TON)	(EACH)	(EACH)
130+02.00 TO 136+97.00	LT	IL 8	695							
131+53.00 TO 137+00.00	RT	IL 8	547							
134+24.90 TO 141+20.97	RT	IL 8		612.5	1			144	1	8
139+50.00 TO 140+80.97	LT	IL 8		37.5		1		28	1	4
141+32.00 TO 141+37.00	LT	IL 8	40							
141+32.00 TO 144+13.00	RT	IL 8	281							
144+59.72 TO 146+03.30	LT	IL 8		50		1		30	1	4
144+99.72 TO 146+05.40	RT	IL 8		12.5		1		22	1	4
155+72.00 TO 156+88.17	RT	IL 8			2			26	2	4
157+23.83 TO 159+51.17	RT	IL 8		112.5	1	1		51	2	4
SUBTOTAL			1563	825	4	4	4	301	8	26
PAY TOTAL			1563	825	4	4	4	301	8	26

**ROCK FILL SCHEDULE**

LOCATION			ROCK FILL	GEOTECHNICAL FABRIC FOR GROUND STABILIZATION
STATION	SIDE	ROADWAY	(CU YD)	(SQ YD)
157+50 TO 160+66	LT	IL 8	351	536
SUBTOTAL			351	536
PAY TOTAL			351	536*

\* NOT A TOTAL QUANTITY

**REMOVAL SCHEDULE**

LOCATION		PAVEMENT REMOVAL	DRIVEWAY PAVEMENT REMOVAL	GUTTER REMOVAL	APPROACH SLAB REMOVAL	HOT-MIX ASPHALT REMOVAL (SPECIAL)
STATION TO STATION	ROADWAY	(SQ YD)	(SQ YD)	(FOOT)	(SQ YD)	(SQ YD)
125+00.00 TO 136+99.73	EX IL 8	3610				
132+31.28 TO 136+97.00	EX IL 8			466		
136+50.00 TO 136+98.00	EX IL 8				89	
141+32.00 TO 141+72.00	EX IL 8				89	
141+32.23 TO 147+39.40	EX IL 8			607		
141+32.23 TO 160+50.00	EX IL 8	6033				
142+96.07 TO 146+86.88	EX IL 8			391		
144+52.56	EX IL 8		68			
144+85.93	EX IL 8		105			
145+35.54	EX IL 8		67			
4+45.00 TO 6+73.00	POWDER MILL					450
SUBTOTAL		9643	240	1464	178	450
PAY TOTAL		9643	240	1464	178	450

**DRAINAGE REMOVAL SCHEDULE**

LOCATION			REMOVING INLETS	BOX CULVERT REMOVAL	PIPE CULVERT REMOVAL	TRENCH BACKFILL	DESCRIPTION
STATION TO STATION	SIDE	ROADWAY	(EACH)	(FOOT)	(FOOT)	(CU YD)	
146+83	LT	EX IL 8	1		43		15" CMP
147+19	LT/RT	EX IL 8		55	62	124.3	48" CMP/4'X3' BOX AND HEADWALL
147+38	RT	EX IL 8	1		15		15" CMP
149+26 TO 149+53	LT	EX IL 8			27		12" CMP
156+56 TO 156+78	LT	EX IL 8			22		24" CMP
156+71 TO 157+02	RT	EX IL 8			32		24" CMP
157+87	LT/RT	EX IL 8		50		73.3	4'X3' BOX AND HEADWALL WITH DROP STRUCTURE
SUBTOTAL			2	105	201	197.6	
PAY TOTAL			2	105	201	198*	

\* NOT A TOTAL QUANTITY

**WICK DRAIN AND SAND BLANKET SCHEDULE**

LOCATION			REMOVAL AND DISPOSAL OF UNSUITABLE MATERIALS	WICK DRAINS	SAND DRAINAGE BLANKET	PIEZOMETERS	SETTLEMENT PLATFORMS	SLOPE INCLINOMETER
STATION TO STATION	SIDE	ROADWAY	(CU YD)	(FOOT)	(CU YD)	(EACH)	(EACH)	(EACH)
133+50 TO 142+19	RT/LT	IL 8		76933	11017	3	2	2
144+16.6 TO 151+50	RT/LT	IL 8	2196	75957	6969	1	2	1
SUBTOTAL			2196	152890	17986	4	4	3
PAY TOTAL			2196	152890	17986	4	4	3

**SEALING ABANDONED WATER WELLS SCHEDULE**

LOCATION			SEALING ABANDONED WATER WELLS
STATION	SIDE	ROADWAY	(EACH)
146+00	RT	IL 8	1
148+10	LT	IL 8	1
149+55	LT	IL 8	1
SUBTOTAL			3
TOTAL			3

FILE NAME: D:\DWG\EN\MINOR\STS\BLS\AS\Sheet311L\_8 over BNSF at EisenhowerPlan revisions IDT post Lock Final Submittal E End with Mail\1668799\ahrschedule.bgn



USER NAME - horstg  
 MODEL NAME - 509-03  
 PLOT SCALE - 0.1667 / in.  
 PLOT DATE - 6/11/2021

DESIGNED - JLS  
 DRAWN - PDB  
 CHECKED - ESW  
 DATE - 01-17-18

REVISED - AAD (DDOT) 05/04/21  
 REVISED - KH (DDOT) 06/11/21  
 REVISED -  
 REVISED -

STATE OF ILLINOIS  
 DEPARTMENT OF TRANSPORTATION

SCHEDULE OF QUANTITIES  
 IL ROUTE 8

SCALE: NONE SHEET 3 OF 6 SHEETS

F.A.S. RTE.	SECTION	COUNTY	TOTAL SHEETS	SHEET NO.
1388	(Z-1V)BR-2	PEORIA	235	26
CONTRACT NO. 68799				
ILLINOIS   FEB. AID PROJECT				

**RIGHT-OF-WAY SCHEDULE**

LOCATION					FURNISHING AND ERECTING RIGHT OF WAY MARKERS (EACH)	PERMANENT SURVEY MARKERS, TYPE I (EACH)
STATION	ROADWAY	OFFSET	SIDE	DESCRIPTION		
125+80.88	IL 8	55.00	RT		1	
126+39.39	IL 8	54.88	LT		1	
126+39.91	IL 0	50.00	LT		1	
128+00.00	IL 8	65.00	RT		1	
128+50.00	IL 8	70.00	LT		1	
131+50.00	IL 8	75.00	RT		1	
132+00.00	IL 8	80.34	LT		1	
133+00.70	IL 8	0.00	MID	PT STATION		1
134+50.00	IL 8	128.36	LT		1	
136+00.00	IL 8	120.00	RT		1	
136+11.26	IL 8	0.00	MID	PC STATION		1
136+50.00	IL 8	200.00	LT		1	
137+50.00	IL 8	135.00	RT		1	
138+67.07	IL 8	204.69	LT		1	
139+00.00	IL 8	150.00	RT		1	
139+61.52	IL 8	0.00	MID	PT STATION		1
141+50.00	IL 8	155.00	RT		1	
142+74.48	IL 8	140.00	RT		1	
142+92.91	IL 8	69.94	RT		1	
143+00.00	IL 8	0.00	MID			1
143+19.39	IL 8	30.69	LT		1	
146+19.17	IL 8	0.00	MID	PC STATION		1
147+42.38	IL 8	157.39	RT		1	
147+50.00	IL 8	110.00	LT		1	
149+37.93	IL 8	377.65	LT		1	
149+68.15	IL 8	110.00	LT		1	
150+31.02	IL 8	0.00	MID	PT STATION		1
151+98.53	IL 8	0.00	MID	PC STATION		1
153+88.45	IL 8	67.09	RT		1	
155+00.00	IL 8	65.00	LT		1	
156+80.89	IL 8	67.34	LT		1	
158+50.00	IL 8	60.00	LT		1	
159+43.20	IL 8	0.00	MID	PT STATION		1
160+50.00	IL 8	55.00	LT		1	
161+00.00	IL 8	40.00	LT		1	
1+00.00	POWDER MILL	0.00	MID	POT STATION		1
2+48.47	POWDER MILL	0.00	MID	PC STATION		1
3+76.75	POWDER MILL	0.00	MID	PT STATION		1
5+55.46	POWDER MILL	0.00	MID	PC STATION		1
7+15.23	POWDER MILL	34.11	LT		1	
7+27.94	POWDER MILL	0.00	MID	PT STATION		1
9+43.35	POWDER MILL	0.00	MID	PC STATION		1
9+50.00	POWDER MILL	70.00	LT		1	
9+97.59	POWDER MILL	125.28	LT		1	
10+30.73	POWDER MILL	0.00	MID	POT STATION		1
10+02.03	POWDER MILL	95.00	LT		1	
11+18.12	POWDER MILL	0.00	MID	PT STATION		1
11+60.12	POWDER MILL	0.00	MID	POT STATION		1
SUBTOTAL					31	17
PAY TOTAL					31	17

**CURB AND GUTTER SCHEDULE**

LOCATION			PROTECTIVE COAT	COMBINATION CONCRETE CURB AND GUTTER, TYPE B-6.24	CLASS SI CONCRETE (OUTLET), SPECIAL	CONCRETE GUTTER, TYPE A (SPECIAL)
STATION TO STATION	SIDE	ROADWAY	(SQ YD)	(FOOT)	(CU YD)	(FOOT)
5+55.46 TO 7+78.94	LT	POWDER MILL	76.5	223.5		
7+70.94 TO 9+19.43	LT	POWDER MILL	40.1			141
9+19.43 TO 9+67.70	LT	POWDER MILL	26.5		6.2	
SUBTOTAL			151.1	223.5	6.2	141
PAY TOTAL			151*	223.5	6.2	141

\* NOT A TOTAL QUANTITY

**ENTRANCE SCHEDULE**

LOCATION			PROTECTIVE COAT	AGGREGATE SURFACE COURSE, TYPE B	AGGREGATE FOR TEMPORARY ACCESS	PORTLAND CEMENT CONCRETE DRIVEWAY PAVEMENT, 6 INCH
STATION	SIDE	ROADWAY	(SQ YD)	(TON)	(TON)	(SQ YD)
156+84.41	LT	IL 8		40		
157+08.01	RT	IL 8		23		
4+84.00	LT	POWDER MILL	37.7	11	26	38
5+28.27	LT	POWDER MILL	33.3	3	19	33
6+64.92	LT	POWDER MILL	12.0	2	13	12
7+38.17	LT	POWDER MILL	11.9	9	32	12
CONTRACTOR ACCESS					100	
SUBTOTAL			94.9	88	190	95
PAY TOTAL			95*	88	190	95

\* NOT A TOTAL QUANTITY

**RIPRAP SCHEDULE**

LOCATION			STONE RIPRAP, CLASS A4	STONE RIPRAP, CLASS A5	STONE RIPRAP, CLASS B3	FILTER FABRIC	STONE DUMPED RIPRAP, CLASS A4
STATION	SIDE	ROADWAY	(SQ YD)	(SQ YD)	(TON)	(SQ YD)	(TON)
140+60	LT	IL 8			45.5		136
141+00	RT	IL 8			62.5		188
141+40	RT	IL 8	47				47
144+80	LT	IL 8			36.1		114
145+20	RT	IL 8			45.3		136
147+50	RT	IL 8		50			50
157+75	RT	IL 8		97			97
9+67 TO 10+99	LT	Powder Mill	399				399
SUBTOTAL			543	50	191.4		1167
PAY TOTAL			543	50	192		1167

NOTE: THE EXACT LOCATION OF THE STONE DUMPED RIPRAP, CLASS A4 SHALL BE DETERMINED THROUGH COORDINATION WITH BNSF RAILWAY.

FILE NAME: \\c:\temp\144\PROJECTS\UNIFORM\DRAWING\UNIFORM\STATE\IL\8\_0ver\_BNSF\_at\_Egan\dwg\plan\_revisions\IDF\_post\_Locn\_Final\_Subs\table.dwg



USER NAME	• d2aza	DESIGNED	- JLS	REVISED	- AAD (IDOT) 05/04/21
MODEL NAME	• Sch-04	DRAWN	- PDB	REVISED	-
PLOT SCALE	• 0.7687 / in.	CHECKED	- ESW	REVISED	-
PLOT DATE	• 5/4/2021	DATE	• 01-17-18	REVISED	-

STATE OF ILLINOIS  
DEPARTMENT OF TRANSPORTATION

SCHEDULE OF QUANTITIES  
IL ROUTE 8

SCALE: NONE SHEET 4 OF 6 SHEETS

F.A.S. RITE	SECTION	COUNTY	TOTAL SHEETS	SHEET NO.
1388	(Z-1V)BIR-2	PEORIA	235	27
CONTRACT NO. 68799				
ILLINOIS   FED. AID PROJECT				

**SIGN SCHEDULE**

LOCATION			MUTCD SIGN NO.	SIGN DESCRIPTION	SIGN DIMENSIONS (IN. X IN.)	SIGN PANEL - TYPE 1 (SQ FT)	SIGN PANEL - TYPE 2 (SQ FT)	REMOVE SIGN PANEL ASSEMBLY - TYPE A (EACH)	REMOVE SIGN PANEL ASSEMBLY - TYPE B (EACH)	RELOCATE SIGN PANEL ASSEMBLY - TYPE A (EACH)	RELOCATE SIGN PANEL ASSEMBLY - TYPE B (EACH)	TELESCOPING STEEL SIGN SUPPORT (FOOT)	WOOD SIGN SUPPORT (FOOT)	
STATION	SIDE	ROADWAY												
124+86	RT	IL 8		SPEED LIMIT	24 x 30					1		16		
125+87	LT	IL 8		STATE PARK/ INTERSTATE									18	
128+15	RT	IL 8		ROUTE	24 x 24			1			1			
128+50	RT	IL 8	M1-100	ROUTE	24 x 24	4.00						15		
128+50	RT	IL 8	M3-2	CARDINAL DIRECTION	24 x 12	2.00								
128+98	RT	IL 8		SPEED LIMIT	30 x 30			1						
128+98	RT	IL 8	W1-4L	CURVE AHEAD	30 x 30					1			15	
129+15	LT	IL 8	R2-1	STOP AHEAD	24 x 30			1						
129+16	LT	IL 8		TOURIST ACTIVITIES	30 x 30						1		29	
129+80	LT	IL 8	W3-1	STOP AHEAD	30 x 30	6.25						15		
130+40	LT	IL 8	W2-1	INTERSECTION	30 x 30						1		16	
132+50	LT	IL 8	R2-1	SPEED LIMIT	24 x 30	5.00						14		
133+03	LT	IL 8		SPEED LIMIT	36 x 24			1						
135+05	LT	IL 8	R12-4	WEIGHT LIMIT				1						
136+10	RT	IL 8	W1-8R	CHEVRON ALIGNMENT	30 x 30	3.00						14		
136+65	LT	IL 8	W2-2L/W16-2P	INTERSECTION/ XX FEET	30 x 30				1					
137+25	RT	IL 8	W1-8L	CHEVRON ALIGNMENT	18 x 24	3.00						14		
137+25	RT	IL 8	W1-8R	CHEVRON ALIGNMENT	18 x 24	3.00								
138+45	RT	IL 8	W1-8L	CHEVRON ALIGNMENT	18 x 24	3.00						14		
138+45	RT	IL 8	W1-8R	CHEVRON ALIGNMENT	18 x 24	3.00								
139+60	RT	IL 8	W1-8L	CHEVRON ALIGNMENT	18 x 24	3.00						14		
140+50	RT	IL 8	W2-2	T-INTERSECTION	18 x 24	6.25						15		
140+50	RT	IL 8	W16-2P	XX FEET	30 x 30	3.00								
145+25	RT	IL 8	W1-4R	CURVE	24 x 18	6.25						15		
145+60	LT	IL 8	W1-8L	CHEVRON ALIGNMENT	30 x 30	3.00						13		
146+37	LT	IL 8	R2-1	SPEED LIMIT	24 x 30			1						
146+49	LT	IL 8	W1-8L	INTERSECTION/ XX FEET	30 x 30				1					
146+80	RT	IL 8	W1-7	TWO DIRECTION LARGE ARROW	18 x 24	8.00						14		
147+03	LT	IL 8	W1-6	LOCATION/SPEED LIMIT	48 x 24			1						
147+95	LT	IL 8	W1-8R	CHEVRON ALIGNMENT	18 x 24	3.00						14		
147+95	LT	IL 8	W1-8L	CHEVRON ALIGNMENT	18 x 24	3.00								
148+00	RT	IL 8	R4-2	PASS WITH CARE	24 x 30	5.00						15		
148+50	LT	IL 8	R2-1	SPEED LIMIT	24 x 30	5.00						14		
149+15	LT	IL 8	W1-8R	CHEVRON ALIGNMENT	18 x 24	3.00						14		
149+15	LT	IL 8	W1-8L	CHEVRON ALIGNMENT	18 x 24	3.00								
150+30	LT	IL 8	W1-8R	CHEVRON ALIGNMENT	18 x 24	3.00						14		
152+00	RT	IL 8	W1-8R	CHEVRON ALIGNMENT	18 x 24	3.00						14		
152+05	LT	IL 8	W1-4	CURVE	30 x 30	6.25						15		
152+86	RT	IL 8	W3-5	ARROW	36 x 36			1						
152+88	LT	IL 8	W1-4	CURVE/ SPEED LIMIT					1					
152+90	LT	IL 8	W2-2	T-INTERSECTION	30 x 30	6.25						15		
152+90	LT	IL 8	W16-2P	XX FEET	24 x 18	3.00								
154+00	RT	IL 8	W1-8L	CHEVRON ALIGNMENT	36 x 36	3.00						15		
154+00	RT	IL 8	W1-8R	CHEVRON ALIGNMENT	18 x 24	3.00								
156+00	RT	IL 8	W1-8R	CHEVRON ALIGNMENT	18 x 24	3.00						16		
156+00	RT	IL 8	W1-8L	CHEVRON ALIGNMENT	18 x 24	3.00								
157+50	RT	IL 8	W14-3	NO PASS ZONE					1					
157+96	LT	IL 8	W1-2	REDUCE SPEED LIMIT	30 x 30			1						
158+00	RT	IL 8	W1-8L	CHEVRON ALIGNMENT	18 x 24	3.00						17		
158+00	RT	IL 8	W1-8R	CHEVRON ALIGNMENT	18 x 24	3.00								
160+00	RT	IL 8	W1-8L	CHEVRON ALIGNMENT	18 x 24	3.00						17		
161+00	LT	IL 8	R2-1	SPEED LIMIT	18 x 24	5.00						19		
161+00	RT	IL 8	R2-1	SPEED LIMIT	24 x 30	5.00						17		
164+00	RT	IL 8	W14-3	NO PASSING ZONE	48 x 36		12					19		
164+00	LT	IL 8	R4-1	PASS WITH CARE	30 x 30	5.00						18		
166+00	LT	IL 8	W3-5	REDUCE SPEED LIMIT	30 x 30	6.25						19		
5+46	RT	POWDER MILL		STOP SIGN	30 x 30			1						
8+02	LT	POWDER MILL	R12-1	WEIGHT LIMIT	36 x 24			1						
11+36	RT	POWDER MILL	R1-1	STOP	36 x 36	9.0						16		
SUBTOTAL						156.50		12	11	4	2	3	461	78
PAY TOTAL								12	11	4	2	3	461	78

FILE NAME: S:\Pro\2014\1488-024-001 IL 8 over BNSF Phase II\Unplan\GDD Smart\0468798-1488-024-001.dwg



USER NAME: Betsy  
 MODEL NAME: SCH05  
 PLOT SCALE: 0.3607"/ft.  
 PLOT DATE: 02/22/09

DESIGNED: JLS  
 DRAWN: PDB  
 CHECKED: ESW  
 DATE: 01-17-08

REVISED: -  
 REVISED: -  
 REVISED: -  
 REVISED: -

**STATE OF ILLINOIS  
 DEPARTMENT OF TRANSPORTATION**

**SCHEDULE OF QUANTITIES  
 IL ROUTE 8**

SCALE: NONE    SHEET 5 OF 5 SHEETS

F.A.S. NO. 1388	SECTION (Z-1VB)R-2	COUNTY PEORIA	TOTAL SHEETS 235	SHEET NO. 28
CONTRACT NO. 68799				
ILLINOIS   FED. AID PROJECT				

DRAINAGE SCHEDULE

LOCATION	PIPE CULVERT CLASS D EQUIV ROUND 42"	PIPE CULVERT CLASS A TYPE 2 36"	PIPE CULVERT CLASS A TYPE 4 48"	PIPE CULVERT CLASS A TYPE 6 48"	PIPE CULVERT CLASS D TYPE 1 24"	PIPE CULVERT CLASS D TYPE 1 48"	TRENCH BACKFILL (1)	PRECAST RC FLARED END SECTION 36"	PRECAST RC FLARED END SECTION 48"	OP RC FLARED END SECTION 48"	METAL FLARED END SECTION 24"	METAL FLARED END SECTION 48"	SLOPED METAL END SECTION 42"	MHTY A 7 DIA TY 1 FRAME CLOSED LID
	F001	F001	F001	F001	F001	F001	CU YD	EACH	EACH	EACH	EACH	EACH	EACH	EACH
<b>STAGE 1</b>														
STA 141+40.43					2'6"		336							
STA 140+22.45, 98.60' LT										1				
STA 142+33.85, 78.42' RT										1				
<b>STAGE 2</b>														
STA 157+98.60		56					25							
STA 158+16.09		56					25							
STA 147+50			154				219							
STA 156+59.72, 49.56' LT TO STA 157+06.71, 50.08' LT					47									
STA 156+67.34, 39.90' RT TO STA 157+68.17, 26.23' RT	116													
STA 147+26.62, 79.02' RT														
STA 156+67.34, 41.41' RT									1					
STA 156+59.72, 48.56' LT										1			1	
STA 157+06.71, 50.08' LT											1			
STA 157+68.17, 28.23' RT												1		
STA 157+98.60, 34' LT								1						
STA 158+16.09, 34' LT								1						
<b>POWDERMILL ROAD</b>														
STA 10+97.00, 82.06' LT														
STA 10+97.00, 82.06' LT TO STA 11+03.24, 88.05' LT						13								
STA 11+04.90, 89.82' LT														1
<b>TOTAL</b>	116	112	154	2'6"	47	13	605	2	1	2	2	1	2	1

\* NO F A TOTAL QUANTITY  
 (1) TRENCH BACKFILL LIMITS STA. 41+40.43 & STA. 147+50 EXTEND LENGTHWISE FROM 3' INSIDE EACH END OF PIPE AND VERTICALLY UP TO THE EXISTING GROUNDLINE OR 1' ABOVE THE TOP OF THE PIPE - WHICHEVER IS GREATER.  
 TRENCH BACKFILL LIMITS STA. 157+98.6 & STA. 158+16.09 EXTEND LENGTHWISE FROM 2' OUTSIDE TO OUTSIDE SHOULDERS AND VERTICALLY TO THE BOTTOM OF THE SUBGRADE.

DITCH CHECK SCHEDULE

LOCATION	TEMPORARY DITCH CHECK FOOT
<b>STAGE I</b>	
STA 135+84, 63.4' LT	16
STA 135+54, 88.6' LT	15
STA 136+15, 60.1' LT	16
STA 136+32, 70.5' LT	16
STA 136+70, 76.8' LT	16
STA 136+62, 51' LT	16
STA 137+03.51, 94.8' LT	10
STA 137+20, 90.7' LT	16
STA 137+35, 97' LT	16
STA 142+58.27, 100.4' RT	15
<b>STAGE II</b>	
STA 143+87.5, 43' LI	12
STA 143+71, 49' LT	12
STA 143+84.5, 55' LT	12
STA 143+98, 62' LT	12
STA 144+11.5, 67' LT	20
STA 144+25, 73' LT	31
STA 148+37.50, 76' LT	7
STA 148+75, 82' LT	9
STA 148+94, 85' LT	16
STA 149+16.85, 86' LT	14
STA 149+33.70, 86' LT	17
STA 149+84.4, 85' LT	11
STA 150+15, 82' RT	12
STA 150+37.50, 83' LT	7
STA 151+00, 81' LT	9
STA 151+62.50, 79' LT	9
STA 151+74, 75' RT	10
STA 152+37.50, 70' LT	6
STA 154+54, 56' RT	6
STA 155+75, 52' LT	9
STA 157+43, 51' LT	22
STA 9+88, 45' LT	31
STA 10+30, 67' LT	19
STA 10+46, 69' LT	19
STA 10+41, 71' LI	19
STA 10+25, 73' LT	19
<b>TOTAL</b>	529
<b>TOTAL 3 APPLICATIONS</b>	1587


EROSION CONTROL SCHEDULE

LOCATION	EROSION CONTROL BLANKET	TEMPORARY EROSION CONTROL SEEDING (1)	PERIMETER EROSION BARRIER	INLET AND PIPE PROTECTION	HEAVY DUTY EROSION CONTROL BLANKET
	SQ YD	POUND	FOOT	EACH	SQ YD
<b>STAGE I</b>					
STA 127+37.49, 51.48' RT TO STA 141+75.29, 134.98' RT		1072	1502		
STA 130+00.00 TO STA 146+62.53					
STA 130+00.00 TO STA 142+20.94	14417				
STA 133+21.86, 20' LT TO STA 141+70.45, 0'			838		
STA 134+25.00, 71' RT TO STA 142+20.94, 0'			944		
STA 137+66.35, 123.78' LT TO STA 139+76.37, 141.92' LT			171		
STA 140+12.59, 108.49' LT				1	
STA 141+70.45, 0' TO STA 142+20.94, 50.24' RT			74		
STA 143+26.76 TO STA 146+62.53	2841				
STA 143+26.76, 50.24' LT TO STA 146+62.53, 0'			324		
STA 143+26.76, 50.24' LT TO STA 143+73.54, 0'			69		
STA 143+73.54, 0' RT TO STA 146+62.53, 0' RT			378		
<b>STAGE 2</b>		1786			
STA 125+00 TO STA 160+75					
STA 125+00.00, 44.39' LT TO STA 138+00.00, 128.10' LT			1342		
LT STA 125+00 TO STA 133+00					
RT STA 125+00 TO STA 133+00					
RT STA 125+00 TO STA 133+00					567
RT STA 130+00 TO STA 134+50	1558				
STA 125+00.00, 36' RT TO STA 141+42.27, 28.66' RT			1667		
LT STA 133+00 TO STA 138+00	4772				
STA 135+00.00, 35.00' LT TO STA 149+84.99, 28.63' LI			565		
STA 137+09.13, 130.37' LT TO STA 139+76.37, 141.92' LT			144		
STA 141+09.51, 252.66' LT TO STA 142+89.38, 48.21' LT			451		
STA 142+18.70, 219.81' LT TO STA 143+03.32, 184.90' LT			92		
STA 143+24.68, 180.38' LT TO STA 143+71.51, 176.05' LT			48		
STA 143+93.81, 175.82' LT TO STA 146+64.31, 218.99' LT			302		
STA 147+54.14, 85.20' LT				1	
STA 150+00.00, 92.24' LT TO STA 155+50.03, 59.08' LT			547		
STA 146+53.79, 65.45' RT TO STA 156+99.54, 42.82' RT			1027		
STA 156+48.16, 48.05' LT				1	
STA 156+54.21, 42.52' RT				1	
STA 157+16.89, 42.44' RT TO STA 160+75.00, 20.50' RT			364		
STA 157+22.05, 57.55' LT TO STA 160+70.00, 49' LT					
STA 157+50.00, 30.84' LT TO STA 160+70.00, 32.30' LT			321		
STA 157+97.90, 43.27' LT				1	
STA 157+08.15, 38.56' RT				1	
STA 158+15.63, 44.22' LT				1	
STA 158+15.70, 35.88' RT				1	
LT STA 141+10 TO STA 146+65					
LT STA 141+18 TO STA 146+51					
RT STA 146+65 TO STA 151+50	2402				
LT STA 147+13 TO STA 150+00	738				
LT STA 150+00 TO STA 160+70					
LT STA 150+00 TO STA 160+70					723
RT STA 151+50 TO STA 163+75					
<b>TOTAL</b>	26787	2856	11170	8	1280

(1) THE QUANTITY FOR TEMPORARY EROSION CONTROL SEEDING ASSUMES THREE SEPARATE APPLICATIONS AT A RATE OF 100 POUNDS/ACRE PER APPLICATION. THE CONTRACTOR SHALL APPLY AS NECESSARY AND AS DIRECTED BY THE ENGINEER IN THE FIELD.




PROP. CURVE PRIL8REV1 PI STA. = 126+59.50 Δ = 19° 25' 25" (RT) D = 1° 30' 00" R = 3,819.83' T = 653.75' L = 1,294.94' E = 55.54' e = 2.4% T.R. = 33° S.E. RUN = 53' P.C. STA. = 120+05.76 P.T. STA. = 133+00.70	PROP. CURVE PRIL8REV2 PI STA. = 137+90.75 Δ = 30° 52' 26" (LT) D = 8° 48' 53" R = 650.00' T = 179.49' L = 350.25' E = 24.33' e = 6.0% T.R. = 33° S.E. RUN = 133' P.C. STA. = 136+11.26 P.T. STA. = 139+61.52	PROP. CURVE PRIL8REV3 PI STA. = 148+32.28 Δ = 36° 18' 13" (RT) D = 8° 48' 53" R = 650.00' T = 213.10' L = 411.85' E = 34.04' e = 6.0% T.R. = 33° S.E. RUN = 133' P.C. STA. = 146+19.17 P.T. STA. = 150+31.02	PROP. CURVE PRIL8REV4 PI STA. = 155+72.74 Δ = 14° 02' 06" (LT) D = 1° 53' 05" R = 3,040.00' T = 374.21' L = 744.67' E = 22.95' e = 3.8% T.R. = 38° S.E. RUN = 97' P.C. STA. = 151+98.53 P.T. STA. = 159+43.20	PROP. CURVE PMILL-1 PI STA. = 3+12.85 Δ = 12° 15' 00" (LT) D = 9° 32' 57" R = 600.00' T = 64.39' L = 128.28' E = 3.44' e = NC T.R. = NA S.E. RUN = NA P.C. STA. = 2+48.47 P.T. STA. = 3+76.75	PROP. CURVE PMILL-2 PI STA. = 6+43.79 Δ = 30° 30' 06" (LT) D = 17° 41' 02" R = 324.00' T = 88.34' L = 172.48' E = 11.83' e = NC T.R. = NA S.E. RUN = NA P.C. STA. = 2+48.47 P.T. STA. = 7+27.94	PROP. CURVE PMILL-3 PI STA. = 10+58.68 Δ = 95° 22' 08" (RT) D = 54° 34' 03" R = 105.00' T = 115.33' L = 174.77' E = 50.97' e = NC T.R. = NA S.E. RUN = NA P.C. STA. = 5+55.46 P.T. STA. = 11+18.12
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ALIGNMENT COORDINATE - IL ROUTE 8		
DESCRIPTION	COORDINATE	
	NORTHING	EASTING
POT 111+00.00	1,485,739.07	2,411,086.85
PC 120+05.76	1,485,785.02	2,411,991.44
PI 126+59.50	1,485,818.18	2,412,644.34
PT 133+00.70	1,485,632.33	2,413,271.12
PC 136+11.26	1,485,544.04	2,413,568.86
PI 137+90.75	1,485,493.02	2,413,740.95
PT 139+61.52	1,485,537.53	2,413,914.83
PC 146+19.17	1,485,700.61	2,414,551.95
PI 148+32.28	1,485,753.45	2,414,758.40
PT 150+31.02	1,485,673.81	2,414,956.06
PC 151+98.53	1,485,611.21	2,415,111.42
PI 155+72.74	1,485,471.36	2,415,458.51
PT 159+43.20	1,485,419.86	2,415,829.16
POT 170+19.32	1,485,271.75	2,416,895.04

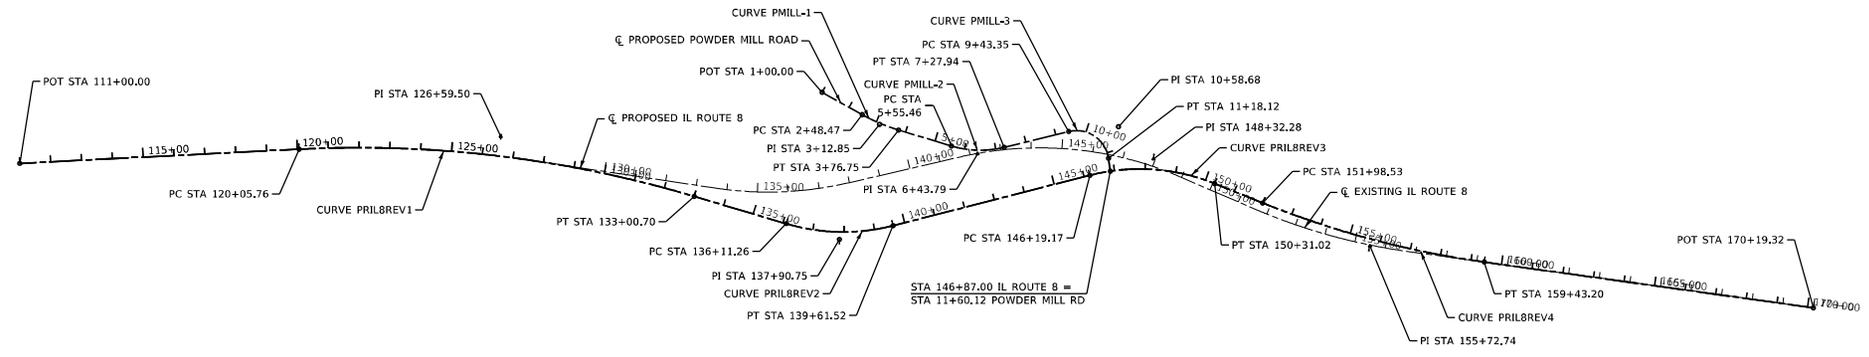ALIGNMENT COORDINATE - POWDER MILL ROAD		
DESCRIPTION	COORDINATE	
	NORTHING	EASTING
POT 1+00.00	1,485,968.77	2,413,684.89
PC 2+48.47	1,485,896.78	2,413,814.74
PI 3+12.85	1,485,865.57	2,413,871.05
PT 3+76.75	1,485,847.01	2,413,932.71
PC 5+55.46	1,485,795.49	2,414,103.83
PI 6+43.79	1,485,770.03	2,414,188.42
PT 7+27.94	1,485,791.02	2,414,274.22
PC 9+43.35	1,485,842.22	2,414,483.46
PI 10+58.68	1,485,869.62	2,414,595.49
PT 11+18.12	1,485,755.52	2,414,612.29
POT 11+60.12	1,485,713.97	2,414,618.41



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 MODEL NAME: AT1601  
 PLOT SCALE: 400.0000'/in.  
 PLOT DATE: 8/22/2019

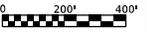DESIGNED: JLS  
 DRAWN: PDB  
 CHECKED: ESW  
 DATE:


















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 REVISED: -

STATE OF ILLINOIS  
 DEPARTMENT OF TRANSPORTATION

SCALE: 1"=200'  
 SHEET 1 OF 2 SHEETS

ALIGNMENT, TIE POINTS & BENCHMARKS  
 IL ROUTE 8 AND POWDER MILL ROAD

F.A.S. NO. 1388	SECTION (Z-1VB)BR-2	COUNTY PEORIA	TOTAL SHEETS 235	SHEET NO. 30
CONTRACT NO. 68799				
ILLINOIS FED. AID PROJECT				

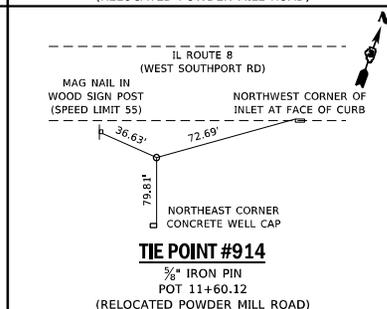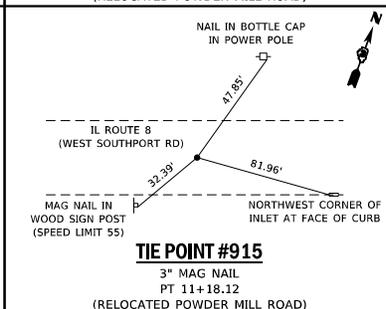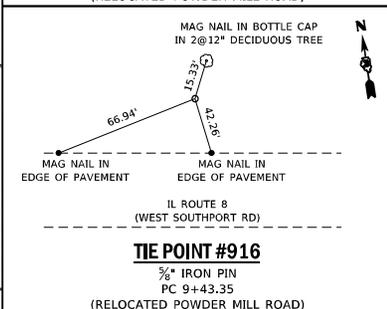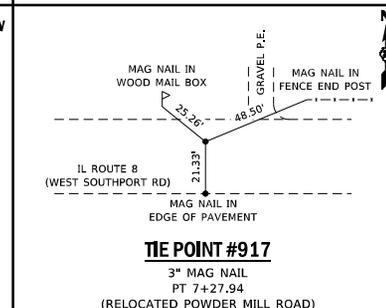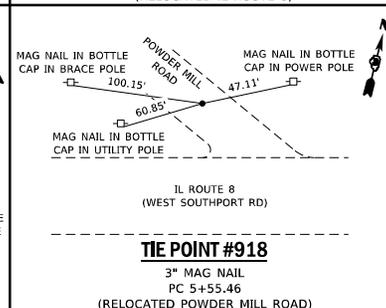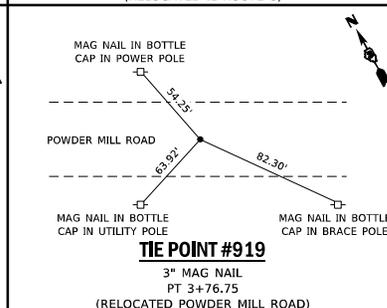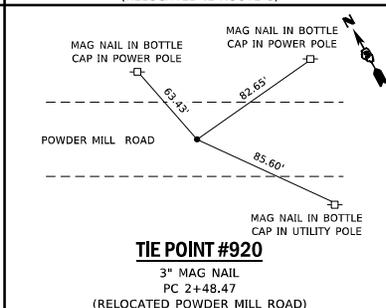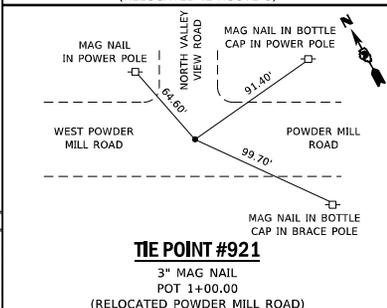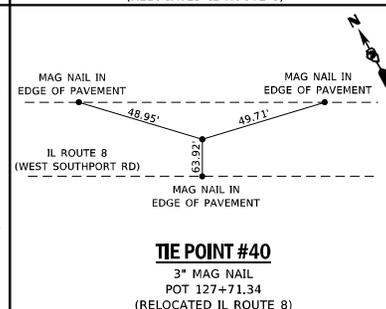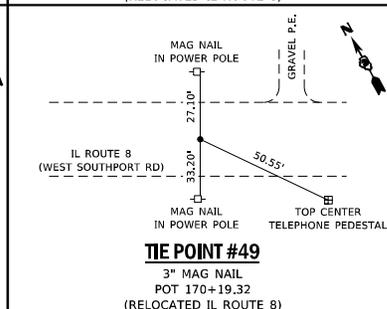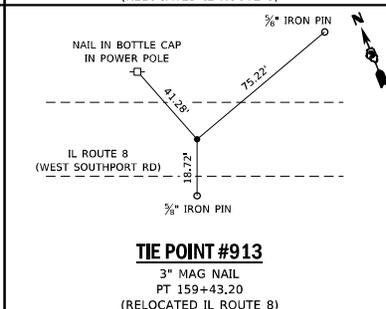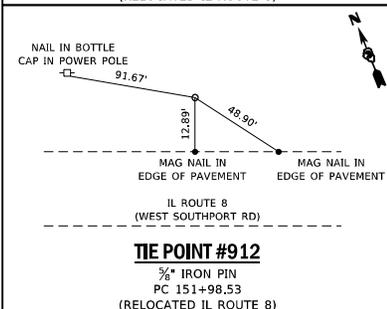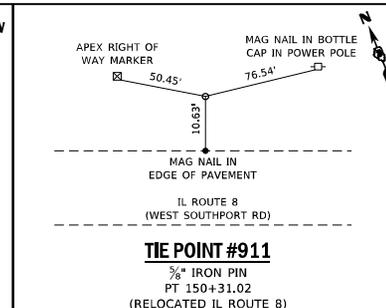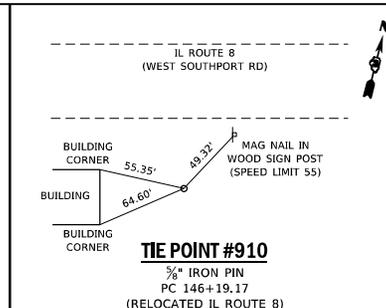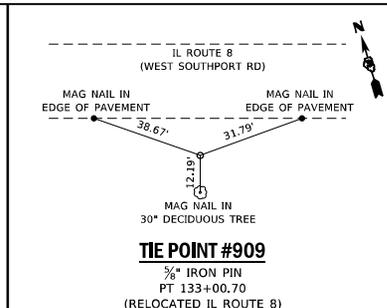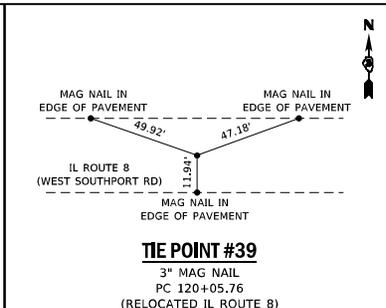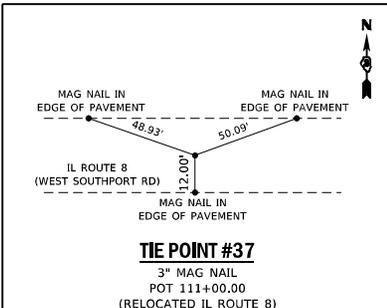

**LOCHMULLER GROUP**  
12255A North Lincoln Ave.  
Chicago, IL 60632  
Phone: 847.442.1433

USER NAME • Rshy  
MODEL NAME • AT040  
PLOT SCALE • 40/2000' / P.  
PLOT DATE • 8/22/2019

DESIGNED - JLS  
DRAWN - PDB  
CHECKED - ESW  
DATE -

REVISED -  
REVISED -  
REVISED -  
REVISED -

**STATE OF ILLINOIS**  
**DEPARTMENT OF TRANSPORTATION**

**TIE POINTS**  
**IL ROUTE 8 AND POWDER MILL ROAD**

SCALE: SHEET 2 OF 2 SHEETS

F.A.S. SITE	SECTION	COUNTY	TOTAL SHEETS	SHEET NO.
1388	(2-1V)BR-2	PEORIA	235	31
CONTRACT NO. 68799				
ILLINOIS FED. AID PROJECT				

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**PROPOSED IL ROUTE 8  
CURVES PRIL8REV1 AND PRIL8REV2**

STATION	LEFT EDGE	SLOPE %	CENTERLINE	SLOPE %	RIGHT EDGE
125+00.00	507.34	0.20	507.32	-2.20	507.05
125+04.00	507.39	0.37	507.35	-2.40	507.06
125+25.00	507.67	1.32	507.51	-2.40	507.22
125+49.00	507.93	2.40	507.64	-2.40	507.35
125+50.00	507.93	2.40	507.64	-2.40	507.35
125+75.00	508.04	2.40	507.76	-2.40	507.47
126+00.00	508.16	2.40	507.87	-2.40	507.58
FULL SUPERELEVATION					
132+25.00	513.97	2.40	513.69	-2.40	513.40
132+50.00	514.69	2.40	514.40	-2.40	514.11
132+75.00	515.44	2.40	515.15	-2.40	514.86
132+79.50	515.57	2.40	515.29	-2.40	515.00
132+99.50	516.06	1.49	515.89	-1.50	515.71
133+00.00	516.08	1.47	515.90	-1.50	515.72
133+25.00	516.69	0.33	516.65	-1.50	516.47
133+50.00	517.30	-0.80	517.40	-1.50	517.22
133+65.50	517.69	-1.50	517.87	-1.50	517.69
133+75.00	517.97	-1.50	518.15	-1.50	517.97
134+00.00	518.72	-1.50	518.90	-1.50	518.72
134+25.00	519.47	-1.50	519.65	-1.50	519.47
134+50.00	520.22	-1.50	520.40	-1.50	520.22
134+75.00	520.97	-1.50	521.15	-1.50	520.97
134+98.46	521.67	-1.50	521.85	-1.50	521.67
135+00.00	521.72	-1.50	521.90	-1.43	521.73
135+25.00	522.47	-1.50	522.65	-0.30	522.61
135+50.00	523.22	-1.50	523.40	0.83	523.50
135+64.46	523.65	-1.50	523.83	1.48	524.01
135+75.00	523.91	-1.97	524.15	1.96	524.39
136+00.00	524.53	-3.10	524.90	3.09	525.27
136+25.00	525.14	-4.22	525.65	4.22	526.16
136+50.00	525.76	-5.35	526.40	5.35	527.04
136+64.46	526.11	-6.00	526.83	6.00	527.55
136+75.00	526.43	-6.00	527.15	6.00	527.87
137+00.00	527.18	-6.00	527.90	6.00	528.62
137+25.00	527.93	-6.00	528.65	6.00	529.37
FULL SUPERELEVATION					
138+50.00	531.68	-6.00	532.40	6.00	533.12
138+75.00	532.40	-6.00	533.12	6.00	533.84
139+00.00	533.07	-6.00	533.79	6.00	534.51
139+17.63	533.51	-6.00	534.23	6.00	534.95
139+25.00	533.73	-5.67	534.41	5.67	535.09
139+50.00	534.43	-4.54	534.97	4.54	535.52
139+75.00	535.07	-3.42	535.48	3.41	535.89
140+00.00	535.66	-2.29	535.94	2.28	536.21
140+17.63	536.05	-1.50	536.23	1.48	536.40
140+25.00	536.16	-1.50	536.34	1.14	536.48
140+50.00	536.51	-1.50	536.69	0.01	536.69
140+75.00	536.80	-1.50	536.98	-1.11	536.85
140+83.63	536.89	-1.50	537.07	-1.50	536.89
141+00.00	537.04	-1.50	537.22	-1.50	537.04
141+25.00	537.23	-1.50	537.41	-1.50	537.23
141+50.00	537.36	-1.50	537.54	-1.50	537.36

**PROPOSED IL ROUTE 8  
CURVES PRIL8REV3 AND PRIL8REV4**

STATION	LEFT EDGE	SLOPE %	CENTERLINE	SLOPE %	RIGHT EDGE
144+25.00	535.30	-1.50	535.48	-1.50	535.30
144+50.00	534.79	-1.50	534.97	-1.50	534.79
144+75.00	534.23	-1.50	534.41	-1.50	534.23
144+97.06	533.69	-1.50	533.87	-1.50	533.69
145+00.00	533.63	-1.37	533.79	-1.50	533.61
145+25.00	533.10	-0.23	533.12	-1.50	532.94
145+50.00	532.51	0.89	532.40	-1.50	532.22
145+63.06	532.19	1.48	532.01	-1.50	531.83
145+75.00	531.89	2.03	531.65	-2.03	531.41
146+00.00	531.28	3.15	530.90	-3.16	530.52
146+25.00	530.66	4.28	530.15	-4.28	529.64
146+50.00	530.05	5.41	529.40	-5.41	528.75
146+63.06	529.73	6.00	529.01	-6.00	528.29
146+75.00	529.37	6.00	528.65	-6.00	527.93
147+00.00	528.62	6.00	527.90	-6.00	527.18
147+25.00	527.87	6.00	527.15	-6.00	526.43
FULL SUPERELEVATION					
149+25.00	521.87	6.00	521.15	-6.00	520.43
149+50.00	521.12	6.00	520.40	-6.00	519.68
149+75.00	520.37	6.00	519.65	-6.00	518.93
149+80.53	520.20	6.00	519.48	-6.00	518.76
150+00.00	519.53	5.24	518.90	-5.24	518.27
150+25.00	518.66	4.26	518.15	-4.26	517.64
150+50.00	517.79	3.28	517.40	-3.28	517.01
150+75.00	516.93	2.29	516.65	-2.29	516.38
151+00.00	516.06	1.31	515.90	-1.31	515.74
151+25.00	515.19	0.33	515.15	-0.33	515.11
151+33.53	514.89	0.00	514.89	0.00	514.89
151+50.00	514.32	-0.65	514.40	0.65	514.48
151+75.00	513.46	-1.62	513.65	1.63	513.85
152+00.00	512.59	-2.60	512.90	2.60	513.21
152+25.00	511.72	-3.58	512.15	3.58	512.58
152+30.53	511.53	-3.80	511.98	3.80	512.44
152+50.00	510.94	-3.80	511.40	3.80	511.86
152+75.00	510.19	-3.80	510.65	3.80	511.11
153+00.00	509.44	-3.80	509.90	3.80	510.36
FULL SUPERELEVATION					
158+50.00	498.58	-3.80	499.03	3.80	499.49
158+75.00	498.50	-3.80	498.95	3.80	499.41
159+00.00	498.42	-3.80	498.87	3.80	499.33
159+11.20	498.38	-3.80	498.84	3.80	499.30
159+25.00	498.40	-3.26	498.80	3.26	499.19
159+50.00	498.44	-2.29	498.72	2.28	498.99
159+70.20	498.47	-1.50	498.64	1.50	498.82
159+75.00	498.45	-1.50	498.63	1.30	498.78
160+00.00	498.36	-1.50	498.54	0.32	498.58
160+25.00	498.27	-1.50	498.45	-0.65	498.37
160+49.20	498.19	-1.50	498.37	-1.60	498.18
160+50.00	498.19	-1.50	498.36	-1.60	498.17
160+63.00	498.14	-1.50	498.32	-1.60	498.13
160+70.00	498.15	-1.20	498.30	-1.60	498.10

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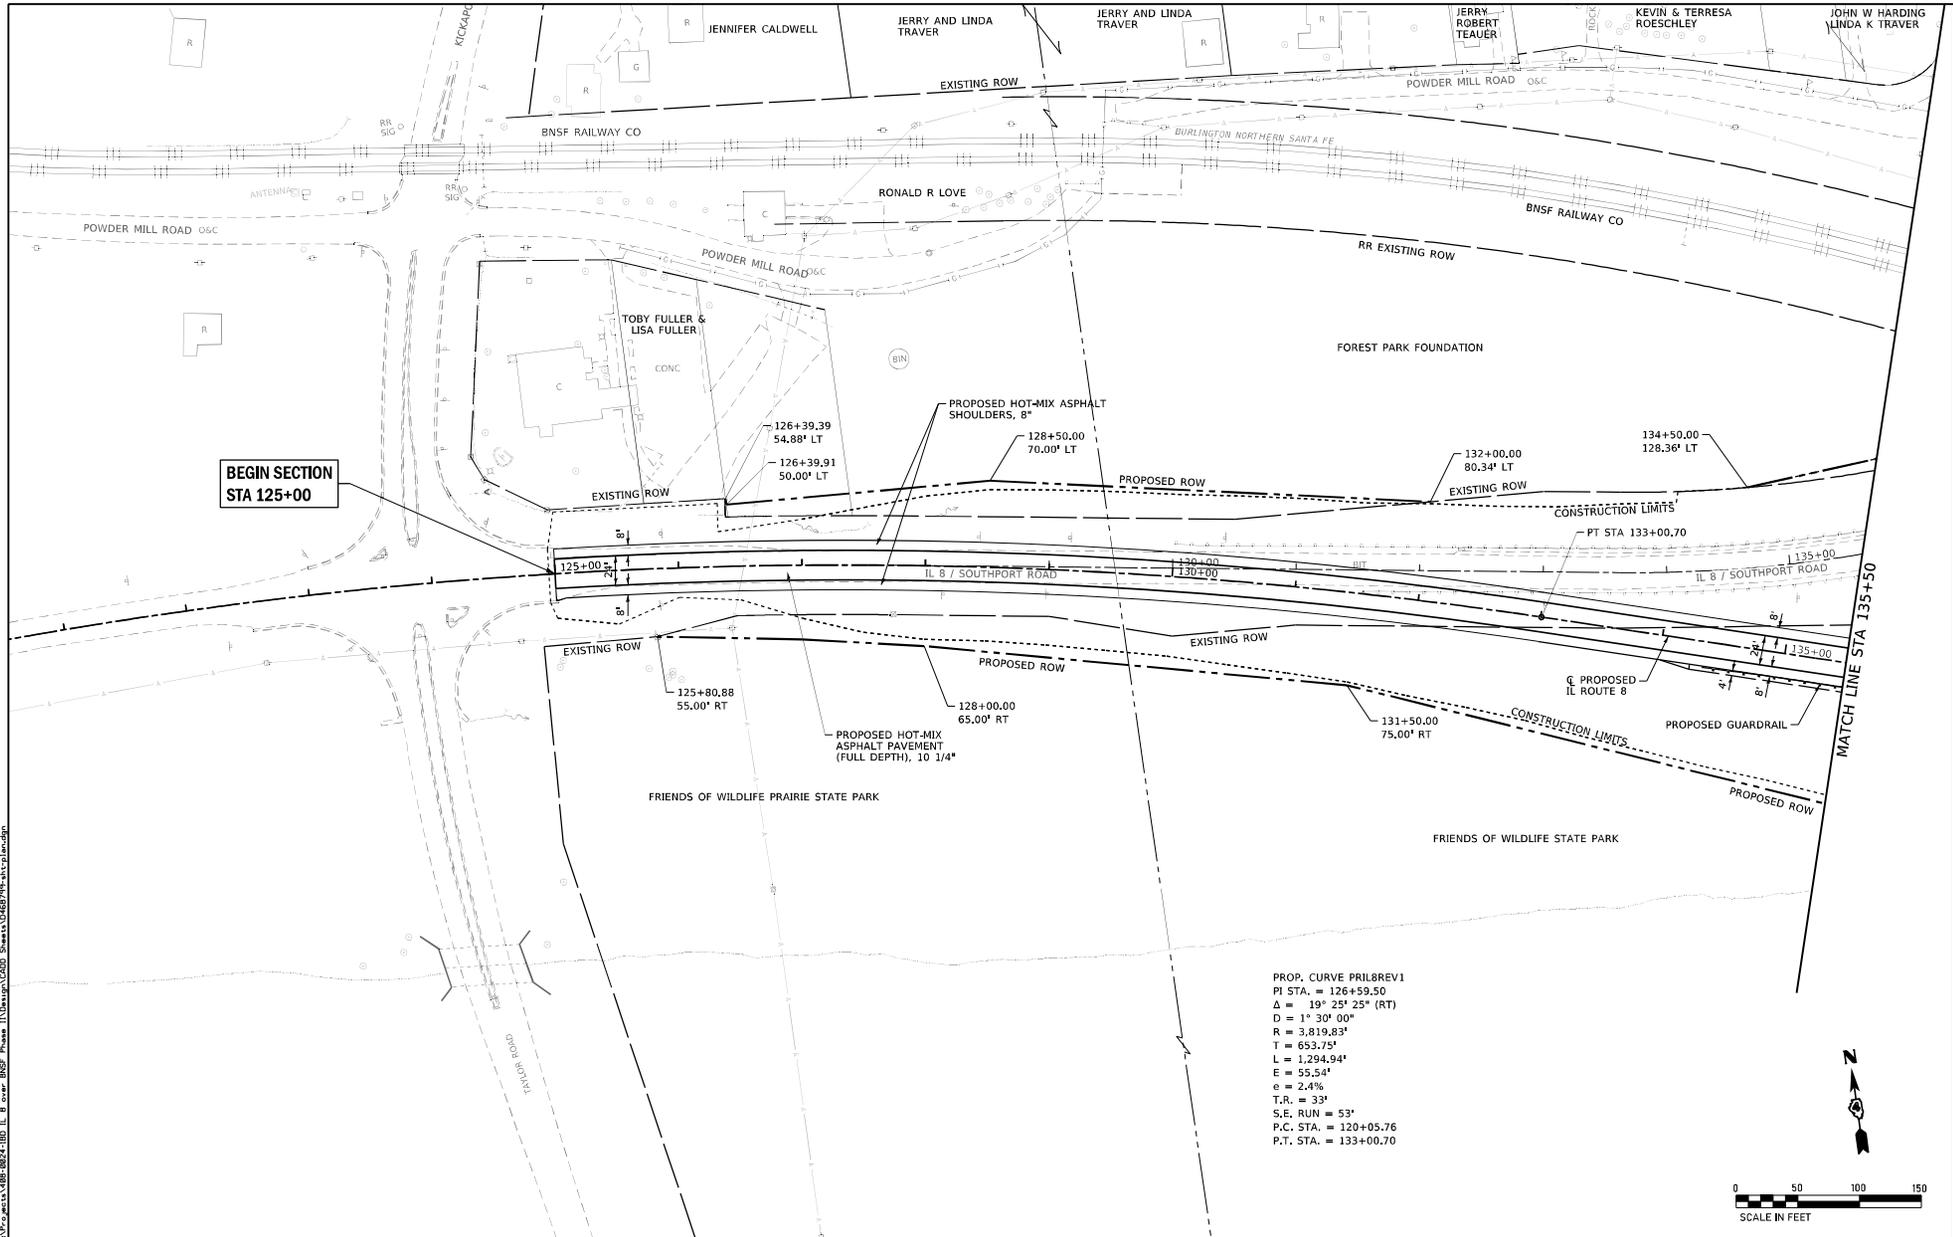
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MODEL NAME	• SE Table	DRAWN	• PDB	REVISED	•
PLOT SCALE	• 0.3607"/ft.	CHECKED	• ESW	REVISED	•
PLOT DATE	• 8/22/2018	DATE	• 01-17-18	REVISED	•

**STATE OF ILLINOIS  
DEPARTMENT OF TRANSPORTATION**

**SUPERELEVATION TABLES  
IL ROUTE 8**

SCALE: NONE SHEET 1 OF 1 SHEETS

F.A.S. NO.	SECTION	COUNTY	TOTAL SHEETS	SHEET NO.
1388	(2-1VB)R-2	PEORIA	235	32
CONTRACT NO. 68799				
ILLINOIS FED. AID PROJECT				



PROP. CURVE PR18REV1  
 PI STA. = 126+59.50  
 $\Delta = 19^\circ 25' 25''$  (RT)  
 $D = 1^\circ 30' 00''$   
 $R = 3,819.83'$   
 $T = 653.75'$   
 $L = 1,294.94'$   
 $E = 55.54'$   
 $e = 2.4\%$   
 $T.R. = 33'$   
 $S.E. RUN = 53'$   
 $P.C. STA. = 120+05.76$   
 $P.T. STA. = 133+00.70$

BEGIN SECTION  
 STA 125+00

MATCH LINE STA 135+50



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USER NAME: Betsy  
 MODEL NAME: 01 Plan  
 PLOT SCALE: 100,0000\*/PL  
 PLOT DATE: 8/22/2019

DESIGNED: JLS  
 DRAWN: PDB  
 CHECKED: ESW  
 DATE: 01-17-18

REVISED: -  
 REVISED: -  
 REVISED: -  
 REVISED: -

STATE OF ILLINOIS  
 DEPARTMENT OF TRANSPORTATION

PLAN SHEETS  
 IL ROUTE 8

SCALE: 1"=50' SHEET 1 OF 4 SHEETS STA 121+50 TO STA 135+50

F.A.S. SITE	SECTION	COUNTY	TOTAL SHEETS	SHEET NO.
1388	(2-1)BJR-2	PEORIA	235	33
CONTRACT NO. 68799				
ILLINOIS FED. AID PROJECT				






PROP. CURVE PRIL8REV4  
 PI STA. = 153+72.74  
 $\Delta = 14^{\circ} 02' 06''$  (LT)  
 $D = 1^{\circ} 53' 05''$   
 $R = 3,040.00'$   
 $T = 374.21'$   
 $L = 744.67'$   
 $E = 22.95'$   
 $e = 3.8\%$   
 $T.R. = 38'$   
 $S.E. RUN = 97'$   
 $P.C. STA. = 151+98.53$   
 $P.T. STA. = 159+43.20$

FRIENDS OF WILDLIFE PRAIRIE STATE PARK

AMEREN OF ILLINOIS

FRIENDS OF WILDLIFE PRAIRIE STATE PARK

END SECTION  
 STA 160+70

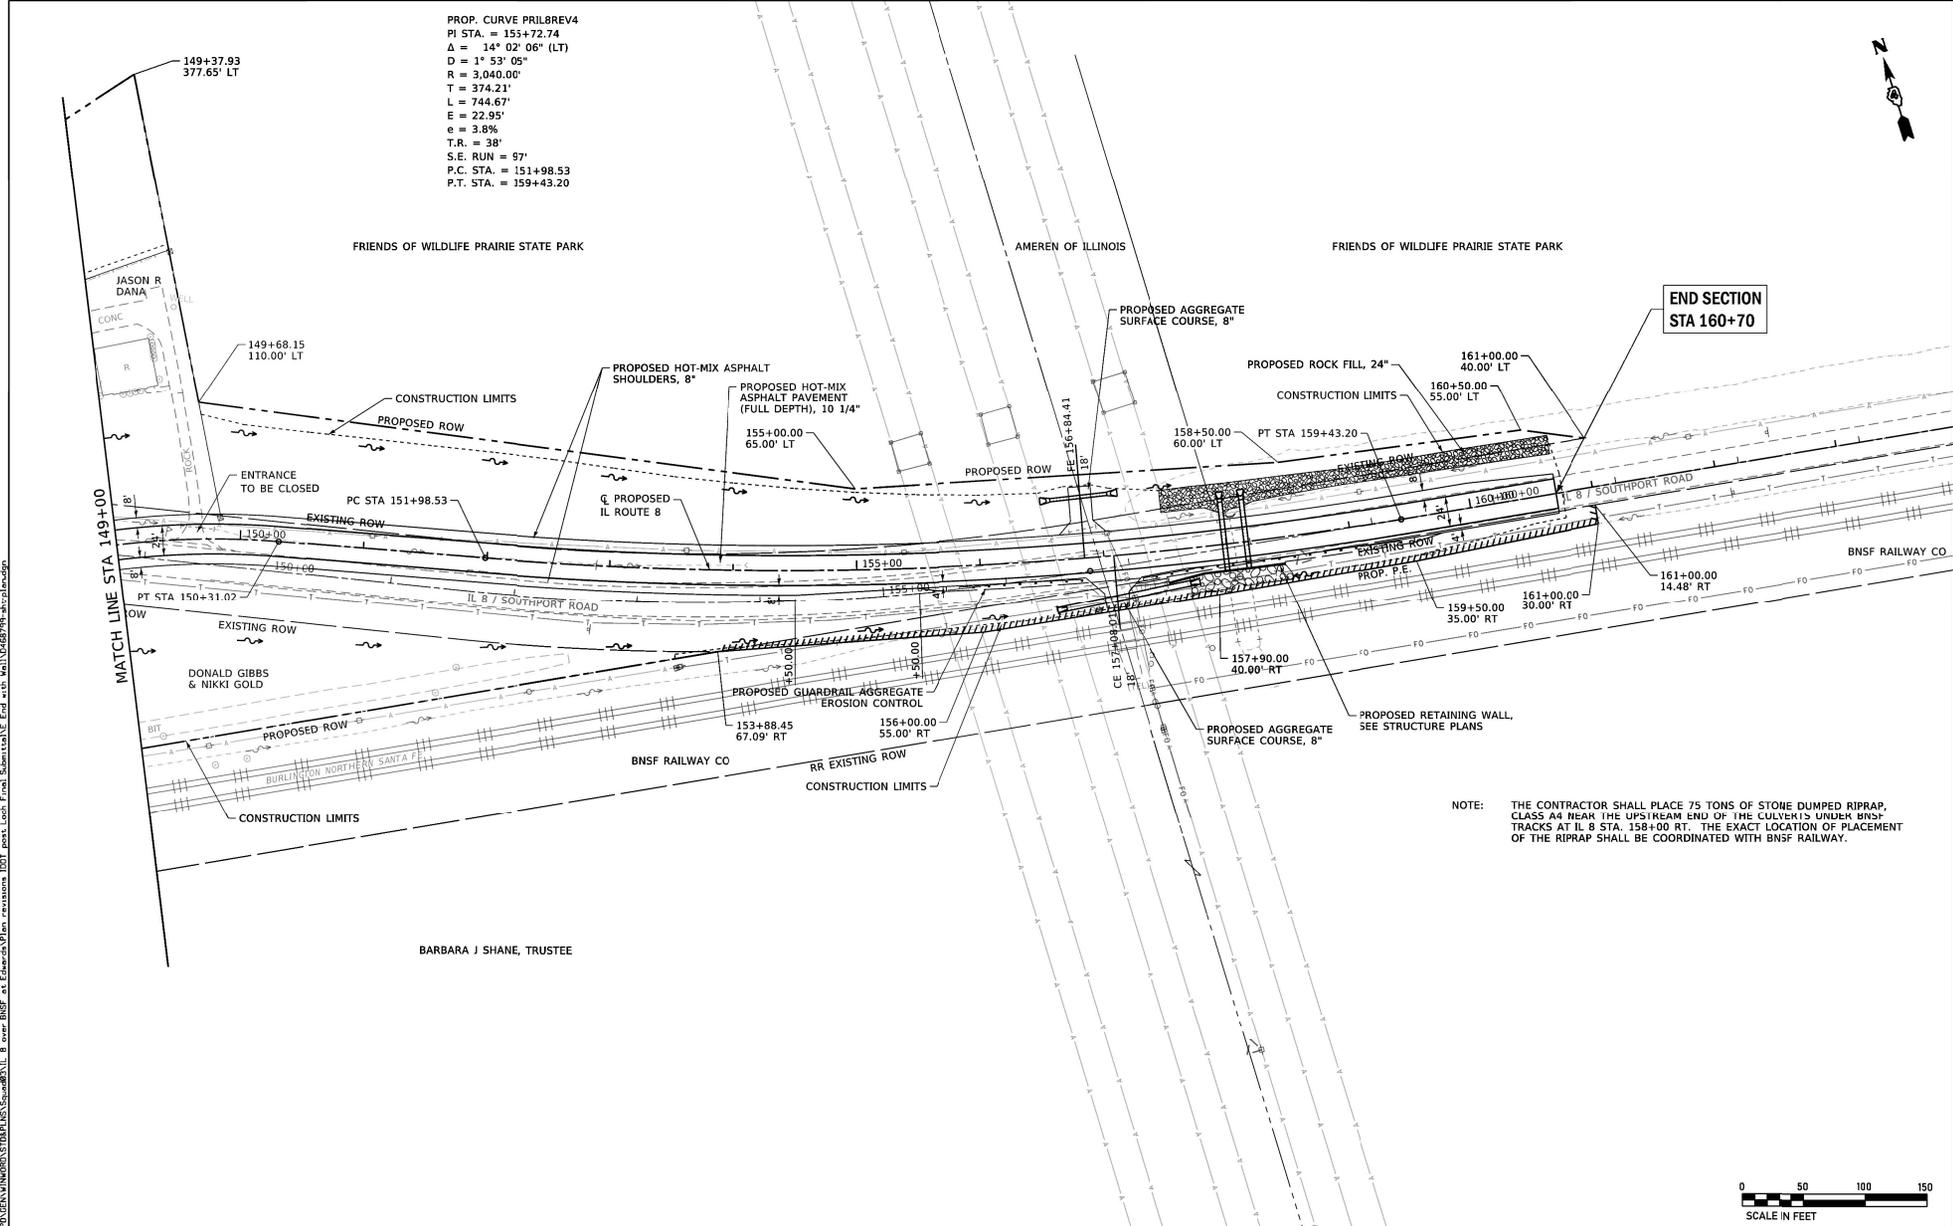

NOTE: THE CONTRACTOR SHALL PLACE 75 TONS OF STONE DUMPED RIPRAP, CLASS A4 NEAR THE UPSTREAM END OF THE CULVERTS UNDER BNSF TRACKS AT IL 8 STA. 158+00 RT. THE EXACT LOCATION OF PLACEMENT OF THE RIPRAP SHALL BE COORDINATED WITH BNSF RAILWAY.



FILE NAME: D:\PROJECTS\MINOR\ST08\PLAN\SUBAREA\PLAN\_8.dwg OVER: BNSF AT EMERSON PLAN REVISIONS ID: post Loc: Final Submittal E End with Mail: 06/27/18



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 MODEL NAME - 03 Plan  
 PLOT SCALE - 100.0000 / in.  
 PLOT DATE - 5/7/2021

DESIGNED - JLS  
 DRAWN - PDB  
 CHECKED - ESW  
 DATE - 01-17-18


REVISED - KH (DDOT) 05/06/21  
 REVISED -  
 REVISED -  
 REVISED -

STATE OF ILLINOIS  
 DEPARTMENT OF TRANSPORTATION

PLAN SHEETS  
 IL ROUTE 8

SCALE: 1"=50' SHEET 3 OF 4 SHEETS STA 149+00 TO STA 163+50

F.A.S. RTE.	SECTION	COUNTY	TOTAL SHEETS	SHEET NO.
1388	(Z-1V)BR-2	PEORIA	235	35
CONTRACT NO. 68799				
ILLINOIS FED. AID PROJECT				

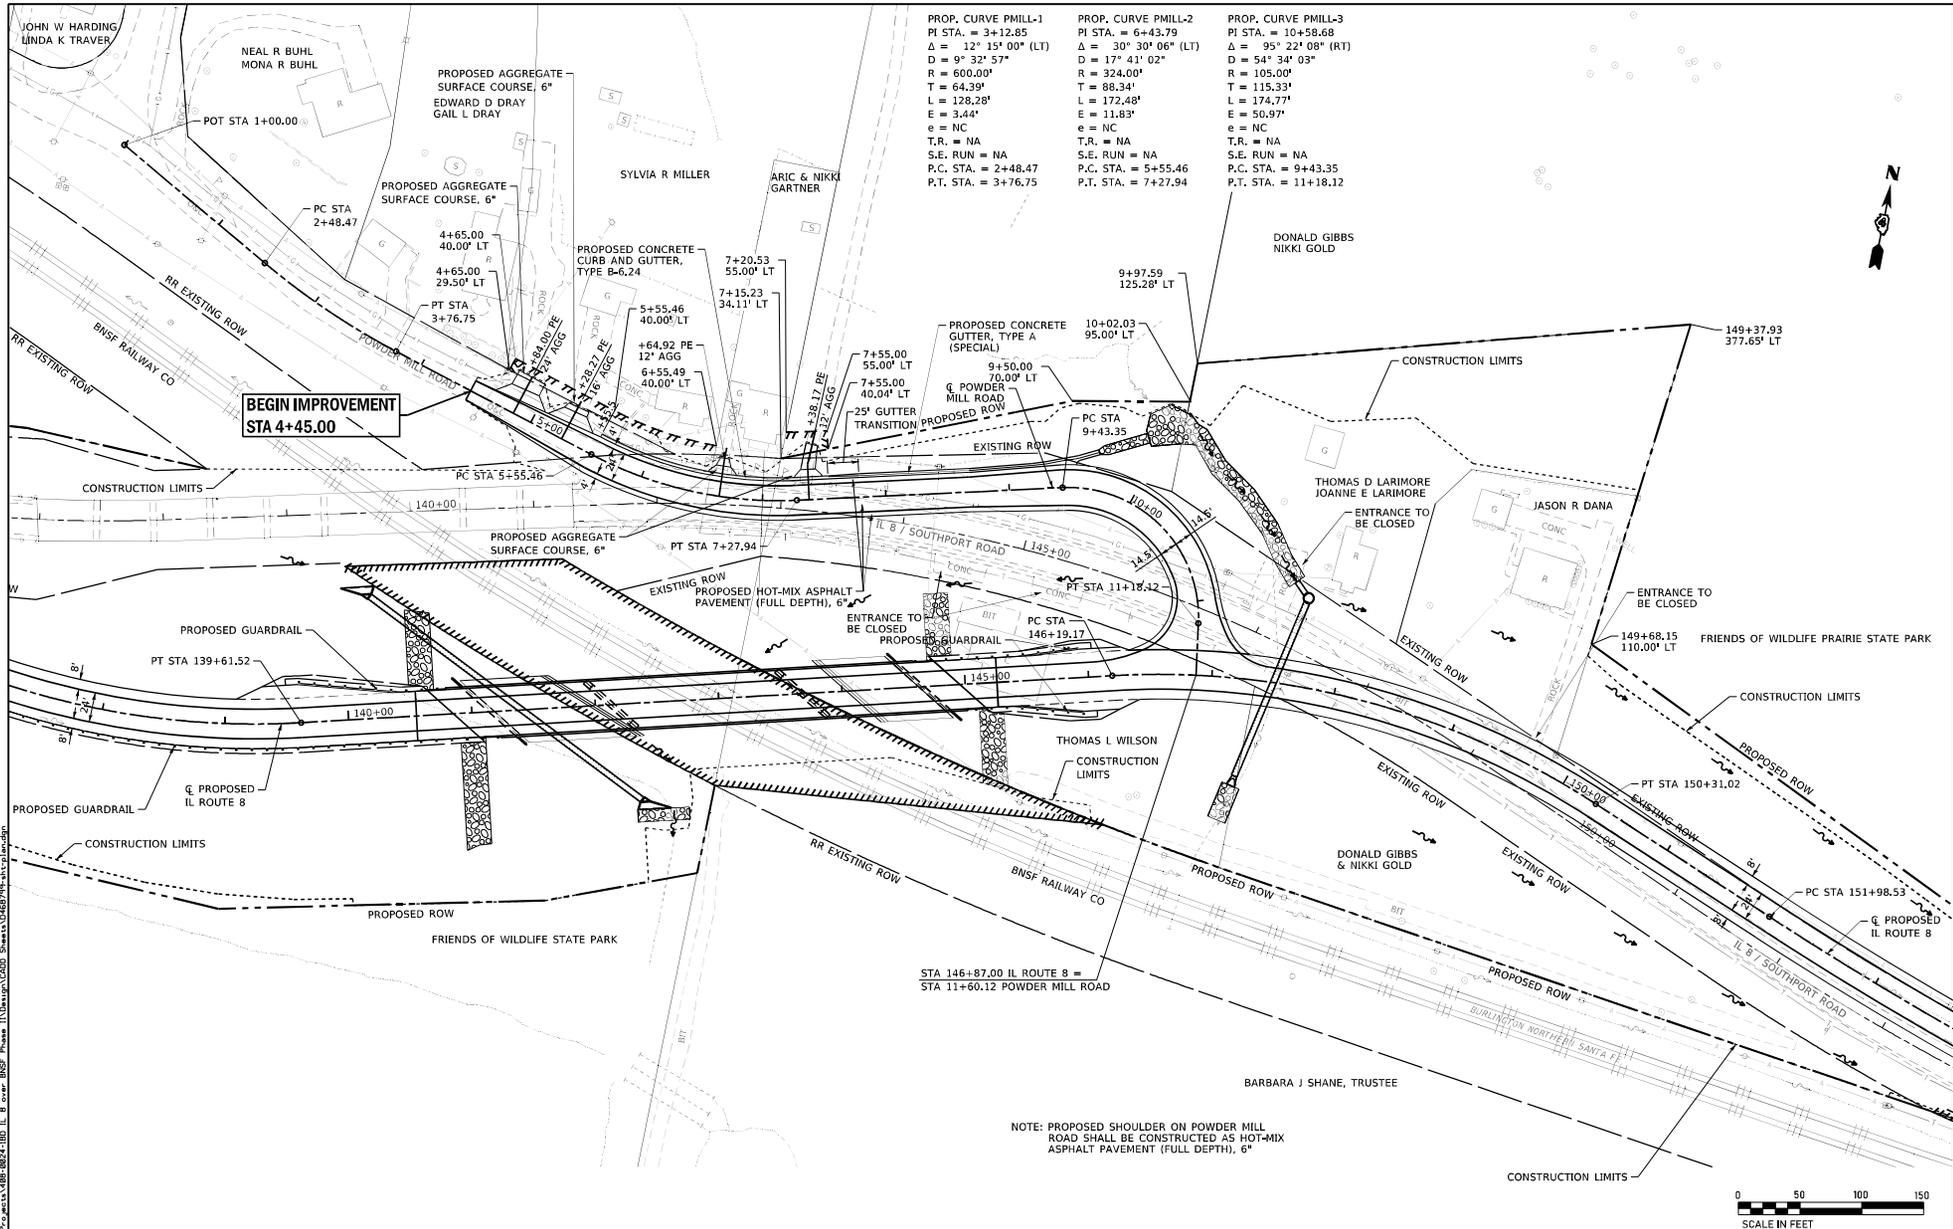

PROP. CURVE PMILL-1  
 P.I. STA. = 3+12.85  
 $\Delta = 12^\circ 15' 00''$  (LT)  
 $D = 9^\circ 32' 57''$   
 $R = 600.00'$   
 $T = 64.39'$   
 $L = 128.28'$   
 $E = 3.44'$   
 $e = NC$   
 $T.R. = NA$   
 $S.E. RUN = NA$   
 $P.C. STA. = 2+48.47$   
 $P.T. STA. = 3+76.75$

PROP. CURVE PMILL-2  
 P.I. STA. = 6+43.79  
 $\Delta = 30^\circ 30' 06''$  (LT)  
 $D = 17^\circ 41' 02''$   
 $R = 324.00'$   
 $T = 88.34'$   
 $L = 172.48'$   
 $E = 11.83'$   
 $e = NC$   
 $T.R. = NA$   
 $S.E. RUN = NA$   
 $P.C. STA. = 5+55.46$   
 $P.T. STA. = 7+27.94$

PROP. CURVE PMILL-3  
 P.I. STA. = 10+58.68  
 $\Delta = 95^\circ 22' 08''$  (RT)  
 $D = 54^\circ 34' 03''$   
 $R = 105.00'$   
 $T = 115.33'$   
 $L = 174.77'$   
 $E = 50.97'$   
 $e = NC$   
 $T.R. = NA$   
 $S.E. RUN = NA$   
 $P.C. STA. = 9+43.35$   
 $P.T. STA. = 11+18.12$



FILE NAME: S:\V2\2114\188-024-100 IL 8 over BNSF Phase 1\Drawings\000 Sheets\046879\Plan\188-024-100.dwg

**BEGIN IMPROVEMENT  
STA 4+45.00**

NOTE: PROPOSED SHOULDER ON POWDER MILL ROAD SHALL BE CONSTRUCTED AS HOT-MIX ASPHALT PAVEMENT (FULL DEPTH), 6"



USER NAME	• Betsy	DESIGNED	- JLS	REVISED	-
MODEL NAME	• 04 Plan	DRAWN	- PDB	REVISED	-
PLOT SCALE	• 100.0000"/PL	CHECKED	- ESW	REVISED	-
PLOT DATE	• 8/22/2019	DATE	- 01-17-18	REVISED	-

**STATE OF ILLINOIS  
DEPARTMENT OF TRANSPORTATION**

**PLAN SHEETS  
POWDER MILL ROAD**


SCALE: 1"=50' SHEET 4 OF 4 SHEETS STA 4+35 TO STA 11+53.88

F.A.S. SITE	SECTION	COUNTY	TOTAL SHEETS	SHEET NO.
1388	(2-1)B/JR-2	PEORIA	235	36
CONTRACT NO. 68799				
ILLINOIS FED. AID PROJECT				

DATE	
BY	
REVISION	
DATE	
BY	
NO.	

DATE	
BY	
REVISION	
DATE	
BY	
NO.	

FILE NAME: G:\p02\1188-0824-180 IL 8 curv BNSF Phase 1\Drawings\1250 Sheet 1\0824180-IL8curv1.dwg

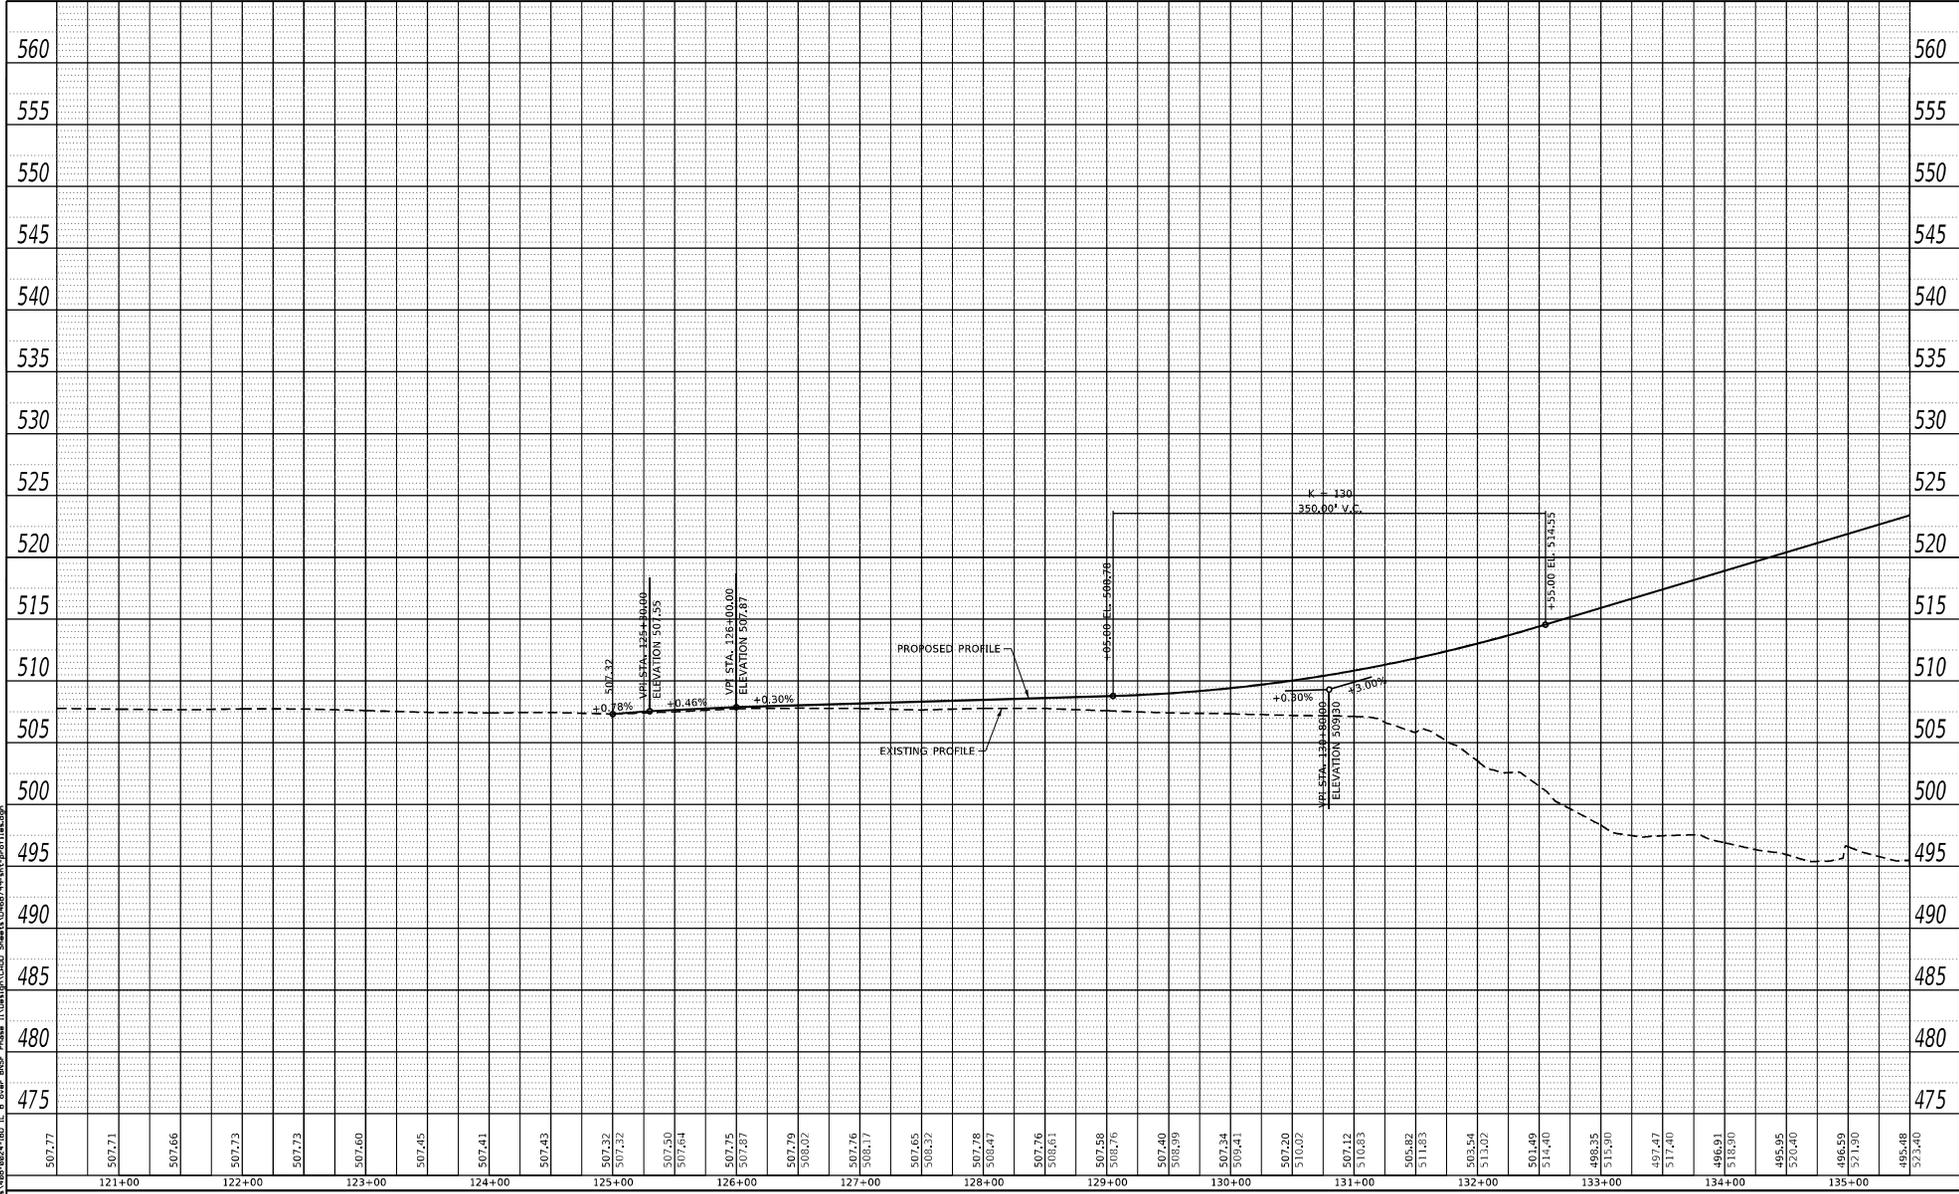

USER NAME: Beloy  
 MODEL NAME: 01 Prof  
 PLOT SCALE: 1/32"=1'-0"  
 PLOT DATE: 8/22/2019

DESIGNED: ALS  
 DRAWN: LEC  
 CHECKED: ESW  
 DATE:

REVISED: -  
 REVISED: -  
 REVISED: -  
 REVISED: -

STATE OF ILLINOIS  
 DEPARTMENT OF TRANSPORTATION

PROFILE SHEETS  
 IL ROUTE 8  
 SCALE: 1"=50'  
 SHEET 1 OF 4 SHEETS  
 STA 121+50 TO STA 135+50


F.A.S. SITE	SECTION	COUNTY	TOTAL SHEETS	SHEET NO.
1388	(2-1VB)BR-2	PEORIA	235	37
CONTRACT NO. 68799				
ILLINOIS FED. AID PROJECT				



BY	
DATE	
REVISION	
NO.	
DATE	
NO.	
DATE	
NO.	

BY	
DATE	
REVISION	
NO.	
DATE	
NO.	
DATE	
NO.	

FILE NAME: C:\p02\1188-9824-IBD\_IL\_8.dwg BNSF Phase II (1188-9824-IBD\_IL\_8.dwg) User: jls Date: 8/22/2019 10:42:58 AM

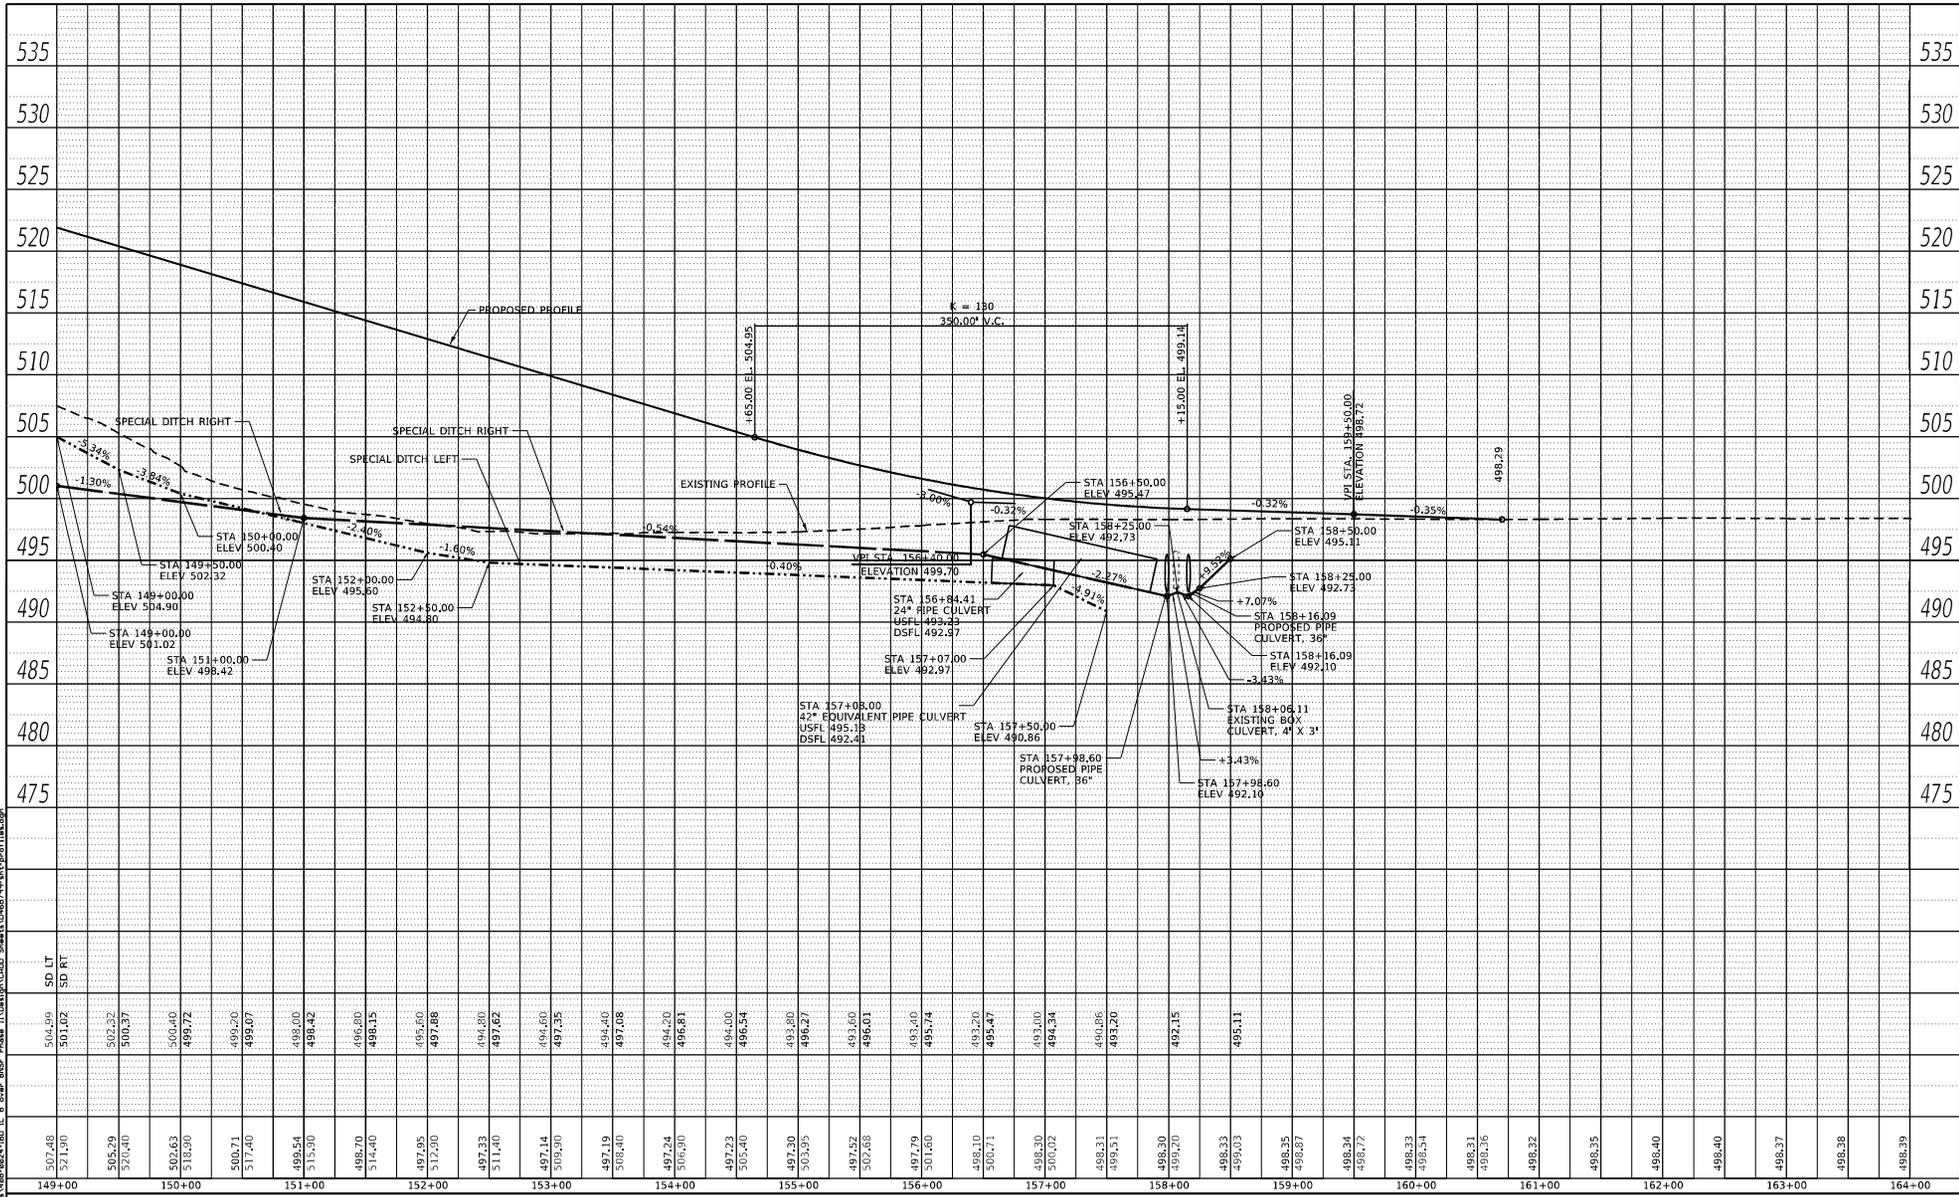

USER NAME	• jls	DESIGNED	• jls	REVISION	-
MODEL NAME	• 03 Prof	DRAWN	• LEC	REVISION	-
PLOT SCALE	• 1/32"=1'-0"	CHECKED	• ESW	REVISION	-
PLOT DATE	• 8/22/2019	DATE	-	REVISION	-


**STATE OF ILLINOIS  
DEPARTMENT OF TRANSPORTATION**

<b>PROFILE SHEETS IL ROUTE 8</b>		
SCALE: 1"=50'	SHEET 3 OF 4 SHEETS	STA 149+00 TO STA 163+50

F.A.S. SITE	SECTION	COUNTY	TOTAL SHEETS	SHEET NO.
1388	(2-1VB)BR-2	PEORIA	235	39
CONTRACT NO. 68799				ILLINOIS FED. AID PROJECT

BY	
DATE	
REVISION	
NO.	
DESCRIPTION	
DATE	
BY	
DATE	
REVISION	
NO.	
DESCRIPTION	
DATE	
BY	
DATE	
REVISION	
NO.	
DESCRIPTION	

BY	
DATE	
REVISION	
NO.	
DESCRIPTION	
DATE	
BY	
DATE	
REVISION	
NO.	
DESCRIPTION	
DATE	
BY	
DATE	
REVISION	
NO.	
DESCRIPTION	

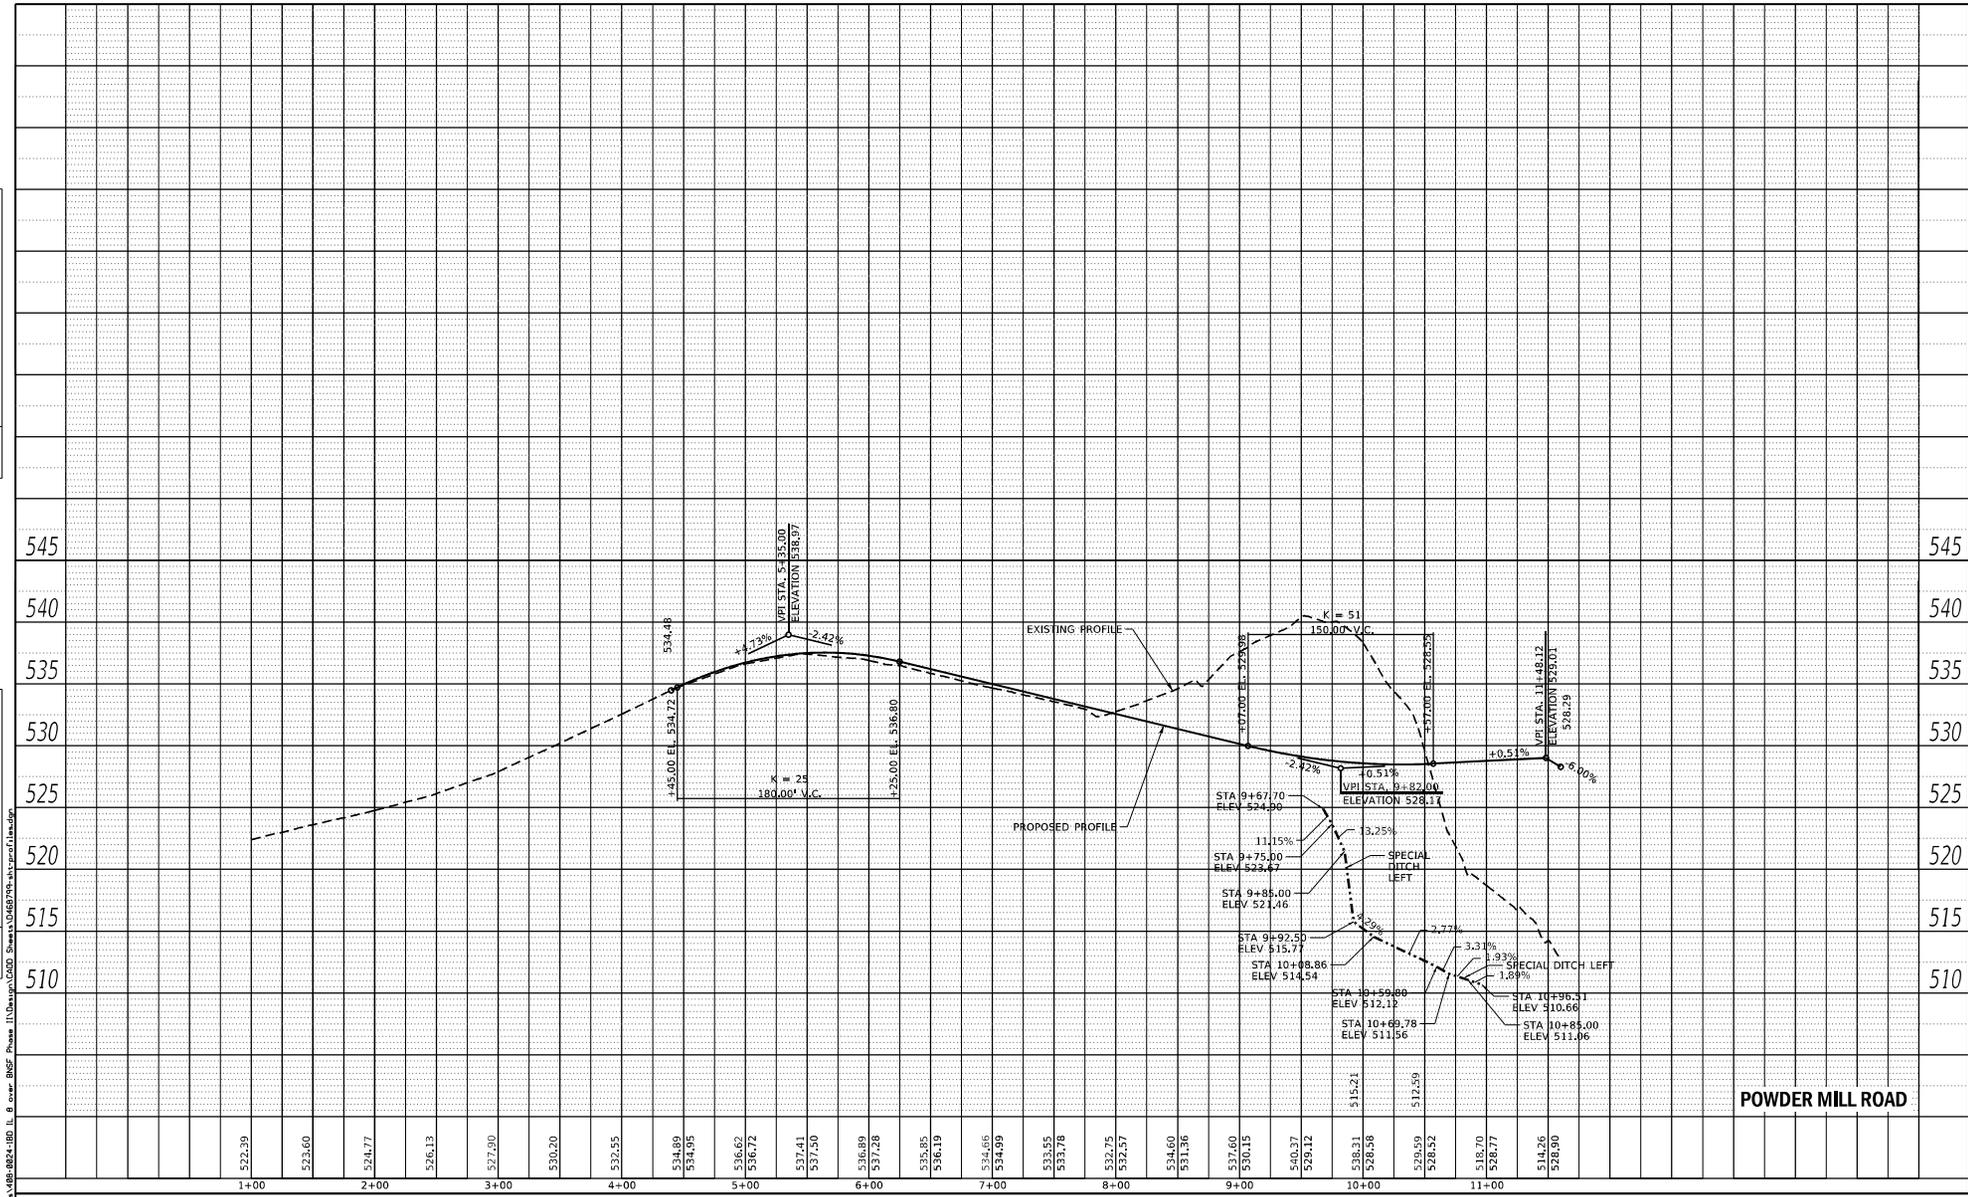

FILE NAME: G:\Projects\1188-0824-180\_11\_0\_0000\_BNSF Phase 1\Drawings\1188-0824-180-11\_0\_0000\_BNSF Phase 1.dwg



USER NAME	• Boley	DESIGNED	• JLS	REVISION	-
MODEL NAME	• 04 Prof	DRAWN	• LEC	REVISION	-
PLOT SCALE	• 1/32"=1'-0"	CHECKED	• ESW	REVISION	-
PLOT DATE	• 8/22/2019	DATE	-	REVISION	-

**STATE OF ILLINOIS  
DEPARTMENT OF TRANSPORTATION**

**PROFILE SHEETS  
POWDER MILL ROAD**

SCALE: 1"=50' SHEET 4 OF 4 SHEETS

F.A.S. SITE	SECTION	COUNTY	TOTAL SHEETS	SHEET NO.
1388	(2-1V)BR-2	PEORIA	235	40
CONTRACT NO. 68799				
ILLINOIS FED. AID PROJECT				

# GENERAL NOTES FOR DETOUR:

BLR 21-9 SHALL BE USED IN ADVANCE OF THE ROAD CLOSURE ON THE EAST END OF THE WESTBOUND APPROACH.

IL 8 SIGNS AND CARDINAL DIRECTION SHALL BE BLACK ON WHITE AND SIZE SHALL BE PER MUTCD FOR CONVENTIONAL ROADS.




DETOUR SIGNS WITH ARROWS SHALL SIZED BE PER MUTCD FOR CONVENTIONAL ROADS WHEN PLACED ON SUCH ROADS. SIGNS ON THE INTERSTATE SHALL BE SIZED AS PER THE MUTCD FOR INTERSTATE ROADS. (INTERSTATE SIGNS ARE OVERSIZED.)

ALL SIGNS SHALL BE POST MOUNTED WHERE LOCATIONS ALLOW. THE RESIDENT ENGINEER SHALL APPROVE ANY STAND MOUNTED SIGN LOCATIONS WHERE POST MOUNTING IS NOT POSSIBLE.

ANY CONFLICTING IL 8 SIGNAGE SHALL BE COVERED OR REMOVED AS NECESSARY.

"DETOUR AHEAD" SIGNS SHALL HAVE A FLASHING LIGHT ATTACHED.

TYPICAL SIGN SIZE-BLACK ON ORANGE- 48 X 48 :

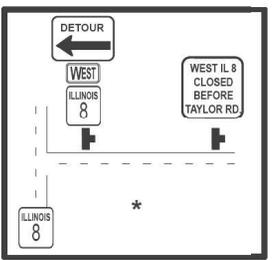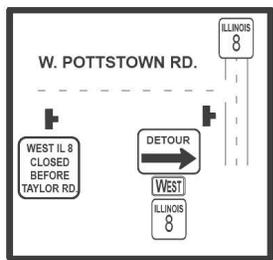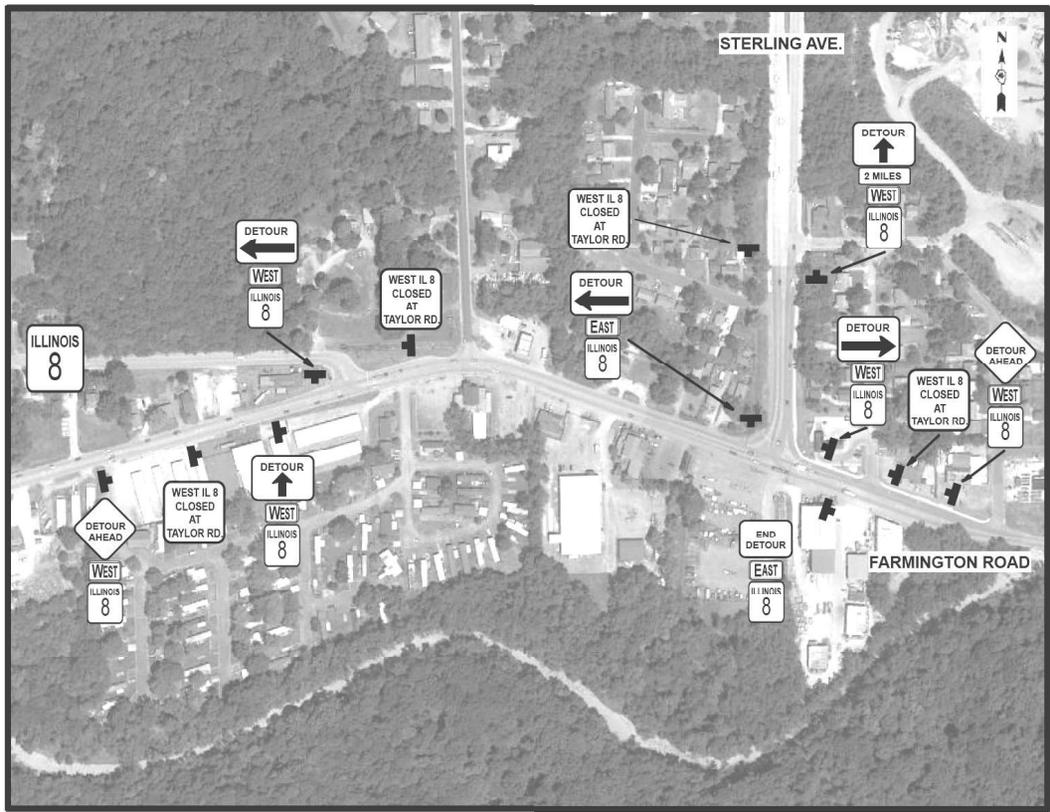

\*= HEINZ LANE  
N. KOERNER ROAD  
RICHWOODS BLVD.  
RESEVOIR BLVD.  
KINGS CT.

FILE NAME: S:\Pro\2011\1188-1024-101 IL 8 over BNSF Phase 1\Unhappy\1024-Sheet1\0188\1188-1024-101-Detour\_Signage.dwg



USER NAME	• Betsy
MODEL NAME	• DTI-01
PLOT SCALE	• 10:2000"=1" PL
PLOT DATE	• 8/22/2019

DESIGNED	- JLS	REVISED	-
DRAWN	- PDB	REVISED	-
CHECKED	- ESW	REVISED	-
DATE	- 01-17-18	REVISED	-

STATE OF ILLINOIS  
DEPARTMENT OF TRANSPORTATION


DETOUR SIGNING PLAN SHEETS			
IL ROUTE 8			
SCALE: NONE	SHEET 1	OF 3	SHEETS

F.A.S. SITE	SECTION	COUNTY	TOTAL SHEETS	SHEET NO.
1388	(2-1V)BR-2	PEORIA	235	41
CONTRACT NO. 68799				
ILLINOIS FED. AID PROJECT				





FILE NAME: E:\Projects\1188-024-IBD\_IL\_8\_mtr\_BNF\_Phase 1\Unsup\1188-024-IBD\_IL\_8\_mtr\_BNF\_Phase 1\Unsup\1188-024-IBD\_IL\_8\_mtr\_BNF\_Phase 1\1188-024-IBD\_IL\_8\_mtr\_BNF\_Phase 1.dwg

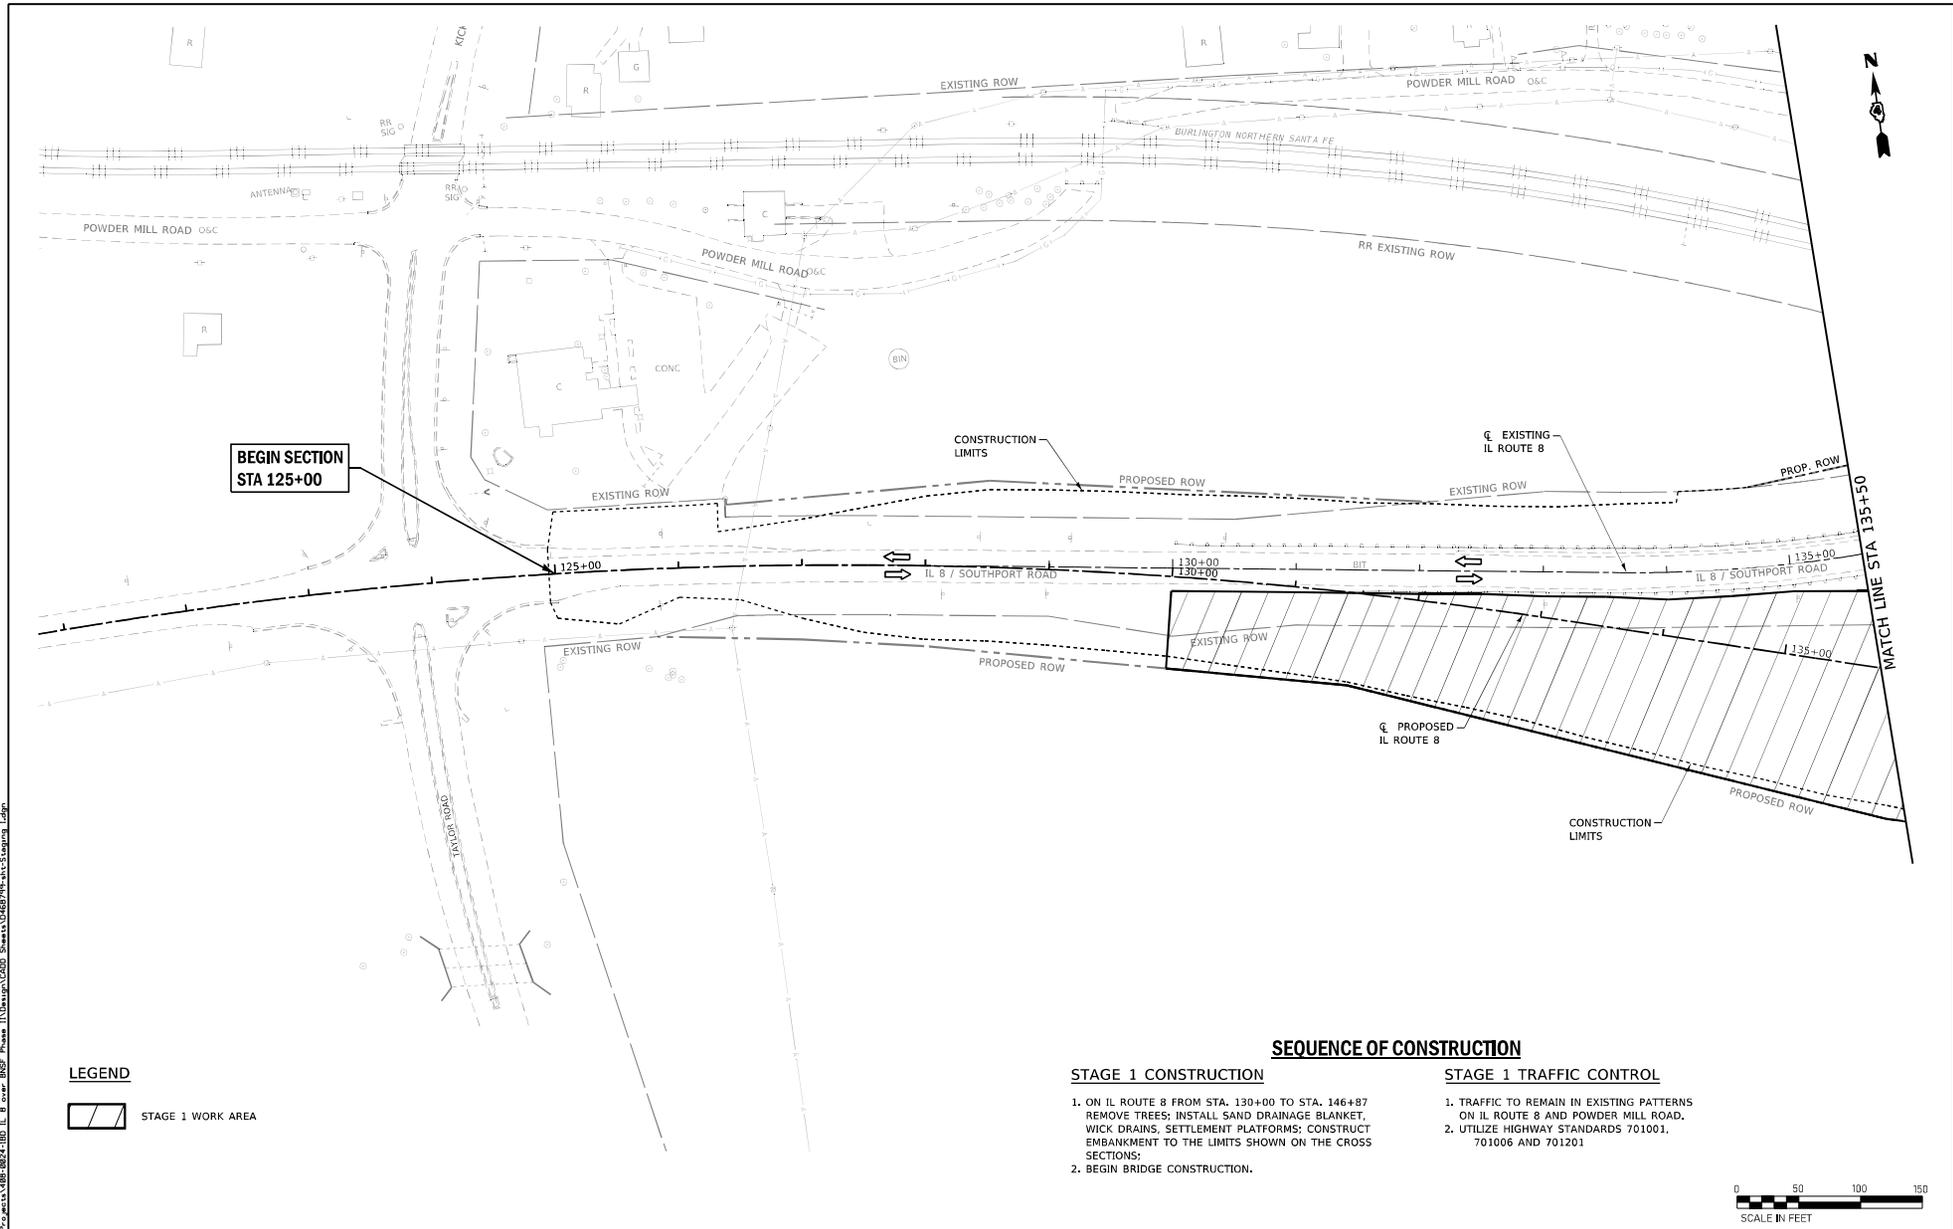

**BEGIN SECTION  
STA 125+00**



**LEGEND**

STAGE 1 WORK AREA

**SEQUENCE OF CONSTRUCTION**

**STAGE 1 CONSTRUCTION**

1. ON IL ROUTE 8 FROM STA. 130+00 TO STA. 146+87 REMOVE TREES; INSTALL SAND DRAINAGE BLANKET, WICK DRAINS, SETTLEMENT PLATFORMS; CONSTRUCT EMBANKMENT TO THE LIMITS SHOWN ON THE CROSS SECTIONS;
2. BEGIN BRIDGE CONSTRUCTION.

**STAGE 1 TRAFFIC CONTROL**

1. TRAFFIC TO REMAIN IN EXISTING PATTERNS ON IL ROUTE 8 AND POWDER MILL ROAD.
2. UTILIZE HIGHWAY STANDARDS 701001, 701006 AND 701201



USER NAME	• Betsy	DESIGNED	- JLS	REVISED	-
MODEL NAME	• 01 Stage 1	DRAWN	- PDB	REVISED	-
PLOT SCALE	• 100,0000"/PL	CHECKED	- ESW	REVISED	-
PLOT DATE	• 8/22/2019	DATE	- 01-17-18	REVISED	-


**STATE OF ILLINOIS  
DEPARTMENT OF TRANSPORTATION**

**MAINTENANCE OF TRAFFIC - STAGE 1 PLAN SHEETS  
IL ROUTE 8**

SCALE: 1"=50'    SHEET 1 OF 3 SHEETS

F.A.S. SITE	SECTION	COUNTY	TOTAL SHEETS	SHEET NO.
1388	(2-1VB)BR-2	PEORIA	235	44
				CONTRACT NO. 68799
ILLINOIS   FED. AID PROJECT				

FILE NAME: S:\Projects\11488-024-001\_IL\_8\_mvt\_BNSF\_Planes\11488\024\001\_Sheet11488\11488-024-001-Stage1-Plan.dwg

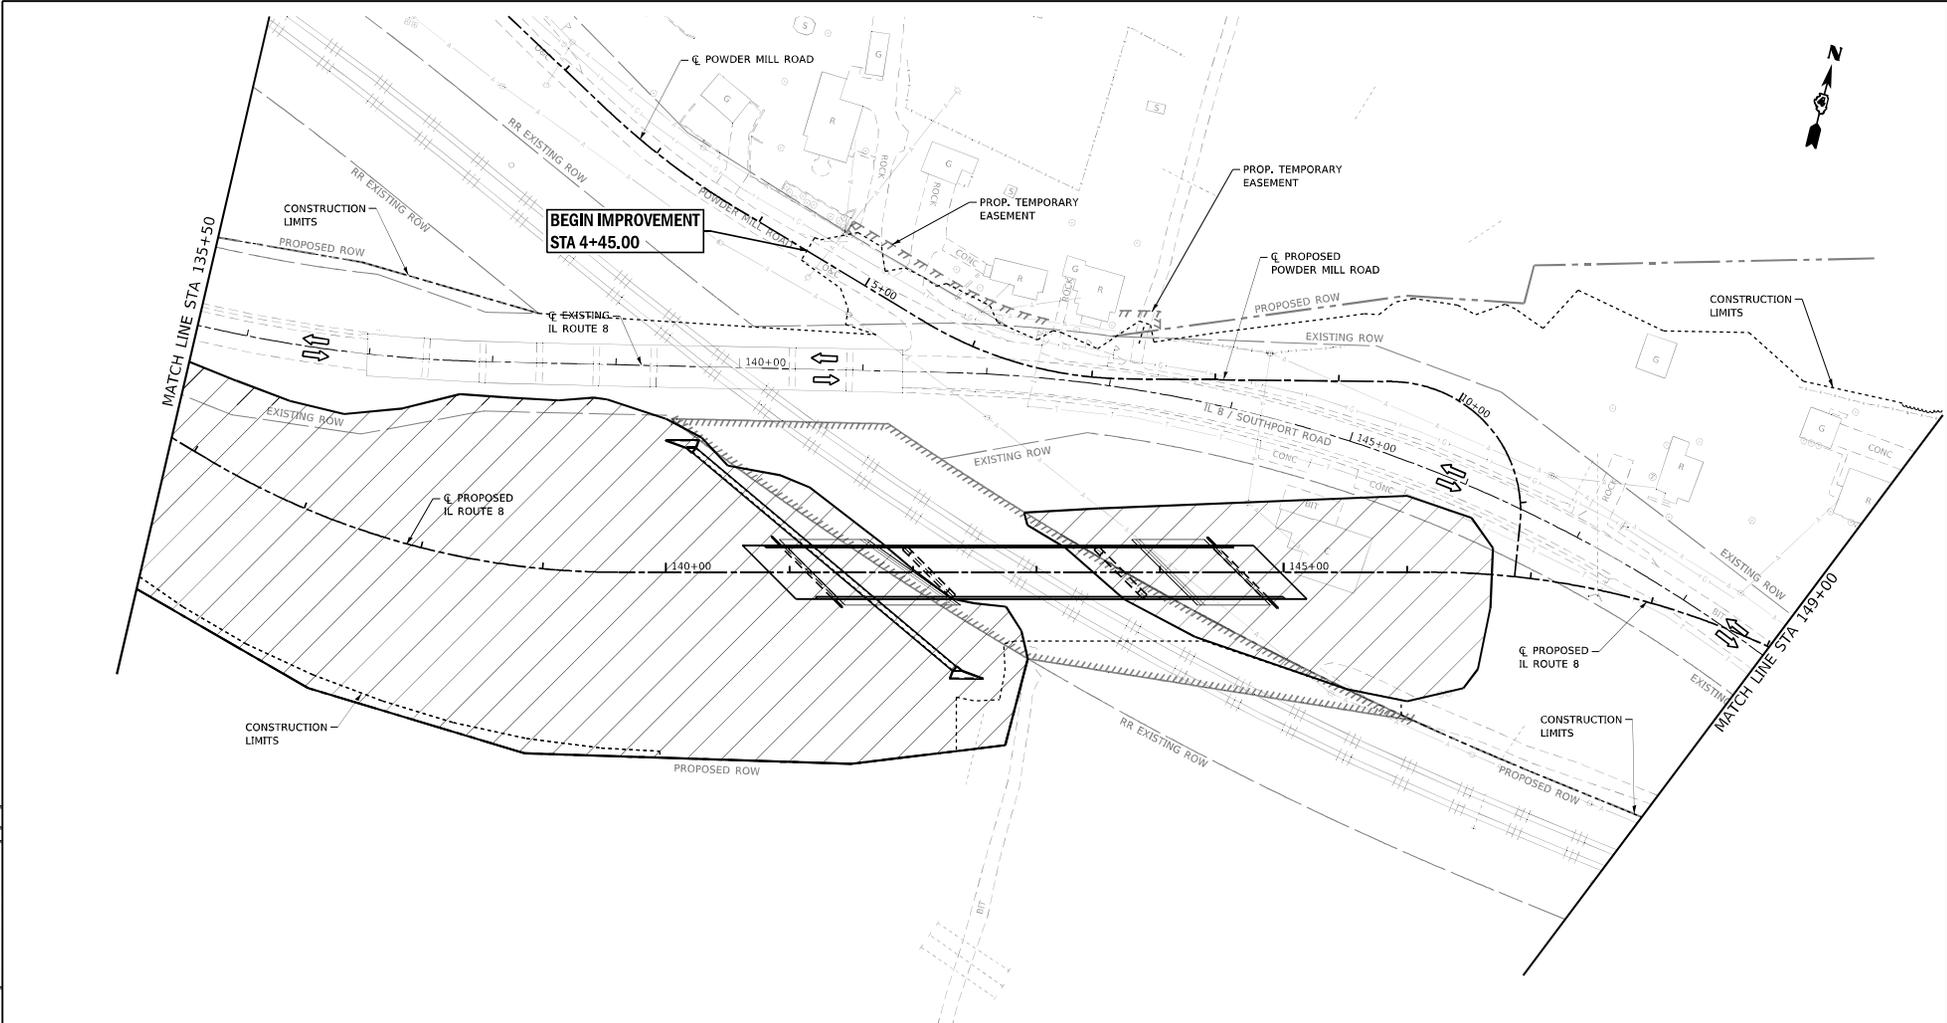

**LEGEND**

 STAGE 1 WORK AREA

**SEQUENCE OF CONSTRUCTION**

- |  |   |
|--|---|
| <p><b>STAGE 1 CONSTRUCTION</b></p> <ol style="list-style-type: none"> <li>ON IL ROUTE 8 FROM STA. 130+00 TO STA. 146+87 REMOVE TREES; INSTALL SAND DRAINAGE BLANKET, WICK DRAINS, SETTLEMENT PLATFORMS; CONSTRUCT EMBANKMENT TO THE LIMITS SHOWN ON THE CROSS SECTIONS;</li> <li>BEGIN BRIDGE CONSTRUCTION.</li> </ol> | <p><b>STAGE 1 TRAFFIC CONTROL</b></p> <ol style="list-style-type: none"> <li>TRAFFIC TO REMAIN IN EXISTING PATTERNS ON IL ROUTE 8 AND POWDER MILL ROAD.</li> <li>UTILIZE HIGHWAY STANDARDS 701001, 701006 AND 701201</li> </ol> |
|--|---|




USER NAME	• Betsy	DESIGNED	- JLS	REVISED	-
MODEL NAME	• 02 Stage 1	DRAWN	- PDB	REVISED	-
PLOT SCALE	• 100,0000"/PL	CHECKED	- ESW	REVISED	-
PLOT DATE	• 8/22/2019	DATE	- 01-17-18	REVISED	-

**STATE OF ILLINOIS  
DEPARTMENT OF TRANSPORTATION**

**MAINTENANCE OF TRAFFIC - STAGE 1 PLAN SHEETS  
IL ROUTE 8**

SCALE: 1"=50'    SHEET 2 OF 3 SHEETS

F.A.S. SITE	SECTION	COUNTY	TOTAL SHEETS	SHEET NO.
1388	(2-1V8)BR-2	PEORIA	235	45
CONTRACT NO. 68799				
ILLINOIS FED. AID PROJECT				

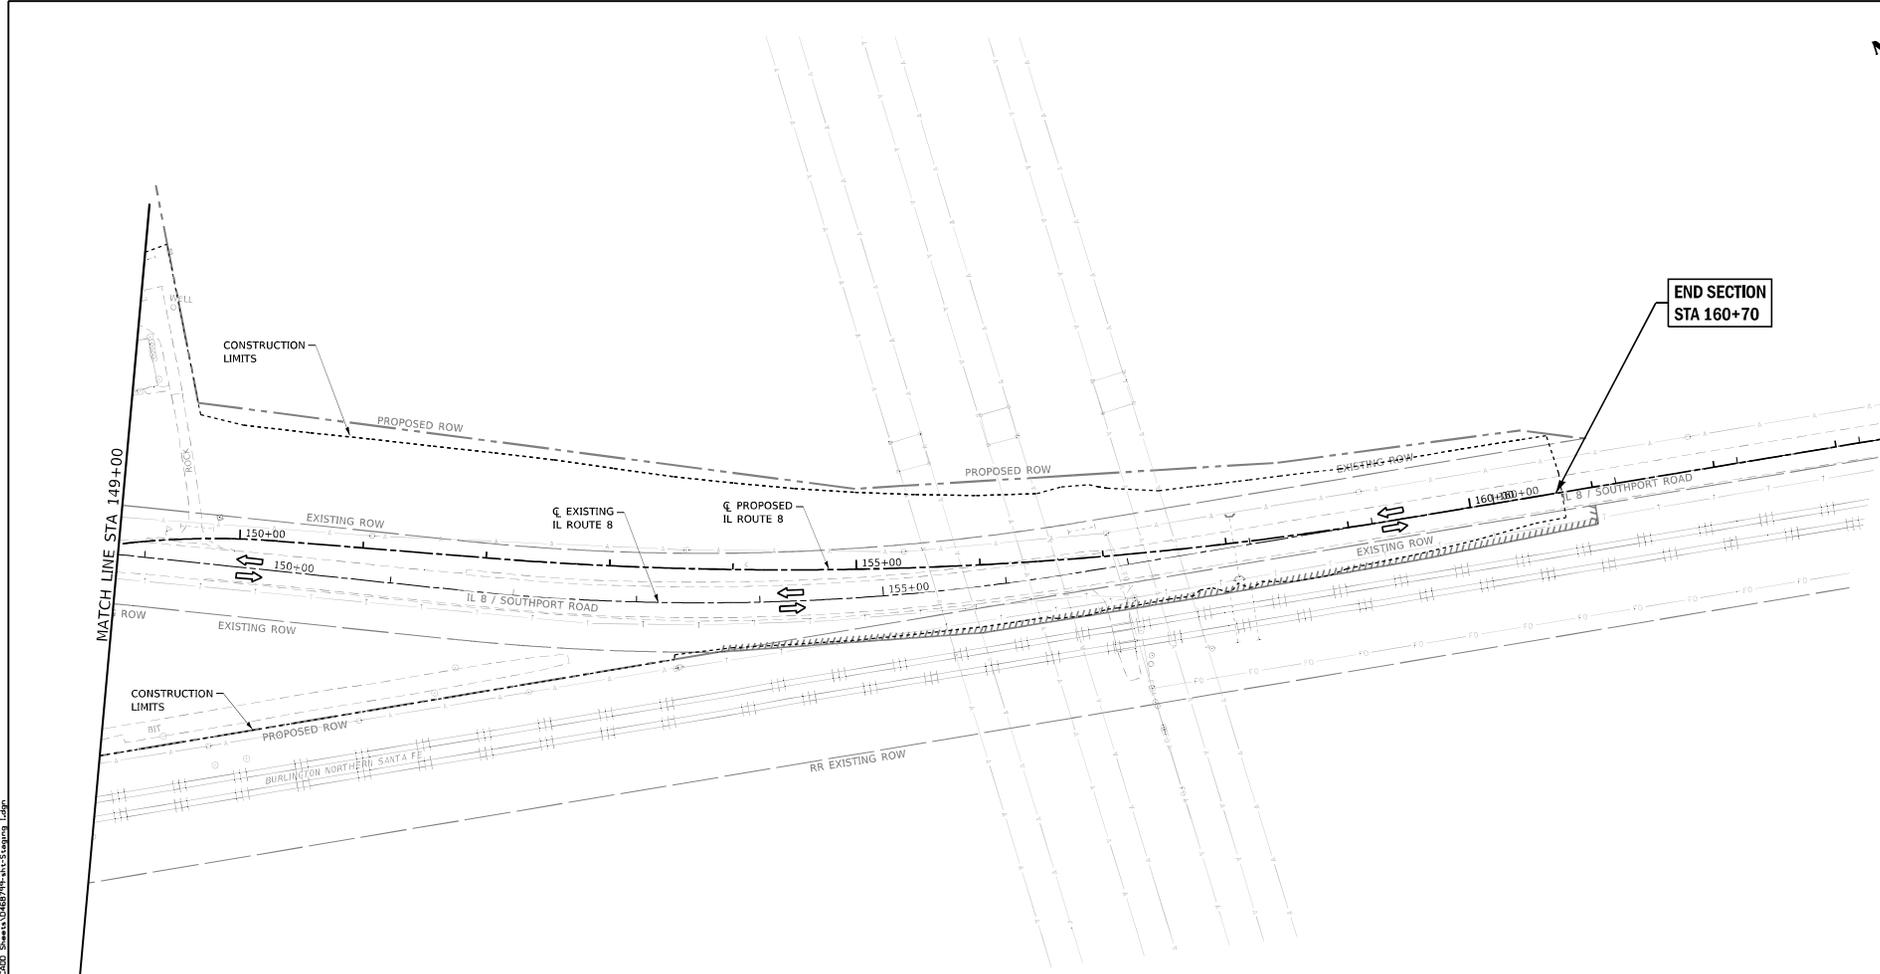

**END SECTION  
STA 160+70**

**LEGEND**

 STAGE 1 WORK AREA


**SEQUENCE OF CONSTRUCTION**

**STAGE 1 CONSTRUCTION**

- ON IL ROUTE 8 FROM STA. 130+00 TO STA. 146+87 REMOVE TREES; INSTALL SAND DRAINAGE BLANKET, WICK DRAINS, SETTLEMENT PLATFORMS; CONSTRUCT EMBANKMENT TO THE LIMITS SHOWN ON THE CROSS SECTIONS;
- BEGIN BRIDGE CONSTRUCTION.

**STAGE 1 TRAFFIC CONTROL**

- TRAFFIC TO REMAIN IN EXISTING PATTERNS ON IL ROUTE 8 AND POWDER MILL ROAD.
- UTILIZE HIGHWAY STANDARDS 701001, 701006 AND 701201

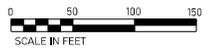

FILE NAME: S:\Projects\1188-024-002\_IL\_8\_mvt\_BNF\_Plan\1188024-002\_Sheet1.dwg User: JLM Date: 11/15/18



USER NAME	• Betsy
MODEL NAME	• 03 Stage 1
PLOT SCALE	• 100,0000"/PL
PLOT DATE	• 8/22/2019

DESIGNED	- JLS	REVISED	-
DRAWN	- PDB	REVISED	-
CHECKED	- ESW	REVISED	-
DATE	- 01-17-18	REVISED	-


**STATE OF ILLINOIS  
DEPARTMENT OF TRANSPORTATION**

**MAINTENANCE OF TRAFFIC - STAGE 1 PLAN SHEETS  
IL ROUTE 8**

SCALE: 1"=50' SHEET 3 OF 3 SHEETS

F.A.S. SITE	SECTION	COUNTY	TOTAL SHEETS	SHEET NO.
1388	(2-1VB)BR-2	PEORIA	235	46
CONTRACT NO. 68799				
ILLINOIS FED. AID PROJECT				

FILE NAME: S:\Projects\1188-024-IBD\_IL\_8\_mtr\_BNF\_Phase II\Output\000 Sheets\0469799.mxd;Drawing: I11g

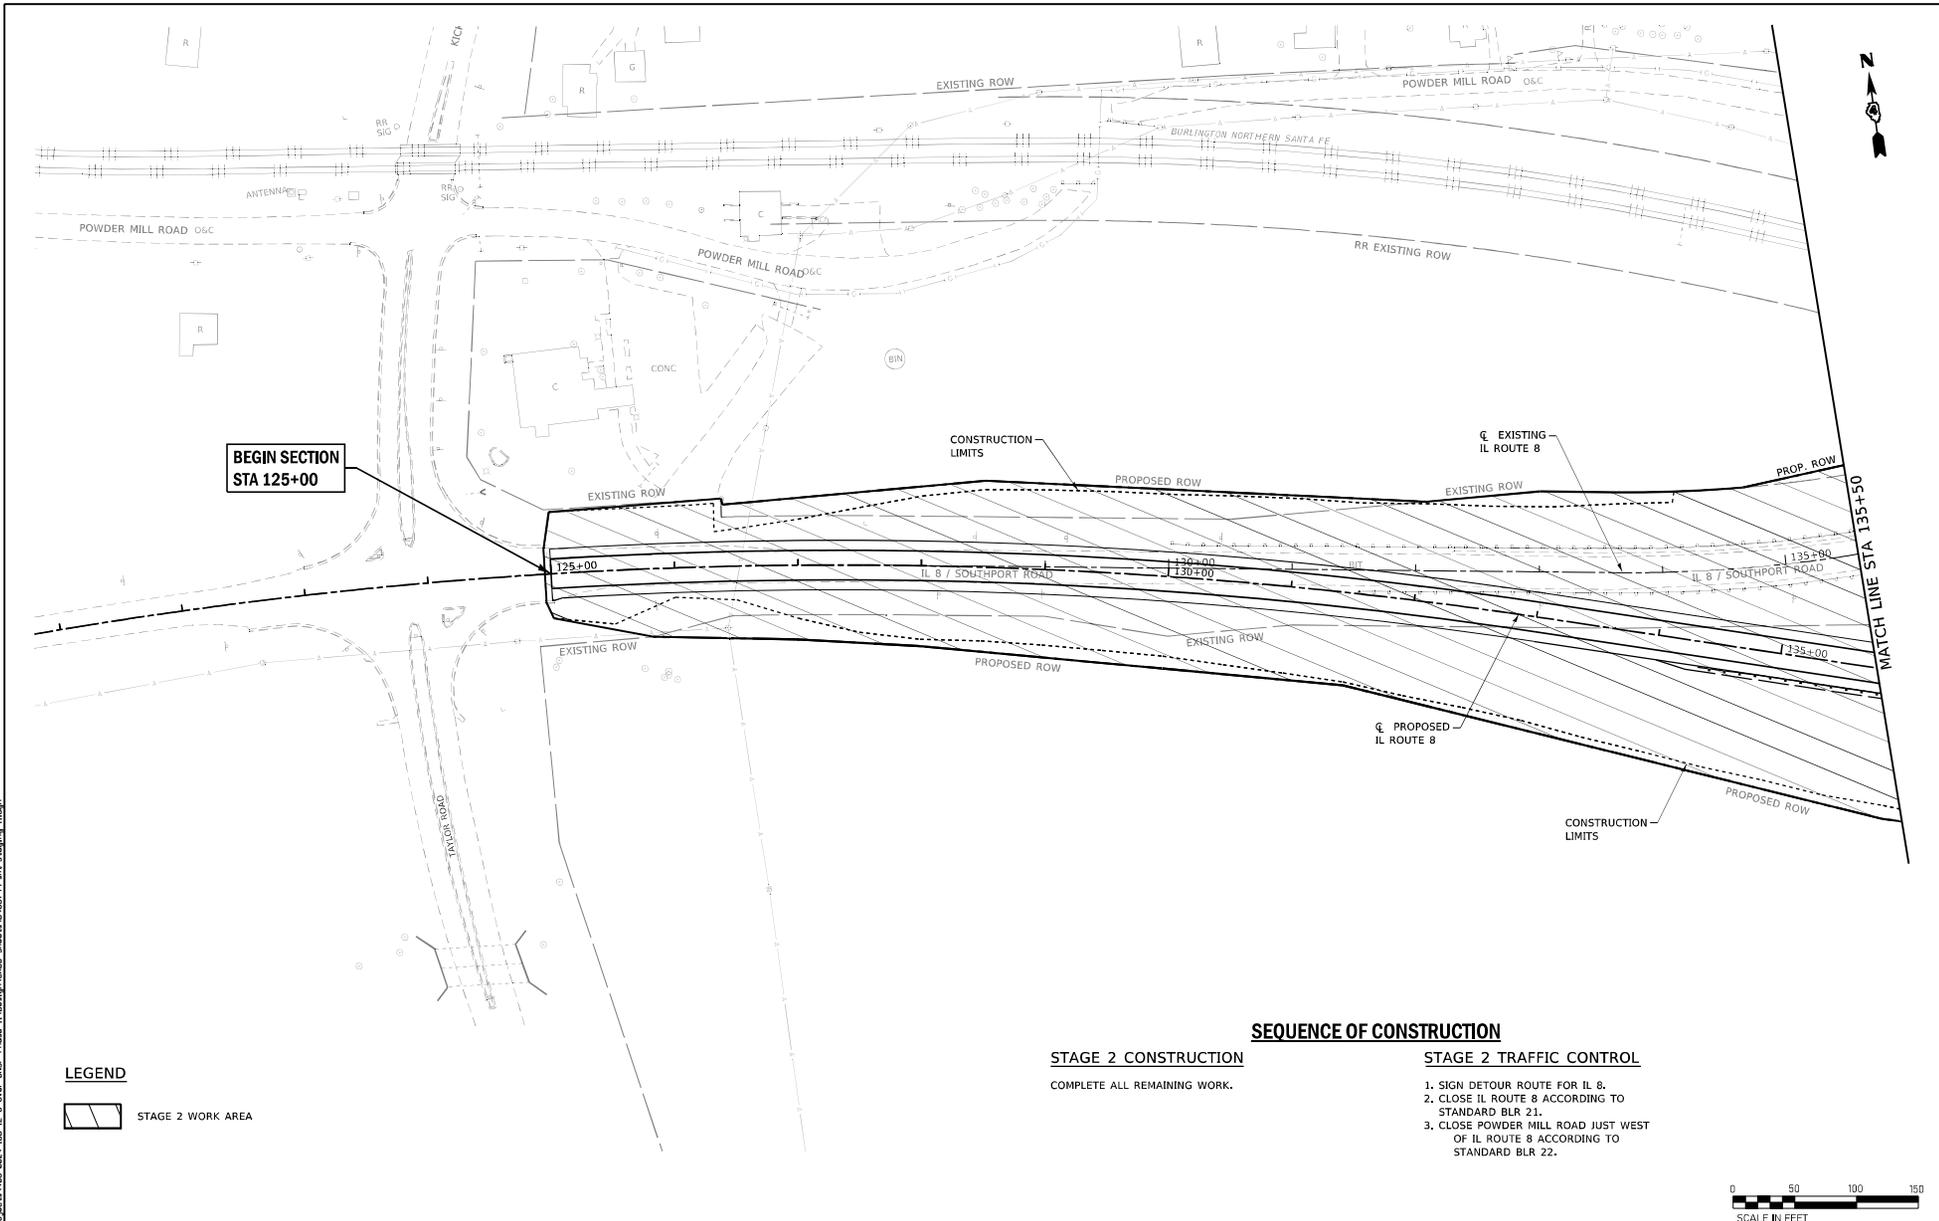

**BEGIN SECTION  
STA 125+00**



**MATCH LINE STA 135+50**

**LEGEND**



STAGE 2 WORK AREA

**SEQUENCE OF CONSTRUCTION**

**STAGE 2 CONSTRUCTION**

COMPLETE ALL REMAINING WORK.

**STAGE 2 TRAFFIC CONTROL**

1. SIGN DETOUR ROUTE FOR IL 8.
2. CLOSE IL ROUTE 8 ACCORDING TO STANDARD BLR 21.
3. CLOSE POWDER MILL ROAD JUST WEST OF IL ROUTE 8 ACCORDING TO STANDARD BLR 22.



USER NAME	• Betsy	DESIGNED	- JLS	REVISED	-
MODEL NAME	• 01 Stage 2	DRAWN	- PDB	REVISED	-
PLOT SCALE	• 100.0000"/ft.	CHECKED	- ESW	REVISED	-
PLOT DATE	• 8/22/2019	DATE	- 01-17-18	REVISED	-


**STATE OF ILLINOIS  
DEPARTMENT OF TRANSPORTATION**

**MAINTENANCE OF TRAFFIC - STAGE 2 PLAN SHEETS  
IL ROUTE 8**

SCALE: 1"=50' SHEET 1 OF 3 SHEETS

F.A.S. SITE:	SECTION	COUNTY	TOTAL SHEETS	SHEET NO.
1388	(Z-1VB)BR-2	PEORIA	235	47
CONTRACT NO. 68799				
ILLINOIS FED. AID PROJECT				

FILE NAME: S:\Projects\11488-02-IL-8-over-BNSF Phase 1\Drawings\02D Sheets\0168799-11488-02-IL-8-over-BNSF-11.dgn

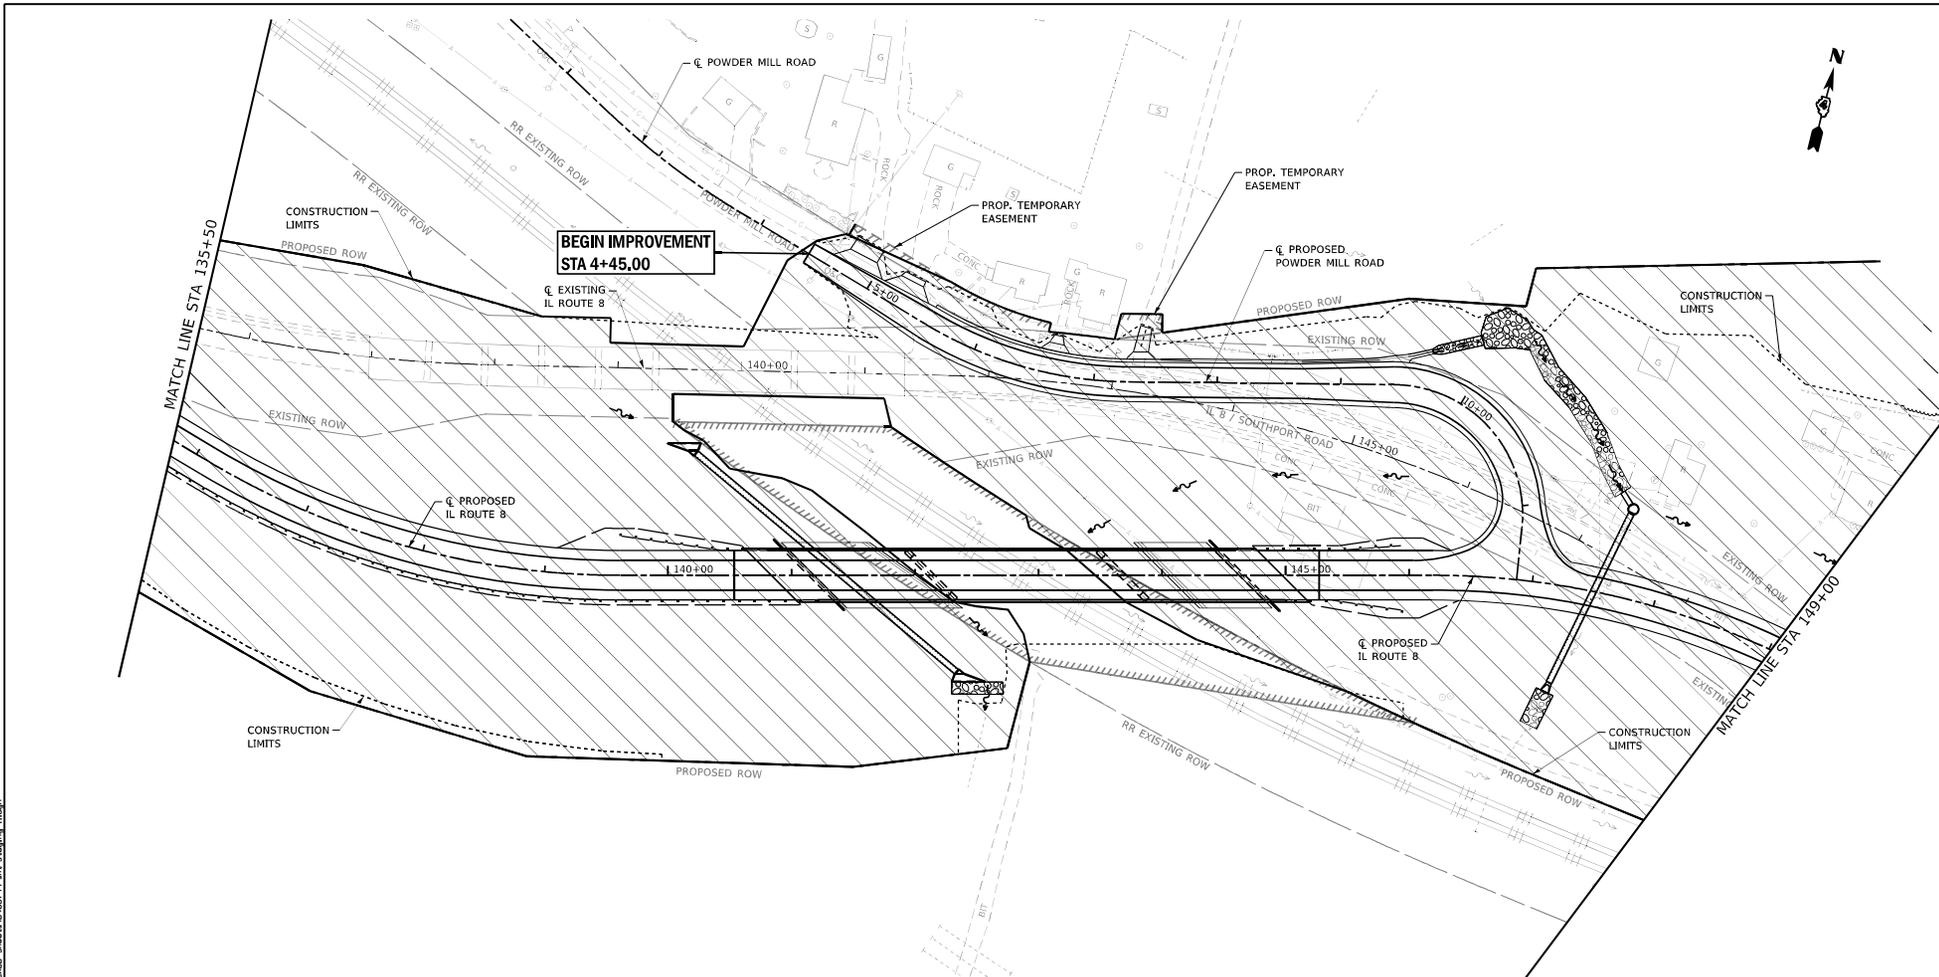


**LEGEND**

STAGE 2 WORK AREA

**SEQUENCE OF CONSTRUCTION**

**STAGE 2 CONSTRUCTION**  
COMPLETE ALL REMAINING WORK.

**STAGE 2 TRAFFIC CONTROL**  
 1. SIGN DETOUR ROUTE FOR IL 8.  
 2. CLOSE IL ROUTE 8 ACCORDING TO STANDARD BLR 21.  
 3. CLOSE POWDER MILL ROAD JUST WEST OF IL ROUTE 8 ACCORDING TO STANDARD BLR 22.

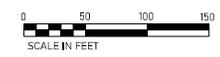

USER NAME	• Betsy	DESIGNED	- JLS	REVISED	-
MODEL NAME	• 02 Stage 2	DRAWN	- PDB	REVISED	-
PLOT SCALE	• 100,0000"/PL	CHECKED	- ESW	REVISED	-
PLOT DATE	• 8/22/2019	DATE	- 01-17-18	REVISED	-

**STATE OF ILLINOIS  
DEPARTMENT OF TRANSPORTATION**


**MAINTENANCE OF TRAFFIC - STAGE 2 PLAN SHEETS  
IL ROUTE 8**

SCALE: 1"=50'    SHEET 2 OF 3 SHEETS

F.A.S. SITE	SECTION	COUNTY	TOTAL SHEETS	SHEET NO.
1388	(2-1V8)BR-2	PEORIA	235	48
				CONTRACT NO. 68799
ILLINOIS   FED. AID PROJECT				



**END SECTION  
STA 160+70**

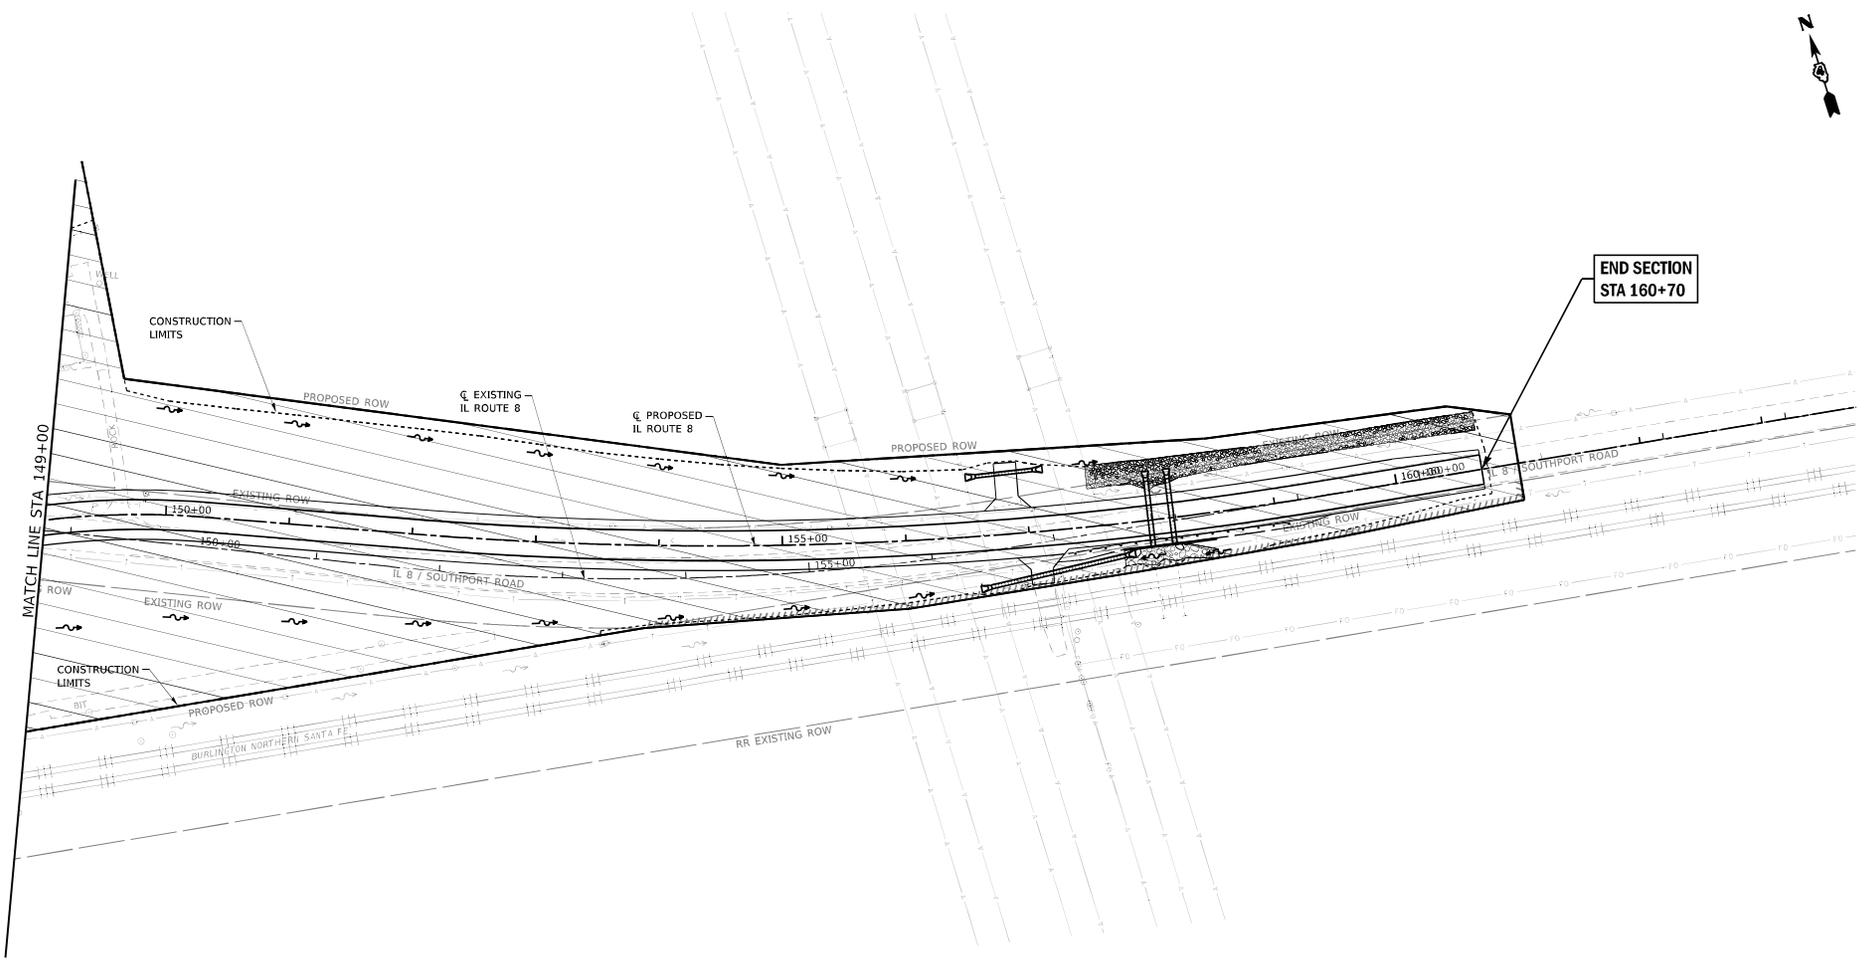

**LEGEND**

 STAGE 2 WORK AREA


**SEQUENCE OF CONSTRUCTION**

**STAGE 2 CONSTRUCTION**

COMPLETE ALL REMAINING WORK.

**STAGE 2 TRAFFIC CONTROL**

1. SIGN DETOUR ROUTE FOR IL 8.
2. CLOSE IL ROUTE 8 ACCORDING TO STANDARD BLR 21.
3. CLOSE POWDER MILL ROAD JUST WEST OF IL ROUTE 8 ACCORDING TO STANDARD BLR 22.

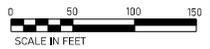

FILE NAME: S:\Projects\1188-024-001\_IL\_8\_mvt\_BNF Phase II\Output\000 Sheets\0168799.mxd; Date: 08/22/09



USER NAME	• Betsy
MODEL NAME	• 03 Stage 2
PLOT SCALE	• 100,0000"/PL
PLOT DATE	• 8/22/09


DESIGNED	- JLS	REVISED	-
DRAWN	- PDB	REVISED	-
CHECKED	- ESW	REVISED	-
DATE	- 01-17-08	REVISED	-

**STATE OF ILLINOIS  
DEPARTMENT OF TRANSPORTATION**

**MAINTENANCE OF TRAFFIC - STAGE 2 PLAN SHEETS  
IL ROUTE 8**

SCALE: 1"=50' SHEET 3 OF 3 SHEETS

F.A.S. SITE	SECTION	COUNTY	TOTAL SHEETS	SHEET NO.
1388	(2-1VB)BR-2	PEORIA	235	49
CONTRACT NO. 68799				
ILLINOIS FED. AID PROJECT				

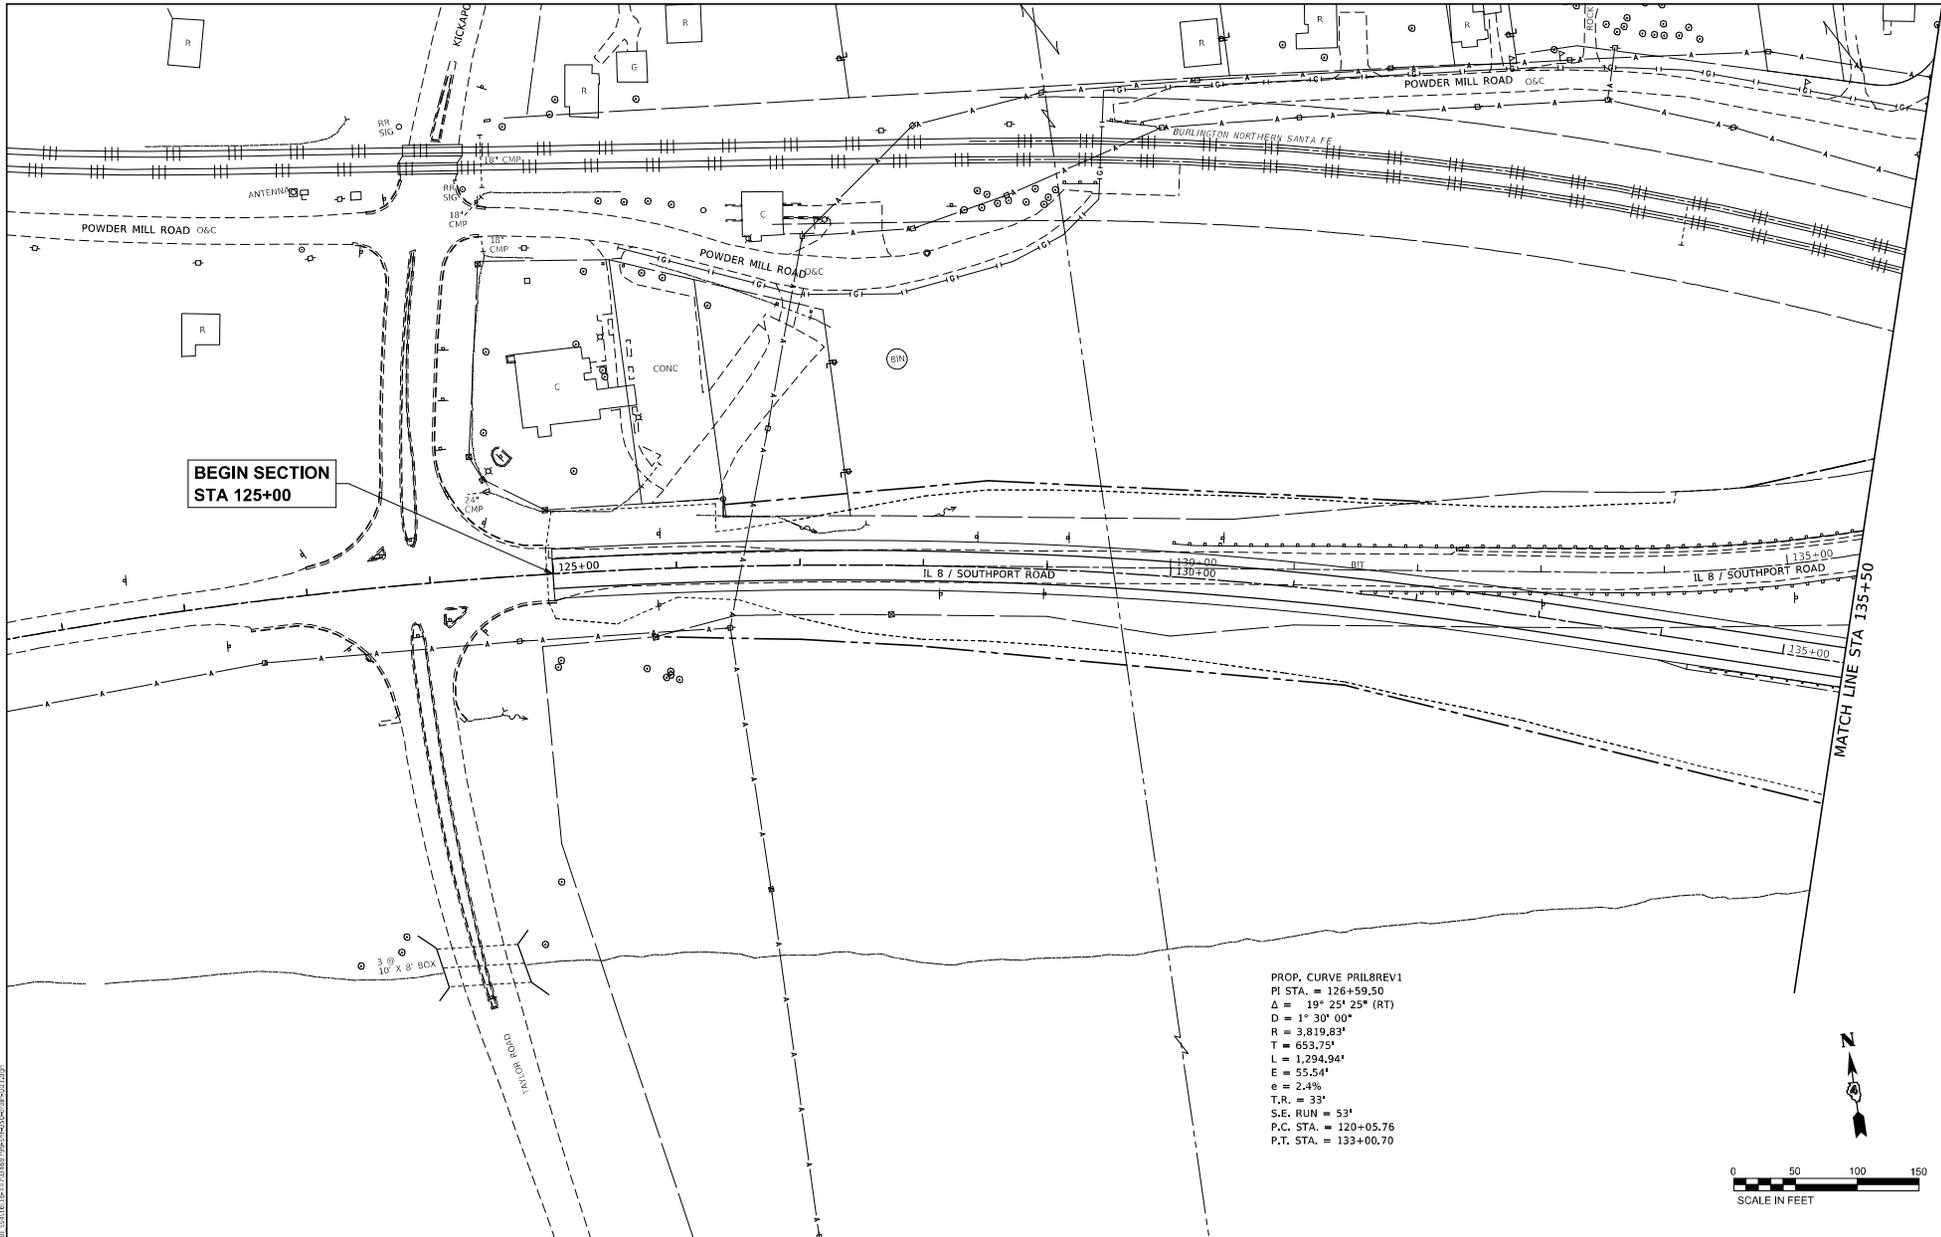

BEGIN SECTION  
STA 125+00

PROP. CURVE PR18REV1  
 PI STA. = 126+59.50  
 $\Delta = 19^{\circ} 25' 25''$  (RT)  
 $D = 1^{\circ} 30' 00''$   
 $R = 3,819.83'$   
 $T = 653.75'$   
 $L = 1,294.94'$   
 $E = 55.54'$   
 $e = 2.4\%$   
 $T.A. = 33'$   
 $S.E. RUN = 53'$   
 $P.C. STA. = 120+05.76$   
 $P.T. STA. = 133+00.70$



**FEHR GRAHAM**  
 ENGINEERING & ENVIRONMENTAL  
 ILLINOIS DESIGN FIRM NO. 04-003525

USER NAME = ccorroy	DESIGNED = MCB	REVISED =
PLOT SCALE = 1/8"=100'-0"	DRAWN = CFC	REVISED =
PLOT DATE = 6/22/2019	CHECKED = MCB	REVISED =
	DATE =	REVISED =


STATE OF ILLINOIS  
 DEPARTMENT OF TRANSPORTATION

DRAINAGE PLAN SHEETS  
 IL ROUTE 8

SCALE:	SHEET 1	OF 3	SHEETS	STA. 121+50	TO STA. 135+50
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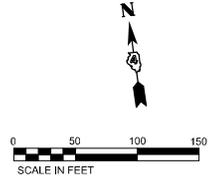
F.A.S. SITE	SECTION	COUNTY	TOTAL SHEETS	SHEET NO.
1388	(7-1VB)BR-2	PEORIA	235	50
CONTRACT NO. 68799				
ILLINOIS FED. AID PROJECT				

FEHR GRAHAM PROJECT NUMBER: 16-447

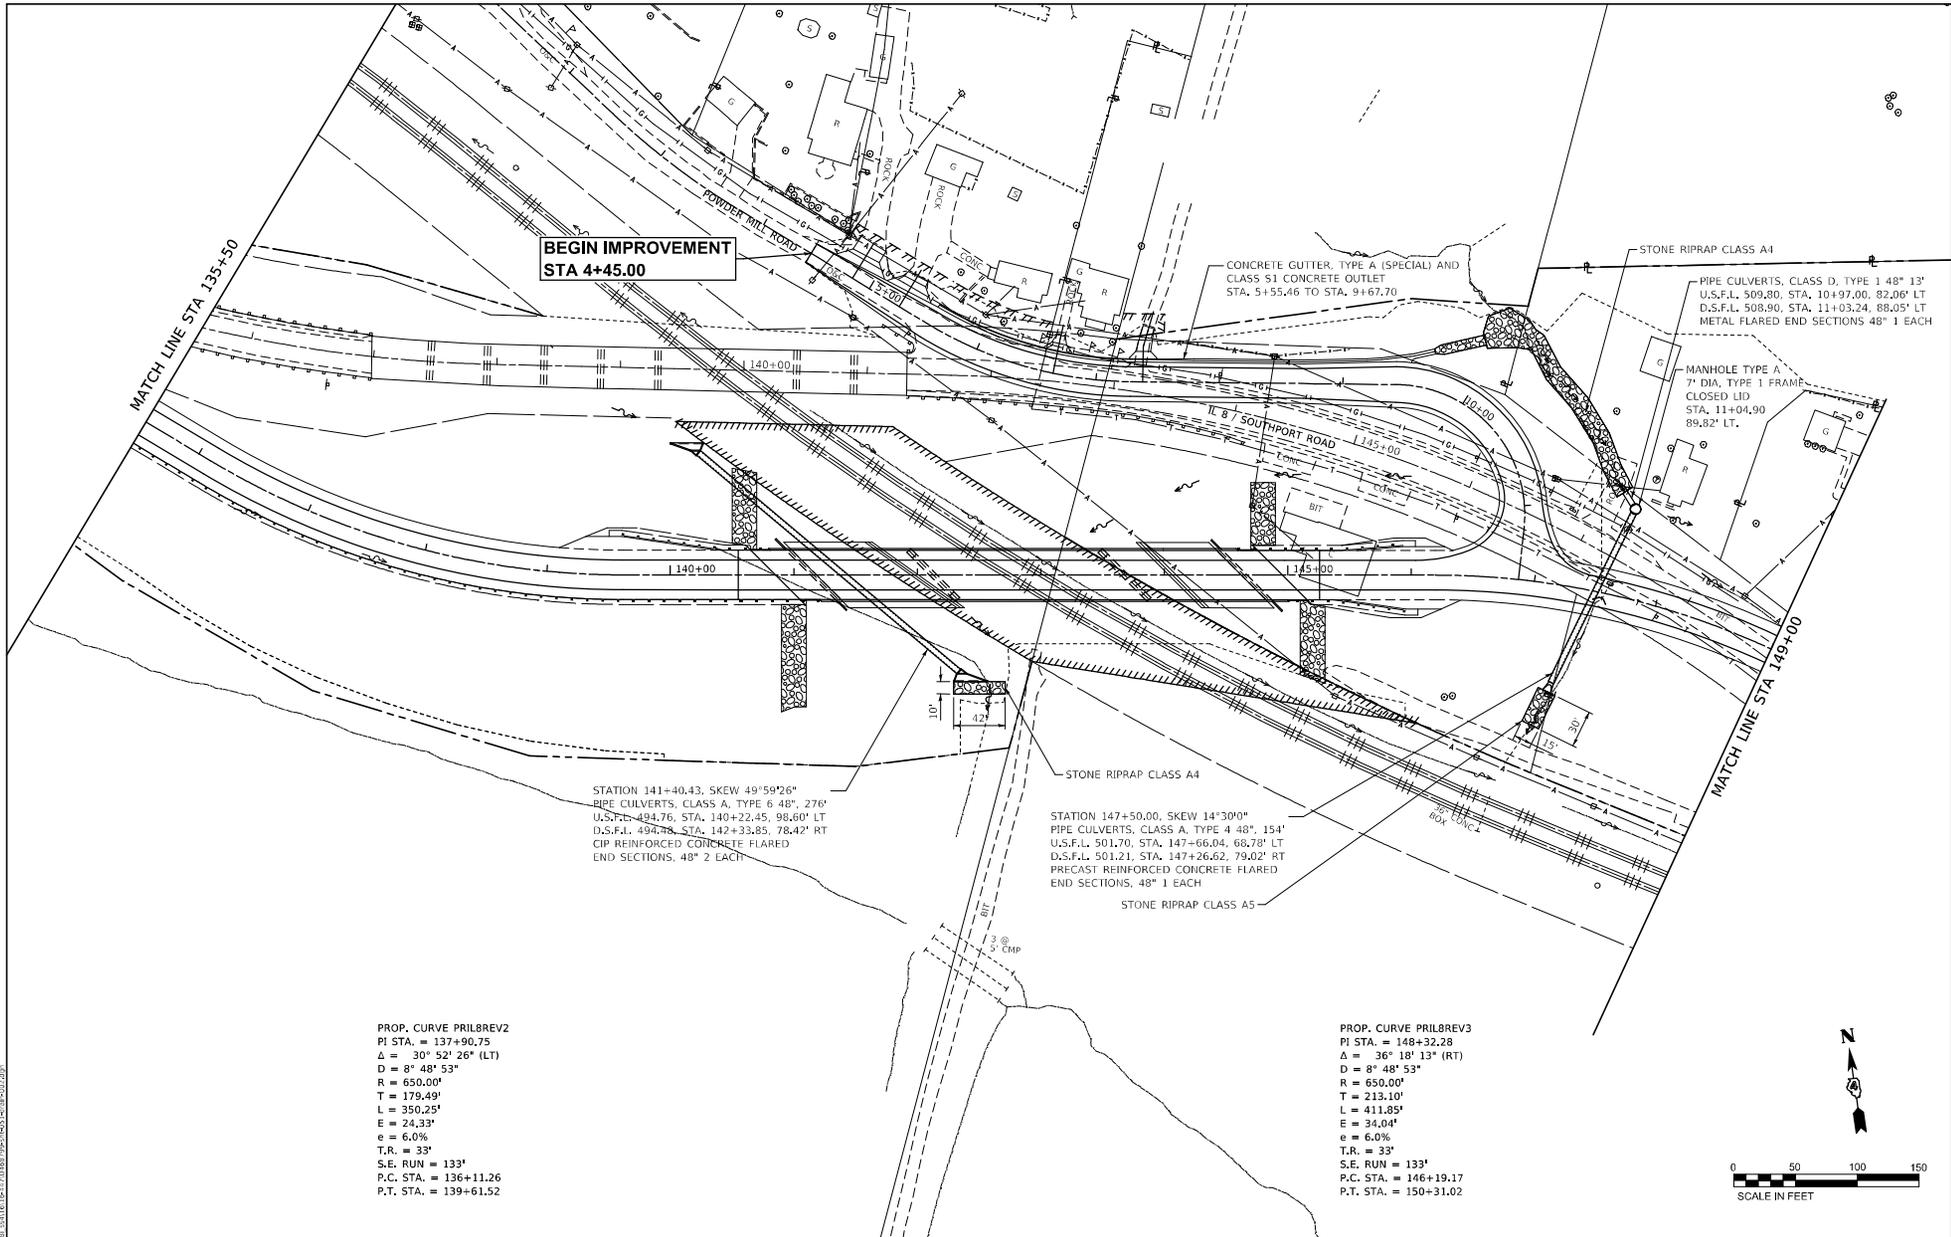

PROP. CURVE PRIL8REV2  
 PI STA. = 137+90.75  
 $\Delta = 30^\circ 52' 26''$  (LT)  
 $D = 8^\circ 48' 53''$   
 $R = 650.00'$   
 $T = 179.49'$   
 $L = 350.25'$   
 $E = 24.33'$   
 $e = 6.0\%$   
 $T.R. = 33'$   
 $S.E. RUN = 133'$   
 $P.C. STA. = 136+11.26$   
 $P.T. STA. = 139+61.52$

PROP. CURVE PRIL8REV3  
 PI STA. = 148+32.28  
 $\Delta = 36^\circ 18' 13''$  (RT)  
 $D = 8^\circ 48' 53''$   
 $R = 650.00'$   
 $T = 213.10'$   
 $L = 411.85'$   
 $E = 34.04'$   
 $e = 6.0\%$   
 $T.R. = 33'$   
 $S.E. RUN = 133'$   
 $P.C. STA. = 146+19.17$   
 $P.T. STA. = 150+31.02$



**FEHR GRAHAM**  
 ENGINEERING & ENVIRONMENTAL  
 ILLINOIS DESIGN FIRM NO. 04-003525

USER NAME = cccorner	DESIGNED = MCB	REVISED =
DRAWN =	CHECKED = MCB	REVISED =
PLOT SCALE = 1/8"=1'-0"	DATE =	REVISED =
PLOT DATE = 8/22/2019		

STATE OF ILLINOIS  
 DEPARTMENT OF TRANSPORTATION

DRAINAGE PLAN SHEETS  
 IL ROUTE 8


SCALE:	SHEET 2	OF 3	SHEETS	STA. 135+50	TO STA. 149+00
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F.A.S. SITE = 138B	SECTION = (7-1VB)BR-2	COUNTY = PEORIA	TOTAL SHEETS = 235	SHEET NO. = 51
CONTRACT NO. 68799				ILLINOIS FED. AID PROJECT

MODEL: DRAINAGE  
 FILE NAME: I:\GIS\PROJECTS\138B\7-1VB\BR-2\DRN\138B7-1VBR-2.DWG

FEHR GRAHAM PROJECT NUMBER: 16-447



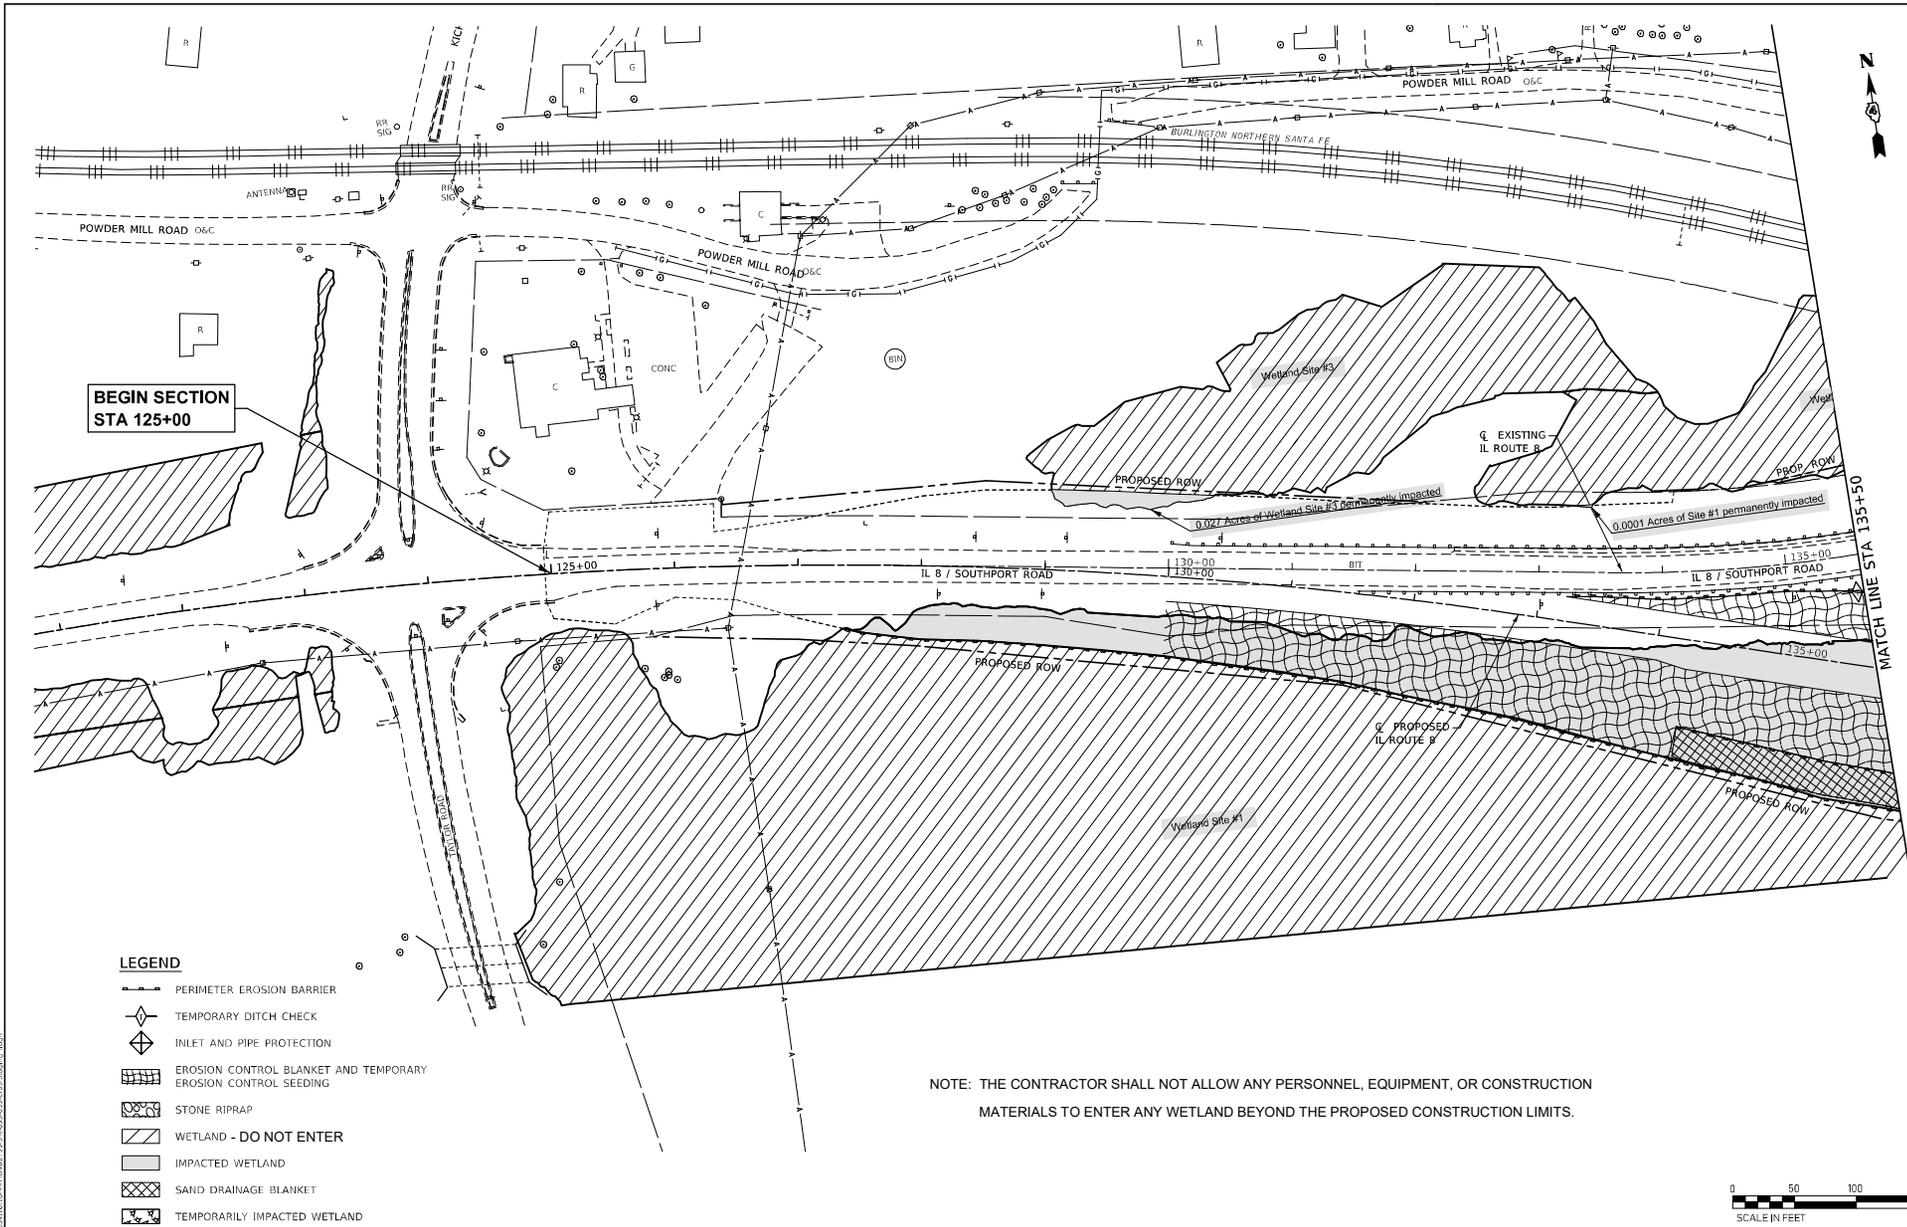

BEGIN SECTION  
STA 125+00



**LEGEND**

- PERIMETER EROSION BARRIER
- TEMPORARY DITCH CHECK
- INLET AND PIPE PROTECTION
- EROSION CONTROL BLANKET AND TEMPORARY EROSION CONTROL SEEDING
- STONE RIPRAP
- WETLAND - DO NOT ENTER
- IMPACTED WETLAND
- SAND DRAINAGE BLANKET
- TEMPORARILY IMPACTED WETLAND

NOTE: THE CONTRACTOR SHALL NOT ALLOW ANY PERSONNEL, EQUIPMENT, OR CONSTRUCTION MATERIALS TO ENTER ANY WETLAND BEYOND THE PROPOSED CONSTRUCTION LIMITS.



**FEHR GRAHAM**  
ENGINEERING & ENVIRONMENTAL  
ILLINOIS DESIGN FIRM NO. 04-003525

USER NAME = ccorcor	DESIGNED - MCB	REVISED - KH (IDOT) 05/05/21
PLOT SCALE = 1/8"=100.0000' (1) in.	DRAWN - CFC	REVISED -
PLOT DATE = 6/22/2019	CHECKED - MCB	REVISED -
	DATE -	REVISED -

STATE OF ILLINOIS  
DEPARTMENT OF TRANSPORTATION

STAGE 1 EROSION CONTROL PLAN  
IL ROUTE 8

SCALE: 1"=50' SHEET 531 OF 3 SHEETS STA 121+50 TO STA 135+50

F.A.S. SITE: 138B	SECTION: (7-1VB)BR-2	COUNTY: PEORIA	TOTAL SHEETS: 235	SHEET NO.: 53
				CONTRACT NO. 68799
				ILLINOIS FED. AID PROJECT


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 FILE NAME: 0519...  
 FILE DATE: 6/22/2019 10:41:16 AM  
 PLOT DATE: 6/22/2019 10:41:16 AM  
 PLOT SCALE: 1/8"=100.0000' (1) in.  
 PLOT DATE: 6/22/2019

FEHR GRAHAM PROJECT NUMBER: 16-447





**END SECTION  
STA 160+70**

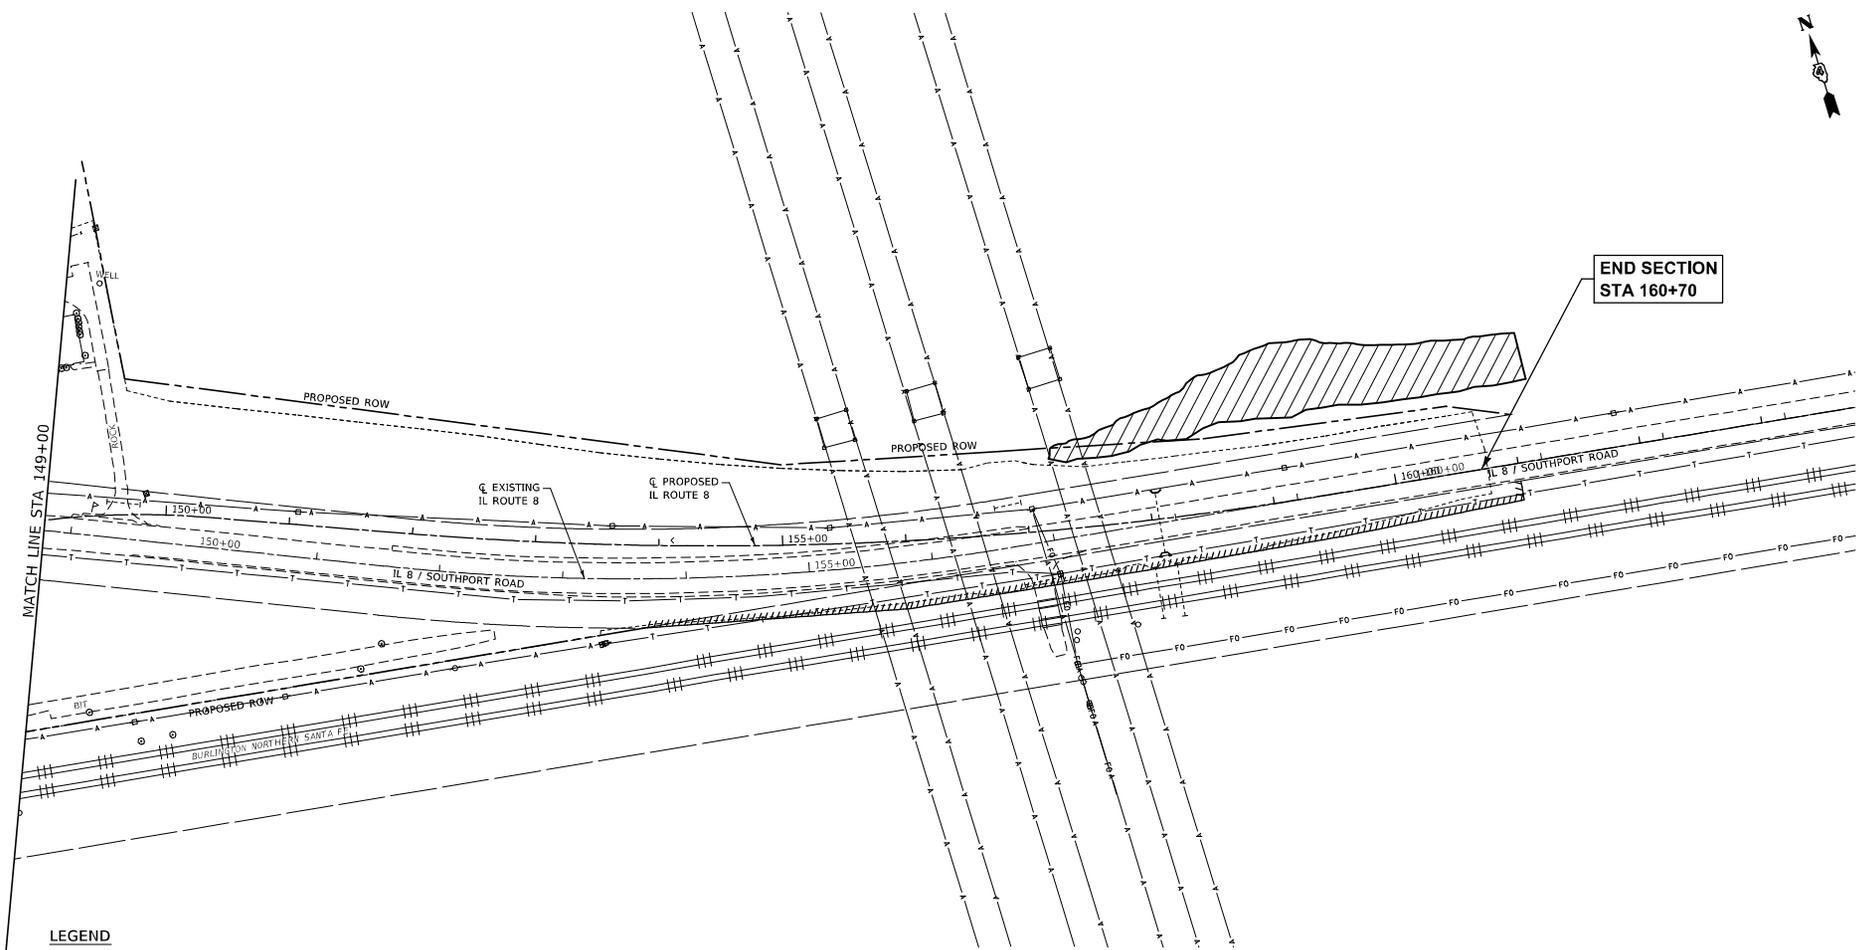

**LEGEND**

- PERIMETER EROSION BARRIER
- TEMPORARY DITCH CHECK
- INLET AND PIPE PROTECTION
- EROSION CONTROL BLANKET AND TEMPORARY EROSION CONTROL SEEDING
- STONE RIPRAP
- WETLAND - DO NOT ENTER
- IMPACTED WETLAND
- SAND DRAINAGE BLANKET
- TEMPORARILY IMPACTED WETLAND

NOTE: THE CONTRACTOR SHALL NOT ALLOW ANY PERSONNEL, EQUIPMENT, OR CONSTRUCTION MATERIALS TO ENTER ANY WETLAND BEYOND THE PROPOSED CONSTRUCTION LIMITS.



**FEHR GRAHAM**  
ENGINEERING & ENVIRONMENTAL  
ILLINOIS DESIGN FIRM NO. 04-003525

USER NAME = cccorner	DESIGNED = MCB	REVISED = KH (IDOT) 05/05/21
PLOT SCALE = 1/8"=100.0000' (1) in.	DRAWN = CFC	REVISED =
PLOT DATE = 6/22/2019	CHECKED = MCB	REVISED =
	DATE =	REVISED =

**STATE OF ILLINOIS  
DEPARTMENT OF TRANSPORTATION**

**STAGE 1 EROSION CONTROL PLAN  
IL ROUTE 8**

SCALE: 1"=50' SHEET 3 OF 3 SHEETS STA 149+00 TO STA 163+50

F.A.S. SITE = 138B	SECTION = (7-1VE)BR-2	COUNTY = PEORIA	TOTAL SHEETS = 235	SHEET NO. = 55
				CONTRACT NO. 68799
				ILLINOIS FED. AID PROJECT

FEHR GRAHAM PROJECT NUMBER: 16-447












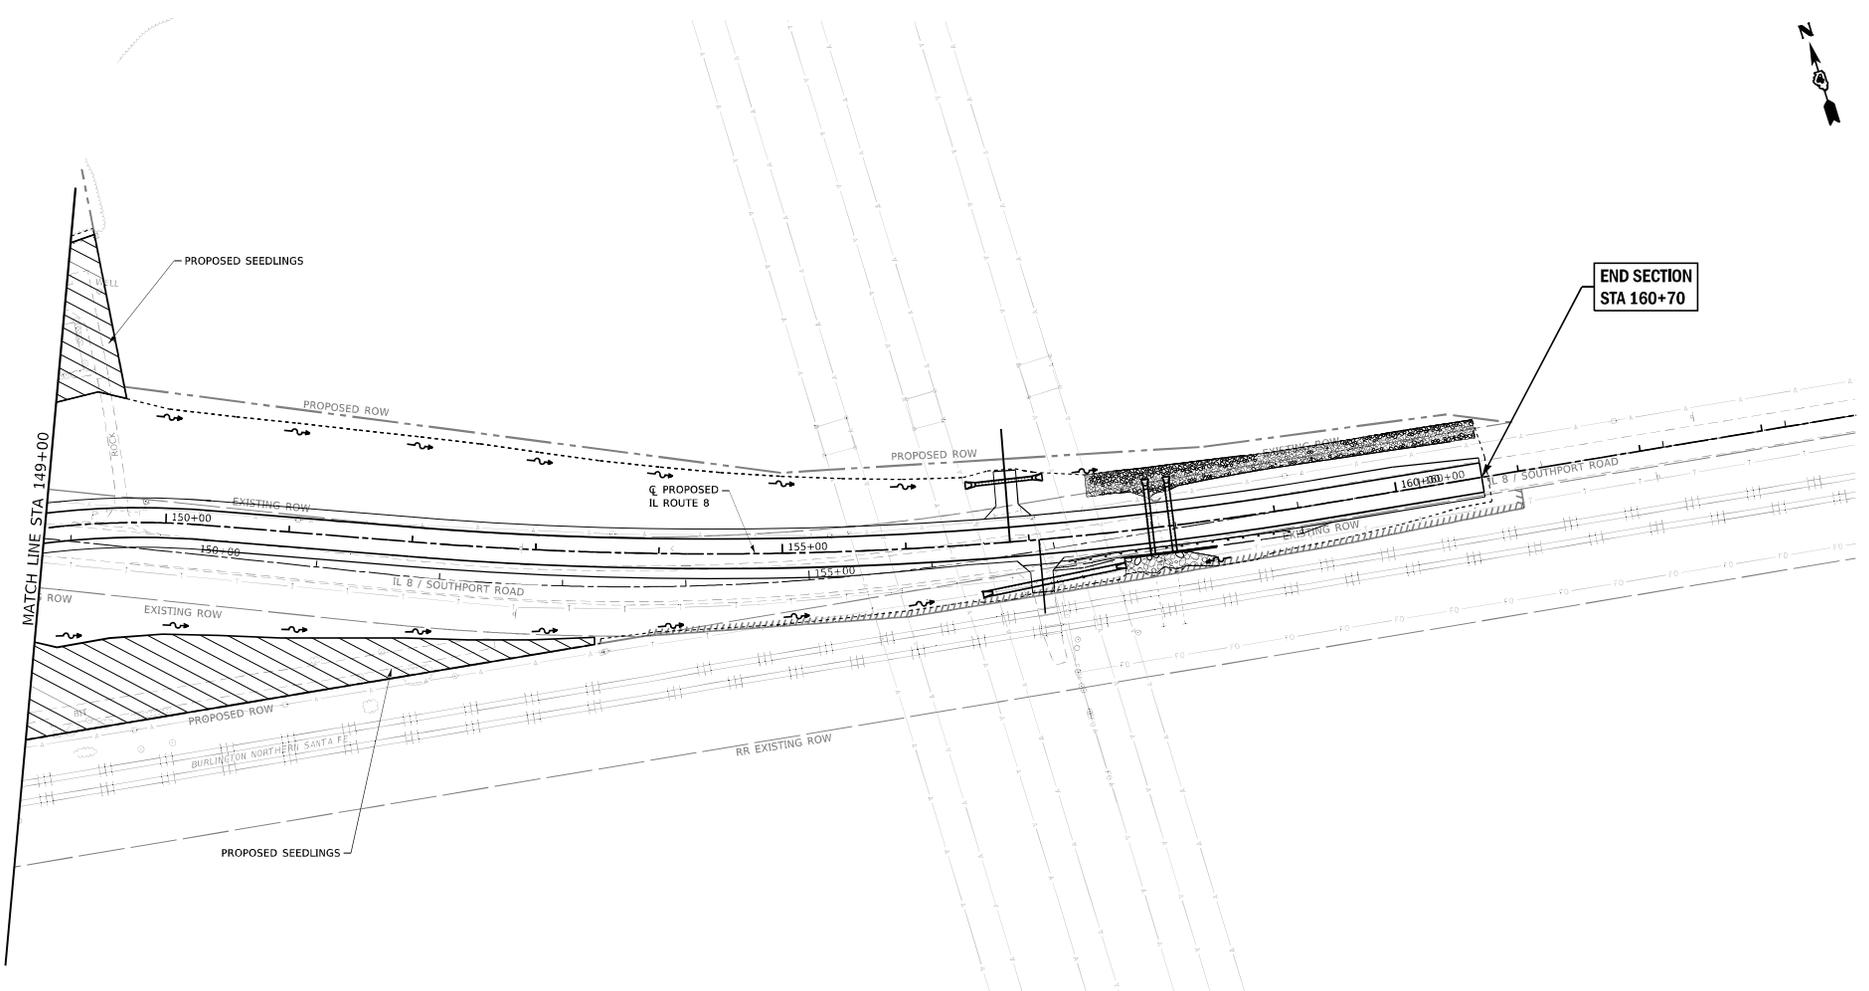


**END SECTION  
STA 160+70**

MATCH LINE STA 149+00

**LEGEND**

- TREE, SYRINGA RETICULATA (JAPANESE TREE LILAC), CONTAINER GROWN, 5-GALLON
- ⊙ TREE, BETULA NIGRA (RIVER BIRCH), CONTAINER GROWN, 3-GALLON
- ▨ SEEDING, CLASS 5B
- ▧ SEEDLINGS

NOTES:  
SEEDING, CLASS 3 SHALL BE USED THROUGH THE PROJECT LIMITS.  
SEEDING, CLASS 5B SHALL OVERLAP THE SEEDING, CLASS 3.

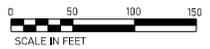

FILE NAME: S:\120214\188-1824-18D\_IL\_8\_ssr\_BNSF\_Phase II\Output\GDD\_Sheet10687181\_Landscaping.dgn



USER NAME: Brlay  
MODEL NAME: 03.LS  
PLOT SCALE: 100.0000"/PL  
PLOT DATE: 8/22/2019

DESIGNED - JLS  
DRAWN - PDB  
CHECKED - ESW  
DATE - 01-17-18


REVISED -  
REVISED -  
REVISED -  
REVISED -

**STATE OF ILLINOIS  
DEPARTMENT OF TRANSPORTATION**

**LANDSCAPING PLAN SHEETS  
IL ROUTE 8**  
SCALE: 1"=50' SHEET 3 OF 3 SHEETS

F.A.S. SITE: 1388	SECTION: (2-1VB)BR-2	COUNTY: PEORIA	TOTAL SHEETS: 235	SHEET NO.: 61
				CONTRACT NO. 68799
ILLINOIS FED. AID PROJECT				

BEARINGS ARE BASED ON IL STATE PLANE  
COORDINATES, NAD 83 (1997), WEST ZONE

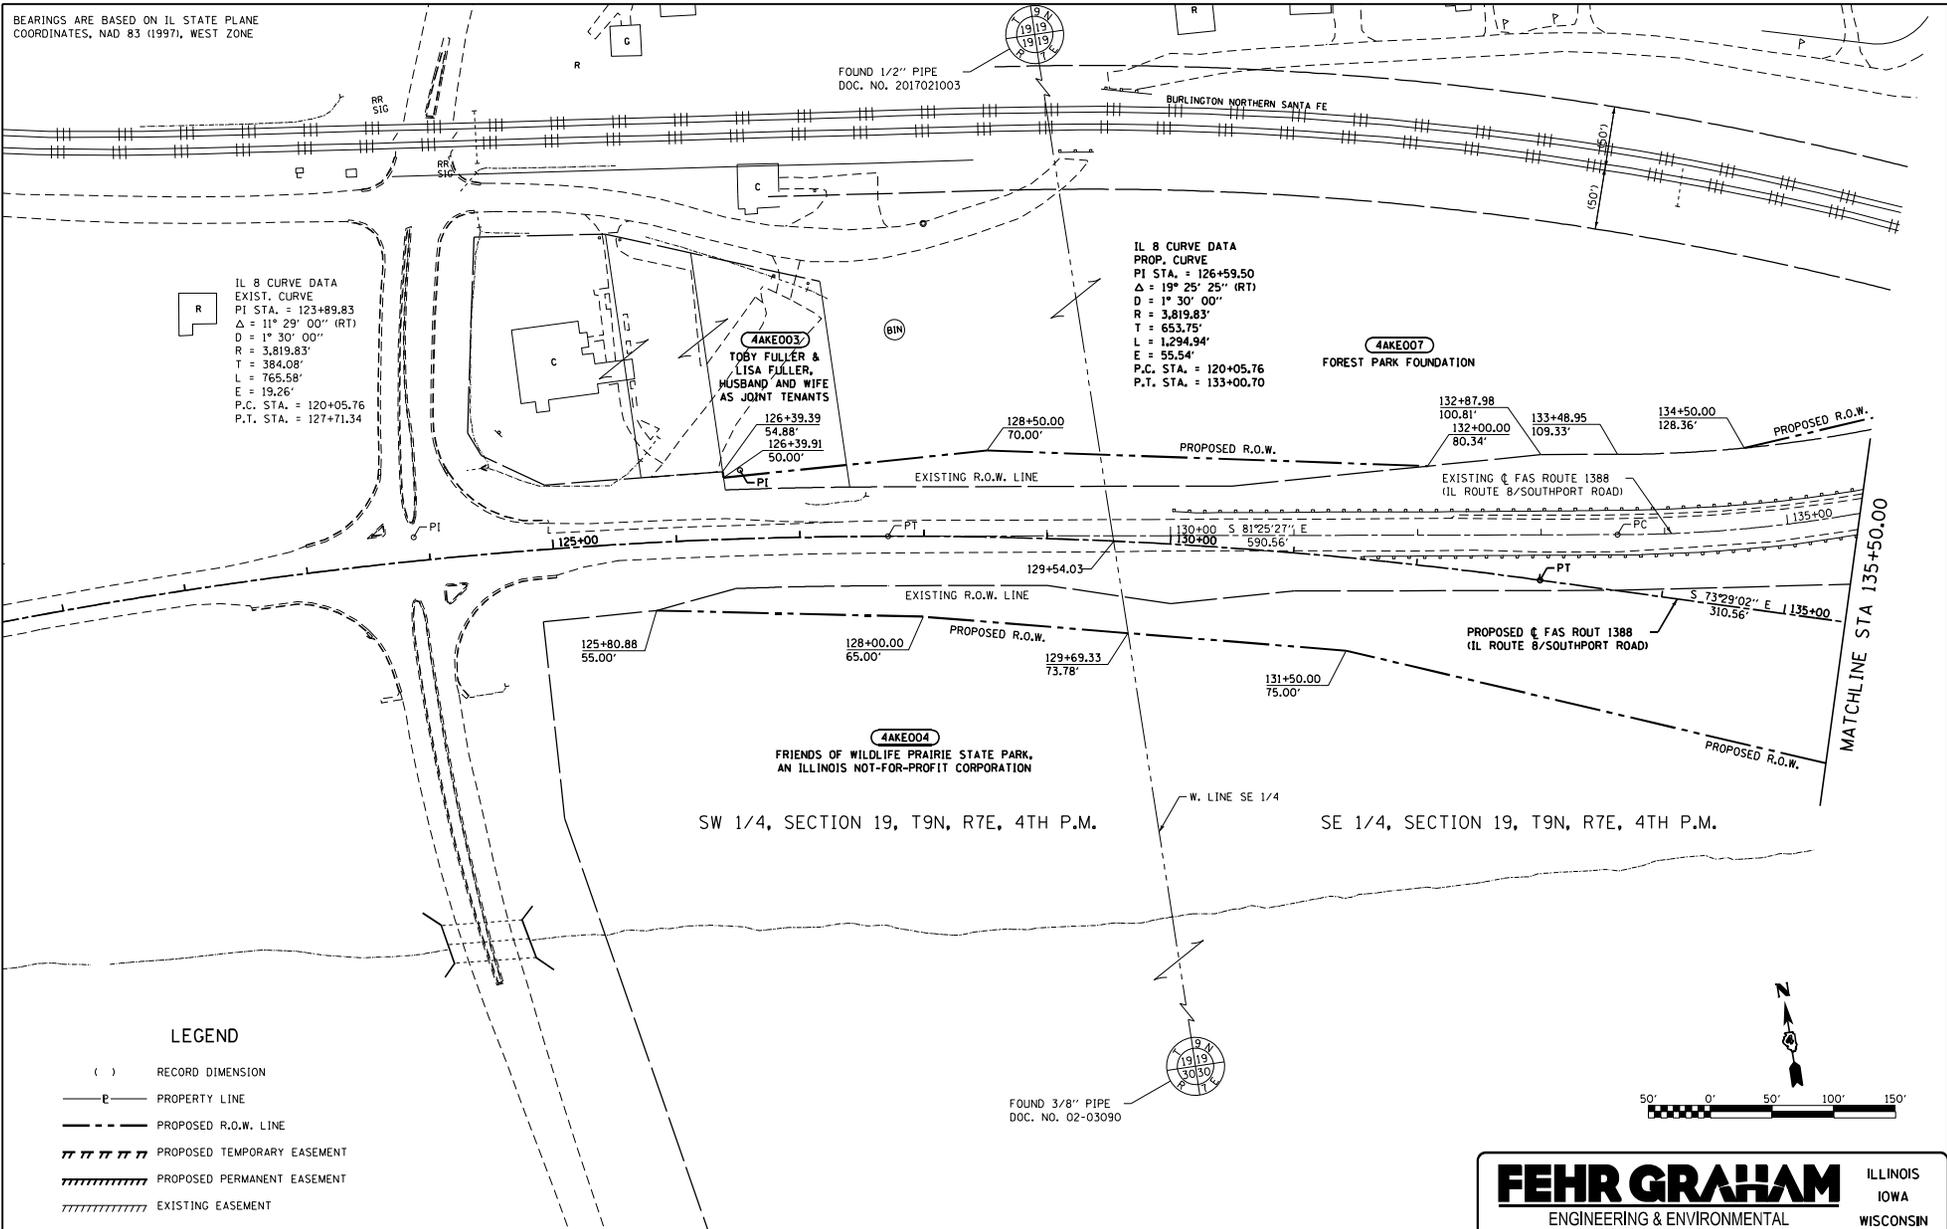


IL 8 CURVE DATA  
EXIST. CURVE  
PI STA. = 123+89.83  
 $\Delta = 11^\circ 29' 00''$  (RT)  
D =  $1^\circ 30' 00''$   
R = 3,819.83'  
T = 384.08'  
L = 765.58'  
E = 19.26'  
P.C. STA. = 120+05.76  
P.T. STA. = 127+71.34

IL 8 CURVE DATA  
PROP. CURVE  
PI STA. = 126+59.50  
 $\Delta = 19^\circ 25' 25''$  (RT)  
D =  $1^\circ 30' 00''$   
R = 3,819.83'  
T = 653.75'  
L = 1,294.94'  
E = 55.54'  
P.C. STA. = 120+05.76  
P.T. STA. = 133+00.70

**LEGEND**

- ( ) RECORD DIMENSION
- P — PROPERTY LINE
- - - PROPOSED R.O.W. LINE
- ||||| PROPOSED TEMPORARY EASEMENT
- ||||| PROPOSED PERMANENT EASEMENT
- ||||| EXISTING EASEMENT

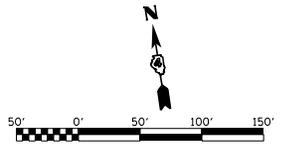


FILE NAME =	USER NAME = Betsy	DESIGNED - WJC	REVISED -
SHProject\488-8024-180 IL 8 over BNSF	Phase II\Design\CADD Sheets\1468799-shr-tran	DRAWN - CFC	REVISED -
RDW-1	PLOT SCALE = 1/8" = 100.000000' / in.	CHECKED - WJC	REVISED -
FEHR GRAHAM PROJECT NUMBER: 09005	PLOT DATE = 8/22/2019	DATE -	REVISED -

**STATE OF ILLINOIS  
DEPARTMENT OF TRANSPORTATION**

**RIGHT OF WAY PLAN  
IL ROUTE 8**

P.A.S. 1388	SECTION 02-1VB/BR-2	COUNTY PEORIA	TOTAL SHEETS 235	SHEET NO. 62
CONTRACT NO. 68799				ILLINOIS FED. AID PROJECT

BEARINGS ARE BASED ON IL STATE PLANE COORDINATES, NAD 83 (1997), WEST ZONE

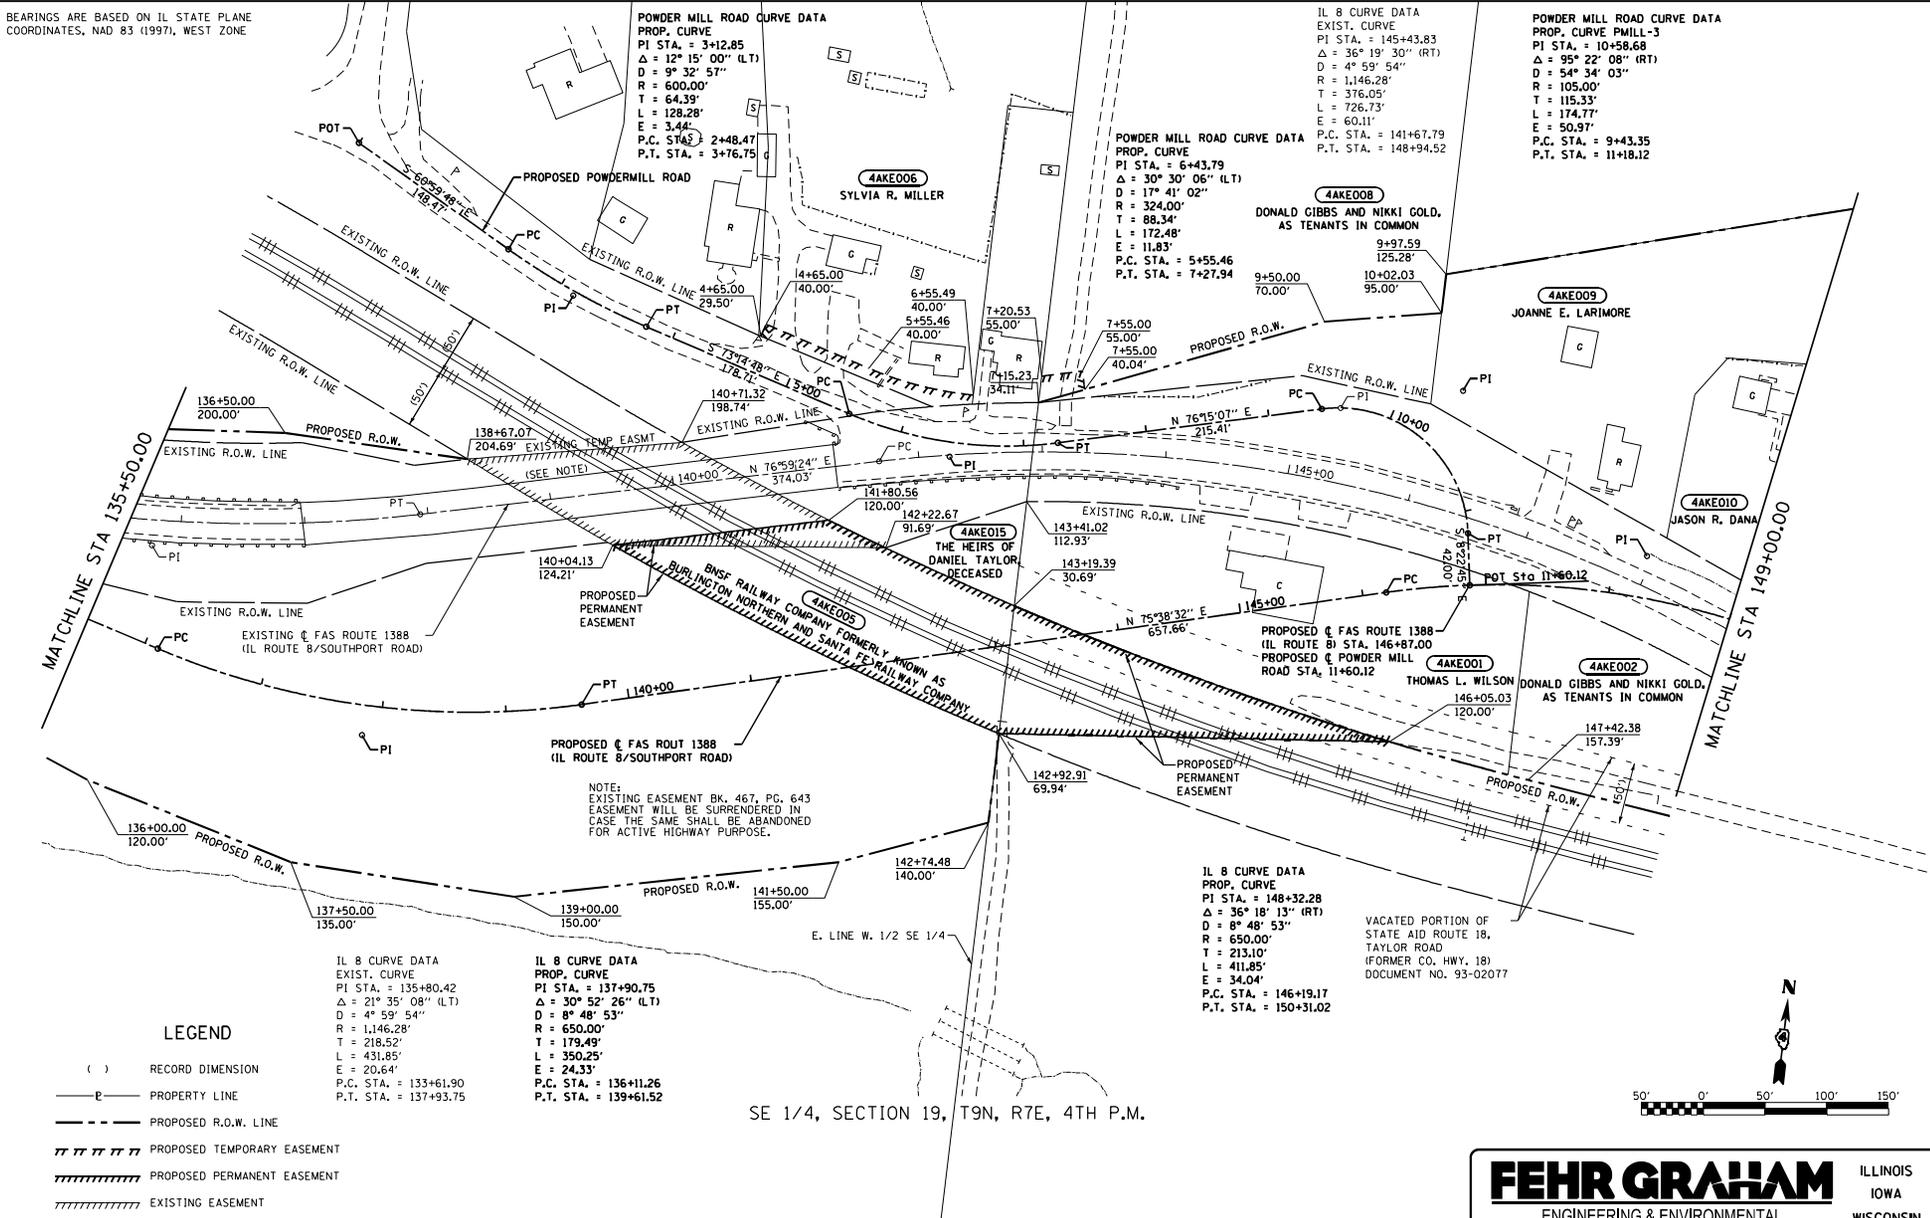

**POWDER MILL ROAD CURVE DATA**  
**PROP. CURVE**  
 PI STA. = 3+12.85  
 $\Delta = 12^\circ 15' 00''$  (LT)  
 $D = 9^\circ 32' 57''$   
 $R = 6000.00'$   
 $T = 64.39'$   
 $L = 128.28'$   
 $E = 3.44'$   
 P.C. STA. = 2+48.47  
 P.T. STA. = 3+76.75

**IL 8 CURVE DATA**  
 EXIST. CURVE  
 PI STA. = 145+43.83  
 $\Delta = 36^\circ 19' 30''$  (RT)  
 $D = 4^\circ 59' 54''$   
 $R = 1,146.28'$   
 $T = 376.05'$   
 $L = 726.73'$   
 $E = 60.11'$   
 P.C. STA. = 141+67.79  
 P.T. STA. = 148+94.52

**POWDER MILL ROAD CURVE DATA**  
**PROP. CURVE**  
 PI STA. = 10+58.68  
 $\Delta = 95^\circ 22' 08''$  (RT)  
 $D = 54^\circ 34' 03''$   
 $R = 105.00'$   
 $T = 115.33'$   
 $L = 174.77'$   
 $E = 50.97'$   
 P.C. STA. = 9+43.35  
 P.T. STA. = 11+18.12

**POWDER MILL ROAD CURVE DATA**  
**PROP. CURVE**  
 PI STA. = 6+43.79  
 $\Delta = 30^\circ 30' 06''$  (LT)  
 $D = 17^\circ 41' 02''$   
 $R = 324.00'$   
 $T = 88.34'$   
 $L = 172.48'$   
 $E = 11.83'$   
 P.C. STA. = 5+55.46  
 P.T. STA. = 7+27.94

**IL 8 CURVE DATA**  
 EXIST. CURVE  
 PI STA. = 145+43.83  
 $\Delta = 36^\circ 19' 30''$  (RT)  
 $D = 4^\circ 59' 54''$   
 $R = 1,146.28'$   
 $T = 376.05'$   
 $L = 726.73'$   
 $E = 60.11'$   
 P.C. STA. = 141+67.79  
 P.T. STA. = 148+94.52

NOTE:  
 EXISTING EASEMENT BK. 467, PG. 643  
 EASEMENT WILL BE SURRENDERED IN  
 CASE THE SAME SHALL BE ABANDONED  
 FOR ACTIVE HIGHWAY PURPOSE.

**LEGEND**

- ( ) RECORD DIMENSION
- P — PROPERTY LINE
- - - - - PROPOSED R.O.W. LINE
- ||||| PROPOSED TEMPORARY EASEMENT
- ||||| PROPOSED PERMANENT EASEMENT
- ||||| EXISTING EASEMENT


**IL 8 CURVE DATA**  
 EXIST. CURVE  
 PI STA. = 135+80.42  
 $\Delta = 21^\circ 35' 08''$  (LT)  
 $D = 4^\circ 59' 54''$   
 $R = 1,146.28'$   
 $T = 218.52'$   
 $L = 431.85'$   
 $E = 20.64'$   
 P.C. STA. = 133+61.90  
 P.T. STA. = 137+93.75

**IL 8 CURVE DATA**  
 PROP. CURVE  
 PI STA. = 137+90.75  
 $\Delta = 30^\circ 52' 26''$  (LT)  
 $D = 8^\circ 48' 53''$   
 $R = 650.00'$   
 $T = 179.49'$   
 $L = 350.25'$   
 $E = 24.33'$   
 P.C. STA. = 136+11.26  
 P.T. STA. = 139+61.52

**IL 8 CURVE DATA**  
 PROP. CURVE  
 PI STA. = 148+32.28  
 $\Delta = 36^\circ 18' 13''$  (RT)  
 $D = 8^\circ 48' 53''$   
 $R = 650.00'$   
 $T = 213.10'$   
 $L = 411.85'$   
 $E = 34.04'$   
 P.C. STA. = 146+19.17  
 P.T. STA. = 150+31.02

VACATED PORTION OF  
 STATE AID ROUTE 18,  
 TAYLOR ROAD  
 (FORMER CO. HWY. 18)  
 DOCUMENT NO. 93-02077


SE 1/4, SECTION 19, T9N, R7E, 4TH P.M.

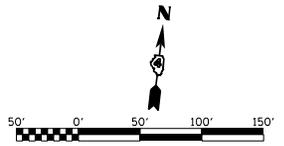

FILE NAME : S:\Projects\488-8024-180 IL 8 over BNSF	USER NAME : Betsy	DESIGNED - WJC	REVISION -	STATE OF ILLINOIS DEPARTMENT OF TRANSPORTATION	RIGHT OF WAY PLAN IL ROUTE 8	P.L. 25, RTE. 1388	SECTION 12-1VB1R-2	COUNTY PEORIA	TOTAL SHEET 235	SHEET NO. 63	CONTRACT NO. 68799
ROW-2	Phase II Design/CADD Sheets/D488799-180-180	CHECKED - WJC	REVISION -	SCALE:	SHEET OF SHEETS	STA. TO STA.	ILLINOIS FED. AID PROJECT				
FEHR GRAHAM PROJECT NUMBER: 09005	PLOT SCALE = 1/80,000,000" = 1" = 100'	DATE = 8/22/2019	REVISION -								

**FEHR GRAHAM** ILLINOIS IOWA WISCONSIN  
 ENGINEERING & ENVIRONMENTAL  
 ILLINOIS DESIGN FIRM NO. 04-00325

BEARINGS ARE BASED ON IL STATE PLANE  
COORDINATES, NAD 83 (1997), WEST ZONE

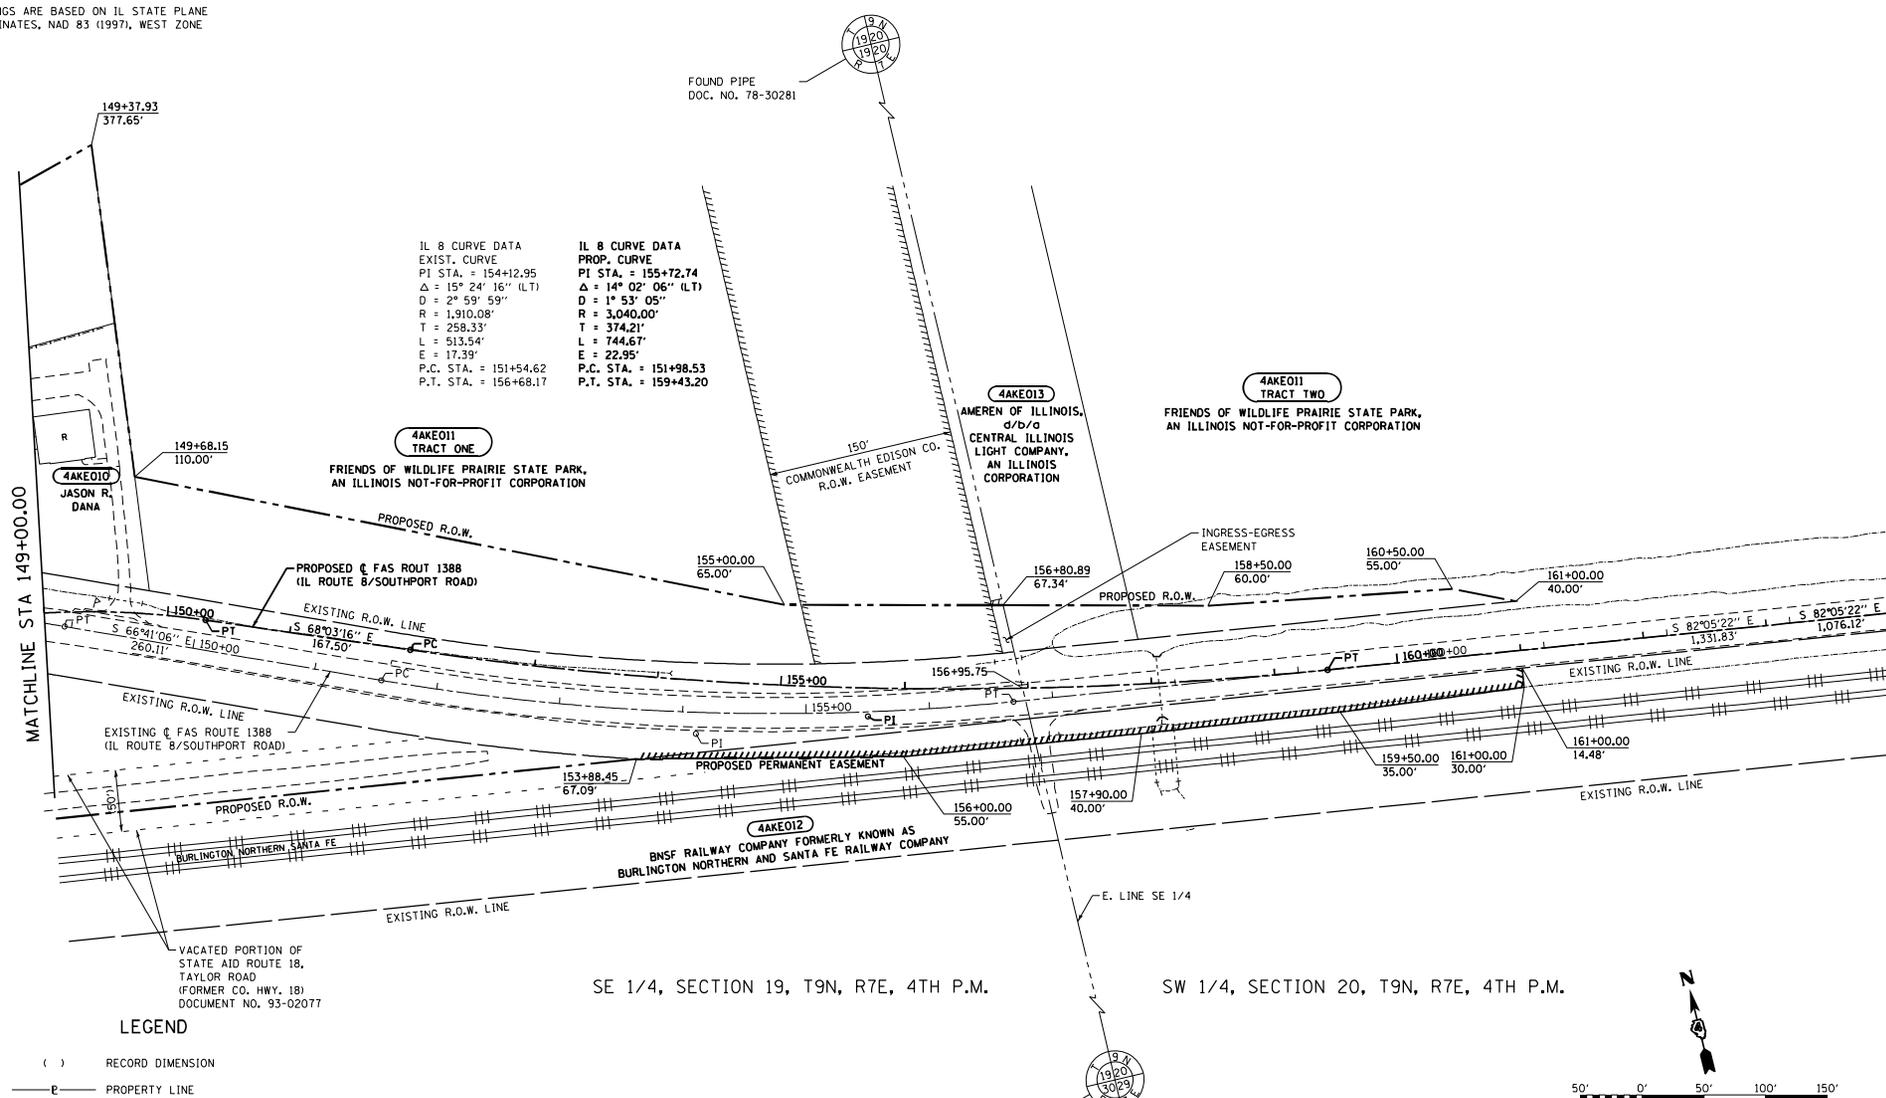


IL 8 CURVE DATA  
EXIST. CURVE  
PI STA. = 154+12.95  
 $\Delta = 15^\circ 24' 16''$  (LT)  
D = 2° 59' 59"  
R = 1,910.08'  
T = 258.33'  
L = 513.54'  
E = 17.39'  
P.C. STA. = 151+54.62  
P.T. STA. = 156+68.17

IL 8 CURVE DATA  
PROP. CURVE  
PI STA. = 155+72.74  
 $\Delta = 14^\circ 02' 06''$  (LT)  
D = 1° 53' 05"  
R = 3,040.00'  
T = 374.21'  
L = 744.61'  
E = 22.95'  
P.C. STA. = 151+98.53  
P.T. STA. = 159+43.20

LEGEND

- ( ) RECORD DIMENSION
- P — PROPERTY LINE
- - - PROPOSED R.O.W. LINE
- ||||| PROPOSED TEMPORARY EASEMENT
- ||||| PROPOSED PERMANENT EASEMENT
- ||||| EXISTING EASEMENT

SE 1/4, SECTION 19, T9N, R7E, 4TH P.M.      SW 1/4, SECTION 20, T9N, R7E, 4TH P.M.

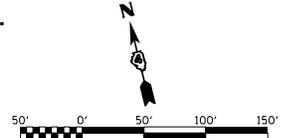

FILE NAME : S:\Projects\488-8024-180 IL 8 over BNSF	USER NAME : Betsy	DESIGNED - WJC	REVISED -
Phase II Design\CAD Sheets\1448799-shr-rdw	DRAWN: dgn	CHECKED - WJC	REVISED -
RDW-3	PLOT SCALE = 1/80,000,000 " = 1"	DATE -	REVISED -
FEHR GRAHAM PROJECT NUMBER: 09005	PLOT DATE = 8/22/2019		

**STATE OF ILLINOIS**  
**DEPARTMENT OF TRANSPORTATION**

**RIGHT OF WAY PLAN**  
**IL ROUTE 8**

SCALE:      SHEET      OF      SHEETS      STA.      TO      STA.


FEHR GRAHAM

ENGINEERING & ENVIRONMENTAL

ILLINOIS DESIGN FIRM NO. 04-003525

ILLINOIS      IOWA      WISCONSIN

P.A.S. RITE:	SECTION	COUNTY	TOTAL SHEET NO.
1388	(2-1VB)R-2	PEORIA	235 64
			CONTRACT NO. 68799
ILLINOIS FED. AID PROJECT			

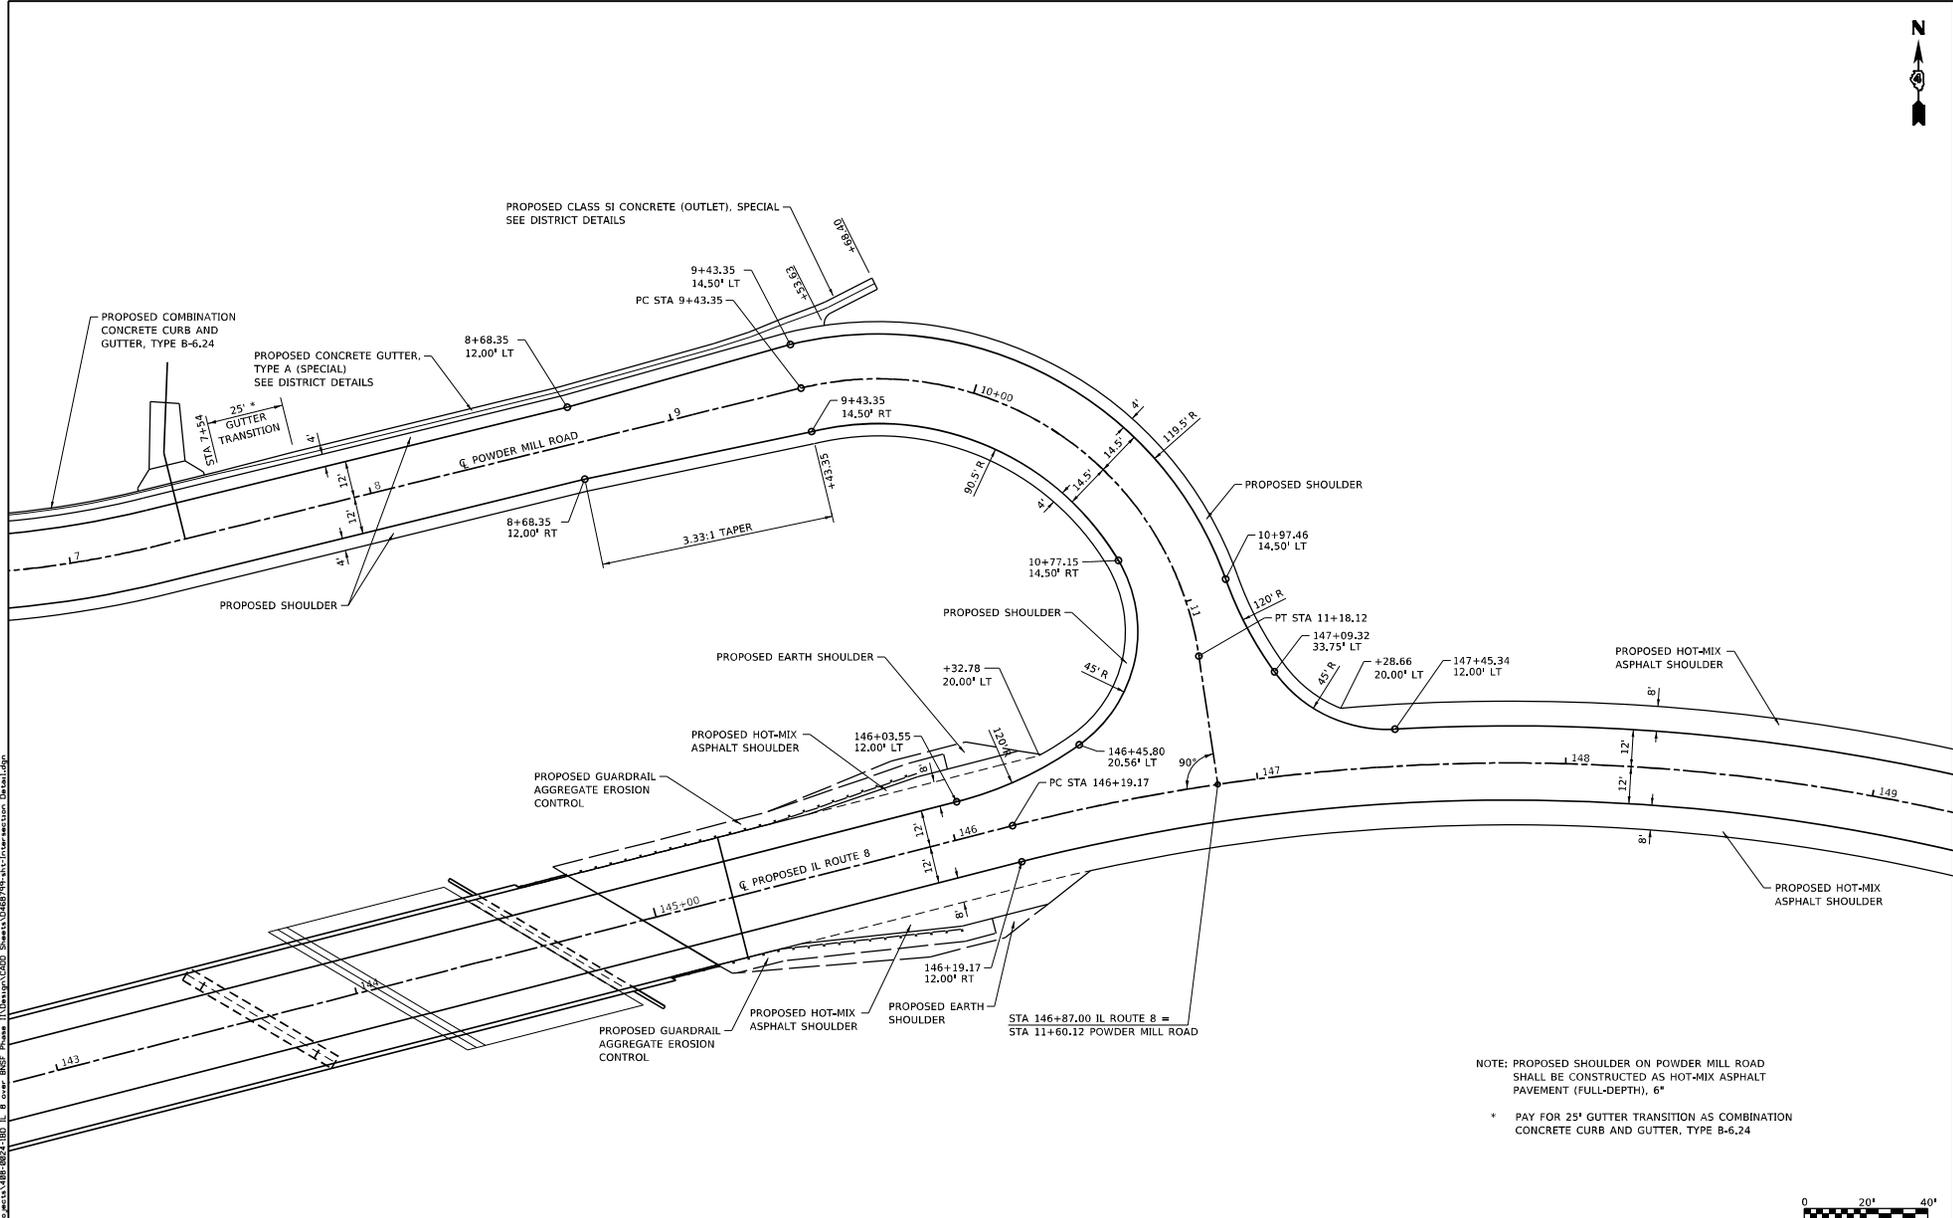

NOTE: PROPOSED SHOULDER ON POWDER MILL ROAD SHALL BE CONSTRUCTED AS HOT-MIX ASPHALT PAVEMENT (FULL-DEPTH), 6"  
 \* PAY FOR 25' GUTTER TRANSITION AS COMBINATION CONCRETE CURB AND GUTTER, TYPE B-6.24



FILE NAME: E:\p2\2011\1188-022-001 IL 8 over BNSF Phase 1\Unsup\000 Sheets\018799\1188-022-001-Intersecton Detail.dwg



USER NAME • Betsy  
 MODEL NAME • 0111.dwg  
 PLOT SCALE • 40/2000' / PL  
 PLOT DATE • 8/22/2011

DESIGNED - JLS  
 DRAWN - PDB  
 CHECKED - ESW  
 DATE - 01-17-10

REVISED -  
 REVISED -  
 REVISED -  
 REVISED -

**STATE OF ILLINOIS  
 DEPARTMENT OF TRANSPORTATION**

**INTERSECTION DETAIL SHEET  
 IL ROUTE 8 AND POWDER MILL ROAD**

SCALE: 1"=20' SHEET 1 OF 1 SHEETS

F.A.S. SITE	SECTION	COUNTY	TOTAL SHEETS	SHEET NO.
1388	(2-1VB)BR-2	PEORIA	235	65
CONTRACT NO. 68799				
ILLINOIS   FED. RD. PROJECT				




**NORTHWEST QUADRANT**

POINT	ELEVATION	NORTHING	EASTING	ROADWAY STATION	ROADWAY OFFSET
<b>IL ROUTE 8</b>					
101	531.19	1,485,708.36	2,414,533.84	146+03.55	-12.00
102	530.94	1,485,711.24	2,414,543.41	146+13.54	-12.42
103	530.68	1,485,714.91	2,414,552.71	146+23.37	-13.68
104	530.43	1,485,719.34	2,414,561.67	146+32.91	-15.88
105	530.17	1,485,724.50	2,414,570.24	146+42.15	-19.02
106	529.91	1,485,730.54	2,414,578.19	146+50.89	-23.29
<b>POWDER MILL ROAD</b>					
107	529.61	1,485,738.11	2,414,584.69	11+31.33	29.84
108	529.30	1,485,746.92	2,414,589.37	11+23.29	23.93
109	528.94	1,485,756.55	2,414,591.99	11+13.21	19.85
110	528.57	1,485,766.52	2,414,592.42	11+01.62	16.97
111	528.50	1,485,776.34	2,414,590.65	10+90.02	15.19
112	528.44	1,485,785.53	2,414,586.75	10+78.42	14.51
113	528.43	1,485,786.47	2,414,586.20	10+77.15	14.50

**NORTHEAST QUADRANT**

POINT	ELEVATION	NORTHING	EASTING	ROADWAY STATION	ROADWAY OFFSET
<b>POWDER MILL ROAD</b>					
201	528.54	1,485,780.44	2,414,620.94	10+97.44	-14.50
202	528.51	1,485,771.17	2,414,624.69	11+06.16	-15.33
203	528.48	1,485,762.25	2,414,629.20	11+14.54	-17.78
204	528.45	1,485,753.73	2,414,634.44	11+23.12	-21.65
205	528.21	1,485,745.83	2,414,640.55	11+31.82	-26.54
<b>IL ROUTE 8</b>					
206	527.97	1,485,739.40	2,414,648.18	147+19.09	-21.63
207	527.72	1,485,734.80	2,414,657.03	147+27.26	-16.25
208	527.48	1,485,732.26	2,414,666.68	147+36.48	-12.98
209	527.26	1,485,731.86	2,414,675.76	147+45.34	-12.00

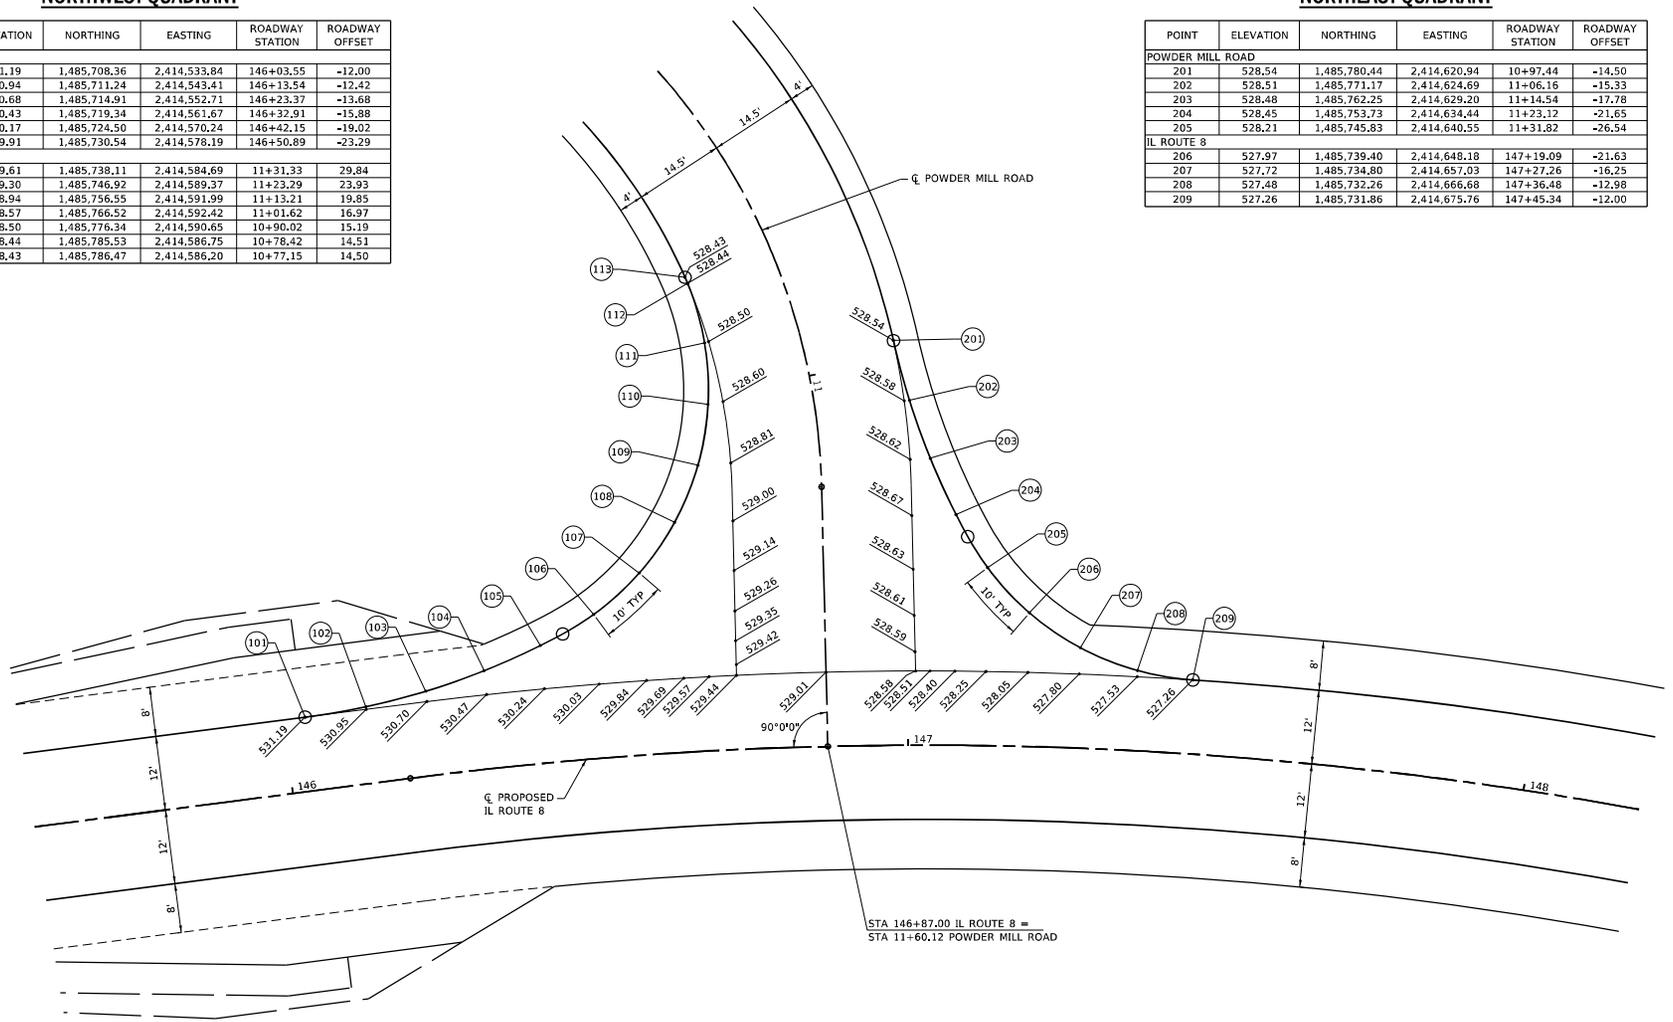

FILE NAME: S:\Projects\188-024-001 IL 8 over BNSF Phase II\Output\000 Sheets\016877.mxd; E:\mxdp



USER NAME • Betsy  
 MODEL NAME • 01 PavElev  
 PLOT SCALE • 20/800"/in.  
 PLOT DATE • 8/22/2019

DESIGNED - JLS  
 DRAWN - PDB  
 CHECKED - ESW  
 DATE - 01-17-18

REVISED -  
 REVISED -  
 REVISED -  
 REVISED -

**STATE OF ILLINOIS  
 DEPARTMENT OF TRANSPORTATION**

**PAVEMENT ELEVATION SHEET  
 IL ROUTE 8 AND POWDER MILL ROAD**

SCALE: 1"=10'    SHEET 1 OF 1 SHEETS

F.A.S. SITE	SECTION	COUNTY	TOTAL SHEETS	SHEET NO.
1388	(2-1VB)BR-2	PEORIA	235	66
CONTRACT NO. 68799				
ILLINOIS FED. AID PROJECT				



FILE NAME: S:\Projects\1188-024-101\_IL\_8\_ssr\_BNF\_Phase II\Output\GD01\_Sheet1\0168798-1111-Grading\_Plan.dwg



BEGIN SECTION  
STA 125+00



NOTE: CONTOURS PLOTTED AT 2' INTERVAL.



USER NAME: Betsy  
 MODEL NAME: 01 Grading Plan  
 PLOT SCALE: 100.0000' / 1" PL.  
 PLOT DATE: 8/22/2019

DESIGNED: JLS  
 DRAWN: PDB  
 CHECKED: ESW  
 DATE: 01-17-18


REVISED: -  
 REVISED: -  
 REVISED: -  
 REVISED: -

STATE OF ILLINOIS  
 DEPARTMENT OF TRANSPORTATION

GRADING PLAN SHEETS  
 IL ROUTE 8  
 SCALE: 1" = 50'  
 SHEET 1 OF 3 SHEETS  
 STA 121+50 TO STA 135+50

F.A.S. SITE	SECTION	COUNTY	TOTAL SHEETS	SHEET NO.
1388	(2-1)BJR-2	PEORIA	235	68
CONTRACT NO. 68799				
ILLINOIS FED. AID PROJECT				

FILE NAME: S:\Projects\1188-024-100 IL 8 over BNSF Phase 1\Drawings\GD Sheets\0168799\1188-024-100 IL 8 over BNSF Phase 1\Grading Plan.dwg

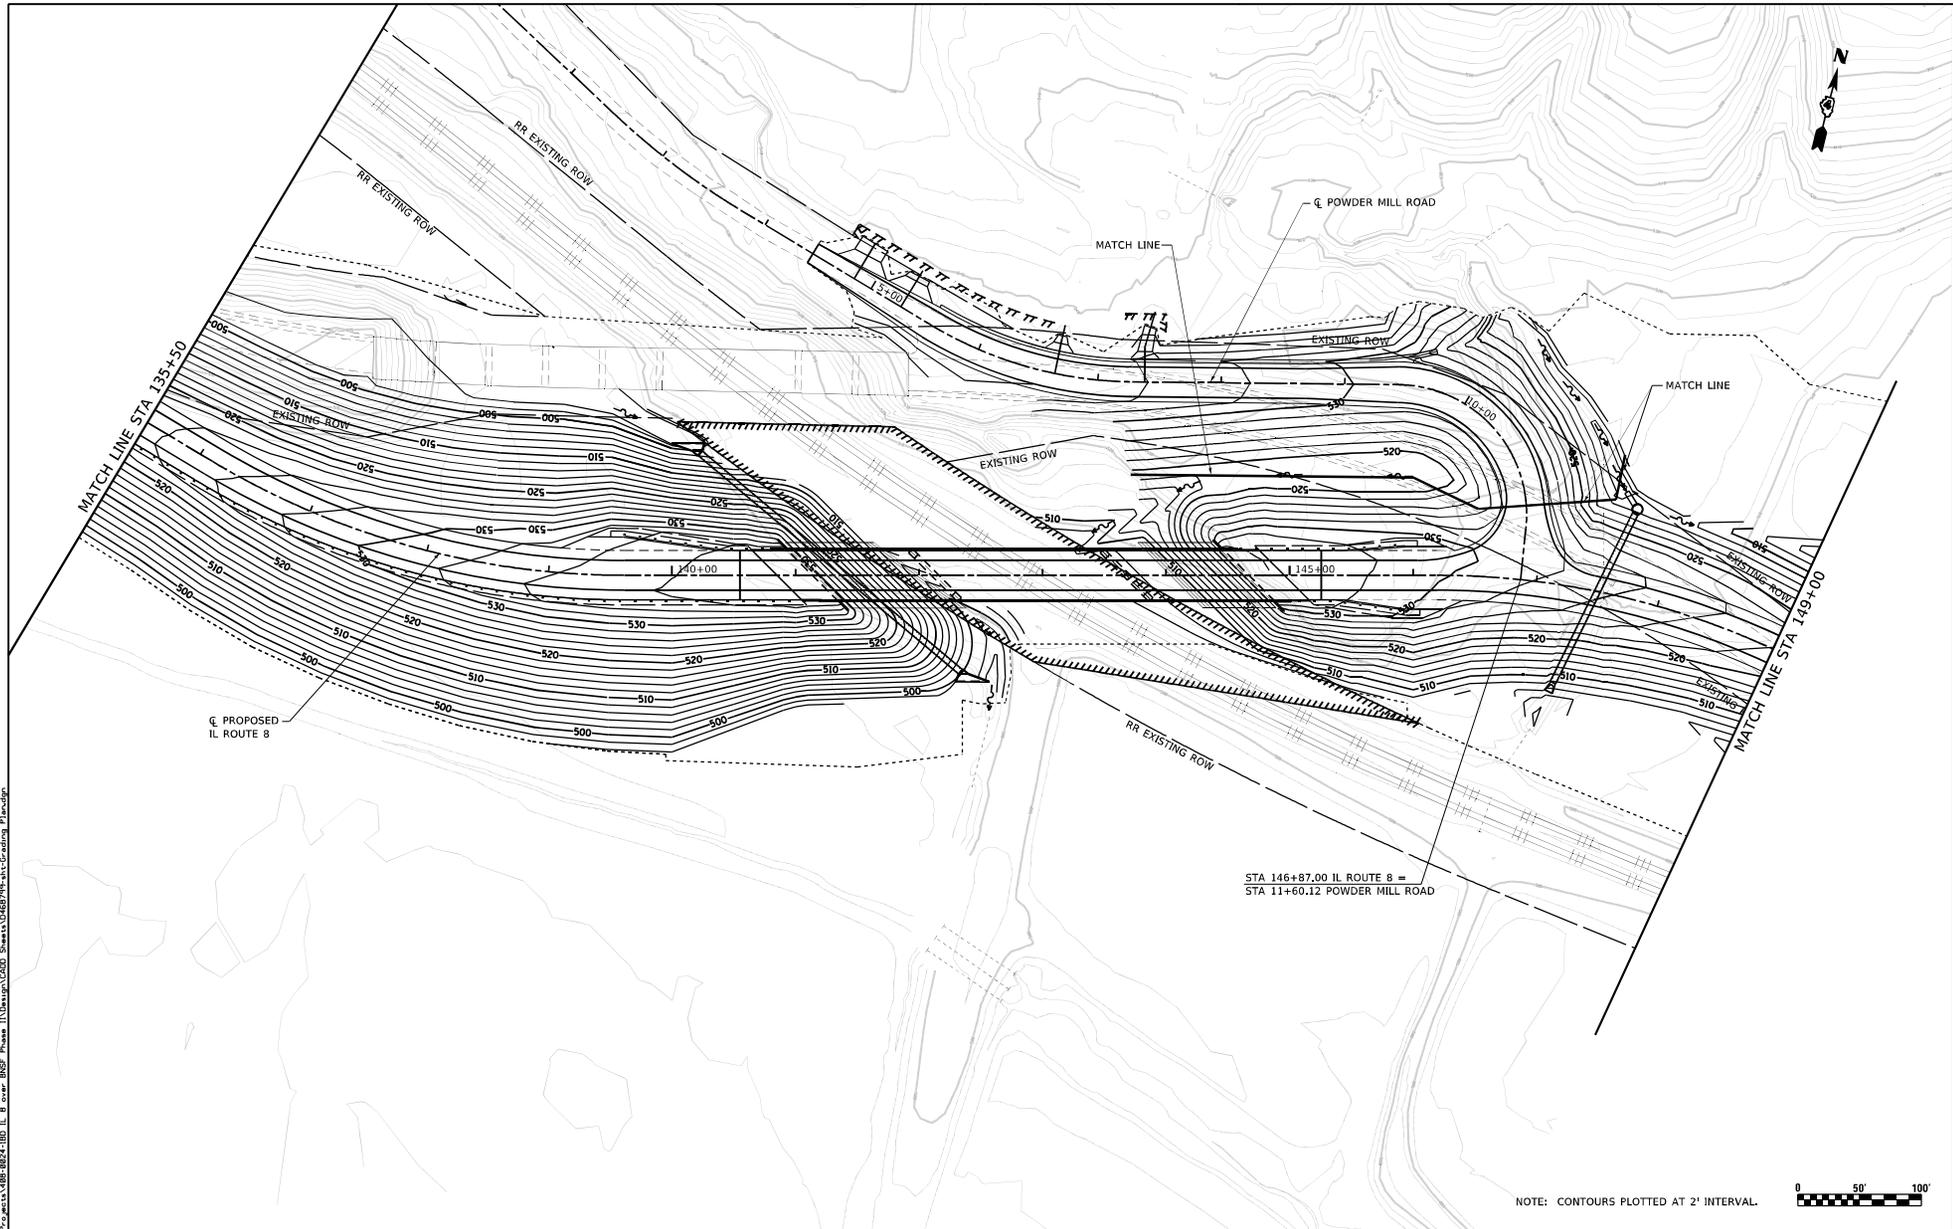

NOTE: CONTOURS PLOTTED AT 2' INTERVAL.



USER NAME: Betsy  
 MODEL NAME: 02 Grading Plan  
 PLOT SCALE: 100.0000'/PL  
 PLOT DATE: 8/22/2019

DESIGNED: JLS  
 DRAWN: PDB  
 CHECKED: ESW  
 DATE: 01-17-18


REVISED: -  
 REVISED: -  
 REVISED: -  
 REVISED: -

STATE OF ILLINOIS  
 DEPARTMENT OF TRANSPORTATION

GRADING PLAN SHEETS  
 IL ROUTE 8

SCALE: 1"=50'  
 SHEET 2 OF 3 SHEETS  
 STA 135+50 TO STA 149+00

F.A.S. NO.	SECTION	COUNTY	TOTAL SHEETS	SHEET NO.
1388	(2-1VB)BR-2	PEORIA	235	69
CONTRACT NO. 68799				
ILLINOIS FED. AID PROJECT				

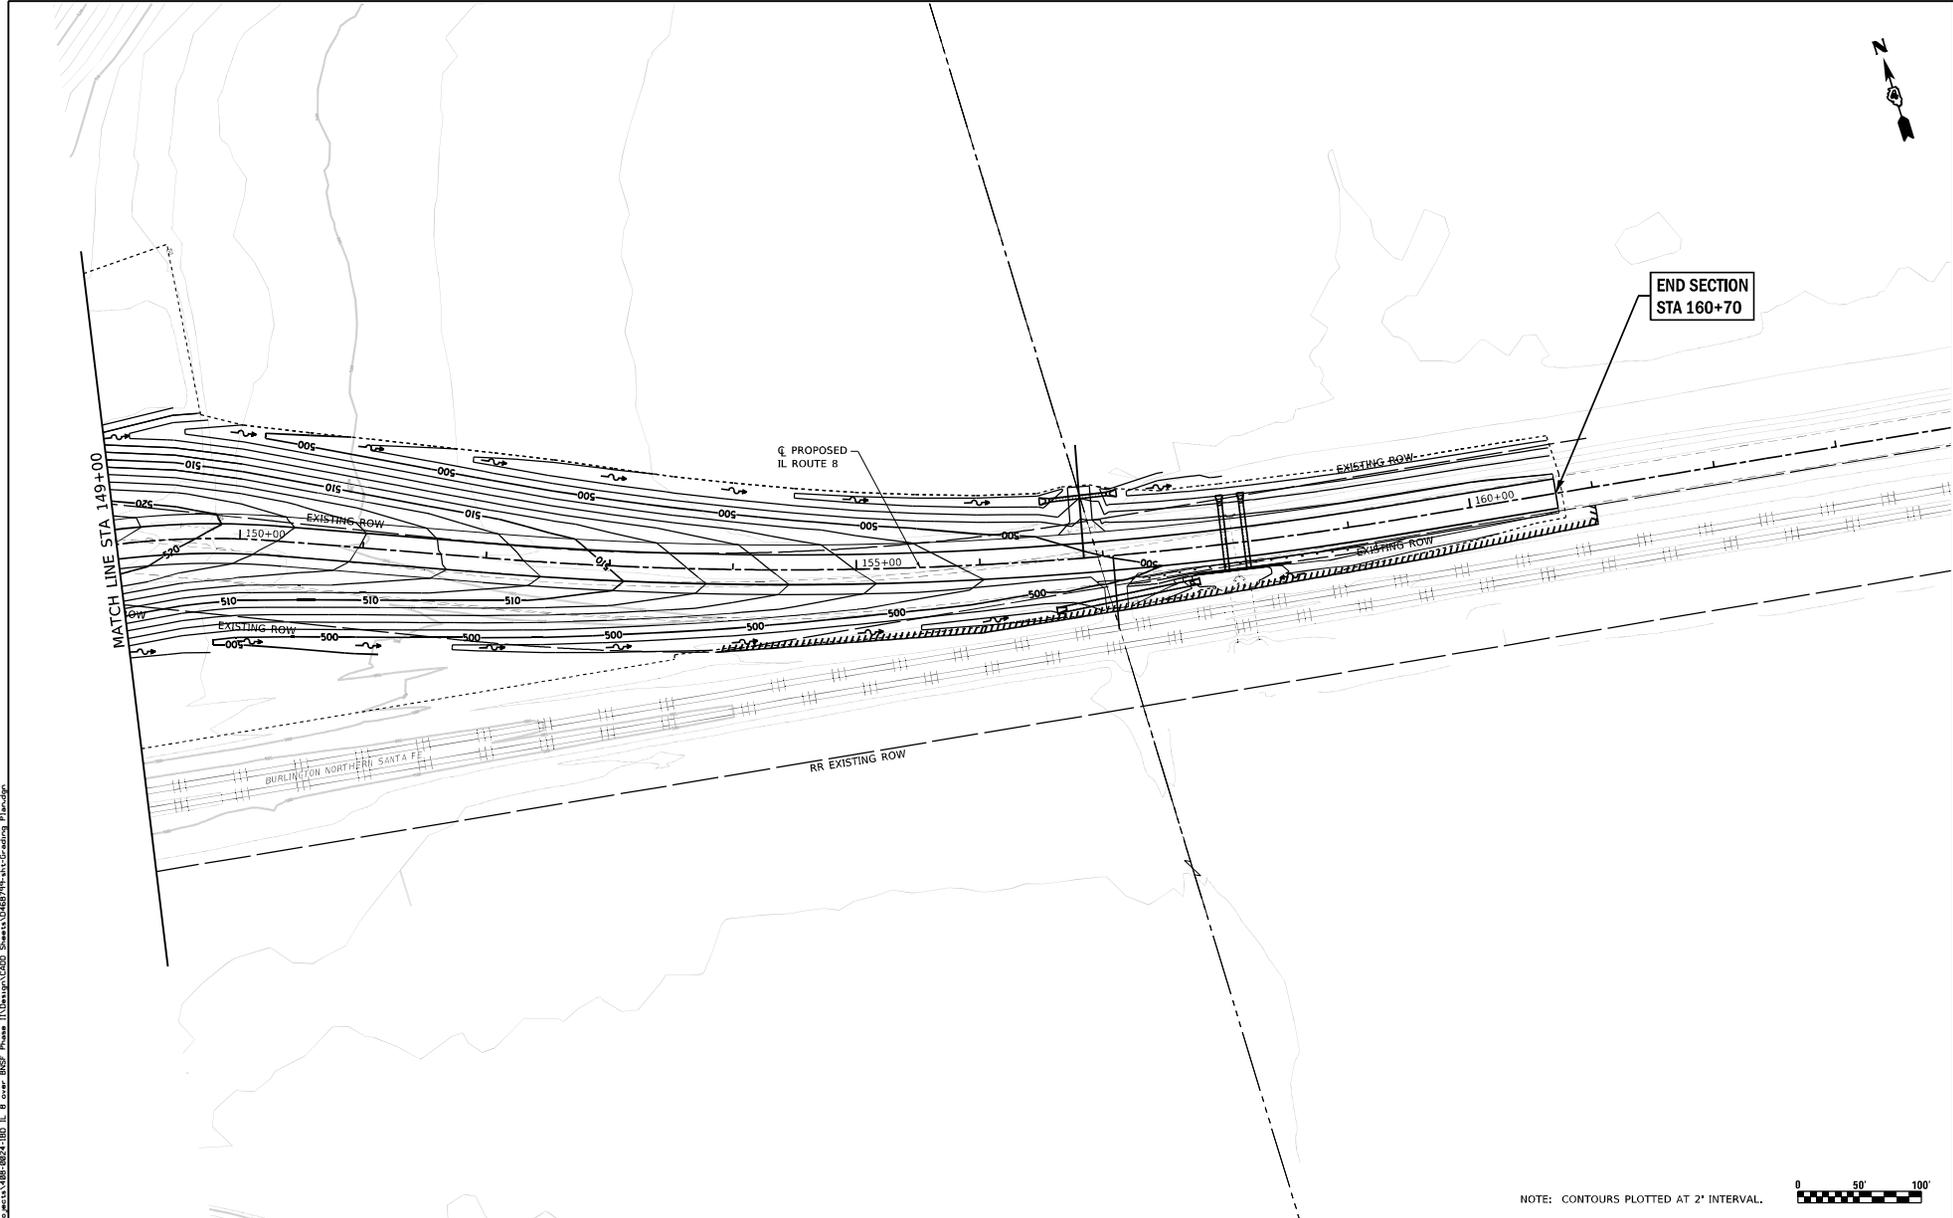

END SECTION  
STA 160+70

PROPOSED  
IL ROUTE 8

MATCH LINE STA 149+00

BURLINGTON NORTHERN SANTA FE  
RR EXISTING ROW

NOTE: CONTOURS PLOTTED AT 2' INTERVAL.



FILE NAME: S:\Projects\188-024-100 IL 8 over BNSF Phase II\Output\000 Sheets\046778\Grading Plan.dwg



USER NAME • Betsy  
MODEL NAME • 03 Grading Plan  
PLOT SCALE • 100.0000"/ft.  
PLOT DATE • 8/22/2019

DESIGNED - JLS  
DRAWN - PDB  
CHECKED - ESW  
DATE - 01-17-18

REVISED -  
REVISED -  
REVISED -  
REVISED -

STATE OF ILLINOIS  
DEPARTMENT OF TRANSPORTATION

GRADING PLAN SHEETS  
IL ROUTE 8

SCALE: 1"=50'  
SHEET 3 OF 3 SHEETS  
STA 149+00 TO STA 163+50


F.A.S. SITE	SECTION	COUNTY	TOTAL SHEETS	SHEET NO.
1388	(2-1VB)BR-2	PEORIA	235	70
CONTRACT NO. 68799				
ILLINOIS FED. AID PROJECT				








**END SECTION  
STA 160+70**

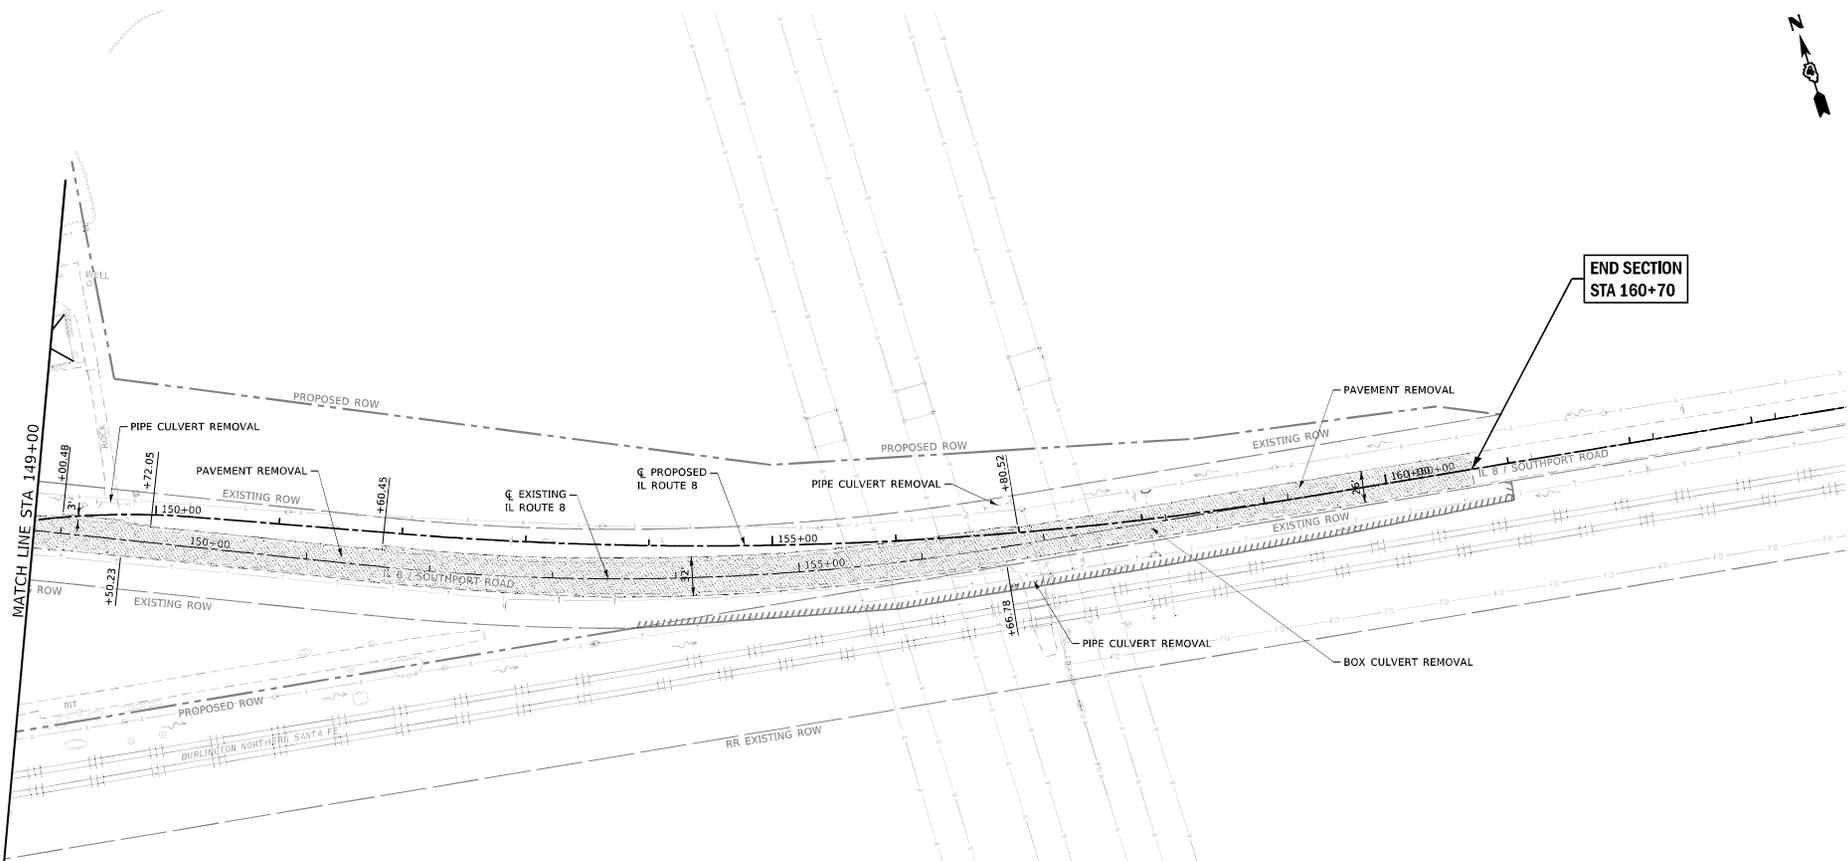

**LEGEND**

-  PAVEMENT REMOVAL
-  DRIVEWAY PAVEMENT REMOVAL
-  GUTTER REMOVAL
-  STRUCTURE REMOVAL
-  HOT-MIX ASPHALT REMOVAL (SPECIAL)
-  APPROACH SLAB REMOVAL
-  TREE REMOVAL, ACRES
-  RUBBLE FILL TO BE REMOVED AS REMOVAL AND DISPOSAL OF UNSUITABLE MATERIALS
-  TREE REMOVAL, EACH

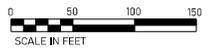

FILE NAME: S:\Projects\149-160-IL-8-rem-BSF Phase 1\Output\GDG Sheet1.DWG\149-160-IL-8-rem-BSF.dwg




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MODEL NAME	• 03 Rem	DRAWN	- PDB	REVISED	-
PLOT SCALE	• 100,0000"/PL	CHECKED	- ESW	REVISED	-
PLOT DATE	• 8/22/2019	DATE	• 01-17-18	REVISED	-

STATE OF ILLINOIS DEPARTMENT OF TRANSPORTATION
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REMOVAL PLAN SHEETS IL ROUTE 8
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SCALE: 1"=50'	SHEET 3 OF 3 SHEETS	STA 149+00 TO STA 163+50
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F.A.S. SITE	SECTION	COUNTY	TOTAL SHEETS	SHEET NO.
1388	(2-1VB)BR-2	PEORIA	235	73
CONTRACT NO. 68799				
ILLINOIS FED. AID PROJECT				



BEGIN SECTION  
STA 125+00

MATCH LINE STA 135+50

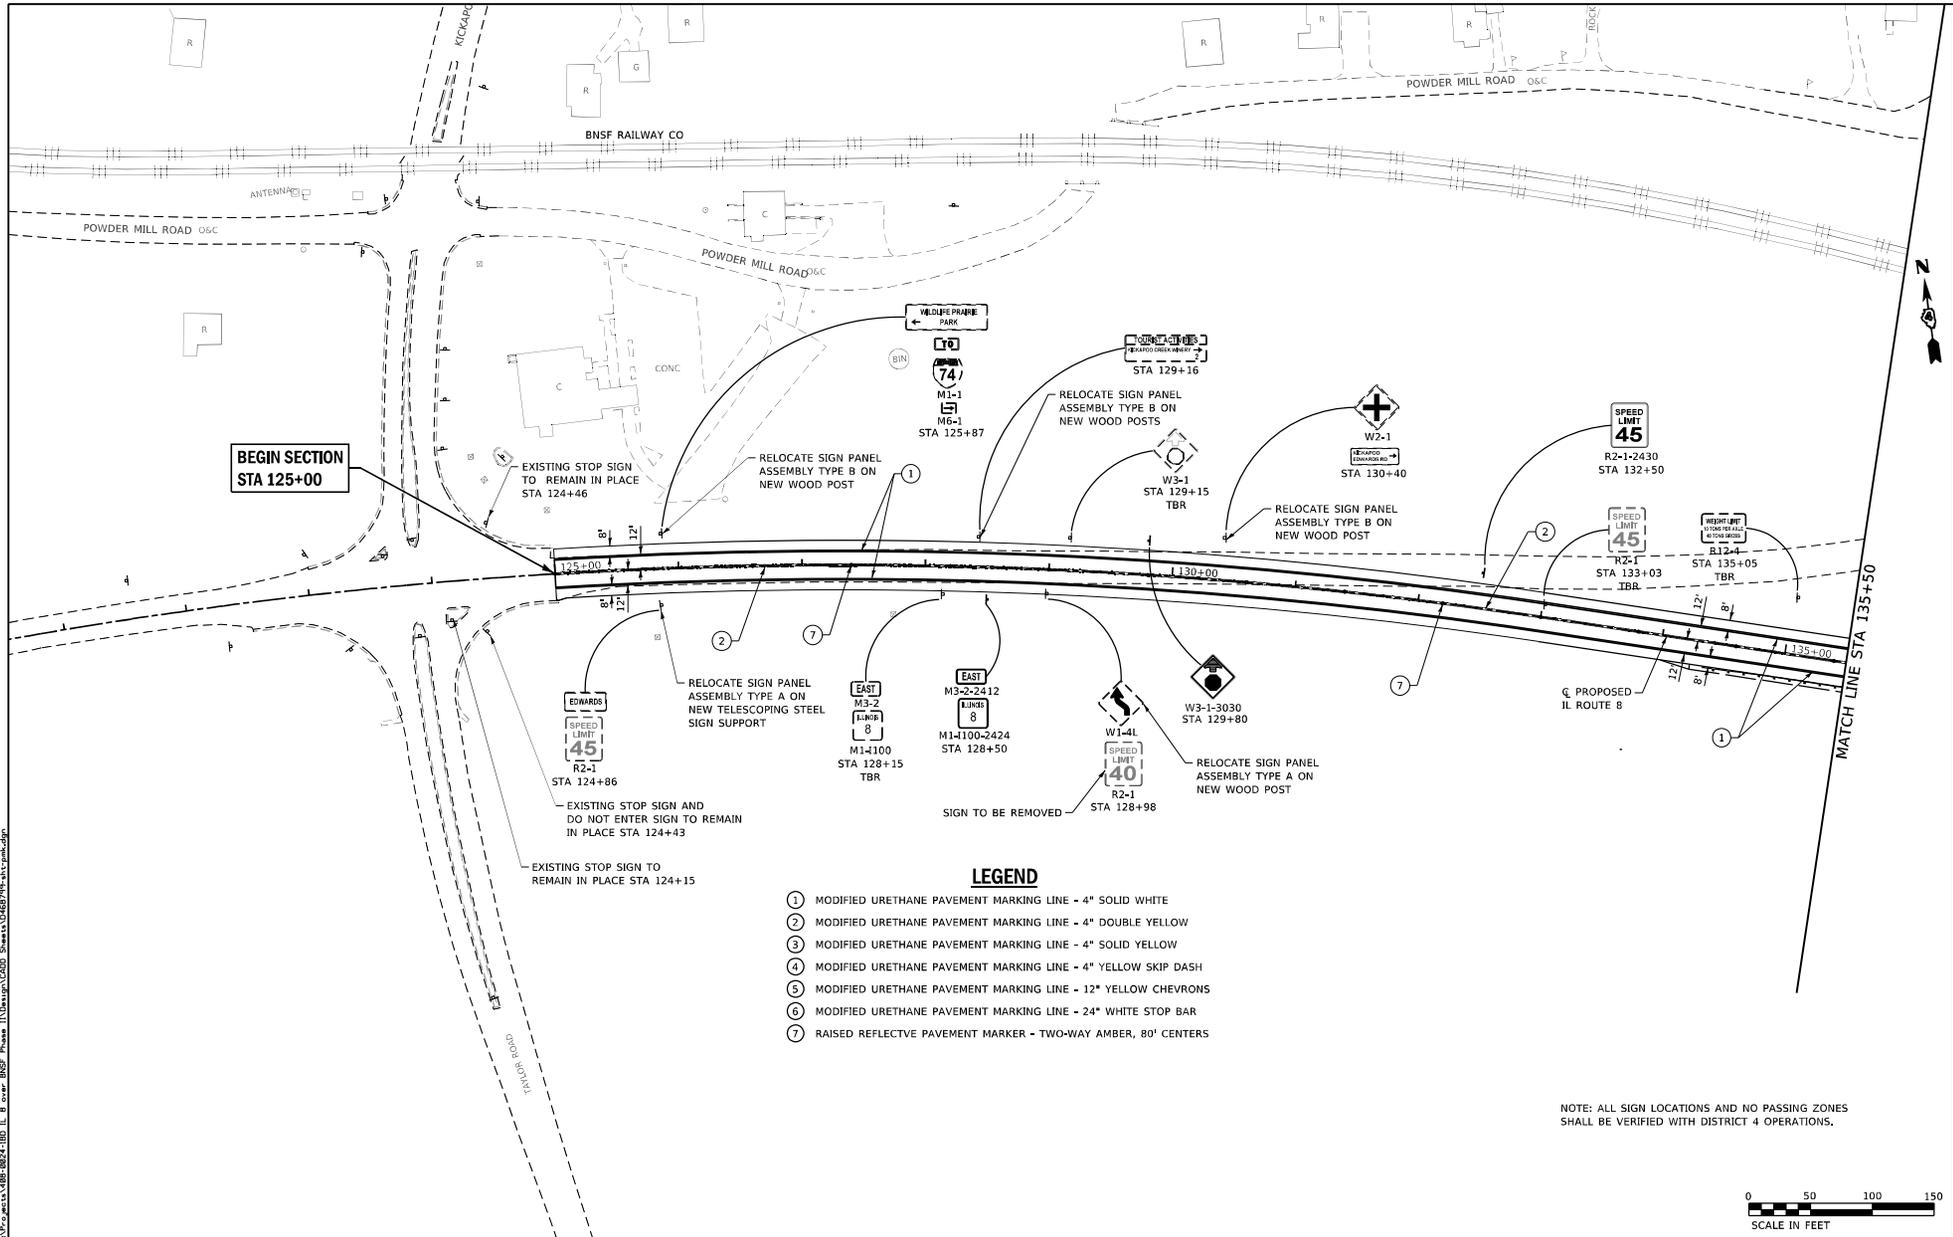**LEGEND**

- ① MODIFIED URETHANE PAVEMENT MARKING LINE - 4" SOLID WHITE
- ② MODIFIED URETHANE PAVEMENT MARKING LINE - 4" DOUBLE YELLOW
- ③ MODIFIED URETHANE PAVEMENT MARKING LINE - 4" SOLID YELLOW
- ④ MODIFIED URETHANE PAVEMENT MARKING LINE - 4" YELLOW SKIP DASH
- ⑤ MODIFIED URETHANE PAVEMENT MARKING LINE - 12" YELLOW CHEVRONS
- ⑥ MODIFIED URETHANE PAVEMENT MARKING LINE - 24" WHITE STOP BAR
- ⑦ RAISED REFLECTIVE PAVEMENT MARKER - TWO-WAY AMBER, 80' CENTERS

NOTE: ALL SIGN LOCATIONS AND NO PASSING ZONES SHALL BE VERIFIED WITH DISTRICT 4 OPERATIONS.



FILE NAME: S:\V2\2018\11\18\24\118-024-101 IL 8 over BNSF Phase 1\Drawings\2018\Sheet\068799-118.dwg




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MODEL NAME	• 01 Pink	DRAWN	- PDB	REVISED	-
PLOT SCALE	• 100.0000"/ft.	CHECKED	- ESW	REVISED	-
PLOT DATE	• 8/22/2019	DATE	- 01-17-18	REVISED	-

**STATE OF ILLINOIS  
DEPARTMENT OF TRANSPORTATION**

**PAVEMENT MARKING AND SIGNING SHEETS  
IL ROUTE 8**

SCALE: 1"=50' SHEET 1 OF 4 SHEETS STA 121+50 TO STA 135+50

F.A.S. NO.	SECTION	COUNTY	TOTAL SHEETS	SHEET NO.
1388	(2-1)VBJR-2	PEORIA	235	74
CONTRACT NO. 68799				
ILLINOIS FED. AID PROJECT				

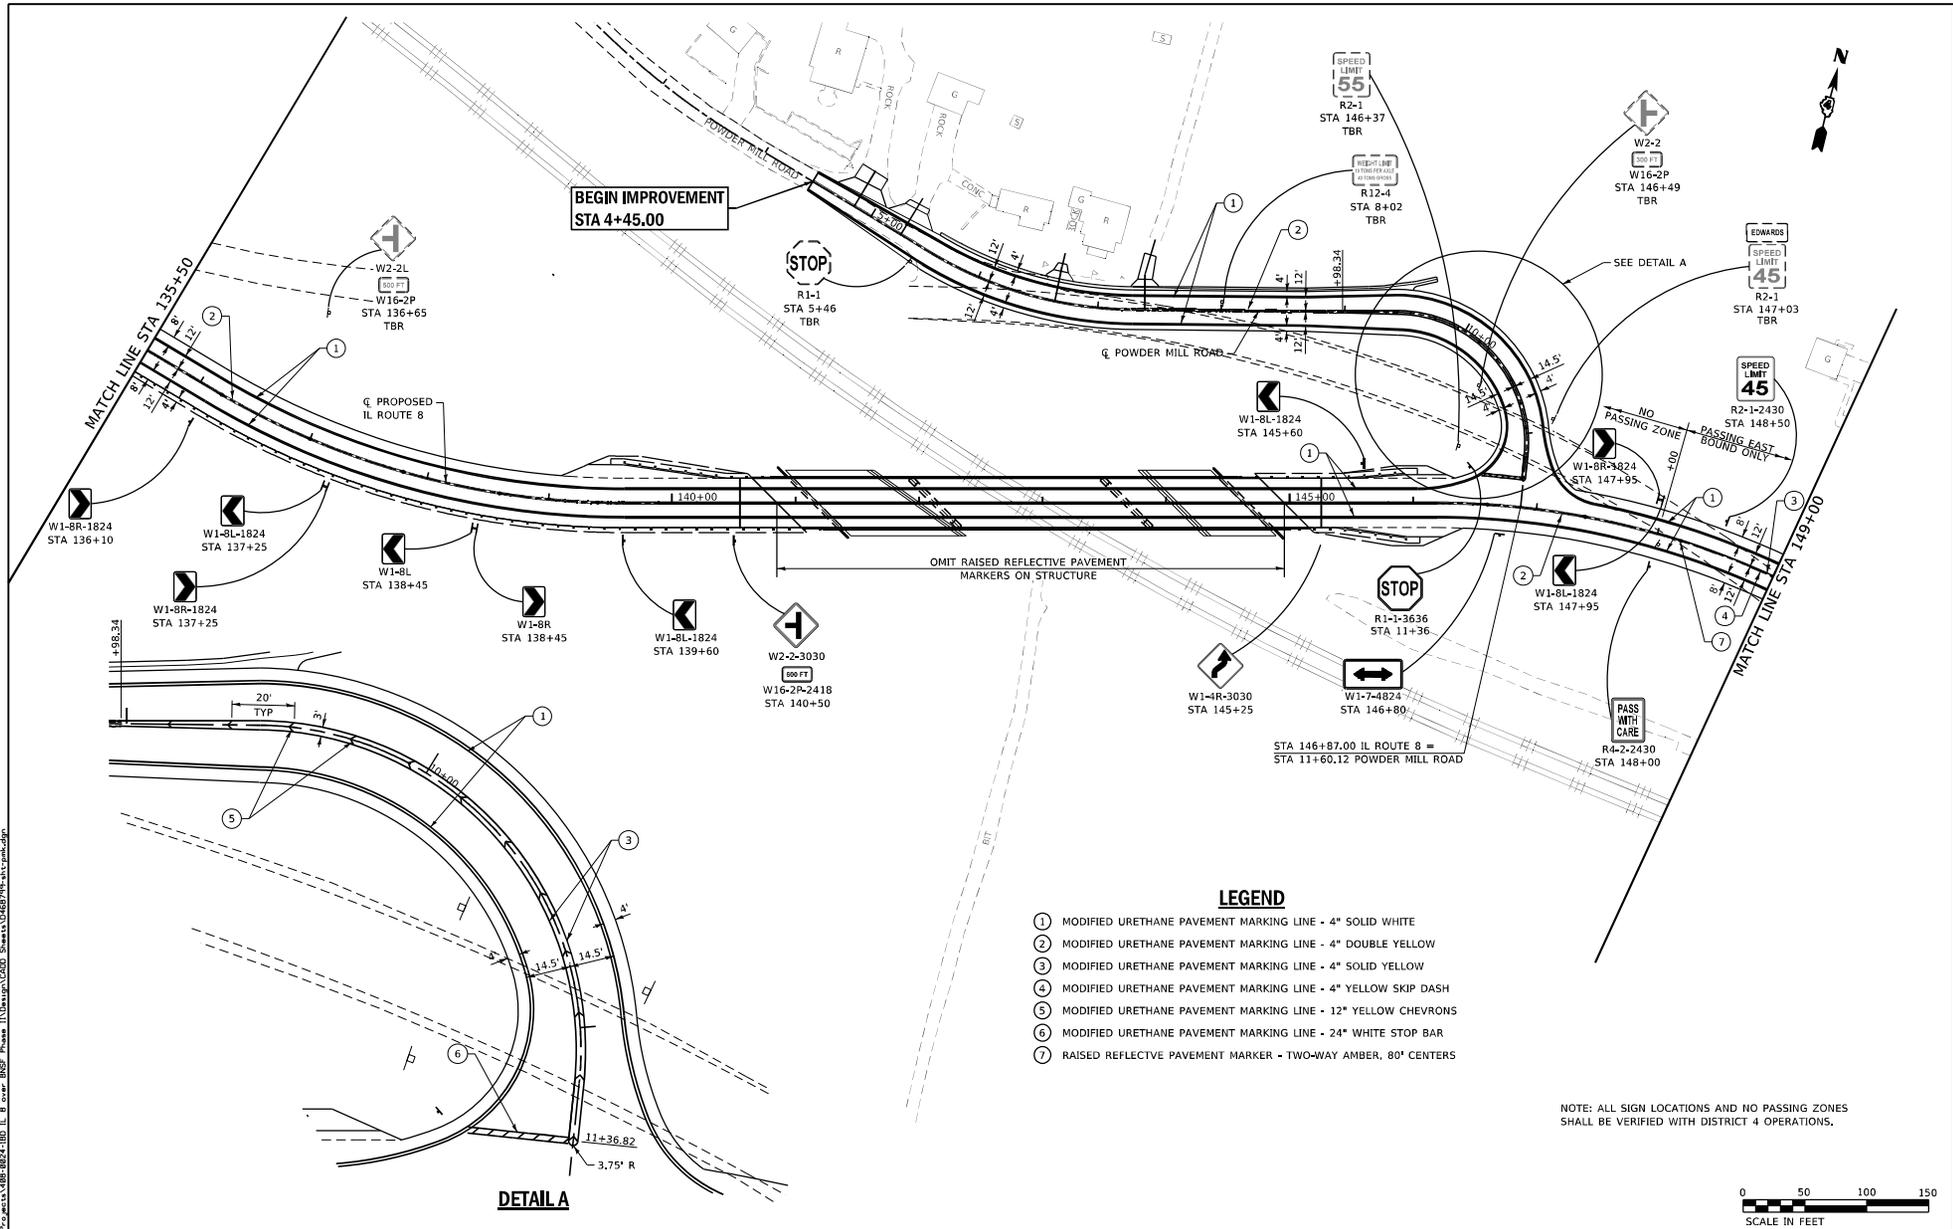

**BEGIN IMPROVEMENT  
STA 4+45.00**

OMIT RAISED REFLECTIVE PAVEMENT  
MARKERS ON STRUCTURE


**LEGEND**

- ① MODIFIED URETHANE PAVEMENT MARKING LINE - 4" SOLID WHITE
- ② MODIFIED URETHANE PAVEMENT MARKING LINE - 4" DOUBLE YELLOW
- ③ MODIFIED URETHANE PAVEMENT MARKING LINE - 4" SOLID YELLOW
- ④ MODIFIED URETHANE PAVEMENT MARKING LINE - 4" YELLOW SKIP DASH
- ⑤ MODIFIED URETHANE PAVEMENT MARKING LINE - 12" YELLOW CHEVRONS
- ⑥ MODIFIED URETHANE PAVEMENT MARKING LINE - 24" WHITE STOP BAR
- ⑦ RAISED REFLECTIVE PAVEMENT MARKER - TWO-WAY AMBER, 80" CENTERS

NOTE: ALL SIGN LOCATIONS AND NO PASSING ZONES  
SHALL BE VERIFIED WITH DISTRICT 4 OPERATIONS.



**DETAIL A**

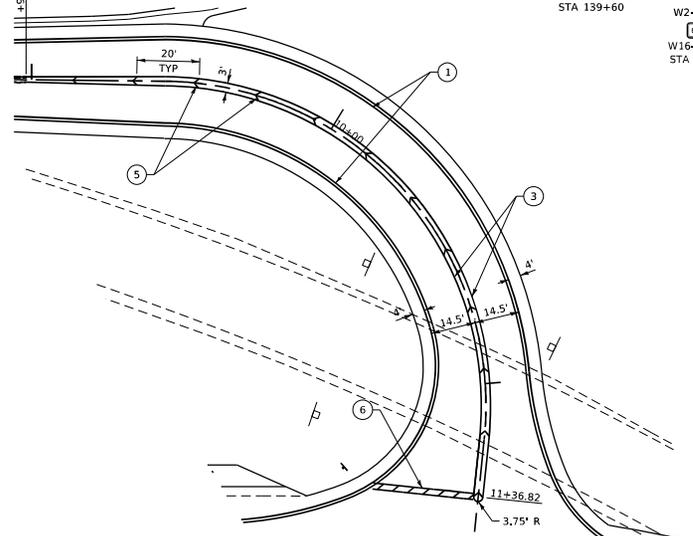

FILE NAME: S:\proj\2018\1808-1824-180 IL 8 over BNSF Phase 1\Drawings\GD01 Sheets\0468799\1808-1824-180 IL 8.dwg



USER NAME: Betsy  
 MODEL NAME: 02 Pink  
 PLOT SCALE: 100.0000"/PL  
 PLOT DATE: 8/22/2018

DESIGNED: JLS  
 DRAWN: PDB  
 CHECKED: ESW  
 DATE: 01-17-18


REVISED: -  
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 REVISED: -  
 REVISED: -

**STATE OF ILLINOIS  
DEPARTMENT OF TRANSPORTATION**

**PAVEMENT MARKING AND SIGNING SHEETS  
IL ROUTE 8**

SCALE: 1"=50' SHEET 2 OF 4 SHEETS STA 135+50 TO STA 149+00

F.A.S. NO.	SECTION	COUNTY	TOTAL SHEETS	SHEET NO.
1388	(2-1)VBRR-2	PEORIA	235	75
				CONTRACT NO. 68799
				ILLINOIS FED. AID PROJECT

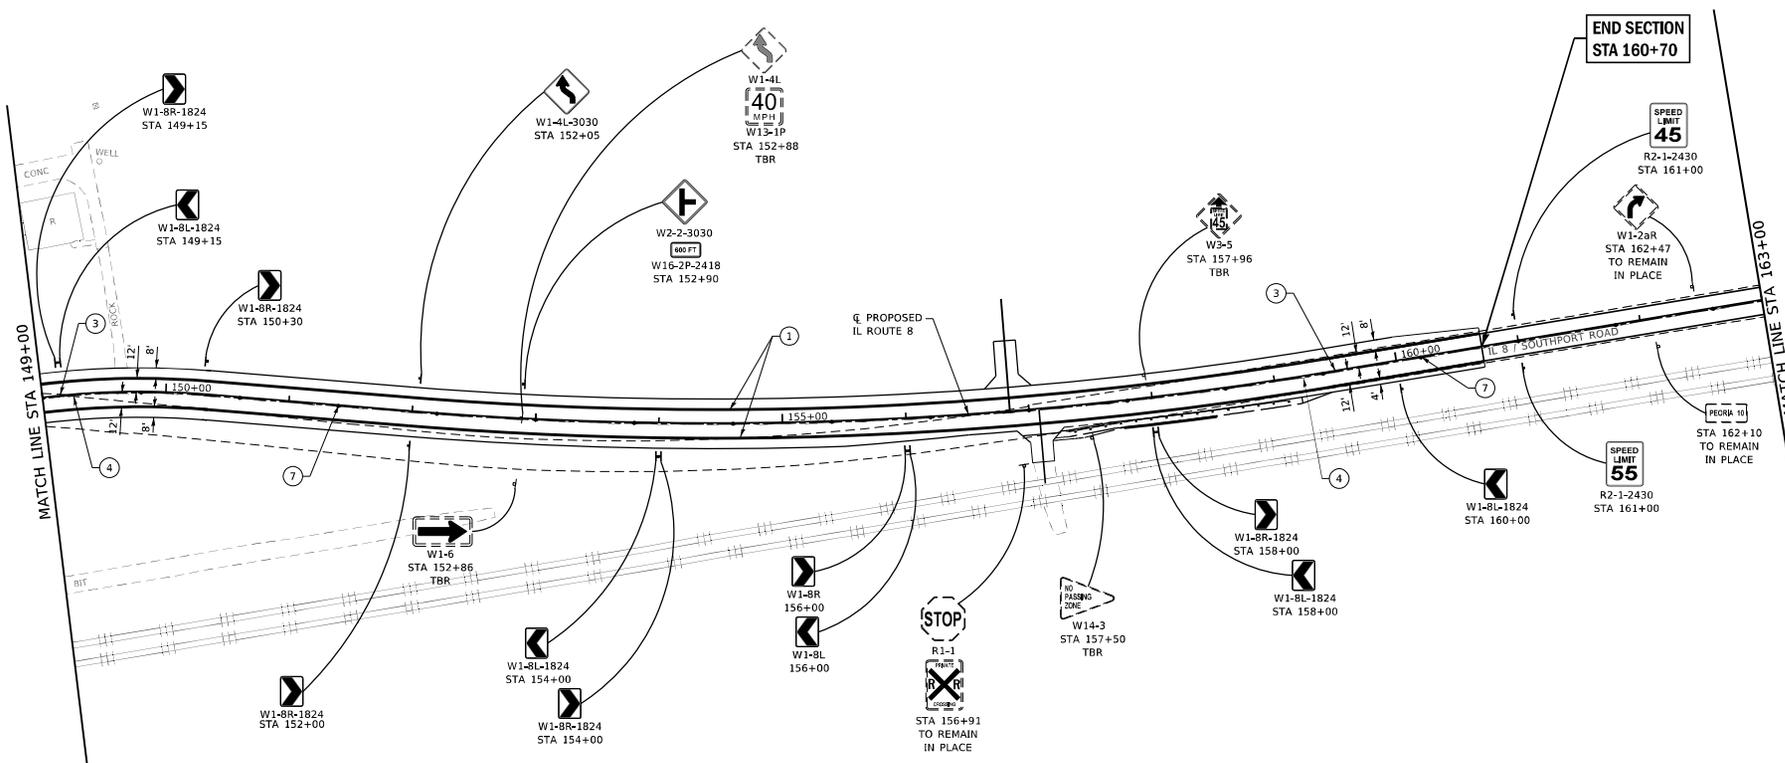

**LEGEND**

- ① MODIFIED URETHANE PAVEMENT MARKING LINE - 4" SOLID WHITE
- ② MODIFIED URETHANE PAVEMENT MARKING LINE - 4" DOUBLE YELLOW
- ③ MODIFIED URETHANE PAVEMENT MARKING LINE - 4" SOLID YELLOW
- ④ MODIFIED URETHANE PAVEMENT MARKING LINE - 4" YELLOW SKIP DASH
- ⑤ MODIFIED URETHANE PAVEMENT MARKING LINE - 12" YELLOW CHEVRONS
- ⑥ MODIFIED URETHANE PAVEMENT MARKING LINE - 24" WHITE STOP BAR
- ⑦ RAISED REFLECTIVE PAVEMENT MARKER - TWO-WAY AMBER, 80° CENTERS

NOTE: ALL SIGN LOCATIONS AND NO PASSING ZONES SHALL BE VERIFIED WITH DISTRICT 4 OPERATIONS.



FILE NAME: S:\proj\214\188-024-001\_IL\_8\_scar\_BNSF\_Plane\_IL\Output\000\_Sheet10.dwg




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MODEL NAME	• 03 Pmk	DRAWN	- PDB	REVISED	-
PLOT SCALE	• 100.0000"/PL	CHECKED	- ESW	REVISED	-
PLOT DATE	• 8/22/2019	DATE	• 01-17-18	REVISED	-

STATE OF ILLINOIS  
DEPARTMENT OF TRANSPORTATION

PAVEMENT MARKING AND SIGNING SHEETS  
IL ROUTE 8

SCALE: 1"=50'	SHEET	3	OF	4	SHEETS	STA 149+00 TO STA 163+00
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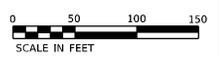
F.A.S. SITE	SECTION	COUNTY	TOTAL SHEETS	SHEET NO.
1388	(2-1)B)R-2	PEORIA	235	76
CONTRACT NO. 68799				
ILLINOIS   FED. AID PROJECT				

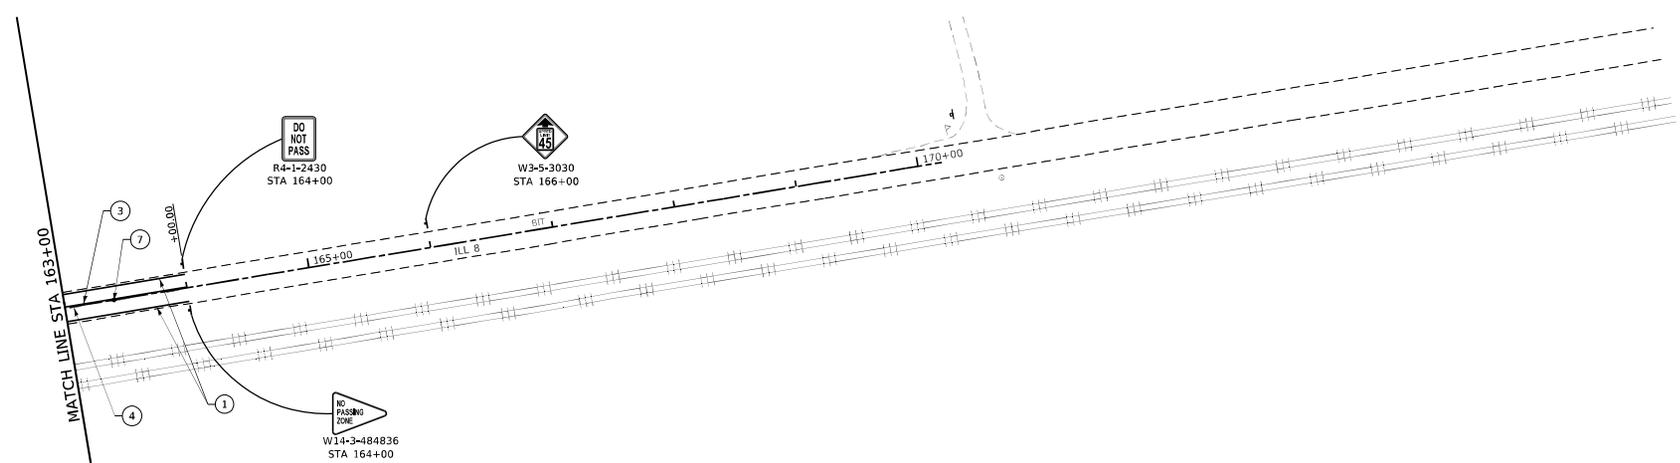

**LEGEND**

- ① MODIFIED URETHANE PAVEMENT MARKING LINE - 4" SOLID WHITE
- ② MODIFIED URETHANE PAVEMENT MARKING LINE - 4" DOUBLE YELLOW
- ③ MODIFIED URETHANE PAVEMENT MARKING LINE - 4" SOLID YELLOW
- ④ MODIFIED URETHANE PAVEMENT MARKING LINE - 4" YELLOW SKIP DASH
- ⑤ MODIFIED URETHANE PAVEMENT MARKING LINE - 12" YELLOW CHEVRONS
- ⑥ MODIFIED URETHANE PAVEMENT MARKING LINE - 24" WHITE STOP BAR
- ⑦ RAISED REFLECTIVE PAVEMENT MARKER - TWO-WAY AMBER, 80' CENTERS

NOTE: ALL SIGN LOCATIONS AND NO PASSING ZONES SHALL BE VERIFIED WITH DISTRICT 4 OPERATIONS.



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USER NAME	• Betsy	DESIGNED	- JLS	REVISED	-
MODEL NAME	• 04 Pink	DRAWN	- PDB	REVISED	-
PLOT SCALE	• 100.0000"/PL	CHECKED	- ESW	REVISED	-
PLOT DATE	• 8/22/2018	DATE	- 01-17-18	REVISED	-

DESIGNED	- JLS	REVISED	-
DRAWN	- PDB	REVISED	-
CHECKED	- ESW	REVISED	-
DATE	- 01-17-18	REVISED	-



**STATE OF ILLINOIS  
DEPARTMENT OF TRANSPORTATION**

**PAVEMENT MARKING AND SIGNING SHEETS  
IL ROUTE 8**

SCALE: 1"=50'	SHEET	4	OF	4	SHEETS	STA 163+00 TO STA 170+00.00
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F.A.S. SITE	SECTION	COUNTY	TOTAL SHEETS	SHEET NO.
1388	(2-1VB)BR-2	PEORIA	235	77
CONTRACT NO. 68799			ILLINOIS FED. AID PROJECT	

FILE NAME: S:\Projects\188-0824-IBD IL B over BNSF Phase II\Drawings\GD02 Sheets\0188799\Guardrail-Plan-Dwg.dwg

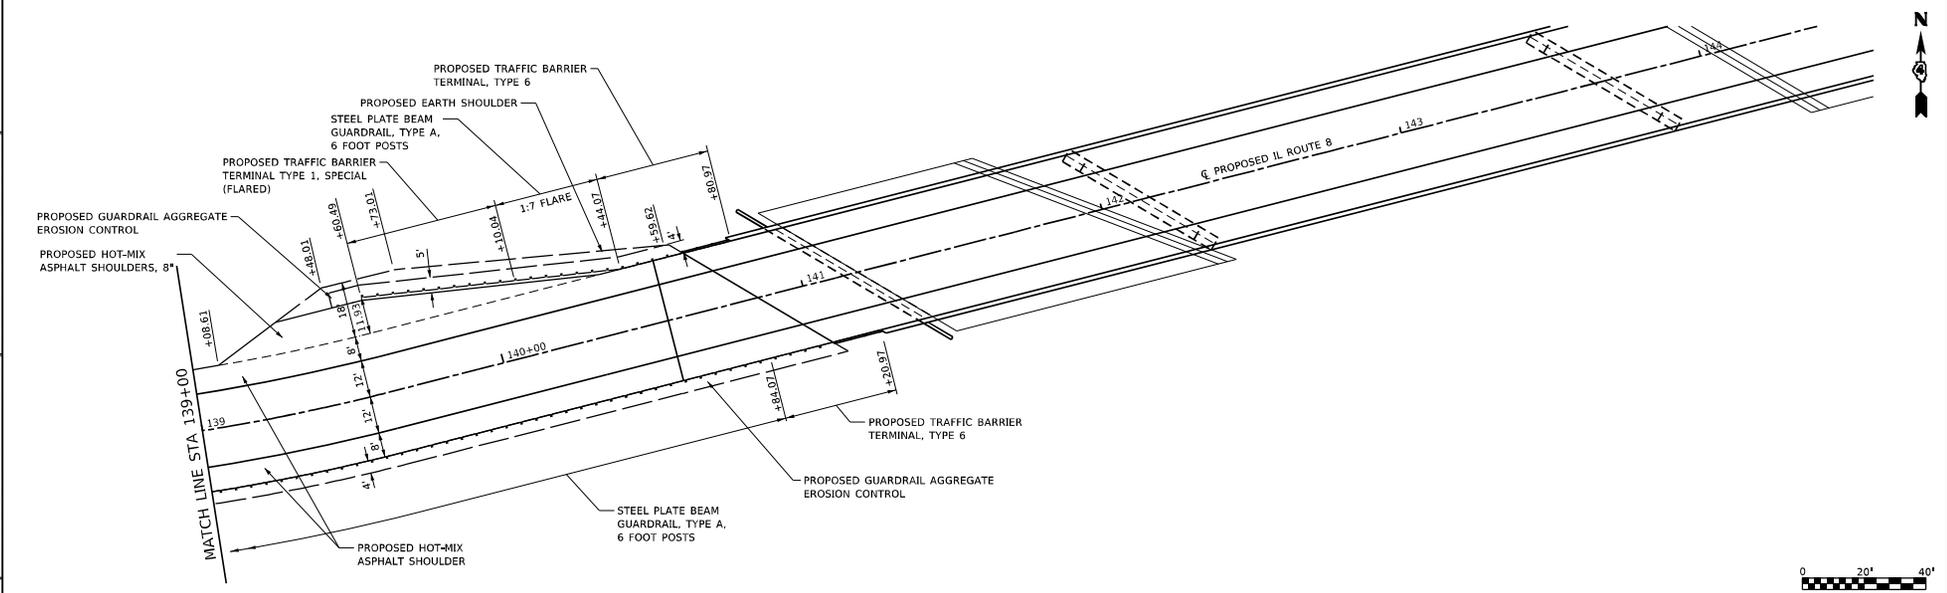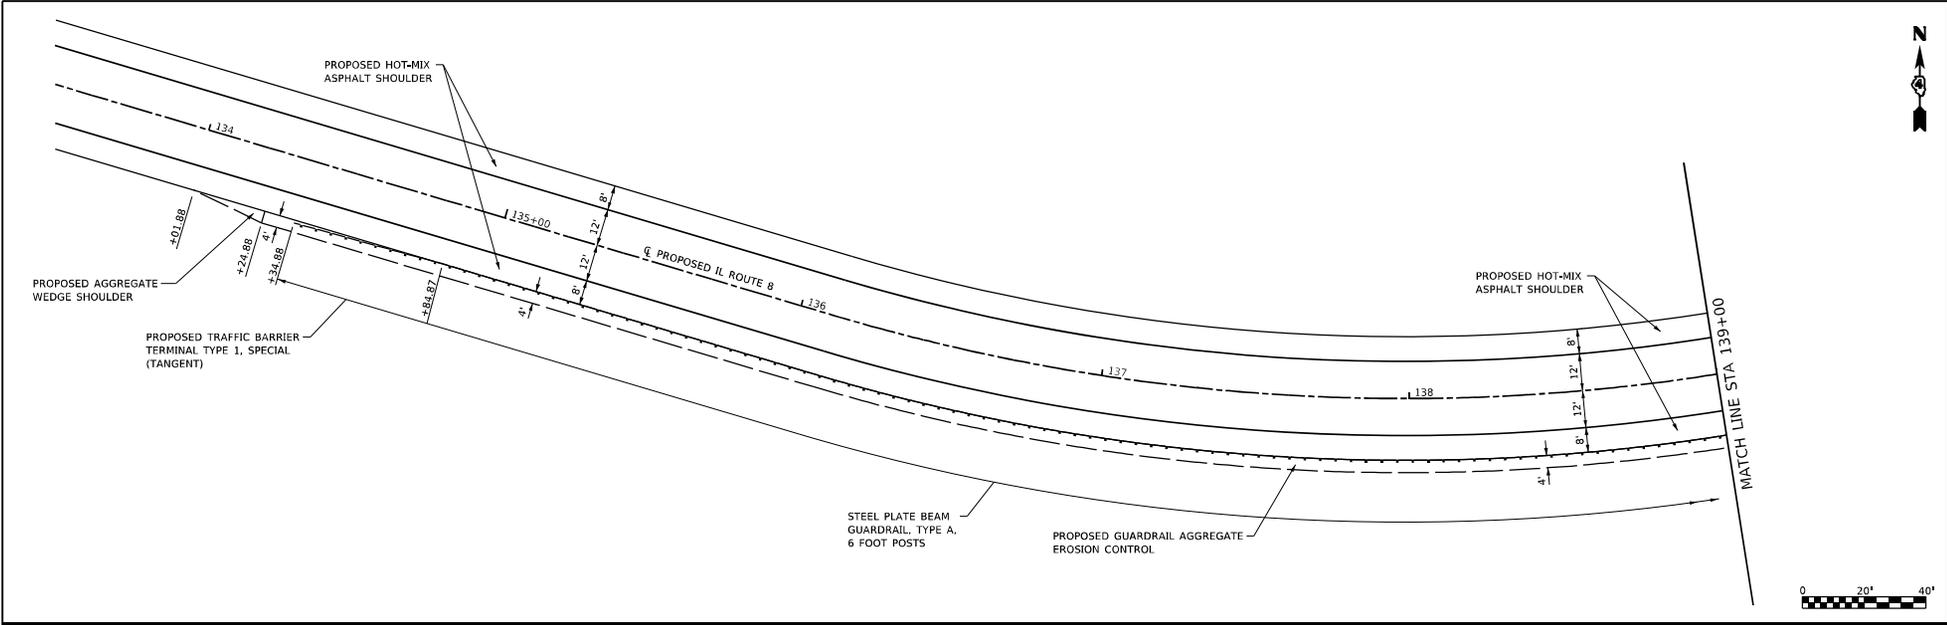

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MODEL NAME	• 01 GRD DET	DRAWN	- PDB	REVISED	-
PLOT SCALE	• 40,0000' / IN.	CHECKED	- ESW	REVISED	-
PLOT DATE	• 8/22/2019	DATE	- 01-17-18	REVISED	-



**STATE OF ILLINOIS  
DEPARTMENT OF TRANSPORTATION**

**GUARDRAIL DETAIL SHEETS  
IL ROUTE 8**

SCALE: 1"=20' SHEET 1 OF 2 SHEETS

F.A.S. SITE	SECTION	COUNTY	TOTAL SHEETS	SHEET NO.
1388	(2-1VB)BR-2	PEORIA	235	78
				CONTRACT NO. 68799
				ILLINOIS FED. AID PROJECT

FILE NAME: D:\WORK\MINNIPROD\SUBAREA\SUBAREA11\_8 over BNSF at EisenhowerPlan revisions IDOT post Loc. Final Subtotal E End with Mail\68799ah-Guardrail Plan.Dwg

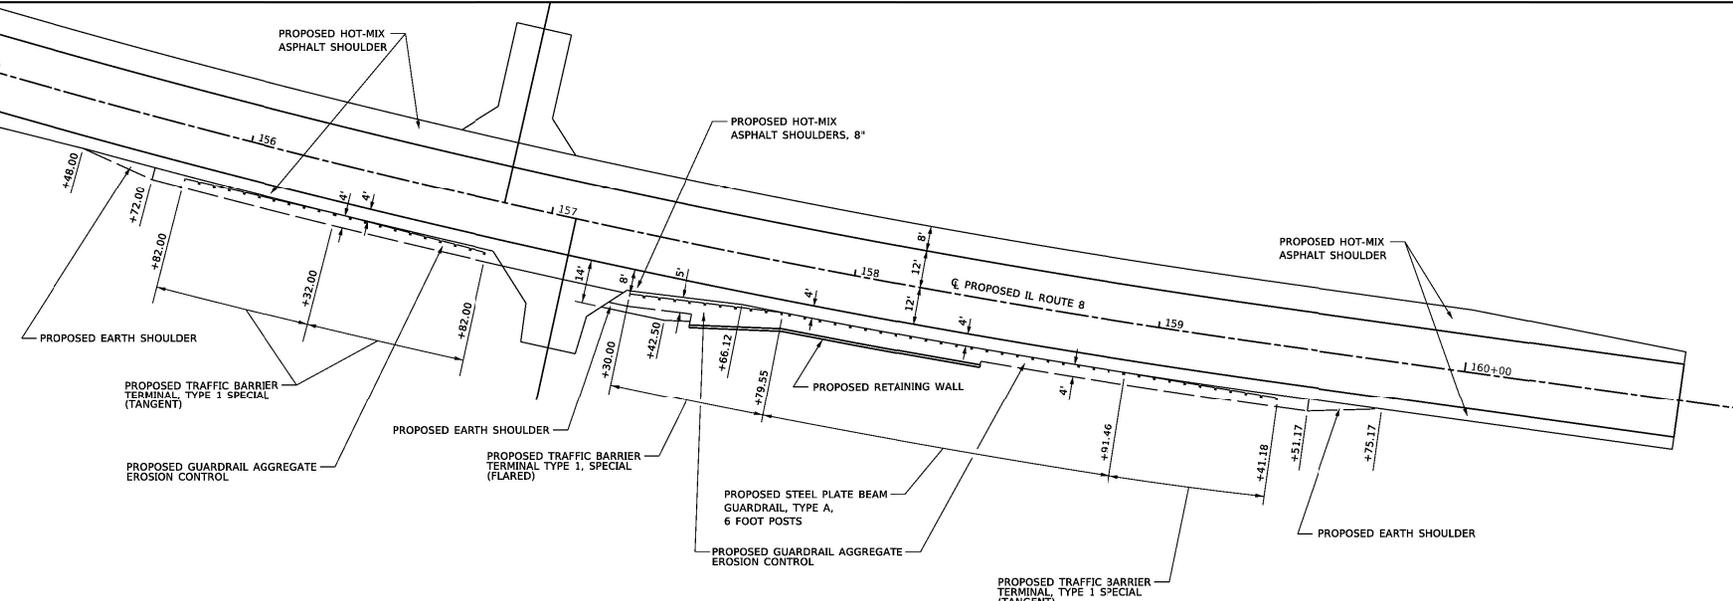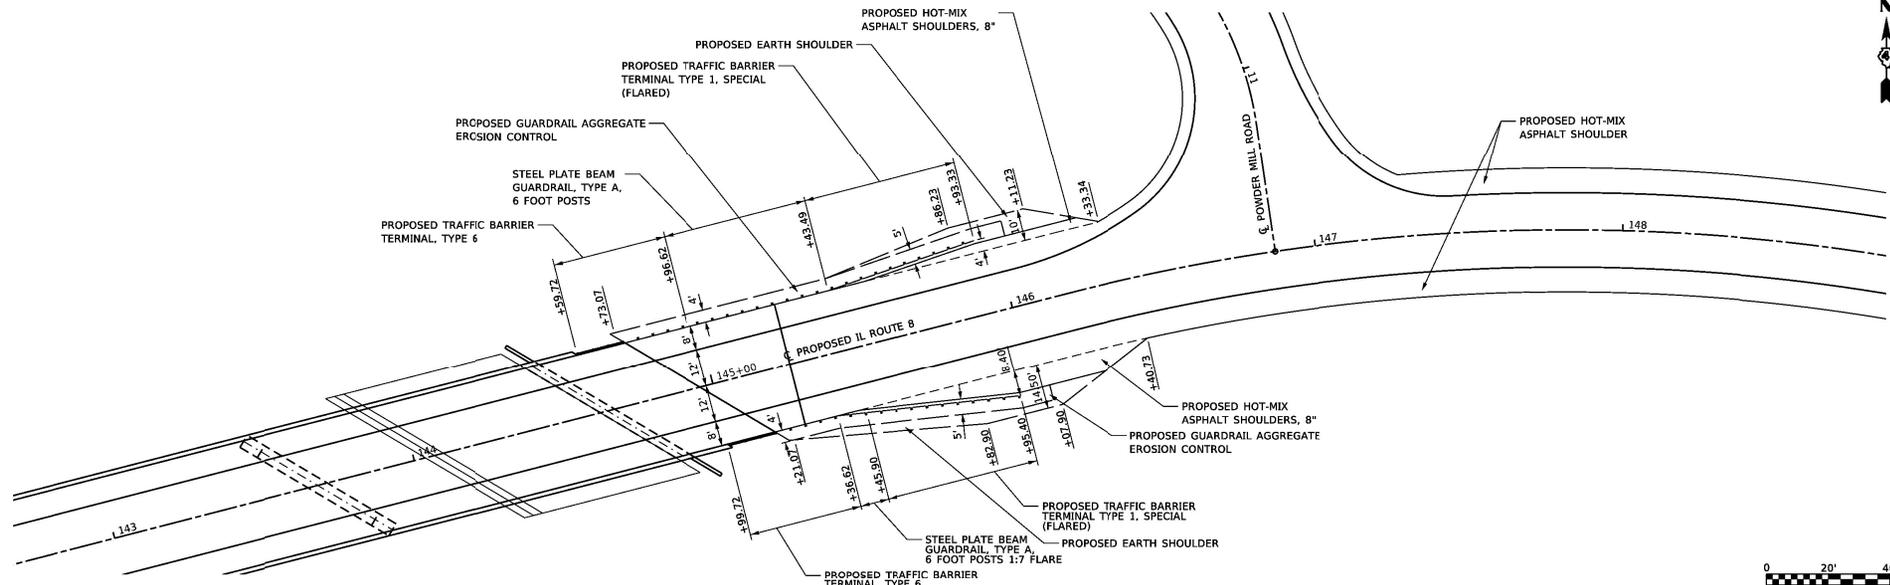

USER NAME - hor9th  
 MODEL NAME - 02 GRD DET  
 PLOT SCALE - 40.0000' / in.  
 PLOT DATE - 4/27/2021

DESIGNED - JLS  
 DRAWN - PDB  
 CHECKED - ESW  
 DATE - 01-17-18

REVISED - K.H. (IDOT) 04/27/21  
 REVISED -  
 REVISED -  
 REVISED -

**STATE OF ILLINOIS  
 DEPARTMENT OF TRANSPORTATION**

**GUARDRAIL DETAIL SHEETS  
 IL ROUTE 8**

SCALE: 1"=20' SHEET 2 OF 2 SHEETS

F.A.S. RTE.	SECTION	COUNTY	TOTAL SHEETS	SHEET NO.
1388	(Z-1V)BR-2	PEORIA	235	79
CONTRACT NO. 68799				
ILLINOIS FED. AID PROJECT				













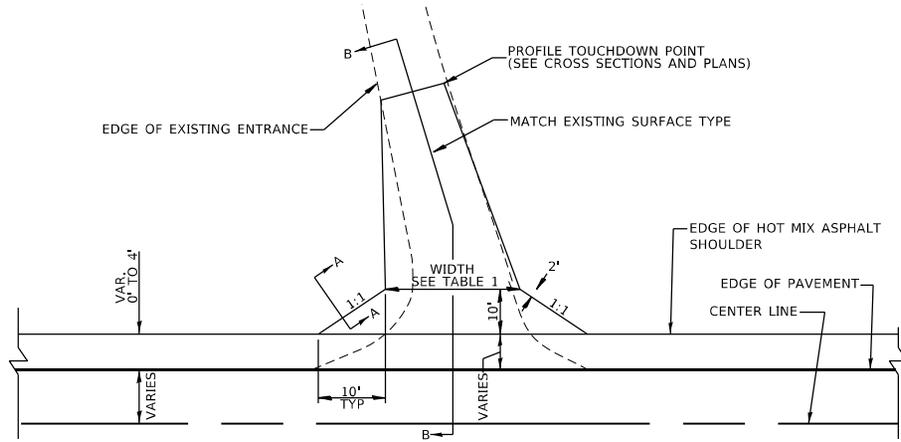

**PLAN**  
RURAL ENTRANCE

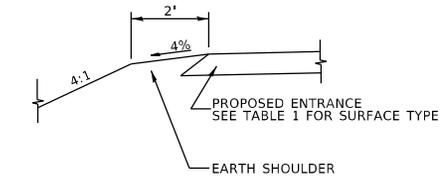


**SECTION A-A**  
SHOULDER TREATMENT FOR RURAL ENTRANCES

TABLE 1		
RURAL ENTRANCE DESIGN		
ELEMENT	NON-COMMERCIAL	
WIDTH (W)	12' MIN.	24' MAX.
FLARE	1:1.5	
MAX. GRADE (G)	12%	
SURFACE TYPE		
INCIDENTAL HOT MIX ASPHALT SURFACING	6"	
AGGREGATE SURFACE COURSE	6"	
PCC DRIVEWAY PAVEMENT	6"	

**GENERAL NOTES - RURAL ENTRANCES**

- ENTRANCES SHALL SLOPE AWAY FROM THE PAVEMENT AT A RATE EQUAL TO THE SHOULDER SLOPE FOR THE WIDTH OF THE SHOULDER.

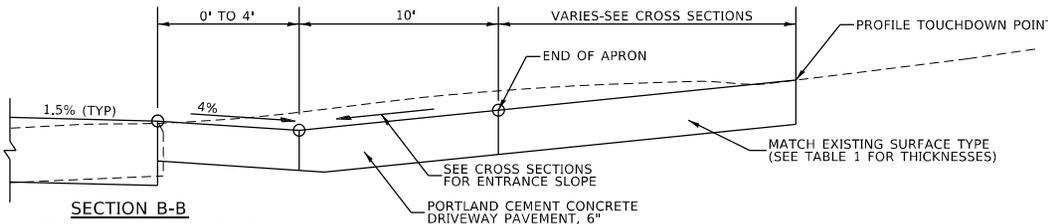


**SECTION B-B**  
RECONSTRUCTED RURAL ENTRANCE  
(EXISTING ENTRANCE HIGHER THAN APRON)


**GENERAL NOTES - URBAN ENTRANCE**

- COMBINATION CONCRETE CURB & GUTTER SHALL BE DEPRESSED IN ACCORDANCE WITH STANDARD 606001.
- COMBINATION CONCRETE CURB & GUTTER WILL BE MEASURED FOR PAYMENT AS SPECIFIED IN ARTICLE 606.13 OF THE STANDARD SPECIFICATIONS.
- COMBINATION CONCRETE CURB & GUTTER CONSTRUCTION JOINTS WILL BE AS SHOWN ON STANDARD 606001.
- EXCEPTIONS TO THE RADIUS FLARE/PROPERTY LINE RELATIONSHIP ARE AS SHOWN IN THE PLANS FOR COMMON ENTRANCES, WITH JOINTLY EXECUTED ACCESS PERMITS.

TABLE 2		
URBAN ENTRANCE DESIGN CONTROLS		
ELEMENT	NON-COMMERCIAL	
WIDTH (W)	12' MIN.	24' MAX.
RADIUS EQUIVALENT 1:1 FLARE (F)	5' MIN.	25' MAX.
MAX. GRADE (G)	12%	

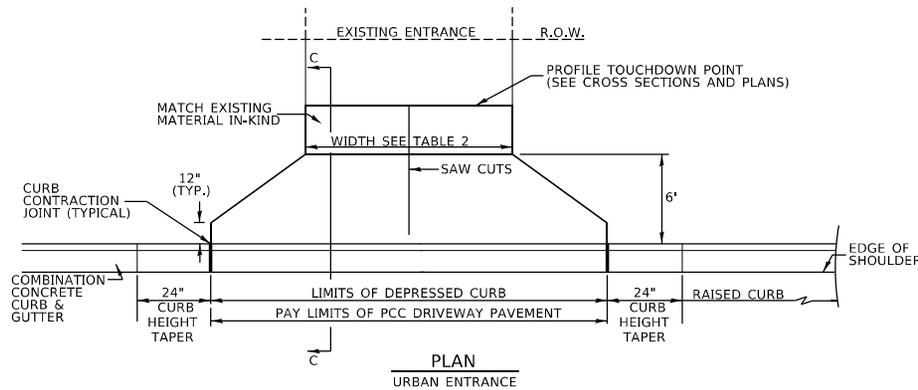

**PLAN**  
URBAN ENTRANCE

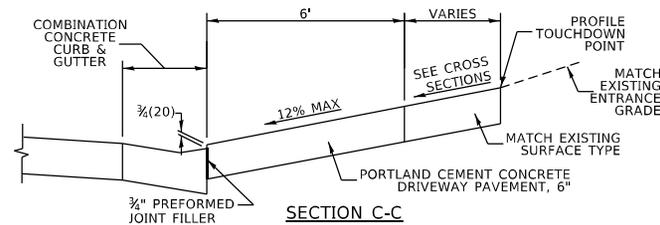

**SECTION C-C**

ALL DIMENSIONS ARE IN INCHES UNLESS OTHERWISE NOTED.

FILE NAME: S:\Proje\114\11488-024-001 IL B over BNSF Phase 1\Urban\11488-024-001\_Sheet1.DWG Date: 08/22/2019



USER NAME: Betsy  
 MODEL NAME: DTI-201 Etek  
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 PLOT DATE: 8/22/2019

DESIGNED: JLS  
 DRAWN: PDB  
 CHECKED: ESW  
 DATE: 01-17-18


REVISED: -  
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 REVISED: -

STATE OF ILLINOIS  
 DEPARTMENT OF TRANSPORTATION

ENTRANCE DETAILS  
 POWDER MILL ROAD


SCALE: 1"=5' SHEET 1 OF 1 SHEETS

F.A.S. SITE	SECTION	COUNTY	TOTAL SHEETS	SHEET NO.
1388	(2-1V)BR-2	PEORIA	235	84
				CONTRACT NO. 68799
ILLINOIS FED. AID PROJECT				

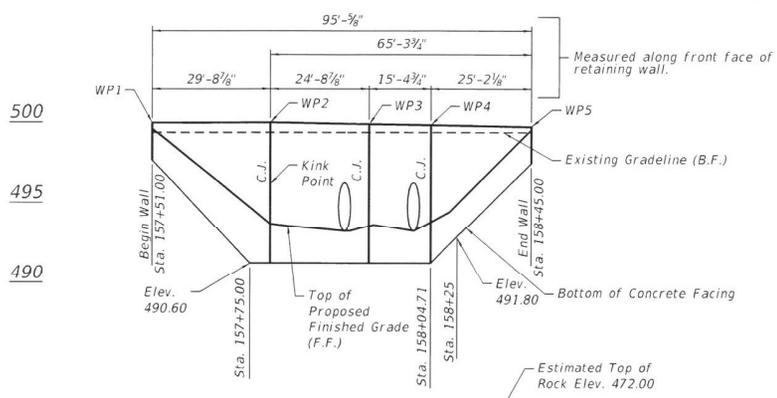

(Looking at F.F. of wall)  
Vertical scale exaggerated 4x for clarity

C.J. = Construction Joint

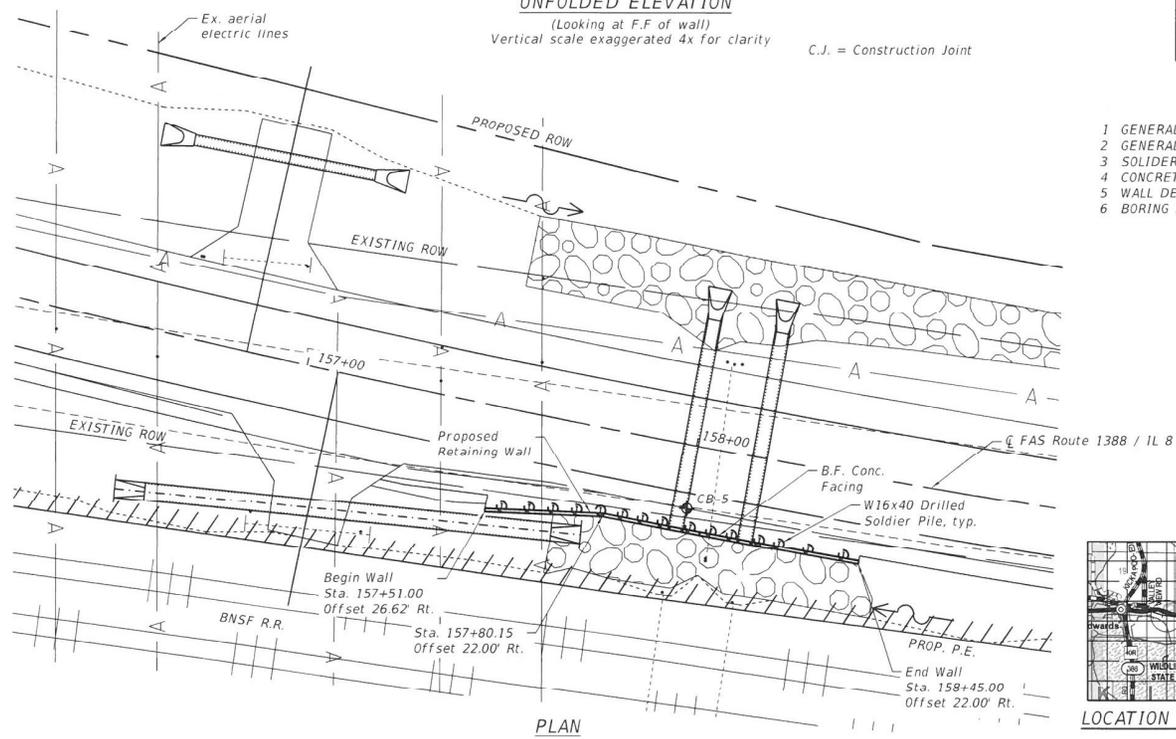

**LOCATION SKETCH**

**WORK POINT TABLE**

WP No.	Cent Segment	Offset in Feet	Top of C.I.P Wall Elev.	Bott. of C.I.P Wall Elev.
1	157+51.00	26.62 Rt.	499.34	496.80
2	157+80.15	22.00 Rt.	499.36	490.60
3	158+04.71	22.00 Rt.	499.26	490.60
4	158+20.00	22.00 Rt.	499.21	490.60
5	158+45.00	22.00 Rt.	499.11	496.50

Note: All offsets are to front face of wall.

**TOTAL BILL OF MATERIAL**

ITEM	UNIT	TOTAL
Structure Excavation	Cu. Yd.	76
Furnishing Soldier Piles, (W Section)	Foot	477
Drilling and Setting Soldier Piles (In Soil)	Cu. Ft.	1898
Drilling and Setting Soldier Piles (In Rock)	Cu. Ft.	442
Concrete Structures	Cu. Yd.	20.8
Geocomposite Wall Drain	Sq. Yd.	37
Reinforcement bars, Epoxy Coated	Pound	3300
Untreated Timber Lagging	Sq. Ft.	508
Stud Shear Connectors	Each	113

**INDEX OF SHEETS**

- 1 GENERAL PLAN & ELEVATION
- 2 GENERAL NOTES & TYPICAL SECTIONS
- 3 SOLDIER PILE LAYOUT
- 4 CONCRETE LAYOUT
- 5 WALL DETAILS
- 6 BORING LOG

**DESIGN SPECIFICATIONS**

2020 AASHTO LRFD Bridge Design Specifications, 9th Edition

**DESIGN STRESSES**

**FIELD STRESSES**

$f'_c = 3,500$  psi  
 $f_y = 60,000$  psi (Reinforcement)  
 $f_y = 36,000$  psi (Soldier Piles)  
 AASHTO M270 Grade 36



Mary Coonle Blodgett  
 ILLINOIS STRUCTURAL NO. 4859  
 EXPIRES 11/30/22  
 DATE: 12/09/2020

**GENERAL PLAN AND ELEVATION**

**RETAINING WALL**  
**IL ROUTE 8 (SOUTHPORT RD.)**  
**F.A.S. 1388 - SEC. (Z-1VB)BR-2**  
**PEORIA COUNTY**  
**STATION 157+51 TO 158+45**

MODEL: D:\dmr\...  
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 FEHR GRAHAM PROJECT NUMBER: 15-1016L




USER NAME	DESIGNED	REVISION
mblaxdbrf	MCB	-
	CHKD	RJM
	DRWN	RIN/CFC
	CHKD	MCB

**STATE OF ILLINOIS**  
**DEPARTMENT OF TRANSPORTATION**

**IL 8 RETAINING WALL STA. 158+51 TO STA. 158+45**  
**GENERAL PLAN**

F.A.S. RTE.	SECTION	COUNTY	TOTAL SHEETS	SHEET NO.
1388	(Z-1VB)BR-2	PEORIA	235	84A
				CONTRACT NO. 68799
ILLINOIS FED. AID PROJECT				

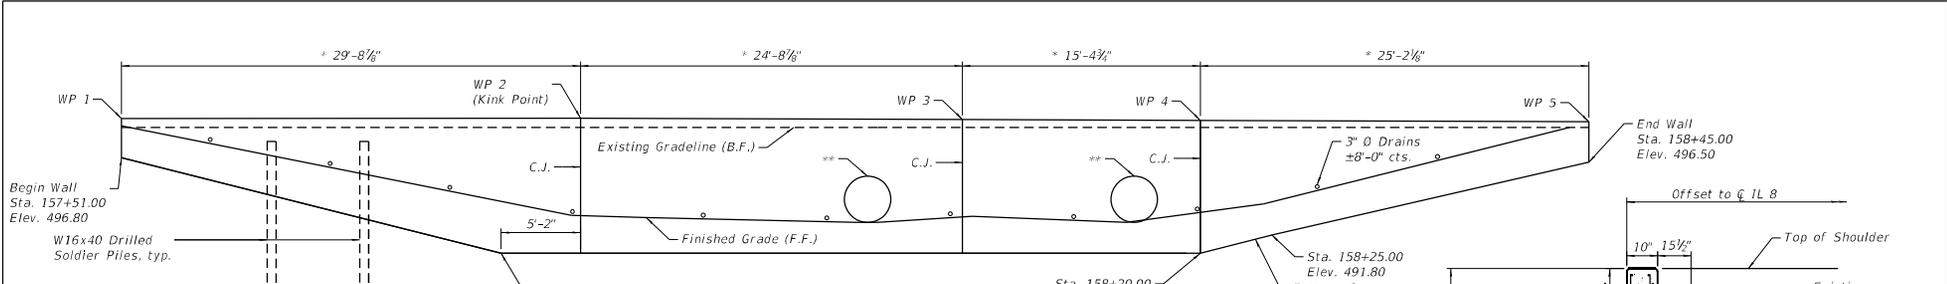

**UNFOLDED ELEVATION**  
(Looking north at front face of retaining wall)


C.J. = Construction Joint  
 \*Measured along the front face of the retaining wall.  
 \*\*36" RCP - See Roadway plans.  
 F.F. Front Face  
 B.F. Back Face

**GENERAL NOTES**

1. Reinforcement bars designated (E) shall be epoxy coated.
2. The Contractor is responsible for the design and performance of the lagging using no less than a 3 in. nominal rough-sawn thickness and timber with a minimum allowable bending stress of 1000 psi.
3. Offsets are to CL piles.
4. Pile lengths are based on minimum embedment below estimated rock elevation of 472.00. If rock elevation is found to be below 471.50, contact the Engineer before setting soldier piles.
5. Structure Excavation is measured 2'-0" from front face of wall to back of drilled shaft timber lagging.
6. Wall to be built along straight chords between workpoints.

**SEQUENCE OF CONSTRUCTION**

1. Drill shaft excavation for Soldier Piles to the elevation shown on the plans and set soldier piles in excavation.
2. Place soldier pile encasement concrete to the bottom of facing elevation at each pile location. Place Controlled Low Strength Material (CLSM) to the elevation of the existing ground or top of pile, whichever is lower at the front flange at each pile location.
3. Excavate in front of the wall to the bottom of the CIP facing by placing timber lagging downward.
4. Once the embankment behind the wall is complete the cast in place facing shall be installed.

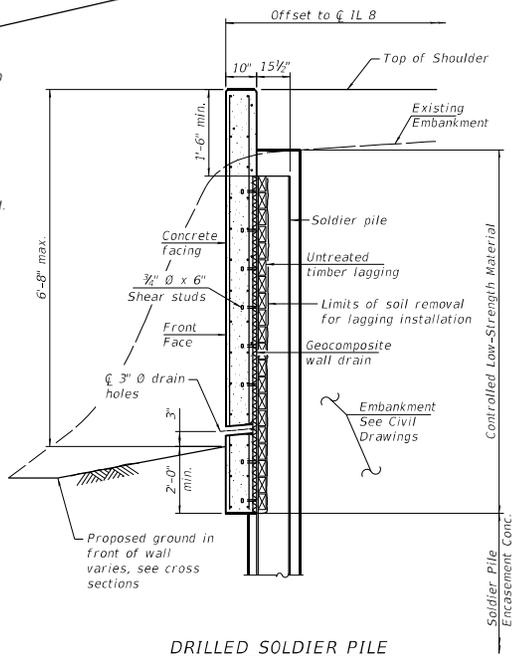

**DRILLED SOLDIER PILE TYPICAL WALL SECTION**  
(Looking Downstation)

**FEHR GRAHAM**  
 ENGINEERING & ENVIRONMENTAL  
 ILLINOIS DESIGN FIRM NO. 84-003525

USER NAME = mlbxdorf	DESIGNED = MCB	REVISIONS
CHECKED = RJM	REVISIONS	
PLOT SCALE = 8:0.000000 " = 1" / in.	DRAWN = CFC	REVISIONS
PLOT DATE = 12/9/2020	CHECKED = MCB	REVISIONS

STATE OF ILLINOIS  
 DEPARTMENT OF TRANSPORTATION

**GENERAL NOTES & TYPICAL SECTIONS**

SHEET 2 OF 6 SHEETS


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CONTRACT NO. 68799				ILLINOIS FED. AID PROJECT

MODEL: DRIFAILL  
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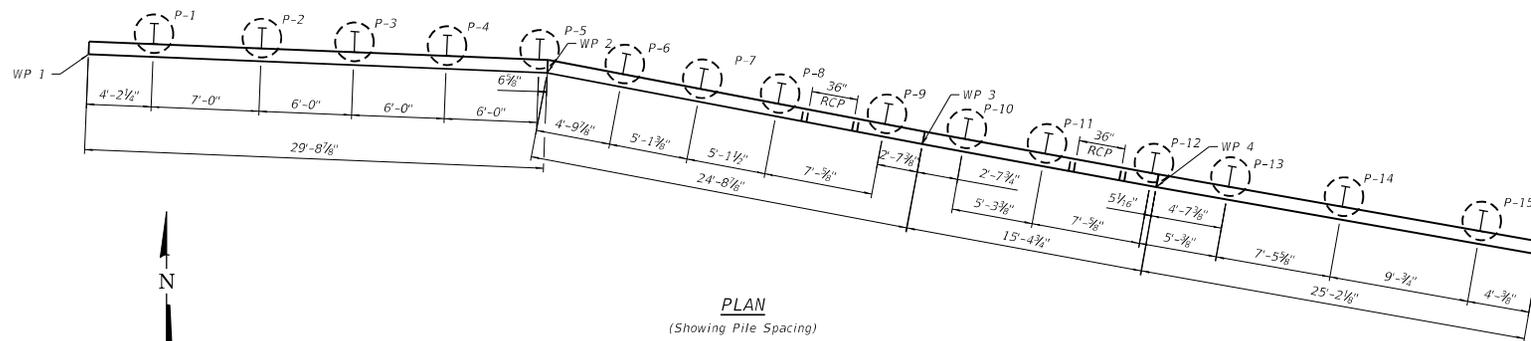
FEHR GRAHAM PROJECT NUMBER: 15-10161

**PILE SCHEDULE**

Soldier Pile No.	Size	Station	Offset	Top of Pile Elevation	Bottom of Pile Elevation	Pile Length	No. of Studs Per Pile
1	W16x40	157+54.86	24.47	497.84	466.00	31.75	4
2	W16x40	157+61.72	23.37	497.84	466.00	31.75	6
3	W16x40	157+67.60	22.43	497.85	466.00	31.75	8
4	W16x40	157+73.49	21.51	497.85	466.00	31.75	9
5	W16x40	157+79.38	20.60	497.86	466.00	31.75	9
6	W16x40	157+84.94	20.48	497.84	466.00	31.75	9
7	W16x40	157+90.02	20.48	497.82	466.00	31.75	9
8	W16x40	157+95.11	20.48	497.80	466.00	31.75	9
9	W16x40	158+02.11	20.49	497.78	466.00	31.75	9
10	W16x40	158+07.34	20.49	497.76	466.00	31.75	9
11	W16x40	158+12.58	20.49	497.74	466.00	31.75	9
12	W16x40	158+19.58	20.50	497.71	466.00	31.75	8
13	W16x40	158+24.58	20.48	497.69	466.00	31.75	7
14	W16x40	158+32.00	20.47	497.66	466.00	31.75	5
15	W16x40	158+41.00	20.49	497.63	466.00	31.75	3

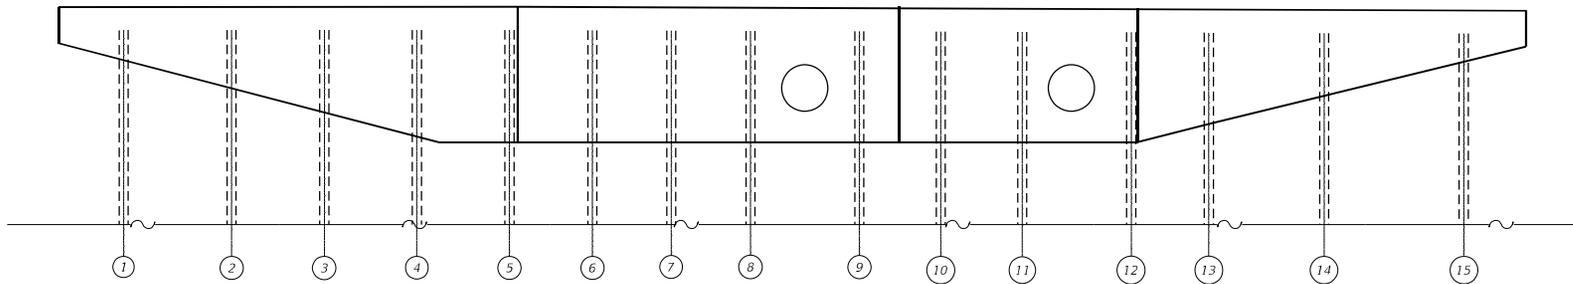

**ELEVATION**  
(Looking north at F.F. of wall)



**PLAN**  
(Showing Pile Spacing)

MODEL: D:\FAHILL  
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 FEHR GRAHAM PROJECT NUMBER: 15-1016L

**FEHR GRAHAM**  
ENGINEERING & ENVIRONMENTAL  
ILLINOIS DESIGN FIRM NO. 04-003525


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CHECKED = RJM	DRAWN = RJM	REVISED =
PLOT SCALE = 8:0.000000 " = 1" / in.	CHECKED = MCB	REVISED =
PLOT DATE = 12/9/2020		

STATE OF ILLINOIS  
DEPARTMENT OF TRANSPORTATION

**SOLDIER PILE LAYOUT**

SHEET 3 OF 6 SHEETS

F.A.S. SITE: 138B	SECTION: (7-1VB)B-2	COUNTY: PEORIA	TOTAL SHEETS: 235	SHEET NO.: 84C
			CONTRACT NO. 68799	
ILLINOIS FED. AID PROJECT				

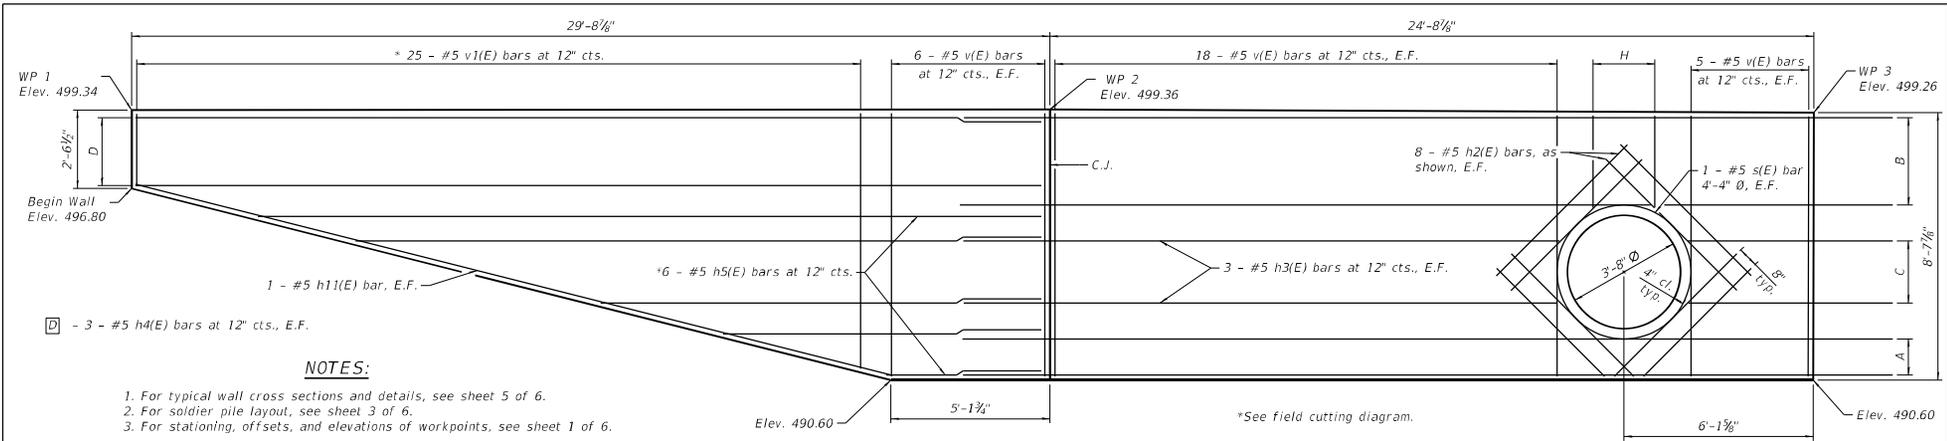

**NOTES:**

1. For typical wall cross sections and details, see sheet 5 of 6.
2. For soldier pile layout, see sheet 3 of 6.
3. For stationing, offsets, and elevations of workpoints, see sheet 1 of 6.

- E** - 3 - #5 h6(E) bars at 12" cts., E.F.
- F** - 3 - #5 h7(E) bars at 12" cts., E.F.
- G** - 4 - #5 h8(E) bars at 12" cts., E.F.
- L** - 3 - #5 v(E) bars at 12" cts., E.F.
- V** - 3 - #5 v2(E) bars at 12" cts., E.F.

**ELEVATION**

(looking north, showing reinforcement)

**LEGEND:**

C.J. = Construction Joint  
E.F. = Each Face


- A** - 3 - #5 h(E) bars at 12" cts., E.F.
- B** - 4 - #5 h(E) bars at 12" cts., E.F.
- C** - 3 - #5 h1(E) bars at 12" cts., E.F.
- H** - 3 - #5 v2(E) bars at 12" cts., E.F.

**BILL OF MATERIAL**

Bar	No.	Size	Length	Shape
h1(E)	14	#5	28'-3"	—
h1(E)	6	#5	4'-2"	—
h2(E)	32	#5	6'-0"	—
h3(E)	6	#5	20'-4"	—
h4(E)	6	#5	29'-5"	—
h5(E)	6	#5	30'-6"	—
h6(E)	6	#5	15'-2"	—
h7(E)	6	#5	9'-0"	—
h8(E)	8	#5	19'-0"	—
h9(E)	8	#5	24'-10"	—
h10(E)	5	#5	28'-9"	—
h11(E)	2	#5	25'-3"	—
h12(E)	2	#5	25'-6"	—
v(E)	84	#5	8'-3"	—
v1(E)	25	#5	10'-5"	—
v2(E)	12	#5	3'-0"	—
v3(E)	26	#5	10'-6"	—
s(E)	4	#5	16'-5"	○
Concrete Structures		Cu. Yd.	20.8	
Reinforcement Bars, Epoxy Coated		Pound	3300	

**MIN. BAR LAP**

#5 BARS = 3'-7" (Horizontal)

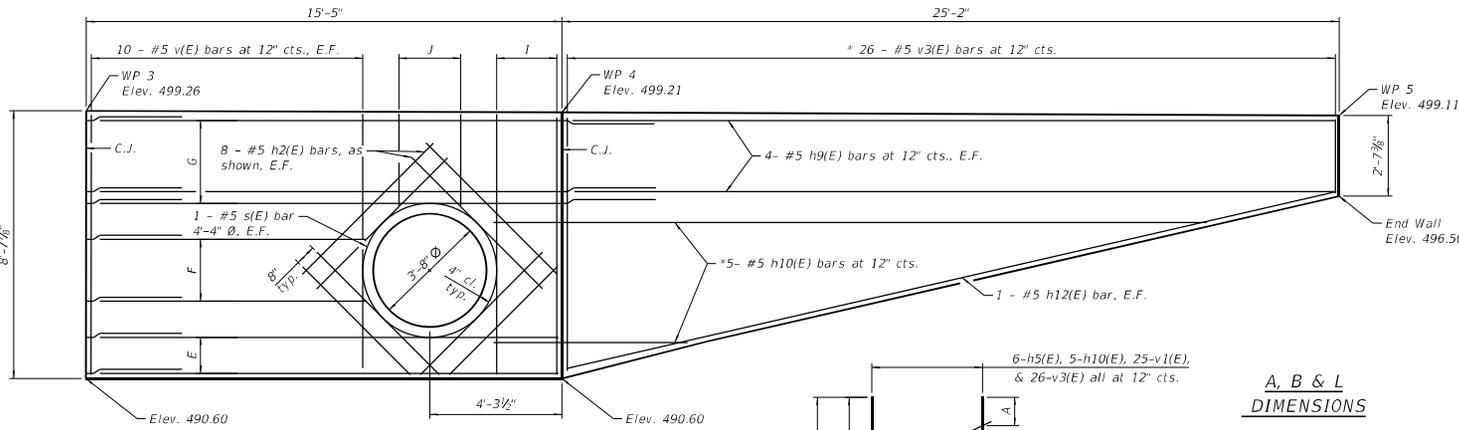

**ELEVATION**


(looking north, showing reinforcement)

**A, B & L DIMENSIONS**

Bar	A	B	L
h5(E)	5'-2"	25'-4"	30'-6"
h10(E)	6'-0"	22'-9"	28'-9"
v1(E)	2'-3"	8'-2"	10'-5"
v3(E)	2'-3"	8'-3"	10'-6"

**FIELD CUTTING DIAGRAM**

Order h5(E), h10(E), v1(E) and v3(E) full length. Cut as shown and use remainder of bars in opposite face of wall.

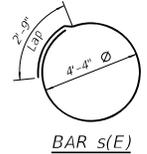

**BAR s(E)**

**FEHR GRAHAM**  
ENGINEERING & ENVIRONMENTAL  
ILLINOIS DESIGN FIRM NO. 84-003525

USER NAME - mlofoxdorf	DESIGNED - RJM	REVISIONS -
	CHECKED - MCB	REVISIONS -
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PLOT DATE - 12/9/2020	CHECKED - MCB	REVISIONS -


**STATE OF ILLINOIS  
DEPARTMENT OF TRANSPORTATION**

**CONCRETE FACING**

SHEET 4 OF 6 SHEETS


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CONTRACT NO. 68799				
ILLINOIS FED. AID PROJECT				

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**CONSTRUCTION JOINT DETAIL**

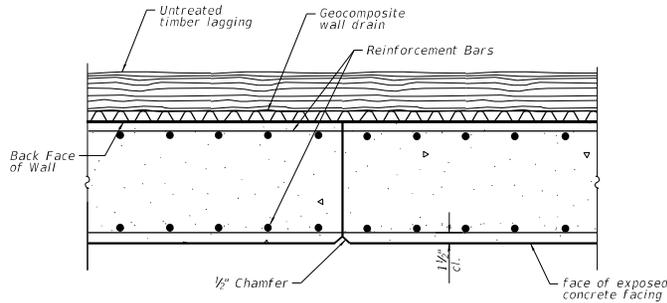Reinforcement to pass thru joint




**WEEP HOLE DRAIN DETAIL**

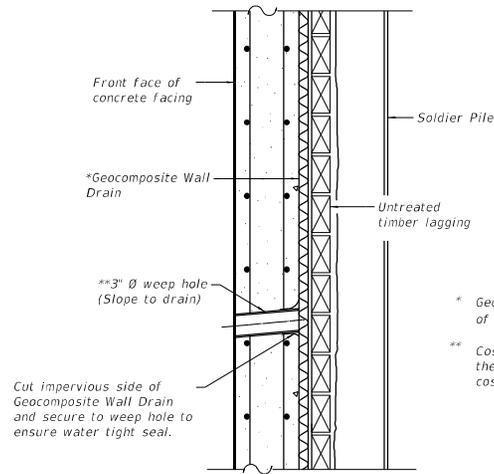Cut impervious side of Geocomposite Wall Drain and secure to weep hole to ensure water tight seal.

\* Geocomposite Wall Drain not to exceed thickness of 3/4".

\*\* Cost of the weep hole drain and connection to the Geocomposite Wall Drain are included in the cost of Concrete Structures.

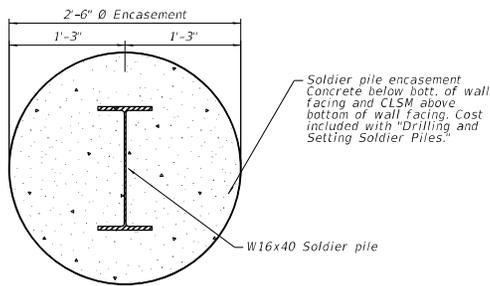


**SECTION THRU SOLDIER PILE**

Typical at Soldier Piles

Soldier pile encasement  
Concrete below bott. of wall facing and CLSM above bottom of wall facing. Cost included with "Drilling and Setting Soldier Piles."

W16x40 Soldier pile

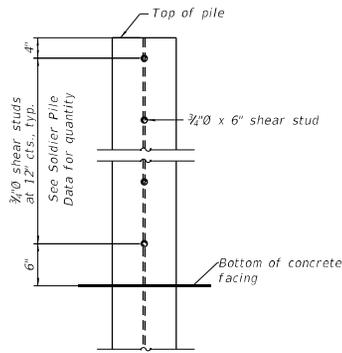


**SHEAR STUD DETAIL**

3/4" shear studs at 12" cts., typ.

See Soldier Pile Data for quantity

3/4" x 6" shear stud

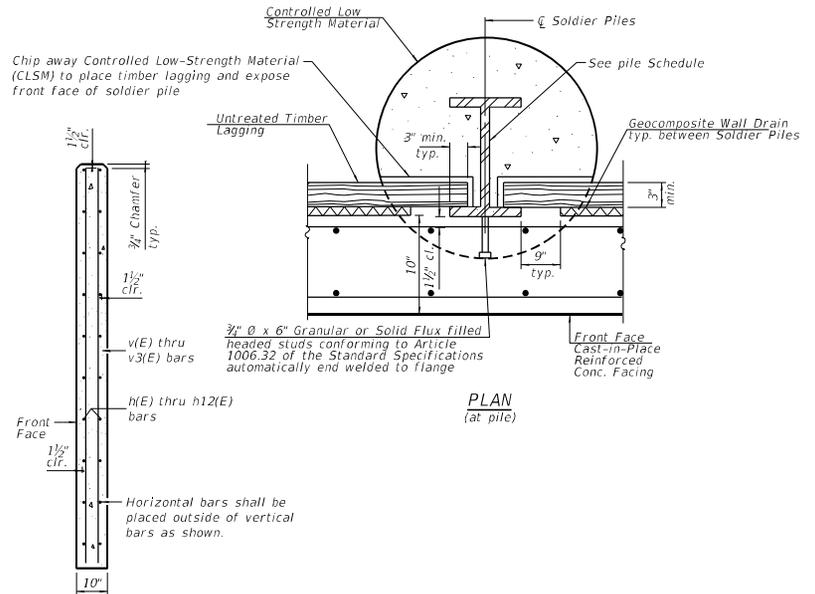

**SECTION THRU FACING**

3/4" x 6" Granular or Solid Flux filled headed studs conforming to Article 1006.32 of the Standard Specifications automatically end welded to flange

Front Face Cast-in-Place Reinforced Conc. Facing

PLAN (at pile)

Horizontal bars shall be placed outside of vertical bars as shown.

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**FEHR GRAHAM**  
ENGINEERING & ENVIRONMENTAL  
ILLINOIS DESIGN FIRM NO. 84-003525

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STATE OF ILLINOIS  
DEPARTMENT OF TRANSPORTATION

WALL DETAILS

SHEET 5 OF 6 SHEETS

F.A.S. SITE = 138B	SECTION = (7-1VB)BR-2	COUNTY = PEORIA	TOTAL SHEETS = 235	SHEET NO. = 84E
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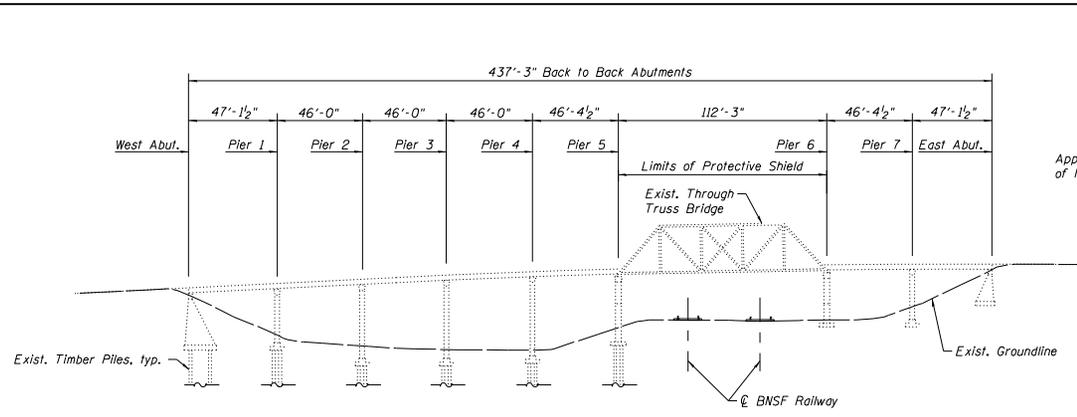
CONTRACT NO. 68799

ILLINOIS FED. AID PROJECT











**EXISTING BRIDGE ELEVATION**  
(Looking Northwest)

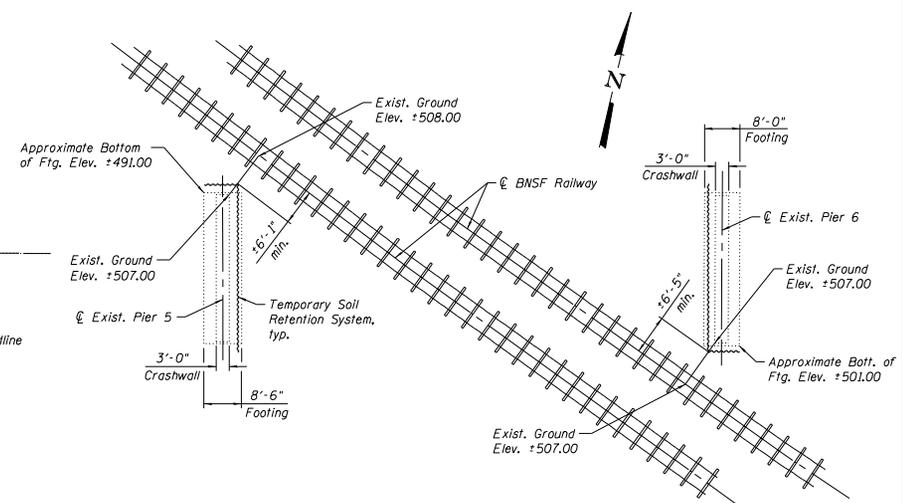

**DETAIL A**

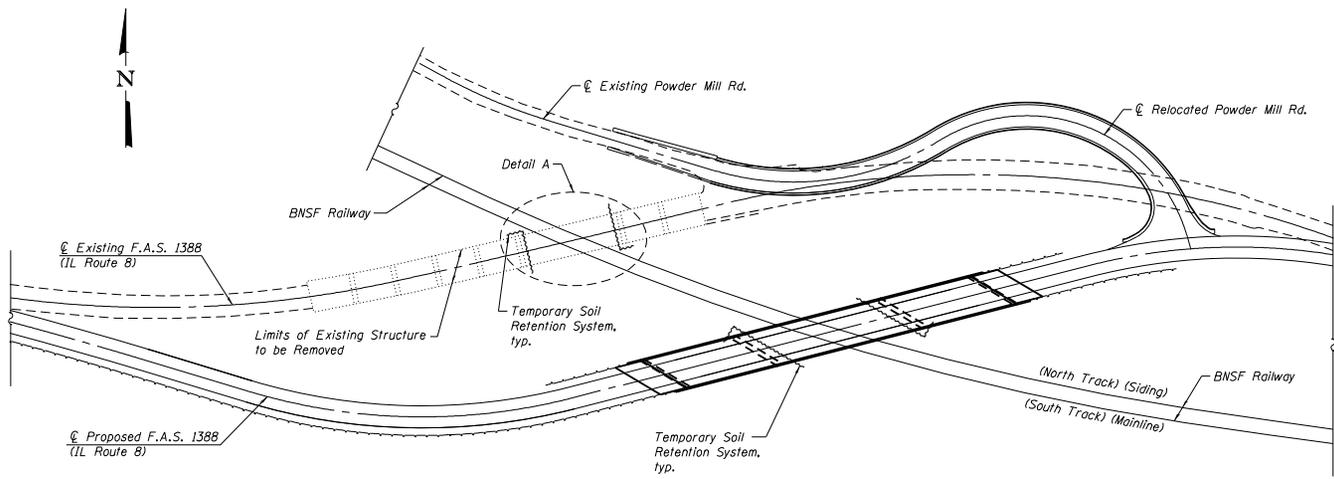

**LOCATION SKETCH**  
(showing proposed temporary soil retention systems)

**Notes:**  
 Existing Piers 5 & 6 shall be removed to at least 3 feet below the top of rail. The remaining existing structure shall be removed to at least one foot below the proposed ground surface, according to Article 501.04 of the Standard Specifications. See Removal Elevation Detail on sheet 4 of 34.  
 Pier 5 is severely deteriorated and it is the Contractor's responsibility to take the condition of Pier 5 into account when developing construction procedures for removal of the structure.  
 Limits and Schedule of Removal of the existing through truss bridge and piers adjacent to the BNSF Railway shall be coordinated with the Railway.  
 For details of Temporary Soil Retention Systems see sheets 5 & 6 of 34.

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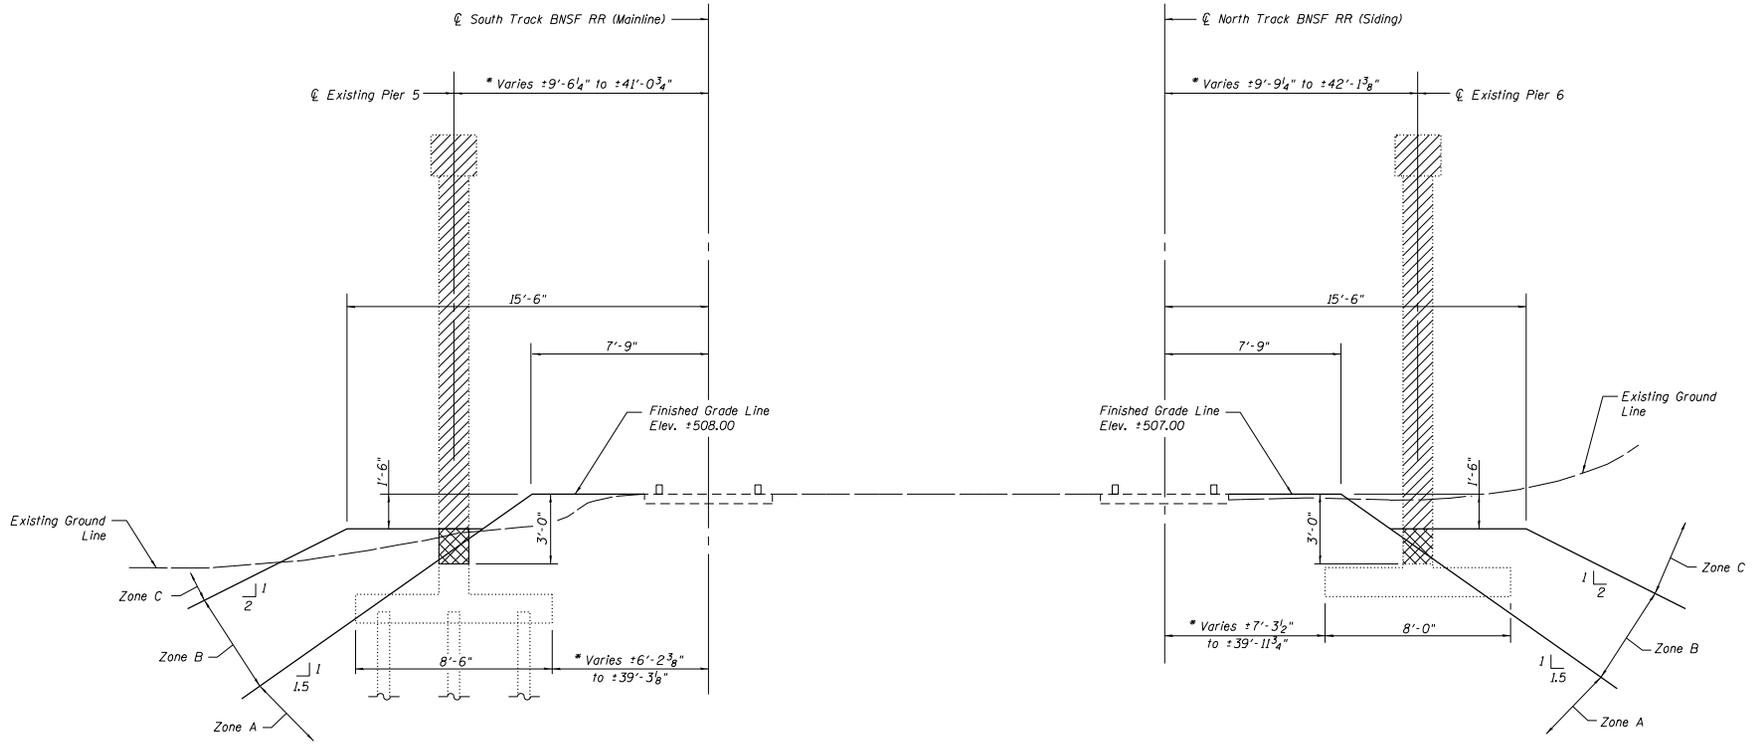
STATE OF ILLINOIS  
DEPARTMENT OF TRANSPORTATION

REMOVAL DETAILS  
STRUCTURE NO. 072-0248

SHEET NO. 3 OF 34 SHEETS

F.A.S. SITE	SECTION	COUNTY	TOTAL SHEETS	SHEET NO.
1388	(Z-1)BIBR-2	PEORIA	235	87
CONTRACT NO. 68799			ILLINOIS FED. AID PROJECT	

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**ELEVATION - LOOKING ALONG  $\phi$  RAILROAD**  
(Looking Northwest)

\* Dimensions taken at Rt. L's to Tracks

Indicates Limits of Structural Removal

Indicates Limits of Structure to be Broken and Left in Place




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STATE OF ILLINOIS  
DEPARTMENT OF TRANSPORTATION


REMOVAL DETAILS  
STRUCTURE NO. 072-0248

SHEET NO. 4 OF 34 SHEETS


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138B	(Z-1VB)BR-2	PEORIA	235	88
CONTRACT NO. 68799			ILLINOIS FED. AID PROJECT	

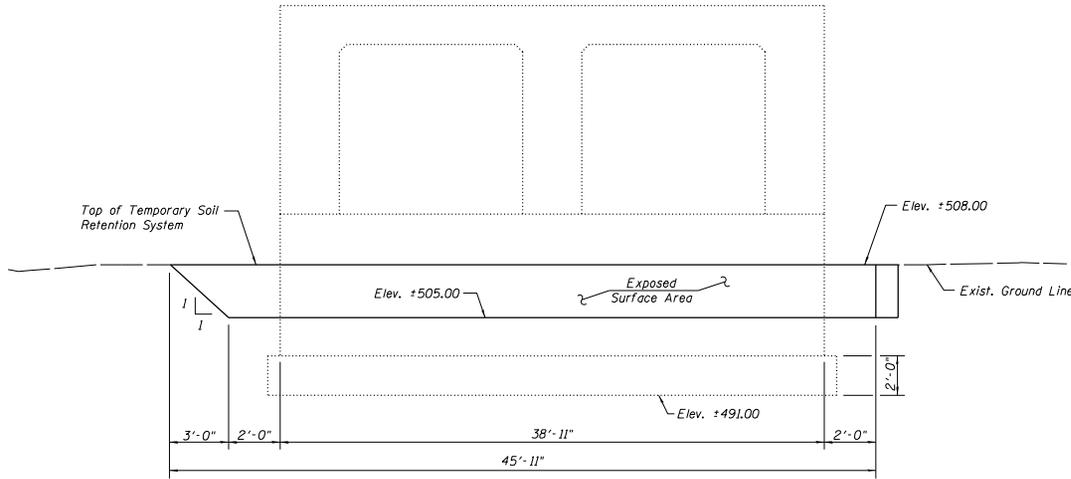


**EXIST. PIER 5 TEMPORARY SOIL RETENTION SYSTEM ELEVATION**  
(Looking West)

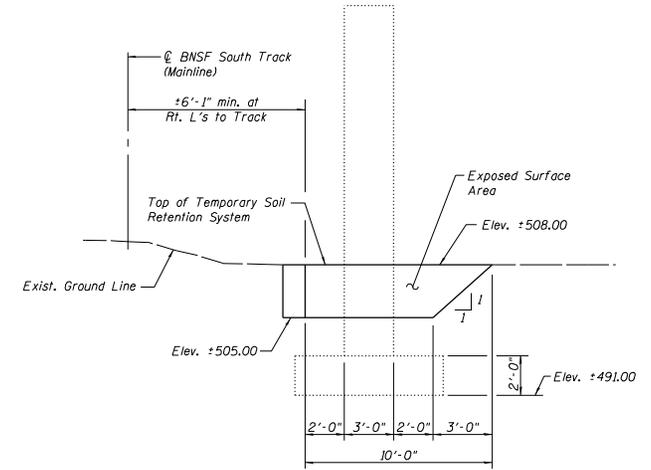

**EXIST. PIER 5 TEMPORARY SOIL RETENTION SYSTEM END VIEW**  
(Looking South)

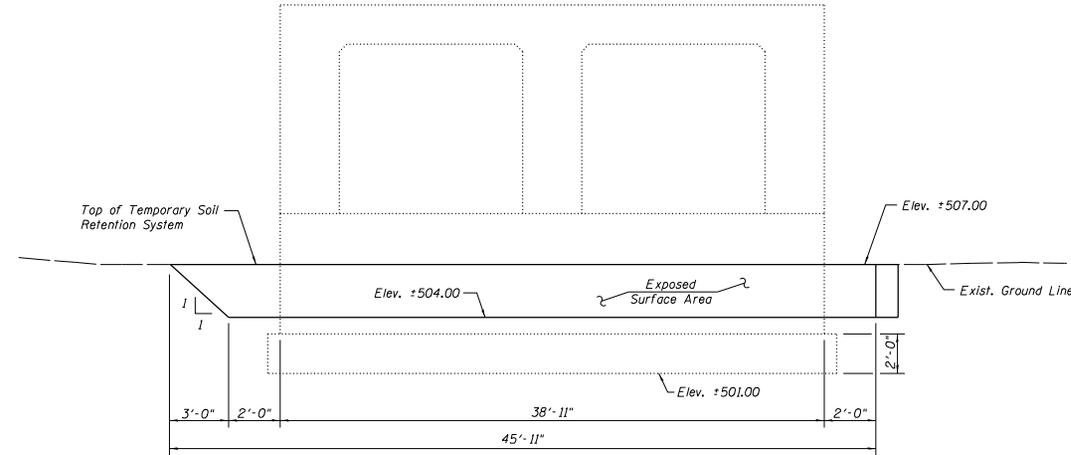

**EXIST. PIER 6 TEMPORARY SOIL RETENTION SYSTEM ELEVATION**  
(Looking East)

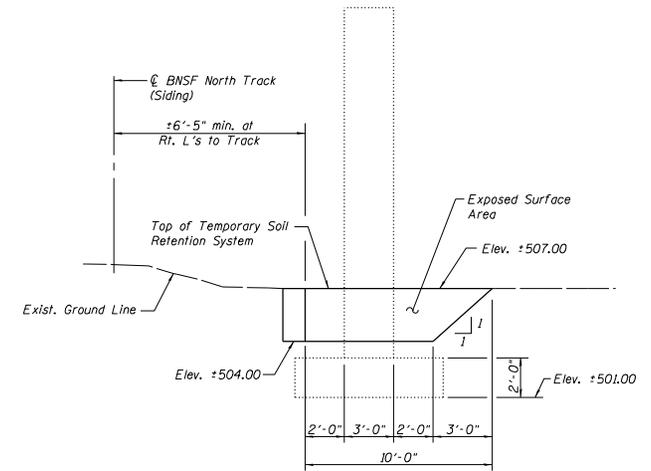

**EXIST. PIER 6 TEMPORARY SOIL RETENTION SYSTEM END VIEW**  
(Looking North)

**Notes:**  
For Existing Pier 5 and 6 Removal Details see sheets 3 & 4 of 34.  
A cantilevered sheet piling design does not appear feasible and additional members or other retention systems may be necessary. The Contractor shall submit a temporary soil retention system design including plan details and calculations for review and acceptance by the Engineer.

**BILL OF MATERIAL**

Item	Unit	Total
Temporary Soil Retention System	Sq. Ft.	318

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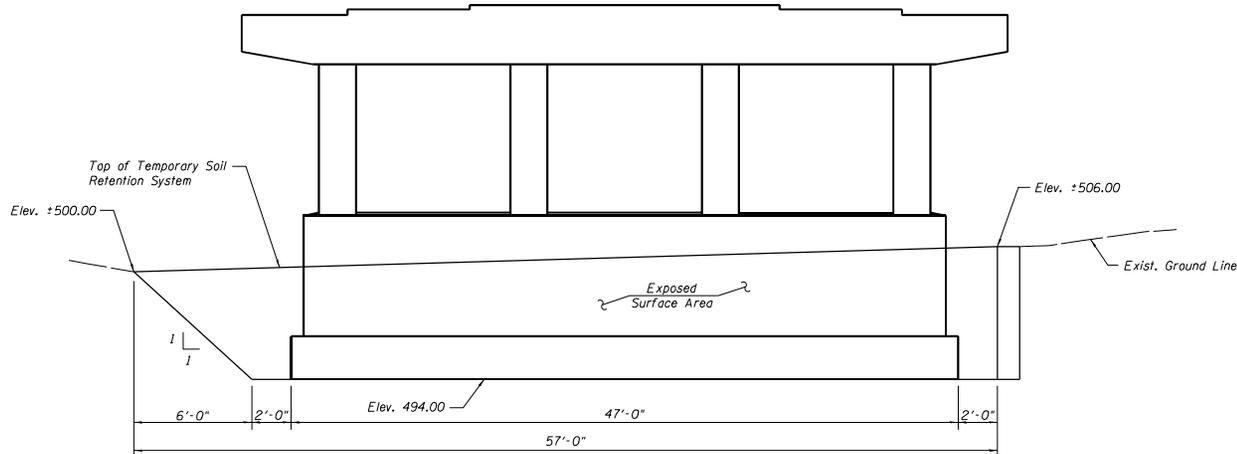
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**STATE OF ILLINOIS**  
**DEPARTMENT OF TRANSPORTATION**


**TEMPORARY SOIL RETENTION SYSTEM**  
**STRUCTURE NO. 072-0248**

SHEET NO. 5 OF 34 SHEETS


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CONTRACT NO. 68799				ILLINOIS FED. AID PROJECT




**PROPOSED PIER 1 - TEMPORARY SOIL RETENTION SYSTEM ELEVATION**  
(Looking Southwest)

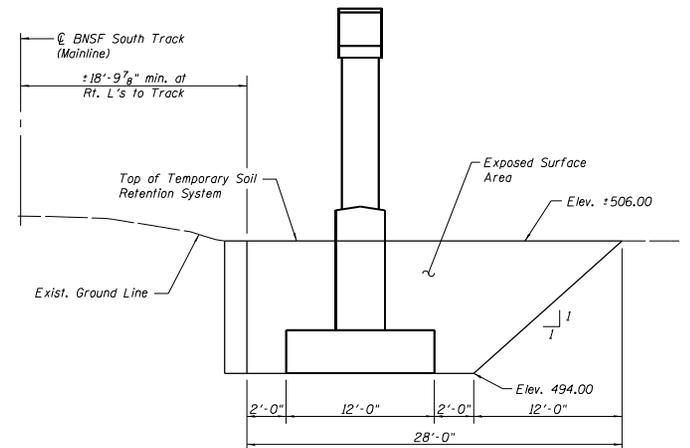

**PROPOSED PIER 1 - TEMPORARY SOIL RETENTION SYSTEM END VIEW**  
(Looking Southeast)

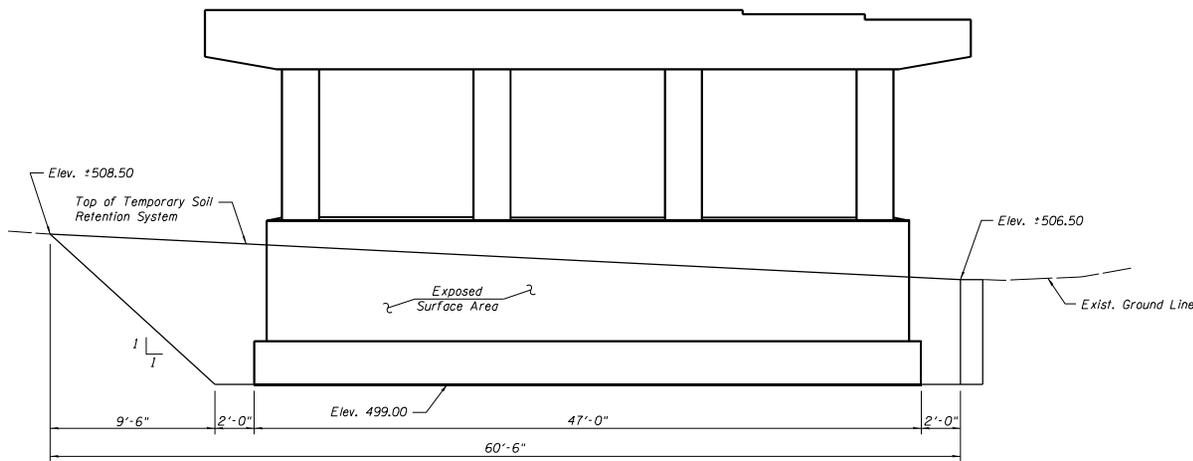

**PROPOSED PIER 2 - TEMPORARY SOIL RETENTION SYSTEM ELEVATION**  
(Looking Northeast)

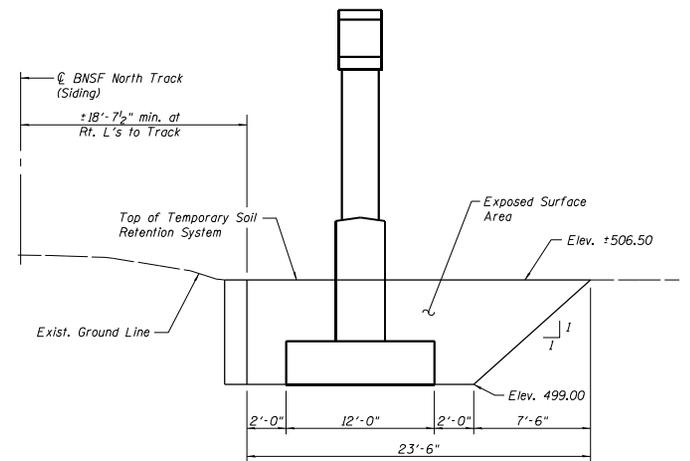

**PROPOSED PIER 2 - TEMPORARY SOIL RETENTION SYSTEM END VIEW**  
(Looking Northwest)

Notes:  
For details of proposed Piers 1 and 2 see sheets 27 & 28 of 34, respectively.  
A cantilevered sheet piling design does not appear feasible and additional members or other retention systems may be necessary. The Contractor shall submit a temporary soil retention system design including plan details and calculations for review and acceptance by the Engineer.

**BILL OF MATERIAL**

Item	Unit	Total
Temporary Soil Retention System	Sq. Ft.	1,378

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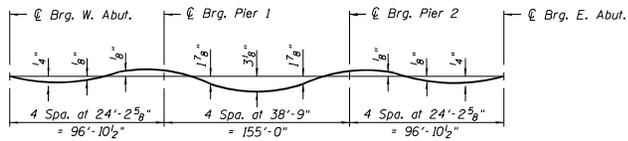
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**STATE OF ILLINOIS  
DEPARTMENT OF TRANSPORTATION**

**TEMPORARY SOIL RETENTION SYSTEM  
STRUCTURE NO. 072-0248**

F.A.S. SITE: 1388	SECTION: (Z-1)BIBR-2	COUNTY: PEORIA	TOTAL SHEETS: 235	SHEET NO.: 90
CONTRACT NO. 68799				ILLINOIS FED. AID PROJECT

SHEET NO. 6 OF 34 SHEETS




**DEAD LOAD DEFLECTION DIAGRAM**

(Includes weight of concrete only.)


Note:

The above deflections are not to be used in the field if the Engineer is working from the grade elevations adjusted for dead load deflections as shown on sheets 8 thru 10 of 34.

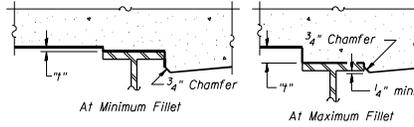

To determine "f": After all structural steel has been erected, elevations of the top flanges of the beams shall be taken at intervals shown below. These elevations subtracted from the "Theoretical Grade Elevations Adjusted for Dead Load Deflection" shown on sheets 8 thru 10 of 34, minus slab thickness, equals the fillet heights "f" above top flange of beams.


**FILLET HEIGHTS**

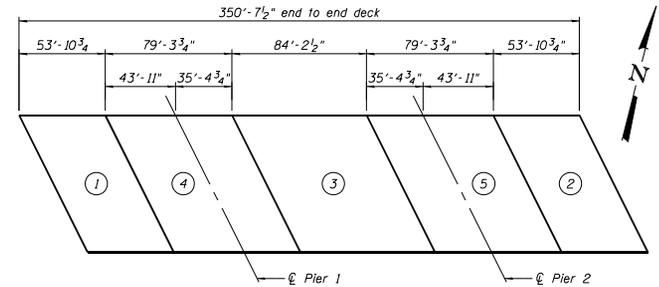

**DECK POURING SEQUENCE**

When the deck pour is stopped for the day at one or more of the transverse bonded construction joints in the deck pouring sequence as shown, the next pour shall not be made until both of the following are met:

1. At least 72 hours shall have elapsed from the end of the previous pour.
2. The concrete strength shall have attained a minimum flexural strength of 675 psi or a minimum compressive strength of 4,000 psi.

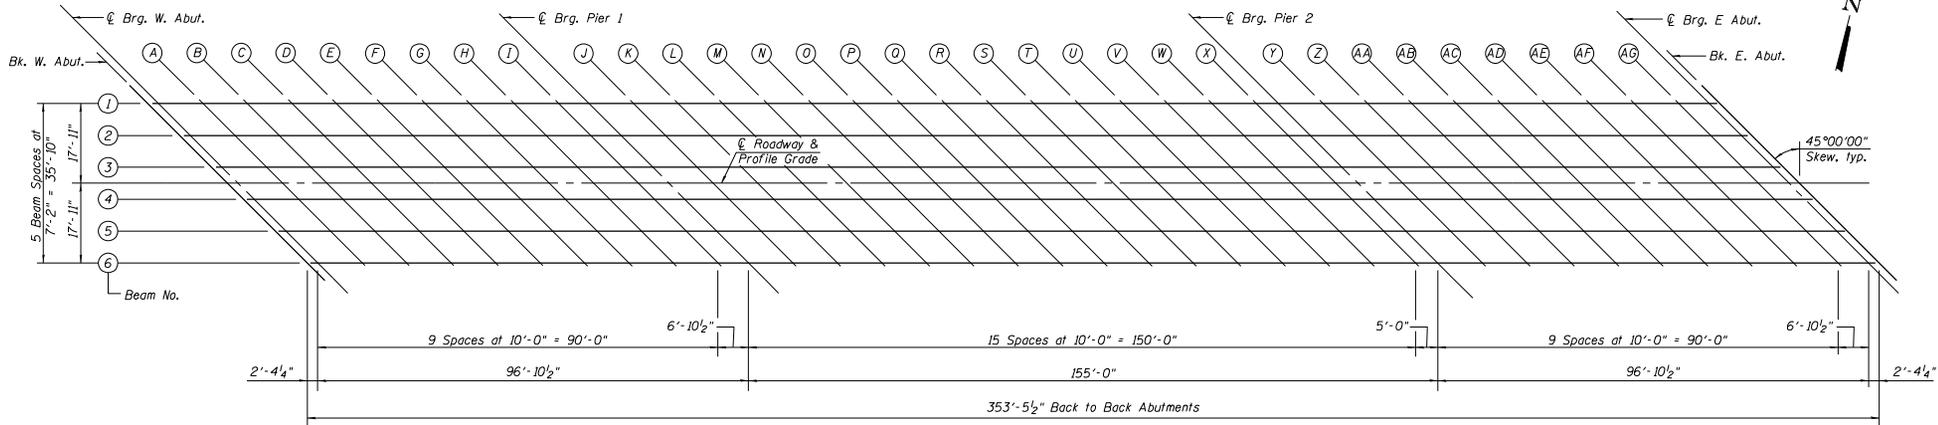

**PLAN**

S:\Projects\072024\072024-00 - E. of East BNSF Phase 1\072024\072024-00 Design Phase\072024-00\072024-00.dwg

	USER NAME = Betsy	DESIGNED - ACS	REVISED	<b>STATE OF ILLINOIS</b> <b>DEPARTMENT OF TRANSPORTATION</b>	<b>TOP OF SLAB ELEVATIONS</b> <b>STRUCTURE NO. 072-0248</b>	F.A.S. SITE = 1388	SECTION = (Z-1VBIBR-2)	COUNTY = PEORIA	TOTAL SHEETS = 235	SHEET NO. = 91
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	PLAT DATE = 8/22/2019 3:54:05 PM	CHECKED - ACS	REVISED			ILLINOIS FED. AID PROJECT				

**BEAM 1**

Location	Station	Offset	Theoretical Grade Elevations	Theoretical Grade Elevations Adjusted For Dead Load Deflection
Bk. W. Abut.	140+95.70	-17.92	536.89	536.89
⊕ Brg. W. Abut.	140+98.05	-17.92	536.91	536.91
A	141+08.05	-17.92	536.99	537.00
B	141+18.05	-17.92	537.06	537.09
C	141+28.05	-17.92	537.13	537.15
D	141+38.05	-17.92	537.19	537.21
E	141+48.05	-17.92	537.24	537.25
F	141+58.05	-17.92	537.28	537.28
G	141+68.05	-17.92	537.31	537.30
H	141+78.05	-17.92	537.33	537.32
I	141+88.05	-17.92	537.35	537.33
⊕ Brg. Pier 1	141+94.93	-17.92	537.35	537.35
J	142+04.93	-17.92	537.35	537.38
K	142+14.93	-17.92	537.34	537.41
L	142+24.93	-17.92	537.33	537.44
M	142+34.93	-17.92	537.30	537.46
N	142+44.93	-17.92	537.27	537.47
O	142+54.93	-17.92	537.22	537.46
P	142+64.93	-17.92	537.17	537.43
Q	142+74.93	-17.92	537.11	537.37
R	142+84.93	-17.92	537.04	537.29
S	142+94.93	-17.92	536.97	537.19
T	143+04.93	-17.92	536.88	537.06
U	143+14.93	-17.92	536.79	536.92
V	143+24.93	-17.92	536.68	536.77
W	143+34.93	-17.92	536.57	536.61
X	143+44.93	-17.92	536.45	536.46
⊕ Brg. Pier 2	143+49.93	-17.92	536.39	536.39
Y	143+59.93	-17.92	536.26	536.24
Z	143+69.93	-17.92	536.11	536.10
AA	143+79.93	-17.92	535.96	535.96
AB	143+89.93	-17.92	535.81	535.81
AC	143+99.93	-17.92	535.64	535.65
AD	144+09.93	-17.92	535.46	535.48
AE	144+19.93	-17.92	535.28	535.30
AF	144+29.93	-17.92	535.09	535.10
AG	144+39.93	-17.92	534.88	534.89
⊕ Brg. E. Abut.	144+46.80	-17.92	534.74	534.74
Bk. E. Abut.	144+49.16	-17.92	534.69	534.69

**BEAM 2**

Location	Station	Offset	Theoretical Grade Elevations	Theoretical Grade Elevations Adjusted For Dead Load Deflection
Bk. W. Abut.	141+02.86	-10.75	537.08	537.08
⊕ Brg. W. Abut.	141+05.22	-10.75	537.10	537.10
A	141+15.22	-10.75	537.18	537.19
B	141+25.22	-10.75	537.25	537.27
C	141+35.22	-10.75	537.31	537.33
D	141+45.22	-10.75	537.36	537.38
E	141+55.22	-10.75	537.40	537.41
F	141+65.22	-10.75	537.44	537.44
G	141+75.22	-10.75	537.46	537.45
H	141+85.22	-10.75	537.48	537.46
I	141+95.22	-10.75	537.49	537.48
⊕ Brg. Pier 1	142+02.10	-10.75	537.49	537.49
J	142+12.10	-10.75	537.48	537.51
K	142+22.10	-10.75	537.47	537.53
L	142+32.10	-10.75	537.44	537.56
M	142+42.10	-10.75	537.41	537.57
N	142+52.10	-10.75	537.37	537.58
O	142+62.10	-10.75	537.32	537.56
P	142+72.10	-10.75	537.27	537.52
Q	142+82.10	-10.75	537.20	537.46
R	142+92.10	-10.75	537.13	537.37
S	143+02.10	-10.75	537.04	537.26
T	143+12.10	-10.75	536.95	537.13
U	143+22.10	-10.75	536.85	536.99
V	143+32.10	-10.75	536.74	536.83
W	143+42.10	-10.75	536.62	536.67
X	143+52.10	-10.75	536.50	536.51
⊕ Brg. Pier 2	143+57.10	-10.75	536.43	536.43
Y	143+67.10	-10.75	536.29	536.28
Z	143+77.10	-10.75	536.14	536.13
AA	143+87.10	-10.75	535.99	535.98
AB	143+97.10	-10.75	535.82	535.83
AC	144+07.10	-10.75	535.65	535.66
AD	144+17.10	-10.75	535.47	535.49
AE	144+27.10	-10.75	535.28	535.30
AF	144+37.10	-10.75	535.08	535.10
AG	144+47.10	-10.75	534.87	534.88
⊕ Brg. E. Abut.	144+53.97	-10.75	534.72	534.72
Bk. E. Abut.	144+56.33	-10.75	534.67	534.67

**BEAM 3**

Location	Station	Offset	Theoretical Grade Elevations	Theoretical Grade Elevations Adjusted For Dead Load Deflection
Bk. W. Abut.	141+10.03	-3.58	537.25	537.25
⊕ Brg. W. Abut.	141+12.39	-3.58	537.27	537.27
A	141+22.39	-3.58	537.34	537.35
B	141+32.39	-3.58	537.40	537.42
C	141+42.39	-3.58	537.45	537.48
D	141+52.39	-3.58	537.50	537.52
E	141+62.39	-3.58	537.54	537.55
F	141+72.39	-3.58	537.56	537.56
G	141+82.39	-3.58	537.58	537.57
H	141+92.39	-3.58	537.59	537.58
I	142+02.39	-3.58	537.60	537.59
⊕ Brg. Pier 1	142+09.26	-3.58	537.59	537.59
J	142+19.26	-3.58	537.58	537.61
K	142+29.26	-3.58	537.56	537.63
L	142+39.26	-3.58	537.53	537.64
M	142+49.26	-3.58	537.49	537.65
N	142+59.26	-3.58	537.45	537.65
O	142+69.26	-3.58	537.39	537.63
P	142+79.26	-3.58	537.33	537.58
Q	142+89.26	-3.58	537.25	537.51
R	142+99.26	-3.58	537.17	537.42
S	143+09.26	-3.58	537.08	537.31
T	143+19.26	-3.58	536.99	537.17
U	143+29.26	-3.58	536.88	537.02
V	143+39.26	-3.58	536.77	536.85
W	143+49.26	-3.58	536.64	536.68
X	143+59.26	-3.58	536.51	536.52
⊕ Brg. Pier 2	143+64.26	-3.58	536.44	536.44
Y	143+74.26	-3.58	536.29	536.28
Z	143+84.26	-3.58	536.14	536.13
AA	143+94.26	-3.58	535.98	535.97
AB	144+04.26	-3.58	535.81	535.81
AC	144+14.26	-3.58	535.63	535.64
AD	144+24.26	-3.58	535.44	535.46
AE	144+34.26	-3.58	535.24	535.27
AF	144+44.26	-3.58	535.04	535.06
AG	144+54.26	-3.58	534.83	534.83
⊕ Brg. E. Abut.	144+61.14	-3.58	534.67	534.67
Bk. E. Abut.	144+63.49	-3.58	534.62	534.62

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USER NAME	Betsy	DESIGNED	ACS	REVISED
Illinois Design Firm Number	104.001670	CHECKED	CPA	REVISED
PLOT SCALE		DRAWN	WJS	REVISED
PLOT DATE	8/22/2019 3:56:05 PM	CHECKED	ACS	REVISED

**STATE OF ILLINOIS  
DEPARTMENT OF TRANSPORTATION**

**TOP OF SLAB ELEVATIONS  
STRUCTURE NO. 072-0248**

F. & S. DIST.	SECTION	COUNTY	TOTAL SHEETS
138B	(2-1VB)BR-2	PEORIA	235 92
			CONTRACT NO. 68799
ILLINOIS FED. AID PROJECT			

SHEET NO. 8 OF 34 SHEETS

☉ ROADWAY & P.G.L.

Location	Station	Offset	Theoretical Grade Elevations	Theoretical Grade Elevations Adjusted For Dead Load Deflection
Bk. W. Abut.	141+13.61	0.00	537.33	537.33
☉ Brg. W. Abut.	141+15.97	0.00	537.35	537.35
A	141+25.97	0.00	537.42	537.43
B	141+35.97	0.00	537.47	537.50
C	141+45.97	0.00	537.52	537.55
D	141+55.97	0.00	537.57	537.59
E	141+65.97	0.00	537.60	537.61
F	141+75.97	0.00	537.63	537.63
G	141+85.97	0.00	537.64	537.63
H	141+95.97	0.00	537.65	537.63
I	142+05.97	0.00	537.65	537.64
☉ Brg. Pier 1	142+12.84	0.00	537.64	537.64
J	142+22.84	0.00	537.63	537.65
K	142+32.84	0.00	537.60	537.67
L	142+42.84	0.00	537.57	537.68
M	142+52.84	0.00	537.53	537.69
N	142+62.84	0.00	537.48	537.69
O	142+72.84	0.00	537.42	537.66
P	142+82.84	0.00	537.36	537.61
Q	142+92.84	0.00	537.28	537.54
R	143+02.84	0.00	537.20	537.44
S	143+12.84	0.00	537.10	537.33
T	143+22.84	0.00	537.00	537.19
U	143+32.84	0.00	536.89	537.03
V	143+42.84	0.00	536.78	536.86
W	143+52.84	0.00	536.65	536.69
X	143+62.84	0.00	536.51	536.52
☉ Brg. Pier 2	143+67.84	0.00	536.44	536.44
Y	143+77.84	0.00	536.29	536.28
Z	143+87.84	0.00	536.14	536.12
AA	143+97.84	0.00	535.97	535.96
AB	144+07.84	0.00	535.80	535.80
AC	144+17.84	0.00	535.62	535.63
AD	144+27.84	0.00	535.43	535.44
AE	144+37.84	0.00	535.23	535.25
AF	144+47.84	0.00	535.03	535.03
AG	144+57.84	0.00	534.80	534.81
☉ Brg. E. Abut.	144+64.72	0.00	534.65	534.65
Bk. E. Abut.	144+67.08	0.00	534.59	534.59

BEAM 4

Location	Station	Offset	Theoretical Grade Elevations	Theoretical Grade Elevations Adjusted For Dead Load Deflection
Bk. W. Abut.	141+17.20	3.58	537.30	537.30
☉ Brg. W. Abut.	141+19.55	3.58	537.32	537.32
A	141+29.55	3.58	537.38	537.40
B	141+39.55	3.58	537.44	537.46
C	141+49.55	3.58	537.49	537.51
D	141+59.55	3.58	537.53	537.55
E	141+69.55	3.58	537.56	537.57
F	141+79.55	3.58	537.58	537.58
G	141+89.55	3.58	537.59	537.58
H	141+99.55	3.58	537.60	537.58
I	142+09.55	3.58	537.59	537.58
☉ Brg. Pier 1	142+16.43	3.58	537.58	537.58
J	142+26.43	3.58	537.57	537.59
K	142+36.43	3.58	537.54	537.60
L	142+46.43	3.58	537.50	537.62
M	142+56.43	3.58	537.46	537.62
N	142+66.43	3.58	537.41	537.61
O	142+76.43	3.58	537.35	537.58
P	142+86.43	3.58	537.28	537.53
Q	142+96.43	3.58	537.20	537.46
R	143+06.43	3.58	537.11	537.36
S	143+16.43	3.58	537.02	537.24
T	143+26.43	3.58	536.91	537.09
U	143+36.43	3.58	536.80	536.94
V	143+46.43	3.58	536.68	536.77
W	143+56.43	3.58	536.55	536.59
X	143+66.43	3.58	536.41	536.42
☉ Brg. Pier 2	143+71.43	3.58	536.34	536.34
Y	143+81.43	3.58	536.19	536.17
Z	143+91.43	3.58	536.03	536.01
AA	144+01.43	3.58	535.86	535.85
AB	144+11.43	3.58	535.68	535.68
AC	144+21.43	3.58	535.49	535.51
AD	144+31.43	3.58	535.30	535.32
AE	144+41.43	3.58	535.10	535.12
AF	144+51.43	3.58	534.89	534.90
AG	144+61.43	3.58	534.67	534.67
☉ Brg. E. Abut.	144+68.30	3.58	534.51	534.51
Bk. E. Abut.	144+70.66	3.58	534.46	534.46

BEAM 5

Location	Station	Offset	Theoretical Grade Elevations	Theoretical Grade Elevations Adjusted For Dead Load Deflection
Bk. W. Abut.	141+24.36	10.75	537.24	537.24
☉ Brg. W. Abut.	141+26.72	10.75	537.26	537.26
A	141+36.72	10.75	537.32	537.33
B	141+46.72	10.75	537.44	537.39
C	141+56.72	10.75	537.51	537.43
D	141+66.72	10.75	537.55	537.46
E	141+76.72	10.75	537.57	537.48
F	141+86.72	10.75	537.58	537.48
G	141+96.72	10.75	537.59	537.48
H	142+06.72	10.75	537.60	537.47
I	142+16.72	10.75	537.58	537.47
☉ Brg. Pier 1	142+23.59	10.75	537.46	537.46
J	142+33.59	10.75	537.44	537.47
K	142+43.59	10.75	537.41	537.47
L	142+53.59	10.75	537.37	537.48
M	142+63.59	10.75	537.32	537.48
N	142+73.59	10.75	537.26	537.46
O	142+83.59	10.75	537.19	537.43
P	142+93.59	10.75	537.11	537.37
Q	143+03.59	10.75	537.03	537.29
R	143+13.59	10.75	536.94	537.18
S	143+23.59	10.75	536.83	537.06
T	143+33.59	10.75	536.72	536.91
U	143+43.59	10.75	536.61	536.74
V	143+53.59	10.75	536.48	536.57
W	143+63.59	10.75	536.34	536.38
X	143+73.59	10.75	536.20	536.21
☉ Brg. Pier 2	143+78.59	10.75	536.12	536.12
Y	143+88.59	10.75	535.96	535.95
Z	143+98.59	10.75	535.80	535.78
AA	144+08.59	10.75	535.62	535.62
AB	144+18.59	10.75	535.44	535.44
AC	144+28.59	10.75	535.25	535.26
AD	144+38.59	10.75	535.05	535.07
AE	144+48.59	10.75	534.84	534.86
AF	144+58.59	10.75	534.62	534.64
AG	144+68.59	10.75	534.40	534.40
☉ Brg. E. Abut.	144+75.47	10.75	534.24	534.24
Bk. E. Abut.	144+77.83	10.75	534.18	534.18

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USER NAME : Betsy	DESIGNED - ACS	REVISED
Illinois Design Firm Number 104.001670	CHECKED - CPA	REVISED
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PLLOT DATE : 8/22/2019 3:56:06 PM	CHECKED - ACS	REVISED

STATE OF ILLINOIS  
DEPARTMENT OF TRANSPORTATION

TOP OF SLAB ELEVATIONS  
STRUCTURE NO. 072-0248

F. & S. DIST.	SECTION	COUNTY	TOTAL SHEETS	SHEET NO.
138B	(2-1VBRR-2)	PEORIA	235	93
CONTRACT NO. 68799			ILLINOIS FED. AID PROJECT	

SHEET NO. 9 OF 34 SHEETS



**NORTH EDGE OF SHOULDER**


Location	Station	Offset	Theoretical Grade Elevations
W. End of W. Appr. Slab	140+65.03	-20.00	536.53
A1	140+75.03	-20.00	536.64
A2	140+85.03	-20.00	536.74
E. End of W. Appr. Slab	140+95.03	-20.00	536.84

**NORTH EDGE OF ROADWAY**

Location	Station	Offset	Theoretical Grade Elevations
W. End of W. Appr. Slab	140+73.03	-12.00	536.78
A1	140+83.03	-12.00	536.88
A2	140+93.03	-12.00	536.98
E. End of W. Appr. Slab	141+03.03	-12.00	537.07

**☉ ROADWAY & P.G.L.**

Location	Station	Offset	Theoretical Grade Elevations
W. End of W. Appr. Slab	140+85.03	0.00	537.08
A1	140+95.03	0.00	537.18
A2	141+05.03	0.00	537.26
E. End of W. Appr. Slab	141+15.03	0.00	537.34

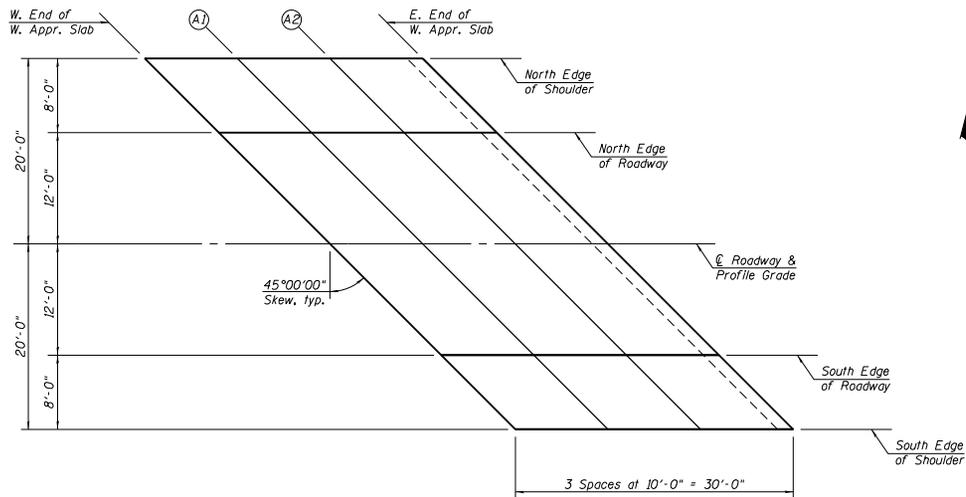

**PLAN**

**SOUTH EDGE OF ROADWAY**

Location	Station	Offset	Theoretical Grade Elevations
W. End of W. Appr. Slab	140+97.03	12.00	537.02
A1	141+07.03	12.00	537.10
A2	141+17.03	12.00	537.17
E. End of W. Appr. Slab	141+27.03	12.00	537.24

**SOUTH EDGE OF SHOULDER**

Location	Station	Offset	Theoretical Grade Elevations
W. End of W. Appr. Slab	141+05.03	20.00	536.92
A1	141+15.03	20.00	537.00
A2	141+25.03	20.00	537.07
E. End of W. Appr. Slab	141+35.03	20.00	537.13

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USER NAME : Betsy	DESIGNED - ACS	REVISED
Illinois Design Firm Number 184.001670	CHECKED - CPA	REVISED
PLLOT SCALE =	DRAWN - WJS	REVISED
PLLOT DATE = 8/22/2019 3:54:07 PM	CHECKED - ACS	REVISED

**STATE OF ILLINOIS  
DEPARTMENT OF TRANSPORTATION**

**TOP OF WEST APPROACH SLAB ELEVATIONS  
STRUCTURE NO. 072-0248**

SHEET NO. 11 OF 34 SHEETS

F.A.S. DIST. 1388	SECTION (Z-1VB)BR-2	COUNTY PEORIA	TOTAL SHEETS 235	SHEET NO. 95
CONTRACT NO. 68799				ILLINOIS FED. AID PROJECT

**NORTH EDGE OF SHOULDER**


Location	Station	Offset	Theoretical Grade Elevations
W. End of E. Appr. Slab	144+45.66	-20.00	534.72
A3	144+55.66	-20.00	534.51
A4	144+65.66	-20.00	534.29
E. End of E. Appr. Slab	144+75.66	-20.00	534.05

**NORTH EDGE OF ROADWAY**

Location	Station	Offset	Theoretical Grade Elevations
W. End of E. Appr. Slab	144+53.66	-12.00	534.71
A3	144+63.66	-12.00	534.49
A4	144+73.66	-12.00	534.26
E. End of E. Appr. Slab	144+83.66	-12.00	534.02

**☉ ROADWAY & P.G.L.**

Location	Station	Offset	Theoretical Grade Elevations
W. End of E. Appr. Slab	144+65.66	0.00	534.63
A3	144+75.66	0.00	534.39
A4	144+85.66	0.00	534.15
E. End of E. Appr. Slab	144+95.66	0.00	533.90

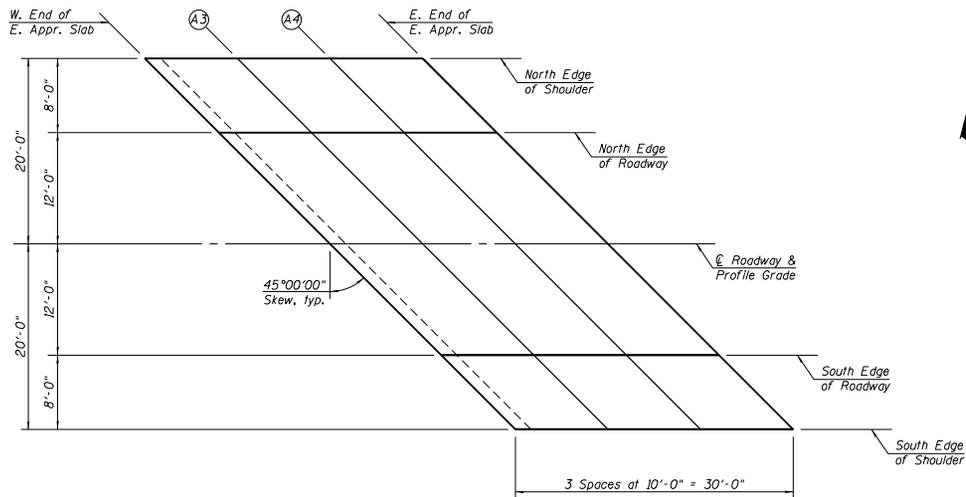

**PLAN**

**SOUTH EDGE OF ROADWAY**

Location	Station	Offset	Theoretical Grade Elevations
W. End of E. Appr. Slab	144+77.66	12.00	534.17
A3	144+87.66	12.00	533.92
A4	144+97.66	12.00	533.67
E. End of E. Appr. Slab	145+07.66	12.00	533.41

**SOUTH EDGE OF SHOULDER**

Location	Station	Offset	Theoretical Grade Elevations
W. End of E. Appr. Slab	144+85.66	20.00	533.81
A3	144+95.66	20.00	533.56
A4	145+05.66	20.00	533.31
E. End of E. Appr. Slab	145+15.66	20.00	533.04

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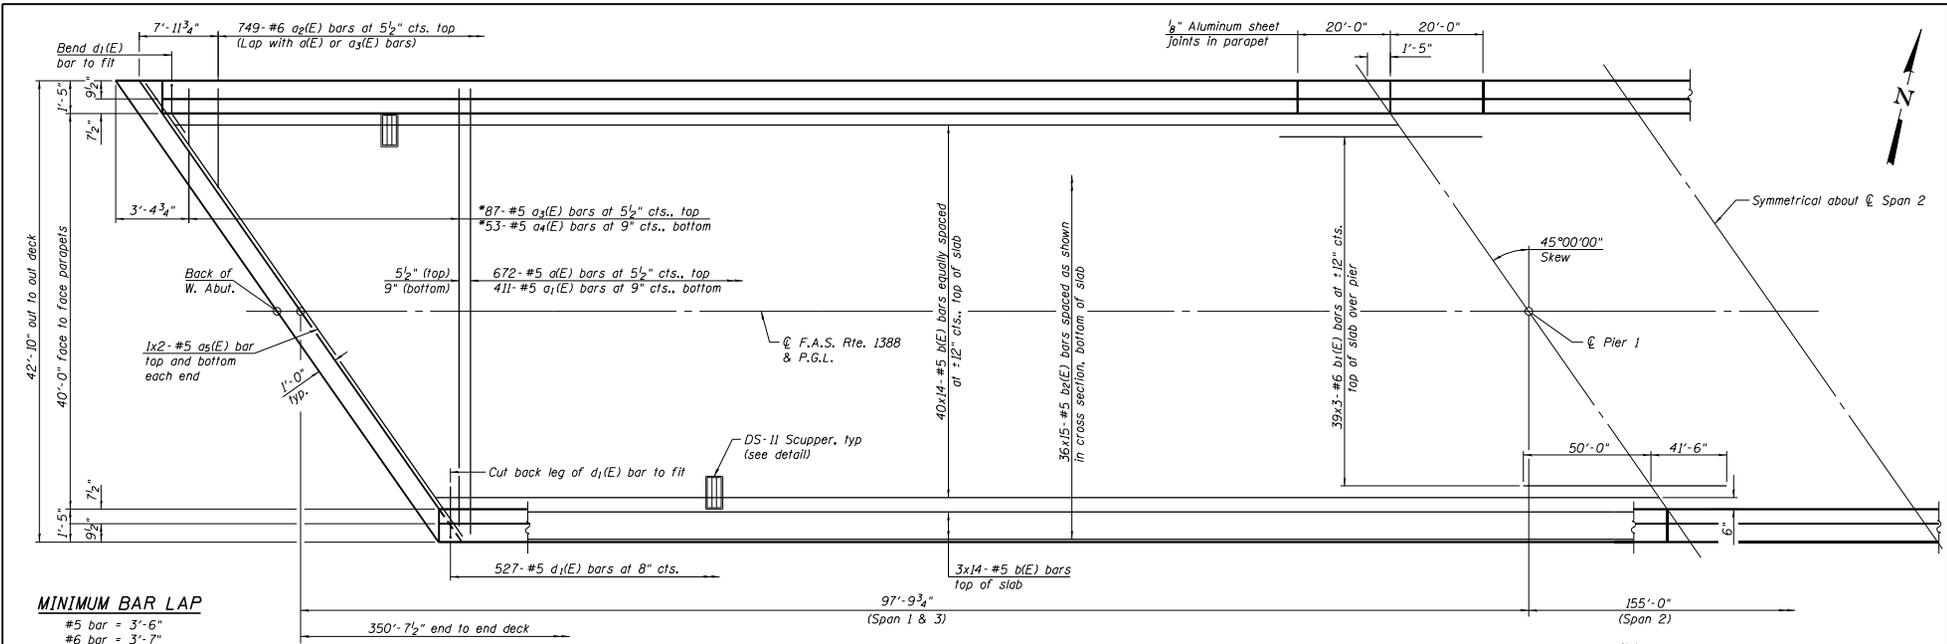
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Illinois Design Firm Number 184.001670	CHECKED - CPA	REVISED
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**STATE OF ILLINOIS  
DEPARTMENT OF TRANSPORTATION**

**TOP OF EAST APPROACH SLAB ELEVATIONS  
STRUCTURE NO. 072-0248**

SHEET NO. 12 OF 34 SHEETS

F.A.S. DIST. 1388	SECTION (Z-1VB)BR-2	COUNTY PEORIA	TOTAL SHEETS 235	SHEET NO. 96
CONTRACT NO. 68799				ILLINOIS FED. AID PROJECT




**MINIMUM BAR LAP**

#5 bar = 3'-6"  
 #6 bar = 3'-7"

\* See Field Cutting Diagram on sheet 14 of 34.

**PARTIAL PLAN**

Notes:  
 See sheet 14 of 34 for superstructure details, scupper reinforcement detail, and Bill of Material. Bars indicated thus 20 x 3-#5 etc. indicates 20 lines of bars with 3 lengths per line.

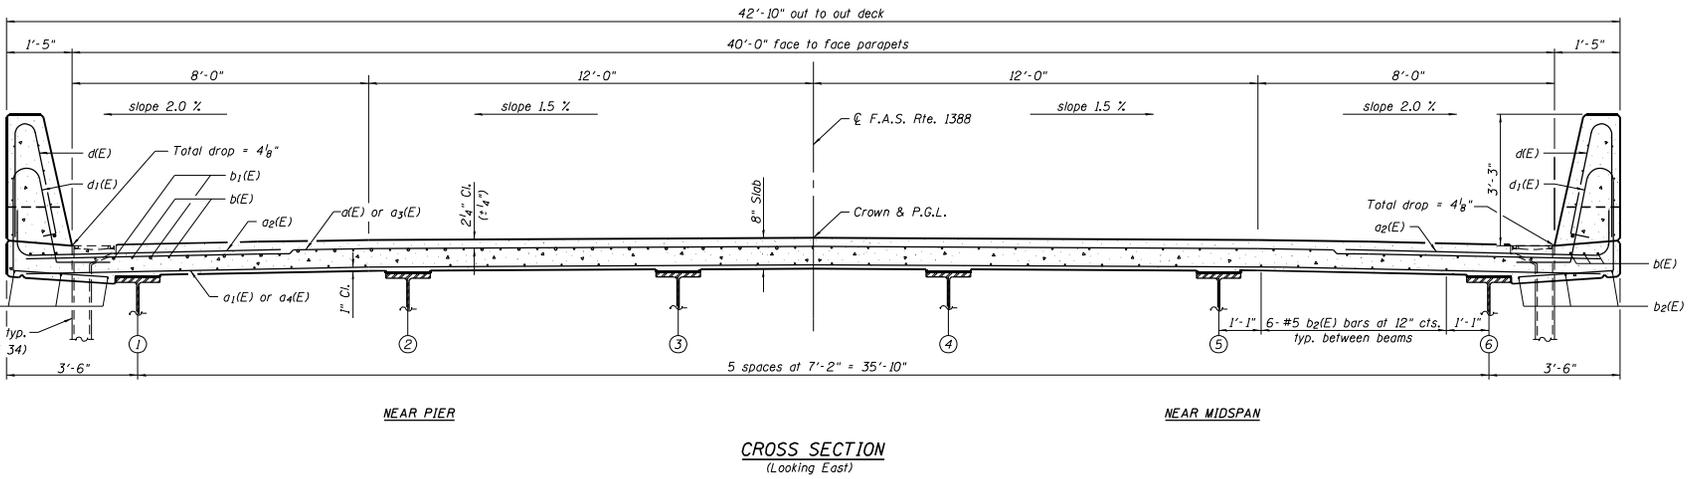

**NEAR PIER**

**NEAR MIDSPAN**

**CROSS SECTION**  
 (Looking East)

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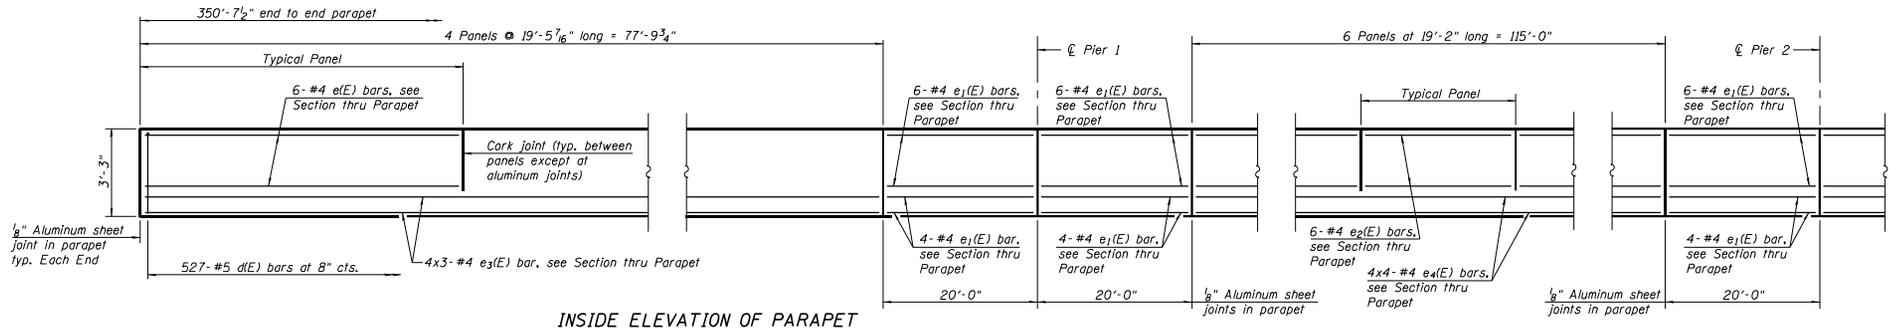
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Illinois Design Firm Number 184.001670	CHECKED - CPA	REVISED
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**STATE OF ILLINOIS**  
**DEPARTMENT OF TRANSPORTATION**


**SUPERSTRUCTURE**  
**STRUCTURE NO. 072-0248**

F.A.S. RTE. 1388	SECTION (Z-1VBRR-2)	COUNTY PEORIA	TOTAL SHEETS 235	SHEET NO. 97
CONTRACT NO. 68799				ILLINOIS FED. AID PROJECT


SHEET NO. 13 OF 34 SHEETS



INSIDE ELEVATION OF PARAPET

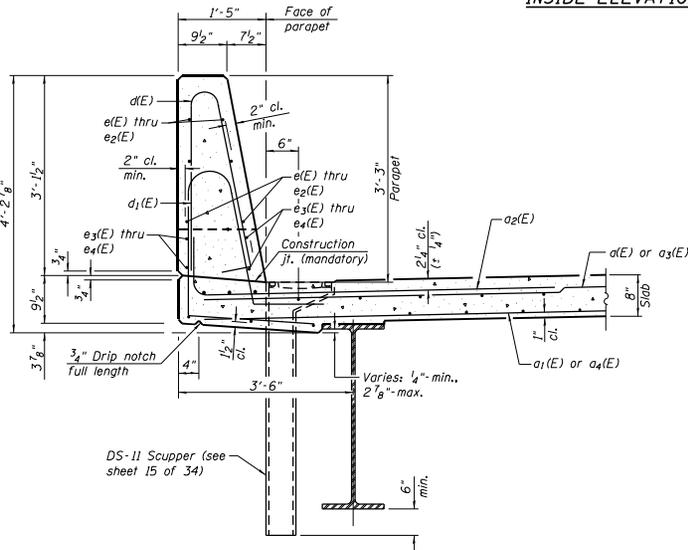


SECTION THRU PARAPET

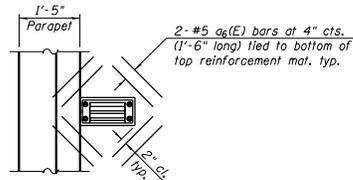


SCUPPER DETAIL

Note:  
Cut longitudinal reinforcement to clear drainage scuppers.  
See sheet 15 of 34 for DS-II Drainage Scupper Details.

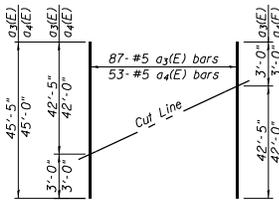


FIELD CUTTING DIAGRAM

Order a3(E) and a4(E) bars full length. Cut as shown and use remainder of bars in opposite end of deck.

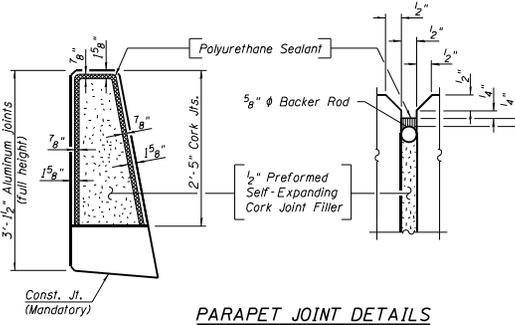

PARAPET JOINT DETAILS



Notes:  
The 1/8" Aluminum sheet shall be ASTM B 209 alloy 3003-H14 and coated to minimize reaction with wet concrete. Cost included with Concrete Superstructure.  
The Polyurethane Sealant shall be according to Article 1050.04 of the Std. Spec. and the color shall be gray.  
Headed bars shall conform to ASTM A970 with threaded attachment; Class HA; and reinforcement bars conforming to ASTM A706. Cost included with Reinforcement Bars, Epoxy Coated.

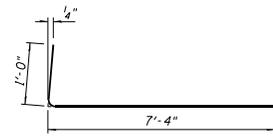


MINIMUM BAR LAP (Parapet)  
#4 bar = 2'-5"

BAR a2(E)


BAR s(E) (Headed)

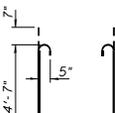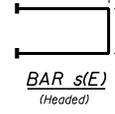


BAR s1(E)

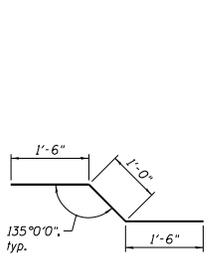

BAR m3(E)

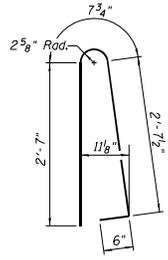

BAR d(E)

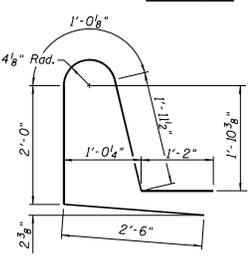

BAR d1(E)

SUPERSTRUCTURE BILL OF MATERIAL

Bar	No.	Size	Length	Shape
a(E)	672	#5	42'-6"	—
a1(E)	411	#5	42'-6"	—
a2(E)	1,498	#6	8'-4"	—
a3(E)	87	#5	45'-5"	—
a4(E)	53	#5	45'-0"	—
a5(E)	8	#5	31'-11"	—
a6(E)	32	#5	1'-6"	—
b(E)	644	#5	28'-4"	—
b1(E)	234	#6	32'-11"	—
b2(E)	540	#5	26'-8"	—
d(E)	1,054	#5	6'-5"	—
d1(E)	1,054	#5	8'-8"	—
e(E)	96	#4	19'-2"	—
e1(E)	80	#4	19'-9"	—
e2(E)	72	#4	18'-11"	—
e3(E)	48	#4	27'-6"	—
e4(E)	32	#4	30'-6"	—
m(E)	24	#6	32'-5"	—
m1(E)	50	#6	9'-8"	—
m2(E)	20	#6	4'-8"	—
m3(E)	60	#5	4'-0"	—
s(E)	120	#5	8'-8"	—
s1(E)	120	#5	13'-2"	—
Concrete Superstructure		Cu. Yd.	544.4	
Bridge Deck Grooving		Sq. Yd.	1,481	
Protective Coat		Sq. Yd.	1,878	
Reinforcement Bars, Epoxy Coated		Pound	145,640	

Bars indicated thus 1 x 2-#8 etc. Indicates 1 line of bars with 2 lengths per line.

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USER NAME : Betsy  
Illinois Design Firm Number 184.001670  
PLOT SCALE :  
PLOT DATE : 8/22/2019 3:56:09 PM

DESIGNED - ACS  
CHECKED - CPA  
DRAWN - WJS  
CHECKED - ACS



REVISED  
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STATE OF ILLINOIS  
DEPARTMENT OF TRANSPORTATION


SUPERSTRUCTURE DETAILS  
STRUCTURE NO. 072-0248

F.P.S. RES.	SECTION	COUNTY	TOTAL SHEETS	SHEET NO.
138B	(Z-1)BRR-2	PEORIA	235	98
				CONTRACT NO. 68799
ILLINOIS FED. AID PROJECT				


SHEET NO. 14 OF 34 SHEETS

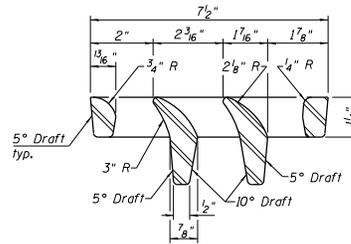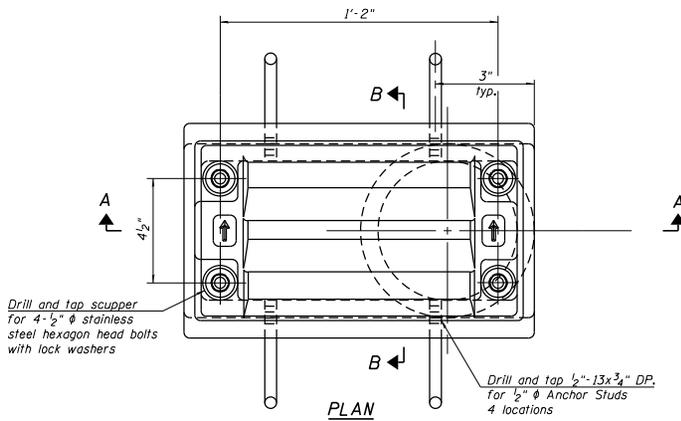


VANE GRATE DETAIL

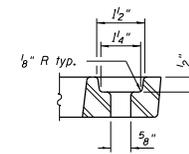


BOLT HOLE DETAIL

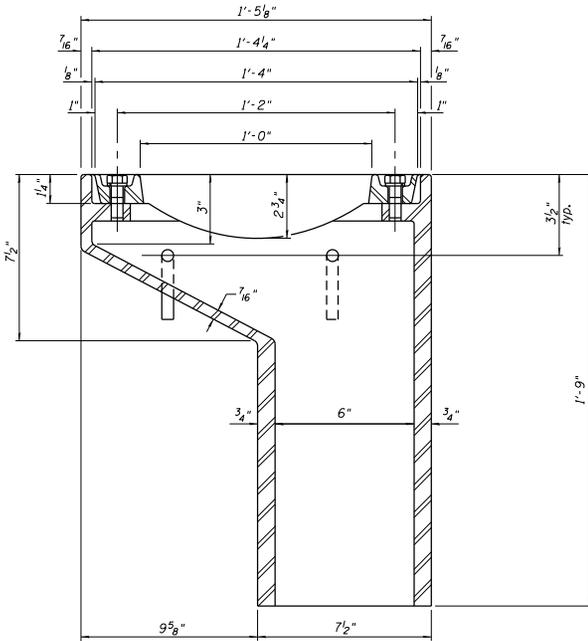


SECTION A-A  
See sheet 14 of 34 for scupper location relative to parapet.

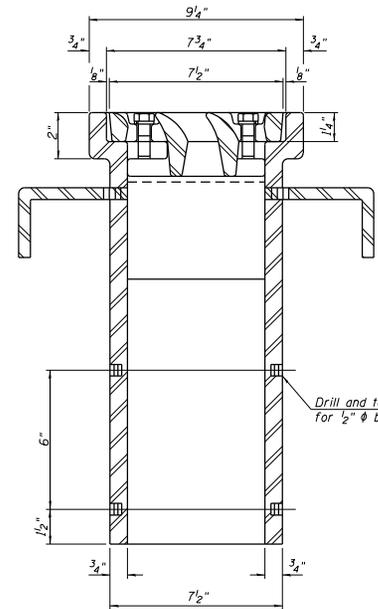

SECTION B-B

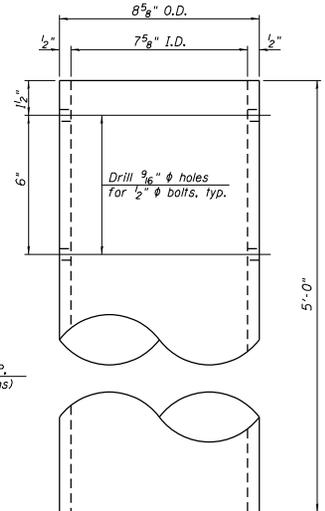

DOWNSPOUT

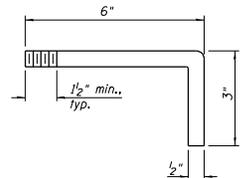

ANCHOR STUD DETAIL

BILL OF MATERIAL

ITEM	UNIT	QUANTITY
Drainage Scupper, DS-II	Each	4

DS-11

2-17-2017

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USER NAME	104-0016-100	DESIGNED	- CPA	REVISED	
Illinois Design Firm Number	104.001670	CHECKED	- ACS	REVISED	
PLOT SCALE	1"=1'-0"	DRAWN	- WJS	REVISED	
PLOT DATE	8/22/2009 3:56:00 PM	CHECKED	- CPA	REVISED	

STATE OF ILLINOIS  
DEPARTMENT OF TRANSPORTATION

DRAINAGE SCUPPER, DS-11  
STRUCTURE NO. 072-0248

SHEET NO. 15 OF 34 SHEETS

F.A.S. SITE	SECTION	COUNTY	TOTAL SHEET NO.
138B	(Z-1VBBR-2)	PEORIA	235 99
			CONTRACT NO. 68799
ILLINOIS FED. AID PROJECT			

