## INDEX OF SHEETS SHEET NO. DESCRIPTION 1 COVER SHEET INDEX OF SHEETS, STANDARDS, AND GENERAL NOTES SUMMARY OF QUANTITIES TYPICAL SECTIONS PLANS SCHEDULE OF QUANTITIES 10 ALIGNMENT, TIES & BENCHMARKS PLAN EXISTING & PROPOSED ROADWAY PLAN / EXISTING PROFILE 13 14**-**17B SUGGESTED STAGES OF CONSTRUCTION AND TRAFFIC CONTROL PROPOSED EROSION CONTROL PROPOSED DRAINAGE PLAN 20-24 PLAT OF HIGHWAYS 25 PROPOSED PAVEMENT MARKING PLAN 26 PROPOSED LANDSCAPING PLAN 27 PROPOSED SIGNING PLAN 28-40 PROPOSED TRAFFIC SIGNAL PLANS 41 CULVERT EXTENSION PLAN DETAILS DRIVEWAY DETAILS - DISTANCE BETWEEN R.O.W AND FACE OF CURB & EDGE OF SHOULDER >= 15\(\frac{1}{2}\) (4.5 m) (BD-01 DRIVEWAY DETAILS - DISTANCE BETWEEN ROW AND FACE OF CURB $\langle 15\frac{1}{2}\rangle$ (4.5 m) PAVEMENT PATCHING FOR HMA SURFACED PAVEMENT (BD-22) BUTT JOINT AND HMA TAPER DETAILS (BD-32) \*\* 46 TRAFFIC CONTROL AND PROTECTION FOR SIDE ROADS, INTERSECTIONS AND, DRIVEWAYS (TC-10) 47 TYPICAL APPLICATIONS RAISED REFLECTIVE PAVEMENT MARKERS (SNOW-PLOW RESISTANT) (TC-11) DISTRICT ONE TYPICAL PAVEMENT MARKINGS (TC-13) SHORT TERM PAVEMENT MARKING LETTERS AND SYMBOLS (TC-16) 51 ARTERIAL ROAD INFORMATION SIGN (TC-22) DELETED 52-57 CROSS SECTION PLANS 40A & 40B SHEETS ADDED HERE \*\* 45A SHEETS ADDED HERE GENERAL NOTES TWO WEEKS PRIOR TO A SCHEDULE TRAFFIC SIGNAL TURN-ON CHANGABLE MESSAGE SIGN IN EACH DIRECTION OF IL-60 SHALL BE INSTALLED WITH THE FOLLOWING MESSAGES: STARTING DATE NEW TRAFFIC FOR SIGNAL TURN-ON ON THE DAY OF THE TURN-ON THE MESSAGE SHALL BE REVISED TO READ: NEW SIGNAL PREPARED USER NAME = paraynoal DESIGNED REVISED ents\IDOT Offices\District 1\Projects\P10941b\DAQDHNo\Design\P109410-Design.dgn REVISED

PLOT SCALE = 100.0588 '/ in.

PLOT DATE = 6/11/2021

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STANDARD NO.	DESCRIPTION

TANDARD	NO. DESCRIPTION
000001-08	STANDARD SYMBOLS, ABBREVIATIONS AND PATTERNS
280001 <b>-</b> 07	TEMPORARY EROSION CONTROL SYSTEMS
442201-03	CLASS C AND D PATCHES
542301-03	PRECAST REINFORCED CONCRETE FLARED END SECTION
542311-07	TRAVERSABLE PIPE GRATE FOR CONCRETE END SECTIONS
701001-02	OFF-ROAD OPERATIONS 2L, 2W, MORE THAN 15'
701201-05	LANE CLOSURE, 2L, 2W, DAY ONLY, FOR SPEEDS > 45 MPH
701301-04	LANE CLOSURE, 2L, 2W, SHORT TIME OPERATIONS
701311-03	LANE CLOSURE, 2L, 2W SLOW, MOVING OPERATIONS- DAY ONLY,
701326-04	LANE CLOSURE, 2L, 2W, PAVEMENT WIDENING FOR SPEEDS > 45 MPH
701701 <b>-</b> 10	URBAN LANE CLOSURE, MULTILANE INTERSECTION
701901 <b>-</b> 08	TRAFFIC CONTROL DEVICES
704001-08	TEMPORARY CONCRETE BARRIER
720001 <b>-</b> 01	SIGN PANEL MOUNTING DETAIL
720006 <b>-</b> 04	SIGN PANEL ERECTION DETAILS
725001-01	OBJECT AND TERMINAL MARKERS
780001-05	TYPICAL PAVEMENT MARKINGS
782006 <b>-</b> 01	GUARDRAIL AND BARRIER WALL REFLECTOR MOUNTING DETAILS
805001-01	ELECTRIC SERVICE INSTALLATION DETAILS
814001-03	HANDHOLES
814006-03	DOUBLE HANDHOLES
857001 <b>-</b> 01	STANDARD PHASE DESIGNATION DIAGRAMS AND PHASE SEQUENCES
862001-01	UNINTERRUPTABLE POWER SUPPLY (UPS)
873001-02	TRAFFIC SIGNAL GROUNDING & BONDING
877001-08	STEEL MAST ARM ASSEMBLY & POLE 16' THROUGH 55'
877011 <b>-</b> 10	STEEL COMBO MAST ARM ASSEMBLY AND POLE 16' THROUGH 55'
878001 <b>-</b> 11	CONCRETE FOUNDATION DETAILS
880006-01	TRAFFIC SIGNAL MOUNTING DETAILS
886001-01	DETECTOR LOOP INSTALLATIONS
	/

GENERAL NOTES

IYPICAL LAYOUTS FOR DETECTOR LOOPS

886006-01

701502-09

THIS PROJECT REQUIRES A US ARMY CORPS OF ENGINEERS (USACE) 404 PERMIT THAT WILL BE SECURED BY THE DEPARTMENT. AS A CONDITION OF THIS PERMIT, THE CONTRACTOR WILL NEDD TO SUBMIT AN IN-STREAM WORK PLAN TO THE DEPARTMENT FOR APPROVAL. GUIDELINES ON ACCEPTABLE IN-STREAM WORK TECHNIQUES CAN BE FOUND ON THE USACE WEBSITE. THE USACE DEFINES AND DETERMINES IN-STREAM WORK. THE COST OF ALL MATERIALS AND LABOR NECESSARY TO COMPLY WITH THE ABOVE PROVISIONS TO PREPARE AND IMPLEMENT AN IN-STREAM WORK PLAN WILL NOT BE PAID FOR SEPARATELY, BUT SHALL BE CONSIDERED AS INCLUDED IN THE UNIT BID PRICES OF THE CONTRACT AND NO ADDITIONAL COMPENSATION WILL BE ALLOWED.

URBAN LANE CLOSURE, 2L, 2W, WITH BIDIRECTIONAL LEFT-TURN LANE

BEFORE STARTING ANY EXCAVATION, THE CONTRACTOR SHALL CALL "JULIE" AT 800-892-0123 OR 811 FOR FIELD LOCATIONS OF BURIED ELECTRIC, TELEPHONE AND GAS FACILITIES. (48 HOUR NOTIFICATION IS REQUIRED).

THE CONTRACTOR SHALL COORDINATE CONSTRUCTION ACTIVITIES WITH UTILITY COMPANIES AND WAUCONDA AND FREEMONT TOWNSHIPS

THE CONTRACTOR WILL NOT BE ALLOWED TO SET UP A YARD OR FIELD OFFICE ON STATE PROPERTY WITHOUT WRITTEN PERMISSION FROM THE DEPARTMENT

## GENERAL NOTES (CONTINUED)

WHEN MILLED PAVEMENT IS OPEN TO TRAFFIC THE MAXIMUM GRADE DIFFERENTIAL BETWEEN PASSES OF THE MILLING MACHINE SHALL NOT EXCEED 1 1/2 INCHES (40 MM) WHERE THE SPEED LIMIT IS 45 MPH (45 KM/H) OR LESS AND 1 INCH WHERE THE SPEED LIMIT IS GREATER THAN 45 MPH (45 KM/H). WITH WRITTEN APPROVAL FROM THE ENGINEER. A MAXIMUM GRADE DIFFERENTIAL OF 3 INCHES MAY BE ALLOWED IF THE EDGE OF THE MILLING IS SLOPED A

BUTT JOINTS WILL BE INSTALLED AT THE ENDS OF ALL RESURFACING (WHERE RESURFACING MEETS EXISTING PAVEMENT), IN ACCORDANCE WITH THE "BUTT JOINT AND HOT-MIX ASPHALT TAPER DETAILS" SHEET INCLUDED IN THE PLANS, UNLESS OTHERWISE SPECIFIED.

THE RESIDENT ENGINEER SHALL CONTACT MR. WALTER CZARNY, IDOT'S AREA TRAFFIC FIELD ENGINEER, VIA EMAIL AT WALTER.CZARNY@ILLINOIS.GOV A MINIMUM OF 2 WEEKS PRIOR TO PLACEMENT OF PERMANENT PAVEMENT MARKING.

BEFORE BEGINNING ANY WORK, THE CONTRACTOR SHALL RETAIN AND RECORD FOR FUTURE REFERENCE, ALL EXISTING PAVEMENT MARKING LINES (AND RAISED REFLECTIVE PAVEMENT MARKERS) IN ORDER THAT THESE LOCATIONS CAN BE RE-ESTABLISHED FOR STRIPING. EXACT LOCATIONS OF ALL PAVEMENT MARKINGS SHALL BE AS DIRECTED BY THE ENGINEER.

IT SHALL BE THE CONTRACTOR'S RESPONSIBILITY TO VERIFY ALL DIMENSIONS AND CONDITIONS EXISTING IN THE FIELD PRIOR TO CONSTRUCTION AND ORDERING OF MATERIALS

THE CONTRACTOR SHALL CONTACT THE DISTRICT ONE TRAFFIC CONTROL SUPERVISOR AT (8847)705-4470 KALPANA KANNAN-HOSADURGA QILLINDIS GOV A MINIMUM OF 72 HOURS IN ADVANCE OF BEGINNING WORK.

THE CONTRACTOR SHALL BE REQUIRED TO PROVIDE ACCESS TO ABUTTING PROPERTY AT ALL TIMES DURING THE CONSTRUCTION OF THIS PROJECT.

PRIOR TO EMBANKMENT PLACEMENT, ALL VEGETATION, LOOSE MATERIAL, AND UNSTABLE MATERIAL SHOUL BE REMOVED TO DEPTH ENCOUNTERED AND REPLACED WITH SUITABLE EMBANKMENT MATERIAL. ANY EMBANKMENT WIDENING ON EXISTING SLOPES SHOULD BE BENCHED IN ACCORDANCE WITH ARTICLE 205.04 OF THE STANDARD SPECIFICATIONS FOR ROAD AND BRIDGE CONSTRUCTION.

THE CONTRACTOR SHALL CHECK THE PROPOSED TRAFFIC SIGNAL EQUIPMENT LOCATIONS FOR OVERHEAD UTILITY CONFLICTS, THE CONTRACTOR SHALL COORDINATE ANY CONFLICTS WITH THE UTILITY COMPANIES AND THE RESIDENT ENGINEER BEFORE ORDERING MATERIALS.

ALL PAVEMENT PATCHING LOCATIONS WILL BE DETERMINED IN THE FIELD BY THE ENGINEER.

THE THICKNESS OF THE HMA MIXTURE SHOWN ON THE PLANS IS THE NOMINAL THICKNESS. DEVIATIONS FROM THE NOMINAL THICKNESS WILL BE PERMITTED WHEN SUCH DEVIATIONS OCCUR DUE TO IRREGULARITIES IN THE EXISTING SURFACE OR BASE ON WHICH THE HMA MIXTURE IS PLACED

ALL DROP-OFFS GREATER THAN 18 INCHES MUST BE BACKFILLED AT THE END OF EACH WORK DAY AND EXCAVATED AREA MUST BE PROTECTED WITH DEVICES PLACED AT THE DROP-OFF ELEVATION TO PRESERVE LANE WIDTH. THE REFLECTIVE AREA AND WARNING LIGHT SHALL BE RAISED TO THE ELEVATION ABOVE TRAVELING LANE REQUIRED BY STANDARD 701901.

GEOTECHNICAL FABRIC FOR GROUND STABILIZATION AND/OR AGGREGATE SUBGRADE IMPROVEMENT (CU YD) HAVE BEEN PROVIDED FOR USE AT THE LOCATIONS INDICATED FOR SOILS THAT TEND TO BE UNSTABLE AND/OR UNSUITABLE. THE ACTUAL NEED FOR REMOVAL AND REPLACEMENT WITH ABOVE ITEM WILL BE DETERMINED IN THE FIELD AT THE TIME OF CONSTRUCTION BY THE GEOTECHNICAL ENGINEER. ALL POTENTIALLY UNSTABLE SOILS SHOULD BE TESTED WITH A STATIC OR DYNAMIC CONE PENETROMETER AND TREATED IN ACCORDANCE WITH ARTICLE 301.04 OF THE SSRBC AND IDOT SUBGRADE STABILITY MANUAL. IF UNSTABLE AND/OR UNSUITABLE SOILS ARE NOT ENCOUNTERED, THEN THE QUANTITY SHALL BE DEDUCTED AND NO ADDITIONAL COMPENSATION WILL BE DUE TO THE CONTRACTOR.

ANY AGGREGATE SUBGRADE IMPROVEMENT CONTAMINATED AND/OR DAMAGED BY THE CONTRACTOR'S VEHICLES AND/OR EQUIPMENTS IS TO BE REMOVED AND REPLACED AS DIRECT BY THE ENGINEER AT CONTRACTOR EXPENSE.

REVISED 7-20-2021

**REV-SEP** 

STATE OF ILLINOIS **DEPARTMENT OF TRANSPORTATION**  INDEX OF SHEETS, LIST OF STATE STANDARDS & GENERAL NOTES FAP 535 / IL ROUTE 60 AT WILSON ROAD

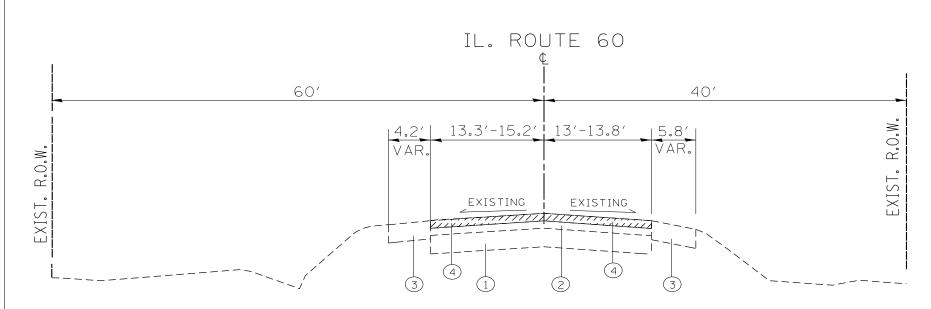
SECTION COUNTY LAKE | 57 | 2 535 118N-2 CONTRACT NO. 60X57 SCALE: 1"=50" SHEET NO. 1 OF 1 SHEETS STA. TO STA. FED. ROAD DIST. NO. | ILLINOIS FED. AID PROJECT

	SUMMARY OF QUANTITIES					•	ON TYPE		1 1	SUMMARY OF QUANTITIES					ONSTRUCTI			
			TOTAL	ROADWAY 0004	INTERCONNECT 0021	Signals 0021	EVP 0021			33		TOTAL	ROADWAY 0004	INTERCONNECT 0021	Signals 0021	EVP 0021		
CODE NO	ITEM	UNIT	l	STATE 10%	FED 90% STATE 6.3% COUNTY 3.7%	FED 90% STATE 10%	FIRE DEPT 100%		CODE NO	ITEM	UNIT	QUANTITIES URBAN		COUNTY 3.7%	FED 90% STATE 10%	FIRE DEPT 100%		
20200100	EARTH EXCAVATION	CU YD	1770	1770					28000400	PERIMETER EROSION BARRIER	FOOT	1600	1600	$\ \land$				
20100110	TREE REMOVAL (6 TO 15 UNITS DIAMETER)	UNIT	38	38										[				
20201200	REMOVAL AND DISPOSAL OF UNSUITABLE	CU YD	1525	1525	<u>}</u>				28000510	INLET FILTERS	EACH	10	10					
	MATERIAL																	
20100210	TREE REMOVAL (60VER 15 UNITS DIAMETER)	UNIT	136	136					28001100	TEMPORARY EROSION CONTROL BLANKET	SQ YD	7550	7550					
20800150	TRENCH BACKFILL	CU YD	19	19														
									30300001	AGGREGATE SUBGRADE IMPROVEMENT	CU YD	475	475					
21001000	GEOTECHNICAL FABRIC FOR GROUND	SQ YD	475	475														
	STABILIZATION								30300112	AGGREGATE SUBGRADE IMPROVEMENT 12"	SO YD	1430	1430					
									35501308	HOT-MIX ASPHALT BASE COURSE, 6"	SO YD	50	50					
21101505	TOPSOIL EXCAVATION AND PLACEMENT	CU YD	1592	1592					40600290	BITUMINOUS MATERIALS (TACK COAT)	POUND	5000	5000					
									40600400	MIXTURE FOR CRACKS, JOINTS, AND	TON	9	9					
										FLANGEWAYS								
25000210	SEEDING, CLASS 2A	ACRE	0.5	0.5										$\triangle$				
									40600982	HOT-MIX ASPHALT SURFACE REMOVAL - BUTT	SO YD	41	41	<u>}</u>				
25000400	NITROGEN FERTILIZER NUTRIENT	POUND	188	188						JOINT		{}		<u>}</u>				
												{		R				
25000500	PHOSPHORUS FERTILIZER NUTRIENT	POUND	188	188					40603090	HOT-MIX ASPHALT BINDER COURSE, IL-19.0,	TON	620	620	<u> </u>				
										N90		( i						
25000600	POTASSIUM FERTILIZER NUTRIENT	POUND	188	188														
									40603200	POLYMERIZED HOT-MIX ASPHALT BINDER	TON	307	307					
25100630	EROSION CONTROL BLANKET	SQ YD	7550	7550						COURSE, IL-4.75, N50								
25200200	SUPPLEMENTAL WATERING	UNIT	151	151					40604060	HOT-MIX ASPHALT SURFACE COURSE, MIX	TON	6	6					
										"D", N50								
28000250	TEMPORARY EROSION CONTROL SEEDING	POUND	156	156														
									40604172	POLYMERIZED HOT-MIX ASPHALT SURFACE	TON	730	730					
28000305	TEMPORARY DITCH CHECKS	FOOT	100	100	}					COURSE, MIX "E", N70								
										* SPECIALTY ITEMS				<u></u>	ISED 7-	20-202	1	REV-SE
ILE NAME =	USER NAME = guilloumefp	DESIGNED -	1	REVISED				07.77		IL ROUTE 60	AT WILSON		1	F.A.P. RTE.		rion		TOTAL SHEET SHEETS NO.
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	SUMMARY OF QUANTITIES				C	ONSTRUCT:	ION TYPE	CODE			SUMMARY OF QUANTITIES				1	CONSTRUCT	ON TYPE	CODE	
	COMMITTEE CONTRACTOR		TOTAL	ROADWAY 0004	INTERCONNECT 0021	SIGNALS 0021	EVP 0021				SOMMAN OF GOANTITIES		TOTAL	ROADWAY 0004	INTERCONNECT 0021	SIGNALS 0021	EVP 0021		
CODE NO	ITEM	UNIT	l	STATE 10%	FED 90% STATE 6.3% COUNTY 3.7%	FED 90% STATE 10%	FIRE DEPT 100%			CODE NO	ITEM	UNIT	QUANTITIES URBAN	FED 90% STATE 10%	FED 90% STATE 6.3% COUNTY 3.77	FED 90% STATE 10%	FIRE DEPT 100%		
44000159	HOT-MIX ASPHALT SURFACE REMOVAL. 2	SO YD	6000	6000						542A0241	PIPE CULVERTS, CLASS A, TYPE 1 36"	FOOT	29	29					
	1/2"									550A0070	STORM SEWERS, CLASS A, TYPE 1, 15"	FOOT	200	200					
										60500050	REMOVING CATCH BASINS	EACH	2	2					
44201803	CLASS D PATCHES, TYPE II, 13 INCH	SO YD	20	20															
										63000003	STEEL PLATE BEAM GUARDRAIL, TYPE A, 9	F00T	1870	1870					
44201807	CLASS D PATCHES, TYPE III, 13 INCH	SO YD	25	25							FOOT POSTS								<u> </u>
																			<u> </u>
44201809	CLASS D PATCHES, TYPE IV, 13 INCH	SO YD	40	40						63100167	TRAFFIC BARRIER TERMINAL, TYPE 1	EACH	4	4	<u> </u> 				<u> </u>
											(SPECIAL) TANGENT								<u> </u>
44201914	CLASS D PATCHES, TYPE II, 22 INCH	SO YD	20	20											<u> </u> 				<u> </u>
		1								63200310	GUARDRAIL REMOVAL	FOOT	310	310					
48101620	AGGREGATE SHOULDERS, TYPE B 10"	SO YD	930	930						64300350	IMPACT ATTENUATORS (FULLY REDIRECTIVE.	FACH	m	m	$\frac{1}{2}$				
										\[ \frac{-64300350}{}{\rightarrow} \]		HACH	1	1 1	}				
48203029	HOT-MIX ASPHALT SHOULDERS, 8"	SO YD	1920	1 920							WIDE), TEST LEVEL 2	•••••	<u> </u>	<u> </u>	3				<del>                                     </del>
50105000	DIDE CHAVEDT DEVOVA	FOOT	220	222				<u> </u>		66000530	SOIL DISPOSAL ANALYSIS	FACU							<u> </u>
50105220	PIPE CULVERT REMOVAL	FOOT	220	220						66900530	SUIL DISPUSAL ANALYSIS	EACH	2	2					_
50800105	REINFORCEMENT BARS	POUND	112	112						66901001	REGULATED SUBSTANCES PRE-CONSTRUCTION	LSUM	1	1					+
											PLAN								
54002020	EXPANSION BOLTS 3/4 INCH	EACH	32	32															
										66901003	REGULATED SUBSTANCES FINAL CONSTRUCTION	LSUM	1	1					
54213660	PRECAST REINFORCED CONCRETE FLARED END	EACH	8	8							REPORT								
	SECTIONS 15"	<u> </u>																	
										66901006	REGULATED SUBSTANCES MONITORING	CAL DA	15	15					
54213681	PRECAST REINFORCED CONCRETE FLARED END	EACH	4	4															
	SECTIONS 36"									67000400	ENGINEER'S FIELD OFFICE, TYPE A	CAL MO	9	9					<u> </u>
																			<u> </u>
54248510	CONCRETE COLLAR	CU YD	2.4	2. 4						67100100	MOBILIZATION	L SUM	1	1					<u> </u>
542A0220	PIPE CULVERTS, CLASS A, TYPE 1 15"	FOOT	149	149						70103815	TRAFFIC CONTROL SURVEILLANCE	CAL DA	30	30		<u> </u>			
											* SPECIALTY ITEMS				↑ REV	ISED 7	20-20	1	DEV. 65:
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	SUMMARY OF QUANTITIES			D0 : 0::::		RUCTION T					SUMMAR	Y OF QUANTITIES				ONSTRUCTI		ODE	
			TOTAL	0004	INTERCONNECT SIGN		1							TOTAL	ROADWAY INTERCONNECT 00021	SIGNALS 0021	EVP 0021		
CODE NO	ITEM	UNIT	QUANTITIES URBAN	FED 90% STATE 10%	FED 90% FED STATE 6.3% STATE COUNTY 3.7%	90% FIRE 10% DEP1 100%	•			CODE NO		ITEM	UNIT	QUANTITIES URBAN	FED 90% FED 90% STATE 10% STATE 6.3% COUNTY 3.7%	FED 90% STATE 10%	FIRE DEPT 100%		
70300100	SHORT TERM PAVEMENT MARKING	F 00T	4200	4200					*	78000100	THERMOPLASTIC	PAVEMENT MARKING -	SO FT	72.6	72.6				
											LETTERS AND S	SYMBOL S							
70300150	SHORT TERM PAVEMENT MARKING REMOVAL	SO FT	1400	1400															
70107025	CHANGEABLE MESSAGE SIGN	CAL DA	30	30	<u>}</u>				_*	78000200	THERMOPLASTIC	PAVEMENT MARKING - LINE	FOOT	7700	7700				
70300210	TEMPORARY PAVEMENT MARKING LETTERS AND	SO FT	72.6	72.6							4"								
	SYMBOLS																		
									<del> </del>	78000400	THERMOPLASTIC	PAVEMENT MARKING - LINE	FOOT	700	700				_
70300220	TEMPORARY PAVEMENT MARKING - LINE 4"	F OOT	7700	7700							6"								 
70300240	TEMPORARY PAVEMENT MARKING - LINE 6"	FOOT	700	700					_  _ <del> </del>	78000600	THERMOPLASTIC	PAVEMENT MARKING - LINE	FOOT	150	150				$\vdash$
											12"								H
70300260	TEMPORARY PAVEMENT MARKING - LINE 12"	F 00T	150	150				,	*	78009004	MODIFIED URETH	ANE PAVEMENT MARKING - LINE 4"	FOOT	5500	5500				T
									*	78000650		PAVEMENT MARKING - LINE	FOOT	100	100				T
70300280	TEMPORARY PAVEMENT MARKING - LINE 24"	F 00T	100	100							24"	·····		~~~					
									*	78009024	MODIFIED URETHA	NE PAVEMENT MARKING - LINE 24"	FOOT	24	24 3				
70300520	PAVEMENT MARKING TAPE, TYPE III 4"	F OOT	1050	1050					*	78100100	RAISED REFLEC	CTIVE PAVEMENT MARKER	EACH	30	30				<u> </u>
70700004	DAVENEUT MADWING TARE TYPE IV. 4"	F007	5500	5500						7020005	CUADODA II DEI	THEOTOPS TWOSE A	FACU	70	70				$\perp$
70300904	PAVEMENT MARKING TAPE, TYPE IV 4"	FOOT	5500	5500						78200005	GUARDRAIL REF	TLECTORS, TYPE A	EACH	30	30				<u> </u>
70400100	TEMPORARY CONCRETE BARRIER	F 00T	1160	1160					_ <del> </del> _ <del> </del> *	78200011	BARRIER WALL	REFLECTORS, TYPE C	EACH	180	180				
70400200	RELOCATE TEMPORARY CONCRETE BARRIER	F 00T	1130	1130						78300200	RAISED REFLEC	CTIVE PAVEMENT MARKER	EACH	18	18				<u> </u> 
70600260	IMPACT ATTENUATORS, TEMPORARY (FULLY REDIRECTIVE NARROW), TEST LEVEL 3	EACH	4	4	3						REMOVAL								T
70600320	IMPACT ATTENUATORS, RELOCATE (FULLY	EACH	2	2	31														Ĺ
	REDIRECTIVE), TEST LEVEL 2				3				_ *	81028200	UNDERGROUND (	CONDUIT, GALVANIZED STEEL,	FOOT	2841	604	2237			
70600332	IMPACT ATTENUATORS, RELOCATE (FULLY REDIRECTIVE NARROW), TEST LEVEL 3	EACH	2	<u>2</u>	3						2" DIA.								_
72000100	SIGN PANEL - TYPE 1	SO FT	70	49	21				┨.										1
72501000	TERMINAL MARKER OVEREST CONVER	F40::	7						_ <del> *</del> -	81028220		CONDUIT, GALVANIZED STEEL,	FOOT	104	104				1
72501000	TERMINAL MARKER - DIRECT APPLIED	EACH	3	3	$\wedge$				_		3" DIA.								$\perp$
72800100	TELESCOPING STEEL SIGN SUPPORT	FOOT	82	82	3						—————————————————————————————————————	ALTY ITEMS						_	1
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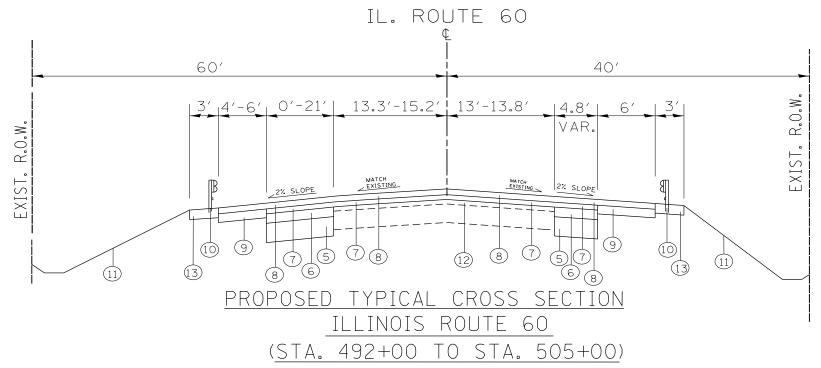
Code of   Code			SUMMARY OF QUANTITIES			D0.10W.11		ONSTRUCTI		CODE	-	SUMMARY OF QUANTITIES			D0 10 m11		ONSTRUCTI		CODE	
1995   1995	F				TOTAL	ROADWAY 0004	INTERCONNECT 0021	SIGNALS 0021	EVP 0021			-		TOTAL	ROADWAY 0004	INTERCONNECT 0021	SIGNALS 0021	EVP 0021		
1000    1000		CODE NO	ITEM	UNIT	QUANTITIES	FED 90% STATE 10%	FED 90% STATE 6.3%		DEPT		CODE NO	ITEM	UNIT	QUANTITIES	FED 90% STATE 10%	FED 90% STATE 6.3%	FED 90% STATE 10%	DEPT		
## MINISTRATE SCHOOL MINISTRATE (AMERICAN)	L				O N.B. (IV		COUNTY 3.7%		100%	1			<u>~~~~</u>	I CIVE/ III	m	COUNTY 3.7%	·	<del>}</del>		+
MERCOP   TOWN TO STEAM RECEPTATE LEADINGS   Labor   C	<b>⊬</b> [ 	88030110		EACH	2		2			{	* * * * * * * * * * * * * * * * * * *	SPETCE FIBER IN CABINET	EACH	, in the same	<del></del>	·····	$\overline{}$	3 🗥	<u> </u>	$\perp$
### 2000   Martic Street, Machania, Laborato, Laborato, Laborato, 1, 1994   Martic Street, Machania, Conference   Machania, Conference   Martic Street, Machania, Conference   Martic Street, Machania, Conference   Machania, Conference	Ļ		MAST-ARM MOUNTED																<u> </u>	1
Table Plant	Ļ			1	1		1				x2501800	SEEDING, CLASS 4 (MODIFIED)	ACRE	1.25	1.25				<u> </u>	
Marcollina   Industria   Ind	*	88200410	TRAFFIC SIGNAL BACKPLATE, LOUVERED,	EACH	6		6												<u> </u>	
100   176			FORMED PLASTIC								- x2502024	SEEDING, CLASS 4B (MODIFIED)	ACRE	1.25	1. 25				<u> </u>	-
### ### ##############################	_ <b>⊬</b> [	88500100	INDUCTIVE LOOP DETECTOR	EACH	3		3				X7010216	TRAFFIC CONTROL AND PROTECTION,	L SUM	1	1					$\frac{1}{1}$
## 1700000 Light Detectors    EACH   2												(SPECIAL)								+
STATEORIO   LIGHT DETECTOR AMPLIFIER   EACH   1	*	88600100	DETECTOR LOOP, TYPE I	FOOT	176		176													$\frac{1}{1}$
# 8200300 LIGHT DETECTION AMPLETIER  # 8400300 LIGHT DETECTION AMPLET DETECTION AMPLET LIGHT DETECTION LIGH											x7030005	TEMPORARY PAVEMENT MARKING REMOVAL	SO FT	3340	3340					
SERVICE   STATE OF BELLEVICE   STATE	$ egthinspace \mathbb{L}$	88700200	LIGHT DETECTOR	EACH	2				2											
STATE OF   PURCET WENTER PROPERTY STSTEM LINE   FOOT   256   256   256   256   257.55, MILET SEARCH COMBUST, NO.   FOOT   2827											x8620200	UNINTERRUPTABLE POWER SUPPLY, SPECIAL	EACH	1		1				
X0324095   EMERCENCY VEHICLE PRIORITY SYSTEM LINE   FOOT   256   256   256   66, 57 (25, MA)27   SA247	$*$ $\lfloor$	88700300	LIGHT DETECTOR AMPLIFIER	EACH	1				1											
SENSOR CABLE, NO. 20 3/C   A											X8710024	FIBER OPTIC CABLE IN CONDUIT, NO.	FOOT	2827			2827			
20032999   PULD DISTRICT STOM STRINGS	$*$ $\lfloor$	X0324085	EMERGENCY VEHICLE PRIORITY SYSTEM LINE	FOOT	256				256			62. 5/125, MM12F SM24F								
X0326559   PLUD DESTRIG STRIMS MEMBES	$\downarrow$	~~~	•																	
## X1400081 FULL-ACTUATED CONTROLLER AND TYPE SUPER EACH 1 1 1 20028415 GEOTECHNICAL REINFORGEMENT SO VD 475 475			PLUG EXISTING STORM SEWERS				[3				Z0013798	CONSTRUCTION LAYOUT	L SUM	1	1					
T8300201   PAVERENT MARKING RENOVAL - ORRONG   S0 FT   1890   1890   1890   1890   1890   1890   1890   1890   1890   1890   1891   1	*	X1400081		EACH	1		1				Z0028415	GEOTECHNICAL REINFORCEMENT	SO YD	475	475					
TRIDOZO   PARMENT MARKING BENOVAL - GROUNG   S. PT   1890   1890		~~~		~~~~	· · · · · · · · · · · · · · · · · · ·	~~~	$\sum_{i}$				Z0030850	TEMPORARY INFORMATION SIGNING	SO FT	77.1	77. 1					
X 1400102   OUTDOOR RATED NETWORK CABLE   FOOT   181   181			PAVEMENT MARKING REMOVAL - GRINDING				3													
X1400150   SERVICE INSTALLATION, GROUND MOUNTED,   EACH   1   1	*	X1400102	OUTDOOR RATED NETWORK CABLE	FOOT	181		181				Z0033046	RE-OPTIMIZE TRAFFIC SIGNAL SYSTEM LEVEL	EACH	1			1			
X 1400150   SERVICE INSTALLATION, GROUND MOUNTED,   EACH														· · · · · · · · · · · · · · · · · · ·	· · · · · · · · · · · · · · · · · · ·					
METERED	*[	X1400150	SERVICE INSTALLATION, GROUND MOUNTED,	EACH	1		1				ا با	TEMPORARY PAVEMENT (VARIABLE DEPTH)	TON	7	7 4					
X1400201 RADAR VEHICLE DETECTION SYSTEM, SINGLE EACH 1 1 1 1 1 1 1 1 1 1 1 1 1 1 1 1 1 1 1			METERED								Ø z0076600			500	500					
APPROACH, STOP BAR   X1400439 REMOTE CONTROLLED VIDEO SYSTEM  EACH 1  X1400451 LAYER II (DATA LINK) SWITCH  EACH 1  X1400452 TERMINATE FIBER IN CABINET  EACH 24  X1400453 SPLICE FIBER INCABINET  EACH 1  X1400453 SPLICE FIBER INCABINET  EACH 1  X1400453 SPLICE FIBER INCABINET  EACH 1  X1400450 TERMINATE FIBER IN CABINET  EACH 24  X1400450 TERMINATE FIBER IN CABINET  EACH 1  X1400450 TERMINATE FIBER IN CABINET  EACH 24  X1400453 SPLICE FIBER INCABINET  EACH 1  X1400450 TERMINATE FIBER IN CABINET  EACH 24  X1400450 SPLICE FIBER INCABINET  EACH 1  X1400450 TERMINATE FIBER IN CABINET  EACH 24  X1400450 SPLICE FIBER INCABINET  EACH 1  X1400450 SPLICE FIBER INCABINET  EACH 24  XSPECIAL TY ITEMS  ILL ROUTE 60 AT WILSON ROAD  SIMMABAY OF DIJANTITIES  SIMMABAY OF DIJANTITIES  SIMMABAY OF DIJANTITIES											Ø z0076604	TRAINEES-TRAINING PROGRAM GRADUATE	HOURS	500	500					
APPROACH, STOP BAR   X1400439 REMOTE CONTROLLED VIDEO SYSTEM  EACH 1 1  X1400451 LAYER II (DATA LINK) SWITCH  EACH 1 1  X1400452 TERMINATE FIBER IN CABINET  EACH 24  X1400453 SPLICE FIBER IN CABINET  EACH 1 1  X1400455 LANGE  EACH 1 1  X1400455 LANGE  X1400455 LANGE  EACH 1 1	*[	X1400201	RADAR VEHICLE DETECTION SYSTEM, SINGLE	EACH	1		1					··········		· · · · · · · · · · · · · · · · · · ·			$\sim$	$\triangle$		
** X1400215 REMOTE CONTROLLED VIBEO SYSTEM EACH 1 1 1			APPROACH, STOP BAR							1 1 1	ا ا ا									
**X1400453 SPLICE FIBER IN CABINET EACH 1 1 1 **  **X1400217 TERMINATE FIBER IN CABINET EACH 24 **  ***SPECIALTY ITEMS  ***SPECIALTY ITEMS  ***SPECIALTY ITEMS  ***ITEM NAME = guilloumer's DESIGNED - REVISED - REVISED - REVISED - REVISED - STATE OF ILLINOIS  ***IL ROUTE 60 AT WILSON ROAD SIL ROUTE 60 AT WILSON	4	<u> </u>	·····	m	<u> </u>	<u> </u>	~~~	~~~	$2\sqrt{V}$		X1400451	LAYER II (DATA LINK) SWITCH	EACH	1		1				
**SPECIALTY ITEMS  **IL ROUTE 60 AT WILSON ROAD FOR PURISON PROPERTY OF	*[	X1400215	REMOTE CONTROLLED VIDEO SYSTEM	EACH	1		1		3		X1400452	TERMINATE FIBER IN CABINET	EACH	24		24				
**SPECIALTY ITEMS  **SPECIAL TYPICAL ITEMS											ו ו'וא			_		_				
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EXISTING TYPICAL CROSS SECTION

ILLINOIS ROUTE 60

(STA. 492+00 TO STA. 505+00)



#### NOTES:

THE UNIT WEIGHT USED TO CALCULATE ALL HMA SURFACE COURSE MIXTURES IS 112 LBS/SQ YD/IN

"THE "AC TYPE" FOR POLYMERIZED HMA MIXES SHALL BE "SBS/SBR PG 76-22" AND FOR NON-POLYMERIZED HMA THE "AC TYPE" SHALL BE "PG 64-22" UNLESS MODIFIED BY SPECIAL PROVISIONS." FOR USE OF RECYCLED MATERIALS SEE SPECIAL PROVISIONS

QUALITY MANAGEMENT PROGRAM (QMP) IDENTIFIES THE PARTICULAR QUALITY CONTROL SPECIFICATION THAT APPLIES TO THE HMA MIXTURE

### LEGEND

- 1) EXISTING P.C.C. PAVEMENT, ± 9"
- (2) EXISTING HMA SURFACE COURSE, ± 13"
- (3) EXISTING AGGREGATE SHOULDER, TYPE B, 6"
- (4) PROPOSED HMA SURFACE REMOVAL, 2 1/2"
- (5) PROPOSED AGGREGATE SUBGRADE IMPROVEMENT, 12"
- (6) PROPOSED HMA BINDER COURSE, IL-19, N90, 7 3/4"
- 7) PROPOSED POLYMERIZED HMA BINDER COURSE, N50, IL 4.75 3/4"
- (8) PROPOSED POLYMERIZED HMA SURFACE COURSE, (IL 9.5 mm), MIX "E", N70, 1 3/4"
- (9) PROPOSED HMA SHOULDER, 8" (SURFACE AND BINDER)
- (10) PROPOSED GUARDRAIL (SEE PLAN SHEET)
- (11) PROPOSED TOPSOIL, 6"
- (12) EXISTING HMA AFTER REMOVAL, ± 11"
- (13) PROPOSED AGGREGATE SHOULDER, TYPE B, 10"

MIXTURE TYPE	AIR VOIDS (%) @Ndes	QUALITY MANAGEMEN' PROGRAM (QMP)
PAVEMENT WIDENING		
POLYMERIZED HMA SURFACE COURSE, MIX "E", N7O (IL 9.5 mm), 1 3/4"	4% AT 70 GYR.	QC/QA
POLYMERIZED HMA BINDER COURSE, IL-4.75, N50, 3/4″	3.5% AT 50 GYR.	QC/QA
HMA BINDER COURSE, IL-19, N90, 7 3/4"	4% AT 90 GYR.	QC/QA
PAVEMENT RESURFACING	•	
POLYMERIZED HMA SURFACE COURSE, MIX "E", N70 (IL 9.5 mm) , 1 3/4"	4% AT 70 GYR.	QC/QA
POLYMERIZED HMA BINDER COURSE, IL-4.75, N50, 3/4"	3.5% AT 50 GYR.	QC/QA
PATCHING		
CLASS D PATCH (HMA BINDER, IL-19.0 mm)	4% AT 70 GYR.	QC/QA
HMA SHOULDER, 8"		
POLYMERIZED HMA SURFACE COURSE, MIX "E", N70 (IL 9.5 mm), 1 3/4"	4% AT 70 GYR.	QC/QA
HMA BINDER COURSE, IL-19, N90, 6 1/4"	4% AT 90 GYR.	QC/QA
HMA DRIVEWAYS		
HMA SURFACE COURSE, MIX "D", N50 (IL 9.5 mm), 2"	4% AT 50 GYR.	QC/QA
HMA BASE COURSE, (HMA BINDER IL-19 mm), 6"	4% AT 50 GYR.	QC/QA

HMA SURFACE COURSE, MIX "D", N50 (IL 9.5 mm); VARIABLE DEPTH 4% AT 50) GYR. QC/QA

QMP DESIGNATION: QUALITY CONTROL/QUALITY ASSURANCE (QC/QA); QUALITY CONTROL FOR PERFORMANCE (QCP) PAY FOR PERFORMANCE (PFP)

↑ REVISED 7-20-2021

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	PLOT SCALE = 100.0097 '/ in.	CHECKED	REVISED	DEPARTMENT OF TRANSPORTATION	IL ROUTE 60 AT WILSON ROAD			CONTRACT	NO. 60X57
	PLOT DATE = 6/17/2021	DATE	REVISED		SCALE: N/A SHEET NO OF SHEETS STA TO STA	_	ILLINOIS FED. AI	D PROJECT	

EARTHWORK SCHEDULE (IL 60)									
IL RTE 60 AT WILSON ROAD	EARTH EXCAVATION (CU. YD.)	TOP SOIL EXCAVATION (CU. YD.)	EXCAVATION USED AS EMBANKMENT (SHRINKAGE 15%) (CU. YD.)	(CII AD)	TOP SOIL PLACEMENT (CU. YD.)	EARTH WORK BALANCE SURPLUS (+) OR SHORTAGE (-) (CU. YD.)	TOP SOIL BALANCE SURPLUS (+) OR SHORTAGE (-) (CU. YD.)		
STAGE 1	878	801	746	548	235	198	566		
STAGE 2	768	729	653	672	247	-19	482		
TOTAL	1646	1530	1399	1220	482	179	1048		

		EA	RTHWORK	SCH	EDULE (V	VILSON RD.)	
IL RTE 60 AT WILSON ROAD	EARTH EXCAVATION (CU. YD.)	TOP SOIL EXCAVATION (CU. YD.)	EXCAVATION USED AS EMBANKMENT (SHRINKAGE 15%) (CU. YD.)	(CII YD)	TOP SOIL PLACEMENT (CU. YD.)	EARTH WORK BALANCE SURPLUS (+) OR SHORTAGE (-) (CU. YD.)	TOP SOIL BALANCE SURPLUS (+) OR SHORTAGE (-) (CU. YD.)
STAGE 1	124	62	105	51	53	55	0
STAGE 2	0	0	0	0	0	0	0
TOTAL	124	62	105	51	53	55	0

NOTE:

SURPLUS OF TOPSOIL MATERIAL WILL BE PAID AS "REMOVAL AND UNSUITABLE MATERIAL".

TREE REMOVAL												
STATION	OFFSET	TREE REMOVAL (6 TO 15 UNITS DIAMETER) (UNIT)	TREE REMOVAL (OVER 15 UNITS DIAMETER) (UNIT)									
494+60	33	14										
494+92	35		24									
495+05	38		18									
496+51	28		42									
497+11	35	12										
498+04	34		24									
499+31	33		18									
499+57	38	12										

1	REVISED	7-20-2021

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#### MAINTENANCE OF TRAFFIC GENERAL NOTES

ALL OF THE TRAFFIC CONTROL DEVICES SHALL BE IN PLACE BEFORE CONSTRUCTION IS STARTED. ALL TEMPORARY PAVEMENT MARKINGS & TRAFFIC CONTROL DEVICES SHALL BE IN PLACE AT THE BEGINNING OF EACH STAGE, AND SHALL BE MAINTAINED FOR THE DURATION OF THAT STAGE UNLESS OTHERWISE DIRECTED BY THE ENGINEER.

A MINIMUM OF TWO (2) ELEVEN FOOT (11') LANES, ONE IN EACH DIRECTION, SHALL BE KEPT OPEN TO TRAFFIC ON IL ROUTE 60 AND ON WILSON ROAD.

ACCESS SHALL BE MAINTAINED TO ALL PROPERTIES DURING CONSTRUCTION OPERATIONS WITH THE USE OF AGGREGATE FOR TEMPORARY ACCESS AND/OR BY CONSTRUCTING ONE HALF OF PROPOSED DRIVEWAYS AT A TIME.

PROVIDE TEMPORARY HMA RAMP WEDGE TO TRANSITION THE DIFFERENTIAL ELEVATIONS CAUSED BY STAGED CONSTRUCTION BETWEEN THE NEW CONSTRUCTION AND THE EXISTING PAVEMENT. ANY PAVEMENT DROP-OFFS GREATER THAN 3 INCHES IMMEDIATELY ADJACENT TO TRAFFIC SHALL NOT BE LEFT OVERNIGHT. PROVIDE TEMPORARY HMA RAMP WEDGE OR OTHER MITIGATING MEASURES APPROVED BY THE ENGINEER. THE RAMP WEDGE SHALL USE HMA SURFACE COURSE AND WILL BE PAID FOR WITH THE APPLICABLE MIXTURE TYPE PER TON.

CHANNELIZING DEVICES ARE TO BE PLACED AT SAME LEVEL AS TRAVELING LANE OR SHOULDER PROFILE.

CHANNELIZING DEVICES MAY BE PLACED AT THE DROP-OFF ELEVATION TO PRESERVE LANE WIDTH. THE REFLECTIVE AREA AND WARNING LIGHT SHALL BE RAISED TO THE ELEVATION ABOVE THE TRAVELING LANE OR SHOULDER PROFILE AS REQUIRED BY STANDARD 701901.

CHANNELIZING DEVICES ARE TO BE PLACED AT THE SAME LEVEL AS SIDE SLOPE PROFILE TO BE FULLY VISIBLE.

THE CONTRACTOR SHALL MAINTAIN TRAFFIC IN ACCORDANCE WITH THE PLANS, SPECIAL PROVISIONS, STATE STANDARDS AND AS DIRECTED BY THE ENGINEER.

THE CONTRACTOR SHALL INFORM THE ENGINEER OF ANY CHANGES IN STAGING AT LEAST TWO (2) WORKING DAYS IN ADVANCE.

ALL "ROAD CONSTRUCTION AHEAD" SIGNS SHALL BE EQUIPPED WITH MONO-DIRECTIONAL AMBER FLASHING LIGHTS.

EXISTING TRAFFIC CONTROL DEVICES WITHIN THE LIMITS OF CONSTRUCTION, ARE TO BE PROTECTED FROM DAMAGE BY THE CONTRACTOR. ANY DAMAGED SIGNS CAUSED BY HIS WORK SHALL BE REPLACED BY THE CONTRACTOR.

TRAFFIC CONTROL DEPICTED ON THE MAINTENANCE OF TRAFFIC PLANS IS THE MINIMUM REQUIREMENT. OTHER WORK OR SIGNING MAY BE REQUIRED BY THE ENGINEER.

PAVEMENT MARKING TAPE, TYPE IV SHALL BE USED ON ALL FINAL PAVEMENT SURFACES AND EXISTING PAVEMENT SURFACES TO REMAIN. MODIFIED URETHANE PAVEMENT MARKINGS SHALL BE USED ON TEMPORARY PAVEMENT OR EXISTING PAVEMENT THAT IS TO BE REMOVED.

ALL EXISTING PAVEMENT MARKINGS IN CONFLICT WITH THE PAVEMENT MARKING TAPE, TYPE IV AND/OR MODIFIED URETHANE USED FOR STAGING SHALL BE REMOVED. THIS WORK SHALL BE PAID FOR AS "PAVEMENT MARKING REMOVAL-GRINDING" WITHIN THE PROJECT LIMITS AND "PAVEMENT MARKING REMOVAL-WATER BLASTING" OUTSIDE THE PROJECT LIMITS.

ALL MODIFIED URETHANE PAVEMENT MARKINGS USED FOR STAGING SHALL BE REMOVED VIA WATER BLASTING WITH VACUUM RECOVERY ON FINAL PAVEMENT SURFACES, AND VIA GRINDING ON EXISTING OR TEMPORARY PAVEMENT SURFACES THAT ARE TO BE REMOVED. THIS WORK SHALL BE PAID FOR AS "TEMPORARY PAVEMENT MARKING REMOVAL".

CHANGEABLE MESSAGE SIGNS SHALL BE INSTALLED TWO WEEKS PRIOR TO TRAFFIC STAGE CHANGES AND NEW TRAFFIC SIGNAL TURN-ON EVENTS ON EACH APPROACH OF THE EFFECTED ROADWAY TO WARN MOTORISTS OF THE UPCOMING EVENT. THE SIGNS SHALL BE REMOVED TWO WEEKS THEREAFTER UNLESS THE SIGNS ARE NEEDED AGAIN FOR A SUBSEQUENT FUTURE EVENT THAT WILL OCCUR WITHIN TWO WEEKS ON THE SAME APPROACH OF THE EFFECTED ROADWAY. THE SIGN LOCATIONS SHALL BE DETERMINED BY THE ENGINEER.

### MAINTENANCE OF TRAFFIC STAGING NOTES

#### PRE-STAGE

APPLICABLE HIGHWAY STANDARDS FOR TRAFFIC CONTROL AND PROTECTION FOR DAY-TIME LANE CLOSURES SHALL BE UTILIZED TO PERFORM THE FOLLOING WORK:

- MAINTAIN DRIVEWAYS AND ENTRANCE ACCESS WITH TEMPORARY ACCESS (EACH)
- RELOCATION OF UTILITIES

#### STAGE 1

TRAVEL WAY SHALL REMAIN AS ONE LANE IN EACH DIRECTION ON IL ROUTE 60 AND ON WILSON ROAD.

ALL PROPOSED WORK SHALL BE EXECUTED WITHIN THE WORK AREA, THIS INCLUDES, BUT IS NOT LIMITED TO:

- 1. PERFORM EARTH AND PROPOSED DITCH GRADING IN WORK ZONE
- CONSTRUCT PAVEMENT WIDENING, SHOULDERS, CULVERTS EXTENSION AND GUARDRAIL PLACEMENT ON NORTH SIDE OF IL 60 AND ON EACH SIDE OFWILSON ROAD.

#### STAGE II

TRAVEL WAY SHALL REMAIN AS ONE LANE IN EACH DIRECTION ON IL ROUTE 60 AND ON WILSON ROAD.

ALL PROPOSED WORK SHALL BE EXECUTED WITHIN THE WORK AREA, THIS INCLUDES, BUT IS NOT LIMITED TO:

- 1. PERFORM EARTH AND PROPOSED DITCH GRADING IN WORK ZONE
- 2. CONSTRUCT PAVEMENT WIDENING, SHOULDERS, CULVERTS EXTENSION AND GUARDRAIL PLACEMENT ON SOUTH SIDE OF IL 60.

### STAGE III (NOT SHOWN ON MAINTENANCE OF TRAFFIC PLAN SHEETS)

ALL REMAINING PROPOSED WORK SHALL BE COMPLETED DURING THIS STAGE. THIS INCLUDES, BUT IS NOT LIMITED TO:

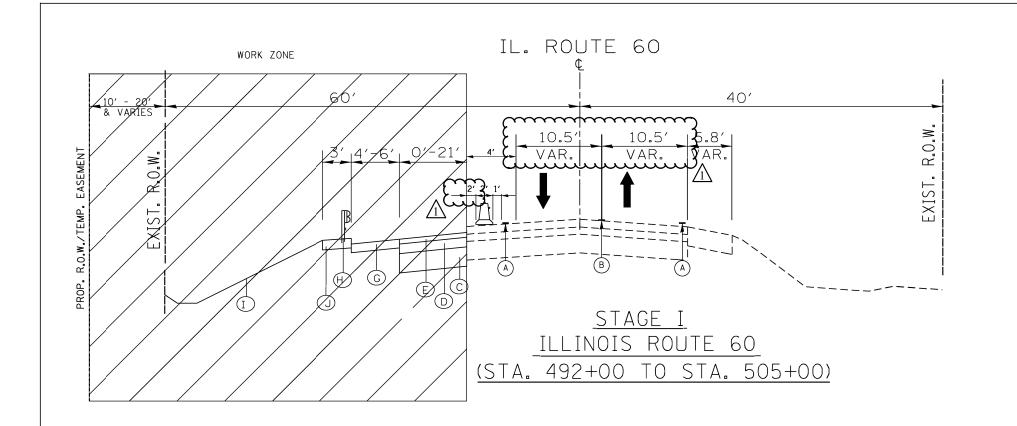
- RESURFACING OF REMAINING EXISTING PAVEMENT
- PLACEMENT OF HMA SURFACE COURSE WITHIN THE ENTIRE PROJECT LIMITS
- INSTALLATION OF PROPOSED LANDSCAPING THROUGHOUT PROJECT LIMITS
- INSTALLATION OF PROPOSED ROADWAY SIGNS
- INSTALLATION OF PROPOSED THERMOPLASTIC PAVEMENT MARKINGS AND RAISED REFLECTIVE PAVEMENT MARKERS (WHERE APPLICABLE)
- INSTALLATION OF PROPOSED TRAFFIC SIGNALS

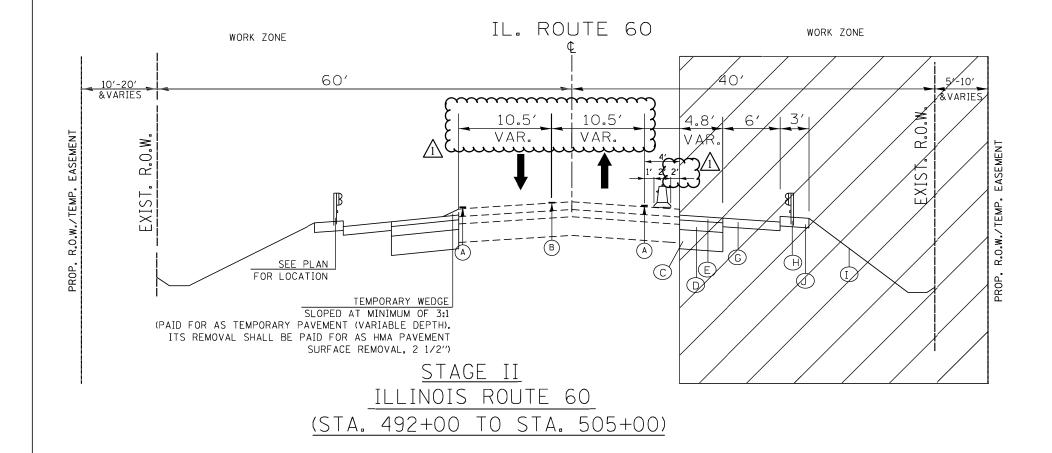
↑ REVISED 7-20-2021

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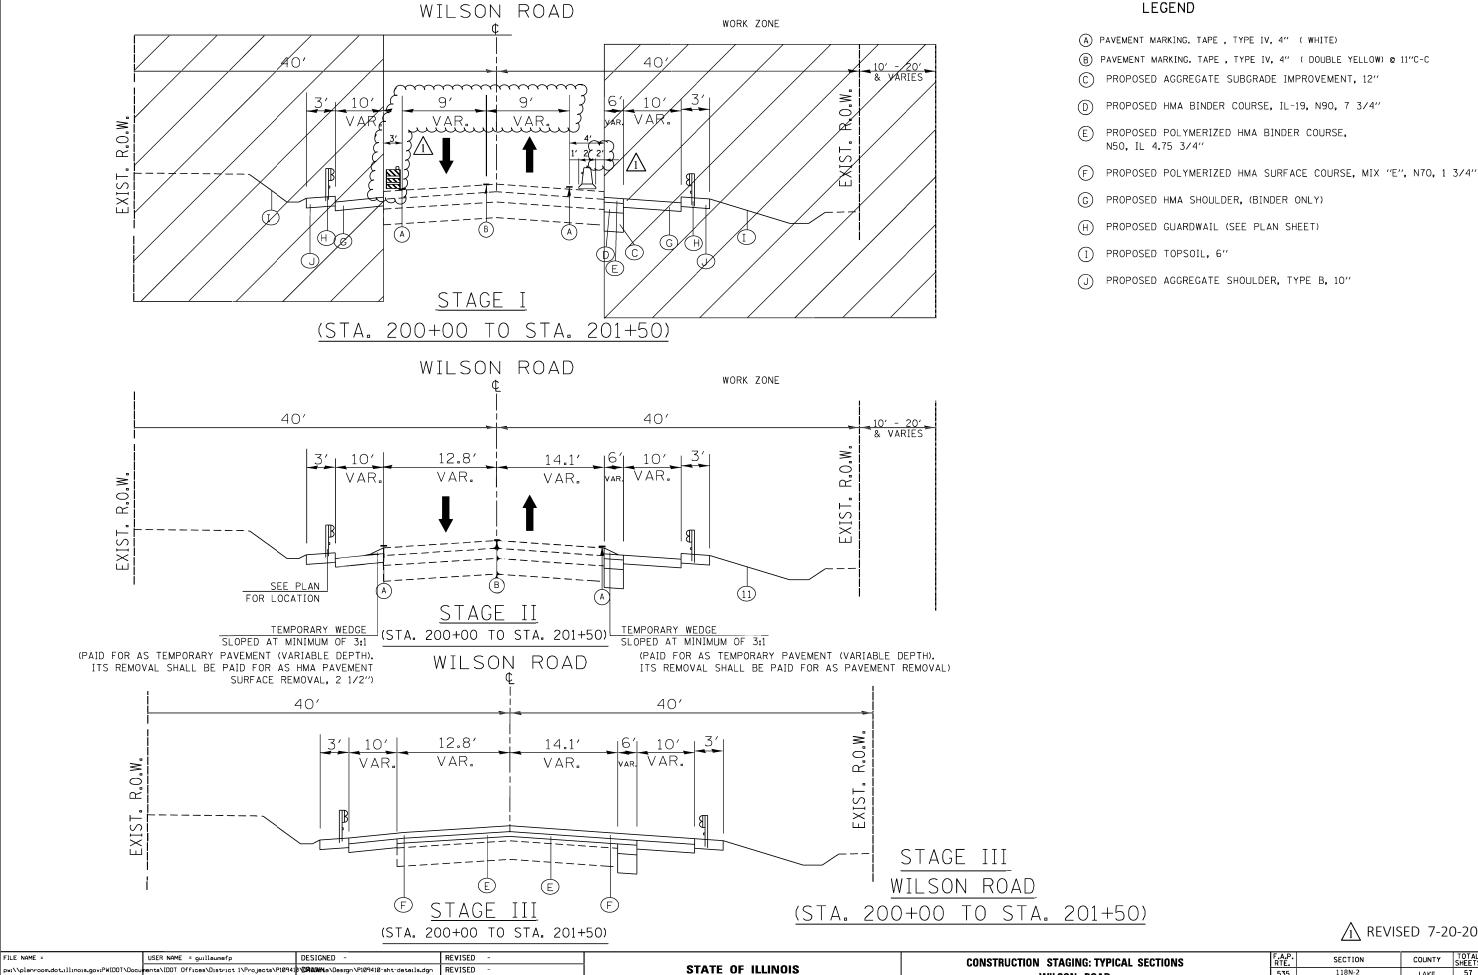


## LEGEND

- (A) PAVEMENT MARKING. TAPE , TYPE IV, 4" ( WHITE)
- (B) PAVEMENT MARKING. TAPE , TYPE IV, 4" ( DOUBLE YELLOW) @ 11"C-C
- (C) PROPOSED AGGREGATE SUBGRADE IMPROVEMENT, 12"
- D PROPOSED HMA BINDER COURSE, IL-19, N90, 7 3/4"
- (E) PROPOSED POLYMERIZED HMA BINDER COURSE, N50, IL 4.75 3/4"
- F) PROPOSED POLYMERIZED HMA SURFACE COURSE, MIX "E", N70, 1 3/4"
- G PROPOSED HMA SHOULDER, (BINDER ONLY)
- (H) PROPOSED GUARDWAIL (SEE PLAN SHEET)
- PROPOSED TOPSOIL, 6"
- J) PROPOSED AGGREGATE SHOULDER, TYPE B, 10"

⚠ REVISED 7-20-2021

FILE NAME =	USER NAME = guillaumefp	DESIGNED -	REVISED -		CONSTRUCTION STAGING: TYPICAL SECTIONS	F.A.P. SECTION	COUNTY TOTAL SHEET
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	PLOT SCALE = 100.0097 '/ in.	CHECKED -	REVISED -	DEPARTMENT OF TRANSPORTATION	IL ROUTE 60	'	CONTRACT NO. 60X57
	PLOT DATE = 7/8/2021	DATE -	REVISED -		SCALE: N/A SHEET NO. OF SHEETS STA. TO STA.	ILLINOIS FED. A	



**DEPARTMENT OF TRANSPORTATION** 

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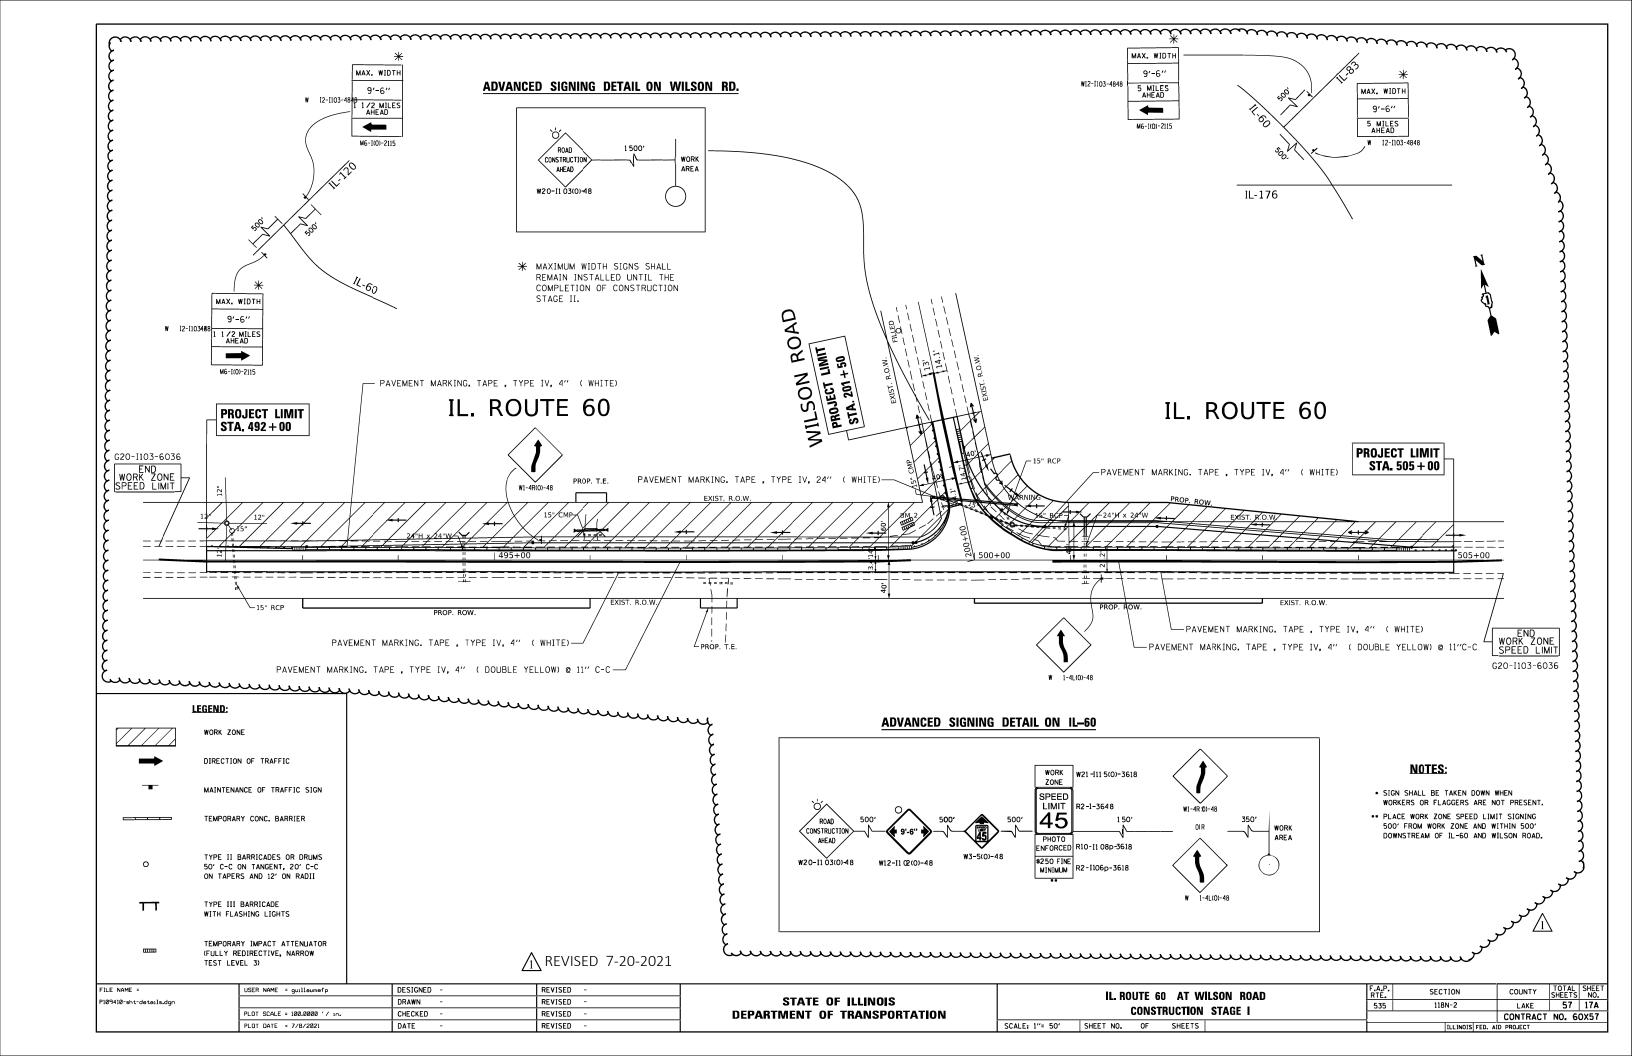
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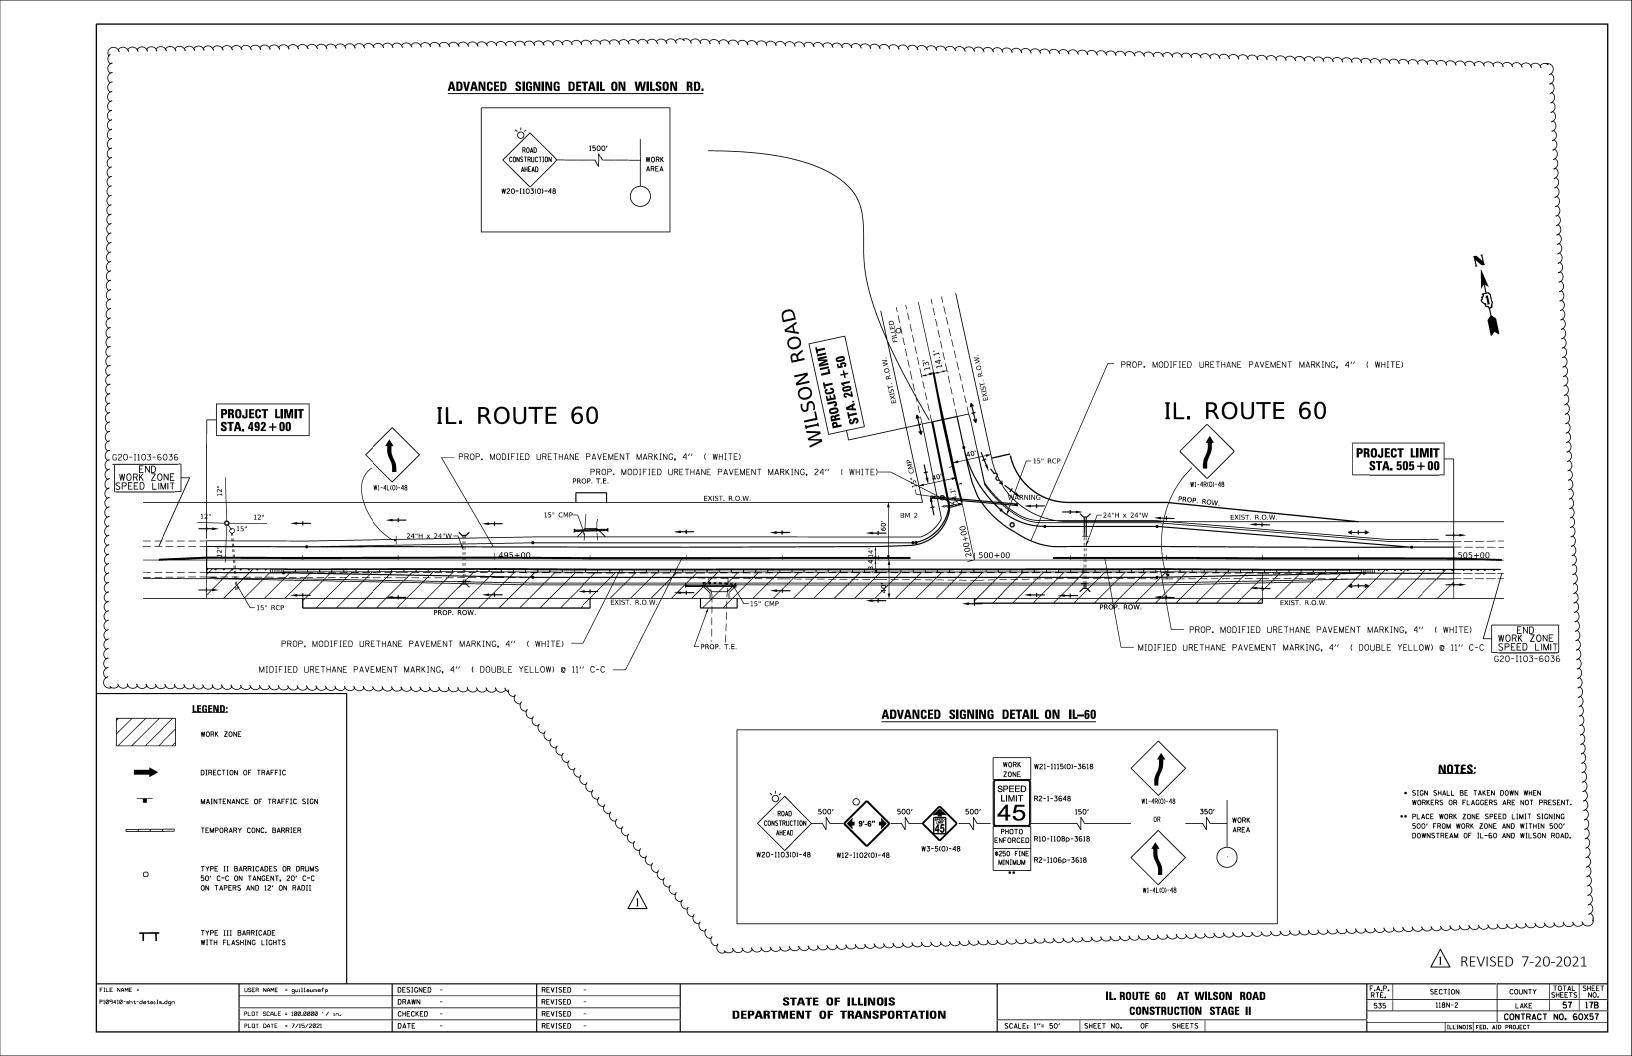
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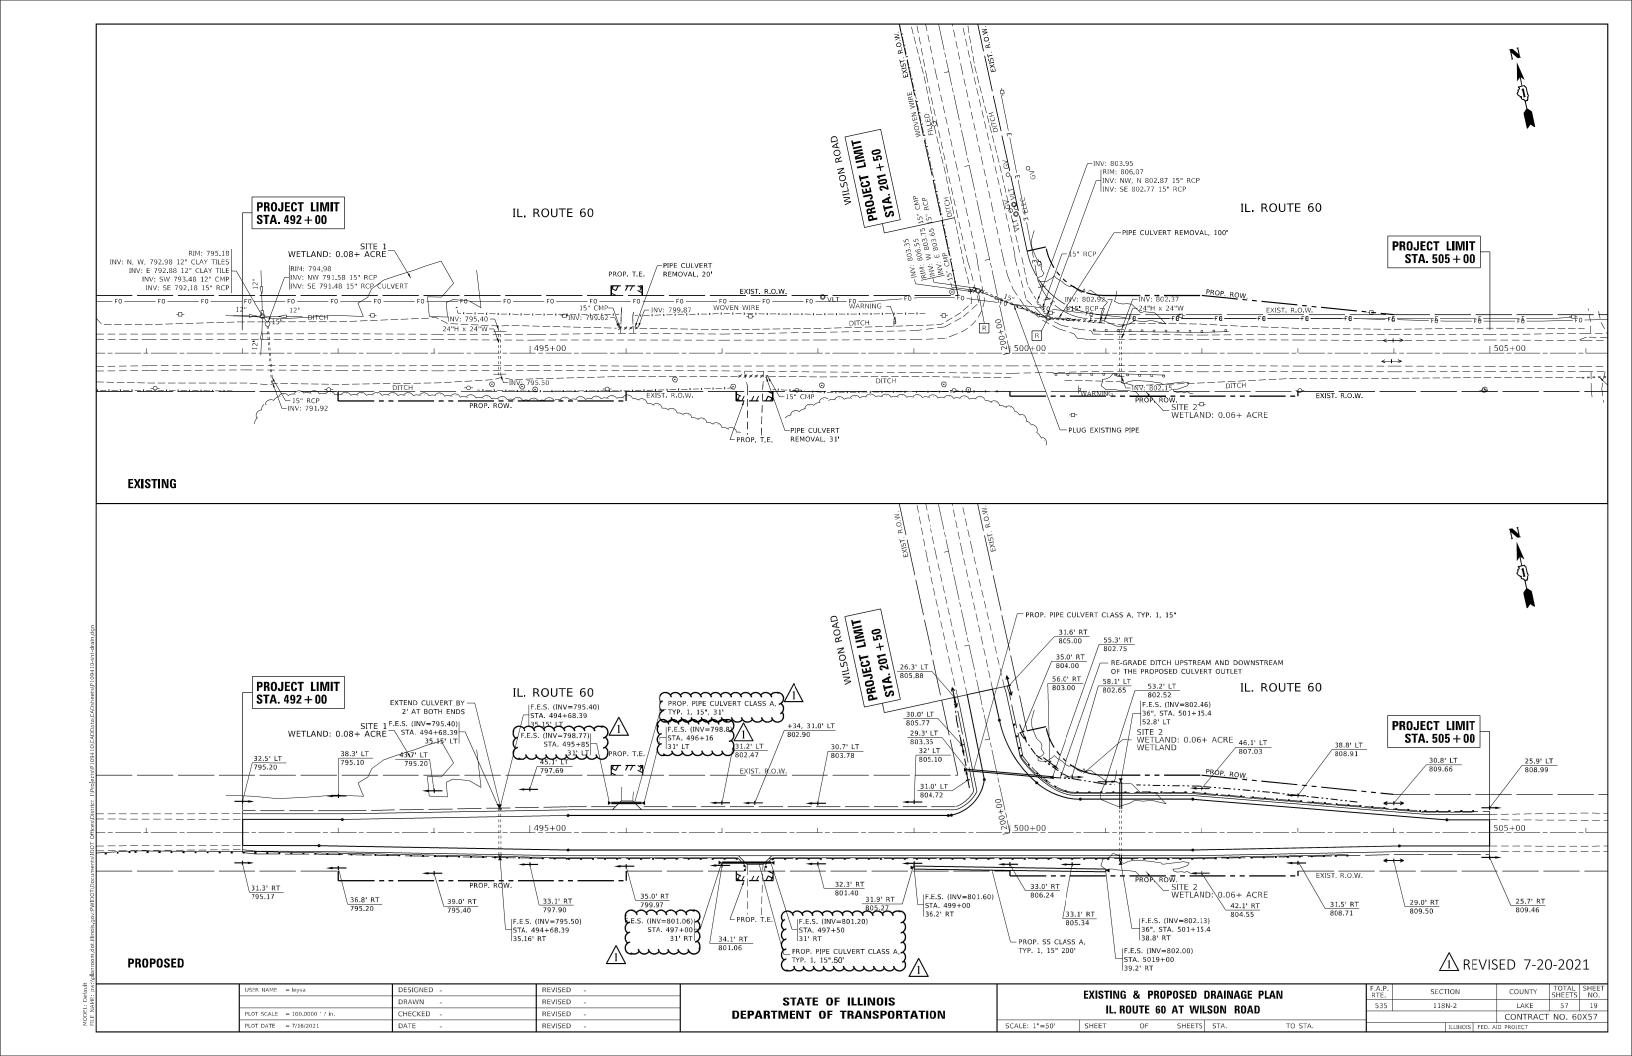
↑ REVISED 7-20-2021

COUNTY TOTAL SHEET NO.

LAKE 57 17 SECTION **CONSTRUCTION STAGING: TYPICAL SECTIONS** 118N-2 535 WILSON ROAD CONTRACT NO. 60X57 SCALE: N/A SHEET NO. OF SHEETS STA. TO STA.







# SCHEDULE OF QUANTITIES

ITEM DESCRIPTION	UNITS	TOTAL QTY.
UNDERGROUND CONDUIT, GALVANIZED STEEL, 2" DIA.	FOOT	2237
HEAVY-DUTY HANDHOLE	EACH	3
MAINTENANCE OF EXISTING TRAFFIC SIGNAL INSTALLATION	EACH	1
ELECTRIC CABLE IN CONDUIT, TRACER, NO. 14 1C	FOOT	2801
DRILL EXISTING HANDHOLE	EACH	1
FIBER OPTIC CABLE IN CONDUIT, NO. 62.5/125, MM12F SM 24F	FOOT	2827
LAYER II (DATA LINK) SWITCH (LCDOT)	EACH	1
TERMINATE FIBER IN CABINET (LCDOT)	EACH	24
SPLICE FIBER IN CABINET (LCDOT)	EACH	1
RE-OPTIMIZE TRAFFIC SIGNAL SYSTEM LEVEL 2	EACH	1

⚠ REVISED 7-20-2021

# LAKE COUNTY PASSAGE

T NO. 13		TERMINATE FIBE SPLICE FIBER I RE-OPTIMIZE TE	R IN CABINET (LCDOT)  R IN CABINET (LCDOT)  RAFFIC SIGNAL SYSTEM L  NTITY TO BE USED AS NEE	EVEL 2	OVED BY THE EN	E E	ACH 24  ACH 1  ACH 1										
TS SH															LAKE CO	UNTY PA	SSAGE
. M	Sam		USER NAME = esalutz	DESIGNED -		REVISED - 07/12/	2021		PROPOSED	INTERCONNE	CT SCHEMA	ATIC AND	SCHEDULE OF QUANTITIES	F A P RTE	SECTION	COUNTY	TOTAL SHEET SHEETS NO.
		223 W. JACKSON		DRAWN -		REVISED -		STATE OF ILLINOIS					FAIRFIELD RD	535	118N-2	LAKE	57 40
<u></u>	Schwai	TZ CHICAGO, IL 60606 TEL: (773) 305-0800	PLOT SCALE = 100.9132 / in.	CHECKED -	PAW	REVISED -		DEPARTMENT OF TRANSPORTATION		IL NOUTE 0	u – WILSU	טו עח וו	LAIULIELD UD			CONTRA	T NO. 60X57
Ē			PLOT DATE = 7/12/2021	DATE -	01/21/2021	REVISED -			SCALE: NTS	SHEET	OF :	SHEETS STA.	TO STA.		ILLINOIS F	ED. AID PROJECT	

