

- GENERAL NOTES

 THE CONTRACTOR SHALL OBTAIN, ERECT, MAINTAIN AND REMOVE ALL SIGNS, BARRICADES, FLAGGERS AND OTHER TRAFFIC CONTROL DEVICES AS MAY BE NECESSARY FOR THE PURPOSE OF REGULATING, WARNING OR GUIDING TRAFFIC. PLACEMENT AND MAINTENANCE OF ALL TRAFFIC CONTROL DEVICES SHALL BE IN ACCORDANCE WITH THE APPLICABLE PARTS OF ARTICLE 107.14 OF THE STANDARD SPECIFICATIONS AND THE ILLINOIS MANUAL ON UNIFORM TRAFFIC CONTROL DEVICES FOR STREETS AND HIGHWAYS.
- 2. LOCATION OF UTILITIES SHOWN ON PLANS ARE APPROXIMATE ONLY, AND ARE NOT NECESSARILY COMPLETE. CONTRACTOR SHALL MAKE HIS OWN INVESTIGATIONS AS TO LOCATION OF ALL EXISTING UNDERGROUND STRUCTURES, CABLES AND PIPELINES IN ACCORDANCE WITH ARTICLE 107.31 OF THE STANDARD SPECIFICATIONS.
- 3. ALL ELEVATIONS ARE BASED ON U.S.G.S. DATUM.

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- 4. ALL ROAD SIGNS, STREET SIGNS AND TRAFFIC SIGNS WHICH NEED TO BE RELOCATED OR MOVED DUE TO CONSTRUCTION SHALL BE TAKEN DOWN AND STORED BY THE CONTRACTOR EXCEPT THOSE THAT ARE NECESSARY FOR PROPER TRAFFIC CONTROL WHICH SHALL BE TEMPORARILY RESET UNTIL COMPLETION OF CONSTRUCTION OPERATIONS. AFTER COMPLETION OF THE WORK, THE CONTRACTOR SHALL RESET ALL SAID SIGNS. THE WORK SHALL BE IN ACCORDANCE WITH ARTICLE 107.25 OF THE STANDARD SPECIFICATIONS. WORK SHALL NOT COMMENCE UNTIL TRAFFIC CONTROL REQUIREMENTS ARE MET.
- 5. SPECIAL ATTENTION IS DRAWN TO THE FACT THAT ARTICLE 105.06 OF THE STANDARD SPECIFICATIONS REQUIRES THE CONTRACTOR TO HAVE A COMPETENT SUPERINTENDENT ON THE PROJECT SITE AT ALL TIMES, IRRESPECTIVE OF THE AMOUNT OF WORK SUBLET. THE SUPERINTENDENT SHALL BE CAPABLE OF READING AND UNDERSTANDING THE PLANS AND SPECIFICATIONS, SHALL HAVE FULL AUTHORITY TO EXECUTE ORDERS TO EXPEDITE THE PROJECT, SHALL BE RESPONSIBLE FOR SCHEDULING AND HAVE CONTROL OF ALL WORK AS THE AGENT OF THE CONTRACTOR. FAILURE BE RESPONSIBLE FOR SCHEDULING AND HAVE CONTROL OF ALL WORK AS THE AGENT OF THE CONTRACTOR. TO COMPLY WITH THIS PROVISION WILL RESULT IN A SUSPENSION OF WORK AS PROVIDED IN ARTICLE 108.07.
- 6. THE UNIT PRICE FOR ALL REMOVAL PAY ITEMS SHALL INCLUDE ALL REQUIRED SAW CUTS.
- 7. ALL WORK PERFORMED RELATIVE TO THIS IMPROVEMENT SHALL COMPLY WITH ALL APPLICABLE RULES AND REGULATIONS OF O.S.H.A.
- 8. THE CONTRACTOR SHALL PROVIDE AND INSTALL TWO WEIGHTED SAND BAGS ON EACH TYPE I OR TYPE II BARRICADE USED. (ONE WEIGHTED SAND BAG ACROSS EACH BOTTOM RAIL.) THIS WORK WILL NOT BE PAID FOR SEPARATELY. BUT THE COST SHALL BE CONSIDERED AS INCLUDED IN THE COST OF TRAFFIC CONTROL AND PROTECTION PAY ITEMS AND NO ADDITIONAL COMPENSATION WILL BE ALLOWED.
- BEFORE STARTING ANY EXCAVATION, THE CONTRACTOR SHALL CALL "JULIE" AT 800-892-0123 FOR FIELD LOCATIONS OF BURIED ELECTRIC, TELEPHONE AND GAS FACILITIES. (48 HOUR NOTIFICATION IS REQUIRED)
- 10. THE CONTRACTOR SHALL COORDINATE CONSTRUCTION ACTIVITIES WITH UTILITY COMPANIES AND THE CITY OF BURR RIDGE AND WILLOWBROOK, THE CONTRACTOR SHALL ALSO COORDINATE WITH DUPAGE COUNTY D.O.T. FOR TRAFFIC SIGNAL LOCATES.
- 11. WHENEVER, DURING CONSTRUCTION OPERATIONS ANY LOOSE MATERIAL IS DEPOSITED IN THE FLOW LINE OF DRAINAGE STRUCTURES SUCH THAT THE NATURAL FLOW OF WATER IS OBSTRUCTED, IT SHALL BE REMOVED AT THE CLOSE OF EACH WORKING DAY. AT THE CONCLUSION OF CONSTRUCTION OPERATIONS, ALL DRAINAGE STRUCTURES SHALL BE FREE FROM DIRT AND DEBRIS. THE WORK SPECIFIED ABOVE WILL NOT BE PAID FOR SEPARATELY, BUT SHALL BE CONSIDERED AS INCLUDED IN THE COST OF EROSION CONTROL PAY ITEMS AND NO ADDITIONAL
- 12. EXISTING PUBLIC AND PRIVATE UTILITIES ARE SHOWN ON THE PLANS ACCORDING TO INFORMATION OBTAINED FROM UTILITY COMPANIES, MUNICIPALITIES, AND SURVEYS. IN ACCORDANCE WITH ARTICLES 105.07 AND 107.31 OF STANDARD SPECIFICATIONS, THE CONTRACTOR SHALL FAMILIARIZE HIMSELF WITH THE LOCATION OF ALL UTILITIES AND STRUCTURES THAT MAY BE FOUND IN THE VICINITY OF THE CONSTRUCTION, HE WILL ALSO ASSUME RESPONSIBILITY FOR ALL UTILITIES WHETHER SHOWN OR NOT, AND MUST REALIZE THAT THE ACTUAL LOCATIONS AND/OR ELEVATIONS OF THE UTILITIES MAY BE DIFFERENT THAN INDICATED.
- 13. SHOULD ANY DAMAGES OCCUR DUE TO THE CONTRACTOR'S NEGLIGENCE, THE CONTRACTOR, AT HIS OWN EXPENSE, SHALL MAKE REPAIRS IN A MANNER ACCEPTABLE TO THE ENGINEER. THE CONTRACTOR SHALL NOTIFY ALL UTILITY COMPANIES OF HIS CONSTRUCTION SCHEDULE AND COORDINATE CONSTRUCTION OPERATIONS WITH THE UTILITY COMPANIES SO THAT RELOCATION OF UTILITY LINES AND STRUCTURES MAY PROCEED IN AN ORDERLY MANNER, IN ACCORDANCE WITH ARTICLES 105.07 AND 107.31 OF STANDARD SPECIFICATIONS.
- 14. ALL UTILITIES, LOCAL POLICE, AND FIRE DEPARTMENTS SHALL BE NOTIFIED BY THE CONTRACTOR PRIOR TO THE START OF CONSTRUCTION.
- 15. UNLESS AUTHORIZED BY THE ENGINEER, ALL EXISTING ACCESS POINTS SHALL BE MAINTAINED AT ALL TIMES BY THE CONTRACTOR.
- 16. DURING THE CONSTRUCTION, THE CONTRACTOR WILL BE REQUIRED, AT HIS EXPENSE, TO HAVE AVAILABLE A WATER TRUCK OR SIMILAR EQUIPMENT TO CONTROL DUST. IF NECESSARY, THE CONTRACTOR SHALL BE REQUIRED TO CONTROL DUST DURING NON-WORKING HOURS. THIS WORK WILL BE IN ACCORDANCE WITH ARTICLE 107.36 OF THE STANDARD SPECIFICATIONS.
- 17. ALL EXCESS MATERIAL (BROKEN CONCRETE, CULVERT'PIPE, WASTE ROADWAY EXCAVATION, SURPLUS MATERIAL FROM SEWER TRENCHES, ETC.) SHALL BE LEGALLY DISPOSED OF OUTSIDE THE LIMITS OF THE RIGHT-OF-WAY. IT SHALL BE THE CONTRACTOR'S RESPONSIBILITY TO SELECT DUMP SITES AND OBTAIN PERMISSION AND ALL NECESSARY PERMITS TO USE SUCH DUMP SITES. PAYMENT FOR THIS WORK SHALL BE INCLUDED IN THE CONTRACT UNIT PRICE FOR EATTH EVCAVATION AND WILL NOT SE PAID FOR CERDALTE! Y
- 18. THE CONTRACTOR WILL BE REQUIRED TO KEEP THE CURRENT SIDEWALK OPEN AT ALL TIMES WITH THE USE OF IDOT STANDARD ROAD PLAN 701801-04. THE CONTRACTOR WILL ONLY BE ALLOWED TO DIRECT PEDESTRIANS TO THE OTHER SIDE OF MADISON STREET AT SIGNALIZED OR 4 WAY STOPPED CONTROLLED INTERSECTIONS.
- 19. ALL FIRE HYDRANTS TO BE RELOCATED AS PART OF THE CONTRACT SHALL BE RELOCATED IN ACCORDANCE WITH IDOT-DISTRICT 1 DETAIL BD-36. ALL WORK ASSOCIATED WITH RELOCATING THE HYDRANT SHALL BE CONSIDERED INCLUDED IN THE COST OF TO PAY ITEM 56400100 'FIRE HYDRANTS TO BE MOVED'.
- 20. THE CONTRACTOR SHALL CONTACT AND OBTAIN APPROVAL FROM THE VILLAGE OF WILLOWBROOK PUBLIC WORKS DEPARTMENT FOR ALL MAIN SHUTOFFS. UNDER NO CONDITION SHALL THE CONTRACTOR OPERATE ANY VALVES OR HYDRANTS WITHIN THE PROJECT AREA. WHENEVER AN EXISTING WATER MAIN OR A SECTION THEREOF IS TO BE SHUT DOWN DURING THE COURSE OF CONSTRUCTION, EVERY INDIVIDUAL CONSUMER SHALL BE NOTIFIED AT LEAST SEVENTY-TWO HOURS PRIOR TO SHUT DOWN.
- 21. TREES NOT MARKED FOR REMOVAL SHALL BE CONSIDERED AS DESIGNATED TO BE SAVED AND SHALL BE PROTECTED UNDER THE PROVISIONS OF ARTICLE 201.05 OF THE STANDARD SPECIFICATIONS.
- 22. ALL LIMBS, BRANCHES, AND OTHER DEBRIS RESULTING FROM THIS WORK SHALL BE DISPOSED OF IN ACCORDANCE WITH ARTICLE 202.03 OF STANDARD SPECIFICATION.
- 23. ALL CLEARING, REMOVAL OF BUSHES, HEDGES AND TREES UNDER SIX (6) INCHES IN DIAMETER SHALL BE AS STATED IN SECTION 201 OF STANDARD SPECIFICATION.
- 24. OVERHANGING LIMBS ARE TO BE TRIMMED OR CUT OFF TO PROVIDE A MINIMUM VERTICAL CLEARANCE OF TWENTY (20) FEET FROM THE FINISHED SURFACE OF THE ROAD. CLEARANCE TO SIDEWALKS OR PATHS SHALL BE ADDIRECTED BY THE ENGINEER, LIMB PRUNING SHALL BE REFORMED UNDER THE SUPERVISION OF AN APPROVED TREE EXPERT AS STATED IN THESE NOTES AND SHALL BE UNDERTAKEN IN A TIMELY FASHION SO AS NOT TO INTERFERE WITH CONSTRUCTION. ALL CUTS OVER ONE (1) INCH IN DIAMETER SHALL BE MADE AT THE GROWTH RING AT THE NEXT LARGE BRANCH. ALL LIMBS, BRANCHES, AND OTHER DEBRIS RESULTING FROM THIS WORK SHALL BE DISPOSED OF BY THE CONTRACTOR AT HIS EXPENSE OUTSIDE THE LIMITS OF THE RIGHT-OF-WAY. THE COST OF THIS WORK WILL NOT BE PAID FOR SEPARATELY BUT SHALL BE INCLUDED IN THE CONTRACT UNIT PRICE FOR TREE PRUNING (OVER 10" DIAMETER).

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STATE OF ILLINOIS **DEPARTMENT OF TRANSPORTATION**

- 25. TOPSOIL SHALL BE PLACED TO A DEPTH OF SIX (6) INCHES AND BE MEASURED IN SQUARE YARDS.
- 27. TOPSOIL SHALL NOT BE STOCKPILED WITHIN THE LIMITS OF CONSTRUCTION; THE LOCATIONS OF TOPSOIL STOCKPILES WITHIN THE RIGHT-OF-WAY MUST BE APPROVED BY THE ENGINEER.
- 28. ALL EXISTING GRANULAR AND HOT-MIX ASPHALT PAVEMENT TO BE REMOVED AND NOT PAID AS A SPECIFIC ITEM SHALL BE CONSIDERED EARTH EXCAVATION AND WILL BE PAID FOR AT THE CONTRACT UNIT PRICE FOR EARTH EXCAVATION. THE CONTRACTOR WILL HAVE THE OPTION OF REMOVING THE EXISTING HOT-MIX ASPHALT PAVEMENT BY GRINDING OR EXCAVATIOG. IF THE HOT-MIX ASPHALT PAVEMENT IS REMOVED BY EXCAVATION, IT MAY NOT BE USED IN EMBANKMENT AREAS UNLESS SPECIFICALLY AUTHORIZED BY THE ENGINEER. HOT-MIX ASPHALT PAVEMENT REMOVED BY GRINDING MAY BE USED AS EMBANKMENT MATERIAL. NO HOT-MIX ASPHALT PAVEMENT SHALL BE REMOVED IN AREAS TO BE USED FOR TEMPORARY ROADWAY.
- 29. THE CONTRACTOR SHALL NOT CROSS COMPLETED BASE COURSE OR EXISTING PAVEMENT, NOT SCHEDULED TO BE REMOVED, WITH TRACK EQUIPMENT OR LOADED SCRAPERS.
- 30. ALL EMBANKMENTS AND SUB-GRADE SHALL BE COMPACTED TO THE SATISFACTION OF THE ENGINEER PRIOR TO PLACING AGGREGATE SUBGRADE OR SUB-BASE GRANULAR MATERIAL.
- 31. ALL EXISTING DOMESTIC BUFFALO BOXES ARE TO BE ADJUSTED BY THE CONTRACTOR. THE COST OF THIS WORK WILL BE INCLUDED IN THE CONTRACT UNIT PRICE FOR EARTH EXCAVATION.
- 32. THE STATION / OFFSET / ELEVATIONS NOTED FOR ALL DRAINAGE STRUCTURES LOCATED IN THE CURB LINE REFER TO THE POSITION OF THE ADJACENT PROPOSED EDGE OF PAVEMENT. THE CONTRACTOR SHALL BE RESPONSIBLE FOR DETERMINING THE OFFSET NECESSARY FOR THE STRUCTURES TO SET THE FRAME AND GRATES IN THE PROPER LOCATION. ALL OTHER STRUCTURES ARE DIMENSIONED TO THE CENTER OF THE STRUCTURE; ELEVATION INDICATES
- 33. EMBANKMENTS SHALL BE COMPLETED TO THE SATISFACTION OF THE ENGINEER PRIOR TO EXCAVATION FOR STORM SEWER.
- 34. THE COST OF MAKING STORM SEWER CONNECTIONS TO EXISTING OR PROPOSED SEWER SHALL BE INCLUDED IN THE CONTRACT UNIT PRICE FOR THE STORM SEWER BEING CONNECTED.
- 35. MANHOLES AND CATCH BASINS SHALL BE CONSTRUCTED WITH FLAT TOPS WHERE THE DIFFERENCE BETWEEN THE RIM ELEVATION AND INVERT ELEVATION IS LESS THAN SIX (6) FEET.
- 36. ADJUSTMENT OF STRUCTURES MAINTAINED BY OTHER AGENCIES SHALL BE MADE TO THE SATISFACTION OF THE ENGINEER.
- 37. ALL MANHOLES AND INLETS SHALL HAVE POURED INVERTS. THE COST OF INVERTS SHALL BE INCLUDED IN THE COST OF THE STRUCTURE.
- 38. ALL FIELD TILES ENCOUNTERED SHALL BE CAREFULLY PRESERVED AND CONNECTED TO PROPOSED DRAINAGE STRUCTURES, SEWERS, OR DITCHES, AS DIRECTED BY THE ENGINEER; THIS WORK WILL BE PAID FOR AT THE APPLICABLE CONTRACT UNIT PRICE OR IN ACCORDANCE WITH ARTICLE 109.04 OF THE STANDARD SPECIFICATIONS.
- 39. WHERE TRENCH BACKFILL IS REQUIRED, THE MATERIAL USED SHALL BE COMPACTED AS SPECIFIED IN ARTICLE 550.07 OF THE STANDARD SPECIFICATIONS USING METHOD ONE.
- 40. TYPE I OR TYPE II BARRICADES WITH TWO-WAY FLASHING LIGHTS SHALL BE REQUIRED AT ALL OPEN TRENCHES, EXCAVATIONS, OPEN OR EXPOSED SEWER STRUCTURES, TRANSVERSE PAVEMENT JOINTS, MATERIALS OR EQUIPMENT WITHIN THE RIGHT-OF-WAY (NUMBER AND SPACING DEPENDS ON THE CONDITIONS); AND AT LOCATIONS DESIGNATED BY THE ENGINEER OR LOCAL LAW ENFORCEMENT AGENCIES.
- 41. TYPE I, II AND / OR III BARRICADES WITH TWO-WAY FLASHING LIGHTS WILL BE REQUIRED TO GUIDE TRAFFIC AWAY FROM PAVEMENT AREAS CLOSED FOR CONSTRUCTION.
- 42. ARROW BOARDS WILL BE REQUIRED WHEN IMPLEMENTING ALL LANE CLOSURES.
- 43. THE CONTRACTOR SHALL PERFORM THE LAYOUT AND STAKING OF THE BIKE PATH ALIGNMENT AT THE PROJECT SITE AND THE COST OF THIS WORK SHALL BE INCLUDED IN THE COST OF THE CONSTRUCTION LAYOUT PAY ITEM AND NO ADDITIONAL COMPENSATION WILL BE ALLOWED.
- 44. THE MATERIALS FOR AGGREGATE BASE COURSE SHALL BE RESTRICTED TO CRUSHED CA-6.
- 45. WHERE CLOSED LIDS ARE PROVIDED, THEY SHALL BE FURNISHED WITH 2-INCH RAISED LETTERS CAST INTO THE LID READING "RESTRICTOR", "STORM", "SANITARY", OR "WATER" AS APPROPRIATE. THE COST OF THIS WORK SHALL BE INCLUDED IN THE COST OF THE LID PAY ITEM AND NO ADDITIONAL COMPENSATION WILL BE ALLOWED.
- 46. THE CONTRACTOR SHALL NOT BEGIN THE WORK TO BE PERFORMED UNDER THE CONTRACT WITHOUT WRITTEN AUTHORIZATION FROM THE ENGINEER TO PROCEED WITH THE WORK AND SHALL COMMENCE WORK NOT LATER THAN TEN (10) DAYS AFTER RECEIVING THE AUTHORIZATION TO PROCEED.

DENOTES WORK NOT PAID FOR SEPERATELY

UTILITY INFORMATION

UTILITY	CONTACT	PHONE
ATT- DISTRIBUTION	SHARON TILJAK	708-709-2523
COMED- JOLIET	JOE STACHO	630-424-5704
COMCAST- BLUE ISLAND	THOMAS MUNAR	630-600-6352
FLAGG CREEK WATER RECLAMATION DISTRICT	TOM O'CONNOR	630-323-3299
LEVEL 3 COMMUNICATIONS		877-366-8344
NICOR GAS	SCOTT STOGSDILL	630-938-8676
ATT- T-TGG	JIM EVERETT	770-335-9815
VILLAGE OF WILLOWBROOK	TIM HALIK	630-920-2261

MADISON STREET (CH 8) BIKE PATH IMPROVEMENTS 07-00001-10-BT DUPAGE 24 2 2674 **GENERAL NOTES** CONTRACT NO: 63470 GENERAL NOTES SHEET NO. 1 OF 1 SHEETS STA. TO STA. SCALE: NTS FED. ROAD DIST. NO. ILLINOIS FED. AID PROJECT

SUMMARY OF QUANTITIES

SPECIALTY ITEM (*)	S.P. NEEDED (X)	PAY ITEM NUMBER	FULL PAY ITEM NAME	UNIT OF MEASURE	QUANTITY (Y047
		20101100	TREE TRUNK PROTECTION	EACH	14
	1	20101200	TREE ROOT PRUNING	EACH	14
		20101350	TREE PRUNING (OVER 10 INCH DIAMETER)	EACH	10
		20200100	EARTH EXCAVATION	CU YD	238
		20201200	REMOVAL AND DISPOSAL OF UNSUITABLE MATERIAL	CU YD	130
		20800150	TRENCH BACKFILL	CU YD	2
		21101625	TOPSOIL FURNISH AND PLACE, 6"	SQ YD	680
	*,	25000400	NITROGEN FERTILIZER NUTRIENT	POUND	ġ
, i		25000500	PHOSPHORUS FERTILIZER NUTRIENT	POUND	9
		25000600	POTASSIUM FERTILIZER NUTRIENT	POUND	9
`		25100630	EROSION CONTROL BLANKET	SQYD	680
		25200110	SODDING, SALT TOLERANT	SQ YD	680
		25200200	SUPPLEMENTAL WATERING	UNIT	18
	,	28000250	TEMPORARY EROSION CONTROL SEEDING	POUND	14
		28000400	PERIMETER EROSION BARRIER	FOOT	1,531
		28000500	INLET AND PIPE PROTECTION	EACH	2
		31101400	SUB-BASE GRANULAR MATERIAL, TYPE B 6"	SQ YD	1,321
		35101800	AGGREGATE BASE COURSE, TYPE B 6"	SQ YD	1,039
	ί,	35501316	HOT⊡MIX ASPHALT BASE COURSE, 8"	SQ YD	163
		40600100	BITUMINOUS MATERIALS (PRIME COAT)	GALLON	459
0.000		40603310	HOT-MIX ASPHALT SURFACE COURSE, MIX "C", N50	TON	218
		42001300	PROTECTIVE COAT	· SQ YD	195
		42400200	PORTLAND CEMENT CONCRETE SIDEWALK 5 INCH	SQ FT	1,244
		42400800	DETECTABLE WARNINGS	SQ FT	214
		44000200	DRIVEWAY PAVEMENT REMOVAL	SQ YD	163
		44000600	SIDEWALK REMOVAL	SQFT	5,315
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STATE OF ILLINOIS DEPARTMENT OF TRANSPORTATION

	MAD	ISON	STR	EET	(C	Н	8) BIKE	PATH	IMPROVEMENTS		
-	SUMMARY OF QUANTITIES										
-	SCALE: NTS	SHEET	NO.	1 ()F	2	SHEETS	STA.	TO STA.		

F.A.U. RTE.	SECTION	NC	COUNTY	SHEETS	SHEET NO.
2674	07-00001-	10-BT	DUPAGE	24	3
	SUMMARY OF	QUANTITIES	CONTRACT	NO: 6347	0
FED. R	OAD DIST. NO. IL	LINOIS FED. A	ID PROJECT		

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SUMMARY OF QUANTITIES

SPECIALTY ITEM (*)	S.P. NEEDED (X)	PAY ITEM NUMBER	FULL PAY ITEM NAME	UNIT OF MEASURE	QUANTITY (Y047
	Х	44001700	COMBINATION CONCRETE CURB AND GUTTER REMOVAL AND REPLACEMENT	FOOT	196
		550A0050	STORM SEWERS, CLASS A, TYPE 1, 12"	FOOT	8
		330,0030	STONIN SEWERS, CLASS A, TIPE 1, 12	1001	
*		56400100	FIRE HYDRANTS TO BE MOVED	EACH	1
	3	5040000		54011	
*	X	56400300	FIRE HYDRANTS TO BE ADJUSTED	EACH	1
	Х	60238800	INLETS, TYPE A	EACH	1
		60250200	CATCH BASINS TO BE ADJUSTED	EACH	1
*		60255500	MANHOLES TO BE ADJUSTED	EACH	1
		60265700	VALVE VAULTS TO BE ADJUSTED	EACH	4
		60402210	GRATES, TYPE 8	EACH	1
	3	00402210	GRAIES, ITPE 0	EACH	3
		60406100	FRAMES AND LIDS, TYPE 1, CLOSED LID	EACH	1
	Magazia	67100100	MOBILIZATION	L SUM	1
-		70102620	TRAFFIC CONTROL AND PROTECTION, STANDARD 701501	LSUM	1
4.		70102622	TRAFFIC CONTROL AND PROTECTION, STANDARD 701502	L SUM	1
		70102635	TRAFFIC CONTROL AND PROTECTION, STANDARD 701701	L SUM	11
	,	70102640	TRAFFIC CONTROL AND PROTECTION, STANDARD 701801	L SUM	1
	X	70106800	CHANGEABLE MESSAGE SIGN	CAL MO	1.50
*		78000400	THERMOPLASTIC PAVEMENT MARKING - LINE 6"	FOOT	499
* .		78000600	THERMOPLASTIC PAVEMENT MARKING - LINE 12"	FOOT	840
*		THERMOPLASTIC PAVEMENT MARKING - LINE 24"	FOOT	27	
	× X	SQ FT	218		
		78300100	PAVEMENT MARKING REMOVAL	2.50	
	Х	XX007657	TRAIL TREE ROOT BARRIER	FOOT	684
	X	Z0013798	CONSTRUCTION LAYOUT	L SUM	1
		<u> </u>	SCHEDULE OF EARTH EXCAVATION (20200100)	1	


* DENOTES SPECIALTY ITEM.

	SCHEDULI	E OF EARTH EXCA	VATION (20200100)			
LOCATION		EARTH	EXCAVATION	EMBANKMENT	BALANCE	REMOVAL AND	SUB-BASE
		EXCAVATION	AVAILABLE	VOLUME	PER STAGE	DISPOSAL OF	GRANULAR
		20200100		NEEDED	WASTE (+)	UNSUITABLE	MATERIAL,
			ADJUSTED FOR		NEED (-)	MATERIAL	TYPE B 6"
			SHRINKAGE			20201200	31101400
		CU YD	CU YD	CU YD	CU YD	CU YD	SQ YD
MADISON ST. BIKE PATH - STA. 9+97.09 TO STA. 19+74.81		238	202	30	172	130	1,321
	PROJECT TOTAL	238				130	1.321
(ASSUMES 15% SHRINKAGE FACTOR)							


SEE CROSS-SECTION SHEETS 15-24 FOR STATION BY STATION BREAKDOWN OF EARTHWORK QUANTITY

STATE OF ILLINOIS
DEPARTMENT OF TRANSPORTATION

MADISON STREET (CH 8) BIKE PATH IMPROVEMENTS	F.A.U. RTE.	SEC.
SUMMARY OF QUANTITIES	2674	07-0000
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NTS SHEET NO 2 OF 2 SHEETS STA TO STA	CED D	OAD DICT NO

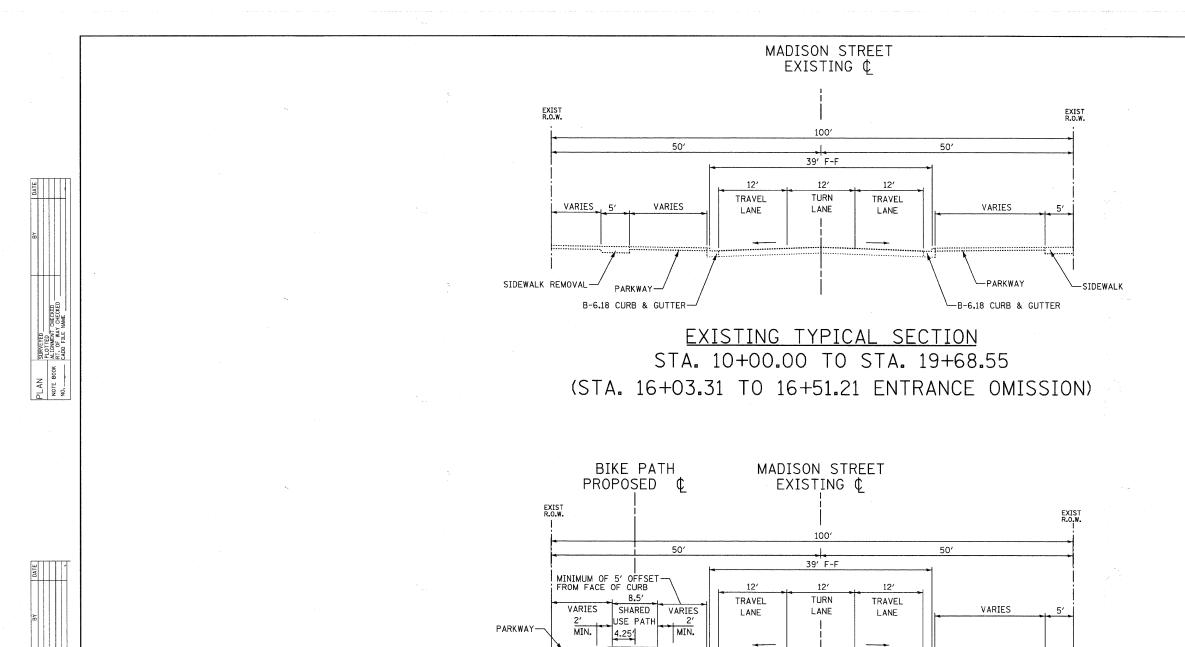


PARKWAY—/
B-6.18 CURB & GUTTER-

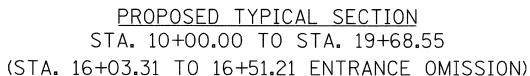

-PARKWAY

-B-6.18 CURB & GUTTER

-EXISTING SIDEWALK TO REMAIN

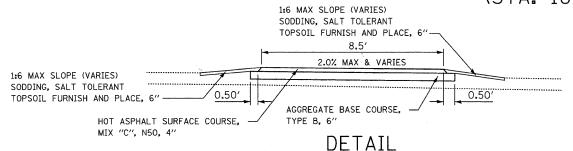

HOT-MIX ASPHALT MIXTURE REQUIREMENTS


THE FOLLOWING MIXTURE REQUIREMENTS ARE APPLICABLE FOR THIS PROJECT:


MIX TYPE	% AIR VOIDS
HOT-MIX ASPHALT SURFACE COURSE, MIX "C", N50 (IL-9.5mm) 2"	4% @ 50 GYRATIONS


UNIT WEIGHT USED TO CALCULATE ALL HOT-MIX SURFACE MIXTURES IS 112 LBS/SY/IN.

THE "AC TYPE" FOR POLYMERIZED HMA MIXES SHALL BE "SBS/SBR PG 70-22" AND FOR NON-POLYMERIZED HMA THE "AC TYPE" SHALL BE "PG 64-22" UNLESS MODIFIED BY DISTRICT ONE SPECIAL PROVISIONS. FOR "PERCENT OF RAP" SEE DISTRICT ONE SPECIAL PROVISIONS.

FILE NAME =	USER NAME = \$USER\$	DESIGNED - CRC	REVISED ~		MADISON STREET (CH 8) BIKE PATH IMPROVEMENTS		F.A.U.	SECTION	COUNTY	TOTAL SHEET	
\$FILEL\$		DRAWN - ML	REVISED -	STATE OF ILLINOIS		2674	07-00001-10-BT	DUPAGE	SHEETS NU.		
	PLOT SCALE = \$SCALE\$	CHECKED - MPK	REVISED -	DEPARTMENT OF TRANSPORTATION		TYPICAL SECTIONS		2014	01-00001-10-51		NO: 63470
	PLOT DATE = \$DATE\$	DATE - 03/12/2010 REVISED -			SCALE: NTS	SHEET NO. 1 OF 1 SHEETS STA.	TO STA.	FED. ROAD DIST. NO. ILLINOIS FED. AID PROJECT		1 001111111011111	10. 03410

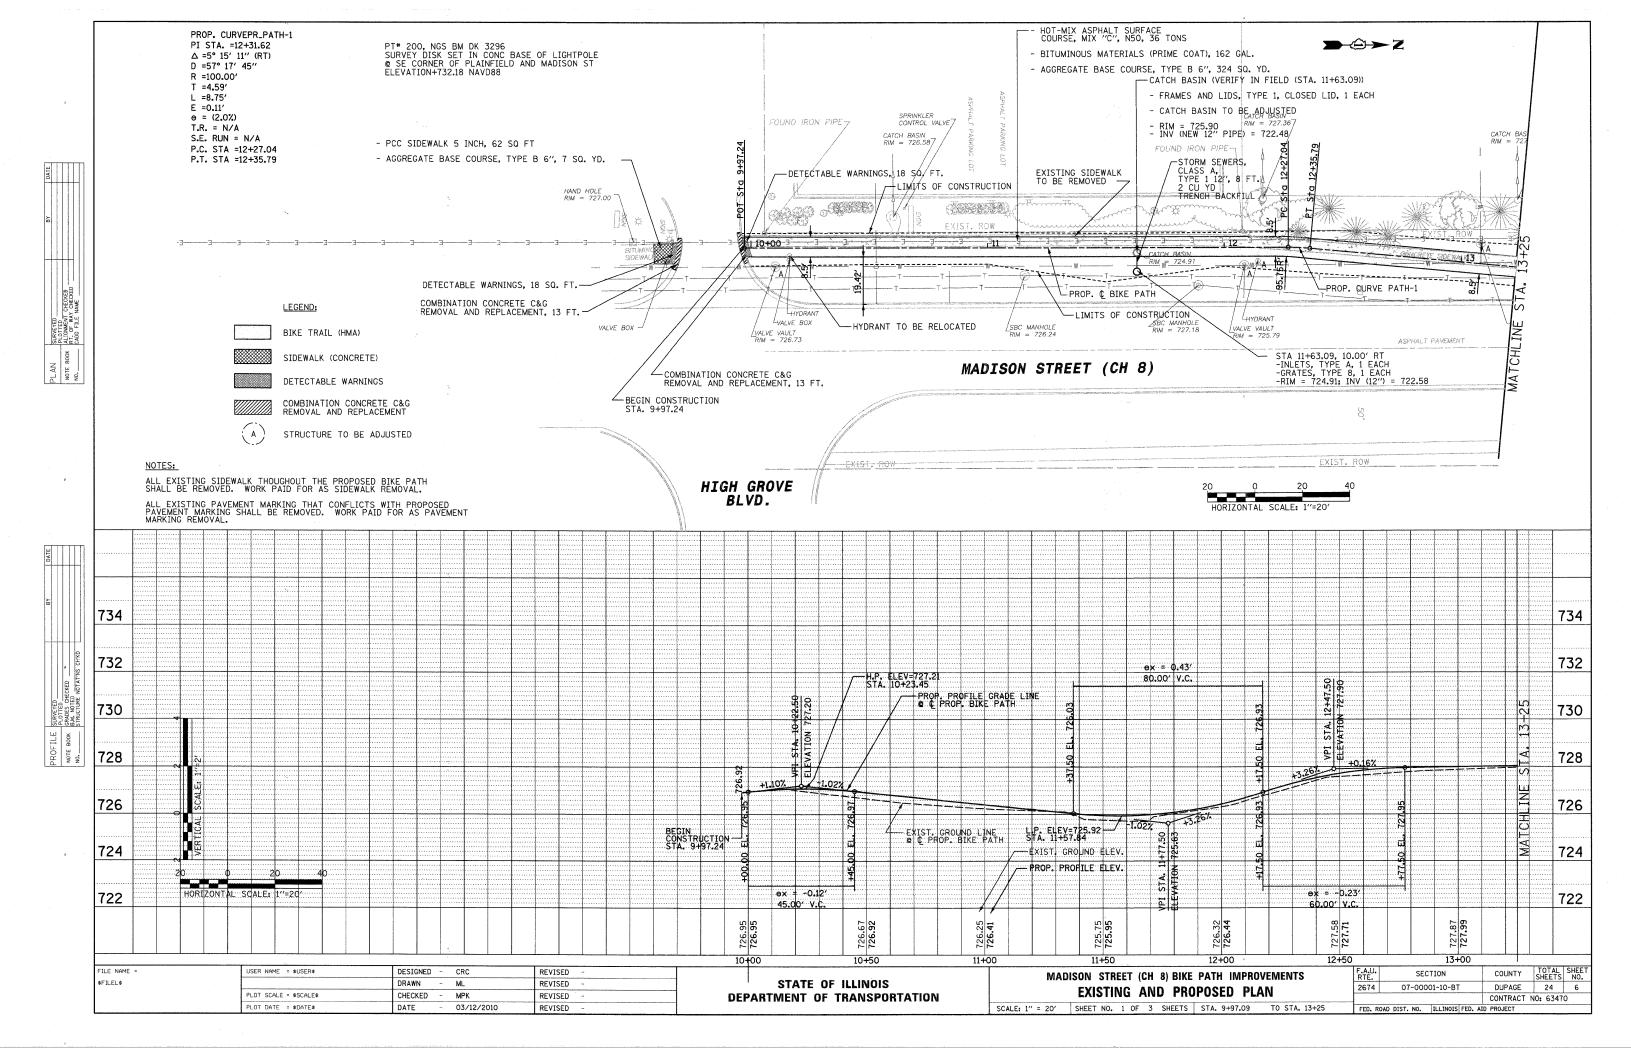

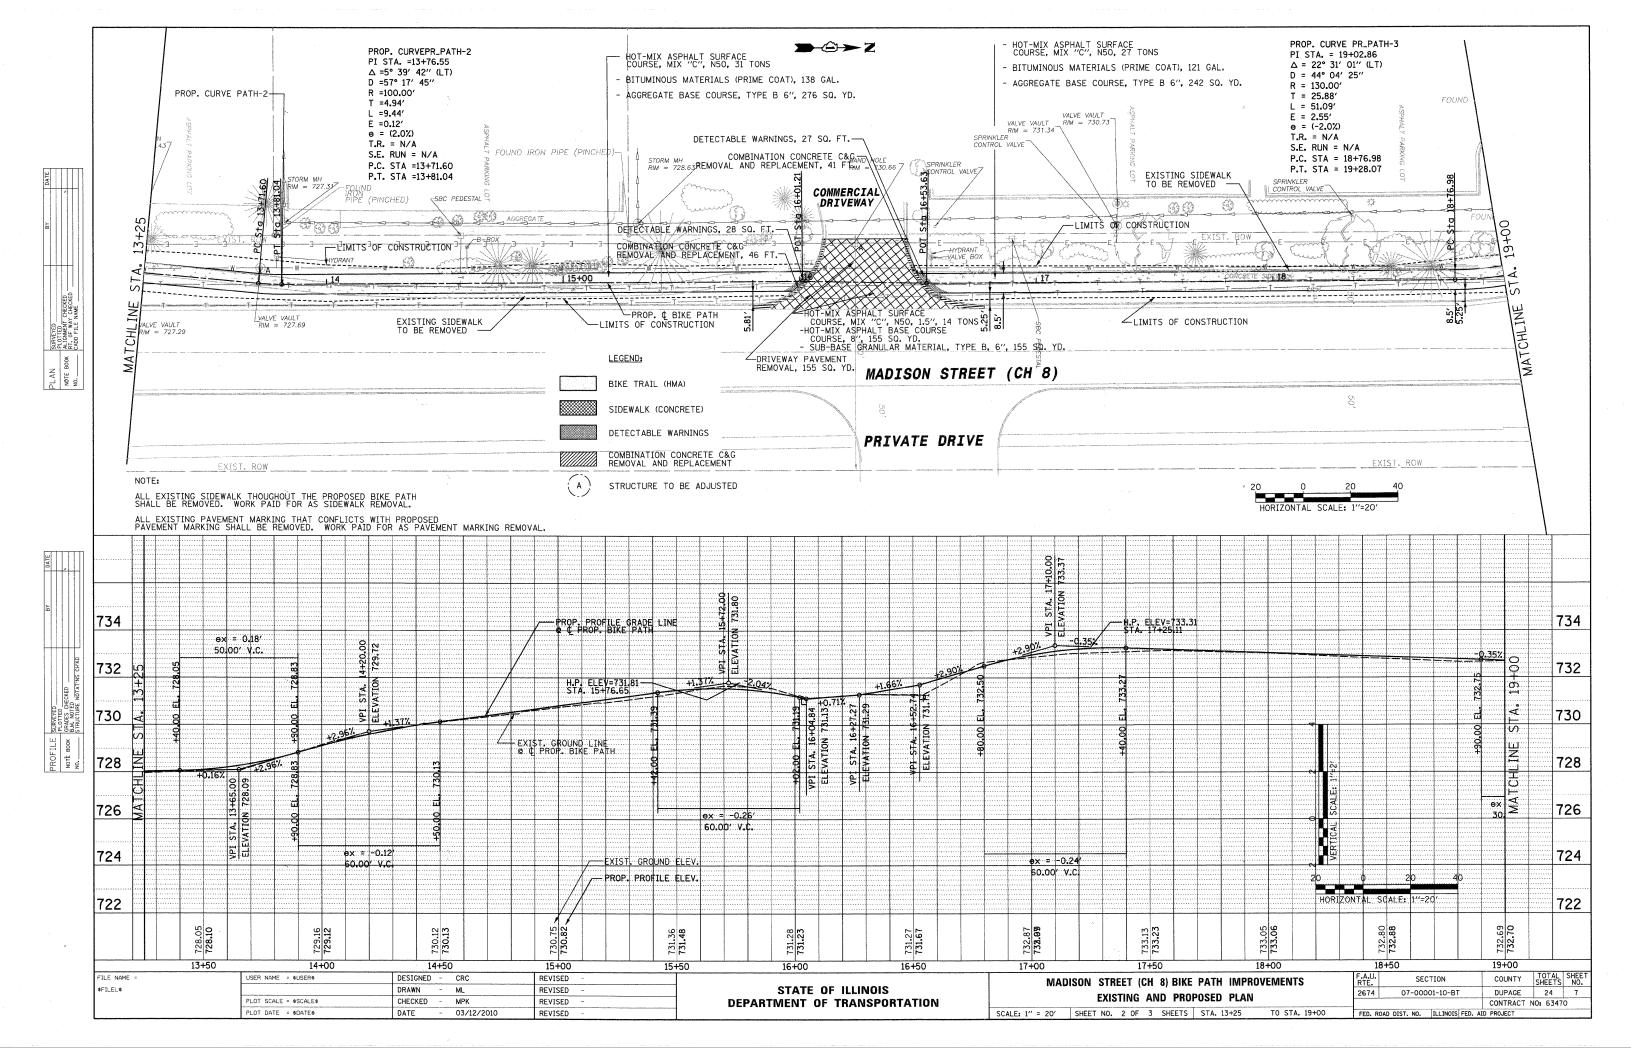

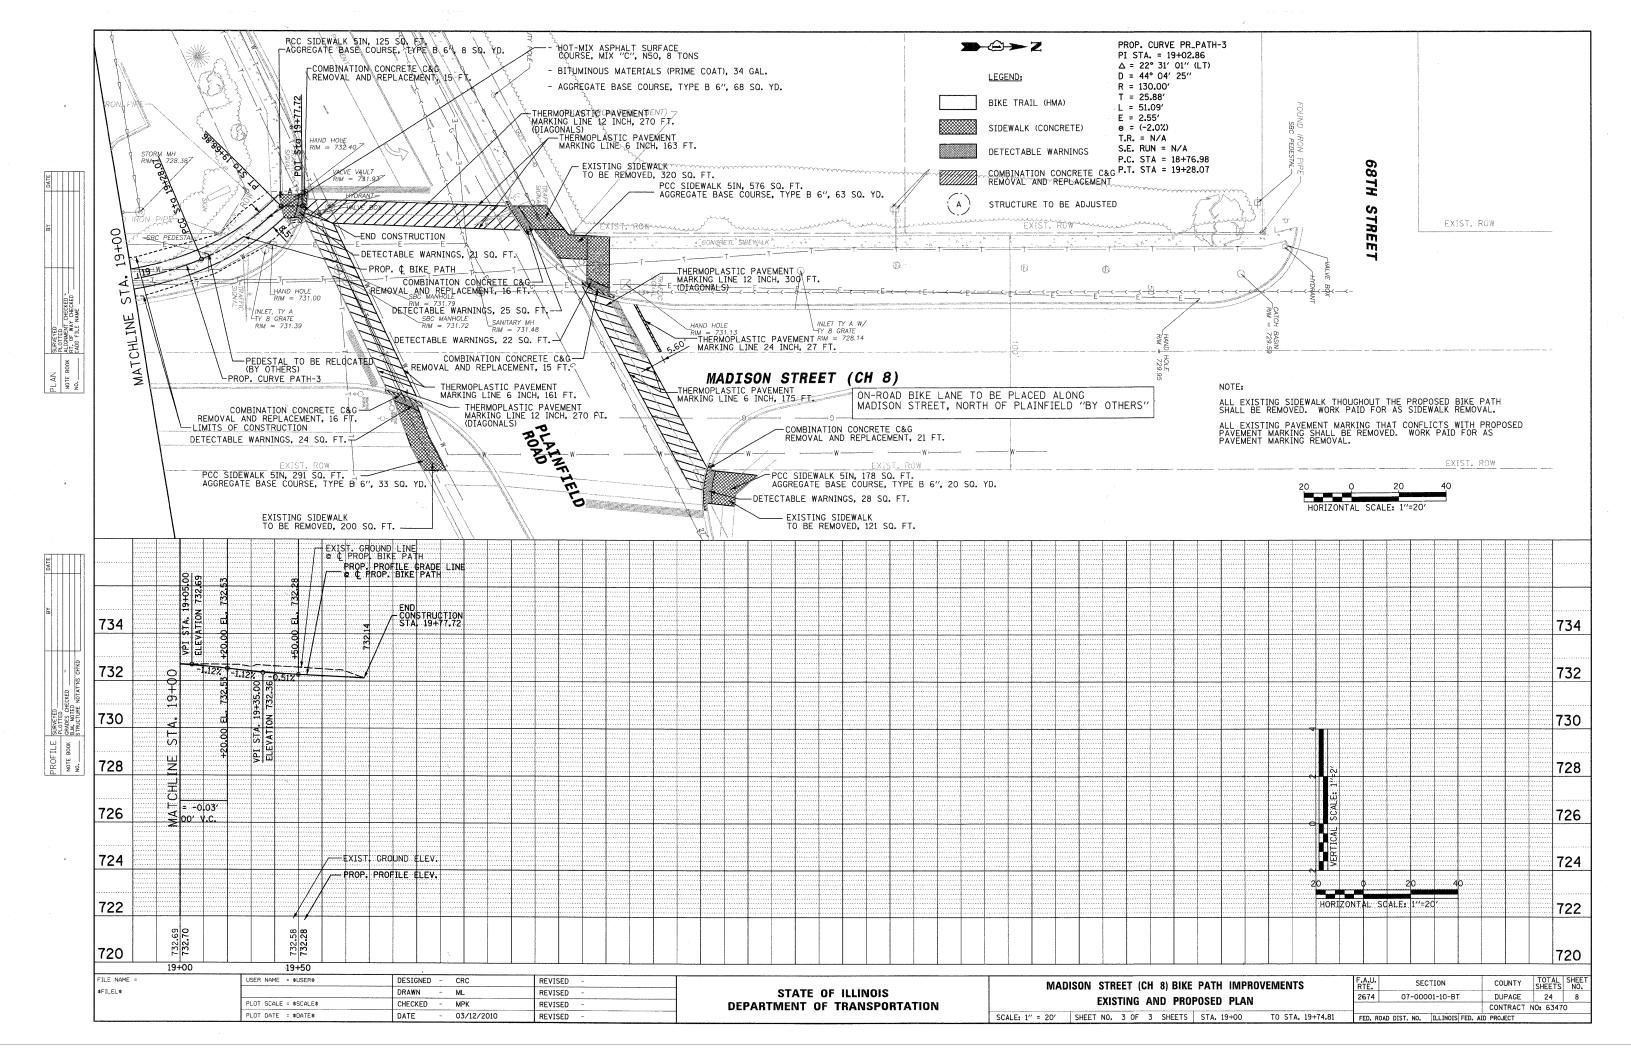

GENERAL NOTES FOR SOIL EROSION CONTROL PERIMETER EROSION BARRIER SHALL BE INSTALLED AT LOCATIONS SPECIFIED IN THE PLANS OUTSIDE THE TOE OF SLOPE OR INSIDE THE RIGHT-OF-WAY WHICHEVER IS CLOSER TO THE CENTERLINE, OR AS DIRECTED BY THE ENGINEER PRIOR TO THE START OF ANY EARTHWORK, CULVERT, OR STORM SEWER CONSTRUCTION. THE PERIMETER EROSION BARRIER SHALL REMAIN IN PLACE UNTIL ALL DISTURBED AREAS HAVE BEEN STABILIZED WITH VEGETATION. AT THIS TIME, THE PERIMETER EROSION BARRIER SHALL BE REMOVED AND AREAS DAMAGED BY THE PERIMETER EROSION BARRIER REMOVAL SHALL BE RESTORED. THE RESTORATION OF THE AREA DISTURBED BY THE PERIMETER EROSION BARRIER REMOVAL SHALL BE INCLUDED IN THE PAY ITEM OF PERIMETER EROSION THE INSTALLATION, REMOVAL & MAINTENANCE OF PERIMETER EROSION BARRIER SHALL BE PAID FOR UNDER THE ITEM OF PERIMETER EROSION BARRIER. 4. ALL DISTURBED AREAS SHALL BE SEEDED/SODDED AS SOON AS PRACTICAL AFTER CONSTRUCTION IN THAT AREA HAS CONCLUDED. 5. ALL SEEDED AREAS SHALL BE COVERED WITH EROSION CONTROL BLANKET. 6. ALL WORK SHALL BE DONE IN ACCORDANCE WITH SECTION 15-116 OF THE DU PAGE COUNTY COUNTYWIDE STORM WATER AND FLOOD PLAIN ORDINANCE, EFFECTIVE SEPTEMBER 24, 1991 AND ALL SUBSEQUENT REVISIONS. ALL SEDIMENT AND EROSION CONTROL MEASURES WILL BE INSTALLED PER IDOT STANDARD 280001 OR AS SPECIFIED HEREIN AND PAID FOR IN ACCORDANCE WITH SECTION 280 OF THE STANDARD SPECIFICATIONS. ALL CONSTRUCTION ACTIVITIES WILL BE IN ACCORDANCE WITH THE NATIONAL POLLUTANT DISCHARGE ELIMINATION SYSTEM STORM WATER PERMIT ILR40. 7. SEDIMENT AND EROSION CONTROL DEVICES SHALL BE FUNCTIONAL BEFORE THE PROJECT SITE IS OTHERWISE DISTURBED. ALL ERODABLE/BARE AREAS SHALL BE SEEDED EVERY 7 DAYS WITH TEMPORARY EROSION CONTROL SEEDING. IF A TOPSOIL STOCKPILE IS TO REMAIN IN PLACE FOR MORE THAN THREE DAYS, EROSION CONTROL MEASURES WILL BE TEMPORARY EROSION CONTROL SEEDING, 3 LB.-EROSION CONTROL ELANKET, 165 SQ. YD.-PERIMETER FROSION BARRIER. 341 FT. EROSION CONTROL BLANKET, 265 SQ. YD.-TEMPORARY EROSION CONTROL SEEDING, 5 LB .--PERIMETER EROSION BARRIER, 340 FT.

LIMITS OF CONSTRUCTION

PERIMETER EROSION BARRIER (28000400)

INLET AND PIPE PROTECTION (28000500)

ML

03/12/2010

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JSER NAME = \$USER\$

PLOT SCALE = \$SCALE\$

PLOT DATE = \$DATE\$

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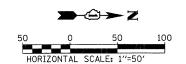
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- 9. WATER PUMPED OR OTHERWISE DISCHARGED FROM THE SITE DURING CONSTRUCTION DEWATERING SHALL BE FILTERED.
- 10. GRAVEL ROADS, ACCESS DRIVES, PARKING AREAS OF SUFFICIENT WIDTH AND LENGTH, AND VEHICLE WASH DOWN FACILITIES IF NECESSARY, SHALL BE PROVIDED TO PREVENT SOIL FROM BEING TRACKED ONTO PUBLIC OR PRIVATE ROADWAYS. ANY SOIL REACHING A PUBLIC OR PRIVATE ROADWAY SHALL BE REMOVED BEFORE THE END OF EACH WORKDAY AND AS NEEDED.
- 11. CLEANING OF VEHICLES AND EQUIPMENT, INCLUDING CONCRETE MIXERS, SHALL BE PERFORMED IN A MANNER TO REDUCE THE AMOUNT OF POLLUTANTS TRIBUTARY TO STORM SEWERS AND OPEN WATERS TO THE MAXIMUM EXTENT PRACTICAL.
- 12. ALL NECESSARY MEASURES SHALL BE TAKEN TO CONTAIN ANY FUEL OR POLLUTION RUNOFF. LEAKING EQUIPMENT OR SUPPLIES SHALL BE IMMEDIATELY REPAIRED OR REMOVED FROM THE SITE.
- 13. SEDIMENT COLLECTED DURING CONSTRUCTION BY THE VARIOUS TEMPORARY EROSION CONTROL SYSTEMS SHALL BE DISPOSED OF ON A REGULAR BASIS. SEDIMENT SHALL BE REMOVED FROM EROSION CONTROL SYSTEMS WHEN THE HEIGHT OF THE SEDIMENT EXCEEDS ONE-HALF OF THE HEIGHT OF THE FILTER DEVICE.
- 14. THE ENGINEER SHALL INSPECT EROSION CONTROL MEASURES PERIODICALLY AND WITHIN 24 HOURS OF ANY STORM EXCEEDING 1/2 INCH PRECIPITATION. DAMAGED AND INEFFECTIVE EROSION CONTROL MEASURES SHALL BE REPAIRED OR REPLACED BY THE CONTRACTOR WITHIN 24 HOURS. EROSION CONTROL SYSTEMS REPLACED DUE TO SEDIMENT LOADING WILL BE PAID FOR AT THE CONTRACT UNIT PRICE FOR THE APPLICABLE EROSION CONTROL ITEM.
- 15. THE COST OF REMOVING SEDIMENT OR REPAIRING EROSION CONTROL SYSTEMS SHALL BE INCLUDED IN THE CONTRACT UNIT PRICE FOR THE APPLICABLE EROSION CONTROL ITEM.

MADISON STREET (CH 8) BIKE PATH IMPROVEMENTS

EROSION CONTROL PLAN

SCALE: 1" = 50' SHEET NO. 1 OF 1 SHEETS STA. 9+97.09 TO STA. 19+74.81



COUNTY TOTAL SHEE NO.


DUPAGE 24 9

CONTRACT NO: 63470

SECTION

07-00001-10-BT

FED. ROAD DIST, NO. ILLINOIS FED. AID PROJECT

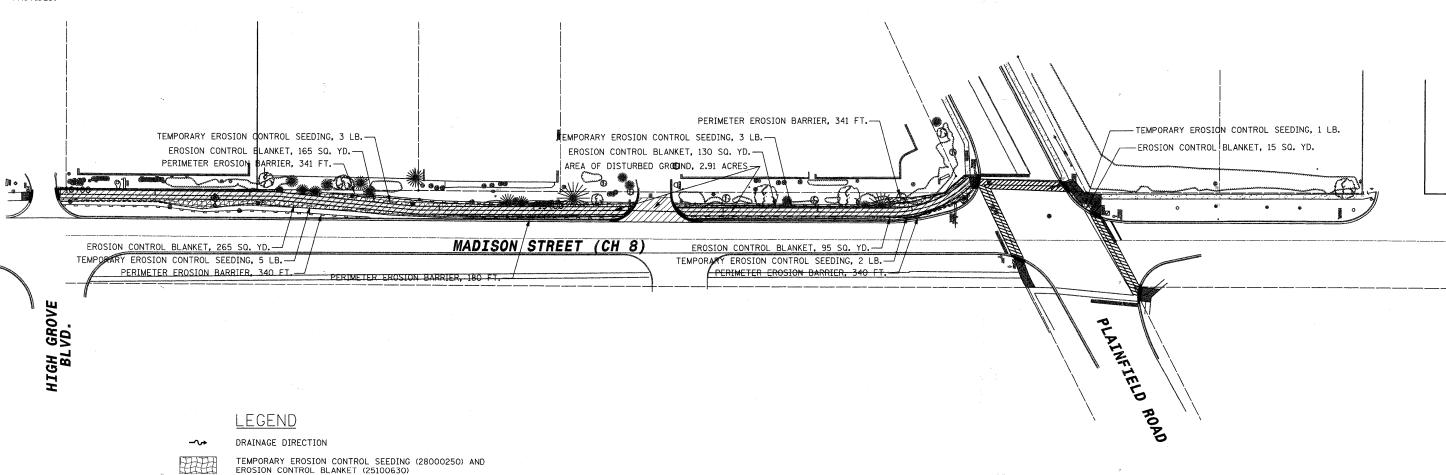


STATE OF ILLINOIS

DEPARTMENT OF TRANSPORTATION






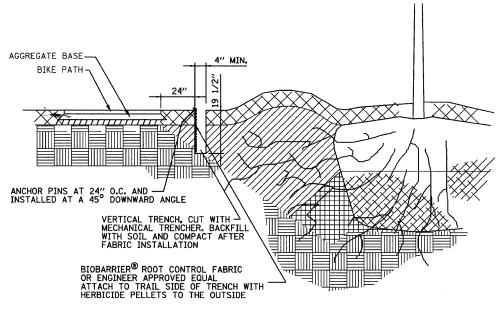

TRAIL ROOT BARRIER

N.T.S.


FILE NAME =	USER NAME = \$USER\$	DESIGNED - CRC	REVISED -		M	ADISON STREET (CH 8) BIKE PATH IMPROVEMENTS	F.A.U.	SECTION	COUNTY	TOTAL SHEET
\$FILEL\$		DRAWN - ML	REVISED -	STATE OF ILLINOIS	•		2674	07-00001-10-BT	DUPAGE	34 10
	PLOT SCALE = \$SCALE\$	CHECKED - MPK	REVISED -	DEPARTMENT OF TRANSPORTATION	DETAIL		2017	01-00001-10-61	CONTRACT NO	24 10
	PLOT DATE = \$DATE\$	DATE - 03/12/2010	REVISED -		SCALE: NTS	SHEET NO. 1 OF 1 SHEETS STA. TO STA.	FED. RO	AD DIST. NO. ILLINOIS FED.	AID PROJECT	1 03410

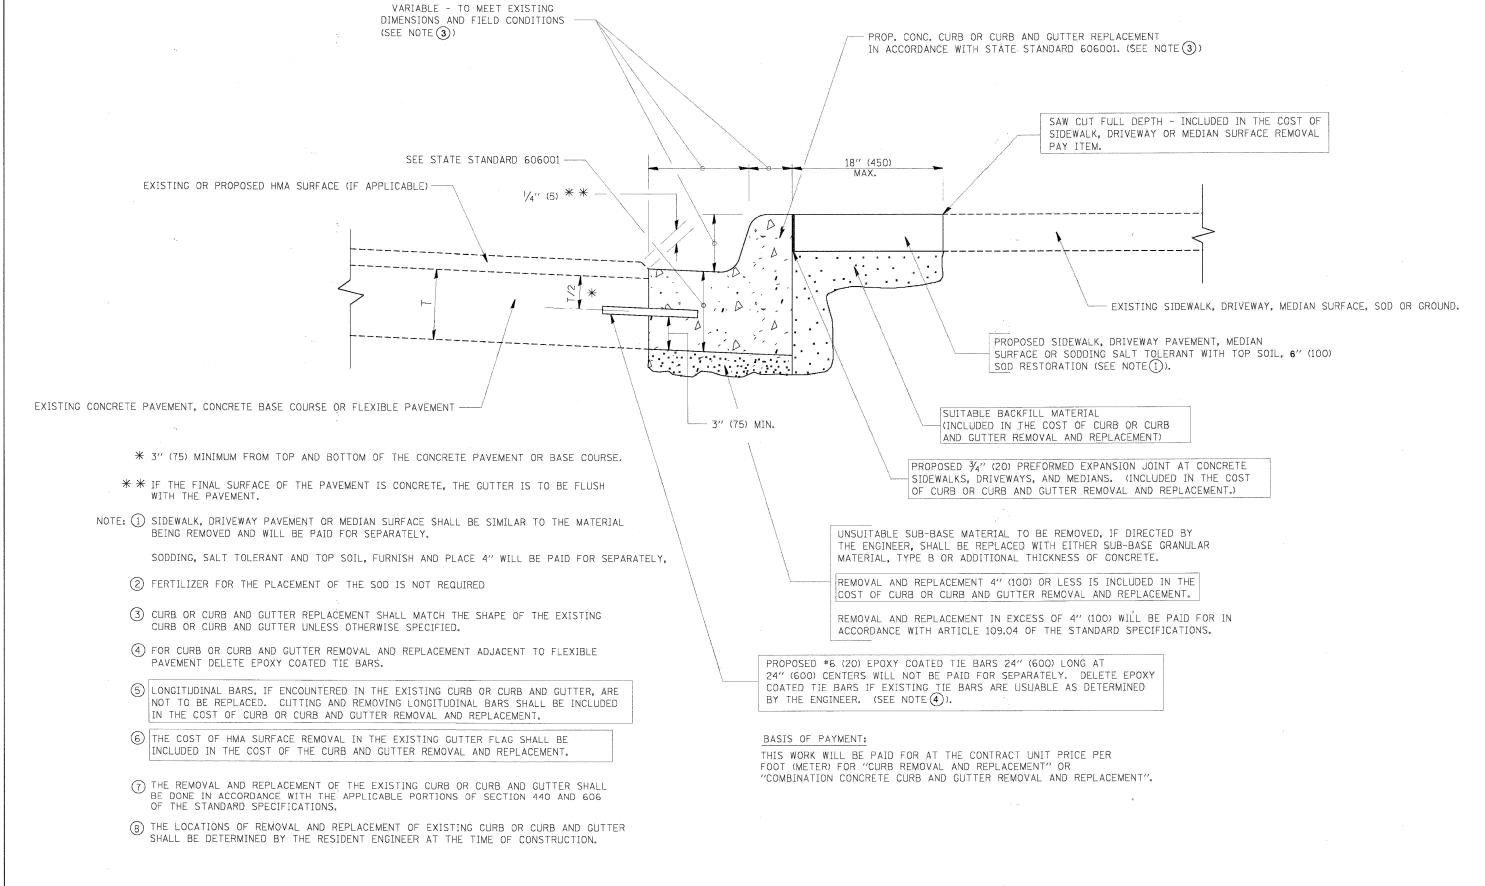

CURB OR CURB AND GUTTER REMOVAL AND REPLACEMENT

ALL DIMENSIONS ARE IN INCHES (MILLIMETERS) UNLESS OTHERWISE SHOWN.

FILE NAME =	USER NAME = drivakosgn	DESIGNED - A. HOUSEH	REVISED - R. SHAH 10-03-96		CURB OR CURB AND GUTTER	F.A. SECTION	COUNTY TOTAL SHEET NO.
e:\pw_work\pwidot/drivakosgn\dDl88315\bc	24.dgn	DRAWN -	REVISED - A. ABBAS 03-21-97 STATE OF ILLINOIS			2674 07-00001-10-BT	DUPAGE 24 11
	PLOT SCALE = 50.000 '/ IN.	CHECKED -	REVISED - M. GOMEZ 01-22-01	DEPARTMENT OF TRANSPORTATION	REMOVAL AND REPLACEMENT	BD600-06 (BD-24)	CONTRACT NO.
	PLOT DATE = 12/15/2009	DATE 03-11-94	REVISED - R. BORO 12-15-09	SCALE	SCALE: NONE SHEET NO. 1 OF 1 SHEETS STA. TO STA.	FED. ROAD DIST. NO. 1 ILLINOIS FED. #	AID PROJECT

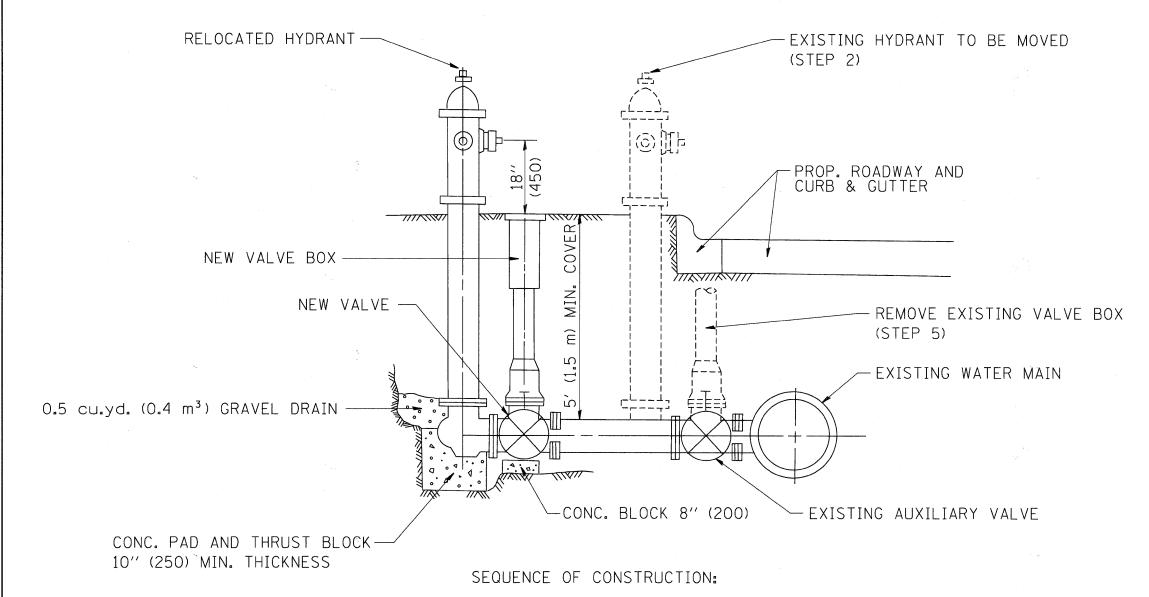


- 1. CLOSE EXISTING VALVE.
- 2. REMOVE EXISTING HYDRANT.
- 3. INSTALL HYDRANT EXTENSION AND NEW VALVE.
- 4. RELOCATE EXISTING HYDRANT.
- 5. OPEN EXISTING VALVE, REMOVE BOX.
- 6. BACKFILL.
- 7. FLUSH AND TEST FOR CHLORIDE RESIDUAL AND PROVIDE TEST.

ALL WORK TO BE DONE IN ACCORDANCE WITH ARTICLE 564 OF THE STANDARD SPECIFICATIONS. NEW VALVE AND BOX SHALL BE SAME MAKE AND MODEL AS EXISTING.

FIRE HYDRANT TO BE MOVED

ALL DIMENSIONS ARE IN INCHES (MILLIMETERS) UNLESS OTHERWISE SHOWN.

FILE NAME =	USER NAME = gaglianobt	DESIGNED -	REVISED - R. SHAH 09-09-94			FIRE INCREASE TO DE MONER	F.A. SECTION	COUNTY TOTAL SHEET
W:\d:ststd\22x34\bd36.dgn		DRAWN -	REVISED - R. SHAH 10-25-94	STATE OF ILLINOIS		FIRE HYDRANT TO BE MOVED	2674 07-00001-10-BT	DITEACE 24 12
	PLOT SCALE = 50.0000 '/ IN.	CHECKED -	REVISED -	DEPARTMENT OF TRANSPORTATION			BD-36	CONTRACT NO.
	PLOT DATE = 1/4/2008	DATE -	REVISED -		SCALE: NONE	SHEET NO. 1 OF 1 SHEETS STA. TO STA.		AID PROJECT

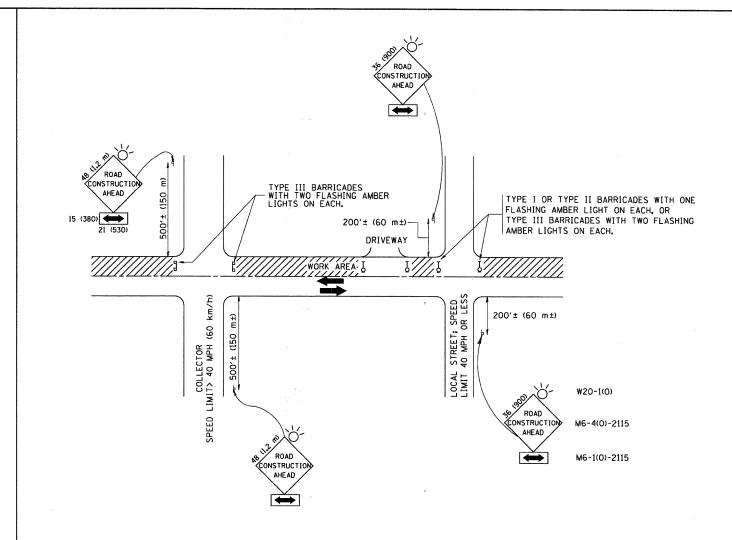

TRAFFIC CONTROL AND PROTECTION FOR SIDE ROADS, INTERSECTIONS, AND DRIVEWAYS

NOTES:

- A. FOR NO LANE RESTRICTION ON THE SIDE ROAD OR DRIVEWAYS
- 1. SIDE ROAD WITH A SPEED LIMIT OF 40 MPH (60 km/h) OR LESS AS SHOWN ON THE DRAWING AND AS DIRECTED BY THE ENGINEER:
- Q) ONE ROAD CONSTRUCTION AHEAD SIGN 36 x 36 (900x900) WITH A FLASHER AND FLAG MOUNTED ON IT APPROXIMATELY 200' (60 m) IN ADVANCE OF THE MAIN ROUTE.
- b) THE CLOSED PORTION OF THE MAIN ROUTE SHALL BE PROTECTED BY BLOCKING WITH TYPE I, TYPE II OR TYPE III BARRICADES, 1/3 OF THE CROSS SECTION OF THE CLOSED PORTION.
- 2. SIDE ROAD WITH A SPEED LIMIT GREATER THAN 40 MPH (60 km/h) AS SHOWN ON THE DRAWING AND AS DIRECTED BY THE ENGINEER:
- O) ONE ROAD CONSTRUCTION AHEAD SIGN 48 x 48 (1.2 m x 1.2 m) WITH A FLASHER MOUNTED ON IT APPROXIMATELY 500' (150 m) IN ADVANCE OF THE MAIN ROUTE.
- b) THE CLOSED PORTION OF THE MAIN ROUTE SHALL BE PROTECTED BY BLOCKING WITH TYPE III BARRICADES, 1/2 OF THE CROSS SECTION OF THE CLOSED PORTION.

SCALE: NONE

3. WHEN THE SIDE ROAD LIES BETWEEN THE BEGINNING OF THE MAINLINE SIGNING AND THE WORK ZONE, A SINGLE HEADED ARROW (MG-1) SHALL BE USED IN LIEU OF THE DOUBLE HEADED ARROW (MG-4).

B. FOR A LANE CLOSURE ON A SIDE ROAD OR DRIVEWAY:

USE APPLICABLE PORTIONS OF THE TYPICAL APPLICATION OF TRAFFIC CONTROL DEVICES (STD. 701501, STD. 701606 OR THE APPROPRIATE STANDARD). THE SPACING OF SIGNS AND BARRICADES SHALL BE ADJUSTED FOR FIELD CONDITIONS AS DIRECTED BY THE ENGINEER. THE DIRECTIONAL ARROW SHALL BE COVERED OR REMOVED WHEN NO LONGER CONSISTENT WITH THE SIDE ROAD LANE CLOSURE.


- C. ADVANCE WARNING SIGNS ARE TO BE OMITTED ON DRIVEWAY UNLESS OTHERWISE NOTED.
- D. THE TRAFFIC CONTROL AND PROTECTION FOR SIDE ROADS, INTERSECTIONS, AND DRIVEWAYS SHALL BE INCIDENTAL TO THE COST OF SPECIFIED TRAFFIC CONTROL STANDARDS OR ITEMS.

All dimensions are in millimeters (inches) unless otherwise shown,

FILE NAME =	USER NAME = gaglianobt	DESIGNED - LHA	REVISED - J. OBERLE 10-18-95
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	PLOT SCALE = 50.000 '/ IN.	CHECKED -	REVISED - A. HOUSEH 10-15-96
	PLOT DATE = 1/4/2008	DATE - 06-89	REVISED -T. RAMMACHER 01-06-00

STATE OF ILLINOIS
DEPARTMENT OF TRANSPORTATION

TR.	AFFIC	CONTR	OL AND I	PROTEC	TION FOR		
SIDE	ROAD	S, INTEI	RSECTIONS	S, AND	DRIVEWAY	S	
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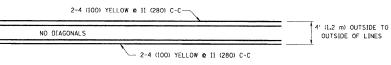
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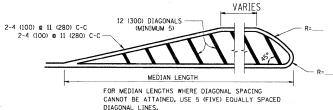
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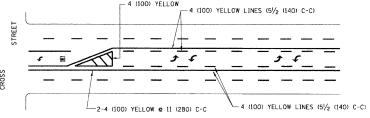
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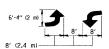
4' (1.2 m) WIDE MEDIANS ONLY

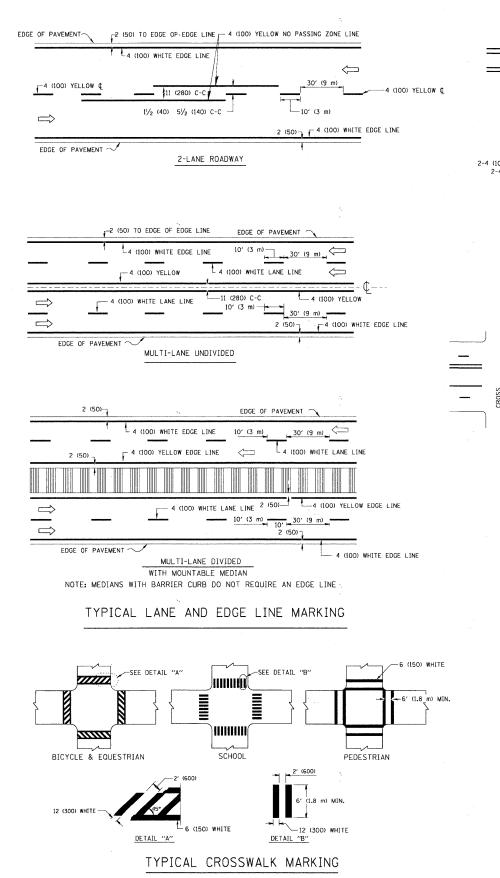

MEDIANS OVER 4' (1.2 m) WIDE




A MINIMUM OF TWO PAIRS OF TURN ARROWS SHALL BE USED, WHITE IN COLOR, ADDITIONAL PAIRS SHALL BE PLACED AT 200' (60 m) TO 300' (90 m) INTERVALS.



MEDIAN WITH TWO-WAY LEFT TURN LANE


TYPICAL PAINTED MEDIAN MARKING

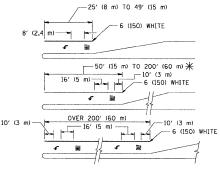

* TURN LANES IN EXCESS OF 400' (120 m) IN LENGTH MAY HAVE AN ADDITIONAL SET OF ARROW - "ONLY" INSTALLED MIDWAY BETWEEN THE OTHER TWO SETS OF ARROW - "ONLY".

TYPICAL LEFT (OR RIGHT) TURN LANE

TYPICAL TURN LANE MARKING

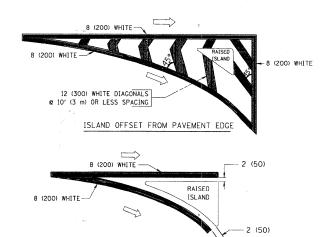

TYPICAL ISLAND MARKING

ISLAND AT PAVEMENT EDGE

TYPE OF MARKING	WIDTH OF LINE	PATTERN	COLOR	SPACING / REMARKS
CENTERLINE ON 2 LANE PAVEMENT	4 (100)	SKIP-DASH	YELLOW	10' (3 m) LINE WITH 30' (9 m) SPACE
CENTERLINE ON MULTI-LANE UNDIVIDED PAVEMENT	2 @ 4 (100)	SOLID	YELLOW	11 (280) C-C
NO PASSING ZONE LINES: FOR ONE DIRECTION FOR BOTH DIRECTIONS	4 (100) 2 @ 4 (100)	SOLID SOLID	YELLOW YELLOW	5½ (140) C-C FROM SKIP-DASH CENTERLINE 11 (280) C-C OMIT SKIP-DASH CENTERLINE BETWEEN
LANE LINES	4 (100) 5 (125) ON FREEWAYS	SKIP-DASH SKIP-DASH	WHITE	10' (3 m) LINE WITH 30' (9 m) SPACE
DOTTED LINES (EXTENSIONS OF CENTER, LANE OR TURN LANE MARKINGS)	SAME AS LINE BEING EXTENDED	SKIP-DASH	SAME AS LINE BEING EXTENDED	2' (600) LINE WITH 6' (1.8 m) SPACE
EDGE LINES	4 (100)	SOLID	YELLOW-LEFT WHITE-RIGHT	OUTLINE MOUNTABLE MEDIANS IN YELLOW: EDGE LINES ARE NOT USED NEXT TO BARRIER CURB
TURN LANE MARKINGS	6 (150) LINE; FULL SIZE LETTERS & SYMBOLS (8' (2.4m))	SOLID	WHITE	SEE TYPICAL TURN LANE MARKING DETAIL
TWO WAY LEFT TURN MARKING	2 @ 4 (100) EACH DIRECTION	SKIP-DASH AND SOLID	YELLOW	10' (3 m) LINE WITH 30' (9 m) SPACE FOR SKIP-DASH; 5½ (140) C-C BETWEEN SOLID LINE AND SKIP-DASH LINE
	8' (2.4m) LEFT ARROW	IN PAIRS	WHITE	SEE TYPICAL TWO-WAY LEFT TURN MARKING DETAIL
CROSSWALK LINES (PEDESTRIAN) A. DIAGONALS (BIKE & EQUESTRIAN) B. LONGITUDINAL BARS (SCHOOL)	2 @ 6 (150) 12 (300) @ 45° 12 (300) @ 90°	SOLID SOLID SOLID	WHITE WHITE WHITE	NOT LESS THAN 6' (1.8 m) APART 2' (600) APART 2' (600) APART SEE TYPICAL CROSSWALK MARKING DETAILS.
STOP LINES	24 (600)	SOLID *	WHITE	PLACE 4" (1.2 m) IN ADVANCE OF AND PARALLEL TO CROSSWALK, IF PRESENT. OTHERWISE, PLACE AT DESIRED STOPPING POINT. PARALLEL TO CROSSROAD CENTERLINE, WHERE POSSIBLE
PAINTED MEDIANS	2 @ 4 (100) WITH 12 (300) DIAGONALS @ 45° NO DIAGONALS USED FOR 4' (1.2 m) WIDE MEDIANS	SOLID	YELLOW: TWO WAY TRAFFIC WHITE: ONE WAY TRAFFIC	11 (280) C-C FOR THE DOUBLE LINE SEE TYPICAL PAINTED MEDIAN MARKING.
CORE MARKING AND CHANNELIZING LINES	8 (200) WITH 12 (300) DIAGONALS @ 45°	SOLID	WHITE	DIAGONALS: 15' (4.5 m) C-C (LESS THAN 30MPH (50 km/h)) 20' (6 m) C-C 30MPH (50 km/h) TO 45MPH (70 km/h)) 30' (9 m) C-C (OVER 45MPH (70 km/h))
RAILROAD CROSSING	24 (600) TRANSVERSE LINES; "RR" IS 6' (1.8 m) LETTERS; 16 (400) LINE FOR "X"	SOLID	WHITE	SEE STATE STANDARD 780001 AREA OF: "R"3.6 SO. FT. (0.33 m²) EACH "X"=54.0 SO. FT. (5.0 m²)
SHOULDER DIAGONALS	12 (300) @ 45°	SOLID	WHITE - RIGHT YELLOW - LEFT	50' (15 m) C-C (LESS THAN 30MPH (50 km/h)) 75' (25 m) C-C (30 MPH (50 km/h) T0 45MPH (70 km/h)) 150' (45 m) C-C (0VER 45MPH (70 km/h))

FOR FURTHER DETAILS ON PAVEMENT MARKING REFER TO STANDARD SPECIFICATIONS FOR ROAD AND BRIDGE CONSTRUCTION AND STATE STANDARD 780001.

All dimensions are in inches (millimeters)

REVISED	-T. RAMMACHER	10-27-94
REVISED	-C. JUCIUS	09-09-09

STATE OF ILLINOIS DEPARTMENT OF TRANSPORTATION

	DI	STRICT OF	VE		F.A RTE.	SECTION	COUNTY	TOTAL	SHEET NO.
	TYPICAL PA	VEMENT	MARKINGS		2674	07-00001-10-BT	DUPAGE	24	14
	TITIONE 17	TC-13		CONTRACT NO.					
SCALE: NONE	SHEET NO. 1 OF 1	SHEETS	STA.	TO STA.	FED. ROAD DIST. NO. 1 ILLINOIS FED. AID PROJECT				

