STATE OF ILLINOIS

DEPARTMENT OF TRANSPORTATION

DIVISION OF HIGHWAYS

PROPOSED HIGHWAY PLANS

FAU 1587 MCCARTHY ROAD ST JAMES WAY TO 1150' WEST SECTION: 3098-T **DRAINAGE IMPROVEMENT COOK COUNTY** C-91-588-10

HY ROAD GLENEAGLES COUNTRY CLUB

SCALE: N.T.S.

LEMONT TOWNSHIP

GROSS LENGTH & NET LENGTH OF PROJECT = 1090 LINEAL FT. = 0.21 MILE

IMPROVEMENT ENDS STA 211+33

IMPROVEMENT BEGINS

DESIGN DESIGNATION MINOR ARTERIAL

STA 200 + 43

FOR INDEX OF SHEETS, SEE SHEET NO. 2

THE IMPROVEMENT IS LOCATED IN

THE VILLAGE OF LEMONT

TRAFFIC DATA 2009 ADT = 8,800 VPDPOSTED SPEED LIMIT = 50 MPH

FULL SIZE PLANS HAVE BEEN PREPARED USING STANDARD ENGINEERING SCALES. REDUCED SIZED PLANS WILL NOT CONFORM TO STANDARD SCALES. IN MAKING MEASUREMENTS ON REDUCED PLANS, THE ABOVE SCALES MAY BE USED.

JOINT UTILITY LOCATION INFORMATION FOR EXCAVATION 1-800-892-0123 OR 811

PROJECT ENGINEER: TOM SLATTERY PROJECT MANAGER: KEN ENG (847) 705-4247

CONTRACT NO. 60K75

FED. ROAD DIST NO. | ILLINOIS | CONTRACT NO. 60K75


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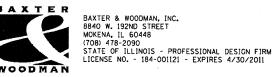
C-91-588-10

3098-T

1587





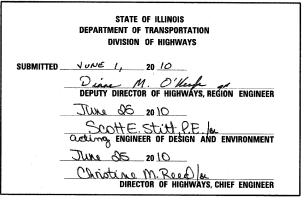

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HIGHWAY STANDARDS

000001-05	STANDARD SYMBOLS, ABBREVIATIONS AND PATTERNS	
2 ø 80001- <i>05</i>	TEMPORARY EROSION CONTROL SYSTEMS	
442201- <i>03</i>	CLASS C AND D PATCHES	
542101 -<i>02</i>	REINFORCED CONCRETE END SECTIONS FOR PIPE CULVERTS	
	15" THRU 36" DIA. AT RIGHT ANGLES WITH ROADWAY	
542301 <i>-0</i> 2	PRECAST REINFORCED CONCRETE FLARED END SECTION	
602401- <i>02</i>	MANHOLE TYPE A	
602601- <i>02</i>	PRECAST REINFORCED CONCRETE FLAT SLAB TOP	
602701 -02	MANHOLE STEPS	
604036 <i>-02</i>	GRATE TYPE 8	
701006 <i>-03</i>	OFF ROAD OPERATIONS. 2L, 2W, 15' TO 24' FROM PAVEMENT	EDGE
70150 1-<i>05</i>	URBAN LANE CLOSURE, 2L, 2W UNDIVIDED	
701601 -06	URBAN LANE CLOSURE, MULTILANE, 1W OF 2W WITH	
	NON TRAVERSABLE MEDIAN	
701901- <i>01</i>	TRAFFIC CONTROL DEVICES	

GENERAL NOTES

- 1. BEFORE STARTING EXCAVATION, THE CONTRACTOR SHALL CALL "JULIE" AT 800-892-0123 FOR FIELD LOCATIONS OF BURIED ELECTRIC, TELEPHONE AND GAS FACILITIES. (48 HOURS NOTIFICATION REQUIRED).
- 2. THE CONTRACTOR SHALL COORDINATE CONSTRUCTION ACTIVITIES WITH UTILITY COMPANIES.
- 3. BEFORE BEGINNING ANY WORK, THE CONTRACTOR SHALL RETAIN AND RECORD FOR FUTURE REFERENCE, ALL EXISTING PAVEMENT MARKING LINES (AND RAISED REFLECTIVE MARKINGS) IN ORDER THAT THESE LOCATIONS CAN BE RE-ESTABLISED FOR STRIPING. EXACT LOCATIONS OF ALL PAVEMENT MARKINGS SHALL BE AS DIRECTED BY THE ENGINEER.
- 4. THE RESIDENT ENGINEER SHOULD CONTACT MS. PATRICE HARRIS, AREA TRAFFIC FIELD TECHNICIAN, AT (708) 597-9800 AT LEAST TWO WEEKS PRIOR TO PLACING PERMANENT PAVEMENT MARKINGS.
- 5. THE CONTRACTOR WILL NOT BE ALLOWED TO SET UP A YARD OR FIELD OFFICE ON STATE PROPERTY WITHOUT WRITTEN PERMISSION FROM THE DEPARTMENT.
- 6. THE RESIDENT ENGINEER SHALL CONTACT THE TRAFFIC CONTROL SUPERVISOR AT (847)705-4470 A MINIMUM OF 72 HOURS PRIOR TO THE PLACEMENT OF TEMPORARY TRAFFIC CONTROL DEVICES.
- 7. BARRICADES: THE CONTRACTOR SHALL PROVIDE AND INSTALL TWO (2) WEIGHTED SAND BAGS ON EACH TYPE I OR TYPE II BARRICADE USED - ONE (1) WEIGHTED SAND BAG ACROSS EACH BOTTOM RAIL.
- 8. WHEN ARTIFICIAL LIGHTING IS USED IN NIGHT OPERATIONS THE CONTRACTOR SHALL EXERCISE THE UTMOST PRECAUTIONS IN PREVENTING ADVERSE VISIBILITY TO MOTORING PUBLIC AND ADJOINING RESIDENTIAL AREAS.
- 9. FOR PAVEMENT MARKING, REFER TO DISTRICT ONE TYPICAL MARKINGS FOR DETAILS SHOWN.

DESIGNED	-	CAC	REVISED	-	PER	IDOT	5-19-10	_
DRAWN	-	BCD	REVISED	-				_
CHECKED	-	TMS	REVISED	-				_
DATE	-	04/26/10	FILE -	100	153-I	ndex.	shf	

9		
INDEX OF SHEETS, LIST OF HIGHWAY STANDARDS &	F.A. RTÉ.	SECTION
GENERAL NOTES	1587	3098-T
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	 		CONTRACT	T NO. 6	OK 7
1587	30	98-T	COOK	17	2
F.A. RTE.	SE	CTION	COUNTY	TOTAL SHEETS	SHE

HT & 2010, BY BAXTER & WOODMAN, INC. DF ILLINOIS - PROFESSIONAL DESIGN FIRM NO. - 184-001121 - EXPIRES 4/30/2011

	SUMMARY OF QUANTITES		URBAN	CONSTRUCTIO	N TYPE CODE
CODE NO	ITEM	UNIT	TOTAL QUANTITIES	Y007 DRAINAGE QUANTITY	1112 000
20100110	TREE REMOVAL (6 TO 15 UNITS DIAMETER)	UNIT	72	72	
20200100	EARTH EXCAVATION	CU YD	267	267	
20201200	REMOVAL AND DISPOSAL OF UNSUITABLE MATERIAL	CU YD	389	389	
20800150	TRENCH BACKFILL	CU YD	76	76	
21101615	TOPSOIL FURNISH AND PLACE, 4"	SQ YD	3997	3997	
25000210	SEEING, CLASS 2A	ACRE	0.8	0.8	
25000210	NITROGEN FERTILIZER NUTRIENT	POUND	72	72	
25000500	PHOSPHORUS FERTILIZER NUTRIENT				
	* ************************************	POUND	72	72	
25000600	POTASSIUM FERTILIZER NUTRIENT	POUND	72	72	
25100630	EROSION CONTROL BLANKET	SQ YD	3997	3997	
28000250	TEMPORARY EROSION CONTROL SEEDING	POUND	80	80	
28000305	TEMPORARY DITCH CHECKS	FOOT	48	48	
28000400	PERIMETER EROSION BARRIER	FOOT	382	382	
28000500	INLET AND PIPE PROTECTION	EACH	2	2	
28000510	INLET FILTERS	EACH	6	6	
28100105	STONE RIPRAP, CLASS A3	SQ YD	15	15	
28200200	FILTER FABRIC	SQ YD	15	15	
35102000	AGGREGATE BASE COURSE, TYPE B 8"	SQ YD	65	65	
35501308	HOT-MIX ASPHALT BASE COURSE, 6"	SQ YD	65	65	
40600100	BITUMINOUS MATERIALS (PRIME COAT)	GALLON	5	5	
40600300	AGGREGATE (PRIME COAT)	TON	0.1	0.1	
40603310	HOT-MIX ASPHALT SURFACE COURSE, MIX "C," N50	TON	15	15	
44201833	CLASS D PATCHES, TYPE IV, 15 INCH	SQ YD	48	48	
50104400	CONCRETE HEADWALL REMOVAL	EACH	4	4	
50105220	PÎPE CULVERT REMOVAL	FOOT	180	180	
542A0220	PIPE CULVERTS, CLASS A, TYPE 1 15"	FOOT	42	42	
542A1069	PIPE CULVERTS, CLASS A, TYPE 2 24"	FOOT	55	55	
54213663	PRECAST REINFORCED CONCRETE FLARED END SECTIONS 18"	EACH	1	1	
54215415	CAST-IN-PLACE REINFORCED CONCRETE END SECTIONS 15"	EACH	2	2	
54215424	CAST-IN-PLACE REINFORCED CONCRETE END SECTIONS 24"	EACH	2	2	
550A0380	STORM SEWERS, CLASS A, TYPE 2 18"	FOOT	859	859	
55037900	STORM SEWERS TO BE CLEANED 15"	FOOT	248	248	
60219000	MANHOLES, TYPE A, 4'-DIAMETER, TYPE 8 GRATE	EACH	2	2	
67000400	ENGINEER'S FIELD OFFICE, TYPE A	CAL MO	6 .	6	
67100100	MOBILIZATION (AND	L SUM	1	1	
70102620	TRAFFIC CONTROL PROTECTION - STANDARD 701501	L SUM	1	1	
70102630	TRAFFIC CONTROL PROTECTION - STANDARD 701601	L SUM	1	1	
78000200	THERMOPLASTIC PAVEMENT MARKING - LINE 4"	FOOT	120	120	
Z0013798	CONSTRUCTION LAYOUT	L SUM	1	1	
Z0018500	DRAINAGE STRUCTURES TO BE CLEANED	EACH	3	3	
20030850	TEMPORARY INFORMATION SIGNING	SQ FT	52	52	
20023202	SEDIMENT CONTROL, DRAINAGE STRUCTURE INLET FILTER CLEANING	EACH	6	6	
20023206	SEDIMENT CONTROL, SILT FENCE MAINTENANCE	FOOT	382	382	
			1		

EARTHWORK

	SQUA	ARE FEET BY ST	ATION	VOLU	MES, IN CUBIC Y	'ARDS			
							REMOVAL AND DISPOSAL OF		
	TOPSOIL	EARTH		TOPSOIL	EARTH		UNSUITABLE	EARTH EXCAVATION	BALANCE
	EXCAVATION	EXCAVATION	EMBANKMENT	EXCAVATION	EXCAVATION	EMBANKMENT	MATERIAL	TO BE USED IN	WASTE (+)
STATION	(SQ FT)	(SQ FT)	(SQ FT)	(CU YD)	(CU YD)	(CU YD)	(CU YD)	EMBANKMENT	SHORTAGE (-
200+43.00	5.0	0.0	0.2						····
201+00.00	8.2	0.2	3.3	14.0	1.0	4.0	14.0	0.9	-3.2
202+00.00	7.3	11.7	0.1	29.0	23.0	7.0	29.0	19.6	12.6
203+00.00	9.0	14.8	0.1	31.0	50.0	1.0	31.0	42.5	41.5
203+90.00	9.0	14.8	0.1	30.0	50.0	1.0	30.0	42.5	41.5
204+00.00	22.0	122.8	55.8	6.0	26.0	11.0	6.0	22.1	11.1
204+10.00	10.0	3.9	3.6	6.0	24.0	11.0	6.0	20,4	9.4
205+00.00	10.0	3.9	3.6	34.0	13.0	12.0	34.0	11.1	-1.0
206+00.00	11.0	3.6	0.2	39.0	14.0	8.0	39.0	11.9	3.9
207+00.00	9.5	5.7	0.3	38.0	⊭ 18.0	1.0	38.0	15.3	14.3
208+00.00	9.8	8.5	0.6	36.0	27.0	2.0	36.0	23.0	21.0
209+00.00	9.5	6.7	0.2	36.0	29.0	2.0	36.0	24.7	22.7
210+00.00	9.5	11.5	0.2	36.0	34.0	1.0	36.0	28.9	27.9
210+00.00	9.5	11.5	0.2	0.0	0.0	0.0	0.0	0.0	0.0
211+00.00	10.0	12.0	1.0	37.0	44.0	3.0	37.0	37.4	34.4
211+11.00	27.0	313.7	187.9	8.0	67.0	39.0	8.0	57.0	18.0
211+20.00	6.0	2.0	2.0	6.0	53.0	32.0	6.0	45.1	13.1
211+33.00	6.0	0.0	. 0.0	3.0	1.0	1.0	3.0	0.9	-0.2
- <u></u>									
TOTALS:				389.0	474.0	136.0	389.0	402.9	266.9

NOTES: 15% SHRINKAGE FACTOR WAS USED ASSUMED 6" TOPSOIL EXCAVATION PAVEMENT REMOVAL AREA IS INCLUDED AS EARTH EXCAVATION

SCALE: NONE

DESIGNED	-	CAC	REVISED - PER IDOT 5-19-10
DRAWN	-	BCD	REVISED -
CHECKED	-	TMS	REVISED -
DATE		04/26/10	FILE - 100153-S00.sht


STATE OF ILLINOIS
DEPARTMENT OF TRANSPORTATION

CHARLADY OF CHARITITICS		F.A. RTE.	SEC-	TION	COUNTY	TOTAL SHEETS	SHEE NO.
SUMMARY OF QUANTITIES		1587	309	B-T	COOK	17	3
					CONTRACT	NO. 6	OK 75
STA.	TO STA.	FED. RO	DAD DIST. NO.	ILLINOIS FED. AI	D PROJECT		

[•] SPECIALTY ITEMS

EXISTING TYPICAL SECTION MCCARTHY ROAD

STA 200+43 TO STA 211+33

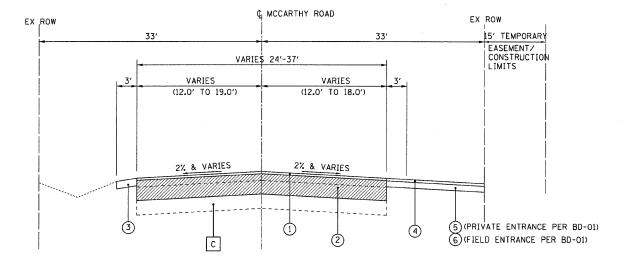

PROPOSED TYPICAL SECTION MCCARTHY ROAD

STA 200+43 TO STA 211+33

EXISTING LEGEND

- HOT-MIX ASPHALT PAVEMENT, (AVG. DEPTH 5")
- PCC BASE COURSE, (10" & VARIES)
- С AGGREGATE BASE COURSE, (VARIES 6"-11")
- AGGREGATE SHOULDERS, VARIABLE DEPTH
- EXISTING DRIVEWAY

PROPOSED LEGEND

- HOT-MIX ASPHALT SURFACE COURSE, MIX "D", N50 2" (INCLUDED IN THE COST OF THE CLASS D PATCH)
- CLASS D PATCHES, TYPE IV. 15 INCH (PLACED IN 4 LIFTS)
- 3 AGGREGATE SHOULDERS, TYPE B-6" (INCLUDED IN THE COST OF THE CLASS D PATCH)
- 4 HMA SURFACE COURSE, MIX "C". N50-2"
- (5) HMA BASE COURSE, 6" (PLACED IN 2 LIFTS)
- AGGREGATE BASE COURSE, TYPE B, 8"

HOT-MIX ASPHALT MIXTURE REQUIREMENTS

	AIR VOIDS @ Ndes
PATCHING	,
HOT-MIX ASPHALT SURFACE COURSE, MIX "D", N50 (IL 9.5 mm) - 2"	4% @ 50 Gyr
CLASS D PATCHES, TYPE IV, (HMA BINDER IL-19mm)	4% © 70 Gyr
DRIVEWAYS	
HOT-MIX ASPHALT SURFACE COURSE, MIX "C", N50 (IL 9.5 mm) - 2"	4% @ 50 Gyr
HOT-MIX ASPHALT BASE COURSE (HMA BINDER IL 19mm) N50: PE - 6"	4% @ 50 Gyr

1. THE UNIT WEIGHT USED TO CALCULATE ALL HOT-MIX ASPHALT SURFACES MIXTURE IS 112 LBS/SQ YD/IN. 2. THE "AC TYPE" FOR POLYMERIZED HMA MIXES SHALL BE "SBS/SBR PG 70-22 AND FOR NON-POLYMERIZED HMA THE "AC TYPE" SHALL BE "PG 64-22" UNLESS MODIFIED BY DISTRICT ONE SPECIAL PROVISIONS." FOR "PERCENT OF RAP" SEE DISTRICT ONE SPECIAL PROVISIONS.

DESIGNED REVISED PER IDOT 5-19-10 REVISED REVISED CHECKED - TMS FILE - 100153-TypSec.sht 04/26/10

STATE OF ILLINOIS **DEPARTMENT OF TRANSPORTATION**

COUNTY TOTAL SHEETS NO. TYPICAL SECTIONS 1587 3098-T CONTRACT NO. 60K75 SCALE: NONE

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BENCHMARKS

CP #1 - ELEV=720.21 CP #2 - ELEV=718.44

20.21 MAG NAIL SET IN BITUM.
18.44 MAG NAIL SET IN BITUM.


CP #3 - ELEV=705.53


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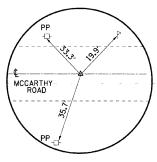
CP #4 - ELEV=715.944

MAG NAIL SET IN BITUM.

HORIZONTAL & VERTICAL CONTROL



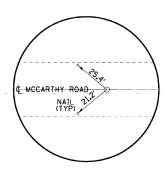


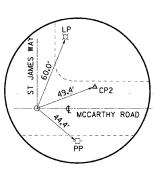



PROJECT ENDS MCCARTHY ROAD STA 211+33


P.O.T. #100 STA 190+79.55 MCCARTHY ROAD N 1088353.402, E 1820731.717 P.O.T. #101 STA 200+00.00 MCCARTHY ROAD N 1089273.334, E 1820762.603 P.O.T. #102 STA 222+71.56 MCCARTHY ROAD N 1091343.903, E 1820826.664

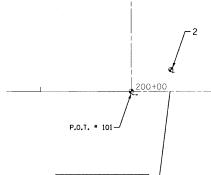




PROJECT BEGINS MCCARTHY ROAD STA 200+43


MCCARTHY ROAD

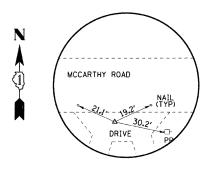


CP *1 STA 196+47.50 MCCARTHY ROAD N 1088921.704, E 1820730.869

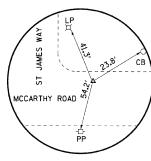


CP *2 STA 200+43.55 MCCARTHY ROAD N 1089316.129, E 1820787.541

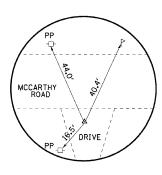


CP #3 STA 220+54.86 MCCARTHY ROAD N 1091327.683, E 1820810.858

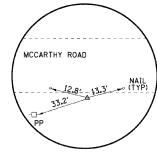


CP #4 STA 216+64.47 MCCARTHY ROAD N 1090937.493, E 1820798.401

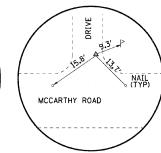

CP #5 STA 207+79.51 MCCARTHY ROAD N 1090051.998, E 1820801.956

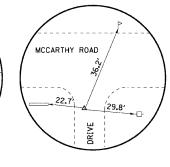

CP #6 STA 204+25.65 MCCARTHY ROAD N 1089699.220, E 1820761.458

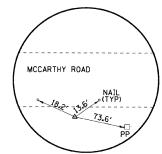

CP #7 STA 211+76.08 MCCARTHY ROAD N 1090449.348, E 1820782.905

TIE-POINTS



DESIGNED	-	CAC	REVISED - PER IDOT 5-19-10
DRAWN	-	BCD	REVISED -
CHECKED	-	TMS	REVISED -
DATE	-	04/26/10	FILE - 100153-Alignment.sht

STATE	. OF	ILLINOIS
DEPARTMENT	OF	TRANSPORTATION

		ALIGNMENT	PLAN
SCALE:	1"=50"		STA.


	F.A. RTÉ.	SECTION	COUNTY	TOTAL SHEETS	SHEE NO.
	1587	3098-T	COOK	17	5
			CONTRACT	NO. 6	OK 75
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WERNER WO. - 184-20121 POPPERS - 97-942/201

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SOIL EROSION AND SEDIMENT CONTROL NOTES:

- 1. SOIL EROSION AND SEDIMENT CONTROL FEATURES SHALL BE CONSTRUCTED PRIOR TO THE COMMENCEMENT OF UPLAND DISTURBANCE. SEE MAINTENANCE OF TRAFFIC PLAN FOR SUGGESTED CONSTRUCTION SEQUENCE.
- 2. ALL STORM SEWER FACILITIES THAT ARE OR WILL BE FUNCTIONING DURING CONSTRUCTION SHALL BE PROTECTED, FILTERED, OR OTHERWISE TREATED TO REMOVE SEDIMENT.
- 3. ALL TEMPORARY AND PERMANENT EROSION CONTROL MEASURES SHALL BE MAINTAINED AND REPAIRED AS NEEDED OR AS DIRECTED BY THE ENGINEER. THE GENERAL CONTRACTOR SHALL BE RESPONSIBLE FOR MAINTENANCE AND REPAIR DURING CONSTRUCTION. MAINTENANCE AND CLEANING OF THE EROSION CONTROL ITEMS SHALL BE INCLUDED IN THE RESPECTIVE EROSION CONTROL PAY ITEM.
- 4. ALL OPEN FLARED CULVERTS SHALL HAVE TEMPORARY DITCH CHECKS, ROLLED EXCELSIOR PLACED PERPENDICULAR TO THE WATER FLOW AND EROSION CONTROL BLANKET SHALL LINE THE DITCH AROUND THE OPEN FLARED CULVERTS.
- 5. ALL SEDIMENTATION AND EROSION CONTROL MEASURES SHALL BE IN ACCORDANCE WITH THE "ILLINOIS URBAN MANUAL", LATEST EDITION, WHERE NOT ALREADY PROVIDED FOR WITHIN THE PLANS, SPECIFICATIONS, AND SPECIAL PROVISIONS.
- 6. ALL SOIL EROSION AND SEDIMENT CONTROL PRACTICES ARE REFERENCED FROM THE ILLINOIS URBAN MANUAL.
- 7. SOIL DISTURBANCE SHALL BE CONDUCTED IN SUCH A MANNER AS TO MINIMIZE EROSION. SOIL STABILIZATION MEASURES SHALL CONSIDER THE TIME OF YEAR, SITE CONDITIONS AND THE USE OF TEMPORARY OR PERMANENT MEASURES.
- 8. SOIL EROSION AND SEDIMENT CONTROL FEATURES SHALL BE CONSTRUCTED PRIOR TO THE COMMENCEMENT OF HYDROLOGIC DISTURBANCE OF UPLAND AREAS.
- 9. DISTURBED AREAS SHALL BE STABILIZED WITH TEMPORARY OR PERMANENT MEASURES WITHIN 14 CALENDAR DAYS OF THE END OF ACTIVE HYDROLOGIC DISTURBANCE, OR REDISTURBANCE.
- 10. ALL TEMPORARY EROSION CONTROL AND SEDIMENT CONTROL MEASURES SHALL BE REMOVED WITHIN 30 DAYS AFTER FINAL SITE STABILIZATION IS ACHIEVED OR AFTER THE TEMPORARY MEASURES ARE NO LONGER NEEDED.
- 11. AN APPROPRIATE CLEANING MEASURE SHALL BE LOCATED WHERE TRAFFIC WILL BE ENTERING OR LEAVING THE CONSTRUCTION SITE / PUBLIC RIGHT-OF-WAY, STREET, ALLEY OR PARKING AREA. ANY SEDIMENT OR SOIL REACHING THE PUBLIC RIGHT-OF-WAY, STREET, ALLEY OR PARKING AREA SHALL BE REMOVED BY SCRAPING OR STREET CLEANING AS ACCUMULATIONS WARRANT AND TRANSPORTED TO A CONTROLLED OFF-SITE SEDIMENT DISPOSAL AREA. THE COSTS ASSOCIATED WITH THESE ITEMS SHALL BE INCLUDED IN THE COST OF THE CONTRACT.

TEMPORARY EROSION CONTROL LEGEND

INLET AND PIPE PROTECTION

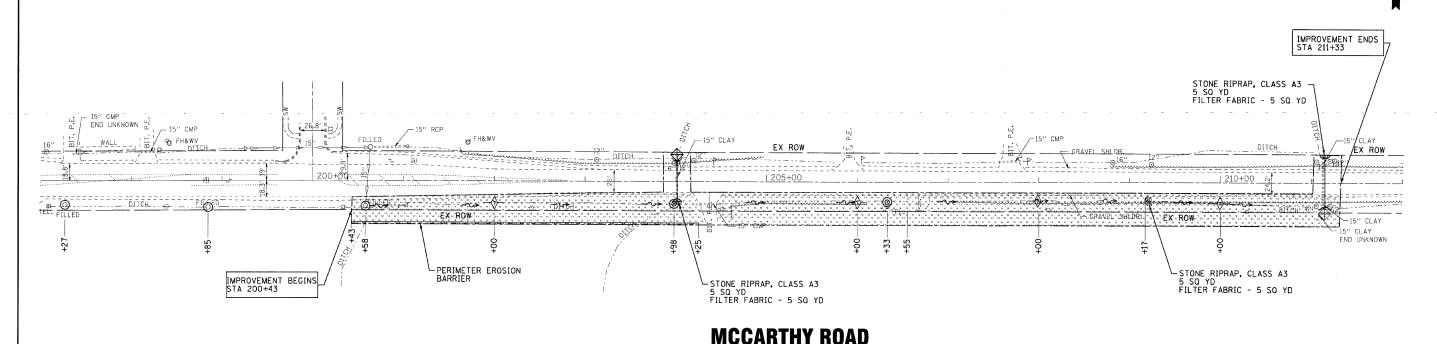TEMPORARY DITCH CHECKS

 \circ FILTER FABRIC - INLET PROTECTION

PERIMETER EROSION BARRIER

TEMPORARY EROSION CONTROL SEEDING (ENTIRE DISTURBED AREA AS DIRECTED BY THE ENGINEER.)

PROFESSIONAL IZI - EXPIRES

DESIGNED CAC REVISED - PER IDOT 5-19-10 DRAWN BCD REVISED CHECKED TMS REVISED 04/26/10 FILE - 100153-Erosion.sht


STATE OF ILLINOIS **DEPARTMENT OF TRANSPORTATION**

EROSION CONTROL PLAN


STA. 198+00 TO STA. 212+00

SECTION TOTAL SHEET SHEETS NO. COUNTY 1587 3098-T COOK CONTRACT NO. 60K75 FED. ROAD DIST, NO. ILLINOIS FED. AIL

SCALE: 1"=50"

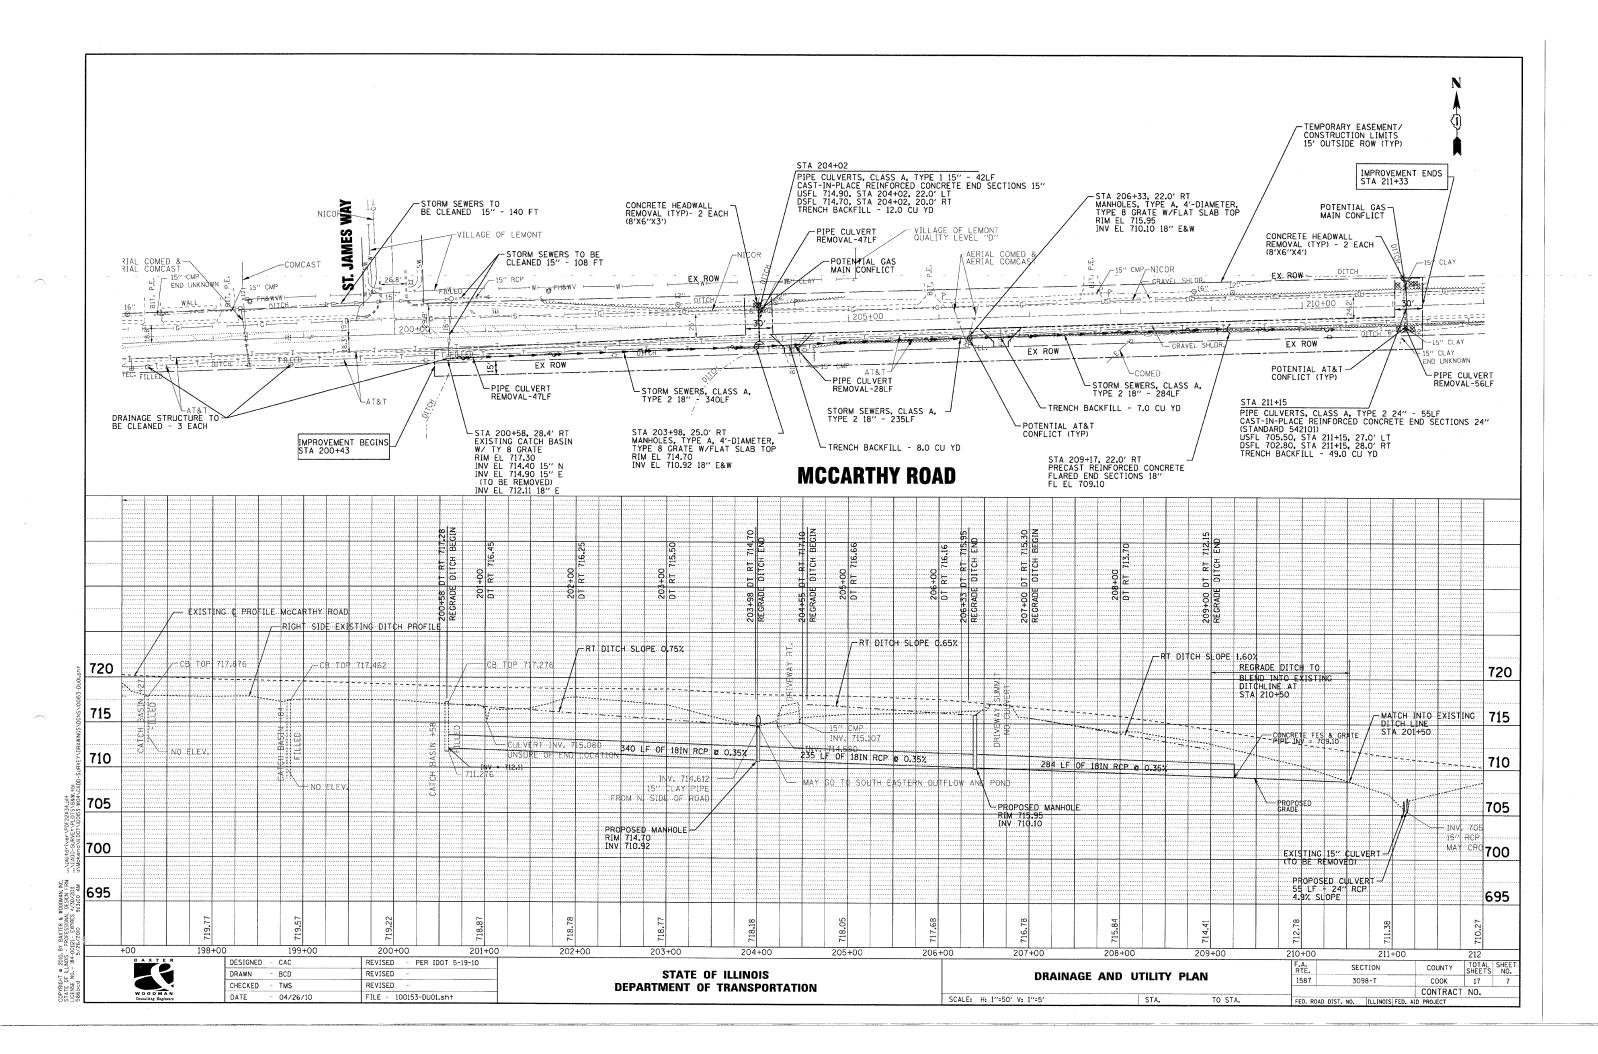



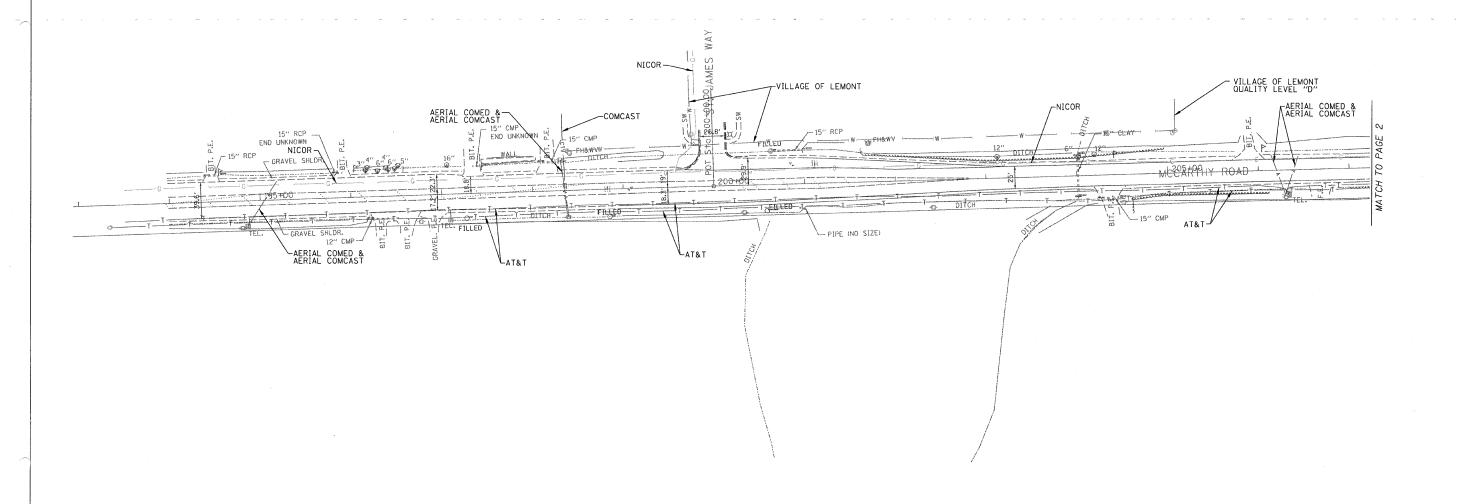

AERIAL UTILITY --- UNKNOWN CABLE TV --- TELEPHONE GAS -E--- ELECTRIC WATER - FIBER OPTIC ->- SEWER TBE TEST HOLE

Utilities shown in color on these plans as depicted in the legend have been investigated by Cardno TBE in accordance with SUE Industry Standards. All other information shown has been provided to Cardno TBE by others. TBE's SUE field investigation was finished on 4/23/10.Changes to utilities after this date may have been made and therefore may result in variances from this plan. Consideration should be given to updating this plan if deemed advisable prior to final design and construction.

ALL UTILITIES SHOWN IN COLOR QUALITY LEVEL "B" UNLESS NOTED OTHERWISE.



McCarthy Road 2000' E. and 700' W. of St. James Way in Lemont.

COUNTY TOTAL SHEET NO.
Cook 17 8 F.A. RTE. 1587 3098-T Contract No. 60K75


CIVIL ENGINEERING * TRANSPORTATION * ENVIRONMENTAL * PLANNING * UTILITY ENGINEERING/LOCATING

Utility	Quality	Level	"A"	:	Test Hole
Utility	Quality	Level	"B"	;	Test Hole Designating
Utility	Quality	Level	"C"	:	Research with Survey
					Records Research

DESIGNED	IP	REVISED	
DRAWN	KLC	REVISED	
CHECKED		REVISED	
DATE	5/05/10	REVISED	

STATE OF ILLINOIS **DEPARTMENT OF TRANSPORTATION**



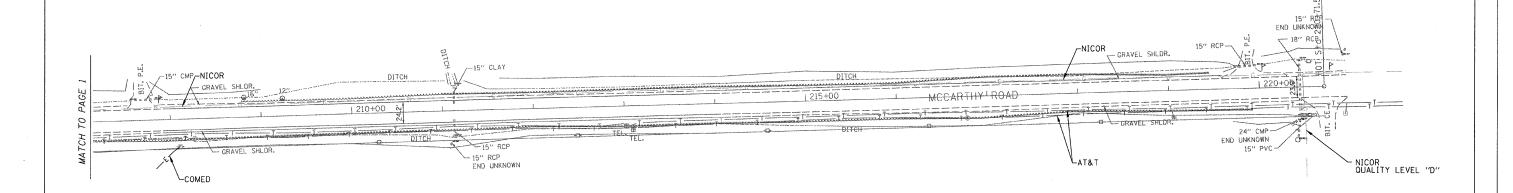

A A A AERIAL UTILITY

UNKNOWN

CTV CTV CTV CABLE TV

TELEPHONE

G G GS

E E E ELECTRIC

WATER

FO FO FO FIBER OPTIC

SEWER

TBE TEST HOLE

Utilities shown in color on these plans as depicted in the legend have been investigated by Cardno TBE in accordance with SUE Industry Standards. All other information shown has been provided to Cardno TBE by others. TBE's SUE field investigation was finished on 4/23/10. Changes to utilities after this date may have been made and therefore may result in variances from this plan. Consideration should be given to updating this plan if deemed advisable prior to final design and construction.

ALL UTILITIES SHOWN IN COLOR QUALITY LEVEL "B" UNLESS NOTED OTHERWISE.



Utility Quality Level "A" : Test Hole
Utility Quality Level "B" : Designating

Utility Quality Level "C": Research with Survey
Utility Quality Level "D": Records Research

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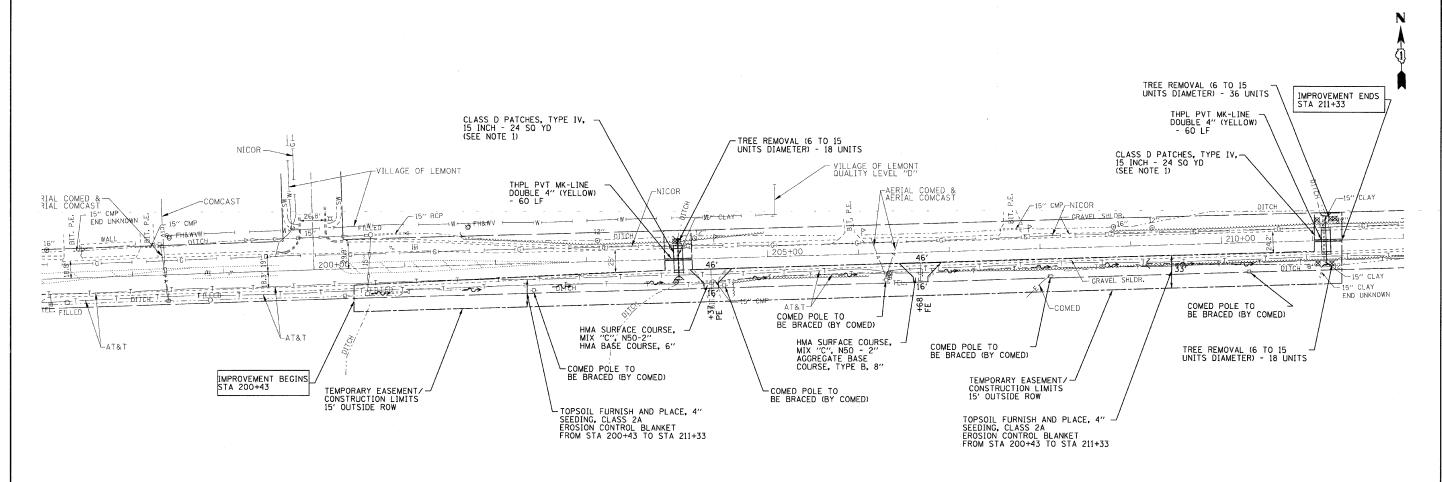
 CHECKED
 REVISED

 DATE
 5/05/10
 REVISED

STATE OF ILLINOIS
DEPARTMENT OF TRANSPORTATION

McCarthy Road 2000' E. and 700' W. of St. James Way in Lemont.

TBE Job No. ILO9510407 SUE Plan Page: 2 of 2							
F.A. RTE.	SECTION		COUNTY	TOTAL	SHEET NO.		
1587	3098-T		Cook	17	9		
Contract No. 60K75							
FED. RO	FED. ROAD DIST, NO. ILL INDIS IDOT Project No. D-91-588-10						



MCCARTHY ROAD

NOTES:

- THE TOP 2 INCHES OF THE CLASS D PATCH SHALL BE HOT-MIX ASPHALT SURFACE COURSE, "MIX D", N50.
- THE COST FOR THE HOT-MIX ASPHALT SURFACE COURSE, "MIX D", N50 WHICH IS TO BE PLACED OVER THE CLASS D PATCH SHALL BE INCLUDED IN THE COST FOR CLASS D PATCHES, TYPE IV, 15 INCH.
- THE CLASS D PATCHES, TYPE IV, 15 INCH SHALL BE FOR THE ENTIREMENT PAVEMENT THICKNESS. THE EXISTING PAVEMENT DEPTH FOR MCCARTHY ROAD; HMA PAVEMENT, AVERAGE DEPTH OF 5 INCHES AND THE PCC BASE COURSE AVGERAGE DEPTH OF 10 INCHES FOR A TOTAL DEPTH OF 15 INCHES.
- THE COST FOR THE AGGREGATE SHOULDERS, TYPE B-6" SHALL BE INCLUDED IN THE COST FOR CLASS D PATCHES.


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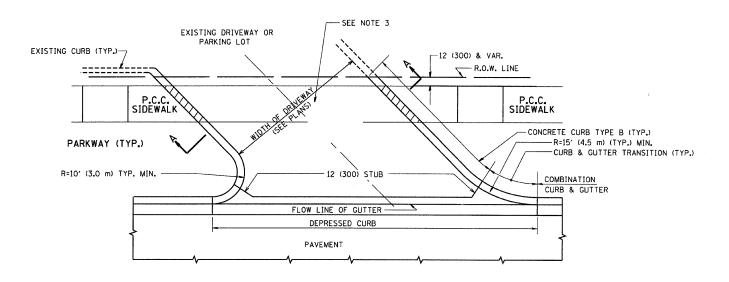
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	DESIGNED	-	CAC	REVISED - PER IDOT 5-19-10
	DRAWN	-	BCD	REVISED -
	CHECKED	-	TMS	REVISED -
	DATE	**	04/26/10	FILE - 100153-Landscaping.sht


STATE OF ILLINOIS **DEPARTMENT OF TRANSPORTATION**

F. R			F.A. RTE.	SECTION	COUNTY	TOTAL SHEETS	SHEET NO.	
I	ROADWAY PLAN				3098-T	COOK	17	10
I						CONTRACT	NO. 6	OK 75
	SCALE: 1" = 50'	STA.	TO STA.	FED. RO	DAD DIST. NO. ILLINOIS FED. A	D PROJECT		


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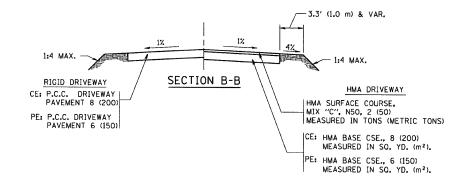




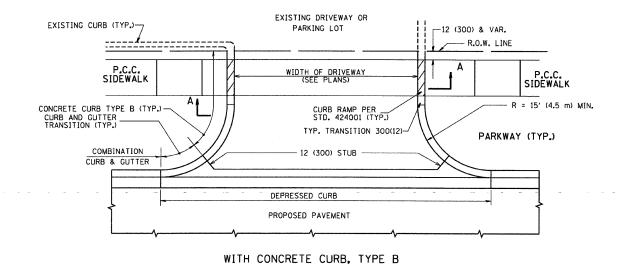

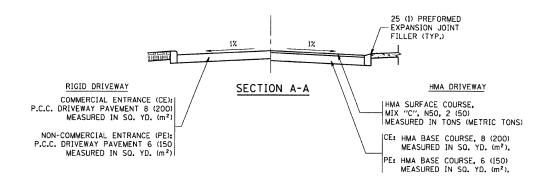WITH CONCRETE CURB, TYPE B



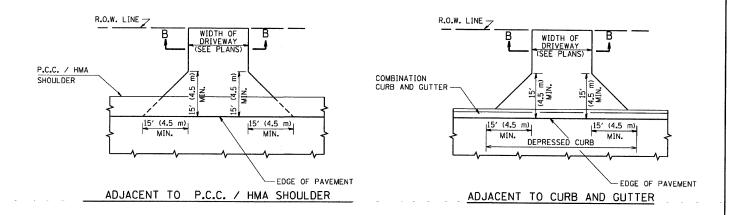

RURAL FIELD ENTRANCE (FE)

HMA SURFACE COURSE, MIX "C", N50, 2 (50) MEASURED IN TONS (METRIC TONS)

AGGREGATE BASE CSE., TYPE B, 8 (200) MEASURED IN SO. YD. (m²).

GENERAL NOTES:

DRIVEWAY SLOPES, LOCATIONS, & GEOMETRIC LAYOUT SHALL BE IN ACCORDANCE WITH THE LATEST EDITION OF THE "HANDBOOK FOR POLICY ON PERMITS FOR ACCESS DRIVEWAYS TO STATE HIGHWAYS". FOR FURTHER LAYOUT REQUIREMENTS, REFER TO ILLUSTRATIONS IN THE PERMIT HANDBOOK. DRIVEWAYS SHALL BE REPLACED IN KIND, UNLESS OTHERWISE NOTED ON THE PLANS.

COMMERCIAL DRIVEWAYS SHALL BE CONSTRUCTED WITH CONCRETE CURB, TYPE B RETURNS EXCEPT WHEN THE SIDEWALK EDGE IS 4 FEET (1.2 METERS) OR LESS FROM THE BACK OF CURB, CONSTRUCT A FLARE DRIVEWAY WITHOUT CURB.

THE RESIDENT ENGINEER SHALL CONTACT THE TRAFFIC PERMIT OFFICE AT 847/ 705-4131 FOR ANY QUESTIONS ON DRIVEWAYS SHOWN IN THE PLANS; SPECIFICALLY IN REFERENCE TO ADDITIONAL AND/OR RELOCATION/REMOVAL OF A DRIVEWAY.

COMBINATION CONCRETE CURB & GUTTER SHALL BE MEASURED STRAIGHT ACROSS THE DRIVEWAY. NO ADDITIONAL COMPENSATION WILL BE ALLOWED FOR THE CURB & GUTTER TRANSITION.


1 (25) PREFORMED EXPANSION JOINT FILLER WILL NOT BE PAID SEPARATELY, BUT SHALL BE CONSIDERED INCLUDED IN THE COST OF THE P.C.C. DRIVEWAY PAVEMENT OR P.C.C. SIDEWALK.

WHEN THE P.C.C. SIDEWALK EXTENDS THROUGH THE DRIVEWAY, THE THICKNESS OF THE SIDEWALK IN THE DRIVEWAY AREA SHALL BE THE SAME AS THE DRIVEWAY THICKNESS. SIDEWALK WILL BE PAID FOR AS P.C.C. SIDEWALK OF THE THICKNESS SPECIFIED. SIDEWALK CROSS SLOPE THRU DRIVEWAY AREA TO BE A MAXIMUM OF 1:50.

FILE NAME =	USER NAME = bauerdl	DESIGNED - R. SHAH	REVISED - M. GOMEZ 04-06-01
c:\projects\diststd22x34\bd01.dgn		DRAWN -	REVISED - P. LaFLUER 04-15-03
	PLOT SCALE = 49,9999 '/ IN.	CHECKED -	REVISED - R. BORO 01-01-07
	PLOT DATE = 6/12/2008	DATE - 11-04-95	REVISED - R. BORO 06-11-08

STATI	E 01	- ILLINOIS
DEPARTMENT	OF	TRANSPORTATION

DRIVEWAY DETAILS – DISTANCE BETWEEN R.O.W.	F.A RTE.	SECTION	COUNTY	TOTAL	SHEET NO.
AND FACE OF CURB & EDGE OF SHOULDER > = 15' (4.5 m)	1587	3098-T	COOK	17	11
		BD0156-07 (BD-01)	CONTRACT	NO.	60K75
CALE: NONE SHEET NO. 1 OF 1 SHEETS STA. TO STA.	FED. R	OAD DIST. NO. 1 ILLINOIS FED. A	ID PROJECT		

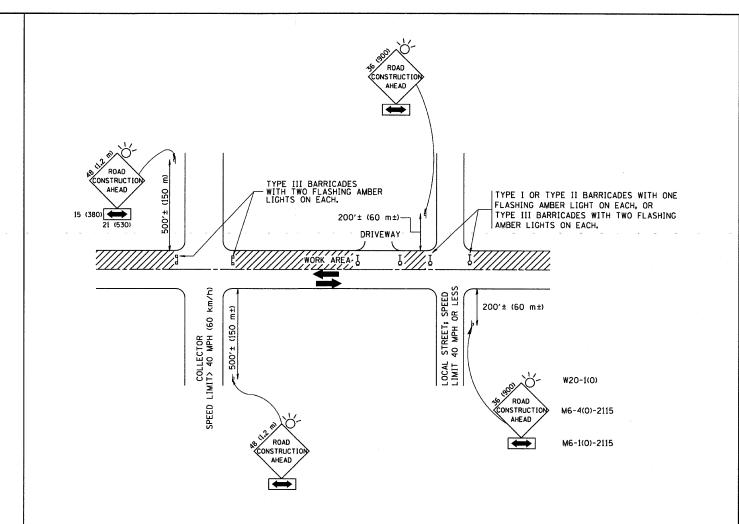

TRAFFIC CONTROL AND PROTECTION FOR SIDE ROADS, INTERSECTIONS, AND DRIVEWAYS

NOTES:

- A. FOR NO LANE RESTRICTION ON THE SIDE ROAD OR DRIVEWAYS
- 1. SIDE ROAD WITH A SPEED LIMIT OF 40 MPH (60 km/h) OR LESS AS SHOWN ON THE DRAWING AND AS DIRECTED BY THE ENGINEER:
- O) ONE ROAD CONSTRUCTION AHEAD SIGN 36 x 36 (900x900) WITH A FLASHER AND FLAG MOUNTED ON IT APPROXIMATELY 200' (60 m) IN ADVANCE OF THE MAIN ROUTE.
- b) THE CLOSED PORTION OF THE MAIN ROUTE SHALL BE PROTECTED BY BLOCKING WITH TYPE I, TYPE II OR TYPE III BARRICADES, 1/3 OF THE CROSS SECTION OF THE CLOSED PORTION.
- 2. SIDE ROAD WITH A SPEED LIMIT CREATER THAN 40 MPH (60 km/h) AS SHOWN ON THE DRAWING AND AS DIRECTED BY THE ENGINEER:
- o) ONE ROAD CONSTRUCTION AHEAD SIGN 48 \times 48 (1.2 m \times 1.2 m) WITH A FLASHER MOUNTED ON 1T APPROXIMATELY 500' (150 m) IN ADVANCE OF THE MAIN ROUTE.
- b) THE CLOSED PORTION OF THE MAIN ROUTE SHALL BE PROTECTED BY BLOCKING WITH TYPE III BARRICADES, 1/2 OF THE CROSS SECTION OF THE CLOSED PORTION,
- 3. WHEN THE SIDE ROAD LIES BETWEEN THE BEGINNING OF THE MAINLINE SIGNING AND THE WORK ZONE, A SINGLE HEADED ARROW (M6-1) SHALL BE USED IN LIEU OF THE DOUBLE HEADED ARROW (M6-4).

B. FOR A LANE CLOSURE ON A SIDE ROAD OR DRIVEWAY:

USE APPLICABLE PORTIONS OF THE TYPICAL APPLICATION OF TRAFFIC CONTROL DEVICES (STD. 701501, STD. 701606 OR THE APPROPRIATE STANDARD). THE SPACING OF SIGNS AND BARRICADES SHALL BE ADJUSTED FOR FIELD CONDITIONS AS DIRECTED BY THE ENGINEER. THE DIRECTIONAL ARROW SHALL BE COVERED OR REMOVED WHEN NO LONGER CONSISTENT WITH THE SIDE ROAD LANE CLOSURE.


- C. ADVANCE WARNING SIGNS ARE TO BE OMITTED ON DRIVEWAY UNLESS OTHERWISE NOTED.
- D. THE TRAFFIC CONTROL AND PROTECTION FOR SIDE ROADS, INTERSECTIONS, AND DRIVEWAYS SHALL BE INCIDENTAL TO THE COST OF SPECIFIED TRAFFIC CONTROL STANDARDS OR ITEMS.


All dimensions are in millimeters (inches) unless otherwise shown.


FILE NAME =	USER NAME = gaglianobt	DESIGNED - LHA	REVISED - J. OBERLE 10-18-95
W:\diststd\22x34\tc10.dgn		DRAWN -	REVISED - A. HOUSEH 03-06-96
	PLOT SCALE = 50.000 ' / IN.	CHECKED -	REVISED - A. HOUSEH 10-15-96
	PLOT DATE = 1/4/2008	DATE - 06-89	REVISED -T. RAMMACHER 01-06-00

STATI	E OF	ILLINOIS
DEPARTMENT	OF	TRANSPORTATION

TRAFFIC CONTROL AND PROTECTION FOR					F.A RTE.	SECTION	COUNTY	TOTAL SHEETS	SHEET NO.
	SIDE ROADS, INTE	RSECTIONS	AND	DRIVEWAVS	1587	3098-T	соок	17	12
						TC-10 CONTRACT			0K75
SCALE: NONE	SHEET NO. 1 OF 1	SHEETS	STA.	TO STA.	FED. ROAD DIST. NO. 1 ILLINOIS FED. AID PROJECT				

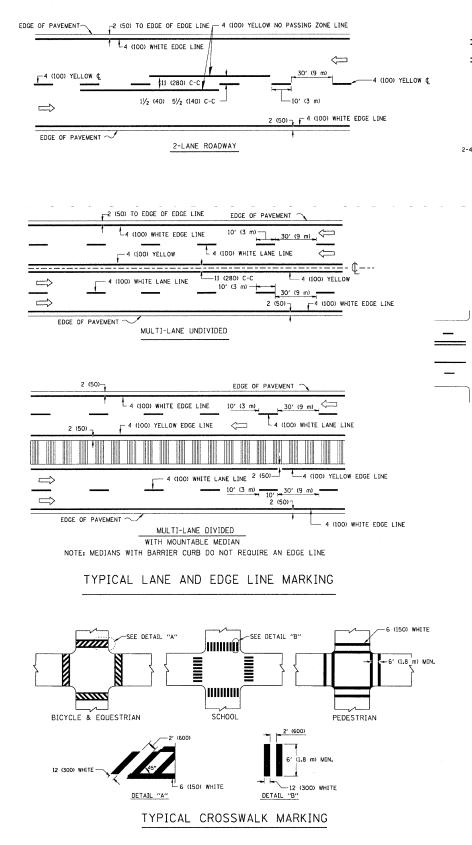


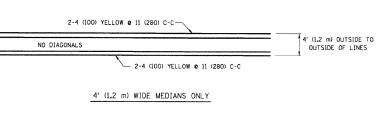

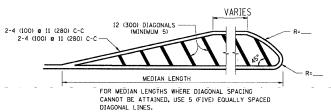


DIAGONAL LINE SPACING: 50' (15 m) C-C (LESS THAN 30MPH (50 km/h))
75' (25 m) C-C 30MPH (50 km/h) T0 45MPH (70 km/h))
150' (45 m) C-C (MORE THAN 45MPH (70 km/h))

MEDIANS OVER 4' (1.2 m) WIDE

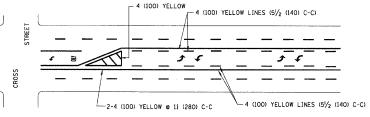


A MINIMUM OF TWO PAIRS OF TURN ARROWS SHALL BE USED, WHITE IN COLOR, ADDITIONAL PAIRS SHALL BE PLACED AT 200' (60 m) TO 300' (90 m) INTERVALS.

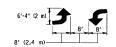

MEDIAN WITH TWO-WAY LEFT TURN LANE

TYPICAL PAINTED MEDIAN MARKING

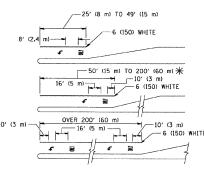


FULL SIZE LETTERS 8' (2.4 m) AND ARROWS SHALL BE USED. \P AREA = 15.6 SQ. FT. (1.5 m²) ONLY AREA = 20.8 SQ. FT. (1.9 m²)

* TURN LANES IN EXCESS OF 400' (120 m) IN LENGTH MAY HAVE AN ADDITIONAL SET OF ARROW - "ONLY" INSTALLED MIDWAY BETWEEN THE OTHER TWO SETS OF ARROW - "ONLY".

TYPICAL LEFT (OR RIGHT) TURN LANE

TYPICAL TURN LANE MARKING

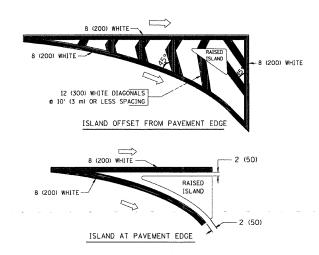

TYPICAL ISLAND MARKING

	T	T	1	
TYPE OF MARKING	WIDTH OF LINE	PATTERN	COLOR	SPACING / REMARKS
CENTERLINE ON 2 LANE PAVEMENT	4 (100)	SKIP-DASH	YELLOW	10' (3 m) LINE WITH 30' (9 m) SPACE
CENTERLINE ON MULTI-LANE UNDIVIDED PAVEMENT	2 @ 4 (100)	SOLID	YELLOW	11 (280) C-C
NO PASSING ZONE LINES: FOR ONE DIRECTION FOR BOTH DIRECTIONS	4 (100) 2 @ 4 (100)	SOLID SOLID	YELLOW YELLOW	5/2 (140) C-C FROM SKIP-DASH CENTERLINE 11 (280) C-C OMIT SKIP-DASH CENTERLINE BETWEEN
LANE LINES	4 (100) 5 (125) ON FREEWAYS	SKIP-DASH SKIP-DASH	WHITE WHITE	10' (3 m) LINE WITH 30' (9 m) SPACE
DOTTED LINES (EXTENSIONS OF CENTER, LANE OR TURN LANE MARKINGS)	SAME AS LINE BEING EXTENDED	SKIP-DASH	SAME AS LINE BEING EXTENDED	2' (600) LINE WITH 6' (1.8 m) SPACE
EDGE LINES	4 (100)	SOLID	YELLOW-LEFT WHITE-RIGHT	OUTLINE MOUNTABLE MEDIANS IN YELLOW: EDGE LINES ARE NOT USED NEXT TO BARRIER CURB
TURN LANE MARKINGS	6 (150) LINE; FULL SIZE LETTERS & SYMBOLS (8' (2.4m))	SOLID	WHITE	SEE TYPICAL TURN LANE MARKING DETAIL
TWO WAY LEFT TURN MARKING	2 @ 4 (100) EACH DIRECTION	SKIP-DASH AND SOLID	YELLOW	10' (3 m) LINE WITH 30' (9 m) SPACE FOR SKIP-DASH; 5½ (140) C-C BETWEEN SOLID LINE AND SKIP-DASH LINE
	8' (2.4m) LEFT ARROW	IN PAIRS	WHITE	SEE TYPICAL TWO-WAY LEFT TURN MARKING DETAIL
CROSSWALK LINES (PEDESTRIAN) A. DIAGONALS (BIKE & EQUESTRIAN) B. LONGITUDINAL BARS (SCHOOL)	2 @ 6 (150) 12 (300) @ 45° 12 (300) @ 90°	SOLID SOLID SOLID	WHITE WHITE WHITE	NOT LESS THAN 6' (1.8 m) APART 2' (600) APART 2' (600) APART 5EE TYPICAL CROSSWALK MARKING DETAILS.
STOP LINES	24 (600)	SOLID	WHITE	PLACE 4' (1.2 m) IN ADVANCE OF AND PARALLEL TO CROSSWALK, IF PRESENT. OTHERWISE, PLACE AT DESIRED STOPPING POINT. PARALLEL TO CROSSROAD CENTERLINE, WHERE POSSIBLE
PAINTED MEDIANS	2 @ 4 (100) WITH 12 (300) DIAGONALS	SOLID	YELLOW: TWO WAY TRAFFIC	11 (280) C-C FOR THE DOUBLE LINE
	© 45° NO DIAGONALS USED FOR 4' (1.2 m) WIDE MEDIANS		WHITE: ONE WAY TRAFFIC	SEE TYPICAL PAINTED MEDIAN MARKING.
GORE MARKING AND CHANNELIZING LINES	8 (200) WITH 12 (300) DIAGONALS @ 45°	SOLID	WHITE	DIAGONALS: 15' (4,5 m) C-C (LESS THAN 30MPH (50 km/h)) 20' (6 m) C-C 30MPH (50 km/h) TO 45MPH (70 km/h)) 30' (9 m) C-C (OVER 45MPH (70 km/h))
RAILROAD CROSSING	24 (600) TRANSVERSE LINES; "RR" IS 6' (1.8 ml LETTERS; 16 (400) LINE FOR "X"	SOLID	WHITE	SEE STATE STANDARD 780001 AREA OF: "R"=3.6 SO. FT. (0.33 m ²) EACH "X"=54.0 SO. FT. (5.0 m ²)
SHOULDER DIAGONALS	12 (300) & 45°	SOLID	WHITE - RIGHT YELLOW - LEFT	50' (15 m) C-C (LESS THAN 30MPH (50 km/h)) 75' (25 m) C-C (30 MPH (50 km/h) TO 45MPH (70 km/h)) 150' (45 m) C-C (OVER 45MPH (70 km/h))


FOR FURTHER DETAILS ON PAVEMENT MARKING REFER TO STANDARD SPECIFICATIONS FOR ROAD AND BRIDGE CONSTRUCTION AND STATE STANDARD 780001.


All dimensions are in inches (millimeters) unless otherwise shown.

FILE NAME =	USER NAME = drivakosgn	DESIGNED	-	EVERS	REVISED	-T. F	RAMMACHER	10-27-94
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	PLOT SCALE = 50.000 '/ IN.	CHECKED	**		REVISED	-		
	PLOT DATE = 9/9/2009	DATE	-	03-19-90	REVISED	-		

STATE	0F	ILLINOIS
DEPARTMENT (OF 1	TRANSPORTATION

	DIS	TRICT ONE		F.A. RTE	SECTION	COUNTY	TOTAL SHEETS	SHEET NO.	
	TYPICAL PAL	/EMENT MARKINGS		1587	3098-T	COOK	17	13	
7					TC-13		NO. 60	K75	
 SCALE: NONE	SHEET NO. 1 OF 1	SHEETS STA.	TO STA.	FED. RO	FED. ROAD DIST. NO. 1 ILLINOIS FED. AID PROJECT				

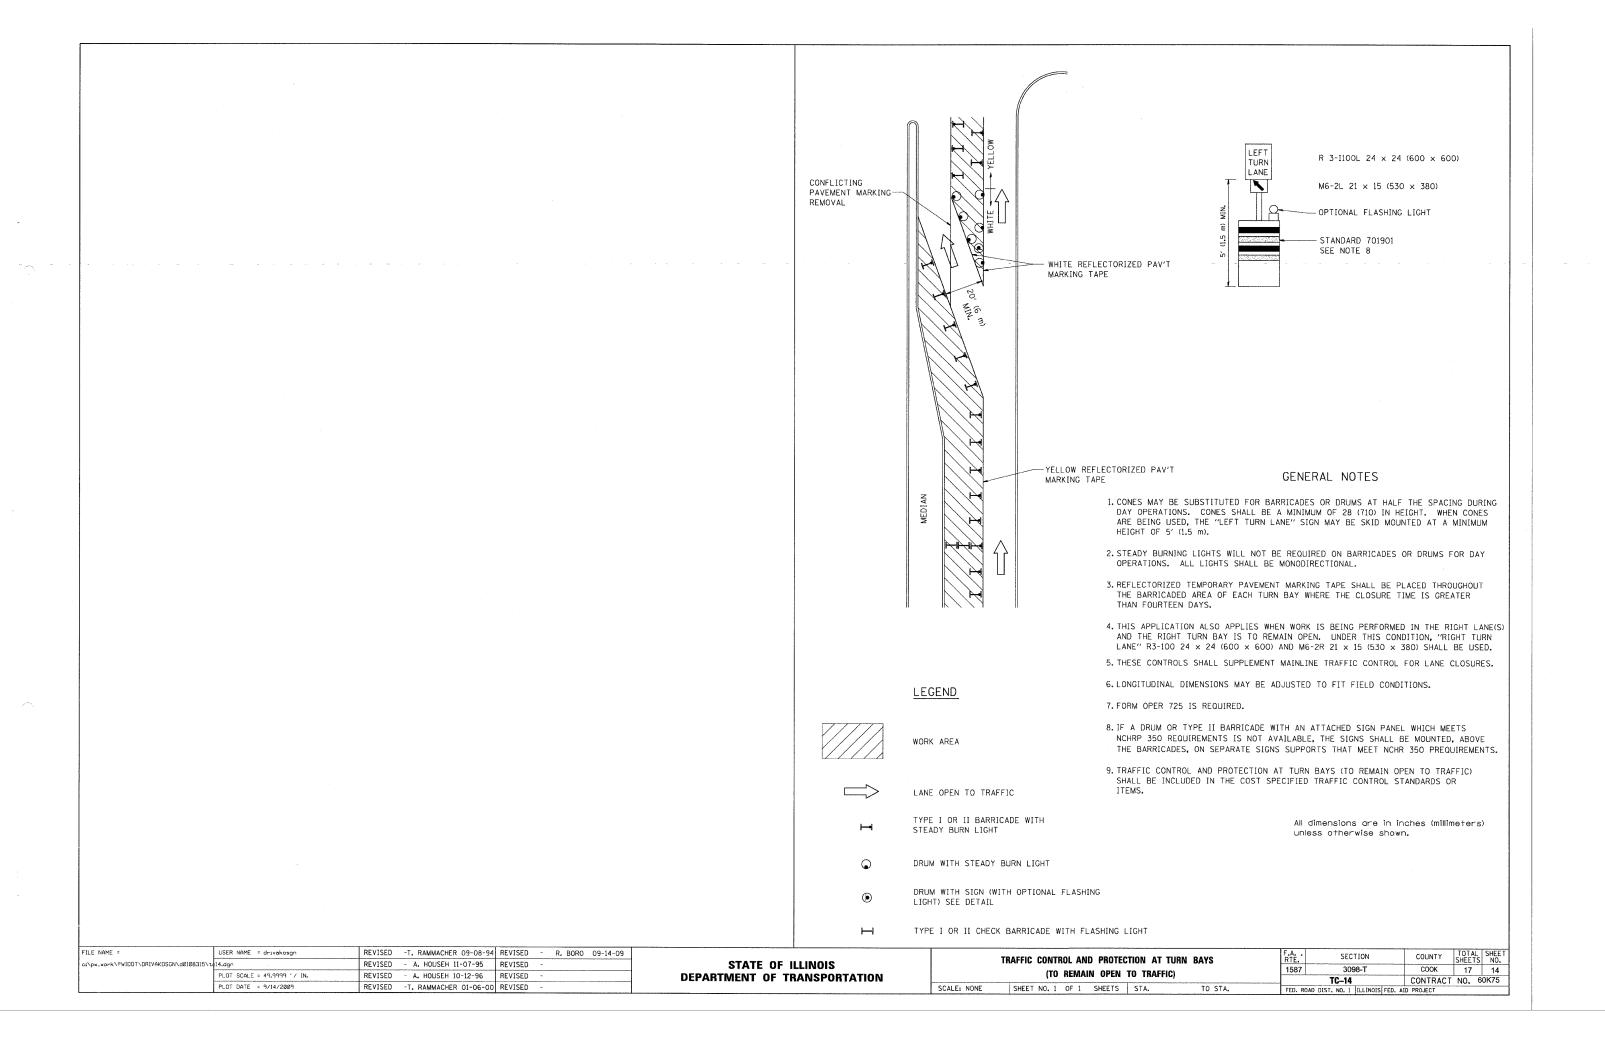

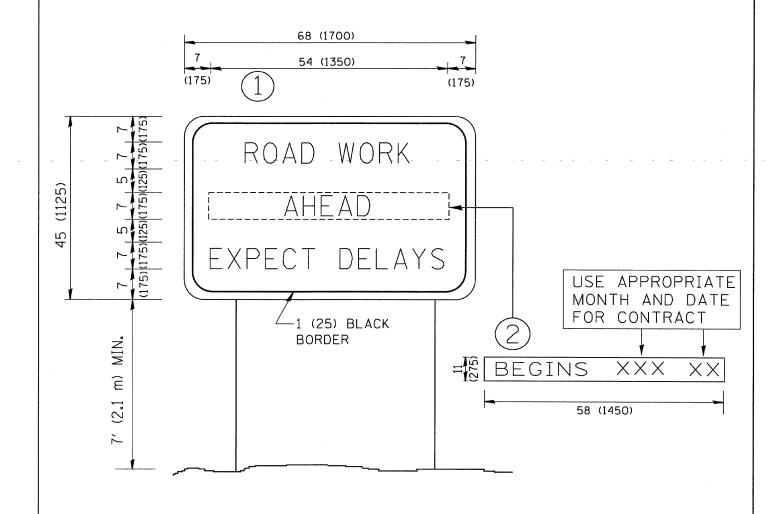

NOTES:

- 1. USE BLACK LETTERING ON ORANGE BACKGROUND.
- 2. ERECT SIGNS IN ADVANCE OF THE LOCATION FOR THE "ROAD CONSTRUCTION AHEAD" SIGN AT LOCATIONS AS DIRECTED BY THE ENGINEER.
- 3. ERECT SIGN (1) WITH INSTALLED PANEL (2) ONE WEEK PRIOR TO THE START OF CONSTRUCTION.
- 4. REMOVE PANEL 2 SOON AFTER THE START OF CONSTRUCTION.
- 5. SEE SPECIAL PROVISION FOR "TEMPORARY INFORMATION SIGNING" FOR ADDITIONAL INFORMATION.
- 6. ONE SIGN ASSEMBLY EQUALS 25.70 SQ. FT. (2.3 SQ. M.)
- 7. SHALL BE PAID FOR AS TEMPORARY INFORMATION SIGNING.

ALL DIMENSIONS ARE IN INCHES (MILLIMETERS) UNLESS OTHERWISE SHOWN.

FILE NAME =	USER NAME = gaglianobt	DESIGNED -	REVISED - R. MIRS 09-15-97		APTERIAL BANK	F.A SECTION	COUNTY TOTAL SHEET
Ws\diststd\22x34\to22.dgn		DRAWN -	REVISED - R. MIRS 12-11-97	STATE OF ILLINOIS	ARTERIAL ROAD	1587 3098-T	COOK 17 15
	PLOT SCALE = 50.000 '/ IN.	CHECKED -	REVISED -T. RAMMACHER 02-02-99	DEPARTMENT OF TRANSPORTATION	INFORMATION SIGN	TC-22	CONTRACT NO. 60K75
	PLOT DATE = 1/4/2008	DATE -	REVISED - C. JUCIUS 01-31-07		SCALE: NONE SHEET NO. 1 OF 1 SHEETS STA. TO STA.		AID PROJECT

