FOR INDEX OF SHEETS, SEE SHEET NO. 2

IMPROVEMENT LOCATED IN THE VILLAGE OF GLENCOE **VILLAGE OF WHEELING** CITY OF PARK RIDGE **VILLAGE OF SUGAR GROVE**

CONFORM TO STANDARD SCALES. IN MAKING MEASUREMENTS

JOINT UTILITY LOCATING INFORMATION FOR EXCAVATORS 1-800-892-0123 OR 811

CONTRACT NO. 60J08


STATE OF ILLINOIS


DEPARTMENT OF TRANSPORTATION

DIVISION OF HIGHWAYS

PROPOSED HIGHWAY PLANS

VARIOUS ROUTES SECTION 2009–108 I VARIOUS LOCATIONS SCOUR COUNTERMEASURES COOK AND KANE COUNTIES C-91-179-10

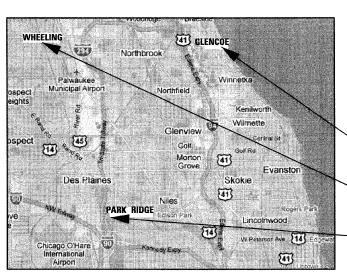

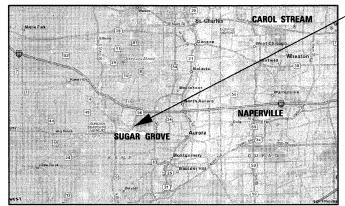

LOCATION 2: S.N. 016-0618, SHERIDAN ROAD OVER RAVINE NO. 2

LOCATION 1: S.N. 016-0556, MCHENRY ROAD **OVER WHEELING DRAINAGE DITCH**

LOCATION 3: S.N. 016-0829, TOUHY AVENUE **OVER DES PLAINES RIVER**


LOCATION 4: S.N. 045-0026 (E.B.); 045-0027 (W.B.) IL 56 OVER BLACKBERRY CREEK



* 23-1 = 22

D-91-179-10



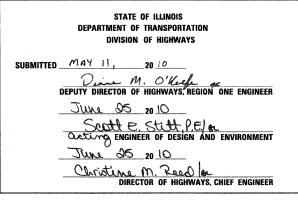



Birinder S. Sachde BIRINDER S. SACHDEVA, P.E. EXPIRES: 11-30-2011

DRAWING NO. 1-10, 12-16 & 19-23

DATE

5-10-10

CHRISTIAN-ROGE & ASSOCIATES, INC. ENGINEERS - PLANNERS - SURVEYORS 211 W. WACKER DRIVE CHICAGO, IL. 0 0

PRINTED BY THE AUTHORITY OF THE STATE OF ILLINOIS

FULL SIZE PLANS HAVE BEEN PREPARED USING STANDARD ENGINEERING SCALES. REDUCED SIZED PLANS WILL NOT ON REDUCED PLANS, THE ABOVE SCALES MAY BE USED.

ENGINEER:

 \circ

 \circ

INDEX OF SHEETS

1	COVER SHEET
2	INDEX OF SHEETS, LIST OF STATE STANDARDS AND GENERAL NOTES SCOUR COUNTERMEASURES - VARIOUS LOCATIONS
3	SUMMARY OF QUANTITIES SCOUR COUNTERMEASURES - VARIOUS LOCATIONS
4	LOCATION MAPS
5 - 6	SCOUR COUNTERMEASURES - MCHENRY ROAD OVER WHEELING DRAINAGE DITCH
7 - 8	SCOUR COUNTERMEASURES - SHERIDAN ROAD OVER RAVINE NO. 2
9 - 10	SCOUR COUNTERMEASURES - TOUHY AVENUE OVER DES PLAINES RIVER
11	SCOUR COUNTERMEASURES - IL 56 OVER BLACKBERRY CREEK
12 - 18	CROSS SECTIONS SCOUR COUNTERMEASURES - VARIOUS LOCATIONS
19	ARTERIAL ROAD INFORMATION SIGN
20	TRAFFIC CONTROL & PROTECTION FOR SIDEROADS, INTERSECTIONS AND DRIVEWAYS
21 - 23	DEWATERING SYSTEM DETAILS SCOUR COUNTERMEASURES - VARIOUS LOCATIONS

LIST OF STATE STANDARDS

STANDARD NO.	DESCRIPTION
701426 - 03	LANE CLOSURE, MULTILANE INTERMITTENT OR MOVING OPERATIONS ONLY, FOR SPEEDS > 45 MPH
701501 - 05	URBAN LANE CLOSURE, 2L, 2W, UNDIVIDED
701601 - 06	URBAN LANE CLOSURE, MULTILANE, 1W OR 2W WITH NONTRAVERSABLE MEDIAN
701606- <i>06</i>	URBAN LANE CLOSURE, MULTILANE, 2W WITH MOUNTABLE MEDIAN
701901 - <i>01</i>	TRAFFIC CONTROL DEVICES
NOTE: \	NIGHT TIME CLOSURES WILL NOT BE REQUIRED FOR THIS PROJECT.

GENERAL NOTES

- 1. BEFORE STARTING ANY EXCAVATION, THE CONTRACTOR SHALL CALL "J.U.L.I.E." (JOINT UTILITY LOCATING INFORMATION

 FOR EXCAVATORS) AT (800) 892-0123 OR 811 FOR FIELD LOCATIONS OF BURIED ELECTRIC, TELEPHONE & GAS

 FACILITIES. (48 HOURS NOTIFICATION IS REQUIRED.)
- 2. THE CONTRACTOR WILL NOT BE ALLOWED TO SET UP A YARD OF FIELD OFFICE ON STATE PROPERTY WITHOUT WRITTEN PERMISSION FROM THE DEPARTMENT.
- 3. EXCAVATION INTO THE STREAM BED FOR STONE RIPRAP INSTALLATION SHALL NOT BE DEEPER THAN THE BOTTOM OF THE FOOTING ON THE PIER OR ABUTMENT TO BE PROTECTED.
- 4. DEBRIS REMOVAL, IF ENCOUNTERED, SHALL BE INCLUDED IN THE COST OF THE STONE RIPRAP.
- 5. IT SHALL BE THE CONTRACTOR'S RESPONSIBILITY TO VERIFY ALL DIMENSIONS & CONDITIONS EXISTING IN THE FIELD PRIOR TO CONSTRUCTION ORDERING OF MATERIAL.
- 6. THE CONTRACTOR SHALL CONTACT THE DISTRICT ONE ARTERIAL TRAFFIC CONTROL SUPERVISOR AT (847) 705-4470

 A MINIMUM OF 72 HOURS IN ADVANCE OF BEGINNING WORK.
- 7. ALL AREAS (INCLUDING WETLAND AREAS) OUTSIDE THE LIMITS OF RIPRAP PLACEMENT AND/OR EXCAVATION WHICH ARE DISTURBED (WHERE EXISTING SOIL CONTOURS HAVE BEEN ALTERED AND/OR EXISTING VEGETATION HAD BEEN DESTROYED BY THE CONTRACTOR'S OPERATIONS) SHALL BE RESTORED BY REGRADING TO THE ORIGINAL CONTOURS AND/OR SEEDING WITH SEEDING, CLASSES 4 AND 5, AND MULCHING WITH EROSION CONTROL BLANKET. PLACE TEMPORARY SEEDING AND TEMPORARY EROSIONS CONTROL BLANKET AS NEEDED. THIS WORK WILL NOT BE PAID FOR SEPARATELY, BUT THE COSTS SHALL BE CONSIDERED INCLUDED IN THE CONTRACT UNIT PRICES FOR THE CONSTRUCTION ITEMS INVOLVED, AND NO ADDITIONAL COMPENSATION WILL BE ALLOWED.
- 8. THE CONTRACTOR IS ADVISED TO AVOID OR MINIMIZE ANY DISTURBANCE TO EXISTING VEGETATION OUTSIDE THE LIMITS OF RIPRAP PLACEMENT AND CHANNEL EXCAVATION.
- 9. THE CONTRACTOR MUST PROTECT PAVEMENT WHEN DUMPING RIPRAP ONTO PAVEMENT AND WILL BE RESPONSIBLE FOR RESTORING PAVEMENT MARKINGS AND REFLECTORS.
- 10. ANY GUARDRAIL OR SIGNS DAMAGED BY THE CONTRACTOR'S OPERATIONS SHALL BE REPLACED IN KIND AT THE CONTRACTOR'S EXPENSE.
- 11. THE CONTRACTOR SHALL BE REQUIRED TO PROVIDE ACCESS TO ABUTTING PROPERTY AT ALL TIMES DURING THE CONSTRUCTION OF THIS PROJECT.
- 12. DO NOT SCALE PLANS FOR CONSTRUCTION DIMENSIONS.
- 13. THE CONTRACTOR SHALL SUBMIT DEWATERING AND SEDIMENT CONTROL PLANS FOR EACH SITE.
- 14. THE CONTRACTOR SHALL CONTACT THE ENGINEER AFTER DEWATERING FOR FINAL RIPRAP OR SLOPE MATTRESS PLACEMENT.

FILE NAME = D160J08-sht-gennote.dgn PLOT DATE = 5/10/2010

CHRISTIAN-ROGE & ASSOCIATES, INC.

ENGINEERS-PLANNERS-SURVEYORS
211 WEST WACKER DRIVE
CHICAGO, ILLINOIS 60606
PHONE: (312)372-2023 FAX: (312)372-3274

DATE

APRIL

STATE OF ILLINOIS
DEPARTMENT OF TRANSPORTATION

INDEX		-					AND GENERAL LOCATIONS	NOTES	F
SCALE: NON	IE SI	EET NO.	1 ()F 1	SHEETS	STA.	TO STA.		F

	AND DICT. NO. 1. THE THORE FED.	CONTRACT	NO. 6	0108
VAR.	2009-108 I	COOK/KANE	23	2
A.P. RTE.	SECTION	COUNTY	TOTAL SHEETS	SHEE NO.

	SUMMARY OF QUANTITIES		URBAN		SFT	Y-2A		7	
CODE NO	ITEM	UNIT	TOTAL QUANTITIES	LOCATION 1 MCHENRY	LOCATION 2 SHERIDAN	LOCATION 3 TOUHY COOK COUNTY	LOCATION 4 IL 56 KANE COUNTY		
20300100	CHANNEL EXCAVATION	CU YD	520				520		
28100107	STONE RIPRAP, CLASS A4	SQ YD	1,530			840	690		
28100109	STONE RIPRAP, CLASS A5	SQ YD	505	112	393				
28200200	FILTER FABRIC	SQ YD	288	·			288		
28400100	GABIONS	CU YD	30	·			30		
28401000	SLOPE MATTRESS, 12"	SQ YD	258			15	258	>	
67000400	ENGINEER'S FIELD OFFICE, TYPE A	CAL MO	4	1	1	1	1		
67100100	MOBILIZATION	L SUM	1	0.25	0.25	0.25	0.25		
70102620	TRAFFIC CONTROL AND PROTECTION, STANDARD 701501	L SUM	1		1				
70102625	TRAFFIC CONTROL AND PROTECTION, STANDARD 701606	L SUM	1	0.33		0.34	0.33		
X0301852	DEWATERING STRUCTURE NO. 1	EACH	1	1					
X0301853	DEWATERING STRUCTURE NO. 2	EACH	1		1				
X0301854	DEWATERING STRUCTURE NO. 3	EACH	1			- 1		» ·	
X0301855	DEWATERING STRUCTURE NO. 4	EACH	1				1		
Z0030850	TEMPORARY INFORMATION SIGNING	SQ FT	205.6	51.4	51.4	51.4	51.4		
			·						
								а	
,									

FILE NAME = D160J08-sht-SOQ.dgn PLOT DATE = 5/10/2010


CHRISTIAN-ROGE & ASSOCIATES, INC. ENGINEERS-PLANNERS-SURVEYORS 211 WEST WACKER DRIVE CHICAGO, ILLINOIS 60506	
PHONE: (312)372–2023 FAX: (312)372–5274	L


C.	DESIGNED	-	K.R.K.	REVISED -	
	DRAWN	-	J.V.	REVISED -	
	CHECKED	-	G.F.L	REVISED -	
274	DATE	-	MARCH, 2010	REVISED -	

STATE	OF	ILLINOIS
DEPARTMENT	0F	TRANSPORTATION

	SCO	JR CO	-					ANTITIES VARIOUS	LOCATIONS
SCALE:	NONE	SHEET	NO.	1	0F	1	SHEETS	STA.	TO STA.

F.A.P. RTE.	Γ		S	EC	TIC	N	Т	COUNTY	TOTAL	SHEET NO.	
VAR.	2009-108 I								COOK/KANE	23	3
								Т	CONTRACT	NO. 6	800
EED D	OAD	DICT	NO	•	TI I	TMOTO	EEO	ATO	DDA IECT		

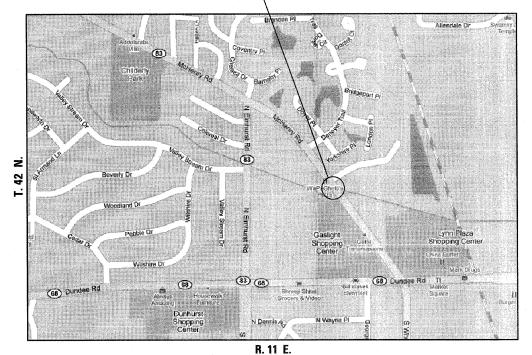

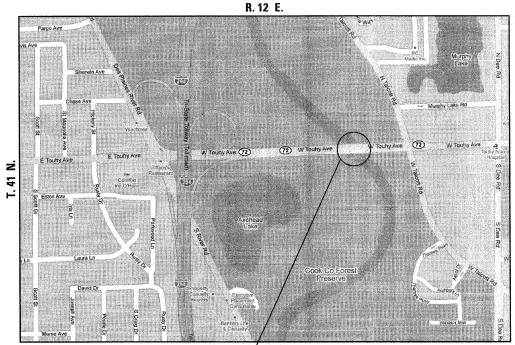


TRAFFIC DATA SPEED LIMIT = 40 MPH 2007 ADT = 26,600


LOCATION 3 – COOK COUNTY STRUCTURE NUMBER: 016–0829 TOUHY AVENUE OVER DES PLAINES RIVER LOCATED IN MAINE TOWNSHIP, CITY OF PARK RIDGE

TRAFFIC DATA SPEED LIMIT = 30 MPH 2007 ADT = 3,500

LOCATION 2 - COOK COUNTY STRUCTURE NUMBER: 016-0618 SHERIDAN ROAD OVER RAVINE NO. 2 LOCATED IN NEW TRIER TOWNSHIP, VILLAGE OF GLENCOE

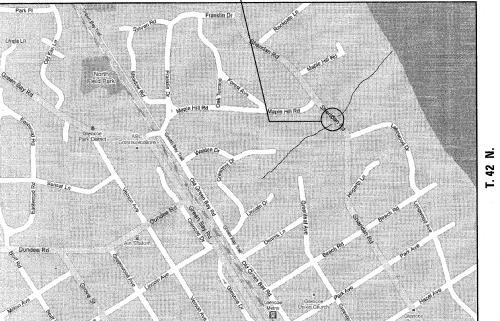

R. 13 E. R. 7 E.

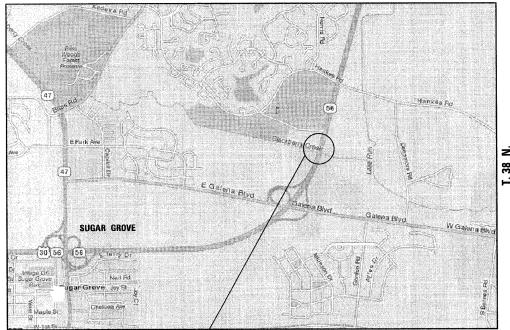

TRAFFIC DATA SPEED LIMIT = 55 MPH 2007 ADT = 19,800

LOCATION 4 - KANE COUNTY STRUCTURE NUMBER: 045-0026 (E.B.); 045-0027 (W.B.) IL 56 OVER BLACKBERRY CREEK LOCATED IN SUGAR GROVE TOWNSHIP, VILLAGE OF SUGAR GROVE

FILE NAME = D160J08-sht-location


REVISED - J.V./K.R.K. REVISED REVISED CHECKED - E.J.M. APRIL 28, 2010 REVISED

DEPARTMENT OF TRANSPORTATION

COUNTY TOTAL SHEETS NO.
COOK/KANE 23 4 SECTION LOCATION MAPS 2009-108 I VAR. SCOUR COUNTERMEASURES - VARIOUS LOCATIONS CONTRACT NO. 60J08 SCALE: NONE SHEET NO. 1 OF 1 SHEETS STA. FED. ROAD DIST. NO. 1 | ILLINOIS FED. AID PROJECT

PLOT DATE = 5/6/2010

STATE OF ILLINOIS

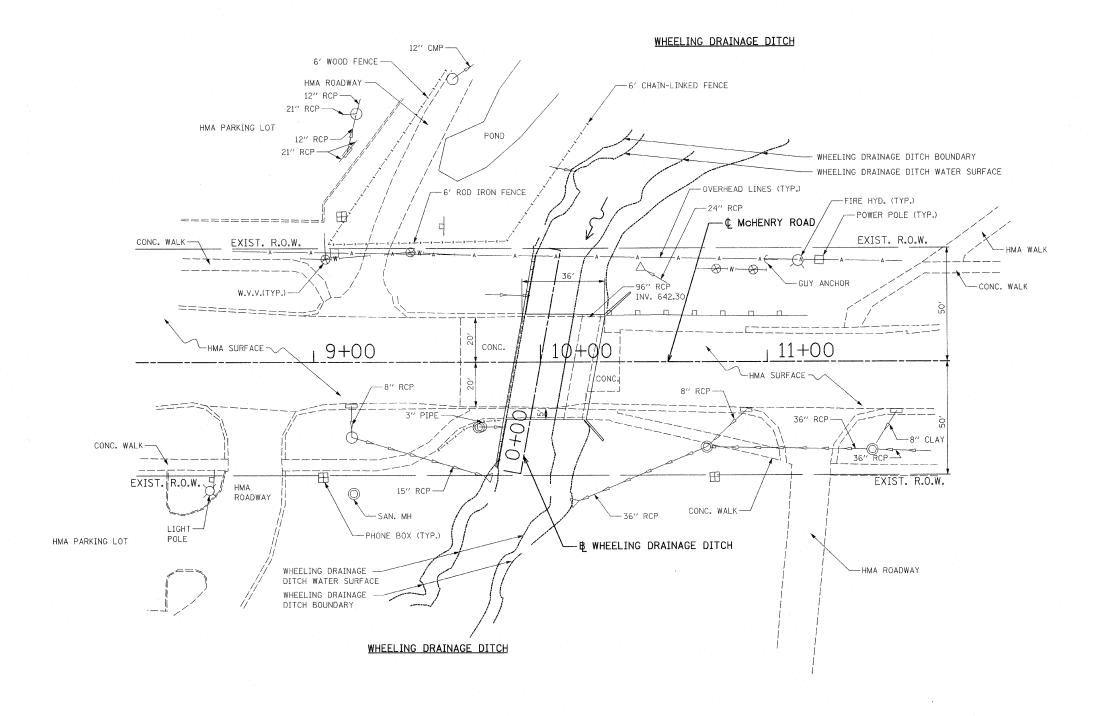

FILE NAME = D160J08-6-siteplan.dgn PLOT DATE = 5/6/2010


CHRISTIAN-ROGE & ASSOCIATES, INC.
ENGINEERS-PLANNERS-SURVEYORS
211 WEST WACKER DRIVE
CHICAGO, ILLIIOIS 60606
PHONE: (312)372-2023 FAX: (312)372-5274

NC.	DESIGNED	-	G.F.L.	REVISED -	
S	DRAWN	-	J.V./K.R.K.	REVISED -	
	CHECKED	-	E.J.M.	REVISED -	
5274	DATE	-	APRIL 28, 2010	REVISED -	

STATE	OF	ILLINOIS
DEPARTMENT ()F	TRANSPORTATION

SITE PLAN		F.A.P. RTE.	SECTION	COUNTY	TOTAL	
MCHENRY ROAD OVER WHEELI	C DRAINAGE DITCH	VAR.	2009-108 I	COOK/KANE	23	5
WICHERITI HOAD OVER WHELEH	d DIMINAGE DITOII			CONTRACT	NO. 6	80L08
SCALE: 1" = 20' SHEET NO. 1 OF 2 SHEETS	STA. 8+00 TO STA. 12+00	FED. R	OAD DIST. NO. 1 ILLINOIS FED. A	D PROJECT		



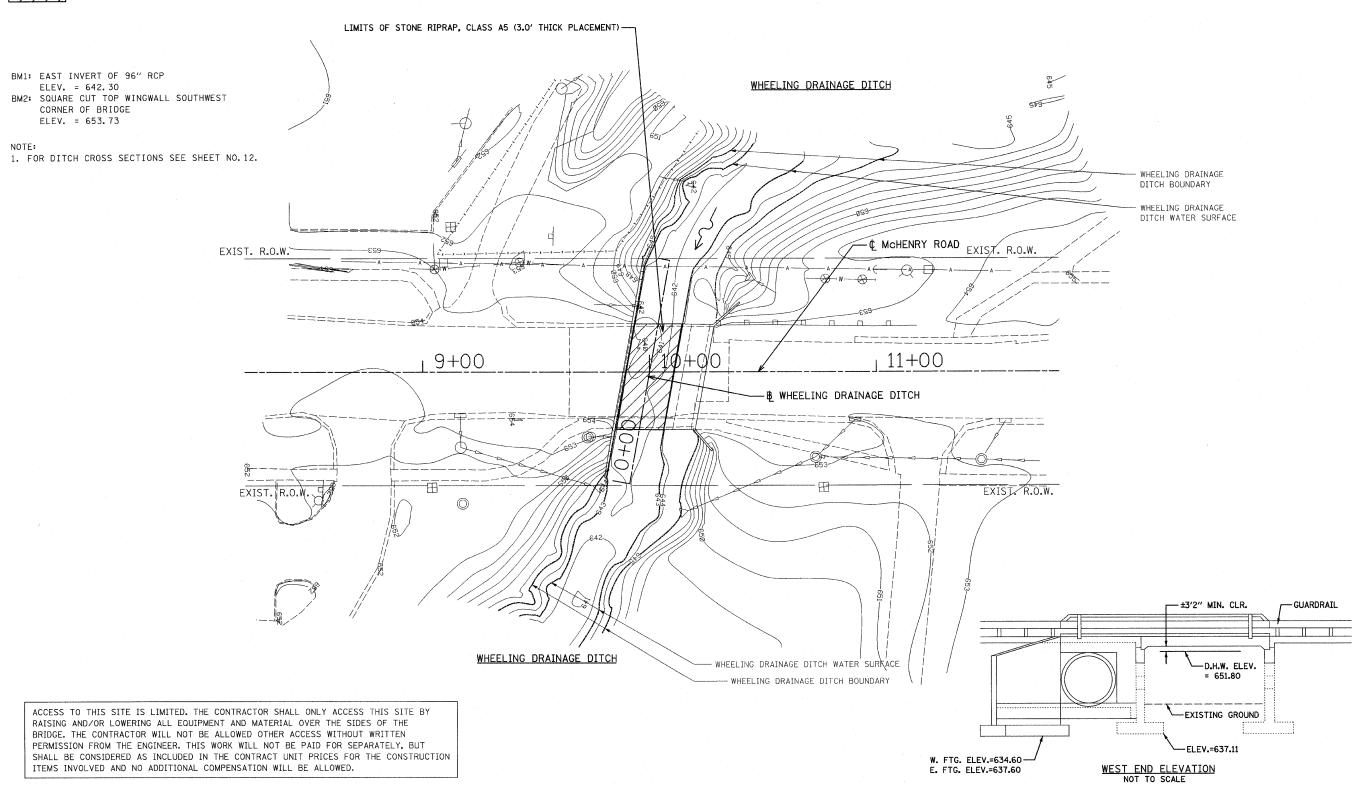


FILE NAME = D160J08-6-sht-eros.dgn PLOT DATE = 5/6/2010

CHRISTIAN-ROGE & ASSOCIATES, INC.	ı
ENGINEERS-PLANNERS-SURVEYORS 211 WEST WACKER DRIVE	-
CHICAGO, ILLINOIS 60606	-
PHONE: (312)372-2023 FAX: (312)372-5274	

C.	DESIGNED	-	G.F.L.	REVISED -
	DRAWN		J.V./K.R.K.	REVISED -
	CHECKED	-	E.J.M.	REVISED -
274	DATE	-	APRIL 28, 2010	REVISED -

STATE OF ILLINOIS DEPARTMENT OF TRANSPORTATION

EROSION AND SEDIMENT CONTROL PLAN	F.A.P. RTE.	SECTION	COUNTY	TOTAL	SHEET NO.
McHENRY ROAD OVER WHEELING DRAINAGE DITCH	VAR.	2009-108 I	COOK/KANE	23	6
MICHEMIT HOAD OVER WHELEING DIRMAGE BITON		-	CONTRACT	NO. 6	0J08
SCALE: 1" = 20' SHEET NO. 2 OF 2 SHEETS STA. 8+00 TO STA. 12+00	FED. R	OAD DIST. NO. 1 ILLINOIS FED. A	ID PROJECT		

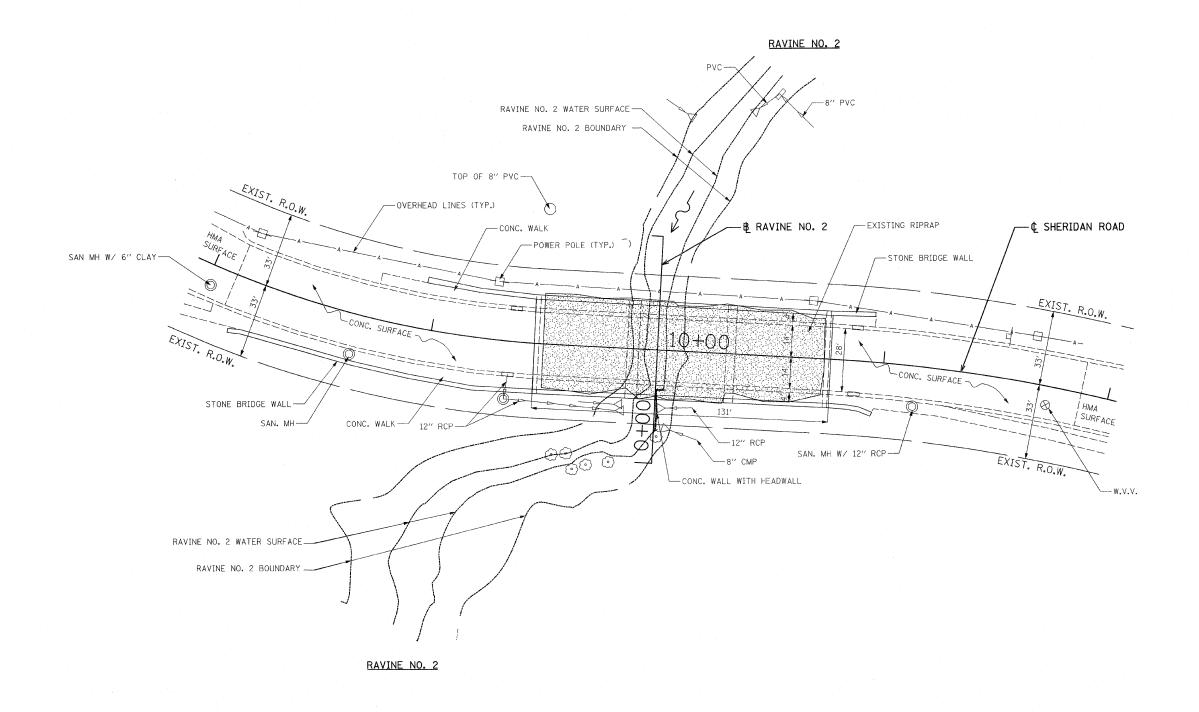



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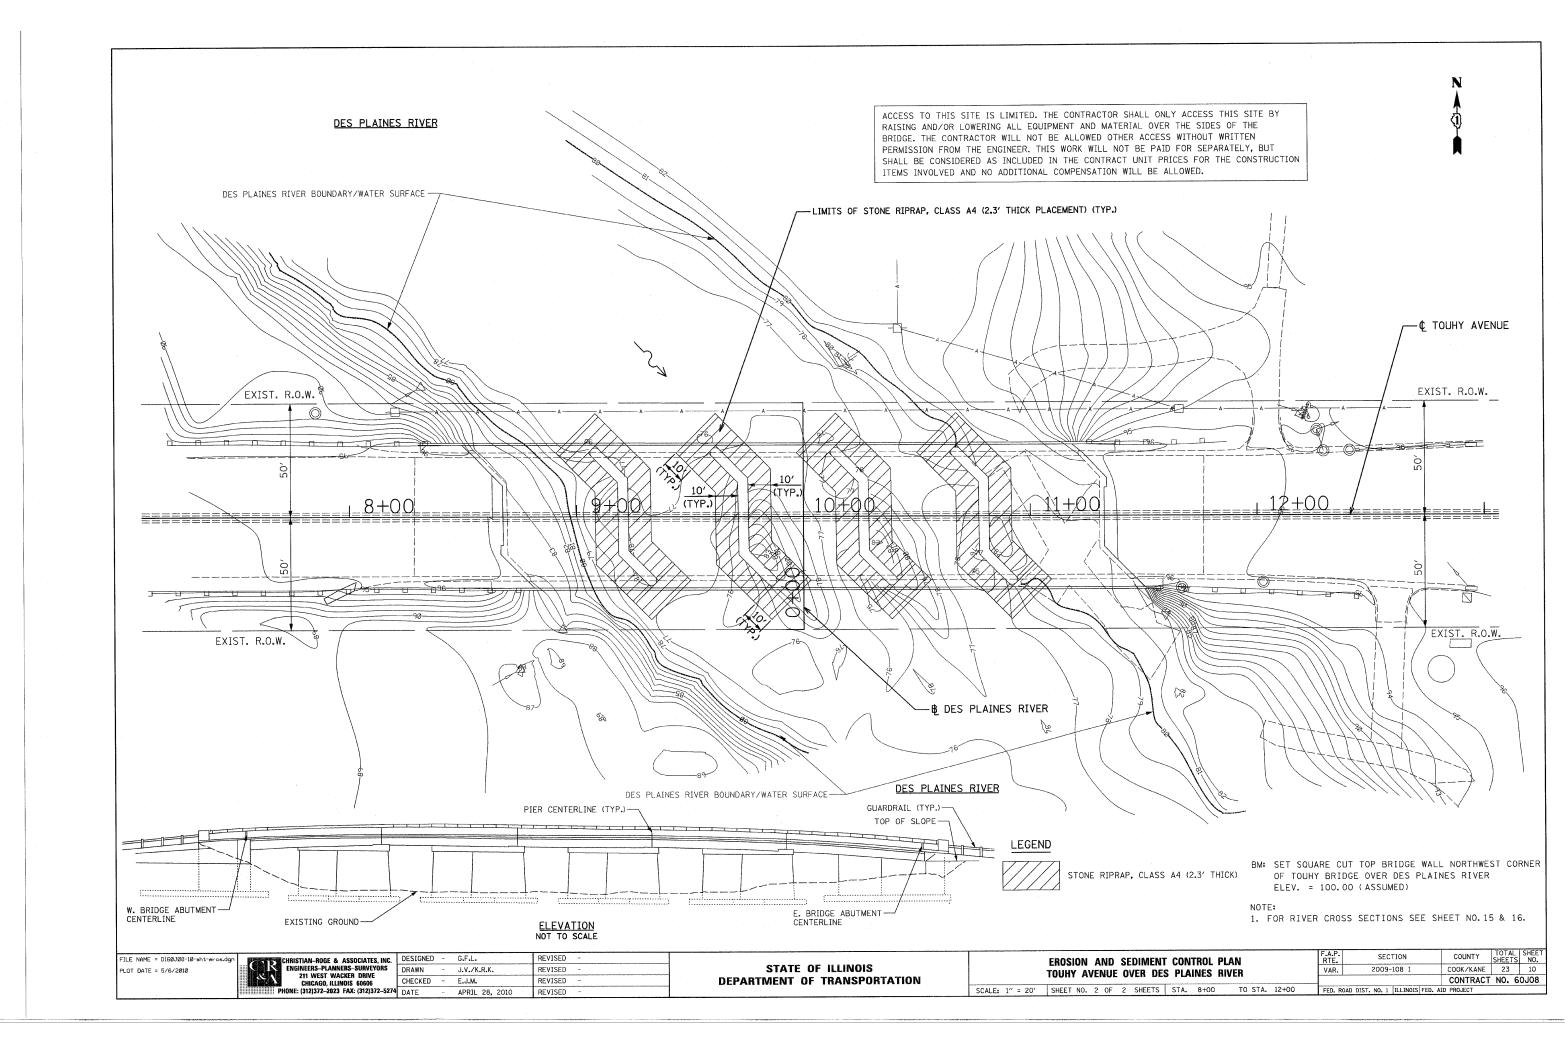
CHRISTIAN-BOGE & ASSOCIATES, INC.
ENGINEERS-PLANNERS-SURVEYORS
211 WEST WACKER DRIVE
CHICAGO, ILLINOIS 60606
CHECKE
PHONE: (312)372-2023 FAX: (312)372-5274
DATE


STATE OF ILLINOIS
DEPARTMENT OF TRANSPORTATION


1	SITE PLA	V	F.A.P. RTE.	SECTION	COUNTY	TOTAL	SHEET NO.
	SHERIDAN ROAD OVER	· -	VAR.	2009-108 I	COOK/KANE	23	7
i	SHEMDAN HOAD OVE	HAVINE NO. 2			CONTRACT	NO. 6	80L0
	SCALE: 1" = 20' SHEET NO. 1 OF 2 SHEETS	STA. 8+00 TO STA. 12+00	FED. RO	AD DIST. NO. 1 ILLINOIS FED. AL	D PROJECT		




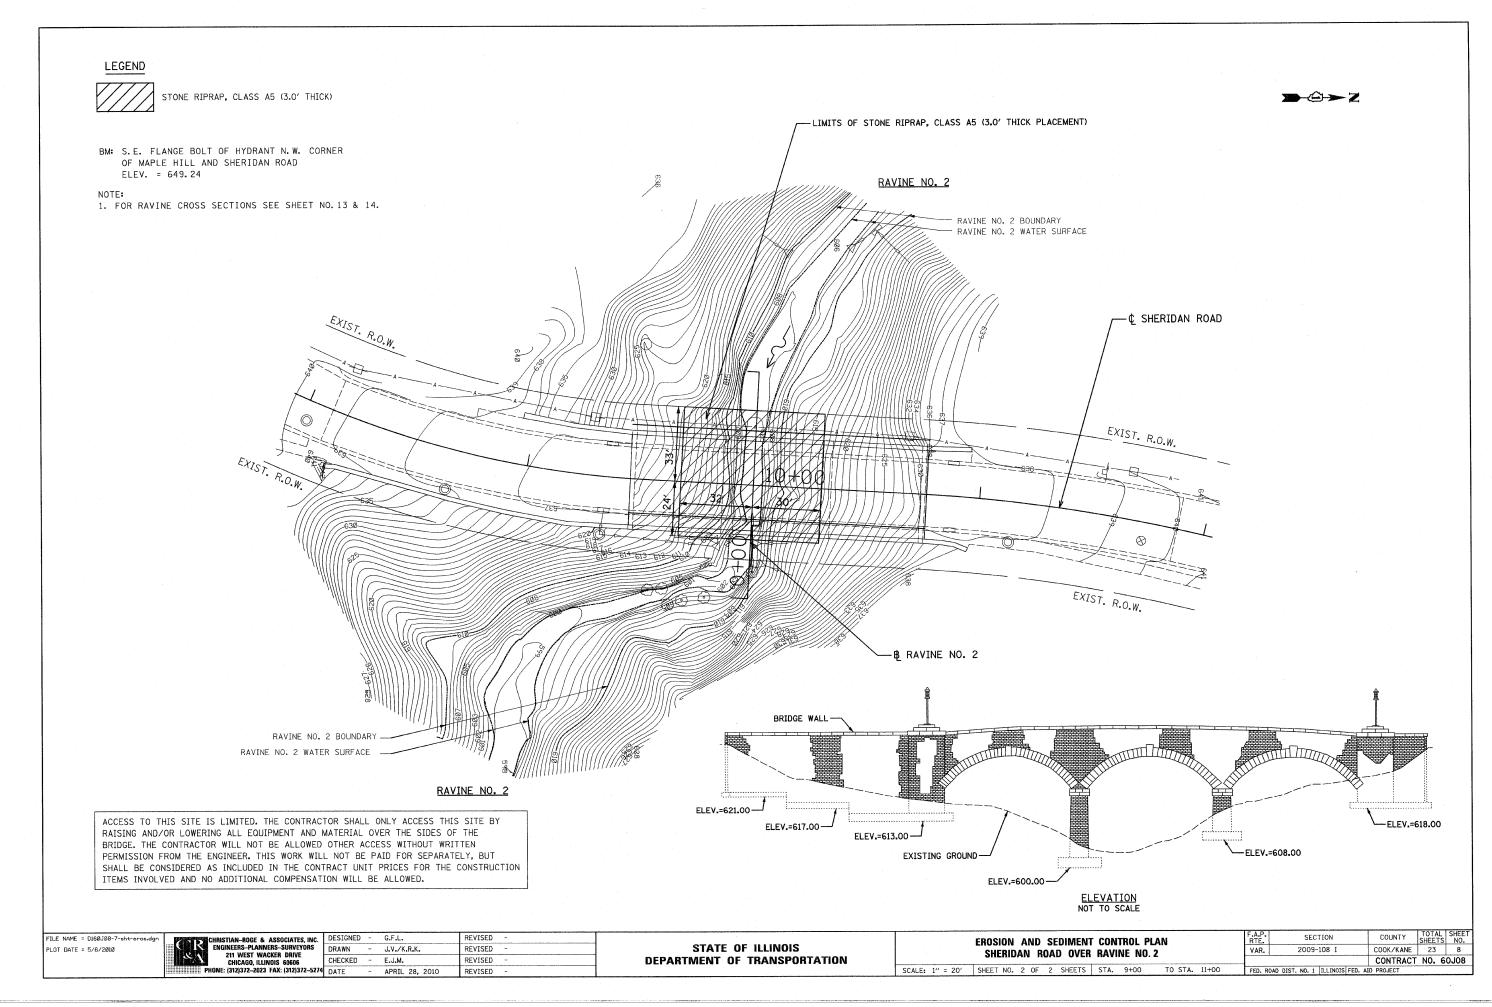


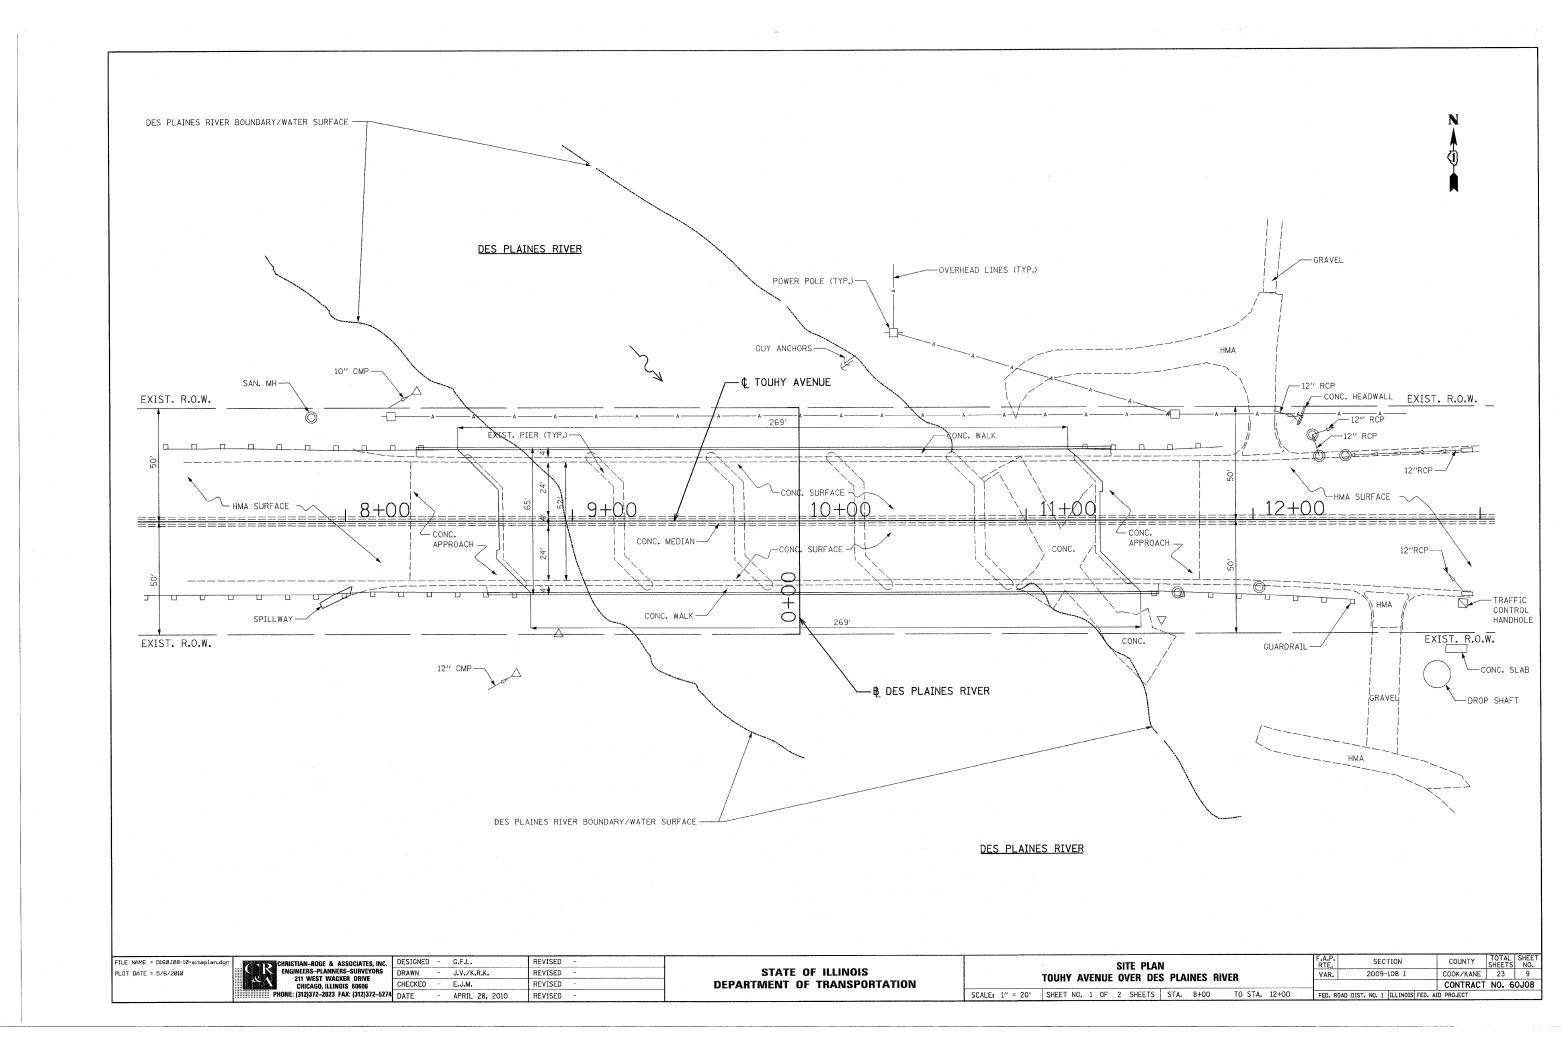


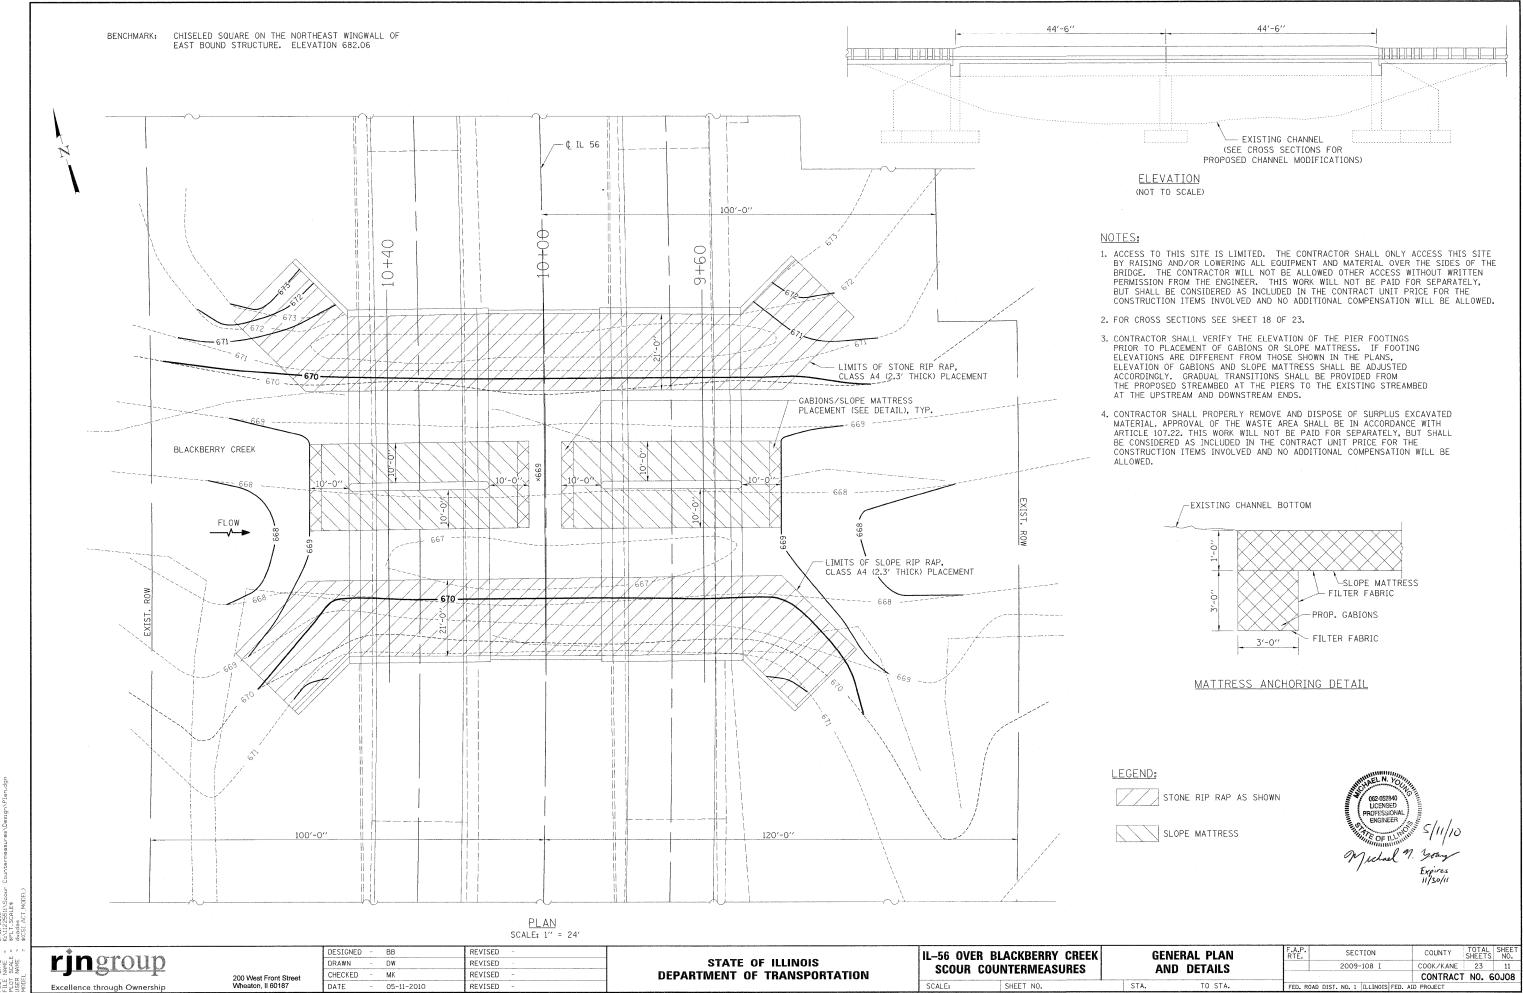


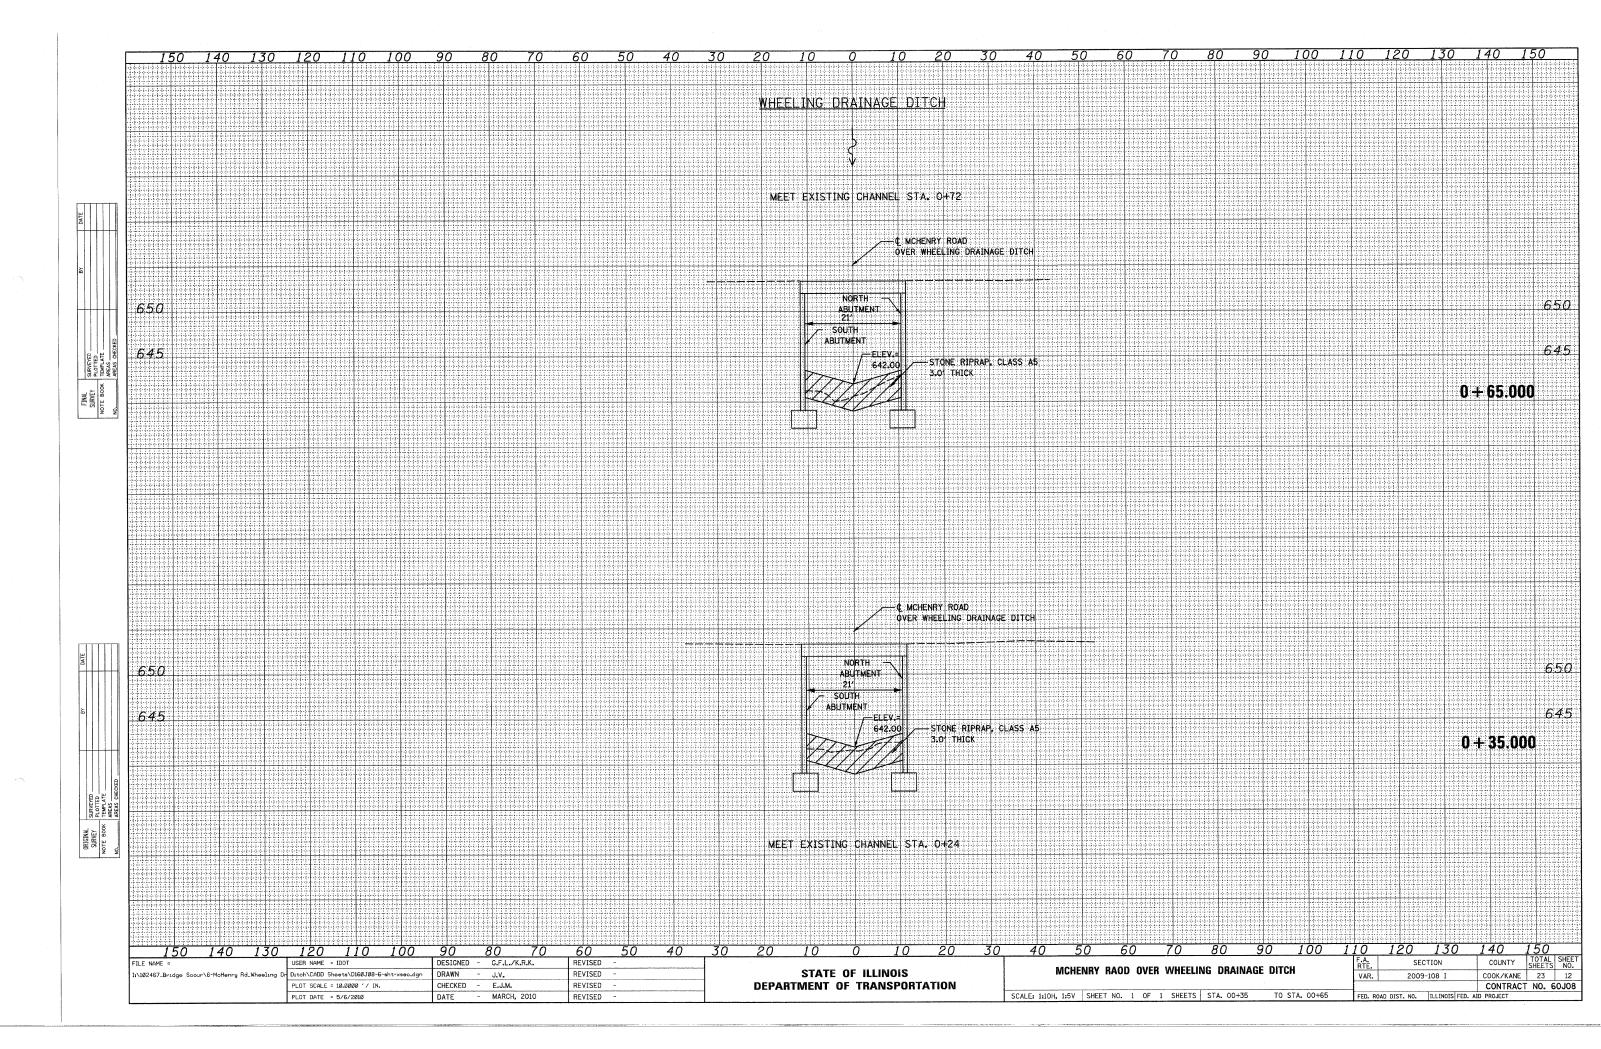


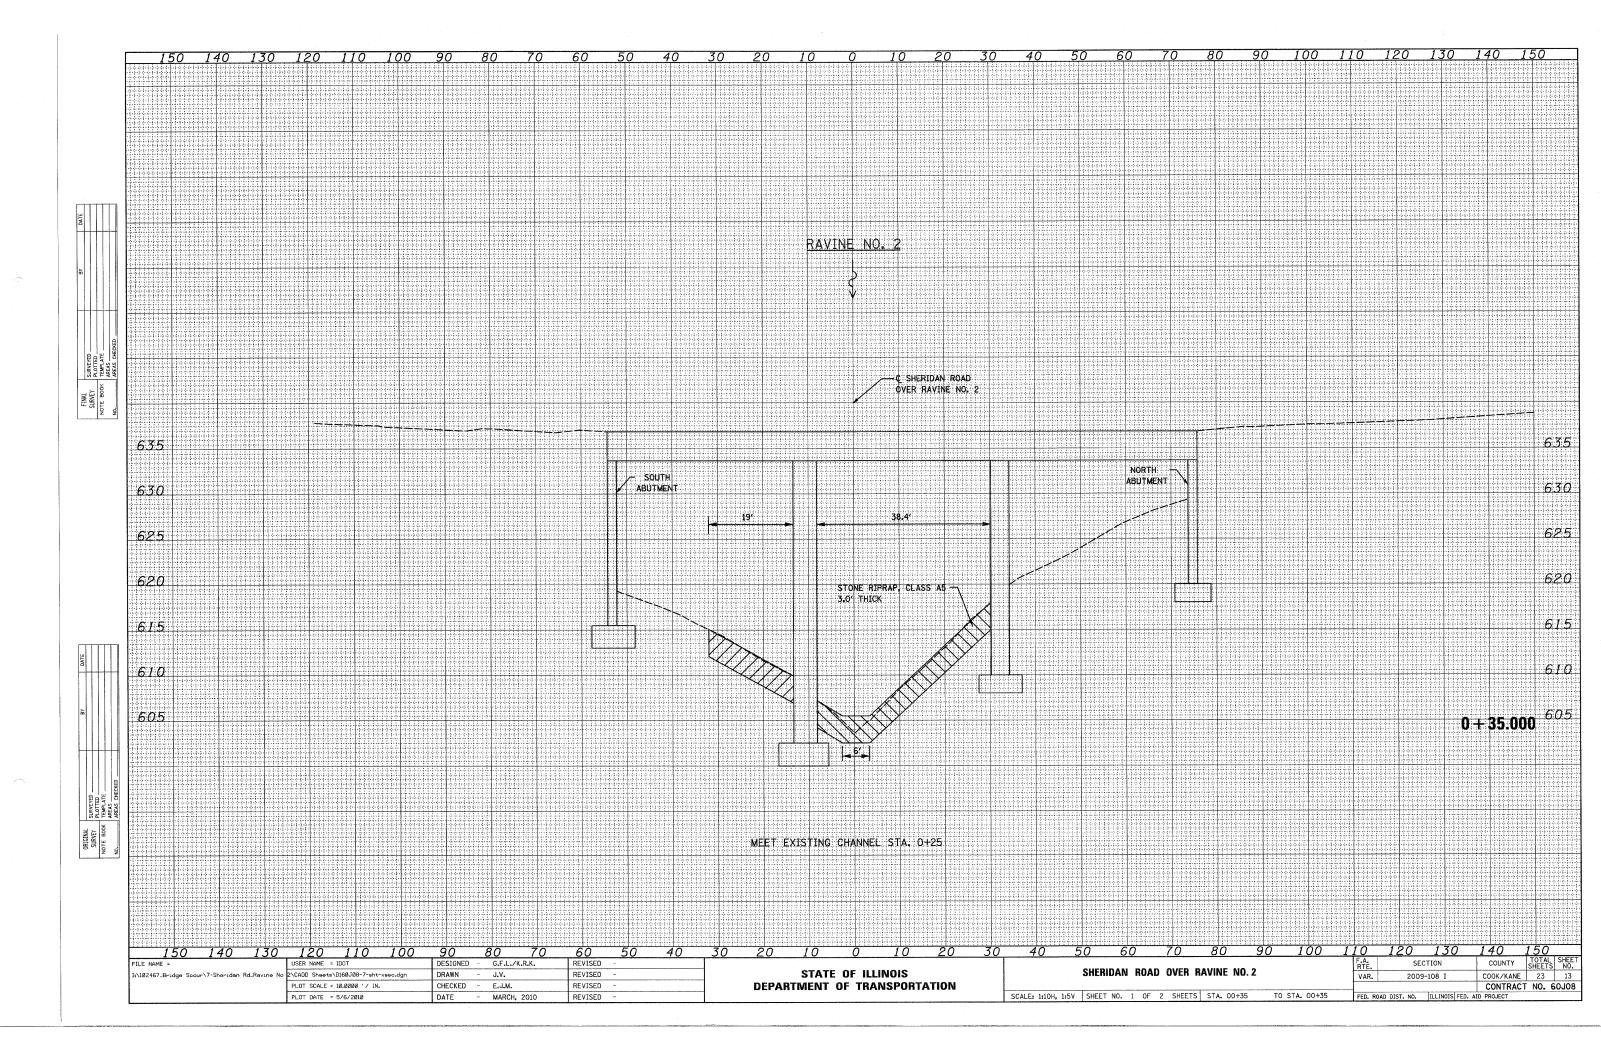


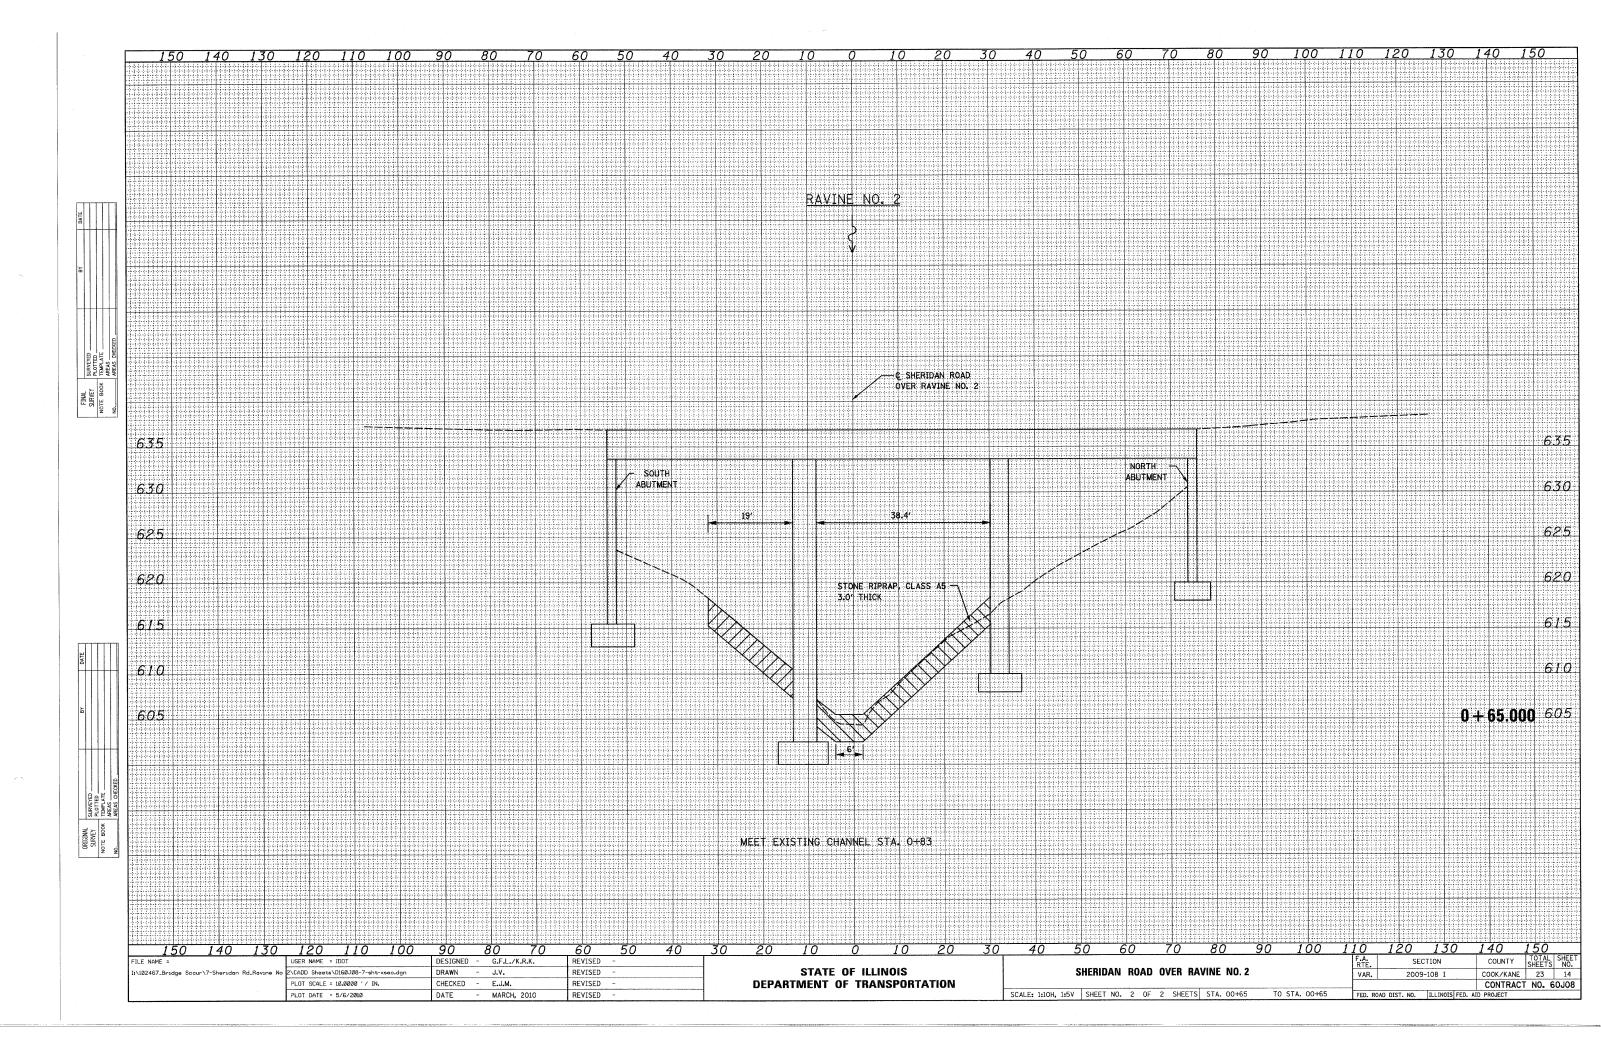

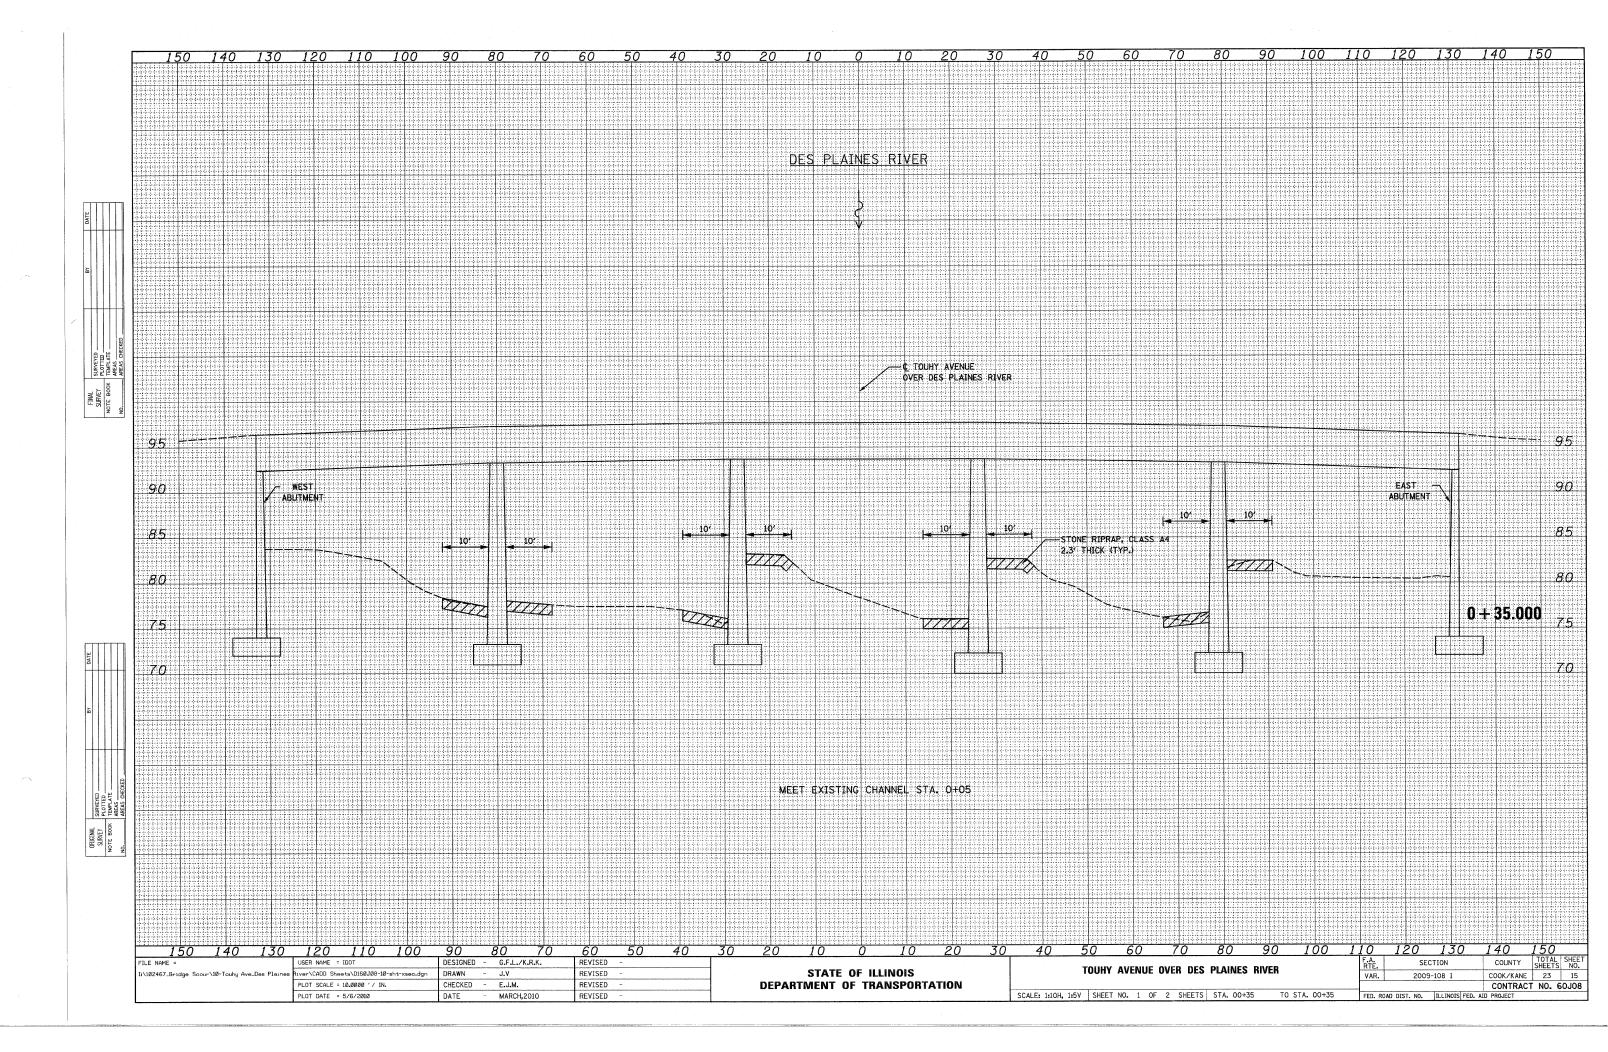

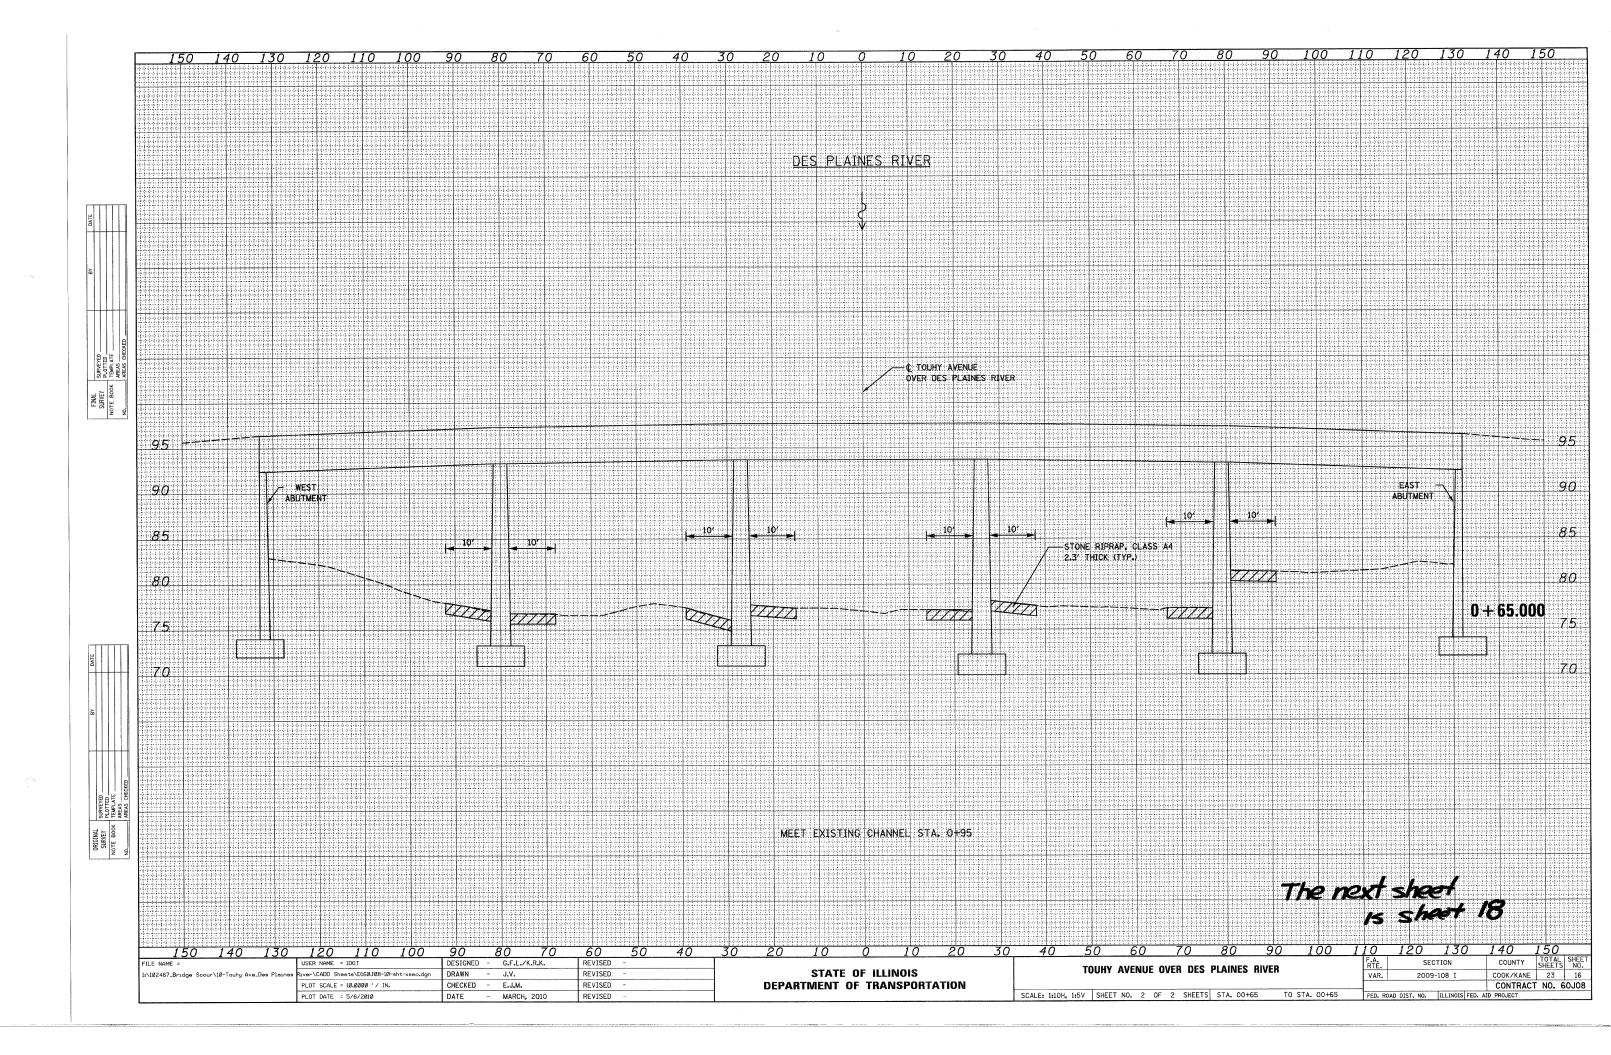

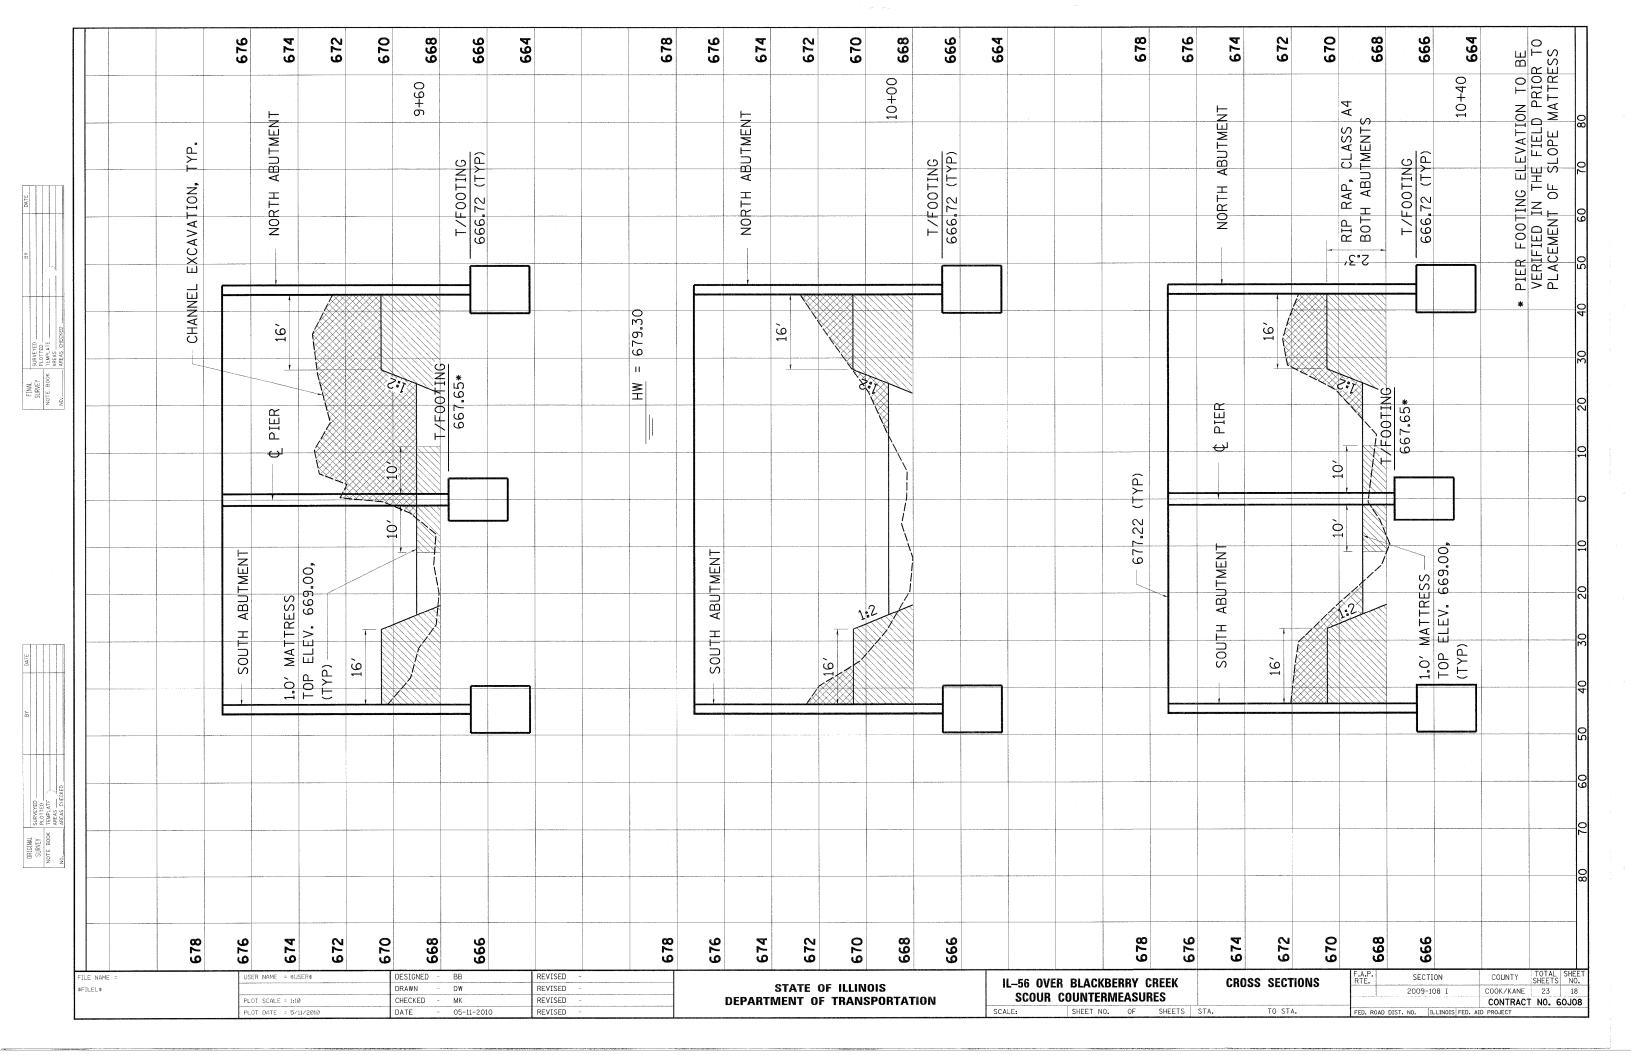

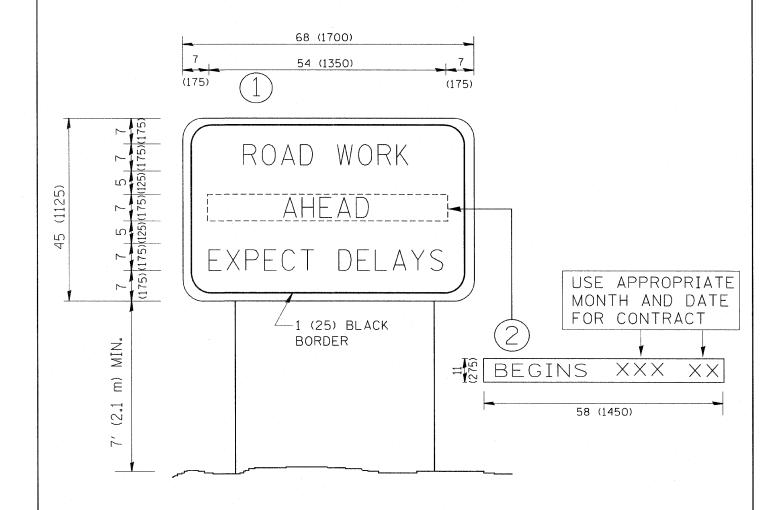


NOTES:

- 1. USE BLACK LETTERING ON ORANGE BACKGROUND.
- 2. ERECT SIGNS IN ADVANCE OF THE LOCATION FOR THE "ROAD CONSTRUCTION AHEAD" SIGN AT LOCATIONS AS DIRECTED BY THE ENGINEER.
- 3. ERECT SIGN (1) WITH INSTALLED PANEL (2) ONE WEEK PRIOR TO THE START OF CONSTRUCTION.
- 4. REMOVE PANEL 2 SOON AFTER THE START OF CONSTRUCTION.
- 5. SEE SPECIAL PROVISION FOR "TEMPORARY INFORMATION SIGNING" FOR ADDITIONAL INFORMATION.
- 6. ONE SIGN ASSEMBLY EQUALS 25.70 SQ. FT. (2.3 SQ. M.)
- 7. SHALL BE PAID FOR AS TEMPORARY INFORMATION SIGNING.

ALL DIMENSIONS ARE IN INCHES (MILLIMETERS) UNLESS OTHERWISE SHOWN.

FILE NAME =	USER NAME = gaglianobt	DESIGNED -	REVISED - R. MIRS 09-15-97		ARTERIAL ROAD INFORMATION SIGN			FAP.	SECTION	COUNTY	TOTAL SHEET
W:\diststd\22x34\tc22.dgn	PLOT SCALE = 50,000 1/ IN	DRAWN -	REVISED - R. MIRS 12-11-97 REVISED - T. RAMMACHER 02-02-99	STATE OF ILLINOIS DEPARTMENT OF TRANSPORTATION				VAR.	2009-108 [COOK/KANE	23 19
	PLOT DATE = 1/4/2008	DATE -	REVISED - C. JUCIUS 01-31-07	DEPARTMENT OF TRANSPORTATION	SCALE: NONE	SHEET NO. 1 OF 1 SHEETS STA.	TO STA.	FED. ROAD D	TC-22 DIST. NO. 1 ILLINOIS FEE	. AID PROJECT	NO. 60J08

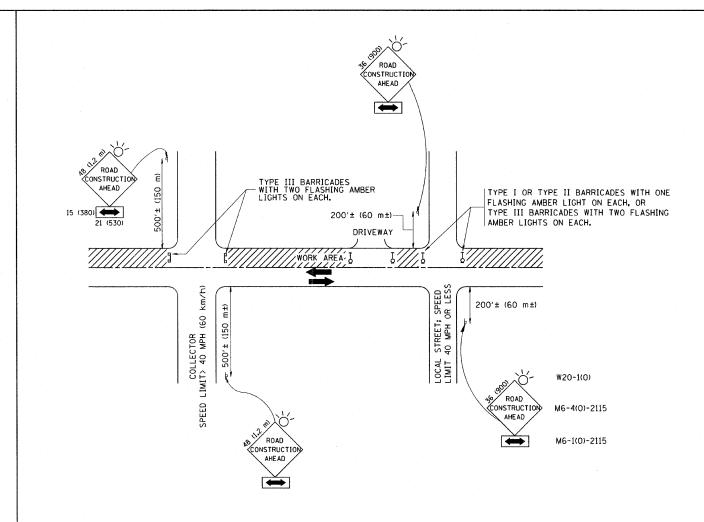

TRAFFIC CONTROL AND PROTECTION FOR SIDE ROADS, INTERSECTIONS, AND DRIVEWAYS

NOTES:

- A. FOR NO LANE RESTRICTION ON THE SIDE ROAD OR DRIVEWAYS
- 1. SIDE ROAD WITH A SPEED LIMIT OF 40 MPH (60 km/h) OR LESS AS SHOWN ON THE DRAWING AND AS DIRECTED BY THE ENGINEER:
- O) ONE ROAD CONSTRUCTION AHEAD SIGN 36 × 36 (900×900) WITH A FLASHER AND FLAG MOUNTED ON IT APPROXIMATELY 200' (60 m) IN ADVANCE OF THE MAIN ROUTE.
- b) THE CLOSED PORTION OF THE MAIN ROUTE SHALL BE PROTECTED BY BLOCKING WITH TYPE 1, TYPE II OR TYPE III BARRICADES, 1/3 OF THE CROSS SECTION OF THE CLOSED PORTION.
- 2. SIDE ROAD WITH A SPEED LIMIT GREATER THAN 40 MPH (60 km/h) AS SHOWN ON THE DRAWING AND AS DIRECTED BY THE ENGINEER:
- O) ONE ROAD CONSTRUCTION AHEAD SIGN 48 x 48 (1.2 m x 1.2 m) WITH A FLASHER MOUNTED ON IT APPROXIMATELY 500' (150 m) IN ADVANCE OF THE MAIN ROUTE.
- b) THE CLOSED PORTION OF THE MAIN ROUTE SHALL BE PROTECTED BY BLOCKING WITH TYPE III BARRICADES, 1/2 OF THE CROSS SECTION OF THE CLOSED PORTION.
- 3. WHEN THE SIDE ROAD LIES BETWEEN THE BEGINNING OF THE MAINLINE SIGNING AND THE WORK ZONE, A SINGLE HEADED ARROW (M6-1) SHALL BE USED IN LIEU OF THE DOUBLE HEADED ARROW (M6-4).

- B. FOR A LANE CLOSURE ON A SIDE ROAD OR DRIVEWAY:
- USE APPLICABLE PORTIONS OF THE TYPICAL APPLICATION OF TRAFFIC CONTROL DEVICES (STD. 701501, STD. 701606 OR THE APPROPRIATE STANDARD). THE SPACING OF SIGNS AND BARRICADES SHALL BE ADJUSTED FOR FIELD CONDITIONS AS DIRECTED BY THE ENGINEER. THE DIRECTIONAL ARROW SHALL BE COVERED OR REMOVED WHEN NO LONGER CONSISTENT WITH THE SIDE ROAD LANE CLOSURE.
- C. ADVANCE WARNING SIGNS ARE TO BE OMITTED ON DRIVEWAY UNLESS OTHERWISE NOTED.
- D. THE TRAFFIC CONTROL AND PROTECTION FOR SIDE ROADS, INTERSECTIONS, AND DRIVEWAYS SHALL BE INCIDENTAL TO THE COST OF SPECIFIED TRAFFIC CONTROL STANDARDS OR ITEMS.

All dimensions are in millimeters (inches) unless otherwise shown.

FILE NAME = USER NAME = geglianobt DESIGNED - LHA REVISED - J. OBERLE 10-18-95

Wi\distatd\22x34\to10.dgn - REVISED - A. HOUSEH 03-06-96

PLOT SCALE = 50.000 '/ IN. CHECKED - REVISED - A. HOUSEH 10-15-96

PLOT DATE = 1/4/2008 DATE - 06-89 REVISED - T. RAMMACHER 01-06-00

STATE OF ILLINOIS
DEPARTMENT OF TRANSPORTATION

TRAFFIC CONTROL AND PROTECTION FOR						
	SIDE ROADS, INTERSECTIONS, AND DI	RIVEWAYS				
SCALE: NONE	SHEET NO. 1 OF 1 SHEETS STA.	TO STA.				

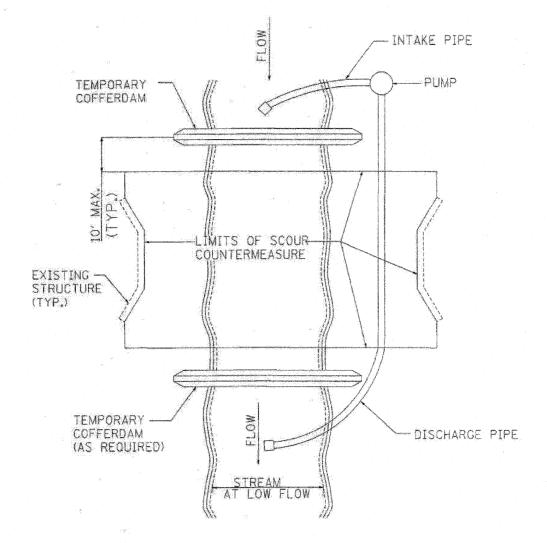


FIGURE D1. TEMPORARY COFFERDAM WITH PUMP BYPASS

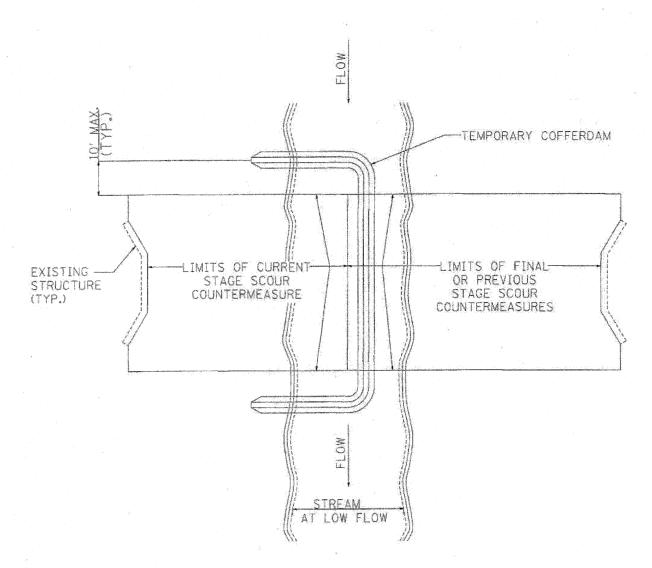


FIGURE D2. STAGED IN-STREAM COFFERDAM DIVISION

NOTE: DEWATERING SYSTEM DETAILS SHALL BE USED IN CONJUNCTION WITH THE PROJECT SPECIAL PROVISIONS.

COUNTY TOTAL SHEET NO.

COOK/KANE 23 21 CHRISTIAN-HOGE & ASSOCIATES, INC.
ENGINEERS-PLANNERS-SURVEYORS
211 WEST WACKER DRIVE
CHICAGO, ILLINOS 60606
II PHONE: (312)372-2023 FAX: (312)372-5274 FILE NAME = D160J08_-sht-details DESIGNED - G.F.L. REVISED F.A.P. RTE. VAR. **DEWATERING SYSTEM DETAILS** STATE OF ILLINOIS PLOT DATE = 5/10/2010 DRAWN - J.V./K.R.K. REVISED 2009-108 I SCOUR COUNTERMEASURES - VARIOUS LOCATIONS **DEPARTMENT OF TRANSPORTATION** CHECKED - G.F.L REVISED CONTRACT NO. 60J08 SCALE: NONE SHEET NO. OF SHEETS STA. APRIL 28, 2010 REVISED

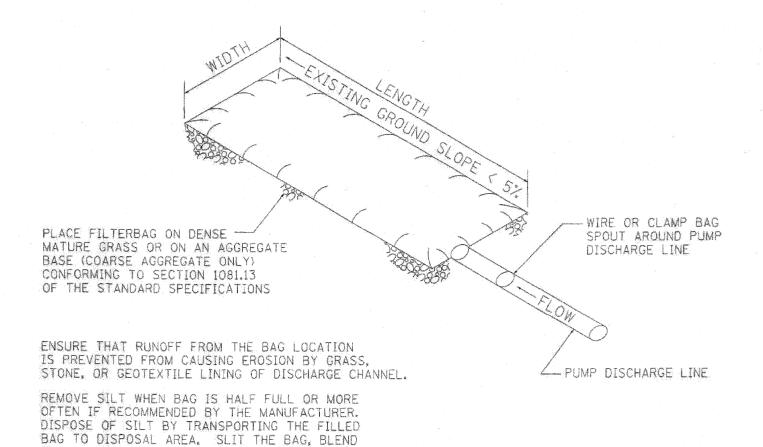


FIGURE S1. SEDIMENT FILTER BAG

NOTE: DEWATERING SYSTEM DETAILS SHALL BE USED IN CONJUNCTION WITH THE PROJECT SPECIAL PROVISIONS.

FILE NAME = 0160J08_-sht-details2.dgh PLOT DATE = 5/10/2010

CHRISTIAN-ROGE & ASSOCIATES, INC.
ENGINEERS-PLANNERS-SURVEYORS
211 WEST WACKER DRIVE
CHICAGO, ILLINOIS 60606
CHECKE
PHONE: (312)372–2023 FAX: (312)372–5274
DATE


C. DESIGNED - G.F.L. REVISED
DRAWN - J.V./K.R.K. REVISED
CHECKED - G.F.L REVISED
CHECKED - APRIL 28, 2010 REVISED -

SILT INTO EXISTING TOPOGRAGHY, SEED AND MULCH


MAINTAIN EXTRA FILTER BAGS ON SITE. REPLACE DAMAGED BAGS PROMPTLY

TYPICAL FLOW RATE: 10 GPM × W × L

STATE OF ILLINOIS
DEPARTMENT OF TRANSPORTATION

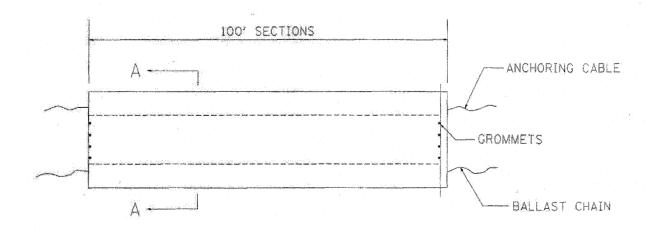DEWATERING SYSTEM DETAILS SCOUR COUNTERMEASURES – VARIOUS LOCATIONS 

ELEVATION

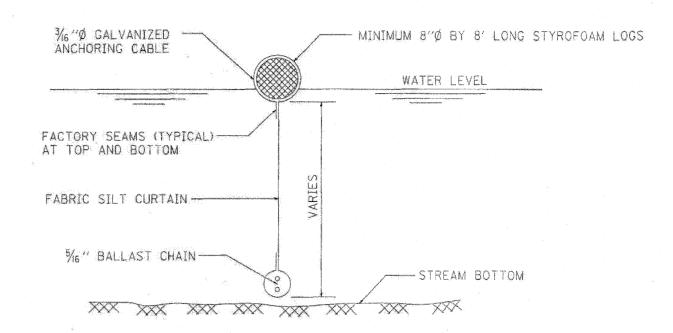

SECTION A-A

FLOTATION BOOM

DESIGNED - G.F.L. REVISED -HRISTIAN_ROGE & ASSOCIATES INC REVISED -DRAWN - J.V./K.R.K. CHECKED - G.F.L REVISED -APRIL 28, 201 REVISED

STATE OF ILLINOIS **DEPARTMENT OF TRANSPORTATION**

RTE. VAR. SECTION **DEWATERING SYSTEM DETAILS** 2009-108 I SCOUR COUNTERMEASURES - VARIOUS LOCATIONS

COUNTY TOTAL SHEET NO.

COOK/KANE 23 23

CONTRACT NO. 60J08

NOTES:

- 1. FLOTATION BOOM SHALL BE ANCHORED TO PREVENT DRIFT SHOREWARD OR DOWNSTREAM. ANCHORAGES SHALL BE INSTALLED ON BOTH SHORE AND STREAM SIDE.
- 2. SHORE ANCHORS SHALL CONSIST OF A POST WITH DEADMAN OR APPROVED EQUAL. STREAM ANCHORS SHALL BE OF SUFFICIENT SIZE TO STABILIZE THE BARRIER WITH NUMBER AND SPACING DEPENDENT ON WATERWAY VELOCITIES.
- 3. FABRIC SECTIONS SHALL BE CONNECTED END TO END WITH MINIMUM 5%" DIAMETER POLYPROPYLENE ROPE.
- 4. DESIGN OF BOOM AND ANCHORAGE SHALL BE IN ACCORDANCE WITH MANUFACTURER'S RECOMENDATIONS. BOTTOM OF BOOM SHALL REACH BOTTOM OF WATERWAY USING ONE OR TWO VERTICAL SECTIONS AS REQUIRED.
- 5. MAINTENANCE SHALL BE PERFORMED AS NEEDED. CONTRACTOR SHALL REMOVE THE BOOM AT COMPLETION OF WORK IN A MANNER THAT WILL PREVENT SILTATION OF THE WATERWAY.

APPLICATION: FLOTATION BOOMS TO BE USED TO CONTROL EROSION, TURBIDITY AND DEBRIS WHEN WORKING IN WATERWAYS.

FILE NAME = D160J08-sht-details3. PLOT DATE = 5/10/2010