07-29-2016 LETTING ITEM 094

STATE OF ILLINOIS **DEPARTMENT OF TRANSPORTATION** FED. ROAD DIST. NO. 1

CONTRACT NO. 61D01

PLAN FOR PROPOSED **FEDERAL AID HIGHWAY**

ROBERT McCLORY BIKE PATH DRAINAGE IMPROVEMENTS MULBERRY PLACE TO LAKE COOK ROAD

> **SECTION NO. 15-00127-00-DR PROJECT NO. TE-01D1(050)**

> > **CITY OF HIGHLAND PARK** LAKE COUNTY

JOB NO. C-91-311-16

R₁₂E

3RD P.M.

FOR INDEX OF SHEETS, SEE SHEET NO. 2


F. RIDDLE, P.E. (847) 705-4406, SCHAUMBURG, IL

PROGRAM AND OFFICE ENGINEER: CHARLES

FOR LIST OF IDOT HIGHWAY STANDARDS, SEE SHEET NO. 2


J.U.L.I.E.

FOR UNDERGROUND UTILITY LOCATION **CALL J.U.L.I.E. TOLL FREE PHONE NO.: 811**

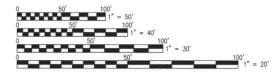

FULL SIZE PLANS HAVE BEEN PREPARED USING STANDARD ENGINEERING SCALES. REDUCED SIZED PLANS WILL NOT CONFORM TO STANDARD SCALES. IN MAKING MEASUREMENTS ON REDUCED PLANS, THE ABOVE SCALES MAY BE USED.

CONTRACT NO. 61D01

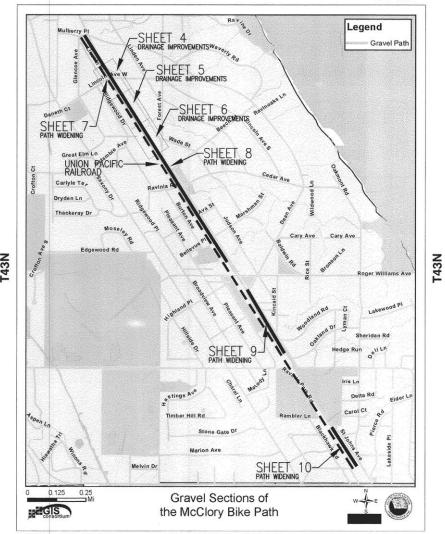


TOWNSHIP 43 NORTH

LOCATION MAP

JASON R. DOLAND, P.E. P.L.S. ILLINOIS REGISTERED PROFESSIONAL ENGINEER NO. 062055693 (LICENSE EXPIRES 11-30-17)



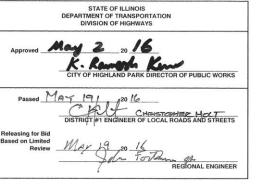

PRINTED BY THE AUTHORITY OF THE STATE OF ILLINOIS

PLANS PREPARED BY: DOLAND ENGINEERING, LLC. PROFESSIONAL DESIGN FIRM NO. 184-006022





GROSS/NET LENGTH 1,500 L.F. = (0.28 MILES)

INDEX OF SHEETS

- 1 COVER SHEET
- 2 GENERAL NOTES
- 3 SUMMARY OF QUANTITIES
- 4 MAINTENANCE OF BICYCLE TRAFFIC (BIKE PATH DETOUR PLAN)
- 5-7 DRAINAGE IMPROVEMENT PLANS
- 8-11 BIKE PATH WIDENING PLANS
- 12 CONSTRUCTION DETAILS

LEGEND

☐ EXISTING CATCH BASIN

EXISTING YARD DRAIN

EXISTING SIGN

10"

x682.5

Co. EXISTING UTILITY POLE

EXISTING POST

EXISTING TREE

EXISTING BRUSH LINE

- - -682- - FXISTING CONTOUR

EXISTING SPOT ELEVATION

---- × ---- EXISTING FENCE

---- >>--- EXISTING STORM SEWER

IDOT HIGHWAY STANDARDS

000001-06	STANDARD SYMBOLS,	ABBREVATIONS AND PATTERNS
000001 00	OTTAINED OTTAINED,	ABBIIE VALIGITO AND I ATTEMIC

604001-04 FRAME AND LIDS TYPE 1

701006-05 OFF-RD OPERATIONS, 2L, 2W, 15' (4-5m) TO 24" (600mm) FROM PAVEMENT EDGE

701011-04 OFF-ROAD MOVING OPERATIONS, 2L, 2W, DAY ONLY

701301-04 LANE CLOSURE, 2L, 2W, SHORT TIME OPERATIONS

701311-03 LANE CLOSURE, 2L, 2W, MOVING OPERATIONS - DAY ONLY

701501-06 URBAN LANE CLOSURE, 2L, 2W, UNDIVIDED

701701-10 URBAN LANE CLOSURE, MULTILANE INTERSECTION

701801-06 SIDEWALK, CORNER OR CROSSWALK CLOSURE

701901-05 TRAFFIC CONTROL DEVICES

GENERAL NOTES

GENERAL NOTES:

BEFORE STARTING ANY EXCAVATION, THE CONTRACTOR SHALL CALL "JULIE" AT 811 FOR FIELD LOCATIONS OF BURIED UTILITY FACILITIES. (48 HOURS NOTIFICATION IS REQUIRED).

PECIFICATIONS:

ALL CONSTRUCTION SHALL BE DONE IN ACCORDANCE WITH THE "STANDARD SPECIFICATIONS FOR ROAD AND BRIDGE CONSTRUCTION", ADOPTED APRIL 1, 2016. THE MANUAL ON UNIFORM TRAFFIC CONTROL DEVISES FOR STREET AND HIGHWAYS", LATEST EDITION, THE DETAILS INCLUDED IN THE PLANS, AND THE SPECIAL PROVISIONS INCLUDED IN THE CONTRACT DOCUMENTS.

STANDARDS:

ANY REFERENCE TO "STANDARDS" THROUGHOUT THE PLANS OR SPECIAL PROVISIONS SHALL BE INTERPRETED TO BE THE LATEST STANDARD OF IDOT AS LISTED ON THIS SHEET.

COORDINATION:

THE CONTRACTOR SHALL NOTIFY THE CITY OF HIGHLAND PARK AT LEAST 48 HOURS IN ADVANCE OF BEGINNING WORK, AND SHALL COORDINATE ALL CONSTRUCTION OPERATIONS WITH THE ENGINEER.

PUBLIC OR PRIVATE UTILITIES:

THE LOCATIONS OF PUBLIC OR PRIVATE UTILITIES SHOWN ON THE PLANS ARE APPROXIMATE, AND THE DISTRICT DOES NOT GUARANTEE THEIR ACCURACY. THE CONTRACTOR SHALL BE REQUIRED TO ASCERTAIN THE EXACT LOCATIONS OF SUCH UTILITIES AND EXERCISE CARE DURING CONSTRUCTION OPERATIONS SO AS NOT TO DAMAGE THEM, IN ACCORDANCE WITH THE SPECIAL PROVISIONS AND ARTICLE 107.20 OF THE "STANDARD SPECIFICATIONS". THE CONTRACTOR SHALL BE RESPONSIBLE FOR CONTACTING THE UTILITY OWNERS SO THAT THEIR FACILITIES MAY BE ADJUSTED OR RELOCATED, IF NECESSARY, PRIOR TO THE START OF CONSTRUCTION OPERATIONS UNLESS OTHERWISE NOTED IN THE PLANS. ALL RELOCATION WORK ON EXISTING PRIVATE UTILITIES WILL BE DONE BY THE OWNER OF THAT UTILITY.

THE CONTRACTOR SHALL BE RESPONSIBLE FOR ANY DAMAGE OR DESTRUCTION OF PUBLIC OR PRIVATE PROPERTY, AND SHALL RESTORE SUCH PROPERTY AT HIS/HER EXPENSE.

SURVEY AND MONUMENTS:

ALL ELEVATIONS IN THE PLANS ARE BASED UPON THE NORTH AMERICAN VERTICAL DATUM OF 1988 (NAVD88)

DISPOSAL OF MATERIALS:

THERE WILL BE NO SPECIAL WASTE REMOVAL NECESSARY TO CONSTRUCT THIS PROJECT.

EXISTING DRAINAGE STRUCTURES:

DURING CONSTRUCTION OPERATIONS, WHENEVER ANY LOOSE MATERIAL IS DEPOSITED IN THE FLOW LINE OF DRAINAGE STRUCTURES, SUCH THAT THE NATURAL FLOW OF WATER IS OBSTRUCTED, IT SHALL BE REMOVED BY THE CONTRACTOR AT THE CLOSE OF EACH WORKING DAY. AT THE CONCLUSION OF CONSTRUCTION OPERATIONS, ALL DRAINAGE STRUCTURES SHALL BE FREE FROM DIRT AND DEBRIS. THE WORK SPECIFIED ABOVE WILL NOT BE PAID FOR SEPARATELY, BUT SHALL BE CONSIDERED AS INCLUDED IN THE COST OF THE CONTRACT PAY ITEM FOR EARTH EXCAVATION.

WHEN EXISTING DRAINAGE FACILITIES ARE DISTURBED, THE CONTRACTOR SHALL PROVIDE AND MAINTAIN TEMPORARY OUTLETS AND CONNECTIONS FOR ALL PRIVATE OR PUBLIC DRAINS, SEWERS OR CATCH BASINS. CONTRACTOR SHALL PROVIDE FACILITIES TO TAKE IN ALL STORM WATER WHICH WILL BE RECEIVED BY THESE DRAINS AND SEWERS, AND DISCHARGE SAME. CONTRACTOR SHALL PROVIDE AND MAINTAIN AN EFFICIENT PUMPING PLANT, IF NECESSARY, AND A TEMPORARY OUTLET, AND BE PREPARED AT ALL TIMES TO DISPOSE OF THE WATER RECEIVED FROM THESE TEMPORARY CONNECTIONS UNTIL SUCH TIME AS THE PERMANENT CONNECTIONS WITH SEWERS ARE BUILT AND IN SERVICE. THIS WORK WILL NOT BE PAID FOR DIRECTLY, BUT SHALL BE CONSIDERED INCLUDED IN THE CONTRACT PAY ITEM FOR EARTH EXCAVATION. BEFORE ORDERING PIPE CULVERTS, THE CONTRACTOR SHALL CONTACT THE ENGINEER AS TO THE EXACT LENGTH AND QUANTITY REQUIRED.

INSUITABLE MATERIAL:

BEFORE REMOVAL OF ANY UNSUITABLE MATERIAL, THE CONTRACTOR SHALL TREAT THE SUBGRADE AS PER ARTICLE 301.03 OF THE "STANDARD SPECIFICATIONS" TO THE SATISFACTION OF THE ENGINEER. UNSUITABLE MATERIAL SHALL NOT BE USED AS EMBANKMENT OR FILL UNDER THE PROPOSED TRAIL AS SHOWN ON THE TYPICAL CROSS SECTIONS.

STOCKPILES:

STOCKPILES OF TOPSOIL AND OTHER MATERIALS SHALL NOT BE LOCATED WITH A SPECIAL MANAGEMENT AREA. APPROVAL OF THE LOCATION MUST BE OBTAINED FROM THE ENGINEER PRIOR TO PLACEMENT. IF A STOCKPILE IS TO REMAIN IN PLACE FOR MORE THAN THREE DAYS, EROSION CONTROL MEASURES SHALL BE PROVIDED. STOCKPILES TO REMAIN IN PLACE FOR 30 DAYS OR MORE SHALL RECEIVE TEMPORARY SEEDING.

TREE TRIMMING:

ALL BRANCHES THAT ARE LESS THAN 12 FEET ABOVE THE SURFACE OF THE TRAIL SHALL BE REMOVED BY THE CONTRACTOR. THE CONTRACTOR SHALL PERFORM THE WORK IN ACCORDANCE WITH ANSI STANDARD A300-2001 (PART 1) FOR TREE, SHRUB AND OTHER WOODY PLANT MAINTENANCE AND ANSI Z133.1-1994 FOR THREE CARE OPERATIONS PRUNING, TRIMMING, REPAIRING, MAINTAINING AND REMOVING TREES AND CUTTING BRUSH. THIS WORK SHALL BE NOT BE PAID FOR SEPARATELY, BUT SHALL BE INCLUDED IN THE COST OF MOBILIZATION.

ACCESS TO PROPERTY:

THE CONTRACTOR SHALL MAINTAIN ACCESS TO ABUTTING PROPERTY DURING CONSTRUCTION OF THIS PROJECT, EXCEPT FOR PERIODS OF SHORT DURATION AS APPROVED BY THE ENGINEER.

SAW CUTTING

THE LIMITS OF REMOVAL OF ALL CONCRETE OR BITUMINOUS PAVEMENTS, CURBING OR SIDEWALKS SHALL BE SAWCUT IN ACCORDANCE WITH SECTION 440 OF THE "STANDARD SPECIFICATIONS" AND AT THE DIRECTION OF THE ENGINEER. THE SAW CUTTING OF BITUMINOUS PAVEMENT, DRIVEWAYS, CURBS OR SIDEWALK SHALL BE INCLUDED IN THE COST OF THE ITEM BEING REMOVED.

RESTORATION:

GRASS AREAS DISTURBED DURING CONSTRUCTION SHALL BE RESTORED WITH SIX INCHES OF TOPSOIL AND SOD.

SEDIMENTATION AND EROSION CONTROL NOTES:

A) SOIL DISTURBANCE SHALL BE CONDUCTED IN SUCH A MANNER AS TO MINIMIZE EROSION. SOIL STABILIZATION MEASURES SHALL CONSIDER THE TIME OF YEAR, SITE CONDITIONS AND THE USE OF TEMPORARY OR PERMANENT MEASURES.

B) SOIL EROSION AND SEDIMENT CONTROL FEATURES SHALL BE CONSTRUCTED PRIOR TO THE COMMENCEMENT OF UPLAND DISTURBANCE.

C) TEMPORARY SOIL STABILIZATION SHALL BE APPLIED TO DISTURBED AREAS WITH 14 CALENDAR DAYS OF THE END OF ACTIVE HYDROLOGIC DISTURBANCE. PERMANENT STABILIZATION SHALL BE DONE WITHIN 14 DAYS AFTER COMPLETION OF FINAL GRADING. D) ALL STORM SEWER FACILITIES THAT ARE OR WILL BE FUNCTIONING DURING CONSTRUCTION SHALL BE PROTECTED, FILTERED, OR OTHERWISE TREATED TO REMOVE SEDIMENT.

E) ALL TEMPORARY EROSION AND SEDIMENT CONTROL MEASURES SHALL BE REMOVED WITHIN 30 DAYS OF FINAL SITE STABILIZATION OR AFTER THE TEMPORARY MEASURES ARE NO LONGER NEEDED. TRAPPED SEDIMENT AND OTHER DISTURBED SOIL AREAS SHALL BE PERMANENTLY STABILIZED.

F) ALL TEMPORARY AND PERMANENT EROSION CONTROL MEASURES SHALL BE MAINTAINED AND REPAIRED AS NEEDED. THE CONTRACTOR SHALL BE RESPONSIBLE FOR INSPECTION AND REPAIR DURING CONSTRUCTION.

G) THE EROSION CONTROL MEASURES INDICATED ON THE PLANS OR AS DIRECTED BY THE ENGINEER ARE THE MINIMUM REQUIREMENTS. ADDITIONAL MEASURES MAY BE REQUIRED, AS DIRECTED BY THE ENGINEER.

H) THE CONTRACTOR SHALL INSTALL ALL EROSION CONTROL PRIOR TO THE START OF ANY EARTHWORK.

I) IF A STOCKPILE IS TO REMAIN IN PLACE FOR MORE THAN THREE DAYS, EROSION CONTROL MEASURES SHALL BE PROVIDED BY THE CONTRACTOR.

J) EROSION CONTROL MEASURES SHALL COMPLY WITH THE MINIMUM REQUIREMENTS OF THE LAKE COUNTY STORMWATER AND FLOODPLAIN ORDINANCE SPECIFICATIONS AT ALL TIMES.

ALL WORK PERFORMED UNDER THIS IMPROVEMENT SHALL BE GUARANTEED TO THE LOCAL AUTHORITY BY THE CONTRACTOR AND HIS SURETY FOR A PERIOD OF 18 MONTHS AFTER FINAL PAYMENT HAS BEEN MADE, TO ENSURE WORK AND MATERIALS BE COMPLETE AND FREE OF ALL DEFECTS IN WORKMANSHIP AND MATERIALS, OF WHATEVER NATURE



USER NAME:	DESIGNED:	REVISED:	
	DRAWN:	REVISED:	
PLOT SCALE: 1" = 20'	CHECKED:	REVISED:	
PLOT DATE:	DATE:	REVISED:	

SCALE: N/A

SUMMARY OF QUANTITIES

SPECIAL PROVISION	CODE NO.	ITEM DESCRIPTION	UNIT	TOTAL ESTIMATED QUANITY
	20101100	TREE TRUNK PROTECTION	EACH	12
	20101200	TREE ROOT PRUNING	EACH	6
	20200500	EARTH EXCAVATION (WIDENING)	CU YD	100
//	20800150	TRENCH BACKFILL	CU YD	130
	21101615	TOPSOIL FURNISH AND PLACE, 4"	SQ YD	1,000
	25200100	SODDING	SQ YD	1,000
	25200200	SUPPLEMENTAL WATERING	UNIT	20
	28000400	PERIMETER EROSION BARRIER	FOOT	200
	28100101	STONE RIP RAP, CLASS A1	SQ YD	30
	42400200	PORTLAND CEMENT CONCRETE SIDEWALK, 5"	SQ FT	150
	44000600	SIDEWALK REMOVAL	SQ FT	150
	54213657	PRECAST REINFORCED CONCRETE FLARED END SECTIONS 12"	EACH	1 ,


PECIAL PROVISION	CODE NO.	ITEM DESCRIPTION	UNIT	TOTAL ESTIMATED QUANITY
	550B2510	STORM SEWERS, RUBBER GASKET, CLASS B, TYPE 2, 10"	FOOT	137
	550B2520	STORM SEWERS, RUBBER GASKET, CLASS B, TYPE 2, 12"	FOOT	343
*	55200200	STORM SEWERS JACKED IN PLACE 12"	FOOT	1,145
	60108106	PIPE UNDERDRAINS	FOOT	320
	60218300	MANHOLES, TYPE A, 4-DIAMETER, TYPE 1 FRAME, OPEN LID	EACH	9
	60218400	MANHOLES, TYPE A, 4*-DIAMETER, TYPE 1 FRAME, CLOSED LID	EACH	1
	60234200	INLETS, TYPE A, TYPE 1 FRAME, OPEN LID	EACH	7
	67100100	MOBILIZATION	L SUM	1
	70102620	TRAFFIC CONTROL AND PROTECTION, STANDARD 701501	L SUM	1
	70102635	TRAFFIC CONTROL AND PROTECTION, STANDARD 701701	L SUM	1
*	X0323389	STORM SEWER CONNECTION	EACH	1
*	XX008873	AGGREGATE SURFACE COURSE (SPECIAL)	TON	350
*	Z0013798	CONSTRUCTION LAYOUT	L SUM	1


	DOLAND
Ť	ENGINEER LAS SUPETIM - LAS PLANNES 334 EAST COLFAX STREET, SUITE C PALATINE, ILLINOIS 60067 (47) 391-5088 (87) 334-3477 FAX


USER NAME:	DESIGNED:	REVISED:	
	DRAWN:	REVISED:	
PLOT SCALE: 1" = 20'	CHECKED:	REVISED:	
PLOT DATE:	DATE:	REVISED:	


STATE OF ILLINOIS
DEPARTMENT OF TRANSPORTATION


	SUMMARY OF QUANTITIES					F.A. RTE.	SECTION	COUNT	TY	TOTAL SHEETS	SHEET NO.	
							15-00127-00-DR	LAKE		12	3	
						FED. ROAD DIS	ST. NO	ILLINOIS	FED	DERAL AID PROJECT		
SCALE: N/A	SHEET NO.	3 OF	12 SH	HEETS	STA.	STA.			CONT	RAC	T No. 61001	

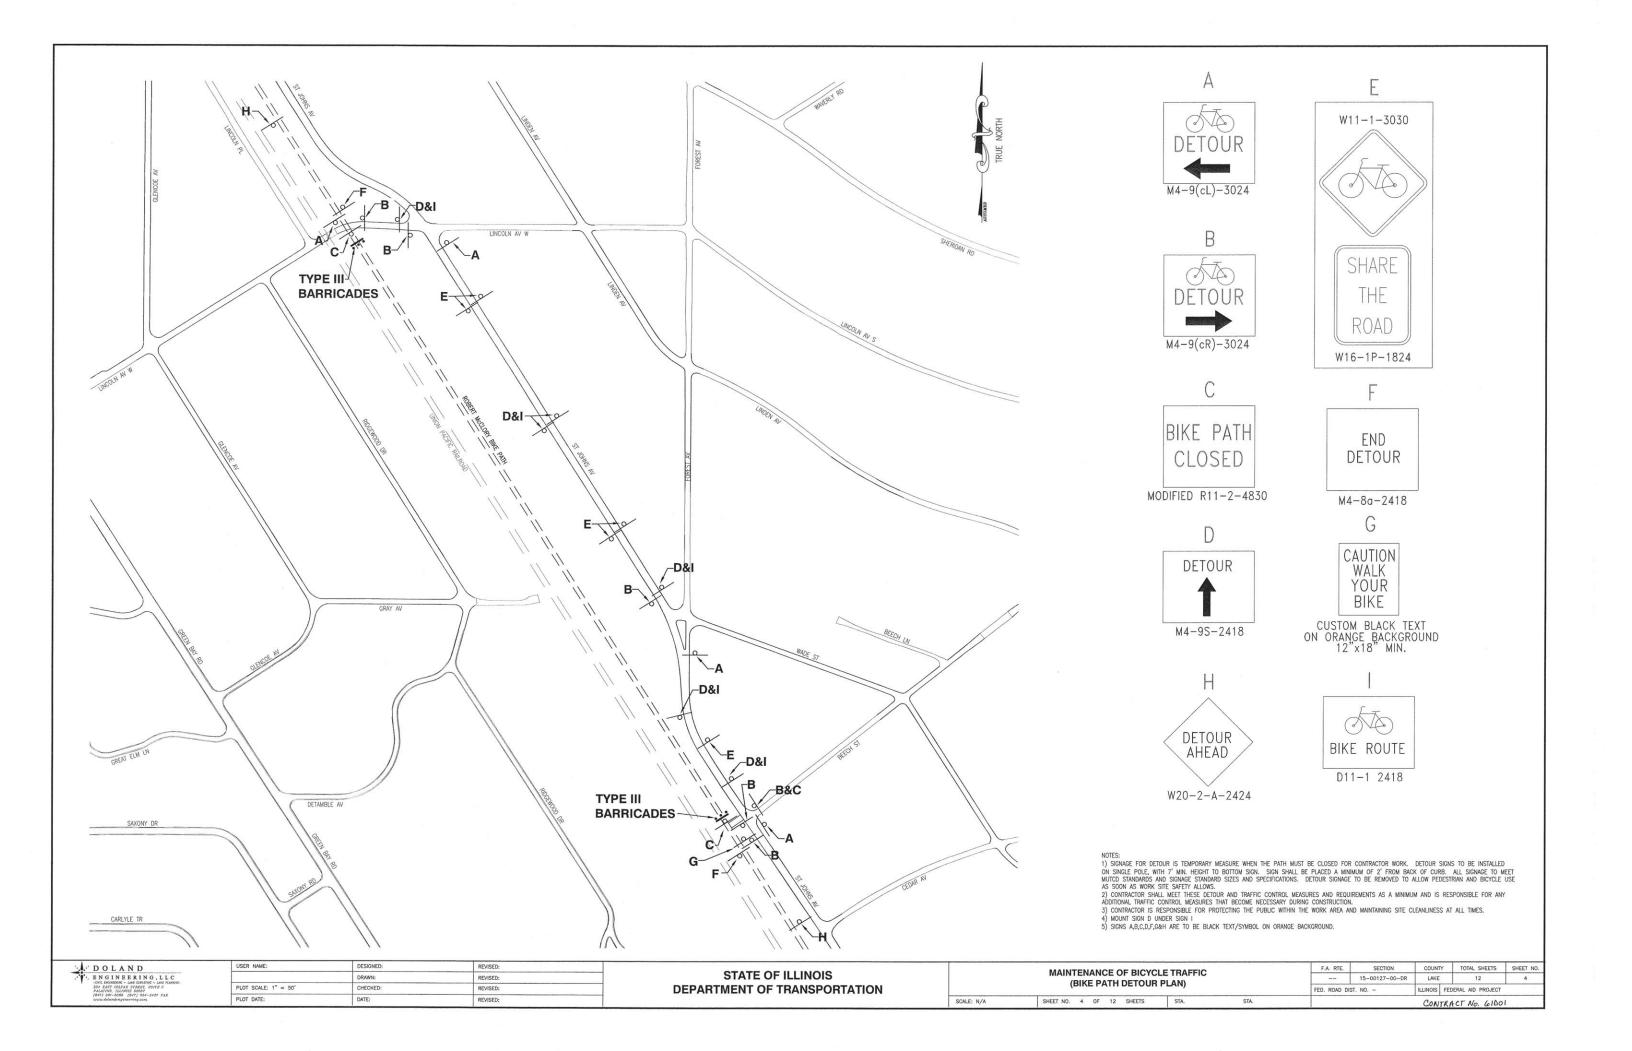


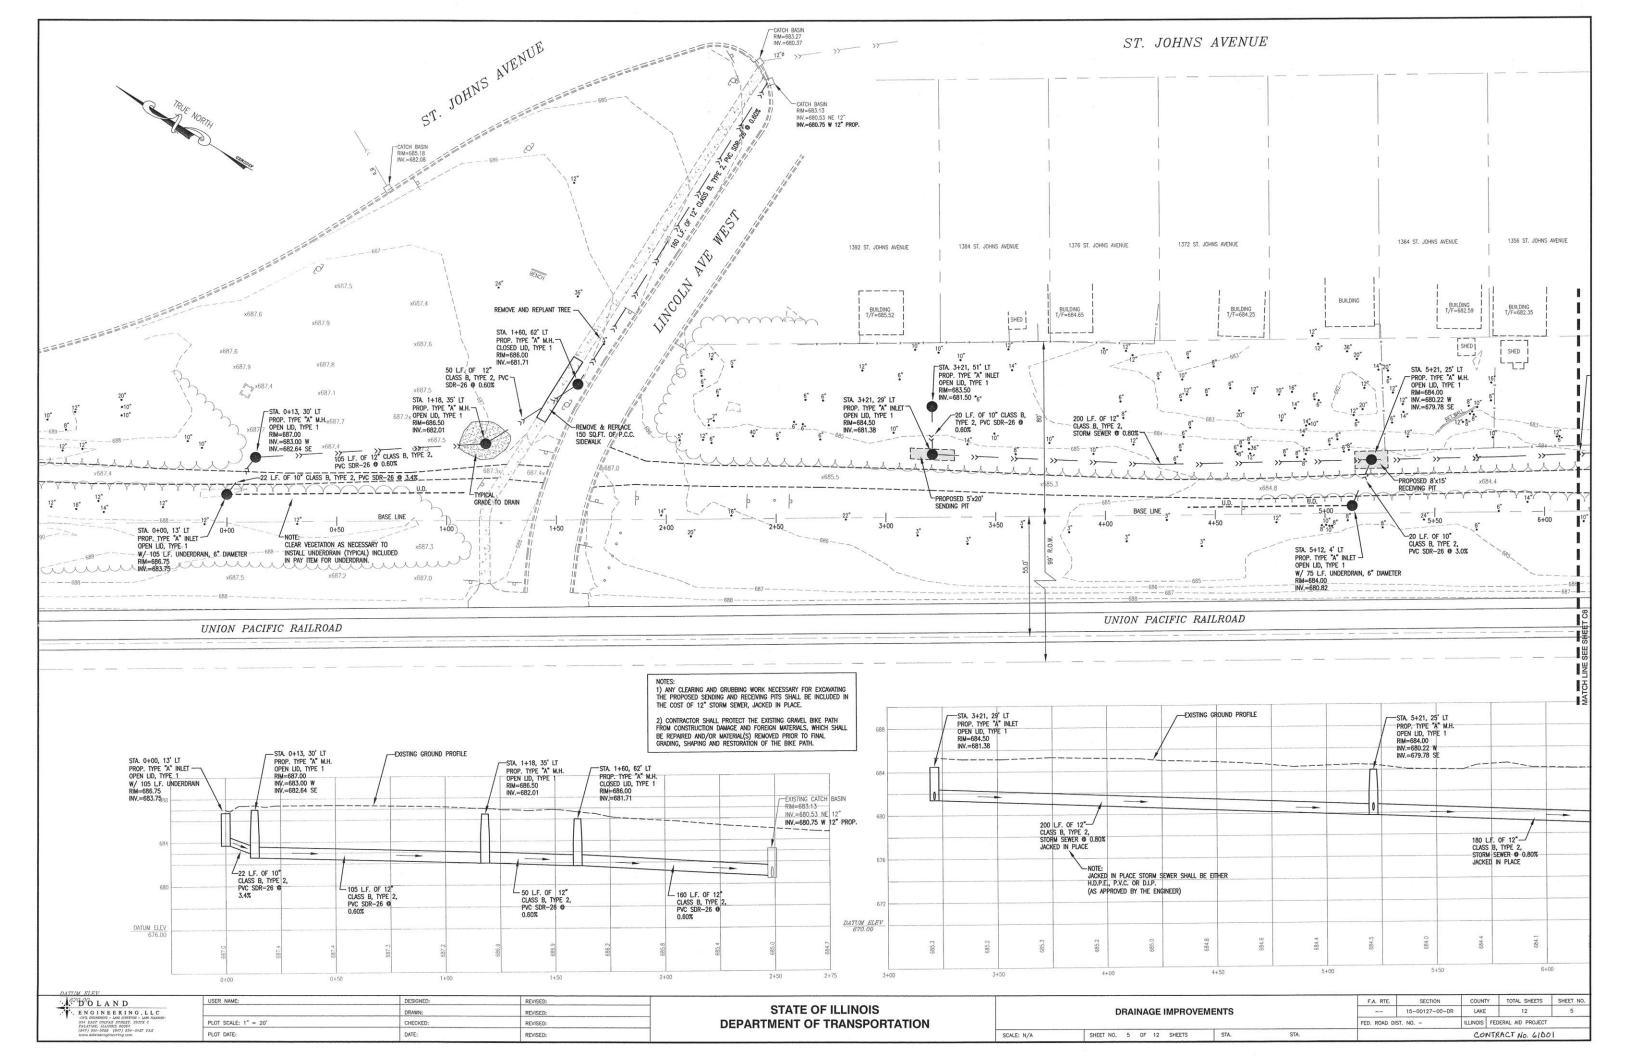


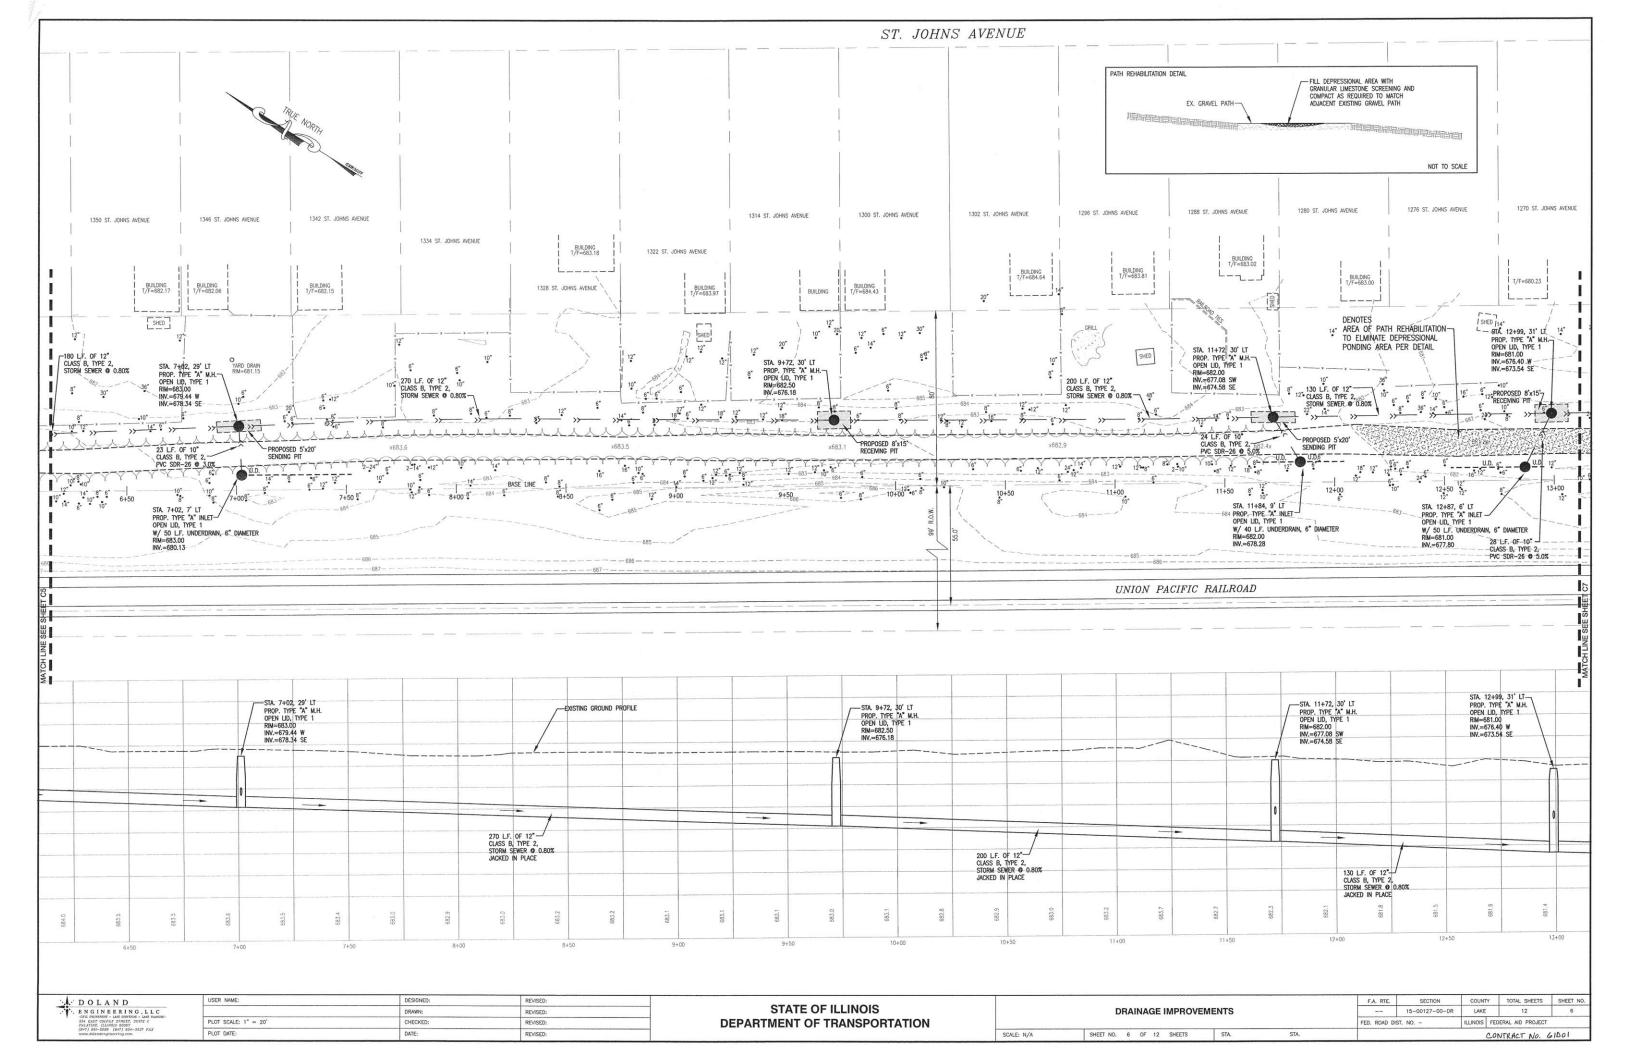


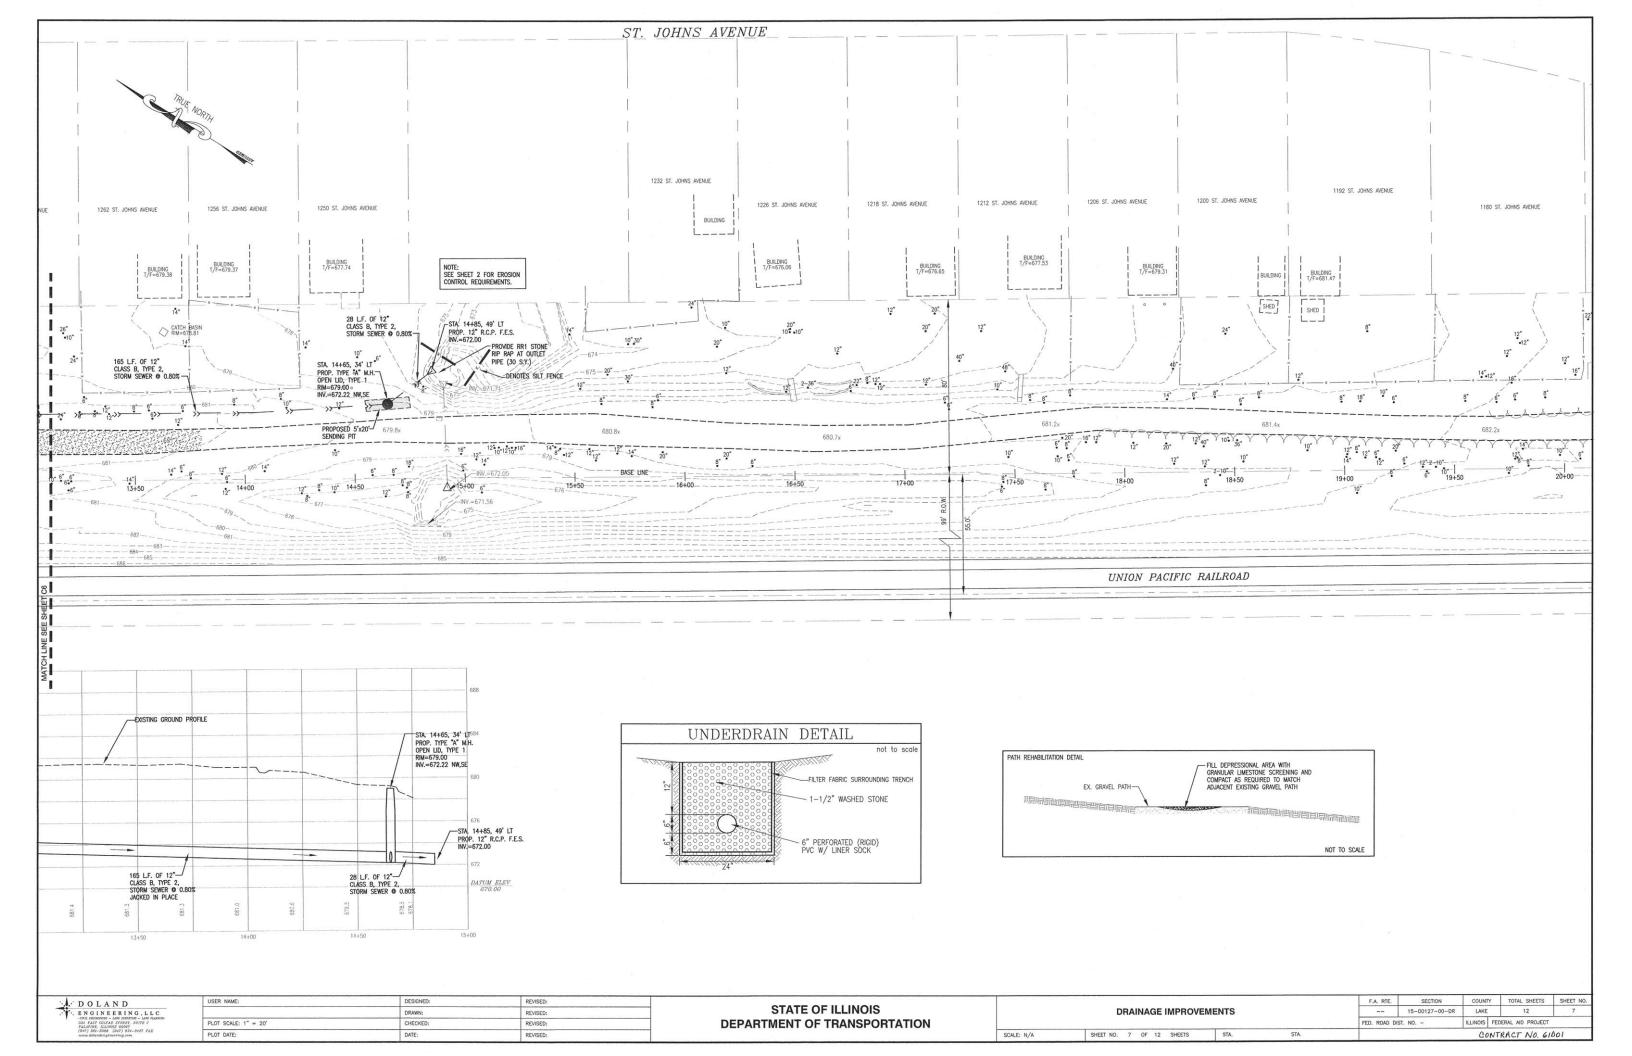


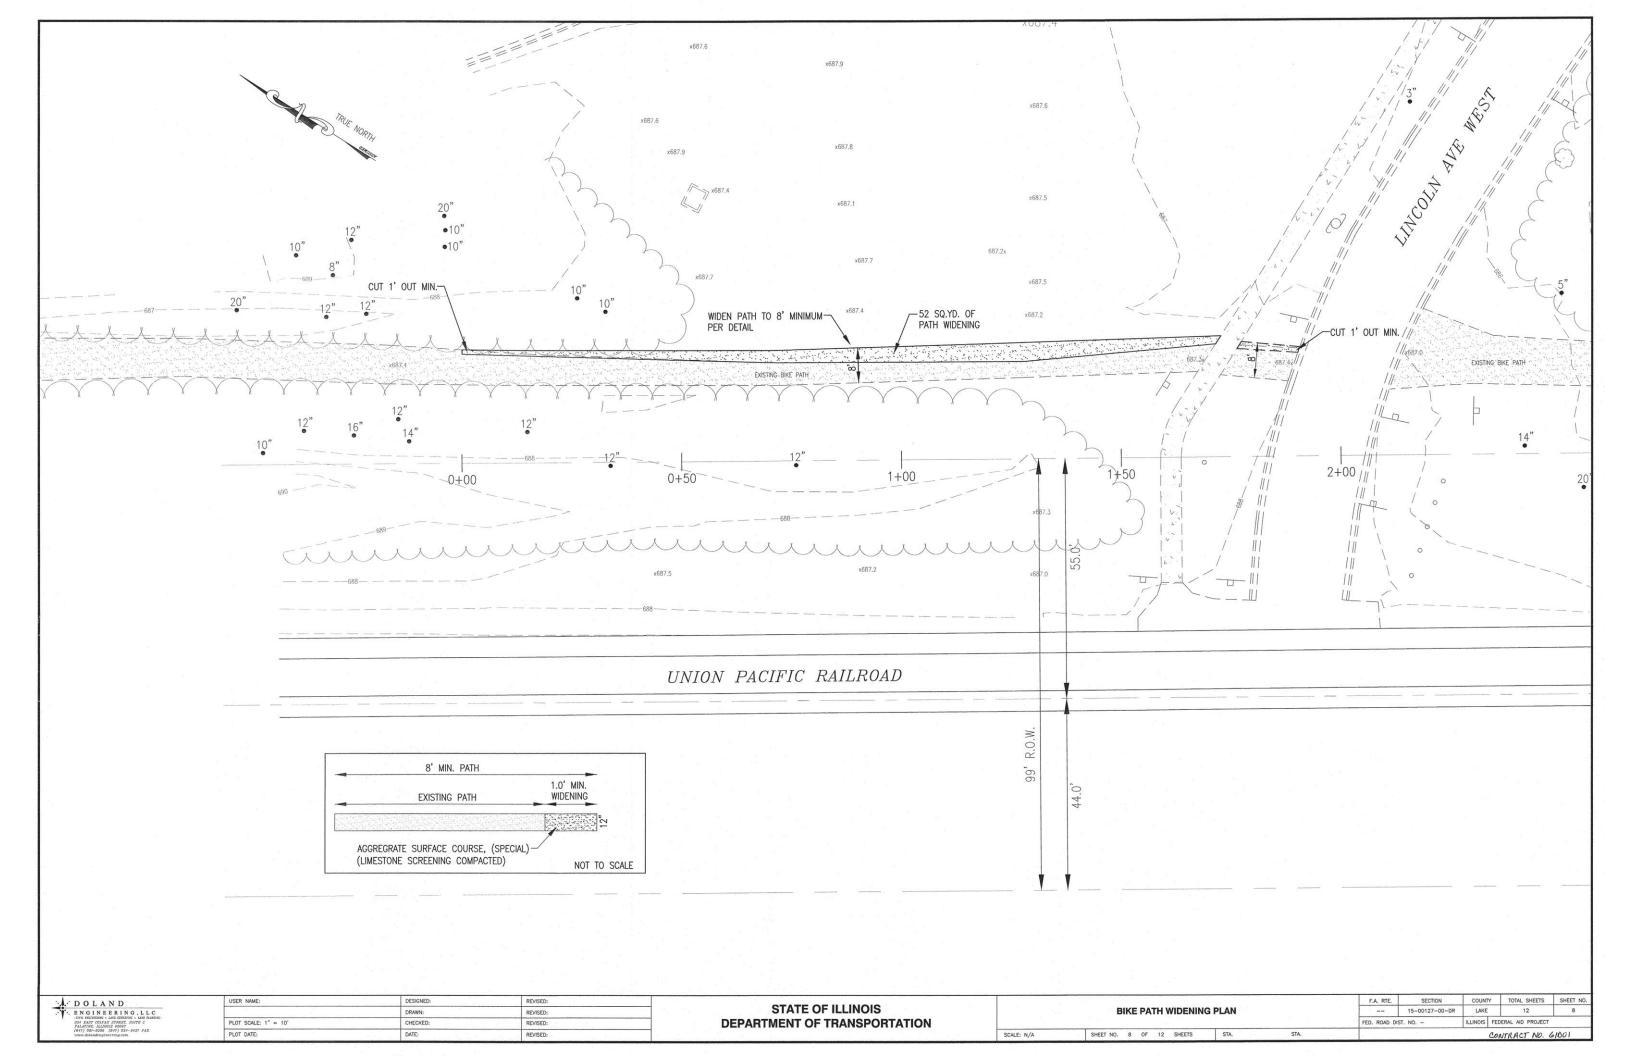


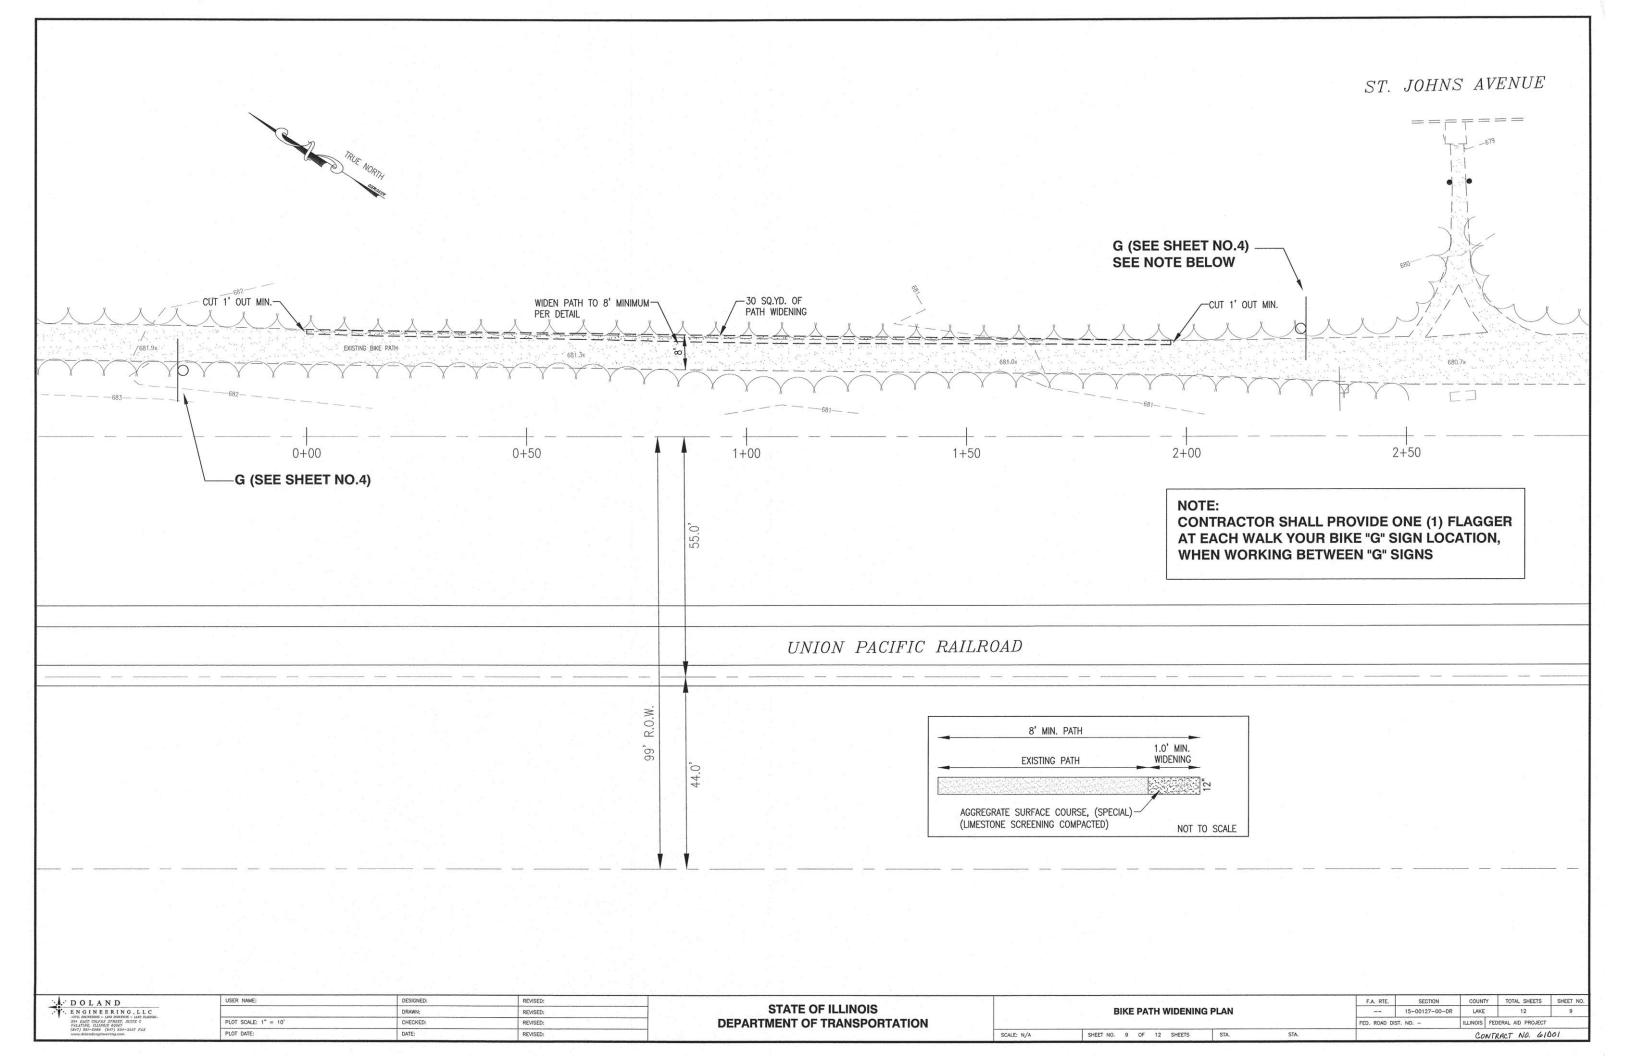


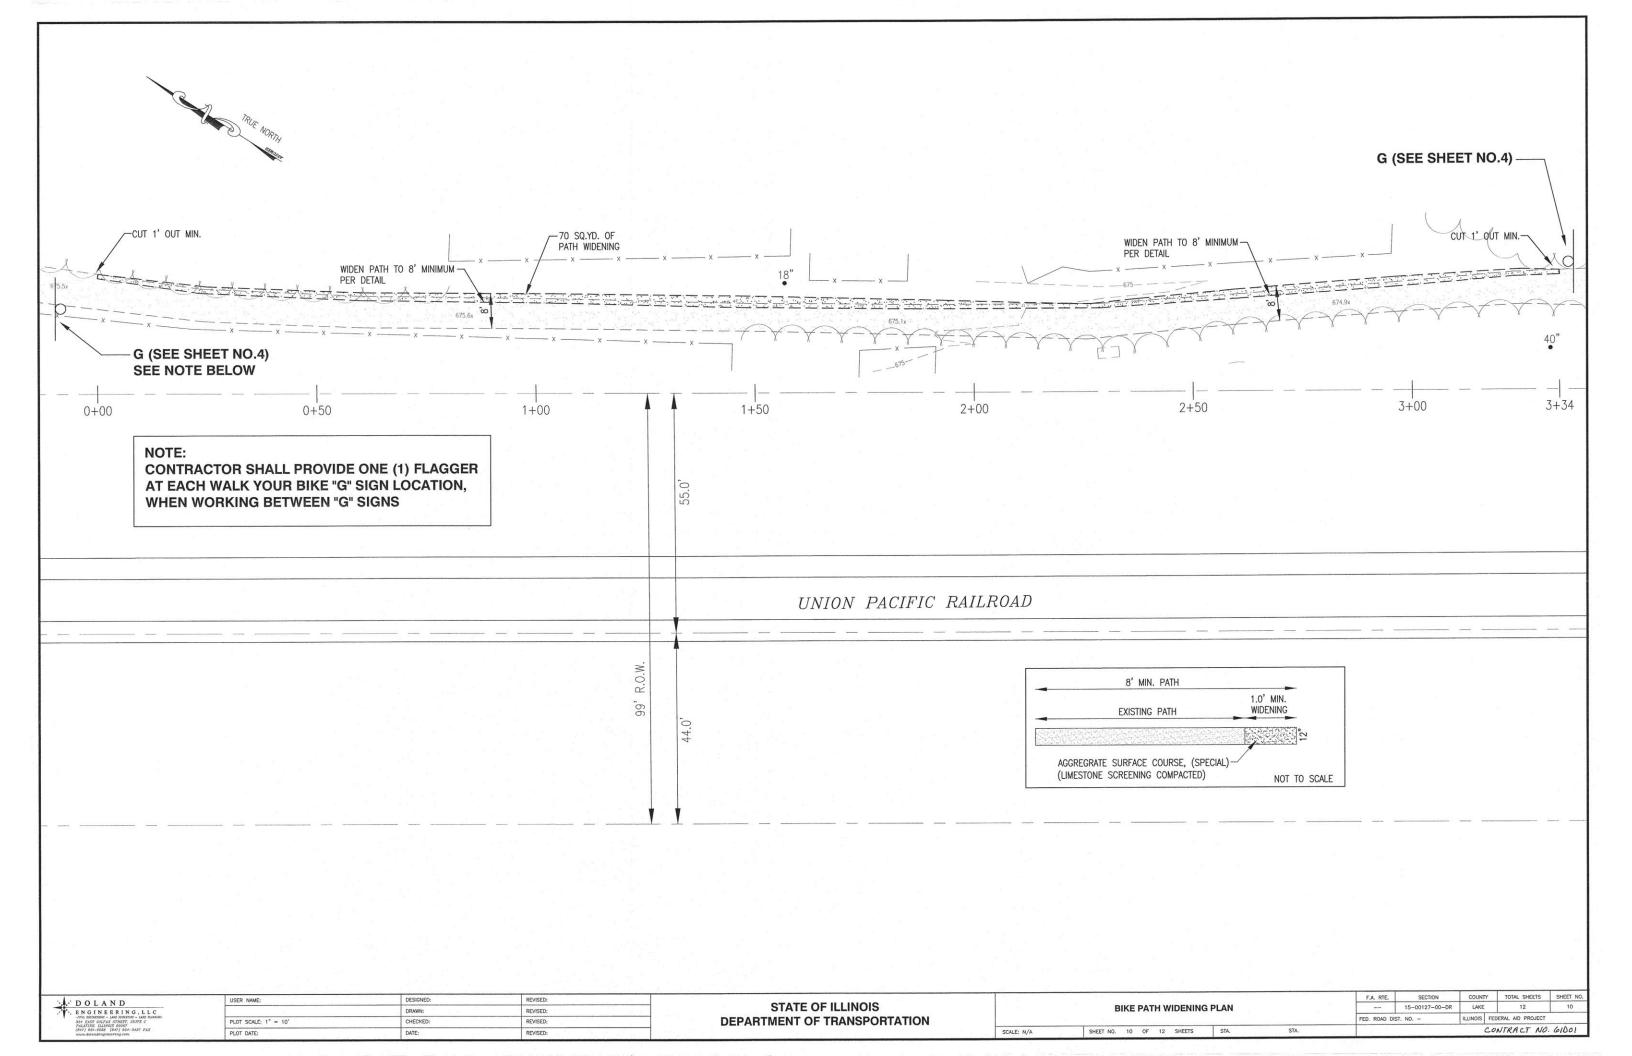


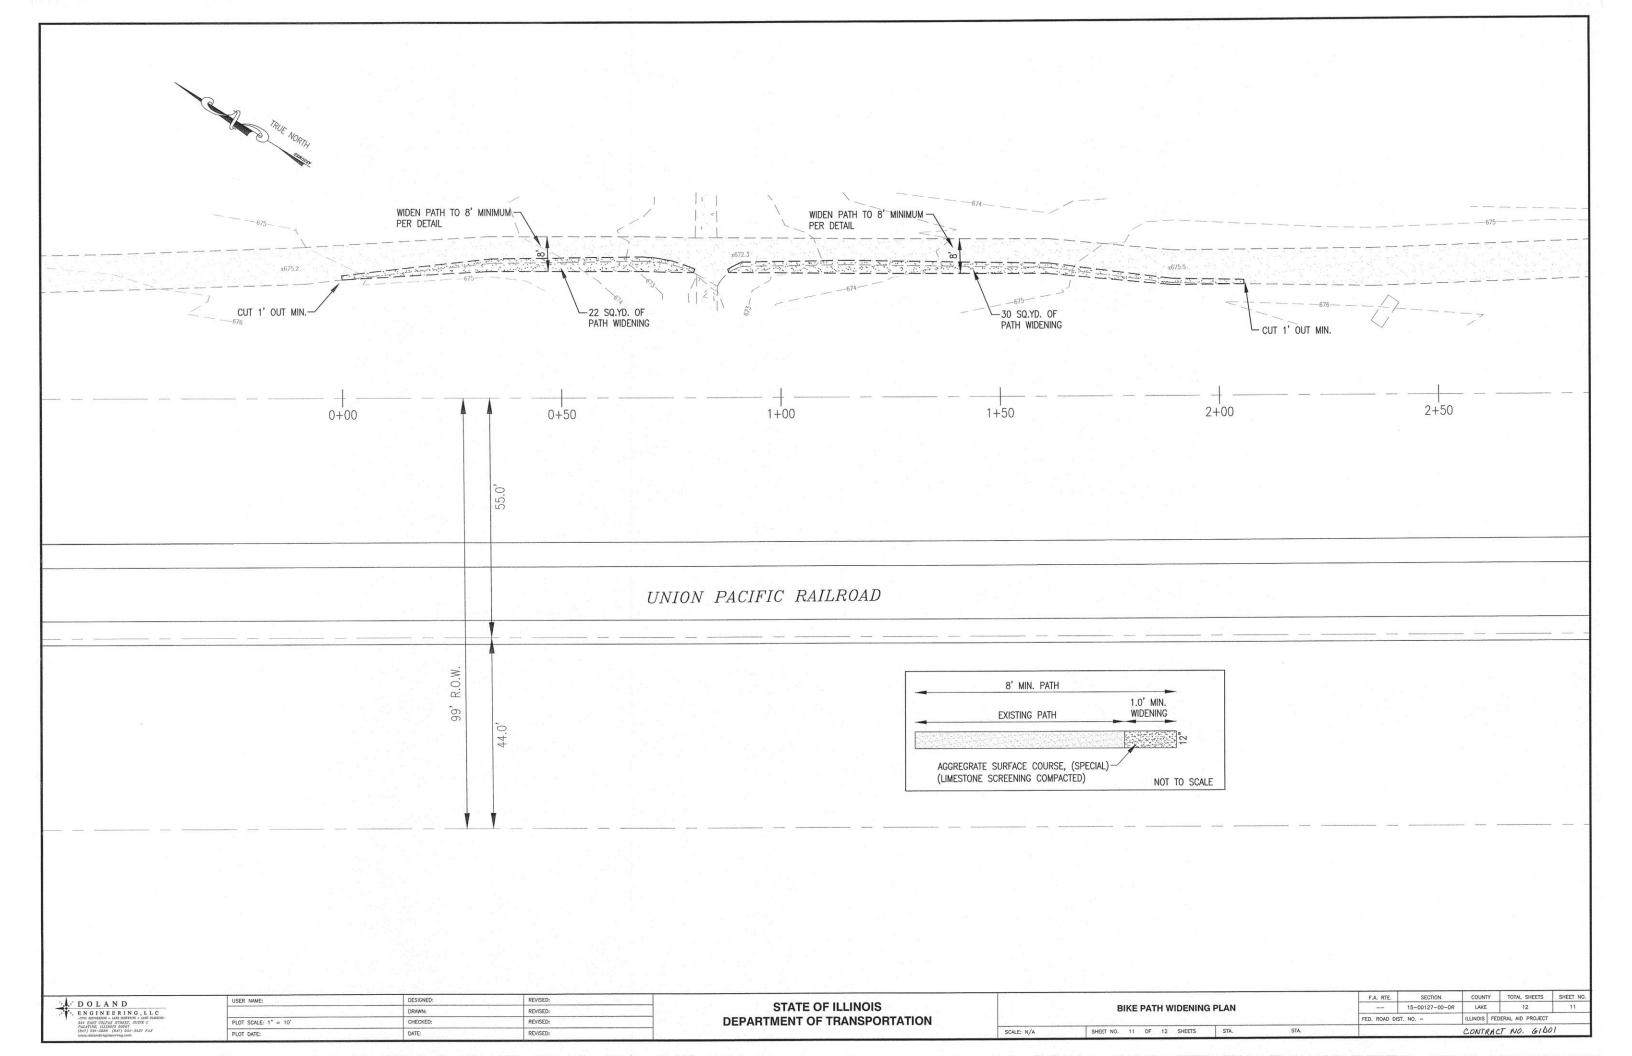

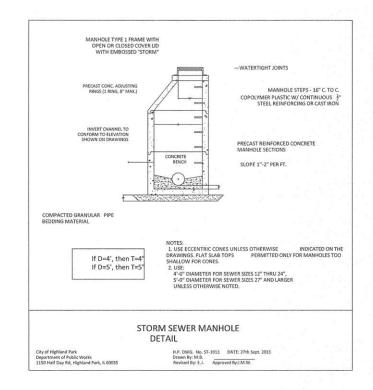

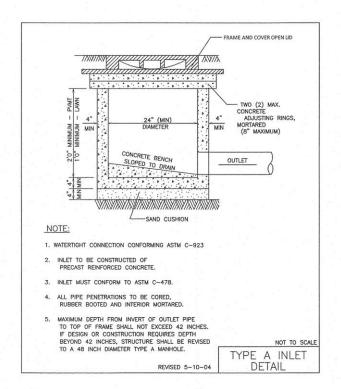

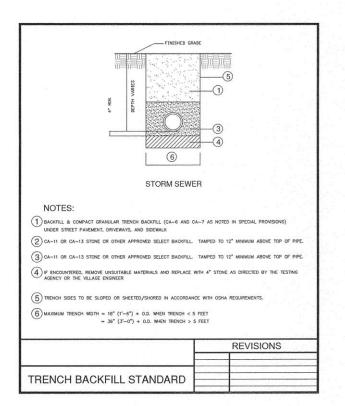

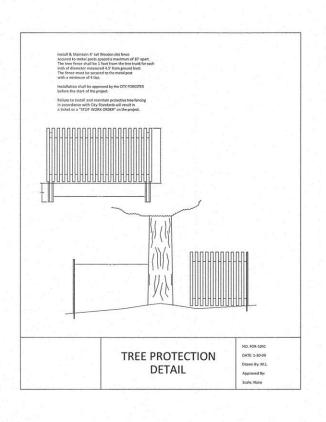

FILTER FABRIC, OR APPROVED EQUAL	ž ž
On the Hotel Edone	M M
	5,0
COMPACTED BACKFILL	ABRIC
	FAE
	FLOW
MIN. 6"X6" —	
	WALL STATE OF THE
	- SUNDANIAN -
	IRVIIRVIIRVIII
	NATURAL SOIL
	ACED AT THOSE LOCATIONS SHOWN
ON THE PLANS. ATTACH FABRIC TO WIRE MESH	
WITH HOG RINGS, TO WOOD P	OSTS WITH NAILS, AND TO STEEL
POSTS WITH TIE-WIRES AT TO	
POSTS WITH TIE-WIRES AT TOO OVERLAP FILTER FABRIC BY 6"	P AND MID-SECTION. AND FOLD WHERE 2 SECTIONS ADJOIN.
POSTS WITH TIE-WIRES AT TOI OVERLAP FILTER FABRIC BY 6" STRAW BALES MAY BE SUBSTITI	P AND MID-SECTION. AND FOLD WHERE 2 SECTIONS ADJOIN. UTED FOR THE FILTER FABRIC,
POSTS WITH TIE-WIRES AT TO	P AND MID—SECTION. AND FOLD WHERE 2 SECTIONS ADJOIN. UTUED FOR THE FILTER FABRIC, ENGINEERING DIVISION
POSTS WITH TIE-WIRES AT TOI OVERLAP FILTER FABRIC BY 6" STRAW BALES MAY BE SUBSTITI IF APPROVED BY THE VILLAGE INSPECTION OF SILT FENCES S WEEK AND AFTER RAIN EVENTS	P AND MID—SECTION. AND FOLD WHERE 2 SECTIONS ADJOIN. UTED FOR THE FILTER FABRIC, ENGINEERING DIVISION SHALL BE AT LEAST ONCE PER S IN EXCESS OF 1/2 ". REPAIR OR
POSTS WITH TIE-WIRES AT TOI OVERLAP FILTER FABRIC BY 6" STRAW BALES MAY BE SUBSTITI IF APPROVED BY THE VILLAGE INSPECTION OF SILT FENCES S WEEK AND AFTER RAIN EVENTS REPLACEMENT SHALL BE MADE	P AND MID-SECTION. AND FOLD WHERE 2 SECTIONS ADJOIN. UTED FOR THE FILTER FABRIC, ENGINEERING DIVISION HALL BE AT LEAST ONCE PER S IN EXCESS OF 1/2 ". REPAIR OR EPROMPTLY AS NEEDED.
POSTS WITH TIE—WIRES AT TOI . OVERLAP FILTER FABRIC BY 6" . STRAW BALES MAY BE SUBSTITI IF APPROVED BY THE VILLAGE INSPECTION OF SILT FENCES S WEEK AND AFTER RAIN EVENTS REPLACEMENT SHALL BE MADE SEDIMENT TRAPPED BY THE FE	P AND MID-SECTION. 'AND FOLD WHERE 2 SECTIONS ADJOIN. UTED FOR THE FILTER FABRIC, ENGINEERING DIVISION HALL BE AT LEAST ONCE PER S IN EXCESS OF 1/2 ". REPAIR OR E PROMPILY AS NEEDED. INCE SHALL BE REMOVED AND
POSTS WITH TIE-WIRES AT TOIL OVERLAP FILTER FABRIC BY 6" STRAW BALES MAY BE SUBSTITI IF APPROVED BY THE VILLAGE INSPECTION OF SILT FENCES S WEEK AND AFTER RAIN EVENTS REPLIACEMENT SHALL BE MADE SEDIMENT TRAPPED BY THE FE PROWPILY DISPOSED OF WHEN BARRIERS SHALL BE MAINTAINE	P AND MID-SECTION. AND FOLD WHERE 2 SECTIONS ADJOIN. UTED FOR THE FILTER FABRIC, ENGINEERING DIVISION HALL BE AT LEAST ONCE PER S IN EXCESS OF 1/2 ". REPAIR OR E PROMPTLY AS NEEDED. INCE SHALL BE REMOVED AND NEVER SIGNIFICANT ACCUMULATION OCCURS. D IN PLACE UNIL COMPLETION OF
POSTS WITH TIE-WIRES AT TOIL OVERLAP FILTER FABRIC BY 6". STRAW BALES MAY BE SUBSTIFE FAPROVED BY THE VILSTIFE FAPROVED BY THE VILSTIFE FAPROVED BY THE FILTER FAPROVED BY THE FEP FAMILY SHALL BE MADE FAMILY SHALL BE FAMILY SHALL BE MADE FAMILY SHALL BE FAMILY SHALL BE FAMILY SHALL BE FAMILY SHALL BY SHALL BE MADE FAMILY SHALL BE FAMILY SHALL BY SHALL BE MADE FAMILY SHALL BE FAMILY SHALL BE FAMILY SHALL BE FAMILY SHALL BY SHA	P AND MID-SECTION. AND FOLD WHERE 2 SECTIONS ADJOIN. UTED FOR THE FILTER FABRIC, ENCINEERING DIVISION HALL BE AT LEAST ONCE PER S IN EXCESS OF 1/2". REPAIR OR EXCESS OF 1/2". REPA
POSTS WITH TIE-WIRES AT TOIL OVERLAP FILTER FABRIC BY 6" STRAW BALES MAY BE SUBSTITI IF APPROVED BY THE VILLAGE INSPECTION OF SILT FENCES S WEEK AND AFTER RAIN EVENTS REPLIACEMENT SHALL BE MADE SEDIMENT TRAPPED BY THE FE PROWPILY DISPOSED OF WHEN BARRIERS SHALL BE MAINTAINE	P AND MID-SECTION. AND FOLD WHERE 2 SECTIONS ADJOIN. UTED FOR THE FILTER FABRIC, ENGINEERING DIVISION HALL BE AT LEAST ONCE PER S IN EXCESS OF 1/2 ". REPAIR OR EPROMPTLY AS NEEDED. INCE SHALL BE REMOVED AND NEVER SIGNIFICANT ACCUMULATION OCCURS. DIN PLACE UNTIL COMPLETION OF OPE AREA HAS BEEN STABILIZED,
POSTS WITH TIE-WIRES AT TOIL OVERLAP FILTER FABRIC BY 6". STRAW BALES MAY BE SUBSTIFE FAPROVED BY THE VILSTIFE FAPROVED BY THE VILSTIFE FAPROVED BY THE FILTER FAPROVED BY THE FEP FAMILY SHALL BE MADE FAMILY SHALL BE FAMILY SHALL BE MADE FAMILY SHALL BE FAMILY SHALL BE FAMILY SHALL BE FAMILY SHALL BY SHALL BE MADE FAMILY SHALL BE FAMILY SHALL BY SHALL BE MADE FAMILY SHALL BE FAMILY SHALL BE FAMILY SHALL BE FAMILY SHALL BY SHA	P AND MID-SECTION. AND FOLD WHERE 2 SECTIONS ADJOIN. UTED FOR THE FILTER FABRIC, ENGINEERING DIVISION HALL BE AT LEAST ONCE PER S IN EXCESS OF 1/2 ". REPAIR OR E PROMPTLY AS NEEDED. INCE SHALL BE REMOVED AND NEVER SIGNIFICANT ACCUMULATION OCCURS. D IN PLACE UNIL COMPLETION OF OPE AREA HAS BEEN STABILIZED, N DIRECTED BY THE VILLAGE. NOT TO SCAL
POSTS WITH TIE-WIRES AT TOIL OVERLAP FILTER FABRIC BY 6". STRAW BALES MAY BE SUBSTIFE FAPROVED BY THE VILSTIFE FAPROVED BY THE VILSTIFE FAPROVED BY THE FILTER FAPROVED BY THE FEP FAMILY SHALL BE MADE FAMILY SHALL BE FAMILY SHALL BE MADE FAMILY SHALL BE FAMILY SHALL BE FAMILY SHALL BE FAMILY SHALL BY SHALL BE MADE FAMILY SHALL BE FAMILY SHALL BY SHALL BE MADE FAMILY SHALL BE FAMILY SHALL BE FAMILY SHALL BE FAMILY SHALL BY SHA	P AND MID-SECTION. AND FOLD WHERE 2 SECTIONS ADJOIN. UTED FOR THE FILTER FABRIC, ENGINEERING DIVISION HALL BE AT LEAST ONCE PER S IN EXCESS OF 1/2 ". REPAIR OR E PROMPTLY AS NEEDED. INCE SHALL BE REMOVED AND NEVER SIGNIFICANT ACCUMULATION OCCURS. DI IN PLACE UNIL COMPLETION OF OPE AREA HAS BEEN STABILIZED, IN DIRECTED BY THE VILLAGE. NOT TO SCAL
POSTS WITH TIE-WIRES AT TOIL OVERLAP FILTER FABRIC BY 6". STRAW BALES MAY BE SUBSTIFE FAPROVED BY THE VILSTIFE FAPROVED BY THE VILSTIFE FAPROVED BY THE FILTER FAPROVED BY THE FEP FAMILY SHALL BE MADE FAMILY SHALL BE FAMILY SHALL BE MADE FAMILY SHALL BE FAMILY SHALL BE FAMILY SHALL BE FAMILY SHALL BY SHALL BE MADE FAMILY SHALL BE FAMILY SHALL BY SHALL BE MADE FAMILY SHALL BE FAMILY SHALL BE FAMILY SHALL BE FAMILY SHALL BY SHA	P AND MID-SECTION. AND FOLD WHERE 2 SECTIONS ADJOIN. UTED FOR THE FILTER FABRIC, ENGINEERING DIVISION HALL BE AT LEAST ONCE PER S IN EXCESS OF 1/2 ". REPAIR OR E PROMPTLY AS NEEDED. INCE SHALL BE REMOVED AND NEVER SIGNIFICANT ACCUMULATION OCCURS. D IN PLACE UNIL COMPLETION OF OPE AREA HAS BEEN STABILIZED, N DIRECTED BY THE VILLAGE. NOT TO SCAL
POSTS WITH TIE-WIRES AT TOIL OVERLAP FILTER FABRIC BY 6". STRAW BALES MAY BE SUBSTIFE FAPROVED BY THE VILSTIFE FAPROVED BY THE VILSTIFE FAPROVED BY THE FILTER FAPROVED BY THE FEP FAMILY SHALL BE MADE FAMILY SHALL BE FAMILY SHALL BE MADE FAMILY SHALL BE FAMILY SHALL BE FAMILY SHALL BE FAMILY SHALL BY SHALL BE MADE FAMILY SHALL BE FAMILY SHALL BY SHALL BE MADE FAMILY SHALL BE FAMILY SHALL BE FAMILY SHALL BE FAMILY SHALL BY SHA	P AND MID-SECTION. AND FOLD WHERE 2 SECTIONS ADJOIN. UTED FOR THE FILTER FABRIC, ENGINEERING DIVISION HALL BE AT LEAST ONCE PER S IN EXCESS OF 1/2 ". REPAIR OR E PROMPTLY AS NEEDED. INCE SHALL BE REMOVED AND NEVER SIGNIFICANT ACCUMULATION OCCURS. DI IN PLACE UNIL COMPLETION OF OPE AREA HAS BEEN STABILIZED, IN DIRECTED BY THE VILLAGE. NOT TO SCAL
POSTS WITH TIE-WIRES AT TOIL OVERLAP FILTER FABRIC BY 6". STRAW BALES MAY BE SUBSTIFE FAPROVED BY THE VILSTIFE FAPROVED BY THE VILSTIFE FAPROVED BY THE FILTER FAPROVED BY THE FEP FAMILY SHALL BE MADE FAMILY SHALL BE FAMILY SHALL BE MADE FAMILY SHALL BE FAMILY SHALL BE FAMILY SHALL BE FAMILY SHALL BY SHALL BE MADE FAMILY SHALL BE FAMILY SHALL BY SHALL BE MADE FAMILY SHALL BE FAMILY SHALL BE FAMILY SHALL BE FAMILY SHALL BY SHA	P AND MID-SECTION. AND FOLD WHERE 2 SECTIONS ADJOIN. UTED FOR THE FILTER FABRIC, ENGINEERING DIVISION HALL BE AT LEAST ONCE PER S IN EXCESS OF 1/2 ". REPAIR OR E PROMPTLY AS NEEDED. INCE SHALL BE REMOVED AND NEVER SIGNIFICANT ACCUMULATION OCCURS. DI IN PLACE UNIL COMPLETION OF OPE AREA HAS BEEN STABILIZED, IN DIRECTED BY THE VILLAGE. NOT TO SCAL

AT 5' SPACING

	DOLAND
Ξij.	ENGINEERING, LLC -CYPL DELEGRANG - LAND SUMMERS 334 EAST COLPAK STREET, SUFFE C PALATINE, ILLINOIS GOOGT (447) 991-6080 (447) 934-3427 FAX unum delegranginering com

USER NAME:	DESIGNED:	REVISED:	
	DRAWN:	REVISED:	
PLOT SCALE: 1" = 20"	CHECKED:	REVISED:	
PLOT DATE:	DATE:	REVISED:	

STATE OF ILLINOIS
DEPARTMENT OF TRANSPORTATION

		F.A. RTE.	SECTION	COUNT	Y TOTAL SHEETS	SHEET NO.
	CONSTRUCTION DET		15-00127-00-DR	LAKE	12	12
		FED. ROAD DIS	ST. NO	ILLINOIS	FEDERAL AID PROJECT	
SCALE: N/A	SHEET NO. 12 OF 12 SHEETS			C	ONTRACT NO. 61	201