

0

0

PRIMERA ENGINEERS LTD. ORERT J. DEMING, P.E.

DATE: 02/02/2022

SIGNATURE AND SEAL APPLY TO DRAWINGS: 1-6

JOHN PERADOTTI, P.E., S.E. DATE: 02/02/2022 SIGNATURE AND SEAL APPLY TO DRAWINGS: 8-11



2021-131-1 COOK 13 1 CONTRACT NO. 62P53

DEPARTMENT OF TRANSPORTATION 06-17-2022 LETTING ITEM 234

FLUIDCLARITY LTD. EMILY BERGNER, P.E., CFM Emily Bergner EMILY R. BERGNER 062-059081 DATE: 02/02/2022 SIGNATURE AND SEAL APPLY TO DRAWINGS: 7 EXPIRES: 11/30/2023

PROPOSED HIGHWAY PLANS

STATE OF ILLINOIS


FAU 2690 **WOLF ROAD OVER ADDISON CREEK SECTION 2021-131-1 CULVERT WINGWALL REPAIRS (S.N. 016-2423) COOK COUNTY**

C-91-004-22

PROJECT IS LOCATED IN THE CITY OF NORTHLAKE IN COOK COUNTY

FOR INDEX OF SHEETS, SEE SHEET NO. 2

TRAFFIC DATA: FUNCTIONAL CLASSIFICATION MAJOR COLLECTOR 2018 ADT = 11300SPEED LIMIT = 30 MPH

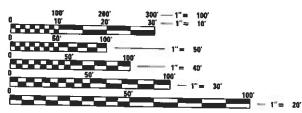

ENGINEERING SCALES. REDUCED SIZED PLANS WILL NOT CONFORM TO STANDARD SCALES. IN MAKING MEASUREMENTS ON REDUCED PLANS, THE ABOVE SCALES MAY BE USED.

J.U.L.J.E. JOINT UTILITY LOCATION INFORMATION FOR EXCAVATORS 1-800-892-0123 OR 811


PROJECT ENGINEER

PRAVEEN KAINI, PE (847) 705-4237

PROJECT MANAGER

(847) 221-3056

CONTRACT NO. 62P53

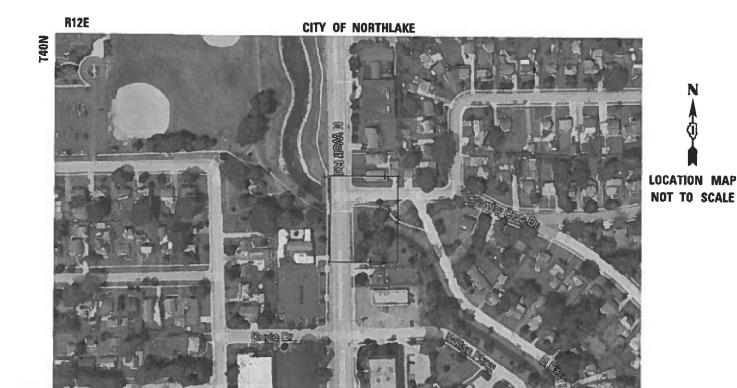




GROSS LENGTH = 200 FT. = 0.038 MILE NET LENGTH = 200 FT. = 0.038 MILE



GONZALEZ COMPANIES, LLC 525 WEST MAIN STREET SUITE 125 BELLEVILLE, IL 62120 WWW.GONZALEZCOS.COM ILLINOIS PROFESSIONAL DESIGN FIRM 184.00456

Muiddarim



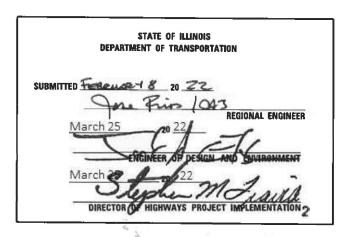

PRINTED BY THE AUTHORITY OF THE STATE OF ILLINOIS

INDEX OF SHEETS

- COVER SHEET
- GENERAL NOTES & STANDARDS
- SUMMARY OF QUANTITIES
- ALIGNMENT, TIES & BENCHMARKS REMOVAL PLANS
- ROADWAY PLANS
- SOIL EROSION AND SEDIMENT CONTROL PLAN AND SCOUR PLAN
- STRUCTURAL PLANS
- 12-13 DISTRICT 1 STANDARD DETAILS

HIGHWAY STANDARDS

000001-08 STANDARD SYMBOLS, ABBREVIATIONS AND PATTERNS 001006 DECIMAL OF AN INCH AND OF A FOOT TEMPORARY EROSION CONTROL SYSTEMS 280001-07 701001-02

OFF-RD OPERATIONS, 2L, 2W, MORE THAN 15' AWAY OFF-RD OPERATIONS, 2L, 2W, 15' TO 24" FROM PAVEMENT EDGE
OFF-RD OPERATIONS, MULTILANE, 15' TO 24" FROM PAVEMENT EDGE 701006-05

701101-05 701301-04 LANE CLOSURE, 2L, 2W, SHORT TIME OPERATIONS

701501-06 URBAN LANE CLOSURE, 2L, 2W, UNDIVIDED

URBAN LANE CLOSURE, MULTILANE, 1W OR 2W WITH NONTRAVERSABLE MEDIAN 701601-09 701701-10 URBAN LANE CLOSURE, MULTILANE INTERSECTION

SIDEWALK, CORNER OR CROSSWALK CLOSURE 701801-06

701901-08 TRAFFIC CONTROL DEVICES

DISTRICT ONE STANDARD DETAILS

TRAFFIC CONTROL AND PROTECTION FOR SIDE ROADS, INTERSECTIONS, AND DRIVEWAYS TC-10 TC-22 ARTERIAL ROAD INFORMATION SIGN

GENERAL NOTES

ALL CONSTRUCTION WORK SHALL BE PERFORMED IN ACCORDANCE WITH THE APPLICABLE SECTIONS OF THE ILLINOIS DEPARTMENT OF TRANSPORTATION "STANDARD SPECIFICATIONS FOR ROAD AND BRIDGE CONSTRUCTION" OF THE JANUARY 1, 2022 EDITION, SUPPLEMENTAL SPECIFICATIONS AND RECURRING SPECIAL PROVISIONS AND SPECIAL PROVISIONS OF THE BUREAU OF DESIGN AND ENVIRONMENT. ANY REFERENCE TO A STANDARD IN THESE PLANS SHALL BE INTERPRETED TO MEAN THE IANUARY 1 2022 EDITION

THE CONTRACTOR SHALL CONTACT J.U.L.I.E. AT LEAST 48 HOURS PRIOR TO EXCAVATION TO DETERMINE WHICH UTILITIES ARE IN THE AREA.

THE CONTRACTOR SHALL BE RESPONSIBLE FOR COLLECTING AND MAINTAINING AN ELECTRONIC LOG OF ALL STAKEOUT SURVEY THAT IS PERFORMED ON THE JOB, EITHER BY HIM/HER OR ANY SUB-CONTRACTOR PERFORMING THE STAKEOUT, UPON REQUEST, ALL LOGS SHALL BE SUBMITTED TO THE DEPARTMENT. NO ADDITIONAL COMPENSATION WILL BE ALLOWED FOR THIS WORK, BUT SHALL BE CONSIDERED INCIDENTAL TO THE CONTRACT.

THE CONTRACTOR SHALL USE CARE IN THEIR CONSTRUCTION OPERATIONS NEAR ANY EXISTING ITEMS THAT WILL NOT BE REMOVED. ANY DAMAGE DONE TO EXISTING ITEMS BY THE CONTRACTOR SHALL RE REPAIRED OR BE REPLACED AT THE CONTRACTOR'S OWN EXPENSE TO THE SATIFICATION OF THE ENGINEER

THE CONTRACTOR SHALL REFER TO THE SPECIAL PROVISION FOR STRUCTURAL ASSESSMENT REPORTS FOR CONTRACTOR'S MEANS AND METHODS WHEN FORMULATING A WORK PLAN THAT INVOLVES LOADS

THE CONTRACTOR IS TO REFER TO THE SPECIAL PROVISION FOR SAW CUTTING CONTRACTION JOINTS IN P.C.C. SIDEWALKS. NO TOOLED JOINTS WILL BE ALLOWED.

IT SHALL BE THE CONTRACTORS RESPONSIBILITY TO VERIFY ALL DIMENSIONS AND CONDITIONS EXISITNG IN THE FIELD PRIOR TO CONSTRUCTION AND ORDERING OF MATERIALS.

SEEDING WILL NOT BE PERMITTED AT ANY TIME WHEN THE GROUND IS FROZEN, WET, OR IN AN UNTILLABLE CONDITION, LOCATIONS TO BE SEEDED WILL BE DETERMINED BY THE ENGINEER.

BEFORE BEGINNING ANY WORK, THE CONTRACTOR SHALL RETAIN AND RECORD FOR FUTURE REFERENCE, ALL EXISTING PAVEMENT MARKING LINES AND RAISED REFLECTIVE PAVEMENT MARKERS THAT CONFLICT WITH TEMPORARY MARKINGS, IN ORDER THAT THESE LOCATIONS CAN BE RE-ESTABLISHED FOR PROPOSED STRIPING AT THE COMPLETION OF THIS CONTRACT. EXACT LOCATIONS OF ALL PROPOSED PAVEMENT MARKINGS SHALL BE DIRECTED BY THE RESIDENT ENGINEER.

THE CONTACTOR WILL NOT BE ABLE TO SET UP A YARD OR FIELD OFFICE ON STATE PROPERTY WITHOUT WRITTEN PERMISSION FROM THE DEPARTMENT

IT SHALL BE THE CONTRACTORS RESPONSIBILITY TO VERIFY ALL DIMENSIONS AND CONDITIONS EXISTING IN THE FIELD PRIOR TO CONSTRUCTION AND ORDERING MATERIALS.

ALL DAMAGE TO EXISTING MARKINGS OR BAISED REFLECTIVE PAVEMENT MARKERS OUTSIDE THE REMOVAL LINE SHOWN ON THE PLANS SHALL BE REPLACED AT NO ADDITIONAL COST TO THE

THE CONTRACTOR SHALL ACCESS THE PROJECT SITE FROM NORTH AVENUE, NORTH ON WOLF ROAD UP TO COUNTRY CLUB DRIVE, AND SHALL NOT BE ALLOWED NORTH OF THE INTERSECTION OF WOLF ROAD AND COUNTRY CLUB DRIVE DUE TO TRUCK RESTRICTIONS ON WOLF ROAD FROM THE CITY OF NORTHLAKE.

GENERAL NOTES

THE CONTRACTOR SHALL USE CARE NEAR ANY AND ALL EXISTING ITEMS THAT WILL NOT BE REMOVED. ANY DAMAGE DONE TO EXISTING ITEMS BY THE CONTRACTOR SHALL BE REPAIRED OR REPLACED TO THE SATISFACTION OF THE ENGINEER AT THE CONTRACTOR'S OWN EXPENSE.

THE CONTRACTOR SHALL TAKE CARE NOT TO DAMAGE THE CITY OF NORTHLAKE'S EXISTING IRRIGATION SYSTEM AND ORNAMENTAL LIGHTING SYSTEM LOCATED IN THE SOUTH PARKWAY OF COUNTRY CLUB DRIVE.

DO NOT SCALE PLANS FOR CONSTRUCTION DIMENSIONS.

DURING CONSTRUCTION OPERATIONS, IF ANY LOOSE MATERIAL IS DEPOSITED IN THE FLOW LINE OF DRAINAGE STRUCTURES SUCH THAT THE NATURAL FLOW OF WATER IS OBSTRUCTED, THE MATERIAL SHALL BE REMOVED AT THE CLOSE OF EACH WORKDAY. AT THE CONCLUSION OF CONSTRUCTION OPERATIONS, ALL UTILITY STRUCTURES SHALL BE FREE FROM DUST AND DEBRIS. THE WORK SPECIFIED ABOVE WILL NOT BE PAID SEPARATELY BUT SHALL BE INCLUDED IN THE COST OF

THE SUBGRADE STABILITY SHALL BE VERIFIED BY STATIC CONE PENETROMETER (SCP) OR DYNAMIC CONE PENETROMETER (DCP) IN THE FIELD DURING CONSTRUCTION BY THE ENGINEER.

THE STRIPPED TOPSOIL SHALL BE STOCKPILED, SORTED, AND REUSED FOR THE PROPOSED LANDSCAPING IMPROVEMENTS, THE ACTUAL REMOVAL DEPTH AND QUANTITY OF TOPSOIL REMOVAL SHALL BE VERIFIED IN THE FIELD.

LANDSCAPING AND EROSION CONTROL QUANTITIES ARE ONLY ESTIMATED AND EXACT QUANTITY WILL BE DETERMINED UPON THE SIZE OF AREA DISTURBED

BACKFILLING STORM SEWER CONSTRUCTED UNDER THE ROADWAY SPECIFICED UNDER ART. 550.071b. c) OF THE SSRBC WILL NOT BE ALLOWED.

COMMITMENTS:

NONE

ILLINOIS DEPARTMENT OF TRANSPORTATION

- THE CONTRACTOR SHALL CONTACT THE DISTRICT ONE TRAFFIC CONTROL SUPERVISOR AT KALPANA, KANNAN-HOSADURGA@ILLINOIS.GOV A MINIMUM OF 72 HOURS INADVANCE OF BEGINNING WORK
- THE CONTRACTOR SHALL CONTACT THE CITY OF NORTHLAKE A MINIMUM OF 72 HOURS IN ADVANCE OF BEGINNING WORK.



	USER NAME = rvandermus	DESIGNED	-	RM/RMV	REVISED -
		DRAWN	-	RM/RMV	REVISED -
l	PLOT SCALE = 2.0000 / in	CHECKED	-	MPV	REVISED -
i	PLOT DATE = 3/11/2022	DATE	-	07/07/2021	REVISED -

SCALE:

	STANDA	ARDS A	ND GEN	NERAL NO	TES	F.A.U. RTE	SEC	TION		COUNTY	TOTAL SHEETS	SHEET NO.
v	VOLF ROAD	RRING	F OVER	ADDISON	CREEK	2690	2021	-131-I		COOK	13	2
_ •	VOLI HOAD	טטווט	L OVEN	ADDIOUN	UNLEK					CONTRACT	NO. 62	2P53
	SHEET	OF	SHEETS	STA.	TO STA.			THINOIS	FED A	D PROJECT		

				ľ	CONSTRUCTION CODE			
				ļ	BRIDGE 0013			
				İ	100% STATE			
	CODE NO.	ITEM	UNIT	TOTAL QUANT I TY URBAN	WOLF RD			
	20101000	TEMPORARY FENCE	FOOT	220	220			
	20700220	POROUS GRANULAR EMBANKMENT	CU YD	90.0	90.0			
	25000300	SEEDING, CLASS 3	ACRE	0.25	0.25			
	21101615	TOPSOIL FURNISH AND PLACE 4"	SQ YD	120	120			
İ	28000305	TEMPORARY DITCH CHECKS	FOOT	70	70			
	28100101	STONE RIPRAP, CLASS A1	SQ YD	158	158			
	28200200	FILTER FABRIC	SQ YD	45	45			
-	42400200	PORTLAND CEMENT CONCRETE SIDEWALK 5 INCH	SQ FT	200	200			
Ì	44000600	SIDEWALK REMOVAL	SQ FT	200	200			
	50102400	CONCRETE REMOVAL	CU YD	13.1	13.1			
	50200100	STRUCTURE EXCAVATION	CU YD	119.0	119.0			
	50900805	PEDESTRIAN RAILING	FOOT	47	47			
	550A0090	STORM SEWERS, CLASS A, TYPE 1 18"	FOOT	8	8			
	55100900	STORM SEWER REMOVAL 18"	FOOT	8	8			
	67100100	MOBILIZATION	L SUM	1	1			
ĸ	66900200	NON-SPECIAL WASTE DISPOSAL	CU YD	105	105			
k	66901001	REGULATED SUBSTANCE PRE-CONSTRUCTION PLAN	L SUM	1	1			
	66900530	SOIL DISPOSAL ANALYSIS	EACH	1	1			
- 1	66901003 66901006	REGULATED SUBSTANCES FINAL CONSTRUCTION REPORT REGULATED SUBSTANCES MONITORING	L SUM CAL DA	1 4	1 4			
	70102630	TRAFFIC CONTROL AND PROTECTION, STANDARD 701601	L SUM	1	1			
	70102640	TRAFFIC CONTROL AND PROTECTION, STANDARD 701801	L SUM	1	1			
-	F30170Y2	SEEDLING-SALIX NIGRA (BLACK WILLOW), 2-YEAR OLD, BARE ROOT	UNIT	0.5	0.5			
İ	G20030Y2	SEEDLING-CORNUS AMOMUM (SILKY DOGWOOD), 2-YEAR OLD, BARE ROOT	UNIT	0.5	0.5			
	X0900075	COFFERDAM (TYPE 1) (IN-STREAM/WETLAND WORK)	EACH	1	1			
-	X2510635	HEAVY DUTY EROSION CONTROL BLANKET, SPECIAL	SQ YD	45	45			
-	X5040050	PRECAST CONCRETE SUBSTRUCTURE	L SUM	1	1			
-	X6640300	CHAIN LINK FENCE REMOVAL	FOOT	51	51			
	X6700407	ENGINEER'S FIELD OFFICE, TYPE A (D1)	CAL MO	12	12			
-	Z0012754	STRUCTURAL REPAIR OF CONCRETE (DEPTH EQUAL TO OR LESS THAN 5 INCHES)	SQ FT	50	50			
	Z0012755	STRUCTURAL REPAIR OF CONCRETE (DEPTH GREATER THAN 5 INCHES)	SQ FT	10	10			
	Z0030850	TEMPORARY INFORMATION SIGNING	SQ FT	26	26			
		7						
-								
Ĺ								

* SPECIALTY ITEM


Primera
SO NU JACKSON BUYD. SUITE 600 . CHICAGO IL GORGI P-272-405-4915 P372-405-4415


USER NAME = rvandermus	DESIGNED		RM/RMV	REVISED	=
	DRAWN	2	RM/RMV	REVISED	2
PLOT SCALE = 2.0000 / in.	CHECKED		MPV	REVISED	+)
PLOT DATE = 2/10/2022	DATE	*	07/07/2021	REVISED	÷
-	PLOT SCALE = 2.0000 // in.	DRAWN PLOT SCALE = 2.0000 / in. CHECKED	DRAWN PLOT SCALE = 2.0000 / in.	DRAWN = RM/RMV PLOT SCALE = 2.0000 / in. CHECKED = MPV	DRAWN - RM/RMV REVISED PLOT SCALE = 2.0000 / in. CHECKED - MPV REVISED

STATE OF ILLINOIS DEPARTMENT OF TRANSPORTATION

SCALE:

	90				
SUMMARY OF QUANTITIES	F.A.U. RTE.	SECTION	COUNTY	TOTAL	SHEET NO.
WOLF ROAD BRIDGE OVER ADDISON CREEK	2690	2021-131-I	соок	13	3
TOOL HOAD BIIIDGE OVER ADDIOUT CHEEK			CONTRACT	NO. 62	P53
SHEET OF SHEETS STA. TO ST	Α.	LILLINOIS FED. A	D PROJECT		

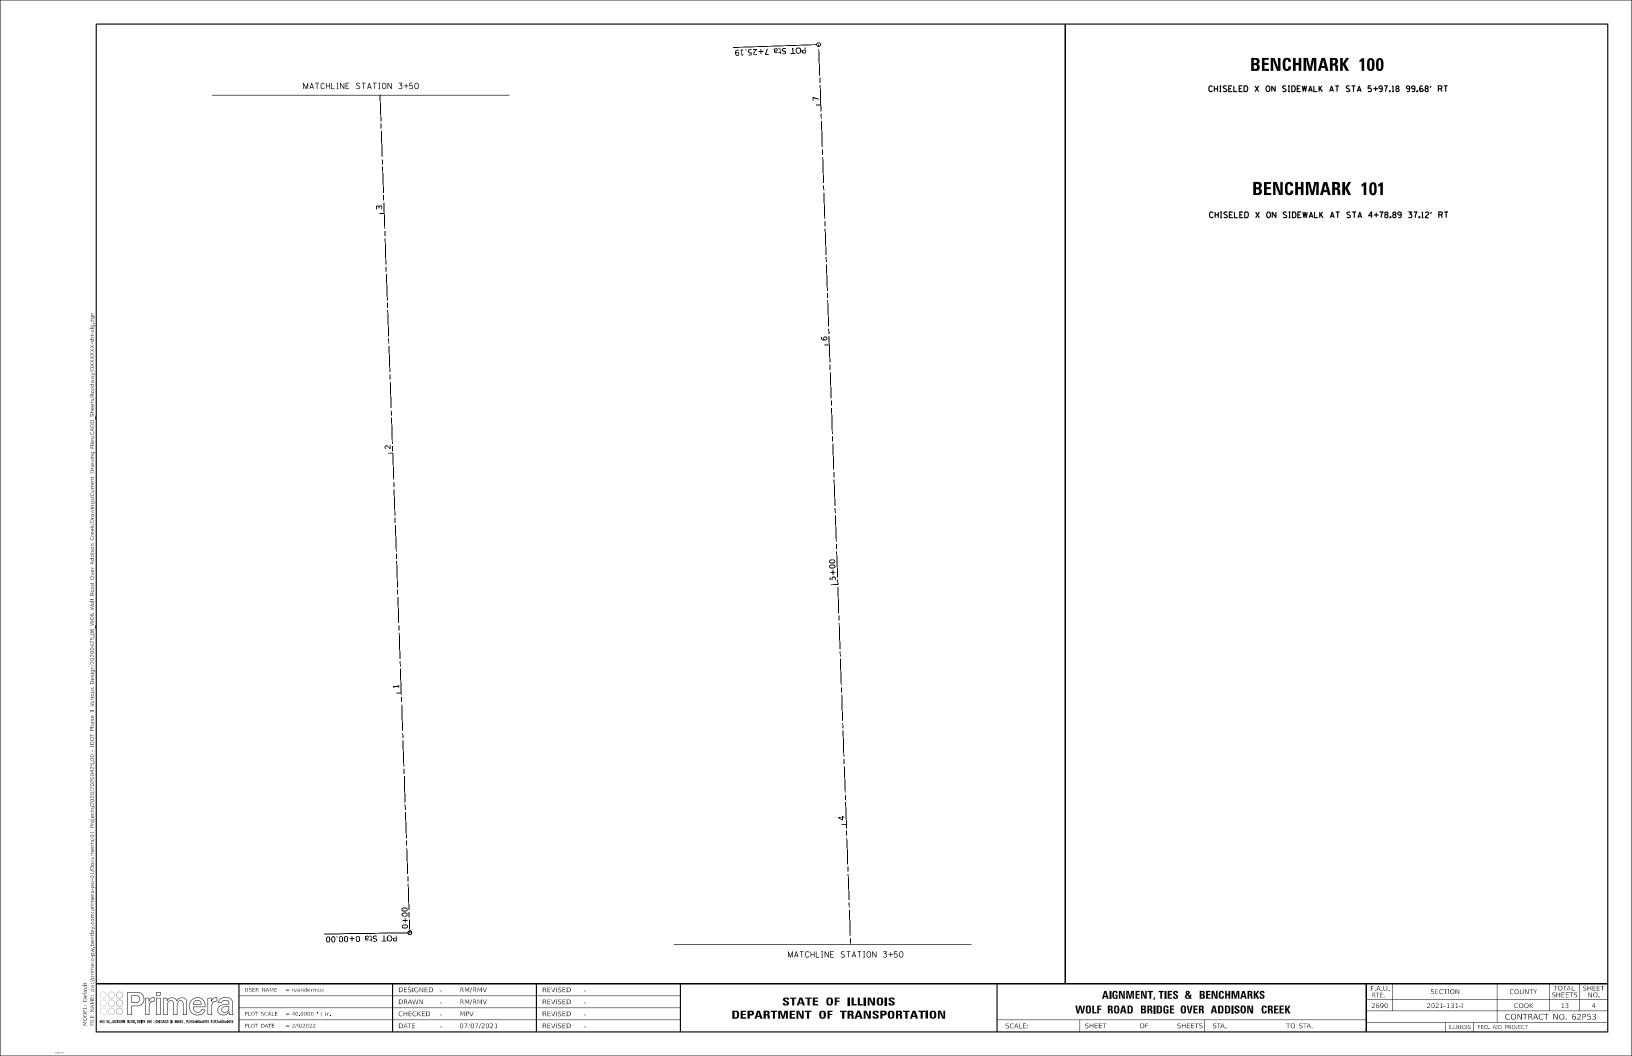

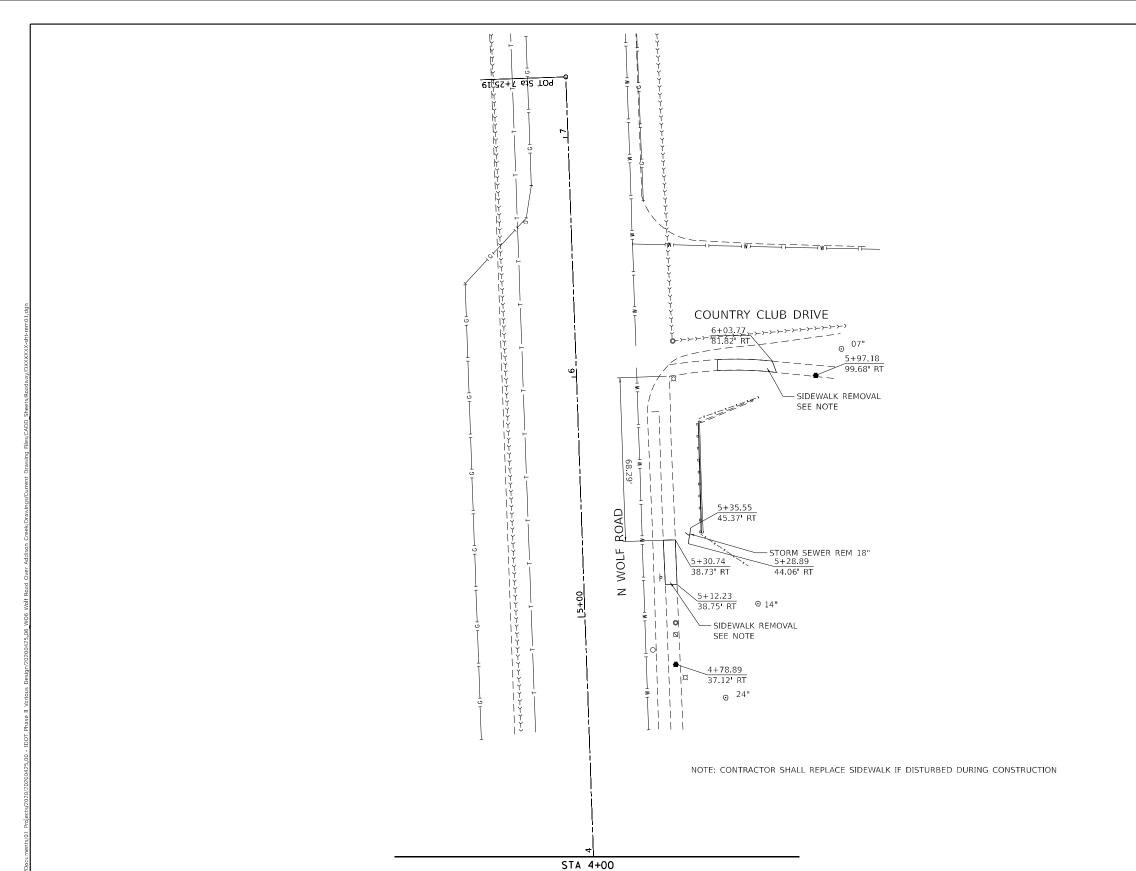


	USER NAME = rvandermus	DESIGNED - RM/RMV	REVISED -					IOVAL PL			F.A.U. RTE	SECTION
nera		DRAWN - RM/RMV	REVISED -	STATE OF ILLINOIS		MOLE BOA				DEEK	2690	2021-131-I
	PLOT SCALE = 40.0000 ' / in.	CHECKED - MPV	REVISED -	DEPARTMENT OF TRANSPORTATION		WULF KUA	n RKING	JE UVEK	ADDISON C	KEEK		
JL 60561 , P.312-606-0910 F.312-606-0415	PLOT DATE = 2/9/2022	DATE - 07/07/2021	REVISED -		SCALE:	SHEET	OF	SHEETS	STA.	TO STA.		ILLINOIS FE

COUNTY

COUNTY SHEETS NO.

COOK 13 5

CONTRACT NO. 62P53

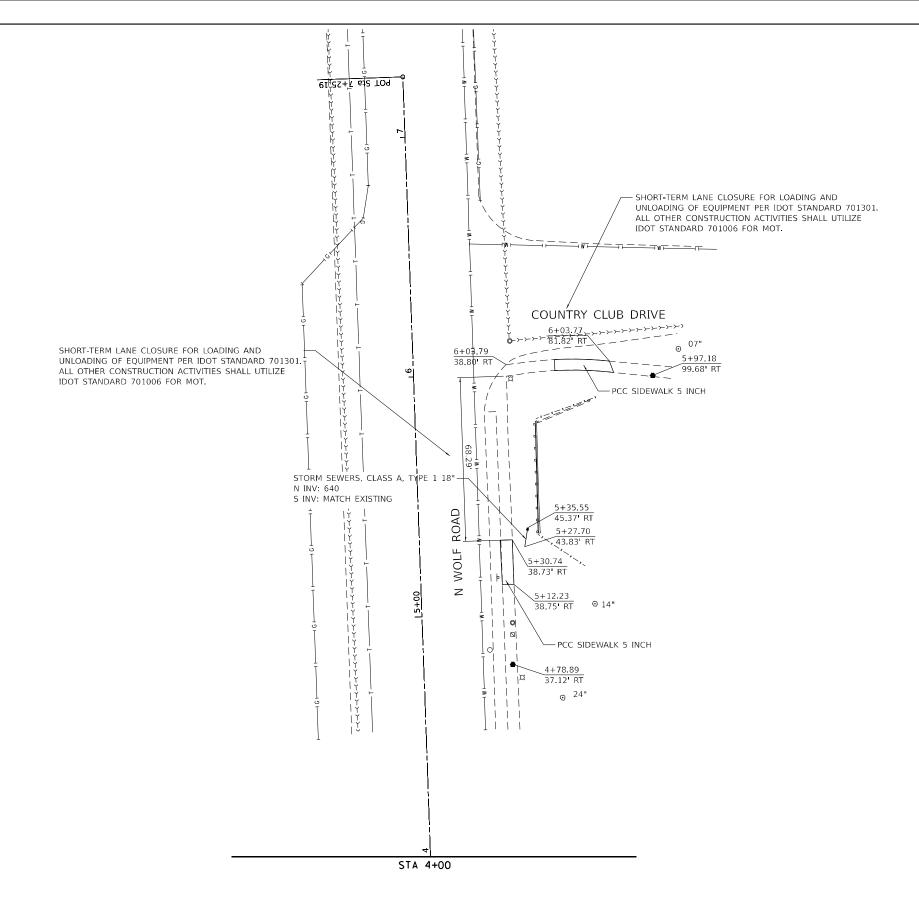

5.		
MIL.	Drimara	Γ
Ž		Г
i	550 W. JACKSON BLYD, SUITE 600 CHICAGO IL 60861 P.312-608-0910 P.312-608-0415	H

	USER NAME = rvandermus	DESIGNED -	RM/RMV	REVISED -
١		DRAWN -	RM/RMV	REVISED -
l	PLOT SCALE = 40.0000 / in.	CHECKED -	MPV	REVISED -
15	PLOT DATE = 3/10/2022	DATE -	07/07/2021	REVISED -


STATE 0	F ILLINOIS
DEPARTMENT OF	TRANSPORTATION


SCALE:


		ROAD	WAY P	LAN		F.A.U. RTE	SECTION		COUNTY	TOTAL SHEETS	SHEET NO.
WOLF ROAD BRIDGE OVER ADDISON CREEK					2690	2021-131-I		COOK	13	6	
VVOL	ווטאט	טטוווט	L OVEN	ADDIOUN	UILLK				CONTRACT	NO. 62	2P53
SHE	ET	OF	SHEETS	STA.	TO STA.		ILLINOIS	FED. A	D PROJECT		


EROSION CONTROL NOTES:

- 1. STREAMBANK SLOPE DISTURBED BY WINGWALL INSTALLATION SHALL BE COVERED WITH HEAVY DUTY EROSION CONTROL BLANKET, SEEDED WITH CLASS 3 SEEDING, AND HAVE (G20030Y2) SEEDLING CORNUS AMOMUM (SILKY DOGWOOD), 2-YEAR OLD, BARE ROOT AND (F30170Y2) SEEDLING, SALIX NIGRA (BLACK WILLOW), 2-YEAR OLD, BARE ROOT. PLANT MATERIAL SHALL ONLY BE PLACED IN AREAS OF SLOPE DISTURBANCE IN ADDITION TO SEEDING, CLASS 3. QUANTITIES ARE ONLY ESTIMATED AND EXACT QUANTITIY WILL BE DETERMINED UPON THE SIZE OF AREA DISTURBED.
- 2. GRASSED AREAS DISTURBED BY CONSTRUCTION (OTHER THAN STREAMBANK SLOPES) SHALL BE SODDED WITH SALT TOLERANT SODDING.
- 3. CONTRACTOR IS RESPONSIBLE FOR MAINTENANCE/REPAIR OF EROSION CONTROL MEASURES UNTIL ADEQUATE VEGETATION GROWTH HAS OCCURRED.
- 4. TEMPORARY DITCH CHECKS SHALL BE INSTALLED ACROSS THE ENTIRE CHANNEL AT 50' AND 70' DOWNSTREAM (EAST) OF THE EAST CULVERT FACE, PER THE DETAIL.

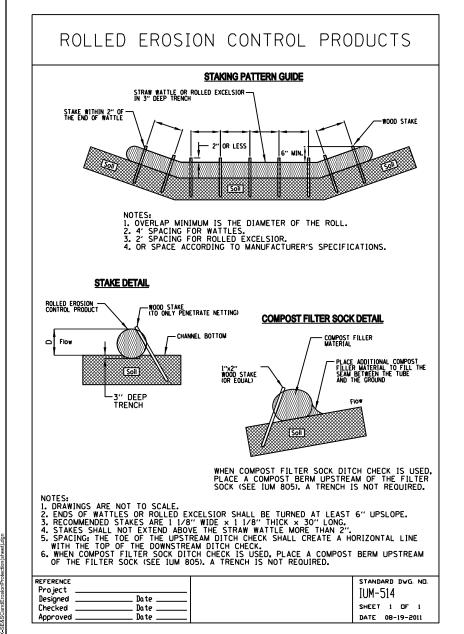

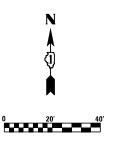


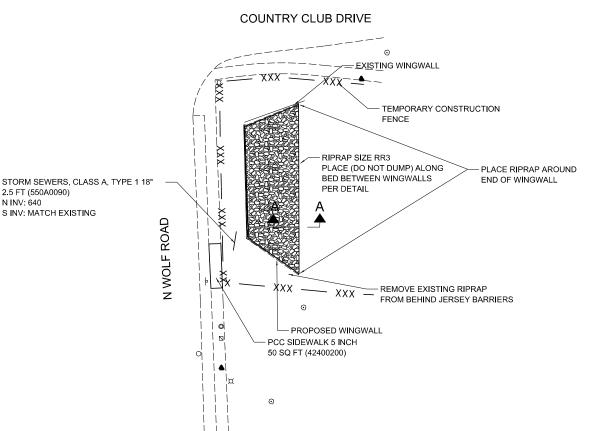

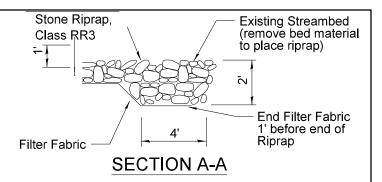

CHANNEL RIPRAP INSTALLATION DETAIL

(NTS)

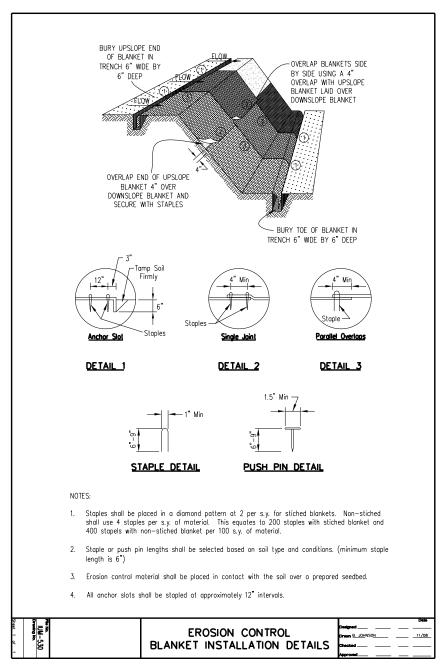


Middarity

STATE OF ILLINOIS
DEPARTMENT OF TRANSPORTATION

SOIL EROSION AND SEDIMENT CONTROL PLAN AND SCOUR PLAN WOLF ROAD BRIDGE OVER ADDISON CREEK

SCALE: 1"=20' SHEET OF SHEETS STA. TO STA.

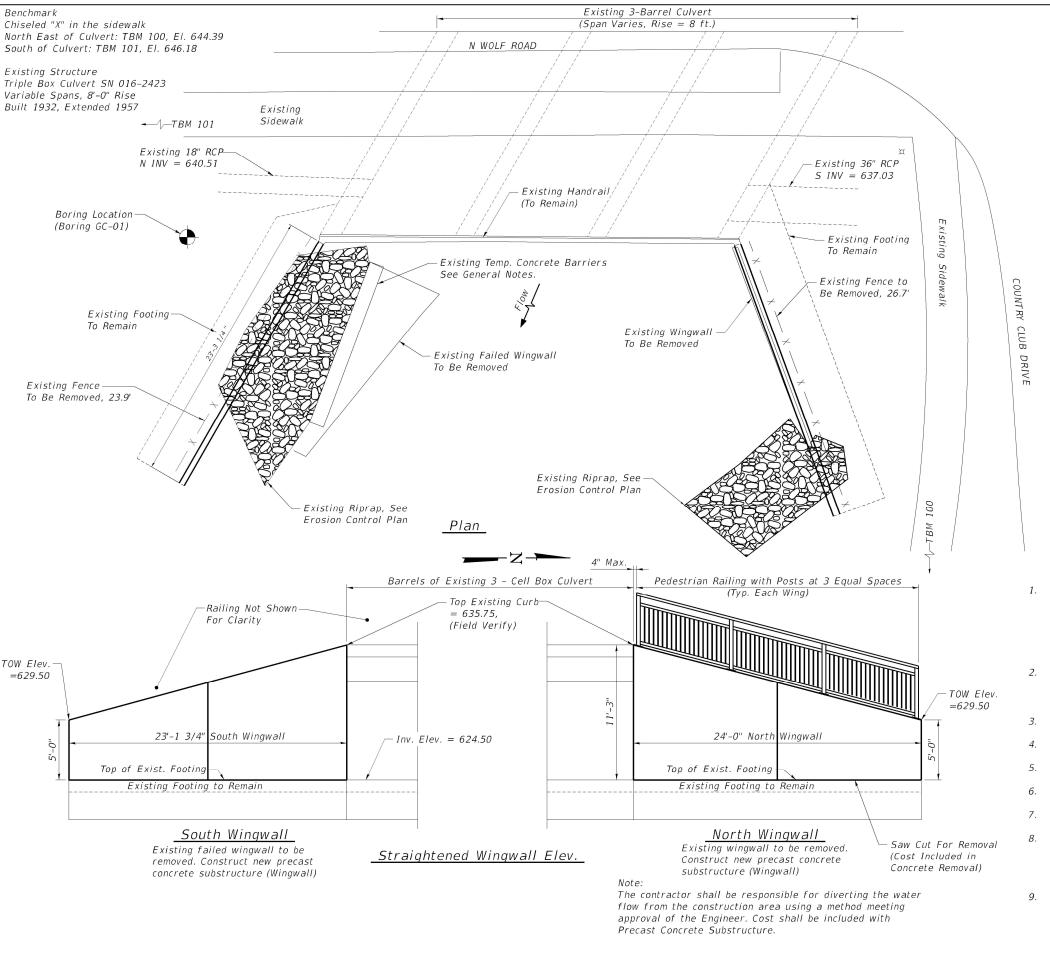

GONZALEZ COMPANIES, LLC

SALEM, IL 62881

_qonzalez

DESIGNED - JSP

CHECKED - GLH

DATE - 02/09/2022

KMA/JMV

REVISED -

REVISED -

REVISED -

REVISED

TOTAL BILL OF MATERIAL

ITEM	UNIT	TOTAL
Porous Granular Embankment	Cu Yd	90
Concrete Removal	Cu Yd	13.1
Structure Excavation	Cu Yd	119
Pedestrian Railing	Foot	47
* Precast Concrete Substructure	L Sum	1
* Chain Link Fence Removal	Foot	51
* Structural Repair of Concrete (Depth Equal To or Less than 5 inches)	Sq Ft	50.0
* Structural Repair of Concrete (Depth Greater than 5 inches)	Sq Ft	10.0

* See Special Provisions

DESIGN SPECIFICATIONS

2020 AASHTO LRFD Bridge Design Specifications, 9th Edition

DESIGN STRESSES

FIELD UNITS

f'c = 3.500 psi


fy = 60,000 psi (Reinforcement)fy = 50,000 psi (AASHTO M270 Grade 50)

PRECAST UNITS

f'c = 5.000 psi

fy = 60,000 psi (Reinforcement)

fy = 65,000 psi (WWR)

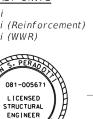

Range 12 E, 3rd P.M.

LOCATION SKETCH

-Project

Location

John S. Peradotti Salem, Illinois Illinois Licensed Structural Engineer No. 081-005671 Expires Nov. 30, 2022 Date Signed Jan. 25, 2022

GENERAL NOTES

- 1. Plan dimensions and details relative to the existing plans are subject to nominal construction variations. The Contractor shall field verify existing dimensions and details affecting new construction and make necessary approved adjustments prior to construction or ordering materials. Such variations shall not be cause for additional compensation for a change in scope of the work. However, the Contractor will be paid for the quantity actually furnished at the unit price bid for the work.
- The Contractor shall take extra care during removal of the existing wingwall adjacent to existing culvert and storm sewer as to not damage or undermine the existing foundation(s).
- 3. All exposed concrete edges shall be chamfered $\frac{3}{4}$ " except where noted.
- All structural steel shall conform to the requirements of AASHTO M270 Grade 50.
- Refer to Structure Geotechnical Report for site preparation and backfilling.
- See Erosion Control Sheets for Layout of the Slope Protection System.
- See Erosion Control Plan for Riprap placement (existing and proposed).
- The existing concrete barriers shall be removed, salvaged and placed within the ROW. The IDOT District 1 maintenance department shall be contacted for removal and possession. The cost for this work shall be included in the cost per Cubic Yard for Concrete Removal.
- Removal of existing wingwall shall be measured and payed for as concrete removal.

STATE OF ILLINOIS **DEPARTMENT OF TRANSPORTATION** **GENERAL PLAN AND ELEVATION** BRIDGE SHEET 1 OF 4

SECTION COUNTY 2690 2021-13-I COOK 13 8 CONTRACT NO. 62P53




The Existing Footings shall be repaired as directed by Engineer and paid for as Structural Repair of Concrete.

Quantity of Concrete Repair shown is estimated, actual areas shall be determind by Engineer in field.

Drill and epoxy grout anchors in accordance with Section 584 of the IDOT Standard Specifications.

Temporary shoring may be required to protect existing utilities as directed by Engineer, Cost included in the Price of Precast Concrete Substructure.

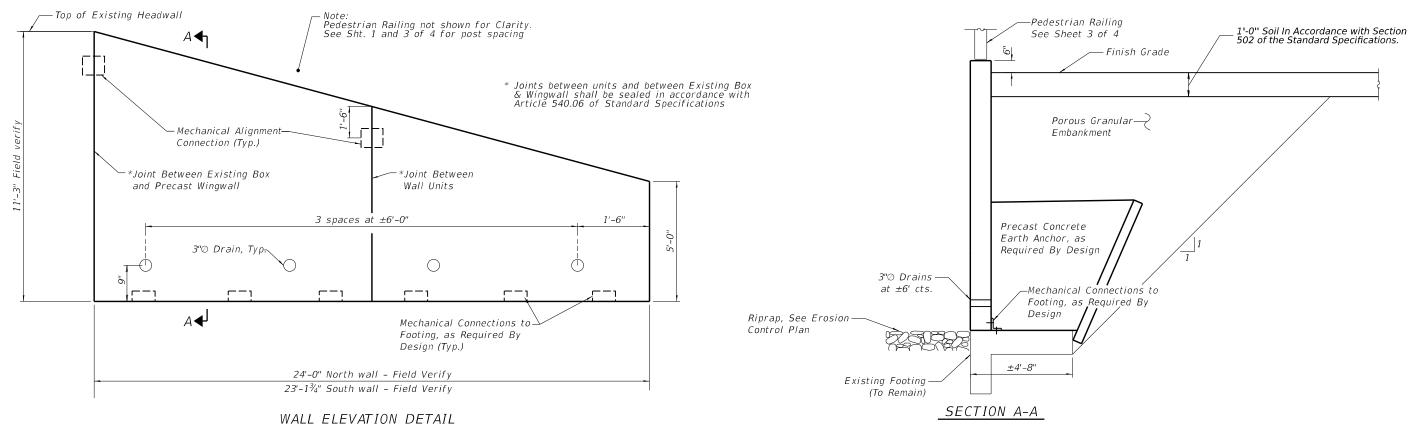

WALL ELEVATION DETAIL North Wingwall Shown, South Wingwall Similar

BILL OF MATERIAL

Item	Unit	Quantity	
Precast Concrete Substructure	L Sum	1	
Structural Repair of Concrete (Depth Equal to or Less than 5 in.)	Sq Ft	50.0	
Structural Repair of Concrete (Depth Greater than 5 in.)	Sq Ft	10.0	

_gonzalez

GONZALEZ COMPANIES, LLC
7 CARPENTER DRIVE
SALEM, IL 62881
PHONE (618) 222-2221
www.gonzalezoszom
LLINOS POPOESSIONAL DESIGNO FIRM 184,004564

 DESIGNED JSP
 REVISED

 CHECKED GLH
 REVISED

 DRAWN KMA/JMW
 REVISED


 DATE 02/09/2022
 REVISED


STATE OF ILLINOIS
DEPARTMENT OF TRANSPORTATION


WINGWALL DETAILS


BRIDGE SHEET 2 OF 4

| FAU. | SECTION | COUNTY | TOTAL | SHEET | NO. 20-1142 | SHEET | NO. 20-1142 | SHEET | NO. 20-1142 | SHEET | NO. 20-1142 | SHEET | NO. 20-1142 | SHEET | NO. 20-1142 | SHEET | NO. 20-1142 | SHEET | NO. 20-1142 | SHEET | NO. 20-1142 | SHEET | NO. 20-1142 | SHEET | SHEET 
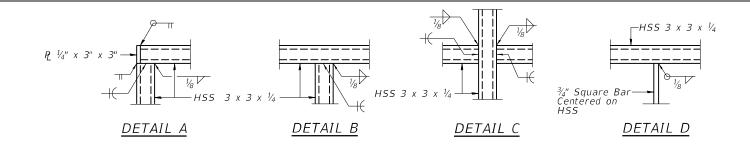

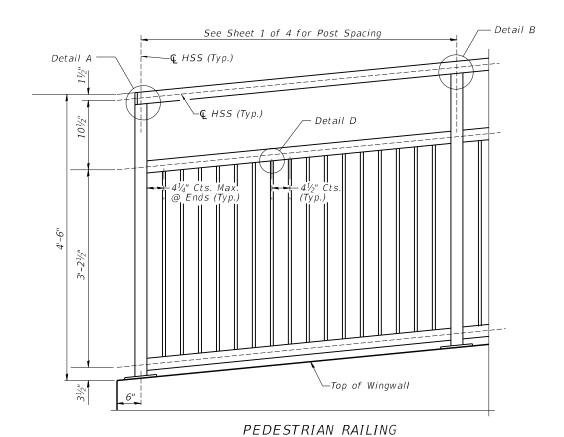

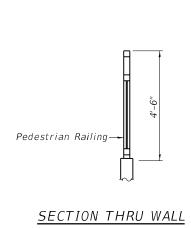

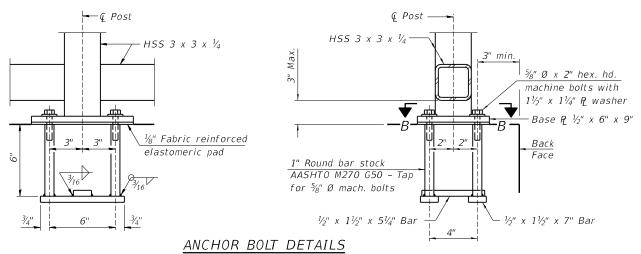


In lieu of the cast-in-place anchor device shown, the Contractor has the option of drilling and setting $\frac{5}{8}$ " Ø anchor rods according to Article 509.06 of the Standard Specifications. Embedment shall be according to the manufacturer's specifications for the full capacity of the anchor.

Notes:

Place reinforcement bars to miss anchor rod locations. CVN testing is not required for the HSS tubing used in the Bycycle Railing.

All steel rail elements shall be galvanized according to Article 509.05 of the Standard Specifications. All picket / post Elements Shall be Vertical and Plumb when erected.

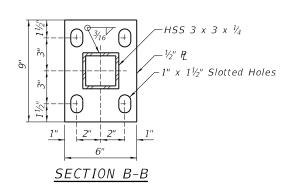

BILL OF MATERIAL

Item	Unit	Quantity
Pedestrian Railing	Foot	47



GONZALEZ COMPANIES, LLC
7 CARPENTER DRIVE
SALEM, IL 62881
PHONE (618) 222-2221
www.gonzalezos.com
ILLINOIS PROFESSIONAL DESIGN FIRM 184,004564

DESIGNED	-	JSP	REVISED	-
CHECKED	-	GLH	REVISED	-
DRAWN	-	KMA/JMW	REVISED	-
DATE	-	02/09/2022	REVISED	-

STATE OF ILLINOIS
DEPARTMENT OF TRANSPORTATION

PEDESTR	IAN	I RAI	LIN	G DETAILS	
BRIDGE SHEET	3	OF	4		

				GCL Job No.	20-114-06		
LU.	SECTION		COUNTY	TOTAL SHEETS	SHEET NO.		
90	2021-13-I	COOK 13 1					
CONTRACT NO. 62P53							
	ILLINOIS	FED A	D PRO IECT				



SECTION: COUNTY: STRUCT. NO.:

STATION & OFFSET:

VERTICAL DATUM:

SURFACE ELEV.:

LAT/LONG:

LOCATION:

SOIL BORING LOG

Log of Boring GC-01 Sheet 1 of 2

FAU2688 (Wolf Road)	DESCRIPTION:
TAO2000 (WOII NOBU)	DRILLER:
Cook	DRILLED BY:
016-2423	DRILL RIG TYPE:
,	DRILLING METHOD:
645.5 ft	SAMPLING METHOD:
NAVD83	HAMMER TYPE:
41.910181, -87.903129	HAMMER EFFICIENC
Over Addison Creek	REMARKS:

	Wolf Road over Addison Cree	k					
	Rubino Engineering, Inc.	DATE(S) DRILLED:	08/13/2021 to 08/13/2021				
	Joe Kenny	LOGGED BY:	Nikki Kurfman (Gonzalez)				
	Geoprobe 7822DT	BACKFILL:	Backfilled with auger cuttings.				
:	3-1/4" hollow stem auger	Ground Water Observation(s):					
):		First Encounter:	16.30 ft				
	Auto Hammer (140 lb)	Upon Completion:	32.00 ft				
CY:	88.8 %	After Drilling:					
	Gonzalez Project No. 20-114-	06	<u> </u>				

Material Description Material Description	Flevation (ft): 645.5	Sample Number	Recovery, in. (%)	Sampling Resist. Or Core RQD(%)	Rimac, Qu (tsf)	Pocket Pen. Qu (tsf)	Moisture Content (%)	Dry Unit Weight (pcf)	Liquid _imit	Plasticity Index	Depth (ft)	Remarks
TOPSOII CLAY: stiff, brown, dry, low plastic, with brick, few sand, few gravel (FILL)	645.0	SS-1	18 (75)	3-7-7-7 N = 14		2.0 P	19				1-	
3-1-1-1-1-1-1-1-1-1-1-1-1-1-1-1-1-1-1-1	6.	SS-2	19 (79)	6-4-5-5 N = 9		>4.5 P	16				3-	
5- CLAY: stiff, dry, dark brown, low plastic, trace sand, trace gravel (GLACIAL TILL)	640.7	SS-3	13 (54)	4-4-4-7 N = 8		>4.5 P	15				2 6	
7 CLAY: medium stiff, moist, gray to brown, high plastic, little sand; iron oxide	638.5	SS-4A SS-4B	16 . (67)	3-4-5-6 N = 9	4.3 S	4.2 P					7-	
staining (A-7-6) (GLACIAL TILL)	6:	SS-5	18 (75)	3-3-4-4 N = 7	2.5 5	2.2 P 2.5 P 2.0 P	l .		55	31	8 9	
11-1	6:	SS-6	18 (75)	2-2-3-3 N = 5	1.6 B	2.8 P	22				11 -	
13 1	6:	SS-7A	20 (83)	2-5-6-7 N = 11	5.0 B	2.5 P 4.2 P 2.5 P	20				13	
14-9 SITY LOAM: medium stiff wet gray low.	630.6	SS-7B SS-8A	18 (75)	4-4-3-3 N = 7	2.5 B	1.2 P	16				14	
plastic, few fine sand (GLACIAL TILL)	629.2	SS-8B SS-9A		N = 7		1.0 P 0.8 P					16	
SAND: loose, wet, black, fine to coarse 17	628.4	SS-9B SS-9C	20 (83)	1-3-3-3 N = 6		0.5 P					17	
18 gravel (GLACIAL TILL) SAND: loose, wet, black, fine to coarse 19 (GLACIAL TILL)	627.4	SS-10A	17 (71)	0-1-2-3 N = 3	-						18	
CLAY: medium stiff, moist, dark gray, low plastic, few fine to coarse sand, few	62	SS-10B			1.1 B	1.0 P	22				20 –	



Log of Boring GC-01

ROUTE:	FAU2688 (Wolf Road)	DESCRIPTION:	Wolf Road over Addison Creek						
SECTION:		DRILLER:	Rubino Engineering, Inc.	DATE(S) DRILLED:	08/13/2021 to 08/13/2021				
COUNTY:	Cook	DRILLED BY:	Joe Kenny	LOGGED BY:	Nikki Kurfman (Gonzalez)				
STRUCT. NO.:	016-2423	DRILL RIG TYPE:	Geoprobe 7822DT	BACKFILL:	Backfilled with auger cuttings.				
STATION & OFFSET:	,	DRILLING METHOD:	3-1/4" hollow stem auger	Ground Water Ob	servation(s):				
SURFACE ELEV.:	645.5 ft	SAMPLING METHOD:		First Encounter:	16.30 ft				
VERTICAL DATUM:	NAVD83	HAMMER TYPE:	Auto Hammer (140 lb)	Upon Completion:	32.00 ft				
LAT/LONG:	41.910181, -87.903129	HAMMER EFFICIENCY	: 88.8 %	After Drilling:					
LOCATION:	Over Addison Creek	REMARKS:	Gonzalez Project No. 20-11	4-06					

LAT/LONG:	41.910181, -87.903129	_	R EFFICIE	_				▼ A	fter Dri	lling:			
LOCATION:	Over Addison Creek	REMARK	S:	_	ionzalez Projec	t No. 2	0-114-0	06					
Depth (ft) Graphic	Material Description	Elevation (ft): 645.5	Sample Number	Recovery, in. (%)	Sampling Resist. Or Core RQD(%)	Rimac, Qu (tsf)	Pocket Pen. Qu (tsf)	Moisture Content (%)	Dry Unit Weight (pcf)	Liquid Limit	Plasticity Index	Depth (ft)	Remarks
21-	CLAY: medium stiff, moist, dark gray, low plastic, few fine to coarse sand, few gravel (A-6) (GLACIAL TILL)	624	SS-11	24 (100)	1-2-3-4 N = 5	3.1 B	0.8 P 1.2 P 2.2 P	21		34	14	21	
22-	72.8	622.7	SS-12A	24	0-3-6-9	1.1 B	1.0 P					22	i I
23-	CLAY: stiff, dry, dark gray, low plastic, few fine to coarse sand, trace gravel; some fine sand lenses (GLACIAL TILL)	622	SS-12B	(100)	N = 9		2.5 P 4.2 P	12				23 -	
25		620	SS-13	18 (75)	6-6-6-6 N = 12	1.8 B	>4.5 P	12				25	
26 –			SS-14A SS-14B	23 (96)	3-8-5-5 N = 13	3.1 B	>4.5 P					26 -	
28		618	SS 14C				2.2 P	12				28	
29		615.9 - 616	SS-15A	24 (100)	5-8-12-15 N = 20	7.8 B	2.5 P >4.5 P	14				29	
30 —	SANDY LOAM: dense, dry, gray, fine sand (GLACIAL TILL)	613.5	SS-15B SS-16	19 (79)	2-5-17-22 N = 22							31 –	
32 - 33 - 33 - 34 - 34 - 34 - 34 - 34 -	SILTY LOAM: hard, dry, gray, low plastic, some fine sand (GLACIAL TILL)	611.5	SS-17	24 (100)	12-17-13-20 N = 30	3.8 S	>4.5 P >4.5 P >4.5 P	15				33 -	
35	SANDY LOAM: very dense, moist, gray, fine sand, trace gravel (GLACIAL TILL)	610	SS-18	20 (83)	20-24-48-26 N = 72							35	
36	SILT: very stiff, dry to moist, gray, low plastic, trace sand (GLACIAL TILL)	608	SS-19	24 (100)	8-10-10-9 N = 20	1.8 B	>4.5 P >4.5 P 3.2 P	18				36 –	
38 -		606	SS-20	19 (79)	3-5-4-4 N = 9	2.0 B	1.0 P 0.8 P 1.0 P					38-	
40	Boring terminated at 40.0'	605.5										40	


_gonzalez

GONZALEZ COMPANIES, LLC
7 CARPENTER DRIVE
SALEM, IL 62881
PHONE (618) 222-2221
www.gonzalecos.com
ILLINOS PODESSIONAL DESIGN FIRM 184,004564

	DESIGNED	-	JSP	REVISED	-
	CHECKED	-	GLH	REVISED	-
	DRAWN	-	KMA/JMW	REVISED	-
ı	DATE	-	02/09/2022	REVISED	-

STATE OF ILLINOIS **DEPARTMENT OF TRANSPORTATION**

						GCL Job No.	20-114
act papture		SEC ⁻	LION		COUNTY	TOTAL SHEETS	SHE
SOIL BORINGS	2690	2021	-13-I		соок	13	11
					CONTRACT	NO. 62P	53
BRIDGE SHEET 4 OF 4			ILLINOIS	FED. All	D PROJECT		

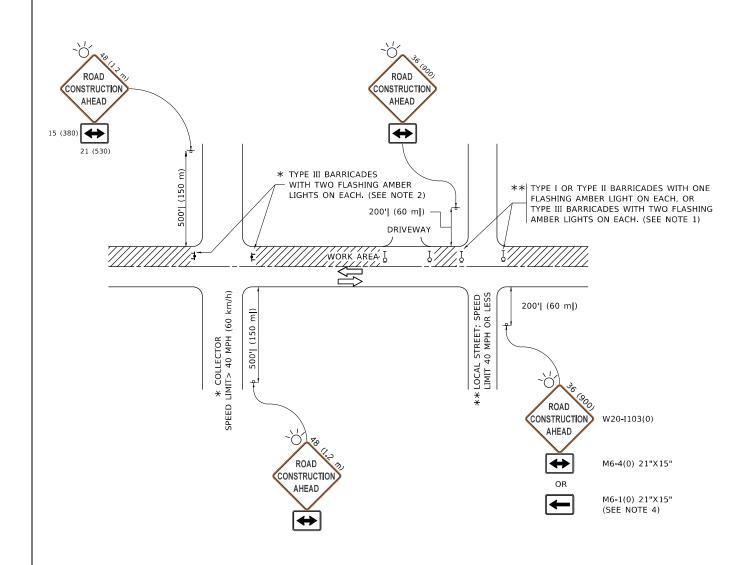

NOTES:

- 1. SIDE ROAD WITH A SPEED LIMIT OF 40 MPH (60 km/h) OR LESS AS SHOWN ON THE DRAWING AND AS DIRECTED BY THE ENGINEER:
- a) ONE "ROAD CONSTRUCTION AHEAD" SIGN 36 x 36 (900x900) WITH A FLASHER MOUNTED ON IT APPROXIMATELY 200' (60 m) IN ADVANCE OF THE MAIN ROUTE.
- b) THE CLOSED PORTION OF THE MAIN ROUTE SHALL BE PROTECTED BY BLOCKING WITH TYPE I, TYPE II OR TYPE III BARRICADES, 1/3 OF THE CROSS SECTION OF THE CLOSED PORTION.
- SIDE ROAD WITH A SPEED LIMIT GREATER THAN 40 MPH (60 km/h) AS SHOWN ON THE DRAWING AND AS DIRECTED BY THE ENGINEER:
- a) ONE "ROAD CONSTRUCTION AHEAD" SIGN 48 x 48 (1.2 m x 1.2 m) WITH A FLASHER MOUNTED ON IT APPROXIMATELY 500' (150 m) IN ADVANCE OF THE MAIN ROUTE,
- THE CLOSED PORTION OF THE MAIN ROUTE SHALL BE PROTECTED BY
 b) BLOCKING WITH TYPE III BARRICADES, 1/2 OF THE CROSS SECTION
 OF THE CLOSED PORTION.
- 3. CONES MAY BE SUBSTITUTED FOR BARRICADES OR DRUMS AT HALF THE SPACING DURING DAY OPERATIONS. CONES SHALL BE A MINIMUM OF 28 (710)
- WHEN THE SIDE ROAD LIES BETWEEN THE BEGINNING OF THE MAINLINE
 4. SIGNING AND THE WORK ZONE, A SINGLE HEADED ARROW (M6-1) SHALL
 BE USED IN LIEU OF THE DOUBLE HEADED ARROW (M6-4).

- WHEN WORK IS BEING PERFORMED ON A SIDE ROAD OR DRIVEWAY, FOLLOW THE APPLICABLE STANDARD(S). THE DIRECTIONAL ARROW (M6-1 OR M6-4) SHALL BE COVERED OR REMOVED WHEN NO LONGER CONSISTENT WITH THE TRAFFIC CONTROL SET-UP.
- 6. ADVANCE WARNING SIGNS ARE TO BE OMITTED ON DRIVEWAYS UNLESS OTHERWISE SPECIFIED IN THE PLANS OR BY THE ENGINEER
- 7. THE TRAFFIC CONTROL AND PROTECTION FOR SIDE ROADS, INTERSECTIONS, AND DRIVEWAYS SHALL BE INCLUDED IN THE COST OF SPECIFIED TRAFFIC CONTROL STANDARDS OR ITEMS.

All dimensions are in inches (millimeters) unless otherwise shown.


USER NAME = footemj	DESIGNED - L.H.A.	REVISED	- A. HOUSEH 10-15-96
	DRAWN -	REVISED	- T. RAMMACHER 01-06-00
PLOT SCALE = 50.0000 / in.	CHECKED -	REVISED	- A. SCHUETZE 07-01-13
PLOT DATE = 3/4/2019	DATE - 06-89	REVISED	_ A. SCHUETZE 09-15-16

STATE OF ILLINOIS
DEPARTMENT OF TRANSPORTATION

TRAFFIC CONTROL AND PROTECTION FOR SIDE ROADS, INTERSECTIONS, AND DRIVEWAYS

| SHEET 1 OF 1 SHEETS STA. TO ST

tc10.dgn 3/4/2019 10:27:07 A

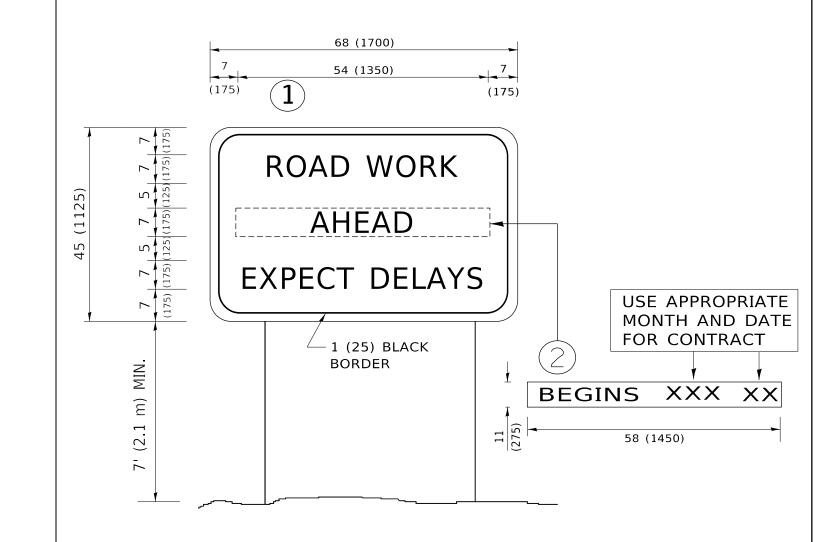

NOTES:

- 1. USE BLACK LETTERING ON ORANGE BACKGROUND.
- 2. ERECT SIGNS IN ADVANCE OF THE LOCATION FOR THE "ROAD CONSTRUCTION AHEAD" SIGN AT LOCATIONS AS DIRECTED BY THE ENGINEER.
- 3. ERECT SIGN 1 WITH INSTALLED PANEL 2 ONE WEEK PRIOR TO THE START OF CONSTRUCTION.
- 4. REMOVE PANEL(2)SOON AFTER THE START OF CONSTRUCTION.
- 5. SEE SPECIAL PROVISION FOR "TEMPORARY INFORMATION SIGNING" FOR ADDITIONAL INFORMATION.
- 6. ONE SIGN ASSEMBLY EQUALS 25.70 SQ. FT. (2.3 SQ. M.)
- 7. SHALL BE PAID FOR AS TEMPORARY INFORMATION SIGNING.

ALL DIMENSIONS ARE IN INCHES (MILLIMETERS) UNLESS OTHERWISE SHOWN.

SHEETS NO.

COOK
CONTRAC
FED. AID PROJECT
<u>-</u> ₅∏