

## GENERAL NOTES

- 1. TRAFFIC CONTROL AND PROTECTION AND PROPER BARRICADES SHALL BE MAINTAINED BY THE CONTRACTOR.
- 2. THE CONTRACTOR WILL BE REQUIRED TO HAVE TWO FLAGGERS ON-SITE DURING ALL MAINLINE PAVING OPERATIONS.
- 3. THE CONTRACTOR IS RESPONSIBLE FOR CONTACTING THE MONROE COUNTY HIGHWAY DEPARTMENT AT LEAST 48 HOURS IN ADVANCE PRIOR TO COMMENCEMENT OF ANY CONSTRUCTION ACTIVITIES OR WORK REQUIRING INSPECTION OR APPROVAL.
- 4. USE ALL FLUORESCENT ORANGE 48" CONSTRUCTION SIGNS.
- 5. NO OVERNIGHT LANE CLOSURES WILL BE ALLOWED ON THIS PROJECT.
- 6. FACTORS USED FOR QUANTITY CALCULATIONS ARE AS FOLLOWS:
  ALL HOT-MIX ASPHALT 112.0 LBS/SQ YD PER 1" THICKNESS
  ALL BITUMINOUS MATERIAL (TACK COAT) 0.05 LB/SQ FT
- 7. THE THICKNESS OF THE BITUMINOUS MIXTURE SHOWN ON THE PLANS IS THE NOMINAL THICKNESS, DEVIATIONS FROM THE NOMINAL THICKNESS WILL BE PERMITTED WHEN SUCH DEVIATIONS OCCUR DUE TO IRREGULARITIES IN THE EXISTING SURFACE OR BASE ON WHICH THE BITUMINOUS MIXTURE IS PLACED.
- 8. ALL TEMPORARY PAVEMENT MARKINGS WILL BE PLACED IN SUCH A MANNER SO AS NOT TO INTERFERE WITH THE PLACEMENT OF PERMANENT PAVEMENT MARKINGS.
- 9. THERMOPLASTIC PAVEMENT MARKINGS SHALL MATCH EXISTING EXCEPT WHERE INDICATED ON THE PLANS AND AS DIRECTED BY THE ENGINEER.
- 10. ACCESS SHALL BE PROVIDED TO/FROM PRIVATE ENTRANCES AT ALL LOCATIONS DURING ALL STAGES.
- 11. THE CONTRACTOR SHALL VERIFY ALL DIMENSIONS AND CONDITIONS IN THE FIELD PRIOR TO CONSTRUCTION AND ORDERING MATERIALS.
- 12. 1/2" EXPANSION MATERIAL SHALL BE PLACED BETWEEN CURB AND SIDEWALK AT ALL LOCATIONS.
- 13. FORMS FOR COMBINATION CONCRETE CURB AND GUTTER SHALL BE OF METAL ONLY, EXCEPT THAT WOOD FORMS SHALL BE USED ON SHORT RADIUS CURVES.
- 14. AGGREGATE BASE SHALL BE PLACED AND COMPACTED, AS NEEDED, AND AS APPROVED BY THE ENGINEER, TO OBTAIN PROPER SIDEWALK SLOPE COST FOR THIS WORK IS CONSIDERED INCLUDED IN THE COST OF 4 INCH SIDEWALK.
- 15. EXISTING SIGNS SHALL BE REMOVED, STORED AND RE-ERECTED AS SHOWN IN THE PLANS. SIGNS NOT RE-ERECTED WILL REVERT BACK TO THE RESPONSIBLE PARTY. ANY DAMAGE TO SIGNS SHALL BE THE RESPONSIBILITY OF THE CONTRACTOR.
- 16. EXISTING DITCHES/SWALES MAY NEED TO BE REGRADED OR RESHAPED TO ENSURE ALL FLOWS ENTER THE PROPER DITCH, CULVERT OR OTHER DRAINAGE APPURTENANCES DURING AND AT THE COMPLETION OF THE PROJECT. COST FOR THIS WORK IS CONSIDERED INCLUDED IN THE COST OF EARTH EXCAVATION.
- 17. IT SHALL BE THE RESPONSIBILITY OF THE CONTRACTOR TO MAINTAIN POSITIVE DRAINAGE DURING VARIOUS STAGES OF CONSTRUCTION
  THIS INCLUDES ALL LABOR, EQUIPMENT AND MATERIALS USED BEYOND WHAT IS SPECIFIED IN THE PLANS. NECESSARY ITEMS SUCH
  AS TEMPORARY DITCHES OR PIPES WILL NOT BE PAID FOR SEPARATELY AND SHALL BE CONSIDERED INCLUDED IN THE COST OF EARTH EXCAVATION.

SALVAGE: NONE

COMMITMENTS: NONE

HIGHWAY STANDARDS

STANDARD SYMBOLS 000001-08
EROSION CONTROL 280001-07

SIDEWALK

424001-11 424006-05 424011-04 424016-05 424021-06

424001-11

424031-02

DRAINAGE 542301-03

CURB AND GUTTER 606001-08

MEDIAN

606301÷04 701306÷04

TRAFFIC CONTROL

701311-03 701602-10 701701-10 701901-08

SIGNING

720001-01

PAVEMENT MARKING

780001-05 781001-04 782001-01

814001-03 838001-01

SIGNALS

857001-01 873001-02 876001-04 878001-11 880006-01

886006-01 886006-01

HOT-MIX ASPHALT MIXTURE REQUIR	HOT-MIX ASPHALT MIXTURE REQUIRMENTS							
LOCATIONS	ALL							
MIXTURE USE	SURFACE							
AC/PG	PG 64-22							
RAP % (MAX)	SEE SPECIAL PROVISIONS							
DESIGN AIR VOIDS	4.0% @ Ndes= 70							
MIXTURE COMPOSITION (GRADATION MIXTURE)	IL-9.5							
FRICTION AGGREGATE	MIXTURE D							
MIXTURE WEIGHT	112.0 LB/SQ YD/IN							
QUALITY MANAGEMENT PROGRAM	QC/QA							
SUBLOT SIZE	N/A							
MATERIAL TRANSFER DEVICE	NO							

USER HANE +	DESIGNED -	REVISED -			F.A.S. SECTION COUNTY TOTAL SHEET NO.
	DRAWN -	REVISED -	MONROE COUNTY	GENERAL NOTES, COMMITMENTS AND HIGHWAY STANDARDS	21-00082-04-SW MONROE 13 2
PLOT SCALE = 100.000' / in.	CHECKED -	REVISED -	HIGHWAY DEPARTMENT		CONTRACT NO. 97775
PLOT D.A. TE =	DATE -	R MISED -	<del></del>	SCALE: NA SHEET 1 OF 1 SHEETS STA. TO STA.	I_LLINGS FROJECT

		SUMMARY OF QUANTITIES			1		SUMMARY OF QUANTITIES		
SP	CODE	ITEM	UNIT	QUANTITY	SP	CODE	ITEM	UNIT	QUANTITY
	20200100	EARTH EXCAVATION	CU YD	25		78000650	THERMOPLASTIC PAVEMENT MARKING - LINE 24"	FT_	96
	20800150	TRENCH BACKFILL	CU YD	3.6		78100100	RAISED REFLECTIVE PAVEMENT MARKER	EACH	34
	25100115	MULCH METHOD, 2	ACRE	0.25		78300200	RAISED REFLECTIVE PAVEMENT MARKER REMOVAL	EACH	34
	40600290	BITUMINOUS MATERIALS (TACK COAT)	POUND	1160		78300201	PAVEMENT MARKING REMOVAL - GRINDING	SQ FT	2026
	40600990	TEMPORARY RAMP	SQ YD	22		∆ 80300100	LOCATING UNDERGROUND CABLE	FT_	495
	40604062	HOT-MIX ASPHALT SURFACE COURSE, IL-9.5, MIX "D" N70	TON	290		81028340	UNDERGROUND CONDUIT, PVC, 1 1/2" DIA.	FT	168
	42400100	PORTLAND CEMENT CONCRETE SIDEWALK, 4 INCH	SQ FT	2350		3 81028350	UNDERGROUND CONDUIT, PVC, 2" DIA.	FT_	159
	42400800	DETECTABLE WARNINGS	SQ FT	120		81028370	UNDERGROUND CONDUIT, PVC, 3" DIA.	FT	133
	44000157	HOT-MIX ASPHALT SURFACE REMOVAL, 2"	SQ YD	2563		81400100	HANDHOLE	EACH	2
	44000500	COMBINATION CURB AND GUTTER REMOVAL	FT	162	1	87301215	ELECTRIC CABLE IN CONDUIT, SIGNAL NO. 14 2C	FT	1312
	44000600	SIDEWALK REMOVAL	SQ FT	386		87301225	ELECTRIC CABLE IN CONDUIT, SIGNAL NO. 14 3C	FT	1354
	54213657	PRECAST REINFORCED CONCRETE END SECTION, 12"	EACH	1		87301245	ELECTRIC CABLE IN CONDUIT, SIGNAL NO. 14 5C	FT	230
	550A0050	STORM SEWERS, CLASS A, TYPE I, 12"	FT	39		87301255	ELECTRIC CABLE IN CONDUIT, SIGNAL NO. 14 7C	FT	230
-	60605000	COMBINATION CURB AND GUTTER, TYPE B-6.24	FT	279		87301305	ELECTRIC CABLE IN CONDUIT LEAD IN NO. 14 1 PAIR	FT	905
	60618300	CONCRETE MEDIAN SURFACE, 4 INCH	SQ FT	750		87301900	ELECTRIC CABLE IN CONDUIT EQUIPMENT, GROUNDING CONDUCTOR, NO. 6 1C	FT	587
	66900200	NON-SPECIAL WASTE DISPOSAL	CU YD	16		87502680	TRAFFIC SIGNAL POST, ALUMINUM 14 FT.	EACH	3
	66900530	SOIL DISPOSAL ANALYSIS	EACH	1		87800100	CONCRETE FOUNDATION, TYPE A	FT	21
	2 66901001	REGULATED SUBSTANCES PRE-CONSTRUCTION PLAN	L SUM	1		87900200	DRILL EXISTING HANDHOLE	EACH	4
	66901003	REGULATED SUBSTANCES FINAL CONSTRUCTION REPORT	L SUM	1		88102825	PEDESTRIAN SIGNAL HEAD, POLYCARBONATE, LED, 1-FACE, BRACKET MOUNTED WITH COUNT DOWN TIMER	EACH	6
	66901006	REGULATED SUBSTANCES MONITORING	CAL DAYS	5		88500520	INDUCTION LOOP DETECTOR AMPLIFIER WITH CALL DELAY AND CALL CARRY-OVER, DIGITAL DESGIN	EACH	4
	67100100	MOBILIZATION	L SUM	1		88600600	DETECTOR LOOP REPLACEMENT	FT	677
	70300100	SHORT TERM PAVEMENT MARKING	FT	120	Δ	89501250	RELOCATE EXISTING TRAFFIC SIGNAL EQUIPMENT	EACH	1
	70300150	SHORT TERM PAVEMENT MARKING REMOVAL	SQ FT	40		89502200	MODIFY EXISTING CONTROLLER	EACH	1
	70300211	TEMPORARY PAVEMENT MARKING LETTERS AND SYMBOLS - PAINT	SQ FT	166.4		89502300	REMOVE ELECTRIC CABLE FROM CONDUIT	FT	1138
	70300221	TEMPORARY PAVEMENT MARKING - LINE 4" - PAINT	FT	2616		89502385	REMOVE EXISTING CONCRETE FOUNDATION	EACH	1
	70300251	TEMPORARY PAVEMENT MARKING - LINE 8" - PAINT	FT	378	*	X0322936	REMOVE EXISTING FLARED END SECTION	EACH	1
	70300261	TEMPORARY PAVEMENT MARKING - LINE 12" - PAINT	FŤ	586	*	X2501000	SEEDING, CLASS 2 (SPECIAL)	ACRE	0.25
	70300281	TEMPORARY PAVEMENT MARKING - LINE 24" - PAINT	FT	96	*	X4402020	CONCRETE MEDIAN SURFACE REMOVAL	SQ FT	1115
	72000100	SIGN PANEL - TYPE 1	SQ FT	5.64	*	X5510100	STORM SEWER REMOVAL	FT	10
	72400100	REMOVE SIGN PANEL ASSEMBLY - TYPE A	EACH	2	*	X7010216	TRAFFIC CONTROL AND PROTECTION, (SPECIAL)	L SUM	1
	72400500	RELOCATE SIGN PANEL ASSEMBLY — TYPE A	EACH	1	*△	X7800200	PAINT PAVEMENT MARKING CURB	FT	208
	78000100	THERMOPLASTIC PAVEMENT MARKING — LETTERS AND SYMBOLS	SQ FT	166.4	* 🛆	X8760200	ACCESSIBLE PEDESTRIAN SIGNALS	EACH	6
Δ	78000200	THERMOPLASTIC PAVEMENT MARKING - LINE 4"	FT	2616	* 🛆	X8760201	PEDESTRIAN PUSH-BUTTON POST	EACH	3
	78000500	THERMOPLASTIC PAVEMENT MARKING - LINE 8"	FT	378	*△	X8950450	REMOVE EXISTING UNDERGROUND CONDUIT	FŤ	48
	78000600	THERMOPLASTIC PAVEMENT MARKING - LINE 12"	FT	586		l Δ SPECIALΓ	 ゲ /TEMS	<u> </u>	
	<u></u>	The U I was to the second	l		-				

NORTH WATERLOO PEDESTRUAR CROSSINGLO

A SPECIALTY ITEMS

USER NAME =

MONROE COUNTY HIGHWAY DEPARTMENT SUMMARY OF QUANTITIES


SCALE:NA SHEET 1 OF 1 SHEETS STA. TO STA.

SECTION COUNTY TOTAL SHEET NO.

21-00062-04-SW MONROE 13 3

CONTRACT NO. 97775


| ILLINOIS | FED. NO PROJECT

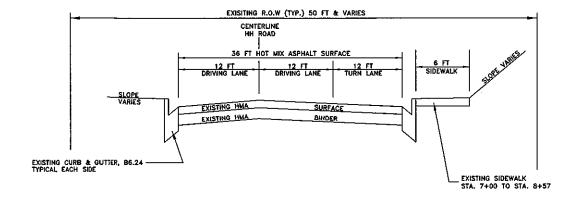


EXISTING SECTION

HH ROAD

STA. 7+00 TO STA. 9+57

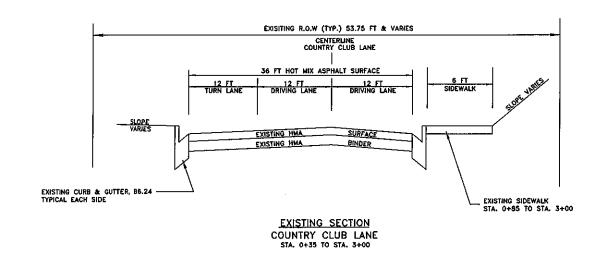

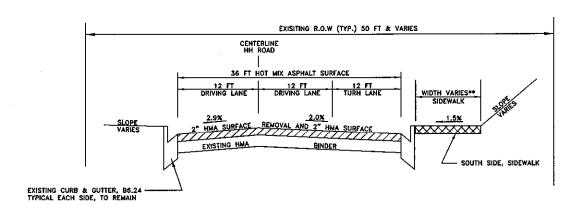


PROPOSED SECTION

HH ROAD

STA. 7+00 TO STA. 9+57

\*\* PROPOSED 7 FT SIDEWALK STA. 8+57 TO STA. 9+57 EXISTING 6 FT SIDEWALK STA. 7+00 TO STA. 8+57

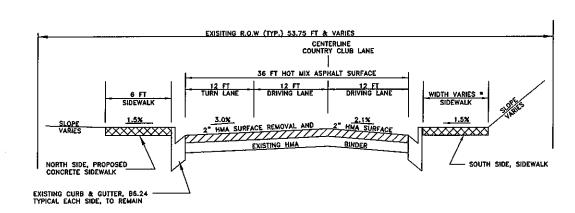

PROPOSED SECTION
COUNTRY CLUB LANE
STA. 0+35 TO STA. 3+00

 PROPOSED 7 FT SIDEWALK STA. 0+35 TO STA. 0+85 EXISTING 6 FT SIDEWALK STA. 0+85 TO STA. 3+00

USER NAME =	DESIG	GNED -	REVISED -								F.A.	SECTION	COUNTY	CHECTE	SHEET
	DRAW	₩N -	REVISED -	MONROE COUNTY		-	TYPICAL	ひたしょ	IONS		\\\\	21-00062-04-SW	MONROE	13	4
PLOT SCALE =	CHEC	CKED -	REVISED -	HIGHWAY DEPARTMENT									CONTRAC	T NO. 977	75
PLOT DATE .	DATE	-	REVISED -	· ·	SCALE;	SHEET	OF S	HEETS	STA.	TO STA.		ILLINOIS FED.	AID PROJECT		

	HOT-MIX A	SPHALT QUANTITII	ES	
LOCATION	HMA SURFACE COURSE IL - 9.5 MIX "D" N70	HMA SURFACE REMOVAL 2"	BITUMINOUS MATERIALS (TACK COAT)	TEMPORARY RAMP
	TON	SQ YD	LB	SQ YD
STA. 7+00 TO STA. 9+57	147.5	1304	590	11.2
STA. 0+35 TO STA. 3+00	142.5	1259	570	10.8
TOTAL	290	2563	1160	22

A 18.51 1 18.60)		DRAINAGE	QUANTITIES	(10)		
LOCATION	SIDE	PRECAST REINFORCED CONCRETE END SECTION, 12"	STORM SEWER CLASS A TYPE I, 12"	REMOVE EXISTING FLARED END SECTION	STORM SEWER REMOVAL	TRENCH BACKFILL
		EACH	FOOT	EACH	FOOT	CU YD
STA. 0+30 TO 0+60 STA	RT	<del>24.3.500</del> 1	39	1	10	3.6
TOTAL		1	39	1	10	3.6

17		EARTH EXCAVATION	QUANTITIES		3 12
LOCATION	EARTH EXCAVATION	EARTH EXCAVATION W/ 25% SHRINKAGE	EMBANKMENT REQUIRED	EARTH EXCAVATION BALANCE	NON-SPECIAL WASTE DISPOSAL
(MAID CO-02)	CU YD	CU YD	CU YD	CU YD	CU YD
STA. 7+00 TO STA. 3+00	25	18.75	0	18.75	16
TOTAL	25	18.75	0	18.75	16

<sup>\*</sup>ALL EXCESS MATERIAL EXCAVATED SHALL BECOME PROPERTY OF THE CONTRACTOR. THE COST FOR HAULING AND DISPOSAL OF EXCESS MATERIAL SHALL BE INCLUDED IN THE COST OF EARTH EXCAVATION OR NON—SPECIAL WASTE DISPOSAL.

	- 131111	SIGN	SCHEDULE			
LOCAT	ΠΟΝ		DE		*SIGN PANEL TYPE 1	
STATION	OFFSET SIDE		SIGN	SHAPE	SIZE	
		LT/RT				SQ FT
HH ROAD			_	77.7		
9+49.47	43.50	LT	R10-3EL	RECTANGLE	9X15	0.94
9+39.02	20.19	RT	R10-3EL	RECTANGLE	9X15	0.94
9+46.03	31.2	RT	R10-3EL	RECTANGLE	9X15	0.94
COUNTRY CLUB LANE			- 1000			
0+41.62	35.16	RT	R10-3EL	RECTANGLE	9X15	0.94
0+56.59	21.75	LT	R10-3ER	RECTANGLE	9X15	0.94
IL ROUTE 3			1 2 2 2 2 2 2 2			
2174+58.29	36.26	RT	R10-3ER	RECTANGLE	9X15	0.94
					TOTAL	5.64

<sup>\*</sup>SEE TRAFFIC SIGNAL PLANS FOR ADDITIONAL INFORMATION


			TEMPORARY	PAVEMENT MARKI	NG QUANTITIES	-04-34-30-20-20-20-20-20-20-20-20-20-20-20-20-20			
LOCATION	TEMPORARY PAVEMENT	MARKING - LINE 4"	TEMPORARY	TEMPORARY	TEMPORARY	TEMPORARY	SHORT TERM	SHORT TERM	PAVEMENT MARKING
	YELLOW	WHITE	PAVEMENT MARKING	PAVEMENT MARKING	PAVEMENT MARKING	PAVEMENT MARKING	PAVEMENT	PAVEMENT MARKING	REMOVAL
	SOLID	SOLID	LETTERS AND SYMBOLS	LINE 24"	LINE 12"	LINE 8"	MARKING	REMOVAL	GRINDING
	FOOT	FOOT	SQUARE FOOT	FOOT	FOOT _	FOOT	FOOT	SQUARE FOOT	SQUARE FOOT
STA. 7+00 TO STA. 3+00	884	1732	166.4	96	586	378	120	40	2026
SUBTOTAL	884	1732	-				2 2 117		
TOTAL	2	616	166.4	96	586	378	120	40	2026


7.			PERMAN	NENT PAVEMENT MARK	KING QUANTITIES			5-6-000	
LOCATION	THERMOPLASTIC PAVEMEN	IT MARKING - LINE 4"	THERMOPLASTIC	THERMOPLASTIC	THERMOPLASTIC	THERMOPLASTIC	RAISED REFLEC	TIVE PAVEMENT	RAISED REFLECTIVE
	YELLOW	WH!TE	PAVEMENT MARKING	PAVEMENT MARKING	PAVEMENT MARKING	PAVEMENT MARKING	MARI	KERS	□ PAVEMENT MARKER
	SOLID	SOLID	LETTERS AND SYMBOLS	LINE 24"	LINE 12"	LINE 8"	2-WAY AMBER	1-WAY WHITE	REMOVAL
304	FOOT	FOOT	SQUARE FOOT	FOOT	FOOT	FOOT	EACH	EACH	EACH
STA. 7+00 TO STA. 3+00	884	1732	166.4	96	_ 586	378	13	21	34
SUBTOTAL	884	1732					13	21	76
TOTAL	261	16	166.4	96	586	378	3	4	34


USER NAME =	DESIGNED -	REVISED -
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PLOT SCALE = 100.000' / in.	CHECKED -	REVISED -
PLOT DATE =	DATE -	REVISED -


MONROE COUNTY HIGHWAY DEPARTMENT

SCALE: NA

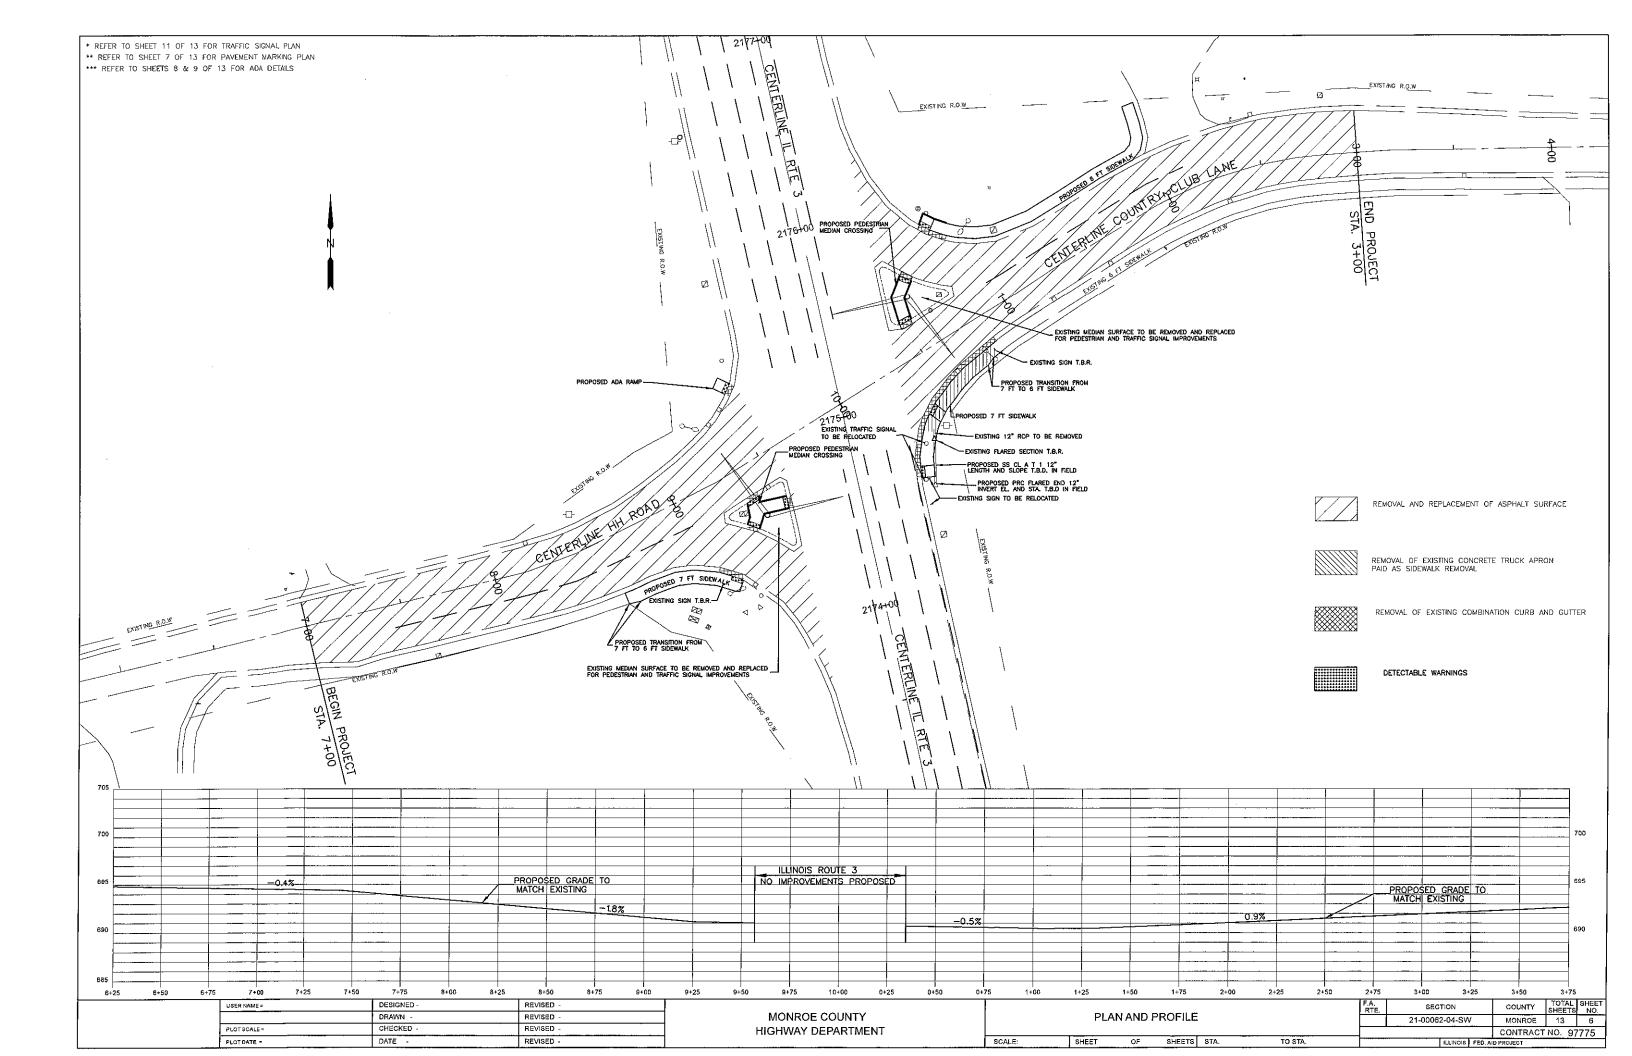

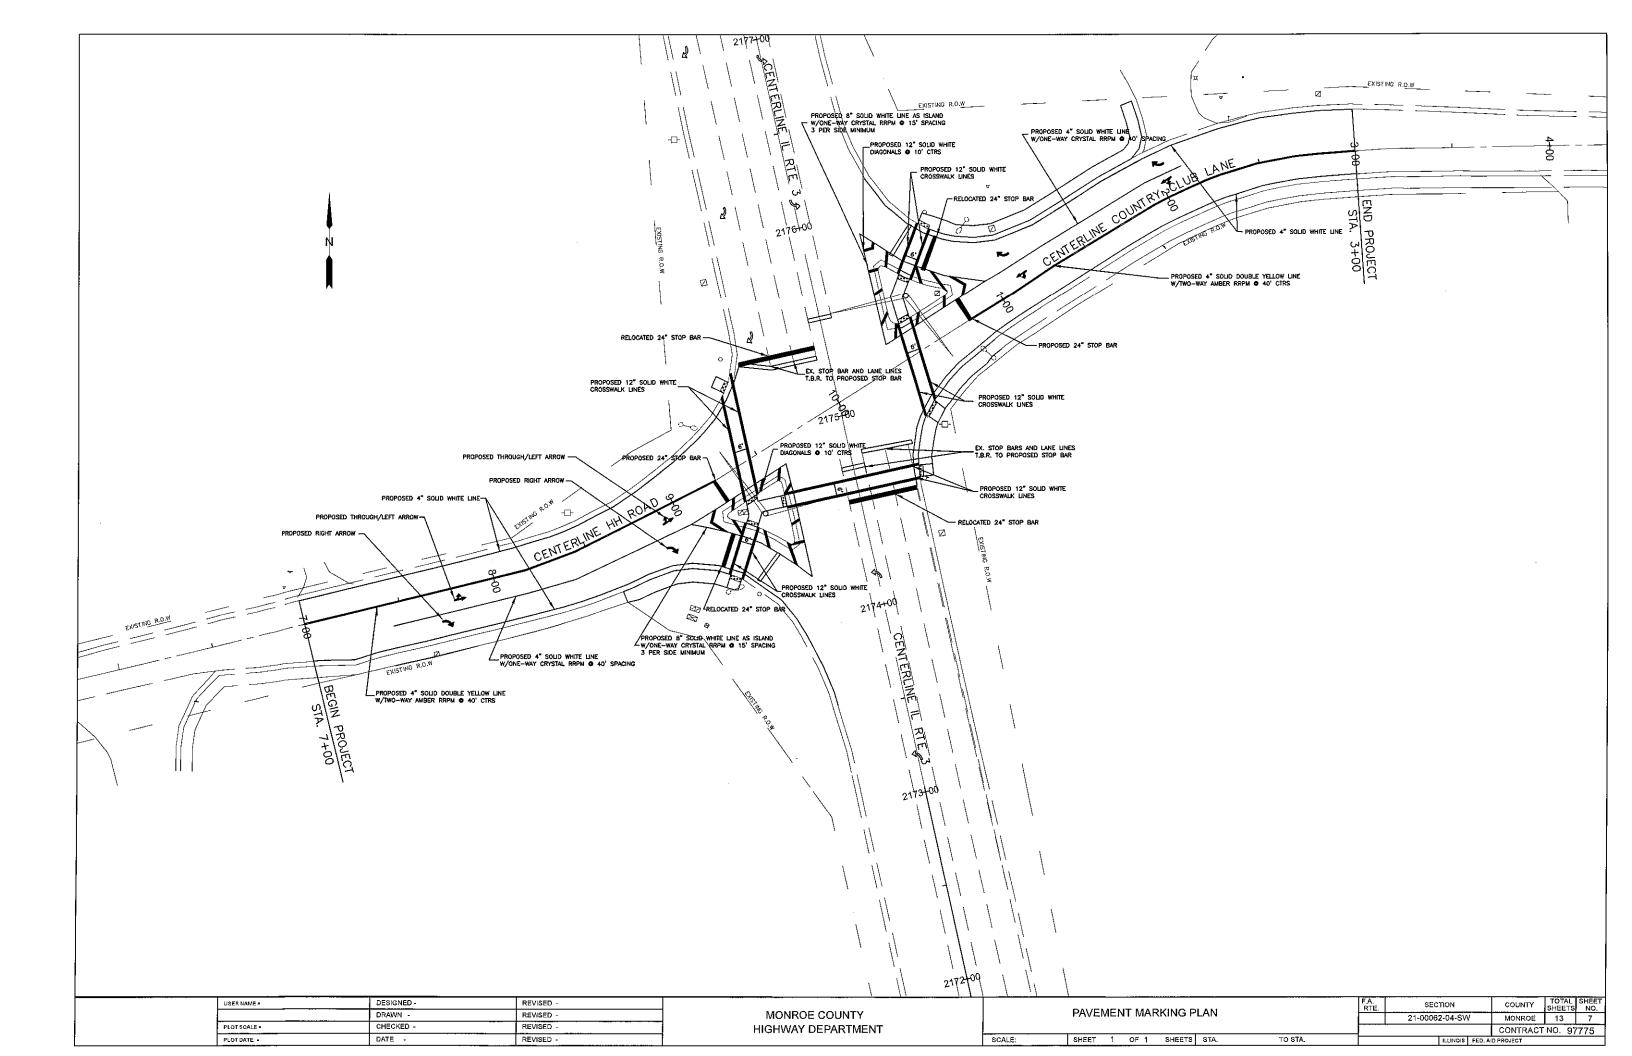


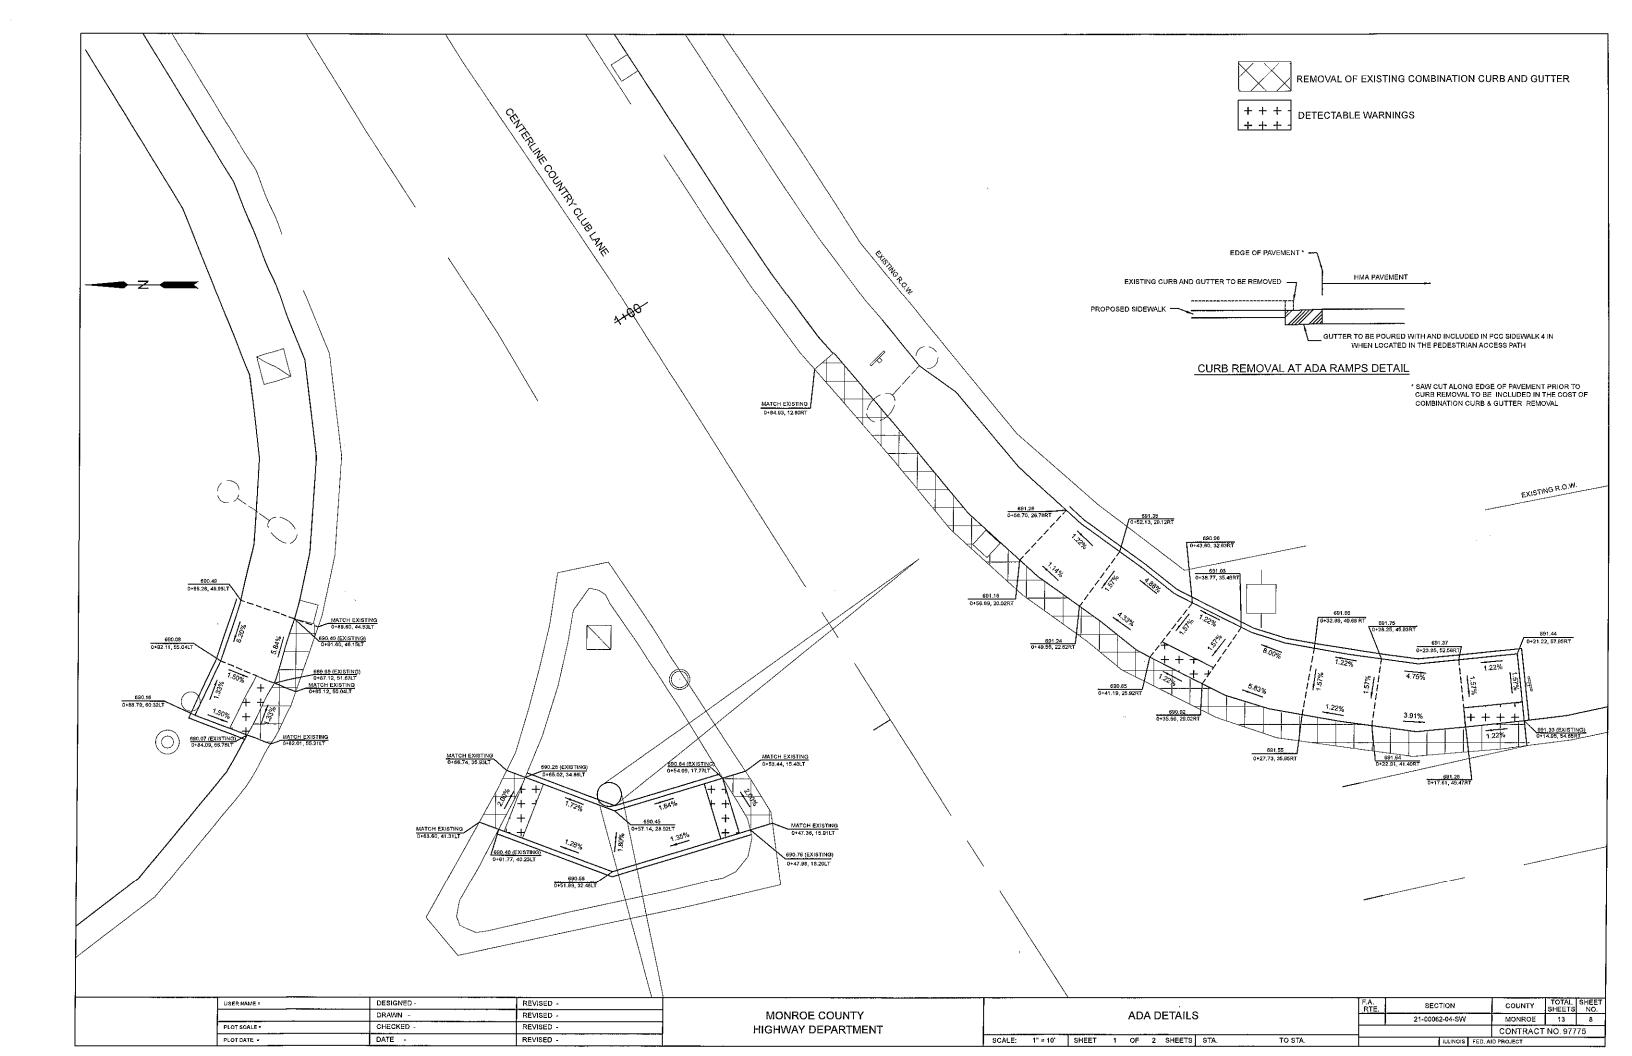

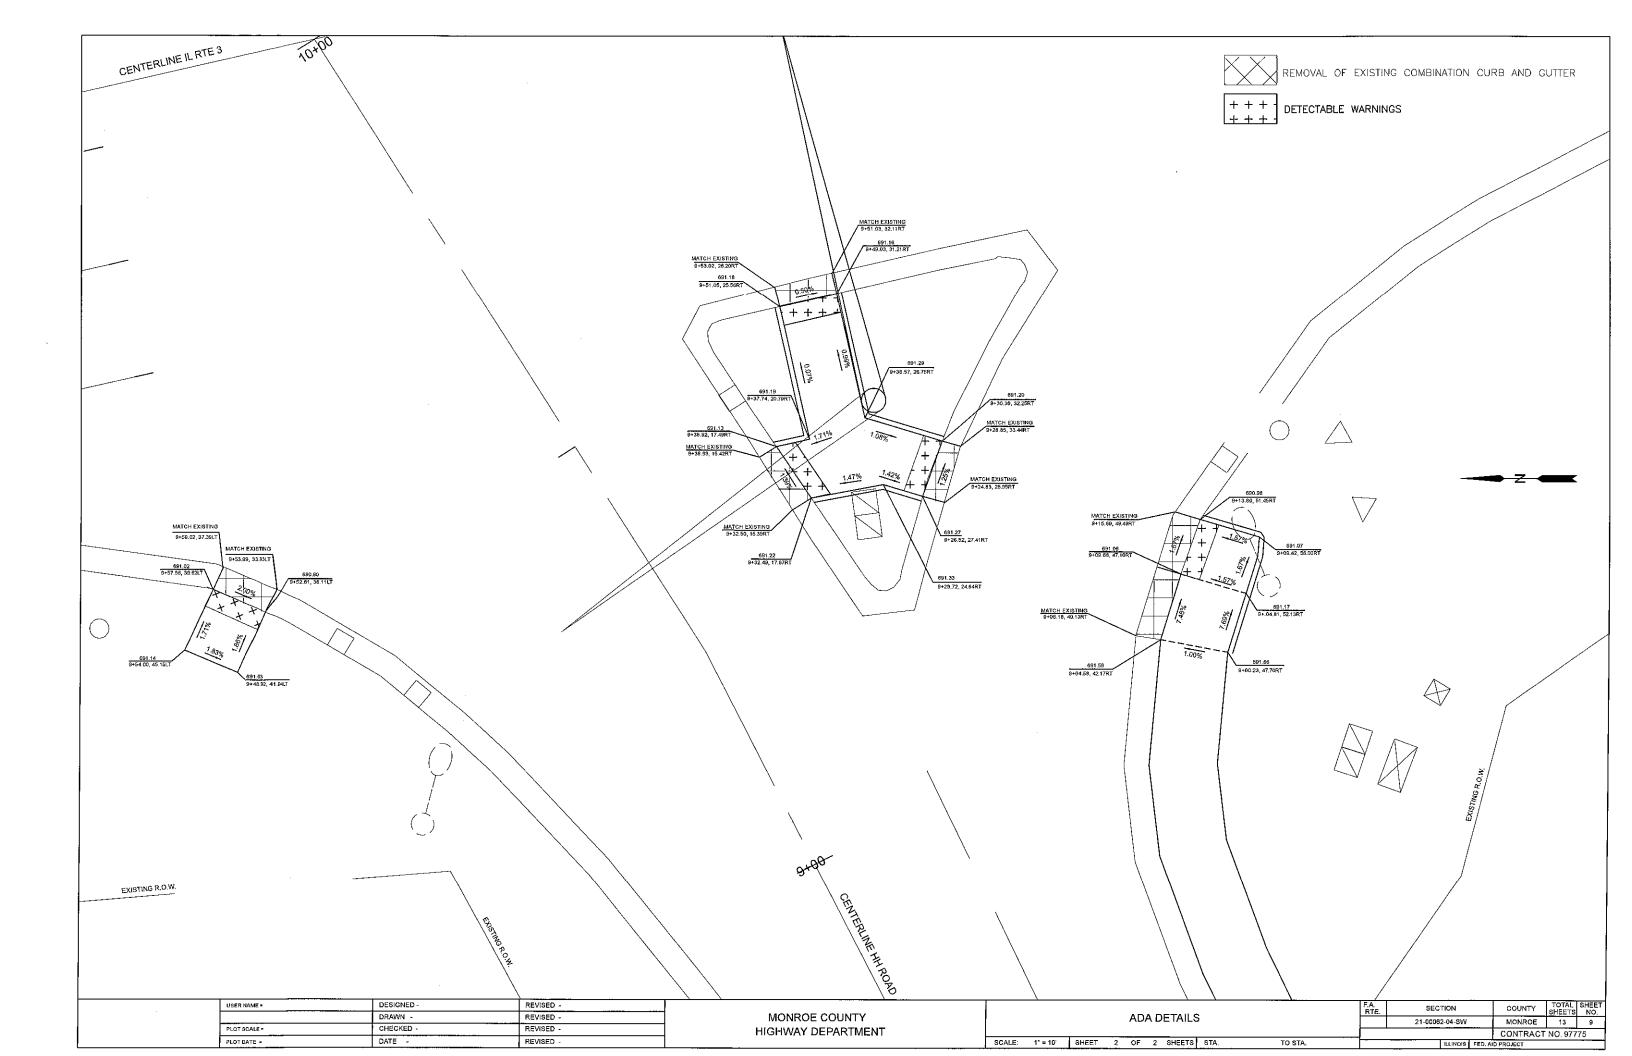

## GENERAL NOTES

- TRAFFIC SIGNALS SHALL BE OPERATIONAL AND ALL TRAFFIC SIGNAL WORK SHALL BE COMPLETED DURING THE ILLINOIS 3 PEDESTRIAN
- ALL MOUNTING HARDWARE SHALL BE ALUMINUM. ALL BOLTS, SCREWS, NUTS, AND WASHERS SHALL BE STAINLESS STEEL. ANTI-SEIZE PASTE COMPOUND SHALL BE USED ON ALL MOUNTING HARDWARE FIELD CONNECTIONS.
- THE LOCATION OF THE TRAFFIC SIGNAL POST SHALL BE APPROVED BY THE ENGINEER BEFORE FOUNDATIONS ARE CONSTRUCTED. POLE CENTER SHALL BE LOCATED A MINIMUM OF 4 FEET FROM THE BACK OF CURB.
- ALL TRAFFIC SIGNAL CABLES SHALL BE #14 AWG STRANDED COPPER UNLESS OTHERWISE SPECIFIED. TERMINAL ENDS SHALL HAVE CRIMPED-ON FORK TONGUE CONNECTORS.
- THE LOCATION OF ALL DETECTOR LOOPS SHALL BE APPROVED BY THE IDOT BEFORE ANY SLOTS ARE SAWED IN THE PAVEMENT.
- DETECTOR LOOP LEAD-IN SPLICES SHALL BE MADE IN A HANDHOLE PER ARTICLE 873.03 OF THE STANDARD SPECIFICATIONS FOR ROAD AND BRIDGE CONSTRUCTION AND STANDARD DRAWING 886001. CONDUCTORS SHALL BE SPLICED IN A RIGID MOLD. ROSIN-CORE SOLDER SHALL BE USED.
- CALL DELAY SHALL NOT FUNCTION WHEN THE RELATED PHASES ARE IN THE GREEN MODE.
- ALL HANDHOLES SHALL BE CAST-IN-PLACE PORTLAND CEMENT CONCRETE (PER ARTICLE 814.03(A)). THE CAST-IN-PLACE LEGEND ON THE COVER SHALL BE "TRAFFIC SIGNALS". SLOPE HANDHOLE COVERS TO MATCH PROPOSED GRADE ELEVATIONS.
- ALL INDUCTIVE LOOP DETECTORS SUPPLIED FOR THIS PROJECT SHALL HAVE THE CAPACITY OF OPERATING WITH BOTH DELAY AND EXTENSION MODES ACTIVE. IF A TIME SETTING IS PROGRAMMED, THEY SHALL BE RACK MOUNTED.
- CABLE MARKING TAPE SHALL BE INCLUDED WITH THE PAY ITEM "UNDERGROUND CONDUIT" AND INSTALLED PER ARTICLE 810.04 OF THE STANDARD SPECIFICATION FOR ROAD AND BRIDGE CONSTRUCTION.
- 11. A 1/4" DIAMETER CONTINUOUS NYLON PULL ROPE SHALL BE FURNISHED AND INSTALLED IN ALL NEW CONDUITS. THIS WORK SHALL BE INCLUDED WITH THE CONDUIT PAY ITEMS.
- QUADRUPLE DETECTOR LOOPS SHALL HAVE 3 TURNS WITH SIX WIRES IN THE CENTER SLOT.
- ALL EXISTING TRAFFIC SIGNAL EQUIPMENT TO BE REMOVED SHALL REMAIN THE PROPERTY OF IDOT AND SHALL BE DELIVERED TO THEIR 13. MAINTENANCE FACILITY AS DIRECTED BY THE ENGINEER.
- LOCATE UNDERGROUND CABLES PRIOR TO ATTEMPTING TO CONSTRUCT THIS PROJECT.
- 15. ANY EXTENDERS NECESSARY FOR INSTALLATION OF THE PEDESTRIAN PUSH BUTTONS SHALL BE INCIDENTAL TO THE PRICE FOR PEDESTRIAN
- THE FOLLOWING IDOT STANDARDS SHALL APPLY TO CONSTRUCTION OF THE SIGNALS: 000001-08, 606301-04, 720001-01, 814001-03, 16. 838001-01, 857001-01, 873001-02, 876001-04, 878001-11, 880006-01, 886001-01, 886006-01.

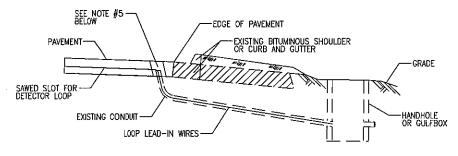

## INSTALLING DETECTOR LOOP WIRES IN EXISTING CONDUIT (NO SCALE)

DRILL OUT PAVEMENT SEALANT AND CLEAN EXISTING CONDUIT,
REMOVE EXISTING DETECTOR LOOP WIRES TO HANDHOLE OR GULFBOX,
INSTALL NEW LOOP LEAD—IN WIRES IN EXISTING CONDUIT.
SPLICE NEW DETECTIOR LOOP WIRES TO EXISTING LOOP LEAD IN CABLE IN HANDHOLE OR GULFBOX.
FILL HOLE WITH APPROVED SEALER. PREVENT SEALER FROM ENTERING CONDUIT
LOCATING UNDERGROUND CABLE WILL BE PAID FOR SEPARATELY.


NOT A PAY ITEM. THE COST OF THIS WORK SHALL BE INCLUDED IN THE PAY ITEM "DETECTOR LOOP REPLACEMENT"

*EXISTING	SEQUENCE	OF C	PERATION	
3	4		5	6


			"EXISTING	SEQUENCE OF C	PERATION			
PHASE	1	2	3	4	5	6	7	8
MOVEMENT	~	🕏	+	-09-1	L	ф <del> </del> -	NOT USED	NOT USED
CONCURRENT MOVEMENT PERMITTED	5 OR 6	5 OR 6	NONE	NONE	1 OR 2	1 0R 2		

EXISTING FULL-ACTUATED CONTROLLER

\*SEQUENCE TO REMAIN AS IS, A 6 PHASE.

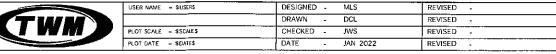

CODE NUMBER ITEM UNIT QUANTITY CONCRETE MEDIAN SURFACE, 4 INCH 60618300 SQ FT 750 72000100 SIGN PANEL - TYPE 1 5.64 SQ FT 80300100 LOCATING UNDERGROUND CABLE FOOT 495 UNDERGROUND CONDUIT, PVC, 1 1/2" DIA. 81028340 FOOT 168 UNDERGROUND CONDUIT, PVC, 2" DIA. 81028350 FOOT 159 81028370 UNDERGROUND CONDUIT, PVC, 3" DIA. **FOOT** 133 HANDHOLE 81400100 FACH ELECTRIC CABLE IN CONDUIT, SIGNAL NO. 14 2C F00T 1312 ELECTRIC CABLE IN CONDUIT, SIGNAL NO. 14 3C 1354 FOOT 87301225 87301245 ELECTRIC CABLE IN CONDUIT, SIGNAL NO. 14 5C FOOT 230 ELECTRIC CABLE IN CONDUIT, SIGNAL NO. 14 7C FOOT 230 87301255 ELECTRIC CABLE IN CONDUIT, LEAD IN, NO. 14 1 PAIR FOOT 905 87301305 87301900 ELECTRIC CABLE IN CONDUIT, EQUIPMENT GROUNDING CONDUCTOR, NO. 6 1C FOOT 587 87502680 TRAFFIC SIGNAL POST, ALUMINUM 14 FT. FACH 87800100 CONCRETE FOUNDATION, TYPE A FOOT 21 87900200 DRILL EXISTING HANDHOLE FACH 88102825 PEDESTRIAN SIGNAL HEAD, POLYCARBONATE, LED, 1-FACE, BRACKET MOUNTED WITH COUNT DOWN TIMER EACH 88500520 INDUCTION LOOP DETECTOR AMPLIFIER WITH CALL DELAY AND CALL CARRY-OVER, DIGITAL DESIGN EACH 677 88600600 DETECTOR LOOP REPLACEMENT FOOT 89501250 EACH RELOCATE EXISTING TRAFFIC SIGNAL EQUIPMENT 89502200 EACH MODIFY EXISTING CONTROLLER 89502300 REMOVE ELECTRIC CABLE FROM CONDUIT FOOT 1138 89502385 REMOVE EXISTING CONCRETE FOUNDATION EACH X4402020 CONCRETE MEDIAN SURFACE REMOVAL SO FT 1115 X8760200 ACCESSIBLE PEDESTRIAN SIGNALS EACH X8760201 PEDESTRIAN PUSH-BUTTON POST FACH X8950450 REMOVE EXISTING UNDERGROUND CONDUIT FOOT 48

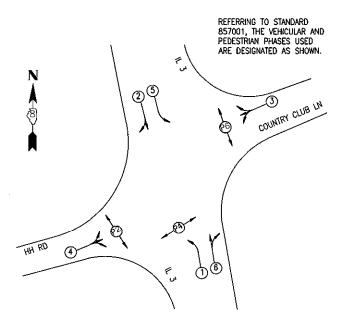



DETECTI INTERSECTION OF I			ND CALCULATIONS RD AND COUNTRY	CLUB LN	
LOOP	PHASE	LOOP SIZE (FT)	REQUIRED # OF TURNS	CALCULATED INDUCTANCE MICROHENRIES	CALCULATED RESISTANCE OHMS
HH ROAD EB THRU/LT	4	6' X 50' (Q)	3-6-3	814.16	2.230
HH ROAD EB RT	4	6' X 50' (Q)	3-6-3	815.48	2.260
COUNTRY CLUB LANE WB THRU/LT	3	6' X 50' (Q)	3-6-3	858.38	3.235
COUNTRY CLUB LANE WB RT	3	6' X 50' (Q)	3-6-3	858.38	3.235

THE ABOVE VALUES ARE CALCULATED OF COMBINED LOOP AND LEAD-IN INDUCTANCE AND RESISTANCE. ACTUAL MEASURED VALUES SHOULD BE WITHIN +/- 20% OF THESE VALUES

MONROE COUNTY **HIGHWAY DEPARTMENT** 

								F.A.P. ROUTE	SECTION	COUNTY	TOTAL SHEETS	SHEE
								312	21-00062-04-SW	MONROE	13	10
										CONTRACT	NO. 9	7775
SCALE: NTS SHEET 1 OF				OF 4 SHEETS STA. TO STA.					IT LINOIS LEED A			

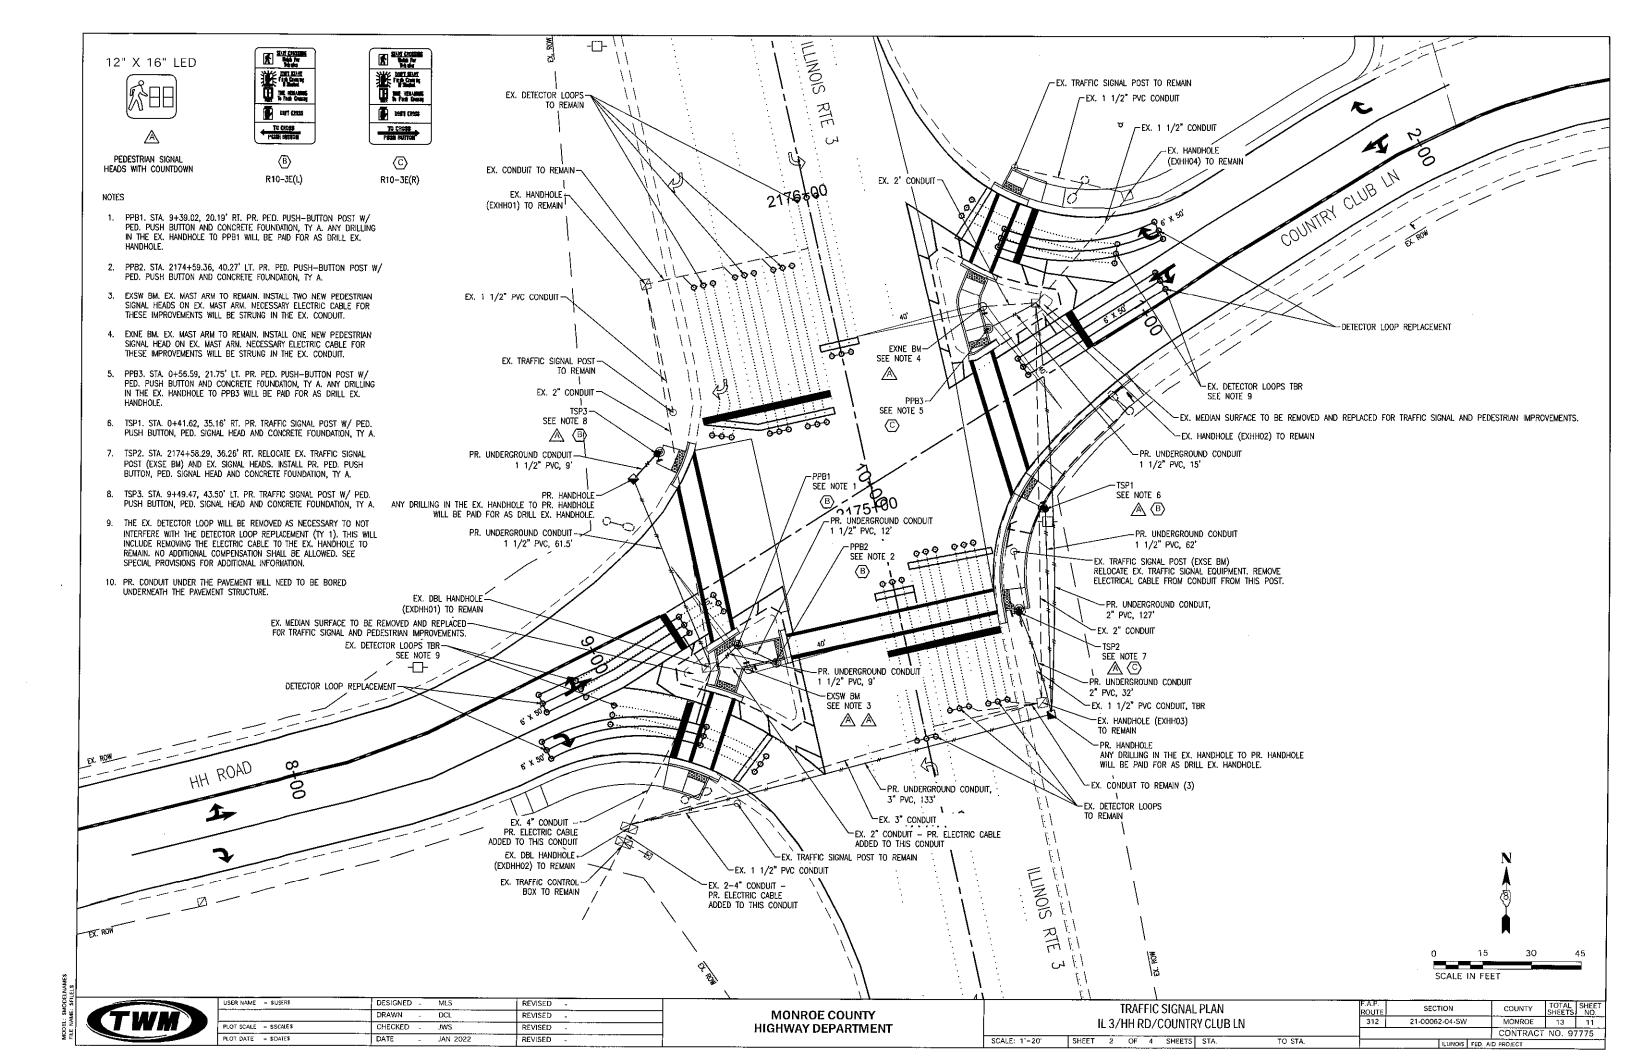


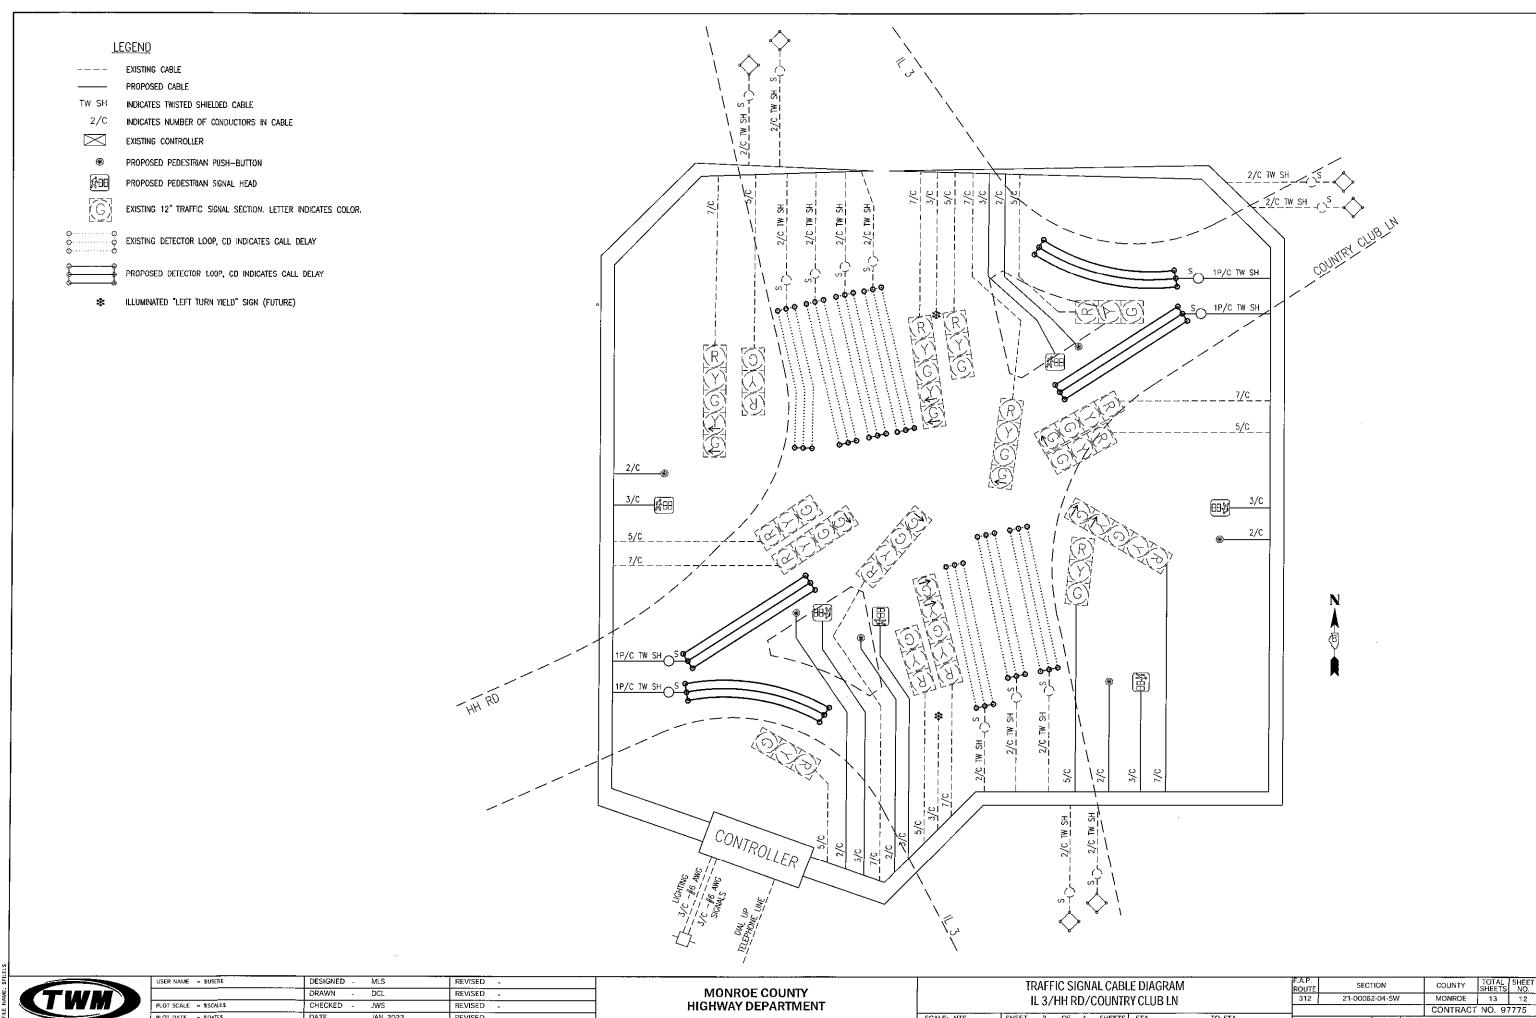


SCALE: NTS SHEET 3 OF 4 SHEETS STA.

TO STA.

JAN 2022

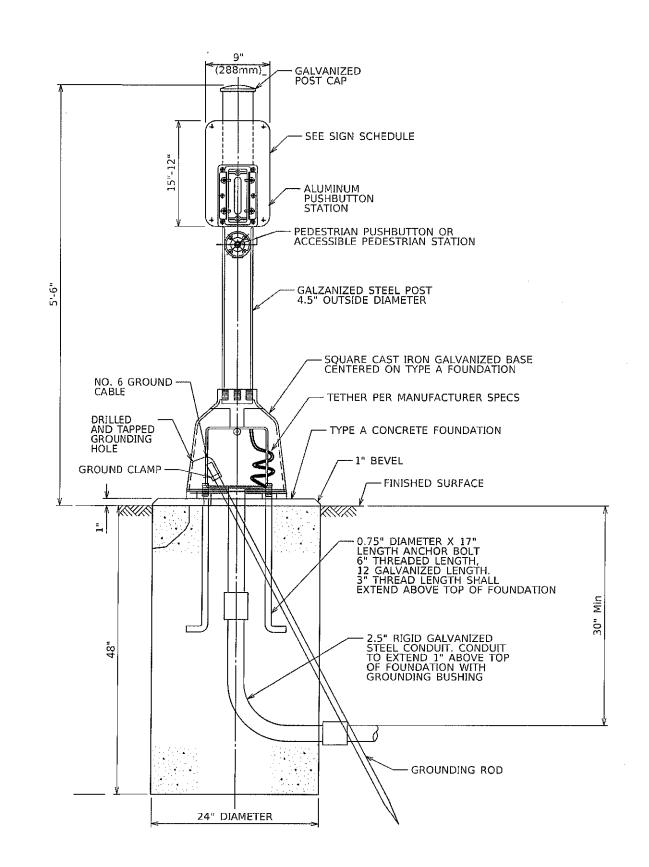

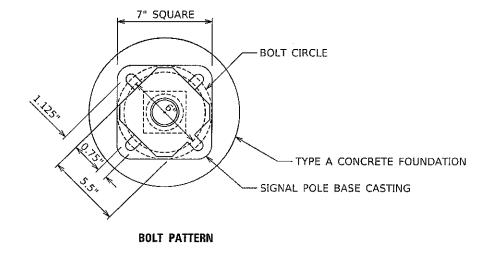

PEDESTRIAN PUSH-BUTTON POST



	USER NAME = \$USER\$	DESIGNED	-	MLS	REVISED	-	
		DRAWN	-	DCL	REVISED	-	
'	PLOT SCALE = \$SCALE\$	CHECKED	-	JWS	REVISED	-	
	PLOT DATE - SDAYE\$	DATE	-	JAN 2022	REVISED	-	

TRAFFIC SIGNAL DETAILS - PEDESTRIAN PUSH-BUTTON										SECTION		COUNTY	TOTAL SHEETS	SHEET NO.
	IL 3/HH RD/COUNTRY CLUB LN							312	21-00062-04-SW		MONROE	13	13	
											CONTRACT	NO. 97	7775	
	SCALE: NTS	SHEET	4	OF	4	SHEETS	STA.	TO STA.		ILLINOIS FED. AID PROJECT				