


SUMMARY OF QUANTITIES			URBAN	CONSTRUCTION TYPE CODE
PAY ITEM NUMBER	PAY ITEMS	UNITS	TOTAL QUANTITY	0014
20201200	REMOVAL AND DISPOSAL OF UNSUITABLE MATERIAL	CU YD	230	230
20800150	TRENCH BACKFILL	CU YD	14	14
21101615	TOPSOIL FURNISH AND PLACE, 4"	SO YD	55	55
25000210	SEEDING, CLASS 2A	ACRE	0.1	0.1
25000400	NITROGEN FERTILIZER NUTRIENT	POUND	1	1
25000500	PHOSPHORUS FERTILIZER NUTRIENT	POUND	1	1
25000600	POTASSIUM FERTILIZER NUTRIENT	POUND	1	1
25100630	EROSION CONTROL BLANKET	SO YD	110	110
28000250	TEMPORARY EROSION CONTROL SEEDING	POUND	5	5
28000400	PERIMETER EROSION BARRIER	FOOT	57	57
28000500	INLET AND PIPE PROTECTION	EACH	7	7
28100109	STONE RIPRAP, CLASS A5	SO YD	495	495
28200200	FILTER FABRIC	SO YD	495	495
31101200	SUB-BASE GRANULAR MATERIAL, TYPE B 4"	SO YD	680	680
35501316	HOT-MIX ASPHALT BASE COURSE, 8"	SO YD	580	580
40600100	BITUMINOUS MATERIALS (PRIME COAT)	GALLON	120	120
40603085	HOT-MIX ASPHALT BINDER COURSE, IL-19.0, N70	TON	85	85
40603340	HOT-MIX ASPHALT SURFACE COURSE, MIX "D", N70	TON	50	50
42300200	PORTLAND CEMENT CONCRETE DRIVEWAY PAVEMENT, 6 INCH	SO YD	25	25
42400200	PORTLAND CEMENT CONCRETE SIDEWALK 5 INCH	SO FT	1,265	1,265
42400800	DETECTABLE WARNINGS	SO FT	20	20
44000100	PAVEMENT REMOVAL	SO YD	615	615
44000200	DRIVEWAY PAVEMENT REMOVAL	SO YD	25	25.0
44000500	COMBINATION CURB AND GUTTER REMOVAL	FOOT	237	237
44000600	SIDEWALK REMOVAL	SO FT	851	851
50101500	REMOVAL OF EXISTING SUPERSTRUCTURES	EACH	1	1
50300255	CONCRETE SUPERSTRUCTURE	CU YD	240.4	240.4
50300260	BRIDGE DECK GROOVING	SO YD	317	317
50300300	PROTECTIVE COAT	SO YD	459	459
50800205	REINFORCEMENT BARS, EPOXY COATED	POUNDS	48,590	48,590
50901750	PARAPET RAILING	FOOT	113	113
51500100	NAME PLATES	EACH	1	1
52100010	ELASTOMERIC BEARING ASSEMBLY, TYPE I	EACH	24	24
59000200	EPOXY CRACK INJECTION	FOOT	221	221
60200305	CATCH BASINS, TYPE A, 4'-DIAMETER, TYPE 3 FRAME AND GRATE	EACH	1	1
60235700	INLETS, TYPE A, TYPE 3 FRAME AND GRATE	EACH	1	1
60604400	COMBINATION CONCRETE CURB AND GUTTER, TYPE B - 6.18	FOOT	170	170
67000400	ENGINEER'S FIELD OFFICE, TYPE A	CAL MO	4	4
67100100	MOBILIZATION	L SUM	1	1
70106800	CHANGEABLE MESSAGE SIGN	CAL MO	16	16
70300220	TEMPORARY PAVEMENT MARKING - LINE 4"	FOOT	2,440	2,440
70300260	TEMPORARY PAVEMENT MARKING - LINE 12"	FOOT	80	80
78000510	EPOXY PAVEMENT MARKING - LINE 4"	FOOT	610	610
78000510	EPOXY PAVEMENT MARKING - LINE 12"	FOOT	20	20
X2070304	POROUS GRANULAR EMBANKMENT, SPECIAL	CU YD	15.8	15.8
X4021000	TEMPORARY ACCESS (PRIVATE ENTRANCE)	EACH	1	1
X5091755	PARAPET RAILING, SPECIAL	FOOT	59.0	59.0
X6061900	CONCRETE MEDIAN, TYPE SB-6.12 (SPECIAL)	SO FT	200.0	200.0
X7010216	TRAFFIC CONTROL AND PROTECTION, SPECIAL	L SUM	1.0	1.0
Z0012754	STRUCTURAL REPAIR OF CONCRETE (DEPTH EQUAL TO OR LESS THAN 5 INCHES)	SO FT	170.0	170.0
Z0013798	CONSTRUCTION LAYOUT	L SUM	1.0	1.0
Z0021904	SILICONE JOINT SEALER, 1"	FOOT	155.0	155.0
Z0042002	POROUS GRANULAR EMBANKMENT, SUBGRADE	CU YD	226.0	226.0
Z0056648	STORM SEWERS, TYPE 1, WATER MAIN QUALITY PIPE, 12 INCH	FOOT	66.0	66.0

* SPECIAL TY ITEM
 △ SPECIAL PROVISION PROVIDED

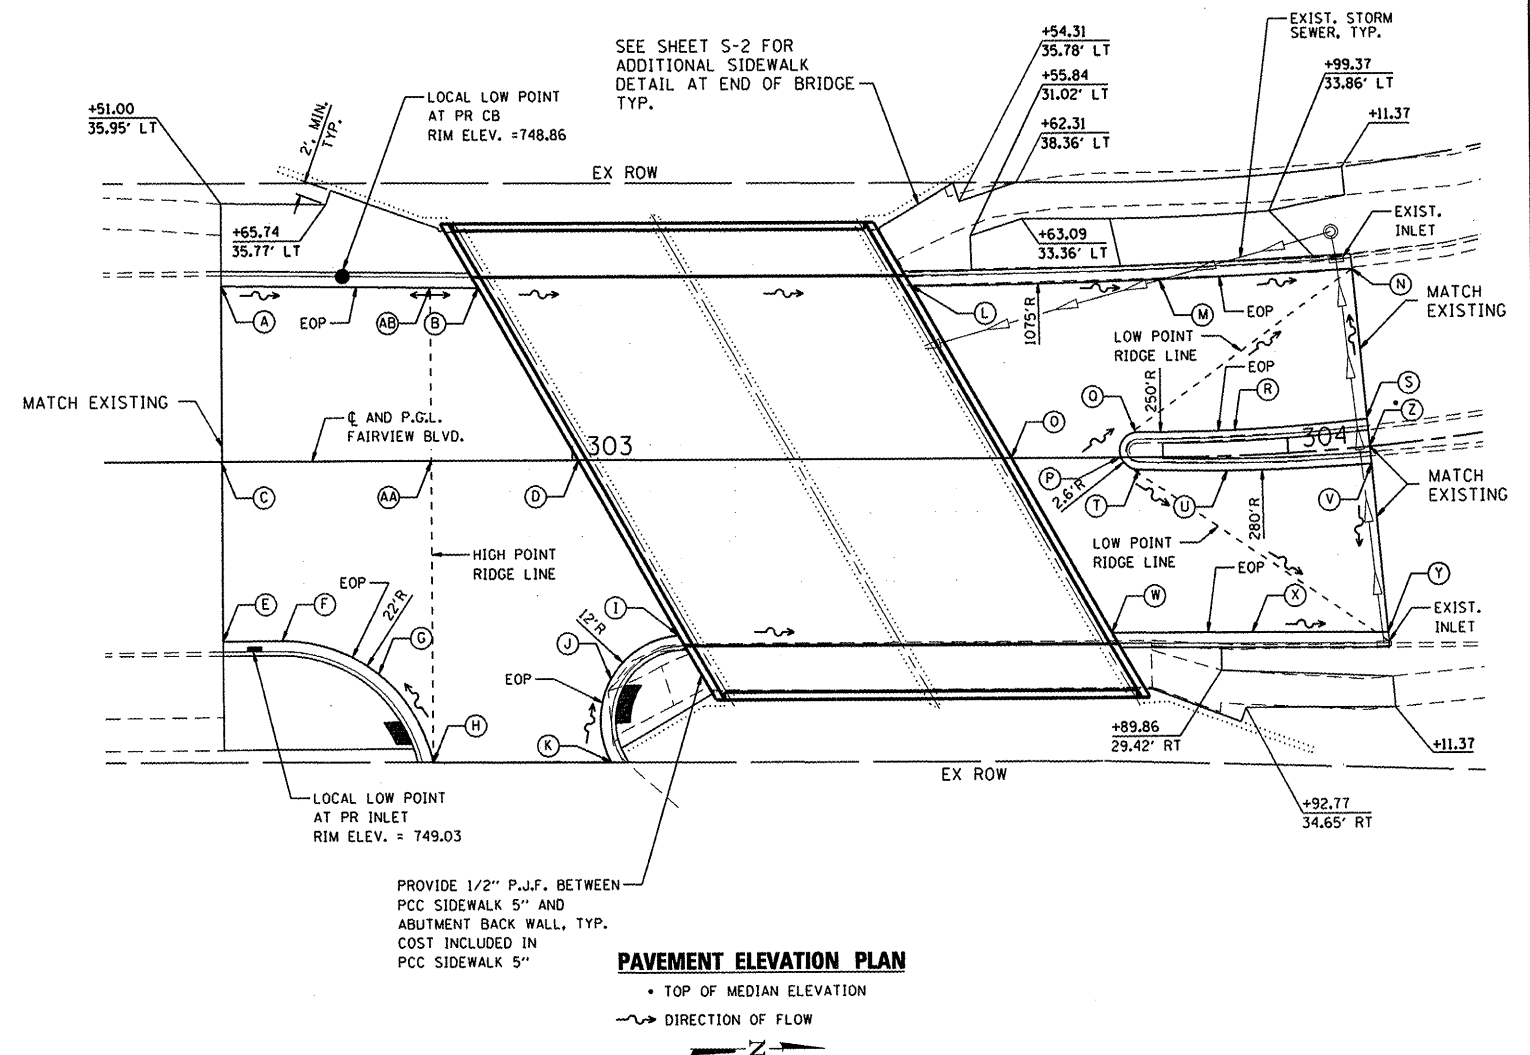

POINT	STATION	OFFSET (FT)	ELEVATION
A	302+51.00	24.36 LT	748.88
B	302+86.93	24.00 LT	749.01
C	302+51.00	0.00 LT	749.37
D	303+00.82	0.00 LT	749.30
E	302+51.00	24.59 RT	749.05
F	302+59.28	24.58 RT	749.01
G	302+72.74	29.29 RT	749.25
H	302+80.29	41.39 RT	749.48
I	303+14.73	24.00 RT	748.87
J	303+05.17	30.13 RT	749.15
K	303+05.11	41.47 RT	749.42
L	303+47.51	24.00 LT	748.70
M	303+78.35	24.58 LT	748.43
N	304+11.37	24.86 LT	748.14

POINT	STATION	OFFSET (FT)	ELEVATION
O	303+61.40	0.00 LT	748.99
P	303+76.73	0.00 LT	748.92
Q	303+79.21	3.53 LT	748.85
R	303+95.27	3.61 LT	748.90
S	304+11.37	3.89 LT	749.22
T	303+79.13	1.66 RT	748.88
U	303+95.28	2.06 RT	748.92
V	304+11.37	2.35 RT	749.12
W	303+75.29	24.00 RT	748.56
X	303+93.98	24.28 RT	748.34
Y	304+11.37	25.57 RT	748.13
Z	304+11.37	0.00 LT	749.58
AA	302+80.00	0.00 LT	749.40
AB	302+80.00	24.06 LT	749.04

PAVEMENT ELEVATION TABLE
 OFFSETS ARE BASED ON Q ROADWAY

COMPANY NAME: HRGreen.com
 PROJECT CONTACT: WJH
 CLIENT: CITY OF ROCKFORD
 DATE PLOTTED: 3/31/2011 12:56:02 AM
 FILE NAME: 86100021-Soq.dgn
 PLOT NUMBER: 1
 PEN TABLE: 3/11/07 22:54:41



USER NAME: KofFt	DESIGNED: KMA	REVISED:
FILE NAME: 86100021-Soq.dgn	DRAWN: WJH	REVISED:
PLOT SCALE: N.T.S.	CHECKED: RGD	REVISED:
PLOT DATE: 3/31/2011	DATE: 3/31/11	REVISED:

CITY OF ROCKFORD

SUMMARY OF QUANTITIES			
FAIRVIEW BOULEVARD OVER KEITH CREEK			
SCALE: N.T.S.	SHEET NO.	OF SHEETS	STA. TO STA.

F.A.U. RTE.	SECTION	COUNTY	TOTAL SHEETS	SHEET NO.
5141	10-00573-00-BR	WINNEBAGO	20	3
CONTRACT NO. 85540				
FED. ROAD DIST. NO. 2 (ILLINOIS) FED. AID PROJECT				