STATE OF ILLINOIS

DEPARTMENT OF TRANSPORTATION

DIVISION OF HIGHWAYS

PLANS FOR PROPOSED FEDERAL AID HIGHWAY

INDEX TO SHEETS:

SHEET NO. DESCRIPTION COVER SHEET

GENERAL NOTES SUMMARY OF QUANTITIES TYPICAL SECTIONS
PLAN SHEETS 7-15. SIGN INVENTORY

EROSION AND SEDIMENT CONTROL PLANS EROSION AND SEDIMENT CONTROL NOTES

STREET RETURN DETAILS, PIPE HANDRAIL DETAIL, RETAINING WALL DETAIL & HOT-MIX

ASPHALT MIXTURE CHART
DISTRICT 1 DETAIL-TC10-TRAFFIC CONTROL AND PROTECTION FOR SIDE ROADS
DISTRICT 1 DETAIL-TC13-TYPICAL PAVEMENT MARKINGS
CROSS-SECTIONS; ROBERTS ROAD R.O.W.

HIGHWAY STANDARDS:

STANDARD NO. DESCRIPTION

STANDARD SYMBOLS, ABBREVIATIONS AND PATTERNS TEMPORARY EROSION CONTROL SYSTEMS CURB RAMPS FOR SIDEWALKS 000001-06:

280001-05:

604036-02: 606001-04: **GRATE TYPE 8**

CONCRETE CURB TYPE B AND COMBINATION CONCRETE CURB AND GUTTER URBAN LANE CLOSURE, MULTILANE, 2W WITH MOUNTABLE MEDIAN LANE CLOSURE, MULTILANE 1W OR 2W CROSSWALK OR SIDEWALK CLOSURE TRAFFIC CONTROL DEVICES 701606-07:


701801-04: 701901-01:

TYPICAL PAVEMENT MARKINGS

ADT=32,500 (2006) 79th STREET =22,500 (2006) ROBERTS ROAD SPEED LIMIT=35 MPH (ROBERTS RD) =45 MPH (79th ST)

DESIGN SPEED = 35 MPH (ROBERTS RD) =45 MPH (79th ST)

DESIGN DESIGNATION = MINOR ARTERIAL

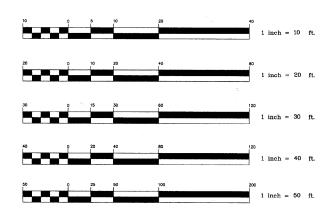


FULL SIZE PLANS HAVE BEEN PREPARED USING STANDARD ENGINEERING SCALES, REDUCED SIZED PLANS MILL NOT CONFORN TO STANDARD SCALES, IN MAKING MEASUREMENTS ON REDUCED PLANS, THE ABOVE SCALES MAY BE USED

JOINT UTILITY LOCATION FOR EXCAVATION 1-800-892-0123 -OR- 811

CONTRACT NO. 63441

FAU RTE 1548 (79th ST) & FAU RTE 2757 (ROBERTS RD) SIDEWALK CONSTRUCTION **CORK AVE TO ROBERTS RD ON 79th ST** 79th ST TO I-294 TOLLWAY ON ROBERTS RD SECTION NO. 01-00024-00-SW PROJECT NO: CMM-9003(287) JOB NO: C-91-499-09 VILLAGE OF JUSTICE COOK COUNTY THIS PROJECT IS LOCATED IN THE VILLAGE OF JUSTICE

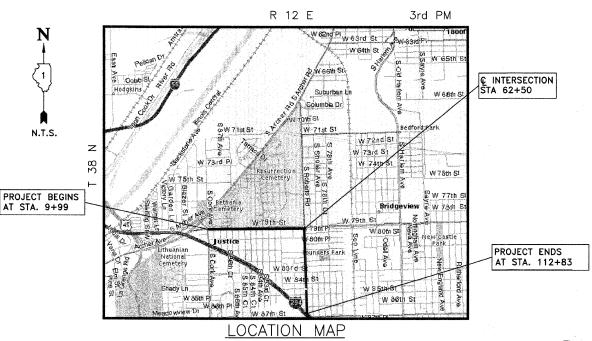





GROSS LENGTH OF PROJECT

10,284 FEET (1.95 MILES) 10,284 FEET (1.95 MILES)

FAU RTEs.	SECTI	ON	COUNTY	TOTAL SHEETS	SHEET NO.
1547, 2757	01-00024	-00-SW	COOK	24	1
STA. 09+99		Ŧ	O STA. 112	2+83	
FED. ROAD	DIST. NO.	ILLINOIS	FED. AID	PROJECT	
CONTRACT	VO 6344	1			

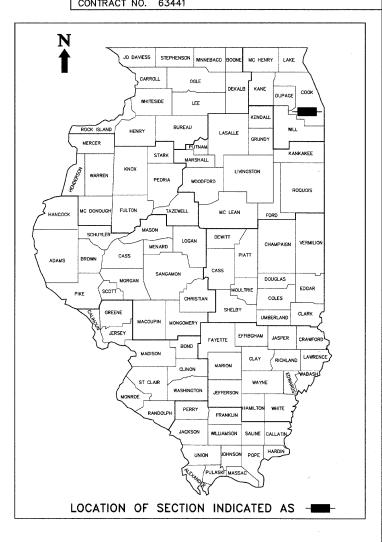

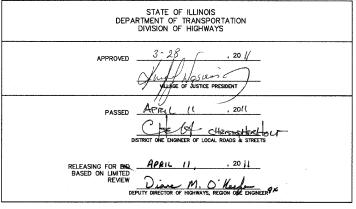



GENERAL NOTES

UTILITIES

THE CONTRACTOR SHALL BE RESPONSIBLE FOR CONTACTING THE OWNER OF ALL EXISTING FACILITIES SO THAT THE UTILITIES AND THEIR APPURTENANCES MAY BE LOCATED AND ADJUSTED OR MOVED, IF NECESSARY, PRIOR TO THE START OF CONSTRUCTION OPERATIONS. THE CONTRACTORS SHALL COOPERATE WITH ALL UTILITY OWNERS AS PROVIDED FOR IN THE STANDARD SPECIFICATIONS.

THE LOCATIONS OF EXISTING DRAINAGE STRUCTURES, STORM AND SANITARY SEWERS, WATER SERVICE LINES AND OTHER UTILITY LINES ARE APPROXIMATE, AND THE VILLAGE DOES NOT GUARANTEE THEIR ACCURACY, THEIR EXACT HORIZONTAL AND VERTICAL LOCATIONS ARE TO BE DETERMINED IN THE FIELD BY THE CONTRACTOR AT HIS OWN EXPENSE.

THE CONTRACTOR SHALL BE RESPONSIBLE FOR THE PROTECTION OF ALL UNDERGROUND OR SURFACE UTILITIES EVEN THOUGH THEY MAY NOT BE SHOWN ON THE PLANS. ANY UTILITY THAT IS DAMAGED DURING CONSTRUCTION SHALL BE REPAIRED OR REPLACED TO THE SATISFACTION OF THE ENGINEER OR THE VILLAGE. THIS WORK SHALL BE AT THE CONTRACTORS EXPENSE.

COORDINATION OF ALL UTILITY WORK INVOLVED IN THE CONSTRUCTION AREA WILL BE DISCUSSED AT THE PRECONSTRUCTION

BEFORE STARTING ANY EXCAVATION, THE CONTRACTOR SHALL CALL "JULIE" AT 800-892-0123 FOR FIELD LOCATIONS OF BURIED ELECTRIC, TELEPHONE, GAS AND CABLE TELEVISION FACILITIES. (48 HOURS NOTIFICATION IS REQUIRED.)

STORM SEWER

WHENEVER, DURING CONSTRUCTION OPERATIONS, ANY LOOSE MATERIAL IS DEPOSITED IN THE FLOW LINE OF DRAINAGE STRUCTURES SUCH THAT THE NATURAL FLOW OF WATER IS OBSTRUCTED, IT SHALL BE REMOVED AT THE CLOSE OF EACH WORKING DAY. AT THE CONCLUSION OF CONSTRUCTION OPERATIONS, ALL UTILITY STRUCTURES SHALL BE FREE FROM DIRT AND DEBRIS. THE WORK SPECIFIED ABOVE WILL NOT BE PAID FOR SEPARATELY BUT SHALL BE INCLUDED IN THE COST FOR FRAMES AND LIDS TO BE ADJUSTED (SPECIAL) OR MANHOLES TO BE ADJUSTED.

ANY EXISTING OR PROPOSED STORM SEWER DAMAGED BY THE CONTRACTOR DURING CONSTRUCTION SHALL BE REPLACED BY THE CONTRACTOR AT HIS OR HER OWN EXPENSE.

RESTORATION

CONTRACTOR IS TO RESTORE ALL UNPAVED AREAS DAMAGED DURING CONSTRUCTION OPERATIONS TO THEIR ORIGINAL CONDITION INCLUDING THE FINE GRADING AND SODDING OR SEEDING OF AREAS WITHIN EASEMENTS AND RIGHTS-OF-WAY.

TRAFFIC SIGNS
THE RESIDENT ENGINEER SHALL CONTACT THE TRAFFIC CONTROL SUPERVISOR AT (847)705-4470 PRIOR TO THE PLACEMENT OF ANY TEMPORARY TRAFFIC CONTROL DEVICES.

THE COOK COUNTY TRAFFIC FIELD OFFICE SHALL BE CONTACTED PRIOR TO ANY REMOVAL AND RELOCATION OF TRAFFIC AND PARKING SIGNS ON ROBERTS ROAD.

THE COST OF REMOVAL AND RE-INSTALLATION OF TRAFFIC SIGNS WHICH ARE IN CONFLICT WITH, BLOCK ACCESS TO THE PROPOSED WORK, OR INHIBIT CONSTRUCTION IN ANY WAY, SHALL BE PAID FOR IN ACCORDANCE WITH ARTICLE 107.25 OF THE

MISCELLANEOUS

ACCESS: THE CONTRACTOR SHALL PROVIDE ACCESS TO ABUTTING PROPERTY AT ALL TIMES DURING THE CONSTRUCTION OF THIS PROJECT, EXCEPT FOR PERIODS OF SHORT DURATION

DIMENSIONS: IT SHALL BE THE CONTRACTOR'S RESPONSIBILITY TO VERIFY ALL DIMENSIONS AND CONDITIONS EXISTING IN THE FIE'D PRIOR TO ORDERING MATERIALS AND BEGINNING CONSTRUCTION.

ALL SAWCUTTING SHALL BE INCLUDED IN THE UNIT OF COST OF REMOVAL ITEMS AND SHALL BE PERFORMED PRIOR TO BEGINNING REMOVAL. ANY ITEMS OF WORK REMOVED PRIOR TO SAWCUTTING WILL NOT BE MEASURED FOR PAYMENT.

BARRICADES: THE CONTRACTOR SHALL PROVIDE AND INSTALL TWO (2) WEIGHTED SAND BAGS ON EACH TYPE I OR TYPE II BARRICADE USED. (ONE (1) WEIGHTED SAND BAG ACROSS EACH BOTTOM RAIL.) TYPE III BARRICADES SHALL HAVE A MINIMUM OF FOUR SANDBAGS PER BARRICADE.

ANY EXISTING PAVEMENT DAMAGED BY THE CONTRACTOR DURING THE CONSTRUCTION SHALL BE REPLACED/REPAIRED BY THE CONTRACTOR AT HIS/HERS OWN EXPENSE TO THE SATISFACTION OF THE ENGINEER WITH NO ADDITIONAL COMPENSATION TO THE CONTRACTOR.

THE CONTRACTOR SHALL TAKE CARE TO PROTECT AND PRESERVE ALL STAKING AND MARKING DURING CONSTRUCTION. CONTINUOS DESTRUCTION OF STAKES AS A RESULT OF CARELESSNESS MAY RESULT IN DAMAGES,

HOEFFERLE-BUTLER ENGINEERING SHALL BE NOTIFIED AT LEAST TWO (2) WORKING DAYS PRIOR TO THE COMMENCEMENT OF WORK. THEY SHALL BE NOTIFIED AT LEAST 72 HOURS IN ADVANCE IF CONSTRUCTION STAKING IS REQUIRED.

FAU RTEs.	SECTI	ON	COUNTY	TOTAL SHEETS	SHEET NO.
1547, 2757	01-00024	-00-SW	COOK	24	2
STA. 09+99)	7	O STA. 112-	+83	
FED. ROAD	DIST. NO.	ILLINOIS	FED. AID F	PROJECT	
CONTRACT	NO. 6344	1			

ILLINOIS DEPARTMENT OF TRANSPORTATION
VILLAGE OF JUSTICE
79th STREET & ROBERTS ROAD SIDEWALK CONSTRUCTION
CORK AVENUE TO ROBERTS ROAD
79th STREET TO I—294
GENERAL NOTES DRAWN BY: JAH
12/03/09 CHECKED BY: SAL

| NOOTHENDO | MOOTHENDO | MACHINE |


SUMMARY OF QUANTITIES

FAU RTEs.	SECTION	ON	COUNTY	TOTAL SHEETS	SHEET NO.
1547, 2757	01-00024	-00-SW	COOK	24	3
STA. 09+99		1	O STA. 112-	-83	
FED. ROAD	DIST. NO.	ILLINOIS	FED. AID I	PROJECT	
CONTRACT	NO. 6344	1	***************************************		

ITEM No.	ITEMS	UNITS	CONSTRUCTION TYPE CODE 0021 QTY.
20100110	TREE REMOVAL (6 TO 15 UNITS DIAMETER))	UNIT	39
		1	
20200100	EARTH EXCAVATION	CU YD	25
21101615	TOPSOIL FURNISH AND PLACE, 4"	SQ YD	4,136
21400100	GRADING AND SHAPING DITCHES	FOOT	900
25000210	SEEDING, CLASS 2A	ACRE	0.75
25000400	NITROGEN FERTILIZER NUTRIENT	POUND	52
25000500	PHOSPHOROUS FERTILIZER NUTRIENT	POUND	52
25000600	POTASSIUM FERTILIZER NUTRIENT	POUND	52
25100630	EROSION CONTROL BLANKET	SQ YD	1,500
25200110	SODDING, SALT TOLERANT	SQ YD	1,500
X2800500	TEMPORARY DITCH CHECKS, SPECIAL	EACH	6
28000400	PERIMETER EROSION BARRIER	FOOT	3,520
28000500	INLET AND PIPE PROTECTION	EACH	1
78000510	INLET FILTERS	EACH	9
31101200	SUB BASE GRANULAR MATERIAL, TYPE B 4"	SQ YD	72
35102000	AGGREGATE BASE COURSE, TYPE B 8"	SQ YD	42
35102200	AGGREGATE BASE COURSE, TYPE B 10"	SQ YD	1,053
35501287	HOT-MIX ASPHALT BASE COURSE, 2 1/4"	SQ YD	1,095
35600700	HOT-MIX ASPHALT BASE COURSE WIDENING, 6"	SQ YD	72
40000040			
	HOT-MIX ASPHALT SURFACE COURSE, MIX "C", N50	TON	92
40603595	POLYMERIZED HOT-MIX ASPHALT SURFACE COURSE, MIX "F", N90	TON	44
42400200	PORTLAND CEMENT CONCRETE SIDEWALK 5 INCH	SQ FT	26,857
42400410	PORTLAND CEMENT CONCRETE SIDEWALK 8 INCH	SQ FT	390
42400800	DETECTABLE WARNINGS	SQ FT	830
44000200	DRIVEWAY PAVEMENT REMOVAL	SQ YD	1,379
44000300	CURB REMOVAL	FOOT	288
44000500	COMBINATION CURB AND GUTTER REMOVAL	FOOT	378

ITEM No.	ITEMS	UNITS	CONSTRUCTION TYPE CODE 0021 QTY.
44000600	SIDEWALK REMOVAL	SQ FT	150
50105220	PIPE CULVERT REMOVAL	FOOT	30
50901760	PIPE HANDRAIL	FOOT	136
550A0050	STORM SEWERS, CLASS A, TYPE 1 12"	FOOT	20
56500600	DOMESTIC WATER SERVICE BOXES TO BE ADJUSTED	EACH	7
60107600	PIPE UNDERDRAINS 4"	FOOT	282
60255500	MANHOLES TO BE ADJUSTED	EACH	7
60265700	VALVE VAULTS TO BE ADJUSTED	EACH	3
60266600	VALVE BOXES TO BE ADJUSTED	EACH	1
60402210	GRATES, TYPE 8	EACH	2
60603800	COMBINATION CONCRETE CURB AND GUTTER, TYPE B-6.12	FOOT	1,872
63200310	GUARDRAIL REMOVAL	FOOT	5
67100100	MOBILIZATION	L SUM	1
70102625	TRAFFIC CONTROL AND PROTECTION , STANDARD 701606	L SUM	1
70102640	TRAFFIC CONTROL AND PROTECTION , STANDARD 701801	L SUM	.1
Z0013302	SEGMENTAL CONCRETE BLOCK WALL	SQ FT	1,343
Z127900	RETAINING WALL REMOVAL	FOOT	5
X0323569	STEEL POST REMOVAL	EACH	2
X0326681	REMOVE AND RE-ERECT BOULDERS	L SUM	1
X4021000	TEMPORARY ACCESS (PRIVATE ENTRANCE)	EACH	4
X4022000	TEMPORARY ACCESS (COMMERCIAL ENTRANCE)	EACH	22
XX003505	PORTLAND CEMENT CONCRETE SIDEWALK 10 INCH (SPECIAL)	SQ FT	1,626
XX007747	PARK BENCH REMOVAL AND REPLACEMENT	EACH	5

* DENOTES SPECIALTY ITEM

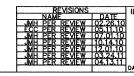

INOIS DEPARTMENT OF TRANSPORTATION
VILLAGE OF JUSTICE
79th STREET & ROBERTS ROAD
SIDEWALK CONSTRUCTION
SUMMARY OF QUANTITIES &
HMA MIXTURE CHART


TE: 12/03/09

DRAWN BY: J CHECKED BY: S (2) EXISTING CURB AND GUTTER (DEPRESSED) (3) EXISTING HOT-MIX ASPHALT DRIVEWAY PAVEMENT SECTION A-A EXISTING TYPICAL CROSS SECTION AT HIT-MIX ASPHALT DRIVEWAYS 79th ST & ROBERTS RD (COMMERCIAL AND RESIDENTIAL) EXISTING CURB (WHERE SHOWN ON PLANS) R.O.W. EXISTING DRIVEWAY PAVEMENT EXISTING CURB AND GUTTER


HOT-MIX ASPHALT DRIVEWAY DETAIL (COMMERCIAL AND RESIDENTIAL)

(1) EXISTING ROADWAY PAVEMENT

| FAU | SECTION | COUNTY | TOTAL SHEET | SHEETS | NO. | 1547, 2757 | 01-00024-00-SW | COOK | 24 | 4 | | STA. 09+99 | TO STA. 112+83 | FED. ROAD DIST. NO. | ILLINOIS | FED. AID | PROJECT | CONTRACT NO. | 63441 |

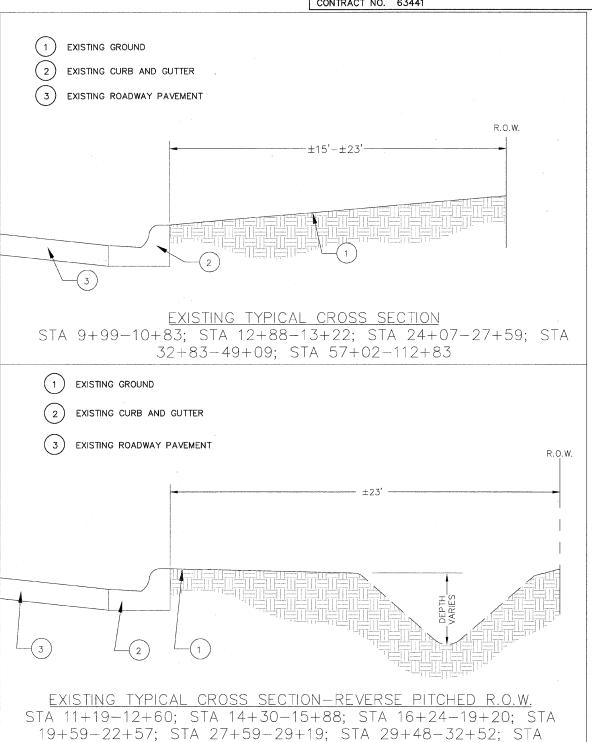

LINOIS DEPARTMENT OF TRANSPORTATION VILLAGE OF JUSTICE
79th STREET & ROBERTS ROAD SIDEWALK CONSTRUCTION CORK AVENUE TO ROBERTS ROAD 79th STREET TO 1-294
TYPICAL EXISTING SECTIONS
DRAWN BY:

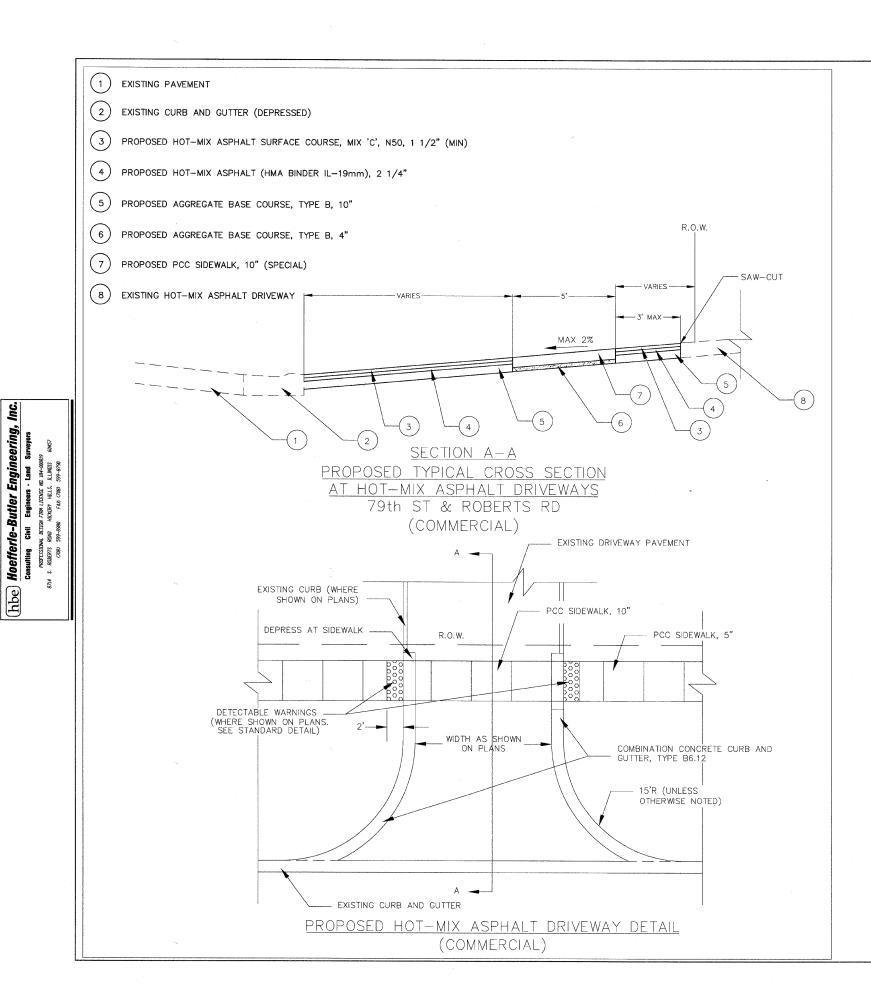


hbe

FAU RTEs. SHEET NO. TOTAL SECTION COUNTY SHEETS 1547, 2757 01-00024-00-SW COOK STA. 09+99 TO STA. 112+83 FED. ROAD DIST. NO. ILLINOIS FED. AID PROJECT CONTRACT NO. 63441

- (1) PROPOSED P.C.C. SIDEWALK, 5"
- PROPOSED AGGREGATE BASE COURSE, TYPE B, 4"
- EXISTING GROUND


- EXISTING CURB AND GUTTER
- EXISTING ROADWAY PAVEMENT
- PROPOSED SODDING (SALT TOLERANT) OR SEEDING (CLASS 2A)

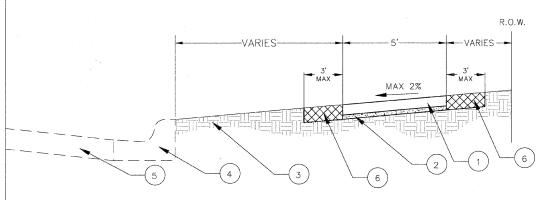

PROPOSED TYPICAL CROSS SECTION STA 9+99-10+83; STA 12+88-13+22; STA 24+07-27+59; STA 32+83-49+09; STA 57+02-112+83

- PROPOSED P.C.C. SIDEWALK, 5"
- PROPOSED AGGREGATE BASE COURSE, TYPE B, 4"
- EXISTING GROUND

- (5) EXISTING ROADWAY PAVEMENT
- PROPOSED PIPE HANDRAIL WHERE INDICATED ON PLANS
- PROPOSED SODDING (SALT TOLERANT) OR SEEDING (CLASS 2A) R.O.W.

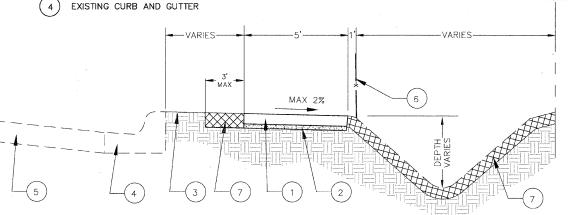

PROPOSED TYPICAL CROSS SECTION-REVERSE PITCHED SIDEWALK STA 11+19-12+60; STA 14+30-15+88; STA 16+24-19+20; STA 19+59-22+57; STA 27+59-29+19; STA 29+48-32+52; STA 49+40-55+77; STA 56+07-56+85

ILLINOIS DEPARTMENT OF TRANSPORTATION
VILLAGE OF JUSTICE
79th STREET & ROBERTS ROAD
SIDEWALK CONSTRUCTION
CORK AVENUE TO ROBERTS ROAD
79th STREET TO 1–294
TYPICAL PROPOSED SECTIONS
DATE: 12/03/09

JUNE 12/03/09


(hbe) Hoefferle-Butler Engineering, Inc.

Consulting Civil Engineers - Land Surveyors
PRETEXENAL REXION THA LIEDER AL 184-00689
8714 S. REMENTS ROAD HECKEY HELLS. ILLINGIS 64457
CORD 559-6899 FAM. CORD 559-6709


EXISTING PAVEMENT PROPOSED AGGREGATE BASE COURSE, TYPE B, 4" EXISTING CURB AND GUTTER (DEPRESSED) PCC SIDEWALK, 8" PROPOSED HOT-MIX ASPHALT SURFACE COURSE, MIX 'C', N50, 1 1/2" (MIN) (8) EXISTING HOT-MIX ASPHALT DRIVEWAY PROPOSED HOT-MIX ASPHALT BINDER COURSE, IL19.0, N50, 2 1/4" PROPOSED AGGREGATE BASE COURSE, TYPE B, 8" R.O.W. -VARIES-MAX 2% PROPOSED TYPICAL CROSS SECTION AT HOT-MIX ASPHALT DRIVEWAYS


(PRIVATE OR NON-COMMERCIAL)


FAU RTEs. SHEET NO. SECTION 1547, 2757 01-00024-00-SW COOK STA. 09+99 TO STA. 112+83 FED. ROAD DIST. NO. ILLINOIS FED. AID PROJECT CONTRACT NO. 63441

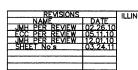



ILLINOIS DEPARTMENT OF TRANSPORTATION
VILLAGE OF JUSTICE
79th STREET & ROBERTS ROAD
SIDEWALK CONSTRUCTION
STREET RETURN, PIPE HANDRAIL,
& RETAINING WALL DETAILS

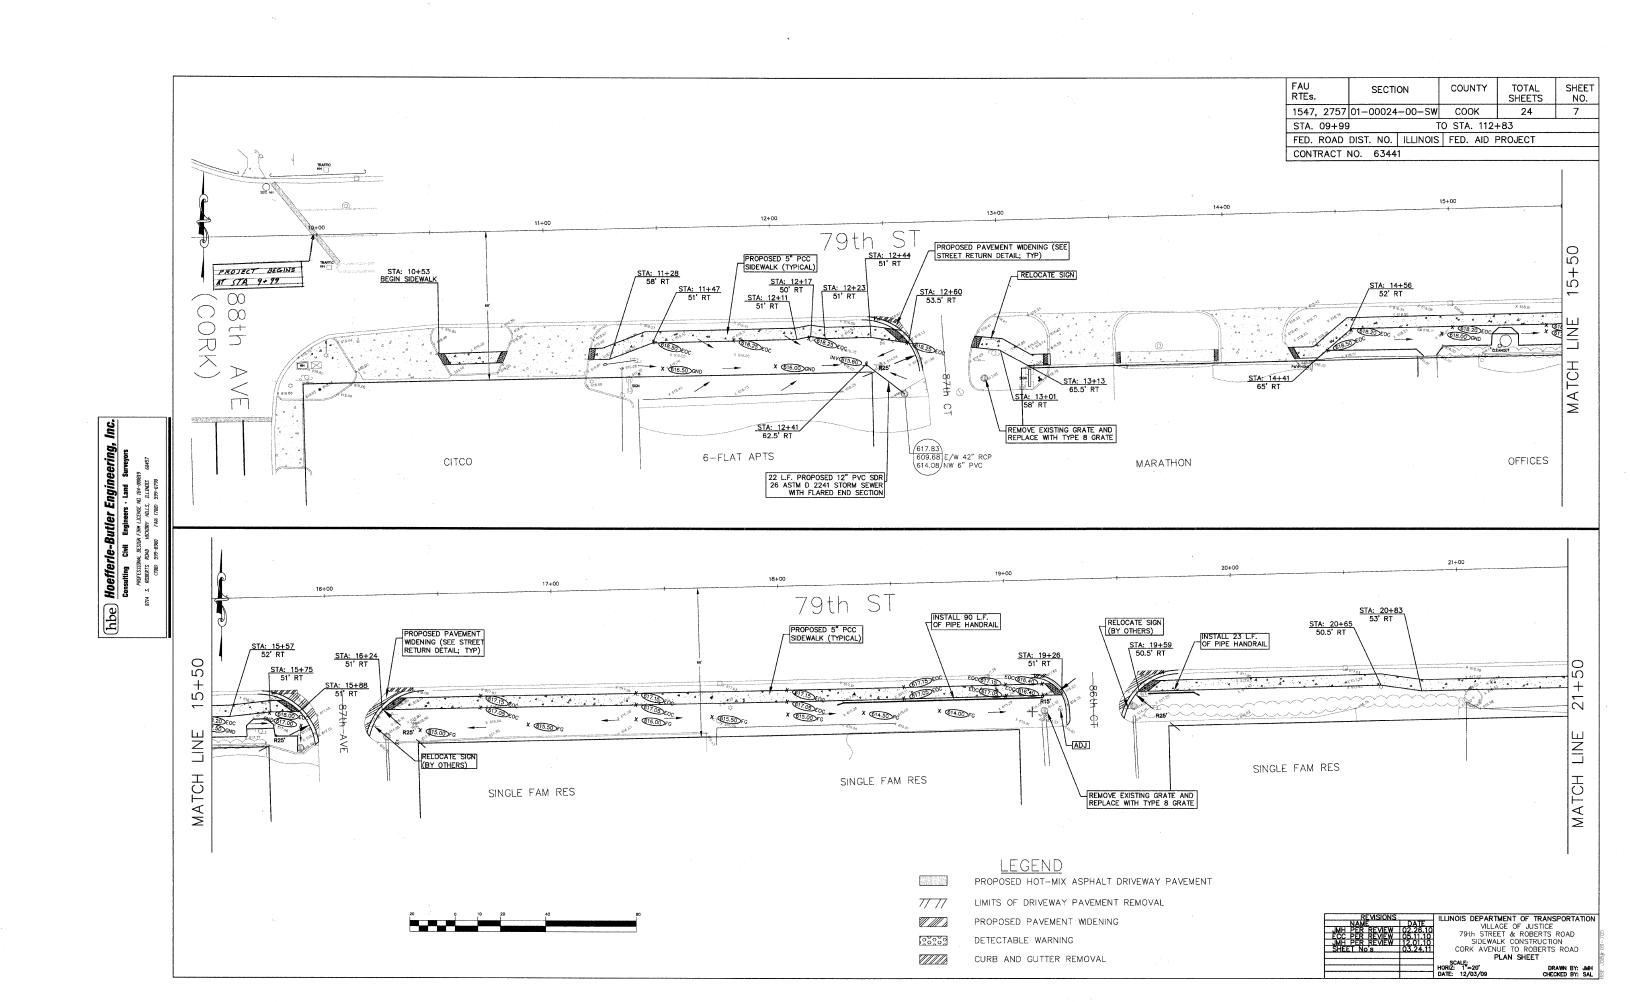


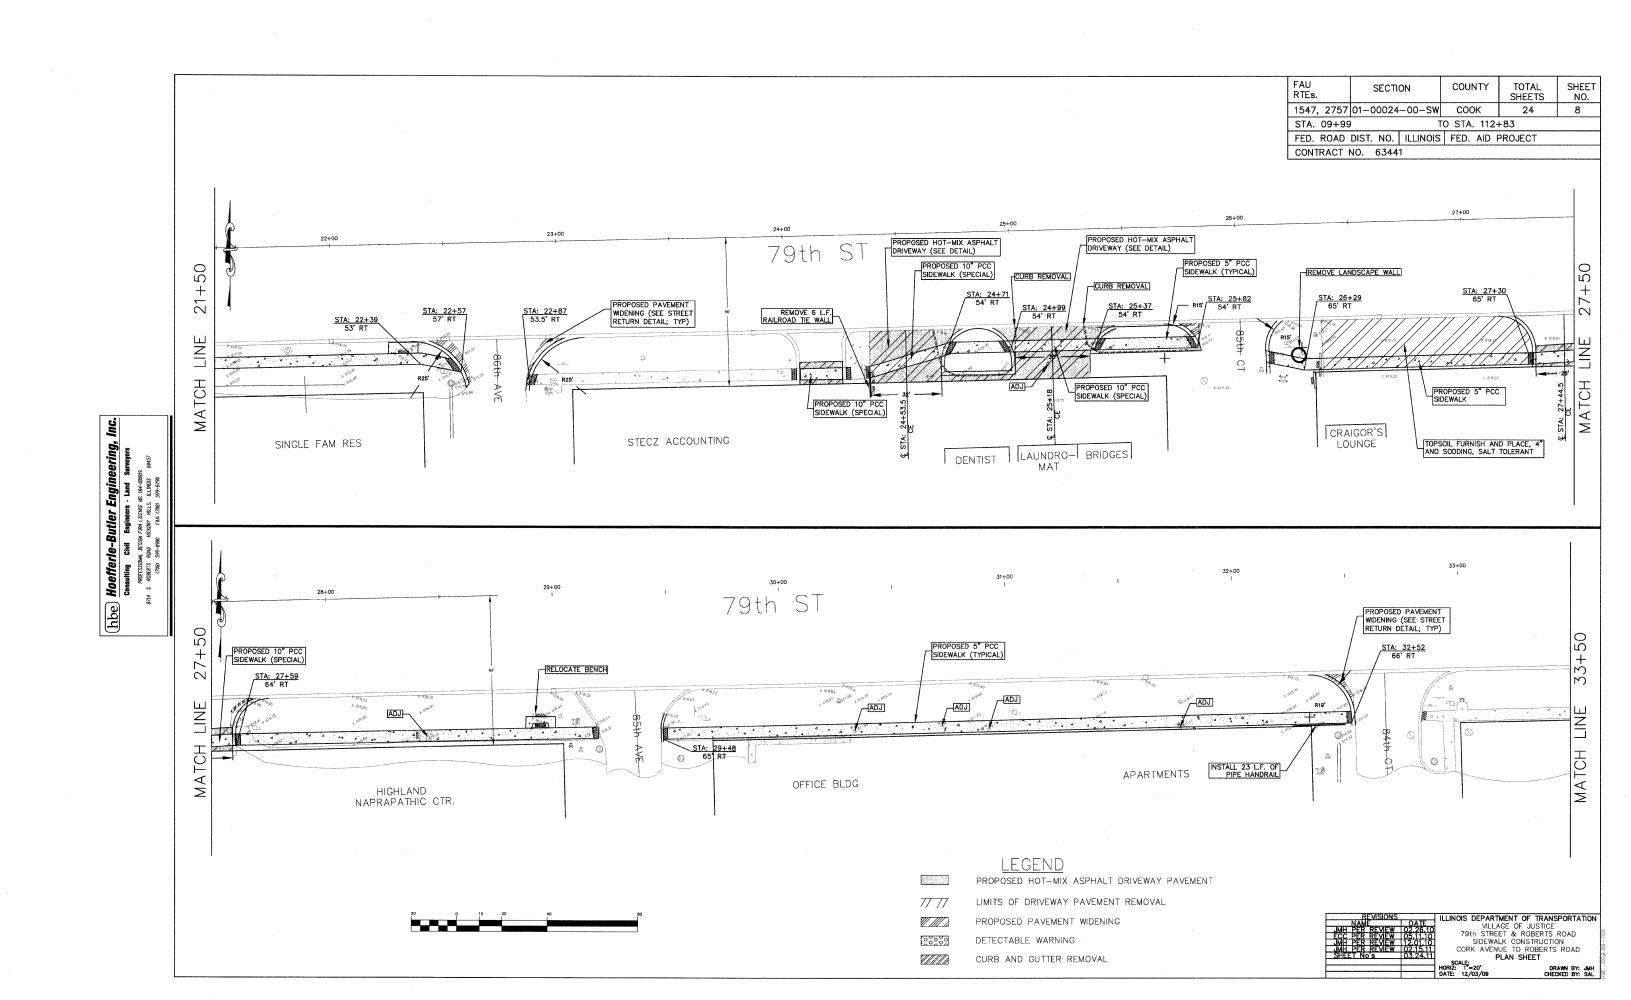


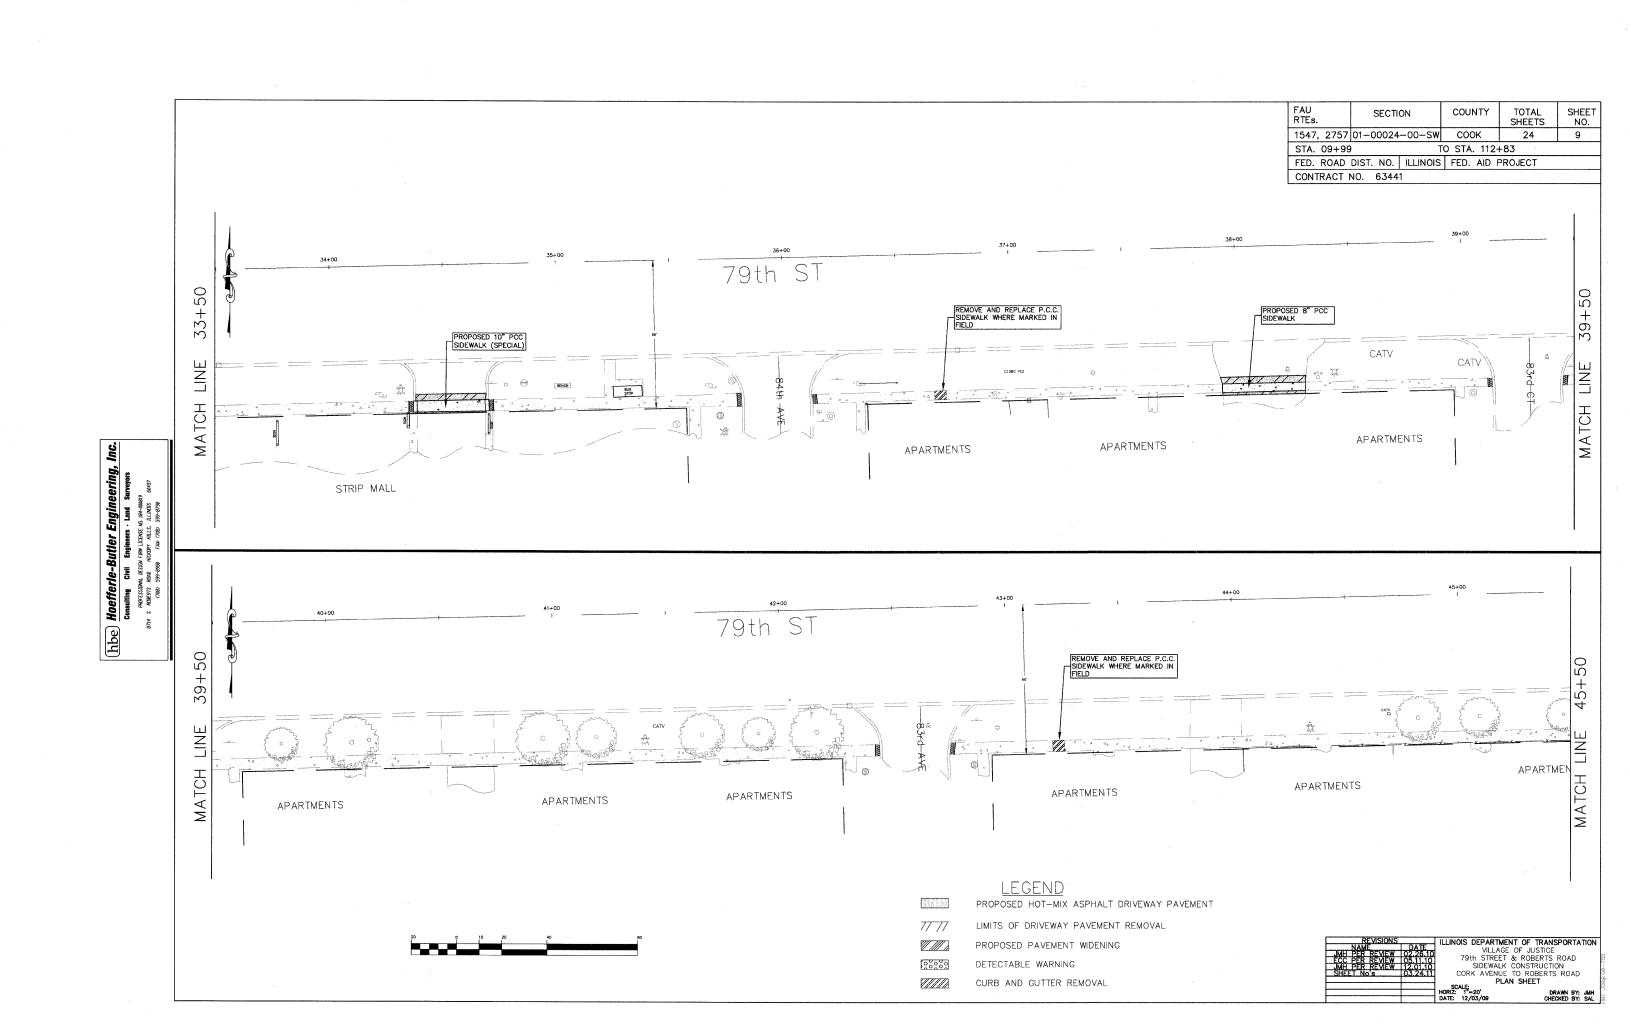


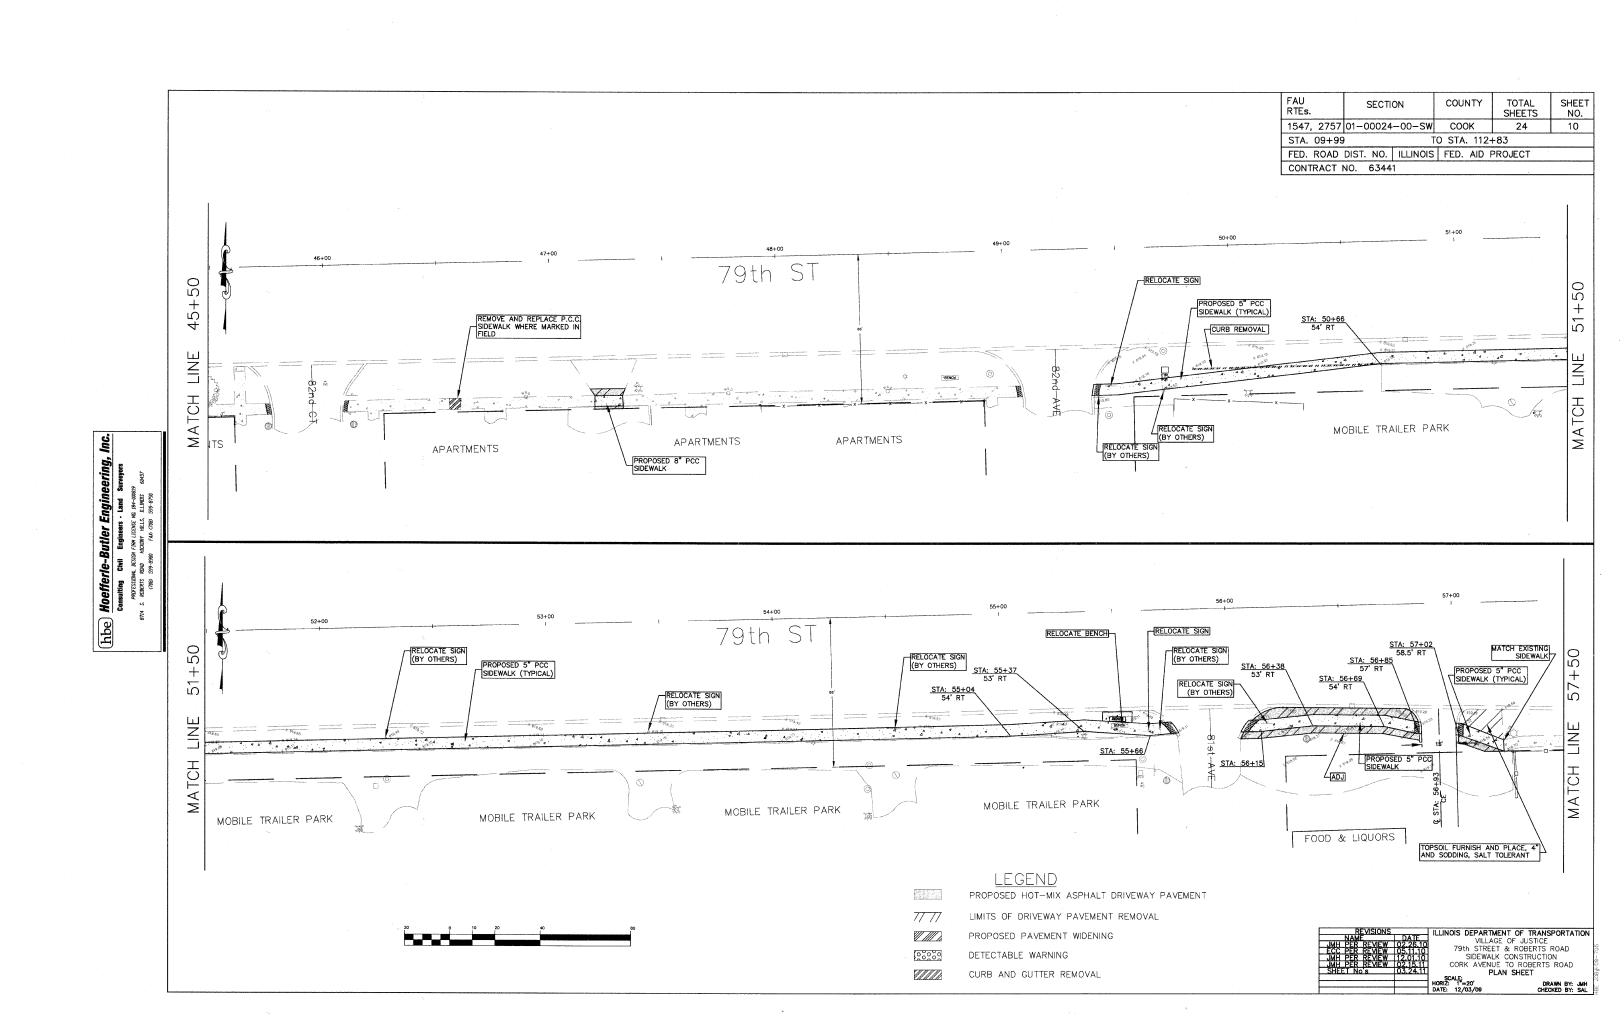

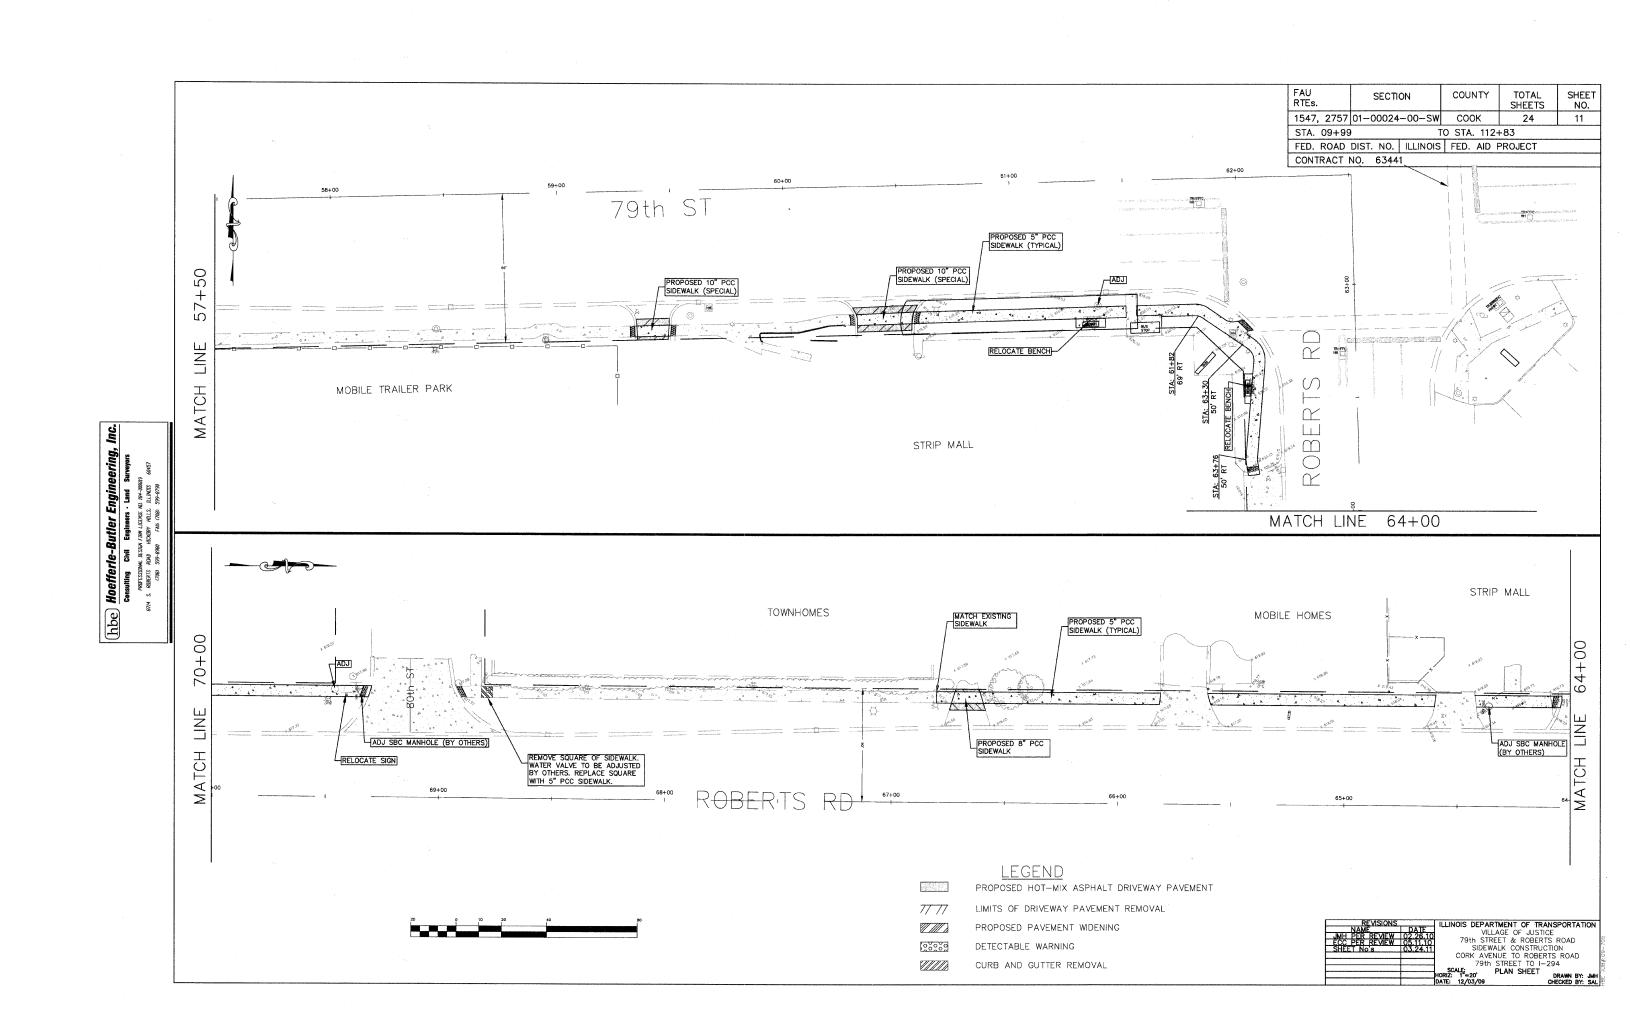


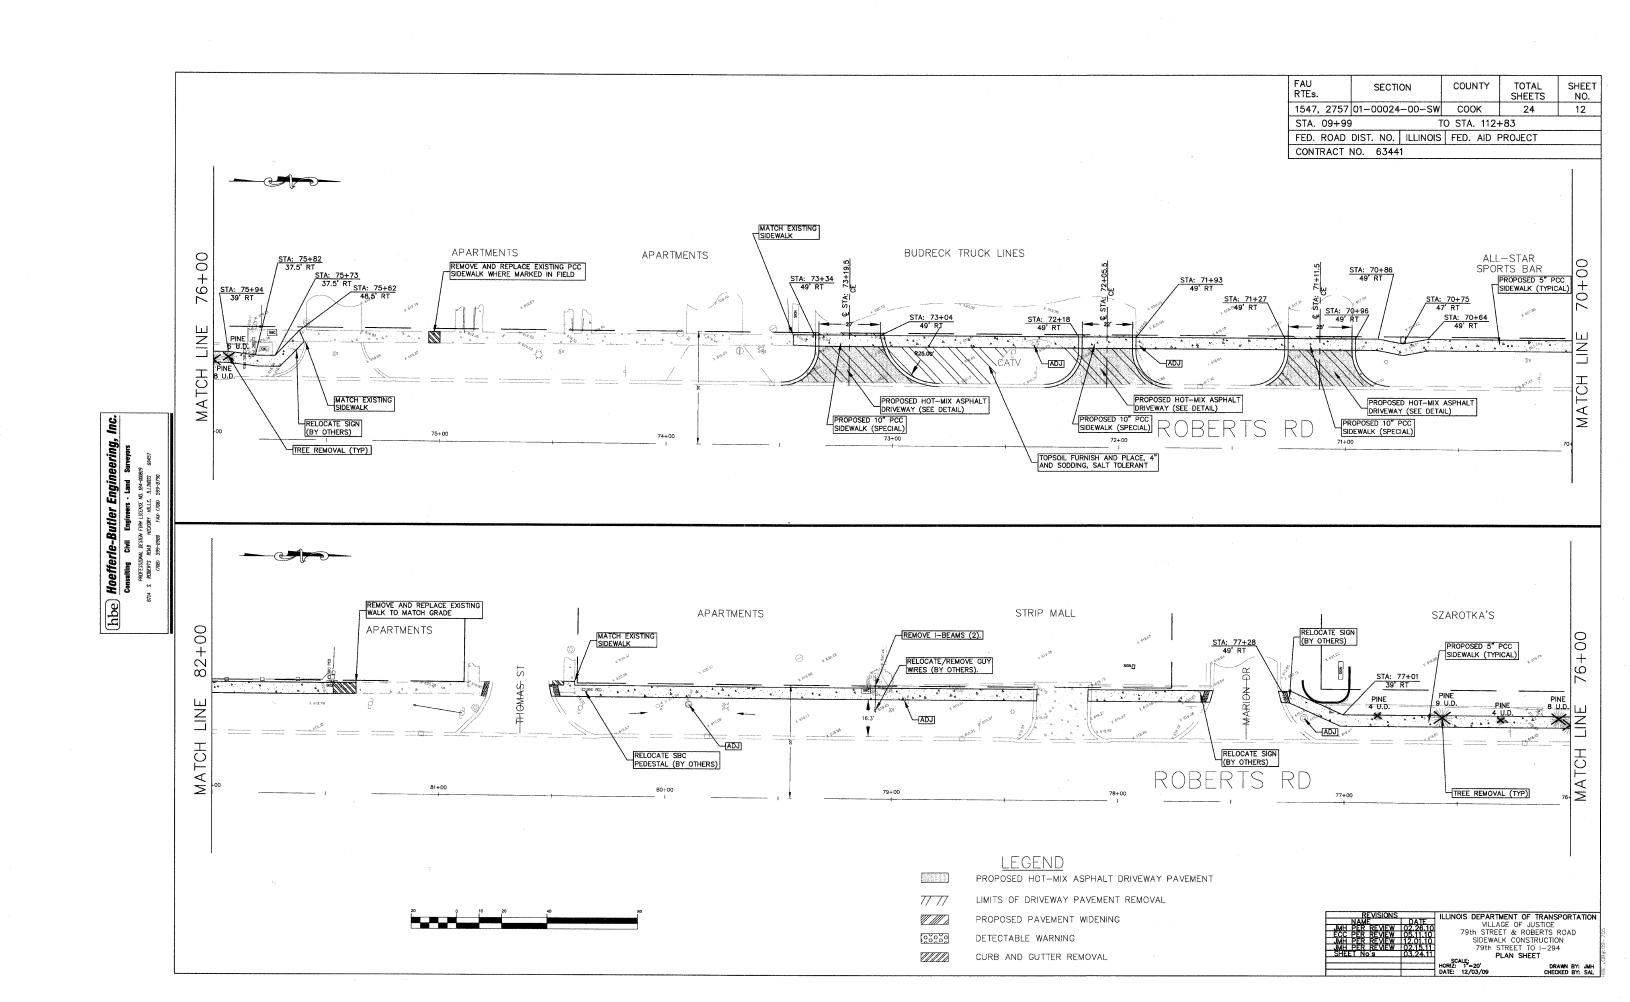

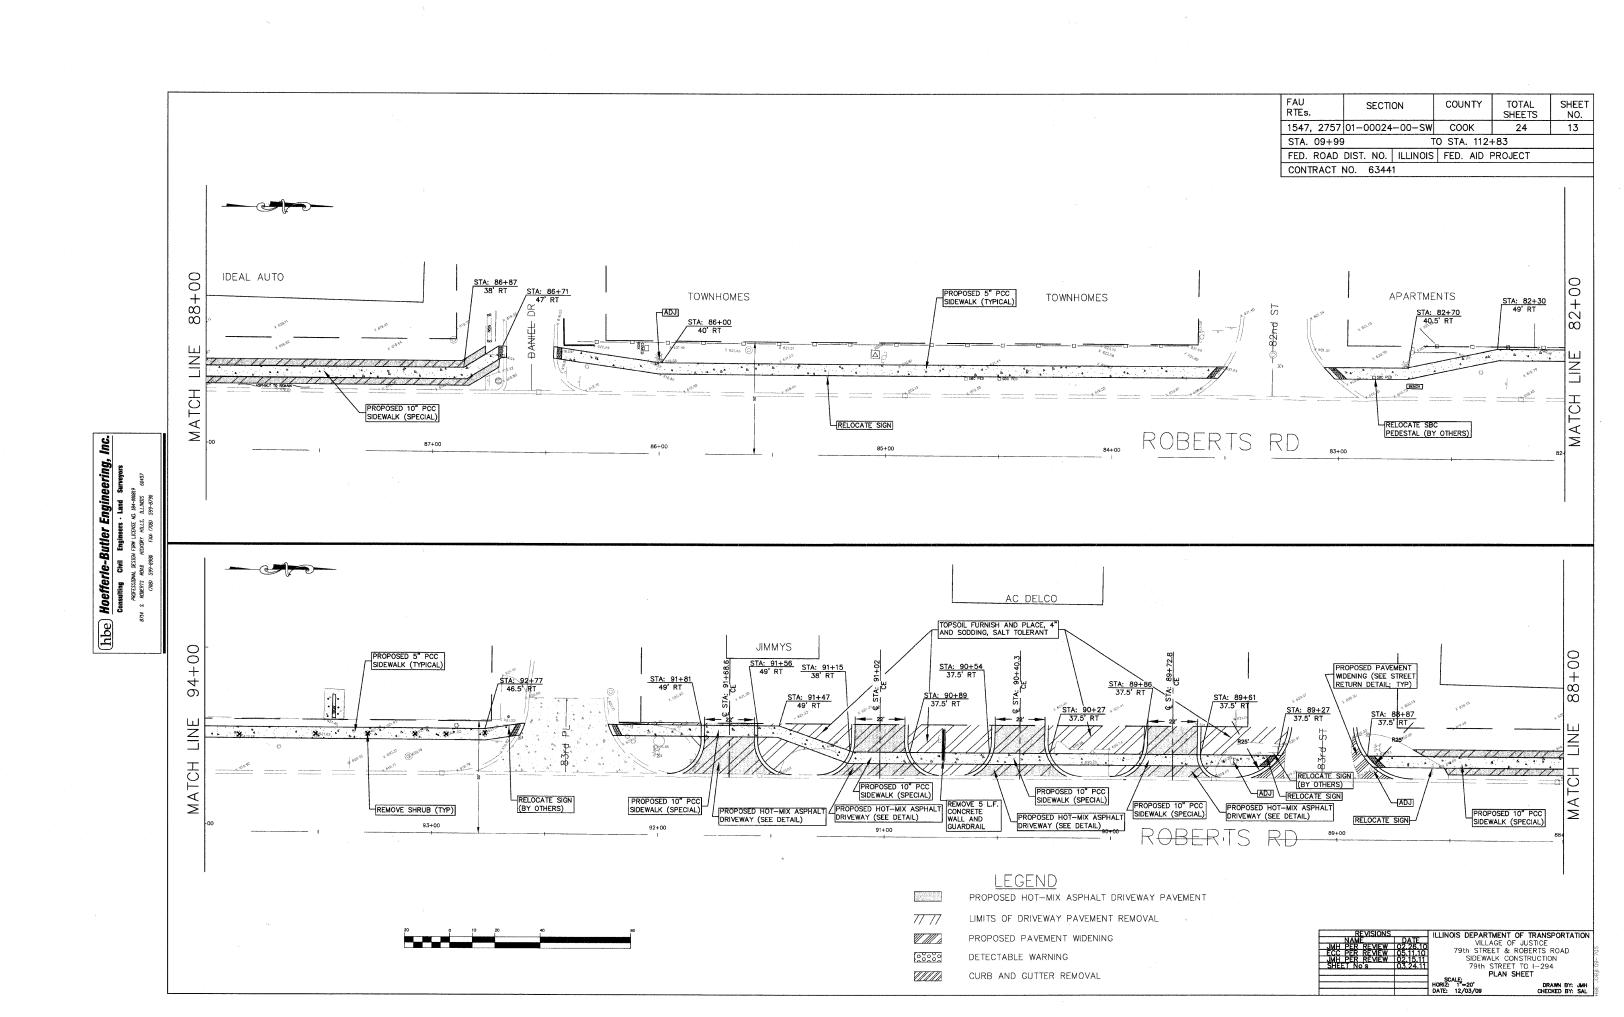

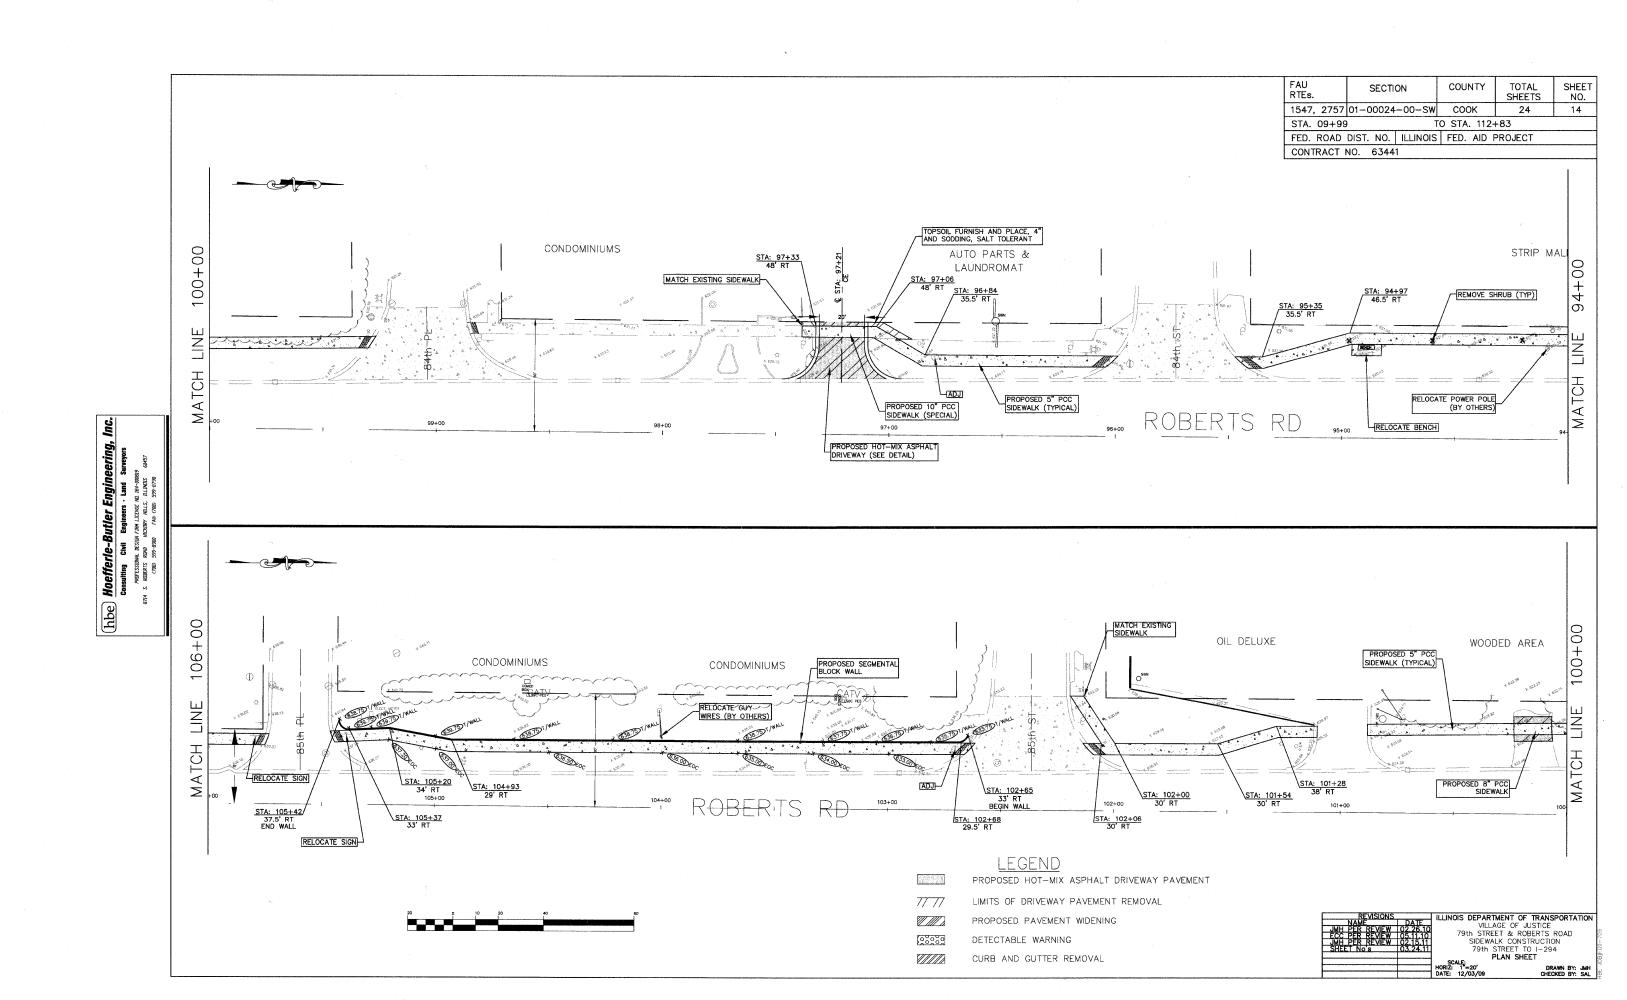




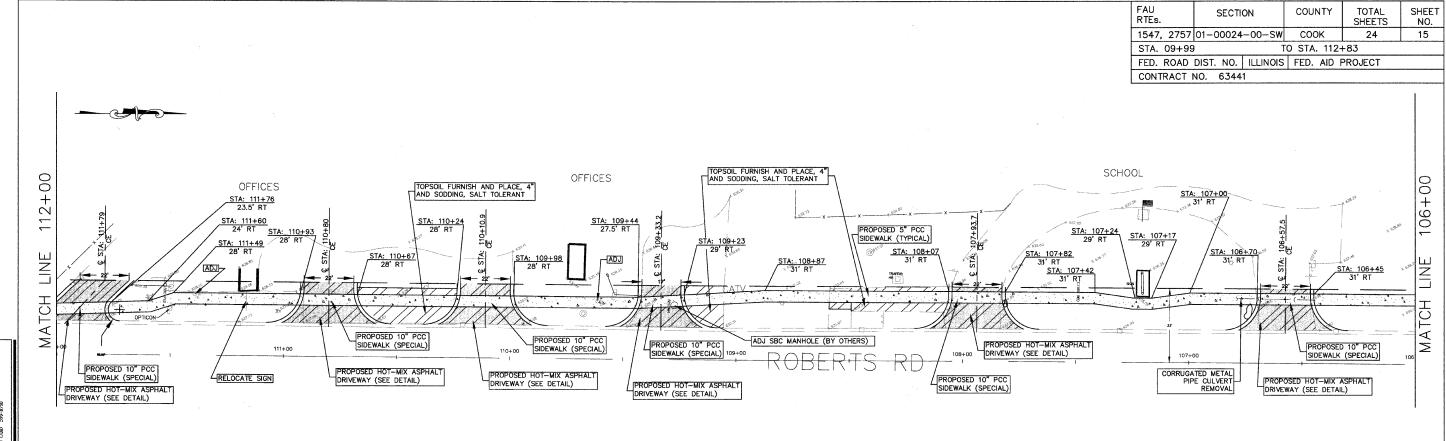

STATION	TYPE	NOTES
63+30	PEDESTRIAN CROSSING	SIGNAL POLE MOUNTED
65+26	SPEED LIMIT	DOUBLE SIGN
ar na marriada senar tura a uma tura senar	NO PARKING	DOUBLE SIGN
69+42	STREET SIGN	
70+83	NO PARKING	LIGHT POLE MOUNTED
72+38	SCHOOL CROSSING	CONTROL OF A THE STREET OF A T
74+19	SCHOOL SPEED ZONE	engennammen managemannen, menne nammen mennen mellen, de ner i solver men Domondor uddirek i en e hand ynder de ner en nammen en en en en de ner en
77+69	STREET SIGN	APT Cold for from the monoment is to the present the control of th
78+48	NO PARKING	LIGHT POLE MOUNTED
78+62	SPEED LIMIT	DOUBLE SIGN
	NO PARKING	DOUBLE SIGN
80+39	STREET SIGN	POWER POLE MOUNTED
82+27	SCHOOL SPEED ZONE	THE ARTICLE STOCK CONTROL CONT
83+55	STREET SIGN	The second of th
85+27	SCHOOL CROSSING	TO THE STATE OF TH
86+36	STREET SIGN	r manne sammen and manne and an analysis of the same same same same same same same sam
86+42	ONE WAY	THE ANY PROPERTY OF THE PROPER
86+77	SCHOOL SPEED ZONE	DOUBLE SIGN
	ONE WAY	DOUBLE SIGN
88+59	SCHOOL CROSSING	
89+32	STREET SIGN	
90+09	NO PARKING	LIGHT POLE MOUNTED
92+72	STREET SIGN	
93+38	SPEED LIMIT	The control of the co
96+14	STREET SIGN	
97+51	NO PARKING	LIGHT POLE MOUNTED
98+78	STREET SIGN	THE FIRST CONTROL OF THE PROPERTY SHOWS THE PROPERTY OF THE PR
102+65	STREET SIGN	
102+88	SCHOOL SPEED ZONE	
103+37	SPEED LIMIT	MITTERNATION MATERIAL CONTRACTOR
105+39	STREET SIGN	*** **********************************
105+40	ONE WAY	The state of the s
105+78	ONE WAY FIRE STATION SIGN	DOUBLE POST SIGN

STATION	TYPE	NOTES
10+03	NO TURN ON RED WHEN PEDESTRIANS PRESENT	SIGNAL POLE MOUNTED
12+18	SPEED LIMIT	LIGHT POLE MOUNTED
12+98	STREET SIGN	
16+30	STREET SIGN	
16+29	STREET SIGN	
23+03	STREET SIGN	Cofficients of non-electromagnet water momentum commission from the state of the st
23+38	SPEED LIMIT	LIGHT POLE MOUNTED
26+24	STREET SIGN	
29+63	STREET SIGN	LOGIC ACTIONES COMMISSION SERVICES CONTRACTOR CONTRACTO
32+92	STREET SIGN	The state of the s
36+25	STREET SIGN	A series and a series of the production of the series of t
37+38	SPEED LIMIT	LIGHT POLE MOUNTED
39+57	STREET SIGN	SERVICE CONTRACTOR CON
42+88	STREET SIGN	Maringo - 197 Maringo 197 I Maringo Sentra a Bendra Jean Lander (1984) (1987) (1987) (1986) (
46+13	STREET SIGN	The state of the s
49+37	STREET SIGN	FIT STATES AND REPORTED TO THE PERSON AND AND AND AND AND AND AND AND AND AN
51+18	SPEED LIMIT	LIGHT POLE MOUNTED
54+18	PEDESTRIAN CROSSING	LIGHT POLE MOUNTED
55+66	STREET SIGN	ang pantaunanan menangkan menangkan menangkan kasanan samun merupa samun di bandah samun di berbasan dibebah d Bandan samun di bandan samun menangkan menangkan samun menangkan samun di bandan samun di berbasan dibebah sam
57+28	SPEED LIMIT	LIGHT POLE MOUNTED
59+78	NO PARKING	LIGHT POLE MOUNTED
61+98	PEDESTRIAN CROSSING	SIGNAL POLE MOUNTED

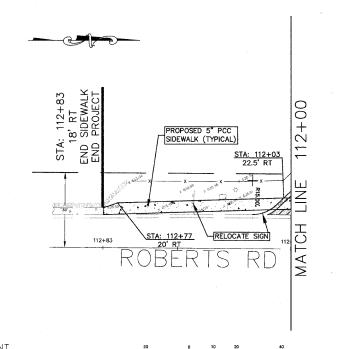

		(ᅺ	1	V	L											
OP	OSET)	HO	T-	_	М	Х	ASPI	IAL	Т	DRI	VF	WΑ	Υ	PA	VFN	/FN

LIMITS OF DRIVEWAY PAVEMENT REMOVAL 77 77

PROPOSED PAVEMENT WIDENING 00000 DETECTABLE WARNING

CURB AND GUTTER REMOVAL ILLINOIS DEPARTMENT OF TRANSPORTATION
VILLAGE OF JUSTICE
79th STREET & ROBERTS ROAD
SIDEWALK CONSTRUCTION
79th STREET TO 1-294
PLAN SHEET & SIGN INVENTORY


TOTAL

COUNTY

SECTION

SHEET



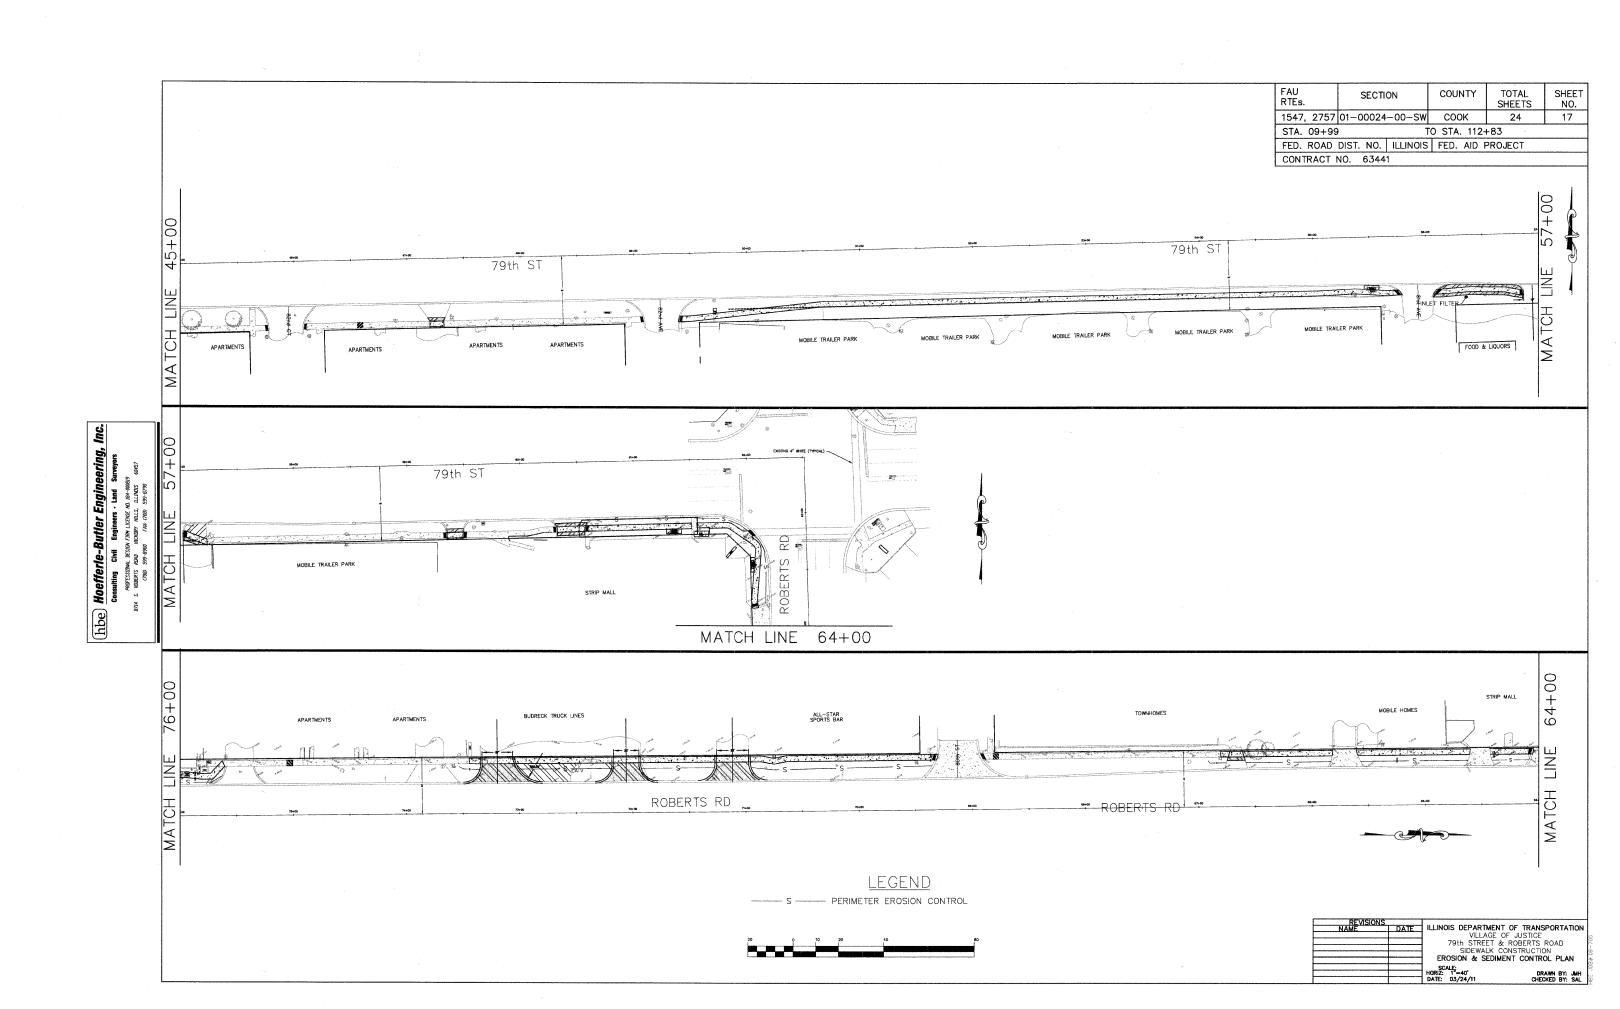

FAU RTEs. TOTAL SHEETS SHEET NO. COUNTY SECTION 1547, 2757 01-00024-00-SW COOK 24 18 STA. 09+99 TO STA. 112+83

FED. ROAD DIST. NO. | ILLINOIS | FED. AID PROJECT.

CONTRACT NO. 63441 88+00 76+00 IDEAL AUTO APARTMENTS H H H MATCH ROBERTS RD MATCH ROBERTS RD 100+00 88+00 (hbe) Hoefferle-Butler Engineering, In consulting Civil Engineers Land Surveyors PROFESSIONAL RESIDENCE LECTOR IN 1894-000819
8714 S. REDENTS GAVE HIGHERY HALLS, ALLHURS 6457
CROB 5794-6988 FAX CROB 579-6988 STRIP MALL LINE MATCH ROBERTS RD *** ROBERTS RD **** 112+00 100+00 OFFICES LI NE MATCH H **** ROBERTS RD MAT ROBERTS RD 112+00 LEGEND - S ----- PERIMETER EROSION CONTROL IN N H DATE
ILLINOIS DEPARTMENT OF TRANSPORTATION
VILLAGE OF JUSTICE
79th STREET & ROBERTS ROAD
SIDEWALK CONSTRUCTION
EROSION & SEDIMENT CONTROL PLAN

EROSION AND SEDIMENT CONTROL NOTES

THE FOLLOWING PLAN IS ESTABLISHED AND INCORPORATED IN THE PROJECT TO DIRECT THE CONTRACTOR IN THE PLACEMENT OF TEMPORARY EROSION CONTROL SYSTEMS AND TO PROVIDE A STORM SEWER WATER POLLUTION PREVENTION PLAN FOR COMPLIANCE UNDER NPDES.

THE PURPOSE OF THIS PLAN IS TO MINIMIZE EROSION WITHIN THE CONSTRUCTION SITE AND TO LIMIT SEDIMENTS FROM LEAVING THE CONSTRUCTION SITE BY UTILIZING PROPER TEMPORARY EROSION CONTROL SYSTEMS AND PROVIDING GROUND COVER WITHIN A REASONABLE AMOUNT OF TIME.

CERTAIN EROSION CONTROL FACILITIES SHALL BE INSTALLED BY THE CONTRACTOR AT THE BEGINNING OF CONSTRUCTION. OTHER ITEMS SHALL BE INSTALLED BY THE CONTRACTOR AS IDENTIFIED BY THE ENGINEER ON A CASE SITUATION DEPENDING ON T CONTRACTOR'S SEQUENCE OF ACTIVITIES, TIME OF YEAR, AND EXPECTED WEATHER CONDITIONS.

THE CONTRACTOR SHALL INSTALL PERMANENT EROSION CONTROL SYSTEMS AND SEEDING WITHIN A TIME FRAME SPECIFIED HEREIN AND AS OUTLINED BY THE ENGINEER, THEREFORE MINIMIZING THE AMOUNT OF AREA SUSCEPTIBLE TO EROSION AND REDUCING THE AMOUNT OF TEMPORARY SEEDING. THE ENGINEER WILL DETERMINE IF ANY TEMPORARY EROSION CONTROL SYSTEMS SHOWN IN THE PLAN CAN BE DELETED AND IF ANY ADDITIONAL TEMPORARY EROSION CONTROL. SYSTEMS, WHICH ARE NOT INCLUDED IN THIS PLAN, CAN BE ADDED. THE CONTRACTOR SHALL PERFORM ALL WORK AS STIPULATED BY THE ENGINEER, LOCAL MUNICIPAL CODES, AND AS SHOWN IN IDOT STANDARD 280001 WHICH SUPPLEMENTS THIS PLAN. THE TEMPORARY EROSION CONTROL PROVISIONS OUTLINED IN SECTION 280 OF THE IDOT STANDARD SPECIFICATIONS ADDITIONALLY SUPPLEMENT THIS PLAN.

DESCRIPTION OF SITE AND PLANNED CONSTRUCTION ACTIVITIES

- THE PROJECT IS LOCATED IN THE VILLAGE OF JUSTICE, ILLINOIS.
- 2. THE TOTAL AREA OF THE PROJECT SITE IS APPROXIMATELY 2.0 ACRES. THE AREA DISTURBED BY CONSTRUCTION ACTIVITIES IS
- 3. THE PROJECT INVOLVES EXCAVATION OF EXISTING GROUND FOR INSTALLATION OF CONCRETE SIDEWALK, AND REPLACEMENT OF EXISTING DRIVEWAYS DUE TO AFOREMENTIONED SIDEWALKS.

SEQUENCE FOR MAJOR CONSTRUCTION ACTIVITIES

THE FOLLOWING DESCRIBES THE PROJECTED SEQUENCE OF MAJOR CONSTRUCTION ACTIVITIES WHICH WILL DISTURB SOILS WITHIN THE

- INSTALLATION OF TEMPORARY EROSION CONTROL MEASURES REQUIRED TO LIMIT SOIL MIGRATION DURING SITE CLEARING, GRADING, FILLING, AND SUBSEQUENT DEVELOPMENT ACTIVITIES. MEASURES MAY INCLUDE PERIMETER EROSION CONTROL BARRIER, TEMPORARY DITCH CHECKS, INLET AND PIPE PROTECTION, EROSION CONTROL BLANKETS, TEMPORARY SEEDING, AND OTHER SIMILAR MEASURES. THE MEASURES ARE TO BE ADJUSTED IN KEEPING WITH SITE WORK PROGRESS
- 2. CLEARING AND GRUBBING OF PROJECT SITE CONSISTENT WITH PHASING OF SIDEWALK CONSTRUCTION.
- 3. EXCAVATION AND GRADING TO ACHIEVE INTERIM WORK SITE ELEVATIONS
- 4. FORMING AND INSTALLATION OF SIDEWALK
- . FINISHED GRADING AND LANDSCAPE RESTORATION.
- 6. MAINTENANCE, REMOVAL, AND PROPER CLEAN-UP OF TEMPORARY EROSION CONTROL MEASURES.

OTHER REPORTS, STUDIES, PLANS, SPECIFICATIONS WHICH ARE REFERENCED DOCUMENTS OF THE STORM WATER POLLUTION PREVENTION PLAN

- INFORMATION CONCERNING THE SOILS CHARACTER AND TERRAIN WITHIN THE SITE WAS OBTAINED FROM TOPOGRAPHIC SURVEYS AND SOIL MAPS THAT WERE UTILIZED FOR THE DEVELOPMENT OF THE PROPOSED TEMPORARY EROSION CONTROL SYSTEMS.
- 2. PROJECT SPECIFICATIONS, SPECIAL PROVISIONS, AND DRAWINGS INDICATING DRAINAGE PATTERNS AND APPROXIMATE SLOPES ANTICIPATED AFTER GRADING ACTIVITIES, WERE UTILIZED FOR THE PROPOSED PLACEMENT OF THE TEMPORARY EROSION CONTROL
- 3. ILLINOIS URBAN MANUAL FOR SOIL EROSION CONTROL GUIDANCE AND CONTROL MEASURES.
- 4. IDOT STANDARD SPECIFICATIONS FOR ROAD AND BRIDGE CONSTRUCTION FOR SOIL EROSION CONTROL MATERIALS AND INSTALLATION
- 5. LOCAL MUNICIPAL REQUIREMENTS FOR EROSION CONTROL

EROSION AND SEDIMENT CONTROL PRACTICES

THE DRAWINGS, SPECIFICATIONS AND SPECIAL PROVISIONS HAVE BEEN PLANNED TO ENSURE THAT EXISTING VEGETATION IS PRESERVED WHERE FEASIBLE, AND DISTURBED PORTIONS OF THE SITE ARE STABILIZED. STABILIZATION PRACTICES INCLUDE TEMPORARY SEEDING, PERMANENT SEEDING, MULCHING, PROTECTION OF TREES, PRESERVATION OF NATURAL VEGETATION, AND OTHER APPROPRIATE MEASURES AS IDENTIFIED BY THE ENGINEER. STABILIZATION MEASURES SHALL BE INITIATED AS SOON AS PRACTICABLE IN PORTIONS OF THE SITE WHERE CONSTRUCTION ACTIVITIES HAVE TEMPORARILY OR PERMANENTLY CEASED, BUT IN NO CASE MORE THAN 7 DAYS AFTER THE CONSTRUCTION TY IN THAT PORTION OF THE SITE HAS TEMPORARILY OR PERMANENTLY CEASED.

- AREAS OF EXISTING VEGETATION, WOOD AND GRASSLANDS, OUTSIDE THE PROPOSED CONSTRUCTION LIMITS SHALL BE PROTECTED FROM
- 2. DEAD, DISEASED, UNSUITABLE, OR CONFLICTING VEGETATION WITHIN THE SITE SHALL BE REMOVED. ALONG WITH REQUIRED TREE
- 3. TEMPORARY DITCH CHECKS, INLET AND PIPE PROTECTION, AND PERIMETER EROSION BARRIER SHALL BE INSTALLED PRIOR TO STRIPPING OF EXISTING VEGETATION
- BARE AND SPARSELY VEGETATED GROUND IN HIGH ERODABLE AREAS SHALL BE TEMPORARILY SEEDED AT THE BEGINNING OF CONSTRUCTION WHERE NO CONSTRUCTION ACTIVITIES ARE EXPECTED WITHIN SEVEN (7) DAYS
- 5. IMMEDIATELY AFTER TREE REMOVAL IS COMPLETED, AREAS WHICH ARE HIGHLY ERODABLE AS DETERMINED BY THE ENGINEER, SHALL BE TEMPORARILY SEEDED WHEN NO CONSTRUCTION ACTIVITIES ARE EXPECTED WITHIN SEVEN (7) DAYS.
- 6. AT LOCATIONS WHERE A SIGNIFICANT AMOUNT OF WATER DRAINS INTO THE CONSTRUCTION ZONE FROM OUTSIDE AREAS ON ADJACENT LANDOWNERS, TEMPORARY DITCH CHECKS SHALL BE UTILIZED TO LOCALLY DIVERT WATER, REDUCE FLOW RATES, AND COLLECT OUTSIDE SILTATION INSIDE THE RIGHT-OF-WAY LINE.
- 7. DURING CONSTRUCTION, AREAS OUTSIDE THE CONSTRUCTION LIMITS INDICATED ON THE PLANS SHALL BE PROTECTED FROM DAMAGE THE CONTRACTOR SHALL NOT USE THESE AREAS FOR STAGING, PARKING OF VEHICLES OF CONSTRUCTION EQUIPMENT, STORAGE OF MATERIALS OR OTHER CONSTRUCTION RELATED ACTIVITIES EXCEPT AS DESCRIBED ON THE PLANS AND INDICATED BY THE ENGINEER.
- WITHIN THE CONSTRUCTION LIMITS, AREAS WHICH MAY BE SUSCEPTIBLE TO EROSION SHALL REMAIN UNDISTURBED UNTIL THE STAGE OF CONSTRUCTION IS INITIATED TO AVOID UNNECESSARY SOIL EROSION.
- 9. EARTH STOCKPILES SHALL BE TEMPORARILY SEEDED IF THEY ARE TO REMAIN UNUSED FOR MORE THAN FOURTEEN (14) DAYS.
- 10. AS CONSTRUCTION PROCEEDS, THE CONTRACTOR SHALL PLACE TEMPORARY EROSION CONTROL FACILITIES AT NECESSARY LOCATIONS. THE ERODABLE EXPOSED EARTH SURFACES SHALL BE TEMPORARILY SEEDED ON A WEEKLY BASIS TO MINIMIZE THE AMOUNT OF EROSION THAT WILL OCCUR WITHIN THE PROJECT LIMITS. THE ROADSIDE DITCHES WITHIN THE PROJECT LIMITS SHALL BE MAINTAINED OR CONSTRUCTED AS REQUIRED TO LIMIT EROSION. TEMPORARILY DIVERT WATER AROUND PROPOSED CULVERT LOCATIONS UNTIL EROSION CONTROL MEASURES ARE IN PLACE.
- CONSTRUCTION EQUIPMENT SHALL BE STORED AND FUELED ONLY AT DESIGNATED LOCATIONS. ALL NECESSARY MEASURES SHALL BE TAKEN TO CONTAIN ANY FUEL OR OTHER POLLUTANT IN ACCORDANCE WITH EPA WATER QUALITY REGULATIONS. LEAKING EQUIPMENT OR SUPPLIES SHALL BE IMMEDIATELY REPAIRED OR REMOVED FROM THE SITE.
- 12. THE CONTRACTOR SHALL INSPECT THE PROJECT DAILY DURING CONSTRUCTION ACTIVITIES. INSPECTION SHALL ALSO BE DONE WEEKLY AND AFTER RAINS OF 1/2-INCH OR GREATER OR EQUIVALENT SNOWFALL AND DURING THE WINTER SHUTDOWN PERIOD. THE PROJECT SHALL ADDITIONALLY BE INSPECTED BY THE WORK SITE CONSTRUCTION MANAGER ON A BI-WEEKLY BASIS TO DETERMINE THAT EROSION CONTROL EFFORTS ARE IN PLACE AND EFFECTIVE AND IF OTHER EROSION CONTROL WORK IS NECESSARY.
- 13. SEDIMENT COLLECTED DURING CONSTRUCTION OF THE VARIOUS TEMPORARY EROSION CONTROL SYSTEMS SHALL BE DISPOSED OF ON THE SITE ON A REGULAR BASIS. THE COST OF THIS MAINTENANCE SHALL BE INCLUDED IN THE UNIT BID PRICE FOR EACH EXCAVATION FOR EROSION CONTROL.
- 14. THE TEMPORARY EROSION CONTROL SYSTEMS SHALL BE REMOVED 30 DAYS AFTER USE IS NO LONGER NEEDED OR NO LONGER FUNCTIONING. AT THAT TIME, THE EROSION CONTROL SYSTEMS SHALL BE REMOVED, AND THE AREAS DAMAGED BY THE SYSTEMS' INSTALLATION SHALL BE RESTORED
- 15. TEMPORARY DITCH CHECKS SHALL BE LOCATED AT EVERY 1 FOOT FALL OR RISE IN DITCH GRADE OR AS STIPULATED ON THE PLAN
- 16. WHERE REQUIRED THE TEMPORARY EROSION CONTROL SEEDING SHALL BE APPLIED AT A RATE OF 100 LBS PER ACRE OF AREA
- 17. WATER PUMPED FROM EXCAVATIONS SHALL BE DIRECTED INTO THE SEDIMENT BASIN. THE SEDIMENT BASIN SHALL BE MAINTAINED AT A DEPTH BETWEEN 2 AND 3 FEET AND CLEARED OF SEDIMENT AS REQUIRED. SEDIMENT SHALL BE DISPOSED OF IN A MANNER NOT TO INCREASE SOIL MIGRATION
- 18. ALL TEMPORARY AND PERMANENT EROSION CONTROL MEASURES MUST BE MAINTAINED AND REPAIRED AS NEEDED. THE CONTRACTOR SHALL BE ULTIMATELY RESPONSIBLE FOR MAINTENANCE AND REPAIR
- 19. THE EROSION CONTROL MEASURES INDICATED ON THE PLANS ARE THE MINIMUM REQUIREMENTS. ADDITIONAL MEASURES MAY BE REQUIRED, AS DIRECTED BY THE ENGINEER OR GOVERNING AGENCY.

MAINTENANCE AFTER CONSTRUCTION

- 1. THE CONSTRUCTION WILL BE CONSIDERED TO BE COMPLETE AFTER ACCEPTANCE BY THE MUNICIPAL AGENCY WITH JURISDICTION OVER THE IMPROVEMENTS. MAINTENANCE OF EROSION MEASURES AS WELL AS THE SITE IMPROVEMENTS WILL BE THE RESPONSIBILITY OF THE CONTRACTOR UNTIL THE DATE OF ACCEPTANCE.
- 2. TEMPORARY EROSION CONTROL SYSTEMS SHALL BE LEFT IN PLACE WITH PROPER MAINTENANCE UNTIL PERMANENT EROSION CONTROL IS IN PLACE AND WORKING PROPERLY AND ALL PROPOSED SEEDED OR SODDED AREAS HAVE BEEN ESTABLISHED.
- 3. ONCE PERMANENT EROSION CONTROL SYSTEMS AS PROPOSED IN THE PLANS ARE FUNCTIONAL AND ESTABLISHED, TEMPORARY ITEMS SHALL BE REMOVED, CLEANED UP, AND DISTURBED SURFACES RESTORED.

	FAU RTEs.	SECTI	ON	COUNTY	TOTAL SHEETS	SHEET NO.
Ì	1547, 2757	01-00024	-00-SW	COOK	24	19
	STA. 09+99)	1	O STA. 112-	⊦83	
	FED. ROAD	DIST. NO.	ILLINOIS	FED. AID F	PROJECT	
	CONTRACT I	NO. 6344	1			


A COPY OF THE SWPPP (INCLUDING A COPY OF THE PERMIT), NOI, AND ACKNOWLEDGEMENT LETTER FROM EPA MUST BE RETAINED AT THE CONSTRUCTION SITE (OR OTHER LOCATION EASILY ACCESSIBLE DURING NORMAL BUSINESS HOURS TO EPA, A STATE, TRIBAL OR LOCAL AGENCY APPROVING SEDIMENT AND EROSION PLANS, GRADING PLANS, OR STORM WATER MANAGEMENT PLANS; LOCAL GOVERNMENT OFFICIALS; THE OPERATOR OF A MUNICIPAL SEPARATE STORM SEWER RECEIVING DISCHARGES FROM THE SITE; AND REPRESENTATIVES OF THE U.S. FISH AND WILDLIFE SERVICE OR THE NATIONAL MARINE FISHERIES SERVICE) FROM THE DATE OF COMMENCEMENT OF CONSTRUCTION ACTIVITIES TO THE DATE OF FINAL STABILIZATION. IF YOU HAVE DAY-TO-DAY OPERATIONAL CONTROL OVER SWPPP IMPLEMENTATION, YOU MUST HAVE A COPY OF THE SWPPP AVAILABLE AT A CENTRAL LOCATION ON-SITE FOR THE USE OF ALL THOSE IDENTIFIED AS HAVING RESPONSIBILITIES UNDER THE SWPPP WHENEVER THEY ARE ON THE CONSTRUCTION SITE. IF AN ON-SITE LOCATION IS UNAVAILABLE TO STORE THE SWPPP WHEN NO PERSONNEL ARE PRESENT, NOTICE OF THE PLAN'S LOCATION MUST BE POSTED NEAR THE MAIN ENTRANCE AT THE

A SIGN OR OTHER NOTICE MUST BE POSTED CONSPICUOUSLY NEAR THE MAIN ENTRANCE OF THE CONSTRUCTION SITE. DISPLAYING NEAR THE MAIN ENTRANCE IS INFEASIBLE, THE NOTICE CAN BE POSTED IN A LOCAL PUBLIC BUILDING SUCH AS THE TOWN HALL OR PUBLIC LIBRARY. THE SIGN OR OTHER NOTICE MUST CONTAIN THE FOLLOWING INFORMATION: 1. A COPY OF THE COMPLETED NOTICE OF INTENT AS SUBMITTED TO THE EPA STORM WATER NOTICE PROCESSING CENTER;


2. IF THE LOCATION OF THE SWPPP OR THE NAME AND TELEPHONE NUMBER OF THE CONTACT PERSON FOR SCHEDULING SWPPP VIEWING TIMES HAS CHANGED (I.E., IS DIFFERENT THAN THAT SUBMITTED TO EPA IN THE NO!), THE CURRENT LOCATION OF THE SWPPP AND NAME AND TELEPHONE NUMBER OF A CONTACT PERSON FOR SCHEDULING VIEWING

DATE ILLINOIS DEPARTMENT OF TRANSPORTATION VILLAGE OF JUSTICE 79th STREET & ROBERTS ROAD EROSION & SEDIMENT CONTROL NOTES



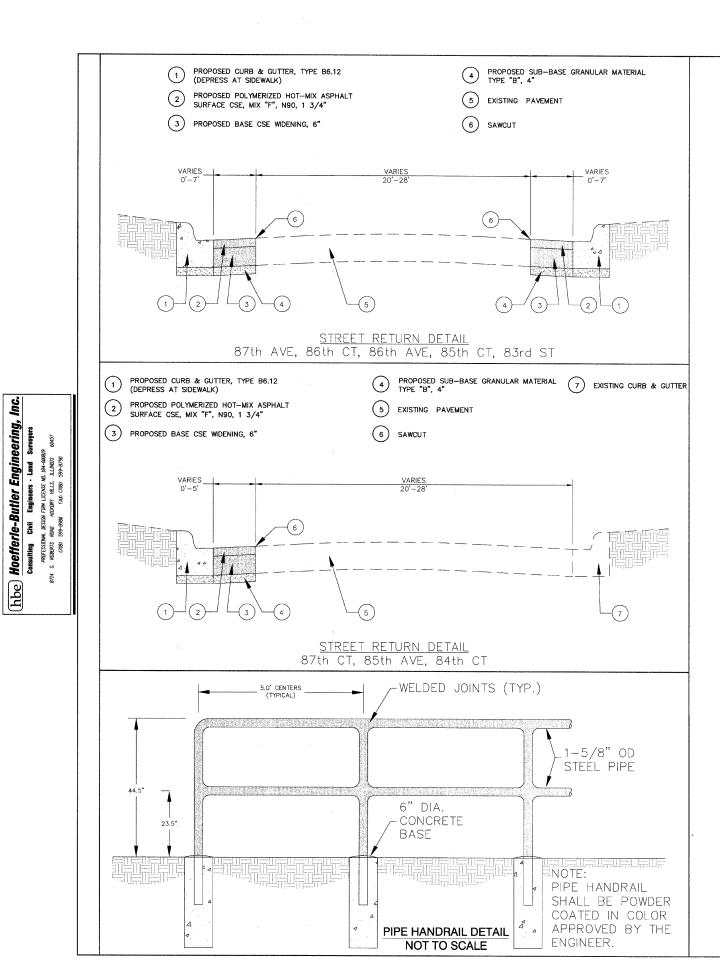

FAU RTEs.	SECTI	NC	COUNTY	TOTAL SHEETS	SHEET NO.
1547, 2757	01-00024	-00-SW	COOK	24	20
STA. 09+99)	T	O STA. 112-	⊦83	
FED. ROAD	DIST. NO.	ILLINOIS	FED. AID F	PROJECT	
CONTRACT I	NO. 6344	1			

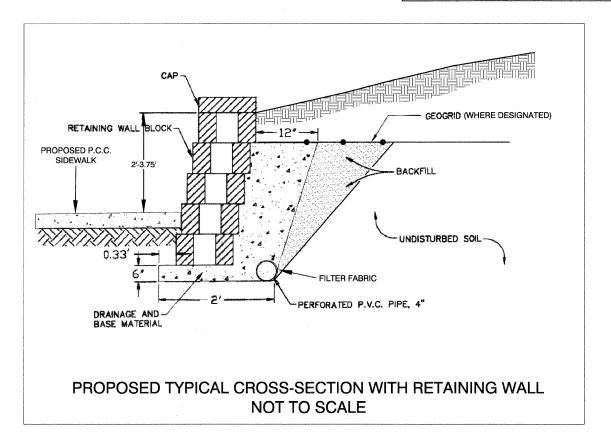


HOT-MIX ASPHALT MIXTURE REQUIREMENTS CHART	
MIXTURE TYPE	AIR VOIDS AT Ndes
DRIVEWAYS	
HOT-MIX ASPHALT SURFACE COURSE, MIX 'C', N50 (IL 9.5), 1 1/2"	4% AT 50 GYR
HOT-MIX ASPHALT BASE COURSE (HMA BINDER IL-19mm), 2 1/4"	4% AT 50 GYR
PAVEMENT WIDENING	
POLYMERIZED HOT-MIX ASPHALT SURFACE COURSE, MIX "F", N90 (IL 9.5mm); 1 3/4"	4% AT 90 GYR
HMA BASE COURSE (HMA BINDER IL-19mm); 6" (IN TWO LIFTS)	4% AT 90 GYR

THE UNIT WEIGHT USED TO CALCULATE ALL HMA SURFACE MIXTURE QUANTITIES IS 112 LBS/SQ YD/IN

THE "AC TYPE" FOR POLYMERIZED HMA MIXES SHALL BE "SBS/SBR PG 70-22" AND FOR NON-POLYMERIZED HMA THE "AC TYPE" SHALL BE "PG 64-22" UNLESS MODIFIED BY DISTRICT ONE SPECIAL PROVISIONS.

FOR "PERCENT OF RAP" SEE DISTRICT ONE SPECIAL PROVISIONS.

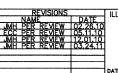

LLINOIS DEPARTMENT OF TRANSPORTATION
VILLAGE OF JUSTICE
79th STREET & ROBERTS ROAD
SIDEWALK CONSTRUCTION
STREET RETURN, PIPE HANDRAIL,
& RETAINING WALL DETAILS

12/03/00

DRAWN BY: CHECKED BY:

FAU RTEs. COUNTY SECTION 1547, 2757 01-00024-00-SW COOK 75+00 STA. 09+99 TO STA. 112+83 85+00 FED. ROAD DIST. NO. ILLINOIS FED. AID PROJECT 95+00 622.0 CONTRACT NO. 63441 624.0 620.0 620.0 622.0 622.0 74+00 618.0 620.0 620.0 84+00 618.0 618.0 94+00 624.0 103+00 622.0 73+00 622.0 622.0 620.0 620.0 C-1.86 S.F. 620.0 620.0 622.0 C-4.87 S.F. 618.0 642.0 618.0 620.0 618.0 620.0 83+00 640.0 93+00 618.0 618.0 C-1.59 S.F. 638.0 616.0 616.0 60 622.0 622.0 622.0 636.0 PROPOSED BLOCK WALL (TYP) 636.0 72+00 620.0 620.0 620.0 620.0 634.0 634.0 C-3.91 S.F. C-3.80 S.F. 622.0 618.0 618.0 618.0 632.0 632.0 620.0 82+00 92+00 618.0 618.0 102+00 C-4.50 S.F. 622.0 616.0 622.0 616.0 622.0 632.0 632.0 620.0 620.0 71+00 620.0 620.0 630.0 630.0 C-2.51 S.F. 618.0 618.0 618.0 618.0 628.0 628.0 81+00 91+00 616.0 101+00 622.0 622.0 70+00 622.0 622.0 620.0 620.0 620.0 C-4.33 S.F. 626.0 626.0 618.0 618.0 618.0 618.0 618.0 624.0 90+00 80+00 100+00 622.0 622.0 69+00 622.0 622.0 620.0 620.0 620.0 620.0 622.0 622.0 618.0 618.0 C-2.95 S.F. C-1.29 S.F. 618.0 618.0 C--5.21 S.F. 30 616.0 616.0 79+00 89+00 99+00 68+00 622.0 622.0 622.0 622.0 622.0 622.0 620.0 620.0 620.0 620.0 620.0 618.0 618.0 618.0 618.0 88+00 98+00 78+00 67+00 622.0 622.0 622.0 620.0 620.0 620.0 620.0 620.0 C-6.87 S.F. 618.0 618.0 618.0 618.0 C-5.56 S.F. 618.0 618.0 616.0 616.0 77+00 97+00 87+00 66+00 624.0 624.0 622.0 622.0 620.0 620.0 622.0 622.0 618.0 620.0 620.0 618.0 620.0 620.0 C-2.85 S.F. 618.0 C-3.73 S.F. 618.0 618.0 86+00 65+00 96+00 76+00 PROPOSED PCC WALK (TYP) 622.0 622.0 622.0 622.0 ILLINOIS DEPARTMENT OF TRANSPORTATION
VILLAGE OF JUSTICE
79th STREET & ROBERTS ROAD
SIDEWALK CONSTRUCTION
79th STREET TO 1-294
CROSS-SECTIONS
SCALE: | REVISIONS | DATE | DA 620.0 620.0 620.0 620.0 620.0 C-1.18 S.F. 618.0 C-2.77 S.F. 618.0 618.0 618.0 618.0 SCALE: HORIZ: 1"=10' VERT: 1"=5' DATE: 12/03/09

SHEET NO.

21

TOTAL SHEETS

24

Inc. Consulting Civil Engineers - Land Surveyors

ROTESSIONAL RESIDENT RELEASE NO. 184-100019

STH. S. REDERTS NO. 18 HOCKEY HILLS LLINGIS 60457

CHOO 599-6980 FAN CHO 599-9790

107+00 638.0 634.0 106+00 636.0 C-2.46 S.F. 634.0 105+50 640.0 640.0 638.0 636.0 105+00 642.0 642.0 640.0 640.0 638.0 638.0 636.0 636.0 C=12.11 S.F. 634.0 634.0 60 104+50 644.0 642.0 112+00 640.0 638.0 628.0 636.0 636.0 634.0 C-15.35 S.F. 626.0 634.0 111+00 104+00 628.0 626.0 626.0 642.0 642.0 640.0 110+00 640.0 638.0 638.0 636.0 636.0 C-15.62 S.F. 30 60 103+50 109+00 2% g 632.0 632.0 630.0 642.0 640.0 640.0 108+00 638.0 636.0 C-4.96 S.F. 634.0 632.0

FAU RTEs.	SECTI	ON	COUNTY	TOTAL SHEETS	SHEET NO.		
1547, 2757	01-00024	-00-SW	COOK	24	22		
STA. 09+99)	7	TO STA. 112+83				
FED. ROAD	DIST. NO.	ILLINOIS	FED. AID I	PROJECT			
CONTRACT	NO. 6344	1					

ILLINOIS DEPARTMENT OF TRANSPORTATION
VILLAGE OF JUSTICE
79th STREET & ROBERTS ROAD
SIDEWALK CONSTRUCTION
79th STREET TO 1-294
CROSS-SECTIONS
HORIZ. 11-10' VERT: 11-5' DRAWN BY: JMH
DATE: 12/03/09 CHECKED BY: SAL REVISIONS
NAME DATE
JMH PER REVIEW 12.01.10
SHEET No's 03.24.11

(hbe) Hoefferle-Butler Engineering, Inc. Consulting Civil Engineers Land Surveyors PROTESTOWN DESIGN FOR LEGIS OF SHADOS OF STATES OF SPREAD FAN CHELS, ILLINGS 64457 CIRES 559-6790

CONTRACT NO. 63441

| F.A. | SECTION | COUNTY | 1547, | 01-00024-00-SW | COOK SECTION COUNTY TOTAL SHEETS NO. 24 23 TO STA. 112+83 STA. 09+99 FED. ROAD DIST. NO. ILLINOIS FED. AID PROJECT

ROAD CONSTRUCTION AHEAD TYPE III BARRICADES -WITH TWO FLASHING AMBER LIGHTS ON EACH. TYPE I OR TYPE II BARRICADES WITH ONE FLASHING AMBER LIGHT ON EACH, OR TYPE III BARRICADES WITH TWO FLASHING AMBER LIGHTS ON EACH. 21 (530) 200'+ (60 m+)---STREET, SPEED 40 MPH OR LESS 200'± (60 m±) 09) COLLECTOR LIMIT> 40 MPH (LOCAL W20-1(0)

TRAFFIC CONTROL AND PROTECTION FOR SIDE ROADS, INTERSECTIONS, AND DRIVEWAYS

NOTES:

- A. FOR NO LANE RESTRICTION ON THE SIDE ROAD OR DRIVEWAYS
- 1. SIDE ROAD WITH A SPEED LIMIT OF 40 MPH (60 km/h) OR LESS AS SHOWN ON THE DRAWING AND AS DIRECTED BY THE ENGINEER:
- G) ONE ROAD CONSTRUCTION AHEAD SIGN 36 x 36 (900x900) WITH A FLASHER AND FLAG MOUNTED ON IT APPROXIMATELY 200' (60 m) IN ADVANCE OF THE MAIN ROUTE.

SPEED

- b) THE CLOSED PORTION OF THE MAIN ROUTE SHALL BE PROTECTED BY BLOCKING WITH TYPE I, TYPE II OR TYPE III BARRICADES, 1/3 OF THE CROSS SECTION OF THE CLOSED PORTION.
- 2. SIDE ROAD WITH A SPEED LIMIT GREATER THAN 40 MPH (60 km/h) AS SHOWN ON THE DRAWING AND AS DIRECTED BY THE ENGINEER:
- O) ONE ROAD CONSTRUCTION AHEAD SIGN 48 x 48 (1.2 m x 1.2 m) WITH A FLASHER MOUNTED ON IT APPROXIMATELY 500' (150 m) IN ADVANCE OF THE MAIN ROUTE.
- b) THE CLOSED PORTION OF THE MAIN ROUTE SHALL BE PROTECTED BY BLOCKING WITH TYPE III BARRICADES, 1/2 OF THE CROSS SECTION OF THE CLOSED PORTION.
- 3. WHEN THE SIDE ROAD LIES BETWEEN THE BEGINNING OF THE MAINLINE SIGNING AND THE WORK ZONE, A SINGLE HEADED ARROW (M6-1) SHALL BE USED IN LIEU OF THE DOUBLE HEADED ARROW (M6-4).

- B. FOR A LANE CLOSURE ON A SIDE ROAD OR DRIVEWAY:
- USE APPLICABLE PORTIONS OF THE TYPICAL APPLICATION OF TRAFFIC OSE AFFILIABLE PORTIONS OF THE TIPICAL AFFILIATION OF THAFFIC CONTROL DEVICES (STD. 701501, STD. 701506 OR THE APPROPRIATE STANDARD). THE SPACING OF SIGNS AND BARRICADES SHALL BE ADJUSTED FOR FIELD CONDITIONS AS DIRECTED BY THE REGISEER. THE DIRECTIONAL ARROW SHALL BE COVERED OR REMOVED WHEN NO LONGER CONSISTENT WITH THE SIDE ROAD LANE CLOSURE.
- C. ADVANCE WARNING SIGNS ARE TO BE OMITTED ON DRIVEWAY UNLESS

ROAD

M6-4(0)-2115

M6-1(0)-2115

D. THE TRAFFIC CONTROL AND PROTECTION FOR SIDE ROADS, INTERSECTIONS, AND DRIVEWAYS SHALL BE INCIDENTAL TO THE COST OF SPECIFIED TRAFFIC CONTROL STANDARDS OR ITEMS.

All dimensions are in millimeters (inches) unless otherwise shown.

T	REVISIONS		
1	DATE	NAME	
Т т	6/89	LHA	
] '	09/08/94	T. RAMMACHER	
	10/18/95	J. OBERLE	
] ,	03/06/96	A. HOUSEH	
	10/15/96	A. HOUSEH	
]	01/06/00	T. RAMMACHER	
]			
٦.,			

ILLINOIS DEPARTMENT OF TRANSPORTATION TRAFFIC CONTROL AND PROTECTION FOR SIDE ROADS, INTERSECTIONS, AND DRIVEWAYS

SCALE: NONE

CHECKED BY

(hbe) Hoefferle-Butler Engineering, In consulting Givil Engineer: Land Surveyors

PARTEXIONA, EXIGN FIRM LEDGE IN 184-00819

STA S. REBECTS GADE INCORDY HELS, ILLUNES GAST

CROB 579-6989 FAM (FRO) 579-6799

Inc.

DATE NAME SCALE NAME PLOT PLOT USER

72 (50) TO EDGE OF EDGE LINE 7 4 (100) YELLOW NO PASSING ZONE LINE 1 -4 (100) WHITE EDGE LINE 1/2 (40) 51/2 (140) C-C 10' (3 m) \Rightarrow 2 (50) - 4 (100) WHITE EDGE LINE 2-LANE ROADWAY 2 (50) TO EDGE OF EDGE LINE 4 (100) WHITE LANE LINE \Leftrightarrow - 4 (100) WHITE LANE LINE \Rightarrow 2 (50) 4 (100) WHITE EDGE LINE EDGE OF PAVEMENT MULTI-LANE UNDIVIDED 2 (50)-EDGE OF PAVEMENT 4 (100) WHITE EDGE LINE 4 (100) WHITE LANE LINE Î 4 (100) YELLOW EDGE LINE 2 (50) 7 EDGE OF PAVEMENT 4 (100) WHITE EDGE LINE MULTI-LANE DIVIDED WITH MOUNTABLE MEDIAN NOTE: MEDIANS WITH BARRIER CURB DO NOT REQUIRE AN EDGE LINE TYPICAL LANE AND EDGE LINE MARKING SEE DETAIL "B" SEE DETAIL "A" 711111 11111111111 BICYCLE & EQUESTRIAN SCHOOL PEDESTRIAN 2' (600) DETAIL "A" TYPICAL CROSSWALK MARKING

Inc.

hbe

DATE NAME SCHLE NAME

Consulting Civil Engineers - Land Surveyors
POPESTATION ESSENT HILLIEUS IN 1894-18999
STA S. ROBERTS GADE HILLIEUS IN LUNDES GAST
COMD. 5794-9990 STA COND. 559-6990

2-4 (100) YELLOW © 11 (280) C-C

NO DIAGONALS

4' (1.2 m) OUTSIDE TO OUTSIDE TO OUTSIDE OF LINES

4' (1.2 m) WIDE MEDIANS ONLY

VARIES

2-4 (100) © 11 (280) C-C

MINIMUM 5)


MEDIAN LENGTH

8 (200)

DIAGONAL LINE SPACING: 50' (15 m) C-C (LESS THAN 30MPH (50 km/h))
75' (25 m) C-C 30MPH (50 km/h) TO 45MPH (70 km/h))
150' (45 m) C-C (MORE THAN 45MPH (70 km/h))

MEDIANS OVER 4' (1.2 m) WIDE

FOR MEDIAN LENGTHS WHERE DIAGONAL SPACING CANNOT BE ATTAINED, USE 5 (FIVE) EQUALLY SPACED

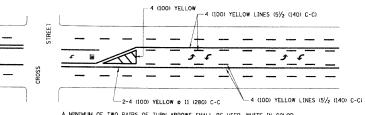


A MINIMUM OF TWO PAIRS OF TURN ARROWS SHALL BE USED, WHITE IN COLOR. ADDITIONAL PAIRS SHALL BE PLACED AT 200' (60 m) TO 300' (90 m) INTERVALS.



MEDIAN WITH TWO-WAY LEFT TURN LANE

TYPICAL PAINTED MEDIAN MARKING

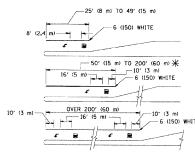

FULL SIZE LETTERS 8' (2.4 m) AND ARROWS SHALL BE USED.


AREA = 15.6 SO. FT. (1.5 m²) MIX AREA = 20.8 SO. FT. (1.9 m²)

** TURN LANES IN EXCESS OF 400' (120 m) IN LENGTH MAY HAVE AN ADDITIONAL

★ TURN LANES IN EXCESS OF 400' (120 m) IN LENGTH MAY HAVE AN ADDITIONAL SET OF ARROW - "ONLY" INSTALLED MIDWAY BETWEEN THE OTHER TWO SETS OF ARROW - "ONLY".

TYPICAL LEFT (OR RIGHT) TURN LANE

TYPICAL TURN LANE MARKING

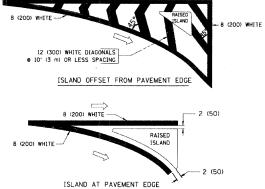

TYPICAL ISLAND MARKING

TYPE OF MARKING	WIDTH OF LINE	PATTERN	COLOR	SPACING / REMARKS
CENTERLINE ON 2 LANE PAVEMENT	4 (100)	SKIP-DASH	YELLOW	10' (3 m) LINE WITH 30' (9 m) SPACE
CENTERLINE ON MULTI-LANE UNDIVIDED PAVEMENT	2 2 4 (100)	SOLID	YELLOW	11 (280) C-C
NO PASSING ZONE LINES: FOR ONE DIRECTION FOR BOTH DIRECTIONS	4 (100) 2 e 4 (100)	SOLID SOLID	YELLOW YELLOW	5½ (140) C-C FROM SKIP-DASH CENTERLINE 11 (280) C-C OMIT SKIP-DASH CENTERLINE BETWEEN
LANE LINES	4 (100) 5 (125) ON FREEWAYS	SKIP-DASH SKIP-DASH	WHITE WHITE	10' (3 m) LINE WITH 30' (9 m) SPACE
DOTTED LINES (EXTENSIONS OF CENTER, LANE OR TURN LANE MARKINGS)	SAME AS LINE BEING EXTENDED	SKIP-DASH	SAME AS LINE BEING EXTENDED	2' (600) LINE WITH 6' (1.8 m) SPACE
EDGE LINES	4 (100)	SOLID	YELLOW-LEFT WHITE-RIGHT	OUTLINE MOUNTABLE MEDIANS IN YELLOW: EDGE LINES ARE NOT USED NEXT TO BARRIER CURB
TURN LANE MARKINGS	6 (150) LINE; FULL SIZE LETTERS & SYMBOLS (8' (2.4m))	SOLID	WHITE	SEE TYPICAL TURN LANE MARKING DETAIL
TWO WAY LEFT TURN MARKING	2 & 4 (100) EACH DIRECTION	SKIP-DASH AND SOLID	YELLOW	10' (3 m) LINE WITH 30' (9 m) SPACE FOR SKIP-DASH; 51/2 (140) C-C BETWEEN SOLID LINE AND SKIP-DASH LINE
	8' (2.4m) LEFT ARROW	IN PAIRS	WHITE	SEE TYPICAL TWO-WAY LEFT TURN MARKING DETAIL
CROSSWALK LINES (PEDESTRIAN) A. DIAGONALS (BIKE & EQUESTRIAN) B. LONGITUDINAL BARS (SCHOOL)	2 @ 6 (150) 12 (300) @ 45° 12 (300) @ 90°	SOLID SOLID	WHITE WHITE WHITE	NOT LESS THAN 6' (1.8 m) APART 2' (500) APART 2' (500) APART 5EE TYPICAL CROSSWALK MARKING DETAILS.
STOP LINES	24 (600)	SOLID	WHITE	PLACE 4' (1.2 m) IN ADVANCE OF AND PARALLEL TO CROSSMALK, IF PRESENT. OTHERWISE, PLACE AT DESIRED STOPPING POINT. PARALLEL TO CROSSROAD CENTERLINE, WHERE POSSIBLE
PAINTED MEDIANS	2 @ 4 (100) WITH 12 (300) DIAGONALS @ 45° NO DIAGONALS USED FOR 4' (1.2 m) WIDE MEDIANS	SOLID	YELLOW: TWO WAY TRAFFIC WHITE: ONE WAY TRAFFIC	11 (280) C-C FOR THE DOUBLE LINE SEE TYPICAL PAINTED MEDIAN MARKING.
GORE MARKING AND CHANNELIZING LINES	8 (200) WITH 12 (300) DIAGONALS & 45°	SOLID	WHITE	DIACONALS: 15' (4.5 m) C-C (LESS THAN 30MPH (50 km/h)) 20' (6 m) C-C 30MPH (50 km/h) TO 45MPH (70 km/h)) 30' (9 m) C-C (0VER 45MPH (70 km/h))
RAILROAD CROSSING	24 (600) TRANSVERSE LINES: "RR" IS 6' (1.8 m) LETTERS: 16 (400) LINE FOR "X"	SOLID	WHITE	SEE STATE STANDARD 780001 AREA OF: "R"=3.6 SO. FT. (0.33 m²) EACH "X"=54.0 SO. FT. (5.0 m²)
SHOULDER DIAGONALS	12 (300) e 45°	SOLID	WHITE - RIGHT YELLOW - LEFT	50' (15 m) C-C (LESS THAN 30MPH (50 km/h)) 75' (25 m) C-C (30 MPH (50 km/h) TO 45MPH (70 km/h) 1150' (45 m) C-C (OVER 45MPH (70 km/h))

FOR FURTHER DETAILS ON PAVEMENT MARKING REFER TO STANDARD SPECIFICATIONS FOR ROAD AND BRIDGE CONSTRUCTION AND STATE STANDARD 780001.

All dimensions are in inches (millimeters) unless otherwise shown,

NAME	DATE
EVERS	03-19-90
T. RAMMACHER	10-27-94
C. JUCIUS	09-09-09

ILLINOIS DEPARTMENT OF TRANSPORTATION

DISTRICT ONE TYPICAL PAVEMENT MARKINGS

SCALE: NONE

CHECKED BY
TC-13