0

0

0

0

STATE OF ILLINOIS

DEPARTMENT OF TRANSPORTATION

FOR INDEX OF SHEETS, SEE SHEET NO. 2


PROPOSED HIGHWAY PLANS


F.A.I. ROUTE 55: I-55 EB RAMP TO CHINA TOWN **SECTION: FAI 55 22 DECK OVERLAY** PROJECT: NHPP- 2IMU(385)
BRIDGE REPAIR AND DECK OVERLAY **COOK COUNTY**

C-91-091-23

LOCATION OF IMPROVEMENT SN 016-1056

PROJECT LOCATED IN THE CITY OF CHICAGO

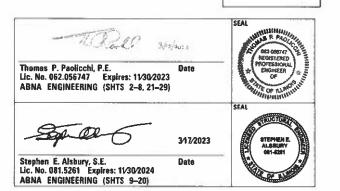

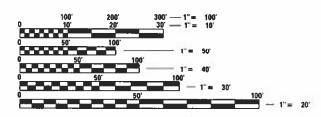

ENGINEERING SCALES, REDUCED SIZED PLANS WILL NOT CONFORM TO STANDARD SCALES. IN MAKING MEASUREMENTS ON REDUCED PLANS, THE ABOVE SCALES MAY BE USED.

JOINT UTILITY LOCATION INFORMATION FOR EXCAVATORS 1-800-892-0123 OR 811

PROJECT ENGINEER: PRAVEEN KAINI, PE 847-705-4237 PROJECT MANAGER: J. ALAIN MIDY, PE 847-221-3056

R 14 E CICERO Lake Michagan

> GROSS LENGTH = 1565 FT. = 0.296 MILE NET LENGTH = 1565 FT. = 0.296 MILE

CONTRACT NO. 62U63

D-91-064-23

55 FAI 55 22 DECK OVERLAY

COOK ILLINOIS CONTRACT NO. 62U63



LOCATION OF SECTION INDICATED THUS: -- -

STATE OF ILLINOIS DEPARTMENT OF TRANSPORTATION SUBMITTED MACCH 17 20 23 May 12, 2023

PRINTED BY THE AUTHORITY OF THE STATE OF ILLINOIS

INDEX OF SHEETS COVER SHEET INDEX OF SHEETS, STATE STANDARDS AND GENERAL NOTES SUMMARY OF QUANTITIES TYPICAL SECTIONS RAMP CLOSURE AND DETOUR PLANS 5 - 6 PAVEMENT MARKING PLANS 7 - 8 STRUCTURAL PLANS 9 - 20 BUTT JOINT AND HMA TAPER DETAILS (BD-32) 21 22 ENTRANCE AND EXIT RAMP CLOSURE DETAILS (TC-08) 23 TRAFFIC CONTROL DETAILS FOR FREEWAY SINGLE & MULTI-LANE WEAVE (TC-09) 24 - 25 MULTI-LANE FREEWAY PAVEMENT MARKING DETAILS (TC-12) 26 DISTRICT ONE TYPICAL PAVEMENT MARKINGS (TC-13) TRAFFIC CONTROL DETAILS FOR FREEWAY SHOULDER CLOSURES AND PARTIAL RAMP CLOSURES (TC-17) 27 28 DETOUR SIGNING FOR CLOSING STATE HIGHWAYS (TC-21)

ARTERIAL ROAD INFORMATION SIGN (TC-22) (NOT USED)

HIGHWAY STANDARDS

420001-10	PAVEMENT JOINTS
701400-11	APPROACH TO LANE CLOSURE, FREEWAY/EXPRESSWAY
701401-13	LANE CLOSURE, FREEWAY/EXPRESSWAY
701406-13	LANE CLOSURE, FREEWAY/EXPRESSWAY, DAY OPERATIONS ONLY
701411-09	MULTI-LANE TRAFFIC CONTROL AT ENTRANCE OR EXIT RAMPS
701426-09	LANE CLOSURE, MULTILANE INTERMITTENT OR MOVING OPER FOR SPEEDS \geq 45 MPH
701427-05	LANE CLOSURE, MULTILANE INTERMITTENT OR MOVING OPER FOR SPEEDS \leq 40 MPH
701428-01	TRAFFIC CONTROL SETUP & REMOVAL FREEWAY/EXPRESSWAY
701446-11	TWO LANE CLOSURE FREEWAY/EXPRESSWAY
701901-08	TRAFFIC CONTROL DEVICES

COMMITMENTS

THERE ARE NO COMMITMENTS FOR THIS CONTRACT.

GENERAL NOTES

- 1. PLAN DIMENSIONS AND DETAILS RELATIVE TO EXISTING PLANS ARE SUBJECT TO NOMINAL
- 2. CONSTRUCTION VARIATIONS. THE CONTRACTOR SHALL FIELD VERIFY EXISTING DIMENSIONS AND DETAILS AFFECTING NEW CONSTRUCTION AND MAKE NECESSARY APPROVED ADJUSTMENTS PRIOR TO CONSTRUCTION OR ORDERING OF MATERIALS. SUCH VARIATIONS SHALL NOT BE CAUSE FOR ADDITIONAL COMPENSATION FOR A CHANGE IN SCOPE OF THE WORK, HOWEVER, THE CONTRACTOR WILL BE PAID FOR THE QUANTITY ACTUALLY FURNISHED BASED AT THE UNIT PRICE BID FOR THE WORK.
- 3. THE CONTRACTOR WILL NOT BE ALLOWED TO SET UP A YARD OR FIELD OFFICE ON STATE PROPERTY WITHOUT WRITTEN PERMISSION FROM THE DEPARTMENT.
- 4. ALL DAMAGE TO EXISTING PAVEMENT MARKINGS OR RAISED REFLECTIVE PAVEMENT MARKERS OUTSIDE THE REMOVAL LINE SHOWN ON THE PLANS SHALL BE REPLACED AT NO ADDITIONAL COST TO THE DEPARTMENT.
- 5. THE CONTRACTOR SHALL CONTACT THE DISTRICT ONE TRAFFIC CONTROL SUPERVISOR AT KALPANA.KANNAN-HOSADURGA@ILLINOIS.GOV A MINIMUM OF 72 HOURS IN ADVANCE OF BEGINNING WORK.
- 6. THE RESIDENT ENGINEER SHALL CONTACT WALTER CZARNY, IDOT'S AREA TRAFFIC FIELD ENGINEER VIA EMAIL AT WALTER.CZARNY@ILLINOIS.GOV A MINIMUM OF TWO (2) WEEKS PRIOR TO THE PLACEMENT OF PERMANENT PAVEMENT MARKINGS. DO NOT SCALE PLANS FOR CONSTRUCTION DIMENSIONS.
- 7. COORDINATION WITH THE CTA IS REQUIRED TO PERFORM THE JOINT REPAIR AT PIER EN11.
 CTA ADJACENT CONSTRUCTION PROJECT MANAGER IS THE CONTACT PERSON.
- 8. SHOULD THE CONTRACTOR FAIL TO COMPLETELY OPEN AND KEEP OPEN ALL THE TRAFFIC LANES TO TRAFFIC IN ACCORDANCE WITH THE LIMITATIONS SPECIFIED UNDER THE SPECIAL PROVISIONS FOR "KEEPING THE EXPRESSWAY OPEN TO TRAFFIC", THE CONTRACTOR SHALL BE LIABLE TO THE DEPARTMENT FOR THE AMOUNT OF:

 ONE LANE OR RAMP BLOCKED = \$2,500

 TWO LANES BLOCKED = \$5,000

ABNA
DESIGN FIRM REG. 184 002117

745 McClintock Drive Suite 210 Burr Ridge, IL 60527 Ph. 773-881-4788 Fax: 773-239-3728
 USER NAME
 DESIGNED - TPP
 REVISED

 CHECKED - JO
 REVISED

 PLOT SCALE
 DRAWN - OJ
 REVISED

 PLOT DATE
 CHECKED - 12.19.2022
 REVISED

STATE OF ILLINOIS
DEPARTMENT OF TRANSPORTATION

INDEX OF SHEETS, STATE STANDARDS AND GENERAL NOTES
STRUCTURE NO. 016-1056

SCALE NONE
SHEET 1 OF 1 SHEETS

				90% FEE
CODE NO.	ITEM	UNIT	TOTAL QUANTITY	10% STA ⁻ BRIDGE 0047 016-1056
			URBAN	
40600290	BITUMINOUS MATERIALS (TACK COAT)	POUND	363	363
40600985	PORTLAND CEMENT CONCRETE SURFACE REMOVAL - BUTT JOINT	SQ YD	230	230
40604062	HOT-MIX ASPHALT SURFACE COURSE, IL-9.5, MIX "D", N70	TON	80	80
42001300	PROTECTIVE COAT	SQ YD	5505	5505
50102400	CONCRETE REMOVAL	CU YD	26.1	26.1
50157300	PROTECTIVE SHIELD	SQ YD	2128	2128
50300255	CONCRETE SUPERSTRUCTURE	CU YD	29.3	29.3
50800205	REINFORCEMENT BARS, EPOXY COATED	POUND	3820	3820
52000110	PREFORMED JOINT STRIP SEAL	FOOT	140	140
52318802	DRAINAGE SYSTEM FOR STRUCTURES	L SUM	1	1
67100100	MOBILIZATION	L SUM	1	1
70107025	CHANGEABLE MESSAGE SIGN	CAL DA	60	60
78008210	POLYUREA PAVEMENT MARKING TYPE I - LINE 4"	FOOT	3128	3128
X5030250	BRIDGE DECK GROOVING (LONGITUDINAL)	SQ YD	2653	2653

					CONSTR. COD
					90% FED
					10% STATE
					BRIDGE
	CODE			TOTAL	0047
	NO.	ITEM	UNIT	QUANTITY	016-1056
				URBAN	
*	X6700407	ENGINEER'S FIELD OFFICE, TYPE A (D1)	CAL MO	12	12
*	X7010216	TRAFFIC CONTROL AND PROTECTION, (SPECIAL)	L SUM	1	1
	X1010210	THAT TO CONTROL AND TROTECTION, (CITECIAL)	L GOW	<u>'</u>	'
*	X7011015	TRAFFIC CONTROL AND PROTECTION (EXPRESSWAYS)	L SUM	1	1
*	Z0006016	BRIDGE DECK LATEX CONCRETE OVERLAY, 2 3/4 INCHES	SQ YD	4252	4252
*	Z0012130	BRIDGE DECK SCARIFICATION 3/4"	SQ YD	4252	4252
*	Z0012754	STRUCTURAL REPAIR OF CONCRETE (DEPTH EQUAL TO OR LESS THAN 5 INCHES)	SQ FT	120	120
*	Z0018051	DRAINAGE SCUPPERS TO BE ADJUSTED	EACH	7	7
*	Z0029090	DIAMOND GRINDING (BRIDGE SECTION)	SQ YD	3647	3647
	4				
*	Z0030850	TEMPORARYINFORMATION SIGNING	SQ FT	51.4	51.4
*	Z0048665	RAILROAD PROTECTIVE LIABILITY INSURANCE	L SUM	1	1

745 McClintock Drive Suite 210
Burr Ridge, IL 60527
Ph, 773-881-4788
Fax: 773-239-3728

USER NAME =

PLOT SCALE =

PLOT DATE =

REVISED _ DESIGNED - TPP CHECKED - JO REVISED -DRAWN - OJ REVISED -CHECKED - 12.19.2022 REVISED -

STATE OF ILLINOIS DEPARTMENT OF TRANSPORTATION

SCALE NONE

SUMMARY OF QUANTITIES STRUCTURE NO. 016-1056 SHEET 1 OF 1 SHEETS

AT APPROACHES (WEST AND NORTH)


SCARIFICATION AND OVERLAY (SEE STRUCTURAL PLANS)

CONCRETE REPAIR (SEE STRUCTURAL PLANS)


1.75"

ABUTMENT

WEST APPROACH SLAB SECTION A-A

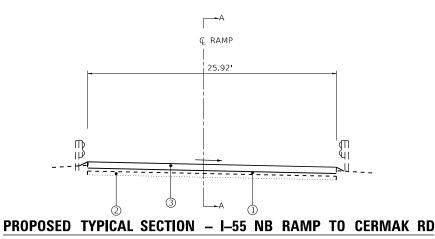

AT APPROACHES (WEST AND NORTH)

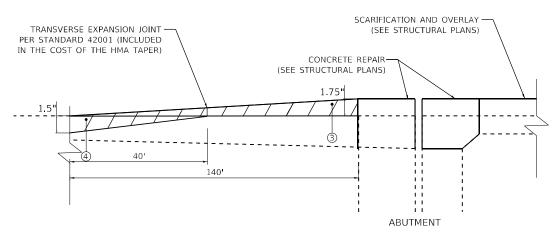

NORTH APPROACH SLAB SECTION A-A

HOT-MIX ASPHALT MIXTURE REQUIREMENTS

MIXTURE TYPE	AIR VOIDS (%) AT N DES	QUALITY MANAGEMENT PROGRAM (QMP)
HMA APPROACH PAVEMENT		
HOT-MIX ASPHALT SURFACE COURSE, MIX "D", IL-9.5, N70; VARIABLE DEPTH	4.0% AT 70 GYR.	QC/QA
QMP DESIGNATIONS: QUALITY CONTROL/QUALITY ASSURANCE (QC/QA); QUALITY CONTROL FOR		

3 PROPOSED HMA SC IL-9.5 MIX D N704 BUTT JOINT

LEGEND

① EXISTING HMA PAVEMENT

② EXISTING AGGREGATE BASE COURSE

NOTES

1. THE UNIT WEIGHT USED TO CALCULATE ALL HMA SURFACE MIXTURE QUANTITIES IS 112 LBS/SQ. YD./IN.

2. THE "AC TYPE" FOR POLYMERIZED HMA MIXES SHALL BE "SBS/SBR PG 76-22", AND FOR NON-POLYMERIZED HMA THE "AC TYPE" SHALL BE "PG 64-22" UNLESS MODIFIED BY RECLAIMED MATERIALS SPECIFICATIONS.



745 McClintock Drive Suite 210 Burr Ridge, IL 60527 Ph. 773-881-4788 Fax: 773-239-3728

PERFORMANCE (QCP); PAY FOR PERFORMANCE (PFP)

STATE OF ILLINOIS
DEPARTMENT OF TRANSPORTATION


TYPICAL SECTIONS
STRUCTURE NO. 016-1056
SHEET 1 OF 1 SHEETS

SCALE NONE

2/23/2023 3:34:30 PM

13032)6041)WO 216A Shoot-10163-004-5HT-DETAILS don

NAME: \\abna\jobfile

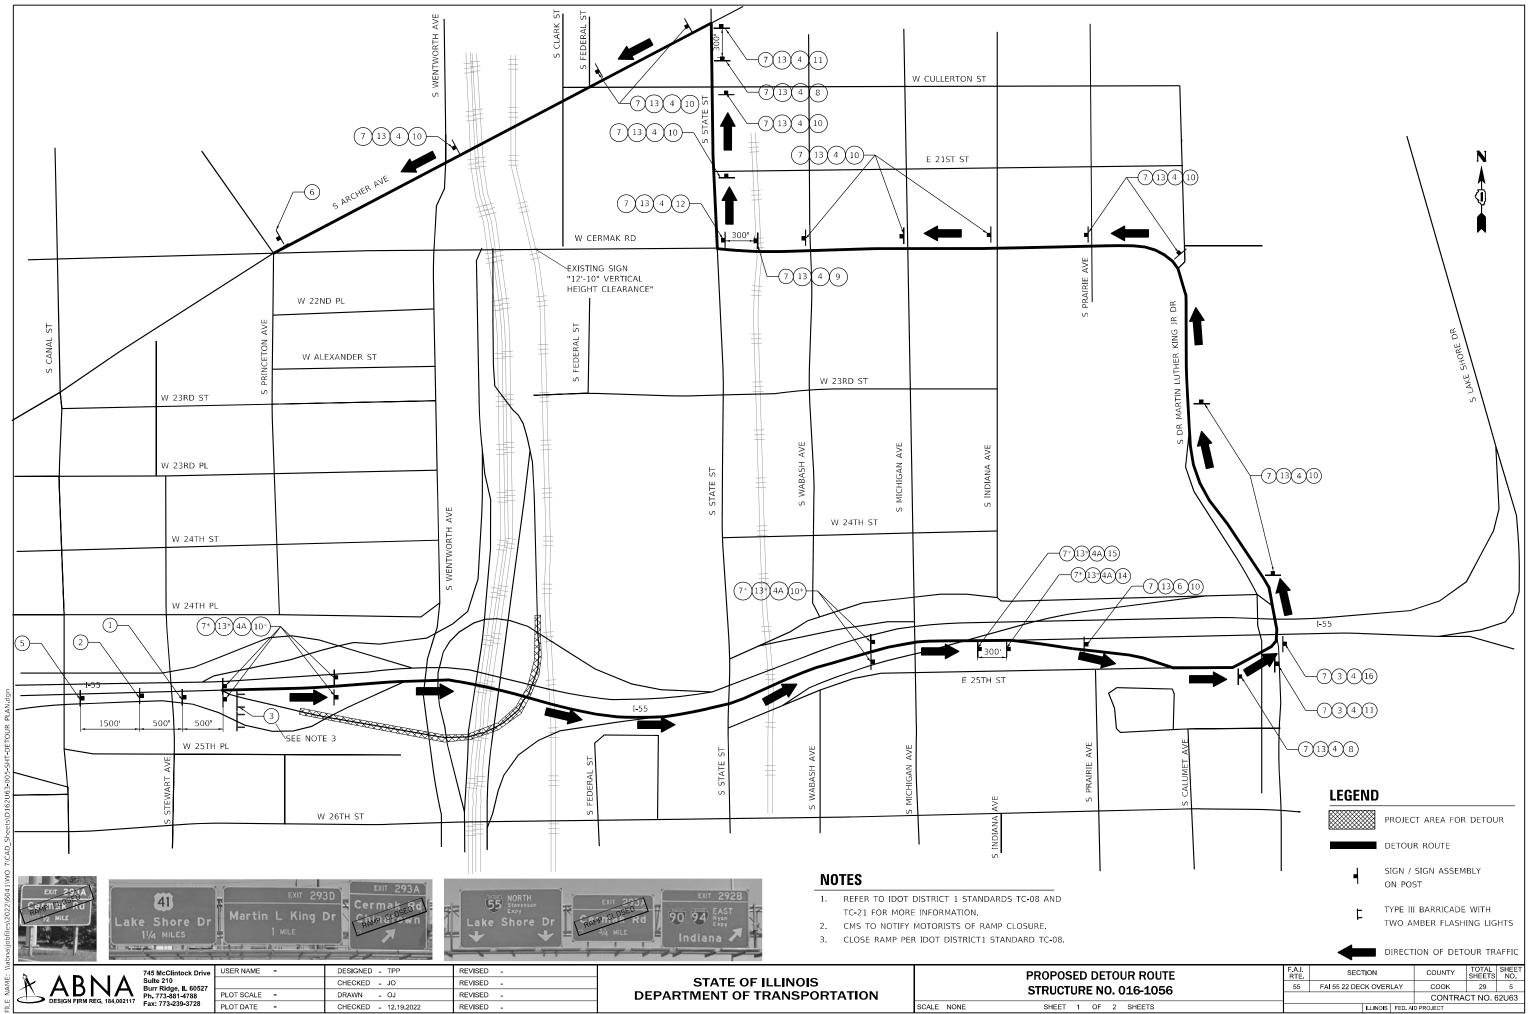

SIGN LEGEND

1 AHEAD

W20-2(0) 4848



W20-3(0) 4848

3

4

2

RAMP CLOSED

R11-2 4830 (B/W)

CERMAK RD CHINATOWN

SPECIAL SIGN 3618 4" BLACK LETTERING ON FLUORESCENT ORANGE BACKGROUND

(4A)

CERMAK RD CHINATOWN SPECIAL SIGN 3618 5" BLACK LETTERING ON FLUORESCENT ORANGE BACKGROUND



W20-I103 4848

END DETOUR

M4-8A(0) 2418

DETOUR

M4-8(0) 2412 * M4-8(0) 3618

8

9

6

7

M5-1L(0) 2115



M5-1R(0) 2115

10



M6-3(0) 2115 * M6-3(0) 3021

M6-1L(0) 2115

12



M6-1R(0) 2115

13

EAST

M3-2(0) 2412 * M3-2(0) 3618

14)



M6-2R(0) 3021



MS-2R(0) 3021



M6-2L(0) 2115

* USE LARGER SIGN SIZES ON I-55.

SCALE NONE

CERMAK RD CHINATOWN

SPECIAL SIGN 4" BLACK LETTERING ON FLUORESCENT ORANGE BACKGROUND

NOTES:

- USE BLACK LETTERING ON FLUORESCENT ORANGE BACKGROUND UNLESS NOTED.
- 2. SEE SPECIAL PROVISION FOR "TEMPORARY INFORMATION SIGNING" FOR ADDITIONAL INFORMATION FOR INSTALLATION OF "RAMP CLOSURE ADVANCE INFORMATION SIGN". ONE SIGN ASSEMBLY EQUALS 20.0 SQ FT.
- 3. EACH SIGN ASSEMBLY SHALL BE PAID FOR AS "TEMPORARY INFORMATION SIGNING". REFER TO IDOT DISTRICT 1 STANDARD TC-08 FOR SIGN DETAIL.
- 4. THE CONTRACTOR SHALL NOTIFY THE CHICAGO DEPARTMENT OF TRANSPORTATION ONE MONTH PRIOR TO THE RAMP CLOSURE.

- 5. SIGNS FOR THE DETOUR ARE INCLUDED IN THE CONTRACT LUMP SUM COST OF TRAFFIC CONTROL AND PROTECTION (SPECIAL).
- 6. SIGN PLACEMENT SHALL BE DONE ACCORDING TO DISTRICT STANDARD
- 7. ALL TRAFFIC SIGNS SHALL MEET WITH THE APPROVAL OF THE MANUAL ON UNIFORM TRAFFIC CONTROL DEVICES AND SHALL MEET WITH THE APPROVAL OF THE ENGINEER REGARDING LOCATION, TYPE, SIZE, NUMBER, AND DURATION.
- 8. FOR TYPICAL SIGN INSTALLATION SEE HIGHWAY STANDARD 701901.
- APPROPRIATE IDOT TRAFFIC CONTROL STANDARDS SHALL BE USED TO INSTALL AND REMOVE TRAFFIC CONTROL AND PROTECTION DEVICES.


745 McClintock Drive Suite 210 Burr Ridge, IL 60527 Ph. 773-881-4788 Fax: 773-239-3728

CHECKED - JO DRAWN PLOT DATE =


DESIGNED - TPP REVISED -REVISED -REVISED CHECKED - 12.19.2022 REVISED -

STATE OF ILLINOIS DEPARTMENT OF TRANSPORTATION PROPOSED DETAIL SIGNING **STRUCTURE NO. 016-1056** SHEET 2 OF 2 SHEETS

SECTION COUNTY 55 FAI 55 22 DECK OVERLAY COOK 29 6 CONTRACT NO. 62U63

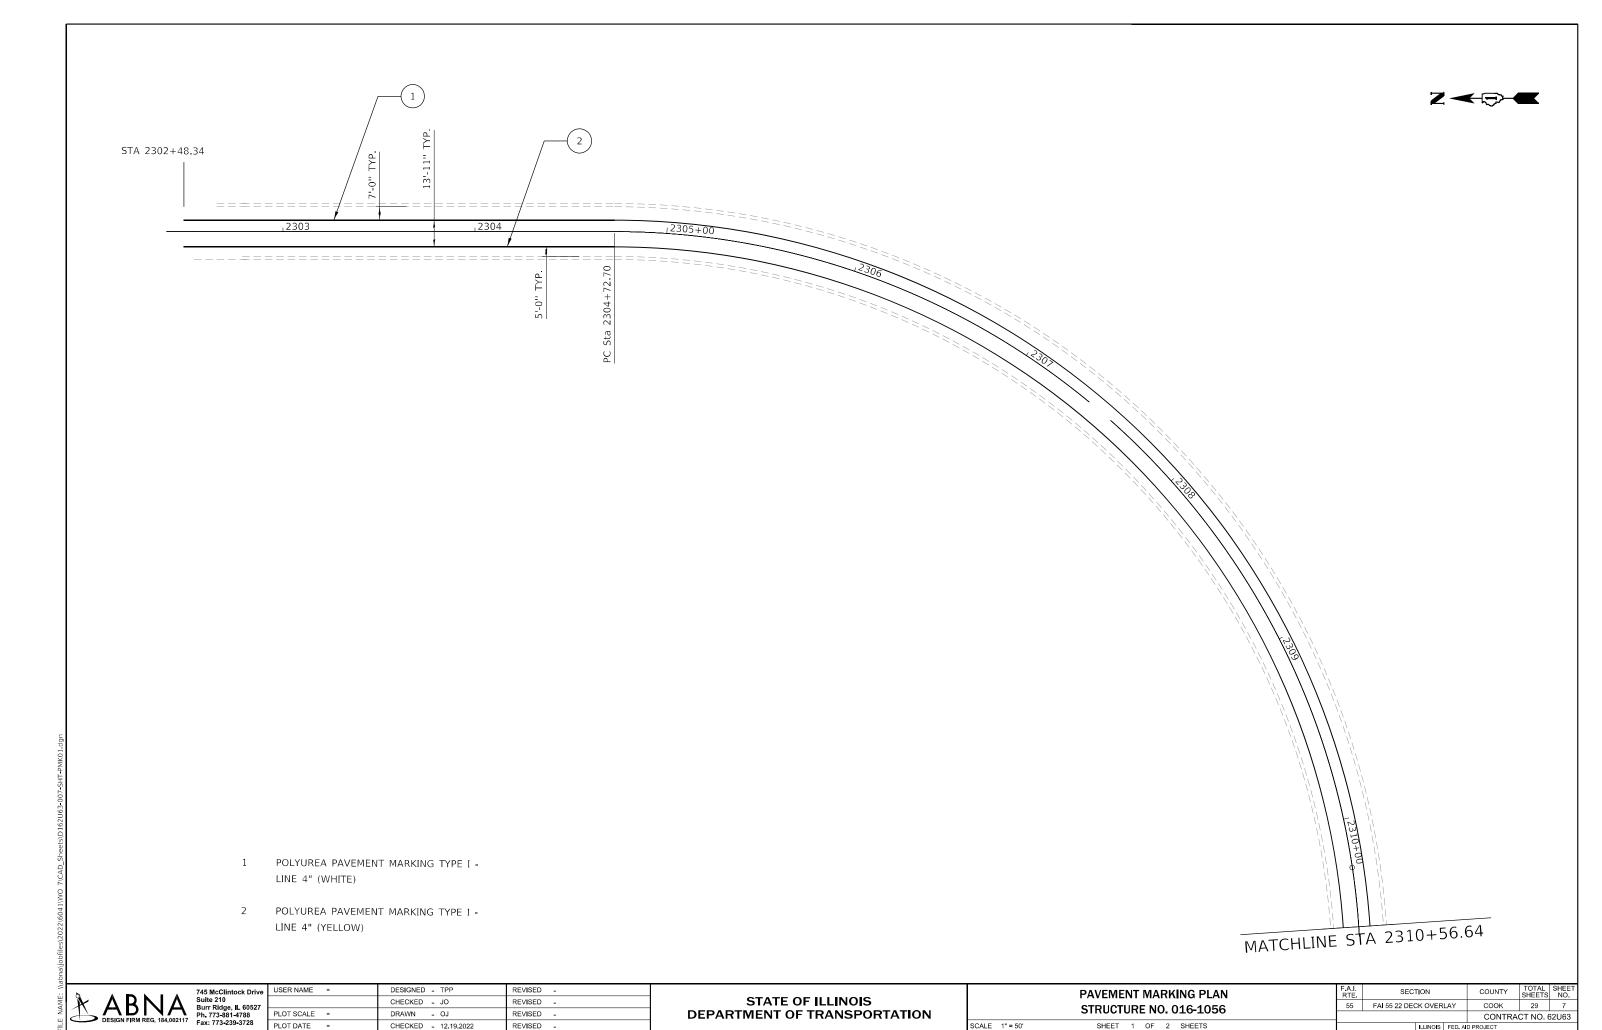



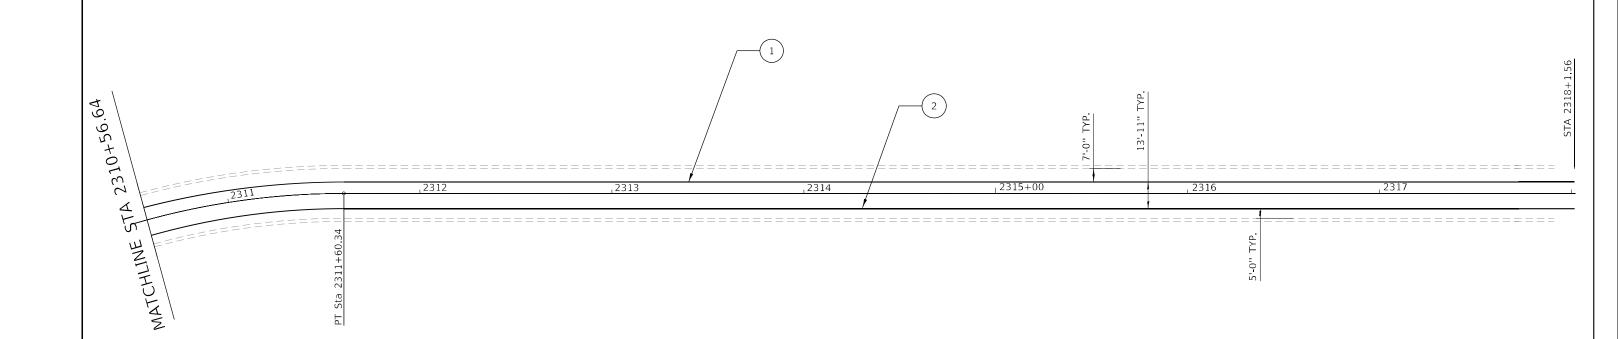

- 1 POLYUREA PAVEMENT MARKING TYPE I -LINE 4" (WHITE)
- 2 POLYUREA PAVEMENT MARKING TYPE I -LINE 4" (YELLOW)

A	A	B	NA
	DESIGN	N FIRM	REG. 184,002117

745 McClintock Drive Suite 210 Burr Ridge, IL 60527 Ph. 773-881-4788 Fax: 773-239-3728

 USER NAME
 =
 DESIGNED - TPP
 REVISED

 CHECKED - JO
 REVISED

 PLOT SCALE =
 DRAWN - OJ
 REVISED


 PLOT DATE =
 CHECKED - 12.19.2022
 REVISED


STATE OF ILLINOIS DEPARTMENT OF TRANSPORTATION

PAVEMENT MARKING PLAN
STRUCTURE NO. 016-1056


SHEET 2 OF 2 SHEETS


SCALE 1" = 50'

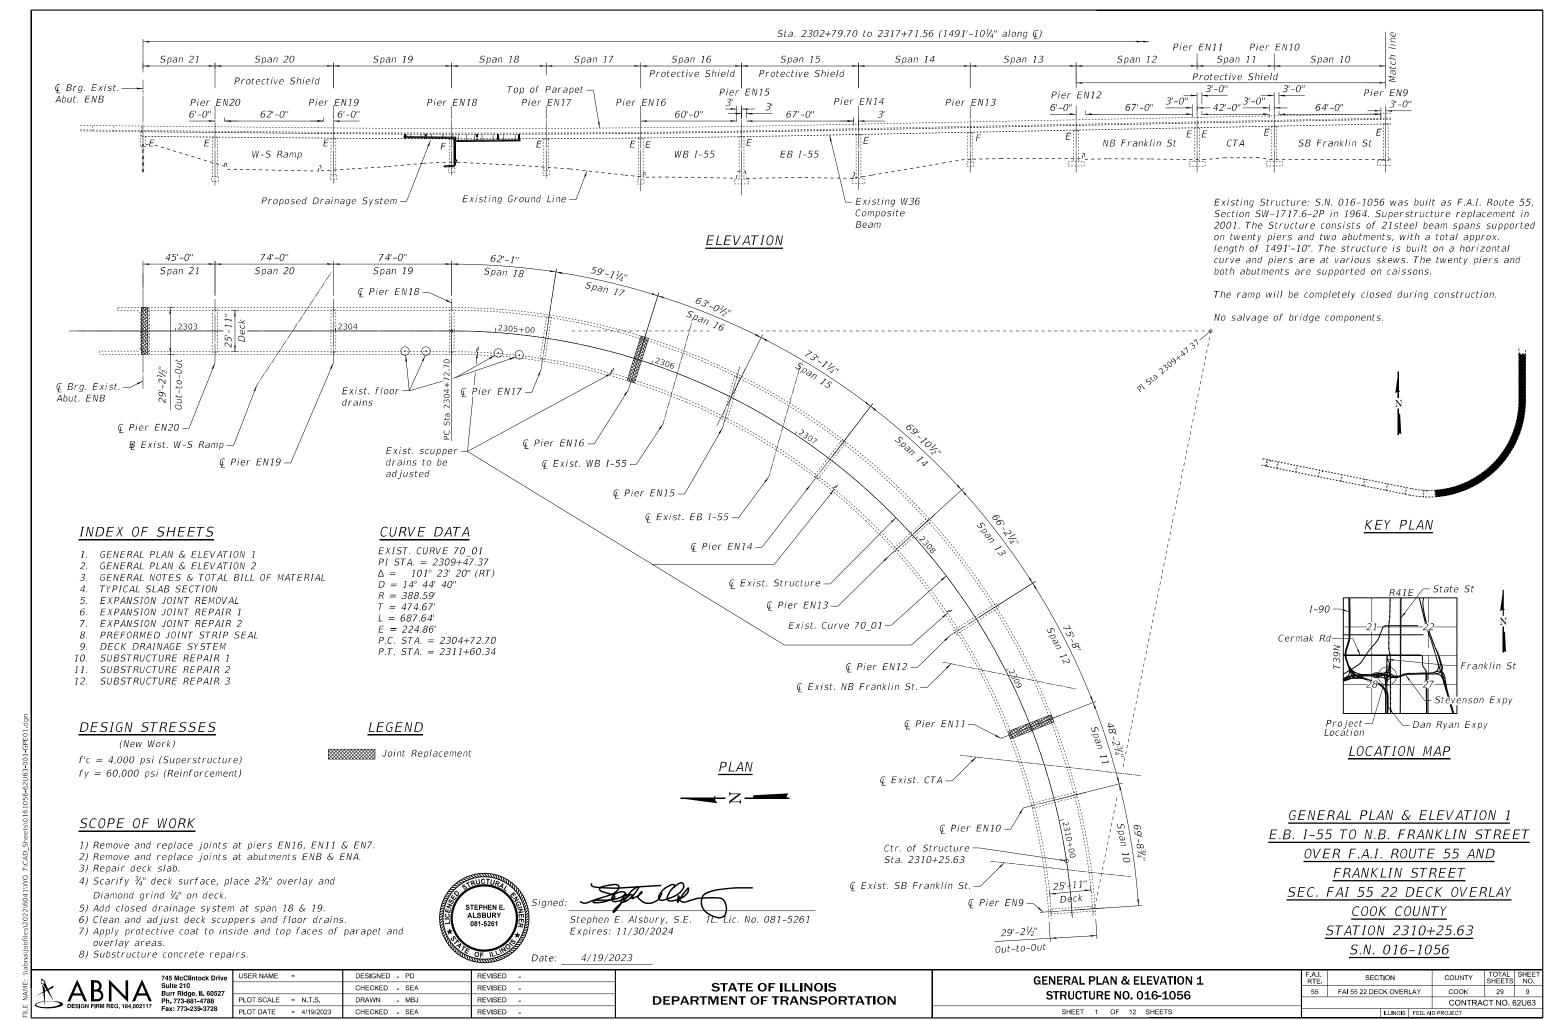

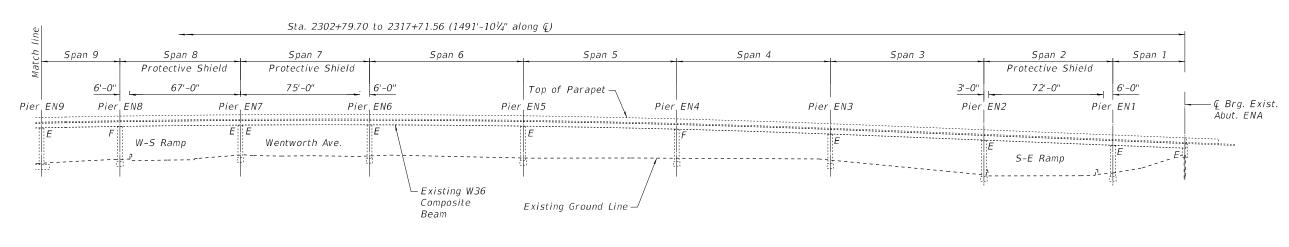



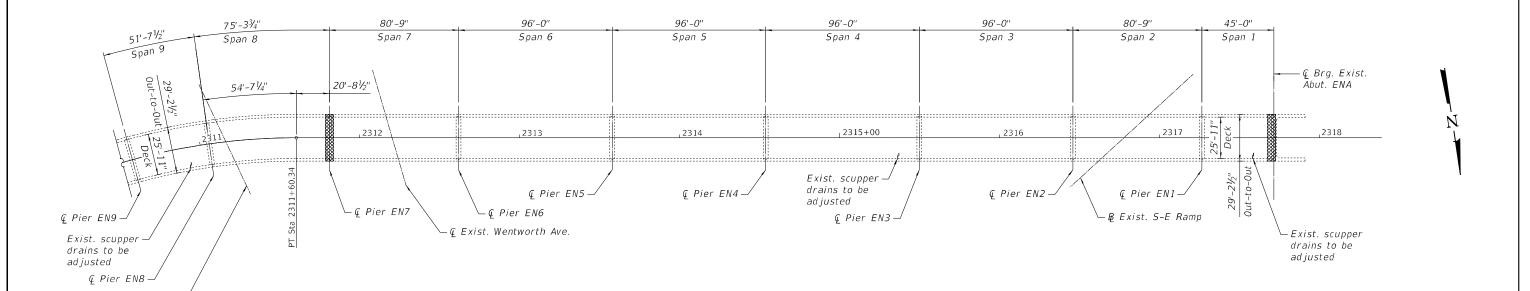

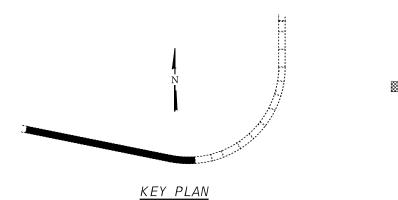

<u>LEGEND</u>

Joint Replacement

<u>PLAN</u>

GENERAL PLAN & ELEVATION 2
E.B. I-55 TO N.B. FRANKLIN STREET

OVER F.A.I. ROUTE 55 AND
FRANKLIN STREET

SEC. FAI 55 22 DECK OVERLAY

COOK COUNTY
STATION 2310+25.63
S.N. 016-1056

ABNA
DESIGN FIRM REG. 184.002117

745 McClintock Drive Suite 210 Burr Ridge, IL 60527 Ph. 773-881-4788 Fax: 773-239-3728

₽ Exist. W-S Ramp-

 Ve
 USER NAME
 =
 DESIGNED
 PD
 REVISED

 7
 CHECKED
 SEA
 REVISED

 PLOT SCALE
 =
 N.T.S.
 DRAWN
 MBJ
 REVISED

 PLOT DATE
 =
 4/19/2023
 CHECKED
 SEA
 REVISED

STATE OF ILLINOIS DEPARTMENT OF TRANSPORTATION

GENERAL PLAN & ELEVATION 2
STRUCTURE NO. 016-1056

SHEET 2 OF 12 SHEETS

 F.A.I. RTE.
 SECTION
 COUNTY
 TOTAL SHEETS
 SHEETS NO.

 55
 FAI 55 22 DECK OVERLAY
 COOK
 29
 10

 CONTRACT NO. 62U63

 ILLINOIS FED. AID PROJECT

GENERAL NOTES

Reinforcement bars designated (E) shall be epoxy coated.

Plan dimensions and details relative to existing plans are subject to nominal construction variations. The Contractor shall field verify existing dimensions and details affecting new construction and make necessary approved adjustments prior to construction or ordering of materials. Such variations shall not be cause for additional compensation for a change in scope of the work, however, the Contractor will be paid for the quantity actually furnished at the unit price bid for the work.

Existing reinforcement shall be cleaned and incorporated into the new construction. Cost included with Concrete Removal. Any reinforcement bars that are damaged during concrete removal shall replaced with an approved bar splicer or anchorage system.

Coordination with CTA is required for work in span 11 and joint replacement at pier EN11.

Up to $\frac{1}{4}$ inch may be ground off the bridge deck.

Joint openings shall be adjusted according to Article 520.04 of the Standard specifications, when the deck is poured at ambient temperature other than 50°.

TOTAL BILL OF MATERIAL


Item	Unit	Total
Concrete Removal	Cu. Yd.	26.1
Protective Shield	Sq. Yd.	2128
Concrete Superstructure	Cu. Yd.	29.3
Protective Coat	Sq. Yd.	5505
Reinforcement Bars, Epoxy Coated	Pound	3820
Preformed Joint Strip Seal	Foot	140
Drainage System for Structures	L. Sum	1
Bridge Deck Grooving (Longitudinal)	Sq. Yd.	2653
Bridge Deck Latex Concrete Overlay, 2 3/4"	Sq. Yd.	4252
Bridge Deck Scarification 3/4"	Sq. Yd.	4252
Structural Repair of Concrete (Depth equal to or less than 5 inches)	Sq. Ft.	120
Drainage Scuppers to be Adjusted	Each	7
Diamond Grinding Bridge Section	Sq. Yd.	3647

ABNA
DESIGN FIRM REG. 184,002117

745 McClintock Drive Suite 210 Burr Ridge, IL 60527 Ph. 773-881-4788 Fax: 773-239-3728


STATE OF ILLINOIS
DEPARTMENT OF TRANSPORTATION

GENERAL NOTES & TOTAL BILL OF MATERIAL STRUCTURE NO. 016-1056

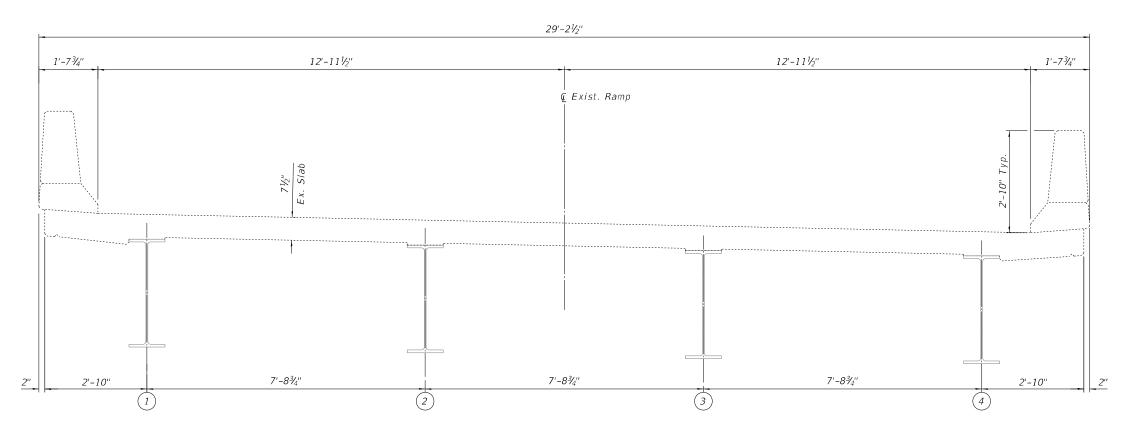

EXISTING TYPICAL SLAB SECTION

(Looking Upstation)

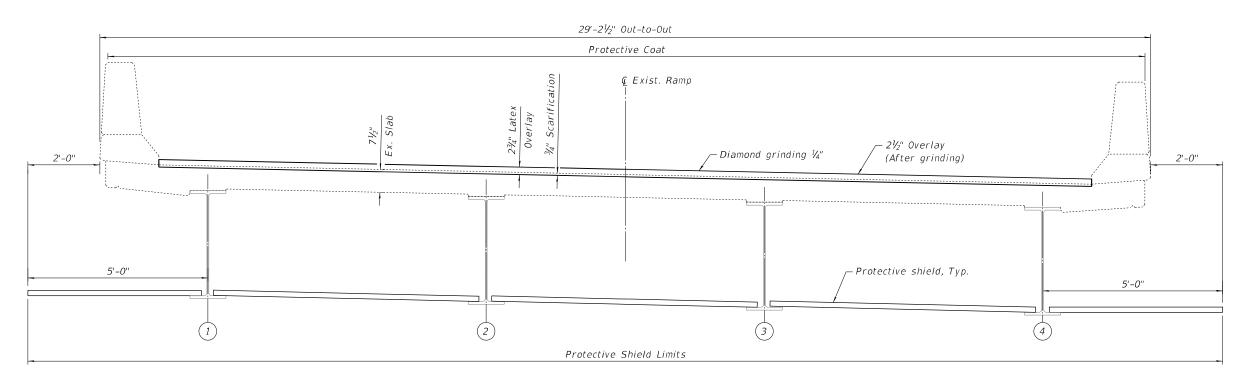

PROPOSED TYPICAL SLAB SECTION

(Looking Upstation)

F.A.I. SECTION

TE. SECTION


55 FAI 55 22 DECK OVERLAY


 COUNTY
 TOTAL SHEET NO.

 COOK
 29
 12

 CONTRACT NO. 62U63

ap							
=	<u> </u>	745 McClintock Drive	USER NAME =	DESIGNED - PD	REVISED -		TYPICAL SLAB SECTION
MA.	» ARNIA	Suite 210 Burr Ridge, IL 60527		CHECKED - SEA	REVISED -	STATE OF ILLINOIS	
Ž		Ph. 773-881-4788	PLOT SCALE = N.T.S.	DRAWN - MBJ	REVISED -	DEPARTMENT OF TRANSPORTATION	STRUCTURE NO. 016-1056
- " "	DESIGN FIRM REG. 184,002117	Fax: 773-239-3728	PLOT DATE = 4/19/2023	CHECKED - SEA	REVISED -		SHEET 4 OF 12 SHEETS

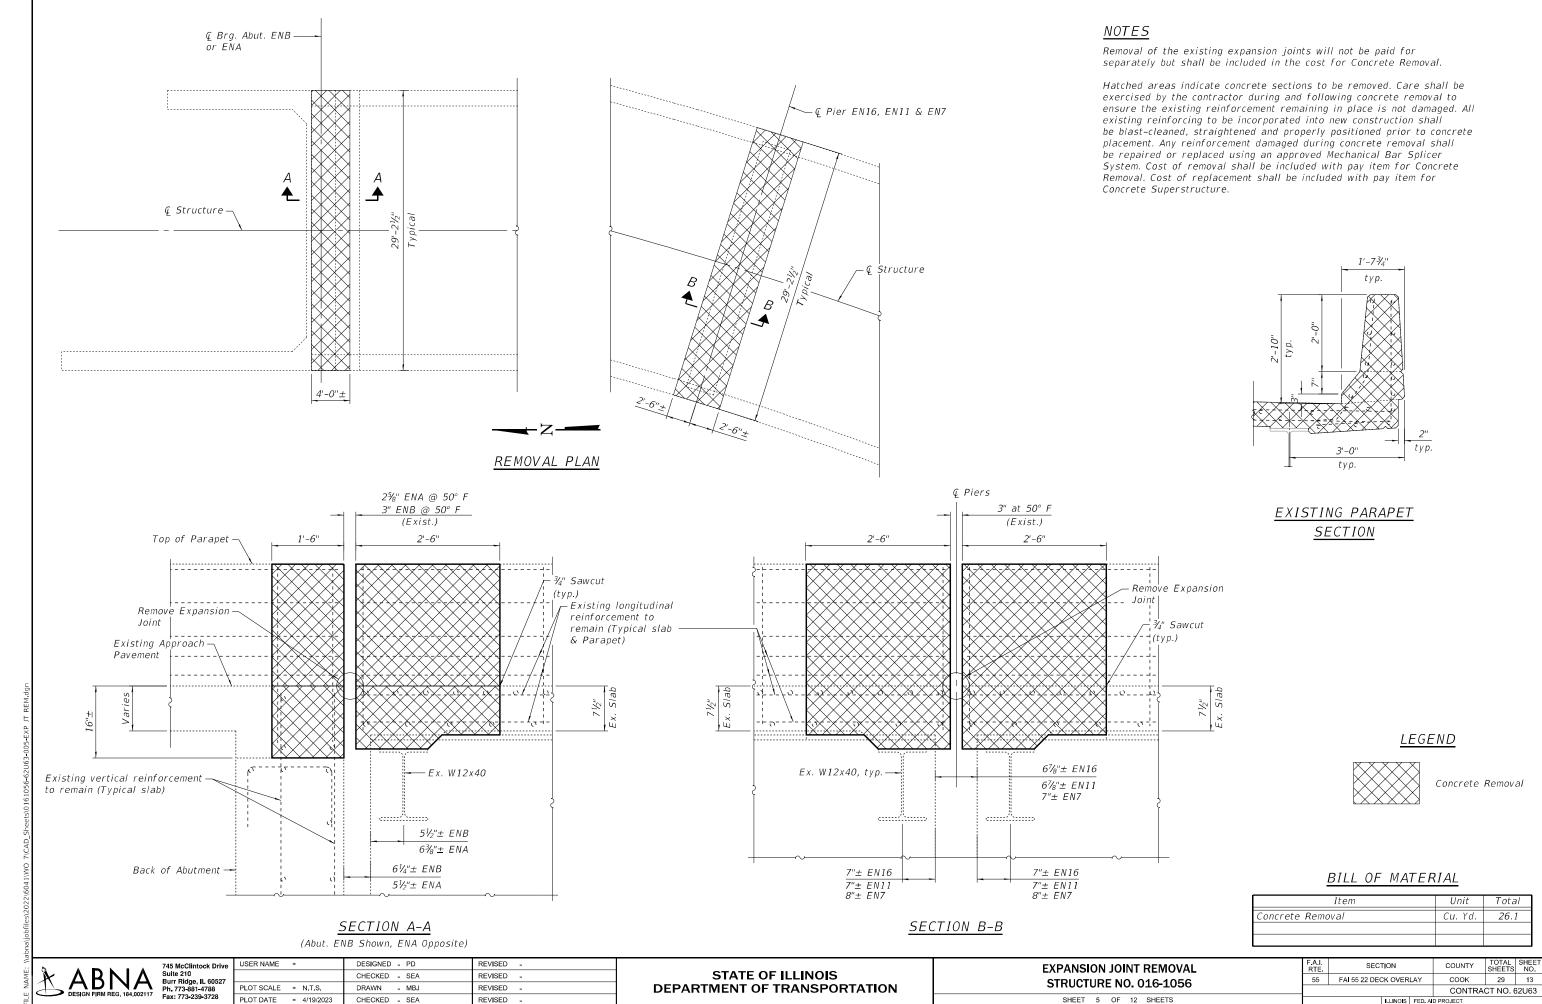

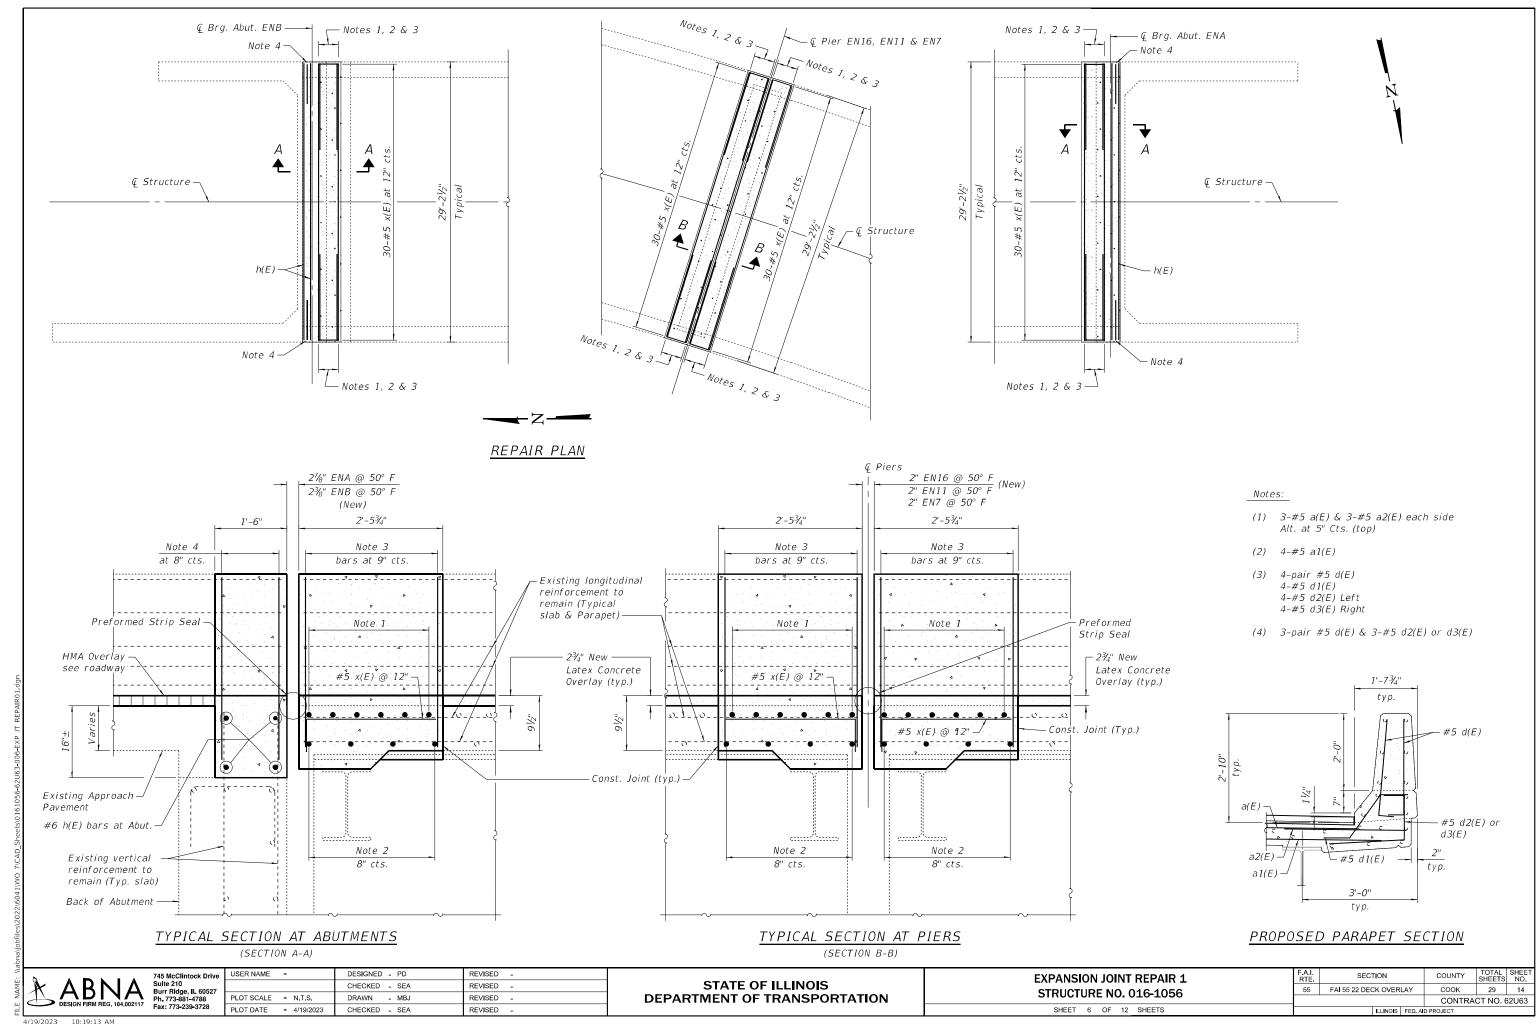

4/19/2023 10:19:13 AM

<u>NOTES</u>

The existing $7\frac{1}{2}$ " slab shall be scarified $\frac{3}{4}$ " and then a $2\frac{3}{4}$ " thick latex concrete overlay shall be placed on the deck.


For details of Preformed Joint Strip Seal Expansion Joints, see Sheet No. 8.





BAR x(E)


BILL OF MATERIAL

Bar	No.	Size	Length	Shape
a(E)	24	#5	28'-6"	
a1(E)	32	#5	27'-7"	
a2(E)	48	#5	4'-0"	
h(E)	8	#6	25'-7"	
d(E)	152	#5	3'-0"	
d1(E)	76	#5	2'-7"	1
d2(E)	38	#5	4'-1"	
d3(E)	38	#5	4'-1"	
x(E)	240	#5	2'-8"	
Reinforce	ment Ba	Pound	3820	
Epoxy Coa			3020	
Concrete S	Superst	Cu. Yd.	29.3	

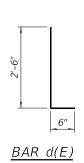

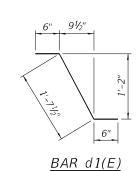

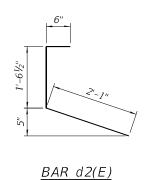

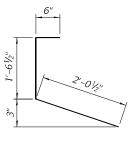

BAR d3(E)

745 McClintock Drive Suite 210 Burr Ridge, IL 60527 Ph. 773-881-4788 Fax: 773-239-3728


е	USER NAME	=	DESIGNED - PD	REVISED -
,			CHECKED - SEA	REVISED -
	PLOT SCALE	= N.T.S.	DRAWN - MBJ	REVISED -
	PLOT DATE	= 4/19/2023	CHECKED - SEA	REVISED -

				REPAIR 2)16-1056	
SHEET	7	OF	12	SHEETS	

A.I. RTE	SEC ⁻	LION		COUNTY	TOTAL SHEETS	SHEET NO.
55	FAI 55 22 DEG	CK OVER	LAY	соок	29	15
			CONTRA	CT NO. 6	32U63	
ILLINOIS FED. AI				D PROJECT		

4/19/2023 10:28:20 AM

003-007-EAF JI NEFAINOZ. Uğlı

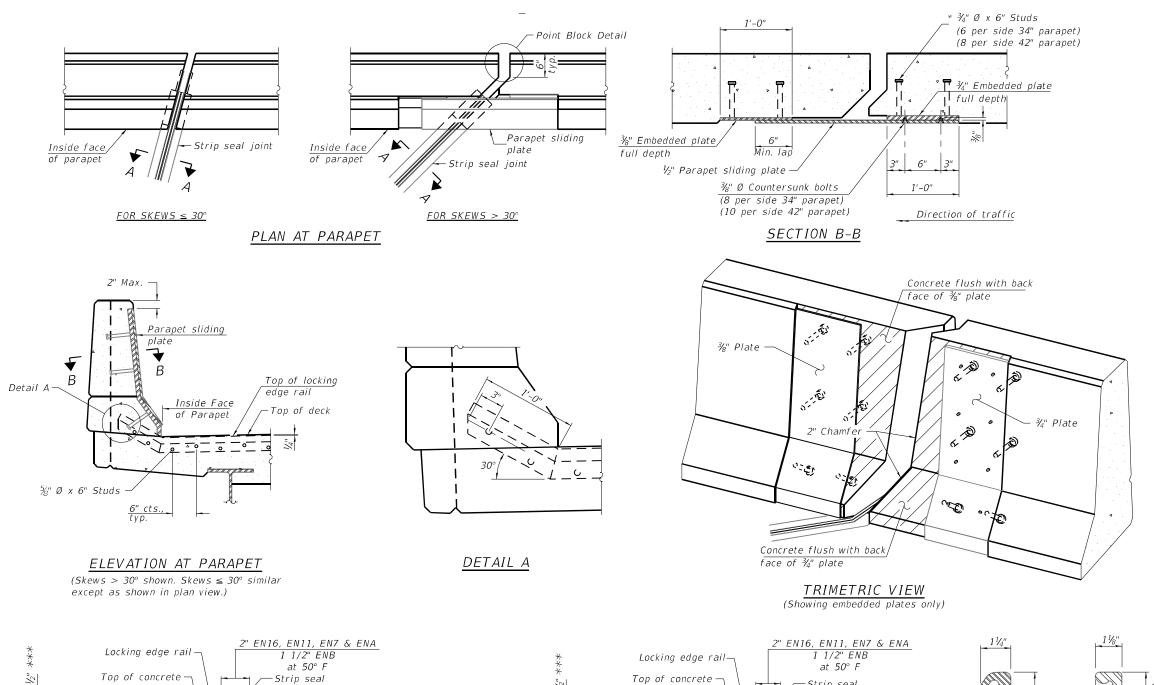

The strip seal shall be made continuous and shall have a minimum thickness of 1/4". The configuration of the strip seal shall match the configuration of the locking edge rails. Open or "webbed" strip seal gland configurations are not permitted. The gland shall be sized for a maximum rated movement of 4 inches.

The locking edge rails depicted are configured for typical applications and are conceptual only. The actual configuration of the locking edge rails and matching strip seal may vary from manufacturer to manufacturer provided they fit the application and meet the minimum anchorage shown. Flanged edge rails, however, will not be allowed. Locking edge rails may exceed the 4½" maximum depth provided the anchorage system is revised according to the manufacturer's recommendation.


The manufacturer's recommended installation methods shall be followed.

All steel components shall be galvanized after fabrication according to Article 520.03 of the Standard Specifications.

The Maximum space between locking edge rail segments shall be $\frac{3}{16}$ " and sealed with a suitable sealant; however, any rail joint within 10' measured perpendicular to the face of the curb or parapet shall be welded as shown in the locking edge rail splice detail.

Cost of parapet sliding plates, embedded plates, and anchorage studs included with Preformed Joint Strip Seal.

34" F-shape barrier shown, 42" F-shape similar as noted. The concrete opening below the strip seal will vary based on the locking edge rail chosen by the Contractor. Deck and parapet lengths shown elsewhere in the plans are dimensioned to the concrete opening, not the joint opening, and are based on the rolled locking edge rail. If the Contractor elects to use a different locking edge rail, dimensional adjustments may be required. One exception to this would be the strip seal joint at the end of the precast bridge approach slab. For these cases the pavement connector length shall be adjusted, not the length of the bridge approach slab.

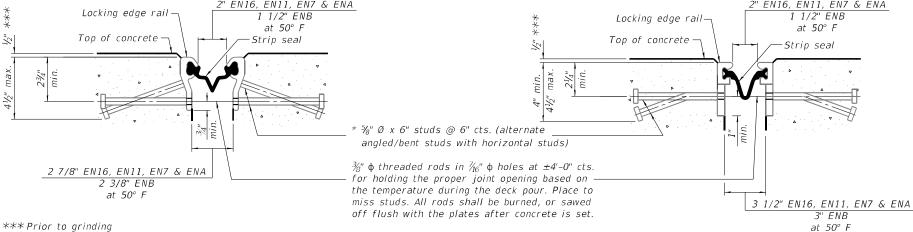


SECTION A-A * Granular or solid flux filled headed studs conforming to Article 1006.32 of the Std. Specs., automatically end welded.

<u>ROLLED</u> WELDED RAIL (EXTRUDED) RAIL

LOCKING EDGE RAILS

** Back gouge not required if complete joint penetration is verified by mock-up.

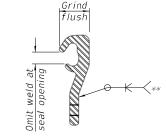

LOCKING EDGE RAIL SPLICE

The inside of the locking edge rail groove shall be free of weld residue. Rolled rail shown, welded rail similar.

BILL OF MATERIAL

Item	Unit	Total
Preformed Joint Strip Seal	Foot	140

Modified

745 McClintock Drive Suite 210 Burr Ridge, IL 60527 Ph. 773-881-4788 Fax: 773-239-3728

SHOWING ROLLED RAIL JOINT


USER NAME DESIGNED - PD REVISED CHECKED - SEA REVISED -PLOT SCALE = N.T.S. REVISED PLOT DATE = 4/19/2023 CHECKED - SEA REVISED .

STATE OF ILLINOIS DEPARTMENT OF TRANSPORTATION


SHOWING WELDED RAIL JOINT

PREFORMED JOINT STRIP SEAL **STRUCTURE NO. 016-1056** SHEET 8 OF 12 SHEETS


SECTION COUNTY 55 FAI 55 22 DECK OVERLAY COOK 29 16 CONTRACT NO. 62U63

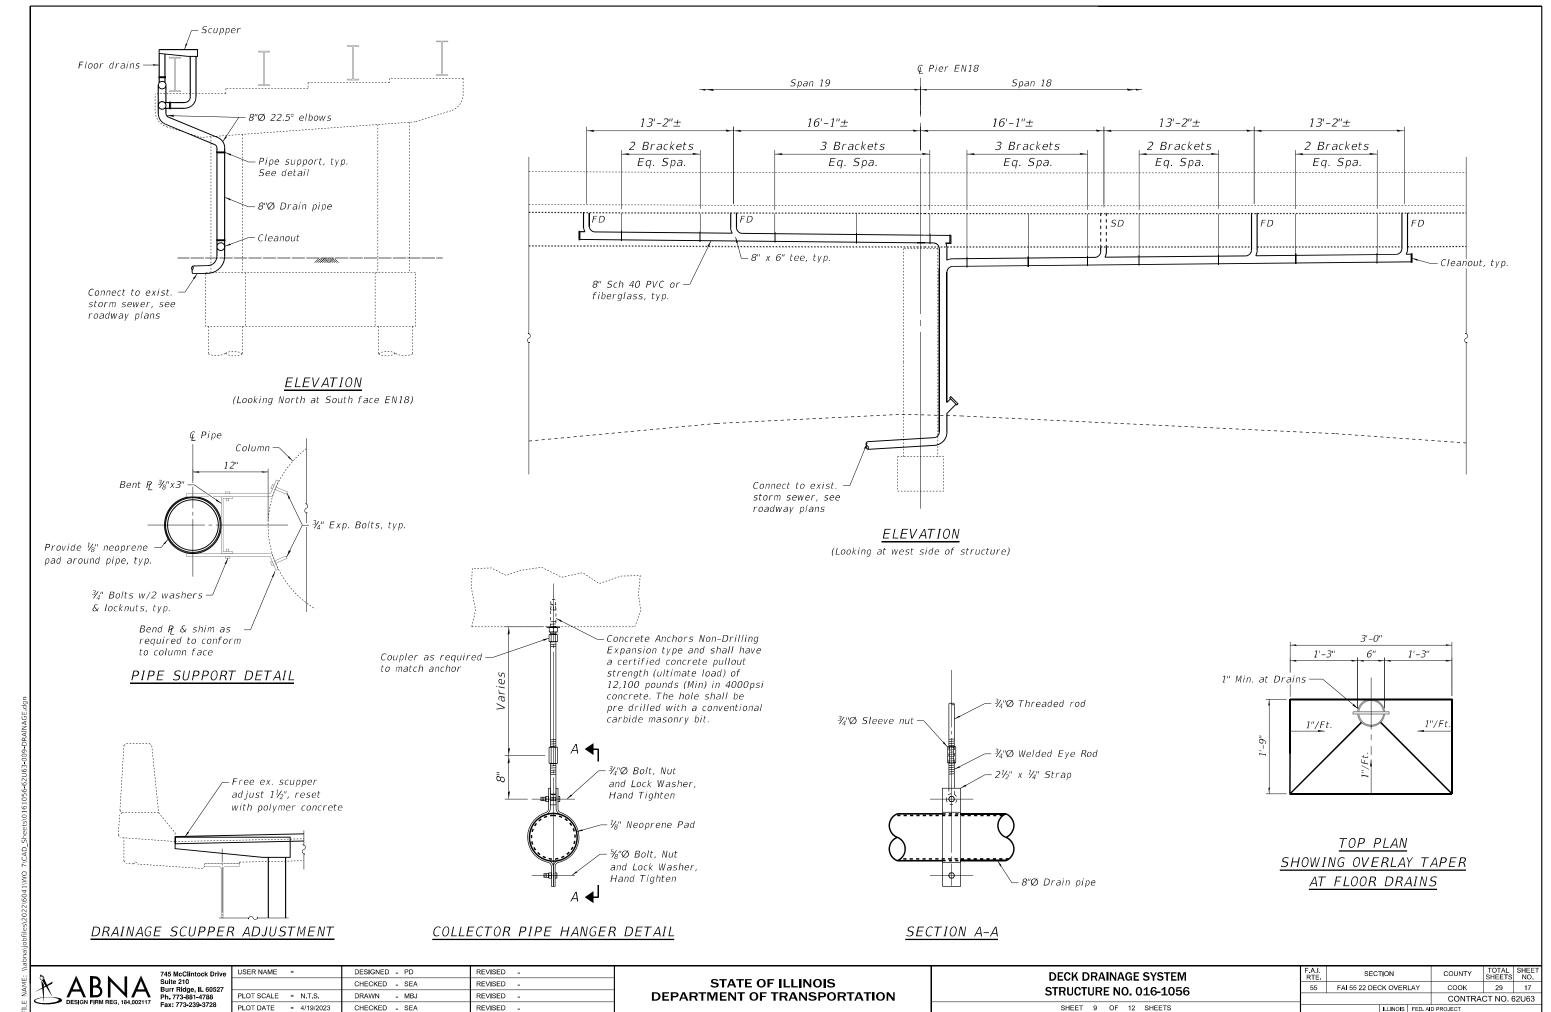

4/19/2023 10:20:39 AM

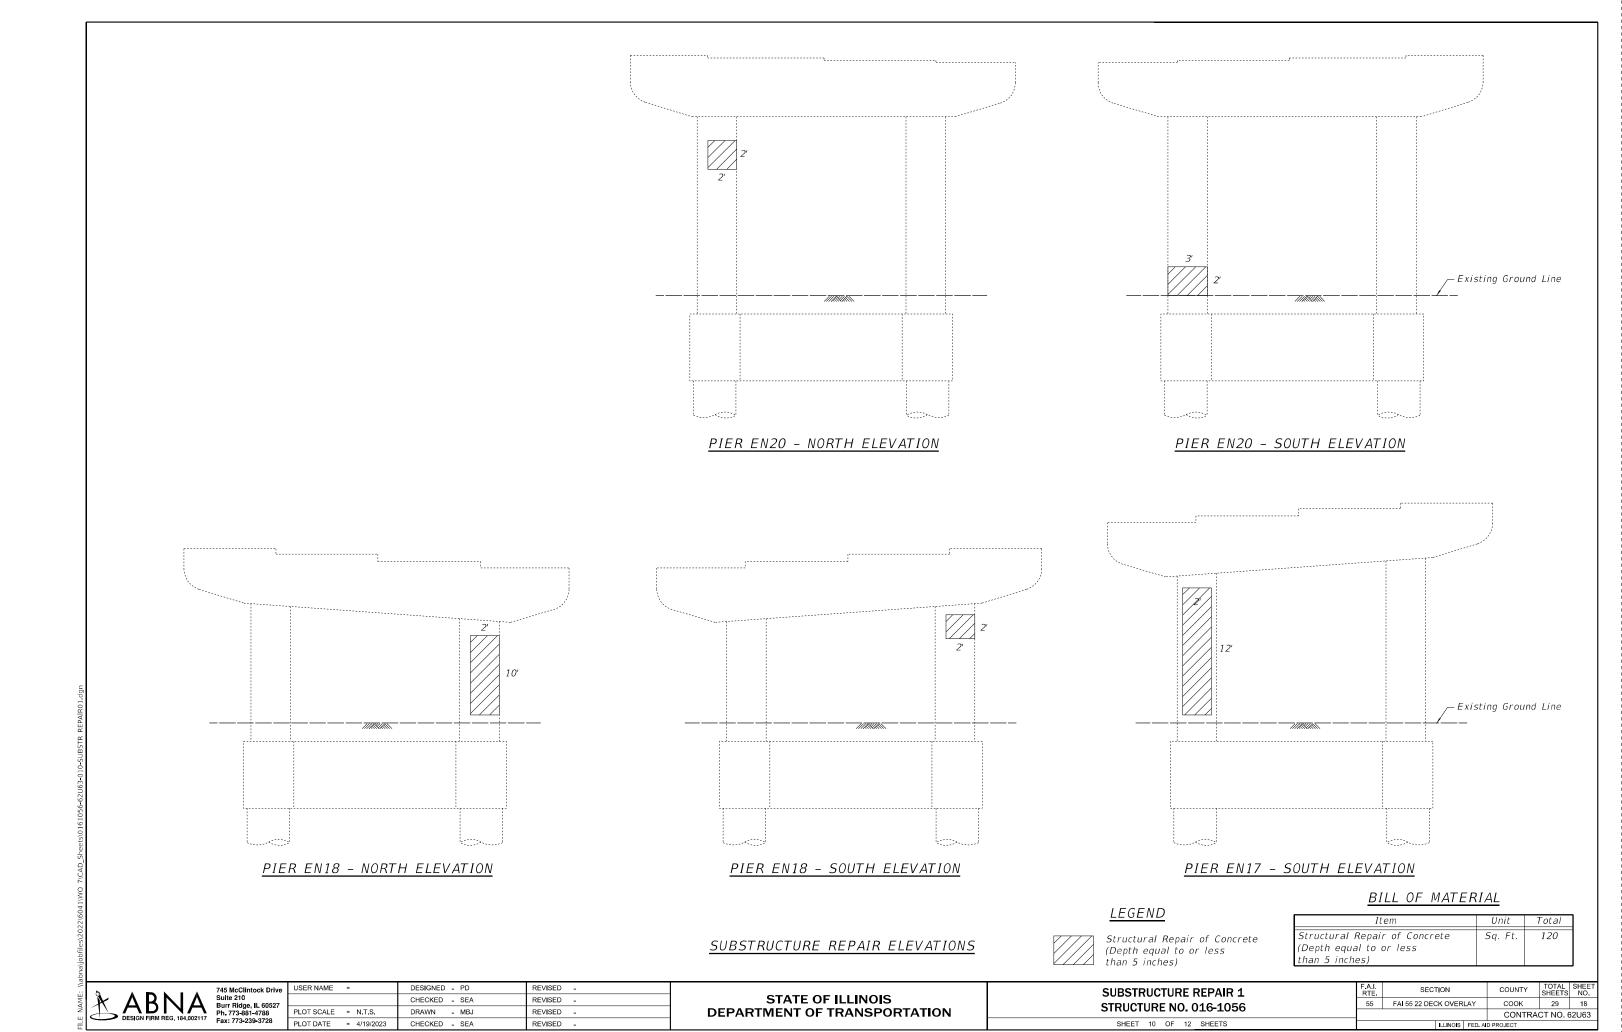

4/19/2023 10:21:16 AM

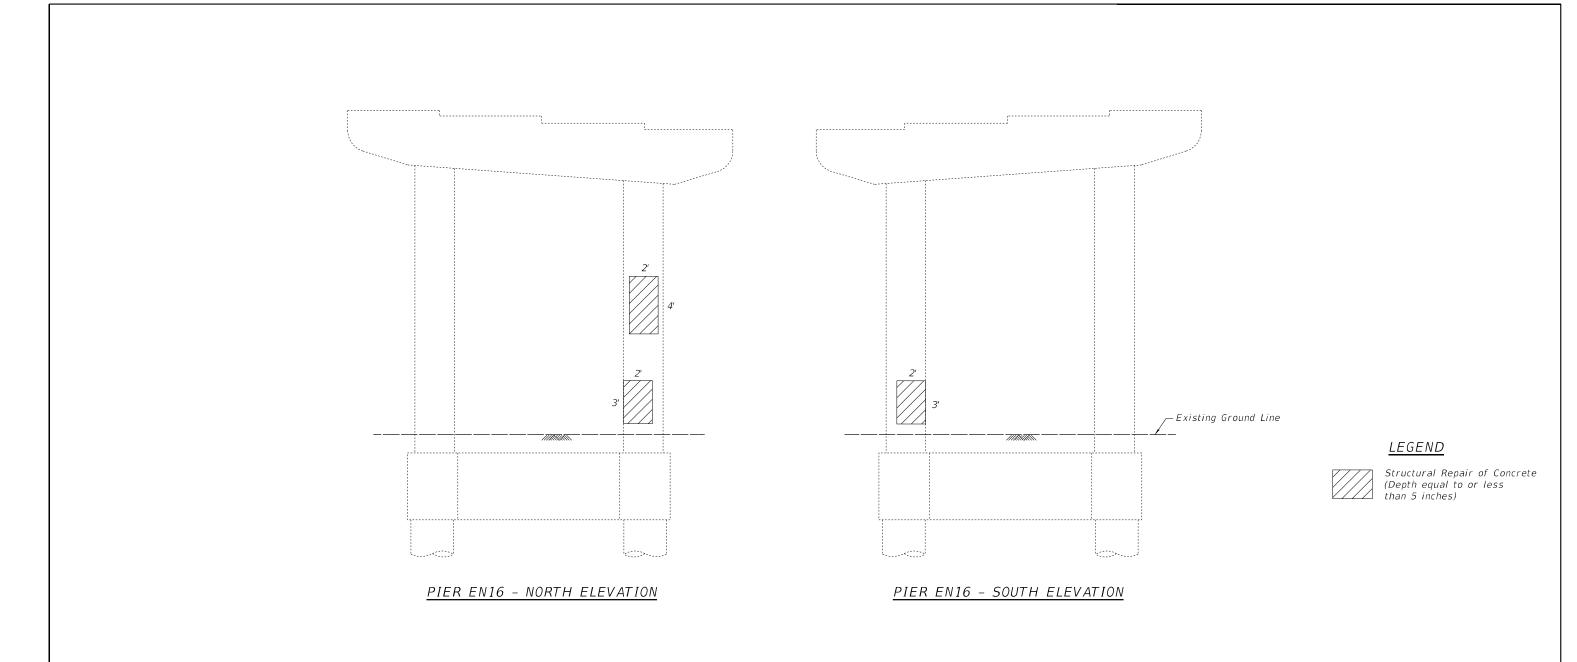

SUBSTRUCTURE REPAIR ELEVATIONS

P A A CClintock Drive Suite 210
Burr Ridge, IL 60527
Ph. 773-881-4788
Fax: 773-239-3728


DESIGNED - PD REVISED -CHECKED - SEA REVISED -PLOT SCALE = N.T.S. DRAWN - MBJ REVISED -PLOT DATE = 4/19/2023 CHECKED - SEA


STATE OF ILLINOIS DEPARTMENT OF TRANSPORTATION

SUBSTRUCTURE REPAIR 2 **STRUCTURE NO. 016-1056** SHEET 11 OF 12 SHEETS

COUNTY TOTAL SHEET NO.

COOK 29 19 SECTION 55 FAI 55 22 DECK OVERLAY CONTRACT NO. 62U63

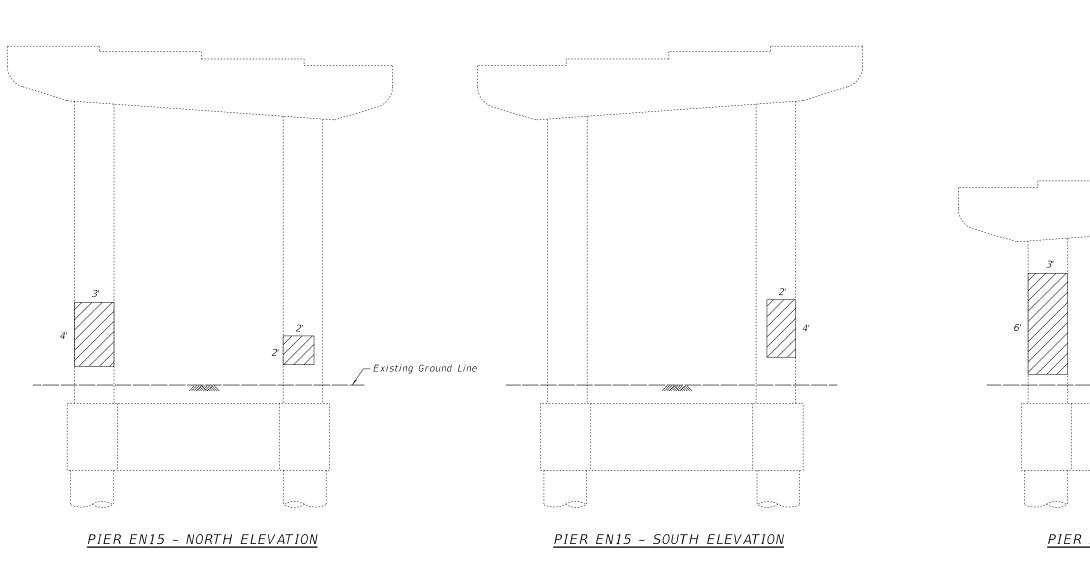

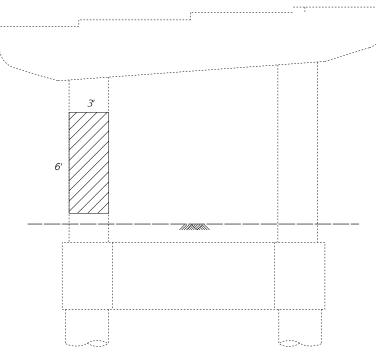

PIER EN7 - WEST ELEVATION

<u>LEGEND</u>



Structural Repair of Concrete (Depth equal to or less than 5 inches)

SUBSTRUCTURE REPAIR ELEVATIONS




DESIGNED - PD REVISED -CHECKED - SEA REVISED -PLOT SCALE = N.T.S. DRAWN REVISED -PLOT DATE = 4/19/2023 CHECKED - SEA


STATE OF ILLINOIS DEPARTMENT OF TRANSPORTATION

SUBSTRUCTURE REPAIR 3 **STRUCTURE NO. 016-1056** SHEET 12 OF 12 SHEETS


COUNTY TOTAL SHEET NO.


COOK 29 20 SECTION 55 FAI 55 22 DECK OVERLAY CONTRACT NO. 62U63

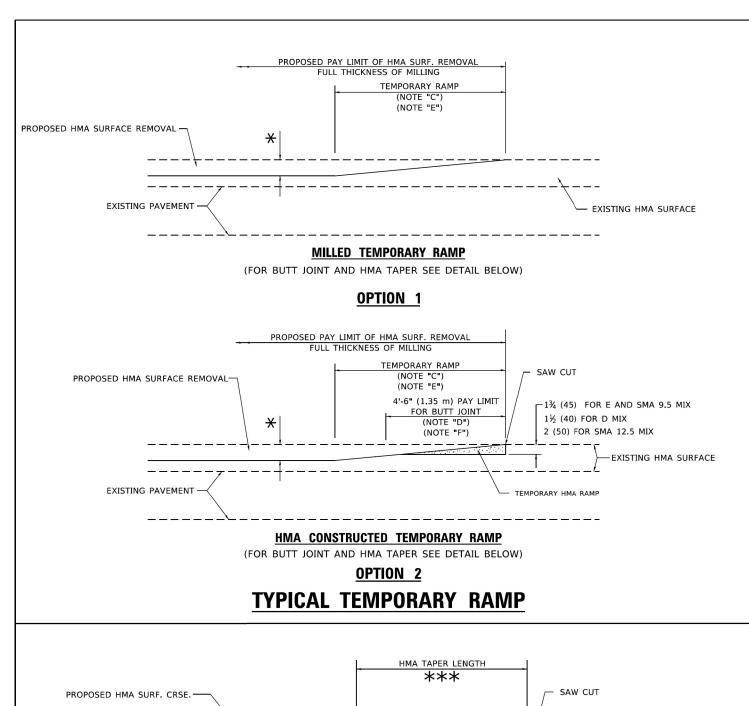

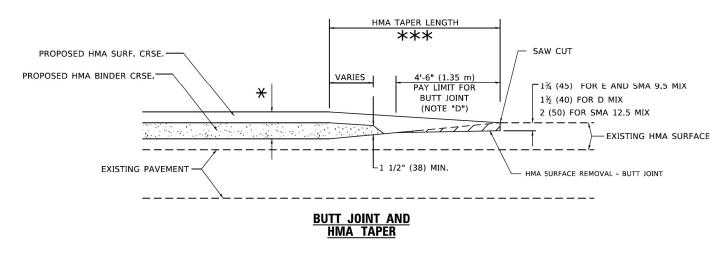

TYPICAL BUTT JOINT AND HMA TAPER FOR MILLING AND RESURFACING

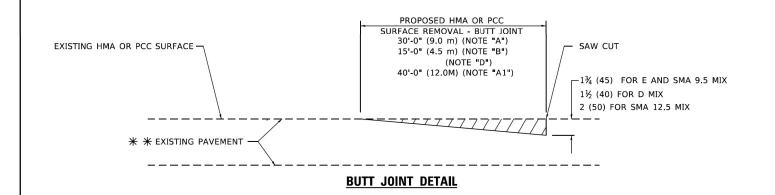

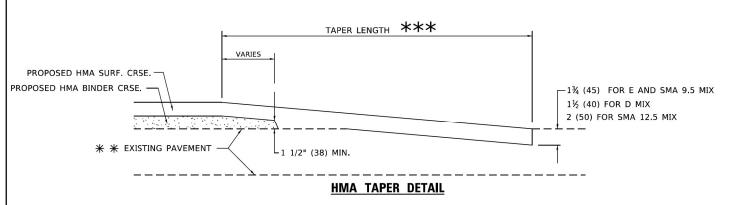

TYPICAL BUTT JOINT AND HMA TAPER FOR RESURFACING ONLY

** PC CONCRETE, HMA OR HMA RESURFACED PAVEMENT.

GENERAL NOTES

- A. MAINLINE ARTERIAL ROADWAYS AND MAJOR SIDE ROADS
- A1. INTERSTATES
- B. MINOR SIDE ROADS
- C. THE TEMP, RAMP SHALL BE CONSTRUCTED IMMEDIATELY UPON REMOVAL OF THE EXISTING HMA SURFACE
- D. THE BUTT JOINT SHALL BE CONSTRUCTED IMMEDIATELY
- E. TAPER THE TEMP. RAMP AT A RATE OF 3' 4" (1.02m) PER 1 INCH (25 mm) OF MILLING THICKNESS.
- FOR "HMA AND/OR PCC SURFACE REMOVAL, BUTT JOINT".
- *** 20'-0" (6.1 m) PER 1 (25) RESURFACING (NOTE "A") 10'-0" (3.0 m) PER 1 (25) RESURFACING (NOTE "B")

BASIS OF PAYMENT

- THE BUTT JOINT WILL BE PAID FOR AT THE CONTRACT UNIT PRICE PER SQUARE YARD (SQUARE METER) FOR "HOT-MIX ASPHALT SURFACE REMOVAL BUTT JOINT" OR FOR "PORTLAND CEMENT CONCRETE SURFACE REMOVAL- BUTT JOINT".
- THE TEMPORARY RAMP AND SAW CUT SHALL BE INCLUDED IN THE UNIT COST FOR HMA OR PCC SURFACE REMOVAL-BUTT JOINT.

ALL DIMENSIONS ARE IN INCHES (MILLIMETERS) UNLESS OTHERWISE SHOWN.




745 McClintock Drive Suite 210 Burr Ridge, IL 60527 Ph. 773-881-4788 Fax: 773-239-3728


DESIGNED - TPF REVISED CHECKED - JO REVISED -DRAWN - OJ REVISED PLOT DATE = CHECKED - 12.19.2022 REVISED .

STATE OF ILLINOIS **DEPARTMENT OF TRANSPORTATION**

BUTT JOINT AND HMA TAPER DETAILS (BD-32) STRUCTURE NO. 016-1056 SHEET 1 OF 9 SHEETS SCALE NONE

SECTION 55 FAI 55 22 DECK OVERLAY COOK 29 21 CONTRACT NO. 62U63

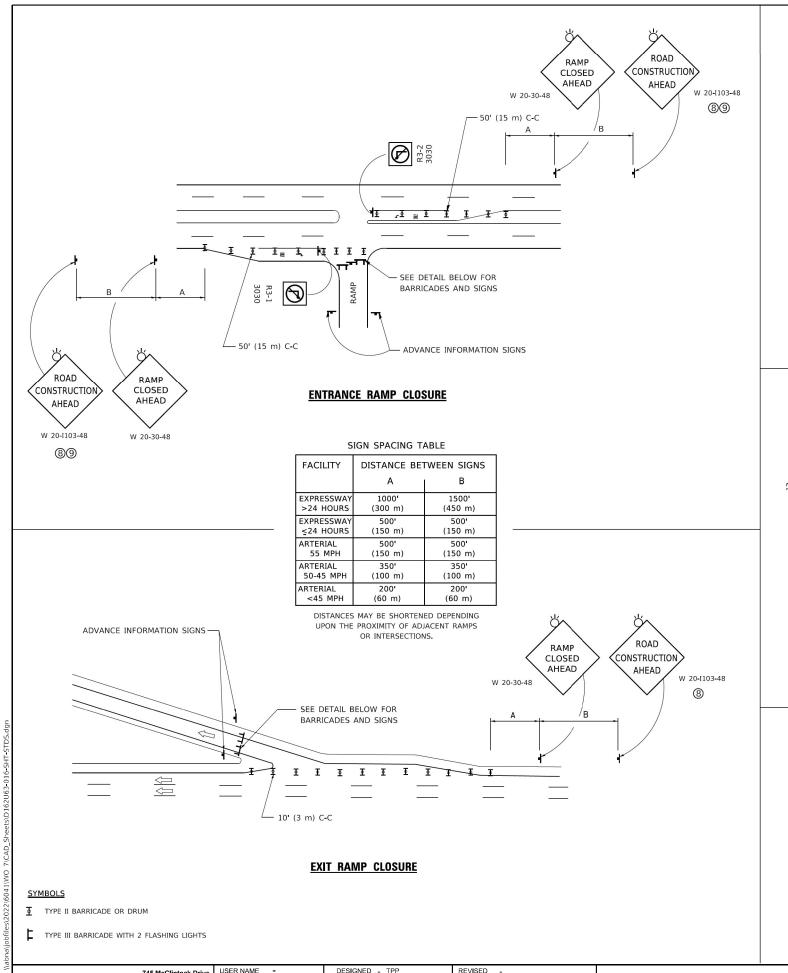

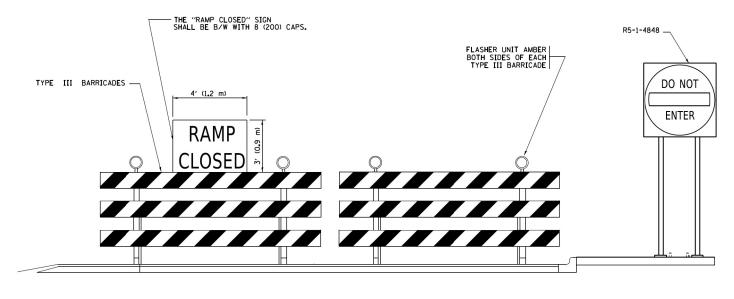

DETAIL FOR REQUIRED BARRICADES & SIGNS


RAMP CLOSURE ADVANCE INFORMATION SIGN

RAMP CLOSURE ADVANCE WARNING SIGN



BLACK LEGEND ON ORANGE BACKGROUND MOUNTED DIAGONALLY E MOD FONT

1 (25) BORDER THESE SIGNS ARE REQUIRED ON ALL THE EXIT GUIDE SIGNS FOR EXIT RAMPS THAT WILL BE CLOSED FOR MORE THAN FOUR (4) CONSECUTIVE DAYS.

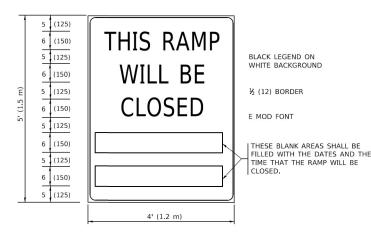

THESE SIGNS ARE REQUIRED ON BOTH SIDES OF THE RAMP, MINIMUM OF 1 WEEK IN ADVANCE OF THE CLOSURE.

THESE SIGNS SHALL BE FABRICATED AND PAID FOR ACCORDING TO THE TEMPORARY INFORMATION SIGNING SPECIAL PROVISION

GENERAL NOTES:

- CONES MAY BE SUBSTITUTED FOR DRUMS OR TYPE II CONES MAY BE SUBSTITUTED FOR DISCUSSION OF THE BEARRICADES DURING DAY OPERATIONS. CONES SHALL BE A MINIMUM OF 28 (700) HIGH.
- ② VERTICAL BARRICADES SHALL NOT BE USED FOR RAMP CLOSURES.
- 3 A FLAGGER SHALL BE POSITIONED AT EACH CLOSED RAMP THAT IS OPEN TO CONSTRUCTION VEHICLES, PRECEEDED BY A W20-7 FLAGGER WARNING SIGN.
- 4 ALL ROUTE MARKERS AND TRAILBLAZER ASSEMBLIES WHICH DIRECT MOTORISTS TO A CLOSED ENTRANCE RAMP SHALL BE COVERED WHEN THE RAMP IS CLOSED FOR MORE THAN FOUR (4) DAYS.
- THE SIGNING AND BARRICADING WHICH IS REQUIRED BY THIS DETAIL SHALL BE INCLUDED IN THE COST OF TRAFFIC CONTROL AND PROTECTION (EXPRESSWAYS).

- 6 AUTHORIZATION FROM THE DISTRICT'S BUREAU OF TRAFFIC IS REQUIRED FOR ALL RAMP CLOSURES.
- THE RAMP CLOSURE ADVANCE INFORMATION SIGNS SHALL BE ERECTED IF THE CLOSURE TIME EXCEEDS TWENTY-FOUR (24) HOURS. ADDITIONAL ADVANCE WARNING SIGNS ON EXIT GUIDE SIGNING WILL BE REQUIRED FOR EXIT RAMP CLOSURES THAT EXCEED FOUR (4) DAYS IN LENGTH
- (8) ROAD CONSTRUCTION AHEAD SIGNS MAY BE OMITTED WHEN THIS DETAIL IS USED IN CONJUNCTION WITH OTHER TRAFFIC CONTROL THAT ALREADY INCLUDES A ROAD CONSTRUCTION AHEAD SIGN.
- ARTERIAL ROAD CONSTRUCTION AHEAD SIGNS SHALL BE INSTALLED ON THE LEFT SIDE OF TRAFFIC IF THE MEDIAN IS MORE THAN 10 FT WIDE.

ALL DIMENSIONS ARE IN INCHES (MILLIMETERS) UNLESS OTHERWISE SHOWN.



Suite 210 Burr Ridge, IL 60527 Ph. 773-881-4788 Fax: 773-239-3728


USER NAME DESIGNED - TPF REVISED CHECKED - JO REVISED REVISED PLOT DATE = CHECKED - 12.19.2022 REVISED


STATE OF ILLINOIS **DEPARTMENT OF TRANSPORTATION**


ENTRANCE AND EXIT RAMP CLOSURE DETAILS (TC-08) STRUCTURE NO. 016-1056 SHEET 2 OF 9 SHEETS SCALE NONE


SECTION COUNTY 55 FAI 55 22 DECK OVERLAY COOK 29 22 CONTRACT NO. 62U63

2/14/2023 3:08:02 PM

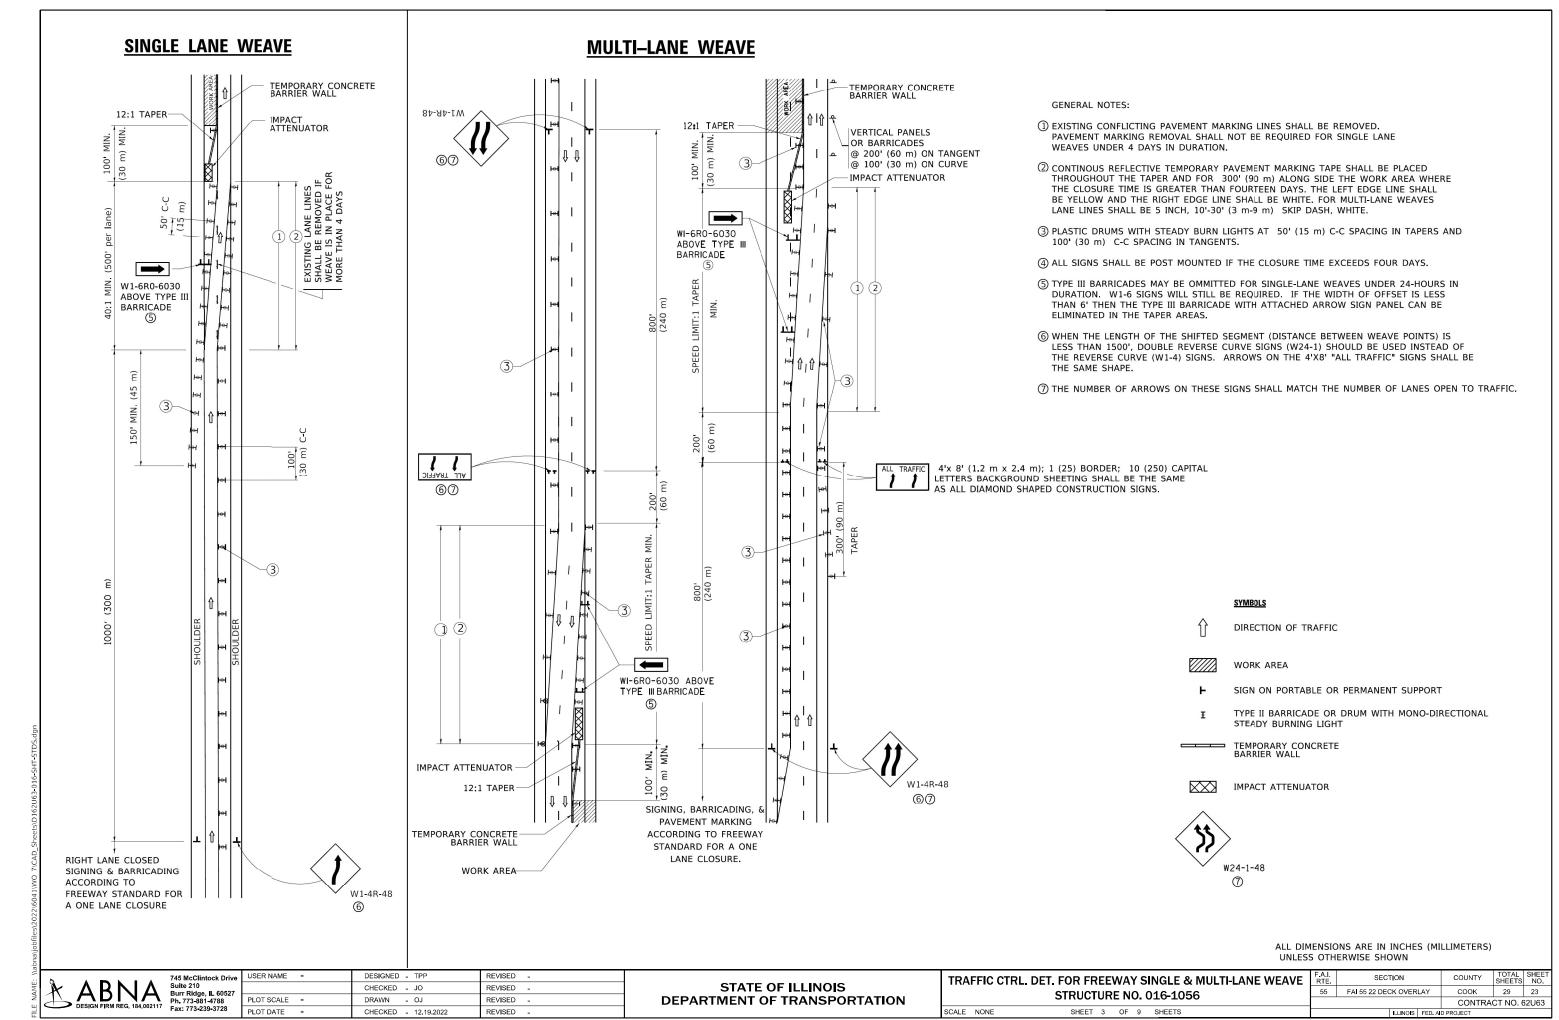

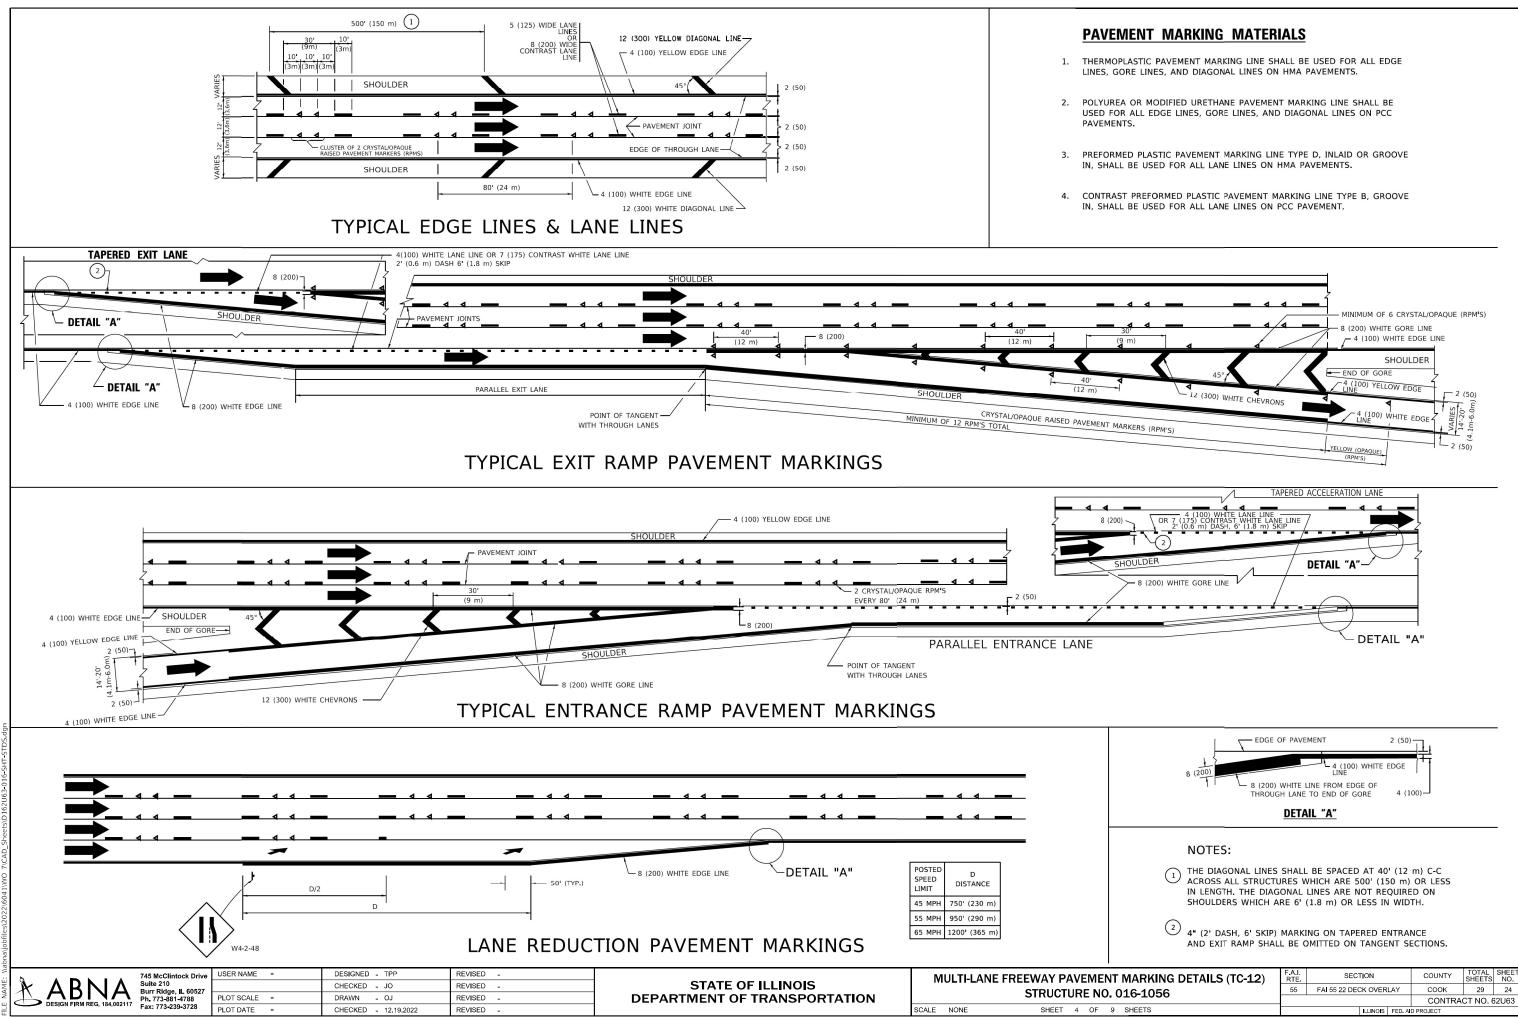

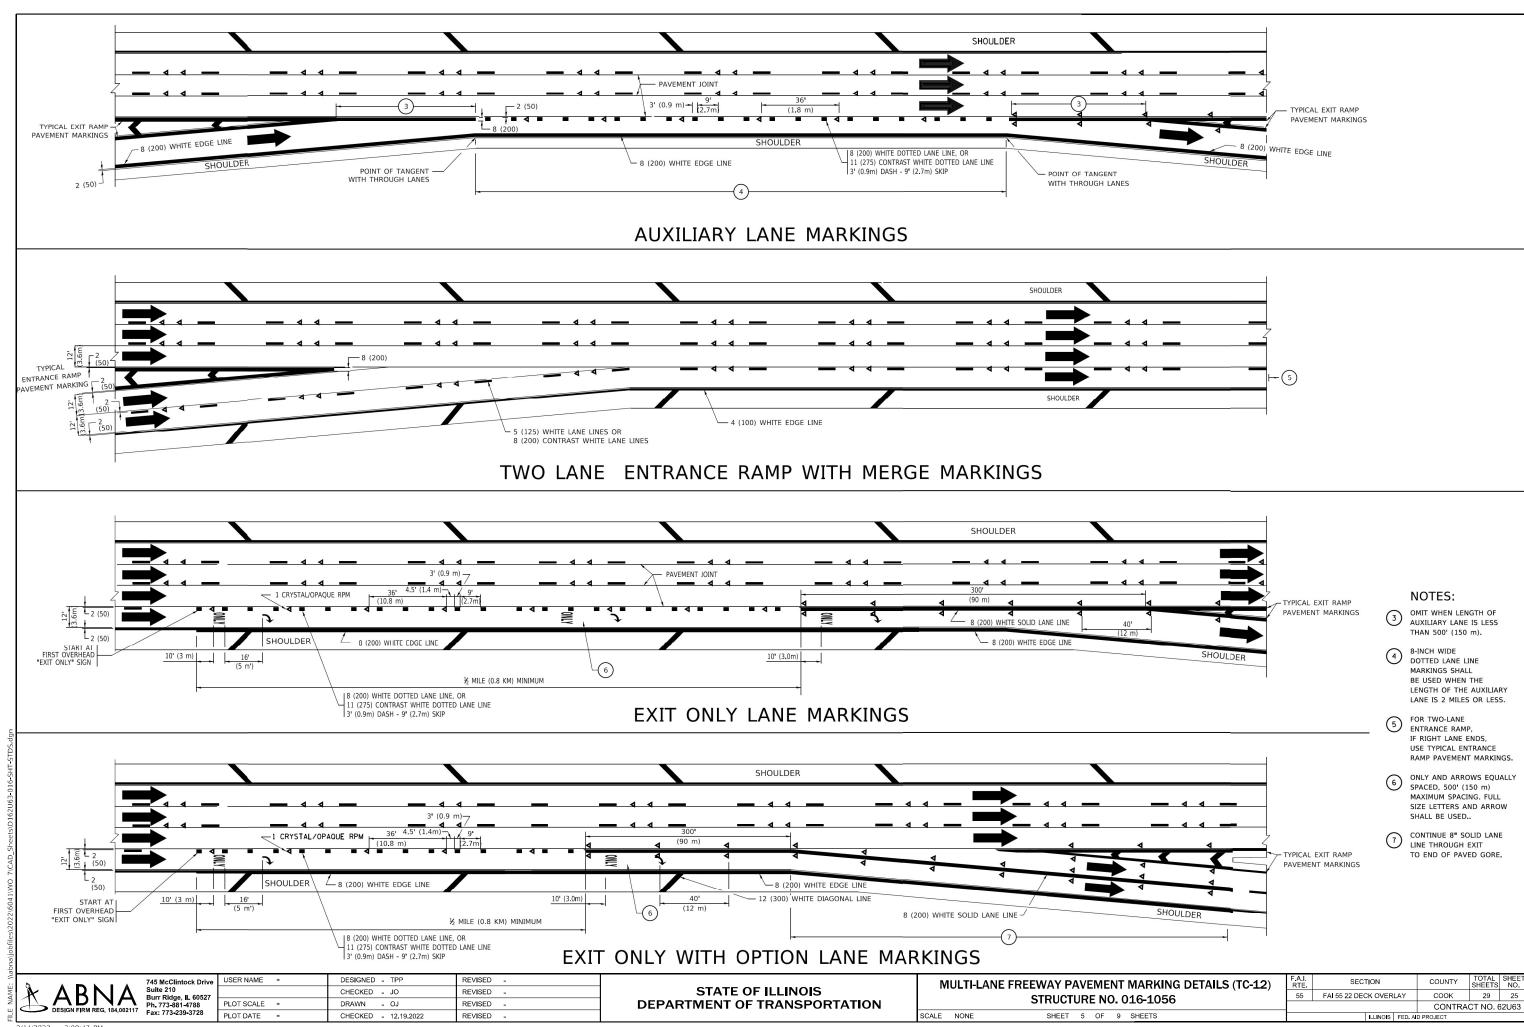

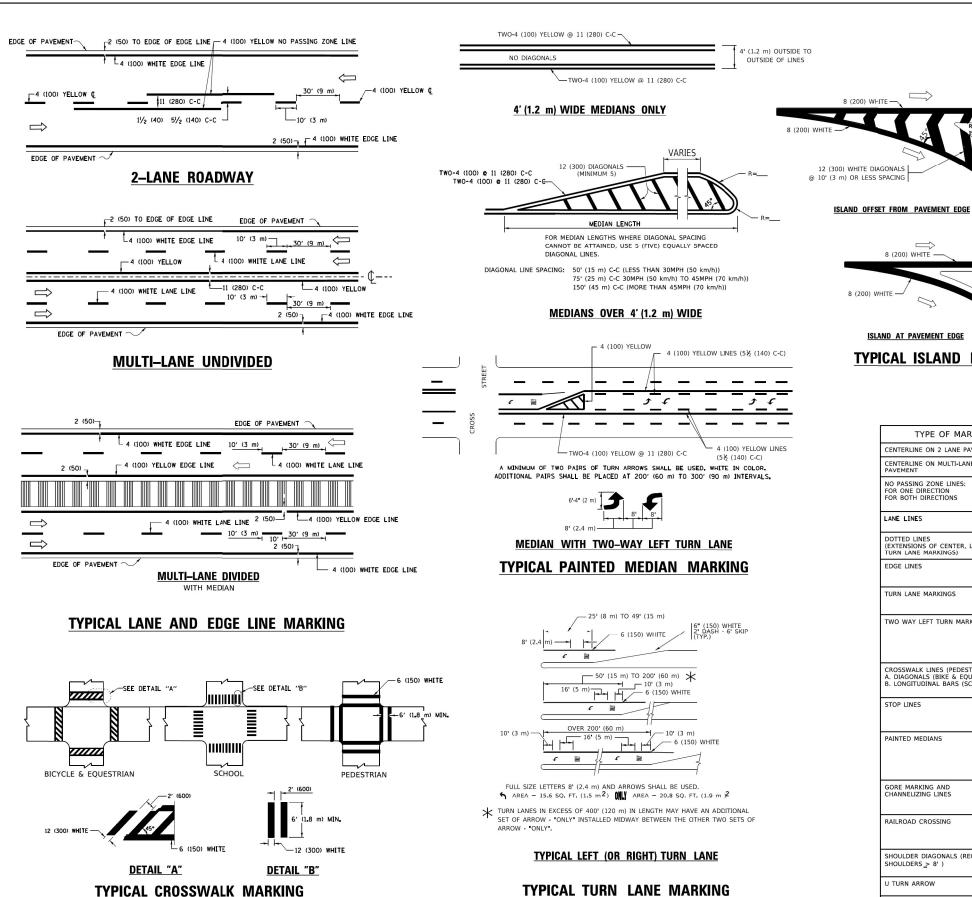

2 ARROW COMBINATION LEFT AND U TURN FOR FURTHER DETAILS ON PAVEMENT MARKING REFER TO STANDARD SPECIFICATIONS FOR ROAD AND BRIDGE CONSTRUCTION AND STATE STANDARD 780001.

8 (200) WHITE -

8 (200) WHITE -

ISLAND AT PAVEMENT EDGE

TYPICAL ISLAND MARKING

TYPE OF MARKING

CENTERLINE ON MULTI-LANE UNDIVIDED PAVEMENT

CENTERLINE ON 2 LANE PAVEMENT

DOTTED LINES (EXTENSIONS OF CENTER, LANE OR TURN LANE MARKINGS)

NO PASSING ZONE LINES:

FOR ONE DIRECTION FOR BOTH DIRECTIONS

TURN LANE MARKINGS

TWO WAY LEFT TURN MARKING

CROSSWALK LINES (PEDESTRIAN) A. DIAGONALS (BIKE & EQUESTRIAN) B. LONGITUDINAL BARS (SCHOOL)

LANE LINES

EDGE LINES

STOP LINES

PAINTED MEDIANS

GORE MARKING AND

RAILROAD CROSSING

SHOULDERS > 8')

SHOULDER DIAGONALS (REQUIRED FOR

All dimensions are in inches (millimeters) unless otherwise shown.

DIAGONALS: 15' (4.5 m) C-C (LESS THAN 30MPH (50 km/h)) 20' (6 m) C-C 30MPH (50 km/h) TO 45MPH (70 km/h)) 30' (9 m) C-C (OVER 45MPH (70 km/h))

50' (15 m) C-C (LESS THAN 30MPH (50 km/h)) 75' (25 m) C-C (30 MPH (50 km/h) TO 45MPH (70 km/h)) 150' (45 m) C-C (OVER 45MPH (70 km/h))

D(FT)

425

500

580

665

750

LANE REDUCTION TRANSITION * LANE REDUCTION ARROWS REQUIRED AT SPEEDS OF 45 MPH OR

GREATER OR WHEN SPECIFIED IN PLANS.

10' (3 m) LINE WITH 30' (9 m) SPACE

5½ (140) C-C FROM SKIP-DASH CENTERLINE 11 (280) C-C OMIT SKIP-DASH CENTERLINE BETWEEN

10' (3 m) LINE WITH 30' (9 m) SPACE

2' (600) LINE WITH 6' (1.8 m) SPACE

SEE TYPICAL TURN LANE MARKING DETAIL

10' (3 m) LINE WITH 30' (9 m) SPACE FOR SKIP-DASH; 5½ (140) C-C BETWEEN SOLID LINE AND SKIP-DASH LINE SEE TYPICAL TWO-WAY LEFT TURN MARKING DETAIL

NOT LESS THAN 6' (1.8 m) APART 2' (600) APART 2' (500) APART SEE TYPICAL CROSSWALK MARKING DETAILS.

PLACE 4' (1.2 m) IN ADVANCE OF AND PARALLEL TO CROSSWALK, IF PRESENT. OTHERWISE, PLACE AT DESIRED STOPPING POINT. PARALLEL TO CROSSROAD CENTERLINE, WHERE POCSTRI F.

11 (280) C-C FOR THE DOUBLE LINE SEE TYPICAL PAINTED MEDIAN MARKING.

SEE STATE STANDARD 780001

16.3 SF

AREA OF:
"R"=3.6 SQ. FT. (0.33 m)² EACH
"X"=54.0 SQ. FT. (5.0 m)²

OUTLINE MEDIANS IN YELLOW

11 (280) C-C

SPACING / REMARKS

SPEED LIMIT

40

45

50

55

745 McClintock Driv Suite 210
Burr Ridge, IL 60527
Ph. 773-881-4788
Fax: 773-239-3728

THE ROAD WHICH IT CROSSES

TYPICAL CROSSWALK MARKING

MARKINGS SHALL BE INSTALLED PARALLEL TO THE CENTERLINE OF

USER NAME DESIGNED - TPF REVISED CHECKED - JO REVISED REVISED PLOT DATE = CHECKED - 12.19.2022 REVISED

STATE OF ILLINOIS DEPARTMENT OF TRANSPORTATION

SECTION COUNTY 55 FAI 55 22 DECK OVERLAY COOK 29 26 **STRUCTURE NO. 016-1056** CONTRACT NO. 62U63

DISTRICT ONE TYPICAL PAVEMENT MARKINGS (TC-13) SHEET 6 OF 9 SHEETS SCALE NONE

COMBINATION

LEFT AND U-TURN

√ 32 R (810)

U-TURN

YELLOW

YELLOW

YELLOW YELLOW

YELLOW-LEFT

WHITE

YELLOW

YELLOW: TWO WAY TRAFFIC

ONE WAY TRAFFIC

WHITE

WHITE

WHITE

WHITE

WHITE - RIGHT YELLOW - LEFT

COLOR

PATTERN

SKIP-DASH

SOLID

SOLID

SOLID

SOLID

SOLID SOLID SOLID

SOLID

SOLID

SOLID

SOLID

SOLID

SOLID

SOLID

SKIP-DASH

ND SOLID N PAIRS

SKIP-DASH SKIP**-**DASH

- 2 (50)

20 (510

WIDTH OF LINE

(100) (125) ON FREEWAYS

SAME AS LINE BEING EXTENDED

6 (150) LINE; FULL SIZE LETTERS &

2 @ 4 (100) EACH DIRECTION

2 @ 6 (150) 12 (300) @ 45° 12 (300) @ 90°

24 (600)

SYMBOLS (8' (2.4m)

8' (2.4m) LEFT ARROW

2 @ 4 (100) WITH 12 (300) DIAGONALS @ 45°

NO DIAGONALS USED FO 4' (1.2 m) WIDE MEDIAN

8 (200) WITH 12 (300) DIAGONALS @ 45°

24 (600) TRANSVERSE LINES; "RR" IS 6' (1.8 m) LETTERS; 16 (400) LINE FOR "X"

12 (300) @ 45°

SEE DETAIL

SEE DETAIL


4 (100)

2 @ 4 (100)

4 (100) 2 @ 4 (100)

4 (100)

ISLAND

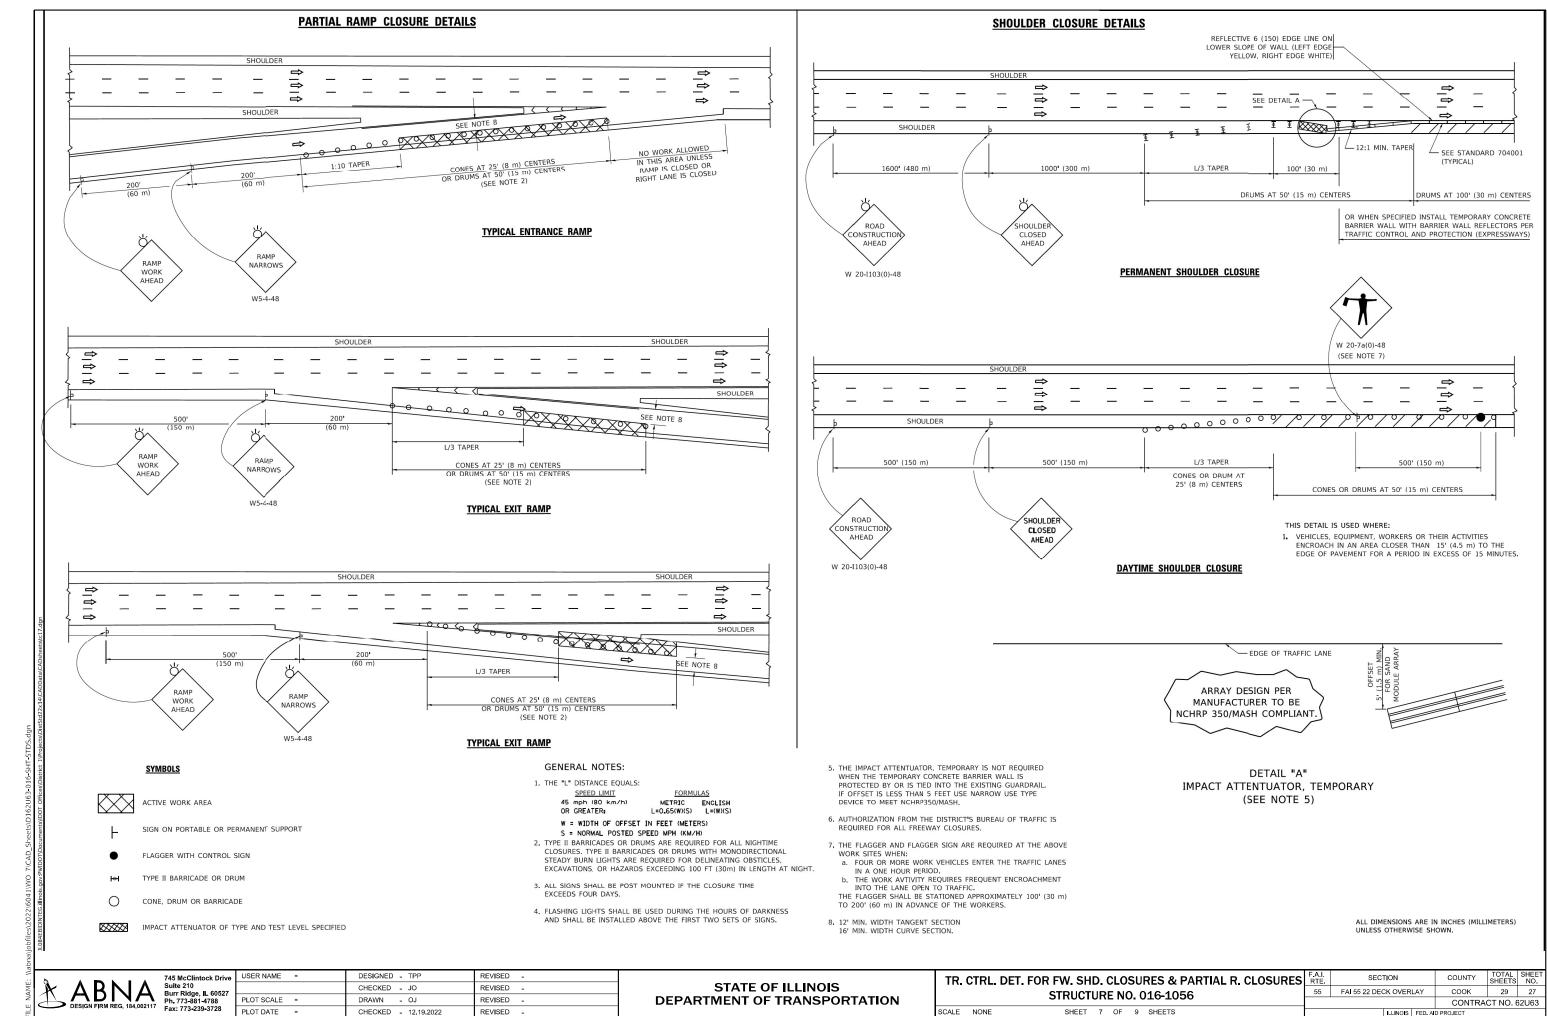

2/14/2023 3:09:18 PM

