FOR INDEX OF SHEETS, SEE SHEET NO. 2

THIS IMPROVEMENT IS LOCATED IN THE CITY OF WHEATON

POSTED AND DESIGN SPEED LIMIT = 40 MPH

TRAFFIC DATA:

AADT (2021) = 21,200 VPD

ADT (2021) = 24,900 VPD

IL ROUTE 38

0

0

0

0


STATE OF ILLINOIS

DEPARTMENT OF TRANSPORTATION

PROPOSED HIGHWAY PLANS

F.A.P. ROUTE 347 IL 38 (ROOSEVELT ROAD) **OVER WINFIELD CREEK** SECTION FAP 0347 22 BJ2 PROJECT NHPP-9PWJ(433) **BRIDGE DECK OVERLAY & JOINT REPAIR DUPAGE COUNTY**

C-91-301-22

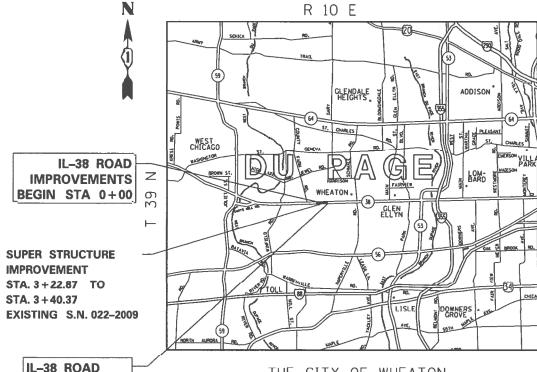

THE CITY OF WHEATON MILTON TOWNSHIP & WINFIELD TOWNSHIP

LOCATION MAP

NOT TO SCALE

GROSS LENGTH = 700.00 FT. = 0.1326 MILE NET LENGTH = 700.00 FT. = 0.1326 MILE



3/17/2023

Kendy Estimable Illinois Registered Engineer No. 062-071404 Registration Expires Nov. 30, 2023




FAP 0347 22 BJ2 DUPAGE 39 1 CONTRACT NO. 62T16

D-91-248-22

LOCATION OF SECTION INDICATED THUS: -

STATE OF ILLINOIS DEPARTMENT OF TRANSPORTATION SUBMITTED MARCH 20 20 23 May 12, 2023

PRINTED BY THE AUTHORITY OF THE STATE OF ILLINOIS

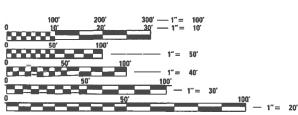

ENGINEERING SCALES. REDUCED SIZED PLANS WILL NOT CONFORM TO STANDARD SCALES, IN MAKING MEASUREMENTS ON REDUCED PLANS, THE ABOVE SCALES MAY BE USED.

JOINT UTILITY LOCATION INFORMATION FOR EXCAVATORS 1-800-892-0123 OR 811

PROJECT ENGINEER: DANIEL WILGREEN (847) 705-4240 PROJECT MANAGER: FAWAD AQUEEL

IMPROVEMENTS

END STA 6+00

CONTRACT NO. 62T16

INDEX OF SHEETS

- INDEX, HIGHWAY STANDARDS & GENERAL NOTES
- SUMMARY OF QUANTITIES
- SCHEDULE OF QUANTITIES TYPICAL SECTIONS
- ALIGNMENT, BENCHMARKS AND TIES
- REMOVAL AND EROSION CONTROL PLAN
- ROADWAY PLAN AND PROFILE
- TRAFFIC CONTROL GENERAL NOTES/SEQUENCE OF CONSTRUCTION
- 1.4 TRAFFIC CONTROL TYPICAL SECTIONS
- TRAFFIC CONTROL PLAN 15-18
- PAVEMENT MARKING PLANS
- 20-30 STRUCTURAL PLANS 31
- PAVEMENT TRANSITION DETAILS
- BUTT JOINT AND HMA TAPER DETAILS (BD-32)
- TRAFFIC CONTROL AND PROTECTION FOR SIDE ROADS, INTERSECTIONS AND DRIVEWAYS (TC-10)
- TYPICAL APPLICATIONS RAISED REFLECTIVE PAVEMENT MARKERS (SNOW-PLOW RESISTANT) (TC-11)
- DISTRICT ONE TYPICAL PAVEMENT MARKINGS (TC-13)
- TRAFFIC CONTROL AND PROTECTION AT TURN BAYS (TC-14) SHORT TERM PAVEMENT MARKING LETTER AND SYMBOL (TC-16)
- ARTERIAL ROAD INFORMATION SIGN (TC-22)
- DRIVEWAY ENTRANCE SIGNING (TC-26)

HIGHWAY STANDARDS

000001-08	STANDARD	SYMBOLS	ABBREVIATIONS	AND	PATTERNS	

- DECIMAL OF AN INCH AND OF A FOOT
- 442201-03 CLASS C AND D PATCHES
- HMA SHLD, STRIPS/SHLDS. WITH RESURFACING OR WIDENING AND RESURFACING PROJECTS
- 515001-04 NAME PLATE FOR BRIDGES
- 630001-12 STEEL PLATE BEAM GUARDRAIL
- SHOULDER WIDENING FOR TYPE 1 (SPECIAL) GUARDRAIL TERMINALS 630301-09
- TRAFFIC BARRIER TERMINAL, TYPE 2 631011-10
- OFF-ROAD OPERATIONS, MULTILANE, 15" TO 24" FROM PAVEMENT EDGE 701101-05
- 701427-05 LANE CLOSURE, MULTILANE INTERMITTENT OR MOVING OPER., FOR SPEED ≤ 40 MPH
- 701606-10 URBAN LANE CLOSURE, MULTILANE 2W WITH MOUNTABLE MEDIAN
- 701701-10 URBAN LANE CLOSURE, MULTILANE INTERSECTION 701901-08 TRAFFIC CONTROL DEVICES
- TEMPORARY CONCRETE BARRIER 704001-08
- OBJECT AND TERMINAL MARKERS 725001-01
- 780001-05 TYPICAL PAVEMENT MARKINGS
- 782006-01 GUARDRAIL AND BARRIER BARRIER WALL REFLECTOR MOUNTING DETAILS

GENERAL NOTES

- THE CONTRACTOR SHALL CALL "J.U.L.I.E" AT (800) 892-0123 OR 811 AT LEAST 48 HOURS PRIOR TO EXCAVATION TO DETERMINE WHICH BURIED ELECTRIC, TELEPHONE, AND GAS UTILITIES ARE IN THE AREA.
- 2. THE CONTRACTOR SHALL COORDINATE CONSTRUCTION ACTIVITIES WITH AFFECTED UTILITY COMPANIES THE CITY OF WHEATON.
- 3. THE CONTRACTOR SHALL NOT SET UP A YARD OR FIELD OFFICE ON STATE PROPERTY WITHOUT WRITTEN PERMISSION FROM THE DEPARTMENT
- 4. THE CONTRACTOR SHALL CONTRACT THE DISTRICT ONE TRAFFIC CONTROL SUPERVISOR KALPANA KANNAN-HOSADURGA, AT KALPANA.KANNAN-HOSADURGA@ILLINOIS.GOV A MINIMUM OF 72 HOURS IN ADVANCE OF BEGINNING ANY WORK.
- 5. THE ENGINEER SHALL CONTACT THE WALTER CZARNY TRAFFIC FIELD AREA ENGINEER VIA EMAIL, AT WALTER CZARNY@ILLINOIS.GOV A MINIMUM OF TWO (2) WEEKS PRIOR TO THE PLACEMENT OF PAVEMENT MARKINGS.
 - DO NOT SCALE PLANS FOR CONSTRUCTION DIMENSIONS.
- WHEN MILLED PAVEMENT IS OPEN TO TRAFFIC, THE MAXIMUM GRADE DIFFERENTIAL BETWEEN PASSES OF THE MILLING MACHINE SHALL NOT EXCEED $1\frac{1}{2}$ INCHES. A MAXIMUM GRADE DIFFERENTIAL OF 3 INCHES MAY BE ALLOWED IF THE EDGE OF THE MILLING IS SLOPED AT A MINIMUM OF 1:3 (V:H).
- THE CONTRACTOR SHALL USE CARE NEAR ANY AND ALL EXISTING ITEMS THAT WILL NOT BE REMOVED. ANY DAMAGE DONE TO EXISTING ITEMS BY THE CONTRACTOR SHALL BE REPAIRED OR REPLACED TO THE SATISFACTION OF THE ENGINEER AT THE CONTRACTOR'S OWN EXPENSE.
- THE CONTRACTOR SHALL BE REQUIRED TO PROVIDE ACCESS TO ABUTTING PROPERTIES AT ALL TIMES DURING 9. THE CONSTRUCTION OF THE PROJECT.
- THE LOCATION OF THE EXISTING DRAINAGE STRUCTURES, STORM SEWERS, WATER MANS, SANITARY SEWERS, 10. AND ANY OTHER PUBLIC OR PRIVATE UTILITIES SHOWN ON THE PLANS IS APPROXIMATE AND THEIR EXACT LOCATION IS TO BE DETERMINED IN THE FIELD BY THE CONTRACTOR.
- 11. THE CONTRACTOR SHALL BE RESPONSIBLE FOR THE PROTECTION OF ALL UNDERGROUND AND SURFACE UTILITIES EVEN THOUGH THEY MIGHT BE SHOWN IN THE PLANS. ANY UTILITY PROPERTY DAMAGED DURING CONSTRUCTION SHALL BE REPAIRED OR REPLACED TO THE SATISFACTION OF THE ENGINEER
- 12. ANY LOOSE MATERIAL DEPOSITED IN THE FLOW LINE OF DRAINAGE STRUCTURES WHICH OBSTRUCTS THE NATURAL FLOW OF WATER SHALL BE REMOVED AT THE CLOSE OF EACH WORKING DAY. PRIOR TO ACCEPTANCE OF THE IMPROVEMENT, ALL DRAINAGE STRUCTURES SHALL BE FREE OF DIRT AND DEBRIS. THIS WORK WILL NOT BE PAID FOR SEPARATELY, BUT SHALL BE CONSIDERED AS INCLUDED IN THE UNIT BID
- 13. IT SHALL BE THE CONTRACTORS RESPONSIBILITY TO VERIFY ALL DIMENSIONS AND CONDITIONS EXISTING IN THE FIELD PRIOR TO CONSTRUCTION AND ORDERING MATERIALS.
- 14. ALL PAVEMENT MARKINGS SHALL BE PLACED THROUGHOUT THE IMPROVEMENT ACCORDING TO THE DISTRICT
- 15. ALL DAMAGE TO EXISTING PAVEMENT MARKINGS OR RAISED REFLECTIVE PAVEMENT MARKERS OUTSIDE THE REMOVAL LINE SHOWN ON THE PLANS SHALL BE REPLACED AT NO ADDITIONAL COST TO THE DEPARTMENT
- 16. ANY REFERENCE TO A STANDARD IN THESE PLANS SHALL BE INTERPRETED TO MEAN THE EDITION AS INDICATED BY THE SUB NUMBER SHOWN IN THE LIST OF STANDARDS OR THE COPY INCLUDED IN THESE
- 17. THE SUBGRADE STABILITY SHALL BE VERIFIED BY PROOF ROLLING WITH A FULL LOADED TANDEM AXLE
- 18. ANY AGGREGATE SUBGRADE IMPROVEMENT CONTAMINATED AND/OR DAMAGED BY THE CONTRACTORS VEHICLES AND/OR EQUIPMENT IS TO BE REMOVED AND REPLACED AS DIRECTED BY THE ENGINEER AT THE
- 19 THE CONTRACTOR MUST VERIEY THE EXISTING SUBBASE AND PAVEMENT DEPTH IF APPLICABLE
- 20. THE THICKNESS OF HMA SHOWN ON THE PLANS IS THE NOMINAL THICKNESS. DEVIATIONS FROM THE NOMINAL THICKNESS WILL BE PERMITTED WHEN SUCH DEVIATIONS OCCUR DUE TO IRREGULARITIES IN THE EXISTING SURFACE OR BASE ON WHICH THE HMA IS PLACED.
- 21. BEFORE BEGINNING ANY WORK, THE CONTRACTOR SHALL RETAIN AND RECORD FOR FUTURE REFERENCE, ALL EXISTING PAVEMENT MARKING LINES AND RAISED REFLECTIVE PAVEMENT MARKERS THAT CONFLICT WITH TEMPORARY MARKINGS. IN ORDER THAT THESE LOCATIONS CAN BE RE-ESTABLISHED FOR PROPOSED STRIPING AT THE COMPLETION OF THIS CONTRACT. EXACT LOCATIONS OF ALL PROPOSED PAVEMENT MARKINGS SHALL BE DIRECTED BY THE RESIDENT ENGINEER.
- 22. THE AGGREGATE GRADATION FOR THE AGGREGATE SUBGRADE IMPROVEMENT 12" LOWER LIFT SHALL BE CS 1
- 23. GEOTECHNICAL FABRIC FOR GROUND STABILIZATION AND/OR AGGREGATE SUBGRADE IMPROVEMENT (CU YD)
 HAVE BEEN PROVIDED FOR USE AT THE LOCATIONS INDICATED FOR SOILS THAT TEND TO BE UNSTABLE
 AND/OR UNSUITABLE. THE ACTUAL NEED FOR REMOVAL AND REPLACEMENT WITH ABOVE ITEM WILL BE DETERMINED IN THE FIELD AT THE TIME OF CONSTRUCTION BY THE GEOTECHNICAL ENGINEER. ALL POTENTIALLY UNSTABLE SOILS SHOULD BE TESTED WITH A STATIC OR DYNAMIC CONE PENETROMETER AND TREATED IN ACCORDANCE WITH ARTICLE 301.04 OF THE SSRBC AND IDOT SUBGRADE STABILITY MANUAL. IF UNSTABLE AND/OR UNSUITABLE SOILS ARE NOT ENCOUNTERED, THEN THE QUANTITY SHALL BE DEDUCTED AND NO ADDITIONAL COMPENSATION WILL BE DUE TO THE CONTRACTOR.
- 24. THE CONTRACTOR'S ATTENTION IS CALLED TO THE FACT THAT THE PRESERVATION OF EXISTING TREES IS OF UTMOST IMPORTANCE TO THE VILLAGE OF WHEATON. EXISTING VEGETATED AREAS (TREES, SHRUBS, VEGETATIVE BUFFERS, TURF AREAS, ETC.) WHERE DISTURBANCE IS NOT OCCURRING (INCLUDING AREAS OUTSIDE THE PROJECT LIMITS) SHALL NOT BE DISTURBED TO ENSURE THAT EXISTING VEGETATION IS PRESERVED TO MINIMIZE SOIL EROSION AND TO ELIMINATE SOIL COMPACTION. NO MATERIALS ARE TO BE STORED OR VEHICLES DRIVEN OR PARKED WITHIN THESE UNDISTURBED AREAS AT ANY TIME
- 25. PHOSPHORUS FERTILIZER HAS BEEN INTENTIONALLY OMITTED FROM THE CONTRACT DUE TO THE PROXIMITY TO THE EXISTING CREEK. A PHOSPHORUS-FREE FERTILIZER SHALL BE USED (MIDDLE NUMBER SHOULD EQUAL 0).

SCALE: NONE



USER NAME = \$USER\$	DESIGNED - KE	REVISED -
	DRAWN - KE	REVISED -
PLOT SCALE = \$SCALE\$	CHECKED - TC	REVISED -
PLOT DATE = \$DATE\$	DATE - 03/22/2023	REVISED -

STATE OF ILLINOIS **DEPARTMENT OF TRANSPORTATION**

	IL 3	38 OVER	WINFIE	D CREE	K	F.A.P. RTE	
ın	EX HIGHW	ΔΥ SΤΔ	NDARDS	& GFN	ERAL NOTES	347	
	LX, IIIGIIVV	A1 01A	INDAILDO	G GLIV	EIIAE NOTES		
	SHEET	OF	SHEETS	STA.	TO STA.		

					CONSTRUC	TION CODE	
				NHPP	NHPP		
				80% FED	80% FED		
				20% STATE	20% STATE		
CODE			TOTAL	ROADWAY	BR IDGE		
NO.	ITEM	UNIT	QUANTITY	0005	0047		
				URBAN	5.N.022-2009		
20200100	EARTH EXCAVATION	CU YD	98	98	0		
21001000	GEOTECHNICAL FABRIC FOR GROUND STABILIZATION	SQ YD	694	694	0		
21101615	TOPSOIL FURNISH AND PLACE, 4"	SQ YD	38	38	0		
25000210	SEEDING, CLASS 2A	ACRE	0.25	0.25	0		
25000400	NITROGEN FERTILIZER NUTRIENT	POUND	23	23	0		
25000600	POTASSIUM FERTILIZER NUTRIENT	POUND	23	23	0		
25100630	EROSION CONTROL BLANKET	SQ YD	38	38	0		
28000305	TEMPORARY DITCH CHECKS	FOOT	300	300	0		
28000400	PERIMETER EROSION BARRIER	FOOT	542	542	0		
28000500	INLET AND PIPE PROTECTION	EACH	4	4	0		
28000510	INLET FILTERS	EACH	2	2	0		
35101800	AGGREGATE BASE COURSE, TYPE B 6"	SQ YD	53	53	0		
35501308	HOT-MIX ASPHALT BASE COURSE, 6"	SQ YD	53	53	0		
35501329	HOT-MIX ASPHALT BASE COURSE, 11 1/4"	SQ YD	52	52	0		

*SPECIALTY	ITEM

CODE

40600290 BITUMINOUS MATERIALS (TACK COAT) POUND 3,312 3,312 0 40600982 HOT-MIX ASPHALT SURFACE REMOVAL - BUTT JOINT SQ YD 400 400 40603085 HOT-MIX ASPHALT BINDER COURSE, IL-19.0, N70 TON 90 90 0 40604060 HOT-MIX ASPHALT SURFACE COURSE, IL-9.5, MIX "D", N50 TON 5.9 5.9 40604062 HOT-MIX ASPHALT SURFACE COURSE, IL-9.5, MIX "D", N70 TON 60 60 0 44000100 PAVEMENT REMOVAL SQ YD 173 48102100 AGGREGATE WEDGE SHOULDER, TYPE B TON 4 4 0 48203029 HOT-MIX ASPHALT SHOULDERS, 8" SQ YD 172 172 50300225 | CONCRETE STRUCTURES CU YD 48 0 48 50300260 BRIDGE DECK GROOVING SQ YD 0 659 SQ YD 659 50300300 PROTECTIVE COAT 0 659 50301350 | CONCRETE SUPERSTRUCTURE (APPROACH SLAB) CU YD 213 0 213 50800205 REINFORCEMENT BARS, EPOXY COATED POUND 72,091 0 72,091 * 50901050 STEEL RAILING, TYPE SM FOOT 1**5**5 155 0

ITEM

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*SPECIALTY ITEM

 USER NAME
 = \$USER\$
 DESIGNED
 - KE
 REVISED

 DRAWN
 - KE
 REVISED

 PLOT SCALE
 = \$SCALE\$
 CHECKED
 - TC
 REVISED

 PLOT DATE
 = \$DATE
 - 03/22/2023
 REVISED

STATE OF ILLINOIS
DEPARTMENT OF TRANSPORTATION

CONSTRUCTION CODE

80% FED

20% STATE

BRIDGE

0047

.N.022-2009

NHPP 80% FED

20% STATE

ROADWAY

0005

URBAN

TOTAL QUANTITY

						CONSTRUCT	TION CODE	
					NHPP	NHPP		
					80% FED	80% FED		
					20% STATE	20% STATE		
					ROADWAY	BRIDGE		
	CODE NO.	ITEM	UNIT	TOTAL QUANTITY	0005	0047		
ļ					URBAN	5.N.022-2009		
*	63000001	STEEL PLATE BEAM GUARDRAIL, TYPE A, 6 FOOT POSTS	FOOT	400	400	0		
*	63100045	TRAFFIC BARRIER TERMINAL, TYPE 2	EACH	2	2	0		
*	63100167	TRAFFIC BARRIER TERMINAL, TYPE 1 (SPECIAL) TANGENT	EACH	1	1	0		
*	63100169	TRAFFIC BARRIER TERMINAL, TYPE 1 (SPECIAL) FLARED	EACH	1	1	0		
	63200310	GUARDRAIL REMOVAL	FOOT	540	540	0		
	66900200	NON-SPECIAL WASTE DISPOSAL	CU YD	98	98	0		
	66900530	SOIL DISPOSAL ANALYSIS	EACH	2	2	0		
ļ								
	66901001	REGULATED SUBSTANCES PRE-CONSTRUCTION PLAN	L SUM	1	1	0		ı
	66901003	REGULATED SUBSTANCES FINAL CONSTRUCTION REPORT	L SUM	1	1	0		İ
	66901006	REGULATED SUBSTANCES MONITORING	CAL DA	11	11	0		
ļ								
	67000400	ENGINEER'S FIELD OFFICE, TYPE A	CAL MO	6	6	0		
	67100100	MOBILIZATION	L SUM	1	1	0		
ļ								
	70300150	SHORT TERM PAVEMENT MARKING REMOVAL	SQ FT	1,964	1,964	0		
	70306120	TEMPORARY PAVEMENT MARKING - LINE 4" - TYPE III TAPE	FOOT	5,456	5,456	0		

					20/0 51/1	2070 STATE	
					ROADWAY	BR I DGE	
	CODE	ITEM	UNIT	TOTAL QUANTITY	0005	0047	
	NO.			QUANTIT	URBAN	5 . N . 022 - 200 9	
						1	
	70307100	TEMPORARY PAVEMENT MARKING LETTERS AND SYMBOLS - TYPE IV TAPE	SQ FT	146	146	0	
	70400100	TEMPORARY CONCRETE BARRIER	FOOT	612.5	612.5	0	
	70400200	RELOCATE TEMPORARY CONCRETE BARRIER	FOOT	600	600	0	
						<u> </u>	
	70600260	IMPACT ATTENUATORS, TEMPORARY (FULLY REDIRECTIVE, NARROW), TEST LEVEL 3	EACH	2	2	0	
		NAMES ATTENUATORS OF GOATS (SULLY DEPOSITING MARROW). TEST LEVEL 2		-			
	70600332	IMPACT ATTENUATORS, RELOCATE (FULLY REDIRECTIVE, NARROW), TEST LEVEL 3	EACH	2	2	0	
	72501000	TERMINAL MARKER - DIRECT APPLIED	EACH	4	4	1	
*	72501000	TENMINAL MARKER - DIRECT APPLIED	EACH	4	4	0	
k	78000100	THERMOPLASTIC PAVEMENT MARKING - LETTERS AND SYMBOLS	SQ FT	42	42	0	
	70000100	THE MINISTER PARTIES PARTIES AND STRIBUTES	3011	72	72		
k	78000200	THERMOPLASTIC PAVEMENT MARKING - LINE 4"	FOOT	2,438	2,438	0	
	70000200		1	2,		1	
k	78000400	THERMOPLASTIC PAVEMENT MARKING - LINE 6"	FOOT	482	482	0	
k	78000600	THERMOPLASTIC PAVEMENT MARKING - LINE 12"	FOOT	38	38	0	
k	78000650	THERMOPLASTIC PAVEMENT MARKING - LINE 24"	FOOT	50	50	0	
k	78009004	MODIFIED URETHANE PAVEMENT MARKING - LINE 4"	FOOT	1,008	1,008	0	
k	78009006	MODIFIED URETHANE PAVEMENT MARKING - LINE 6"	FOOT	78	78	0	
k	78009012	MODIFIED URETHANE PAVEMENT MARKING - LINE 12"	FOOT	28	28	0	

*SPECIALTY ITEM

wsp

USER NAME = \$USER\$	DESIGNED - KE	REVISED -
	DRAWN - KE	REVISED -
PLOT SCALE = \$SCALE\$	CHECKED - TC	REVISED -
PLOT DATE = \$DATE\$	DATE - 03/22/2023	REVISED -

STATE OF ILLINOIS DEPARTMENT OF TRANSPORTATION

		II.	L 38 OVER V	VINFIE	LD CREEK		F.A.P. RTE.	SECTION	COUNTY	TOTAL SHEETS	
SUMMARY OF QUANTITIES					347	FAP 0347 22 BJ2	DUPAGE	39	4		
			JUMMAIII		ANTITIES		_		CONTRACT	NO. 62	2T16
SCALE:	NONE	SHEET	OF	SHEETS	STA.	TO STA.		ILLINOIS FED. A	ID PROJECT		

CONSTRUCTION CODE

80% FED

20% STATE

NHPP

80% FED

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USER NAME = \$USER\$	DESIGNED - KE	REVISED -
	DRAWN - KE	REVISED -
PLOT SCALE = \$SCALE\$	CHECKED - TC	REVISED -
PLOT DATE = \$DATE\$	DATE - 03/22/2023	REVISED -

STATE OF ILLINOIS DEPARTMENT OF TRANSPORTATION

			IL 38 OVER SUMMARY			
SCALE:	NONE	SHEET	OF	SHEETS	STA.	TO STA.

| F.A.P. | SECTION | COUNTY | TOTAL SHEET | SH

*SPECIALTY ITEM	*SPECIALTY ITEM
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				CONSTRUCTION CODE			
					NHPP		
				80% FED	80% FED		
				20% STATE	20% STATE		
CODE			TOTAL	ROADWAY	BRIDGE		
NO.	ITEM	UNIT	QUANTITY	0005	0047		
				URBAN	5.N.022-2009		
78100100	RAISED REFLECTIVE PAVEMENT MARKER	EACH	61	61	0		
78200005	GUARDRAIL REFLECTORS, TYPE A	EACH	9	9	0		
78200011	BARRIER WALL REFLECTORS, TYPE C	EACH	51	51	0		
78300200	RAISED REFLECTIVE PAVEMENT MARKER REMOVAL	EACH	61	61	0		
X2020110	GRADING AND SHAPING SHOULDERS	UNIT	2	2	0		
X4401198	HOT-MIX ASPHALT SURFACE REMOVAL, VARIABLE DEPTH	SQ YD	345	345	0		
X7010216	TRAFFIC CONTROL AND PROTECTION, (SPECIAL)	L SUM	1	1	0		
Z0004552	APPROACH SLAB REMOVAL	SQ YD	340	0	340		
Z0006014	BRIDGE DECK LATEX CONCRETE OVERLAY, 2 1/2 INCHES	SQ YD	149	0	149		
Z0012130	BRIDGE DECK SCARIFICATION 3/4"	SQ YD	149	0	149		
Z0012754	STRUCTURAL REPAIR OF CONCRETE (DEPTH EQUAL TO OR LESS THAN 5 INCHES)	SQ FT	18	0	18		
Z0013798	CONSTRUCTION LAYOUT	L SUM	1	1	0		
Z0016002	DECK SLAB REPAIR (FULL DEPTH, TYPE II)	SQ YD	36	0	36		
Z0016200	DECK SLAB REPAIR (PARTIAL)	SQ YD	10	0	10		

	r			CONCEDUCATION CODE			
				CONSTRUCTION CODE			
				NHPP	NHPP		
				80% FED	80% FED		
				20% STATE	20% STATE		
				ROADWAY	BRIDGE		
CODE NO.	ITEM	UNIT	TOTAL QUANTITY	0005	0047		
10.			QUANTITY	URBAN	5.N.022-2009		
70070050	TEMPORARY INFORMATION SIGNING	SQ FT	51.4	51.4	0		
Z0030850	TEMPORART INFORMATION SIGNING	3Q F1	51,4	31,4	U U		
Z0073500	TEMPORARY SUPPORT SYSTEM	L SUM	1	0	1		
Z0076600	TRAINEES	HOURS	500	500			
Z0076604	TRAINEES - TRAINING PROGRAM GRADUATE	HOURS	500	500			
20070001							
	<u> </u>						
	1						
	1						
		j					
1							

	21101615						
TOPSOIL FURNISH AND PLACE, 4"							
ALIGNMENT	STATION FROM	OFFSET	STATION TO	OFFSET	SQ YD		
IL-38 ROAD	3+40.86	39.26,RT	4+47.37	39.00,RT	38		
				TOTAL	38		

25000210						
SEEDING, CLASS 2A						
ALIGNMENT	STATION FROM	OFFSET	STATION TO	OFFSET	ACRE	
IL-38 ROAD	3+40.86	39.26,RT	4+47.37	39.00,RT	0.25	
				TOTAL	0.25	

	25000400						
	NITROGEN FERTILIZER NUTRIENT						
Г	ALIGNMENT	STATION FROM	OFFSET	STATION TO	OFFSET	POUND	
Г	IL-38 ROAD	3+40.86	39.26,RT	4+47.37	39.00,RT	23	
Ξ					TOTAL	23	

25000600						
	POTASSIUM FERTILIZER NUTRIENT					
ALIGNMENT	STATION FROM	OFFSET	STATION TO	OFFSET	POUND	
IL-38 ROAD 3+40.86 39.26,RT 4+47.37 39.00,RT						
			-	TOTAL	23	

25100630							
	EROSION CONTROL BLANKET						
ALIGNMENT	STATION FROM	OFFSET	STATION TO	OFFSET	SQ YD		
IL-38 ROAD	3+40.86	39.26,RT	4+47.37	39.00,RT	38		
				TOTAL	38		

	28000400						
	PERIMETER EROSION BARRIER						
ALIGNMENT	STATION FROM	OFFSET	STATION TO	OFFSET	FOOT		
IL-38 ROAD	1+03,27	42.38,RT	3+16.40	44.00,RT	212		
IL-38 ROAD	2+42,11	45.42,LT	3+20.65	39.68,LT	80		
IL-38 ROAD	3+42.62	39.98,LT	4+05.85	48.42,LT	66		
IL-38 ROAD	4+28.21	45.59,LT	4+52.63	44.09,LT	24		
IL-38 ROAD	3+44,65	42.84,RT	5+04.32	43.39,RT	160		
				TOTAL	542		

28000500						
INLET AND PIPE PROTECTION						
ALIGNMENT	STATION	OFFSET	EACH			
IL-38 ROAD	2+03.35	36.72,LT	1			
IL-38 ROAD	2+96.43	41.46,RT	1			
IL•38 ROAD	4+35.81	39.41,LT	1			
IL-38 ROAD	5+32,36	39,33,RT	1			
		TOTAL	4			

28000510				
INLET FILTERS				
ALIGNMENT	STATION	OFFSET	EACH	
IL-38 ROAD	5+35.65	28.94,RT	1	
IL-38 ROAD	5+33.67	29.71,LT	1	
		TOTAL	2	

	28000305					
TEMPORARY DITCH CHECKS						
ALIGNMENT	STATION	OFFSET	FOOT			
IL•38 ROAD	2+91.11	41.91, RT	100			
IL•38 ROAD	5+36.17	39.26, RT	100			
IL-38 ROAD	4+57.19	37.87, LT	100			
		TOTAL	300			

35501329							
HOT-MIX ASPHALT BASE COURSE, 11 1/4"							
ALIGNMENT	OFFSET	SQ YD					
IL-38 ROAD	2+89.60	38.68,LT	2+92.60	38.56,LT	26		
IL-38 ROAD 3+70.83 43.33,RT 3+73.83 43.39,RT 2							
TOTAL 52							

	40600290								
Г	BITUMINOUS MATERIALS (TACK COAT)								
Г	ALIGNMENT	OFFSET	POND						
Г	IL-38 ROAD	2+56.87	28.00,RT	2+92.60	28.00,RT	1,008			
	IL-38 ROAD	3+70.72	28.00,RT	4+47.37	28.00,RT	2,156			
	IL-38 ROAD	2+56.87	28.00,RT	4+47.37	28.00,RT	148			
					TOTAL	3.312			

40603085							
HOT-MIX ASPHALT BINDER COURSE, IL-19.0, N70							
ALIGNMENT	STATION FROM	OFFSET	STATION TO	OFFSET	TON		
IL-38 ROAD	2+56.87	28.00,RT	2+92.60	28.00,RT	29		
IL-38 ROAD	3+70.72	28.00,RT	4+47.37	28.00,RT	61		
				TOTAL	90		

	40604062							
	HOT-MIX ASPHALT SURFACE COURSE, IL-9.5, MIX "D", N70							
	ALIGNMENT	STATION FROM	OFFSET	STATION TO	OFFSET	TON		
	IL-38 ROAD	2+56.87	28.00,RT	2+92.60	28.00,RT	19		
[IL-38 ROAD	3+70.72	28.00,RT	4+47.37	28.00,RT	41		
					TOTAL	60		

48102100							
AGGREGATE WEDGE SHOULDER, TYPE B							
ALIGNMENT	STATION FROM	OFFSET	STATION TO	OFFSET	TON		
IL-38 ROAD	2+56.87	39.00,LT	2+92.87	39.00,LT	0.7		
IL-38 ROAD	2+56.87	39.00,RT	2+92.50	39.00,RT	0.7		
IL-38 ROAD	3+70,37	39.00,LT	4+02.91	39.00,LT	0.7		
IL-38 ROAD	4+30.18	39.00,LT	4+47.81	39,00,LT	0,3		
IL-38 ROAD	3+70.86	39.00,RT	4+47.37	39.00,RT	1.5		
				TOTAL	4.0		

	48203029						
HOT-MIX ASPHALT SHOULDERS, 8"							
ALIGNMENT	STATION FROM	OFFSET	STATION TO	OFFSET	SQ YD		
IL-38 ROAD	2+56.87	36.00,LT	2+92.87	36.00,LT	33		
IL-38 ROAD	2+56.87	36.00,RT	2+92.50	36.00,RT	32		
IL-38 ROAD	3+70.37	36.00,LT	4+02.91	36,00,LT	26		
IL-38 ROAD	4+30.18	36.00,LT	4+47.81	36,00,LT	12		
IL-38 ROAD	36.00,RT	69					
				TOTAL	172		

63000001							
STEEL PLATE BEAM GUARDRAIL, TYPE A, 6 FOOT POSTS							
ALIGNMENT	STATION FROM	OFFSET	STATION TO	OFFSET	FOOT		
IL-38 ROAD	2+58.23	38.61,LT	3+07.87	38.25,LT	50		
IL - 38 ROAD	3+55.37	38.25,LT	4+03.77	46.46,LT	50		
IL-38 ROAD	1+32.51	36.73,RT	3+07.87	28,00,RT	175		
IL•38 ROAD	3+55,37	38,25,RT	4+80.21	37.42,RT	125		
TOTAL 400							

63100045						
TRAFFIC BARRIER TERMINAL, TYPE 2						
ALIGNMENT STATION FROM OFFSET STATION TO OFFSET E						
IL-38 ROAD	2+47.61	38.68,LT	2+60.11	38.56,LT	1	
IL-38 ROAD 4+91.82 43.33,RT 5+04.32 43.39,RT 1						
				TOTAL	2	

63100169							
TRAFFIC BARRIER TERMINAL, TYPE 1 (SPECIAL) FLARED							
ALIGNMENT	STATION FROM	OFFSET	STATION TO	OFFSET	EACH		
IL-38 ROAD 0+92.57 40.41, RT 1+05.07 38.39, RT 1							
TOTAL 1							

X2020110							
GRADING AND SHAPING SHOULDERS							
ALIGNMENT	STATION FROM	OFFSET	STATION TO	OFFSET	UNIT		
IL-38 ROAD	2+56,87	39.00,LT	2+92,87	39,00,LT	0.36		
IL-38 ROAD	2+56.87	39.00,RT	2+92.50	39.00,RT	0.36		
IL-38 ROAD	3+70.37	39.00,LT	4+02.91	39.00,LT	0.39		
IL-38 ROAD	4+30.18	39.00,LT	4+47.81	39.00,LT	0.17		
IL-38 ROAD 3+70.86 39.00,RT 4+47.37 39.00,RT 0.77							
				TOTAL	2		

DRIVEWAYS									
ALICNMENT	ALIGNMENT STATION FROM OFFSET STATION TO		OFFSET	HOT-MIX ASPHALT SURFACE COURSE, MIX "D", IL-9.5, N50, 2"	HOT•MIX ASPHALT BASE COURSE, 6"	AGGREGATE BASE COURSE, TYPE B, 6"			
ALIGNMENT	STATION FROM	OTTSET	STATION TO	OITSET	40604060	35501308	35101800		
					TON	SQ YD	SQ YD		
IL-38 ROAD	3+96.54	28.00, LT	4+36.53	28.00, LT	6	53	53		
				TOTAL	6	53	53		



USER NAME ■ majid mastali	DESIGNED - MM	REVISED -
	DRAWN - MM	REVISED -
PLOT SCALE = 20,0000 / in	CHECKED - TC	REVISED -
PLOT DATE ■ 3/22/2023	DATE - 03/22/2023	REVISED -

IL 38 OVER WINFIELD C	F.A.P. RTE	SECTION	COUNTY	TOTAL SHEETS	SHEET NO.	
SCHEDULE OF QUANT	347	FAP 0347 22 BJ2	DUPAGE	39	6	
CONEDULE OF COART			CONTRAC	T NO. 62	2T16	
SCALE: NONE SHEET 1 OF 2 SHEETS STA.	TO STA.		ILLINOIS F	ED, AID PROJECT		


LOC	ATION	THERMOPLAS (78000200)	THERMOPLASTIC PAVEMENT MARKING - LINE 4" (78000200)		THERMOPLASTIC PAVEMENT MARKING - LINE 6" (78000400)		LETTERS AND SYMBOLS	THERMOPLASTIC PAVEMENT MARKING - LINE 12" (78000600)	
STA.	STA.	WHITE SOLID EDGE LINE	WHITE SKIP DASH LINE	YELLOW SOLID CENTERLINE	WHITE SOLID EDGE LINE	WHITE DOTTED LINE	(78000100) SQ FT	YELLOW SOLID LINE	
31A.		FOOT	FOOT	FOOT	FOOT	FOOT		FOOT	
0+95	2+92	288	394	486	125	77	21	6	
4+18	7+33	136	630	504	125	155	21	32	
ТО	TAL	424	1024	990	250	232	42	38	

LOCA	ATION MODIFIED URETHANE PAVEMENT MARKING - LINE 4" (78009004)				MODIFIED URETHANE PAVEMENT MARKING - LINE 6" (78009006)	MODIFIED URETHANE PAVEMENT MARKING - LINE 12" (78009012)
STA.	STA.	WHITE SOLID EDGE LINE	WHITE SKIP DASH LINE	YELLOW SOLID CENTERLINE	WHITE DOTTED LINE	YELLOW SOLID LINE
JIA.	SIA.	FOOT	FOOT	FOOT	FOOT	FOOT
2+92	4+18	252	252	504	78	28
TO ⁻	TAL	252	252	504	78	28

111	SP	
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USER NAME ■ majid mastali	DESIGNED - AT	REVISED -
	DRAWN - AT	REVISED -
PLOT SCALE 20,0000 / in	CHECKED - TC	REVISED -
PLOT DATE ■ 3/22/2023	DATE - 03/22/2023	REVISED -

	IL 38 OVER WINFIELD CREEK		F.A.P. RTE	SECTION	COUNTY	TOTAL SHEETS	
	SCHEDULE OF QUANTITIES				DUPAGE	39	7
	SCHEDOLE OF GOANTITIES		•	CONTRAC	T NO. 62	2T16	
SCALE: NONE	SHEET 2 OF 2 SHEETS STA. TO STA.			ILLINOIS FED,	AID PROJECT		

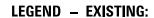


- 1) EXISTING P.C.C. PAVEMENT COURSE, 7" (+/-)
- 2 EXISTING HMA SURFACE COURSE, 7.75" (+/-)
- 3 EXISTING AGGREGATE SHOULDER
- 4 EXISTING HMA SHOULDER
- 5 EXISITING APPROACH FOOTING

LEGEND — REMOVAL








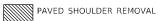

GUARDRAIL REMOVAL

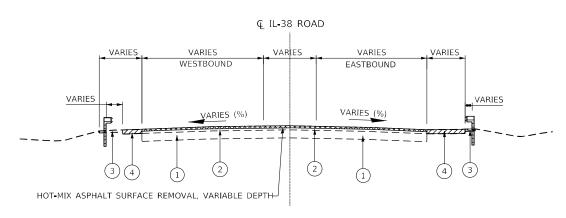


EXISTING TYPICAL SECTION

STA 2+52.87 TO STA 2+89.87 (LOOKING EAST)


LEGEND – PROPOSED:

- 7) HOT-MIX ASPHALT SURFACE COURSE, MIX "D", IL-9.5, N70, 1-1/2"
- 8 HOT-MIX ASPHALT BINDER COURSE, IL-19.0, N70, 2-1/4"
- 9 HOT-MIX ASPHALT SHOULDERS, 8"
- 10) AGGREGATE WEDGE SHOULDER, TYPE B
- 11) STEEL PLATE BEAM GUARDRAIL, TYPE A
- 12) TOPSOIL EXCAVATION AND PLACEMENT
- 13) BRIDGE DECK LATEX CONCRETE OVERLAY,2 1/2"
- 14) BRIDGE DECK SCARIFICATION, 3/4", TYP.
- (15) DECK SLAB REPAIR (FULL DEPTH, TYPE II), TYP.
- (16) STEEL RAILING, TYPE SM
- 17) HOT-MIX ASPHALT BASE COURSE, 11-1/4"
- (18) APPROACH FOOTING, 10"

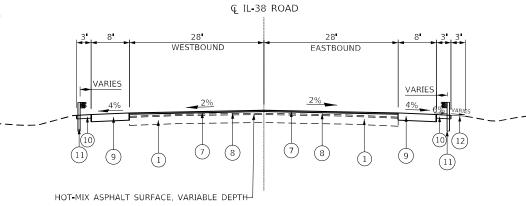

PROPOSED TYPICAL SECTION


STA 2+52.87 TO STA 2+89.87 (LOOKING EAST)

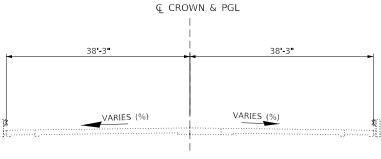

EXISTING TYPICAL SECTION

BRIDGE SECTION

STA STA 2+92.87 TO 3+70.37 (LOOKING EAST)

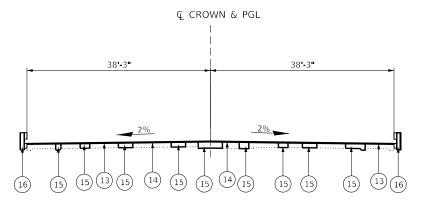

PROPOSED TYPICAL SECTION

BRIDGE SECTION

STA STA 2+92.87 TO 3+70.37 (LOOKING EAST)



USER NAME ■ majid.mastalii	DESIGNED • MM	REVISED -
	DRAWN - MM	REVISED -
PLOT SCALE = 20.0000 / in.	CHECKED - TC	REVISED -
PLOT DATE 3 /22/2023	DATE • 03/22/2023	REVISED -

STATE OF ILLINOIS **DEPARTMENT OF TRANSPORTATION**

IL 38 OVER WINFIELD CREEK								F.A RT	
	TYPICAL SECTIONS								34
				107	L OLO II	ONO			
SCALE: NONE	SHEET	1	OF	2	SHEETS	STA.	2+52,87	TO STA. 3+70.37	

SECTION DUPAGE 39 8 FAP 0347 22 BJ2 CONTRACT NO. 62T16



- 1) EXISTING P.C.C. PAVEMENT COURSE, 7" (+/-)
- 2 EXISTING HMA SURFACE COURSE, 7.75" (+/-)
- (3) EXISTING AGGREGATE SHOULDER
- (4) EXISTING HMA SHOULDER
- (5) EXISITING APPROACH FOOTING

LEGEND - REMOVAL

HOT-MIX ASPHALT SURFACE REMOVAL, VARIABLE DEPTH

P.C.C. PAVEMENT REMOVAL


PAVED SHOULDER REMOVAL

PAVED SHOULDER REMOVAL

GUARDRAIL REMOVAL


LEGEND – PROPOSED:

- (7) HOT-MIX ASPHALT SURFACE COURSE, MIX "D", IL-9.5, N70, 1-1/2"
- 8 HOT-MIX ASPHALT BINDER COURSE, IL-19.0, N70, 2-1/4"
- 9 HOT-MIX ASPHALT SHOULDERS, 8"
- 10) AGGREGATE WEDGE SHOULDER, TYPE B
- (11) STEEL PLATE BEAM GUARDRAIL, TYPE A
- (12) TOPSOIL EXCAVATION AND PLACEMENT
- (13) BRIDGE DECK LATEX CONCRETE OVERLAY,2 1/2"
- 14) BRIDGE DECK SCARIFICATION, 3/4", TYP.
- 15) DECK SLAB REPAIR (FULL DEPTH, TYPE II), TYP.
- 16 STEEL RAILING, TYPE SM
- 17) HOT-MIX ASPHALT BASE COURSE, 11-1/4"
- (18) APPROACH FOOTING, 10"

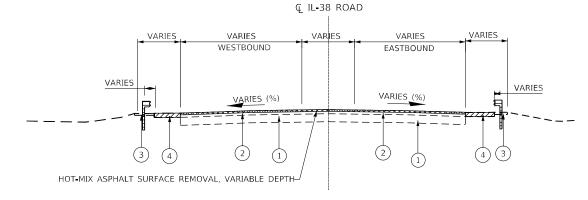


EXISTING TYPICAL SECTION

STA 3+73.37 TO STA 4+47.37 (LOOKING WEST)

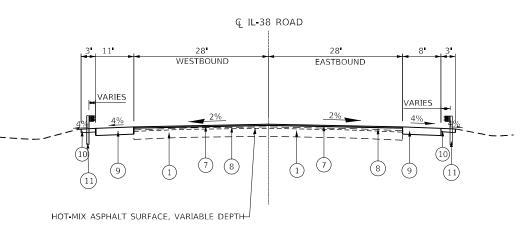

PROPOSED TYPICAL SECTION

STA 3+73.37 TO STA 4+47.37 (LOOKING WEST)

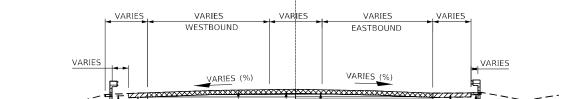


€ IL-38 ROAD

HOT-MIX ASPHALT SURFACE REMOVAL, VARIABLE DEPTH-

EXISTING TYPICAL SECTION

STA 2+89.87 TO STA 2+92.87 AND STA 3+70.37 TO STA 3+73.37

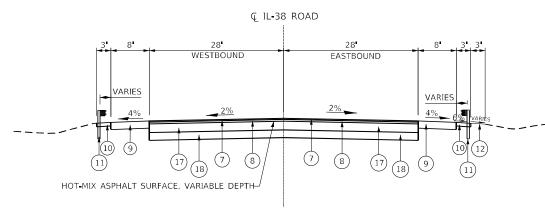

PROPOSED TYPICAL SECTION

STA 2+89.87 TO STA 2+92.87 AND STA 3+70.37 TO STA 3+73.37

	5.77 3.77 c .57 7 c.57	, , 3, 3 ,	
OPERATIONS	PAVEMENT MIXTURE REQUIREMENTS FOR IL-38 ROAD	PERCENTAIR VOIDS @ Ndes	QMP
RESURFACING	HOT-MIX ASPHALT SURFACE COURSE, MIX "D", IL-9.5, N70, 1-1/2"	4% @ 7 0 Gyr.	QC/QA
NESONI ACING	HOT-MIX ASPHALT BINDER COURSE, IL-19.0, N70, 2-1/4"	4% @ 7 0 Gyr.	QC/QA
SHOULDER	HOT-MIX ASPHALT SURFACE COURSE, MIX "D", IL-9.5, N70, 8"	4% @ 7 0 Gyr.	QC/QA or QCP
DRIVEWAYC	HOT-MIX ASPHALT SURFACE COURSE, MIX "D", IL-9.5, N50, 2"	4% @ 50 Gyr.	QC/QA
DRIVEWAYS	HOT-MIX ASPHALT BASE COURSE, 6"(HMA BINDER, IL-19)	4% @ 50 Gyr.	QC/QA
	HOT-MIX ASPHALT SURFACE COURSE, MIX "D", IL-9.5, N70, 1-1/2"	4% @ 70 Gyr.	QC/QA
FULL DEPTH PAVEMENT	HOT-MIX ASPHALT BINDER COURSE, IL-19.0, N70, 2-1/4"	4% @ 7 0 Gyr.	QC/QA
	HOT-MIX ASPHALT BASE COURSE, 11-1/4" (HMA BINDER, IL-19, N70)	4% @ 70 Gyr.	QC/QA

QMP Designations: Quality Control/Quality Assurance (QC/QA); Quality Control for Performance (QCP); Pay for Performance (PFP)


- THE UNIT WEIGHT USED TO CALCULATE ALL HMA SURFACE MIXTURE QUANTITIES IS 112 LBS/SQ YD/IN.
- THE "AC TYPE" FOR POLYMERIZED HMA MIXES SHALL BE "SBS/SBR PG 76 -22" AND FOR NON- OLYMERIZED HMA THE "AC TYPE" SHALL BE "PG 64 -22" UNLESS MODIFIED BY RECLAIMED MATERIALS SPECFICATIONS.



	USER NAME ■ majid.mastali	DESIGNED - MM	REVISED -
		DRAWN - MM	REVISED -
I	PLOT SCALE = 20.0000 * / in.	CHECKED - TC	REVISED -
	PLOT DATE ■ 3/22/2023	DATE • 03/22/2023	REVISED -

STATE OF ILLINOIS
DEPARTMENT OF TRANSPORTATION

IL 38 OVER WINFIELD CREEK	F.A.P. RTE	SECTION	COUNTY	TOTAL SHEETS	SHEET NO.
TYPICAL SECTIONS	347	FAP 0347 22 BJ2	DUPAGE	39	9
111 10/12 020110110			CONTRACT	NO. 62	2T16
SCALE: NONE SHEET 2 OF 2 SHEETS STA, 3+70.37 TO STA, 4+47.37		ILLINOIS F	ED. AID PROJECT		

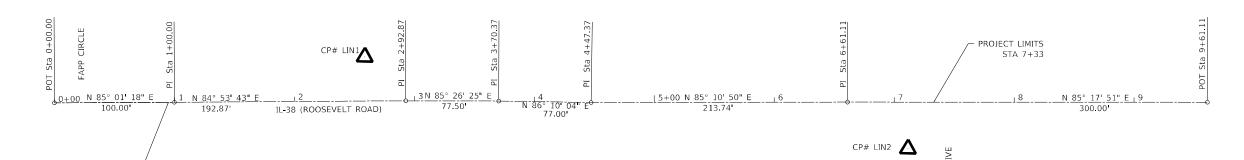


PROJECT LIMITS-STA. 0+95

CP.#LIN1 N:1890923.9130 E:1037508.1810 STA. 2+58.99 37.77 LT SET CP'S (REBARS W/CAP)

CP.#LIN2 N:1890884.9100 E:1037965.7130 STA, 7+11.45 38.02 RT SET CP'S (REBARS W/CAP)

BM1
BENCHMARK BM1 - SQ CUT IN TOP OF ABUTMENT IN SE PART OF BRIDGE IL 38 OVER WINFIELD CREEK (EL=727.08)

IL-38	(RUUSEVELT RU	DAD) ALIGNMENT CO	JURDINATES
POINT	STATION	NORTHING	EASTING
POT	1+00.00	1890872.1441	1037353.1798
PI	2+92.87	1890889.3048	1037545.2832
PI	3+70.37	1890895.4657	1037622.5380
PΙ	4+47.37	1890900.6120	1037699.3658
POT	6+61.11	1890918.5692	1037912.3504

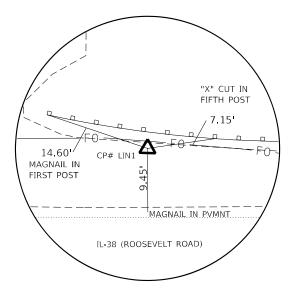

CP #LIN1 STA. 2+58.99 37.77 LT

IL-38 (ROOSEVELT ROAD)	
"X" CUT IN ===================================	
FO CP# LI 24.10' CENTER OF	FO S
F0 — F	TRAFFIC SIGNAL


CP #LIN2 STA. 7+11.45 38.02 RT


USER NAME = andrew.thompson2	DESIGNED - KE	REVISED -
	DRAWN - KE	REVISED -
PLOT SCALE = 80.0000 / in.	CHECKED - TC	REVISED -
PLOT DATE = 3/22/2023	DATE - 03/21/2023	REVISED -

STATE OF ILLINOIS **DEPARTMENT OF TRANSPORTATION**

						LD CREEK BENCHMARKS	
SCALE: 1"=40'	SHEET	1	OF	1	SHEETS	STA.	TO STA.

F.A.P. RTE.	SECTION	COUNTY	TOTAL SHEETS	SHEET NO.	
347	347 FAP 0347 22 BJ2		DUPAGE	39	10
		CONTRACT	NO. 62	2T16	
	ILLINOIS	FFD. A	ID PROJECT		

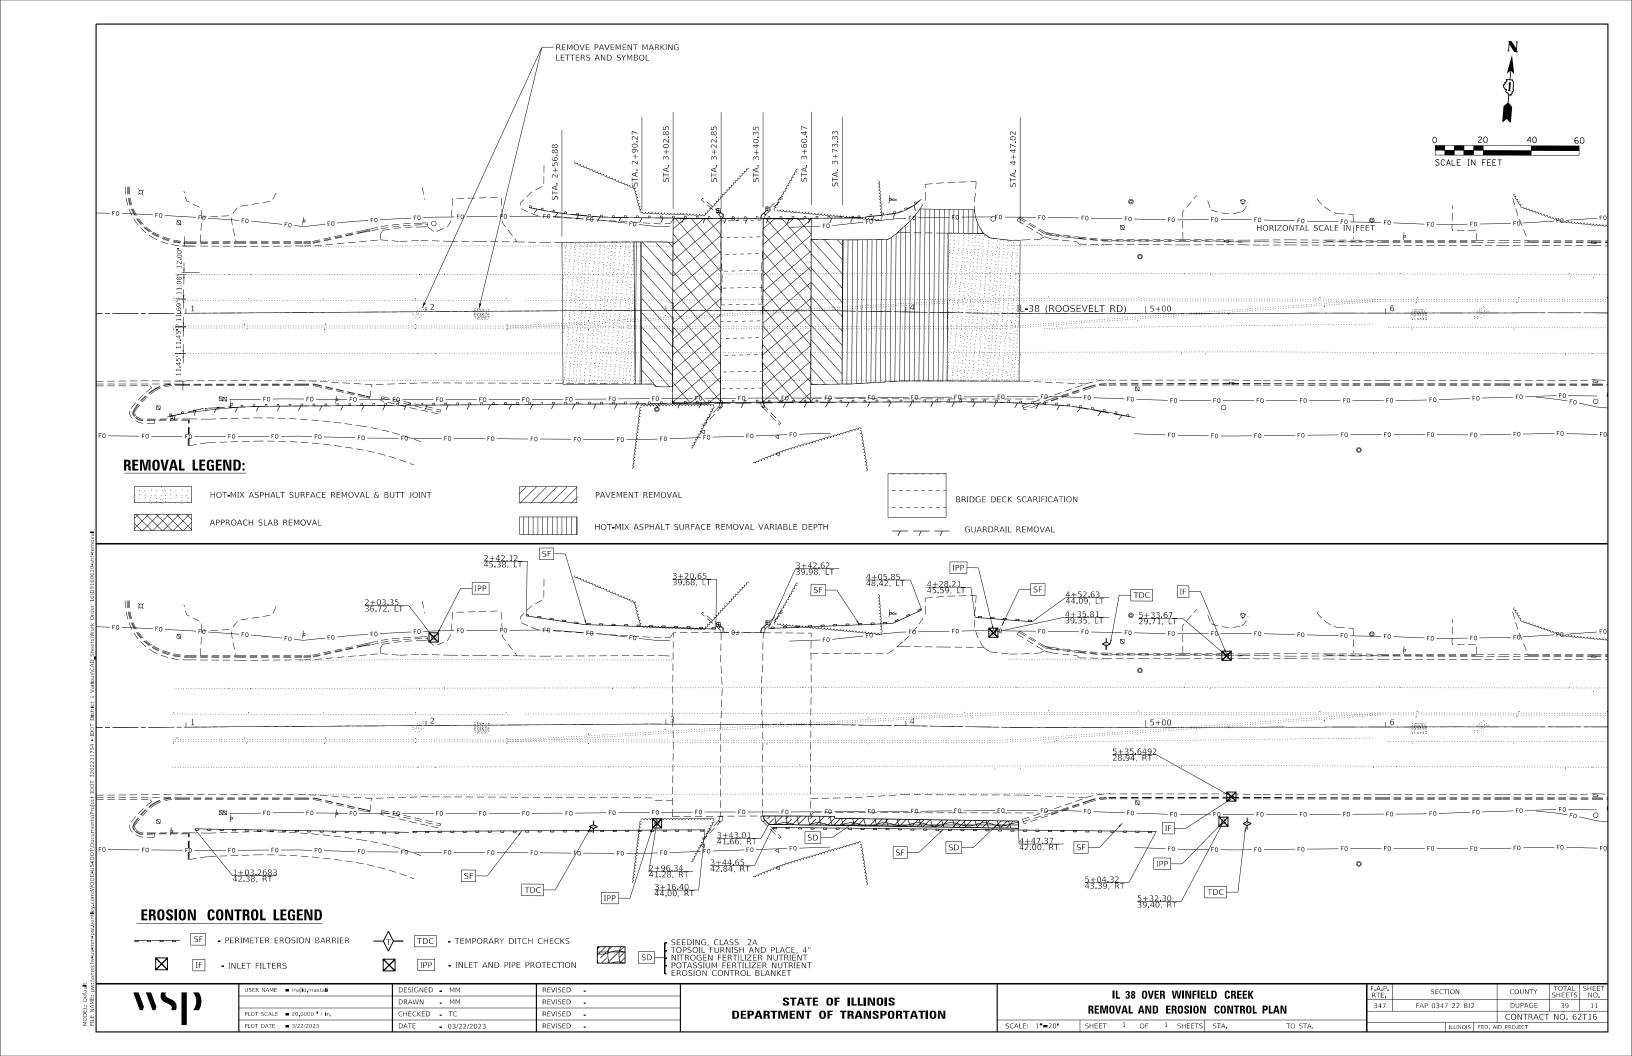

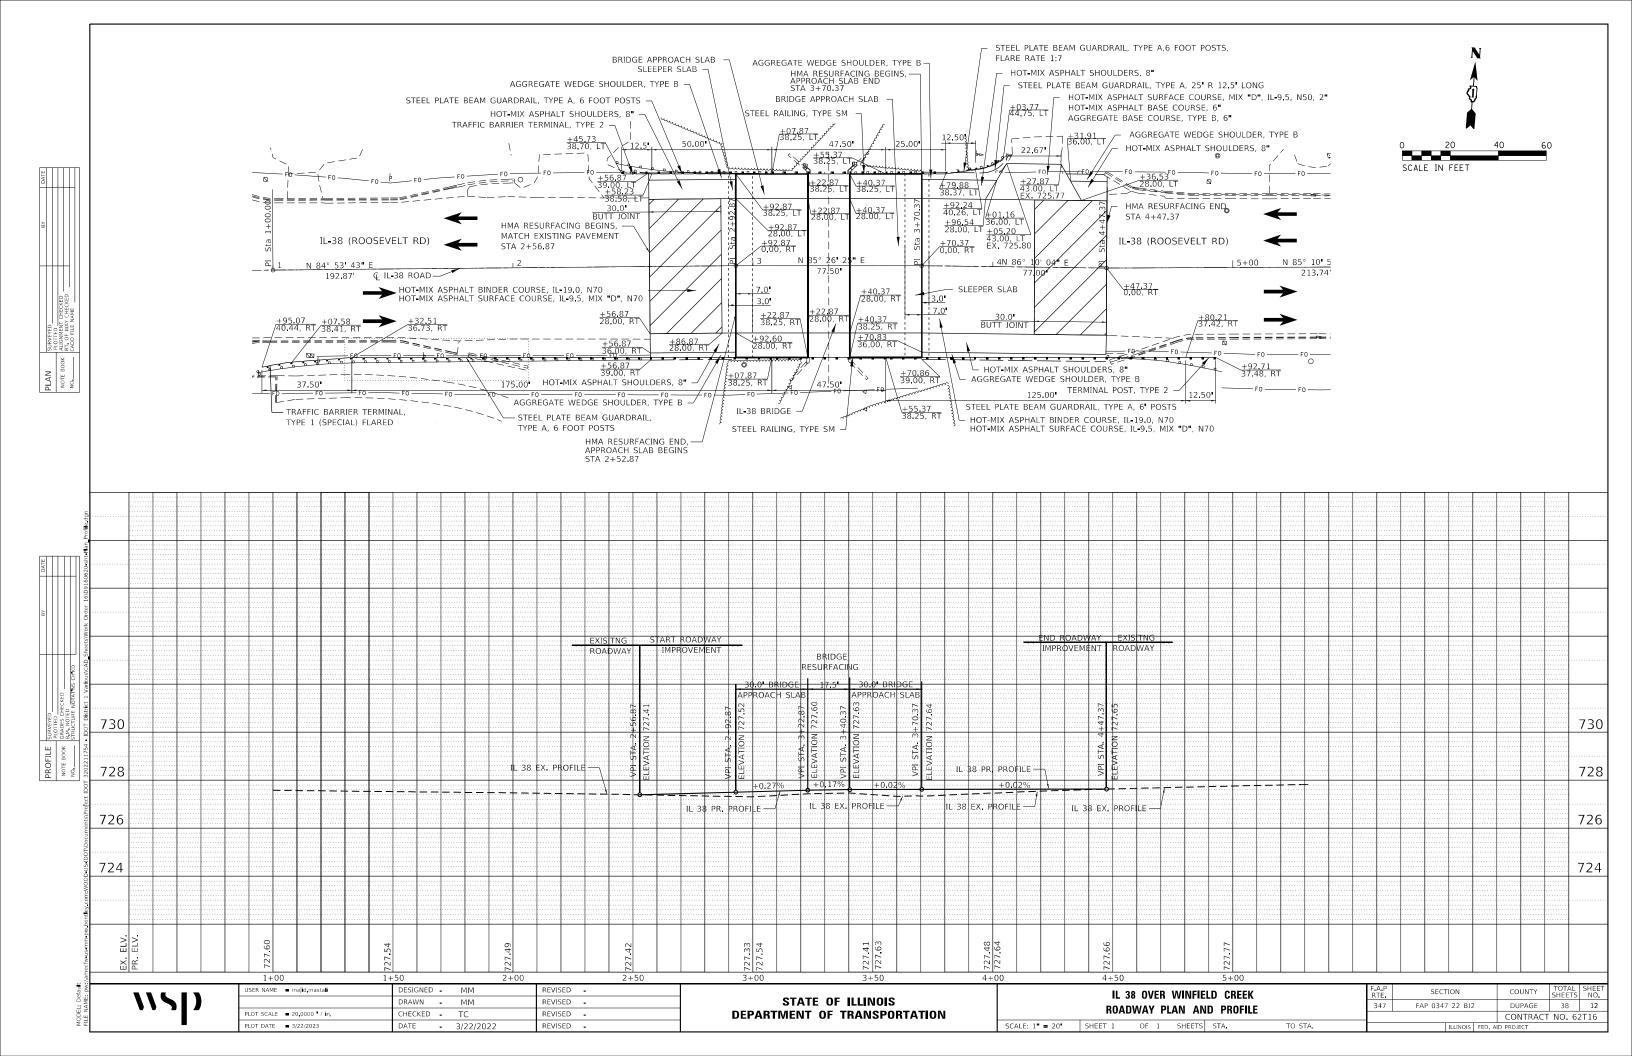

STAGING GENERAL NOTES

- 1. ONE LANE OF TRAFFIC SHALL BE MAINTAINED IN EACH DIRECTION AT ALL TIMES. IL 38 TRAVEL LANE WIDTH SHALL BE A MINIMUM OF 10.5 FT.
- 2. EXISTING TRAFFIC SIGNALS SHALL REMAIN DURING CONSTRUCTION. SIGNAL TIMING AND SIGNAL HEAD LOCATIONS SHALL REMAIN THE SAME.
- 3. TEMPORARY PAVEMENT MARKINGS SHALL BE TAPE, TYPE IV.
- 4. EXISTING PAVEMENT MARKINGS IN CONFLICT WITH TEMPORARY PAVEMENT MARKINGS SHALL BE REMOVED.
- 5. TEMPORARY BARRIER SHALL BE PLACED AT A MINIMUM DISTANCE OF 6 INCHES FROM DROP-OFF, PIN TEMPORARY BARRIER WHEN DROP-OFF IS BETWEEN 6 INCHES AND 2 FEET.
- 6. THE TRAFFIC CONTROL PLANS SHALL SERVE AS A GUIDE FOR SAFE DIVERSION OF TRAFFIC DURING THE EXECUTION OF THIS CONTRACT. THE CONTRACTOR MAY MODIFY THE TRAFFIC CONTROL PLANS AT NO ADDITIONAL COST TO MEET CONSTRUCTION NEEDS BUT NOT AT THE EXPENSE OF PUBLIC SAFETY OR CONVENIENCE. ANY CHANGES TO THE TRAFFIC CONTROL PLAN SHALL BE SUBMITTED TO THE ENGINEER FOR APPROVAL.

SEQUENCE OF CONSTRUCTION

STAGE

- 1. NARROW TRAVEL LANES TO 10.5 FT AS SHOWN ON THE PLAN AND PLACE TEMPORARY TRAFFIC CONTROL DEVICES AS SHOWN ON THE PLANS.
- 2. MAINTAIN ONE LANE IN EACH DIRECTION ALONG IL 38. SHIFT EASTBOUND AND WESTBOUND TRAFFIC ONTO OUTSIDE LANE AND CLOSE INSIDE LANE AS SHOWN ON PLANS. MAINTAIN ALL LEFT TURN MOVEMENTS AT THE INTERSECTION EAST AND WEST OF THE BRIDGE.
- 3. PROCEED WITH WORK ALONG THE MIDDLE SECTION OF THE BRIDGE.
- 4. REMOVE AND REPLACE THE MIDDLE SECTION OF THE APPROACH ALONG WITH EXISTING PAVEMENT AT BOTH ENDS TO ACCOMADATE THE PROPOSED 30 FT SLAB.
- 5. PERFORM HMA SURFACE REMOVAL-BUT JOINT TO TIE EXISTING PAVEMENT TO THE END OF THE APPROACH SLABS.

STAGE 2

- 1. MAINTAIN ONE LANE IN EACH DIRECTION ALONG IL 38 BY SHIFTING EASTBOUND AND WESTBOUND TRAFFIC ONTO INSIDE LANE AND CLOSE OUTSIDE LANE AS SHOWN ON PLANS. MAINTAIN ALL LEFT TURN MOVEMENTS AT THE INTERSECTION EAST AND WEST OF THE BRIDGE
- 2. PROCEED WITH WORK ON THE NORTH AND SOUTH SECTION OF THE BRIDGE.
- 3. REMOVE AND REPLACE THE OUTSIDE SECTIONS OF THE APPROACH ALONG WITH EXISTING PAVEMENT AT BOTH ENDS TO ACCOMADATE THE PROPOSED 30 FT SLAB
- 4. CONSTRUCT THE PROPOSED HMA AND AGGREGATE WEDGE SHOULDERS ALONG BOTH SIDES OF THE ROADWAY.
- 5. REMOVE AND REPLACE THE EXISTING GUARDRAIL AND BRIDGE RAILING.
- 6. PERFORM HMA SURFACE REMOVAL-BUT JOINT TO TIE EXISTING PAVEMENT TO THE END OF THE APPROACH SLABS.


STAGE 3

- 1. REMOVE TEMPOARY PAVEMENT MARKINGS, AND TEMPORARY CONCRETE BARRIER.
- 2. MILL AND RESURFACE PAVEMENT, INSTALL PERMANENT MARKINGS, AND LANDSCAPING PER PLANS.

USER NAME = \$USER\$	DESIGNED - KE	REVISED -
	DRAWN - KE	REVISED -
PLOT SCALE = \$SCALE\$	CHECKED - TC	REVISED -
PLOT DATE = \$DATE\$	DATE - 03/22/2023	REVISED -

IL 38 OVER WINFIELD CREEK	F.A.P. RTE	SECTION	COUNTY	TOTAL SHEETS	
FFIC CONTROL GENERAL NOTES / SEQUENCE OF CONSTRUCTION	347	FAP 0347 22 BJ2	DUPAGE	39	13
TITO CONTINUE GENERAL MOTES / SEGULNOE OF CONSTRUCTION			CONTRACT	NO. 62	2T16
NONE SHEET OF SHEETS STA. TO STA.		ILLINOIS FED. AI	D PROJECT		

40DEL: \$MODELNAME

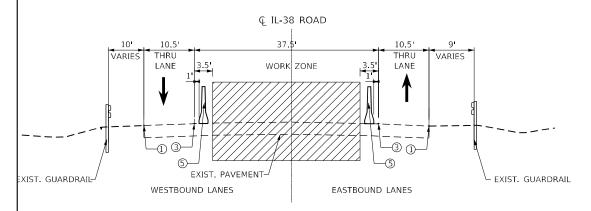



STA 3+70.37 TO STA 4+47.37

ℚ IL-38 ROAD 10.5 THRU THRU LANE WORK ZONE LANE EXIST. GUARDRAIL/RAILING EXIST. DECK/APROACH SLAB -L EXIST. GUARDRAIL/RAILING EASTBOUND LANES

> MAINTENANCE OF TRAFFIC STAGE 1 **IL ROUTE 38 INSIDE LANES CONSTRUCTION LOOKING EAST**


LEGEND

- TEMPORARY PAVEMENT MARKING LINE 4" TYPE IV TAPE WHITE TEMPORARY PAVEMENT MARKING - LINE 4" - TYPE IV TAPE DOUBLE YELLOW
- TEMPORARY PAVEMENT MARKING LINE 4" TYPE IV TAPE YELLOW
- TEMPORARY PAVEMENT MARKING LINE 4" TYPE IV TAPE WHITE SKIP-DASH

TEMPORARY CONCRETE BARRIER



PROPOSED WORK ZONE

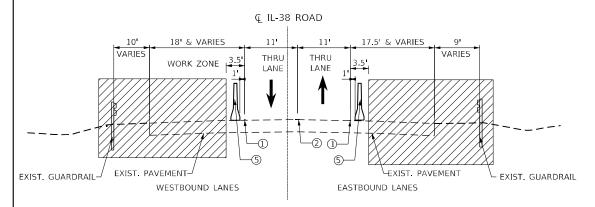

MAINTENANCE OF TRAFFIC STAGE 2 **IL ROUTE 38 INSIDE LANES CONSTRUCTION** LOOKING EAST STA 2+52.87 TO STA 2+92.87 STA 3+70.37 TO STA 4+47.37

€ IL-38 ROAD 18' & VARIES 17.5' & VARIES THRU THRU LANE LANE EXIST. GUARDRAIL/RAILING EXIST. DECK/APROACH SLAB - EXIST. GUARDRAIL/RAILING WESTBOUND LANES EASTBOUND LANES


> **MAINTENANCE OF TRAFFIC** STAGE 2 **IL ROUTE 38 INSIDE LANES CONSTRUCTION LOOKING EAST**




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	DRAWN -	REVISED -
PLOT SCALE = \$SCALE\$	CHECKED - TC	REVISED -
PLOT DATE = \$DATE\$	DATE - 03/22/2023	REVISED -

STATE	: OF	ILLINOIS
DEPARTMENT	OF	TRANSPORTATION

IL 38 OVER WINFIELD CREEK		F.A.P. RTE	SECT	ION		COUNTY	TOTAL SHEETS	SHEET NO.			
TRAFFIC CONTROL TYPICAL SECTIONS				347	847 FAP 0347 22 BJ2		!	DUPAGE	39	14	
THAT I CONTINUE TITIONE SECTIONS								CONTRAC	NO. 62	2T16	
EET	OF	SHEETS	STA.	TO STA.			ILLINOIS	FED. AI	D PROJECT		

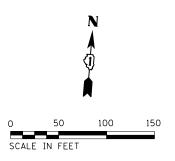

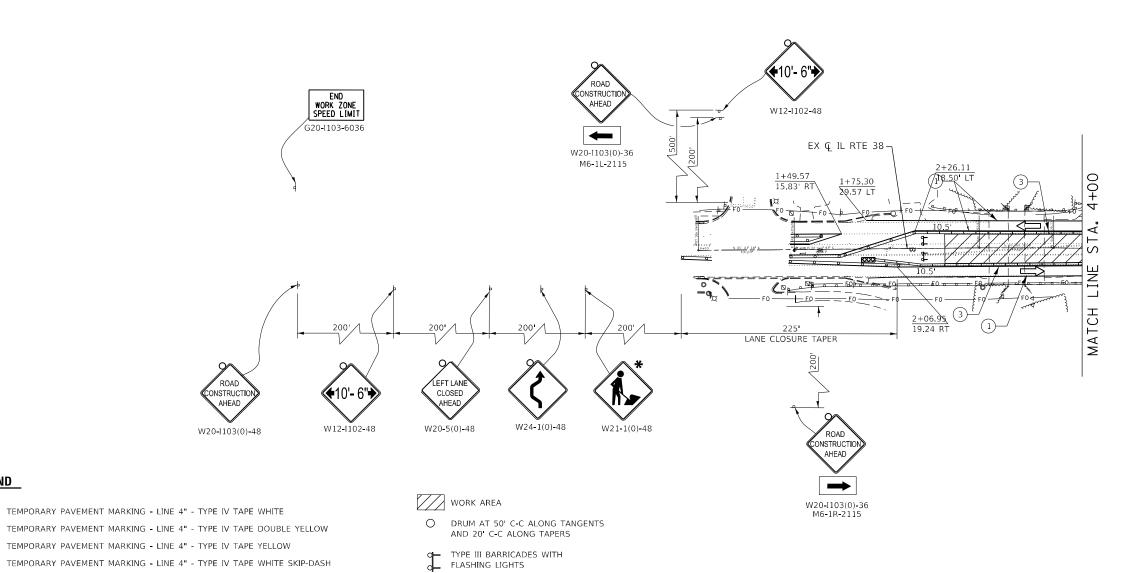

ILE NAME: STITE

LEGEND

2

3

4

(5)

CONSTRUCTION SIGN

 USER NAME
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 PLOT SCALE
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 PLOT DATE
 = \$DATE\$
 DATE
 03/22/2023
 REVISED

TEMPORARY PAVEMENT MARKING - LINE 4" - TYPE IV TAPE WHITE SOLID DOTTED LINE

TYPE II BARRICADE OR DRUM WITH STEADY BURNING LIGHT

STATE OF ILLINOIS
DEPARTMENT OF TRANSPORTATION


DIRECTION OF TRAFFIC


TEMPORARY CONCRETE BARRIER

TEMPORARY IMPACT ATTENUATOR

* THIS SIGN SHALL BE TAKEN DOWN WHEN NO WORKERS

ARE PRESENT

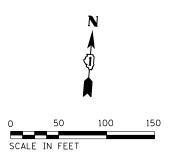

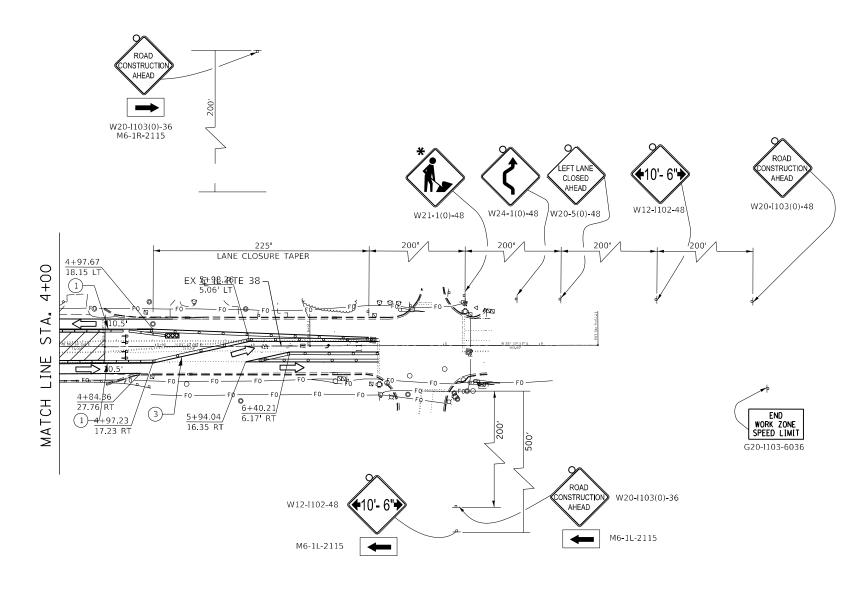

LEGEND

- (1) TEMPORARY PAVEMENT MARKING LINE 4" TYPE IV TAPE WHITE
- (2) TEMPORARY PAVEMENT MARKING LINE 4" TYPE IV TAPE DOUBLE YELLOW
- TEMPORARY PAVEMENT MARKING LINE 4" TYPE IV TAPE YELLOW
- TEMPORARY PAVEMENT MARKING LINE 4" TYPE IV TAPE WHITE SKIP-DASH
- 5 TEMPORARY PAVEMENT MARKING LINE 4" TYPE IV TAPE WHITE SOLID DOTTED LINE
- CONSTRUCTION SIGN
- TYPE II BARRICADE OR DRUM WITH STEADY BURNING LIGHT

WORK AREA

O DRUM AT 50' C-C ALONG TANGENTS AND 20' C-C ALONG TAPERS

TYPE III BARRICADES WITH FLASHING LIGHTS

DIRECTION OF TRAFFIC


TEMPORARY CONCRETE BARRIER


™ TEMPORARY IMPACT ATTENUATOR

* THIS SIGN SHALL BE TAKEN DOWN WHEN NO WORKERS ARE PRESENT



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LEGEND

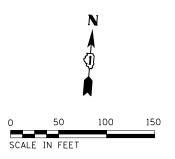2

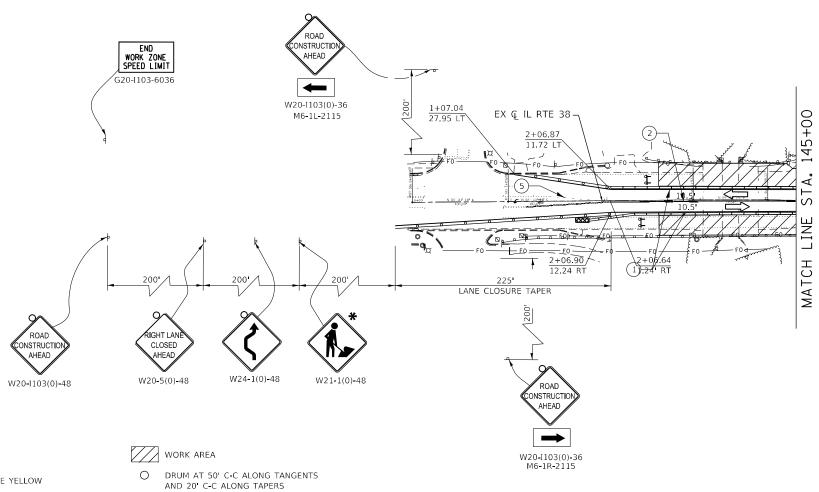4

TEMPORARY PAVEMENT MARKING - LINE 4" - TYPE IV TAPE WHITE

TEMPORARY PAVEMENT MARKING - LINE 4" - TYPE IV TAPE DOUBLE YELLOW

3 TEMPORARY PAVEMENT MARKING - LINE 4" - TYPE IV TAPE YELLOW

TEMPORARY PAVEMENT MARKING - LINE 4" - TYPE IV TAPE WHITE SKIP-DASH

(5) TEMPORARY PAVEMENT MARKING - LINE 4" - TYPE IV TAPE WHITE SOLID DOTTED LINE

CONSTRUCTION SIGN

TYPE II BARRICADE OR DRUM WITH STEADY BURNING LIGHT

TYPE III BARRICADES WITH FLASHING LIGHTS

DIRECTION OF TRAFFIC

TEMPORARY CONCRETE BARRIER

™ TEMPORARY IMPACT ATTENUATOR

* THIS SIGN SHALL BE TAKEN DOWN WHEN NO WORKERS ARE PRESENT


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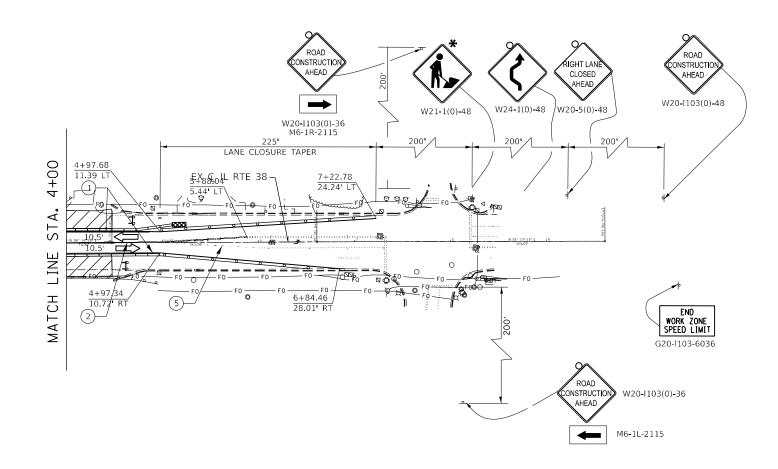


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PLOT SCALE = \$SCALE\$	CHECKED - TC	REVISED -
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STATE OF ILLINOIS **DEPARTMENT OF TRANSPORTATION**

IL 38 OVER WINFIELD CREEK	F.A.P. RTE	SECTION		COUNTY	TOTAL SHEETS	SHEET NO.
STAGING AND TRAFFIC CONTROL PLAN (STAGE II)	347	FAP 0347 22 BJ2		DUPAGE	39	17
STACING AND THATTIC CONTINCE LEAN (STACE II)				CONTRACT	NO. 62	2T16
50' SHEET 1 OF 2 SHEETS STA. TO STA.		ILLINOIS	FED. AI	D PROJECT		



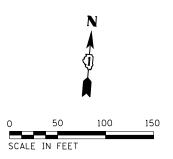

LEGEND

- TEMPORARY PAVEMENT MARKING LINE 4" TYPE IV TAPE WHITE
- 2 TEMPORARY PAVEMENT MARKING - LINE 4" - TYPE IV TAPE DOUBLE YELLOW
- (3) TEMPORARY PAVEMENT MARKING - LINE 4" - TYPE IV TAPE YELLOW
- 4 TEMPORARY PAVEMENT MARKING - LINE 4" - TYPE IV TAPE WHITE SKIP-DASH
- TEMPORARY PAVEMENT MARKING LINE 4" TYPE IV TAPE WHITE SOLID DOTTED LINE
- CONSTRUCTION SIGN
- TYPE II BARRICADE OR DRUM WITH STEADY BURNING LIGHT

WORK AREA

O DRUM AT 50' C-C ALONG TANGENTS AND 20' C-C ALONG TAPERS

TYPE III BARRICADES WITH FLASHING LIGHTS

DIRECTION OF TRAFFIC

TEMPORARY CONCRETE BARRIER

™ TEMPORARY IMPACT ATTENUATOR




* THIS SIGN SHALL BE TAKEN DOWN WHEN NO WORKERS ARE PRESENT


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PLOT SCALE = \$SCALE\$	CHECKED - TC	REVISED -
PLOT DATE = \$DATE\$	DATE - 03/22/2023	REVISED -

STATE OF ILLINOIS **DEPARTMENT OF TRANSPORTATION**

	IL 3	8 OVER V	VINFIELD	CREEK		
STAGING	AND	TRAFFIC	CONTROL	PLAN	(STAGE	II)

•	SECTION	COUNTY	TOTAL SHEETS	()
	EAR 0347 33 PI3	DUBAGE	20	Г

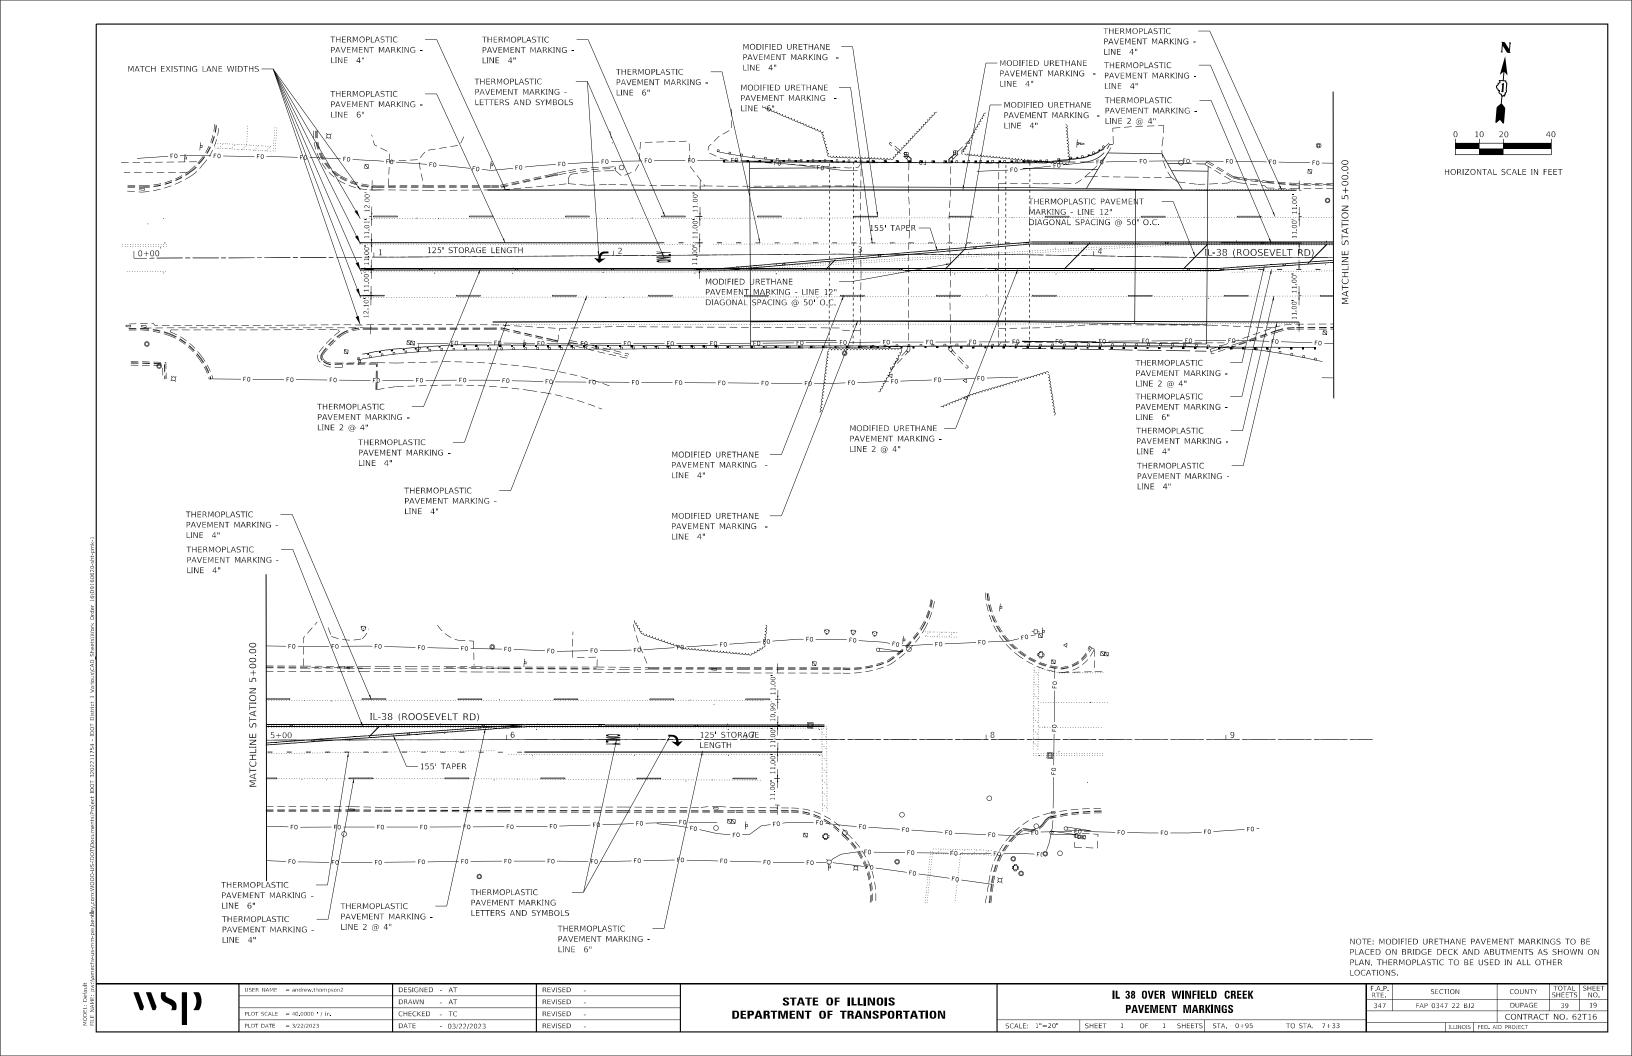

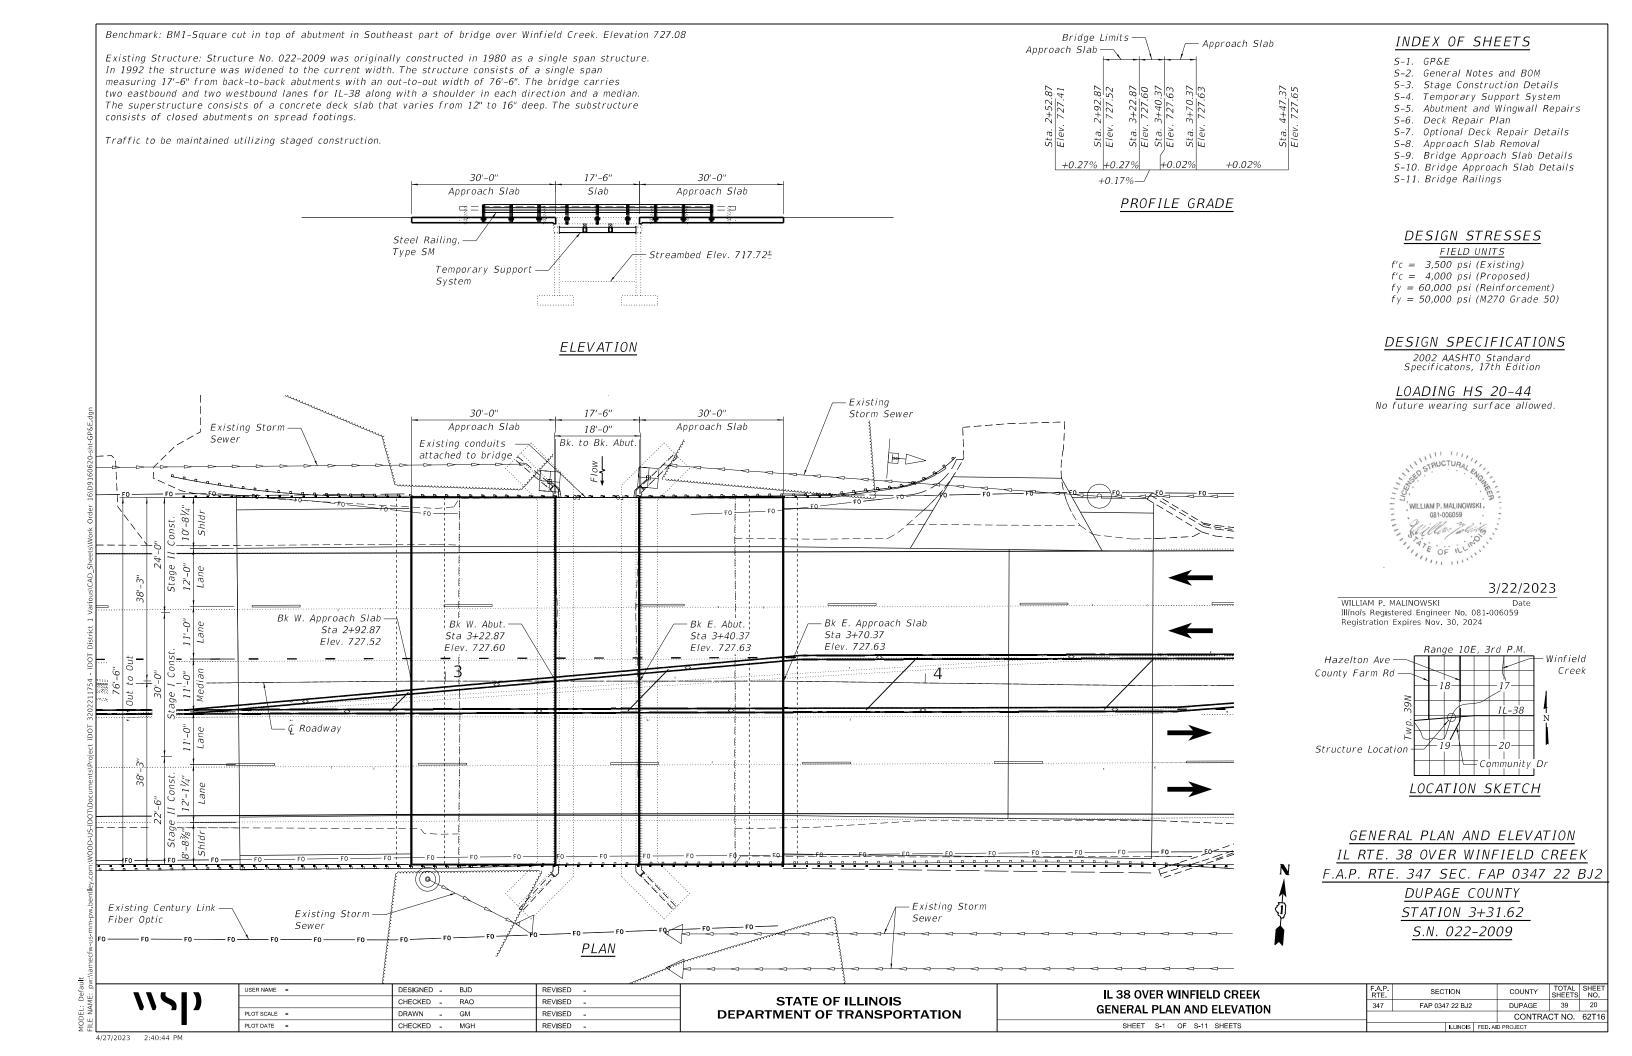

GENERAL NOTES

- 1. Reinforcement bars designated (E) shall be epoxy coated.
- 2. Prior to pouring the new concrete deck, all heavy or loose rust, loose mill scale, and other loose or potentially detrimental foreign material shall be removed from the surfaces in contact with concrete. Removal shall be accomplished by methods that will not damage the steel and the cost will be included in the pay item covering removal of the existing concrete.
- 3. Plan dimensions and details relative to existing plans are subject to nominal construction variations. The Contractor shall field verify existing dimensions and details affecting new construction and make necessary approved adjustments prior to construction or ordering of materials. Such variations shall not be cause for additional compensation for a change in scope of the work, however, the Contractor will be paid for the quantity actually furnished at the unit price bid for the work.
- 4. The Contractor shall make allowance for the deflection of forms, shrinkage and settlement of falsework, in addition to allowance for dead load deflection. Forms for deck slab shall be removed prior to placement of bridge approach slah
- 5. Existing reinforcement shall be cleaned and incorporated into the new construction. Cost included with Deck Slab Repair (Full Depth, Type II).
- 6. Any reinforcement bars that are damaged during concrete removal operations shall be repaired or replaced using an approved bar splicer or anchorage system. Cost included with Deck Slab Repair (Full Depth, Type II)

TOTAL BILL OF MATERIAL

ITEM	UNIT	SUPER	SUB	TOTAL
Concrete Structures	Cu. Yd.	-	48	48
Bridge Deck Grooving	Sq. Yd.	659	-	659
Protective Coat	Sq. Yd.	659	-	659
Concrete Superstructure (Approach Slab)	Cu. Yd.	213	-	213
Reinforcement Bars, Epoxy Coated	Pound	69,099	5,992	72,091
Steel Railing, Type SM	Foot	155	-	155
Approach Slab Removal	Sq. Yd.	340	-	340
Bridge Deck Latex Concrete Overlay, 2 1/2"	Sq. Yd.	149	-	149
Bridge Deck Scarification, 3/4"	Sq. Yd.	149	-	149
Structural Repair of Concrete (Depth Equal to or Less than 5 Inches)	Sq. Ft.	-	18	18
Deck Slab Repair (Full Depth, Type II)	Sq. Yd.	36	-	36
Deck Slab Repair (Partial)	Sq. Yd.	10	_	10
Temporary Support System	L. Sum	0.5	0.5	1

wsp

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STATE OF ILLINOIS
DEPARTMENT OF TRANSPORTATION

IL 38 OVER WINFIELD CREEK
GENERAL NOTES AND BILL OF MATERIAL


SHEET S-2 OF S-11 SHEETS

 FA.P. RTE.
 SECTION
 COUNTY SHEETS
 TOTAL NO.
 SHEETS NO.


 347
 FAP 0347 22 BJ2
 DUPAGE
 39
 21

 CONTRACT NO.
 62T16


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 FED. AID PROJECT

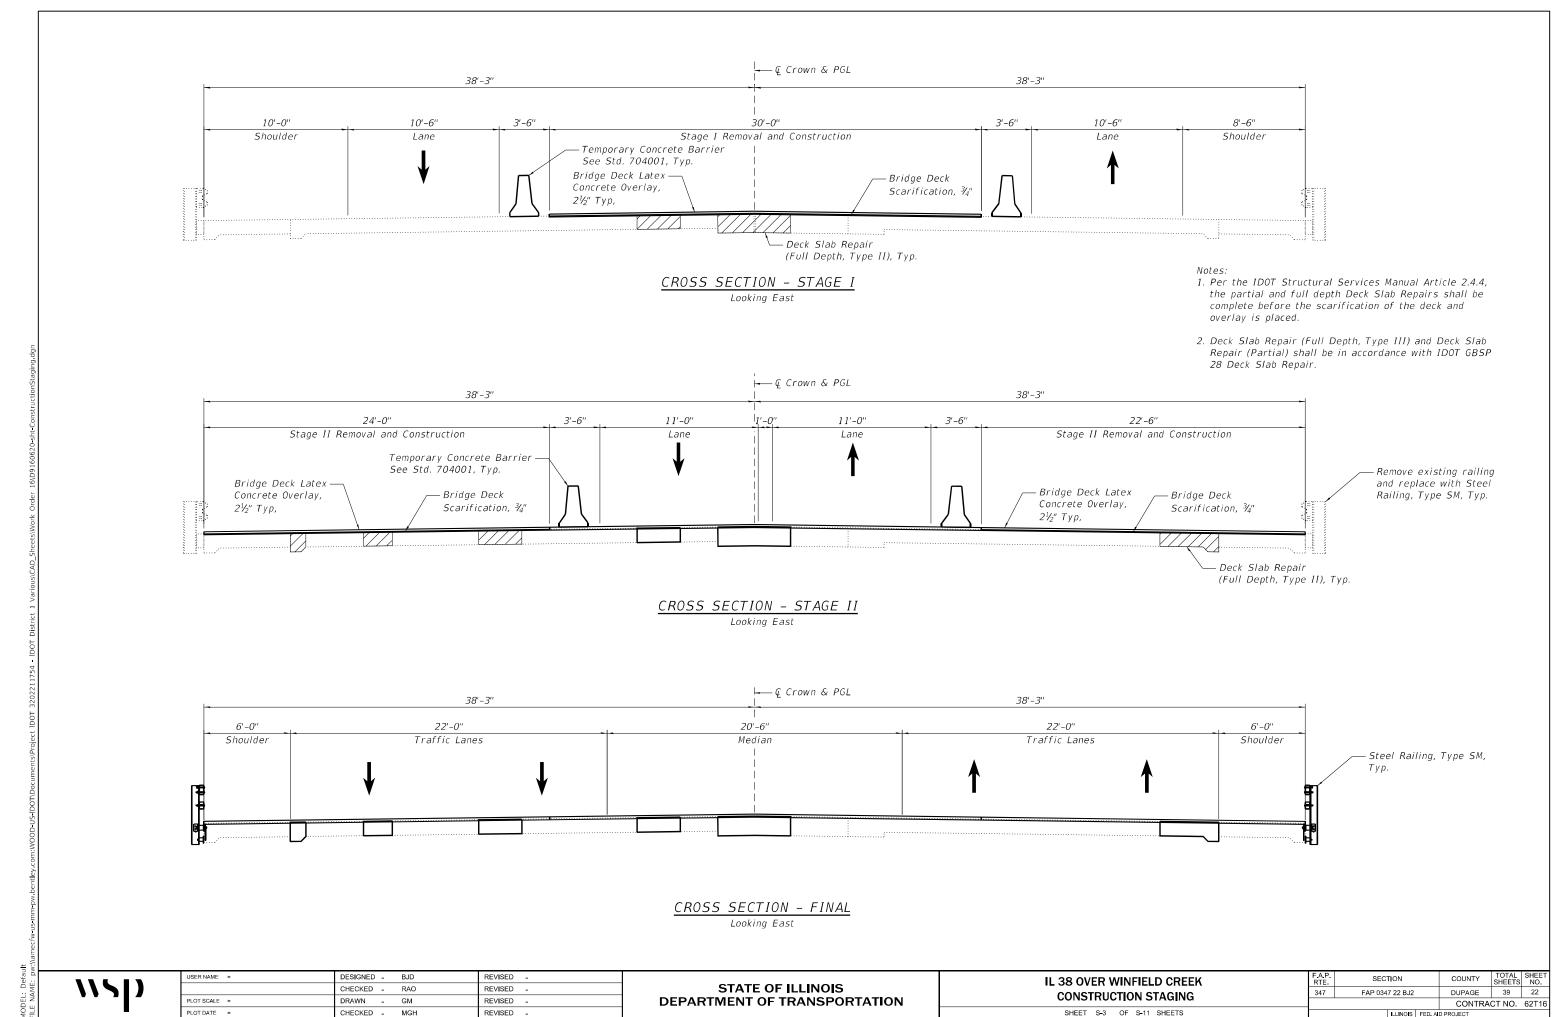

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<u>ELEVATION</u> Space Beams @ 4'-0" OC.

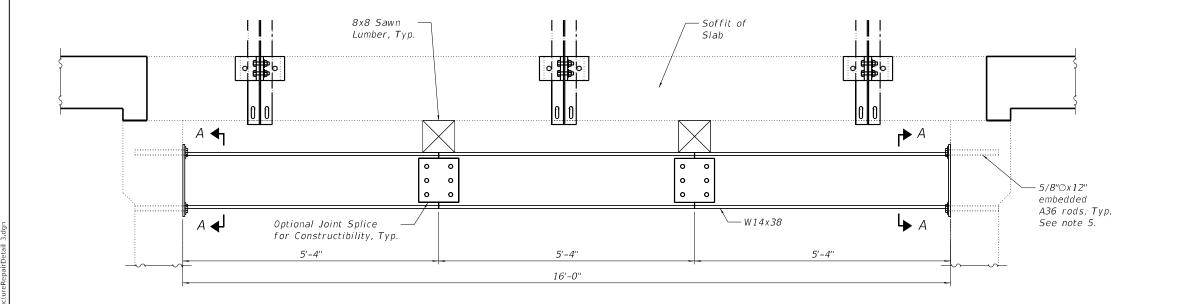

Section A-A

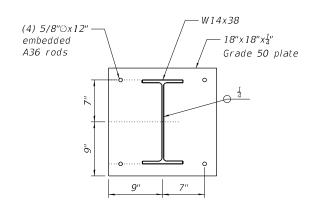Votes:

- 1. The Temporary Support System shall be installed prior to any removal of the concrete deck slab and approach slab.
- 2. Work this sheet with sheets S-5, S-6, & S-7.
- 3. See Special Provision for Temporary Support System.
- 4. Alternative Temporary Support System can be submitted by the Contractor and sealed by a licensed Structural Engineer in the State of Illinois for approval by the Engineer.
- 5. No permanent structures can be installed in the creek.
- 6. Core and set anchor rod according to Article 509.06 of the Standard Specifications, Cored holes shall be roughened or scored per manufacturer's recommendations.

wsp

STATE OF ILLINOIS
DEPARTMENT OF TRANSPORTATION

IL 38 OVER WINFIELD CREEK
TEMPORARY SUPPORT SYSTEM

SHEET S-4 OF S-11 SHEETS


 F.A.P. RTE.
 SECTION
 COUNTY SHEETS NO.
 SHEETS NO.

 347
 FAP 0347 22 BJ2
 DUPAGE
 39
 23


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WEST ABUTMENT (Looking West)




EAST ABUTMENT (Looking East)

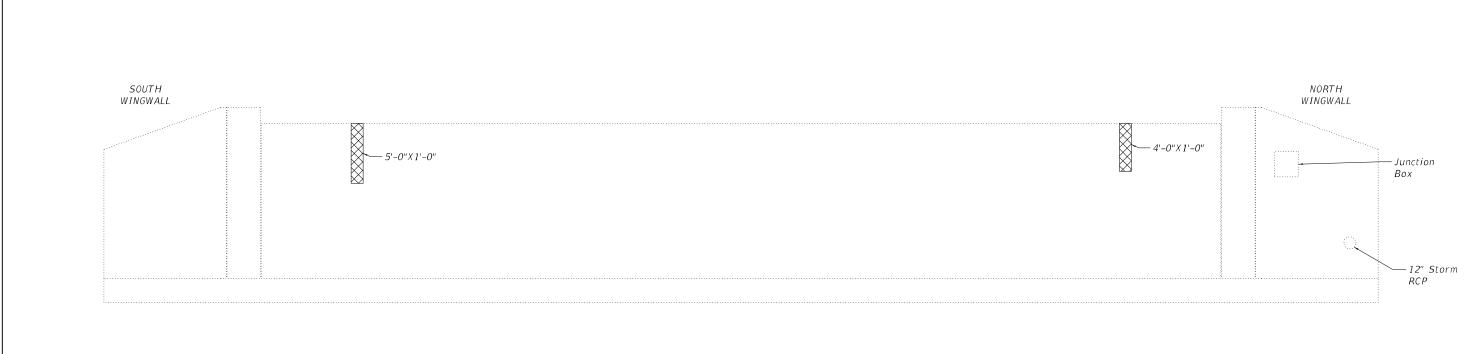BILL OF MATERIAL

Item	Unit	Quantity
Structural Repair of Concrete Less than 5 Inches	Sq.Ft.	18
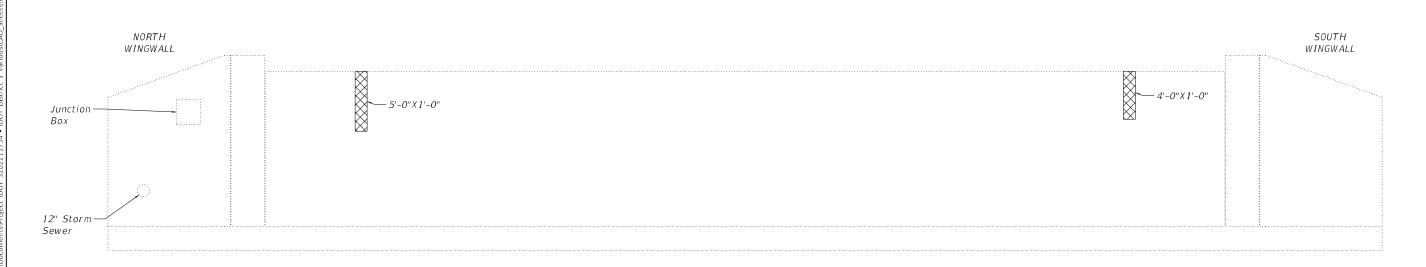
<u>LEGEND</u>

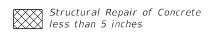



USER NAME =	DESIGNED -	BJD	REVISED -
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PLOT SCALE =	DRAWN -	GM	REVISED -
PLOT DATE =	CHECKED -	MGH	REVISED -


STATE OF ILLINOIS DEPARTMENT OF TRANSPORTATION

_					D CREEK ALL REPAIRS
	SHEET	S-5	OF	S-11	SHEETS

F.A.P. RTE	SECTION			COUNTY	TOTAL SHEETS	SHEE NO.
347	FAP 0347 22 BJ2			DUPAGE	39	24
				CONTRA	CT NO.	62T16
		ILLINOIS	FED. Al	D PROJECT		

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*Contractor to verify section loss of #8 hooked bars. See Repair Details on the following sheet if section loss exceeds 50%.

17'-3"

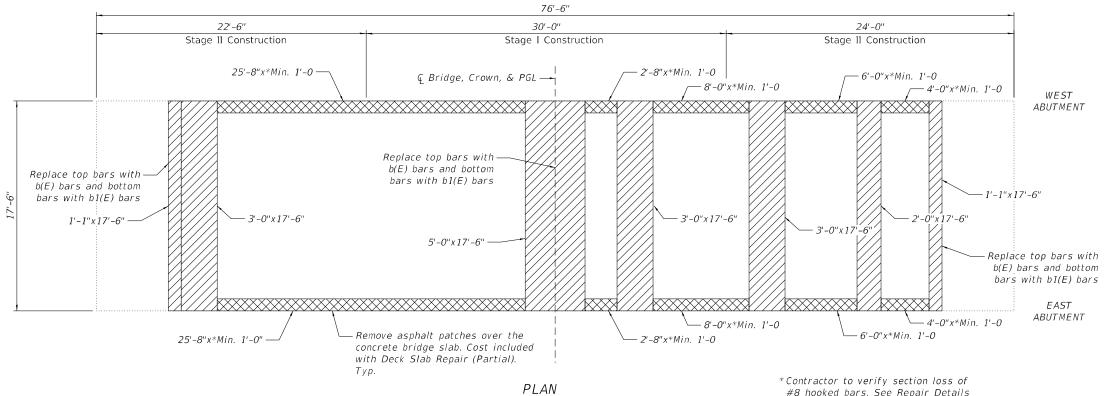BAR b1(E)

LEGEND


Deck Slab Repair (Partial)

Deck Slab Repair (Full Depth, Type II)

BILL OF MATERIAL

Bar	No.	Size	Length	Shape
b(E)	8	#5	17'-2"	
b1(E)	8	#8	19'-1"	ĵ
Bridge Deck	Groovi	ng	Sq. Yd.	149
Protective C	oat		Sq. Yd.	149
Reinforceme Epoxy Coate	Pound	551		
Bridge Deck Concrete Ove		Sq. Yd.	149	
Bridge Deck 3/4"	Scarif	Sq. Yd.	149	
Deck Slab Repair (Full Depth, Type II)			Sq. Yd.	36
Deck Slab Repair (Partial)			Sq. Yd.	10

- 1. Work this sheet with sheets S-4 and S-7.
- 2. Per the IDOT Structural Services Manual Article 2.4.4 the partial and full deck Deck Slab Repairs must be complete before the scarification of the deck and overlay is placed.
- 3. Contractor shall collect and remove the debris to prevent it from falling into the creek.

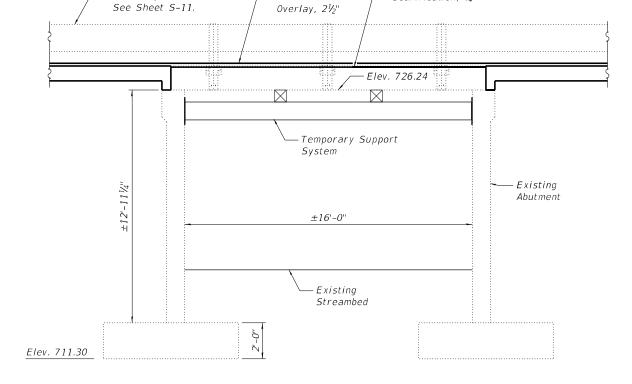

– Bridge Latex

– Bridge Deck

Scarification, 3/4"

ELEVATION


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PLOT SCALE =	DRAWN -	GM	REVISED -
PLOT DATE =	CHECKED -	MGH	REVISED -

-Existing Railing

to be replaced.


IL 38 OVER WINFIELD CREEK							
DECK REPAIR PLAN							
	CHEET	0.0	ΩE	0.11	CHEETC		

SECTION COUNTY FAP 0347 22 BJ2 DUPAGE 39 25 CONTRACT NO. 62T16

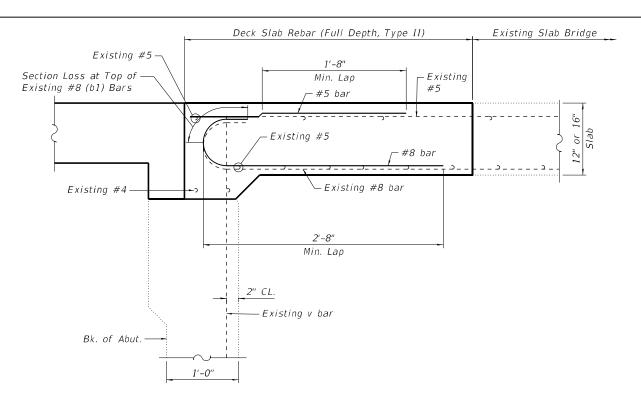

RECOMMENDED REPAIR OVER ABUTMENT - 1

May be used when section loss is 25% or greater at the top of the hook of Existing #8 bar.

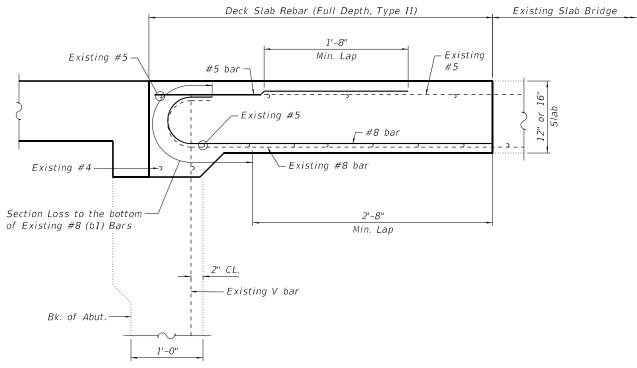

RECOMMENDED REPAIR OVER ABUTMENT - 2

May be used when section loss is 25% or greater at the bottom of Existing #8 bar.



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PLOT SCALE =	DRAWN -	GM	REVISED -
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STATE OF ILLINOIS DEPARTMENT OF TRANSPORTATION

IL 38 OVER WINFIELD CREEK OPTIONAL DECK REPAIR DETAILS SHEET S-7 OF S-11 SHEETS

Deck Slab Rebar (Full Depth, Type II)

RECOMMENDED REPAIR FOR TRANSVERSE SECTION

May be used when section loss is 25% or greater of the existing transverse bars.

1'-8"

Min. Lap Typ.

-End of corroded bar removal, Typ.

Existing Slab Bridge

lotes:

1. Refer to Special Provision for Deck Slab Repair.

2. Work this sheet with sheets S-4 and S-6.


Existing Slab Bridge

Existing #5

LExisting #5

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<u>LEGEND</u>

Approach Slab Removal

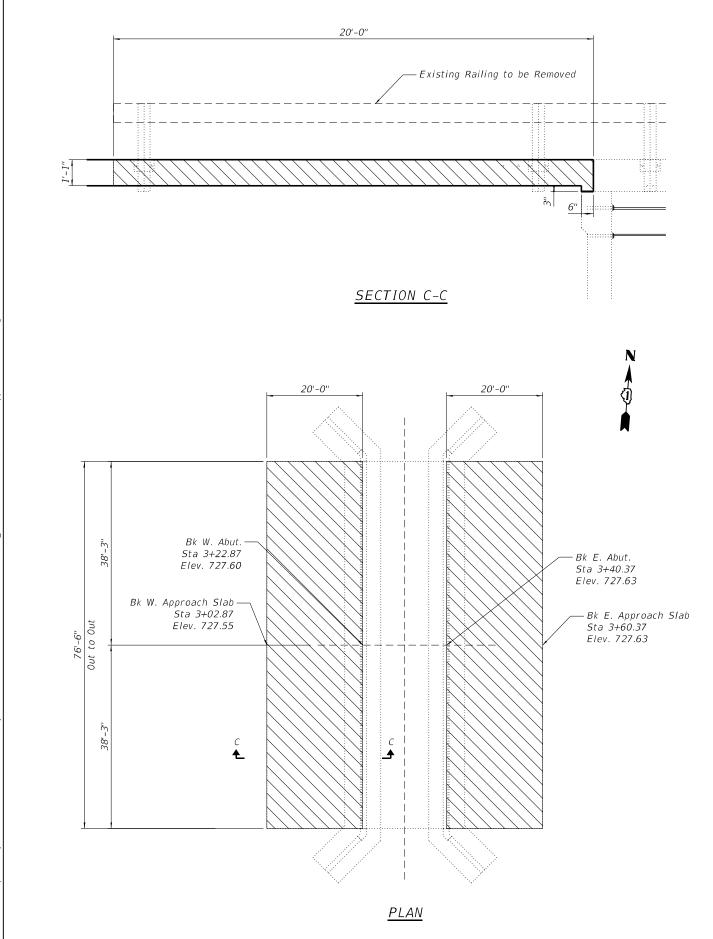
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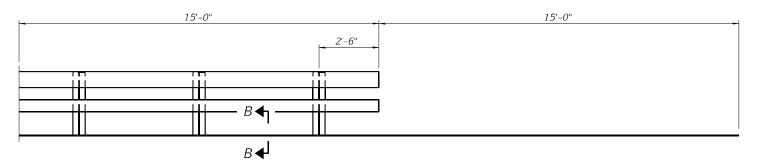
STATE OF ILLINOIS DEPARTMENT OF TRANSPORTATION

IL 38 OVER WINFIELD CREEK
APPROACH SLAB REMOVAL

SHEET S-8 OF S-11 SHEETS

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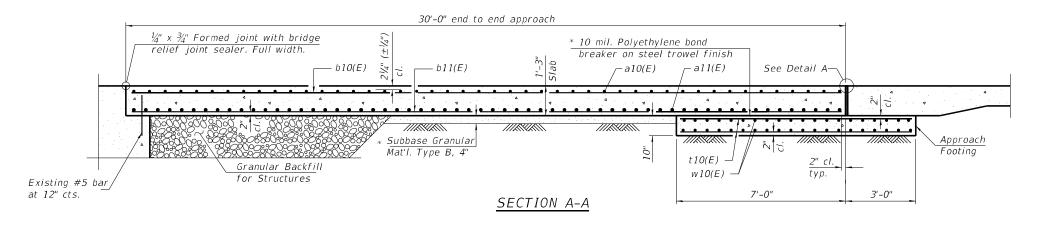


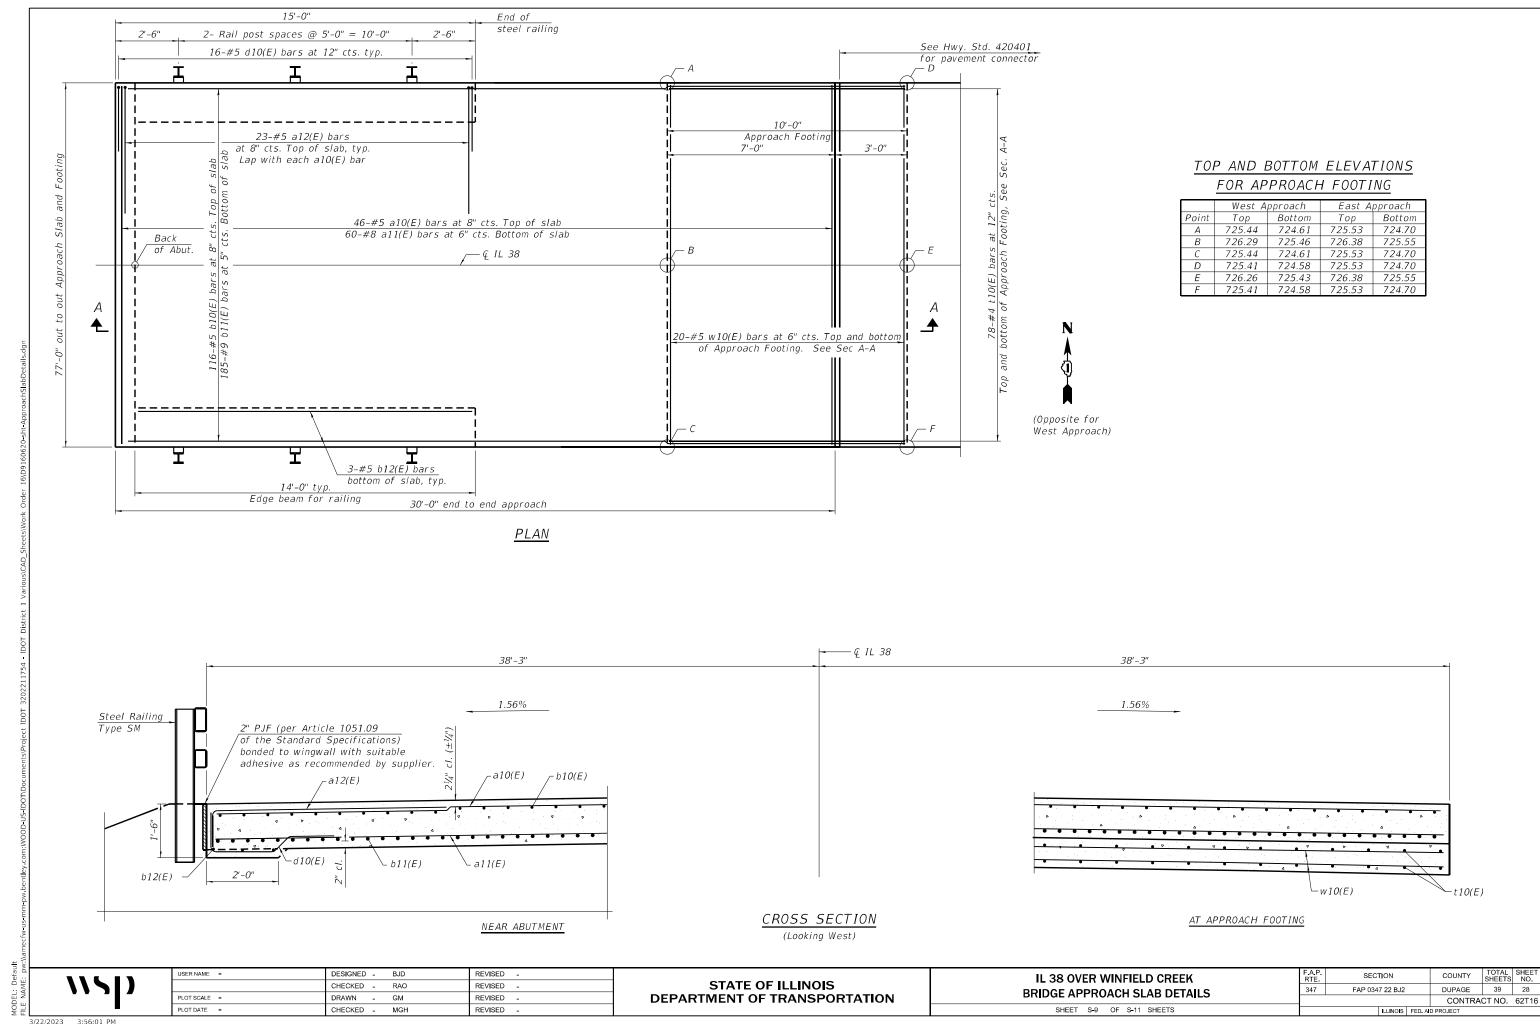


INSIDE ELEVATION OF RAILING

Note:


- 1. The joint opening shall be adjusted for temperature per Article 520.04 of the Standard Specifications. However, since this detail is for jointless structures, the length of bridge used to calculate the adjustment shall be equal to half the total bridge length plus the length of the bridge approach slab.
- 2. Approach slab shall be paid for as Concrete Superstructure (Approach Slab).
- 3. Approach footing concrete shall be paid for as Concrete Structures.
- 4. The approach footing maximum applied service bearing pressure (Qmax) = 2.0 ksf.
- 5. Cost of excavation for approach footing included with Concrete Structures.
- 6. For railing details, see sheet S-11 of S-11.



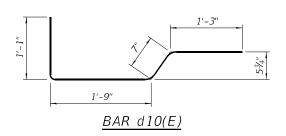

TWO APPROACHES BILL OF MATERIAL

Bar	No.	Size	Length	Shape
a10(E)	92	#5	47'-8"	
a11(E)	120	#8	47'-8"	
a12(E)	92	#5	7'-6"	_
b10(E)	232	#5	29'-8"	
b11(E)	370	#9	29'-8"	
b12(E)	12	#5	13'-8"	
d10(E)	64	#5	4'-8"	
t10(E)	312	#4	9'-8"	
10(5)	22		471 011	
w10(E)	80	#5	47'-8"	
Concrete	Structur	es	Cu. Yd.	48
Bridge D	eck Groo	ving	Sq. Yd.	659
Protective	e Coat	5q. Yd.	659	
Concrete (Approach		Cu. Yd.	213	
Reinforce Epoxy Co		Pound	71,540	

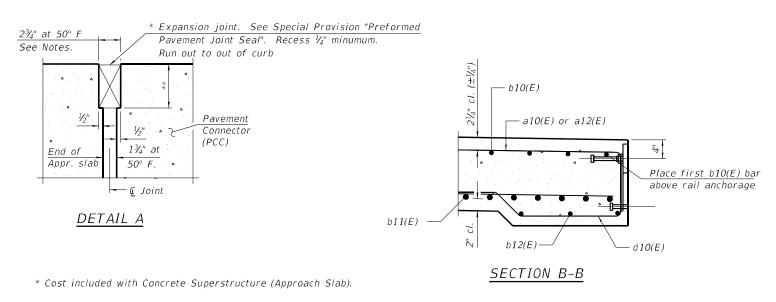

** Per manufacturer recommendations

wsp

USER NAME =	DESIGNED -	BJD	REVISED -
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PLOT SCALE =	DRAWN -	GM	REVISED -
PLOT DATE =	CHECKED -	MGH	REVISED -

STATE OF ILLINOIS
DEPARTMENT OF TRANSPORTATION

IL 38 OVER WINFIELD CREEK
BRIDGE APPROACH SLAB DETAILS

SHEET S-10 OF S-11 SHEETS

6'-6"

BAR a12(E)

 FAP. RTE.
 SECTION
 COUNTY
 TOTAL SHEETS
 SHEET NO.

 347
 FAP 0347 22 BJ2
 DUPAGE
 39
 29


 CONTRACT NO. 62T16

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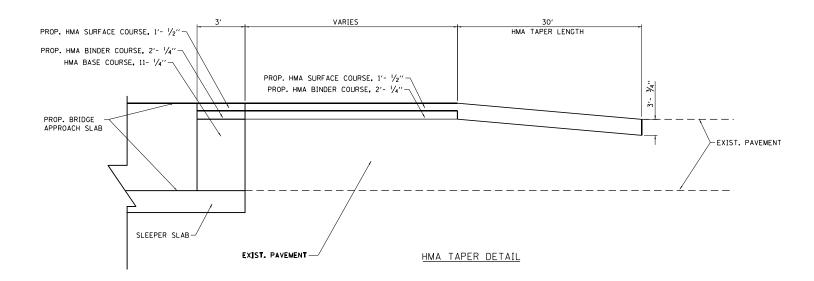
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BUTT JOINT DETAIL




PAVEMENT TRANSITION DETAIL

115)
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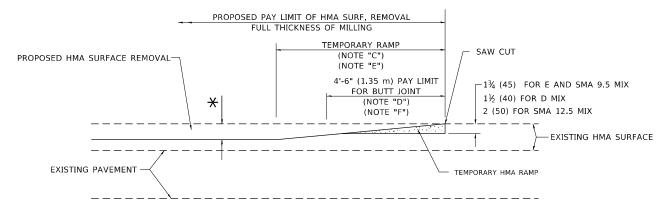
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IL 38 OVER WINFIELD CREEK	F.A.P. SECTION COUNTY TOTAL SHEETS NO
PAVEMENT TRANSITION DETAIL	347 FAP 0347 22 BJ2 DUPAGE 39 3
	CONTRACT NO. 62T16
SCALE: NONE SHEET 1 OF 1 SHEETS STA TO STA	ILLINOIS FED, AID PROJECT

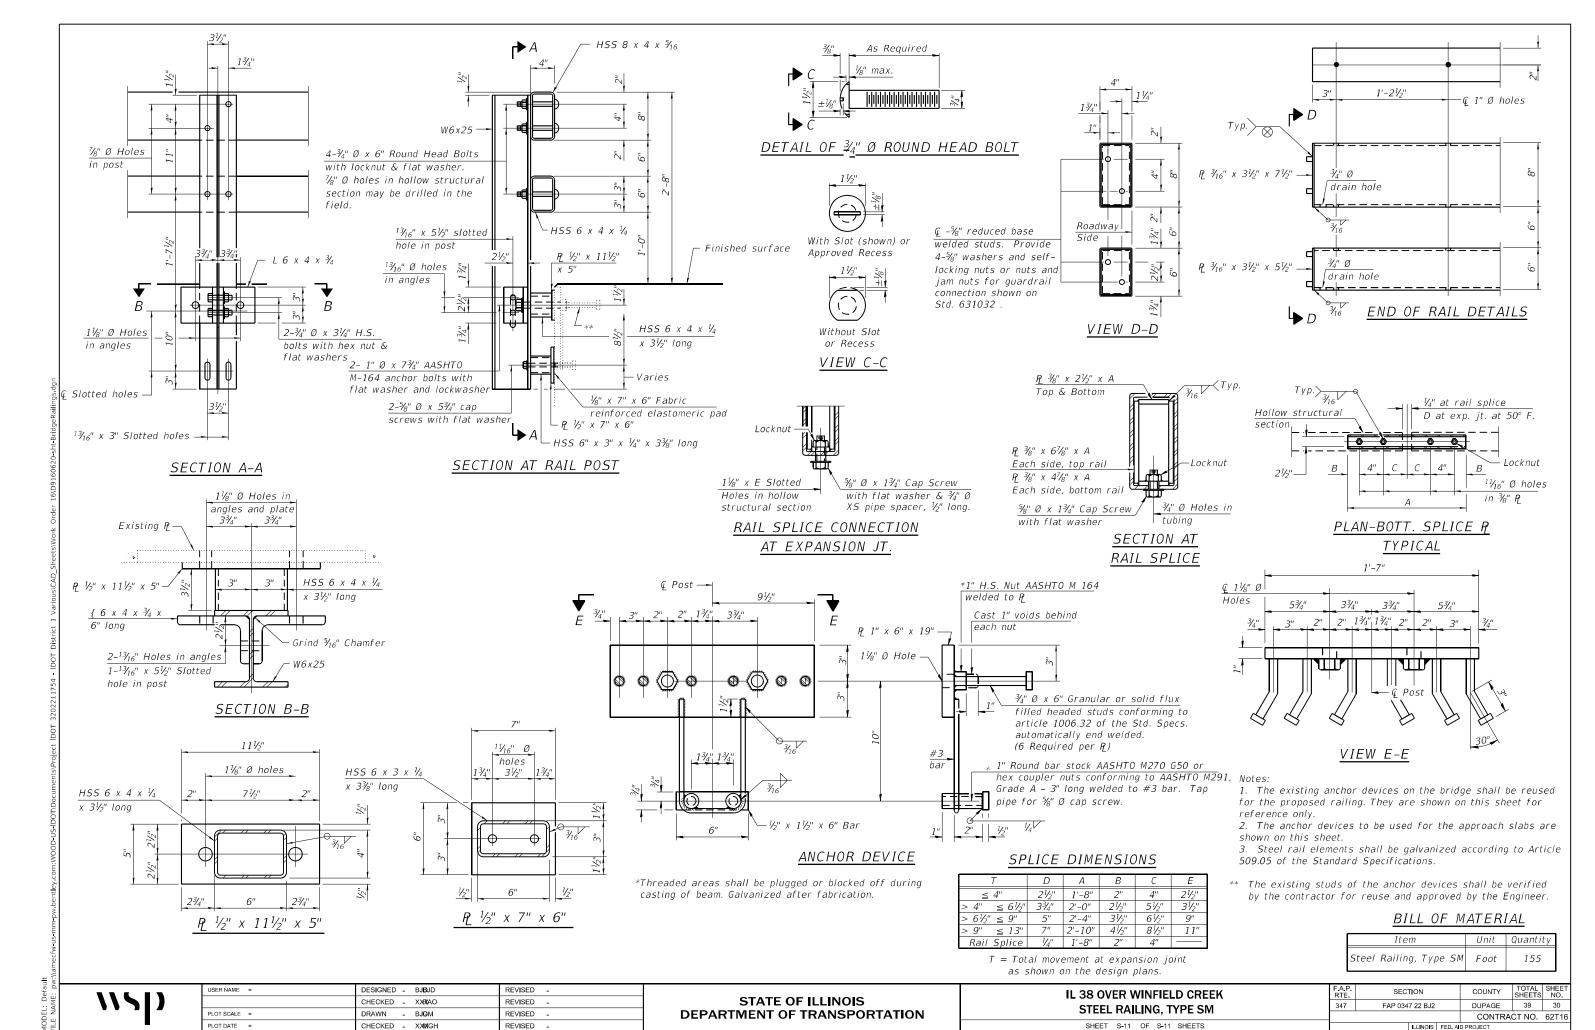

(FOR BUTT JOINT AND HMA TAPER SEE DETAIL BELOW)

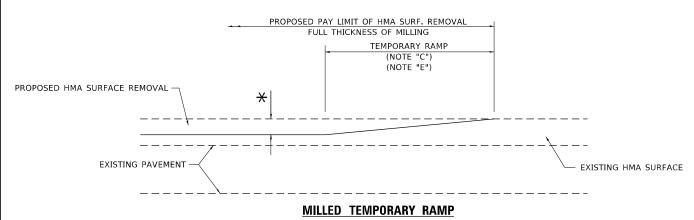OPTION 1




HMA CONSTRUCTED TEMPORARY RAMP

(FOR BUTT JOINT AND HMA TAPER SEE DETAIL BELOW)

OPTION 2

TYPICAL TEMPORARY RAMP

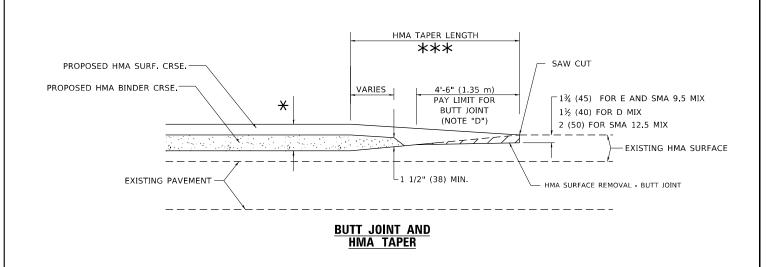


TYPICAL BUTT JOINT AND HMA TAPER FOR MILLING AND RESURFACING

M. DE YONG DESIGNED -DRAWN REVISED - M. GOMEZ 04-06-01 HECKED PLOT DATE = 2/2/2022 K. SMITH 02-01-22 DATE REVISED -

DEPARTMENT OF TRANSPORTATION

SECTION **BUTT JOINT AND HMA TAPER DETAILS** OF 1 SHEETS STA. SHEET 1

PROPOSED HMA OR PCC SURFACE REMOVAL - BUTT JOINT 30'-0" (9.0 m) (NOTE "A") EXISTING HMA OR PCC SURFACE -SAW CUT 15'-0" (4.5 m) (NOTE "B") (NOTE "D") 40'-0" (12.0M) (NOTE "A1") $-1\frac{3}{4}$ (45) FOR E AND SMA 9.5 MIX 1½ (40) FOR D MIX 2 (50) FOR SMA 12.5 MIX * EXISTING PAVEMENT **BUTT JOINT DETAIL**

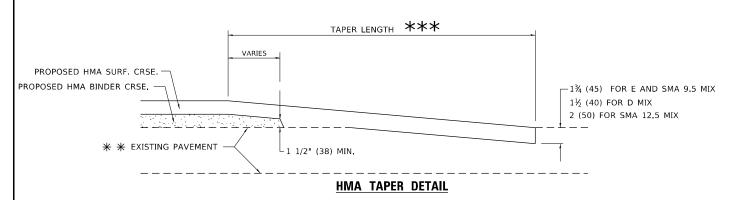

TYPICAL BUTT JOINT AND HMA TAPER FOR RESURFACING ONLY

** PC CONCRETE, HMA OR HMA RESURFACED PAVEMENT.

GENERAL NOTES

- A. MAINLINE ARTERIAL ROADWAYS AND MAJOR SIDE ROADS.
- A1. INTERSTATES
- B. MINOR SIDE ROADS.
- C. THE TEMP, RAMP SHALL BE CONSTRUCTED IMMEDIATELY UPON REMOVAL OF THE EXISTING HMA SURFACE,
- D. THE BUTT JOINT SHALL BE CONSTRUCTED IMMEDIATELY PRIOR TO PLACING THE PROPOSED HMA COURSES.
- E. TAPER THE TEMP. RAMP AT A RATE OF 3' 4" (1.02m) PER 1 INCH (25 mm) OF MILLING THICKNESS.
 - \bigstar SEE TYPICAL SECTIONS FOR MILLING THICKNESS.
- F. SEE ARTICLE 406.08 AND 406.14 OF THE STANDARD SPECIFICATIONS FOR "HMA AND/OR PCC SURFACE REMOVAL, BUTT JOINT".
- *** 20'-0" (6.1 m) PER 1 (25) RESURFACING (NOTE "A") 10'-0" (3.0 m) PER 1 (25) RESURFACING (NOTE "B")

BASIS OF PAYMENT


- THE BUTT JOINT WILL BE PAID FOR AT THE CONTRACT UNIT PRICE PER SQUARE YARD (SQUARE METER) FOR "HOT-MIX ASPHALT SURFACE REMOVAL BUTT JOINT" OR FOR "PORTLAND CEMENT CONCRETE SURFACE REMOVAL- BUTT JOINT"
- THE TEMPORARY RAMP AND SAW CUT SHALL BE INCLUDED IN THE UNIT COST FOR HMA OR PCC SURFACE REMOVAL-BUTT JOINT.

SCALE: NONE

ALL DIMENSIONS ARE IN INCHES (MILLIMETERS) UNLESS OTHERWISE SHOWN.

STATE OF ILLINOIS

FAP 0347 22 BJ2 DUPAGE 39 32 BD400-05 BD-32 CONTRACT NO. 62T16 TO STA.

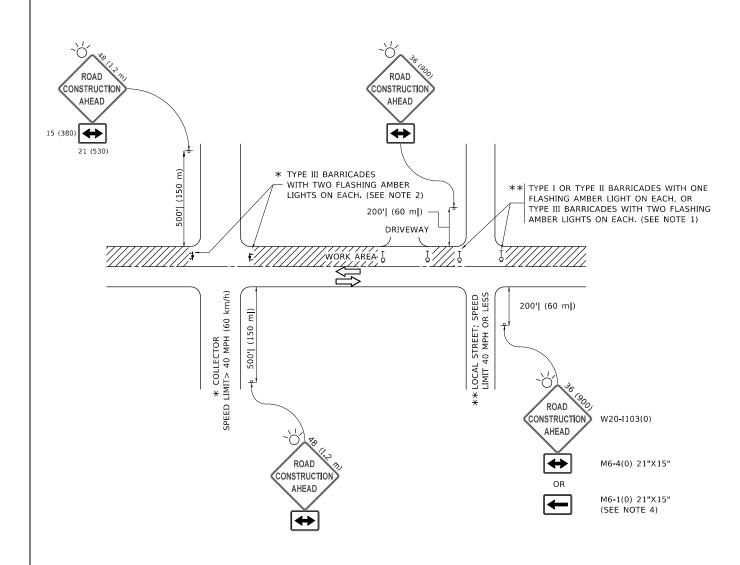

NOTES:

- 1. SIDE ROAD WITH A SPEED LIMIT OF 40 MPH (60 km/h) OR LESS AS SHOWN ON THE DRAWING AND AS DIRECTED BY THE ENGINEER:
- a) ONE "ROAD CONSTRUCTION AHEAD" SIGN 36 x 36 (900x900) WITH A FLASHER MOUNTED ON IT APPROXIMATELY 200' (60 m) IN ADVANCE OF THE MAIN ROUTE.
- b) THE CLOSED PORTION OF THE MAIN ROUTE SHALL BE PROTECTED BY BLOCKING WITH TYPE I, TYPE II OR TYPE III BARRICADES, 1/3 OF THE CROSS SECTION OF THE CLOSED PORTION.
- SIDE ROAD WITH A SPEED LIMIT GREATER THAN 40 MPH (60 km/h) AS SHOWN ON THE DRAWING AND AS DIRECTED BY THE ENGINEER:
- a) ONE "ROAD CONSTRUCTION AHEAD" SIGN 48 x 48 (1.2 m x 1.2 m) WITH A FLASHER MOUNTED ON IT APPROXIMATELY 500' (150 m) IN ADVANCE OF THE MAIN ROUTE.
- THE CLOSED PORTION OF THE MAIN ROUTE SHALL BE PROTECTED BY
 b) BLOCKING WITH TYPE III BARRICADES, 1/2 OF THE CROSS SECTION
 OF THE CLOSED PORTION.
- 3. CONES MAY BE SUBSTITUTED FOR BARRICADES OR DRUMS AT HALF THE SPACING DURING DAY OPERATIONS. CONES SHALL BE A MINIMUM OF 28 (710)
- WHEN THE SIDE ROAD LIES BETWEEN THE BEGINNING OF THE MAINLINE
 4. SIGNING AND THE WORK ZONE, A SINGLE HEADED ARROW (M6-1) SHALL
 BE USED IN LIEU OF THE DOUBLE HEADED ARROW (M6-4).

- 5. WHEN WORK IS BEING PERFORMED ON A SIDE ROAD OR DRIVEWAY, FOLLOW THE APPLICABLE STANDARD(S). THE DIRECTIONAL ARROW (M6-1 OR M6-4) SHALL BE COVERED OR REMOVED WHEN NO LONGER CONSISTENT WITH THE TRAFFIC CONTROL SET-UP.
- 6. ADVANCE WARNING SIGNS ARE TO BE OMITTED ON DRIVEWAYS UNLESS OTHERWISE SPECIFIED IN THE PLANS OR BY THE ENGINEER
- 7. THE TRAFFIC CONTROL AND PROTECTION FOR SIDE ROADS, INTERSECTIONS, AND DRIVEWAYS SHALL BE INCLUDED IN THE COST OF SPECIFIED TRAFFIC CONTROL STANDARDS OR ITEMS.

All dimensions are in inches (millimeters) unless otherwise shown.


USER NAME = footemj	DESIGNED - L.H.A.	REVISED - A. HOUSEH 10-15-96
	DRAWN -	REVISED - T. RAMMACHER 01-06-00
PLOT SCALE = 50.0000 / in.	CHECKED -	REVISED - A. SCHUETZE 07-01-13
PLOT DATE = 3/4/2019	DATE - 06-89	REVISED _ A. SCHUETZE 09-15-16


STATE OF ILLINOIS
DEPARTMENT OF TRANSPORTATION


TRAFFIC CONTROL AND PROTECTION FOR SIDE ROADS, INTERSECTIONS, AND DRIVEWAYS						
SCALE: NONE	SHEET	1 0	F 1	SHEETS	STA.	TO STA.


1		10-10	ILLINOIS	FED A	ID PROJECT	110.02	. 1 1 0
		TC-10			CONTRACT	NO 63	T16
	347 FAP 0347 22 BJ2			DUPAGE	39	33	
	F.A.P. RTE	SEC	TION		COUNTY	TOTAL SHEETS	SHE


t:10.dgm 3/4/2019 10:27:07 A

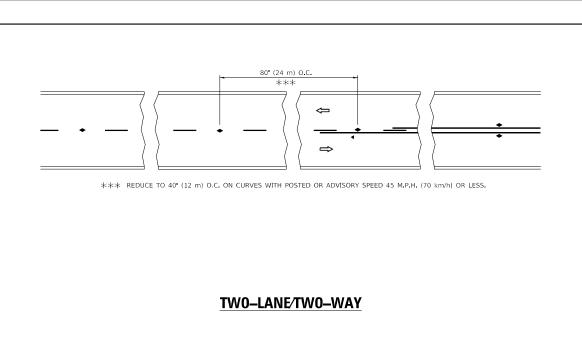


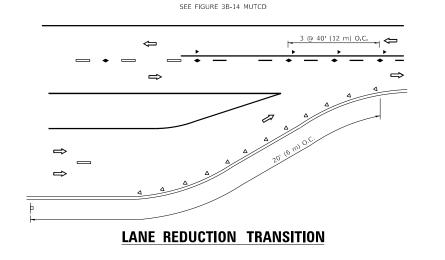

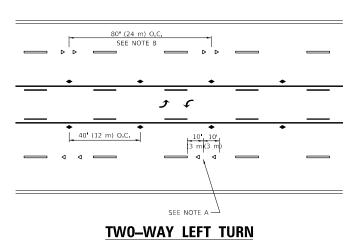

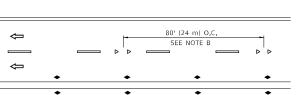


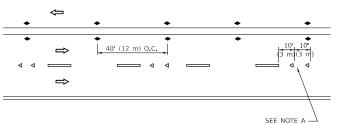


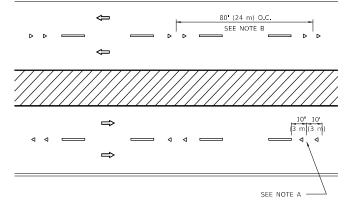

MULTI-LANE/UNDIVIDED



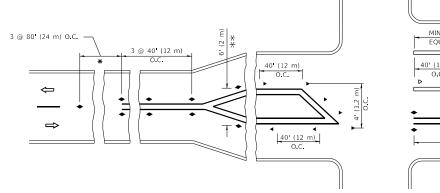

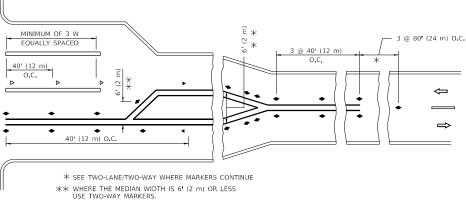

TURN LANES

GENERAL NOTES

- 1. MARKERS USED WITH DASHED LINES SHALL BE CENTERED IN THE GAP BETWEEN SEGMENTS.
- 2. MARKERS USED ADJACENT TO SOLID LINES SHALL BE OFFSET 2 TO 3 (50 TO 75) TOWARD TRAFFIC AS SHOWN.
- 3. MARKERS THROUGH TANGENTS LESS THAN 500' (150 m) IN LENGTH BETWEEN CURVES SHALL BE INSTALLED AT THE LESSER OF THE TWO CURVE SPACINGS.
- 4. MARKERS ARE TO BE USED ADJACENT TO BOTH SOLID WHITE LINES IN DUAL LEFT TURN LANES

LANE MARKER NOTES

- A. USE DOUBLE LANE LINE MARKERS SPACED AS SHOWN.
- B. REDUCE TO 40' (12 m) O.C. ON CURVES WHERE ADVISORY SPEEDS ARE 10 M.P.H (20 km/h) LOWER THAN POSTED SPEEDS.

DESIGN NOTES

- 1. DOUBLE LANE LINE MARKERS SHALL BE USED UNLESS SPECIFIED OTHERWISE.
- 2. EXCEPT AS SHOWN ON THE LANE REDUCTION TRANSITION AND FREEWAY EXIT RAMP DETAIL, MARKERS ARE NOT TO BE SPECIFIED ON RIGHT EDGE LINES.
- 3. THE EXACT MARKER LIMITS, SPACING, AND COLOR SHALL BE INCLUDED IN
- 4. MARKERS SHOULD NOT BE USED ALONGSIDE CURBS EXCEPT FOR EXTREMELY SHORT SECTIONS OF CURBS WHERE NOT MORE THAN TWO MARKERS WOULD BE INVOLVED.

All dimensions are in inches (millimeters) unless otherwise shown.

JSER NAME = footemj DESIGNED -REVISED - T. RAMMACHER 03-12-99 STATE OF ILLINOIS REVISED - T. RAMMACHER 01-06-00 DRAWN CHECKED REVISED - C. JUCIUS 09-09-09 **DEPARTMENT OF TRANSPORTATION** REVISED - C. JUCIUS 07-01-13 PLOT DATE = 3/4/2019 DATE

TYPICAL APPLICATIONS RAISED REFLECTIVE PAVEMENT MARKERS (SNOW-PLOW RESISTANT) SHEET 1 OF 1 SHEETS STA.

SECTION DUPAGE 39 34 FAP 0347 22 BJ2 CONTRACT NO. 62T16

SYMBOLS


ONE-WAY AMBER MARKER


TWO-WAY AMBER MARKER

ONE-WAY CRYSTAL MARKER (W/O)

YELLOW STRIPE

WHITE STRIPE

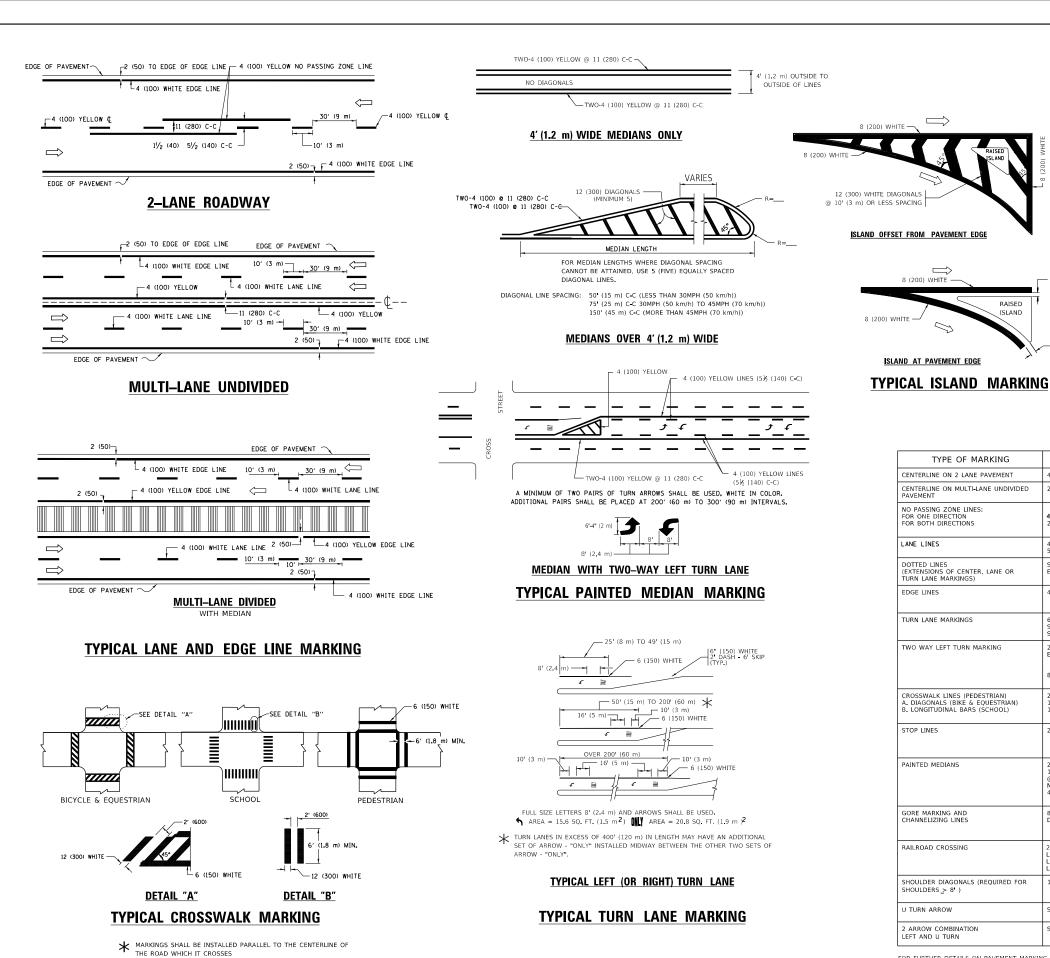

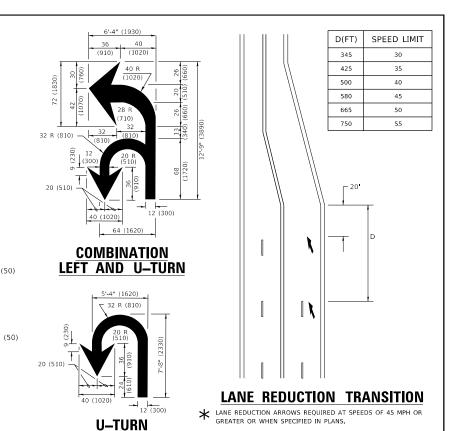

TYPE OF MARKING	WIDTH OF LINE	PATTERN	COLOR	SPACING / REMARKS
CENTERLINE ON 2 LANE PAVEMENT	4 (100)	SKIP-DASH	YELLOW	10' (3 m) LINE WITH 30' (9 m) SPACE
CENTERLINE ON MULTI-LANE UNDIVIDED PAVEMENT	2 @ 4 (100)	SOLID	YELLOW	11 (280) C-C
NO PASSING ZONE LINES: FOR ONE DIRECTION FOR BOTH DIRECTIONS	4 (100) 2 @ 4 (100)	SOLID SOLID	YELLOW YELLOW	5½ (140) C-C FROM SKIP-DASH CENTERLINE 11 (280) C-C OMIT SKIP-DASH CENTERLINE BETWEEN
LANE LINES	4 (100) 5 (125) ON FREEWAYS	SKIP-DASH SKIP-DASH	WHITE WHITE	10' (3 m) LINE WITH 30' (9 m) SPACE
DOTTED LINES (EXTENSIONS OF CENTER, LANE OR TURN LANE MARKINGS)	SAME AS LINE BEING EXTENDED	SKIP-DASH	SAME AS LINE BEING EXTENDED	2' (600) LINE WITH 6' (1.8 m) SPACE
EDGE LINES	4 (100)	SOLID	YELLOW-LEFT WHITE-RIGHT	OUTLINE MEDIANS IN YELLOW
TURN LANE MARKINGS	6 (150) LINE; FULL SIZE LETTERS & SYMBOLS (8' (2.4m))	SOLID	WHITE	SEE TYPICAL TURN LANE MARKING DETAIL
TWO WAY LEFT TURN MARKING	2 @ 4 (100) EACH DIRECTION 8' (2.4m) LEFT ARROW	SKIP-DASH AND SOLID IN PAIRS	YELLOW	10' (3 m) LINE WITH 30' (9 m) SPACE FOR SKIP-DASH; 5½ (140) C-C BETWEEN SOLID LINE AND SKIP-DASH LINE SEE TYPICAL TWO-WAY LEFT TURN MARKING DETAIL
CROSSWALK LINES (PEDESTRIAN) A. DIAGONALS (BIKE & EQUESTRIAN) B. LONGITUDINAL BARS (SCHOOL)	2 @ 6 (150) 12 (300) @ 45° 12 (300) @ 90°	SOLID SOLID SOLID	WHITE WHITE WHITE	NOT LESS THAN 6' (1.8 m) APART 2' (600) APART 2' (600) APART 5EE TYPICAL CROSSWALK MARKING DETAILS.
STOP LINES	24 (600)	SOLID	WHITE	PLACE 4 (1.2 m) IN ADVANCE OF AND PARALLEL TO CROSSWALK, IF PRESENT OTHERWISE, PLACE AT DESIRED STOPPING POINT. PARALLEL TO CROSSROAD CENTERLINE, WHERE POSSIBLE
PAINTED MEDIANS	2 @ 4 (100) WITH 12 (300) DIAGONALS @ 45° NO DIAGONALS USED FOR 4' (1.2 m) WIDE MEDIANS	SOLID	YELLOW: TWO WAY TRAFFIC WHITE: ONE WAY TRAFFIC	11 (280) C-C FOR THE DOUBLE LINE SEE TYPICAL PAINTED MEDIAN MARKING.
GORE MARKING AND CHANNELIZING LINES	8 (200) WITH 12 (300) DIAGONALS @ 45°	SOLID	WHITE	DIAGONALS: 15' (4.5 m) C-C (LESS THAN 30MPH (50 km/h)) 20' (6 m) C-C 30MPH (50 km/h) TO 45MPH (70 km/h)) 30' (9 m) C-C (OVER 45MPH (70 km/h))
RAILROAD CROSSING	24 (600) TRANSVERSE LINES; "RR" IS 6' (1.8 m) LETTERS; 16 (400) LINE FOR "X"	SOLID	WHITE	SEE STATE STANDARD 780001 AREA OF: "X"=3.6 SQ. FT. (0.33 m PEACH "X"=54.0 SQ. FT. (5.0 m P
SHOULDER DIAGONALS (REQUIRED FOR SHOULDERS > 8')	12 (300) @ 45°	SOLID	WHITE - RIGHT YELLOW - LEFT	50' (15 m) C-C (LESS THAN 30MPH (50 km/h)) 75' (25 m) C-C (30 MPH (50 km/h) TO 45MPH (70 km/h)) 150' (45 m) C-C (OVER 45MPH (70 km/h))
U TURN ARROW	SEE DETAIL	SOLID	WHITE	16.3 SF
2 ARROW COMBINATION LEFT AND U TURN	SEE DETAIL	SOLID	WHITE	30.4 SF

FOR FURTHER DETAILS ON PAVEMENT MARKING REFER TO STANDARD SPECIFICATIONS FOR ROAD AND BRIDGE CONSTRUCTION AND STATE STANDARD 780001.

SCALE: NONE

RAISED


All dimensions are in inches (millimeters) unless otherwise shown.

JSER NAME = footemj DESIGNED -EVERS C. JUCIUS 09-09-09 DRAWN REVISED -C. JUCIUS 07-01-13 HECKED REVISED -C. JUCIUS 12-21-15 DATE

STATE OF ILLINOIS **DEPARTMENT OF TRANSPORTATION**

SECTION DISTRICT ONE DUPAGE 39 35 FAP 0347 22 BJ2 TYPICAL PAVEMENT MARKINGS CONTRACT NO. 62T16 TC-13 OF 2 SHEETS STA. SHEET 1


TURN BAY ENTRANCE AT START OF LANE CLOSURE TAPER

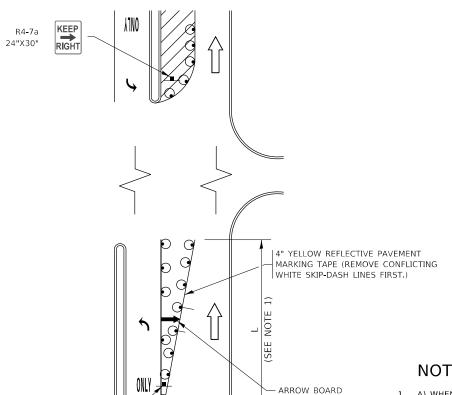



NOTES:

- 1. A) WHEN "L" IS ≤ THE STORAGE LENGTH OF THE TURN LANE (AS SHOWN IN FIG. 1), USE FIGURE 1.
 - B) WHEN "L" IS > THE STORAGE LENGTH OF THE TURN LANE OR THE TURN LANE IS WITHIN THE LANE CLOSURE, USE FIGURE 2.
- 2. CONES MAY BE SUBSTITUTED FOR BARRICADES OR DRUMS AT HALF THE SPACING DURING DAY OPERATIONS. CONES SHALL BE A MINIMUM OF 28 (710) IN HEIGHT.
- 3. LIGHTS WILL NOT BE REQUIRED ON BARRICADES OR DRUMS FOR DAY OPERATIONS. ALL LIGHTS SHALL BE MONODIRECTIONAL.
- 4. REFLECTIVE TEMPORARY PAVEMENT MARKINGS SHALL BE PLACED THROUGHOUT THE BARRICADED AREAS OF EACH TURN BAY AS SHOWN WHERE THE CLOSURE TIME IS GREATER THAN FOURTEEN (14) DAYS.
- 5. THIS APPLICATION ALSO APPLIES WHEN WORK IS BEING PERFORMED IN THE RIGHT LANE(S) AND THE RIGHT TURN BAY IS TO REMAIN OPEN. UNDER THIS CONDITION, "RIGHT TURN LANE" R3-I100R 24 x 24 (600 x 600) AND M6-2R 21 x 15 (530 x 380) SHALL BE USED.
- 6. THESE CONTROLS SHALL SUPPLEMENT MAINLINE TRAFFIC CONTROL FOR LANE CLOSURES.
- 7. THE SIGNS SHALL BE MOUNTED ABOVE THE BARRICADES/DRUMS ON SEPARATE SIGN SUPPORTS THAT MEET NCHRP 350 OR MASH PREOUIREMENTS.
- 8. TRAFFIC CONTROL AND PROTECTION AT TURN BAYS (TO REMAIN OPEN TO TRAFFIC) SHALL BE INCLUDED IN THE COST OF SPECIFIED TRAFFIC CONTROL STANDARDS OR ITEMS.

TURN BAY ENTRANCE WITHIN A LANE CLOSURE

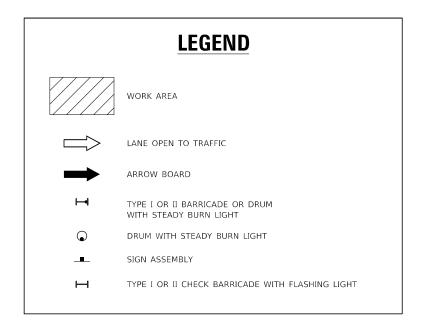

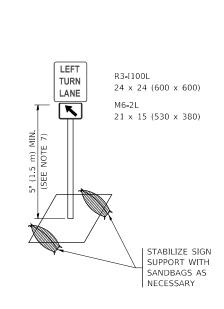

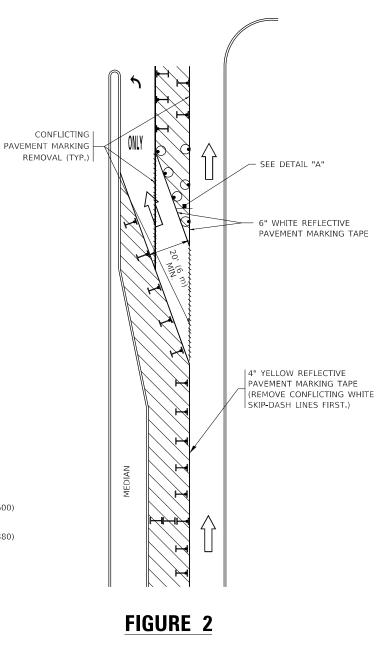

DETAIL A

SCALE: NONE

All dimensions are in inches (millimeters) unless otherwise shown.


SER NAME = footemj DESIGNED -T. RAMMACHER 09-08-94 REVISED - R. BORO 09-14-09 REVISED - A. SCHUETZE 07-01-13 DRAWN - A. HOUSEH 11-07-95 A. HOUSEH 10-12-96 REVISED - A. SCHUETZE 09-15-16 PLOT DATE = 3/4/2019 DATE - T. RAMMACHER 01-06-00 REVISED

FIGURE 1

STATE OF ILLINOIS **DEPARTMENT OF TRANSPORTATION**


TRAFF	IC CONTROL AND	PROTECTION AT TURN	BAYS	F.A.P. RTE	SECTION	COUNTY	TOTAL SHEETS	SHEET NO.
(TO REMAIN OPEN TO TRAFFIC)		347	FAP 0347 22 BJ2	DUPAGE	39	36		
	(10 ILIVIAIN	OI EN TO THATTIC			TC-14	CONTRACT	NO. 62	2T16
ME	SHEET 1 OF 1	SHEETS STA	TO STA		ILLINOIS SED A	ID BROJECT		

SEE DETAIL "A"

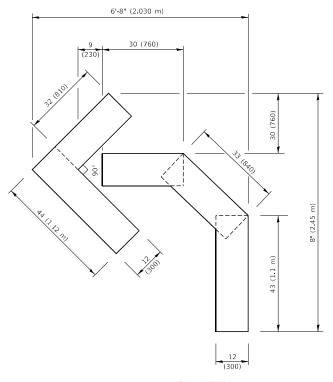


QUANTITY

4 (100) LINE = 45.5 ft. (13.9 m) 15.2 sq. ft. (1.41 sq. m)

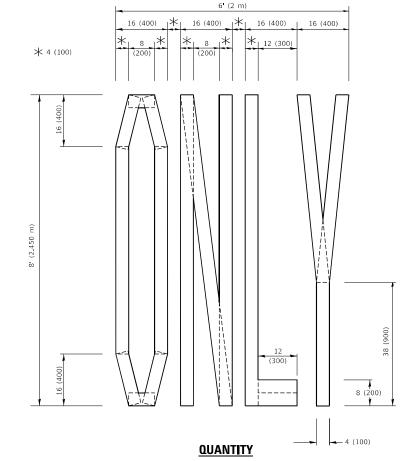

4 (100) LINE = 64.1 ft. (19.5 m) 21.4 sq. ft. (1.99 sq. m)

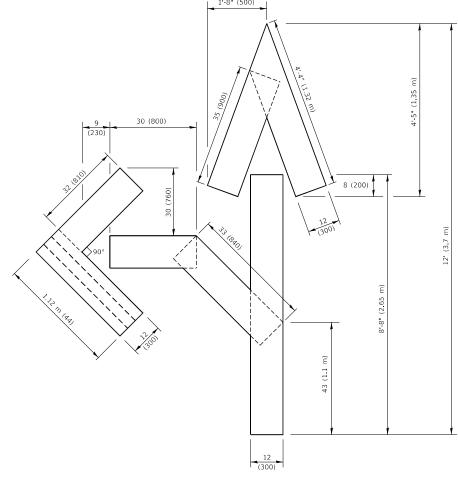


QUANTITY

4 (100) LINE = 82.5 ft. (25.1 m) 27.5 sq. ft. (2.53 sq. m)

NOTE:

ALL QUANTITIES OF PLACEMENT ARE REPRESENTED IN LINEAR FEET OF 4" LINES TO MATCH THE 4" TEMPORARY TAPE PAY ITEM AND REPRESENTS THE TOTAL QUANTITY OF 4" TAPE REQUIRED.

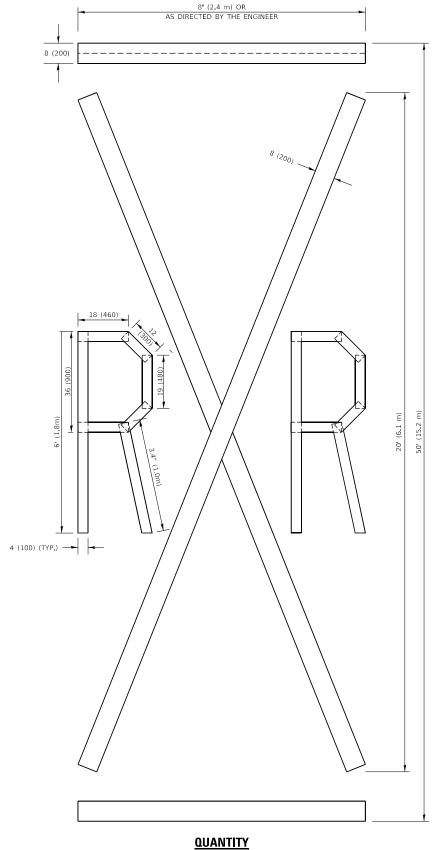

4 (100) LINE = 225.9 ft. (68.9 m) 75.3 sq. ft. (6.99 sq. m)


> All dimensions are in inches (millimeters) unless otherwise shown.

USER NAME = footemj	DESIGNED	-		REVISED	- T. RAMMACHER 03-02-98
	DRAWN	-		REVISED	- E. GOMEZ 08-28-00
PLOT SCALE = 50.0068 / in.	CHECKED	-		REVISED	- E. GOMEZ 08-28-00
PLOT DATE = 3/4/2019	DATE	-	09-18-94	REVISED	- A. SCHUETZE 09-15-16

STATE OF ILLINOIS **DEPARTMENT OF TRANSPORTATION**

	SHORT	TERM	PAV	EMENT	MARK	NG LETTE	RS AND	SYMBOLS	
SCALE:	NONE	SHEE	T 1	OF :	l SHEE	TS STA.		TO STA.	

F.A.P. RTE	SEC	TION	COUNTY	TOTAL SHEETS	SHE				
347	FAP 0347	22 BJ2	DUPAGE	39	37				
TC-16				CONTRACT NO. 62T16					
ILLINOIS FED. AI				ID PROJECT					

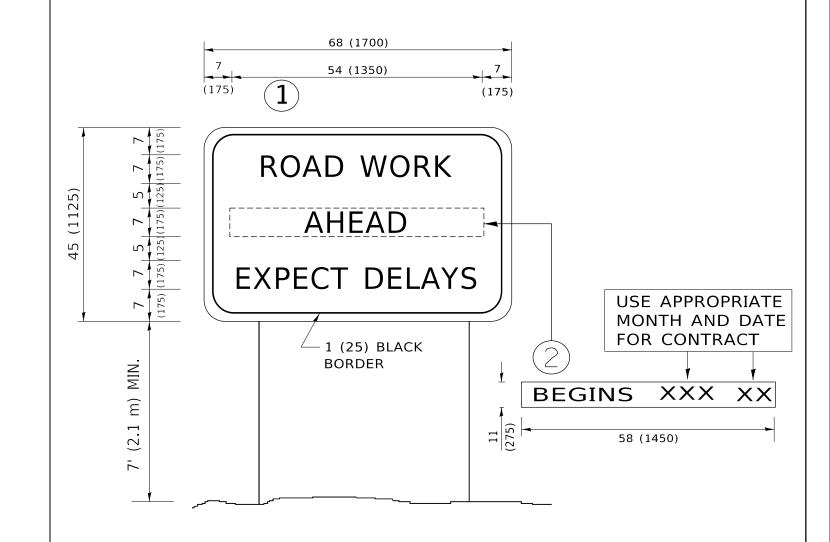


NOTES:

- 1. USE BLACK LETTERING ON ORANGE BACKGROUND.
- 2. ERECT SIGNS IN ADVANCE OF THE LOCATION FOR THE "ROAD CONSTRUCTION AHEAD" SIGN AT LOCATIONS AS DIRECTED BY THE ENGINEER.
- 3. ERECT SIGN 1 WITH INSTALLED PANEL 2 ONE WEEK PRIOR TO THE START OF CONSTRUCTION.
- 4. REMOVE PANEL(2)SOON AFTER THE START OF CONSTRUCTION.
- 5. SEE SPECIAL PROVISION FOR "TEMPORARY INFORMATION SIGNING" FOR ADDITIONAL INFORMATION.
- 6. ONE SIGN ASSEMBLY EQUALS 25.70 SQ. FT. (2.3 SQ. M.)
- 7. SHALL BE PAID FOR AS TEMPORARY INFORMATION SIGNING.

ALL DIMENSIONS ARE IN INCHES (MILLIMETERS) UNLESS OTHERWISE SHOWN.

USER NAME = footem)	DESIGNED -	REVISED - R. MIRS 09-15-97	07477 07 W.W.010	ARTERIAL ROAD INFORMATION SIGN			F.A.P. RTE	SECTION	COUNTY	TOTAL SHEETS	SHEET NO.		
	DRAWN -	REVISED - R. MIRS 12-11-97	STATE OF ILLINOIS				347	FAP 0347 22 BJ2	DUPAGE	39	38		
PLOT SCALE = 50.0000 / in	CHECKED -	REVISED -T. RAMMACHER 02-02-99	DEPARTMENT OF TRANSPORTATION						TC-22	CONTRAC	T NO. 62	T16	
PLOT DATE = 3/4/2019	DATE -	REVISED - C. JUCIUS 01-31-07		SCALE: NONE	SHEET 1	OF 1 SHEETS	S STA.	TO STA.		ILLINOIS	FED. AID PROJECT		

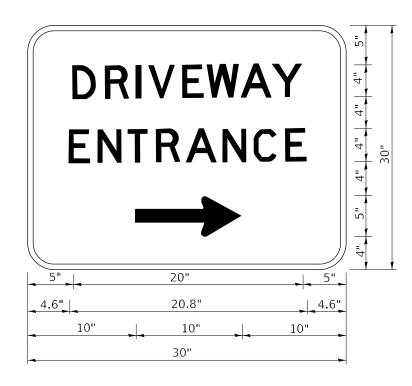

3.0" RADIUS, 0.5" BORDER, WHITE ON GREEN; REFLECTORIZED "DRIVEWAY" D; "ENTRANCE" D; STANDARD ARROW CUSTOM 12.0" x 5.0"

NOTES:

- 1. HALF OF THE SIGNS WILL REQUIRE A LEFT HAND FACING ARROW.
- 2. TWO SIGNS SHALL BE USED AT EACH COMMERCIAL ENTRANCE PLACED BACK-TO-BACK: ONE WITH A RIGHT HAND ARROW (SHOWN) SHALL BE PLACED ON THE NEAR RIGHT SIDE THE DRIVEWAY AND ONE WITH A LEFT HAND ARROW SHALL BE PLACED ON THE FAR LEFT SIDE OF THE DRIVEWAY.
- 3. SIGNS TO BE PAID FOR AS ITEM "TEMPORARY INFORMATION SIGNING".

STATE OF ILLINOIS
DEPARTMENT OF TRANSPORTATION