06-16-2017 LETTING ITEM 225

## STATE OF ILLINOIS DEPARTMENT OF TRANSPORTATION

FOR INDEX OF SHEETS, SEE SHEET NO. 2

# PLANS FOR PROPOSED FEDERAL AID HIGHWAY

TRAFFIC DATA

WINCHESTER AVENUE = 500

POSTED SPEED LIMIT:

WINCHESTER AVENUE = 30 MPH

**DESIGN DESIGNATION: LOCAL ROAD** 


WINCHESTER AVENUE
OGDEN AVENUE TO MIDDLETON AVENUE
SIDEWALK CONSTRUCTION

SECTION: 15-00061-00-SW

PROJECT: SRTS-4009(342)

VILLAGE OF LISLE DuPAGE COUNTY C-91-035-16


PROJECT LOCATED IN VILLAGE OF LISLE

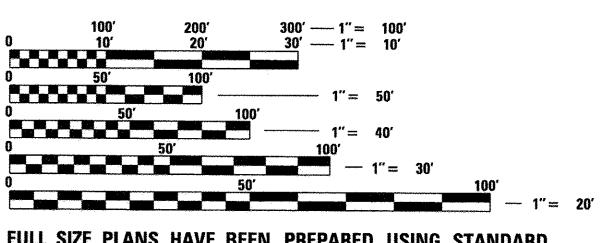

FULL SIZE PLANS HAVE BEEN PREPARED USING STANDARD ENGINEERING SCALES. REDUCED SIZED PLANS WILL NOT CONFORM TO STANDARD SCALES. IN MAKING MEASUREMENTS ON REDUCED PLANS, THE ABOVE SCALES MAY BE USED.

J.U.L.I.E.
JOINT UTILITY LOCATION INFORMATION FOR EXCAVATION
1-800-892-0123
OR 811

CONTRACT NO. 61D69

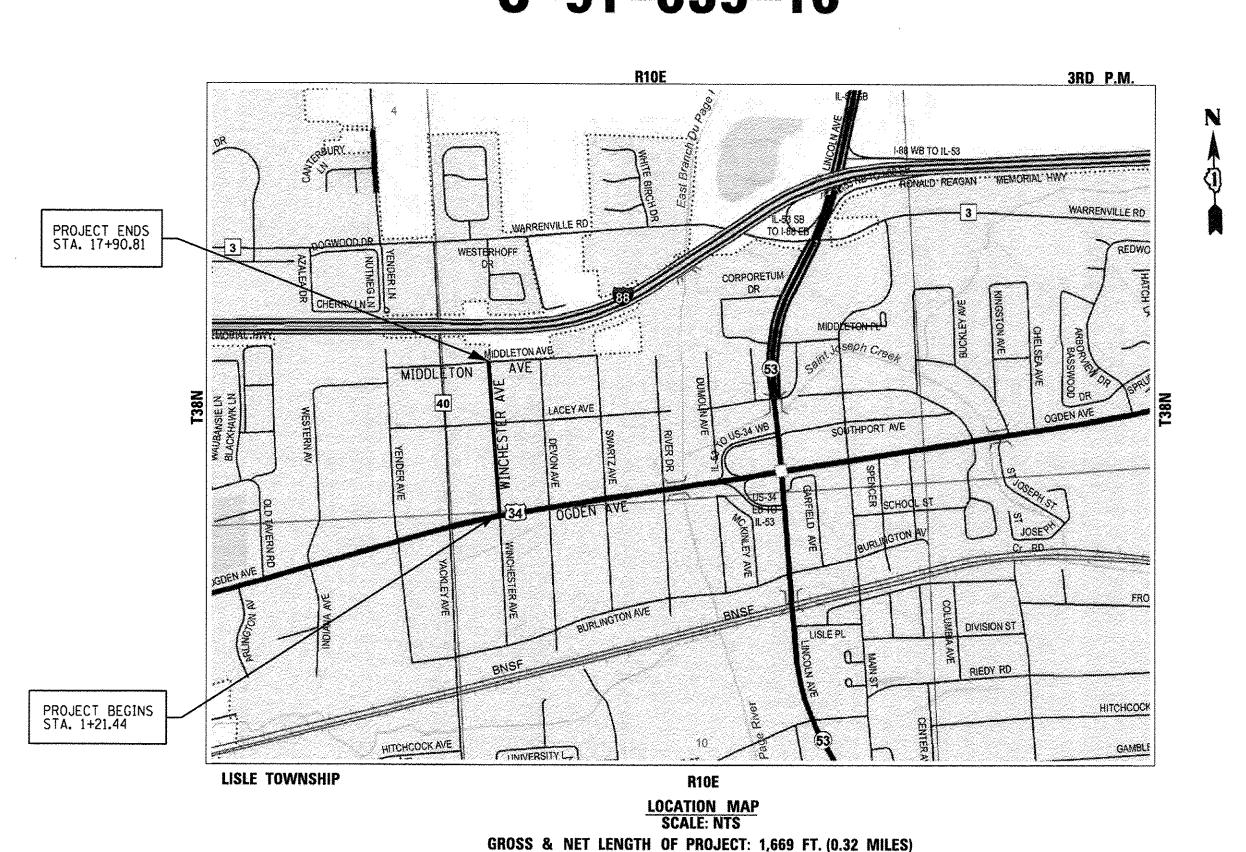

CAPROLI

OOLE

DE KALE

GRENDAL

WARREN

MARSHALL

LA SALLE

GRUNDY

KANK MEE

KANK MARSHALL

LOGAN

DE WIT:

CASS


WARREN

KANK MEE

KA

15-00061-00-SW

ILLINOIS CONTRACT NO. 61D69

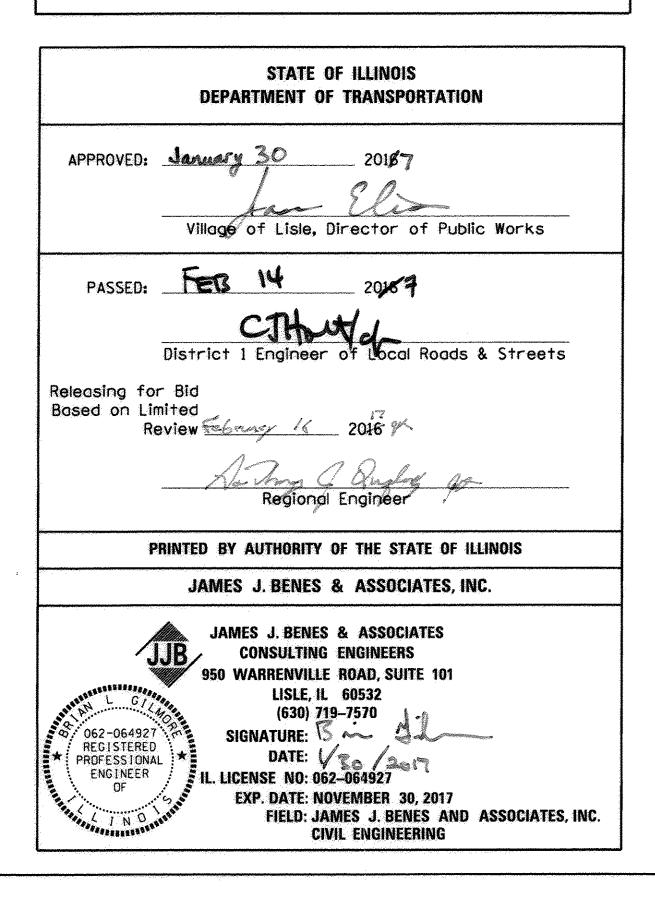

#### INDEX OF SHEETS

SHEET NO.	TITLE						
1	TITLE SHEET						
2	INDEX OF SHEETS, GENERAL NOTES, STATE STANDARDS AND BENCH MARKS						
3	SUMMARY OF QUANTITIES						
4	TYPICAL SECTIONS						
5	SCHEDULES OF QUANTITIES						
6-7	GEOMETRIC PLANS						
8-9	EROSION AND SEDIMENT CONTROL PLANS						
10-11	CONSTRUCTION DETAILS						
12-13	DISTRICT DETAILS						
14-26	CROSS SECTIONS						

#### BENCH MARKS

- BM #1: TOP NORTHWEST FLANGE BOLT ON FIRE HYDRANT. FIRE HYDRANT LOCATED AT THE NORTHWEST CORNER OF WINCHESTER AVENUE AND OGDEN AVENUE, NEAR STA. 1+21, 44' LEFT. ELEVATION = 718.69 (NAVD88)
- BM #2: TOP NORTHEAST FLANGE BOLT ON FIRE HYDRANT.
  FIRE HYDRANT LOCATED ALONG EAST SIDE OF
  WINCHESTER AVENUE NEAR ADDRESS 4613, STA.
  7+81, 24' RIGHT.
  ELEVATION = 710.65 (NAVD88)
- BM #3: TOP NORTHWEST FLANGE BOLT ON FIRE HYDRANT. FIRE HYDRANT LOCATED AT THE NORTHWEST CORNER OF WINCHESTER AVENUE LACEY AVENUE, NEAR STA. 11+18, 38' LEFT. ELEVATION = 699.76 (NAVD88)
- BM #4: TOP NORTH FLANGE BOLT ON FIRE HYDRANT. FIRE HYDRANT LOCATED ALONG EAST SIDE OF WINCHESTER AVENUE NEAR ADDRESS 4509, STA. 14+38, 21' RIGHT. ELEVATION = 707.46 (NAVD88)
- BM #5: TOP SOUTHEAST FLANGE BOLT ON FIRE HYDRANT. FIRE HYDRANT LOCATED AT THE SOUTHEAST CORNER OF WINCHESTER AVENUE AND MIDDLETON AVENUE, NEAR STA. 17+41, 34' RIGHT. ELEVATION = 716.37 (NAVD88)

Dupage county bench mark: No. Li03004, Top of Bronze disk monument established in southwest corner of concrete structure over ogden avenue (US ROUTE 34) BRIDGE OVER THE EAST BRANCH Dupage RIVER.

ELEVATION = 669.28 (NAVD 29) = 669.01 (NAVD 88)

COMMITMENTS: NONE

### DESIGNED BDH REVISED — DRAWN — SMP REVISED — CHECKED — BDH REVISED —

REVISED

DATE — 1/27/2017

#### GENERAL NOTES

- 1. ACCESS TO LOCAL RESIDENCES AND BUSINESSES SHALL BE MAINTAINED DURING CONSTRUCTION.
- 2. THE CONTRACTOR SHALL GIVE THE ENGINEER, MUNICIPALITY, AND JAMES J. BENES AND ASSOCIATES, INC. THREE (3) WORKING DAYS NOTICE PRIOR TO THE COMMENCEMENT OF WORK. (VILLAGE OF LISLE: (630) 271-4170) (JAMES J. BENES AND ASSOCIATES, INC.: (630) 719-7570)
- 3. ALL ELEVATIONS ARE ON NAVD 88 DATUM.
- 4. DO NOT SCALE PLANS FOR CONSTRUCTION DIMENSIONS.
- 5. THE ENGINEER OR THE OWNER, SHALL NOT ASSUME ANY OF THE RESPONSIBILITIES OF THE CONTRACTOR'S SUPERINTENDENT OR OF SUBCONTRACTORS. ADDITIONALLY, THE ENGINEER OR OWNER, SHALL NOT ADVISE ON, OR ISSUE DIRECTIONS CONCERNING, ASPECTS OF CONSTRUCTION MEANS, METHODS, TECHNIQUES, SEQUENCES OR PROCEDURES, OR SAFETY PRECAUTIONS AND/OR PROGRAMS IN CONNECTION WITH THE WORK.
- 6. THE LOCATIONS OF PUBLIC OR PRIVATE UTILITIES SHOWN ON THE PLANS ARE APPROXIMATE AND THEIR ACCURACY IS NOT GUARANTEED. THE CONTRACTOR SHALL VERIFY THE EXACT LOCATION AND ELEVATION OF ALL UTILITIES. THE CONTRACTOR SHALL REPORT ANY ENCOUNTERED DISCREPANCIES TO THE ENGINEER AT ONCE. THE CONTRACTOR SHALL TAKE DUE CARE IN ALL PHASES OF CONSTRUCTION TO PROTECT ANY UTILITIES WHICH MAY BE AFFECTED BY THE WORK. ANY DAMAGE TO EXISTING UTILITIES SHALL BE REPAIRED AT THE CONTRACTOR'S EXPENSE IN ACCORDANCE WITH ARTICLES 105.07, 107.20, AND 107.39.
- 7. THE CONTRACTOR SHALL KEEP THE CONSTRUCTION AREA FREE OF DEBRIS DURING CONSTRUCTION. THE CONTRACTOR SHALL INSPECT THE SITE DAILY FOR DEBRIS ON THE ROADWAY SURFACE IN ACCORDANCE WITH ARTICLE 107.15. THE RIGHT—OF—WAY SHALL BE RESTORED TO PRE—CONSTRUCTION CONDITION IN ACCORDANCE WITH ARTICLE 107.20.
- 8. THE CONTRACTOR SHALL MAINTAIN ALL EXISTING DRAINAGE FACILITIES DURING CONSTRUCTION AND SHALL REPAIR ANY DRAINAGE FACILITIES DAMAGED DURING CONSTRUCTION.
- 9. THE CONTRACTOR SHALL VERIFY THE ELEVATIONS OF EXISTING STORM SEWERS PRIOR TO THE CONSTRUCTION OF PROPOSED STORM SEWER.
- 10. THE RELOCATION OF SIGNS ARE INCLUDED IN THE COST OF THE CONTRACT AND WILL NOT BE PAID FOR SEPARATELY IN ACCORDANCE WITH ARTICLE 107.25.
- 11. BEFORE STARTING ANY EXCAVATION, THE CONTRACTOR SHALL CALL "J.U.L.I.E." AT (800) 892-0123 FOR FIELD LOCATIONS OF BURIED ELECTRIC, TELEPHONE, GAS, SEWERS AND WATER UTILITIES. (48 HOUR NOTIFICATION IS REQUIRED.)
- 12. THE CONTRACTOR SHALL COORDINATE ALL CONSTRUCTION ACTIVITIES WITH ALL UTILITY COMPANIES AND THE VILLAGE OF LISLE.
- 13. SAW CUTTING OF PAVEMENT, SHOULDERS, CURB AND GUTTER, ETC. SHALL BE TO FULL DEPTH AND SHALL RESULT IN CLEAN, STRAIGHT EDGE ON THE PORTION REMAINING.
- 14. THE CONTRACTOR SHALL BE RESPONSIBLE FOR ANY DAMAGE MADE BY THE CONTRACTOR TO THE IRRIGATION SYSTEMS AND IT SHALL BE REPAIRED IN ACCORDANCE WITH ARTICLE 107.20. THE CONTRACTOR WILL DETERMINE THE LOCATIONS OF DAMAGE AND EXTENT OF DAMAGE. ALL LOCATIONS OF REPAIR WORK AND EXTENT OF REPAIR SHALL BE APPROVED BY THE ENGINEER PRIOR TO PERFORMING THE WORK. THE SPRINKLER LINES SHALL BE PRESSURE TESTED. ANY PRESSURE LEAKS SHALL BE IDENTIFIED AND REPAIRS MADE PRIOR TO RETESTING THE SYSTEM FOR APPROVAL. ALL MATERIAL, LABOR AND EQUIPMENT USED TO LOCATE, REPAIR AND TEST THE DAMAGED IRRIGATION SYSTEMS WILL NOT BE PAID FOR SEPARATELY BUT SHALL BE INCLUDED IN THE UNIT BID PRICE OF THE CONTROLLING ITEM BEING WORKED ON AT THE TIME OF DAMAGE.
- 15. ALL CONSTRUCTION SHALL BE DONE IN ACCORDANCE WITH THE "STANDARD SPECIFICATIONS FOR ROAD AND BRIDGE CONSTRUCTION", ADOPTED APRIL 1, 2016: THE "SUPPLEMENTAL SPECIFICATIONS AND RECURRING SPECIAL PROVISIONS", ADOPTED JANUARY 1, 2017: THE LATEST EDITION OF THE "ILLINOIS MANUAL ON UNIFORM TRAFFIC CONTROL DEVICES FOR STREETS AND HIGHWAYS" (MUTCD), "STANDARD SPECIFICATIONS FOR WATER AND SEWER MAIN CONSTRUCTION IN ILLINOIS" JULY 2014 SEVENTH EDITION, THE "DETAILS" IN THE PLANS AND THE "SPECIAL PROVISIONS" INCLUDED IN THE CONTRACT DOCUMENTS.

#### LIST OF STATE STANDARDS

000001-06	STANDARD SYMBOLS, ABBREVIATIONS AND PATTERNS
280001-07	TEMPORARY EROSION CONTROL SYSTEMS
424001-09	PERPENDICULAR CURB RAMPS FOR SIDEWALKS
542401-02	METAL END SECTION FOR PIPE CULVERT
602301-04	INLET - TYPE A
604001-04	FRAME AND LIDS TYPE 1
604036-03	GRATE TYPE 8
701006-05	OFF-RD OPERATIONS, 2L, 2W, 15' (4.5 M) TO 24" (600 mm) FROM PAVEMENT EDGE
701301-04	LANE CLOSURE, 2L, 2W, SHORT TIME OPERATIONS
701501-06	URBAN LANE CLOSURE, 2L, 2W, UNDIVIDED
701801-06	LANE CLOSURE MULTILANE 1W OR 2W CROSSWALK OR SIDEWALK CLOSURE
701901-06	TRAFFIC CONTROL DEVICES

#### LIST OF DISTRICT ONE DETAILS

TC-10	TRAFFIC CONTROL AND PROTECTION INTERSECTIONS, AND DRIVEWAYS	FOR	SIDE	ROADS

TC-13 DISTRICT ONE TYPICAL PAVEMENT MARKINGS

STATE OF ILLINOIS	INDEX OF SHEETS, GENERAL NOTE
DEPARTMENT OF TRANSPORTATION	WINCH

JJB	JAMES J. BENES & ASSOCIATES, INC.
	950 Warrenville Road, Suite 101, Lisle, Illinois 60532 Tel. (630) 719-7570 • Fax (630) 719-7589

CODE NO.

20100110 TREE REMOVAL (6 TO 15 UNITS DIAMETER)

20100210 TREE REMOVAL (OVER 15 UNITS DIAMETER)

20201200 | REMOVAL AND DISPOSAL OF UNSUITABLE MATERIAL

20101000 TEMPORARY FENCE

★ 20101200 | TREE ROOT PRUNING

20400800 FURNISHED EXCAVATION

28000400 PERIMETER EROSION BARRIER

28000500 INLET AND PIPE PROTECTION

40201000 AGGREGATE FOR TEMPORARY ACCESS

40800029 BITUMINOUS MATERIALS (TACK COAT)

42300200 PORTLAND CEMENT CONCRETE DRIVEWAY PAVEMENT, 6 INCH

42400200 PORTLAND CEMENT CONCRETE SIDEWALK 5 INCH

SEGMENTAL CONCRETE BLOCK WALL

54213660 PRECAST REINFORCED CONCRETE FLARED END SECTIONS 15"

20800150 TRENCH BACKFILL

28000510 INLET FILTERS

42001300 PROTECTIVE COAT

42400800 DETECTABLE WARNINGS

54215545 METAL END SECTIONS 10"

54215547 METAL END SECTIONS 12"

550A0070 STORM SEWERS, CLASS A, TYPE 1 15"

550B0040 | STORM SEWERS, CLASS B, TYPE 1 10"

52200800

44000200 DRIVEWAY PAVEMENT REMOVAL

44201725 CLASS D PATCHES, TYPE I, 7 INCH

l	DESIGNED	******	BDH	REVISED	-	 :
I	DRAWN	····	SMP	REVISED	_	
	CHECKED		BDH	REVISED		
	DATE		1/27/2017	REVISED		

#### STATE OF ILLINOIS DEPARTMENT OF TRANSPORTATION

SCALE:

SUMMARY OF QUANTITIES							SECTION	
		WINCHE	STER	AVENUE		- ]	15-00061-00-SI	
NONE	SHEET NO.	OF SHE	ETS	STA. TO STA.			ILLINOIS	

CODE NO. QUANTITY 550B0050 | STORM SEWERS, CLASS B, TYPE 1 12" 102 550B0340 STORM SEWERS, CLASS B, TYPE 2 12" FOOT 28 55100500 STORM SEWER REMOVAL 12" 29 56500600 DOMESTIC WATER SERVICE BOXES TO BE ADJUSTED EACH 60236200 INLETS, TYPE A, TYPE 8 GRATE 60406000 FRAMES AND LIDS, TYPE 1, OPEN LID EACH 60406100 FRAMES AND LIDS, TYPE 1, CLOSED LID 67100100 MOBILIZATION LSUM 70102620 TRAFFIC CONTROL AND PROTECTION, STANDARD 701501 LSUM 70102640 TRAFFIC CONTROL AND PROTECTION, STANDARD 701801 LSUM 78000600 THERMOPLASTIC PAVEMENT MARKING - LINE 12" FOOT 235 235 Z0013798 | CONSTRUCTION LAYOUT Z0017400 DRAINAGE & UTILITY STRUCTURES TO BE ADJUSTED EACH Z0017700 DRAINAGE & UTILITY STRUCTURES TO BE RECONSTRUCTED EACH SQ YD 224 Z0066500 STABILIZED DRIVEWAYS 7" 224 A2007118 TREE, QUERCUS RUBRA (NORTHERN RED OAK), 2" CALIPER, BALLED AND BURLAPPED EACH EACH A2008518 TREE, ULMUS MORTON GLOSSY (TRIUMPH ELM), 2" CALIPER, BALLED AND BURLAPPED B2001116 TREE, CERCIS CANADENSIS (EASTERN REDBUD), 2" CALIPER, TREE FORM, BALLED AND BURLAPPED EACH ACRE 0.5 X2500900 SEEDING, CLASS 1 (SPECIAL) 0.5 EACH X6026050 | SANITARY MANHOLES TO BE ADJUSTED EACH XX001877 SUMP PUMP LINE CONNECTION XX007761 BUFFALO BOX ADJUSTMENT, SPECIAL EACH 5

CONSTRUCTION TYPE CODES

COUNTY

FED. AID PROJECT

DUPAGE 26 3

CONTRACT NO. 61D69

MPROVEMENT

	· · · · · · · · · · · · · · · · · · ·		· · · · · ·		
CONSTRUCTION	ON TYPE CODES				
VOSCO 110-011				LEGEND	
SAFETY IPROVEMENT	The state of the s		* -	DENOTES SPECIALTY	ITEMS
80% FED	***************************************				
20% LOCAL 0021					
54					
		***************************************			
16		value property and the second			
		*			
125					
***					
6	######################################				
340	***************************************				
<u> </u>	CONTROL CONTRO				
16					
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26					
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72					
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60					
371		1			
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205					
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IMPROVEMENT

20% LOCAL

UNIT QUANTITY

16

FOOT 125

EACH

CU YD

FOOT

EACH

EACH

POUNDS 101

SQ YD 922

SQ YD 22

SQ FT 8,096

SQ FT 60

SQ YD 371

205

SQ YD

SQ FT

EACH

EACH

EACH


FOOT

FOOT

23


CU YD 26

72

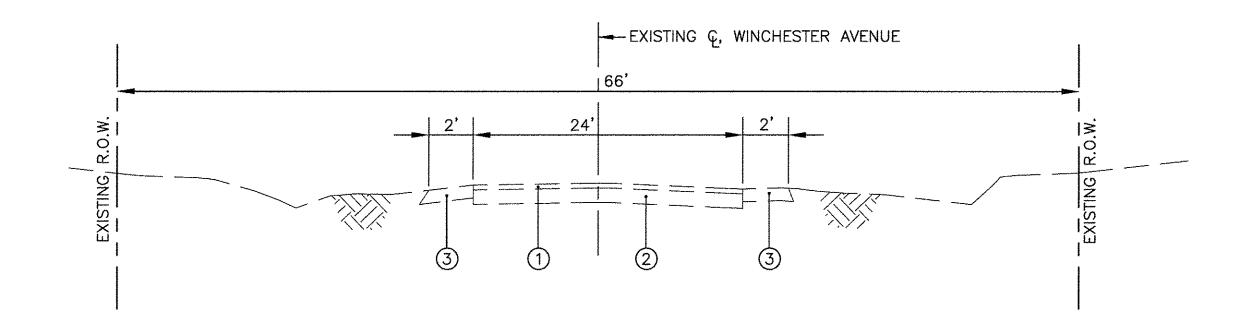


#### EXISTING TYPICAL SECTION-WINCHESTER AVENUE

STA. 1+21.44 (OGDEN AVENUE) TO STA. 17+90.81 (MIDDLETON AVENUE)

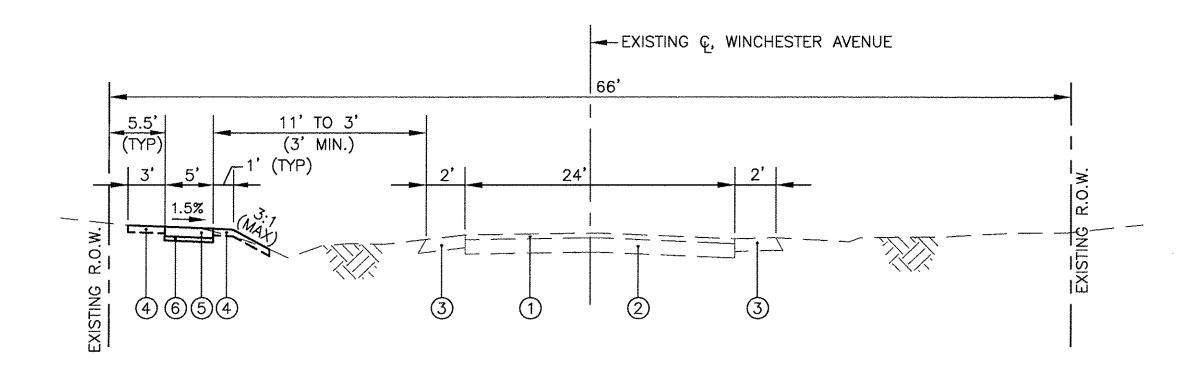

#### PROPOSED TYPICAL SECTION-WINCHESTER AVENUE

STA. 1+21.44 (OGDEN AVENUE) TO STA. 11+00.00 (LACEY AVENUE)

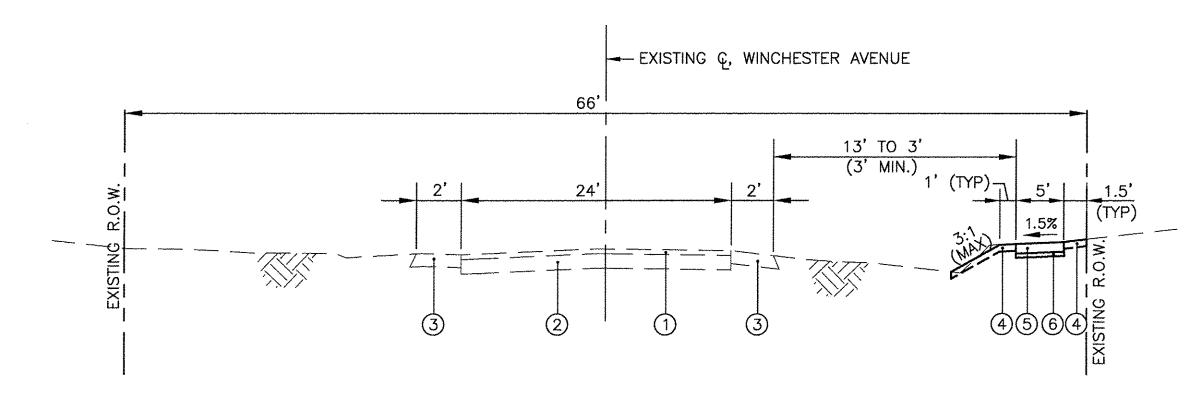

PROPOSED TYPICAL SECTION-WINCHESTER AVENUE

STA. 11+00.00 (LACEY AVENUE) TO STA. 17+90.81 (MIDDLETON AVENUE)

#### **LEGEND**

- 1) EXISTING HOT-MIX ASPHALT SURFACE COURSE, 2" & VARIES
- 2 EXISTING HOT-MIX PAVEMENT, 6" & VARIES
- 3 EXISTING AGGREGATE SHOULDERS, 12" & VARIES
- 4 SEEDING, CLASS 1 (SPECIAL)
  (INCLUDES 4" PULVERIZED TOP SOIL AND FERTILIZER)
  (AT LOCATIONS DESIGNATED BY THE ENGINEER)
- 5 PORTLAND CEMENT CONCRETE SIDEWALK 5"
  (AT ENTRANCES, THE SIDEWALK SHALL BE INCREASED TO THE THICKNESS OF THE DRIVEWAY PAVEMENT, COST INCLUDED IN P.C.C. SIDEWALK 5")
- 6 SUB-BASE GRANULAR MATERIAL, TYPE B (COST INCLUDED IN P.C.C. SIDEWALK 5")

#### HOT-MIX ASPHALT MIXTURE REQUIREMENTS

MIXTURE TYPE	AIR VOIDS
PATCHING	<u></u>
CLASS D PATCHES, 7" (2 LIFTS) (HMA BINDER IL-19mm)	4% @ 70 Gyr.
DRIVEWAYS	
HOT-MIX ASPHALT SURFACE COURSE, MIX "D", N50, 2", (IL-9.5mm)	4% @ 50 Gyr.
HOT-MIX ASPHALT BASE COURSE, 5" (HMA BINDER IL-19mm)	4% @ 50 Gyr.

#### NOTES:

SCALE: NONE

- 1) THE UNIT WEIGHT USED TO CALCULATE ALL HMA QUANTITIES IS 112 LB/SY/IN.
- 2) THE "AC TYPE" FOR POLYMERIZED HMA MIXES SHALL BE "SBS/SBR PG 76-22" AND FOR NON-POLYMERIZED HMA THE "AC TYPE" SHALL BE "PG 64-22" UNLESS MIDIFIED BY DISTRICT ONE SPECIAL PROVISIONS.
- 3)FOR USE OF RECYCLED MATERIAL SEE SPECIAL PROVISIONS.

		-
fillitin.	JAMES J. BENES & ASSOCIATES, INC.	
	950 Warrenville Road, Suite 101, Lisle, Illinois 60532	
	Tel. (630) 719-7570 • Fax (630) 719-7589	

DESIGNED	 BDH	REVISED	 Contract Management Contracts
DRAWN	 TLA	REVISED	 
CHECKED	 BDH	REVISED	 Angular paladit Angula
DATE	 1/27/2017	REVISED	 were the second second

STATE	0F	ILLINOIS	
DEPARTMENT	<b>OF</b>	TRANSPORTATION	

TYPCIAL SECTIONS	F.A.U. RTE.	SECTION	COUNTY	TOTAL SHEETS	SHEET NO.
WINCHESTER AVENUE		15-00061-00-SW	DuPAGE	26	4
			CONTRACT	NO. 6	1D69
SHEET NO OF - SHEETS   STA TO STA		ILLINOIS FED. AI	D PROJECT		

		<del></del>	
TREE RE	MOVAL	(6 TO 15	UNIT DIA)
	OFF	SET	QUANTITY
STATION	(FOOT)	(LT/RT)	(UNIT)
WINCHEST	ER AVE	•	
12+65	22	RT	8
15+58	26	RT	10
16+14	26	RI	12
16+47	25	RT	12
17+05	25	RT	12
TOT	AL		54
-			

(1	TREE R	EMOVA	
	OFFSET		QUANTITY
STATION	(FOOT)	(LT/RT)	(UNIT)
WINCHES	TER AVE	<u>NUE</u>	
12+54	18	RT	16
TOT	AL		16

TREE ROOT PRUNING			
	OFF	SET	QUANTITY
STATION	(FOOT)	(LT/RT)	(EACH)
WINCHEST	ER AVE		
5+33	26	LT	1
10+18	25	LT	1
10+47	24	LT	1
11+80	31	RT	1
12+04	30	RT	1
14+01	25	RT	1
TOT	AL		6

INLET AND PIPE			
PROTECTION			
STATION	STATION OFFSET QI		
	\ <u>=</u> \	(EACH)	
WINCHESTE	R AVENUE		
7+44	15.9' LT	1	
8+47	15' LT	1	
9+34	18.2' LT	1	
14+01	17.2' RT	1	
14+29	17.8' RT	1	
14+94	17.1' RT	1	
15+68	17.4' RT	· ·	
16+87	16.8' RT	1	
17+48	41.6' RT	No.	
тот	LAL	9	

INLET FILTERS					
STA	STATION				
FROM	OFFSET (FEET)	QUANTITY (EACH)			
WINCHESTE	R AVENUE				
1+31	24.67' LT	4			
1+39	14.87' LT	1			
3+33	15.54' LT	1			
10+50	15.33' LT	1			
10+81	15.06' LT	1			
11+76	17.33' RT	1			
12+35	13.35' RT	1			
12+91	14.13' RT	<b>Y</b> ester			
тот	AL	8			

SEGMENTAL CONCRETE BLOCK WALL				
	,	LENGTH	AVERAGE	QUANTITY
LOCATION	OFF SET	(FOOT)	IEIGHT (FOOT	(SQ FT)
/INCHESTER AVENUE 12+35	RT	40	2.3	92
13+50	RT	75	1.5	112.5

CONCRE	TE END SEC	TIONS, 15"
STATION	TION (FOOT)	
INCHESTE	R AVE	
3+30	26	1
	OTAL	1

METALI	END SECT	ioivs, io
	OFFSET	QUANTITY
STATION	(LT/RT)	(EACH)
 <u>Winchest</u>	ER AVE	
14+25	RT	1
I TOTAL		<u>l</u> 1

	OFFSET	QUANTITY
STATION	(LT/RT)	(EACH)
 INCHESTE	R AVE	
17+41	RT	· ·
17+48	RT	r r
TOTAL		2

		ER SERV DJUSTE	ICE BOX
	OFF	SET	QUANTITY
STATION	(FOOT)	(LT/RT)	(EACH)
WINCHEST	ER AVE		
3+28	27	LT	1
7+40	29	LT	1
TOT	AL		2

at: to make the State Manager of		.ID	E1, OPEN
	OFF	SET	QUANTITY
STATION	(FOOT)	(LT/RT)	(EACH)
WINCHEST 1+31	ER AVE 25	LT	4
TOI	ΔΙ		1

FRAI		LIDS, T	YPE 1,
	OFF	SET	QUANTITY
STATION	(FOOT)	(LT/RT)	(EACH)
WINCHEST	ER AVE		
5+33	17	LT	1
ТОТ	'AL	<u> </u>	1

SANIT		NHOLES JSTED	ТОВЕ
	QUANTITY		
STATION	(FOOT)	SET (LT/RT)	(EACH)
WINCHEST	ER AVE		
5+33	17	LT	1

TOTAL

BUFF		X ADJUS CIAL	MENT,
	OFF	SET	QUANTITY
STATION	(FOOT)	(LT/RT)	(EACH)
WINCHEST	ER AVE		
8+17	27	LT	1
8+84	26	LT	1
9+98	23	LT	1
11+92	26	RT	1
14+93	29	RT	1
ТОТ	AL		5

SCALE: NONE

	OFF	SET	QUANTITY
STATION	(FOOT)	(LT/RT)	(EACH)
WINCHEST	ER AVE		
1+31	25	LT	1
11+76	17	RT	1


EARTHWORK								
LOCATION	REMOVAL & DISPOSAL OF UNSUITABLE MAT.* (CU YD)	FURNISHED EXCAVATION** (CU YD)						
WINCHESTER AVE.								
(SOUTH OF LACEY)	f. A.							
STA 1+21 TO STA 10+74	150	5						
WINCHESTER AVE.	COLLEGE PARTY AND THE PARTY AN							
(NORTH OF LACEY)								
STA 11+17 TO STA 17+54	190	11						
TOTAL QUANTITY =	340	16						


\*ALL CUT MATERIAL SHALL BE HAULED OFF SITE DUE TO NO ONSITE STORAGE LOCATIONS.

\*\*ALL FILL MATERIAL (EMBANKMENT) SHALL BE BROUGHT IN FROM OFFSITE LOCATION, SINCE ON SITE EXCAVATED MATERIAL MUST BE HAULED OFF SITE.

CLASS D PATCHES, TYPE I, 7 INCH								
		QUANTITY						
STATION	LOCATION	(SQ YD)						
MINC HE ST	ER AVE							
10+80	LT	4						
TOTAL		4						

		DI	RIVEW	AY QUANTIT	SCHEDULE		
		EXISTI	NG	DRIVEWAY	STABILIZED	P.C.C.	AGG. FOR
	***	PAVEM	ENT	PAVEMENT	DRIVEWAYS, 7"	DRIVEWAY	TEMP
STATION	OFFSET	STRUCT	STRUCTURE			PVMT 6 INCHES	ACCESS
	Annibation	AND T	/PE	(SQ. YD.)	(SQ. YD.)	(SQ. YD.)	(TONS)
NINCHESTER /	AVENUE S	<u> FA 1+00 - 12</u>	2+00				
1+48	LT	P.E.	HMA	36.7	27.3	41	5.0
2+57	LT	P.E.	HMA	7.4	3.0		1.0
3+00	LT LT	P.E.	HMA	51.0	42.4		7.0
5+55	LT	P.E.	HMA	13.7	6.2		1.0
5+96	LT	P.E.	HMA	12.2	5.4	1	1.0
7+55	LT	F.E.	HMA	11.5	5.2		1.0
8+57	LT	P.E.	PCC	28.6		21.8	4.0
9+52	LT	P.E.	HMA	17.5	7.8	4.000	2.0
11+66	RT	P.E.	HMA	19.3	14.1		3.0
<u>VINCHESTER</u>	· · · · · · · · · · · · · · · · · · ·			7			
12+19	RT	P.E.	HMA	12.0	5.4		1.0
12+75	RT	P.E.	HMA	46.2	39,5		6.0
13+73	RT	P.E.	HMA	29.8	24.4		4.0
14+73	RT	P.E.	HMA	18.9	7.5		2.0
15+45	RT	P.E.	HMA	16.3	7.7		2.0
16+65	RT	P.E.	HMA	8.5	2.6		1.0
MIDDLETON A	 /ENUF						
	NORTH	P.E.	HMA	41.2	25.4		4.0
TOTAL QUANT	ITY =		1	371	224	22	45

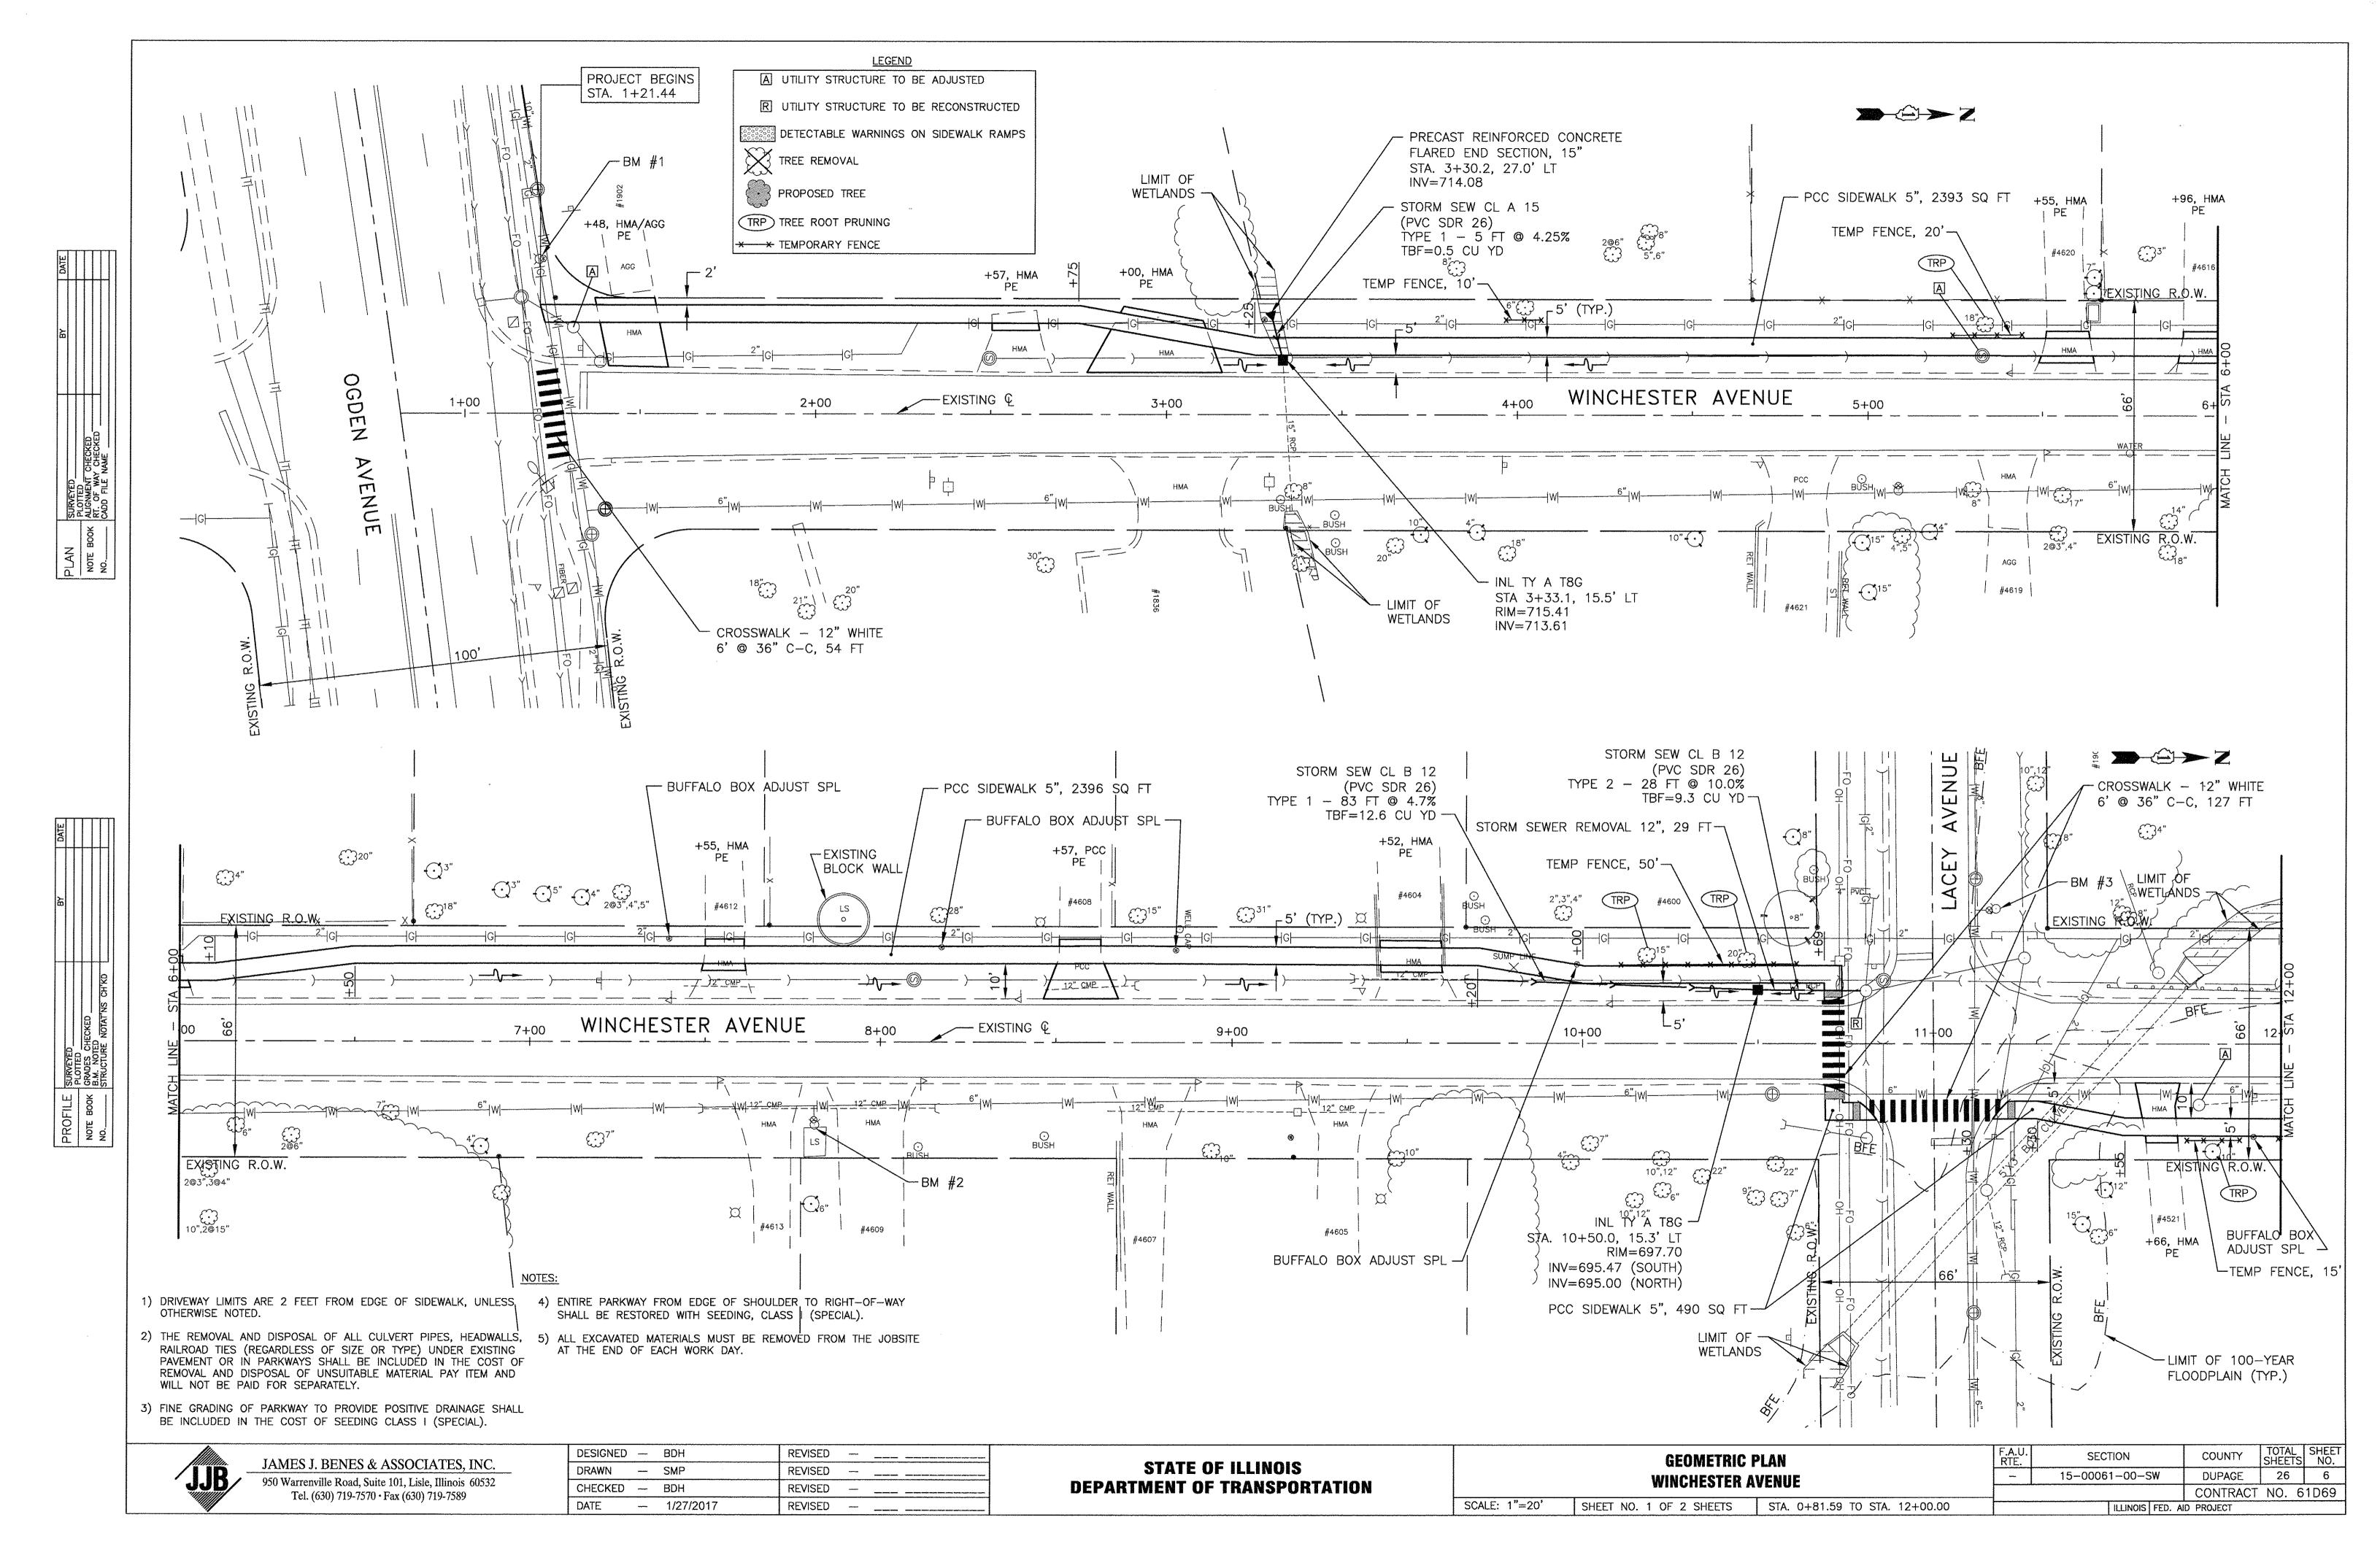

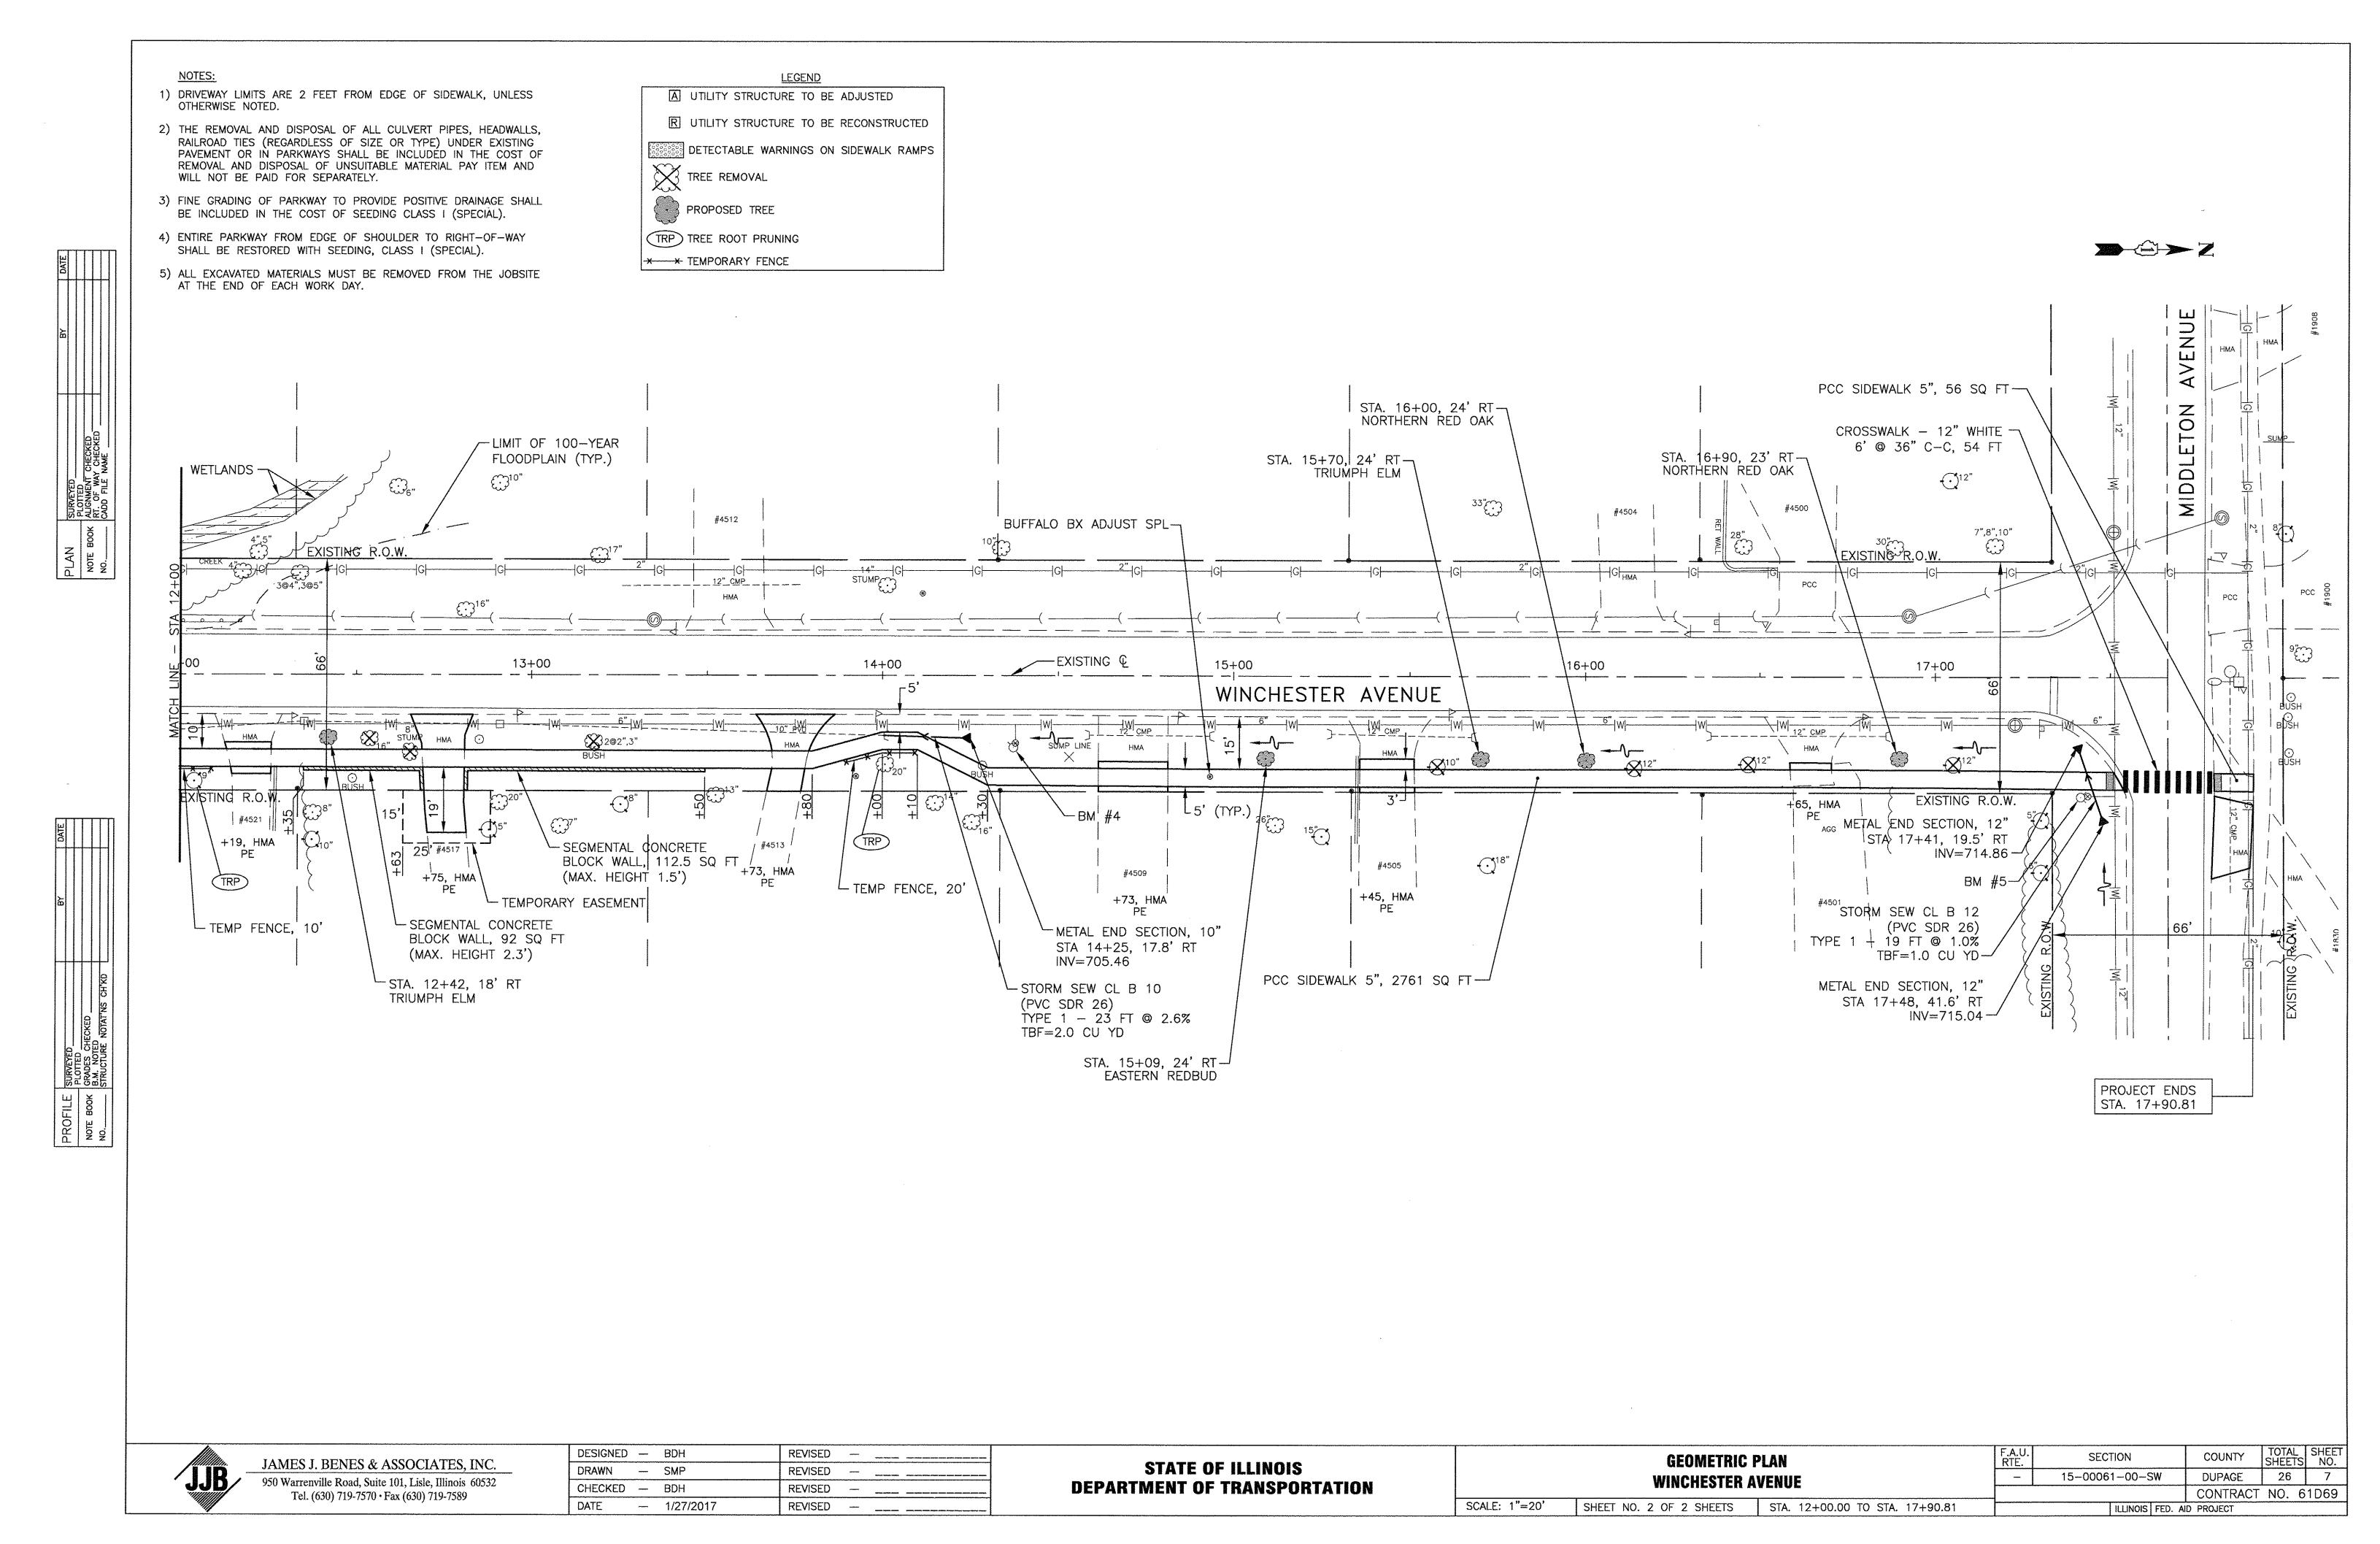

SCALE: 1"=20'


SHEET NO. OF SHEETS


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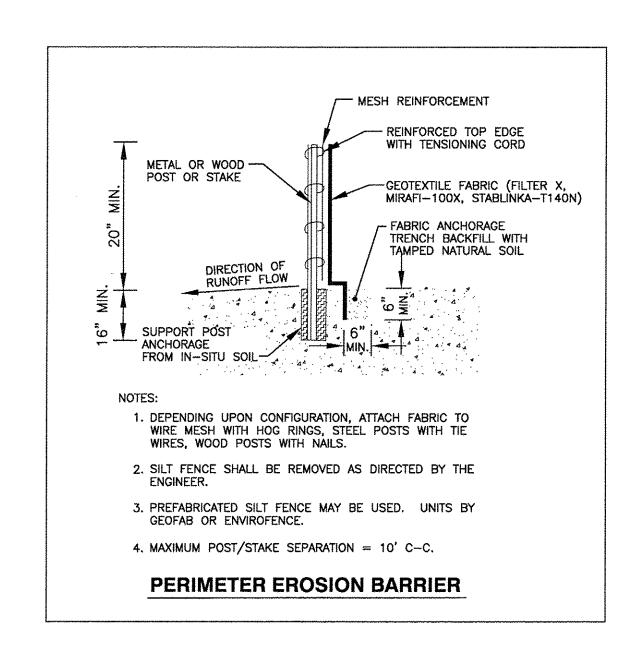
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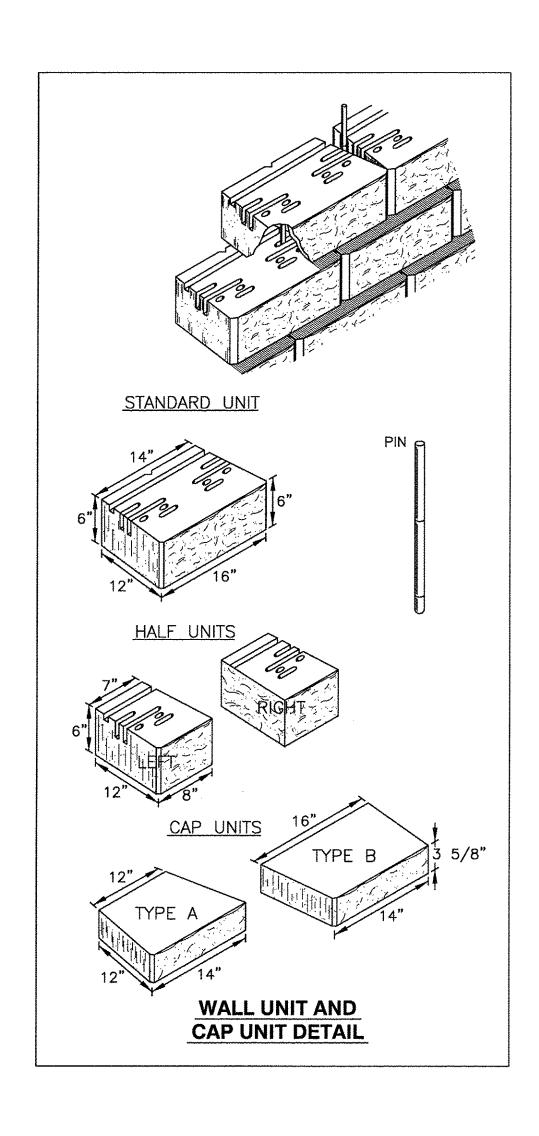
**—** 1/27/2017


REVISED







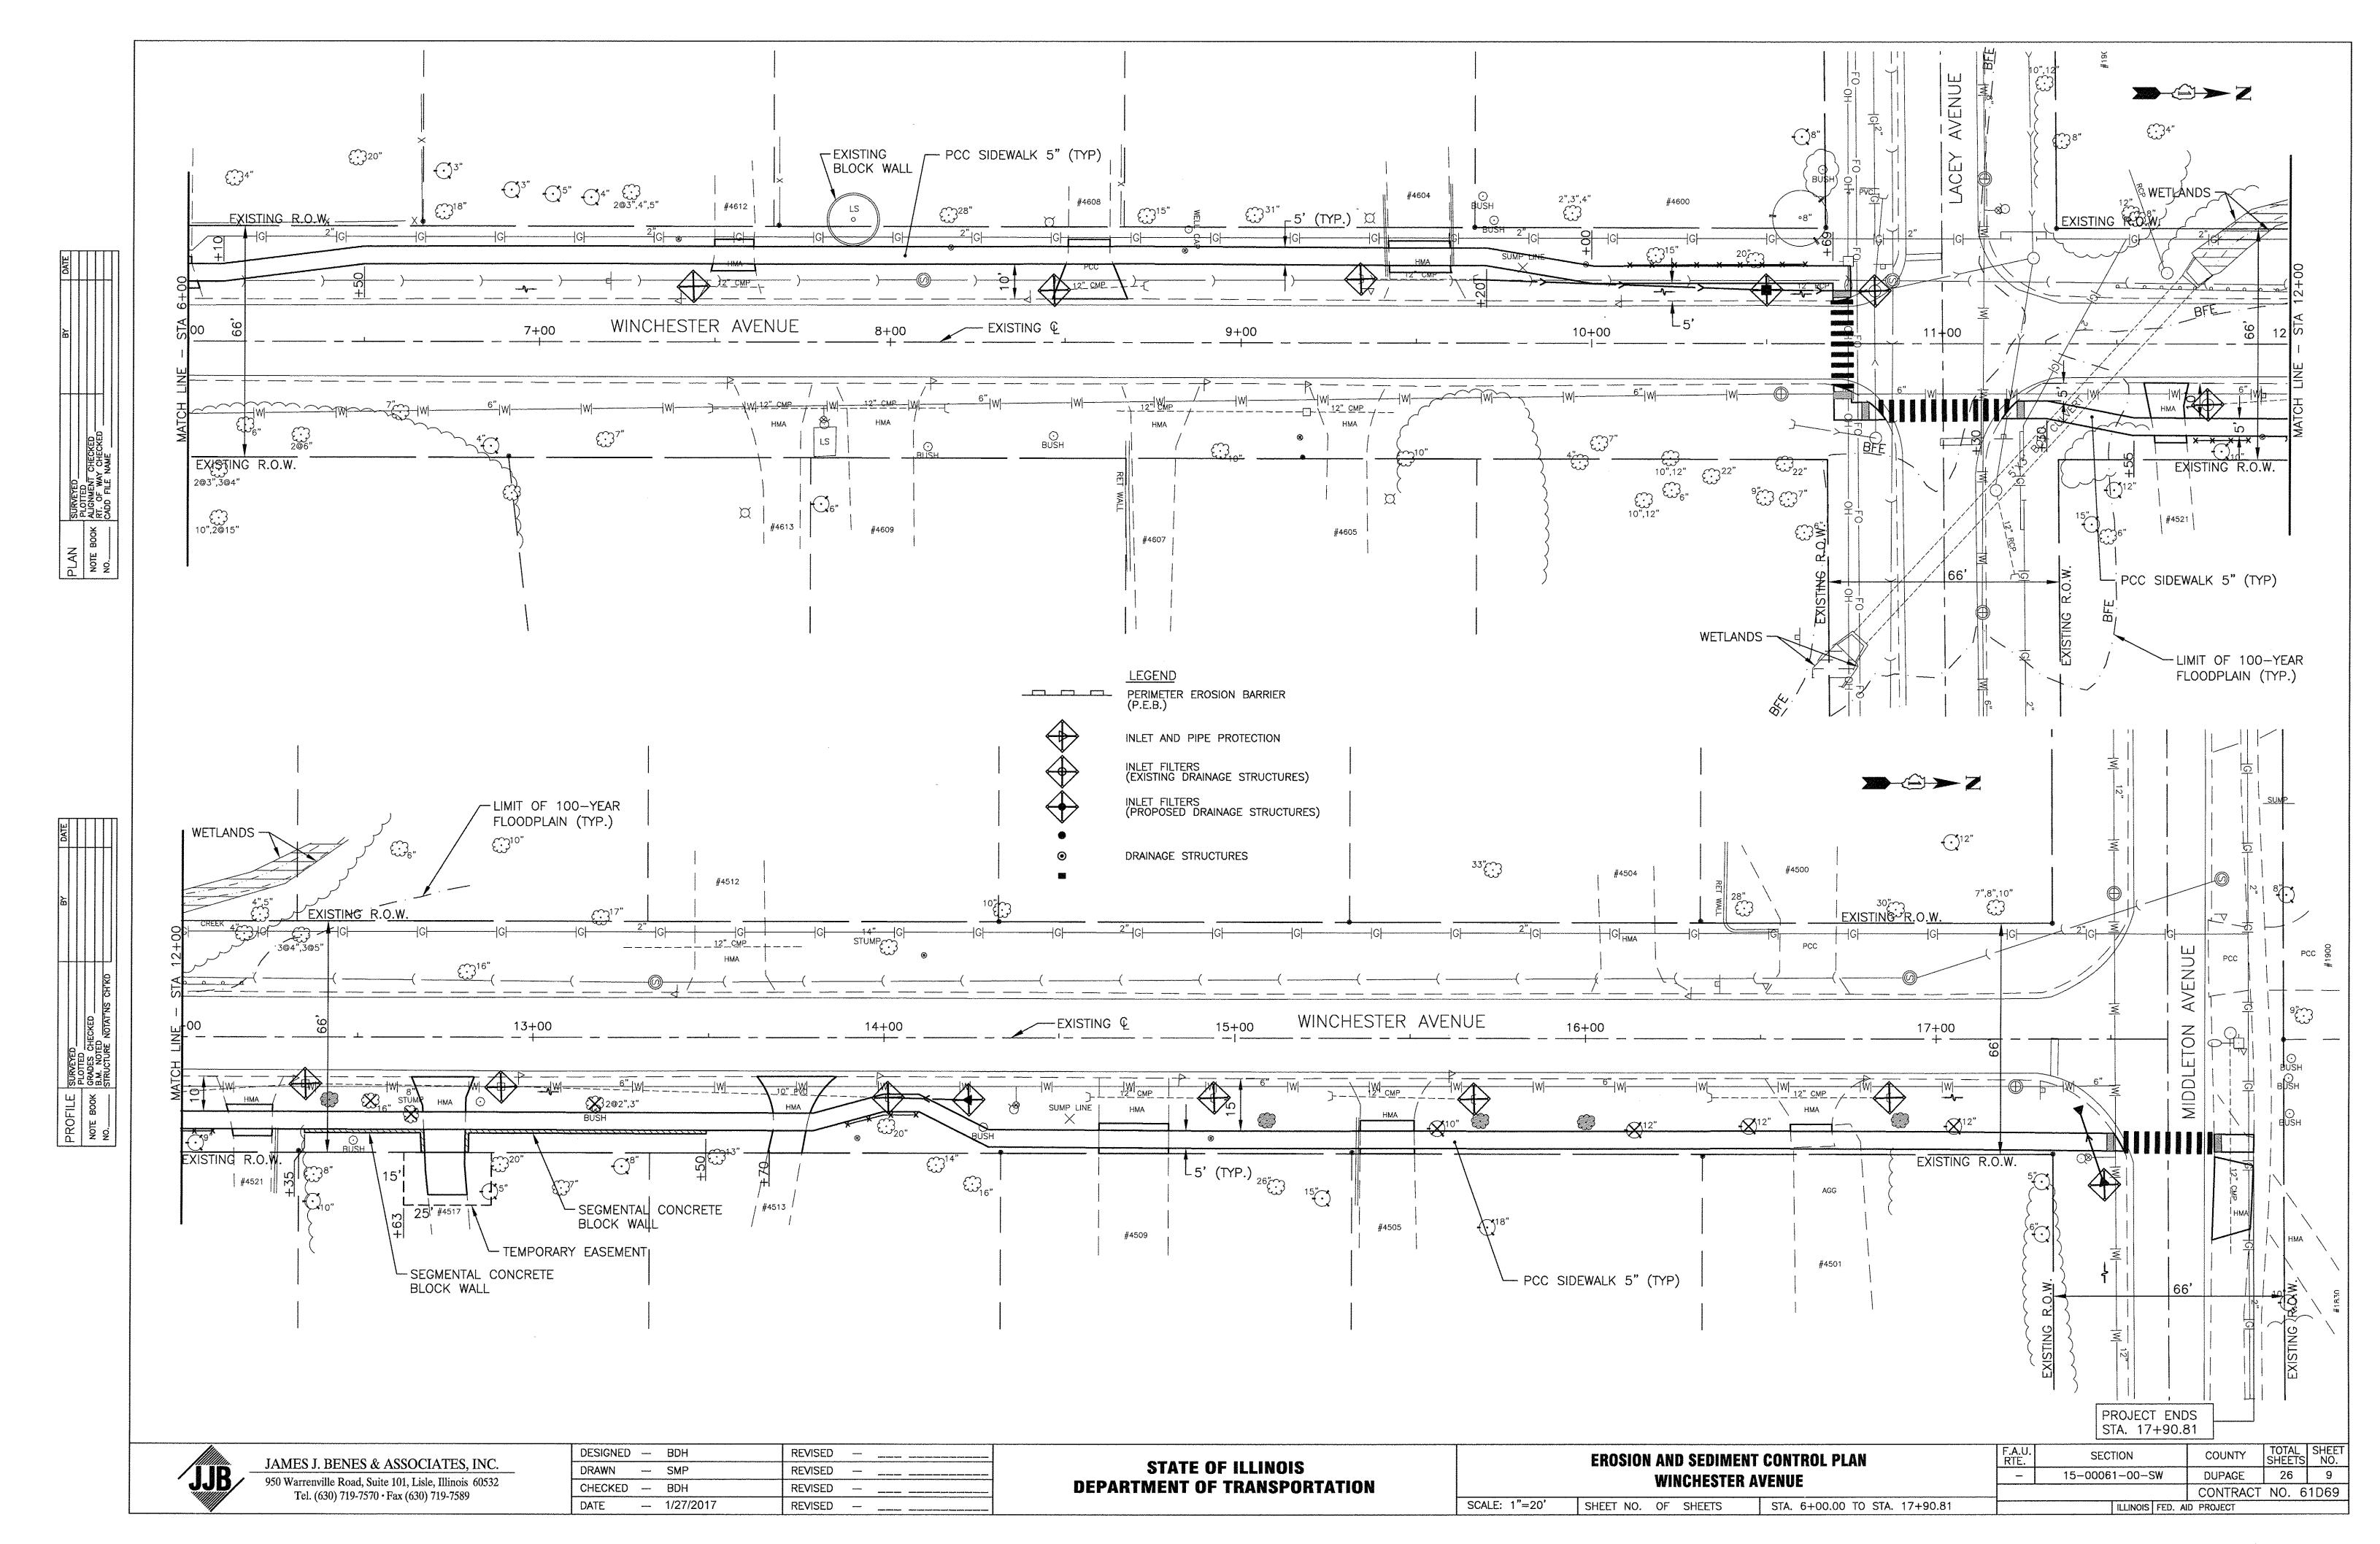

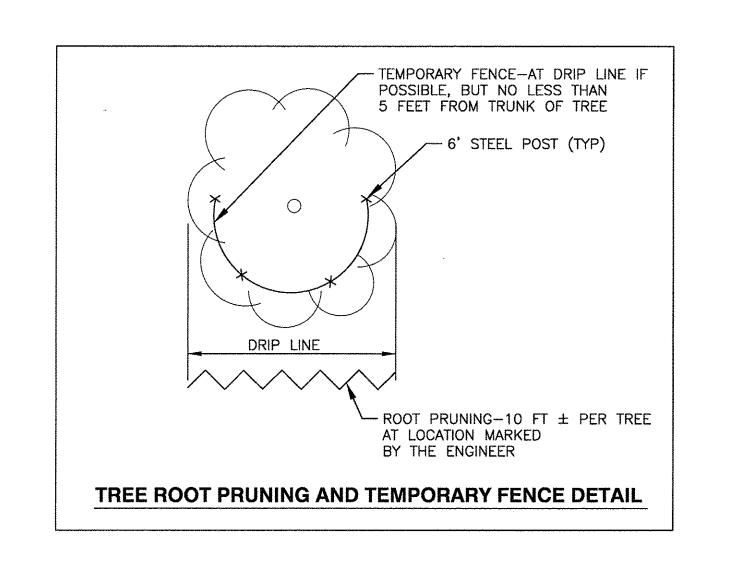

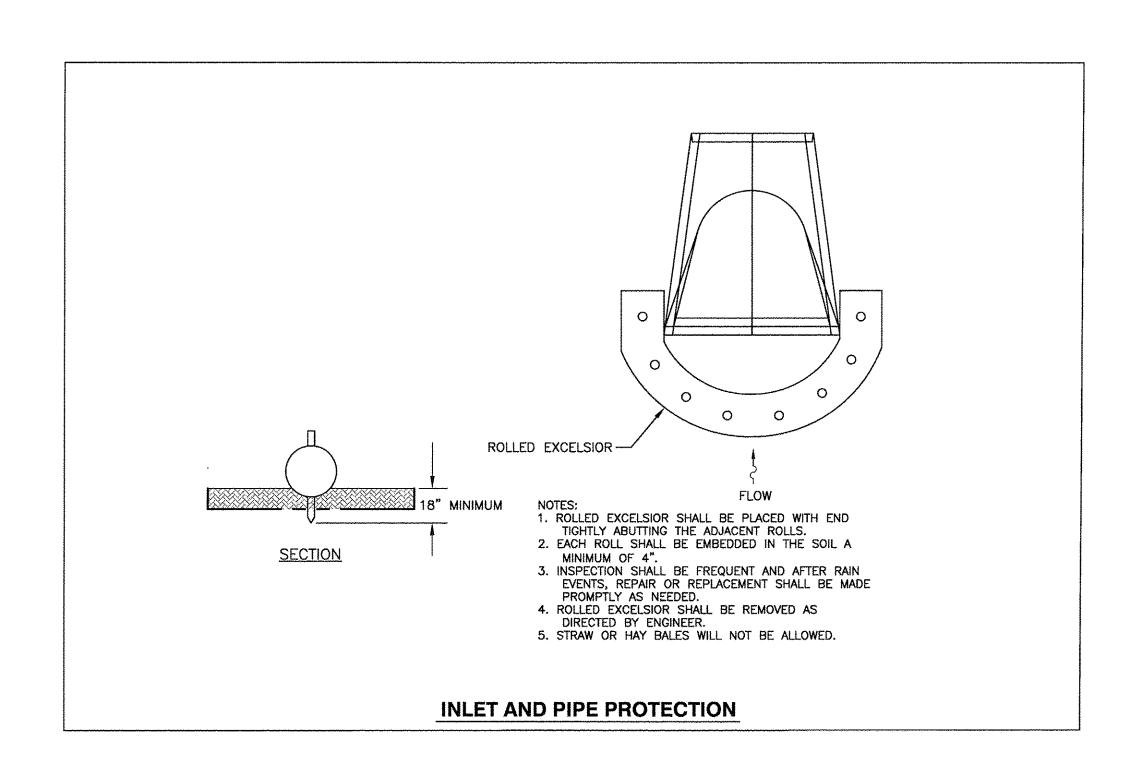

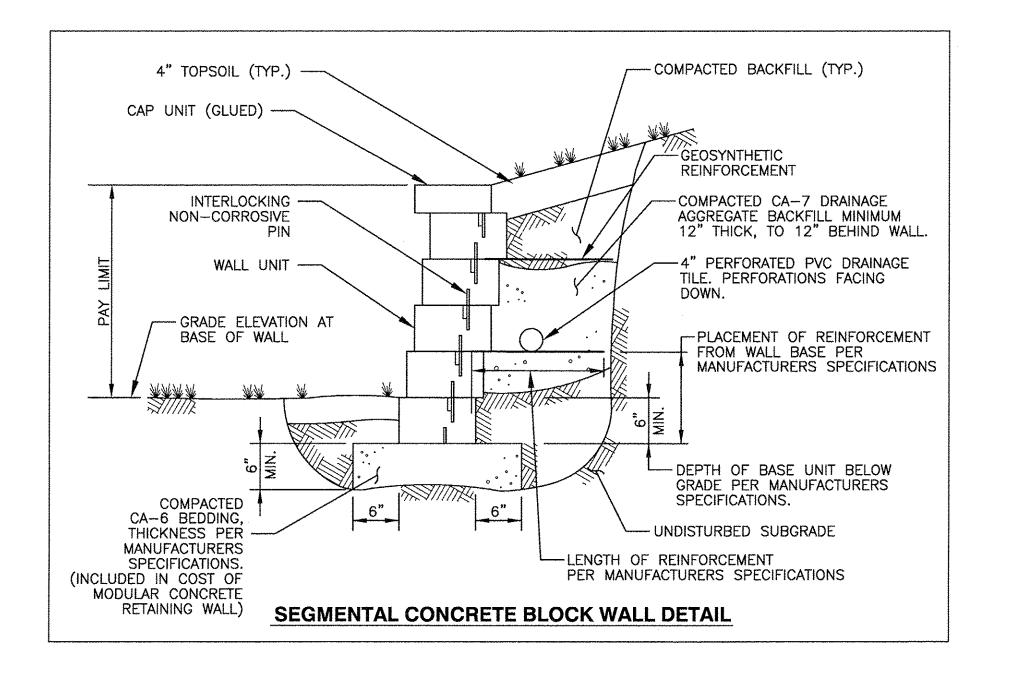

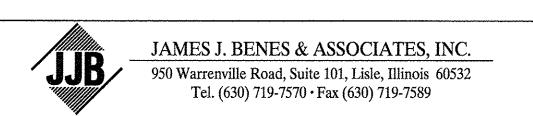


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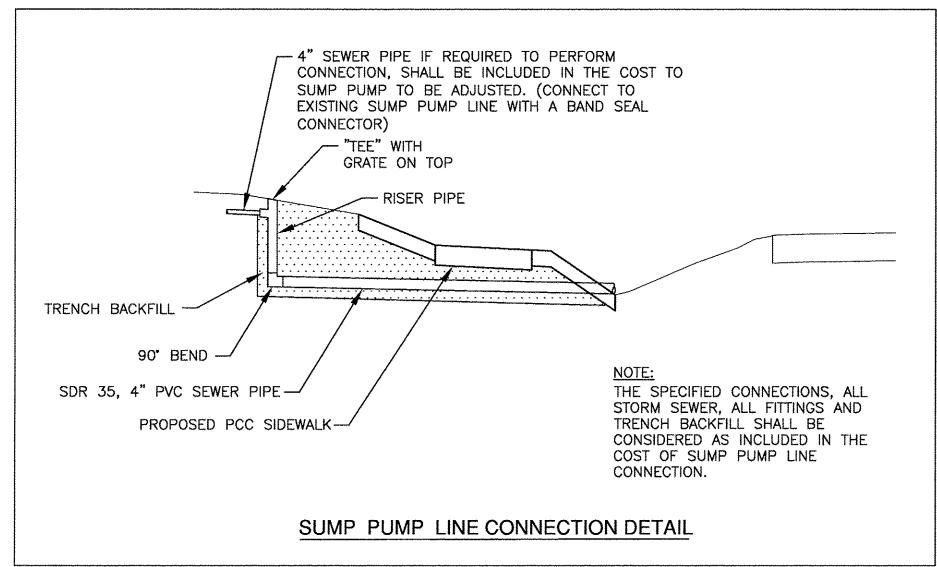
STATE OF ILLINOIS
DEPARTMENT OF TRANSPORTATION


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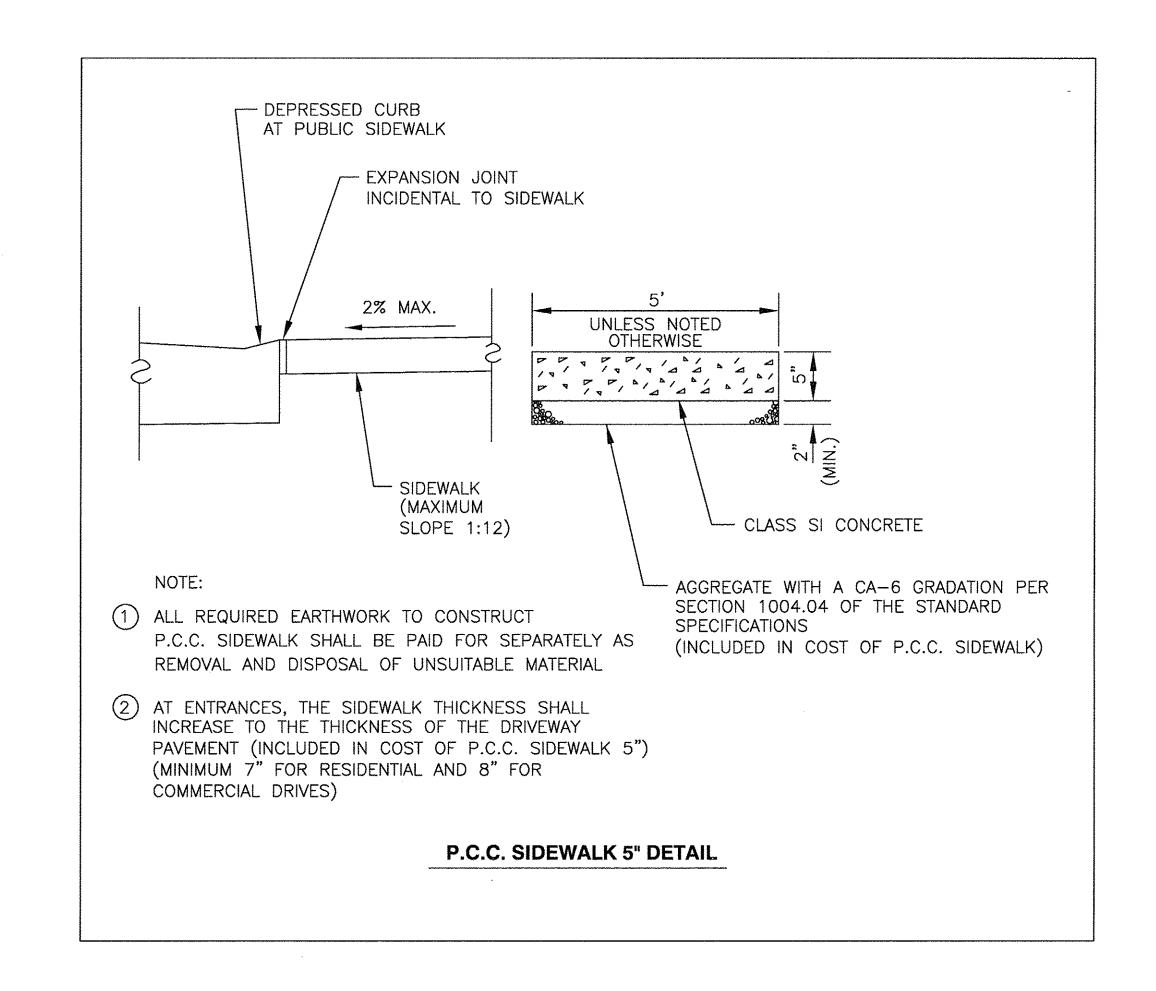
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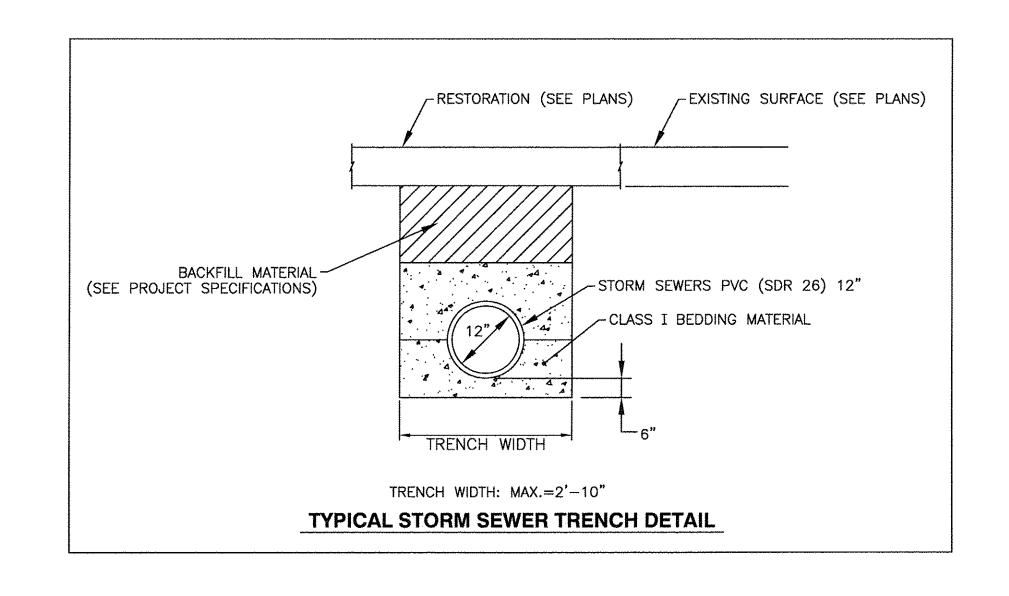
F.A RTE.	SECTION	COUNTY	TOTAL SHEETS	SHEET NO.
	15-00061-00-SW	DUPAGE	26	10
		CONTRACT	NO. 6	1D69
	ILLINOIS FED. AI	D PROJECT		








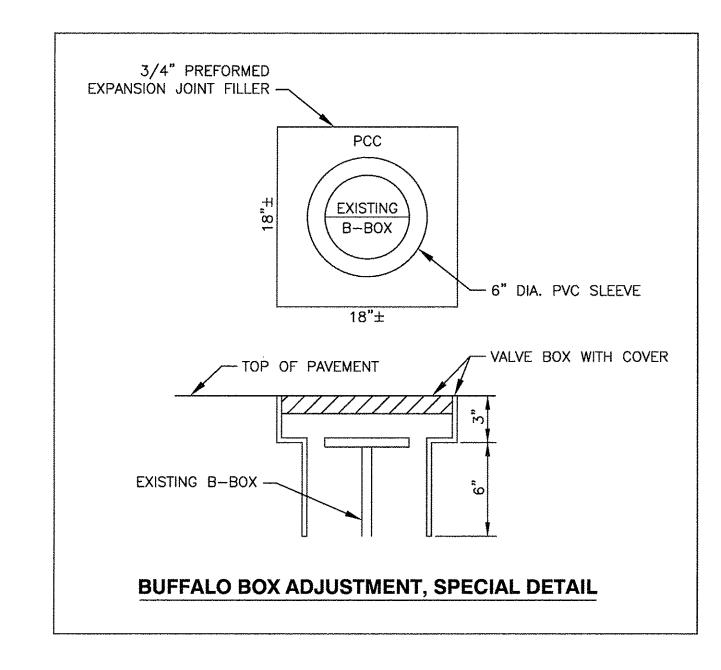

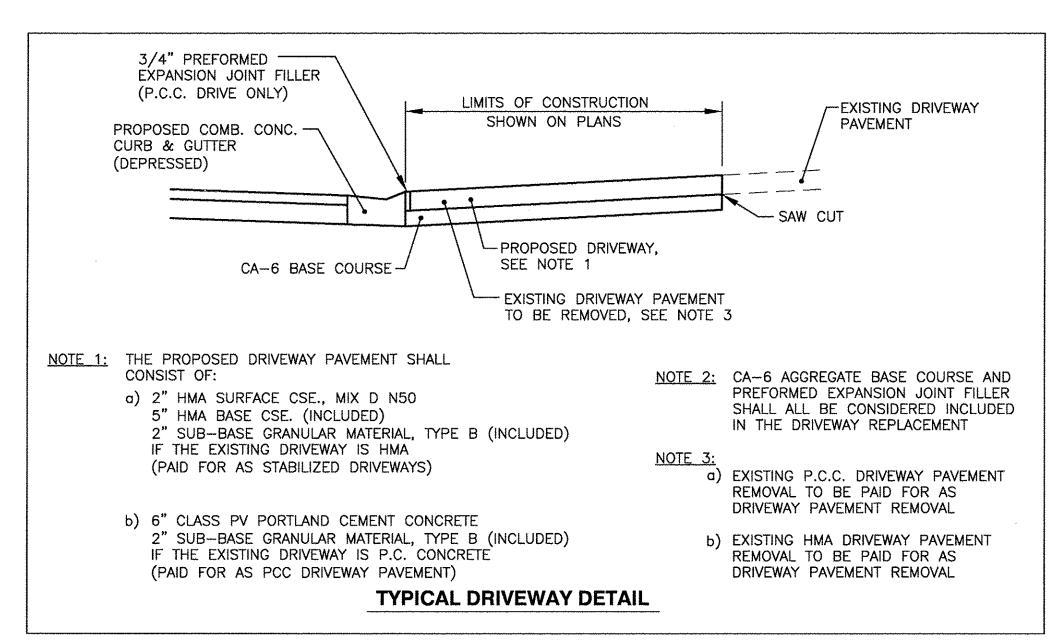

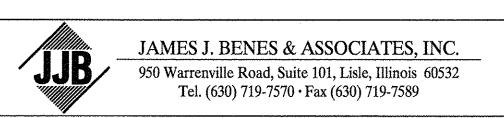


DESIGNED	 BDH	REVISED	
DRAWN	 SMP	REVISED	
CHECKED	 BDH	REVISED	
 DATE	 1/27/2017	REVISED	

STATE OF ILLINOIS DEPARTMENT OF TRANSPORTATION

SCALE: NONE

CONSTRUCTION DETAILS WINCHESTER AVENUE				F.A RTE.	SECTION	COUNTY	TOTAL SHEETS	SHEE NO.	
					15-00061-00-SW	DUPAGE	26	11	
						CONTRACT	NO. 6	31D69	
	SHEET NO.	OF	SHEETS STA.	TO STA.		ILLINOIS FED	AID PROJECT		<del>/</del>

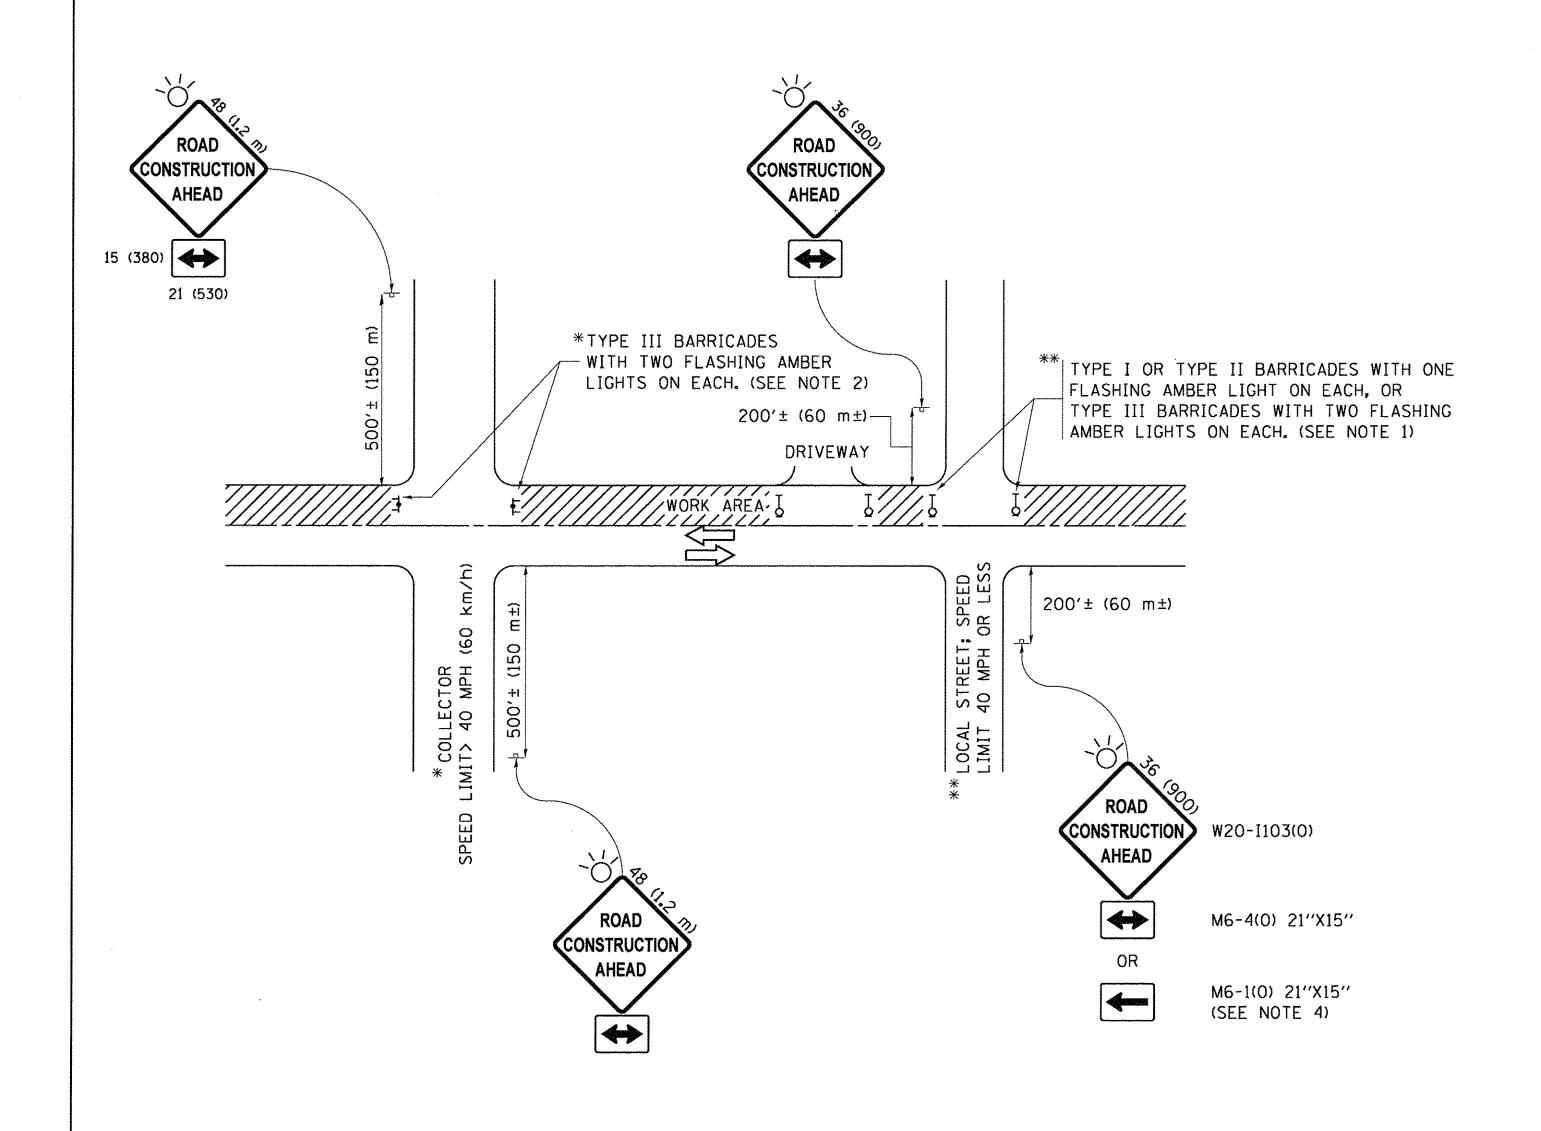

#### NOTES:

- 1. SIDE ROAD WITH A SPEED LIMIT OF 40 MPH (60 km/h) OR LESS AS SHOWN ON THE DRAWING AND AS DIRECTED BY THE ENGINEER:
  - a) ONE "ROAD CONSTRUCTION AHEAD" SIGN 36 x 36 (900x900) WITH A FLASHER MOUNTED ON IT APPROXIMATELY 200" (60 m) IN ADVANCE OF THE MAIN ROUTE.
  - b) THE CLOSED PORTION OF THE MAIN ROUTE SHALL BE PROTECTED BY BLOCKING WITH TYPE I, TYPE II OR TYPE III BARRICADES, 1/3 OF THE CROSS SECTION OF THE CLOSED PORTION.
- 2. SIDE ROAD WITH A SPEED LIMIT GREATER THAN 40 MPH (60 km/h) AS SHOWN ON THE DRAWING AND AS DIRECTED BY THE ENGINEER:
  - a) ONE "ROAD CONSTRUCTION AHEAD" SIGN 48 × 48 (1.2 m × 1.2 m) WITH A FLASHER MOUNTED ON IT APPROXIMATELY 500" (150 m) IN ADVANCE OF THE MAIN ROUTE.
  - b) THE CLOSED PORTION OF THE MAIN ROUTE SHALL BE PROTECTED BY BLOCKING WITH TYPE III BARRICADES, 1/2 OF THE CROSS SECTION OF THE CLOSED PORTION.
- 3. CONES MAY BE SUBSTITUTED FOR BARRICADES OR DRUMS AT HALF THE SPACING DURING DAY OPERATIONS. CONES SHALL BE A MINIMUM OF 28 (710) IN HEIGHT.
- 4. WHEN THE SIDE ROAD LIES BETWEEN THE BEGINNING OF THE MAINLINE SIGNING AND THE WORK ZONE, A SINGLE HEADED ARROW (M6-1) SHALL BE USED IN LIEU OF THE DOUBLE HEADED ARROW (M6-4).

SCALE: NONE

- 5. WHEN WORK IS BEING PERFORMED ON A SIDE ROAD OR DRIVEWAY, FOLLOW THE APPLICABLE STANDARD(S). THE DIRECTIONAL ARROW (M6-1 OR M6-4) SHALL BE COVERED OR REMOVED WHEN NO LONGER CONSISTENT WITH THE TRAFFIC CONTROL SET-UP.
- 6. ADVANCE WARNING SIGNS ARE TO BE OMITTED ON DRIVEWAYS UNLESS OTHERWISE SPECIFIED IN THE PLANS OR BY THE ENGINEER.
- 7. THE TRAFFIC CONTROL AND PROTECTION FOR SIDE ROADS, INTERSECTIONS, AND DRIVEWAYS SHALL BE INCLUDED IN THE COST OF SPECIFIED TRAFFIC CONTROL STANDARDS OR ITEMS.


All dimensions are in inches (millimeters) unless otherwise shown.


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	PLOT SCALE = 50.000 '/ in.	CHECKED -	REVISED - A. SCHUETZ	E 07-01-13
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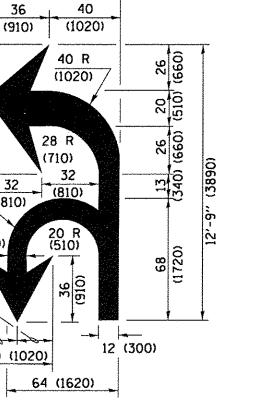
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DEPARTMENT	OF	TRANSPORTATION

TRAFFIC	CONT	ROL	AND	PROTEC	TION	FOR	
SIDE ROADS	S, INTE	RSI	ECTION	IS, AND	DRIV	<b>EWAYS</b>	
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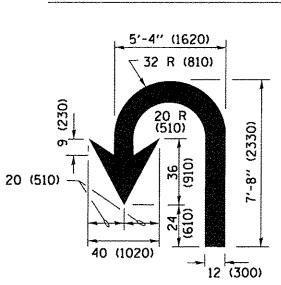
	ILLINOIS FED.	AID PROJECT			
TC-10		CONTRACT	NO. 6	106	
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.U. E.	SECTION	COUNTY	TOTAL SHEETS	SHEI NO	






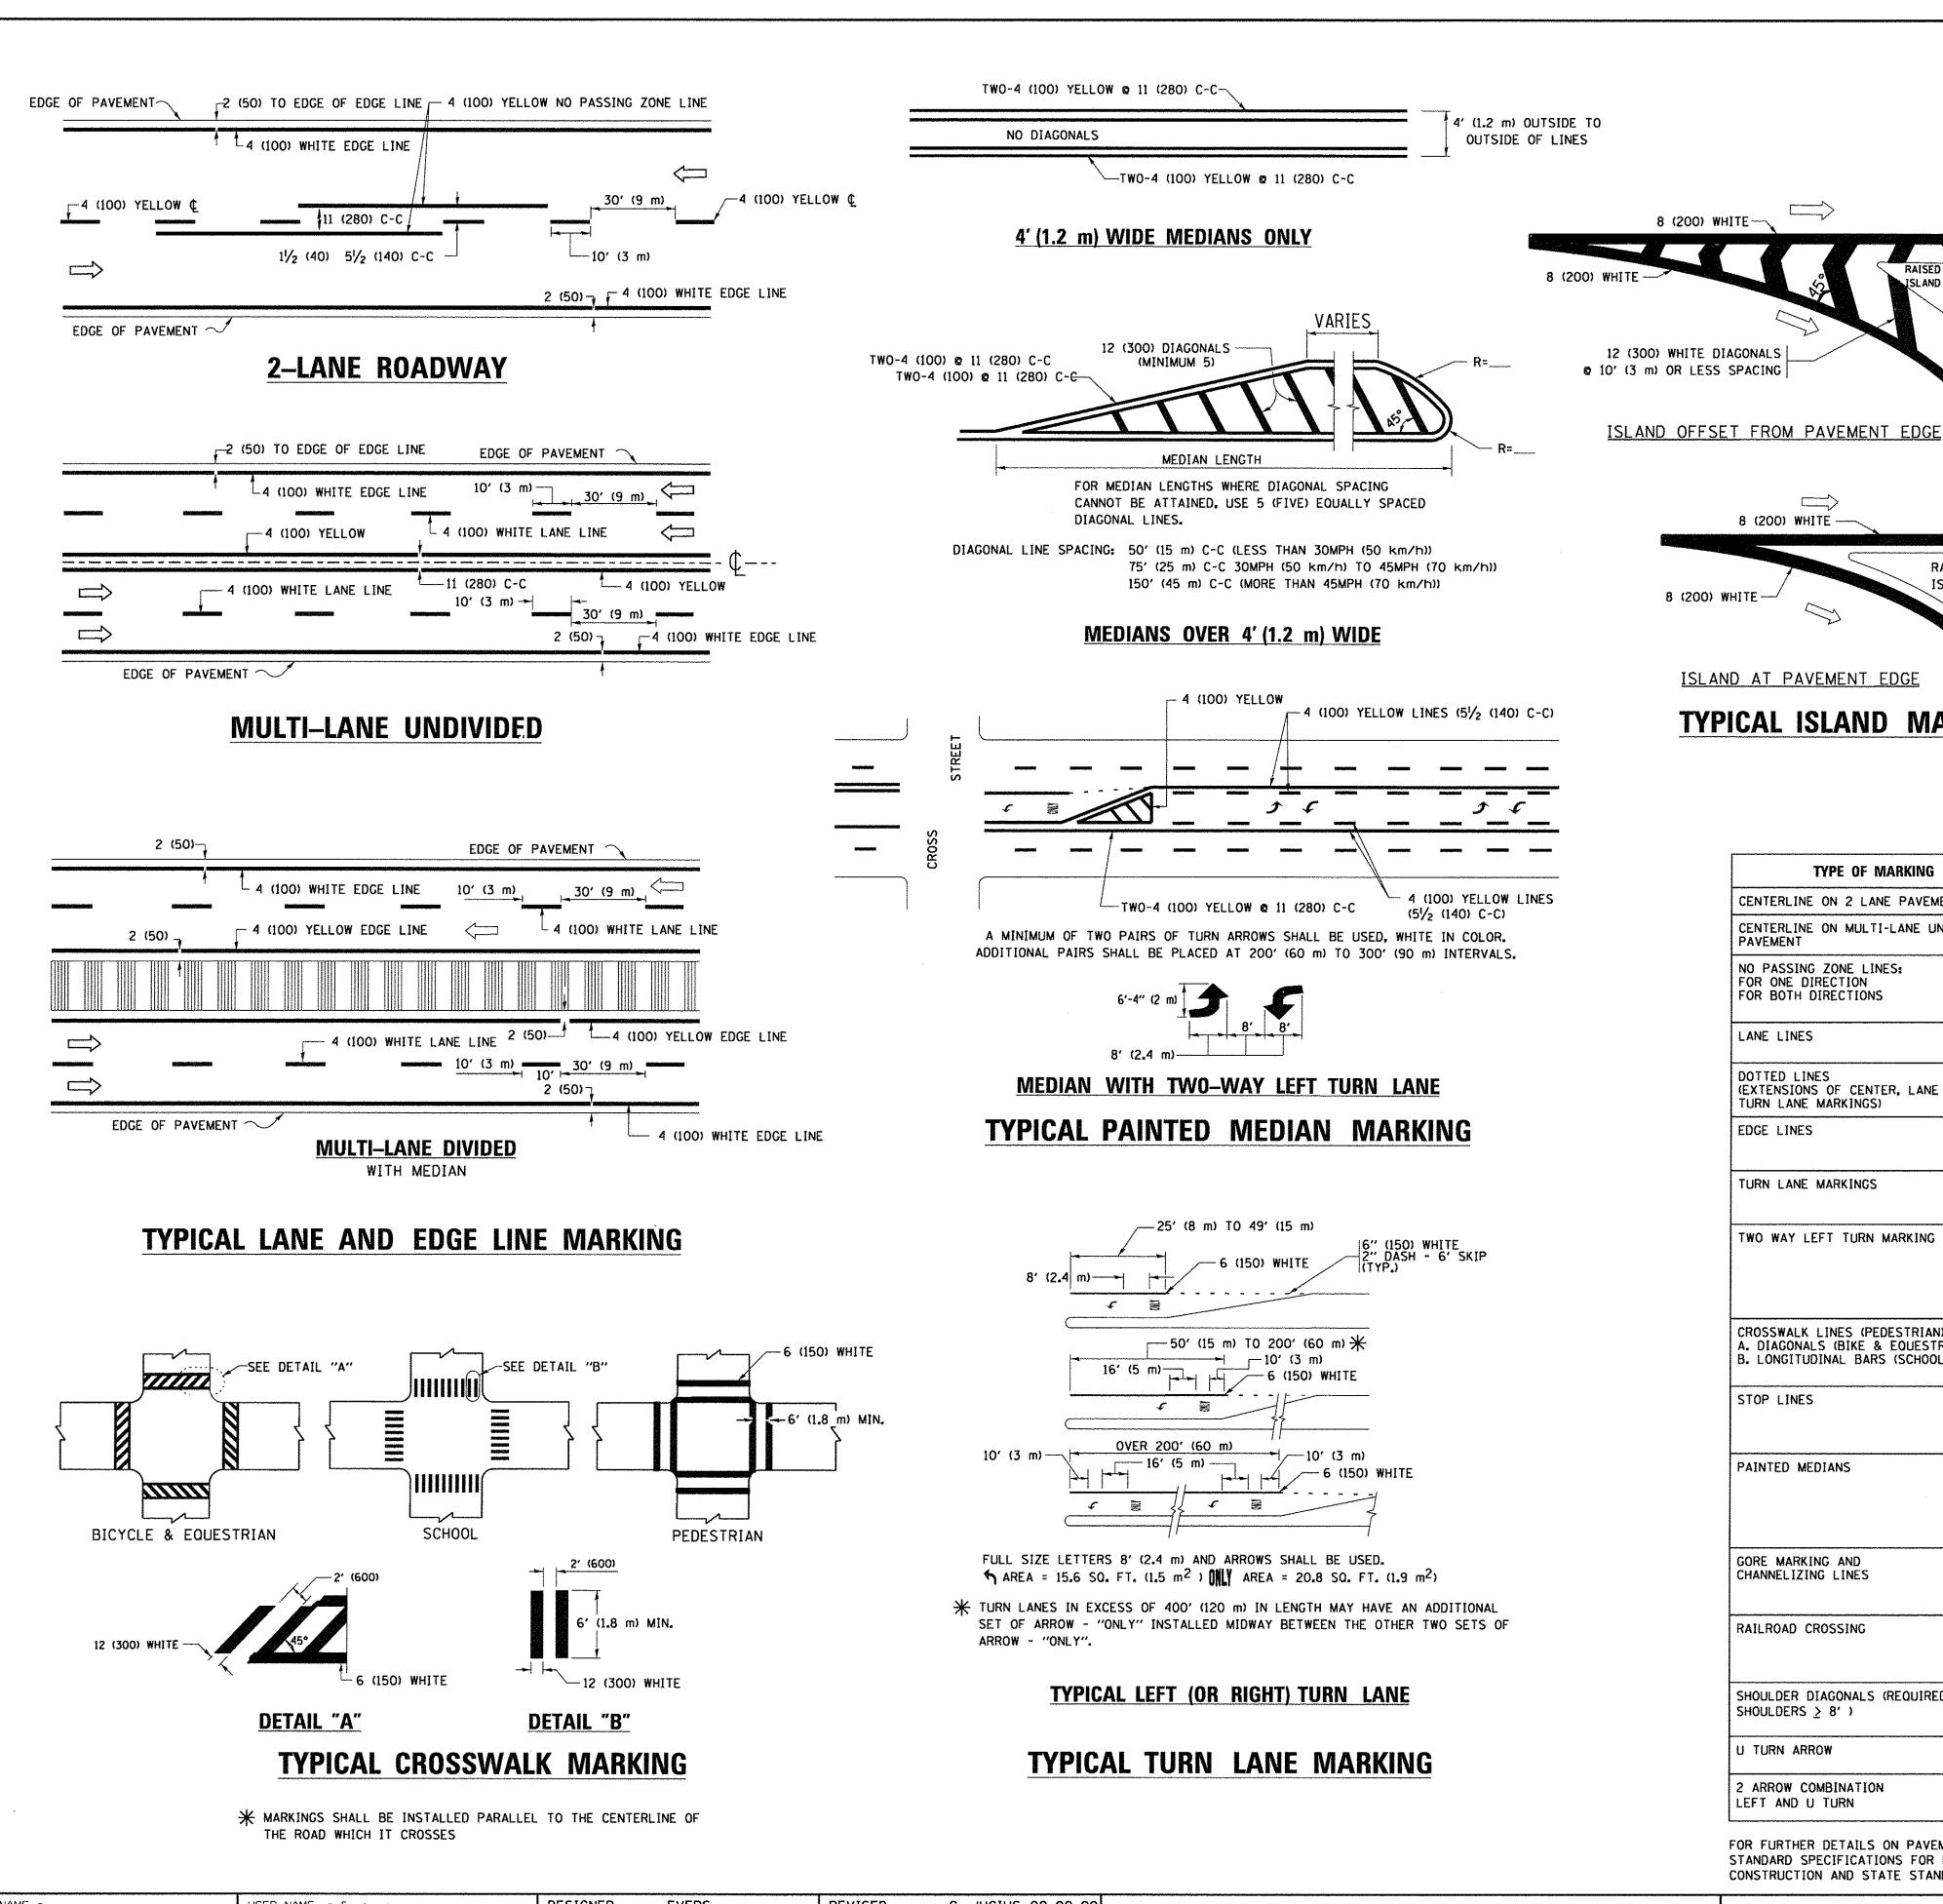

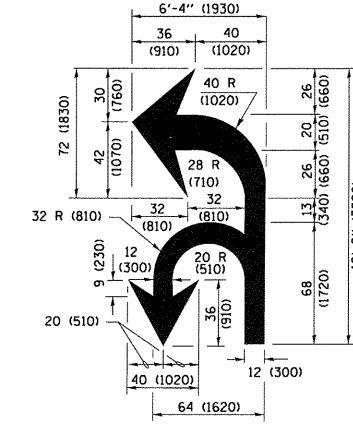



**U-TURN** 

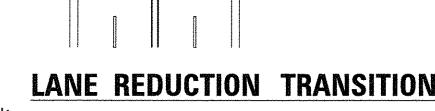

SPEED LIMIT

30

35

40

50

55

345

425

500

580

665

750

\* LANE REDUCTION ARROWS REQUIRED AT SPEEDS OF 45 MPH OR GREATER OR WHEN SPECIFIED IN PLANS.

TYPE OF MARKING	WIDTH OF LINE	PATTERN	COLOR	SPACING /REMARKS			
CENTERLINE ON 2 LANE PAVEMENT	4 (100)	SKIP-DASH	YELLOW	10' (3 m) LINE WITH 30' (9 m) SPACE			
CENTERLINE ON MULTI-LANE UNDIVIDED PAVEMENT	2 2 4 (100)	SOLID	YELLOW	11 (280) C-C			
NO PASSING ZONE LINES: FOR ONE DIRECTION FOR BOTH DIRECTIONS	4 (100) 2 <b>Q</b> 4 (100)	SOLID SOLID	YELLOW YELLOW	5½ (140) C-C FROM SKIP-DASH CENTERLINE 11 (280) C-C OMIT SKIP-DASH CENTERLINE BETWEEN			
LANE LINES	4 (100) 5 (125) ON FREEWAYS	SKIP-DASH SKIP-DASH	WHITE WHITE	10' (3 m) LINE WITH 30' (9 m) SPACE			
DOTTED LINES (EXTENSIONS OF CENTER, LANE OR TURN LANE MARKINGS)	SAME AS LINE BEING EXTENDED	SKIP-DASH	SAME AS LINE BEING EXTENDED	2' (600) LINE WITH 6' (1.8 m) SPACE			
EDGE LINES	4 (100)	SOLID	YELLOW-LEFT WHITE-RIGHT	OUTLINE MEDIANS IN YELLOW			
TURN LANE MARKINGS	6 (150) LINE; FULL SIZE LETTERS & SYMBOLS (8' (2.4m))	SOLID	WHITE	SEE TYPICAL TURN LANE MARKING DETAIL			
TWO WAY LEFT TURN MARKING	2 @ 4 (100) EACH DIRECTION 8' (2.4m) LEFT ARROW	SKIP-DASH AND SOLID IN PAIRS	YELLOW WHITE	10' (3 m) LINE WITH 30' (9 m) SPACE FOR SKIP-DASH; 51/2 (140) C-C BETWEEN SOLID LINE AND SKIP-DASH LINE SEE TYPICAL TWO-WAY LEFT TURN MARKING DETAIL			
CDCCWALK WINES (DEDECTDIAN)	2.5 (150)	COLTO	HE LITE	NOT LESS TUNNS OF A RAPET			
CROSSWALK LINES (PEDESTRIAN) A. DIAGONALS (BIKE & EQUESTRIAN) B. LONGITUDINAL BARS (SCHOOL)	2 <b>e</b> 6 (150) 12 (300) <b>e</b> 45° 12 (300) <b>e</b> 90°	SOLID SOLID SOLID	WHITE WHITE WHITE	NOT LESS THAN 6' (1.8 m) APART 2' (600) APART 2' (600) APART SEE TYPICAL CROSSWALK MARKING DETAILS.			
STOP LINES	24 (600)	SOLID	WHITE	PLACE 4' (1.2 m) IN ADVANCE OF AND PARALLEL TO CROSSWALK, IF PRESENT. OTHERWISE, PLACE AT DESIRED STOPPING POINT. PARALLEL TO CROSSROAD CENTERLINE, WHERE POSSIBLE			
PAINTED MEDIANS	2 @ 4 (100) WITH 12 (300) DIAGONALS @ 45° NO DIAGONALS USED FOR 4' (1.2 m) WIDE MEDIANS	SOLID	YELLOW: TWO WAY TRAFFIC . WHITE: ONE WAY TRAFFIC	11 (280) C-C FOR THE DOUBLE LINE SEE TYPICAL PAINTED MEDIAN MARKING.			
GORE MARKING AND CHANNELIZING LINES	8 (200) WITH 12 (300) DIAGONALS & 45°	SOLID	WHITE	DIAGONALS: 15' (4.5 m) C-C (LESS THAN 30MPH (50 km/h)) 20' (6 m) C-C 30MPH (50 km/h) TO 45MPH (70 km/h)) 30' (9 m) C-C (OVER 45MPH (70 km/h))			
RAILROAD CROSSING	24 (600) TRANSVERSE LINES; "RR" IS 6' (1.8 m) LETTERS; 16 (400) LINE FOR "X"	SOLID	WHITE	SEE STATE STANDARD 780001 AREA OF: "R"=3.6 SO. FT. (0.33 m <sup>2</sup> ) EACH "X"=54.0 SO. FT. (5.0 m <sup>2</sup> )			
SHOULDER DIAGONALS (REQUIRED FOR SHOULDERS > 8')	12 (300) <b>e</b> 45°	SOLID	WHITE - RIGHT YELLOW - LEFT	50' (15 m) C-C (LESS THAN 30MPH (50 km/h)) 75' (25 m) C-C (30 MPH (50 km/h) TO 45MPH (70 km/h)) 150' (45 m) C-C (OVER 45MPH (70 km/h))			
U TURN ARROW	SEE DETAIL	SOLID	WHITE	16.3 SF			
2 ARROW COMBINATION LEFT AND U TURN	SEE DETAIL	SOLID	WHITE	30.4 SF			

FOR FURTHER DETAILS ON PAVEMENT MARKING REFER TO STANDARD SPECIFICATIONS FOR ROAD AND BRIDGE CONSTRUCTION AND STATE STANDARD 780001.

SCALE: NONE

8 (200) WHITE -

ISLAND AT PAVEMENT EDGE

TYPICAL ISLAND MARKING

All dimensions are in inches (millimeters) unless otherwise shown.

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ı	pw:\\ILØ84EBIDINTEG.:lll:nois.gov:PWIDOT\Do	ouments\IDOT Offices\District 1\Projects\Dist	G <b>GRAWM</b> \CADData\CADsheets\tc13.dgn	REVISED -	C. JUCIUS 07-01-1
ı		PLOT SCALE = 50.000 '/ in.	CHECKED -	REVISED -	C. JUCIUS 12-21-1
	Default	PLOT DATE = 4/13/2016	DATE - 1/27/2017	REVISED -	C. JUCIUS 04-12-1

STATE OF ILLINOIS **DEPARTMENT OF TRANSPORTATION** 

DISTRICT ONE TYPICAL PAVEMENT MARKINGS		F.A.U. RTE.	SECTION	COUNTY	TOTAL SHEETS	SHEET NO.
			15-00061-00-SW	DUPAGE	26	13
		TC-13		CONTRACT NO. 61069		
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