STATE OF ILLINOIS


DEPARTMENT OF TRANSPORTATION

PROPOSED HIGHWAY PLANS

FAP ROUTE 805 (IL 161) SECTION 125RS-6

CM - 3P RESURFACING - WEST OF I-64 E.B. RAMPS TO ONE STOP DR. ST. CLAIR COUNTY

C-98-026-17

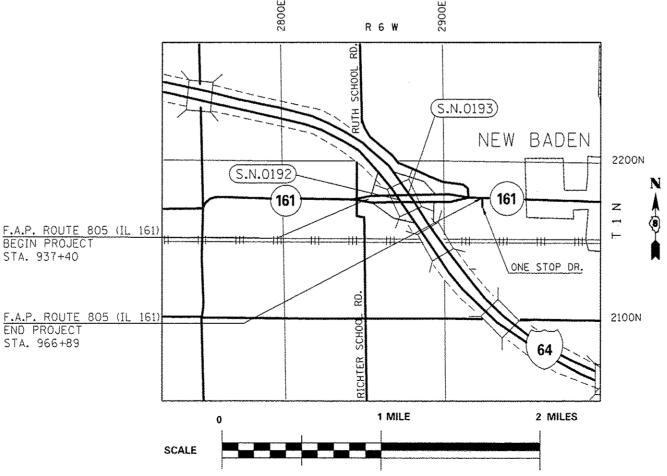


125RS-6

ST. CLAIR 15 1

CONTRACT NO. 76K19



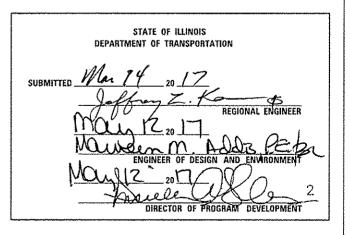

PRINTED BY THE AUTHORITY OF THE STATE OF ILLINOIS

INDEX OF SHEETS

- HIGHWAY STANDARDS, GENERAL NOTES, & COMMITMENTS
- SUMMARY OF QUANTITIES
- TYPICAL SECTIONS
- SCHEDULE OF QUANTITIES
- DETOUR SHEET
- PLAN SHEETS 10-11
- PAVEMENT MARKING SHEETS 12-13
- MISCELLANEOUS DETAILS


TRAFFIC DATA - FAP 805 (IL 161)

2015 ADT = 8700 (ACTUAL)

2017 ADT = 8900 (ESTIMATED)

2037 ADT = 10800 (ESTIMATED)

SU=6.3% MU=2.9%

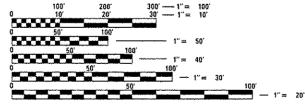

FULL SIZE PLANS HAVE BEEN PREPARED USING STANDARD ENGINEERING SCALES, REDUCED SIZED PLANS WILL NOT CONFORM TO STANDARD SCALES. IN MAKING MEASUREMENTS ON REDUCED PLANS, THE ABOVE SCALES MAY BE USED.

JOINT UTILITY LOCATION INFORMATION FOR EXCAVATION 1-800-892-0123

OR 811

PROJECT ENGINEER TIMOTHY PADGETT 618-346-3325 PROJECT MANAGER JEFFREY SCHWEIZER 618-346-3206

STA. 937+40

END PROJECT

STA. 966+89

CONTRACT NO. 76K19

GROSS LENGTH = 2,949.00 FT. = 0.56 MILE

NET LENGTH = 2,949.00 FT. = 0.56 MILE

LIST OF STANDARDS

000001-06 001006	STANDARD SYMBOLS, ABBREVIATIONS AND PATTERNS DECIMAL OF AN INCH AND OF A FOOT
	PAVEMENT WELDED WIRE REINFORCEMENT
	PAVEMENT JOINTS
442201-03	CLASS C AND D PATCHES
606001-06	CONCRETE CURB TYPE B AND COMBINATION CONCRETE CURB AND GUTTER
606301-04	PC CONCRETE ISLANDS AND MEDIANS
701006-05	OFF-RD OPERATIONS, 2L, 2W, 15' (4.5M) TO 24" (600MM) FROM PAVEMENT EDGE
701011-04	OFF-RD MOVING OPERATIONS, 2L, 2W, DAY ONLY
701101-05	OFF-RD OPERATIONS, MULTILANE, 15' (4.5M) TO 24" (600MM) FROM PAVEMENT EDGE
701201-04	LANE CLOSURE, 2L, 2W, DAY ONLY, FOR SPEEDS > 45 MPH
701301-04	LANE CLOSURE, 2L, 2W SHORT TERM OPERATIONS_
701306-03	LANE CLOSURE, 2L, 2W, SLOW MOVING OPERATIONS DAY ONLY, FOR SPEEDS > 45 MPH
701311-03	LANE CLOSURE, 2L, 2W MOVING OPERATIONS - DAY ONLY
701336-06	LANE CLOSURE, 2L, 2W WORK AREAS IN SERIES, FOR SPEEDS ≥ 45 MPH
701426-09	LANE CLOSURE, MULTILANE, INTERMITTENT OR MOVING OPER., FOR SPEEDS > 45 MPH
701451-04	RAMP CLOSURE FREEWAY/EXPRESSWAY
701901-06	TRAFFIC CONTROL DEVICES
780001-05	TYPICAL PAVEMENT MARKINGS
781001-04	TYPICAL APPLICATIONS RAISED REFLECTIVE PAVEMENT MARKERS
782001-01	CURB REFLECTORS

GENERAL NOTES

1. ILLINOIS STATE LAW REQUIRES A 48-HOUR NOTICE BE GIVEN TO ALL UTILITIES WITHIN THE PROJECT AREA BEFORE DIGGING. FIELD MARKING OF FACILITIES MAY BE OBTAINED BY CONTACTING J.U.L.I.E. OR FOR NON-MEMBERS, THE UTILITY COMPANY DIRECTLY. AGENCIES KNOWN TO HAVE FACILITIES WITHIN THE PROJECT AREA ARE AS FOLLOWS:

UTILITY	ABOVE GROUND	BELOW GROUND
*CHARTER COMMUNICATIONS, INC.	Х	X
*CLINTON COUNTY ELECTRIC COOPERATIVE, INC.	Х	X
*FRONTIER COMMUNICATIONS	Х	X
*VILLAGE OF NEW BADEN		X
*WINDSTREAM KDL, INC.	Х	Х

MEMBERS OF J.U.L.I.E. CALL TOLL FREE (800) 892-0123 OR 811 AND ARE INDICATED BY .. NON- J.U.L.I.E. MEMBERS MUST BE NOTIFIED INDIVIDUALLY.

- 2. "ROAD CONSTRUCTION AHEAD" SIGNS SHALL BE PLACED AT EACH END OF THE PROJECT PLUS THE INTERSECTING SIDE ROADS AND RAMPS, AND WILL BE CONSIDERED INCLUDED IN THE TRAFFIC CONTROL PAY ITEMS. ALL CONSTRUCTION SIGNS SHALL BE 48" X 48" FLUORESCENT ORANGE.
- 3. ALL TURF AREAS DISTURBED BY THE CONTRACTOR SHALL BE SEEDED WITH THE APPROPRIATE EROSION CONTROL, AS DIRECTED BY THE ENGINEER, AT THE CONTRACTOR'S EXPENSE.
- 4. THE CONTRACTOR AND THE ENGINEER SHALL BE AWARE THAT NO SURVEY WAS PERFORMED FOR THIS PROJECT. THE STATIONING, TOPOGRAPHY, AND QUANTITIES SHOWN IN THE PLANS WERE CREATED USING MICROFILM AND FIELD MEASUREMENTS. ALL SHALL BE ASSUMED TO BE APPROXIMATE. THE CONTRACTOR SHALL VERIFY DIMENSIONS AND CONDITIONS IN THE FIELD PRIOR TO CONSTRUCTION AND ORDERING OF MATERIALS.
- 5. THE DEPARTMENT STRONGLY ENCOURAGES THE PRIME CONTRACTOR AND THEIR APPROVED SUB-CONTRACTORS TO HIRE MINORITY, WOMEN AND DISADVANTAGED INDIVIDUALS FROM ITS FEDERALLY FUNDED HIGHWAY CONSTRUCTION CAREERS TRAINING PROGRAM (HCCTP) TO HELP MEET WORKFORCE AND TRAINEE GOALS. THIS PROGRAM IS TRAINING MINORITIES, WOMEN AND DISADVANTAGED INDIVIDUALS IN HIGHWAY CONSTRUCTION-RELATED SKILLS, E.G., MATH FOR THE TRADES, JOB READINESS, TECHNICAL SKILLS COURSEWORK (CARPENTRY, CONCRETE FLATWORK, BLUEPRINT READING, SITE PLANS, SITE WORK, TOOLS USE, ETC.) AND OSHA 10 HOUR CERTIFICATION, TO PREPARE THEM FOR A CAREER IN THE HIGHWAY CONSTRUCTION TRADES. GRADUATES ARE WELL-TRAINED AND READY TO BECOME PRODUCTIVE ENTRY-LEVEL CONSTRUCTION WORKERS. CONTACT THE DISTRICT 8 EEO OFFICE AT 618-346-3360 AND/OR THE HCCTP COORDINATOR AT 618-874-6528 TO LEARN MORE ABOUT THE PROGRAM AND FOR ASSISTANCE IN MEETING WORKFORCE AND TRAINEE GOALS.

- THE PROPOSED PAVEMENT MARKINGS SHALL MATCH THE LOCATIONS OF THE EXISTING PAVEMENT MARKING, AS DIRECTED BY THE ENGINEER,
- 7. THE THICKNESS OF HOT-MIX ASPHALT SURFACE MIXTURES SHOWN ON THE PLANS IS THE NOMINAL THICKNESS. DEVIATIONS MAY OCCUR DUE TO IRREGULARITIES IN THE EXISTING SURFACE OR BASE ON WHICH THE BITUMINOUS MIXTURE IS PLACED.
- 8. AN ESTIMATED QUANTITY OF 2238 TONS OF CUTTINGS FROM THE HMA SURFACE REMOVAL OPERATION IS ANTICIPATED.
- 9. NO OVERNIGHT LANE CLOSURES WILL BE PERMITTED.
- 10. IF THE CONTRACTOR CHOOSES TO USE P.C.C. FOR PAVEMENT PATCHES THE MIX SHALL BE A HIGH EARLY STRENGTH MIXTURE.
- 11. BETWEEN STATIONS 957+71 TO 966+89 THE CONTRACTOR SHALL SEQUENCE MILLING OPERATIONS TO AVOID HAVING A LIFT DIFFERENCE GREATER THAN 2" OR HAVING GREATHER THAN A 1.5" VERTICAL MILLED FACE.
- 12. TEMPORARY ENTRANCE RAMPS SHALL BE CONSTRUCTED USING INCIDENTAL HMA MIX, AT ALL INTERSTATE ON/OFF RAMPS, ENTRANCES, AND SIDE ROADS THAT ARE WITHIN THE PROJECT CONSTRUCTION LIMITS. THE TEMPORARY ENTRANCE RAMPS SHALL BE AS WIDE AS THE EXISTING ENTRANCE AND EXTENDING APPROXIMATELY 2 FT. LONG INTO THE TRAVEL LANES. SEE ENTRANCE DETAIL ON SHEET 15. TEMPORARY ENTRANCE RAMPS WILL BE PAID FOR WITH THE TEMPORARY RAMP PAY CODE.
- 13. SHORT TERM PAVEMENT MARKING REMOVAL IS INCLUDED IN THE QUANTITIES BUT WILL ONLY BE PAID IF THE SHORT TERM PAVEMENT MARKING REMOVAL IS USED ON THE FINAL HMA SURFACE OR AS DIRECTED BY THE ENGINEER.

MIX REQUIREMENTS

ROUTE	FAP ROUTE 805
SECTION	125RS-6
COUNTY	ST. CLAIR
CONTRACT	76K19

	3P RESURFACING ON IL 161 FROM I-64 W OF EB RAMPS TO ONE STOP DRIVE IN NEW BADEN.
--	--

MIXTURE USE	POLY SURFACE	LEVEL BINDER	INCIDENTAL	PATCHING
AC/PG	SBS PG 76-22	PG 64-22	PG 64-22	PG 64-22
RAP % (MAX)	SEE SPECIAL PROVISION	SEE SPECIAL PROVISION	SEE SPECIAL PROVISION	SEE SPECIAL PROVISION
DESIGN AIR VOIDS	4.0% @ Ndes=70	4.0% @ Ndes=70	4.0% @ Ndes=70	4.0% @ Ndes=70
MIX COMPOSITION (Gradation)	IL 9.5	IL 9.5FG	IL 9.5	IL 19.0
FRICTION AGG	MIXTURE "D"	MIXTURE "C"	MIXTURE "C"	MIXTURE "B"
QUALITY MGMT PROGRAM	QCP	QC/QA	QC/QA	QC/QA

PLAN QUANTITIES FOR HMA SURFACE COURSE ITEMS ARE CALCULATED USING A UNIT WEIGHT OF 112 LB/SQ YD/IN (59.8 KG/SQ M/25 MM THICKNESS)

SCALE: N/A

COMMITMENTS

NONE

FILE NAME =	USER NAME = CoppernollPE	DESIGNED -	REVISED -
D876K19-sht-gennote.dgn		DRAWN -	REVISED -
	PLOT SCALE = 100.0000 '/ in.	CHECKED -	REVISED -
Default	PLOT DATE = 3/22/2017	DATE -	REVISED -

STATI	E OF	ILLINOIS
DEPARTMENT	0F	TRANSPORTATION

ŀ	HIGHWA	Y STAN	DARDS,					F.A.P RTE.	SEC	TION	COUNTY	TOTAL SHEETS	
CENER	AL NOTE	:C &. rr		FNITS				805	125	RS-6	ST. CLAIR	15	ĺ
GLINEIN	AL NOIL	.5, & 00	/ IVI I VI I I I I I I I I I I I I I I I	LIVIO							CONTRAC	T NO.	7
SHEET 1	OF 1	SHEETS	STA. N/	A	T0 S1	A. N/	′ A	ILLINOIS FED. AID PROJECT					

2

100 % STATE

CONSTR. CODE

ROADWAY CODE TOTAL 0005 ITEM UNIT QUANTITY RURAL NO. 40600290 BITUMINOUS MATERIALS (TACK COAT) POUND 5032 5032 40600295 POLYMERIZED BITUMINOUS MATERIALS (TACK COAT) POUND 2516 2516 40600637 LEVELING BINDER (MACHINE METHOD), IL-9.5FG, N70 TON 626 626 40600982 HOT-MIX ASPHALT SURFACE REMOVAL - BUTT JOINT SQ YD 87 87 TEMPORARY RAMP SQ YD 373 373 40600990 40603540 POLYMERIZED HOT-MIX ASPHALT SURFACE COURSE, MIX "D", N70 1252 1252 40800050 INCIDENTAL HOT-MIX ASPHALT SURFACING TON 6 6 44000161 HOT-MIX ASPHALT SURFACE REMOVAL, 3" SO YD 11096 11096 44000500 COMBINATION CURB AND GUTTER REMOVAL FOOT 80 80

SO YD

SO YD

SO YD

FOOT

SQ FT

110

105

142

80

400

110

105

142

80

400

100 % STATE

CONSTR. CODE

CODE			TOTAL	ROADWAY 0005
NO.	ITEM	UNIT	QUANTITY	RURAL
	2 holf4			HOME
57000400	ENGINEER'S FIELD OFFICE, TYPE A	CAL MO	7	1
67100100	MOBILIZATION	LSUM	4	1
70100450	TRAFFIC CONTROL AND PROTECTION, STANDARD 701201	LSUM	1	1
70100460	TRAFFIC CONTROL AND PROTECTION, STANDARD 701306	LSUM	1	1
70100600	TRAFFIC CONTROL AND PROTECTION, STANDARD 701336	LSUM	1	1
70100820	TRAFFIC CONTROL AND PROTECTION, STANDARD 701451	LSUM	1	1
70102632	TRAFFIC CONTROL AND PROTECTION, STANDARD 701602	LSUM	1	1
70300100	SHORT TERM PAVEMENT MARKING	FOOT	2291	2291
70300150	SHORT TERM PAVEMENT MARKING REMOVAL	SQ FT	764	764
70300210	TEMPORARY PAVEMENT MARKING LETTERS AND SYMBOLS	SO FT	187	187
70300220	TEMPORARY PAVEMENT MARKING - LINE 4"	FOOT	21804	21804
70300260	TEMPORARY PAVEMENT MARKING - LINE 12"	FOOT	193	193
78000100	THERMOPLASTIC PAVEMENT MARKING - LETTERS AND SYMBOLS	SQ FT	94	94
78000200	THERMOPLASTIC PAVEMENT MARKING - LINE 4"	FOOT	10902	10902

* SPECIALTY ITEM

44200192 PAVEMENT PATCHING, TYPE II. 16 INCH

44200196 PAVEMENT PATCHING, TYPE III. 16 INCH

44200198 PAVEMENT PATCHING, TYPE IV. 16 INCH

60618300 CONCRETE MEDIAN SURFACE, 4 INCH

60605900 COMBINATION CONCRETE CURB AND GUTTER, TYPE B-9.12

STATE OF ILLINOIS
DEPARTMENT OF TRANSPORTATION

14

100% STATE


CONSTR. CODE

		water a second	TOTAL	ROADWAY 0005
CODE NO.	ITEM	UNIT	TOTAL QUANTITY	RURAL
78000600	THERMOPLASTIC PAVEMENT MARKING - LINE 12"	FOOT	97	97
78100100	RAISED REFLECTIVE PAVEMENT MARKER	EACH	33	33
78200020	CURB REFLECTORS	EACH	119	119
78300200	RAISED REFLECTIVE PAVEMENT MARKER REMOVAL	EACH	75	75
X4402020	CONCRETE MEDIAN SURFACE REMOVAL	SO FT	400	400
			204	204
X7015005	CHANGEABLE MESSAGE SIGN	CAL DA	204	204
X7030005	TEMPORARY PAVEMENT MARKING REMOVAL	SO FT	3824	3824
X7800100	PAINT PAVEMENT MARKING - RAISED MEDIAN	SO FT	31	31
X7800200	PAINT PAVEMENT MARKING CURB	FOOT	184	184
		1		
Z0016702	DETOUR SIGNING	LSUM	1	1
Z0033700	LONGITUDINAL JOINT SEALANT	FOOT	6070	6070
Z0034105	MATERIAL TRANSFER DEVICE	TON	1879	1879

12

* SPECIALTY ITEM

FILE NAME :	USER NAME = CoppernolIPE	DESIGNED -	REVISED -					······································		F.A.P. RTE.	SECTION	COUNTY	TOTAL	SHEET NO.
0876K19-sht-500.dgn		DRAWN -	REVISED -	STATE OF ILLINOIS		S	UMMARY	OF QUANTITIES		805	125RS-6	ST. CLAIR	Į\$	4
1	PLOT SCALE * 100.0060 '/ in.	CHECKED -	REVISED -	DEPARTMENT OF TRANSPORTATION								CONTRAC	CT NO.	76K19
Default	PLOT DATE - 3/22/2017	DATE -	REVISED -		SCALE: N/A	SHEET 2	OF 2	SHEETS STA. N/A	TO STA. N/A		ILL INDIS FEO.	ATO PROJECT		

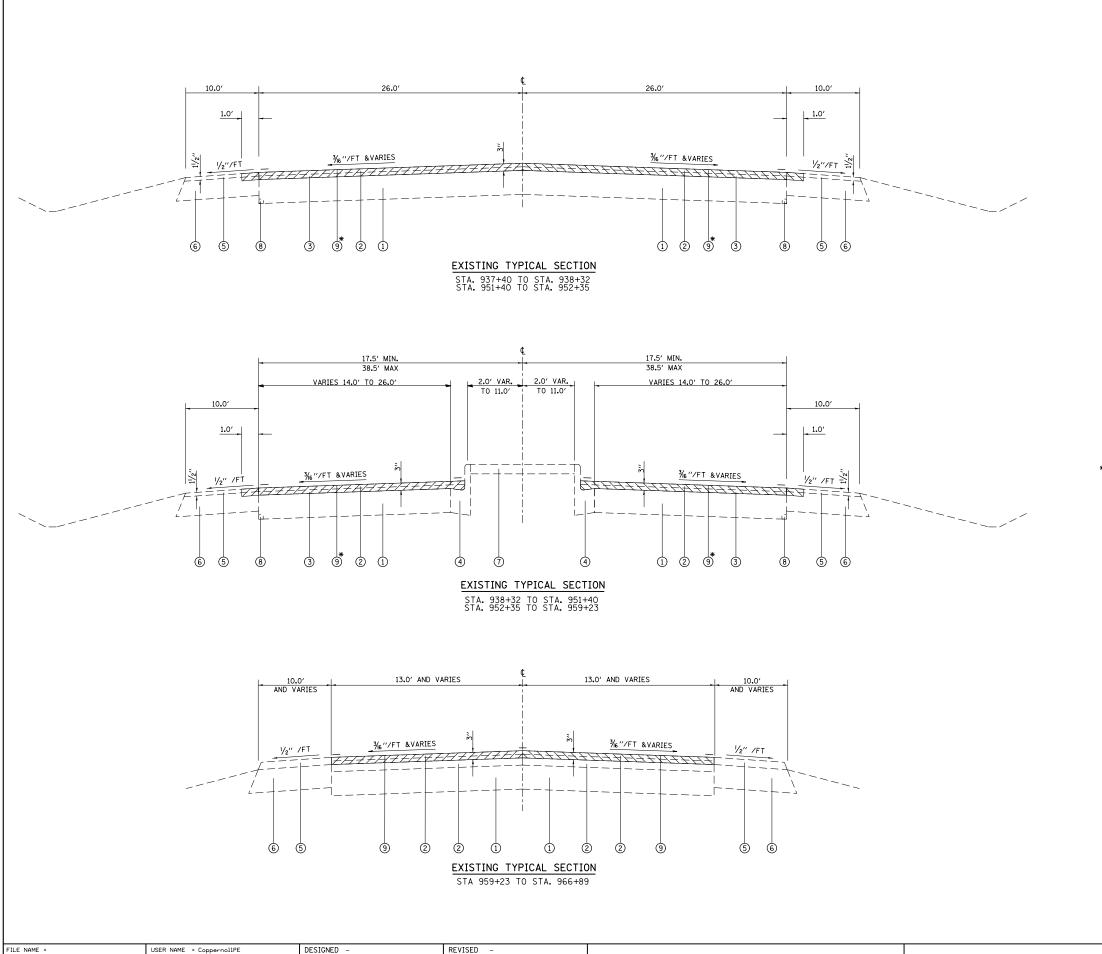

STATE OF ILLINOIS

DEPARTMENT OF TRANSPORTATION

USER NAME = Coppernol1PE

PLOT DATE = 3/22/2017

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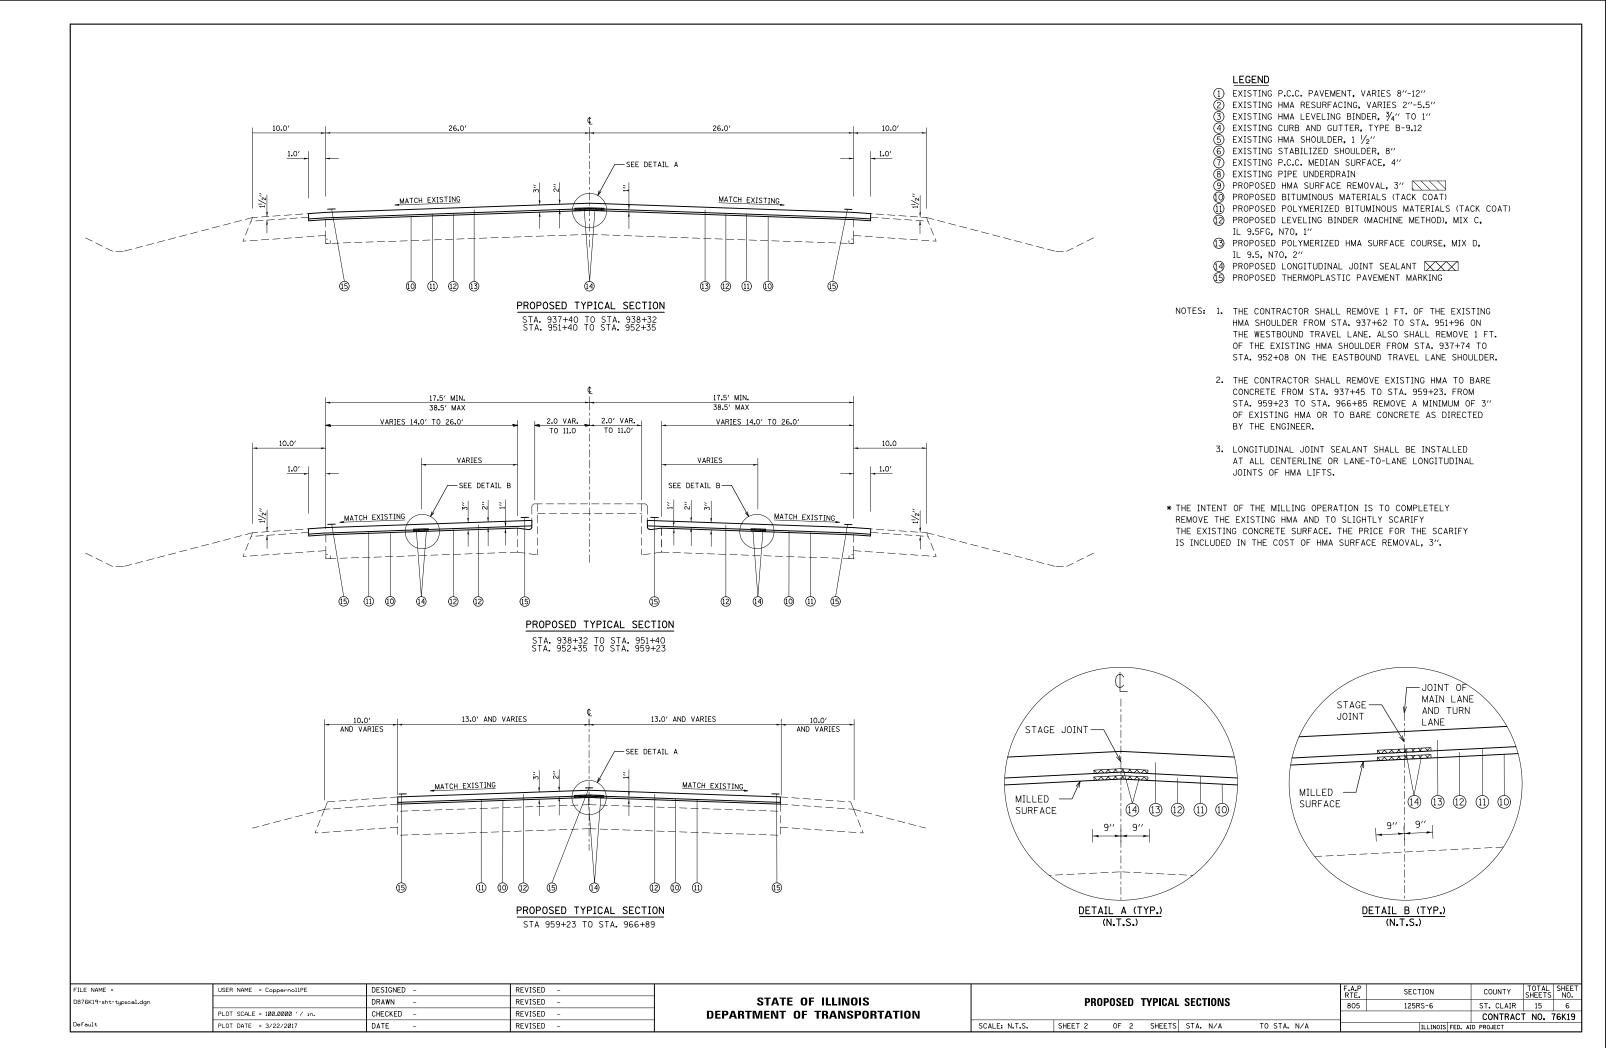
REVISED

D876K19-sht-typical.dgr

LEGEND

- EXISTING P.C.C. PAVEMENT, VARIES 8"-12"
- EXISTING HMA RESURFACING, VARIES 2"-5.5" EXISTING HMA LEVELING BINDER, 3/4" TO 1"
- 4 EXISTING CURB AND GUTTER, TYPE B-9.12
 5 EXISTING HMA SHOULDER, 1 1/2"
- EXISTING STABILIZED SHOULDER, 8"
- EXISTING P.C.C. MEDIAN SURFACE, 4"
- 8 EXISTING PIPE UNDERDRAIN
- PROPOSED HMA SURFACE REMOVAL, 3"
- PROPOSED BITUMINOUS MATERIALS (TACK COAT)
- PROPOSED POLYMERIZED BITUMINOUS MATERIALS (TACK COAT)
- PROPOSED LEVELING BINDER (MACHINE METHOD), MIX C, IL 9.5FG, N70, 1"
- 3 PROPOSED POLYMERIZED HMA SURFACE COURSE, MIX D, IL 9.5, N70, 2"
- (4) PROPOSED LONGITUDINAL JOINT SEALANT XXX (5) PROPOSED THERMOPLASTIC PAVEMENT MARKING
- NOTES: 1. THE CONTRACTOR SHALL REMOVE 1 FT. OF THE EXISTING HMA SHOULDER FROM STA. 937+62 TO STA. 951+96 ON THE WESTBOUND TRAVEL LANE. ALSO SHALL REMOVE 1 FT. OF THE EXISTING HMA SHOULDER FROM STA. 937+74 TO STA. 952+08 ON THE EASTBOUND TRAVEL LANE SHOULDER.
 - 2. THE CONTRACTOR SHALL REMOVE EXISTING HMA TO BARE CONCRETE FROM STA. 937+45 TO STA. 959+23. FROM STA. 959+23 TO STA. 966+85 REMOVE A MINIMUM OF $3^{\prime\prime}$ OF EXISTING HMA OR TO BARE CONCRETE AS DIRECTED BY THE ENGINEER.
 - 3. LONGITUDINAL JOINT SEALANT SHALL BE INSTALLED AT ALL CENTERLINE OR LANE-TO-LANE LONGITUDINAL JOINTS OF HMA LIFTS.
- * THE INTENT OF THE MILLING OPERATION IS TO COMPLETELY REMOVE THE EXISTING HMA AND TO SLIGHTLY SCARIFY THE EXISTING CONCRETE SURFACE. THE PRICE FOR THE SCARIFY IS INCLUDED IN THE COST OF HMA SURFACE REMOVAL, 3".

						RTE.	SECTION	COUNTY	SHEETS	NO.
	EX	ISTING T	YPICAL	SECTIONS		805	125RS-6	ST. CLAIR	15	5
								CONTRAC	T NO.	76K19
SCALE: N.T.S.	SHEET 1	0F 2	SHEETS	STA. N/A	TO STA. N/A		ILLINOIS FED. AI	D PROJECT		



					RESURFACING S	CHEDULE		
L	LOCATION RE		HMA SURFACE REMOVAL, 3"	BITUMINOUS MATERIALS (TACK COAT)	POLYMERIZED BITUMINOUS MATERIALS (TACK COAT)	LEVELING BINDER (MACHINE METHOD), IL-9.5FG, N70, 1"	POLYMERIZED HMA SURFACE COURSE, MIX "D", N70, 2"	LONGITUDINAL JOINT SEALANT
STA	TO	STA	SQ YD	POUND	POUND	TON	TON	FOOT
937+40	TO	938+32	473.8	239.2	119.6	29.8	59.5	552.0
938+32	TO	951+40	5418.7	2438.4	1219.2	303.4	606.9	2040.0
951+40	TO	952+35	548.9	247.0	123.5	30.7	61.5	570.0
952+35	ТО	959+23	2429.9	1093.5	546.7	136.1	272.1	1376.0
959+23	TO	966+89	2224.9	1014.2	507.1	126.2	252.4	1532.0
	SUE	- TOTAL:	11096.1	5032.3	2516.1	626. 2	1252.5	6070.0
ROUNDED TOTAL:		11096	5032	2516	626	1252	6070	

	HMA S	URFACE REM	OVAL - BL	JIT JOIN	NT .
STATION	LOCATION	ROUTE	LENGTH	WIDTH	HMA SURFACE REMOVAL - BUTT JOINT
			FOOT	FOOT	SQ YD
937+40	EB	IL 161	10	26	29
937+40	WB	IL 161	10	26	29
966+89	EB	IL 161	10	13	1 4
966+89	WB	IL 161	10	13	1 4
				TOTAL:	87

							PAVEME	NT MARKING	SCHEDULE							
					THERMOPLA	STIC PAVEMENT 1	MARKING									
					LINE - 4'	,		LINE - 12"			PAINT		RAISED	RAISED	RAISED	CURB
LOCATION				AN/CL YELLOW	TURN LANE SOLID WHITE	SOLID DOUBLE-YELLOW	SKIP-DASH YELLOW CENTERLINE	SOLID YELLOW	LETTERS AND SYMBOLS	PAINT PAVEMENT MARKING CURB	MENT PAVEMENT MENT MARKING -	RAISED REFLECTIVE PAVEMENT MARKER REMOVAL	REFLECTIVE PAVEMENT MARKERS (ONE-WAY CRYSTAL)	REFLECTIVE PAVEMENT MARKERS (ONE-WAY AMBER)	REFLECTIVE PAVEMENT MARKERS (TWO-WAY CRYSTAL)	REFLECTORS (ONE-WAY AMBER PRISMATIC)
	WB	EB	WB	EB												
	FOOT	FOOT	FOOT	FOOT	FOOT	FOOT	FOOT	FOOT	SQ FT	FOOT	SQ FT	EACH	EACH	EACH	EACH	EACH
937+40 TO 938+32	70	58														
938+32 TO 951+40	1308	1308	1312	1312	562				93.6	116	14	47	18			72
951+40 TO 952+35	56	68														
952+35 TO 960+00	660	638	563	540		808	10	96.6		68	17	19		6		47
960+00 TO 966+89	588	689	172				180					9			9	
SUB - TOTAL:	54	43	38	399	562	808	190	96.6	93.6	184	31	75	18	6	9	119
ROUNDED TOTAL:		·			10902	•		97	94	184	31	75		33		119

				TEMPORAR	Y PAVEMENT MARKIN	NG SCHEDULE		
LOCATION		ON	SHORT TERM PAVEMENT MARKING (3 LIFTS)	SHORT TERM PAVEMENT MARKING REMOVAL (1 REMOVAL)	TEMPORARY PAVEMENT MARKING LETTERS AND SYMBOLS (2 LIFTS)	TEMPORARY PAVEMENT MARKING - LINE 4" (2 LIFTS)	TEMPORARY PAVEMENT MARKING - LINE 12" (2 LIFTS)	TEMPORARY PAVEMENT MARKING REMOVAL (1 REMOVAL)
			FOOT	SQ FT	FOOT	FOOT	FOOT	SQ FT
937+40	ТО	938+32	15	5		256		43
938+32	ТО	951+40	1270	423	187	11604		2028
951+40	ТО	952+35	15	5		248		41
952+35	ТО	960+00	732	244		6438	193	1170
960+00	ТО	966+89	259	86		3258	0	543
		TOTAL:	2291	764	187	21804	193	3824

	СОМ	BINATION	CURB AND GUTTER	
LOCATION (APPROXIMATE)		TYPE OF CURB	COMBINATION CURB AND GUTTER REMOVAL	COMBINATION CURB AND GUTTER B-9.12
STATION	EB/WB		FOOT	FOOT
943+50	EB	B-9.12	5	5
944+50	EB	B-9.12	10	10
945+00	WB	B-9.12	25	25
954+50	WB	B-9.12	10	10
955+00	WB	B-9.12	20	20
956+00	WB	B-9.12	10	10
		TOTAL:	80	80

FILE NAME =	USER NAME = CoppernolIPE	DESIGNED -	REVISED -
D876K19-sht-schedule.dgn		DRAWN -	REVISED -
	PLOT SCALE = 100.0000 '/ in.	CHECKED -	REVISED -
Default	PLOT DATE = 3/22/2017	DATE -	REVISED -

STATI	: OI	F ILLINOIS
DEPARTMENT	0F	TRANSPORTATION

						F.A.P. RTE.	SECTION	COUNTY	TOTAL SHEETS	SHEET NO.
	S	CHEDULE	OF QUA	ANTITIES		805	125RS-6	ST. CLAIR	15	7
								CONTRAC	T NO.	76K19
SCALE: N/A	SHEET 1	0F 2	SHEETS	STA. N/A	TO STA. N/A		ILLINOIS FED. AI	D PROJECT		

			PAVEME	NT	PATCHI	NG 16 IN	CH SCHEDULE		
L	OCATIO	N	LANE		LENGTH	LANE WIDTH	PAVEMENT PATCHING TYPE II	PAVEMENT PATCHING TYPE III	PAVEMENT PATCHING TYPE IV
FAP 8	05 (IL	. 161)			FOOT	FOOT	SQ YD	SQ YD	SQ YD
938+34	TO	938+40	EB		6	14	9. 3		
942+30	TO	942+40	WB		10	20		22. 2	
943+67	TO	943+75	WB		8	14	12.4		
944+50	ТО	944+56	EB		6	14	9. 3		
945+37	TO	945+43	WB		6	14	9. 3		
946+00	ТО	946+06	EB		6	14	9. 3		
946+15	TO	946+21	EB		6	14	9. 3		
954+69	TO	954+75	WB		6	14	9. 3		
955+00	TO	955+20	WB		20	14			31.1
956+00	TO	956+06	WB		6	14	9. 3		
958+09	TO	958+15	WB		6	14	9. 3		
959+24	TO	959+30	EB & V	VB	6	26		17.3	
960+53	TO	960+59	EB & V	VB	6	26		17.3	
962+00	TO	962+20	EB & V	VB	20	26			57.8
962+85	TO	962+91	EB & V	VB	6	26		17.3	
963+70	TO	963+76	EB		6	13	8.7		
964+30	TO	964+36	EB & V	VB	6	26		17.3	
964+60	TO	964+66	EB & V	VB	12	26			34.7
					SUB	- TOTAL:	95.8	91.6	123.6
		AN	TICIPAT	ED	FAILURE	S (15%):	14.4	13.7	18.5
						TOTAL:	110	105	142

		INCIDENTAL HMA SUR	FACING S	SCHEDULE		
STATION	LOCATION	ROUTE	LENGTH	H WIDTH	AREA	INCIDENTAL HMA SURFACING
			FOOT	FOOT	SQ YD	TON
944+02	WB	IL 161 HMA WEDGE UNDER I-64 EB BRIDGE	3	56	19	6
				TOTAL:	19	6


	CONCRETE MEDIAN										
LOCATION (APPROXIMATE)	LENGTH	AVERAGE WIDTH	AREA	CONCRETE MEDIAN SURFACE REMOVAL	CONCRETE MEDIAN SURFACE, 4"						
STATION	FOOT	FOOT	SQ FT	SQ FT	SQ FT						
948+45	50	8	400	400	400						
		TOTAL:	400	400	400						


			TEMPORARY RAMP SCHEDL	JLE		
STATION	LOCATION		ROUTE	LENGTH	WIDTH	TEMPORARY RAMP
				FOOT	FOOT	SQ YD
931+80	EB	IL 161	START OF PROJECT	10	26	29
931+80	WB	IL 161	START OF PROJECT	10	26	29
937+45	WB	IL 161	AT I-64 EB OFF RAMP	2	25	6
937+45	EB	IL 161	AT I-64 EB ON RAMP	2	25	6
952+67	EB	IL 161	AT I-64 WB OFF RAMP	2	70	16
952+67	WB	IL 161	AT I-64 WB ON RAMP	2	115	26
960+38	EB	IL 161	AT PARK & RIDE	2	75	17
960+52	WB	IL 161	AT RUTH SCHOOL RD.	2	100	22
963+82	EB	IL 161	AT CASEYS CONC. ENT.	2	70	16
966+06	EB	IL 161	AT ONE STOP DR.	2	165	37
966+85	EB	IL 161	END OF PROJECT	10	13	14
966+85	WB	IL 161	END OF PROJECT	10	13	14
				SUB -	- TOTAL:	187
			TOTA	L FOR TWO	LIFTS:	373


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Default	PLOT DATE = 3/22/2017	DATE -	REVISED -		


STATE 0	F ILLINOIS
DEPARTMENT OF	TRANSPORTATION

SCHEDULE OF QUANTITIES							SECTION	COUNTY	TOTAL SHEETS	SHEET NO.
							125RS-6	ST. CLAIR	15	8
					CONTRAC	T NO.	76K19			
SCALE: N/A	SHEET 2	0F 2		ILLINOIS FED. A	D PROJECT					

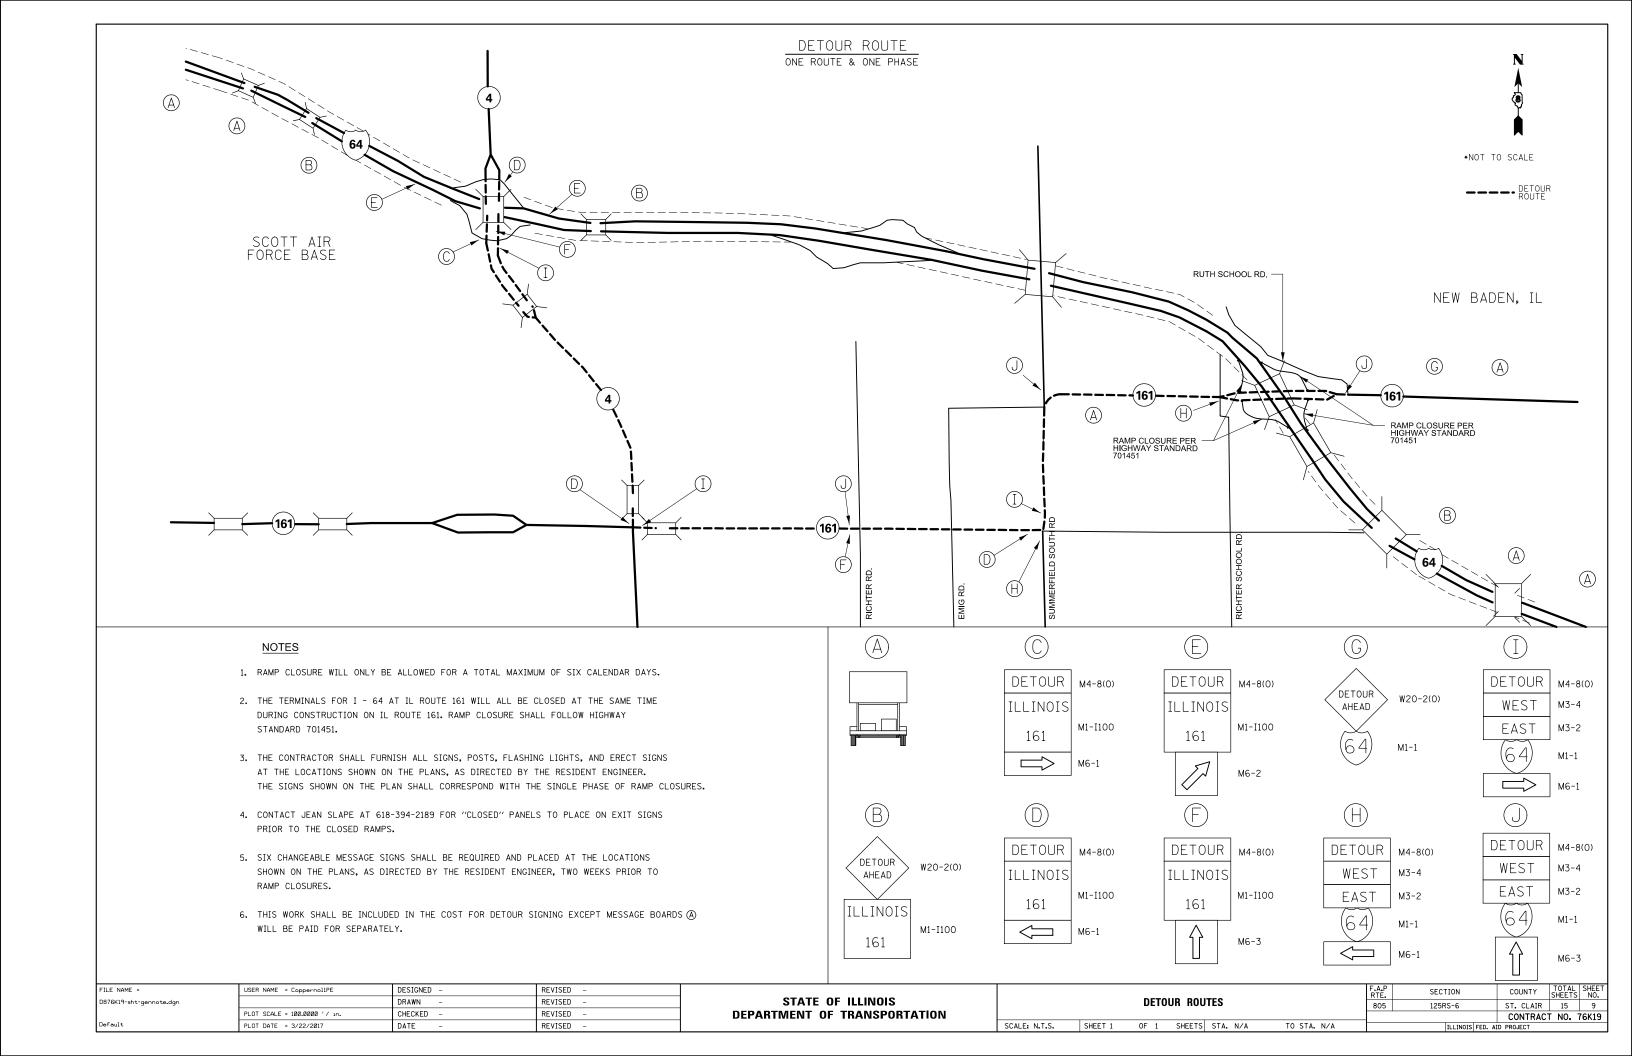


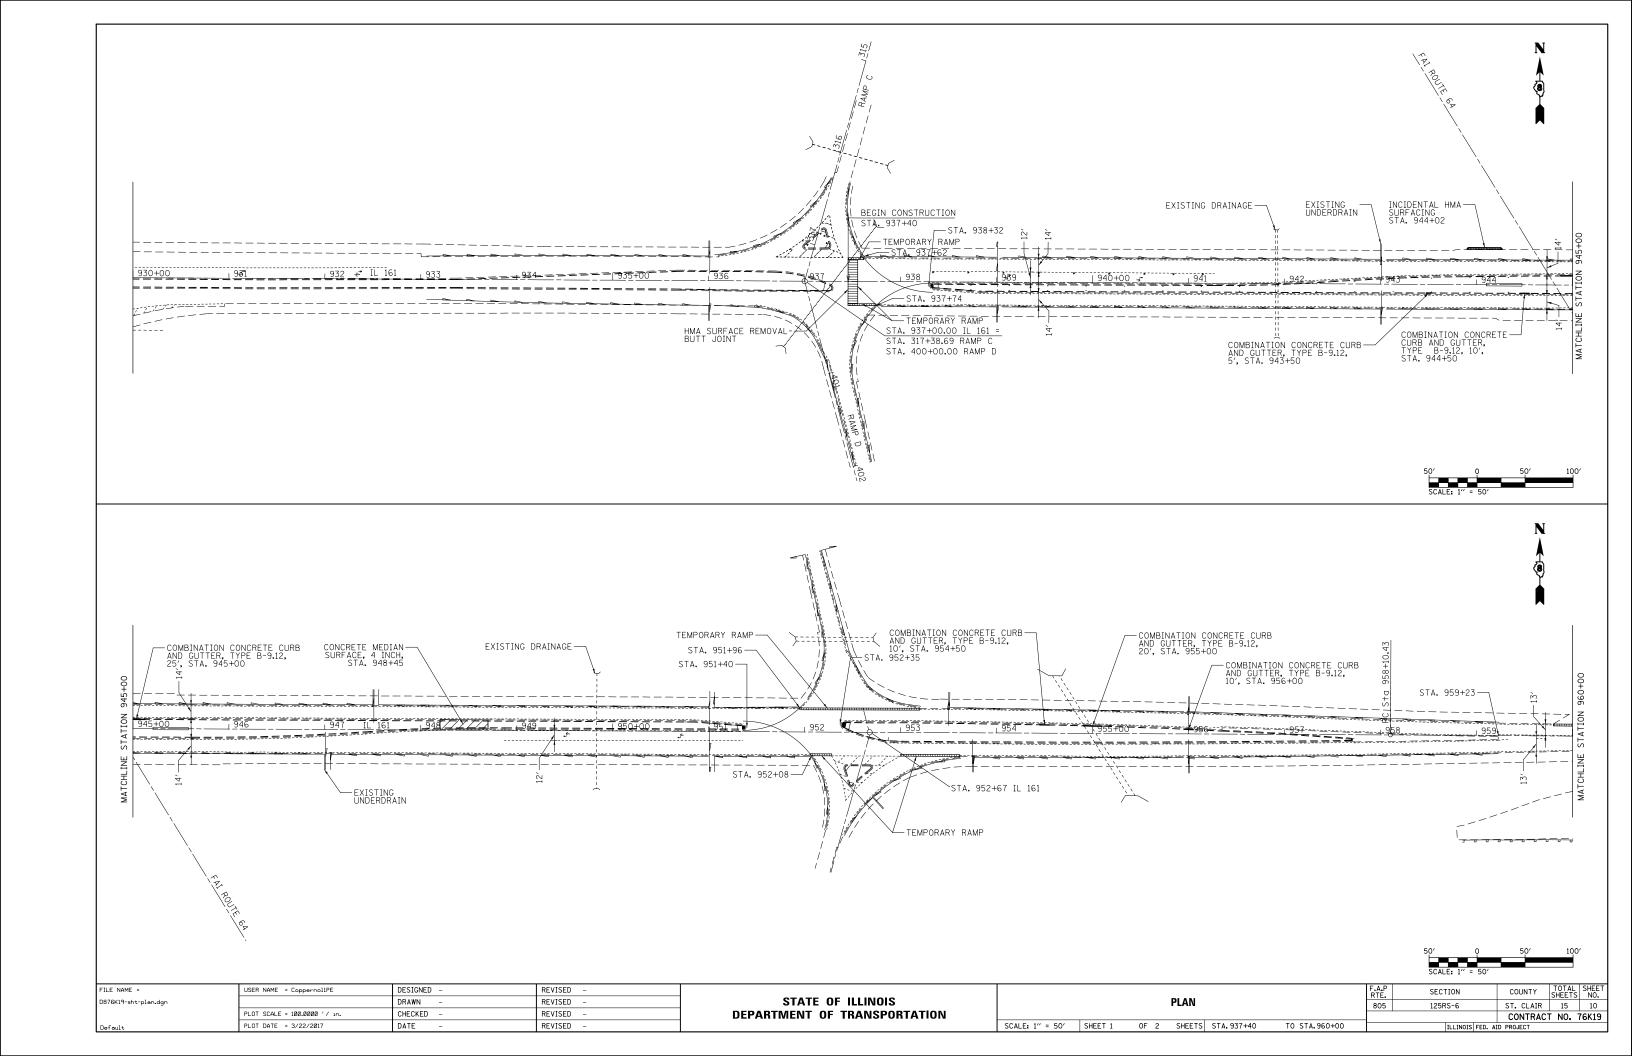


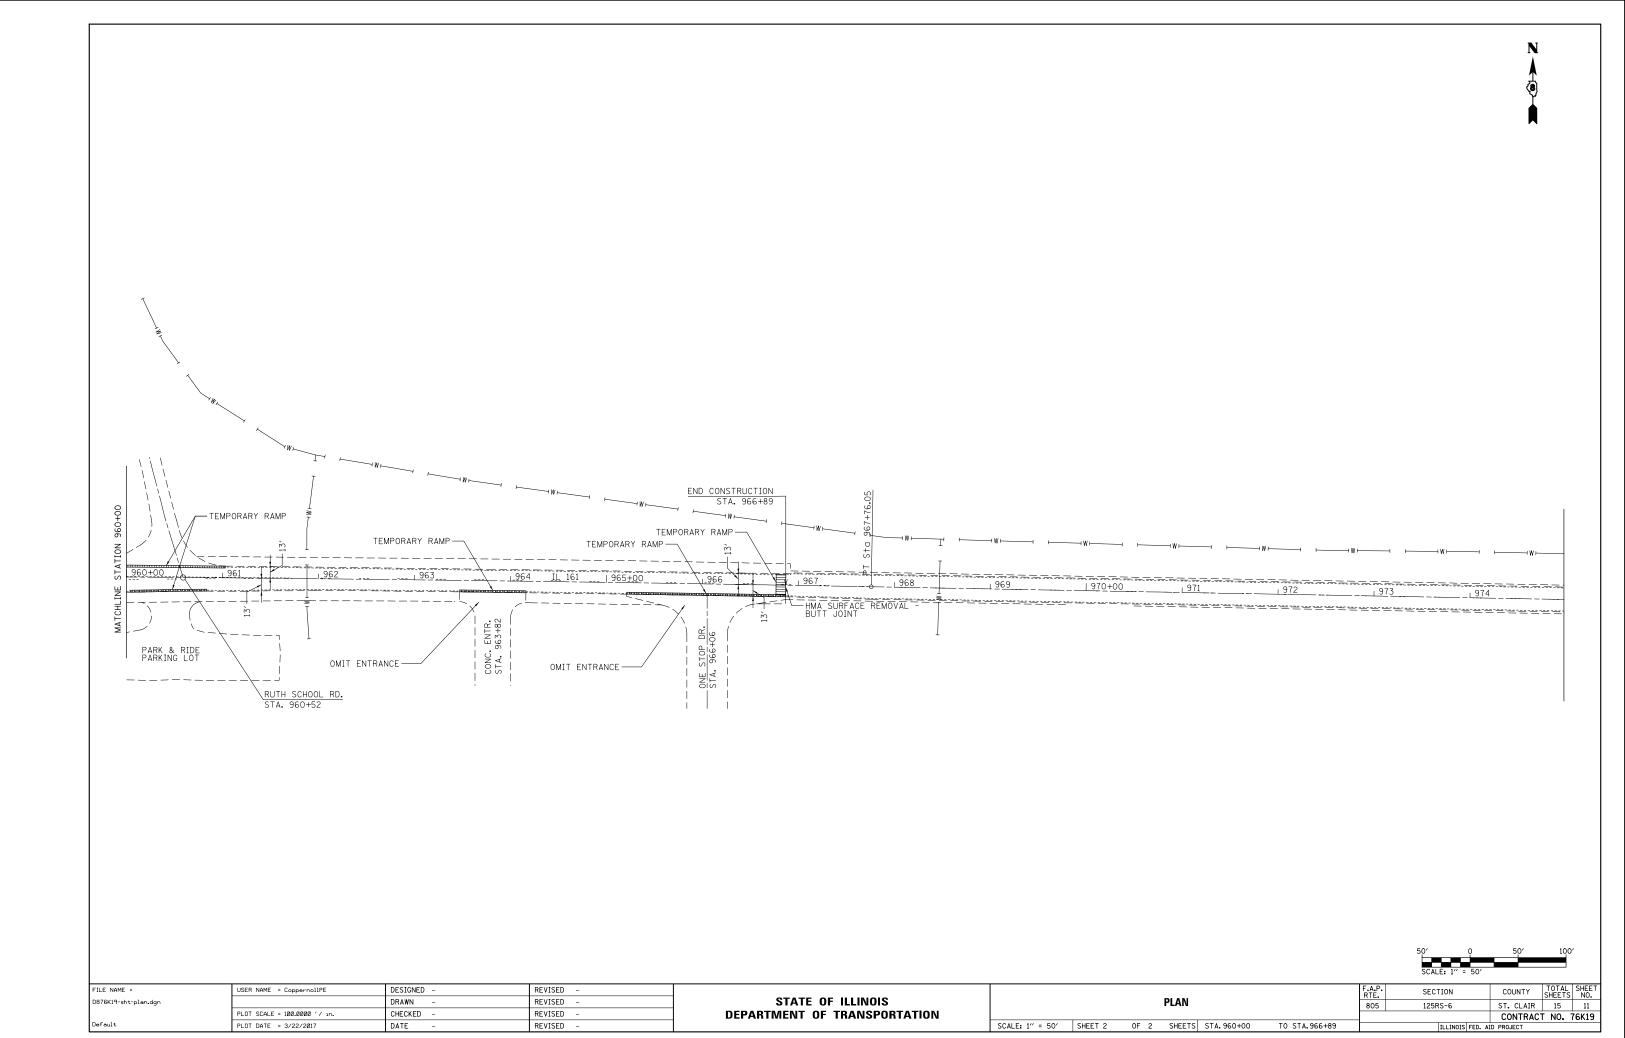

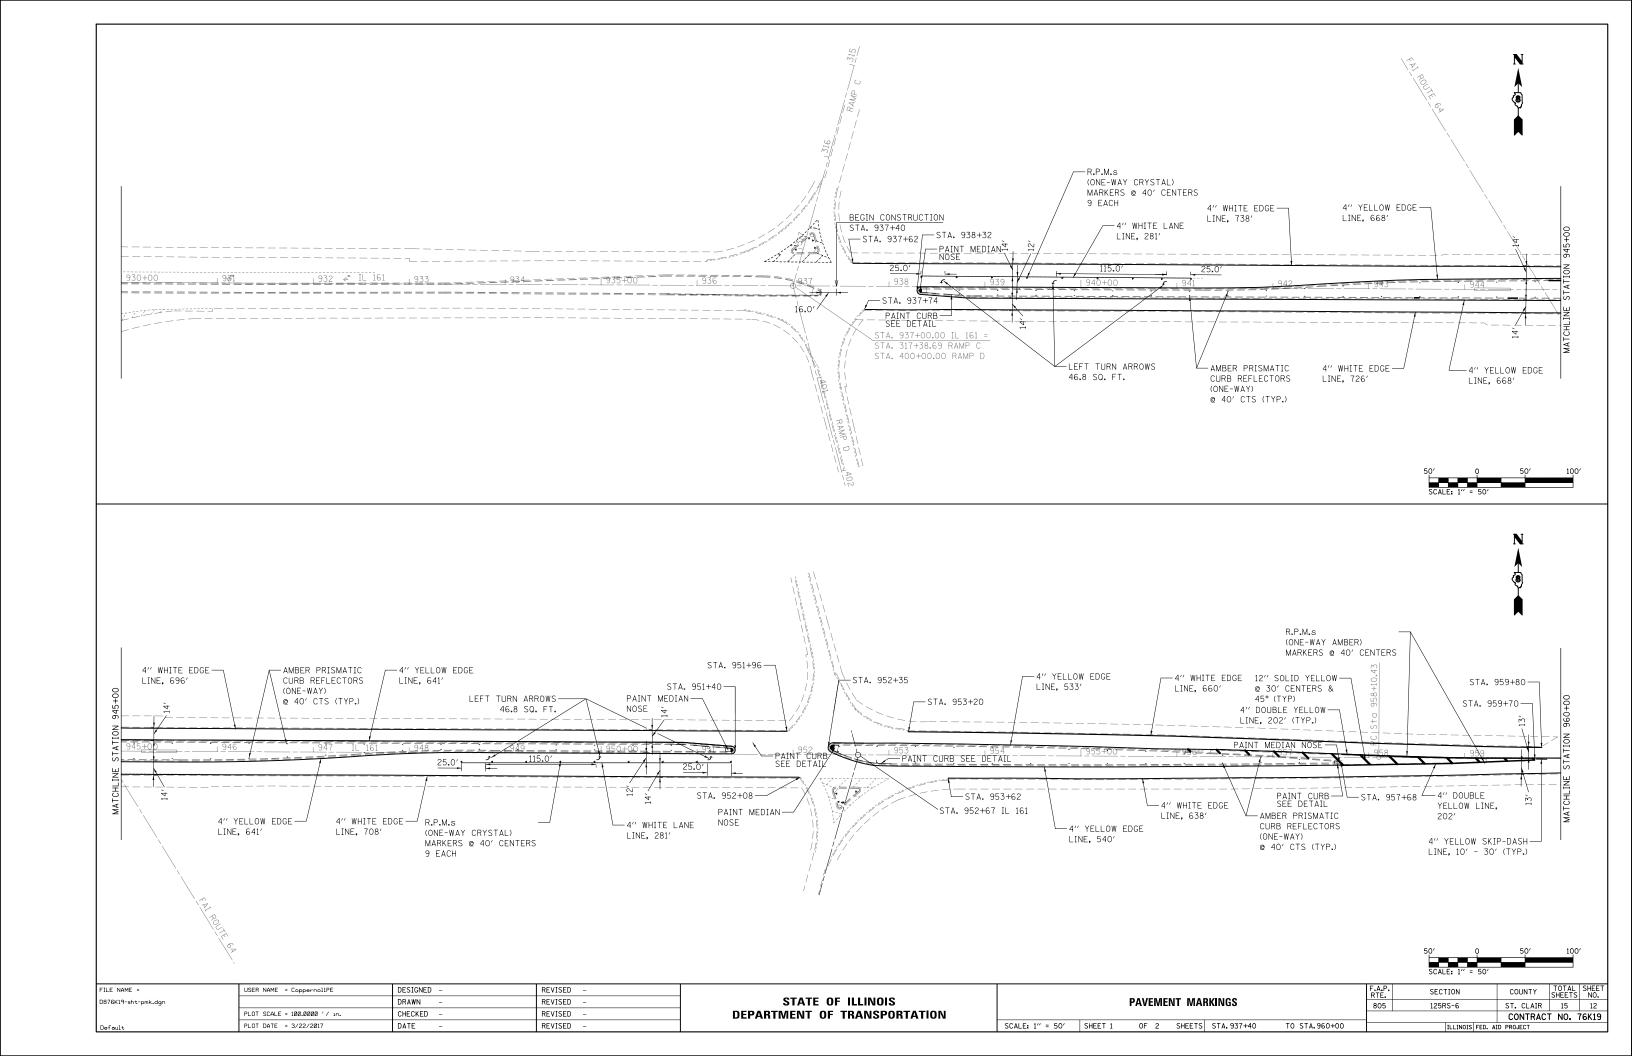

NO P LINE, 960+00 STA. 961+01 RT	ELLOW ASSING ZONE 172' STA. 961+72	<u>963</u>	LINE, 588'	END CONSTRUCTION STA, 966+89 1966 1967 1968 1971 1968 1971 1968 1971	9 1970-00 1971 197	2 973
FILE NAME = D876K19-sht-pmk.dgn Default	USER NAME = CoppernolIPE PLOT SCALE = 100.0000 '/ in. PLOT DATE = 3/22/2017	DESIGNED - DRAWN - CHECKED - DATE -	REVISED - REVISED - REVISED - REVISED -	STATE OF ILLINOIS DEPARTMENT OF TRANSPORTATION	PAVEMENT MARKINGS SCALE: 1" = 50' SHEET 2 OF 2 SHEETS STA. 960+00	F.A.P. SECTION COUNTY TOTAL SHEET NO.

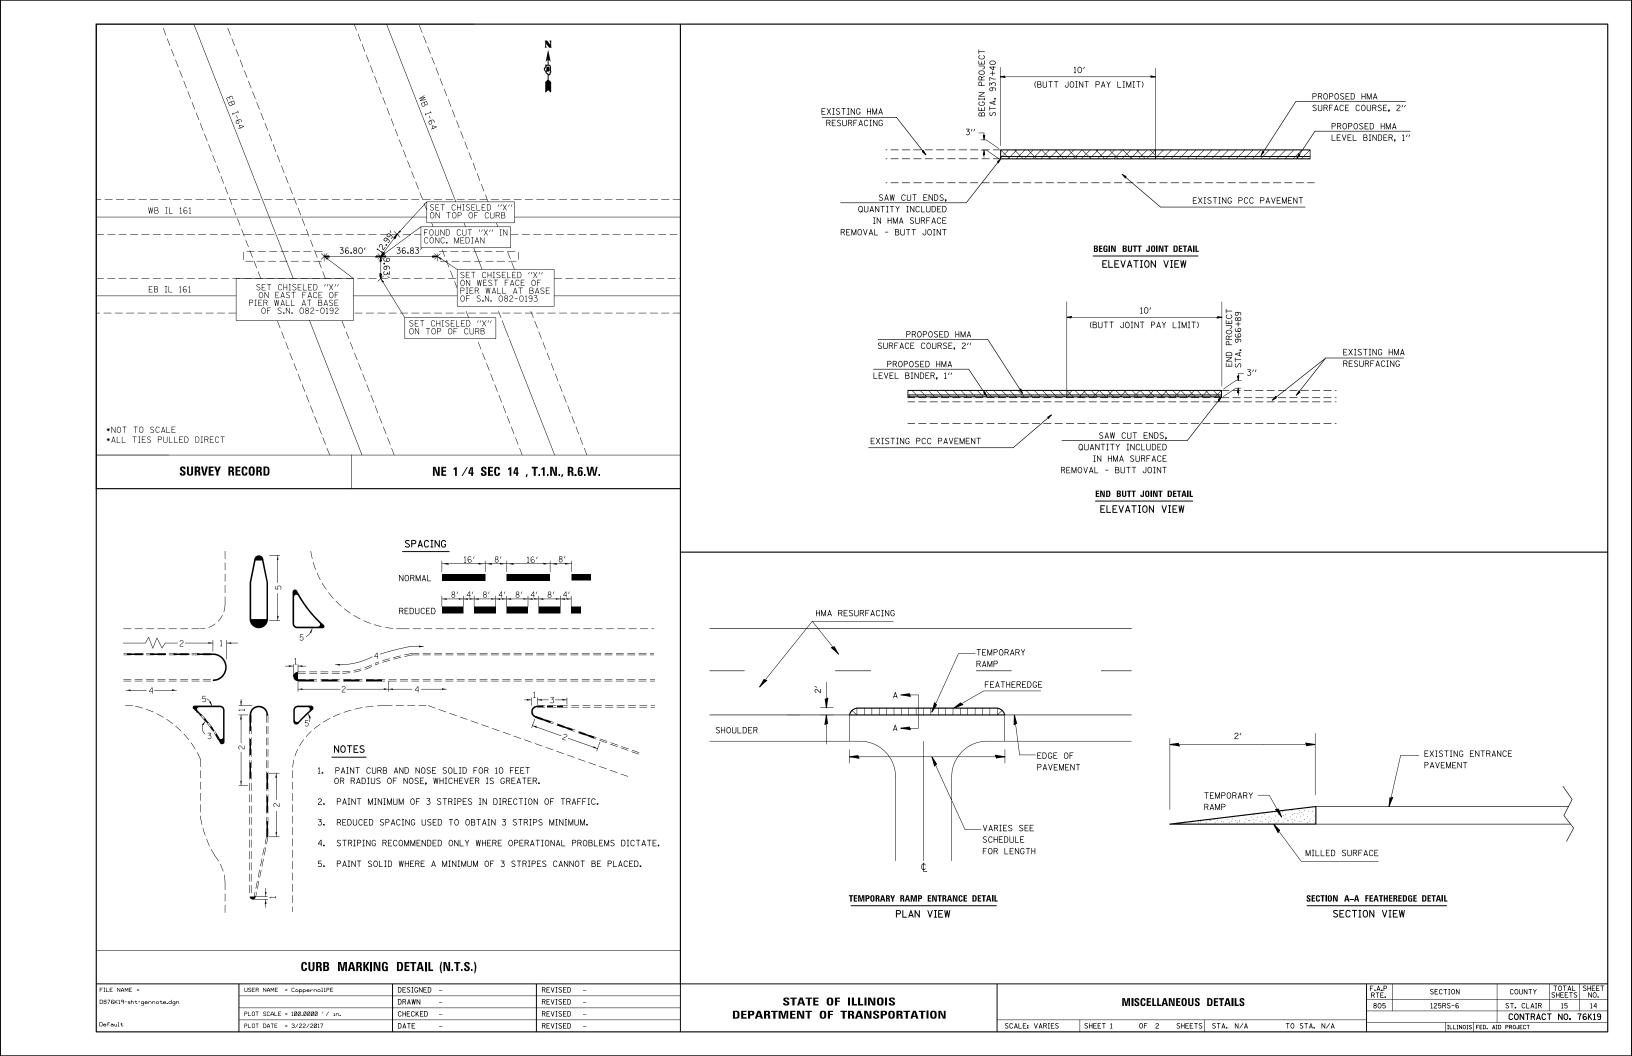


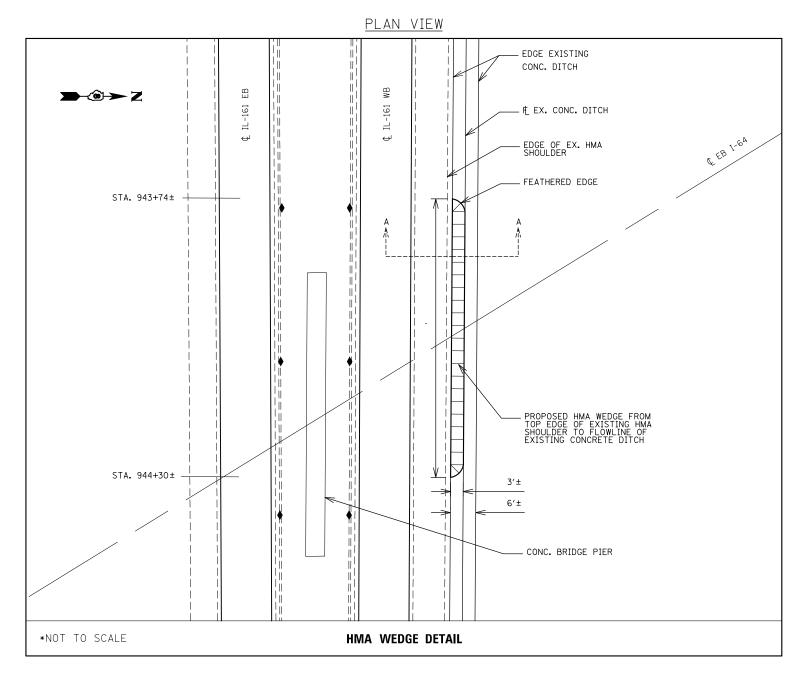

<u>NOTES</u>

- 1. THE SURFACE OF EXISTING CONCRETE DITCH UNDER BRIDGE SHALL BE FREE OF MOISTURE, LOOSE DEBRIS, AND MATERIAL BEFORE HMA WEDGE IS PLACED. CLEANING AND PREPARING THE CONCRETE DITCH SHALL NOT BE MEASURED FOR PAYMENT BUT SHALL BE INCLUDED IN THE COST OF INCIDENTAL HMA SURFACING.
- 2. INCIDENTAL IL 9.5, MIXTURE "C", HMA MIX SHALL BE USED FOR THE WEDGE, SEE GENERAL NOTES SHEET FOR EXACT MIX REQUIREMENTS.
- 3. THE BEGINNING AND END OF HMA WEDGE SHALL HAVE FEATHEREDGE ENDS WITH NO SIGNIFICANT DROPOFF.

SECTION A-A

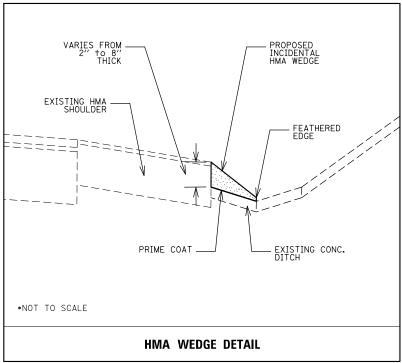

FILE NAME =
D876K19-sht-gennote.dg
Default

USER NAME = CoppernollPE	DESIGNED -	REVISED -
	DRAWN -	REVISED -
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PLOT DATE = 3/22/2017	DATE -	REVISED -

STATE OF ILLINOIS
DEPARTMENT OF TRANSPORTATION

MISCELLANEOUS DETAILS						F.A.P RTE.	SECTION	COUNTY	TOTAL SHEETS	SHEET NO.
						805	125RS-6	ST. CLAIR	15	15
						CONTRAC	T NO.	76K19		
SCALE: N.T.S. SHEET 2 OF 2 SHEETS STA. 943+74 TO STA. 944+30							ILLINOIS FED. A	D PROJECT		