


STATE OF ILLINOIS
DEPARTMENT OF TRANSPORTATION
DIVISION OF HIGHWAYS

FOR INDEX OF SHEETS, SEE SHEET NO. 2

PLANS FOR PROPOSED FEDERAL AID HIGHWAY

F.A.U. 168: JOHNSBURG ROAD
CHAPEL HILL ROAD TO RINGWOOD ROAD
MILLING AND RESURFACING
SECTION NO. 05-00010-00-RS
PROJECT NO. M-8003(610)
VILLAGE OF JOHNSBURG
MCHENRY COUNTY
C-91-283-06

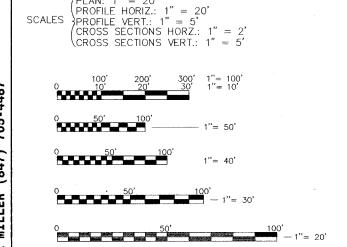


FULL SIZE PLANS HAVE BEEN PREPARED USING STANDARD ENGINEERING SCALES, REDUCED SIZED PLANS WILL NOT CONFORM TO STANDARD SCALES, IN MAKING MEASUREMENTS ON REDUCED PLANS, THE ABOVE SCALES MAY BE USED.


JOHNSBURG ROAD

PROJECT BEGINS STA. 103+33

PROJECT LOCATED IN THE VILLAGE OF JOHNSBURG

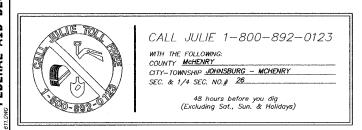

CONTRACT NO. 83854

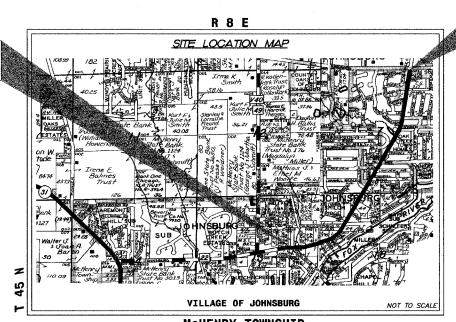

MCHENRY TOWNSHIP

GROSS LENGTH OF PROJECT = 9,907 FEET = 1.876 MILES
NET LENGTH OF PROJECT = 9,907 FEET = 1.876 MILES

JOHNSBURG ROAD PROJECT ENDS STA. 202+40

DESIGN DESIGNATION
JOHNSBURG ROAD - URBAN COLLECTOR
JOHNSBURG ROAD: 35-40 MPH


TRAFFIC DATA JOHNSBURG ROAD: 8,931 (2004)
 F.A.U. RTE.
 SECTION
 COUNTY
 TOTAL SHEETS
 SHEET NO.

 168
 05-00010-00-RS
 MCHENRY
 25
 1

 PROJECT NO.

FED. ROAD DIST. NO. 1 ILLINOIS HIGHWAY PROJECT TO



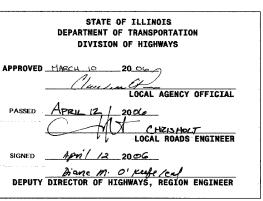

PRINTED BY AUTHORITY OF THE STATE OF ILLINOIS

PROFESSIONAL ENG	INEER'S	SIGN	&	SEAL	7
Theodore Tamilton	J		# No. 10 10 10 10 10 10 10 10 10 10 10 10 10	062-049143	
THEODORE E. HAMILTON P.E.			*	REGISTERED PROFESSIONAL	2 M
DATE:	•	1	MANA.	ENGINEER OF S	- F
			-14	MINISTER DESCRIPTION	F

INDEX OF SHEETS

- COVER SHEET
- 2 INDEX OF SHEETS, LIST OF STATE STANDARDS, GENERAL NOTES
- SUMMARY OF QUANTITIES
- TYPICAL SECTIONS
- 5-13 ROADWAY PLAN
- PAVEMENT MARKING PLAN 14-22
- TRAFFIC CONTROL AND PROTECTION FOR SIDE ROADS 23 INTERSECTIONS AND DRIVEWAYS, DRIVEWAYS
- 24 DISTRICT 1 TYPICAL PAVEMENT MARKINGS, DISTRICT 1 DETAIL
- BUTT JOINT AND BITUMINOUS TAPER DETAILS, DISTRICT 1 DETAIL

GENERAL NOTES

- 1 THE CONTRACTOR WILL PROVIDE AND INSTALL TWO (2) WEIGHTED SAND BAGS ON EACH BARRICADE USED. (TYPE I OR TYPE II (ONE (1) WEIGHTED SAND BAG ACROSS EACH BOTTOM RAIL.) ALL TYPE III BARRICADES SHALL REQUIRE A MINIMUM OF FOUR (4) SANDBAGS PER BARRICADE.
- 2 FORTY-EIGHT HOURS BEFORE STARTING EXCAVATION THE CONTRACTOR WILL CALL J.U.L.I.E. (1-800-892-0123) TO HAVE THE LOCATION OF EXISTING UTILITIES STAKED.
- THE CONTRACTOR SHALL COORDINATE CONSTRUCTION ACTIVITIES WITH UTILITY COMPANIES AND THE
- 4 THE CONTRACTOR WILL NOT BE ALLOWED TO SET UP A YARD OR FIELD OFFICE ON VILLAGE PROPERTY WITHOUT WRITTEN PERMISSION FROM THE VILLAGE.
- 5 BUTT JOINTS WILL BE INSTALLED AT THE ENDS OF ALL RESURFACING (WHERE RESURFACING MEETS EXISTING PAVEMENT), IN ACCORDANCE WITH THE BUTT JOINT AND BITUMINOUS TAPER DETAILS SHEET INCLUDED IN THE PLANS, UNLESS OTHERWISE SPECIFIED.
- 6 THE ENGINEER SHALL BE THE SOLE JUDGE CONCERNING CURING TIME FOR THE VARIOUS BITUMINOUS
- 7 THE BITUMINOUS MATERIAL PRIME COAT QUANTITIES HAVE BEEN DETERMINED USING A RATE OF 0.10 GAL/SQ-YD.
- 8 PRIOR TO COMMENCEMENT OF CONSTRUCTION, THE CONTRACTOR SHALL VERIFY ALL DIMENSIONS AND CONDITIONS AFFECTING THEIR WORK WITH THE ACTUAL CONDITIONS AT THE JOB SITE. IN ADDITION, THE CONTRACTOR MUST VERIFY THE ENGINEER'S LINE AND GRADE STAKES. IF THERE ARE ANY DISCREPANCIES FROM WHAT IS SHOWN ON THE CONSTRUCTION PLANS, HE MUST IMMEDIATELY REPORT SAME TO THE ENGINEER BEFORE DOING ANY WORK, OTHERWISE THE CONTRACTOR ASSUMES FULL RESPONSIBILITY. IN THE EVENT OF DISAGREEMENT BETWEEN THE CONSTRUCTION PLANS, STANDARD SPECIFICATIONS AND/OR SPECIAL DETAILS, THE CONTRACTOR SHALL SECURE WRITTEN INSTRUCTIONS FROM THE ENGINEER PRIOR TO PROCEEDING WITH ANY PART OF THE WORK AFFECTED BY OMISSIONS OR DISCREPANCIES. FAILING TO SECURE SUCH INSTRUCTIONS, THE CONTRACTOR WILL BE CONSIDERED TO HAVE PROCEEDED AT HIS OWN RISK AND EXPENSE. IN THE EVENT OF ANY DOUBT OR QUESTION ARISING WITH RESPECT TO THE TRUE MEANING OF THE CONSTRUCTION PLANS OR SPECIFICATIONS, THE DECISION OF THE ENGINEER SHALL BE FINAL AND
- 9 SAW CUTTING WILL BE REQUIRED FOR ALL REMOVAL ITEMS LISTED IN SECTION 440 OF THE STANDARD SPECIFICATIONS, SHOWN IN THE PLANS, AND AS DIRECTED BY THE ENGINEER. THE COST OF SAW CUTTING WILL BE INCLUDED IN THE COST OF ITEMS BEING REMOVED.
- 10 QUANTITIES FOR CURB AND GUTTER REMOVAL AND REPLACEMENT, PATCHING, SIDEWALK AND DRIVEWAYS SHALL NOT EXCEED THOSE PROVIDED IN THE SUMMARY OF QUANTITIES.
- 11 PAVEMENT PATCHING SHALL BE COMPLETED PRIOR TO ANY BITUMINOUS SURFACE REMOVAL. ALL PATCHING SHALL BE FULL DEPTH AND CONSTRUCTED UP TO THE EXISTING SURFACE ELEVATION.

LIST OF STATE STANDARDS

STANDARD NO. LIST OF DESCRIPTION

000001-04 STANDARD SYMBOLS ABBREVIATIONS AND PATTERNS

424001-04 CURB RAMPS FOR SIDEWALKS 442201-01 CLASS C AND D PATCHES

606001-02 CONCRETE CURB TYPE B AND COMBINATION CONCRETE CURB AND GUTTER

701501-03 URBAN LANE CLOSURE 2L, 2W UNDIVIDED 701701-04 URBAN LANE CLOSURE MULTILANE INTERSECTION

701801-03 LANE CLOSURE MULTILANE 1W OR 2W CROSSWALK OR SIDEWALK CLOSURE

702001-06 TRAFFIC CONTROL DEVICES 780001-01 TYPICAL PAVEMENT MARKINGS

SECTION COUNTY SHEETS NO. 168 05-00010-00-RS MCHENRY 25 STA. TO STA. FED. ROAD DIST. NO. 1 | ILLINOIS HIGHWAY PROJECT CONTRACT # 83854

STMBO	OL LEGEND	
	EXISTING	PROPOSED
SANITARY MANHOLE	©	•
STORM MANHOLE	©	•
STORM CATCH BASIN	0	•
INLET		-
FLARED END SECTION	>	•
VALVE VAULT	8	. 0
FIRE HYDRANT	A	Ψ.
LIGHT POLE	*	*
STREET SIGN	+	
REGULATORY SIGN	- v	
UTILITY POLE	•	
UTILITY BOX		
MAILBOX	₫	
WELL	0	
SANITARY SEWER		
STORM SEWER		>
CULVERT		
WATER MAIN		
WATER MAIN ENCASEMENT		
STORM UNDERDRAIN		
ELECTRIC LINE	E	
TELEPHONE LINE	manufacture of the state of the	
GAS LINE	G	
CABLE TV LINE	c	
TREELINE	amm .	
TREE	₩ 🖰	
FENCE	x	
EROSION CONTROL FENCE		
DITCH CHECK		
DRAINAGE ARROW		-
100 YEAR OVERFLOW		→

STANDARD ABBREVIATIONS

B-B - BACK TO BACK OF CURB
B.C. -- BACK OF CURB
B.O.C. -- BACK OF CURB
B.S.L. -- BUILDING SETBACK LINE
C.B. -- STORM CATCH BASIN
C.E. -- COMMONWEALTH EDISON CO.
D.E. -- DRAINIAGE EASEMENT
E-E -- EDGE TO FLOE OF PAYEMENT
E.O.S. -- EDGE OF PAYEMENT
E.O.S. -- EDGE OF PAYEMENT
E.S. -- EDGE OF SHOULDER
F.E.S. -- ELOGE OF SHOULDER
F.E.S. -- FLARED BIO SECTION
I.B.T. -- ILLINOIS BELL TELEPHONE CO.
L.E. -- LANDSCAPE FASEMENT

I.B.T. — ILLINOIS BELL TELEPHONE CO.

L.E. — LANDSCAPE EASEMENT
M.H. — MANHOLE (TYPE SPECIFIED ON PLANS)
R.O.W. — RIGHT OF WAY
T.B.F. — TRENCH BACKFILL
T.C. — TOP OF CURB
T.C.E. — TEMPORARY CONSTRUCTION EASEMENT
T.O.B. — TOP OF BERM
T.O.C. — TOP OF CURB
U.E. — UTILITY EASEMENT

SMITH ENGINEERING CONSULTANTS, INC.

CIVIL/STRUCTURAL ENGINEERS AND SURVEYORS

4500 FRIME PARKEYS SUITE 201

191: 314-4307, ILLINOIS 6500

PROPERS AND SURVEYORS AND SURVEYORS

4500 FRIME PARKEYS SUITE 201

WWW.mithongineering.com

M.ERINYY SURVEYS **VORVILLE**

VORVILLE

**ILLINOIS PROFESSIONAL DESIGN FIRM # 164-000108

ILLINOIS DEPARTMENT OF TRANSPORTATION

VILLAGE OF JOHNSBURG JOHNSBURG ROAD GENERAL NOTES AND LIST OF STATE STANDARDS

SCALE:

DRAWN BY TK CHECKED BY TEH

SITE BENCHMARKS

NORTHWEST MOST POINT OF CONCRETE RETAINING WALL FRONTING 2213 AND ABUTTING "HETTERMAN'S TAVERN" SOUTH SIDE OF JOHNSBURG ROAD. ELEVATION = 756.35

RAILROAD SPIKE SET IN POWER POLE ON WEST SIDE OF JOHNSBURG ROAD ACROSS FROM IVY LANE.

ELEVATION = 752.95

RAILROAD SPIKE SET IN POWER POLE ON WEST SIDE OF JOHNSBURG ROAD JUST NORTH OF DRIVE TO 4511. ELEVATION = 774.25

RAILROAD SPIKE SET IN WEST FACE OF POWER POLE APPROXIMATELY 150' SOUTH OF RINGWOOD ROAD AT FENCE LINE EAST SIDE OF JOHNSBURG ROAD. ELEVATION = 830.49

REVISIONS NAME DATE

DATE 01-10-06

SMITH ENGINEERING CONSULTANTS INC.

		URBAN CONSTRUCTION TYPE CODE ROADWAY	
AARE NA			80% FEDERA 20% LOCAL
CODE NO.	ITEM	UNIT	1000
40300100	BITUMINOUS MATERIALS (PRIME COAT)	GALLON	4,176
40600300	AGGREGATE (PRIME COAT)	TON	83
40600980	BITUMINOUS SURFACE REMOVAL - BUTT JOINT	SQ YD	2,186
42400200	PORTLAND CEMENT CONCRETE SIDEWALK 5 INCH	SQ FT	863
42400800	DETECTABLE WARNINGS	SQ FT	143
44000600	SIDEWALK REMOVAL	SQ FT	993
44001700	COMBINATION CONCRETE CURB AND GUTTER REMOVAL AND REPLACEMENT	F00T	826
44201737	CLASS D PATCHES, TYPE I, 8 INCH	SQ YD	442
44201741	CLASS D PATCHES, TYPE II, B INCH	SQ YD	575
44201745	CLASS D PATCHES, TYPE III, 8 INCH	SQ YD	610
44201747	CLASS D PATCHES, TYPE IV, 8 INCH	SQ YD	433
48101200	AGGREGATE SHOULDERS, TYPE B	TON	945
67100100	MOBILIZATION	L SUN	1
70101800	TRAFFIC CONTROL AND PROTECTION, SPECIAL	L SUN	1
70300100	SHORT-TERM PAVEMENT MARKING	FOOT	2,160
78000100	- · · · · · · · · · · · · · · · · · · ·		
	THERMOPLASTIC PAVEMENT MARKING - LETTERS AND SYMBOLS	SQ FT	556
78000200	THERMOPLASTIC PAVEMENT MARKING - LINE 4"	FOOT	35,61
78000400	THERMOPLASTIC PAVEMENT MARKING - LINE 6"	FOOT	1,820
78000600	THERMOPLASTIC PAVEMENT MARKING - LINE 12"	FOOT	328
78000650	THERMOPLASTIC PAVEMENT MARKING - LINE 24"	FOOT	460
X0322256	TEMPORARY INFORMATION SIGNING	SQ FT	180
X4066426	BITUMINOUS CONCRETE SURFACE COURSE, SUPERPAVE, MIX "D", N70	TON	4,946
X4066770	LEVELING BINDER (MACHINE METHOD), SUPERPAVE, N70	TON	1,595
Z0017400	DRAINAGE AND UTILTY STRUCTURES TO BE ADJUSTED	EACH	5
XX ∞ ៤553	BITUMINOUS SURFACE REMOVAL - 0 TO 1 3/4"	SQ YD	5,756
××006554	BITUMINOUS SURFACE REMOVAL - BUTT JOINT DRIVEWAY	SQ YD	353
	м.		
			1
·			
·			

F.A.U. RTE.	SECTION .	COUNTY	TOTAL SHEETS	SHEET NO.			
168	05-00010-00-RS	MCHENRY	25	3			
STA. TO STA.							
FED. ROAD DIST. NO. 1 ILLINOIS HIGHWAY PROJECT							
CONTRACT # 83854							

* SPECIALTY ITEM

SMITH ENGINEERING CONSULTANTS, INC.

CIVIL/STRUCTURAL ENGINEERS AND SURVEYORS

4000 PRIME PARKWAY, SUITE 801

PH. 615-630-1779 | IAVE 1010-360-1781

WWw.mnthengineering.com | E-MAIL: sec@sulthengineering.com |

MAGEENRY | HUNTLY | WYORVILLE |

ILLINOIS PROFESSIONAL DESIGN FIRM # 184-000108

ILLINOIS DEPARTMENT OF TRANSPORTATION

VILLAGE OF JOHNSBURG JOHNSBURG ROAD SUMMARY OF QUANTITIES


SCALE: DATE 01-10-06


DRAWN BY TK CHECKED BY TEH







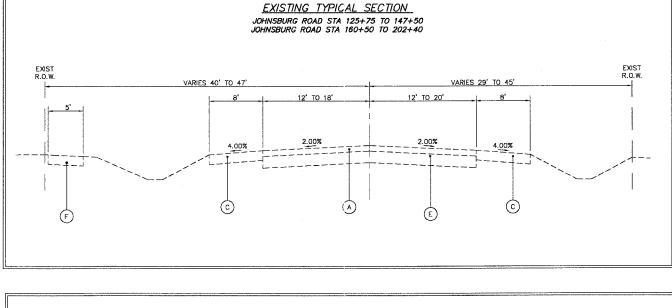

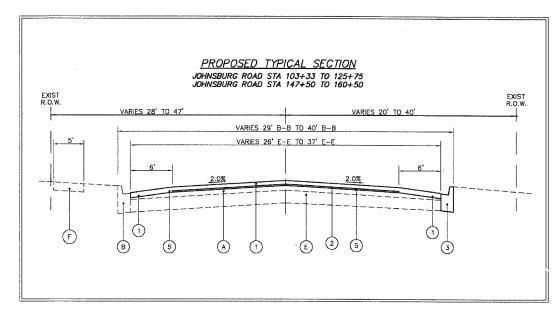

EXISTING TYPICAL SECTION


JOHNSBURG ROAD STA 103+33 TO 125+75 JOHNSBURG ROAD STA 147+50 TO 160+50

VARIES 29' B-B TO 40' B-B VARIES 26' E-E TO 37' E-E

3.00%

VARIES 20' TO 40'

(D) (B)

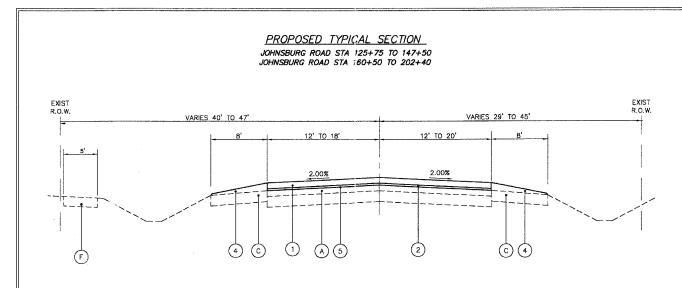

EXISTING LEGEND

- A EXISTING BITUMINOUS PAVEMENT
- COMBINATION CONCRETE CURB AND GUTTER, TYPE 8-6.12 OR 8-6.24
- C EXISTING AGGREGATE SHOULDER
- D PROPOSED BITUMINOUS SURFACE REMOVAL 0 TO 1 3/4"
- (E) EXISTING AGGREGATE BASE
- F EXISTING SIDEWALK

PROPOSED LEGEND

- BITUMINOUS CONCRETE SURFACE COURSE, SUPERPAVE, MIX D, N70, 2"
- LEVELING BINDER (MACHINE METHOD), SUPERPAVE, N70, 3/4"
- COMBINATION CONCRETE CURB AND GUTTER, REMOVAL AND REPLACEMENT (SPOT REPAIRS) 3
- AGGREGATE SHOULDERS, TYPE B (TONS)
- BITUMINOUS MATERIALS (PRIME COAT)

BITUMINOUS SURFACE REMOVAL - 0 TO 1 3/4" DETAIL
6' (TYP.) BIT. SURF. REMOVAL - 0 TO 1 3/4" 1/4"ABOVE GUTTER 1 3/4" 2 A E D B

BITUMINOUS	MIXTURE	REGUIREMENT	
ITEM DESCRIPTION	AC TYPE	VOIDS	RAP %
BITUMINOUS CONCRETE SURFACE COURSE, SUPERPAVE, MIX D, N70	PG 64-22	4% Ø 70 Gyr.	10%
LEVELING BINDER (MACHINE METHOD), SUPERPAVE, N70	PG 64-22	4.0% © 70 Gyr.	10%
CLASS D PATCHES, BINDER IL-19, 8"	PG 64-22	4.0% © 70 Gyr.	15%

THE UNIT WEIGHT USED TO CALCULATE BITUMINOUS SURFACE MIXTURE IS 112 LB/SY PER INCH THICKNESS.

SMITH ENGINEERING CONSULTANTS, INC.
CIVIL/STRUCTURAL ENGINEERS AND SURVEYORS
4000 PRIME PARKWAY, SUITE 201
PH: 815-835-4778 PAX: 8101-886-1781
www.amithongineering.com PAMIL: seed@smithengineering.com
www.amithongineering.com PAMIL: seed@smithengineering.com
www.amithongineering.com PAMIL: seed@smithengineering.com
ILLINOIS PROFESSIONAL DESIGN FIRM # 184-000108

ILLINOIS DEPARTMENT OF TRANSPORTATION

VILLAGE OF JOHNSBURG JOHNSBURG ROAD TYPICAL SECTIONS

SCALE: N.T.S. DATE 12-28-05

DRAWN BY TK CHECKED BY TEH


EXIST R.O.W.


VARIES 28' TO 47'


 \bigcirc


3.00%


REVISIONS NAME DATE

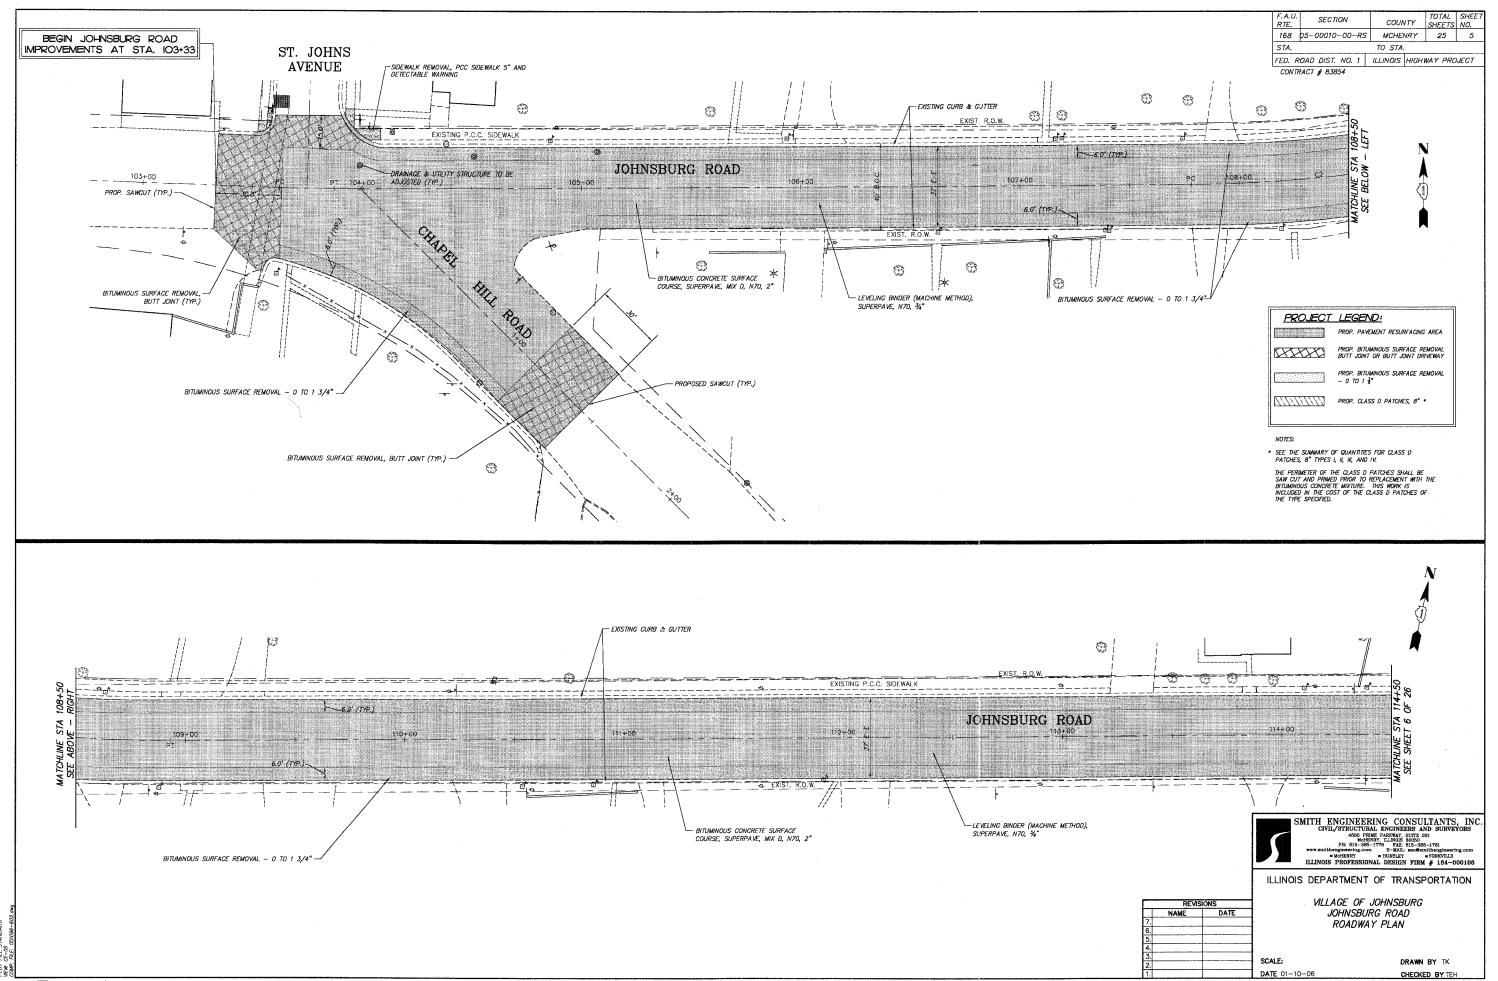


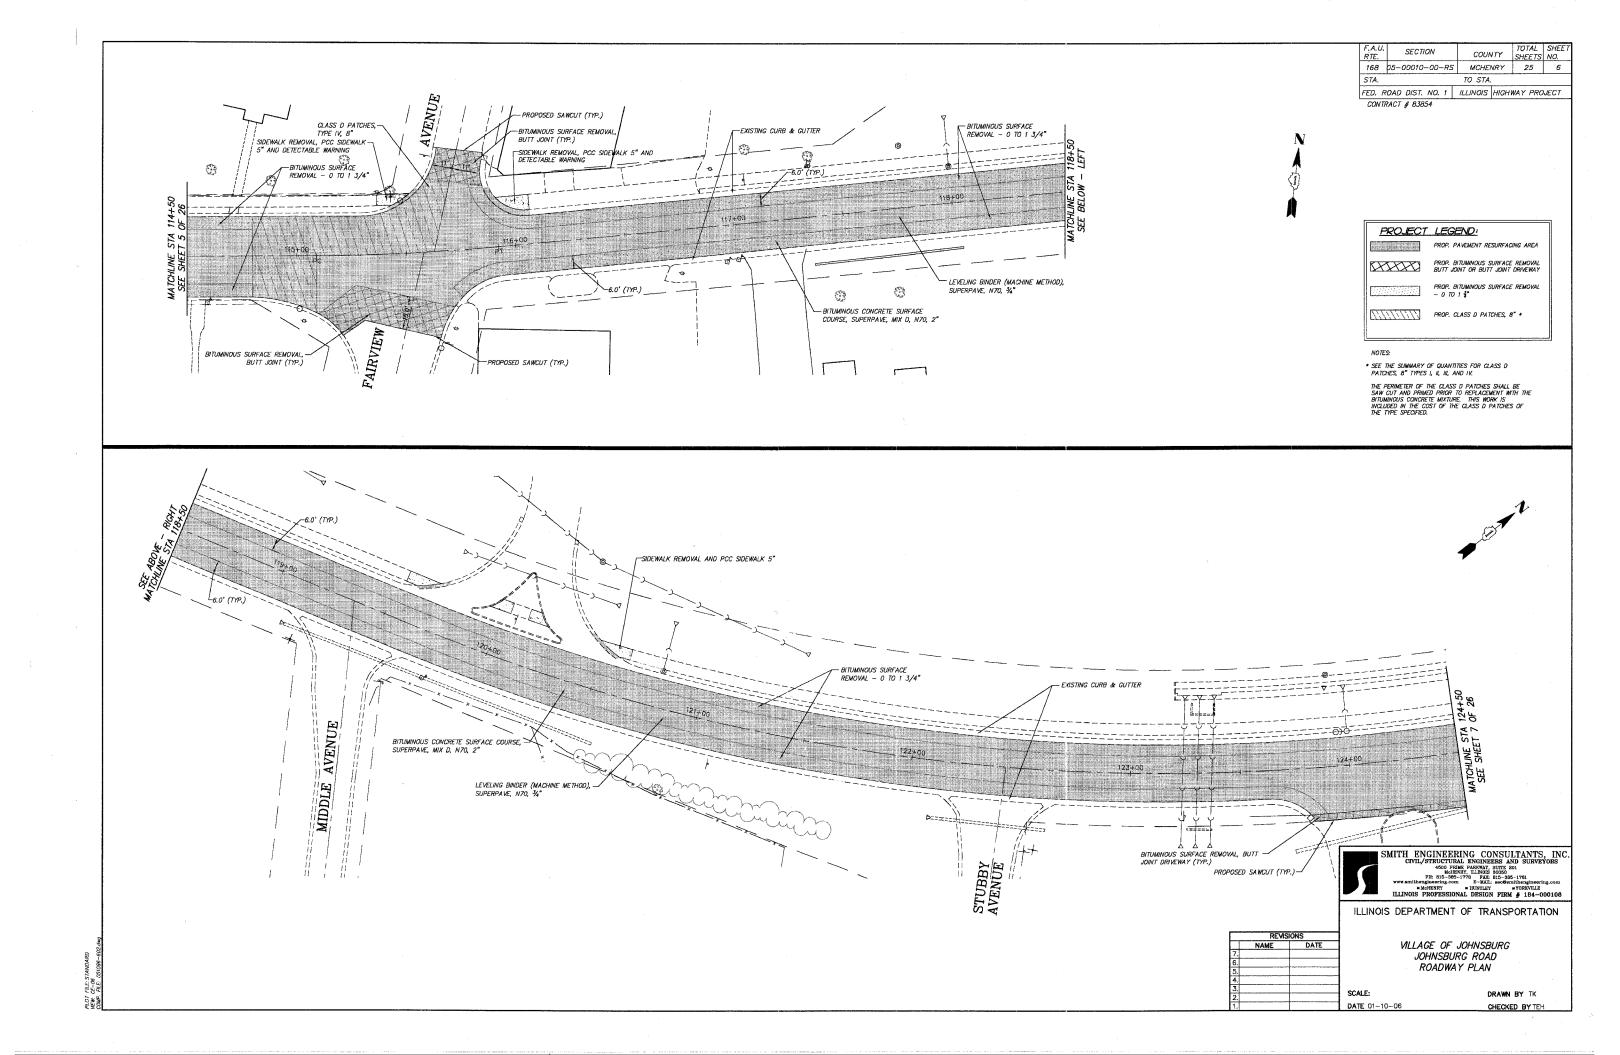


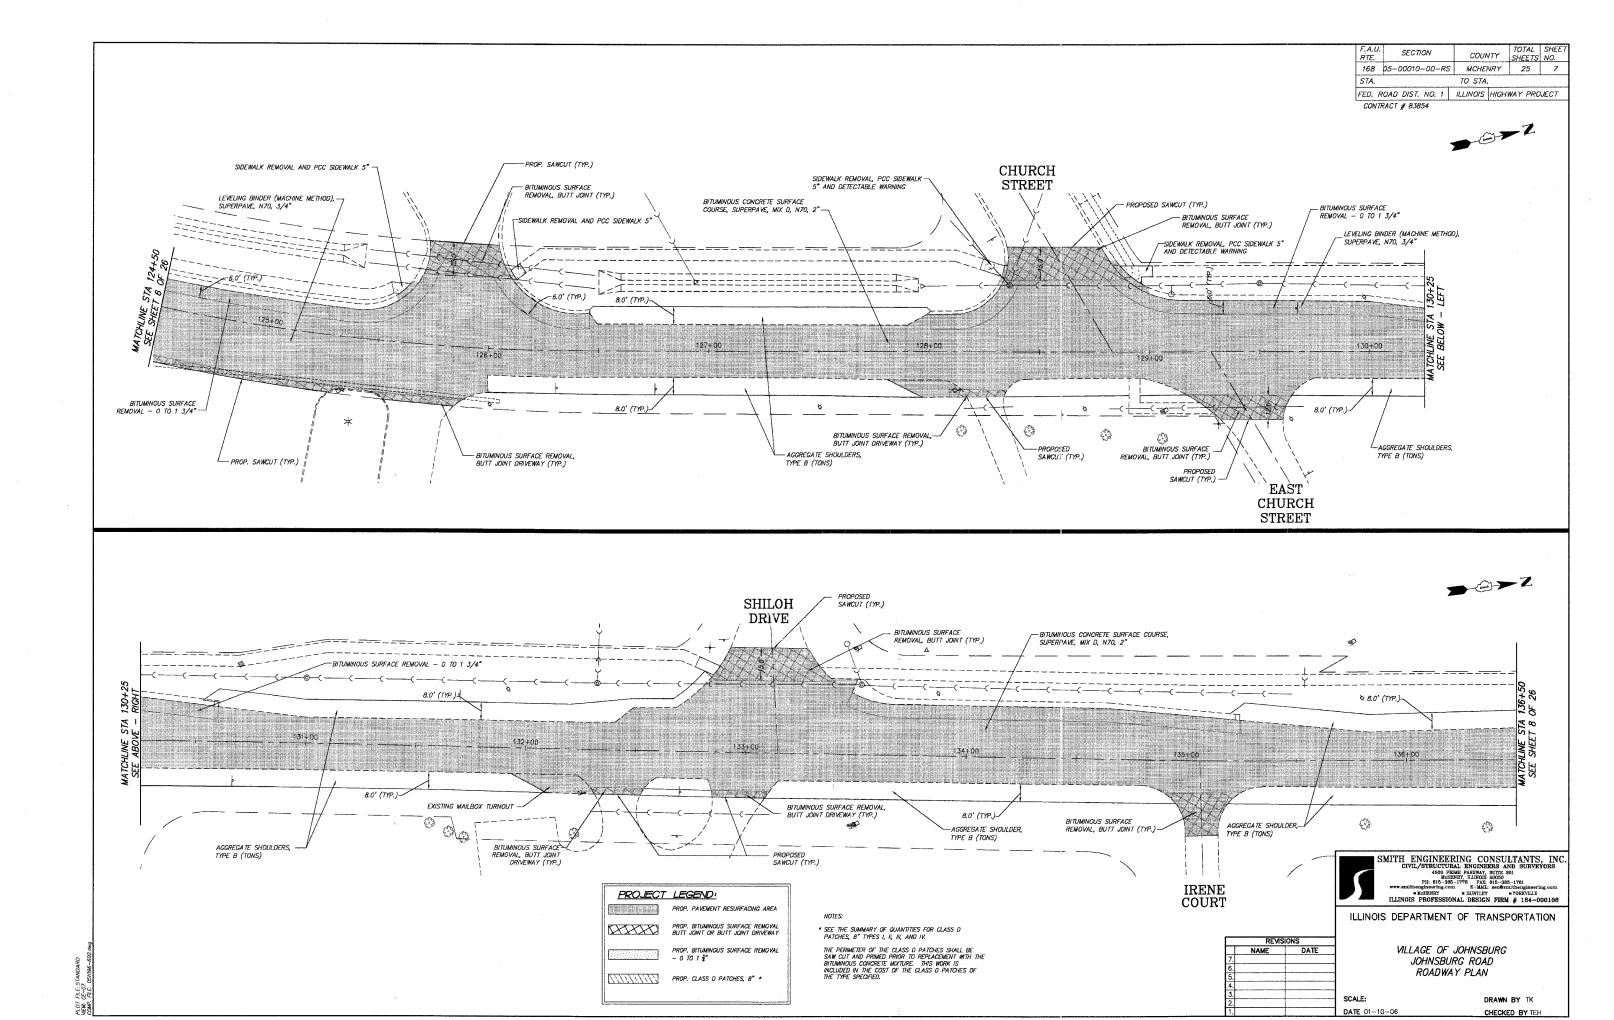


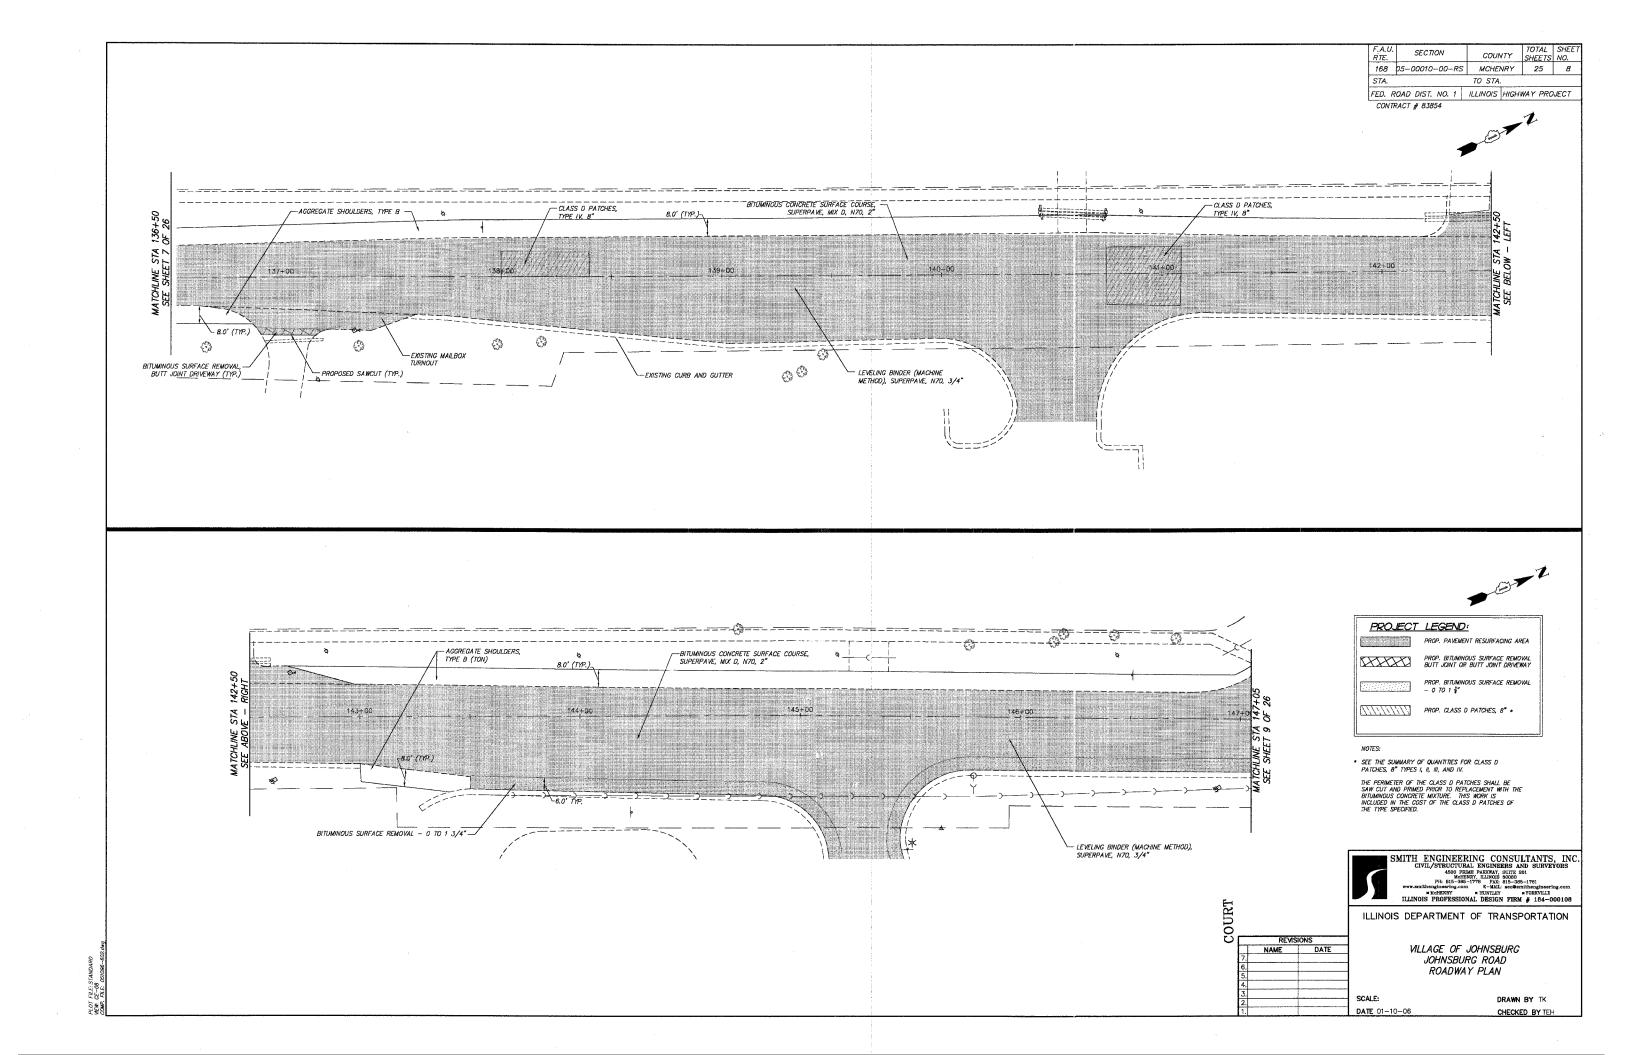

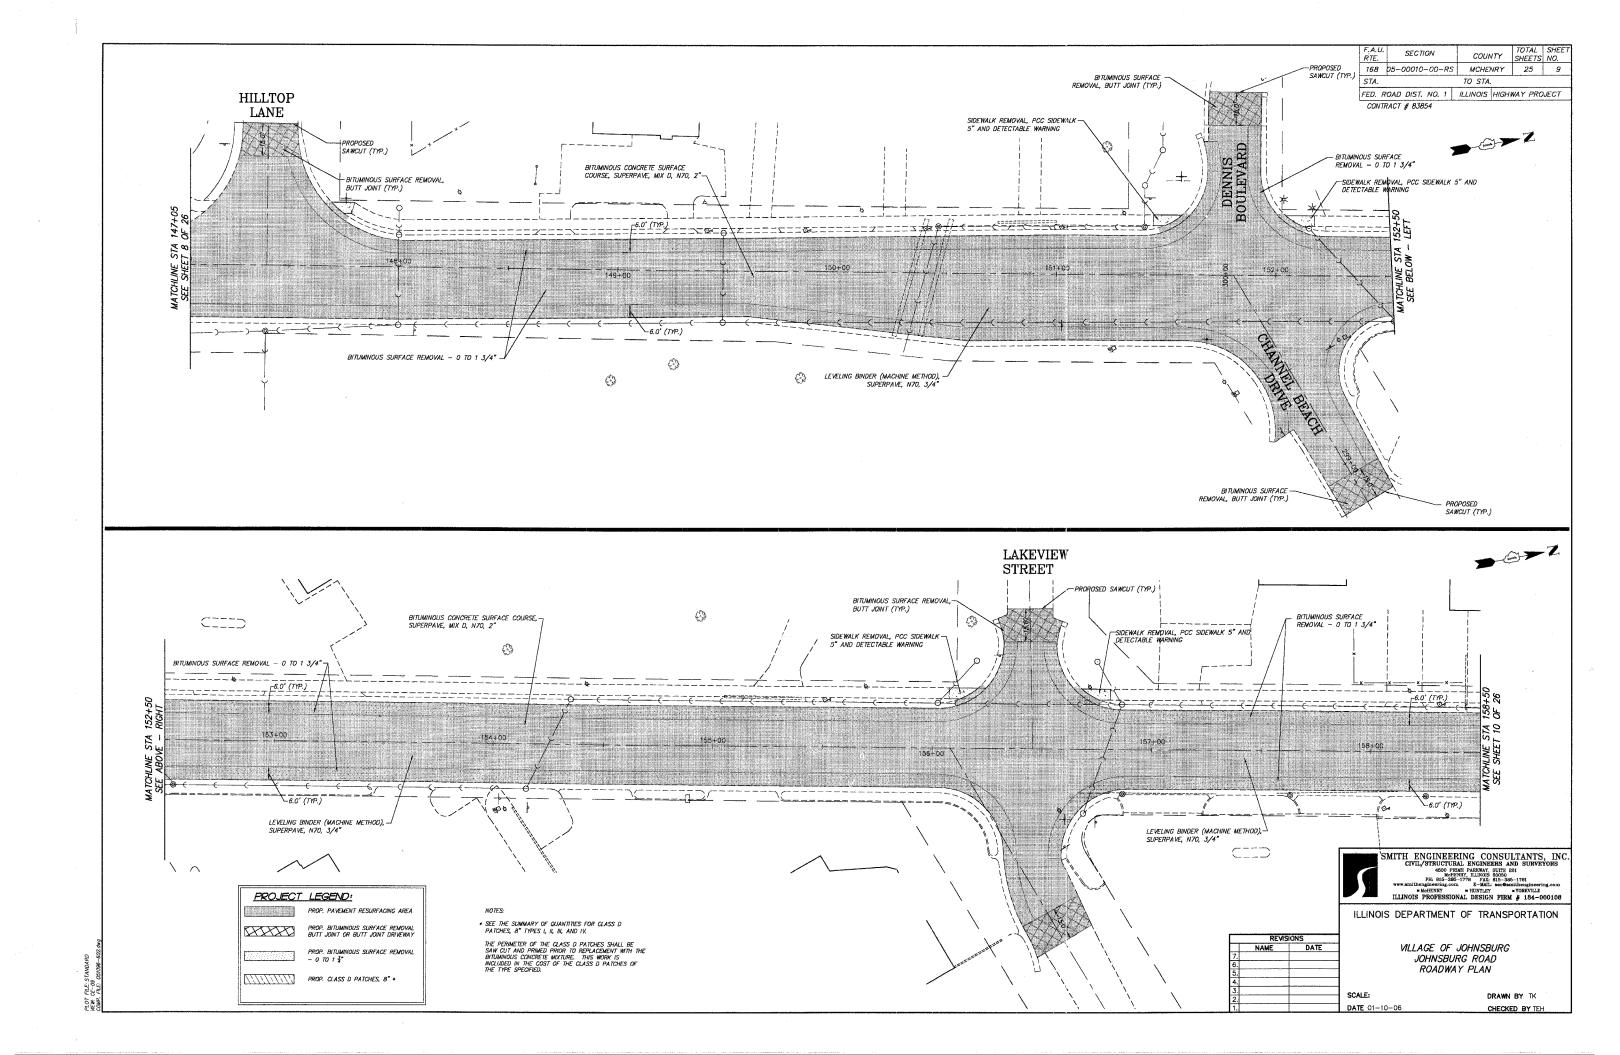

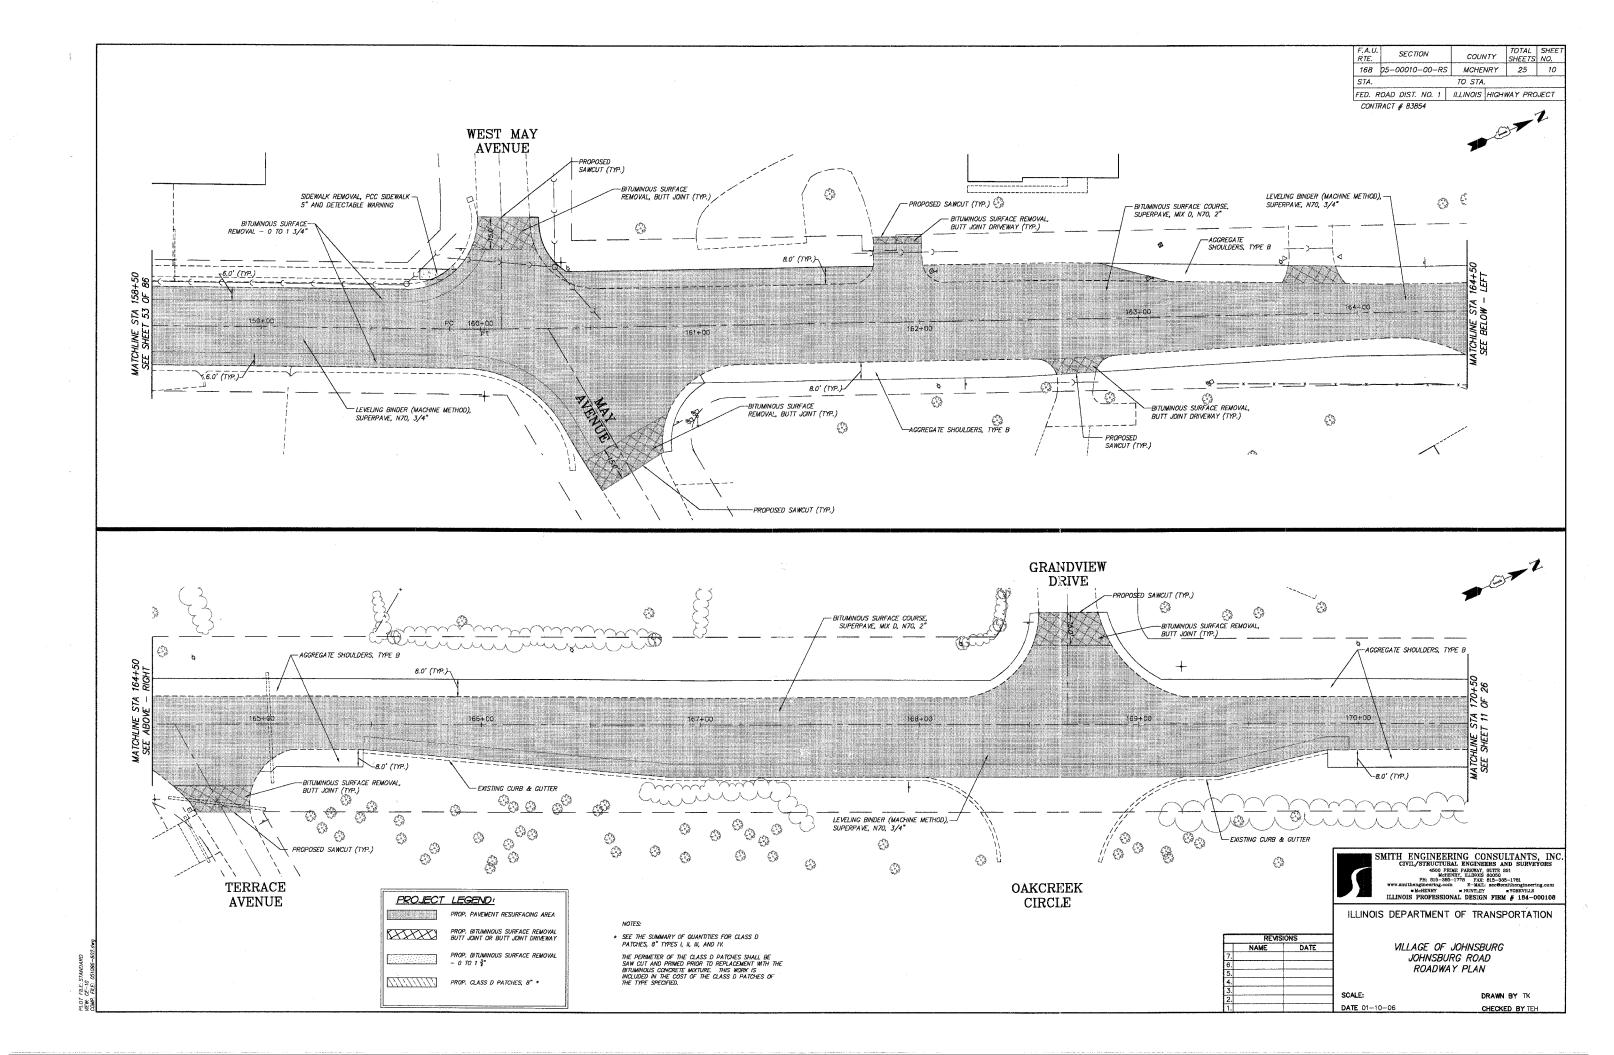


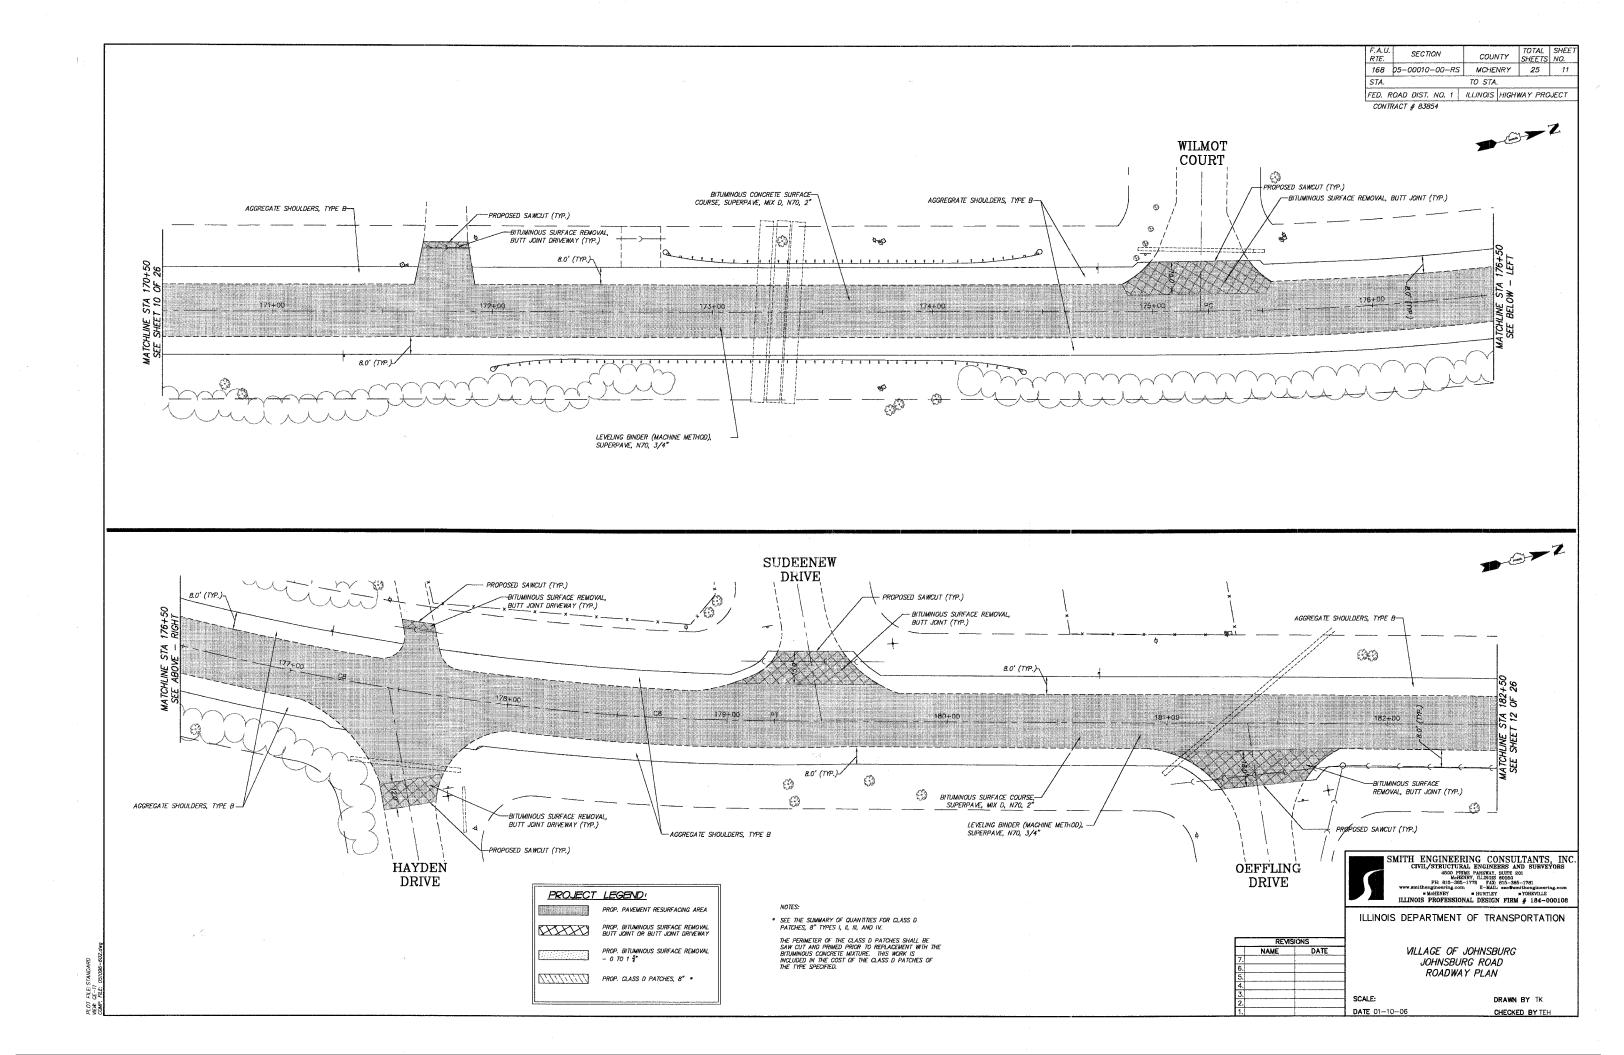


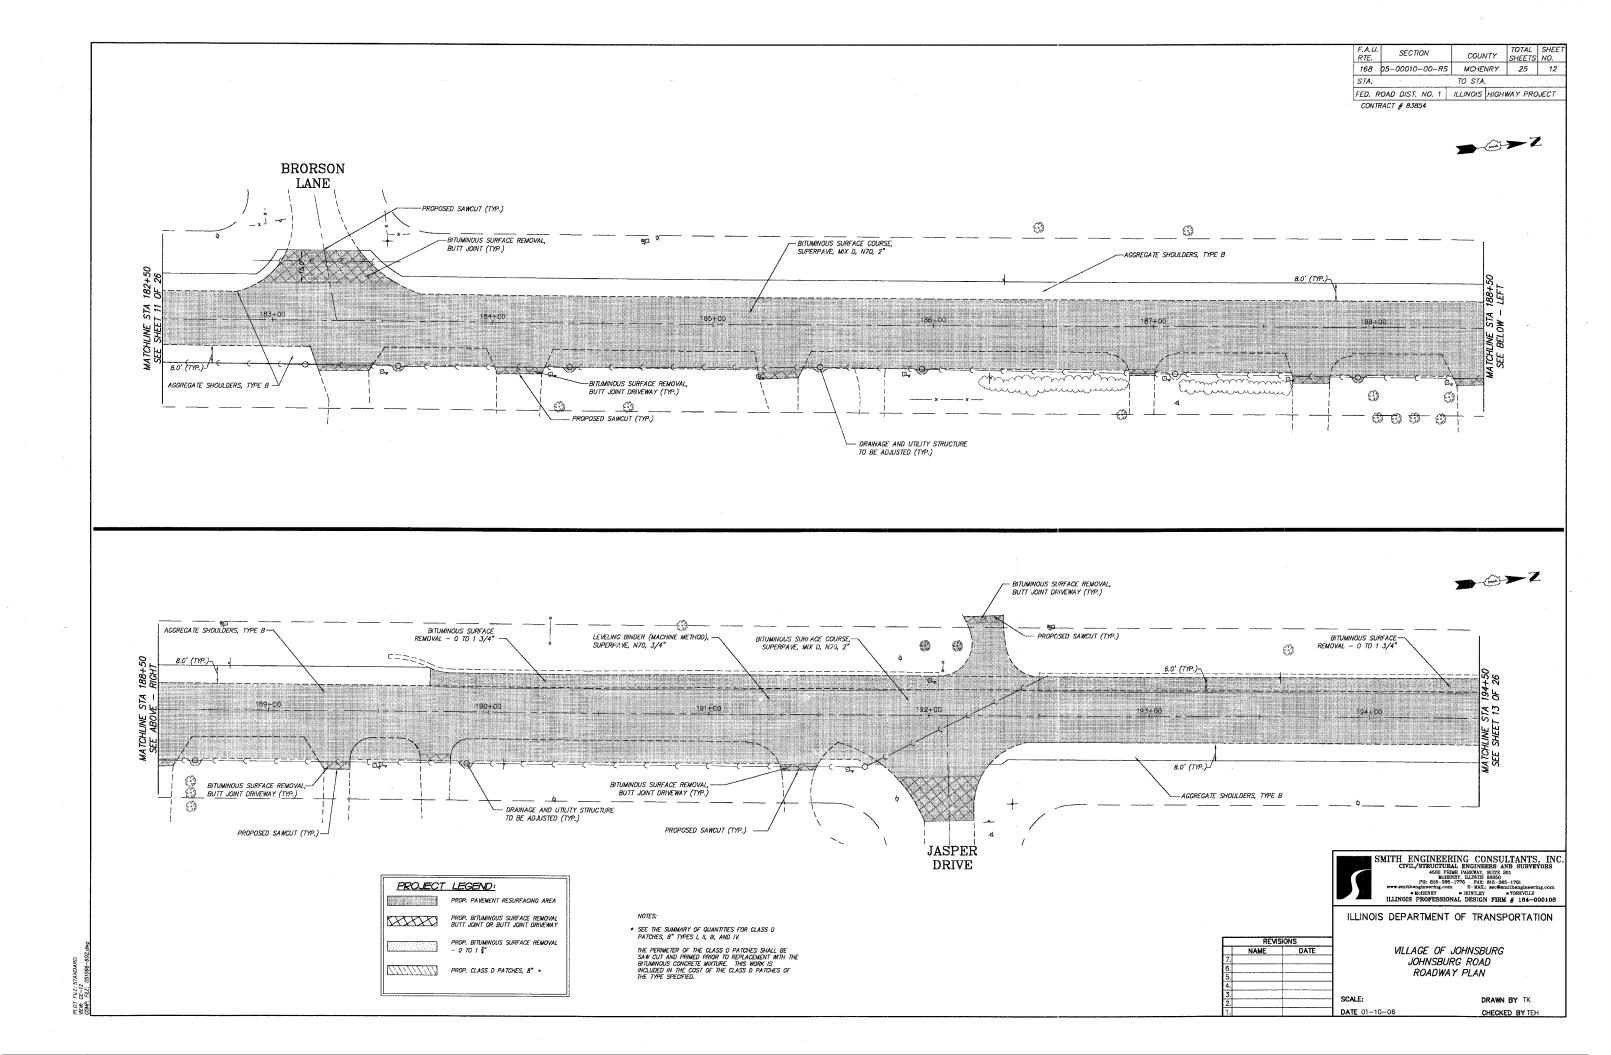


F.A.L RTE.	J.	SECTION			COUN	COUNTY		SHEET NO.
168	05-6	05-00010-00-RS		MCHENRY		25	13	
STA.					TO STA.			
FED.	ROAD	DIST.	NO.	1	ILLINOIS	HIGH	WAY PRO	JECT

CONTRACT # 83854

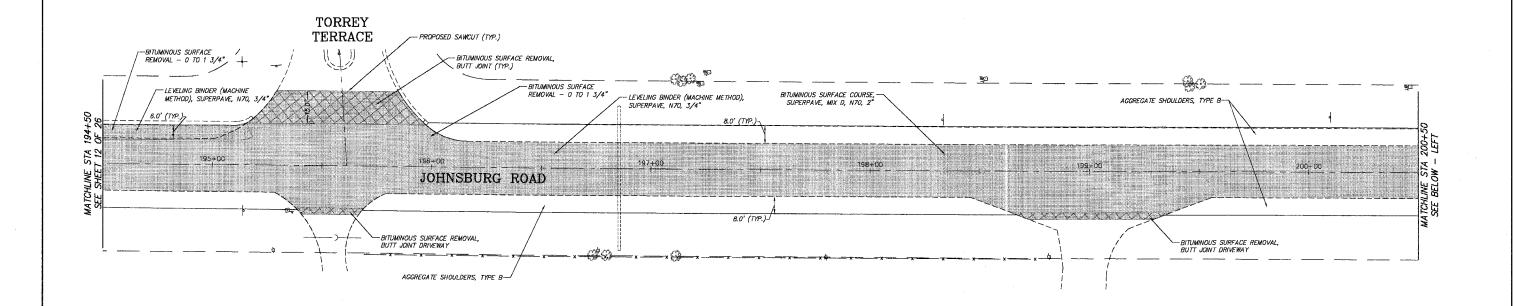

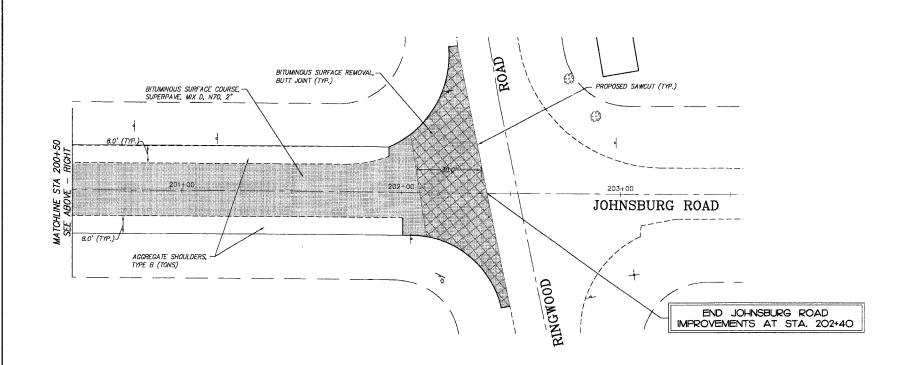



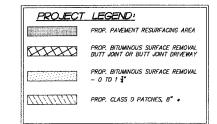

* SEE THE SUMMARY OF QUANTITIES FOR CLASS D PATCHES, 8" TYPES I, II, III, AND IV.

THE PERIMETER OF THE CLASS D PATCHES SHALL BE SAW CUT AND PRIMED PRIOR TO REPLACEMENT WITH THE BITUMINOUS CONCRETE MIXTURE. THIS WORK IS INCLUDED IN THE COST OF THE CLASS D PATCHES OF THE TYPE SPECIFIED.




SMITH ENGINEERING CONSULTANTS, INC.
CIVIL/STRUCTURAL ENGINEERS AND SURVEYORS
4500 PERMS PARKWAY, SUITS 201
PH: 615-535-7176 P.M. 615-355-350-1761
WWW.mithengineering.com E-Mall: sec@maithengineering.com
WWW.mithengineering.com E-Mall: sec@maithengineering.com
WWW.mithengineering.com
HUNTLEY HUNTLEY
HILINOIS PROFESSIONAL DESIGN FIRM # 184-000108


ILLINOIS DEPARTMENT OF TRANSPORTATION


REVISIONS			
NAME	DATE		VILLAGE OF JOHNSBURG JOHNSBURG ROAD ROADWAY PLAN
		SCALE:	DRAWN


DATE 01-10-06


DRAWN BY TK CHECKED BY TEH

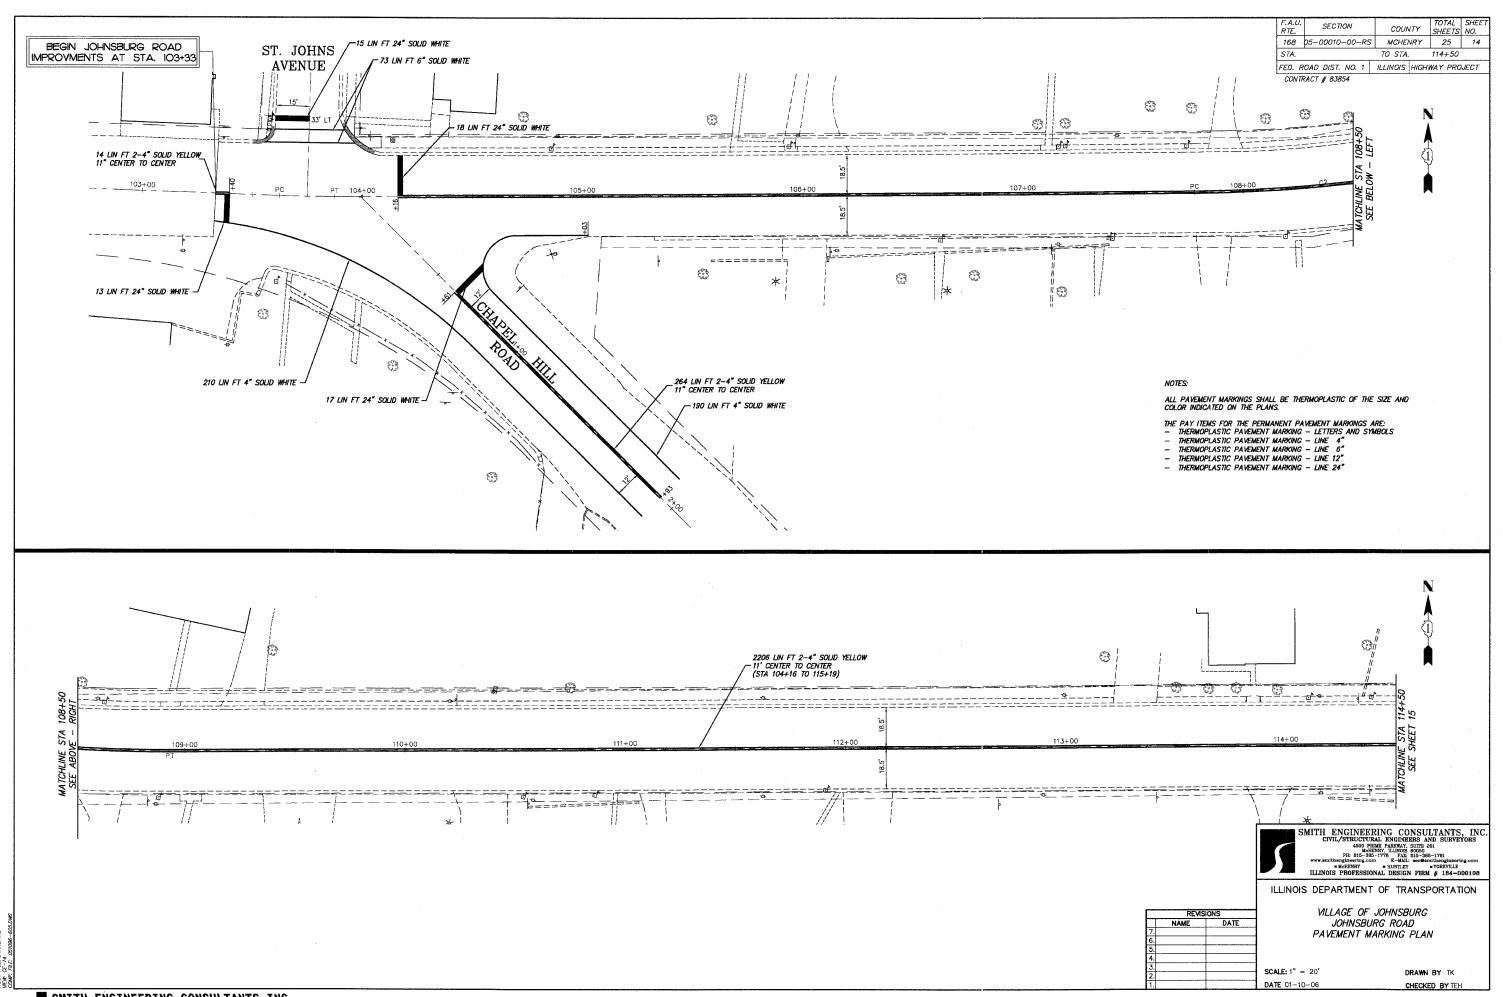


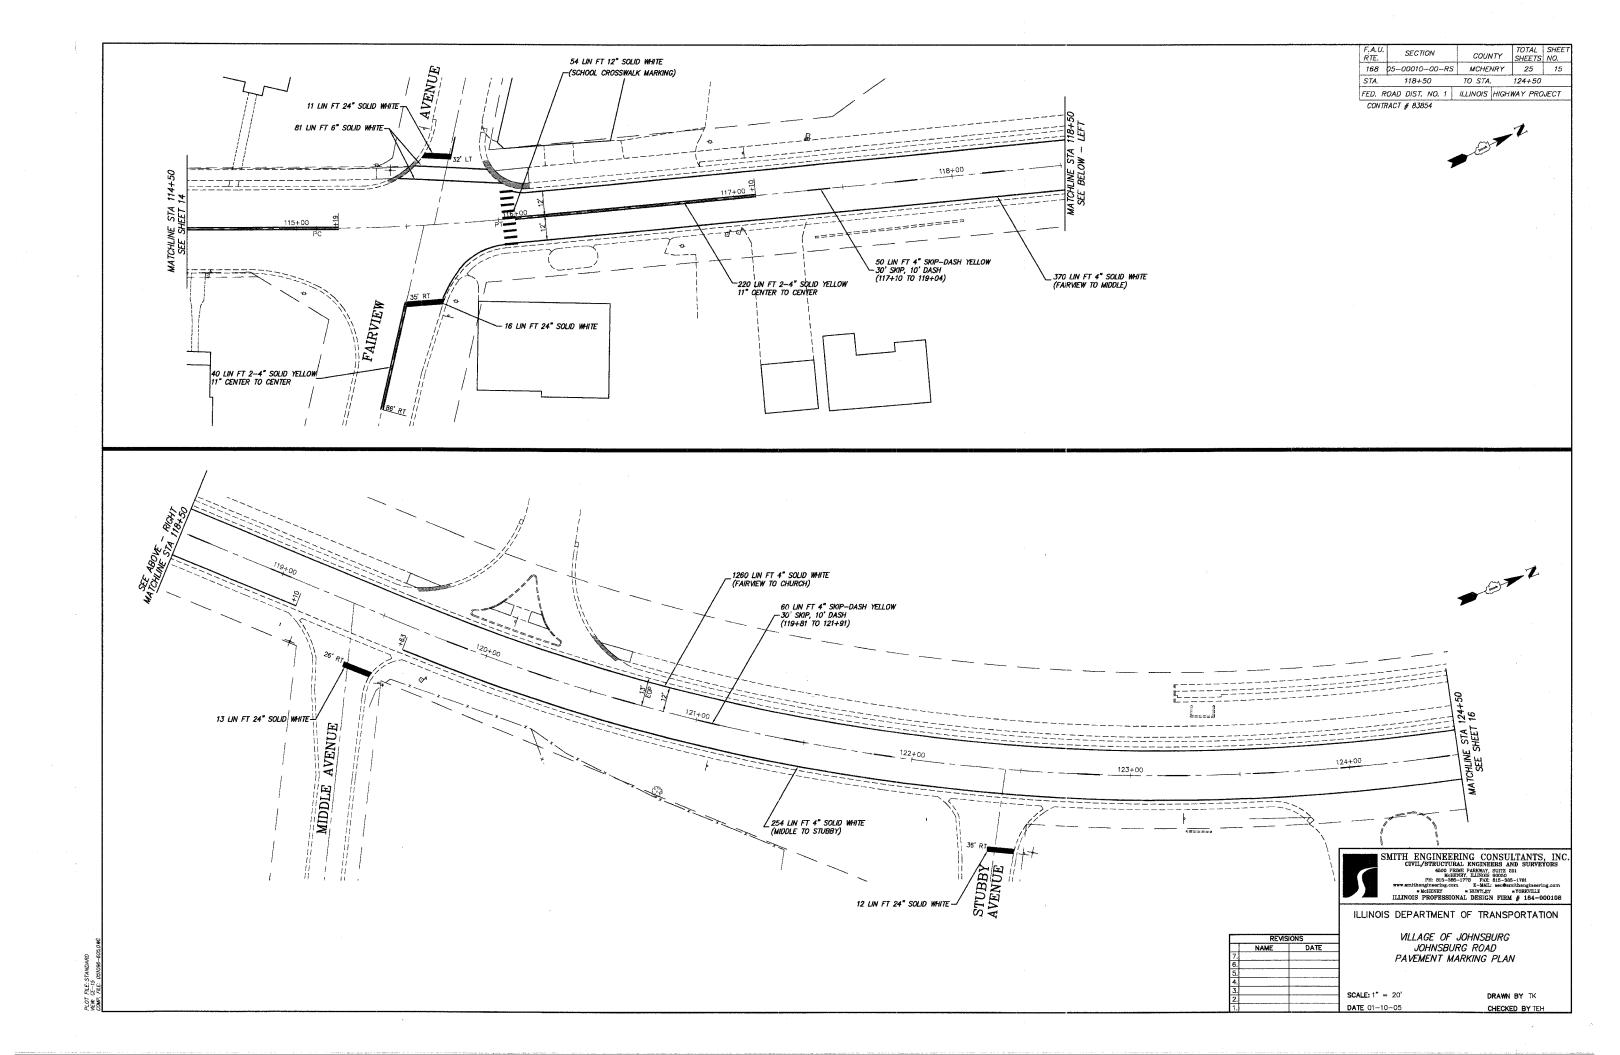


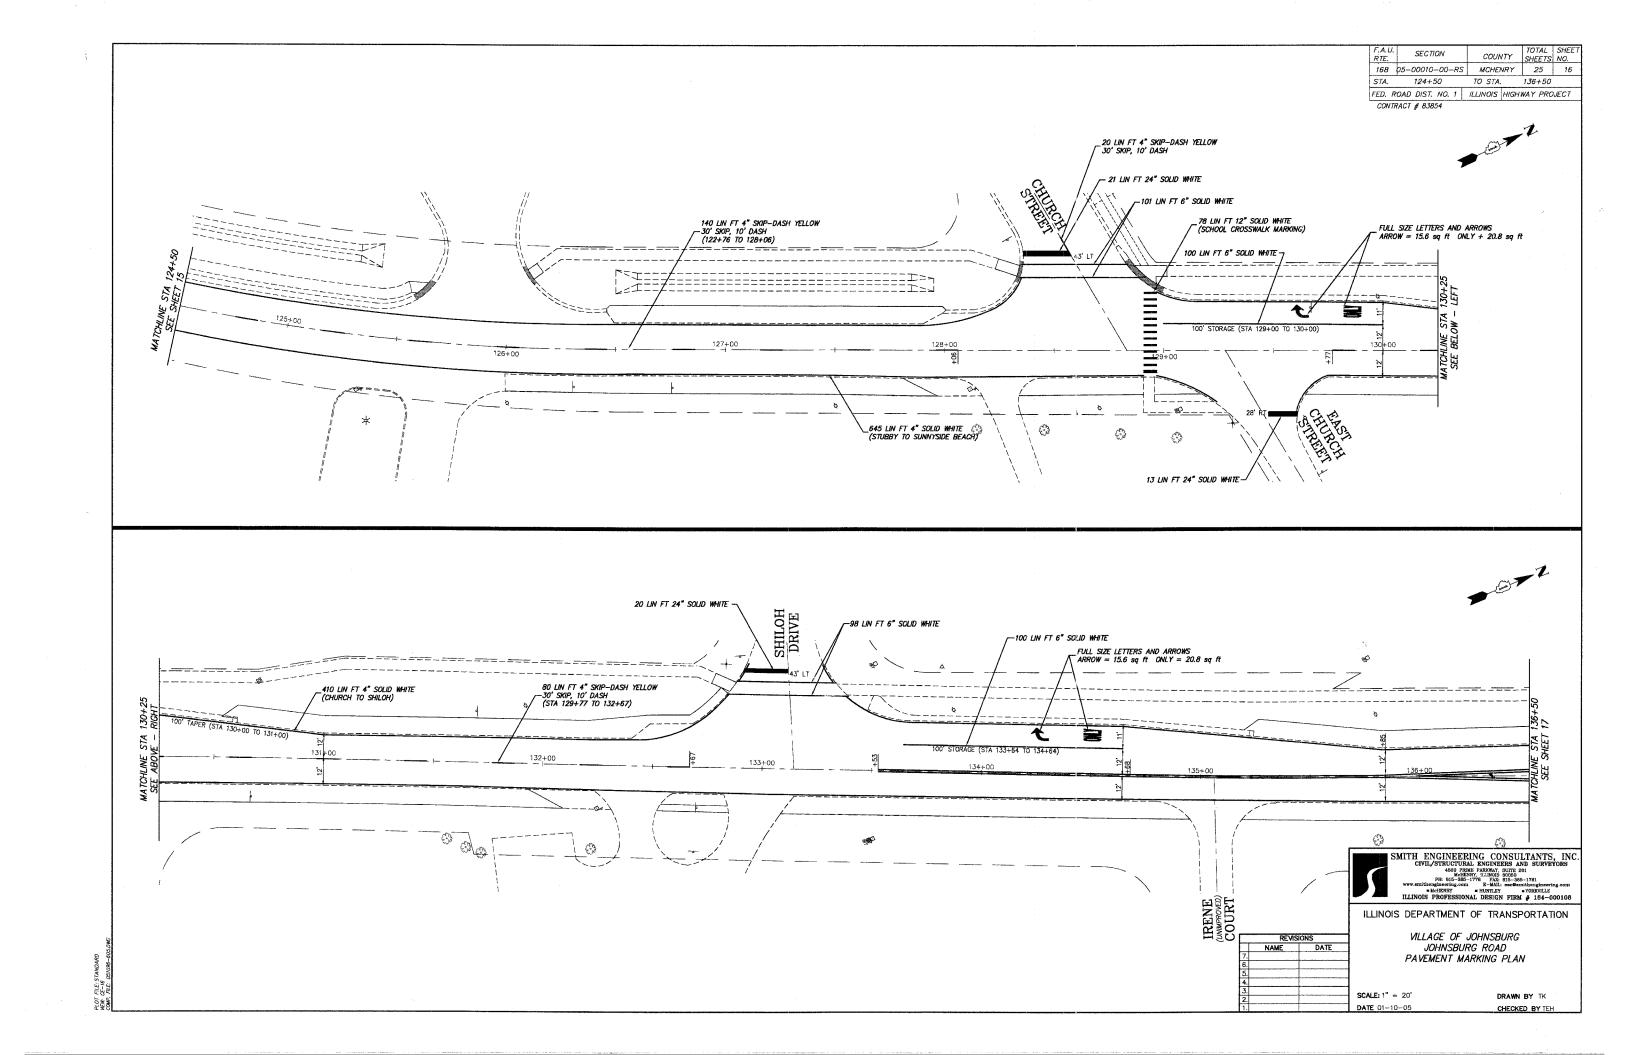


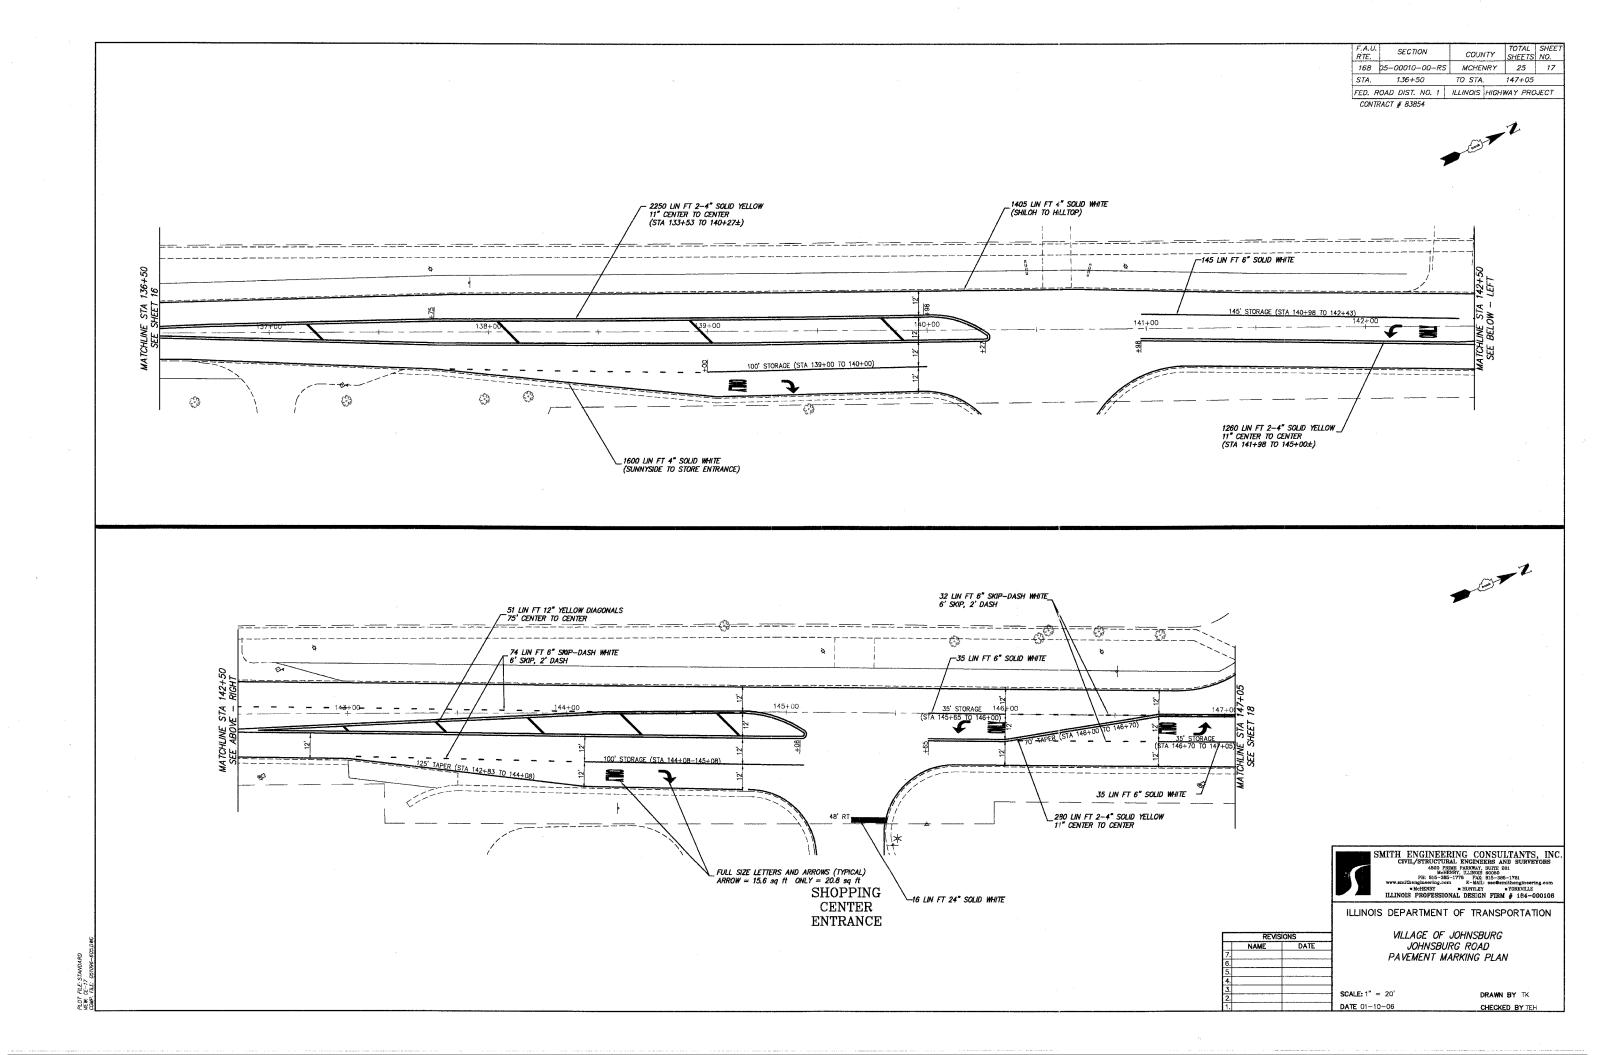

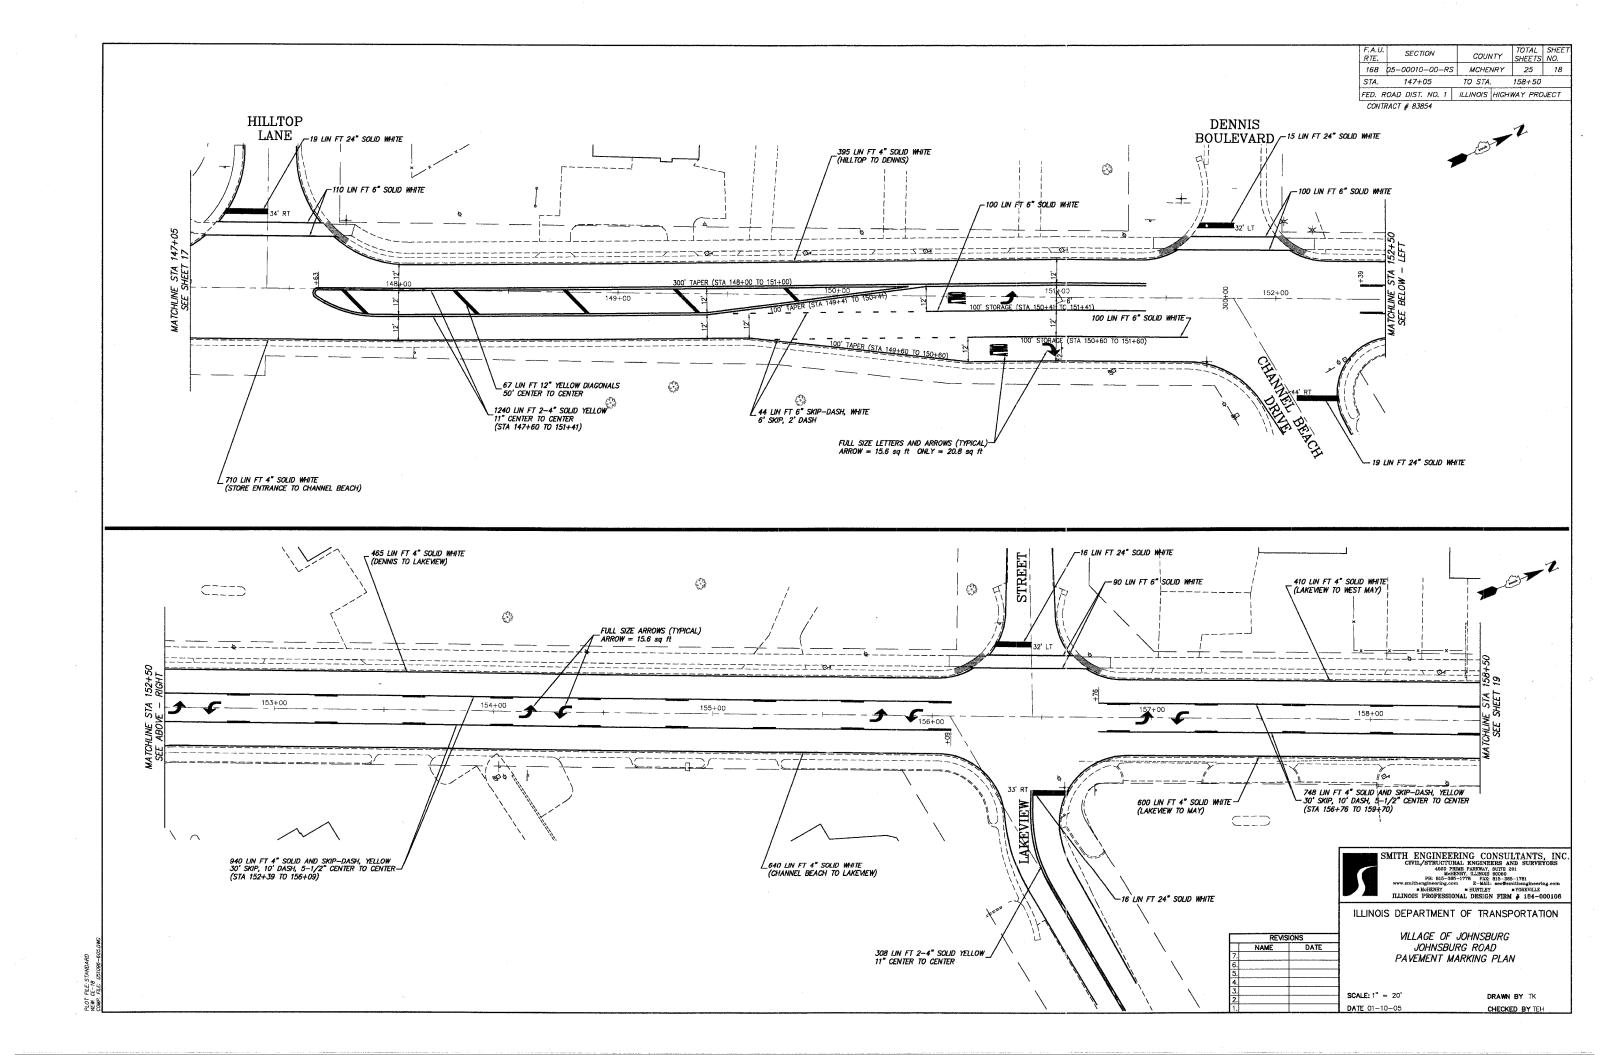

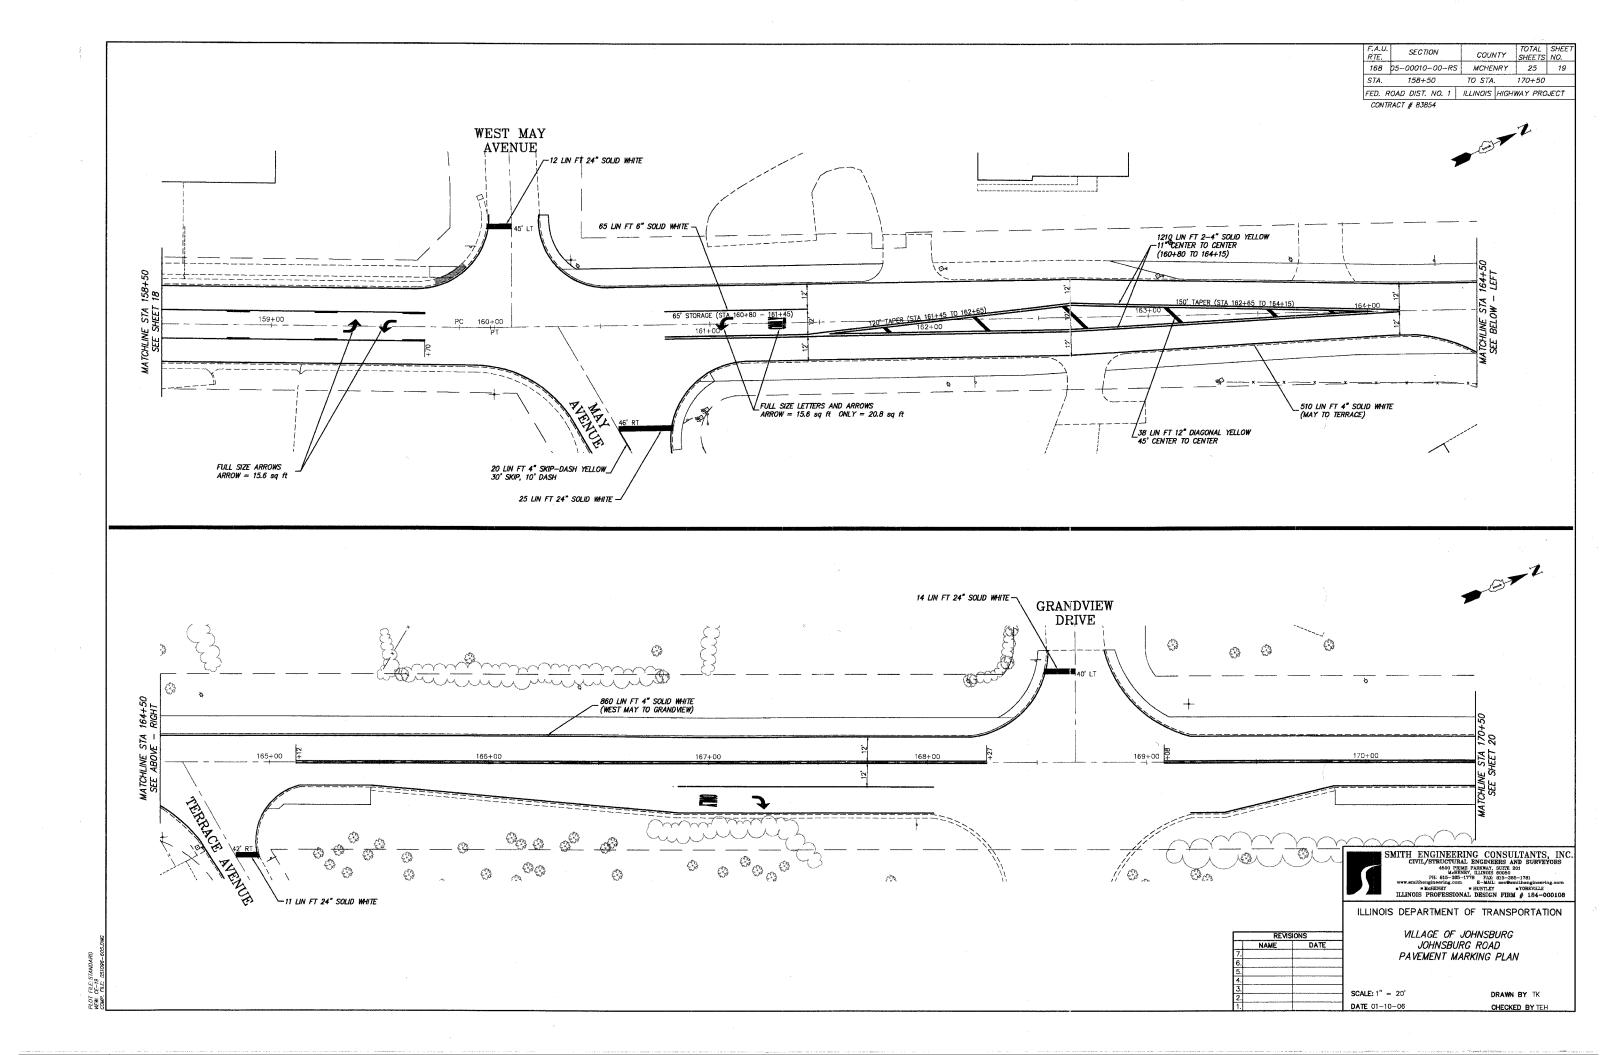

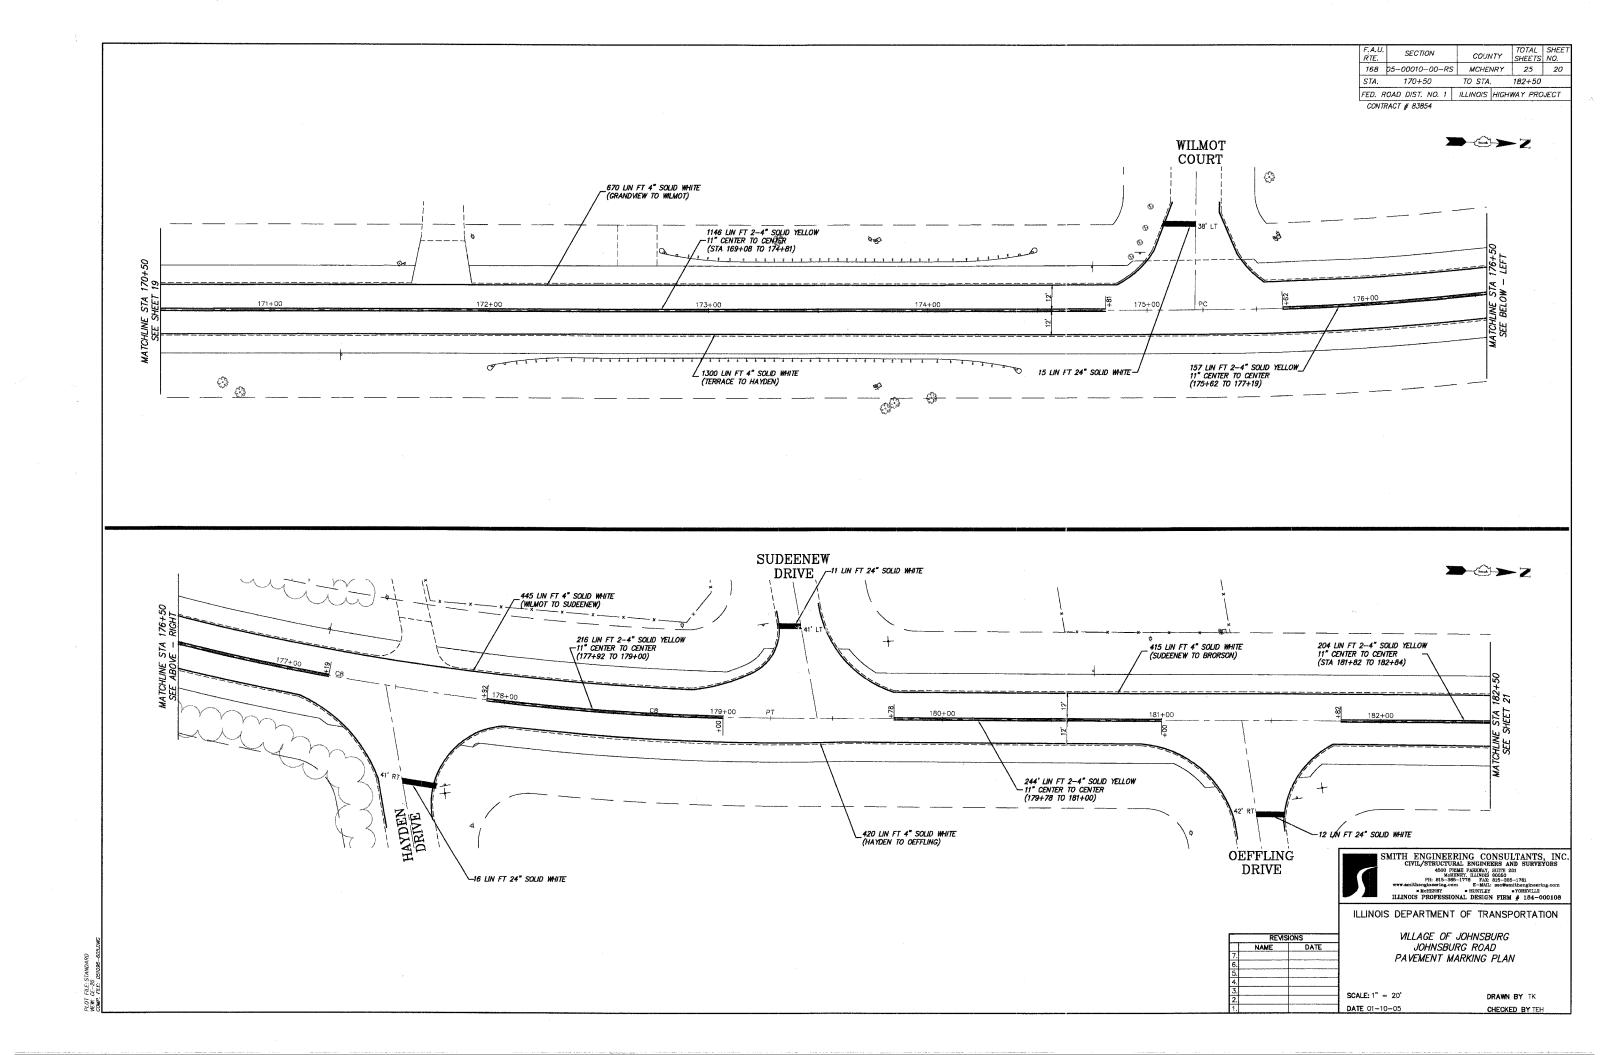

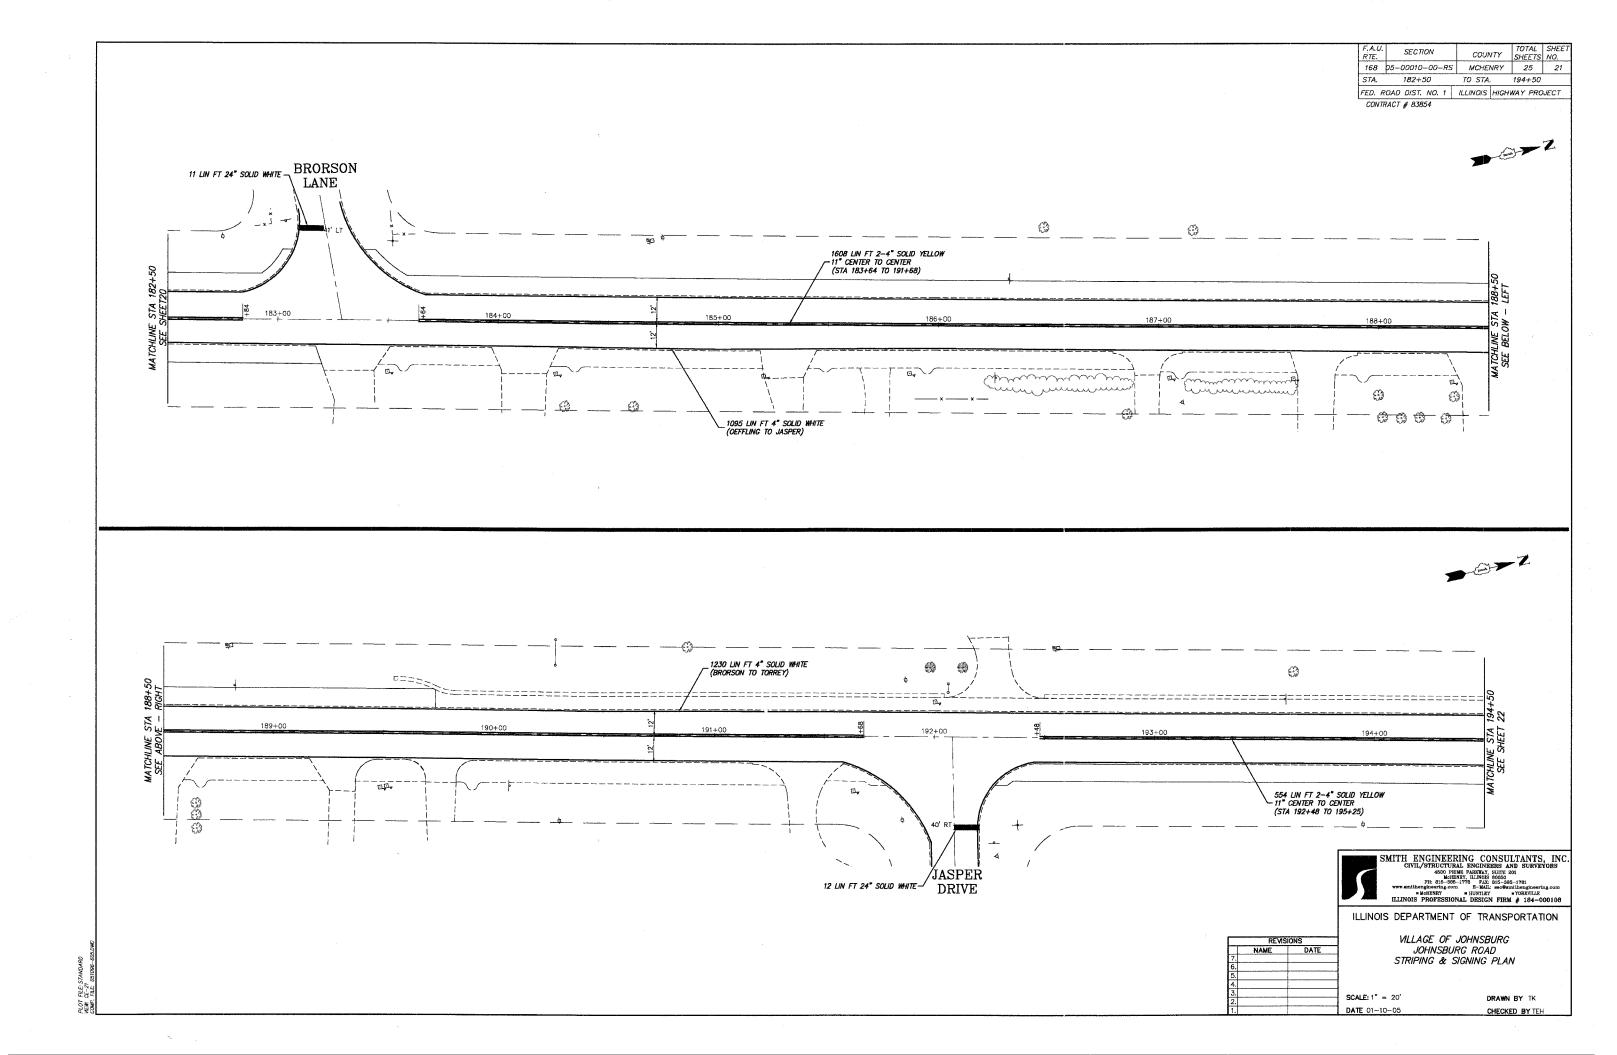


 F.A.U. RTE.
 SECTION
 COUNTY
 TOTAL SHEETS
 SHEETS NO.


 168
 D5-00010-00-RS
 MCHENRY
 25
 22
 F.A.U. RTE. STA. 194+50 TO STA. 202+33 FED. ROAD DIST. NO. 1 ILLINOIS HIGHWAY PROJECT

CONTRACT # 83854



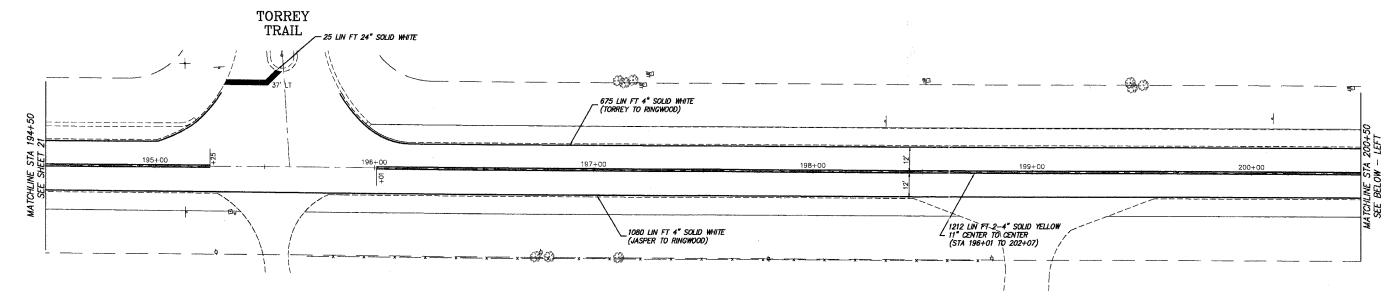



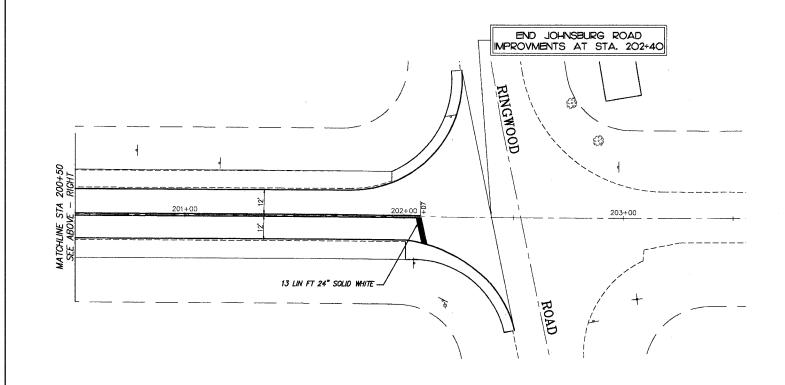




ILLINOIS DEPARTMENT OF TRANSPORTATION

VILLAGE OF JOHNSBURG JOHNSBURG ROAD PAVEMENT MARKING PLAN

SCALE: 1" = 20' DATE 01-10-06 DRAWN BY TK CHECKED BY TEH

REVISIONS NAME DATE

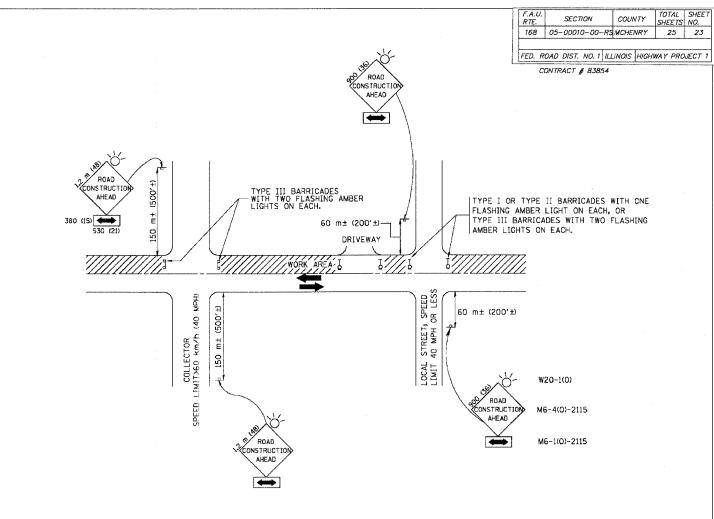

TRAFFIC CONTROL AND PROTECTION FOR SIDE ROADS, INTERSECTIONS, AND DRIVEWAYS

NOTES:

- A. FOR NO LANE RESTRICTION ON THE SIDE ROAD OR DRIVEWAYS
- 1. SIDE ROAD WITH A SPEED LIMIT OF 60 km/h (40 MPH) OR LESS AS SHOWN ON THE DRAWING AND AS DIRECTED BY THE ENGINEER:
- O) ONE ROAD CONSTRUCTION AHEAD SIGN 900×900 (36×36) WITH A FLASHER AND FLAG MOUNTED ON IT APPROXIMATILLY 60 m (200') IN ADVANCE OF THE MAIN ROUTE.
- b) THE CLOSED PORTION OF THE MAIN ROUTE SHALL BE PROTECTED BY BLOCKING WITH TYPE I, TYPE II OR TYPE III BARRICADES, 1/3 OF THE CROSS SECTION OF THE CLOSED PURTION.
- 2. SIDE ROAD WITH A SPEED LIMIT GREATER THAN 60 km/h (40 MPH) AS SHOWN ON THE DRAWING AND AS DIRECTED BY THE ENGINEER:
- a) ONE ROAD CONSTRUCTION AHEAD SIGN 1.2 m \times 1.2 m (48 \times 48) WITH A FLASHER MOUNTED ON IT APPROXIMATELY 150 m (500°) IN ADVANCE OF THE MAIN ROUTE.
- b) THE CLOSED PORTION OF THE MAIN ROLTE SHALL BE PROTECTED BY BLOCKING WITH TYPE III BARRICADES, 1/2 OF THE CROSS SECTION OF THE CLOSED PORTION.
- 3. WHEN THE SIDE ROAD LIES BETWEEN THE BEGINNING OF THE MAINLINE SIGNING AND THE WORK ZONE, A SINGLE HEADED ARROW (M6-1) SHALL BE USED IN LIEU OF THE DOUBLE HEADED ARROW (M6-4).

- B. FOR A LANE CLOSURE ON A SIDE ROAD OR DRIVEWAY:
- USE APPLICABLE PORTIONS OF THE TYPICAL APPLICATION OF TRAFFIC CONTROL DEVICES (STD. 701501, STD. 701606 OR THE APPROPRIATE STANDARD). THE SPACING OF SIGNS AND BARRICADES SHALL BE ADJUSTED FOR FIELD CONDITIONS AS DIRECTED BY THE ENGINEER. THE DIRECTIONAL ARROW SHALL BE COVERED OR REMOVED WHEN NO LONGER CONSISTENT WITH THE SIDE ROAD LANE CLOSURE.
- C. ADVANCE WARNING SIGNS ARE TO BE OMITTED ON DRIVEWAY UNLESS OTHERWISE NOTED.
- D. THE TRAFFIC CONTROL AND PROTECTION FOR SIDE ROADS, INTERSECTIONS, AND DRIVEWAYS SHALL BE INCIDENTAL TO THE COST OF SPECIFIED TRAFFIC CONTROL STANDARDS OR ITEMS.

REVISIO	NS	
NAME	DATE	
LHA	6/89	Т
T. RAMMACHER	09/08/94	1
J. OBERLE	10/18/95	
A. HOUSEH	03/06/96	
A. HOUSEH	10/15/96	
T. RAMMACHER	01/06/00	

ILLINOIS DEPARTMENT OF TRANSPORTATION
TRAFFIC CONTROL AND PROTECTION
FOR

SIDE ROADS, INTERSECTIONS, AND DRIVEWAYS


SCALE: VERT. HORIZ, DATE 10/18/2002


DRAWN BY CHECKED BY

TC-10

L
Friday October 13,2002 & 10:20:23 AM
c:\projects\diststd\to10.dgn LV=35,63
*\USER**

REVISION DATE: 01/06/00

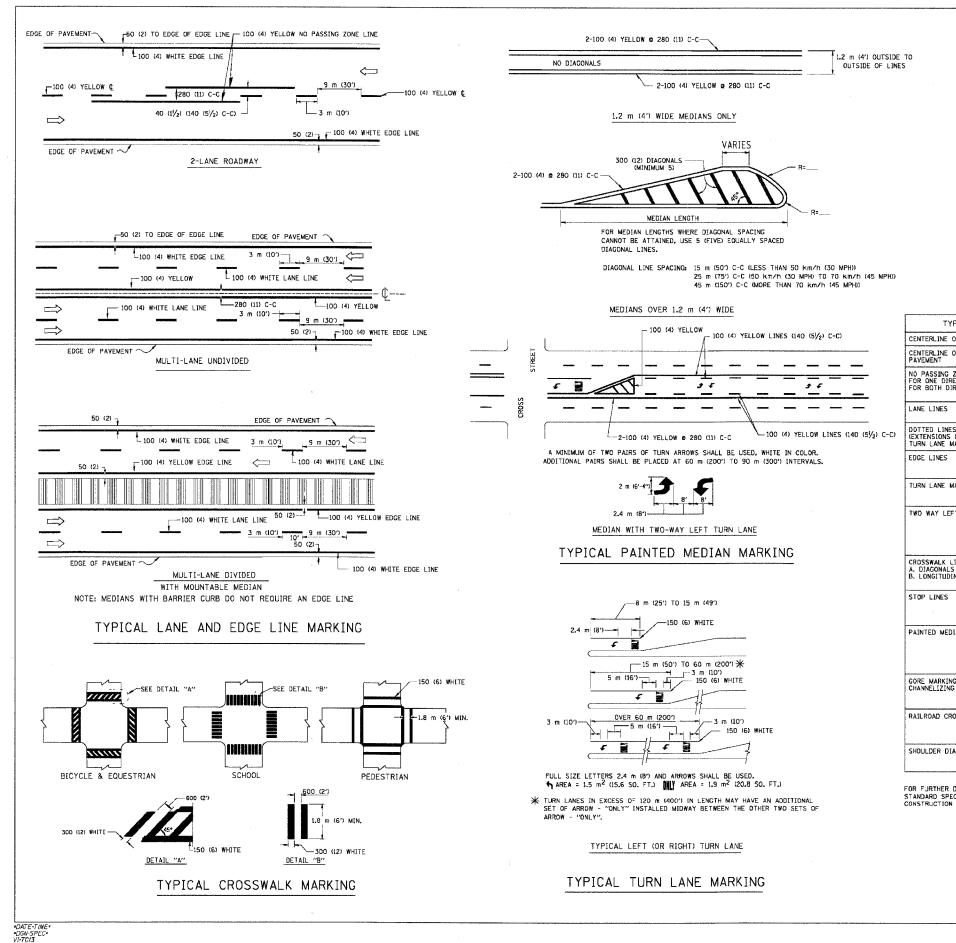

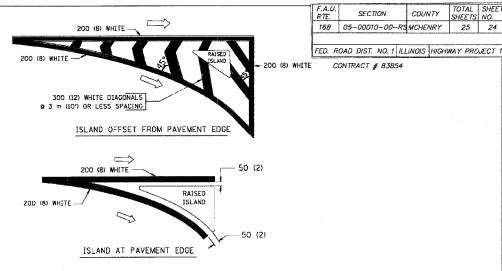

TYPICAL ISLAND MARKING

TYPE OF MARKING	WIDTH OF LINE	DATERN	201.00	SPACING / REMARKS
		PATTERN	COLOR	
CENTERLINE ON 2 LANE PAVEMENT	100 (4)	SKIP-DASH	YELLOW	3 m (10') LINE WITH 9 m (30') SPACE
CENTERLINE ON MULTI-LANE UNDIVEDED PAYEMENT	2 @ 100 (4)	SOLID	YELLOW	280 (11) C-C
NO PASSING ZONE LINES: FOR ONE DIRECTION FOR BOTH DIRECTICNS	100 (4) 2 @ 100 (4)	SOLID SOLID	AETTOM AETTOM	140 (5½) C-C FROM SKIP-DASH CENTERLINE 280 (11) C-C OMIT SKIP-DASH CENTERLINE BETWEEN
LANE LINES	100 (4) 125 (5) ON FREEWAYS	SKIP-DASH SKIP-DASH	WHITE WHITE	3 m (10") LINE WITH 9 m (30") SPACE
DOTTED LINES (EXTENSIONS OF CENTER, LANE OR TURN LANE MARKINGS)	SAME AS LINE BEING EXTENDED	SKIP-DASH	SAME AS LINE BEING EXTENDED	600 (2') LINE WITH 1.8 m (6') SPACE
EDGE LINES	100 (4)	SOLID	YELLOW-LEFT WHITE-RIGHT	OUTLINE MOUNTABLE MEDIANS IN YELLOW; EDGE LINES ARE NOT USED NEXT TO BARRIER CURB
TURN LANE MARKINGS	150 (6) LINE; FULL SIZE LETTERS & SYMBOLS (2.4 m (8'))	SOLID	WHITE	SEE TYPICAL TURN LANE MARKING DETAIL
TWO WAY LEFT TURN MARKING	2 @ 100 (4) EACH DIRECTION	SKIP-DASH AND SOLID	YELLOW	3 m (10") LINE WITH 9 m (30") SPACE FOR SKIP-DASH; 140 (5½) C-C BETWEEN SOLID LINE AND SKIP-DASH LINE
	2.4 m (8') LEFT ARROW	IN PAIRS	WHITE	SEE TYPICAL TWO-WAY LEFT TURN MARKING DETAIL
CROSSWALK LINES PEDESTRIAN) A. DIAGONALS (BIKE & EQUESTRIAN) B. LONGITUDINAL BARS (SCHOOL)	2 @ 150 (6) 300 (12) @ 45° 300 (12) @ 90°	SOLID SOLID SOLID	WHITE WHITE WHITE	NOT LESS THAN 1.8 m (6') APART 600 (2') APART 600 (2') APART SEE TYPICAL CROSSWALK MARKING DETAILS.
STOP LINES	600 (24)	SOLID	WHITE	PLACE 1.2 m (4") IN ADVANCE OF AND PARALLEL TO CROSSWALK, IF PRESENT. OTHERWISE, PLACE AT DESIRED STOPPING POINT. PARALLEL TO CROSSROAD CENTERLINE, WHERE POSSIBLE
PAINTED MEDIANS	2 @ 100 (4) WITH	SOLID	YELLOW:	280 (11) C-C FOR THE DOUBLE LINE
	300 (12) DIAGONALS @ 45°		TWC WAY TRAFFIC	SEE TYPICAL PAINTED MEDIAN MARKING.
	NO DIAGONALS USED FOR 1.2 m (4') WIDE MEDIANS		WHITE: ONE WAY TRAFFIC	
CORE MARKING AND CHANNELIZING LINES	200 (8) WITH 300 (12) DIAGONALS @ 45°	SOLID	WHITE	DIAGONALS; 4.5 m (15') C-C (LESS THAN 50 km/h (30 MPH)) 6 m (20') C-C (50 km/h (30 MPH) TO TO km/h (45 MPH)) 9 m (30') C-C (OVER 70 km/h (45 MPH))
RAILROAD CROSSING	600 (24) TRANSVERSE LINES; "RR" IS 1.8 m (6') LETTERS; 400 (16) LINE FOR "X"	SOLID	WHITE	SEE STATE STANDARD 780001 AREA OF: '%7'=0.33m2' (3.6 SO. FT.) EACH '%7'=5.0 m2' (54.0 SQ. FT.)
SHOULDER DIAGONALS	300 (12) c 45°	SOLID	WHITE - RIGHT YELLOW - LEFT	15 m (50") C-C (LESS THAN 50 km/h (30 MPH)) 25 m (75") C-C (50 km/h (30 MPH) TO 70 km/h (45 MPH)) 45 m (150") C-C (OVER 70 km/h (45 MPH))
	L	L	<u> </u>	1

FOR FURTHER DETAILS ON PAVEMENT MARKING REFER TO STANDARD SPECIFICATIONS FOR ROAD AND BRIDGE CONSTRUCTION AND STATE STANDARD 780001.

All dimensions are in millimeters (inches) unless otherwise shown.

ILLINOIS DEPARTMENT OF TRANSPORTATION

DISTRICT ONE TYPICAL PAVEMENT MARKINGS


> SCALE. NONE DATE 10/18/2002


DRAWN BY CADD CHECKED BY TC-13

REVISION DATE: 01/06/00

TOTAL SHEE

SHEETS NO.

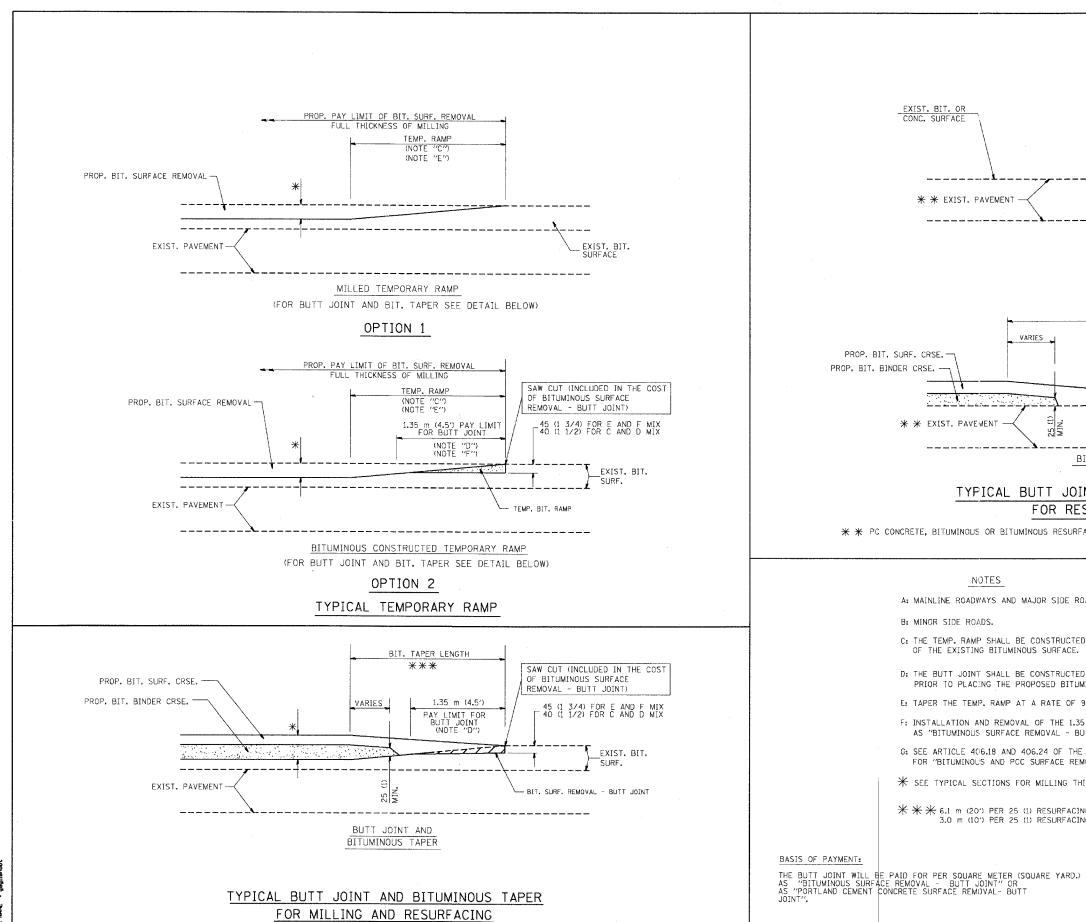

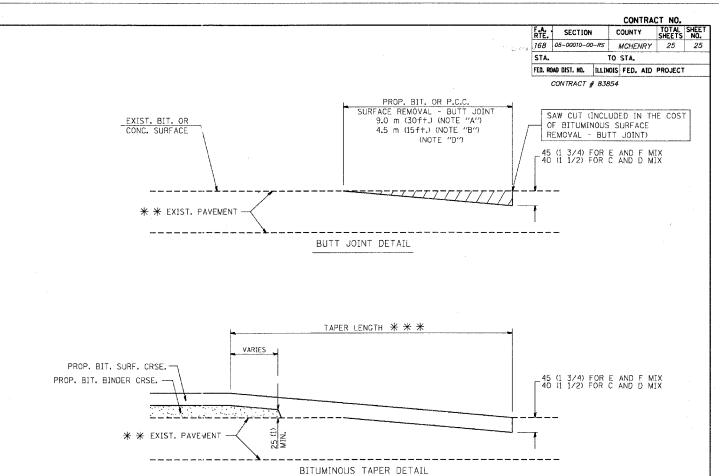

TYPICAL BUTT JOINT AND BITUMINOUS TAPER FOR RESURFACING ONLY

* * PC CONCRETE, BITUMINOUS OR BITUMINOUS RESURFACED PAVEMENT.

NOTES

- A: MAINLINE ROADWAYS AND MAJOR SIDE ROADS.
- B: MINOR SIDE ROADS.
- C: THE TEMP, RAMP SHALL BE CONSTRUCTED IMMEDIATELY UPON REMOVAL OF THE EXISTING BITUMINOUS SURFACE.
- D: THE BUTT JOINT SHALL BE CONSTRUCTED IMMEDIATELY PRIOR TO PLACING THE PROPOSED BITUMINOUS COURSES.
- E: TAPER THE TEMP. RAMP AT A RATE OF 900 (3 ft.) PER INCH OF MILLING THICKNESS.
- F: INSTALLATION AND REMOVAL OF THE 1.35 m (4.5') TEMP. BIT. RAMP WILL BE PAID AS "BITUMINOUS SURFACE REMOVAL - BUTT JOINT".
- G: SEE ARTICLE 406.18 AND 406.24 OF THE STANDARD SPECIFICATIONS FOR "BITUMINOUS AND PCC SURFACE REMOVAL, BUTT JOINT".
- * SEE TYPICAL SECTIONS FOR MILLING THICKNESS.

ALL DIMENSIONS ARE IN MILLIMETERS (INCHES) UNLESS OTHERWISE SHOWN,

ILLINOIS DEPARTMENT OF TRANSPORTATION

R. SHAH A. ABBAS M. GOMEZ

BUTT JOINT AND BITUMINOUS TAPER DETAILS 09/09/9

SCALE: VERT.

DRAWN BY CHECKED BY

BD400-05 (VI=BD32) REVISION DATE: 04/06/01