

SECTION 2774 99-00073-00-WR 116 CMM-7003 (750)

CONTRACT NO. 83727

| | STANDARD | |
|-------|--------------------------------|--|
| | NO. | STANDARD |
| | | |
| | 280001- 02 | TEMPORARY EROSION CONTROL SYSTEMS |
| | 424001 - 04 | CURB RAMPS FOR SIDEWALKS |
| | 442101- 05 | CLASS B PATCHES |
| | 442201 - 01 | CLASS C & D PATCHES |
| | 482011- 0 1 | BITUMINOUS SHOULDER STRIPS/SHOULDERS WITH RESURFACING OR WIDENING AND RESURFACING PROJECTS |
| | 542301 | PRECAST REINFORCED CONCRETE FLARED END SECTIONS |
| | 542311 | GRATING FOR CONCRETE FLARED END SECTIONS |
| | 542401 | METAL END SECTION FOR PIPE CULVERTS |
| | 602001 | CATCH BASIN, TYPE A |
| | 602011 | CATCH BASIN, TYPE C |
| | 602301 - 0 1 | INLET, TYPE A |
| | 602401 - 01 | MANHOLE, TYPE A MANHOLE, TYPE A, 6 ' DIA. |
| | 602406 -02 602601 | PRECAST REINFORCED CONCRETE FLAT SLAB TOP |
| | 602701 -01 | MANHOLE STEPS |
| | 604001 -02 | FRAME AND LIDS, TYPE 1 |
| | 604036- 0 1 | GRATE, TYPE 8 |
| | 604091- 0 | FRAME AND GRATE, TYPE 24 |
| | 606001- 02 | CONCRETE CURB TYPE B AND COMBINATION CONCRETE CURB AND GUTTER |
| | 606006 | OUTLET FOR CONCRETE CURB AND GUTTER, TYPE B-15.60 (B-6.24) |
| | 630001 ~06 | STEEL PLATE BEAM GUARDRAIL |
| | 630101- 06 | GUARDRAIL MOUNTED ON EXISTING CULVERTS |
| | 630201 - 03 | PCC/BITUMINOUS STABILIZATION AT STEEL PLATE BEAM GUARDRAIL |
| | 630301 -03 | SHOULDER WIDENING FOR TYPE 1 (SPECIAL) GUARDRAIL TERMINALS |
| | 635006- 02 | REFLECTOR AND TERMINAL MARKER PLACEMENT |
| | 635011 -01 | REFLECTOR MARKER AND MOUNTING DETAILS |
| | 642001 | SHOULDER RUMBLE STRIPS |
| | 701006- 02 | OFF-ROAD OPR. 2L, 2W. 4.5m (15') TO 600 mm (24") FROM PAVEMENT EDGE |
| | 701011- 0 | OFF-ROAD MOVING OPERATIONS 2L, 2W DAY ONLY |
| | 701101 - 01 | OFF-ROAD OPERATIONS, MULTILANE, 4.5 m (15') to 600 mm (24") FROM PAVEMENT EDGE |
| | 701201- 02 | LANE CLOSURE, 2L, 2W, DAY ONLY, FOR SPEEDS \$ 45 MPH |
| | 701301- 02 | LANE CLOSURE 2L, 2W, SHORT TIME OPERATIONS |
| | 701326- 02 | LANE CLOSURE 2L, 2W, PAVEMENT WIDENING FOR SPEEDS > 45 MPH |
| teal. | (701406-04) | TANE CLOSURE, FREEWAY/EXPRESSWAY, DAY OPERATIONS OFFY |
| 12-06 | 701501- 03 | URBAN LANE CLOSURE, 2L, 2W, UNDIVIDED |
| | 701502 -01 | URBAN LANE CLOSURE, 2L, 2W WITH BIDIRECTIONAL LEFT TURN LANE (2 SHEETS) |
| | 701701 -04 | URBAN LANE CLOSURE, MULTILANE INTERSECTION |
| | 701801- 03 | LANE CLOSURE, MULTILANE 1 W OR 2W CROSSWALK OR SIDEWALK CLOSURE |
| | 702001 ~06 | TRAFFIC CONTROL DEVICES (3 SHEETS) |
| | 720001 | SIGN PANEL MOUNTING DETAILS |
| | 720006 | SIGN PANEL ERECTION DETAILS |
| | 720011 | METAL POSTS FOR SIGNS, MARKERS AND DELINEATORS |
| | 720016 -01 | MAST ARM MOUNTED STREET NAME SIGNS |
| | 729001 | APPLICATIONS OF TYPES OF A & B METAL POSTS |
| | 780001~ 0 [| TYPICAL PAVEMENT MARKINGS |
| | 805001 814001 | ELECTRICAL SERVICE INSTALLATION DETAILS CONCRETE HANDHOLES |
| | 814006 | DOUBLE HANDHOLES |
| | 857001 | STANDARD PHASE DESIGNATION DIAGRAMS AND PHASE SEQUENCES (2 SHEETS) |
| | 877001 -02 | STANDARD PRIASE DESIGNATION DIAGRAMS AND PRIASE SEQUENCES (2 SHEETS) |
| | 877006 -02 | STEEL MAST ARM ASSEMBLY AND POLE WITH DUAL MAST ARMS |
| | 878001- 04 | CONCRETE FOUNDATION DETAILS |
| | 880001 | SPAN WIRE MOUNTED SIGNALS AND FLASHING BEACON INSTALLATION |
| | | |

CTANDADD

880006 886001

ABBREVIATIONS

SPAN WIRE MOUNTED SIGNALS AND FLASHING BEACON INSTALLATION TRAFFIC SIGNAL MOUNTING DETAILS

URBAN LAME CLOSURE, MULTICANE, 2W WITH MOUNTABLE MEDIAN

| CONC | PORTLAND CEMENT CONCRETE | R | STRUCTURE TO BE RECONSTRUCTED |
|---------|--------------------------|----------|---------------------------------|
| BIT | BITUMINOUS PAVEMENT | Α | STRUCTURE TO BE ADJUSTED |
| GR | GRAVEL | A | CENTRAL ANGLE |
| CMP | CORRUGATED METAL PIPE | D= | DEGREE OF CURVE |
| FH | FIRE HYDRANT | T= | TANGENT LENGTH |
| CI | CAST IRON | L= | CURVE LENGTH |
| DI | DUCTILE IRON | R= | RADIUS OF CURVE |
| F-F | FACE-TO-FACE | E= | EXTERNAL DISTANCE |
| E-E | EDGE-TO-EDGE | SE≕ | SUPERELEVATION |
| B-B | BACK-TO-BACK | | (FT. PER FT. OF WIDTH) |
| ВМ | BENCH MARK | X= | EXTERNAL DISTANCE OF |
| INV FI. | INVERT ELEVATION | | VERTICAL CURVE |
| CL EL | CENTERLINE ELEVATION | PC | POINT OF CURVATURE |
| P | | PI | POINT OF INTERSECTION |
| G | POINT GUTTER | PT | POINT OF TANGENCY |
| C | CURB | POT | POINT ON TANGENCY |
| BC | | PCC | POINT OF COMPOUND CURVATURE |
| | EDGE OF PAVEMENT | PRC | POINT OF REVERSE CURVATURE |
| EOP | | | |
| PL | PROPERTY LINE | VC | VERTICAL CURVE |
| ROW | RIGHT OF WAY | N&W | NAIL AND WASHER |
| FL | FLOW LINE | TCE | TEMPORARY CONSTRUCTION EASEMENT |
| TF | TOP OF FRAME | | |
| TC | TOP OF CURB OR CONCRETE | | |
| | | | |

DESCRIPTION CONSULTANTS REV. NO. DATE 4-28-06 PER IDOT AND COOK CO. COMMENTS - REFER TO EQUIPMENT MANUFACTURER'S SHOP DRAWING



| Baxter & Woodman | Crystal Lake, Illimovs | 815.459,1260 | Burlington, Wisconsia | 262.763.7834 | Mokena, Illimois | 262.763.7834 | DeKalb, Illimois | 315.787.3111 | Crayslake, Illimois | 347.223.7608 | Crayslake, Illimois | 262.780.7351 | Crayslake, Illimois | 262.78

CITY OF OAK FOREST, ILLINOIS **OAK PARK AVENUE PROJECT**

LEGENU, HIGHWAY STANDARDS AND ABBREVIATIONS

| DESIGNED BY | SCALE |
|-------------|-------------|
| NJP | NONE |
| DRAWN BY | PROJECT NO. |
| UKB | 020146 |
| CHECKED BY | SHEET NO. |
| NJP | |
| DATE | 2 OE 116 |
| 1-20-05 | ZUFIIO |

SUMMARY OF QUANTITIES, CONTINUED

Deleted 6-12-06

| | | | | TOTAL | ROADWAY | SIGNAL | SIDEWAL |
|-------|--|---|---|---------------|--|--|--|
| PCLTY | IDOT CODE | ITEM | UNIT | QUANTITY | I000-2A | | 5FTY-18 |
| | | | | | | | |
| | 67100100 | MOBILIZATION | LSUM | 1 | 1 | | |
| | 70100450 | TRAFFIC CONTROL AND PROTECTION, STANDARD 701201 | LSUM | 1 | 1 | | |
| | 70100500 | TRAFFIC CONTROL AND PROTECTION, STANDARD 701326 | LSUM | 1 | 1 | PARELLE STATE AND ADDRESS OF THE | |
| 4 | 70100700 | TRAFFIC CONTROL AND PROTECTION, STANDARD 701406 | LSUM | 1 | 1 | | * |
| | 70102620 | TRAFFIC CONTROL AND PROTECTION, STANDARD 701501 | LSUM | 1 | 1 | # # 1000 0 W 100 0 W 1 | \$ } |
| | 70102622 | TRAFFIC CONTROL AND PROTECTION, STANDARD 701502 | LSUM | 1 | 1 | | |
| | 70102550 | TRAFFIC CONTROL AND PROTECTION FOR TEMPORARY DETOUR | EACH | 3 | 3 | | |
| | 70102635 | TRAFFIC CONTROL AND PROTECTION, STANDARD 701701 | LSUM | 1 | 1 | | |
| | 70102640 | TRAFFIC CONTROL AND PROTECTION, STANDARD 701801 | LSUM | 1 | 1 | | |
| - 1 | 70300100 | SHORT-TERM PAVEMENT MARKING | FOOT | 10311 | 10311 | | |
| | 70300200 | TEMPORARY PAVEMENT MARKING | FOOT | 41244 | 41244 | | |
| | 70301000 | WORK ZONE PAVEMENT MARKING REMOVAL | SQ FT | 3437 | 3437 | | |
| ** | 72000100 | SIGN PANEL - TYPE 1 | SQFT | 300 | 200 | 100 | |
| ** | 72900100 | METAL POST - TYPE A | FOOT | 632 | 632 | | |
| ** | 78000100 | THERMOPLASTIC PAVEMENT MARKING - LETTERS AND SYMBOLS | SQ FT | 858 | 858 | | |
| ** | 78000200 | THERMOPLASTIC PAVEMENT MARKING - LINE 4" | FOOT | 33625 | 33625 | ************************************** | |
| ** | 78000400 | THERMOPLASTIC PAVEMENT MARKING - LINE 6" | FOOT | 2654 | 2654 | | |
| ** | 78000600 | THERMOPLASTIC PAVEMENT MARKING - LINE 12" | FOOT | 1296 | 1296 | | - |
| ** | 78000650 | THERMOPLASTIC PAVEMENT MARKING - LINE 24" | FOOT | 326 | 326 | | |
| ** | 78100100 | RAISED REFLECTIVE PAVEMENT MARKER | EACH | 561 | 561 | gan gali gangan san san sagar nggananan san sa | |
| ** | 78200410 | GUARDRAIL MARKERS, TYPE A | EACH | 8 | 8 | | - |
| ** | 78201000 | TERMINAL MARKER - DIRECT APPLIED | EACH | 4 | 4 | | |
| | 78300100 | PAVEMENT MARKING REMOVAL | SQ FT | 3437 | 3437 | | |
| ** | 78300200 | RAISED REFLECTIVE PAVEMENT MARKER REMOVAL | EACH | 208 | 208 | | |
| ** | 81000300 | CONDUIT IN TRENCH, 1" DIA., GALVANIZED STEEL | FOOT | 15 | 15 | | |
| ** | 81000600 | CONDUIT IN TRENCH, 2" DIA., GALVANIZED STEEL | FOOT | 5631 | | 5631 | |
| ** | 81000700 | CONDUIT IN TRENCH, 2 1/2" DIA., GALVANIZED STEEL | FOOT | 287 | | 287 | |
| ** | 81000800 | CONDUIT IN TRENCH, 3" DIA., GALVANIZED STEEL | FOOT | 48 | | 48 | |
| ** | | CONDUIT IN TRENCH, 4" DIA., GALVANIZED STEEL | FOOT | 30 | | 30 | |
| ** | | CONDUIT PUSHED, 2" DIA., GALVANIZED STEEL | FOOT | 581 | | 581 | |
| ** | a an ann an ann ann an ann an ann an an | CONDUIT PUSHED, 2 1/2" DIA., GALVANIZED STEEL | FOOT | 71 | | 71 | |
| ** | | CONDUIT PUSHED, 3" DIA., GALVANIZED STEEL | FOOT | 231 | | 231 | |
| ** | Street Christian American Street Advanced Assessment | CONDUIT PUSHED, 4" DIA., GALVANIZED STEEL | FOOT | 520 | | 520 | |
| ** | | HANDHOLE | EACH | . 18 | | 18 | † |
| ** | · · · · · · · · · · · · · · · · · · · | HEAVY DUTY HANDHOLE | EACH | 11 | | 11 | |
| ** | | DOUBLE HANDHOLE | EACH | 3 | | 3 | The same and the s |
| ** | | TRENCH AND BACKFILL FOR ELECTRICAL WORK | FOOT | 6002 | | 6002 | |
| ** | | LIGHT POLE FOUNDATION, 24" DIAMETER | FOOT | 20 | 20 | JUUZ | |
| ** | THE CONTROL BUILDING SECTION AND ADDRESS OF THE PARTY OF | LIGHT FOLE FOUNDATION, 24 DAMETER LIGHTING FOUNDATION REMOVAL | EACH | 20 | | AN THE THE AND ENGINEERING WITHOUT AND THE | |
| ** | | RELOCATE EXISTING LIGHTING UNIT | EACH | 2 | | 2 | |
| ** | | MAINTAINANCE OF EXISTING TRAFFIC SIGNAL INSTALLATION | EACH | 2 | | 2 | E PER AND |
| ** | | | EACH | 2 | | 2 | 1 |
| ** | | FULL - ACTUATED CONTROLLER AND TYPE IV CABINET | EACH | 1 | | 1 | - |
| ** | | FULL - ACTUATED CONTROLLER AND TYPE V CABINET | EACH | 1 | | 1 | |
| ** | PETERSE PERO RESERVEDADA POLICIA DI MONTO MENTO | MASTER CONTROLLER TRANSCENER FIRE PORTIC | *************************************** | 3 | TOWNSON DECEMBER OF METER INVESTIGATION OF | 3 | |
| ** | | TRANSCEIVER - FIBER OPTIC | EACH | | | | † |
| ** | 1 | ELECTRIC CABLE IN CONDUIT, SIGNAL, NO. 14 2C | FOOT | 813 (2541) | *************************************** | 813 | |
| | *************************************** | ELECTRIC CABLE IN CONDUIT, SIGNAL, NO. 14 3C | FOOT | | | (2541) | The second secon |
| ** | | ELECTRIC CABLE IN CONDUIT, SIGNAL, NO. 14 5C | FOOT | (4526 | * | (4526 | 1 |
| ** | September in the property of the control of the con | ELECTRIC CABLE IN CONDUIT, SIGNAL, NO. 14 7C | FOOT | (2468 | • | (2468 | 1 |
| ** | | ELECTRIC CABLE IN CONDUIT, LEAD-IN, NO. 14 1 PAIR | FOOT | (4619) | 1 | (4619 | |
| ** | | ELECTRIC CABLE IN CONDUIT, SERVICE, NO. 6, 2C | FOOT | (463) | | (463 | |
| ** | | TRAFFIC SIGNAL POST, GALVANIZED STEEL, 10 FT. | EACH | 1 | | 1 | - |
| ** | A COMPANY OF THE SECTION OF THE SECT | TRAFFIC SIGNAL POST, GALVANIZED STEEL, 14 FT. | EACH | 5 | \$44.00.00.00.00.00.00.00.00.00.00.00.00.0 | 5 | 1 |
| ** | 87502500 | TRAFFIC SIGNAL POST, GALVANIZED STEEL, 16 FT. | EACH | 4 | | 4 | ļ |

| F.A.U. ROUTE N | D. SECTION | COUNTY | SHEETS | SHEET NO. |
|-------------------|----------------|----------|-----------|--------------|
| 2774 | 990007300WR | COOK | 116 | 5 |
| STA. | TO STA | λ | | |
| FED. RO | ND DIST. NO. 1 | ILLINOIS | FED AID I | |
| | | | CHM-700 | |

| CONSULTANTS | REV. NO. | DATE | DESCRIPTION |
|---|----------|---------|-----------------------------------|
| | 1 | 4-28-06 | PER IDOT AND COOK COUNTY COMMENTS |
| | 2 | 5-8-06 | PER IDOT COMMENTS |
| * - REFER TO EQUIPMENT MANUFACTURER'S SHOP DRAWINGS | | | |
| 1" .5" 0 1" 2" 3" | | | |
| | | | |



CITY OF OAK FOREST, ILLINOIS OAK PARK AVENUE PROJECT

SUMMARY OF QUANTITIES

| | | | | | |
|-------------|-------------|-----|--|--|--|
| DESIGNED BY | SCALE | | | | |
| NJP | NONE | | | | |
| DRAWN BY | PROJECT NO. | | | | |
| UKB | 020146 | | | | |
| CHECKED BY | SHEET NO. | | | | |
| NJP | | | | | |
| DATE | 5 OF | 116 | | | |
| 1-20-05 | JUF | 110 | | | |

| IMMARY OF QUANTITIES, CONTINUED | SPCLTYIDO | T CODE | ITEM | UNIT | TOTAL QUANTITY | - | | SIDEWALK SFTY-1B | ROUTE NO. SECTION COUN | FED ALC |
|---|--|---|--|---------|------------------------|---|---|---|----------------------------|-------------|
| | ** 87 | 700170 STEEL MAST ARM ASSE | EMBLY AND POLE, 26 FT. | EACH | 2 | | 2 | | CONTRACT NO. 83727 | CMM-7 |
| | ** 87 | 700180 STEEL MAST ARM ASSE | EMBLY AND POLE, 28 FT. | EACH | 4 | | 4 | *************************************** | | |
| | ** 87 | 700190 STEEL MAST ARM ASSE | EMBLY AND POLE, 30 FT. | EACH | 1 | | 1 | - Landanderica de la companya de la | | |
| | ** 87 | 700280 STEEL MAST ARM ASSE | EMBLY AND POLE, 48 FT. | EACH | 1 | | 1 | a succession | | |
| | ** 87 | 800100 CONCRETE FOUNDATIO | DN. TYPE A | FOOT | 40 | *************************************** | 40 | | | |
| | | 800200 CONCRETE FOUNDATION | | FOOT | 12 | | 12 | 70.000 | | |
| | harmon an | 800400 CONCRETE FOUNDATION | | FOOT | 150 | enem enement of the second | 150 | | | |
| | | 800415 CONCRETE FOUNDATION | | FOOT | 15 | ************************************** | 15 | mmaxmatavatatavavamminama | | |
| | | 900200 DRILL EXISTING HANDH | | EACH | 3 | | | | | |
| | | | | EACH | | | · · · · · · · · · · · · · · · · · · · | | | |
| | | | 3-SECTION, MAST ARM MOUNTED | | | | | | | |
| | | | 5-SECTION, MAST ARM MOUNTED | EACH | 4 | | 6 | <u> </u> | | |
| Aevised (| | 200110 TRAFFIC SIGNAL BACKI | | EACH | (27) (22) (2053) | | { 27 { 22 | | | |
| 6-12-06 | 7 ** \\\\\\\\\\\\\\\\\\\\\\\\\\\\\\\\\\ | 500100) INDUCTIVE LOOP DETE | | EACH | S 22 | | 22 | } | | |
| | ** (88 | 600100) DETECTOR LOOP, TYPE | <u> </u> | FOOT | (2053) | | 2053 | 2 | | |
| | ** 88 | 700200 LIGHT DETECTOR | | EACH | 7 | ~~~~~~~~~~~~~~~~~~~~~~~~~~~~~~~~~~~~~~ | 7 | | | |
| | ** 88 | 700300 LIGHT DETECTOR AMPL | .IFIER | EACH | 3 | | 3 | | | |
| | ** 88 | 800100 PEDESTRIAN PUSH BU | TTON | EACH | 7 | | 7 | | | |
| | ** 89 | 000100 TEMPORARY TRAFFIC S | SIGNAL INSTALLATION | EACH | 2 | | 2 | | | |
| | ** 89 | 502200 MODIFY EXISTING CONT | ROLLER | EACH | 1 | | 1 | - | | |
| Revoed 6-2-0 | سم ال | 502300) REMOVE ELECTRIC CA | | FOOT | (4576) | *************************************** | (4576 | 5 | | |
| | | | LL ELECTRIC CABLE FROM CONDUIT | FOOT | 3023 | | 3023 | 1 | | |
| Deleted G-12-06 | \$ ** \ 80 | 502375 REMOVE EXISTING TRA | | EACH | 2 | | າ | Tanganayar. | | |
| | for the second s | | | | | | - 44 | | | |
| | | 502380 REMOVE EXISTING HAN | , and a popular of the second | EACH | 11 | | 11 | | | |
| | ** 89 | 502385 REMOVE EXISTING CON | | EACH | 9 | | 9 | - | | |
| | ** A7 | | ANTHOS INERMIS (THORNLESS COMMON | EVOL | 4 | 4 | | Winds and | | |
| | A2 | | CALIPER, BALLED AND BURLAPPED | EACH | 1 | | | | | |
| | ** ^ | TREE, TILIA CORDATA (1 2008020 BURLAPPED | LITTLE LEAF LINDEN) 2-1/2" CALIPER, BALLED AND | EACH | 2 | . 2 | | BOOK AND | | |
| | | 0036120 MULCH PLACEMENT 4' | | SQ YD | 65 | 65 | | | | |
| | | | | 1 | 60 | | | | | |
| | | (001877 SUMP PUMP LINE CON | | EACH | 3 | . 3 | | | | |
| | | 002202 VEHICLE CONTROL BOI | | EACH | 3 | 3 | | | | |
| | | (002881 TRAFFIC SIGNAL SYSTE | | LSUM | 1 | 1 | | | | |
| | · · · · | (003183 POST MOUNTED FLASH | | EACH | 1 | 1 | | | | |
| | XX | 003817 GRATING FOR CONCRE | TE FLARED END SECTION 12" | EACH | 1 | 1 | | | | |
| | XX | (005011 BOX CULVERT EXTENS | ION WITH HEADWALL | LSUM | 1 | 1 | | | | |
| | X.C | 323426 SEDIMENT CONTROL, D | RAINAGE STRUCTURE INLET FILTER CLEANING | EACH | 1 | 1 | | | | |
| | XX | 006372 STORM SEWERS, TYPE | 1, WATER MAIN QUALITY PIPE 4" | FOOT | 30 | 30 | | | | |
| | XX | 006373 STORM SEWERS, TYPE | 1, WATER MAIN QUALITY PIPE 8" | FOOT | 45 | 45 | - | | | |
| | | | 1, WATER MAIN QUALITY PIPE 12" | FOOT | 67 | 67 | | | | |
| | 4.0000000000000000000000000000000000000 | | 1, WATER MAIN QUALITY PIPE 15" | FOOT | 164 | 164 | | | | |
| | | | DNCRETE SURFACE REMOVAL (COLD MILLING) | 1.50 | | | | | | |
| | x | 0321020 VARIABLE DEPTH | STORIETE GOLLINGE HERIO AVE (OOFD INITERING) | SQ YD | 3503 | 3503 | 4 | Wilders and a second | | |
| | | 0322256 TEMPORARY INFORMAT | FION SIGNING | SQFT | 100 | 100 | | | | |
| | | 0322925 ELECTRIC CABLE IN CO | | FOOT | 4297 | | 4297 | | | |
| | | | A CONTRACTOR OF THE SECOND SEC | EACH | 7201 | 4 | 7431 | | | |
| | | 0323868 DRAINAGE RESTRICTO | | | 7.4 | | | | | |
| | | 0545000 BOX CULVERT REMOVA | | FOOT | 71 | 71 | £ | And Control (Control | Co in spings | |
| | | 2800100 TEMPORARY DITCH CH | | EACH | 12 | 12 | } | | | |
| | | 1021000 TEMPORARY ACCESS (| | EACH | 14 | 14 | | - | | |
| | X4 | 1022000 TEMPORARY ACCESS (| COMMERCIAL ENTRANCE) | EACH | 15 | 15 | • | | | |
| | | 1023000 TEMPORARY ACCESS (| | EACH | 10 | 10 | *************************************** | ļ | | |
| | X | 1066616 BITUMINOUS CONCRET | E BINDER COURSE, SUPERPAVE, IL-19.0, N70 | TON | 5718 | 5718 | | | | |
| | Vocanization in an annual contract of the same | | | | | | n-areason in | | | |
| | X4 | 1066414 BITUMINOUS CONCRET | E SURFACE COURSE, SUPERPAVE, MIX "C", N50 | TON | 386 | 386 | | ļ | | |
| | Y. | 1066426 RITHMINIOUS CONCRET | E SURFACE COURSE, SUPERPAVE, MIX "D", N70 | TON | 3305 | 3305 | u constituire | V-000-00-00-00-00-00-00-00-00-00-00-00-0 | | |
| | | DITOWNNOUS CONCRET | 2 CONTROL COUNTY, SOI ENTRYE, MIN. D., 1910 | 1014 | 3000 | | | | | |
| | X | 1066770 LEVELING BINDER (MAC | CHINE METHOD), SUPERPAVE, N70 | TON | 1097 | 1097 | Sander had not returned the manufacture | | | |
| CONSULTANTS REV. NO. DATE DESCRIPTION | · · | TER Baxter & Woodman | CITY OF OAK FOREST, | וחמווון | S | The second related | | | DESIGNED BY | SCALE NONE |
| 1 4-28-06 PER IDOT AND COOK COUNTY COMMENTS | الأنتان ا | Crystat Lake, Illinois 815.459.1260 | | | | | | | DRAWN BY | PROJECT NO. |
| 2 5-8-06 PER IDOT COMMENTS | | Burlington, Wisconsin 262 763 763 4 Mokena, Illmois 708 478 2090 | OAK PARK AVENUE PR | n Bert | | | | MARY OF QUAN | LIKE | 020 |

| DESIGNED BY | SCALE |
|-------------|-------------|
| NJP | NONE |
| DRAWN BY | PROJECT NO. |
| UKB | 020146 |
| CHECKED BY | SHEET NO. |
| NJP | |
| DATE | 54 OF 116 |
| 1~20~05 | JA UL IIU |

SUMMARY OF QUANTITIES, CONTINUED

| F.A.U. ROUTE NO. | SECTION | COUNTY | TOTAL SHEETS | SHEET NO. |
|---------------------|----------------|----------|-----------------|--------------|
| 2774 | 99-00073-00-WR | COOK | 116 | 6 |
| STA. | TO ST | ۸. | • | |
| FED. ROAD | DIST. NO. 1 | ILLINOIS | FED AID | |

CONTRACT NO. 83727

Revised-

| SPCLTY | IDOT CODE | ITEM | UNIT | TOTAL QUANTITY | ROADWAY 1000-2A | SIGNAL Y031-1F | SIDEWALK SFTY-18 |
|---|-------------------|--|-------|-------------------|--|-------------------|--|
| ** | V0050015 | AFD (OF NOTALLATION DOLF MOUNT | EACH | | | | |
| ~~~~~~~~~~~~~~~~~~~~~~~~~~~~~~~~~~~~~~~ | | SERVICE INSTALLATION, POLE MOUNT | | 4 | | 4007 | the section of the se |
| ** | ~~~~ | FIBER OPTIC CABLE IN CONDUIT, NO. 62.5/125, MM 12F, SM 12F | FOOT | 4297 | 7-777 | 4297 | ······ |
| ** | Marine The second | ELECTRIC CABLE IN CONDUIT, GROUNDING, NO. 61C | FOOT | (1615) | | (1615) | ? |
| ** | X8730250 | ELECTRIC CABLE IN CONDUIT, NO. 20 3/C, TWISTED, SHIELDED | FOOT | 972 | | 972 | |
| ** | X8800020 | SIGNAL HEAD, L.E.D., 1-FACE, 3-SECTION, MAST ARM MOUNTED | EACH | 17 | | 17 | |
| ** | X8800035 | SIGNAL HEAD, L.E.D., 1-FACE, 3-SECTION, BRACKET MOUNTED | EACH | 6 | | 6 | |
| ** | X8800040 | SIGNAL HEAD, L.E.D., 1-FACE, 5-SECTION, BRACKET MOUNTED | EACH | 3 | | 3 | · |
| ** | X8800045 | SIGNAL HEAD, L.E.D., 1-FACE, 5-SECTION, MAST ARM MOUNTED | EACH | 4 | | 4 | |
| ** | X8800060 | SIGNAL HEAD, L.E.D., 2-FACE, 3 SECTION, BRACKET MOUNTED | EACH | 2 | | 2 | Managa and an and an angeles and an angeles and an angeles and an angeles and an an angeles and an an an angel |
| ** | X8805280 | SIGNAL HEAD, L.E.D., 2-FACE, 1-3 SECTION, 1-5 SECTION, BRACKET MOUNTED | EACH | 1 | | 1 | |
| ** | X8810610 | PEDESTRIAN SIGNAL HEAD, L.E.D., 1-FACE, BRACKET MOUNTED | EACH | 4 | | 4 | |
| ** | X8810620 | PEDESTRIAN SIGNAL HEAD, L.E.D., 2-FACE, BRACKET MOUNTED | EACH | 3 | recommended and an analysis of the second and the s | 3 | |
| | Z0001050 | AGGREGATE SUBGRADE 12" | SQ YD | 14767 | 14767 | | |
| | Z0019600 | DUST CONTROL WATERING | UNIT | 50 | 50 | | |
| | Z0064800 | SELECTIVE CLEARING | UNIT | 65 | 65 | | |
| Δ | Z0076600 | TRAINEES | HOUR | 1500 | 1500 | | |
| | Z0013798 | CONSTRUCTION LAYOUT | LSUM | 1 | 1 | | |
| - | Z0022800 | FENCE REMOVAL | FOOT | 360 | 360 | | |
| | XX006571 | REMOVE AND REPLACE BOLLARDS | EACH | 3 | 3 | | |
| ** | xx006572 | STEEL MAST ARM ASSEMBLY AND POLE WITH DUAL MAST ARMS, 38 FT. AND 26 FT. | EACH | 1 | | 1 | |
| | XX006573 | CATCH BASINS, TYPE A, 6' DIAMETER, TYPE 8 GRATE | EACH | 1 | 1 | | |
| | xx006574 | CATCH BASINS, TYPE A, 6' DIAMETER, TYPE 24 FRAME AND GRATE | EACH | 2 | 2 | | |
| | 70102625 | TRAFFIC CONTROL AND PROTECTION, STANDARD, 701606 | 1 sam | 5 1 |) [1 | } | |

Added 6

A 4080

5-08-06 @ 746pm by: 334npp @2004, By Boxter & Woodman, Inc. Illinois -- Professional Design Firm o. - 184-001121 -- Expines 4-30-05


| CONSULTANTS | | | | | | REV. N | 10. | DATE | DESCRIPTION | |
|-------------|---------|--------------|--------|----------|------|----------|-----|------|-------------|-----------------------------------|
| | - | | | | | | 1 | | 4-28-06 | PER IDOT AND COOK COUNTY COMMENTS |
| | | | | | | | 2 | | 5-8-06 | PER IDOT COMMENTS |
| * | - REFER | TO EQUIPMENT | MANUFA | CTURER'S | SHOP | DRAWINGS | | | | |
| 1 | .5" | 0 | 1" | 2" | | 3" | | | | |
| 1 | | | | | | | | | 4~~~ | |



Baxter & Woodmar Crystal Lake, Rimots Burlington, Wisconsin Robera, Rimots DeKalb, Illinois Gruyslake, Illinois Rockford, Rimots 815-889-185 CITY OF OAK FOREST, ILLINOIS OAK PARK AVENUE PROJECT


SUMMARY OF QUANTITIES

| DESIGNED BY | SCALE | |
|-------------|-------------|----------|
| NJP | NON | <u> </u> |
| DRAWN BY | PROJECT NO. | |
| UKB | 020 | 146 |
| CHECKED BY | SHEET NO. | |
| NJP | | |
| DATE | 6 OF | 116 |
| 1~2005 | UUF | 110 |

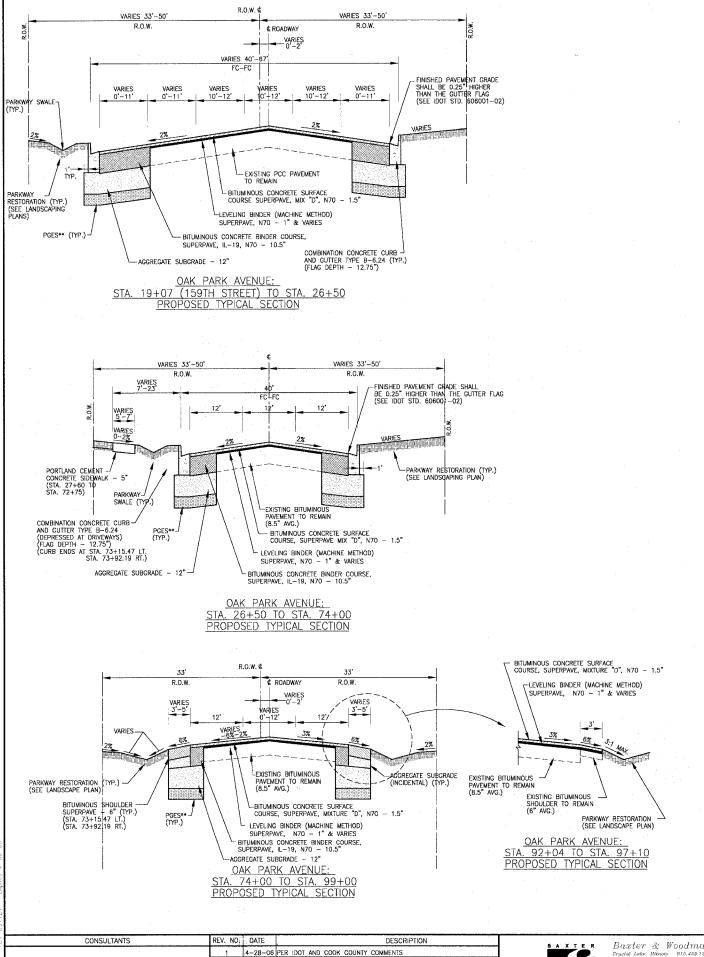


2 5-8-06 PER IDOT COMMENTS

3 5-19-06 PER IDOT COMMENTS

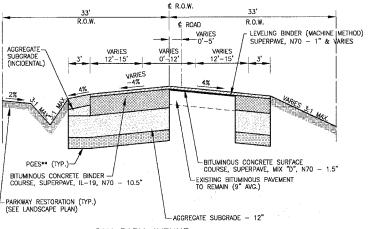

OAK PARK AVENUE: STA. 99+00 TO STA. 100+72 PROPOSED TYPICAL SECTION

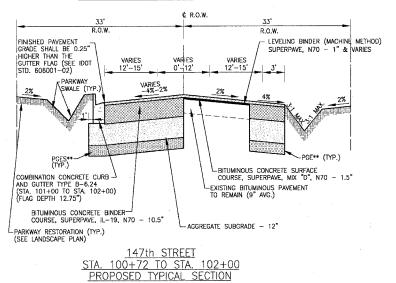

NOTES

STRIP REFLECTIVE CRACK CONTROL TREATMENT SHALL BE PLACED OVER ALL JOINTS WHERE THE EXISTING EDGE OF PAVEMENT ABUTS NEW PAVEMENT WIDENING FRIOR TO THE FINAL RESURFACIO, IN ACCORDANCE WITH SECTION 443 OF THE STANDARD SPECIFICATIONS.

SECTION

116

CMM-7003 (750)

COOK

2774 99-00073-00-WR

FED. ROAD DIST, NO. 1

CONTRACT NO. 83727

- 2. PORTLAND CEMENT CONCRETE BASE COURSE WIDENING SHALL BE USED WHERE WIDENING WOTH FROM EXISTING TO PROPOSED EDGE OF PAVEMENT IS 4 FEET OR LESS, AND NOT PARALLEL AND DIRECTLY OVER PROPOSED MAINLINE STORM SEWER. SEE DETAIL THIS SHEET.
- 3. STATION 100+72, C/L OF OAK PARK AVENUE (BK) = STATION 100+72 C/L OF 147TH STREET (AH)


PARKWAY RESTORATION

PARKWAY RESTORATION SHALL BE PAID AS THE FOLLOWING ITEMS IN AREAS ADJACENT TO RESIDENTIAL OR COMMERICAL PROPERTIES, AND WHERE DIRECTED BY THE ENGINEER:

> TOPSOIL FURNISH AND PLACE, 4" SODDING, SALT TOLERANT NITROGEN, PHOSPHOROUS, AND POTASSIUM NUTRIENTS SUPPLEMENTAL WATERING

PARKWAY RESTORATION SHALL BE PAID AS THE FOLLOWING ITEMS IN AREAS ADJACENT TO FOREST PRESERVE, UNDEVELOPED PROPERTY, AND WHERE DIRECTED BY THE ENGINEER:

> TOPSOIL FURNISH AND PLACE, 4" SEEDING, CLASS 2A NITROGEN, PHOSPHOROUS, AND POTASSIUM NUTRIENTS EROSION CONTROL BLANKET SUPPLEMENTAL WATERING

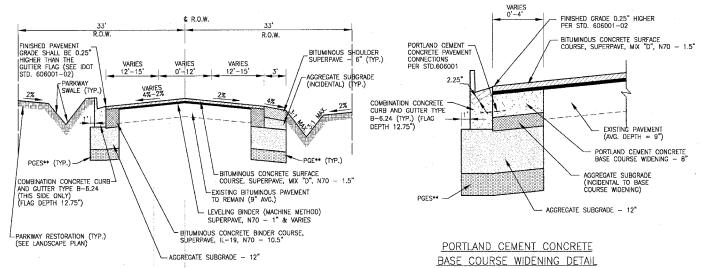

147th STREET STA. 102+00 TO STA. 104+20 PROPOSED TYPICAL SECTION

> POROUS GRANULAR EMBANKMENT SUBGRADE (PGES) QUANTITY HAS BEEN INCLUDED IN CONTRACT FOR USE AT THE LOCATIONS INDICATED FOR SOILS THAT TEND TO BE UNSUITABLE OR UNSTABLE. THE ACTUAL NEED FOR REMOVAL AND REPLACEMENT WITH POE WILL BE DETERMINED IN THE FIELD AT THE TIME OF CONSTRUCTION BY THE GEOTECHNICAL ENGINEER. ALL POTENTIALLY UNSTABLE SOILS SHOULD BE TESTED WITH A STATIC CONF PENETROWETER AND TREATED IN ACCORDANCE WITH ARTICLE 301.03 AND THE UNDERCUT GUIDELINES IN THE IDOT SUBGRADE STABILITY MANUAL. IF UNSTABLE AND/OR UNSUITABLE MATERIAL IS ENCOUNTERED, THE SOIL SHALL BE REMOVED AND REPLACED WITH POE OR EMBANKMENT AS DETERMINED BY THE GEOTECHNICAL ENGINEER. IF UNSTABLE AND/OR UNSUITABLE MATERIAL IS NOT ENCOUNTERED, THEN THE QUANTITY SHALL BE DEDUCTED AND NO ADDITIONAL COMPENSATION WILL BE DUE TO THE CONTRACTOR.


CITY OF OAK FOREST, ILLINOIS **OAK PARK AVENUE PROJECT**


OAK PARK AVENUE/147th STREET PROPOSED TYPICAL SECTIONS


| DESIGNED BY | SCALE |
|-------------|-------------|
| NJP | NONE |
| DRAWN BY | PROJECT NO. |
| UKB | 020146 |
| CHECKED BY | SHEET NO. |
| NJP | |
| DATE. | 13 OF 116 |
| 1-20-05 | 13 OF 110 |


Baxter & Woodman


- REFER TO EQUIPMENT MANUFACTURER'S SHOP DRAWING

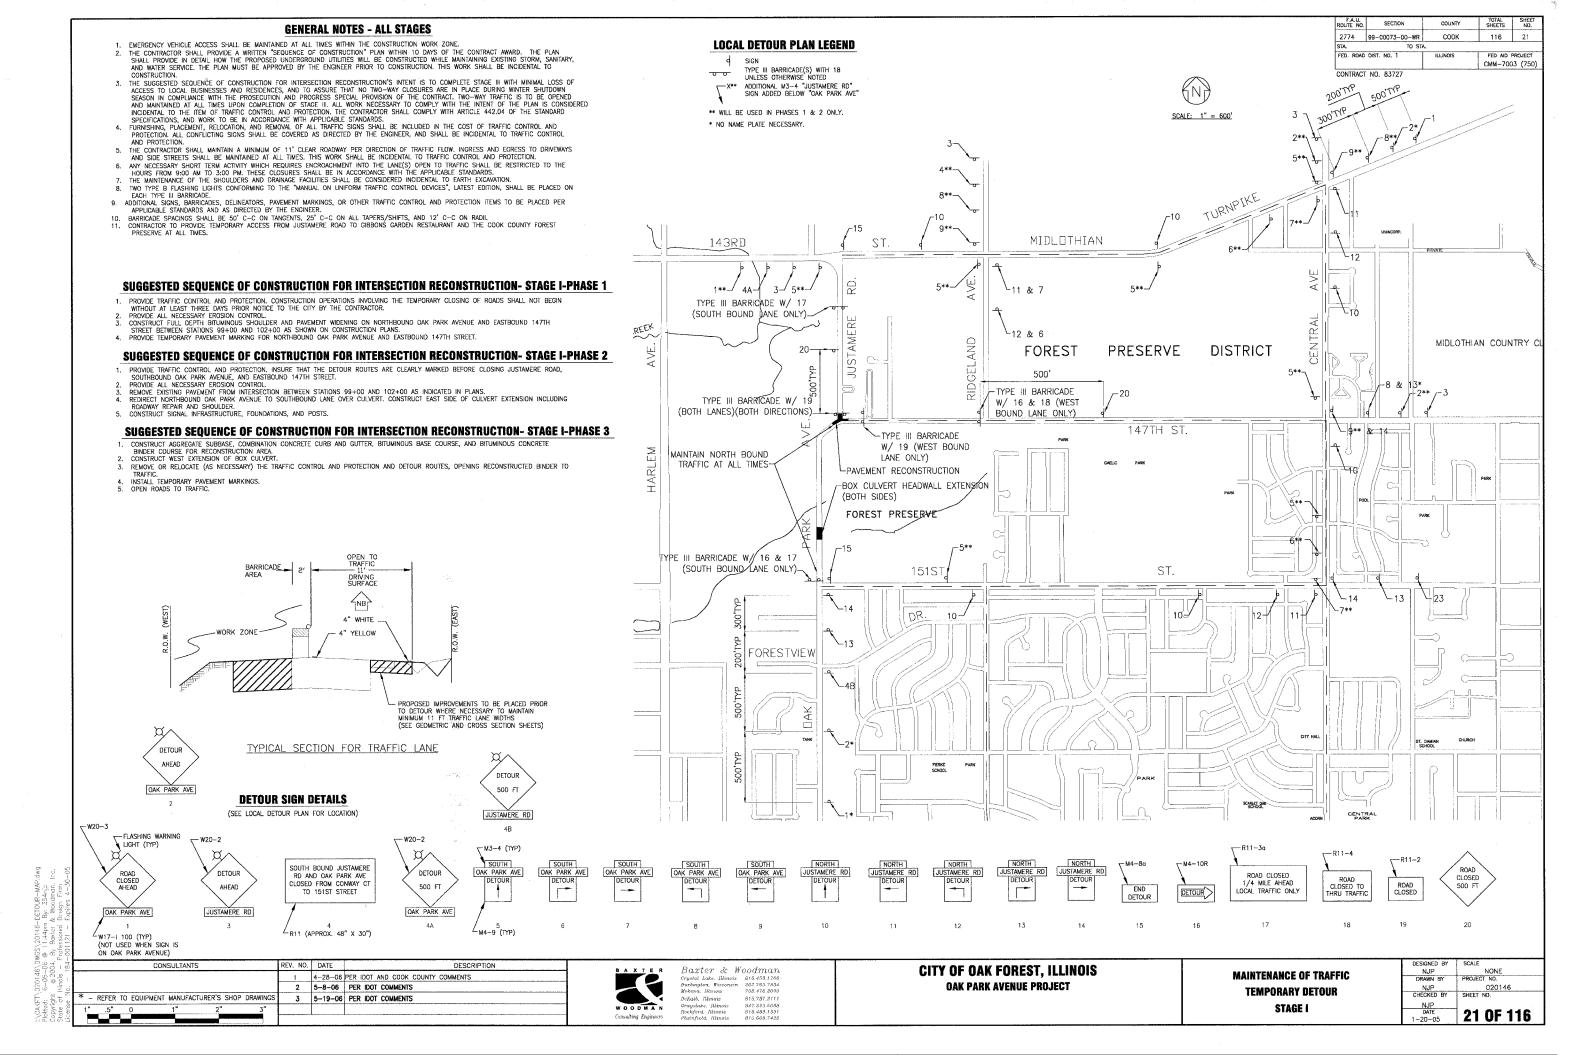

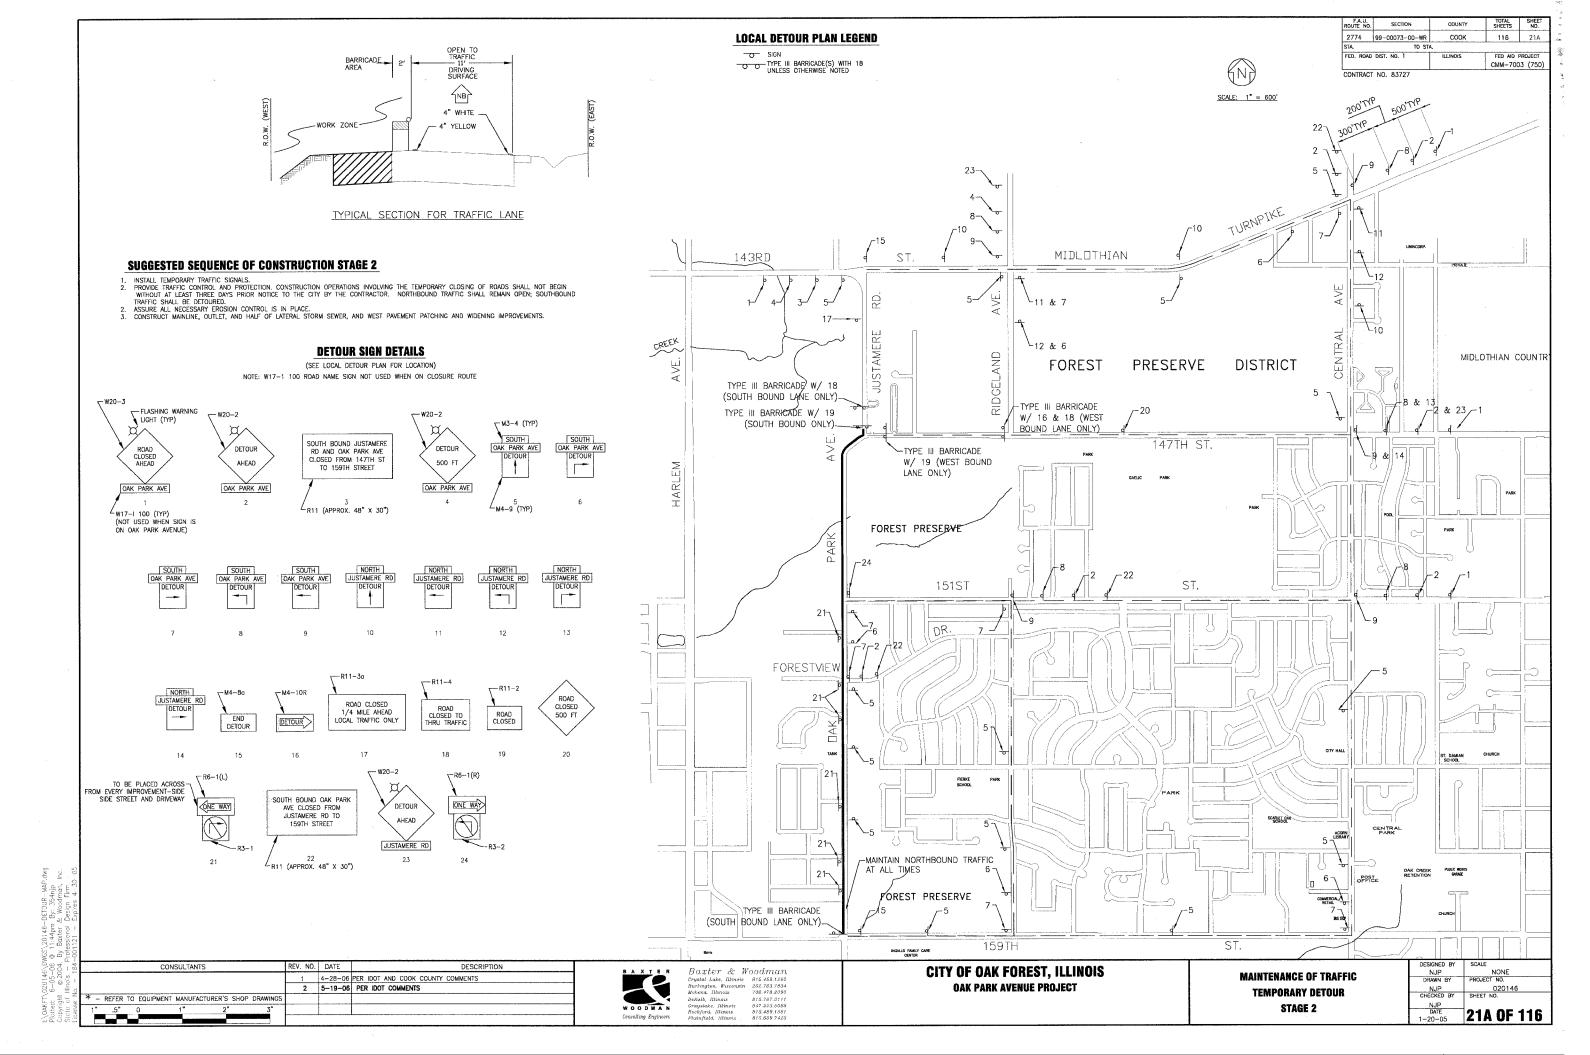

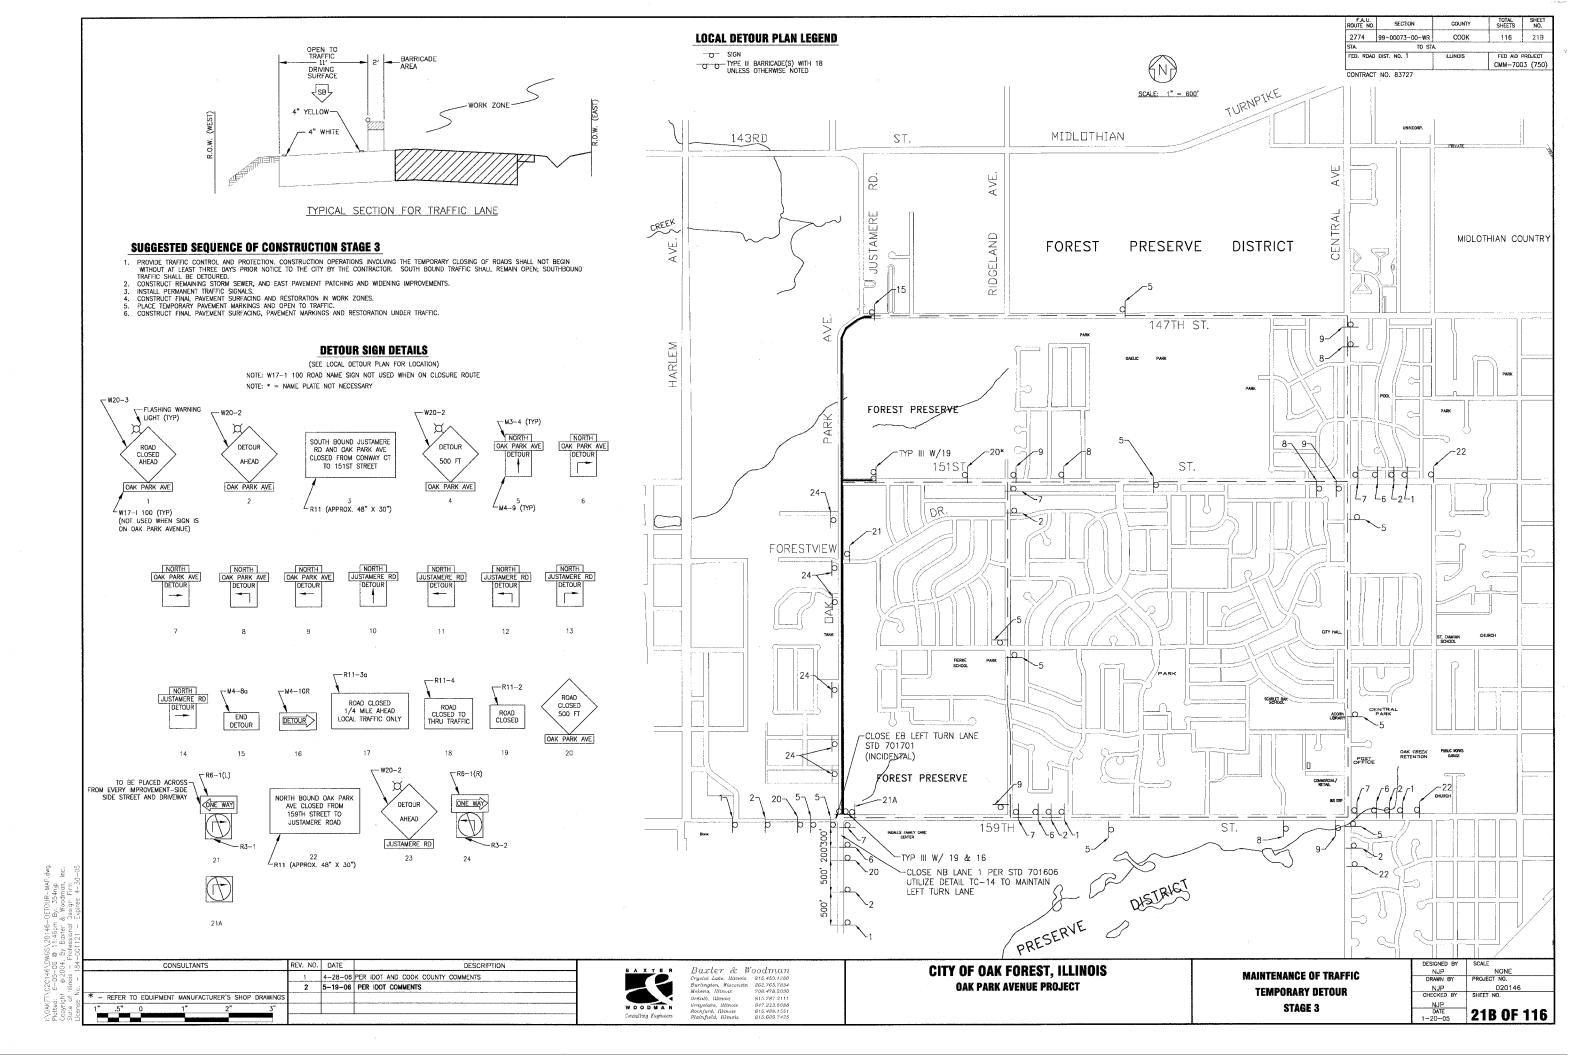

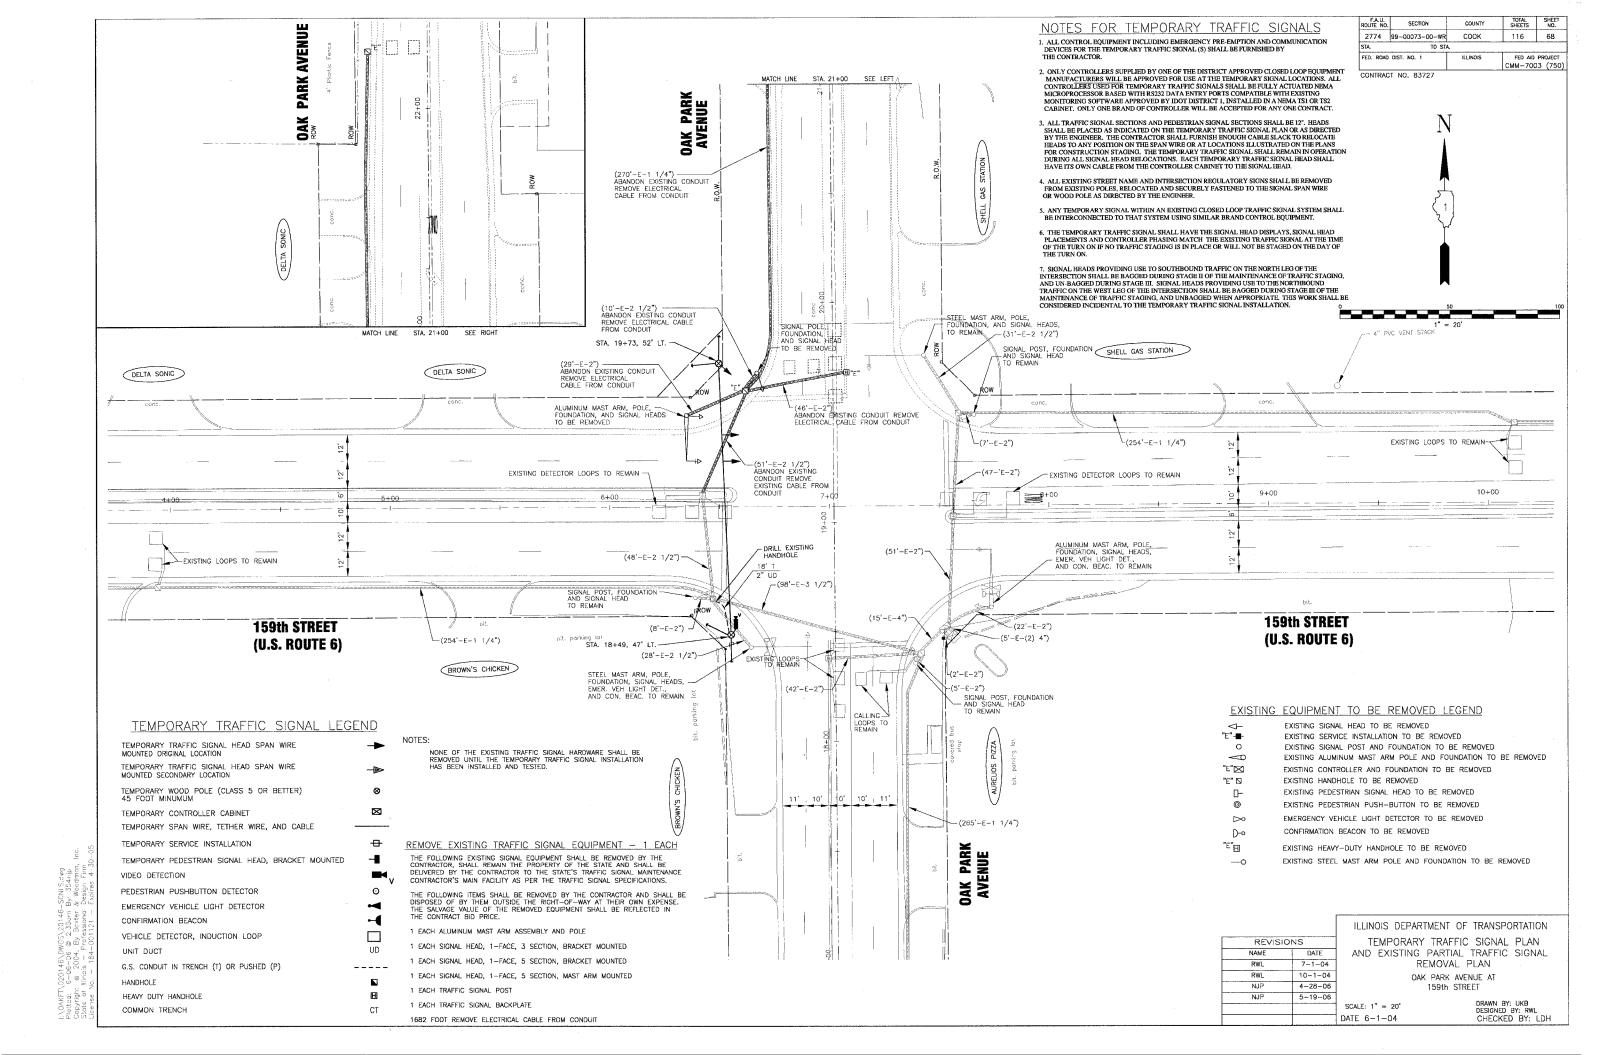

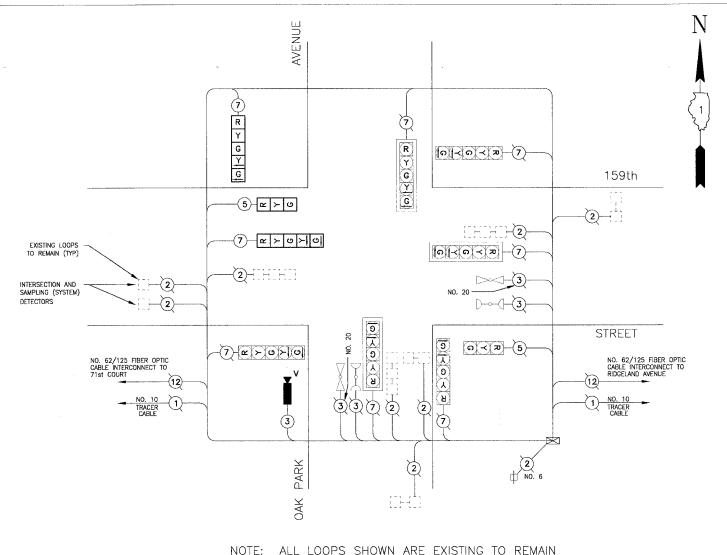

TEMPORARY CABLE DIAGRAM

TEMPORARY CABLE DIAGRAM LEGEND

R TEMPORARY TRAFFIC SIGNAL SECTION OR PEDESTRIAN SIGNAL SECTION 12"

(5) INDICATES NUMBER OF CONDUCTORS IN CABLE. ALL CONDUCTORS TO BE NUMBER 14 AWG WIRE UNLESS OTHER— WISE NOTED.

EMERGENCY VEHICLE
LIGHT DETECTOR

CONFIRMATION BEACON


VEHICLE DETECTOR INDUCTION LOOP

PEDESTRIAN PUSHBUTTON DETECTOR

12" PEDESTRIAN SIGNAL SECTION

VIDEO DETECTION

CONTRACT NO. 83727

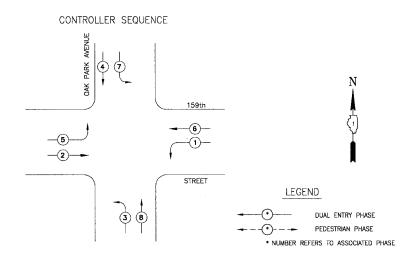


TEMPORARY PHASE DESIGNATION DIAGRAM

NOTE: STAGING PER SUGGESTED MAINTENANCE OF TRAFFIC SHALL BE AS FOLLOWS:

STAGE I: NO CHANGE

STAGE II: MOVEMENT 4 AND 7 WILL NOT EXIST, BAG HEADS STAGE III: MOVEMENT 8 AND 5 WILL NOT EXIST, BAG HEADS

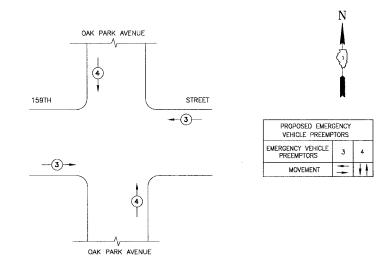

TEMPORARY EMERGENCY VEHICLE PREEMPTION SEQUENCE

| TRAFFIC SIGNAL INSTALLATION ELECTRICAL SERVICE REQUIREMENTS | | | | |
|---|----|------------------|------------|------------------|
| TYPE | | INCAND. WATTAGE | %OPERATION | TOTAL WATTAGE |
| SIGNAL (RED) | 10 | 135 | 0.50 | 675 |
| (YELLOW) | 10 | 135 | 0.25 | 337.5 |
| (GREEN) | 10 | 135 | 0.25 | 337.5 |
| ARROW | 16 | 135 | 0.10 | 216 |
| PED. SIGNAL | _ | 90 | 1.00 | |
| CONTROLLER | 1 | 100 | 1.00 | 100 |
| ILLUM. SIGN | | 40 | 0.50 | |
| STREET LIGHTS | _ | 250 | 0.50 | _ |
| FLASHER | | , | 0.50 | |
| | | | TOTAL == | 1566 |

ENERGY COSTS BILLED TO: IDOT/DIMISION OF HIGHWAY DISTRICT 1

(ADDRESS) 201 WEST CENTER COURT SCHAUMBURG, IL 60196–1096

ENERGY SUPPLY CONTACT: JULIE SNOW
PHONE: 1-866-639-3532
COMPANY: COMMONWEALTH EDISION

REVISIONS

NAME DATE

RWL 7-1-04

RWL 10-1-04

NJP 4-28-06

NJP 5-19-06


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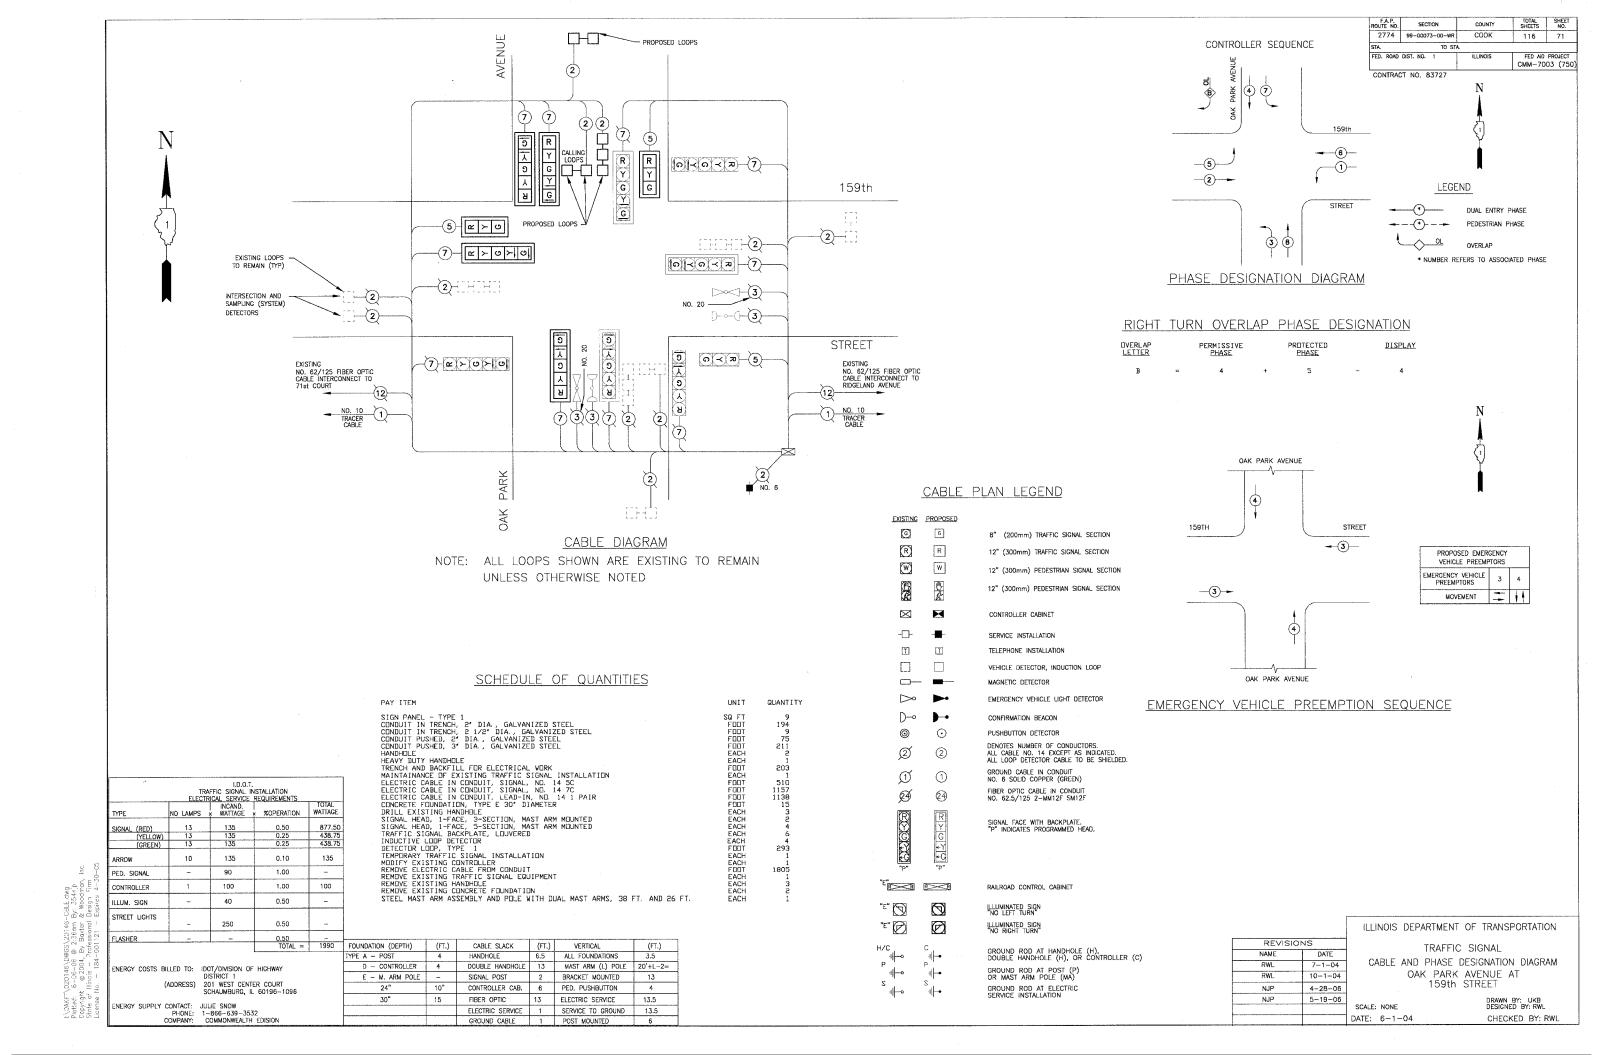
ILLINOIS DEPARTMENT OF TRANSPORTATION


TEMPORARY TRAFFIC SIGNAL
CABLE AND PHASE DESIGNATION DIAGRAM
OAK PARK AVENUE AT
159th STREET


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DATE: 6-1-04


DRAWN BY: UKB DESIGNED BY: RWL CHECKED BY: RWL



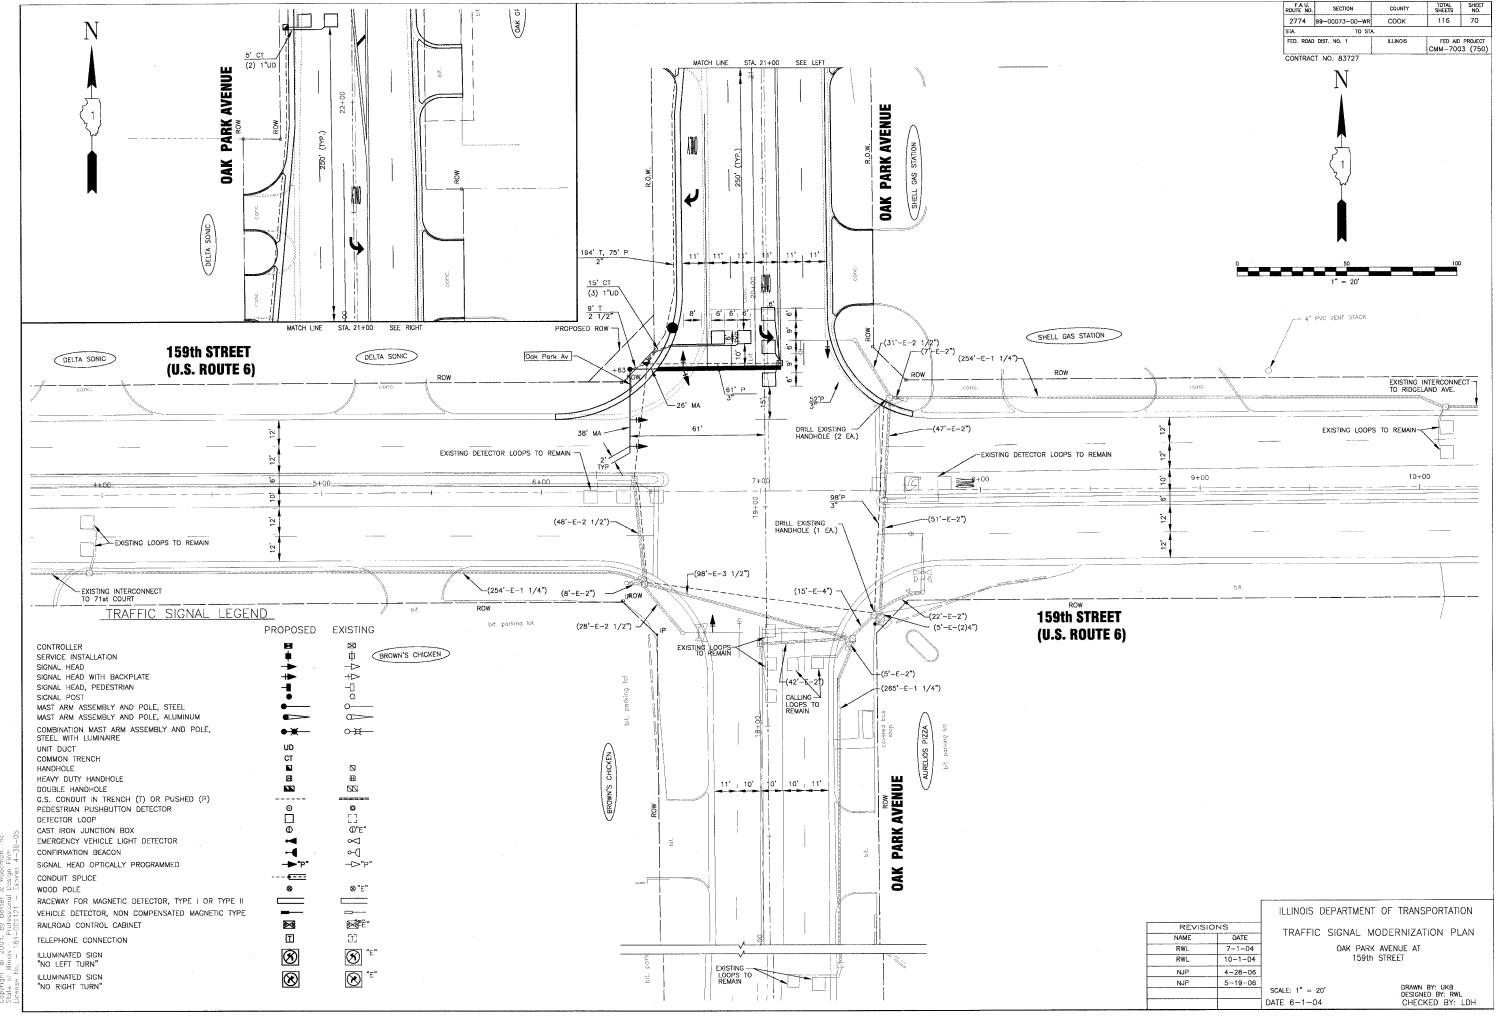


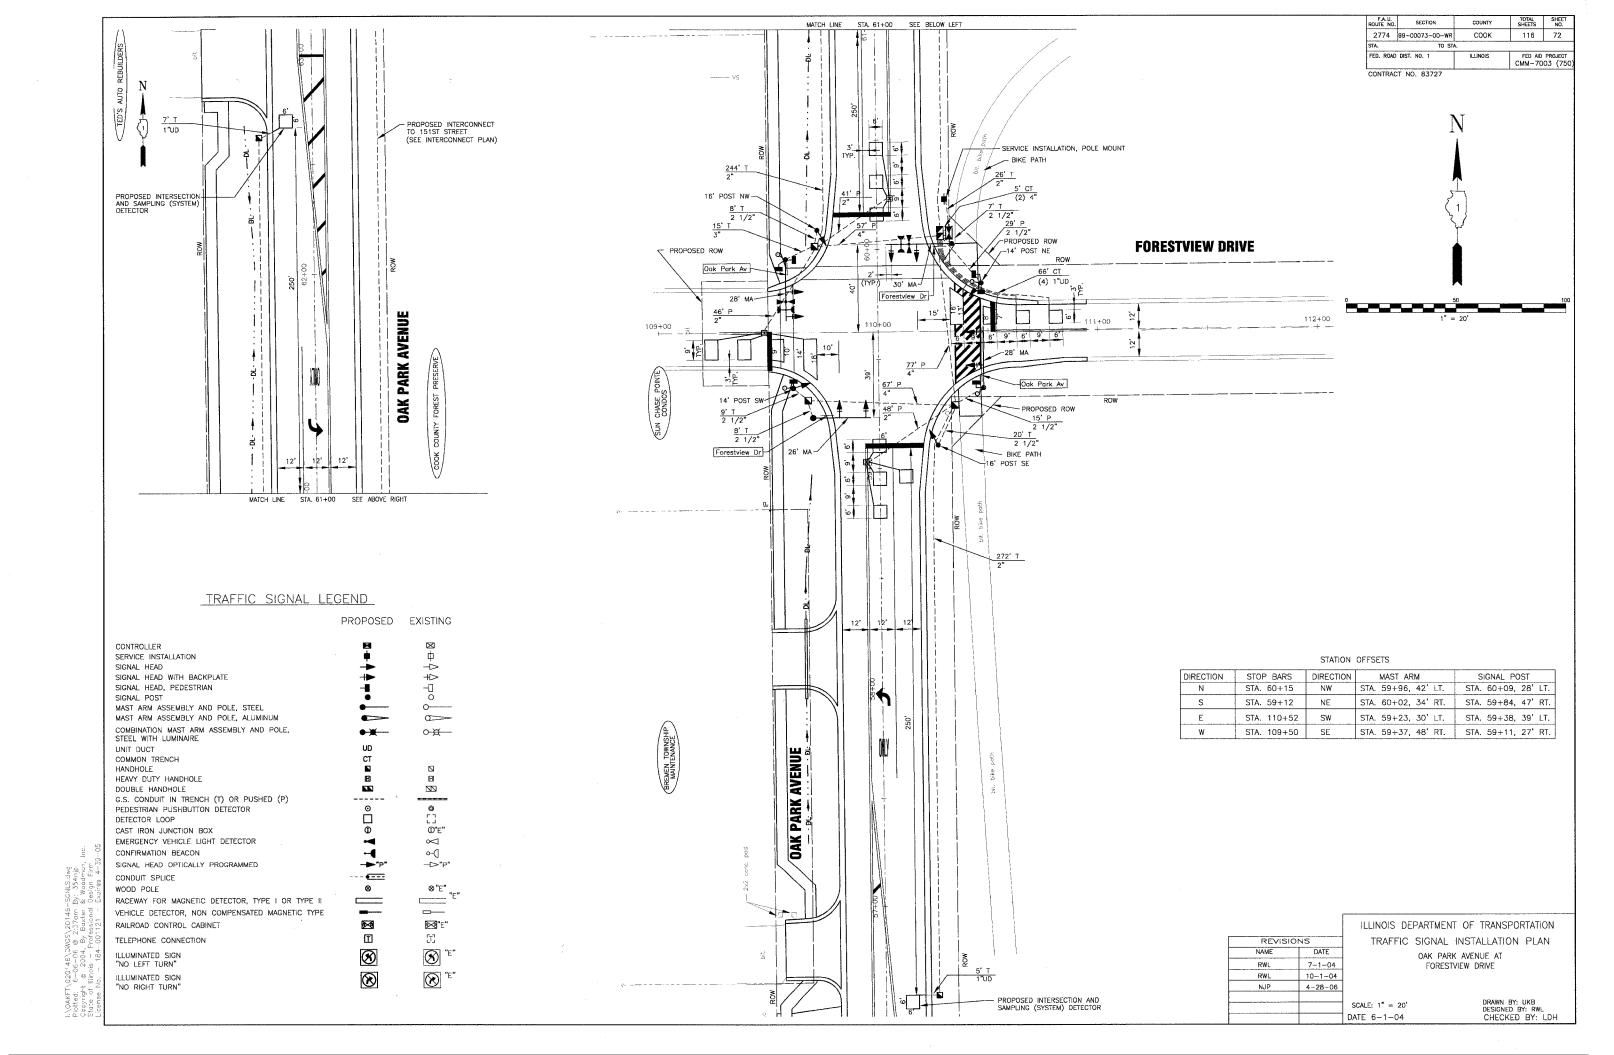

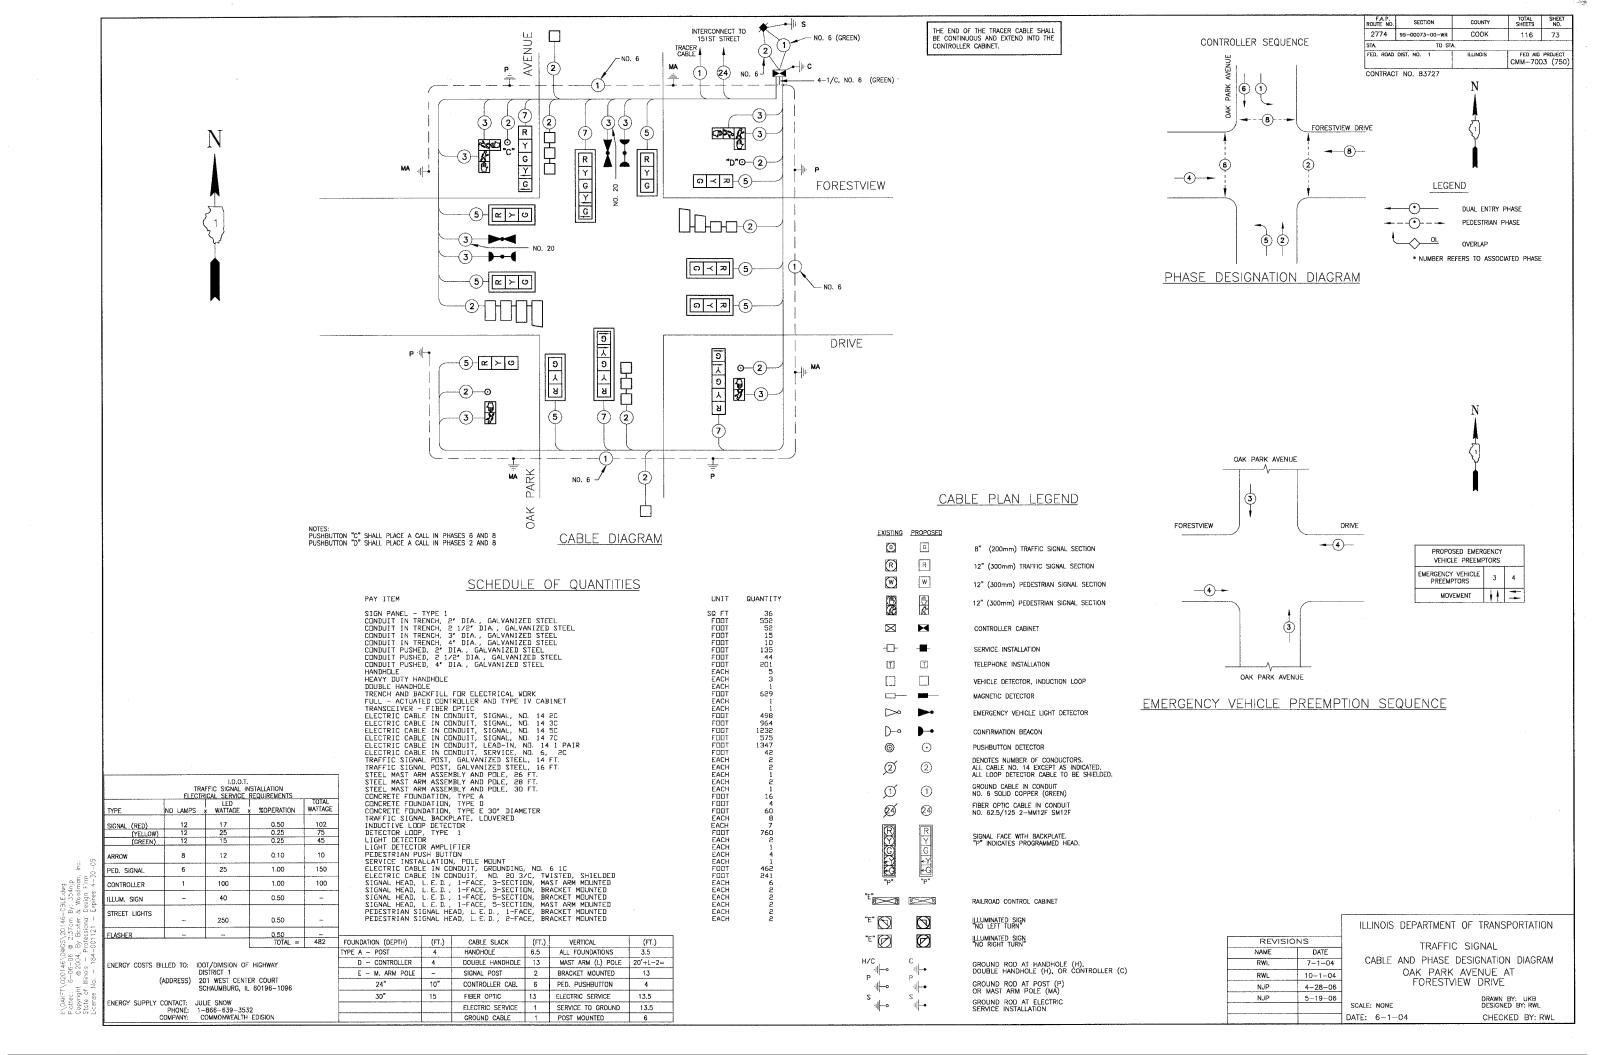

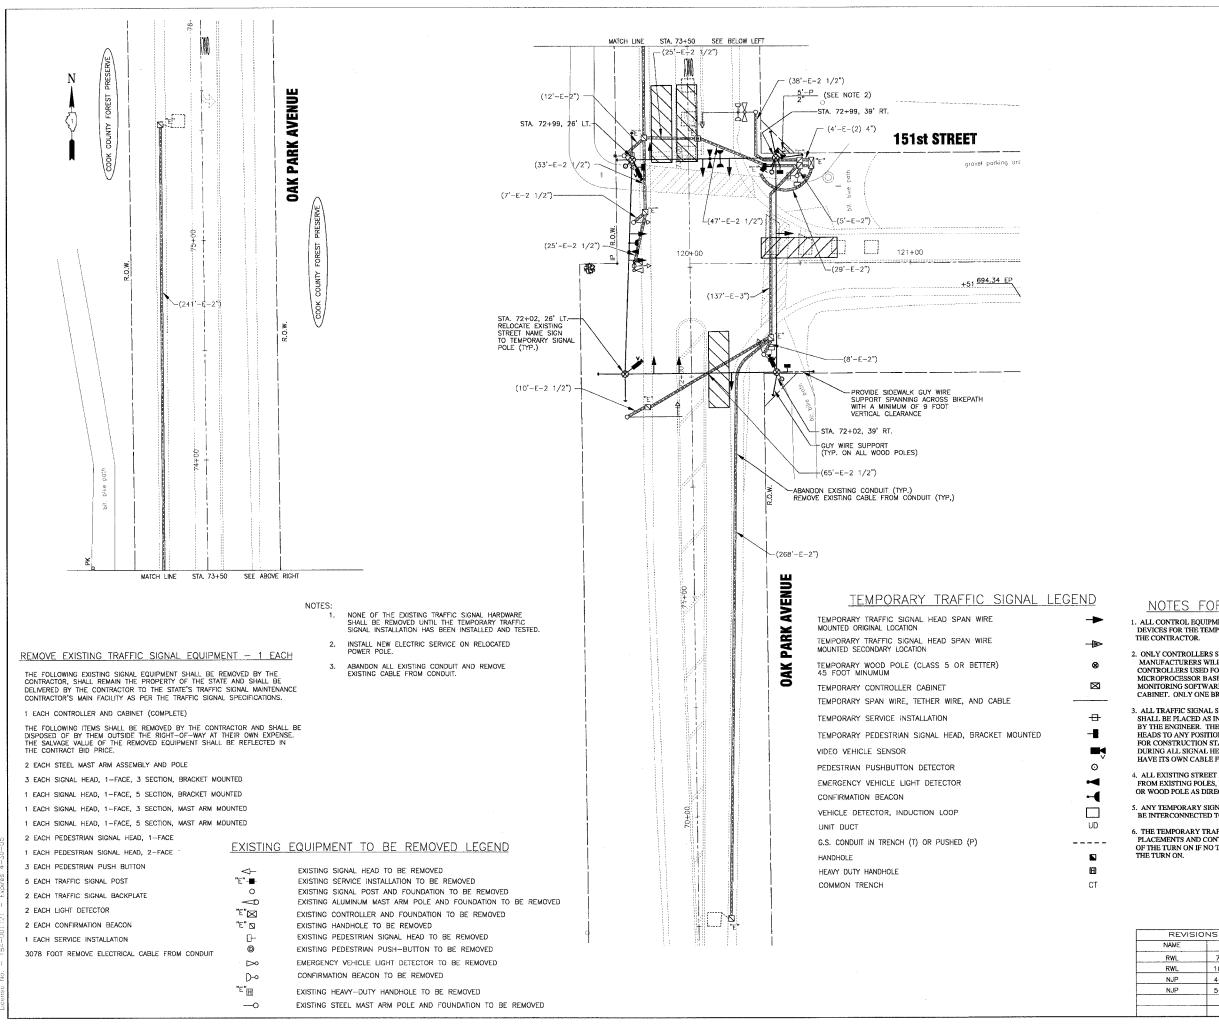

CONTRACT NO. 83727

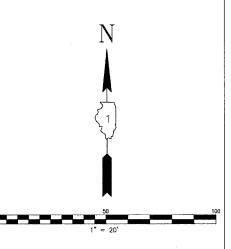

NOTES FOR TEMPORARY TRAFFIC SIGNALS

- 1. ALL CONTROL EQUIPMENT INCLUDING EMERGENCY PRE-EMPTION AND COMMUNICATION DEVICES FOR THE TEMPORARY TRAFFIC SIGNAL (S) SHALL BE FURNISHED BY THE CONTRACTOR.
- 2. ONLY CONTROLLERS SUPPLIED BY ONE OF THE DISTRICT APPROVED CLOSED LOOP EQUIPMENT MANUFACTURERS WILL BE APPROVED FOR USE AT THE TEMPORARY SIGNAL LOCATIONS. ALL CONTROLLERS USED FOR TEMPORARY TRAFFIC SIGNALS SHALL BE FULLY ACTUATED NEMA MICROPROCESSOR BASED WITH RS232 DATA ENTRY PORTS COMPATIBLE WITH EXISTING MONITORING SOFTWARE APPROVED BY IDOT DISTRICT 1, INSTALLED IN A NEMA TSI OR TS2 CABINET. ONLY ONE BRAND OF CONTROLLER WILL BE ACCEPTED FOR ANY ONE CONTRACT.
- 3. ALL TRAFFIC SIGNAL SECTIONS AND PEDESTRIAN SIGNAL SECTIONS SHALL BE 12". HEADS SHALL BE PLACED AS INDICATED ON THE TEMPORARY TRAFFIC SIGNAL PLAN OR AS DIRECTED BY THE ENGINEER. THE CONTRACTOR SHALL FURNISH ENOUGH CABLE SLACK TO RELOCATE HEADS TO ANY POSITION ON THE SPAN WIRE OR AT LOCATIONS ILLUSTRATED ON THE FLANS FOR CONSTRUCTION STAGING. THE TEMPORARY TRAFFIC SIGNAL SHALL REMAIN IN OPERATION DURING ALL SIGNAL HEAD RELOCATIONS. EACH TEMPORARY TRAFFIC SIGNAL HEAD SHALL HAVE ITS OWN CABLE FROM THE CONTROLLER CABINET TO THE SIGNAL HEAD.
- 4. ALL EXISTING STREET NAME AND INTERSECTION REGULATORY SIGNS SHALL BE REMOVED FROM EXISTING POLES, RELOCATED AND SECURELY FASTENED TO THE SIGNAL SPAN WIRE OR WOOD PIOLE AS DIRECTED BY THE ENGINEER.
- 5. ANY TEMPORARY SIGNAL WITHIN AN EXISTING CLOSED LOOP TRAFFIC SIGNAL SYSTEM SHALL BE INTERCONNECTED TO THAT SYSTEM USING SIMILAR BRAND CONTROL EQUIPMENT.
- 6. THE TEMPORARY TRAFFIC SIGNAL SHALL HAVE THE SIGNAL HEAD DISPLAYS, SIGNAL HEAD PLACEMENTS AND CONTROLLER PHASING MATCH THE EXISTING TRAFFIC SIGNAL AT THE TIME OTHE TURN ON IF NO TRAFFIC STAGING IS IN PLACE OR WILL NOT BE STAGED ON THE DAY OF THE TURN ON.

ILLINOIS DEPARTMENT OF TRANSPORTATION

TEMPORARY TRAFFIC SIGNAL PLAN AND EXISTING TRAFFIC SIGNAL REMOVAL PLAN OAK PARK VENUE AT

SCALE: 1'' = 20'DATE 6-1-04

DATE

7--1--04


10-1-04

4-28-06


5-19-06

DRAWN BY: UKB DESIGNED BY: RWL CHECKED BY: LDH


I:\OAK!T\Q20146\DWGS\20146-SGNLS.cw Plotted: 6-06-06 @ 2:37cm By: 354pi Copyright @ 2004. By Baxier & Woodm State of Hinois - Professional Desan Fl

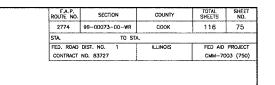

CONTROLLER SEQUENCE

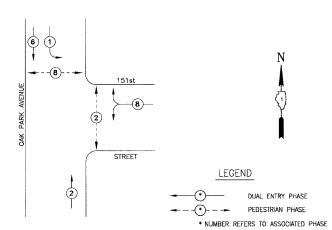

TEMPORARY PHASE DESIGNATION DIAGRAM

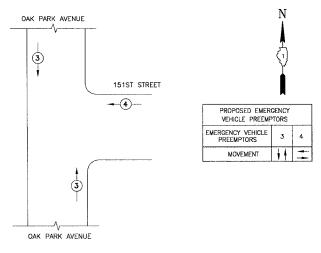

TEMPORARY EMERGENCY VEHICLE PREEMPTION SEQUENCE

| N | AVENUE AVENUE | D R R R G S G S G S G S G S G S G S G S G | 151st |
|---|---------------|---|--|
| | 5 | ğ <u> </u> | |
| | 3 | 9 | STREET |
| | OAR PARK | | TEMPORARY CABLE DIAGRAM LEGEND R TEMPORARY TRAFFIC SIGNAL SECTION OR PEDESTRIAN SIGNAL SECTION 12" TEMPORARY CONTROLLER CABINET TEMPORARY SERVICE INSTALLATION INDICATES NUMBER OF CONDUCTORS IN CABLE. ALL CONDUCTORS TO BE |

TEMPORARY CABLE DIAGRAM

PUSHBUTTON "D" SHALL PLACE A CALL IN PHASES 2 AND 8

INDICATES NUMBER OF CONDUCTORS IN CABLE. ALL CONDUCTORS TO BE NUMBER 14 AWG WIRE UNLESS OTHERWISE NOTED.

EMERGENCY VEHICLE

CONFIRMATION BEACON

VEHICLE DETECTOR, INDUCTION LOOP

PEDESTRIAN PUSHBUTTON DETECTOR 12" PEDESTRIAN SIGNAL SECTION

VIDEO VEHICLE SENSOR

| 1.0.0.1. | | | | |
|---------------------------------------|----------|--------------------|------------|---------|
| TRAFFIC SIGNAL INSTALLATION | | | | |
| ELECTRICAL SERVICE REQUIREMENTS TOTAL | | | | |
| TYPE | NO LAMPS | LED × WATTAGE : | %OPERATION | WATTAGE |
| SIGNAL (RED) | 9 | 17 | 0.50 | 77 |
| (YELLOW) | 9 | 25 | 0.25 | 56 |
| (GREEN) | 9 | 15 | 0.25 | 34 |
| ARROW | 4 | 12 | 0.10 | 5 |
| PED. SIGNAL | 4 | 25 | 1.00 | 100 |
| CONTROLLER | 1 | 100 | 1,00 | 100 |
| ILLUM. SIGN | - | 40 | 0.50 | - |
| STREET LIGHTS | - | 250 | 0.50 | |
| FLASHER | | | 0.50 | |
| | _ | | TOTAL = | 372 |

ENERGY COSTS BILLED TO: IDOT/DIVISION OF HIGHWAY DISTRICT 1

(ADDRESS) 201 WEST CENTER COURT SCHAUMBURG, IL 60196-0196

ENERGY SUPPLY CONTACT: JULIE SNOW
PHONE: 1-866-639-3532
COMPANY: COMMONWEALTH EDISION

REVISIONS RWL 7-1-04 10-1-04 NJP 5-19-06

ILLINOIS DEPARTMENT OF TRANSPORTATION TEMPORARY TRAFFIC SIGNAL

CABLE AND PHASE DESIGNATION DIAGRAM
OAK PARK AVENUE AT
151st STREET

DATE: 6-1-04

CHECKED BY: RWL

