


06-15-2018 LETTING ITEM 003

FOR INDEX OF SHEETS, SEE SHEET NO. 2

IMPROVEMENT IS LOCATED IN THE CITY OF DES PLAINES

DESIGN DESIGNATION: MINOR ARTERIAL (URBAN)  
2014 ADT = 13,000  
POSTED SPEED = 35 MPH

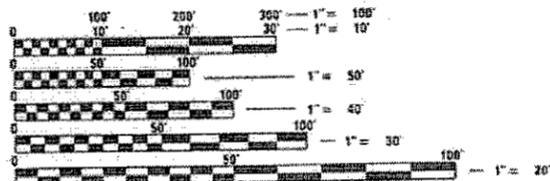

FULL SIZE PLANS HAVE BEEN PREPARED USING STANDARD ENGINEERING SCALES. REDUCED SIZED PLANS WILL NOT CONFORM TO STANDARD SCALES. IN MAKING MEASUREMENTS ON REDUCED PLANS, THE ABOVE SCALES MAY BE USED.

J.U.L.I.E.  
JOINT UTILITY LOCATION INFORMATION FOR EXCAVATION  
1-800-892-0123  
OR 811


PROJECT ENGINEER: MS. RAGHAD ADEIS-DAHMAN, PE, SE (847) 705-4237  
PROJECT MANAGER: MR. FAWAD AQUEEL, PE, PTOE (847) 705-4247

CONTRACT NO. 60W53

STATE OF ILLINOIS  
DEPARTMENT OF TRANSPORTATION

PROPOSED  
HIGHWAY PLANS

FAU ROUTE 2691: WOLF ROAD  
AT WELLER'S DITCH  
SECTION 3434.1-BR(13)  
BRIDGE DECK OVERLAY  
PROJECT NUMBER: STP-HHTX(784)  
COOK COUNTY

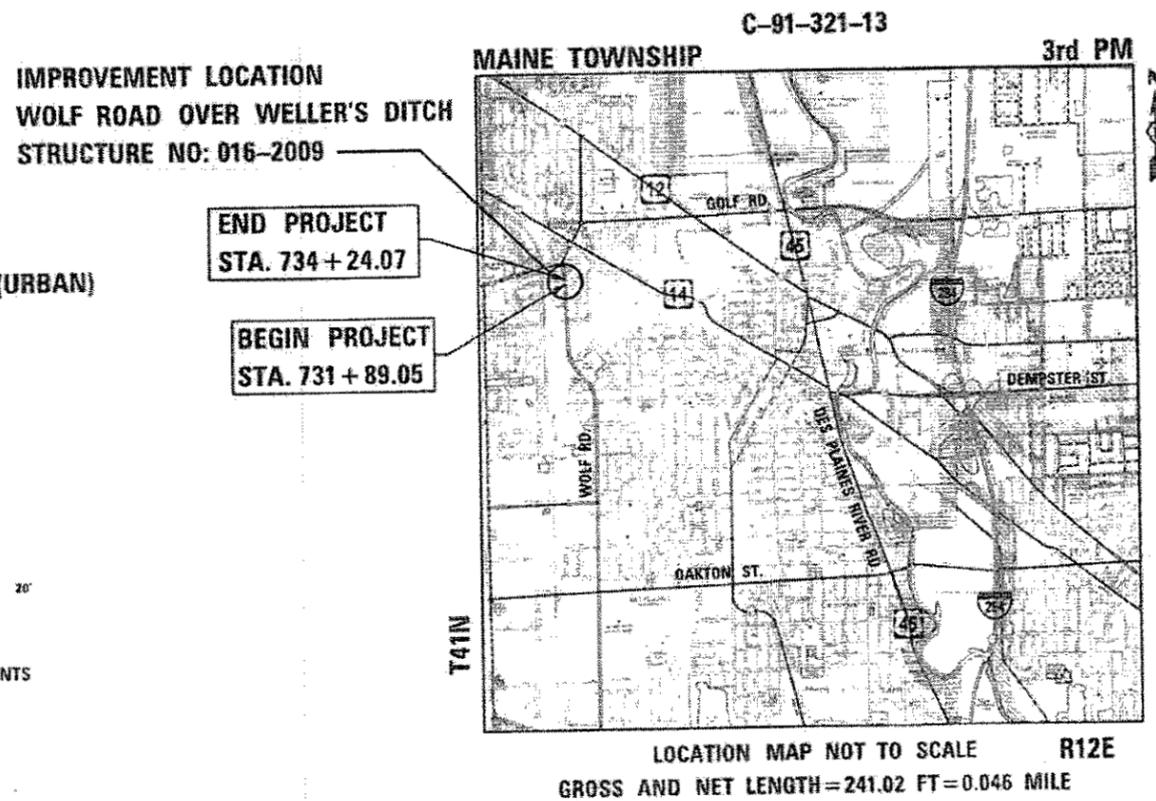

LOCATION MAP NOT TO SCALE R12E  
GROSS AND NET LENGTH = 241.02 FT = 0.046 MILE

\* 58 + 1 = 59 TOTAL SHEETS

F.A.U. RTE.	SECTION	COUNTY	TOTAL SHEETS	SHEET NO.
2691	3434.1-BR(13)	COOK	58	1
ILLINOIS			CONTRACT NO. 60W53	

D-91-321-13



DATE SIGNED: 3/13/2018  
EXP. DATE: 11/30/2019



DATE SIGNED: 03/08/2018  
EXP. DATE: 11/30/2018

STATE OF ILLINOIS  
DEPARTMENT OF TRANSPORTATION  
SUBMITTED March 22, 2018  
Regional Engineer  
Engineer of Design and Environment  
Director of Highways Project Implementation

PRINTED BY THE AUTHORITY  
OF THE STATE OF ILLINOIS



Accurate  
GROUP, INC.

WWW.ACCGI.COM  
101 SCHELTER RD., SUITE 8-200  
LINCOLNSHIRE, ILLINOIS 60069  
T (847) 613-1100 F (847) 613-1110  
ILLINOIS PROFESSIONAL DESIGN FIRM NO. 184.0020 J

## INDEX OF SHEETS

SHEET NO.	DESCRIPTION
1	COVER SHEET
2	INDEX OF SHEETS, STATE STANDARDS AND GENERAL NOTES
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10	TYPICAL SECTIONS
11-12	SCHEDULE OF QUANTITIES
13	ALIGNMENT AND BENCHMARK
14	REMOVAL PLAN
15	PROPOSED PLAN AND PROFILE
16	TRAFFIC CONTROL PLAN TYPICAL SECTIONS AND NOTES
16A	TRAFFIC CONTROL PLAN ADVANCE WIDTH RESTRICTION SIGNING
17	TRAFFIC CONTROL PLAN STAGE I
18	TRAFFIC CONTROL PLAN STAGE II
19	EROSION AND SEDIMENT CONTROL NOTES
20	EROSION AND SEDIMENT CONTROL PLAN
21	EROSION AND SEDIMENT CONTROL DETAILS
22	DRAINAGE AND UTILITY PLAN
23	WATER MAIN PLANS
24	WATER MAIN DETAILS
25	RIGHT OF WAY STRIP MAP
26	PAVEMENT MARKING AND LANDSCAPING DETAILS
27	ADA RAMP DETAILS
28	RETAINING WALLS A AND B
29	RETAINING WALLS C AND D
30	RETAINING WALLS DETAILS
31	HANDRAIL DETAILS
32-40	BRIDGE REPAIR PLANS
41	BD-07 DETAIL OF STORM SEWER CONNECTION TO EXISTING SEWER
42	BD-24 CURB OR CURB AND GUTTER REMOVAL AND REPLACEMENT
43	TC-10 TRAFFIC CONTROL AND PROTECTION FOR SIDE ROADS, INTERSECTIONS, AND DRIVEWAYS
44	TC-11 TYPICAL APPLICATIONS RAISED REFLECTIVE PAVEMENT MARKERS (SNOW-PLOW RESISTANT)
45	TC-13 DISTRICT ONE TYPICAL PAVEMENT MARKINGS
46	TC-22 ARTERIAL ROAD INFORMATION SIGN
47	TC-26 DRIVEWAY ENTRANCE SIGNING
48-58	CROSS SECTIONS

## STATE HIGHWAY STANDARDS

STANDARD NO.	DESCRIPTION
000001-06	STANDARD SYMBOLS, ABBREVIATIONS AND PATTERNS
001001-02	AREAS OF REINFORCEMENT BARS
001006	DECIMAL OF AN INCH AND OF A FOOT
280001-07	TEMPORARY EROSION CONTROL SYSTEMS
424001-10	PERPENDICULAR CURB RAMPS FOR SIDEWALKS
542301-03	PRECAST REINFORCED CONCRETE FLARED END SECTION
542401-03	METAL END SECTION FOR PIPE CULVERTS
602501-03	VALVE VAULT TYPE A
604001-04	FRAME AND LIDS TYPE 1
606001-07	CONCRETE CURB TYPE B AND COMBINATION CONCRETE CURB AND GUTTER
701101-05	OFF-RD OPERATIONS, MULTILANE, 15' TO 24" FROM PAVEMENT EDGE
701106-02	OFF-RD OPERATIONS, MULTILANE, MORE THAN 15' AWAY
701301-04	LANE CLOSURE, 2L, 2W, SHORT TIME OPERATIONS
701311-03	LANE CLOSURE, 2L, 2W, MOVING OPERATIONS - DAY ONLY
701427-05	LANE CLOSURE, MULTILANE, INTERMITTENT OR MOVING OPER., FOR SPEEDS ≤ 40 MPH
701602-09	URBAN LANE CLOSURE, MULTILANE, 2W WITH BIDIRECTIONAL LEFT TURN LANE
701606-10	URBAN LANE CLOSURE, MULTILANE, 2W WITH MOUNTABLE MEDIAN
701701-10	URBAN LANE CLOSURE, MULTILANE INTERSECTION
701801-06	SIDEWALK, CORNER OR CROSSWALK CLOSURE
701901-07	TRAFFIC CONTROL DEVICES
720001-01	SIGN PANEL MOUNTING DETAILS
720006-04	SIGN PANEL ERECTION DETAILS
728001-01	TELESCOPING STEEL SIGN SUPPORT
780001-05	TYPICAL PAVEMENT MARKINGS
781001-04	TYPICAL APPLICATIONS RAISED REFLECTIVE PAVEMENT MARKERS

### COMMITMENTS:

NONE

## GENERAL NOTES:

- ALL ELEVATIONS IN THE PLANS ARE BASED UPON THE NORTH AMERICAN VERTICAL DATUM 1988 (NAVD88).
- BEFORE STARTING ANY EXCAVATION, THE CONTRACTOR SHALL CALL "J.U.L.I.E." AT (800) 892-0123 OR 811 AND THE CITY OF DES PLAINES FOR FIELD LOCATIONS OF BURIED UTILITIES. (48 HOUR NOTIFICATION IS REQUIRED).
- IF THIS CONTRACT REQUIRES THE SERVICES OF AN ELECTRICAL CONTRACTOR, THE CONTRACTOR SHALL BE RESPONSIBLE AT HIS/HER OWN EXPENSE FOR LOCATING EXISTING IDOT ELECTRICAL FACILITIES PRIOR TO PERFORMING ANY WORK. IF THIS CONTRACT DOES NOT REQUIRE THE SERVICES OF AN ELECTRICAL CONTRACTOR, THE CONTRACTOR MAY REQUEST ONE FREE LOCATE FOR EXISTING IDOT ELECTRICAL FACILITIES FROM THE DISTRICT ONE ELECTRICAL MAINTENANCE CONTRACTOR PRIOR TO THE START OF ANY WORK. ADDITIONAL REQUESTS MAY BE MADE AT THE EXPENSE OF THE CONTRACTOR. THE LOCATION OF UNDERGROUND TRAFFIC FACILITIES DOES NOT RELIEVE THE CONTRACTOR OF THEIR RESPONSIBILITY TO REPAIR ANY FACILITIES DAMAGED DURING CONSTRUCTION AT THEIR EXPENSE.
- THE CONTRACTOR SHALL COORDINATE CONSTRUCTION ACTIVITIES WITH UTILITY COMPANIES AND THE CITY OF DES PLAINES.
- THE CONTRACTOR WILL NOT BE ALLOWED TO SET UP A YARD OR FIELD OFFICE ON STATE PROPERTY WITHOUT WRITTEN PERMISSION FROM THE DEPARTMENT.
- BEFORE BEGINNING ANY WORK, THE CONTRACTOR SHALL RECORD AND RETAIN FOR FUTURE REFERENCE, ALL EXISTING PAVEMENT MARKING LINES AND RAISED REFLECTIVE PAVEMENT MARKER LOCATIONS IN ORDER THAT THESE LOCATIONS CAN BE RE-ESTABLISHED FOR STRIPING. EXACT LOCATIONS OF ALL PAVEMENT MARKINGS SHALL BE AS DIRECTED BY THE ENGINEER.
- IT SHALL BE THE CONTRACTOR'S RESPONSIBILITY TO VERIFY ALL DIMENSIONS AND CONDITIONS EXISTING IN THE FIELD PRIOR TO CONSTRUCTION AND ORDERING OF MATERIALS.
- THE CONTRACTOR SHALL CONTACT THE DISTRICT ONE TRAFFIC CONTROL SUPERVISOR AT (847) 705-4470, A MINIMUM OF 72 HOURS IN ADVANCE OF BEGINNING WORK.
- THE CONTRACTOR SHALL BE REQUIRED TO PROVIDE ACCESS TO ABUTTING PROPERTIES AT ALL TIMES DURING THE CONSTRUCTION OF THIS PROJECT.
- ALL DAMAGE TO EXISTING PAVEMENT MARKINGS OR RAISED REFLECTIVE PAVEMENT MARKERS OUTSIDE THE REMOVAL LINES SHOWN ON THE PLANS SHALL BE REPLACED AT NO ADDITIONAL COST TO THE DEPARTMENT.
- DOUBLE LANE MARKERS ARE TO BE USED AS SHOWN ON THE DISTRICT ONE DETAIL "TYPICAL APPLICATIONS- RAISED REFLECTIVE PAVEMENT MARKERS (SNOW-PLOW RESISTANT)" INCLUDED IN THE PLANS.
- PAVEMENT MARKING TAPE, TYPE IV SHALL BE USED FOR SHORT TERM PAVEMENT MARKING ON ALL FINAL SURFACES.
- THE THICKNESS OF HMA MIXTURES SHOWN ON THE PLANS IS THE NOMINAL THICKNESS. DEVIATIONS FROM THE NOMINAL THICKNESS WILL BE PERMITTED WHEN SUCH DEVIATIONS OCCUR DUE TO IRREGULARITIES IN THE EXISTING SURFACE OR BASE ON WHICH THE HMA MIXTURE IS PLACED.
- TEN (10) FOOT TRANSITIONS SHALL BE USED TO MATCH PROPOSED CURB AND GUTTER AND MEDIAN ITEMS OF WORK TO EXISTING CURBS AND GUTTER AND MEDIANS IN THE FIELD, UNLESS OTHERWISE SHOWN. THE TRANSITIONS SHALL BE PAID FOR AT THE CONTRACT UNIT PRICE FOR THE PROPOSED ITEMS OF WORK SPECIFIED.
- THE LOCATIONS OF THE EXISTING UTILITIES, AS SHOWN ON THE DRAWINGS, REPRESENT DATA RECEIVED FROM VARIOUS SOURCES; IT IS NOT GUARANTEED TO BE CORRECT OR ALL INCLUSIVE. THE CONTRACTOR SHALL CONDUCT HIS OWN INVESTIGATIONS INTO THE LOCATION, SIZE, DEPTH AND NATURE OF ANY AND ALL EXISTING UTILITIES WHICH MAY INTERFERE WITH THE WORK UNDER THE CONTRACT. ANY EXISTING UTILITIES WHICH ARE TO REMAIN IN SERVICE SHALL BE FULLY PROTECTED BY THE CONTRACTOR AND ANY DAMAGE CAUSED BY THE CONSTRUCTION SHALL BE IMMEDIATELY REPAIRED AT THE CONTRACTOR'S EXPENSE.
- THE CONTRACTOR SHALL USE CARE IN REMOVING OR EXCAVATING NEAR ALL EXISTING ITEMS WHICH WILL REMAIN. ANY DAMAGE DONE TO EXISTING ITEMS BY THE CONTRACTOR SHALL BE REPAIRED AT THE CONTRACTOR'S EXPENSE.
- ALL EARTH WORK ASSOCIATED WITH THE SIDEWALKS IS INCLUDED IN THE COST OF THE PORTLAND CEMENT CONCRETE SIDEWALK, 5 INCH.
- THE RESIDENT ENGINEER SHALL CONTACT MR. CORY JUCIUS, AREA TRAFFIC FIELD ENGINEER, AT (847) 705-4141 (EMAIL: CORY.JUCIUS@ILLINOIS.GOV) A MINIMUM OF TWO (2) WEEKS PRIOR TO THE PLACEMENT OF PERMANENT PAVEMENT MARKINGS.
- DE-ENERGIZING COM ED'S DISTRIBUTION LINES (12 KV) MAY BE NECESSARY IN ORDER TO ACCOMMODATE THE CONTRACTOR'S EQUIPMENT. COSTS MAY BE INVOLVED. CALL 1-800-EDISON1.
- ALL WATER MAIN WORK IS TO BE DONE IN ACCORDANCE WITH THE LATEST EDITION OF THE STANDARD SPECIFICATIONS FOR WATER AND SEWER MAIN CONSTRUCTION IN ILLINOIS.
- COORDINATE ALL WATER MAIN WORK WITH THE CITY OF DES PLAINES. THE DES PLAINES PUBLIC WORK DEPARTMENT, (847) 391-6121, MUST BE NOTIFIED 48 WORKING HOURS PRIOR TO REQUIRING WATER MAIN SHUTDOWNS OR RETURNING WATER MAINS TO SERVICE.
- THE REMOVAL OF EXISTING DRAINAGE ITEMS LOCATED FURTHER THAN 2 FEET OUTSIDE THE EDGE OF PAVEMENT SHALL BE BACKFILLED WITH NATIVE MATERIALS AND THE COST OF THE BACKFILLING WITH NATIVE MATERIALS WILL NOT BE PAID FOR SEPARATELY, BUT SHALL BE INCLUDED IN THE COST OF THE DRAINAGE ITEM TO BE REMOVED. BACKFILL UNDER AND WITHIN 2 FEET OF THE PAVEMENT SHALL BE IN ACCORDANCE WITH SECTION 208 OF THE STANDARD SPECIFICATIONS.
- THE COST OF CONNECTING EXISTING STORM SEWERS TO THE PROPOSED DRAINAGE SYSTEM AND/OR CONNECTING PROPOSED STORM SEWER TO EXISTING STRUCTURES SHALL BE CONSIDERED INCLUDED IN THE COST OF THE PROPOSED STORM SEWER. ALL NECESSARY ADDITIONAL PIPE USED WILL BE PAID FOR AT THE CONTRACT UNIT PRICE FOR THE STORM SEWER OF THE SIZE REQUIRED.
- WHEN MILLED PAVEMENT IS OPEN TO TRAFFIC, THE MAXIMUM GRADE DIFFERENTIAL BETWEEN PASSES OF THE MILLING MACHINE SHALL NOT EXCEED 1/2 INCHES WHERE THE SPEED LIMIT IS 40 MPH OR LESS AND 1 INCH WHERE THE SPEED LIMIT IS GREATER THAN 40 MPH.

FILE NAME = Q:\Engineering\LiveProjects\13003 IDOT DUR\13003 - W0 1 Contract No. 60W53\CADD\CADD Sheets\Civil\0160W53-Sht-Gannote\_Index.dgn



USER NAME = dheiden	DESIGNED - AB	REVISED -
	DRAWN - CEC	REVISED -
PLOT SCALE = 100.0001' / in.	CHECKED - JMT	REVISED -
PLOT DATE = 4/12/2018	DATE - 4/12/2018	REVISED -

**STATE OF ILLINOIS  
DEPARTMENT OF TRANSPORTATION**

**INDEX OF SHEETS, STATE STANDARDS AND GENERAL NOTES  
WOLF ROAD AT WELLER'S DITCH**

SCALE: SHEET OF SHEETS STA. TO STA.

F.A.U. RTE.	SECTION	COUNTY	TOTAL SHEETS	SHEET NO.
2691	3434.1-BR(13)	COOK	58	2
CONTRACT NO. 60W53				
ILLINOIS FED. AID PROJECT				

CODE NO.	ITEM	UNIT	TOTAL QUANTITY	CONSTRUCTION CODE					
				80% FED 20% STATE				100% CITY OF DES PLAINES	
				ROADWAY 0005 URBAN	BRIDGE 0047 016-2009	ROADWAY 0021 URBAN	RETAINING WALL 0044 URBAN	ROADWAY 0005 URBAN	UTILITY 0043 URBAN
20100110	TREE REMOVAL (6 TO 15 UNITS DIAMETER)	UNIT	17	17					
20100210	TREE REMOVAL (OVER 15 UNITS DIAMETER)	UNIT	90	90					
20101000	TEMPORARY FENCE	FOOT	69	69					
20101200	TREE ROOT PRUNING	EACH	1	1					
20300100	CHANNEL EXCAVATION	CU YD	324					324	
20800150	TRENCH BACKFILL	CU YD	12	12					
21101505	TOPSOIL EXCAVATION AND PLACEMENT	CU YD	50	50					
25000110	SEEDING, CLASS 1A	ACRE	0.25	0.19				0.06	
25000400	NITROGEN FERTILIZER NUTRIENT	POUND	7	5				2	
25000500	PHOSPHORUS FERTILIZER NUTRIENT	POUND	7	5				2	
25000600	POTASSIUM FERTILIZER NUTRIENT	POUND	7	5				2	
25100630	EROSION CONTROL BLANKET	SQ YD	359	267				92	
28000250	TEMPORARY EROSION CONTROL SEEDING	POUND	15	11				4	
28000400	PERIMETER EROSION BARRIER	FOOT	180	180					

\* SPECIALTY ITEM

14

FILE NAME = D:\Engineering\Live\Projects\3083 IDOT DLR\13083e - MD 1 Contract No. 80M53\CA00\CA00 Sheets\Civil\016R\MS3-Sht-500.dgn



USER NAME = dhejden	DESIGNED - AB	REVISED -
DRAWN - JN	CHECKED - JMT	REVISED -
PLOT SCALE = 2.0000' / 1" =	DATE - 3/12/2018	REVISED -
PLOT DATE = 3/12/2018		

STATE OF ILLINOIS  
DEPARTMENT OF TRANSPORTATION

SUMMARY OF QUANTITIES			
SCALE:	SHEET	OF	SHEETS

F.A.U. RTE. 2691	SECTION 3434.1-BR(13)	COUNTY COOK	TOTAL SHEETS 58	SHEET NO. 3
CONTRACT NO. 60W53				ILLINOIS FED. AID PROJECT

FILE NAME = G:\Engineering\LiveProjects\13003 IDOT DUR\13003a - MD 1 Contract No. 88W53\ADD\CADD Sheets C:\1\10169W53-sht-500.dgn

CODE NO.	ITEM	UNIT	TOTAL QUANTITY	CONSTRUCTION CODE					
				80% FED 20% STATE			100% CITY OF DES PLAINES		
				ROADWAY 0005 URBAN	BRIDGE 0047 016-2009	ROADWAY 0021 URBAN	RETAINING WALL 0044 URBAN	ROADWAY 0005 URBAN	UTILITY 0043 URBAN
28000500	INLET AND PIPE PROTECTION	EACH	1	1					
28000510	INLET FILTERS	EACH	10	10					
28100105	STONE RIPRAP, CLASS A3	SQ YD	259					259	
28100205	STONE RIPRAP, CLASS A3	TON	14					14	
28200200	FILTER FABRIC	SQ YD	259					259	
35101800	AGGREGATE BASE COURSE, TYPE B 6"	SQ YD	131	124				7	
40600290	BITUMINOUS MATERIALS (TACK COAT)	POUND	141	141					
40603340	HOT-MIX ASPHALT SURFACE COURSE, MIX "D", N70	TON	56	56					
42400200	PORTLAND CEMENT CONCRETE SIDEWALK 5 INCH	SQ FT	931			931			
42400800	DETECTABLE WARNINGS	SQ FT	22			22			
44000157	HOT-MIX ASPHALT SURFACE REMOVAL, 2"	SQ YD	283	283					
44000500	COMBINATION CURB AND GUTTER REMOVAL	FOOT	25	25					
44000600	SIDEWALK REMOVAL	SQ FT	623	623					
50102400	CONCRETE REMOVAL	CU YD	1		1				

14

\* SPECIALTY ITEM



USER NAME = dhegden	DESIGNED - AB	REVISED -
DRAWN - JN	CHECKED - JMT	REVISED -
PLOT SCALE = 0.2500 m / in	DATE - 3/12/2018	REVISED -
PLOT DATE = 3/12/2018		

STATE OF ILLINOIS  
DEPARTMENT OF TRANSPORTATION

SUMMARY OF QUANTITIES  
WOLF ROAD AT WELLER'S DITCH

SCALE: SHEET OF SHEETS STA. TO STA.

F.A.U. RTE.	SECTION	COUNTY	TOTAL SHEETS	SHEET NO.
2691	3434.1-BR(13)	COOK	58	4
CONTRACT NO. 60W53			ILLINOIS FED. AID PROJECT	

CODE NO.	ITEM	UNIT	TOTAL QUANTITY	CONSTRUCTION CODE					
				80% FED 20% STATE			100% CITY OF DES PLAINES		
				ROADWAY 0005 URBAN	BRIDGE 0047 016-2009	ROADWAY 0021 URBAN	RETAINING WALL 0044 URBAN	ROADWAY 0005 URBAN	UTILITY 0043 URBAN
50300225	CONCRETE STRUCTURES	CU YD	27.1		0.3		26.8		
50300260	BRIDGE DECK GROOVING	SQ YD	196		196				
50300300	PROTECTIVE COAT	SQ YD	398	109	262		27		
50800205	REINFORCEMENT BARS, EPOXY COATED	POUND	5540		2880		2660		
50800515	BAR SPLICERS	EACH	35		35				
50901760	PIPE HANDRAIL	FOOT	84				84		
542C0215	PIPE CULVERTS, CLASS C, TYPE 1 10"	FOOT	44	44					
542C0259	PIPE CULVERTS, CLASS C, TYPE 1 54"	FOOT	14					14	
54213669	PRECAST REINFORCED CONCRETE FLARED END SECTIONS 24"	EACH	1					1	
55101200	STORM SEWER REMOVAL 24"	FOOT	14					14	
55102000	STORM SEWER REMOVAL 54"	FOOT	104					104	
56104900	WATER VALVES 6"	EACH	1						1
60248700	VALVE VAULTS, TYPE A, 4'-DIAMETER, TYPE 1 FRAME, CLOSED LID	EACH	1						1
60250500	CATCH BASINS TO BE ADJUSTED WITH NEW TYPE 1 FRAME, CLOSED LID	EACH	1	1					

\* SPECIALTY ITEM

FILE NAME = G:\Engineering\Live\Projects\13083 IDOT DURY\13083 - WD 1 Contract No. 60W53\CADD\CADD Sheets\Civil\160W53-Sht-500.dgn



USER NAME = dhegden	DESIGNED - AB	REVISED -
PLOT SCALE = 8.2000 in / ft	DRAWN - JN	REVISED -
PLOT DATE = 3/12/2018	CHECKED - JMT	REVISED -
	DATE - 3/12/2018	REVISED -

STATE OF ILLINOIS  
DEPARTMENT OF TRANSPORTATION

SUMMARY OF QUANTITIES  
WOLF ROAD AT WELLER'S DITCH

SCALE: SHEET OF SHEETS STA. TO STA.

F.A.U. RTE. 2691	SECTION 3434.1-BR(13)	COUNTY COOK	TOTAL SHEETS 58	SHEET NO. 5
CONTRACT NO. 60W53			ILLINOIS FED. AID PROJECT	

FILE NAME = G:\Engineering\Live\Projects\13003 - WC 1 Cont-est. No. 80W53\CAD\CRD Sheets\C:\1\1018045-Slt-500.dgn

CODE NO.	ITEM	UNIT	TOTAL QUANTITY	CONSTRUCTION CODE					
				80% FED 20% STATE			100% CITY OF DES PLAINES		
				ROADWAY 0005 URBAN	BRIDGE 0047 016-2009	ROADWAY 0021 URBAN	RETAINING WALL 0044 URBAN	ROADWAY 0005 URBAN	UTILITY 0043 URBAN
60265700	VALVE VAULTS TO BE ADJUSTED	EACH	1	1					
60603900	COMBINATION CONCRETE CURB AND GUTTER, TYPE B-6.12 (ABUTTING EXISTING PAVEMENT)	FOOT	25	25					
66400105	CHAIN LINK FENCE, 4'	FOOT	70	70					
* 66900200	NON-SPECIAL WASTE DISPOSAL	CU YD	260			260			
* 66900450	SPECIAL WASTE PLANS AND REPORTS	L SUM	1			1			
* 66900530	SOIL DISPOSAL ANALYSIS	EACH	3			3			
67000400	ENGINEER'S FIELD OFFICE, TYPE A	CAL MO	4	4					
67100100	MOBILIZATION	L SUM	1	1					
70103815	TRAFFIC CONTROL SURVEILLANCE	CAL DAY	60	60					
70300100	SHORT TERM PAVEMENT MARKING	FOOT	894	894					
70300150	SHORT TERM PAVEMENT MARKING REMOVAL	SQ FT	298	298					
70300904	PAVEMENT MARKING TAPE, TYPE IV 4"	FOOT	13188	13188					
70300912	PAVEMENT MARKING TAPE, TYPE IV 12"	FOOT	1425	1425					
70300924	PAVEMENT MARKING TAPE, TYPE IV 24"	FOOT	80	80					

\* SPECIALTY ITEM



USER NAME = dhayden	DESIGNED - AB	REVISED -
PLOT SCALE = 8,2000 = / 1in.	DRAWN - JN	REVISED -
PLOT DATE = 3/22/2018	CHECKED - JMT	REVISED -
	DATE - 3/22/2018	REVISED -

STATE OF ILLINOIS  
DEPARTMENT OF TRANSPORTATION

SUMMARY OF QUANTITIES  
WOLF ROAD AT WELLER'S DITCH

SCALE: SHEET OF SHEETS STA. TO STA.

F.A.U. RTE.	SECTION	COUNTY	TOTAL SHEETS	SHEET NO.
2691	3434.1-BR(13)	COOK	58	6
CONTRACT NO. 60W53			ILLINOIS FED. AID PROJECT	

FILE NAME = D:\Engineering\Live\Projects\3603 IDOT DUR\3603a - MO 1 Contract No. 60W53\CADD\CADD Sheets\Civil\60W53-Sht-500.dgn

CODE NO.	ITEM	UNIT	TOTAL QUANTITY	CONSTRUCTION CODE						
				80% FED 20% STATE			100% CITY OF DES PLAINES			
				ROADWAY 0005 URBAN	BRIDGE 0047 016-2009	ROADWAY 0021 URBAN	RETAINING WALL 0044 URBAN	ROADWAY 0005 URBAN	UTILITY 0043 URBAN	
* 78000100	THERMOPLASTIC PAVEMENT MARKING - LETTERS AND SYMBOLS	SQ FT	270	270						
* 78000200	THERMOPLASTIC PAVEMENT MARKING - LINE 4"	FOOT	3925	3925						
* 78000400	THERMOPLASTIC PAVEMENT MARKING - LINE 6"	FOOT	276	276						
* 78000600	THERMOPLASTIC PAVEMENT MARKING - LINE 12"	FOOT	101	101						
* 78000650	THERMOPLASTIC PAVEMENT MARKING - LINE 24"	FOOT	27	27						
* 78008210	POLYUREA PAVEMENT MARKING TYPE I - LINE 4"	FOOT	108	108						
* 78100300	REPLACEMENT REFLECTOR	EACH	122	122						
78300200	RAISED REFLECTIVE PAVEMENT MARKER REMOVAL	EACH	119	119						
X0327980	PAVEMENT MARKING REMOVAL - WATER BLASTING	SQ FT	1726	1726						
X2020502	BRACED EXCAVATION	CU YD	116.1				116.1			
X2080250	TRENCH BACKFILL, SPECIAL	CU YD	6							6
X4421790	CLASS D PATCHES, TYPE II, 12 INCH (SPECIAL)	SQ YD	7					7		
X5030305	CONCRETE WEARING SURFACE, 5"	SQ YD	204		204					
* X5610004	DUCTILE IRON WATER MAIN FITTINGS	POUND	175							175

14

\* SPECIALTY ITEM



USER NAME = dheyden	DESIGNED - AB	REVISED -
DRAWN - JN	CHECKED - JMT	REVISED -
DATE - 3/12/2018		

STATE OF ILLINOIS  
DEPARTMENT OF TRANSPORTATION

SUMMARY OF QUANTITIES			
SCALE:	SHEET	OF SHEETS	STA. TO STA.

F.A.U. RTE. 2691	SECTION 3434.1-BR(13)	COUNTY COOK	TOTAL SHEETS 58	SHEET NO. 7
CONTRACT NO. 60W53				
ILLINOIS FED. AID PROJECT				

CODE NO.	ITEM	UNIT	TOTAL QUANTITY	CONSTRUCTION CODE					
				80% FED 20% STATE				100% CITY OF DES PLAINES	
				ROADWAY 0005 URBAN	BRIDGE 0047 016-2009	ROADWAY 0021 URBAN	RETAINING WALL 0044 URBAN	ROADWAY 0005 URBAN	UTILITY 0043 URBAN
X5610706	WATER MAIN REMOVAL, 6"	FOOT	32						32
X5611106	DUCTILE IRON WATER MAIN, CLASS 52 WITH POLYETHYLENE ENCASEMENT, 6"	FOOT	37						37
X5860110	GRANULAR BACKFILL FOR STRUCTURES	CU YD	58.9				58.9		
X6640300	CHAIN LINK FENCE REMOVAL	FOOT	66	66					
X7010216	TRAFFIC CONTROL AND PROTECTION, (SPECIAL)	L SUM	1	1					
X7015005	CHANGEABLE MESSAGE SIGN	CAL DAY	126	126					
X7030005	TEMPORARY PAVEMENT MARKING REMOVAL	SQ FT	2991	2991					
X7830050	RAISED REFLECTIVE PAVEMENT MARKER, REFLECTOR REMOVAL	EACH	122	122					
Z0003700	BEARING PAD ADJUSTMENT	EACH	44		44				
Z0007122	REMOVING AND RE-ERECTING EXISTING RAILING	FOOT	43		43				
Z0007126	HANDRAIL REMOVAL	FOOT	20			20			
Z0012455	CONCRETE STEP REMOVAL	EACH	22			22			
Z0012754	STRUCTURAL REPAIR OF CONCRETE (DEPTH EQUAL TO OR LESS THAN 5 INCHES)	SQ FT	103		103				
Z0012755	STRUCTURAL REPAIR OF CONCRETE (DEPTH GREATER THAN 5 INCHES)	SQ FT	38		38				

\* SPECIALTY ITEM

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USER NAME = dheyden	DESIGNED - AB	REVISED -
PLDT SCALE = 0.2000 m / 1 in.	DRAWN - JN	REVISED -
PLDT DATE = 3/12/2018	CHECKED - JMT	REVISED -
	DATE - 3/12/2018	REVISED -

STATE OF ILLINOIS  
DEPARTMENT OF TRANSPORTATION

SUMMARY OF QUANTITIES  
WOLF ROAD AT WELLER'S DITCH

SCALE: SHEET OF SHEETS STA. TO STA.

F.A.U. RTE.	SECTION	COUNTY	TOTAL SHEETS	SHEET NO.
2691	3434.1-BR(13)	COOK	58	8
CONTRACT NO. 60W53			ILLINOIS FED. AID PROJECT	





HOT-MIX ASPHALT PAVEMENT SCHEDULE			
LOCATION STATION TO STATION	BITUMINOUS MATERIALS (TACK COAT) (POUND)	HOT MIX ASPHALT SURFACE COURSE, MIX "D" N70 (TON)	HOT MIX ASPHALT SURFACE REMOVAL, 2" (SQ YD)
732+60.75 TO 732+82.93	33	18.6	132.7
733+16.87 TO 733+38.75	66	18.5	132.0
COLUMBIA AVENUE SE CORNER	4.	9.4	9.3
COLUMBIA AVENUE NE CORNER	4.8	9.6	9.5
TOTAL	141	56	283

CURB AND GUTTER SCHEDULE		
LOCATION STATION TO STATION	COMBINATION CURB AND GUTTER REMOVAL (FOOT)	COMBINATION CONCRETE CURB AND GUTTER TYPE B-6.12 (ABUTTING EXISTING PAVEMENT) (FOOT)
732+19.92 TO 732+23.13	12	12
732+47.53 TO 732+50.60	13	13
TOTAL	25	25

LANDSCAPING SCHEDULE			
LOCATION STATION TO STATION	OFFSET (LT / RT)	SEEDING CLASS 1A (ACRE)	EROSION CONTROL BLANKET (SQ YD)
731+80.6 TO 732+04.4	RT	0.002	8
731+80.6 TO 732+20.8	RT	0.013	62
732+09.0 TO 732+22.0	RT	0.006	29
732+45.6 TO 732+59.9	RT	0.004	20
732+54.6 TO 732+77	RT	0.006	30
733+05.6 TO 734+29	RT	0.035	169
733+85.5 TO 734+29	RT	0.008	41
ROUNDED TOTAL		0.25	359

EROSION CONTROL SCHEDULE					
LOCATION STATION TO STATION	OFFSET (LT / RT)	PERIMETER EROSION BARRIER (FOOT)	INLET FILTERS (EACH)	TEMPORARY FENCE (FOOT)	INLET AND PIPE PROTECTION (EACH)
730+71 TO 733+97	RT		7		1
730+68 TO 733+96	LT		3		
731+88 TO 732+02.5	RT	15			
732+02.5 TO 732+01	RT	28			
732+60.3 TO 732+61.8	RT	30			
732+61.8 TO 732+92.3	RT	31			
732+89 TO 733+38	RT			35	
732+61 TO 732+92	LT			34	
733+68 TO 733+68	RT	15			
733+68 TO 734+29	RT	61			
TOTAL		180	10	69	1

PCC SIDEWALK SCHEDULE						
LOCATION	ROADWAY	PORTLAND CEMENT CONCRETE SIDEWALK 5 INCH (SQ FT)	SIDEWALK REMOVAL (SQ FT)	CONCRETE STEP REMOVAL (EACH)	DETECTABLE WARNINGS (SQ FT)	AGGREGATE BASE COURSE, TYPE B 6" (SQ YD)
EASTSIDE	WOLF ROAD	158	105	8		21
SOUTH SIDE	COLUMBIA AVE.	97	97	4	10	13
SE CORNER TOP OF STAIRS	WOLF ROAD/ COLUMBIA AVE.		27			
NE CORNER TOP OF STAIRS	WOLF ROAD/ COLUMBIA AVE.		73			
NE CORNER BOTTOM OF STAIRS	WOLF ROAD/ COLUMBIA AVE.		12			
NORTH SIDE	COLUMBIA AVE.	363		2	12	48
NE OF BRIDGE	WOLF ROAD	313	309	8		42
WATER MAIN						7
TOTAL		931	623	22	22	131

FENCE SCHEDULE			
LOCATION / STATION	OFFSET (LT / RT)	CHAIN LINK FENCE 4 FEET (FOOT)	CHAIN LINK FENCE REMOVAL (FOOT)
732+60 TO 732+93	LT	35	33
733+04 TO 733+37	RT	35	33
TOTAL		70	66

HANDRAIL REMOVAL SCHEDULE	
LOCATION / STATION	HANDRAIL REMOVAL (FOOT)
732+76	10
733+69	10
TOTAL	20

TOPSOIL EXCAVATION AND PLACEMENT SCHEDULE		
LOCATION STATION TO STATION	ROADWAY	TOPSOIL EXCAVATION AND PLACEMENT (CU YD)
731+83 TO 732+20	WOLF ROAD	7.2
732+50 TO 732+70	WOLF ROAD	6.0
733+06 TO 733+70	WOLF ROAD	11.0
733+70 TO 734+25	WOLF ROAD	14.5
10+10 TO 10+50	COLUMBIA	10.9
TOTAL		50
NOTE: ASSUME EXISTING TOPSOIL IS 4" THICK		

REMOVE AND RESETTING STREET SIGN		
LOCATION STATION TO STATION	TYPE/ ROADWAY	REMOVE AND RESETTING STREET SIGN (EACH)
733+86.2	RIGHT LANE/WOLF RD.	1
732+50.1	STOP SIGN/COLUMBIA AVE.	1
TOTAL		2

CHANNEL EXCAVATION SCHEDULE	
LOCATION STATION TO STATION	CHANNEL EXCAVATION (CU YD)
50+20 TO 51+00	324

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PLOT SCALE = 0.2000 m / in.	DRAWN - JN	REVISED -
PLOT DATE = 3/12/2018	CHECKED - JMT	REVISED -
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STATE OF ILLINOIS  
DEPARTMENT OF TRANSPORTATION

SCHEDULE OF QUANTITIES  
WOLF ROAD AT WELLER'S DITCH

SCALE: SHEET OF SHEETS STA. TO STA.

F.A.U. RTE.	SECTION	COUNTY	TOTAL SHEETS	SHEET NO.
2691	3434.1-BR(13)	COOK	58	11
CONTRACT NO. 60W53				
ILLINOIS FED. AID PROJECT				

PAVEMENT MARKING TAPE, TYPE IV				
LOCATION STATION TO STATION	TYPE	4" (FOOT)	12" (FOOT)	24" (FOOT)
STAGE I				
726+15 TO 729+30	YELLOW CL	315	---	---
726+15 TO 732+10	WHITE EDGE LN	595	---	---
730+13 TO 732+10	YELLOW CL	788	---	---
730+13 TO 732+10	YELLOW DIAG LN	---	128	---
COLUMBIA AVE. STOP BAR	WHITE STOP BAR	---	---	20
730+55 TO 734+29	WHITE EDGE LN	374	---	---
732+61 TO 734+38	YELLOW CL	354	---	---
735+68 TO 738+22	YELLOW CL	508	---	---
735+68 TO 738+22	YELLOW DIAG LN	---	228	---
STAGE II				
726+15 TO 728+15	WHITE SKIP LN	60	---	---
728+73 TO 732+11	YELLOW CL	1352	---	---
728+73 TO 732+11	YELLOW DIAG LN	---	253	---
730+55 TO 734+29	WHITE EDGE LN	374	---	---
732+60 TO 734+29	YELLOW CL	338	---	---
HARVEY AVE. STOP BAR	WHITE STOP BAR	---	---	20
734+29 TO 737+22	YELLOW CL	1172	---	---
734+29 TO 736+22	YELLOW DIAG LN	---	103	---
734+93 TO 738+15	WHITE EDGE LN	364	---	---
TOTAL		6594	712	40
REPLACEMENT FACTOR		2	2	2
ROUNDED TOTAL		13188	1425	80

SHORT TERM PAVEMENT MARKING SCHEDULE			
LOCATION STATION TO STATION	TYPE	SHORT TERM PAVEMENT MARKING (FOOT)	SHORT TERM PAVEMENT MARKING REMOVAL (SQ FT)
726+15 TO 734+66.5	PAINTED MEDIAN	92	31
726+15 TO 734+66.5	PAINTED MEDIAN	92	30
726+15 TO 734+66.5	SKIP DASH MEDIAN	92	31
726+15 TO 734+66.5	SKIP DASH MEDIAN	92	30
726+15 TO 737+79	SKIP DASH LANE	124	42
726+15 TO 735+23	SKIP DASH LANE	96	32
734+66.5 TO 735+19	PAINTED MEDIAN	48	16
735+82 TO 737+79	PAINTED MEDIAN	96	32
736+00 TO 738+23	TURN LANE	28	9
COLUMBIA AVE.	STOP BAR	42	14
HARVEY AVE.	STOP BAR	39	13
COLUMBIA AVE.	CROSS WALK	53	18
TOTAL		894	298

LOCATION STATION TO STATION	TYPE	POLYUREA PAVEMENT MARKING TYPE I 4" (FOOT)	THERMOPLASTIC PAVEMENT MARKING					REPLACEMENT REFLECTOR (EACH)
			4" (FOOT)	6" (FOOT)	12" (FOOT)	24" (FOOT)	LETTERS & SYMBOLS (SQ FT)	
726+15 TO 734+66.5	YELLOW SOLID CL	---	1636	---	---	---	---	---
726+15.0 TO 734+66.5	30/10 YELLOW SKIP CL	---	580	---	---	---	---	---
726+15 TO 735+19	30/10 WHITE SKIP LN	---	310	---	---	---	---	---
726+15 TO 737+79	30/10 WHITE SKIP LN	---	400	---	---	---	---	---
732+22.1 TO 732+50.1	WHITE CROSS WALK	---	---	53	---	---	---	---
COLUMBIA AVE.	WHITE STOP BAR	---	---	---	---	14	---	---
732+72.7 TO 733+06.8	30/10 WHITE SKIP LN	10	---	---	---	---	---	---
732+79.6 TO 733+13.6	30/10 YELLOW SKIP CL	10	---	---	---	---	---	---
732+79.6 TO 733+13.6	YELLOW SOLID CL	34	---	---	---	---	---	---
732+86.3 TO 733+20.2	30/10 YELLOW SKIP CL	10	---	---	---	---	---	---
732+86.3 TO 733+20.2	YELLOW SOLID CL	34	---	---	---	---	---	---
732+93.2 TO 733+27.0	30/10 WHITE SKIP LN	10	---	---	---	---	---	---
HARVEY AVE.	WHITE STOP BAR	---	---	---	---	13	---	---
734+66.5 TO 735+19	DOUBLE YELLOW SOLID CL	---	212	---	---	---	---	---
734+66.5 TO 735+19	YELLOW DIAGONAL LN	---	---	---	65	---	---	---
736+00 TO 738+23	WHITE TURN LN	---	---	223	---	---	---	---
735+82 TO 737+79	DOUBLE YELLOW SOLID CL	---	788	---	---	---	---	---
735+82 TO 737+79	YELLOW DIAGONAL LN	---	---	---	36	---	---	---
726+85	ARROW	---	---	---	---	---	15.6	---
727+00	ARROW	---	---	---	---	---	15.6	---
729+70	ARROW	---	---	---	---	---	15.6	---
729+85	ARROW	---	---	---	---	---	15.6	---
732+05	ARROW	---	---	---	---	---	15.6	---
732+20	ARROW	---	---	---	---	---	15.6	---
734+05	ARROW	---	---	---	---	---	15.6	---
734+20	ARROW	---	---	---	---	---	15.6	---
736+25	ARROW & ONLY	---	---	---	---	---	72.8	---
737+96	ARROW & ONLY	---	---	---	---	---	72.8	---
726+15 TO 738+23	ONE WAY CRYSTAL	---	---	---	---	---	---	60
726+15 TO 734+66.5	TWO WAY AMBER	---	---	---	---	---	---	42
734+66.5 TO 735+19	ONE WAY AMBER	---	---	---	---	---	---	8
735+82 TO 737+79	TWO WAY AMBER	---	---	---	---	---	---	12
TOTAL		108	3925	276	101	27	270	122

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PLOT DATE = 3/12/2018	CHECKED - JMT	REVISED -
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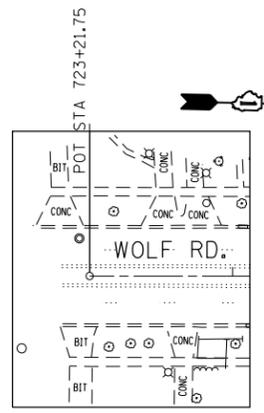
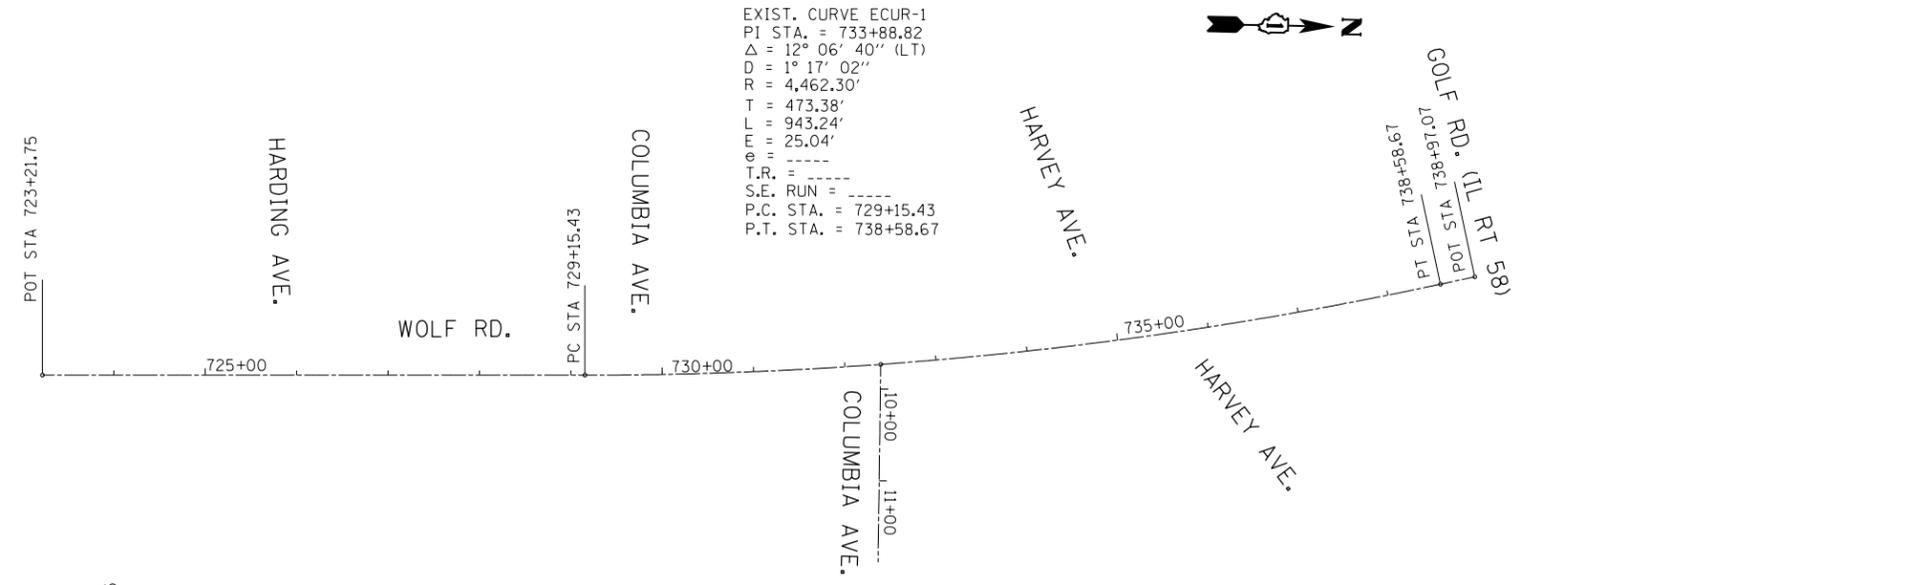
STATE OF ILLINOIS  
DEPARTMENT OF TRANSPORTATION

SCHEDULE OF QUANTITIES  
WOLF ROAD AT WELLER'S DITCH


SCALE: SHEET OF SHEETS STA. TO STA.

F.A.U. RTE.	SECTION	COUNTY	TOTAL SHEETS	SHEET NO.
2691	3434.1-BR(13)	COOK	58	12
CONTRACT NO. 60W53				
ILLINOIS FED. AID PROJECT				


EXIST. CURVE ECUR-1  
 PI STA. = 733+88.82  
 $\Delta = 12^{\circ} 06' 40''$  (LT)  
 $D = 1^{\circ} 17' 02''$   
 $R = 4,462.30'$   
 $T = 473.38'$   
 $L = 943.24'$   
 $E = 25.04'$   
 $\phi = \dots$   
 $T.R. = \dots$   
 S.E. RUN = \dots  
 P.C. STA. = 729+15.43  
 P.T. STA. = 738+58.67




**POT STA. 723 + 21.75**  
 N=1959658.96  
 E=1098700.40

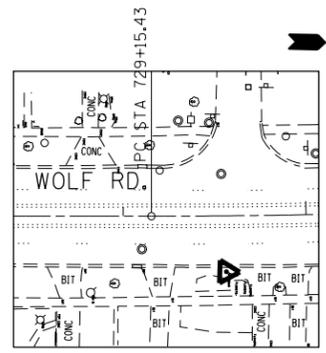


**PC STA. 729 + 15.43**  
 N=1960252.46  
 E=1098685.73

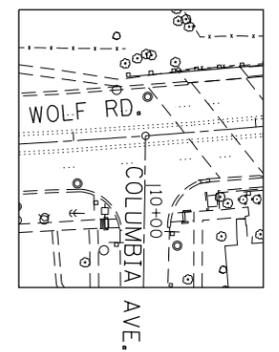


**STA. 732 + 39.70 (WOLF RD.) =  
 STA. 9 + 73.00 (COLUMBIA AVE.)**  
 N=1960575.82  
 E=1098665.97

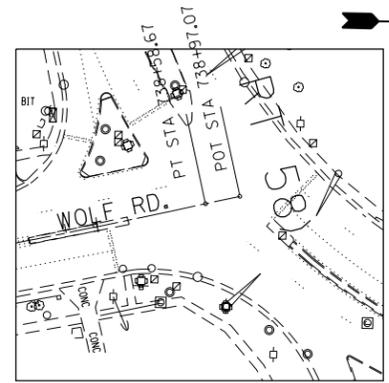


**PT STA. 738 + 58.67**  
 N=1961185.95  
 E=1098563.30  
**POT STA. 738 + 97.07**  
 N=1961437.86  
 E=1099365.52

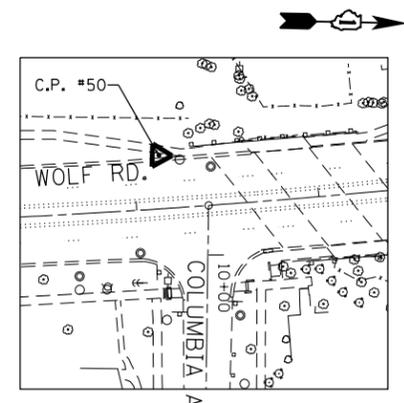

**CONTROL POINT #50**  
 IRON ROD  
 STA. 732+14.06  
 OFFSET=29.18' LT.  
 N=1960547.95  
 E=1098639.30  
 ELEV. = 643.07

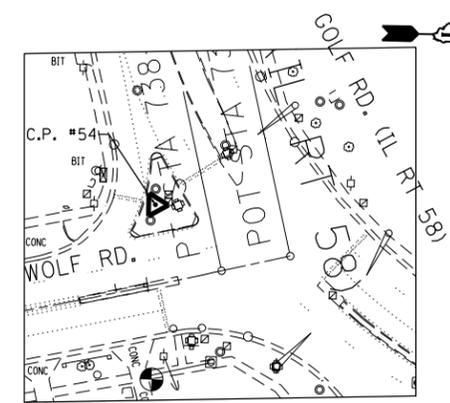

**CONTROL POINT #54**  
 CHISELED "X"  
 STA. 738+30.28  
 OFFSET=42.77' LT  
 N=1961148.86  
 E=1098528.15  
 ELEV. = 650.66

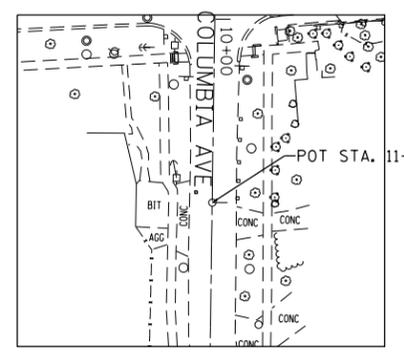

**POT STA. 11 + 00.00 (COLUMBIA AVE.)**  
 N=1960577.25  
 E=1098792.94

BENCHMARK:  
 CHISELED "SQUARE" ON TOP STEP OF SOUTHEAST  
 WINGWALL - ELEV. 650.79

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USER NAME = dhejden	DESIGNED - JN	REVISED -
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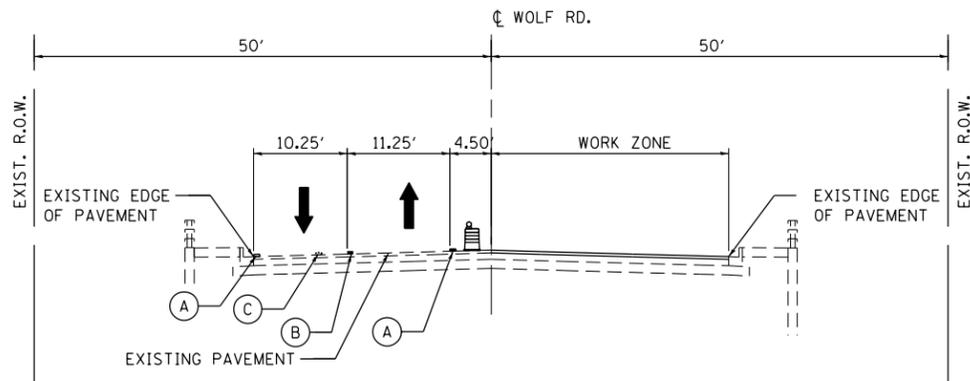
STATE OF ILLINOIS  
 DEPARTMENT OF TRANSPORTATION

ALIGNMENT AND BENCHMARK		WOLF ROAD AT WELLER'S DITCH	
SCALE:	SHEET	OF SHEETS	STA. TO STA.


F.A.U. RTE.	SECTION	COUNTY	TOTAL SHEETS	SHEET NO.
2691	3434.1-BR(13)	COOK	58	13
CONTRACT NO. 60W53				
ILLINOIS FED. AID PROJECT				







**STAGE I TYPICAL SECTION**

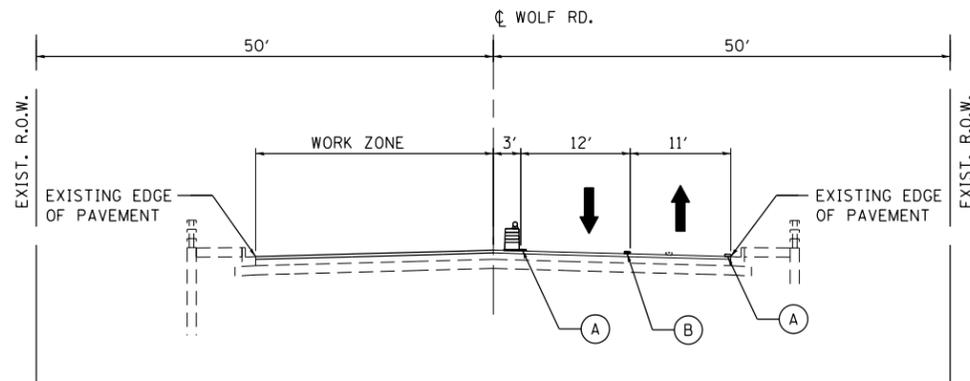

**STAGE II TYPICAL SECTION**

- LEGEND**
- (A) 4" WHITE PAVEMENT MARKING TAPE, TYPE IV
  - (B) 4" DOUBLE YELLOW PAVEMENT MARKING TAPE, TYPE IV
  - (C) EXISTING PAVEMENT MARKING TO BE REMOVED
  - DRUM OR TYPE II BARRICADES WITH BI-DIRECTIONAL STEADY BURN LIGHT
  - DIRECTION OF TRAFFIC

**MAINTENANCE OF TRAFFIC GENERAL NOTES:**

1. THE TRAFFIC CONTROL DEPICTED HEREIN IS THE MINIMUM REQUIREMENT. ADDITIONAL TRAFFIC CONTROL DEVICES AS SPECIFIED IN THE HIGHWAY STANDARDS AS SHOWN IN THE INDEX OF SHEETS AND THE SPECIAL PROVISIONS SHALL BE PLACED BY THE CONTRACTOR TO THE SATISFACTION OF THE ENGINEER. ALL TRAFFIC CONTROL DEVICES SHALL BE CONSIDERED INCLUDED IN THE COST OF TRAFFIC CONTROL AND PROTECTION (SPECIAL) UNLESS OTHERWISE INDICATED WITHIN THESE GENERAL NOTES, PLANS OR SPECIAL PROVISIONS.
2. THE CONTRACTOR SHALL FURNISH, INSTALL, MAINTAIN AND REMOVE ALL SIGNS AND SIGN SUPPORTS REQUIRED FOR MAINTENANCE OF TRAFFIC.
3. THE CONTRACTOR SHALL BE RESPONSIBLE FOR PROVIDING LABOR, SIGNS AND TRAFFIC CONTROL DEVICES NECESSARY FOR THE MAINTENANCE OF TRAFFIC UNLESS NOTED OTHERWISE IN THE SPECIAL PROVISIONS.
4. THE CONTRACTOR SHALL CONTACT THE DISTRICT ONE TRAFFIC CONTROL SUPERVISOR AT (847) 705-4470 A MINIMUM OF 72 HOURS IN ADVANCE OF BEGINNING THE WORK.
5. TRAFFIC CONDITIONS, ACCIDENTS, AND OTHER UNFORESEEN EMERGENCY CONDITIONS MAY REQUIRE THE ENGINEER TO RESTRICT, MODIFY OR REMOVE LANE CLOSURES OR CHANNELIZATION SHOWN IN THE PLANS. THE CONTRACTOR SHALL PROMPTLY RESPOND TO THE TIME OF NOTIFICATION BY THE ENGINEER FOR THE MAINTENANCE OF TRAFFIC CONTROL DEVICES.
6. SIDE STREETS SHALL REMAIN OPEN AT ALL TIMES. SPECIAL CONSIDERATION MAY BE GIVEN TO A SHORT TERM CLOSURE ON AN AS NEEDED BASIS. THESE CLOSURES WILL BE COORDINATED WITH THE RESIDENT ENGINEER.
7. DRUMS OR TYPE II BARRICADES SHALL BE PROVIDED AS SHOWN IN THE PLANS AND SPACED 50 FEET CENTER TO CENTER IN TANGENTS, 20 FEET CENTER TO CENTER IN TAPERS AND 10 FEET CENTER TO CENTER IN CURVES AND RADII.
8. ALL EXISTING SIGNS THAT CONFLICT WITH THE TRAFFIC CONTROL PLAN SHALL BE COVERED OR REMOVED IN ACCORDANCE WITH ARTICLE 107.25 OF THE STANDARD SPECIFICATIONS.
9. ALL ROAD CONSTRUCTION AHEAD SIGNS, ONE LANE ROAD AHEAD SIGNS, AND TYPE III BARRICADES SHALL BE EQUIPPED WITH MONO-DIRECTIONAL TYPE A AMBER FLASHING LIGHTS.
10. THE CONTRACTOR SHALL BE REQUIRED TO REMOVE ALL EXISTING PAVEMENT MARKINGS WHICH CONFLICT WITH THE DESIGNATED TRAFFIC CONTROL PLAN.
11. ALL TEMPORARY PAVEMENT MARKINGS SHOWING DETERIORATION AFTER SEVEN (7) DAYS OF SERVICE SHALL BE REPLACED BY THE CONTRACTOR AS DIRECTED BY THE ENGINEER. ALL MARKINGS THAT REQUIRE REPLACEMENT PRIOR TO SEVEN (7) DAYS OF SERVICE SHALL BE REPLACED BY THE CONTRACTOR AT HIS EXPENSE.
12. THE CONTRACTOR SHALL BE RESPONSIBLE FOR PROVIDING LABOR, SIGNS AND TRAFFIC CONTROL DEVICES NECESSARY FOR THE MAINTENANCE OF TRAFFIC UNLESS NOTED OTHERWISE IN THE SPECIAL PROVISIONS.
13. ALL TRAFFIC CONTROL DEVICES SHALL BE REMOVED, COVERED OR TURNED AWAY FROM THE TRAFFIC IMMEDIATELY WHEN THEY ARE NO LONGER NECESSARY. WHEN A SIGN IS COVERED, ITS POST SHALL HAVE A REFLECTIVE 3" X 6" DELINEATOR INSTALLED. THE COST OF THE DELINEATOR IS INCLUDED IN THE COST OF TRAFFIC CONTROL AND PROTECTION (SPECIAL).
14. WORK ZONE SPEED LIMIT SHALL BE 35 MPH ON WOLF ROAD UNLESS NOTED OTHERWISE.
15. THE CONTRACTOR SHALL BE REQUIRED TO MAINTAIN TRAFFIC IN ACCORDANCE WITH THE TRAFFIC CONTROL PLANS, SPECIAL PROVISIONS, APPLICABLE STATE STANDARDS, AND AS DIRECTED BY THE ENGINEER. ANY CHANGES TO THE TRAFFIC CONTROL SHALL BE SUBMITTED TO THE ENGINEER FOR APPROVAL PRIOR TO IMPLEMENTING ANY CHANGES.
16. THE ENGINEER SHALL BE INFORMED 48 HOURS IN ADVANCE OF ANY PROPOSED CHANGE TO THE SUGGESTED STAGES OF CONSTRUCTION AND TRAFFIC CONTROL PLAN.

17. THE CONTRACTOR SHALL MAINTAIN A MINIMUM OF ONE THROUGH TRAVEL LANE IN EACH DIRECTION AND ONE SIDEWALK THROUGHOUT THE PROJECT AREA AT ALL TIMES.
18. THE CONTRACTOR SHALL PROVIDE ADEQUATE TEMPORARY DRAINAGE AND EROSION CONTROL PROTECTION DURING ALL PHASES OF CONSTRUCTION.
19. IMMEDIATELY AFTER THE COMPLETION OF CONSTRUCTION, THE CONTRACTOR SHALL RESTORE ALL PERMANENT PAVEMENT MARKINGS, SIGNS, AND OTHER TRAFFIC CONTROL DEVICES THAT WERE COVERED, REMOVED, DAMAGED OR OTHERWISE AFFECTED BY CONSTRUCTION.
20. THE CONTRACTOR SHALL PLACE A CHANGEABLE MESSAGE SIGN AT EACH END OF THE PROJECT AND/OR AS DIRECTED BY THE ENGINEER TO INFORM MOTORISTS OF UPCOMING CONSTRUCTION ACTIVITIES. THE MESSAGE SIGNS WITH APPROPRIATE INFORMATION SHALL BE PLACED AS DIRECTED BY THE ENGINEER.

**SUGGESTED SEQUENCE OF CONSTRUCTION & MAINTENANCE OF TRAFFIC**

STAGE I

1. INSTALL EROSION CONTROL DEVICES PER SHEETS 17 AND 18. MAINTAIN TRAFFIC USING IDOT STANDARD 701101.
2. INSTALL STAGE I TRAFFIC CONTROL. SHIFT TRAFFIC TO THE WEST SIDE OF THE EXISTING BRIDGE PAVEMENT.
3. REMOVE EXISTING CMP'S FROM UNDER THE BRIDGE.
4. INSTALL NEW GATE VALVE IN NEW VALVE VAULT. PATCH THE PAVEMENT.
5. REMOVE AND LOWER EXISTING WATER MAIN UNDER THE BRIDGE.
6. INSTALL FLARED END SECTIONS AND DITCH RIPRAP PER THE PLANS.
7. REMOVE EXISTING NORTHBOUND WEARING SURFACE WITHIN THE STAGE I CONSTRUCTION WORK ZONE.
8. CONSTRUCT CONCRETE WEARING SURFACE ON THE EAST SIDE OF THE BRIDGE DECK AND THE HOT MIX ASPHALT SURFACE ON THE EAST SIDE OF THE APPROACHES WITHIN THE STAGE I CONSTRUCTION WORK ZONE.
9. REPAIR THE SIDEWALK ON THE EAST SIDE OF THE BRIDGE.
10. REMOVE THE CONCRETE STEPS AND REPLACE WITH ADA COMPLIANT SIDEWALK PER THE PLANS.
11. LANDSCAPE RESTORATION PER THE PLANS.
12. REMOVE STAGE I TRAFFIC CONTROL AND PLACE STAGE II TRAFFIC CONTROL DEVICES AND TEMPORARY PAVEMENT MARKING PER PLAN. UTILIZE IDOT STANDARD TRAFFIC CONTROL STANDARDS TO MAINTAIN TRAFFIC.

STAGE II

1. SHIFT TRAFFIC TO THE EAST SIDE OF THE BRIDGE UTILIZING THE NEW BRIDGE PAVEMENT.
2. REMOVE EXISTING SOUTHBOUND WEARING SURFACE WITHIN THE STAGE II CONSTRUCTION WORK ZONE.
3. CONSTRUCT CONCRETE WEARING SURFACE ON THE WEST SIDE OF THE BRIDGE DECK AND THE HOT MIX ASPHALT SURFACE ON THE WEST SIDE OF THE APPROACHES WITHIN THE STAGE II CONSTRUCTION WORK ZONE.
4. REPAIR THE SIDEWALK ON THE WEST SIDE OF THE BRIDGE.
5. REMOVE SECTIONS OF WEST SIDE BRIDGE RAIL IN LOCATIONS SHOWN IN BRIDGE REPAIR PLANS.
6. REPAIR THE WEST SIDE BRIDGE RAIL ANCHORS. REERECT THE REMOVED WEST SIDE BRIDGE RAIL SECTIONS.
7. REMOVE TEMPORARY PAVEMENT MARKING AND PLACE PERMANENT PAVEMENT MARKING. REMOVE TEMPORARY EROSION CONTROL DEVICES. UTILIZE IDOT STANDARD TRAFFIC CONTROL STANDARDS TO MAINTAIN TRAFFIC.

FILE NAME = Q:\Engineering\Live\Projects\13003 IDOT DUR\13003a - W0 1 Contract No. 60W53\CADD\CADD Sheets\Civil\0160M53-Sht-Stageing00.dgn



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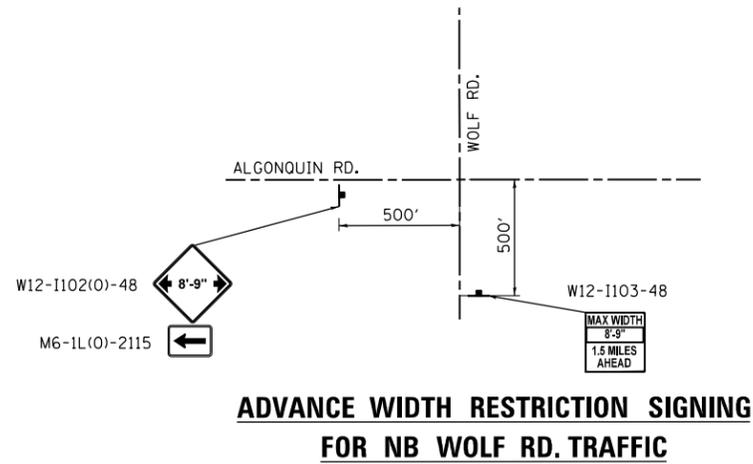
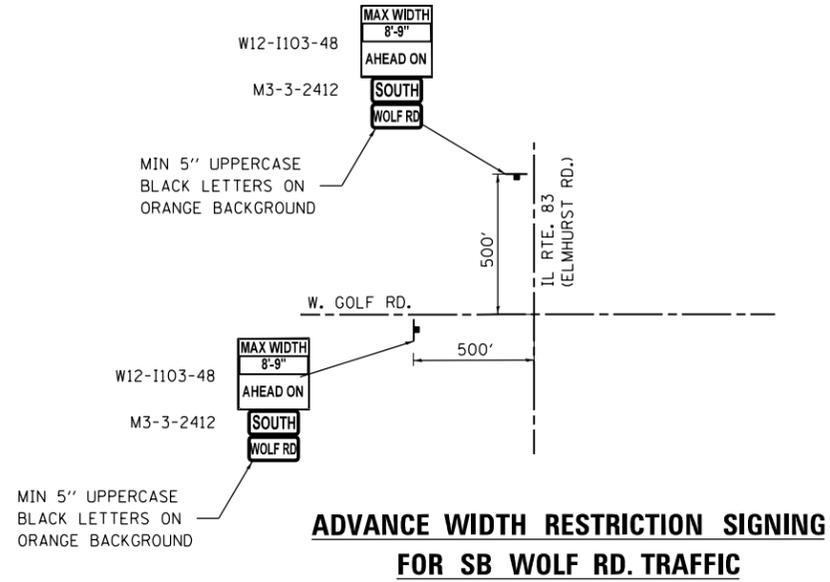
**STATE OF ILLINOIS  
DEPARTMENT OF TRANSPORTATION**

**TRAFFIC CONTROL PLAN - TYPICAL SECTIONS AND NOTES  
WOLF ROAD AT WELLER'S DITCH**

SCALE: SHEET OF SHEETS STA. TO STA.

F.A.U. RTE.	SECTION	COUNTY	TOTAL SHEETS	SHEET NO.
2691	3434.1-BR(13)	COOK	58	16
CONTRACT NO. 60W53				
ILLINOIS FED. AID PROJECT				

FILE NAME = Q:\Engineering\LiveProjects\13003 IDOT DUR\13003 - W0 1 Contract No. 60W53\CADD\CADD Sheets\Civil\160M53-Sht-Staging\_00A.dgn





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**STATE OF ILLINOIS  
DEPARTMENT OF TRANSPORTATION**

**TRAFFIC CONTROL PLAN - ADVANCE WIDTH RESTRICTION SIGNING  
WOLF ROAD AT WELLS DITCH**

SCALE: SHEET OF SHEETS STA. TO STA.

F.A.U. RTE.	SECTION	COUNTY	TOTAL SHEETS	SHEET NO.
269I	3434.1-BR(13)	COOK	58	16A
<b>CONTRACT NO. 60W53</b>				
ILLINOIS FED. AID PROJECT				

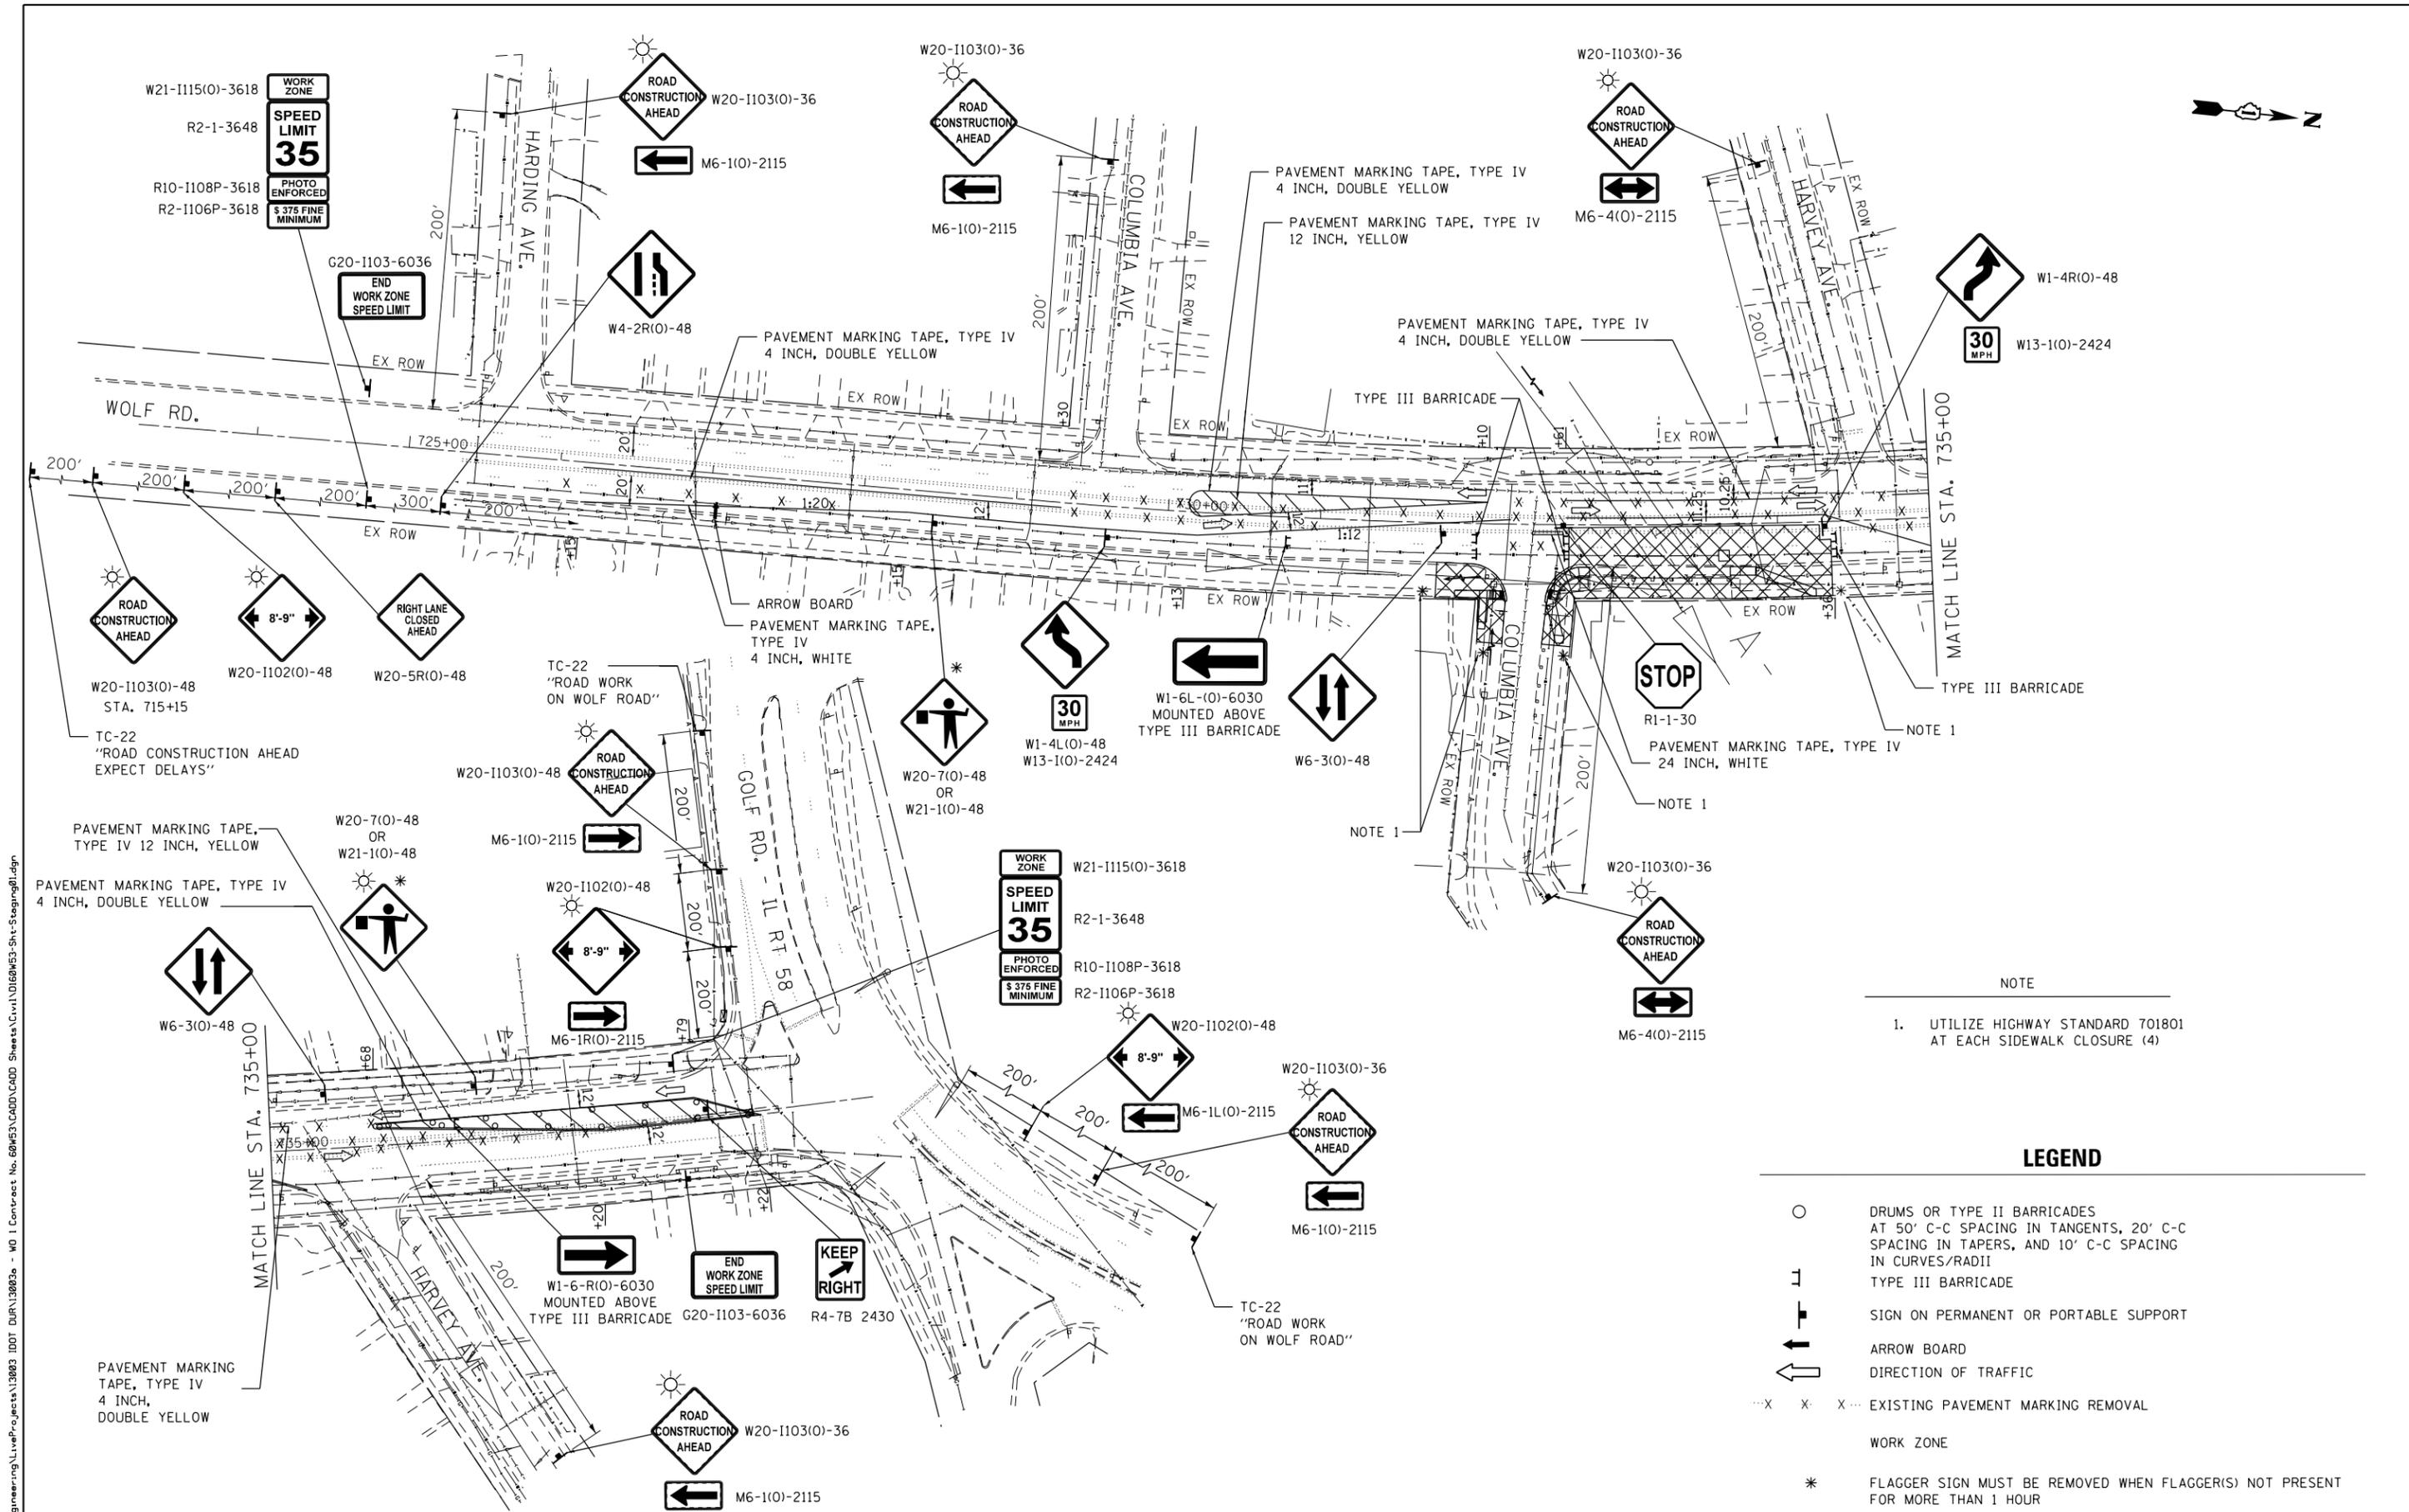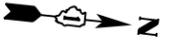

NOTE  
 1. UTILIZE HIGHWAY STANDARD 701801 AT EACH SIDEWALK CLOSURE (4)

**LEGEND**

- DRUMS OR TYPE II BARRICADES AT 50' C-C SPACING IN TANGENTS, 20' C-C SPACING IN TAPERS, AND 10' C-C SPACING IN CURVES/RADII
- ⊥ TYPE III BARRICADE
- SIGN ON PERMANENT OR PORTABLE SUPPORT
- ARROW BOARD
- DIRECTION OF TRAFFIC
- X X X--- EXISTING PAVEMENT MARKING REMOVAL
- WORK ZONE
- \* FLAGGER SIGN MUST BE REMOVED WHEN FLAGGER(S) NOT PRESENT FOR MORE THAN 1 HOUR

FILE NAME = Q:\Engineering\LiveProjects\13003 IDOT DUR\13003 - W0 1 Contract No. 60W53\CADD\CADD Sheets\Cv\1\0160M53-Sht-Stageing.dgn



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	DATE - 4/12/2018	REVISED -

**STATE OF ILLINOIS  
 DEPARTMENT OF TRANSPORTATION**

**TRAFFIC CONTROL PLAN - STAGE I  
 WOLF ROAD AT WELLER'S DITCH**

SCALE: SHEET OF SHEETS STA. 718+15 TO STA. 738+25

F.A.U. RTE.	SECTION	COUNTY	TOTAL SHEETS	SHEET NO.
2691	3434.1-BR(13)	COOK	58	17
CONTRACT NO. 60W53				
ILLINOIS FED. AID PROJECT				



**EROSION AND SEDIMENT CONTROL NOTES:**

- ALL CONTROL MEASURES NECESSARY MUST MEET THE MINIMUM REQUIREMENTS AS DESCRIBED IN THE LATEST EROSION AND SEDIMENT CONTROL FIELD GUIDE FOR CONSTRUCTION INSPECTION BY THE ILLINOIS DEPARTMENT OF TRANSPORTATION. ADDITIONAL DETAILS AND BMPs ARE ALSO AVAILABLE AND CAN BE UTILIZED AS SHOWN IN THE ILLINOIS URBAN MANUAL, REVISED TO LATEST VERSION AS AMENDED. ALL ESC MEASURES WILL BE MAINTAINED IN ACCORDANCE WITH THE IDOT EROSION AND SEDIMENT CONTROL FIELD GUIDE FOR CONSTRUCTION INSPECTION AND IDOT'S BEST MANAGEMENT PRACTICES - MAINTENANCE GUIDE: (HTTP://WWW.IDOT.ILLINOIS.GOV/TRANSPORTATION-SYSTEM/ENVIRONMENT/EROSION-AND-SEDIMENT-CONTROL).
- ALL THE SOIL EROSION AND SEDIMENT CONTROL FEATURES MUST BE CONSTRUCTED PRIOR TO THE COMMENCEMENT OF UPLAND DISTURBANCE. SOIL DISTURBANCE MUST BE PHASED OR ENACTED IN SUCH A MANNER AS TO MINIMIZE EROSION. SOIL STABILIZATION MEASURES MUST CONSIDER THE TIME OF YEAR, SITE CONDITION AND THE USE OF TEMPORARY AND/OR PERMANENT MEASURES.
- IT IS THE RESPONSIBILITY OF THE CONTRACTOR TO ENSURE THAT SEDIMENT TRANSPORT OF THE SITE IS REDUCED BY A COMBINATION OF MINIMIZATION OF EROSION AT THE SOURCE AND WITH THE INSTALLATION OF SPECIFIC MEASURES TO CONTROL OR REDUCE THE TRANSPORT OF SEDIMENT. A COPY OF THE EROSION AND SEDIMENT CONTROL SCHEDULE BEING IMPLEMENTED BY THE CONTRACTOR OF WHICH APPROVED BY THE ENGINEER, WILL BE ON THE CONSTRUCTION SITE AT ALL TIMES.
- ALL RUNOFF ORIGINATING ON DISTURBED AREAS ASSOCIATED WITH THIS PROJECT WILL PASS THROUGH ONE OR MORE MEASURES THAT WILL MINIMIZE THE OFF-SITE SEDIMENT IMPACTS OF THE CONSTRUCTION ACTIVITIES.
- DISTURBED AREAS ARE TO BE PROTECTED FROM EROSION IN A TIMELY MANNER. UPON COMPLETION OF GRADING OR CONSTRUCTION ACTIVITY, THE AREA WILL BE STABILIZED (USING PERMANENT MEASURES WHEN POSSIBLE) WITHIN ONE (1) CALENDAR DAY.
- THE CONTRACTOR MUST CLEAN UP, GRADE THE WORK AREA AS THE PROJECT PROGRESSES AND INSTALL EROSION PROTECTION TO ELIMINATE THE CONCENTRATION OF RUNOFF, OR MUST INSTALL APPROPRIATE SEDIMENT CONTROL DEVICES TO TRAP SEDIMENT. PAVEMENT MUST BE CLEANED DAILY OR AS NECESSARY TO REMOVE EARTHEN MATERIAL TO THE SATISFACTION OF THE ENGINEER OR AUTHORIZED IDOT PERSONNEL.
- STABILIZATION OF CUT OR FILL SLOPES WITH TEMPORARY OR PERMANENT EROSION CONTROL MEASURES IS REQUIRED WHENEVER THE CUT OR FILL ACTIVITY REACHES 10-FT VERTICALLY OR THE FINISHED SLOPE EQUALS 30-FT, WHICHEVER IS MORE RESTRICTIVE. ONCE THE STABILIZATION MEASURES ARE INSTALLED, THE PLACEMENT OF FILL EXCAVATION ACTIVITIES ARE ALLOWED TO PROCEED.
- THE CONTRACTOR WILL ASSUME RESPONSIBILITY FOR MAINTENANCE OF ALL SOIL EROSION CONTROL DURING CONSTRUCTION. THE CONTRACTOR SHALL DESIGNATE ONE OF HIS EMPLOYEES TO BE RESPONSIBLE FOR IMPLEMENTATION OF THE EROSION AND SEDIMENT CONTROL PLAN ON ALL DISTURBED AREAS THROUGHOUT THE PROJECT.
- THE CONTRACTOR'S REPRESENTATIVE AND THE ENGINEER MUST KEEP A WRITTEN REPORT SUMMARIZING THE REQUIRED INSPECTIONS TAKEN PLACE. THE REPORTS MUST BE KEPT AT THE SITE DURING CONSTRUCTION. THE REPORT MUST ALSO BE RETAINED FOR THREE YEARS FROM THE DATE THE SITE IS FINALLY STABILIZED.
- THE CONTRACTOR'S REPRESENTATIVE HAS TO BE KNOWLEDGEABLE ABOUT INSTALLATION AND MAINTENANCE OF THE REQUIRED MEASURES AND HAVE TAKEN AN ILLINOIS DEPARTMENT OF TRANSPORTATION OR APPROVED EQUAL EROSION AND SEDIMENT CONTROL COURSE. THIS PERSON SHALL HAVE THE AUTHORITY TO CARRY OUT THE IMPLEMENTATION OF ANY INSTRUCTION CONCERNING THE EROSION AND SEDIMENT CONTROL PLAN PROVIDED BY THE ENGINEER. THIS INDIVIDUAL AND THE ENGINEER MUST MAKE INSPECTIONS A MINIMUM OF ONCE EVERY SEVEN DAYS OF THE FOLLOWING:
  - DISTURBED AREAS OF THE PROJECT SITE THAT HAVE NOT BEEN FULLY STABILIZED.
  - STRUCTURAL CONTROL MEASURES (SUCH AS PERIMETER EROSION BARRIER, ETC.)
  - LOCATIONS WHERE VEHICLES ENTER OR EXIT THE PROJECT SITE.
  - AN ADDITIONAL INSPECTION OF THE ITEMS LISTED ABOVE MUST BE MADE WITHIN 24-HOURS AFTER A 24-HOUR RAINFALL OR EQUIVALENT SNOWFALL EVENT GREATER THAN 0.5-INCH. DURING WINTER MONTHS, ALL MEASURES MUST BE CHECKED BY THE CONTRACTOR AFTER EACH SIGNIFICANT SNOWMELT.
- ALL THE EROSION AND SEDIMENT CONTROL MEASURES SHALL BE MAINTAINED DURING THE CONSTRUCTION SEASON, AS WELL AS OVER THE WINTER SHUTDOWN PERIOD AND OTHER DAYS WHEN THE PROJECT IS CLOSED DOWN FOR A LONGER DURATION. ANY CONTROL MEASURES FILLED MORE THAN 75% MUST BE CLEANED AND RESET AND THESE SPOILS REMOVED TO AN APPROVED SITE.

- SALVAGED TOPSOIL SHALL BE PLACED ON WELL DRAINED LAND AWAY FROM INTERMITTENT AND ACTIVE DRAINAGE PATHS WITH THE APPROPRIATE RUNOFF CONTROL AND SEDIMENT CONTROL MEASURES INSTALLED AROUND THE STORAGE SITE. IMMEDIATELY AFTER THE FINAL SHAPING OF THE STOCKPILE, THE TOPSOIL WILL BE STABILIZED IN ACCORDANCE WITH THE METHOD APPROVED BY IDOT. THE CONTRACTOR WILL PROVIDE ADEQUATE QUANTITY OF SILT FENCE TO CONTROL THE PERIMETER OF THE STOCKPILE.
- EXCAVATION TO BE USED FOR EMBANKMENTS SHALL NOT BE STOCKPILED UNLESS PERIMETER CONTROLS ARE UTILIZED. WHEN THIS MATERIAL IS STOCKPILED FOR THE CONVENIENCE OF THE CONTRACTOR, THE COST OF THE CONTROLS WILL BE BORNE BY THE CONTRACTOR. IF THE MATERIAL IS STOCKPILED AT THE DIRECTION OF THE ENGINEER, THE DEPARTMENT WILL ASSUME THE COST OF INSTALLING AND MAINTAINING THE CONTROLS.
- IF AND/OR WHEN THE CONTRACTOR REQUESTS CHANGE TO POSTPONE COMPLETION OF THE EXCAVATION OF A SPECIFIC AREA AS A CONTINUOUS OPERATION AND PLACING THE TOPSOIL AS DEFINED IN THE STANDARD SPECIFICATIONS, THE ENGINEER MAY ALLOW THE CONTRACTOR TO STABILIZE THE AREA USING TEMPORARY STABILIZATION WITH STRAW MULCH 25 FEET AWAY FROM THE SHOULDER OF THE ROAD PROVIDED THE FOLLOWING CONDITIONS ARE MET:
  - ALL AREAS BEING STABILIZED ARE 1:3 SLOPES OR FLATTER
  - THE CONTRACTOR BEARS THE COST OF PREPARING THE SEED BED AND STABILIZING THE AREA WITH TEMPORARY STABILIZATION WITH MULCH METHOD 3.
  - ALL REQUIRED SEDIMENT CONTROL MEASURES FOR THE SECTION OF ROAD IN QUESTION HAVE BEEN INSTALLED AND ARE BEING MAINTAINED.
- TOPSOIL PLACEMENT: TOPSOIL WILL BE PLACED ON FINAL SLOPES WHICH WILL NOT BE DISTURBED BY FUTURE CONSTRUCTION. TOPSOIL WILL NOT BE PLACED ON SURFACES WHICH WILL BE PAVED IN THE FUTURE NOR ON TEMPORARY STEEP SLOPES.
- IN AREAS WHERE A PERMANENT VEGETATIVE COVER IS PRACTICABLE AND INCLUDED IN THE CONTRACT DOCUMENTS, A SPECIAL EFFORT SHOULD BE MADE TO ESTABLISH A COVER AS SOON AS A DISTURBED AREA IS BROUGHT TO FINAL GRADE. UNDER NO CIRCUMSTANCES SHALL THE CONTRACTOR PROLONG FINAL GRADING AND SHAPING SO THAT THE ENTIRE PROJECT CAN BE PERMANENTLY SEEDED AT ONE TIME.
- THE CONTRACTOR'S REPRESENTATIVE AND THE ENGINEER MUST KEEP A WRITTEN REPORT SUMMARIZING THE REQUIRED INSPECTIONS. THE REPORTS MUST BE KEPT AT THE SITE DURING CONSTRUCTION. THE REPORT MUST ALSO BE RETAINED FOR THREE YEARS FROM THE DATE THE SITE IS FINALLY STABILIZED.
- ANY SEDIMENT LADEN DEWATERING DISCHARGE MUST BE DIRECTED TO AN APPROVED SEDIMENT TRAPPING CONTROL MEASURE PRIOR TO RELEASE FROM THE PROJECT SITE.
- NO WORK IS ALLOWED BEYOND THE PERMITTED AREA, ANY WORK WITHIN A SWALE OR DITCH CAPABLE OF CONVEYING WATER MUST BE CONDUCTED IN THE DRY. PROVISIONS MUST BE MADE TO BYPASS PUMP OR DEWATER ANY AREAS IN WHICH WORK WILL BE CONDUCTED. IN HIGH FLOW CHANNELS WHERE DEWATERING IS NOT POSSIBLE OR PRACTICAL, SILT FENCE OR SEDIMENT CURTAINS MAY BE INSTALLED PARALLEL TO THE STREAM BANK. IN NO CASE WILL THE CURTAINS BE INSTALLED PERPENDICULAR TO THE FLOW.
- SEEDING USAGE
 

CLASS 1A:  
USED AT FINAL DISTURBED CONSTRUCTION AREAS INDICATED ON THE PLANS.

TEMPORARY EROSION CONTROL SEEDING:  
USED IN AREAS REQUIRING SHORT TERM TEMPORARY SEEDING DURING CONSTRUCTION.
- THE CONTRACTOR MUST COOPERATE WITH THE ENGINEER AND HIS/HER REPRESENTATIVE WHO WILL MAKE THE SITE VISITS TO REVIEW THE COMPLIANCE OF THE PLAN IN THE FIELD AND AUDIT IF NECESSARY. THE CONTRACTOR MUST PREPARE THE LOGS AND RECORDS WHEN REQUIRED AND SUBMIT TO IDOT AND/OR APPROPRIATE AGENCIES.
- STABILIZATION MEASURES SHALL BE INITIATED IMMEDIATELY WHERE CONSTRUCTION ACTIVITIES HAVE TEMPORARILY OR PERMANENTLY CEASED, BUT IN NO CASE MORE THAN ONE (1) DAY AFTER THE CONSTRUCTION ACTIVITY IN THAT PORTION OF THE SITE HAS TEMPORARILY OR PERMANENTLY CEASED ON ALL DISTURBED PORTIONS OF THE SITE WHERE CONSTRUCTION WILL NOT OCCUR FOR A PERIOD OF FOURTEEN (14) OR MORE CALENDER DAYS.

- THE INSTALLATION, MAINTENANCE, REMOVAL AND RESTORATION OF THE AREA DISTURBED BY THE PLACEMENT OF THE PERIMETER EROSION BARRIER ARE INCLUDED IN THE CONTRACT UNIT PRICE FOR PERIMETER EROSION BARRIER. AFTER ALL PERIMETER EROSION BARRIER IS REMOVED, THE AREAS DAMAGED BY THE PERIMETER EROSION CONTROL BARRIER MUST BE RESTORED TO ITS ORIGINAL CONDITION.
- THE CONTRACTOR MUST COOPERATE WITH THE ENGINEER AND HIS/HER REPRESENTATIVE WHO WILL MAKE THE SITE VISITS TO REVIEW THE COMPLIANCE OF THE PLAN IN THE FIELD AND AUDIT IF NECESSARY. THE CONTRACTOR MUST PREPARE THE LOGS AND RECORDS WHEN REQUIRED AND SUBMIT TO IDOT AND/OR APPROPRIATE AGENCIES.
- PERIMETER EROSION BARRIER SHOULD BE ERECTED ALONG THE DRIPLINE OF THE TREES AND SHRUBS WITHIN THE LIMITS OF CONSTRUCTION DESIGNATED TO REMAIN TO ESTABLISH A TREE PROTECTION ZONE BEFORE ANY WORK BEGINS OR ANY MATERIAL IS DELIVERED TO THE JOBSITE. NO WORK IS TO BE PERFORMED (OTHER THAN ROOT PRUNING). MATERIALS STORED OR VEHICLES DRIVEN OR PARKED WITHIN THE TREE PROTECTION ZONE. REMOVE PROTECTIVE PERIMETER EROSION BARRIER ONLY AFTER ALL CONSTRUCTION WORK HAS BEEN COMPLETED.
- TEMPORARY OR PERMANENT STABILIZATION SHALL BE INITIATED IMMEDIATELY UPON COMPLETION OF DISTURBANCE OR IF THE WORK AREA IS TO BE LEFT UNDISTURBED FOR 14 DAYS OR MORE.
- EROSION CONTROL ITEMS ARE CONSIDERED TO BE A HIGH PRIORITY ON THIS CONTRACT. THE CONTRACTOR IS RESPONSIBLE FOR INSTALLATION OF ANY ADDITIONAL EROSION CONTROL MEASURES NECESSARY TO PREVENT EROSION AND SEDIMENTATION AS DETERMINED BY THE ENGINEER.
- THE CONTRACTOR IS REQUIRED TO PROVIDE WASHOUT FACILITIES TO COMPLY WITH EROSION CONTROL PERMITS.

**SOIL PROTECTION SCHEDULE:**

STABILIZATION TYPE	JAN.	FEB.	MAR.	APR.	MAY	JUN.	JUL.	AUG.	SEP.	OCT.	NOV.	DEC.
PERMANENT SEEDING						→					→	
DORMANT SEEDING	→		→								→	→
TEMPORARY SEEDING										→		
EROSION BLANKET / HYDROMULCH											→	

**EROSION AND SEDIMENT CONTROL STRATEGY:**

- ERECT PERIMETER EROSION BARRIERS AS SHOWN ON PLANS.
- CLEAR AND GRUB, REMOVE EXISTING TREES AND BUSHES AS NECESSARY.
- INSPECT AND MAINTAIN ALL EROSION AND SEDIMENT CONTROL MEASURES FOR THE DURATION OF CONSTRUCTION.
- TEMPORARY STABILIZATION OF EACH STAGE SHOULD BE COMPLETED BEFORE WORK IS MOVED TO SUBSEQUENT STAGES.
- STABILIZE DISTURBED AREAS WITH TEMPORARY EROSION CONTROL MEASURES. USE THE PERMANENT SEEDING WITH EROSION CONTROL BLANKET FOR PERMANENT STABILIZATION AS SHOWN ON THE PLANS.
- WHEN THE PERMANENT STABILIZATION IS ESTABLISHED, REMOVE ALL REMAINING TEMPORARY EROSION CONTROL MEASURES.

**HIGHWAY STANDARDS:**

STD. NO. 280001 TITLE TEMPORARY EROSION CONTROL SYSTEM

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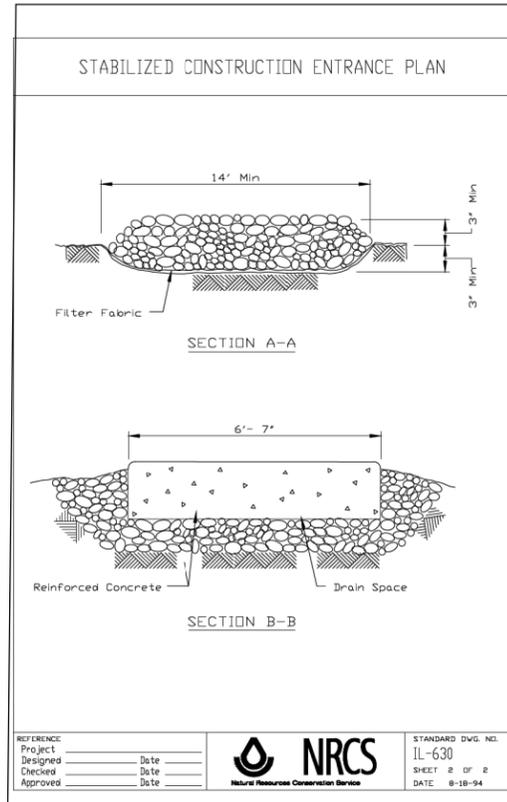
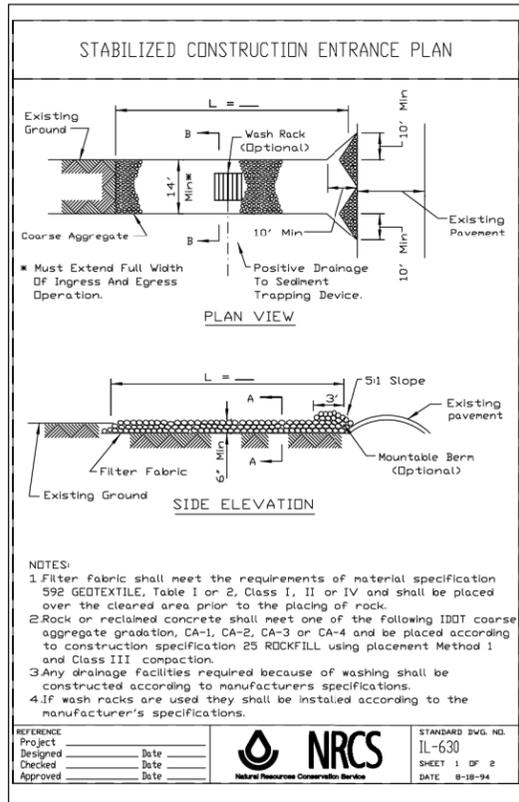
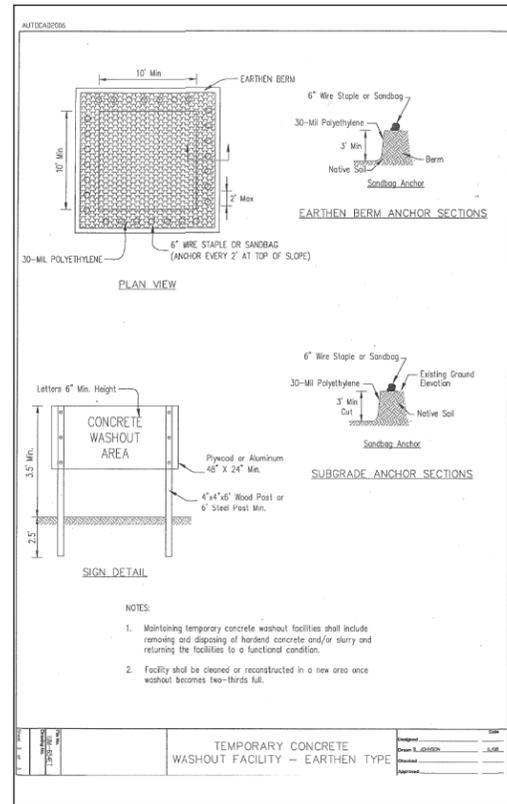
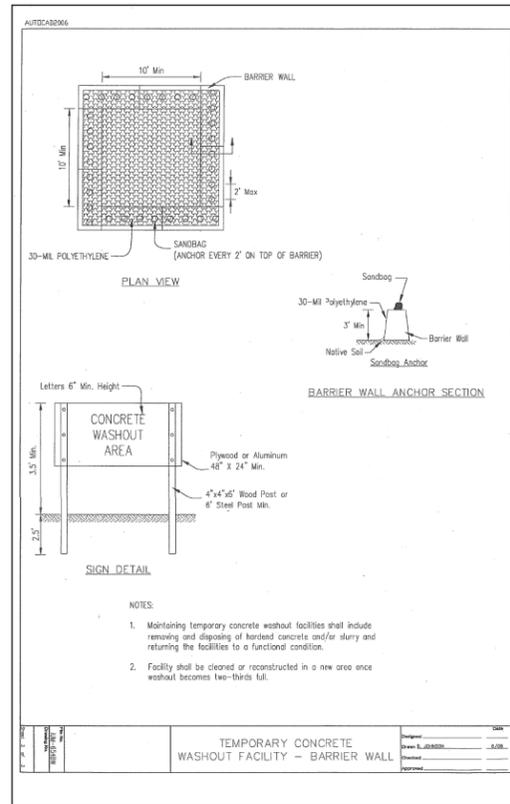
EROSION AND SEDIMENT CONTROL NOTES  
WOLF ROAD AT WELLER'S DITCH

SCALE: SHEET OF SHEETS STA. TO STA.

F.A.U. RTE.	SECTION	COUNTY	TOTAL SHEETS	SHEET NO.
2691	3434.1-BR(13)	COOK	58	19
CONTRACT NO. 60W53				
ILLINOIS FED. AID PROJECT				



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 CHECKED - JMT  
 DATE - 3/12/2018

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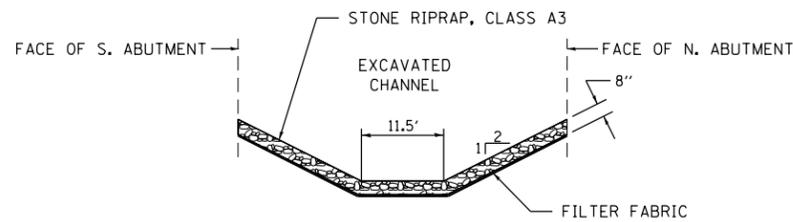
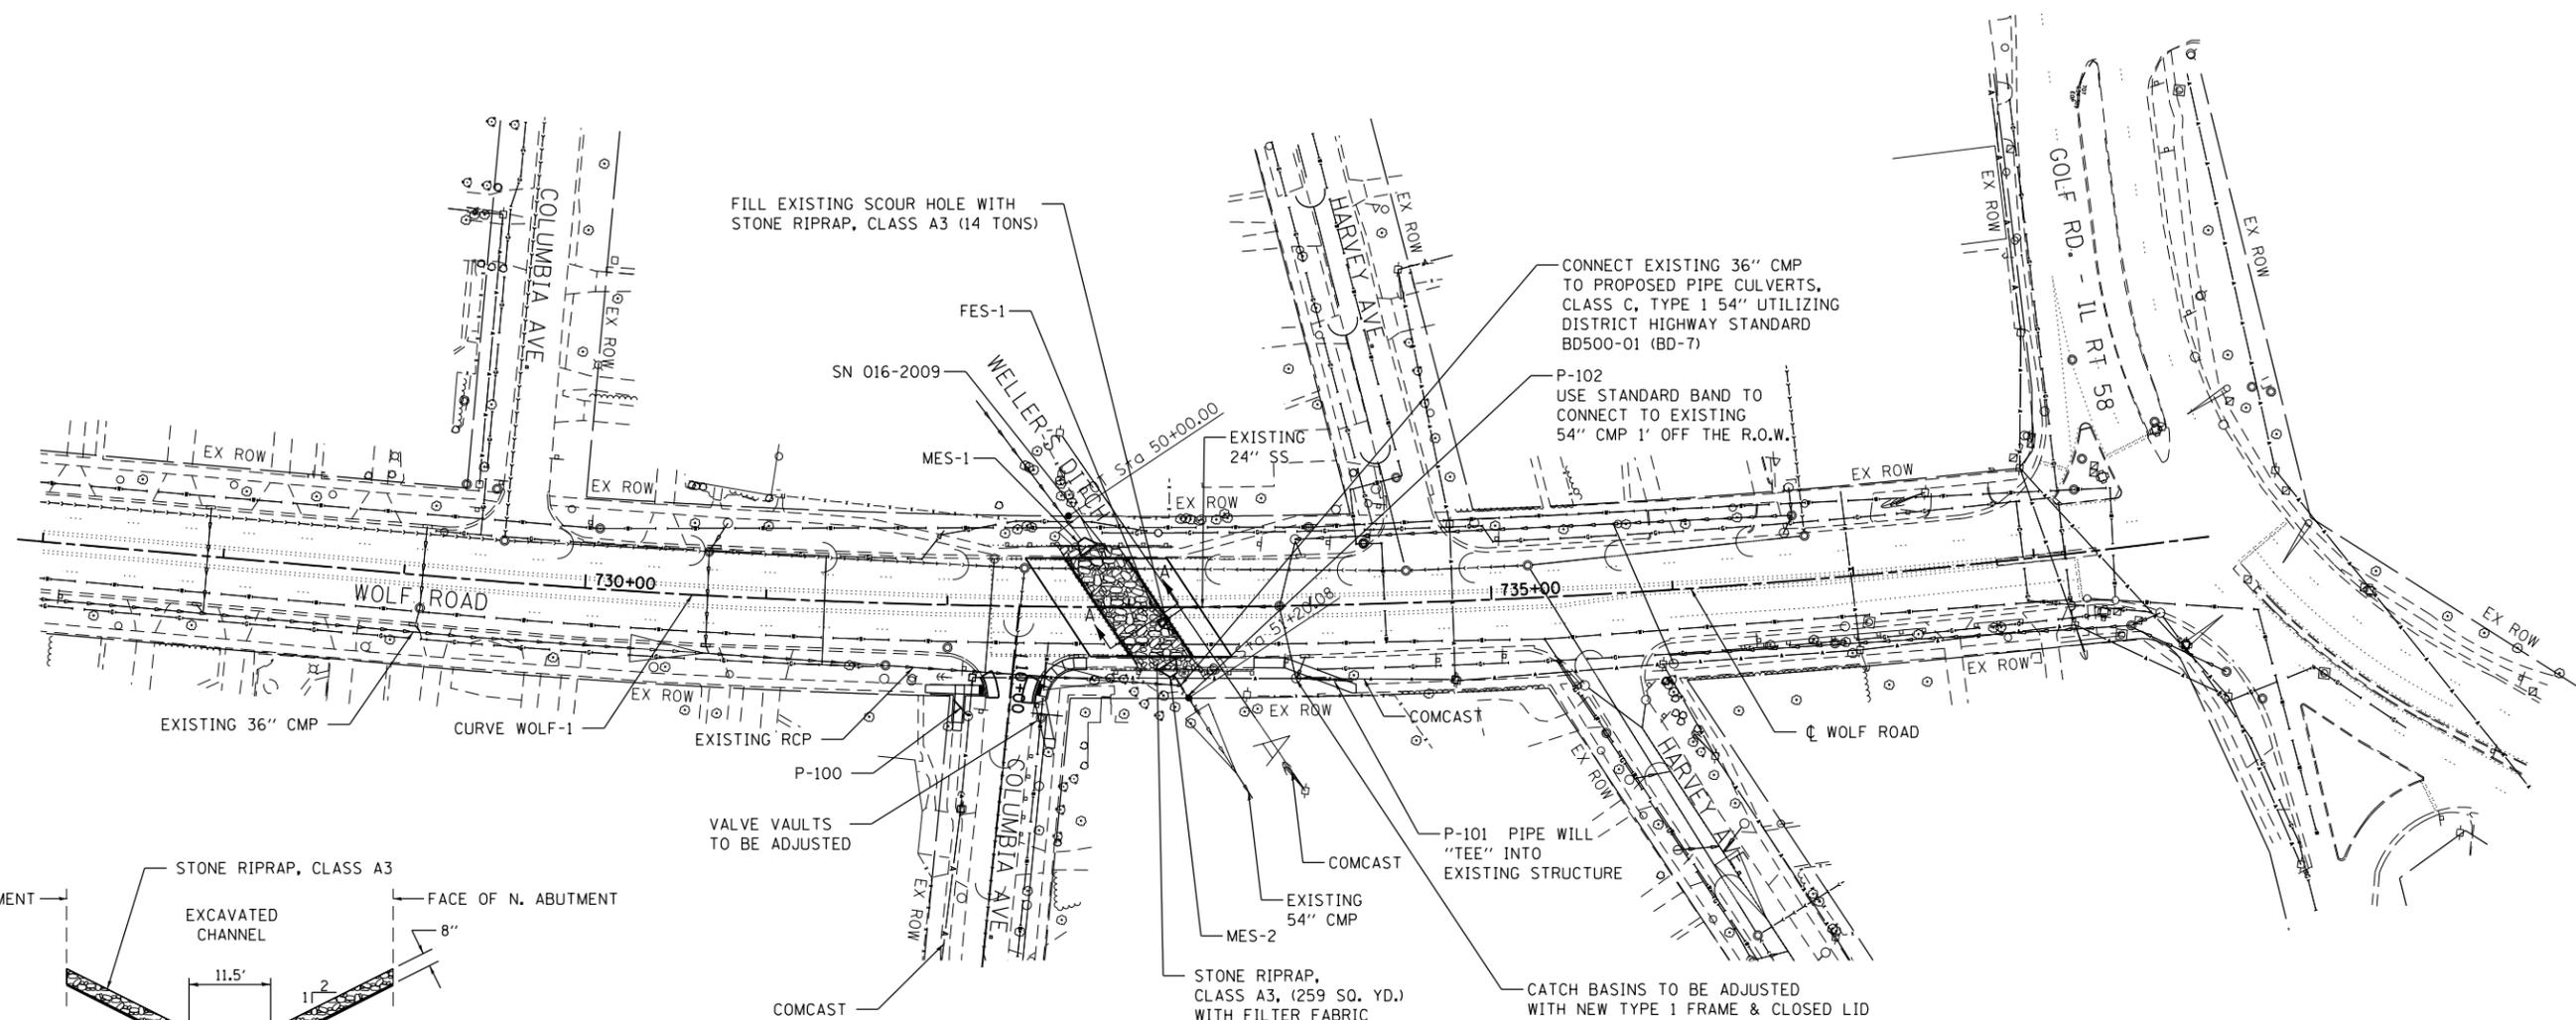
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 DEPARTMENT OF TRANSPORTATION**


**EROSION AND SEDIMENT CONTROL DETAILS  
 WOLF ROAD AT WELLER'S DITCH**

SCALE: SHEET 3 OF 3 SHEETS STA. TO STA.

F.A.U. RTE.	SECTION	COUNTY	TOTAL SHEETS	SHEET NO.
2691	3434.1-BR(13)	COOK	58	21
CONTRACT NO. 60W53				
ILLINOIS FED. AID PROJECT				



**SECTION A-A**

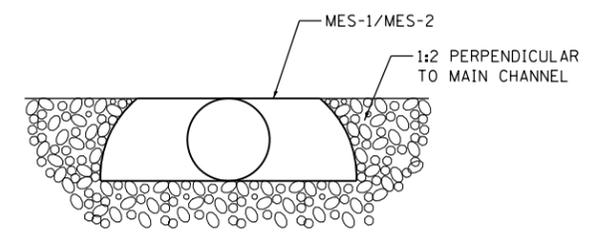


**CHANNEL ENDS**

PROPOSED PIPE SCHEDULE							
PIPE NO.	LENGTH (FT)	DIA. (IN)	PIPE TYPE	SLOPE %	TRENCH BACKFILL	UPSTREAM INVERT	DOWNSTREAM INVERT
P-100	11.5	10	CLASS C, TYPE 1, PVC	10.8	1.6 CU. YD.	639.15	637.91
P-101	32	10	CLASS C, TYPE 1, PVC	1.25	4.4 CU. YD.	640.20	639.80
P-102	14	54	CLASS C, TYPE 1, CMP	0.90	6.0 CU. YD.	631.30	631.10*

PROPOSED END SECTION SCHEDULE					
SECTION NO.	DIA. (IN)	MATERIAL	END STATION	OFFSET (FT)	INVERT
FES-1	24	PRECAST REINFORCED CONCRETE FLARED	733+16.8	9.3 RT	634.00
MES-1	54	METAL	732+77.8	31.4 LT	632.00*
MES-2	54	METAL	733+20.9	31.2 RT	631.30

\*MATCH INVERT AT ENDS OF 54" DIA CMP TO REMAIN

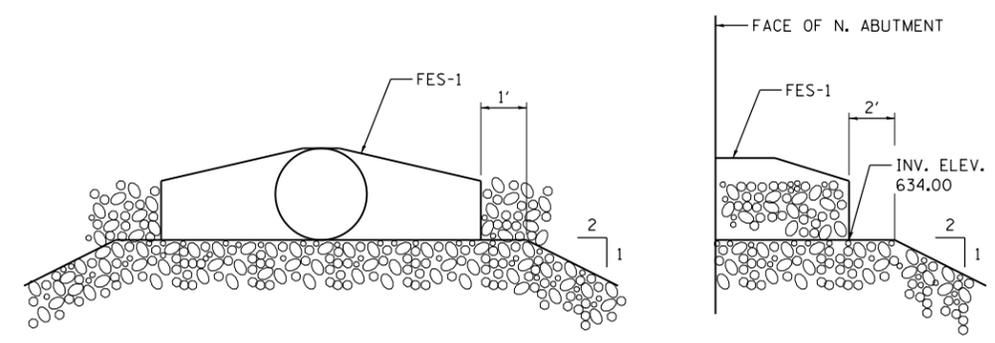

**FES -1 SUPPORT**

FILE NAME = Q:\Engineering\LiveProjects\13003 IDOT DUR\13003a - W0 1 Contract No. 60W53\CADD\CADD Sheets\Cv1\13003a-Sht-D-Drainage.dgn



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**STATE OF ILLINOIS  
DEPARTMENT OF TRANSPORTATION**



**DRAINAGE AND UTILITY PLAN  
WOLF ROAD AT WELLER'S DITCH**

SCALE: SHEET OF SHEETS STA. 731+83.0 TO STA. 734+24.07

F.A.U. RTE.	SECTION	COUNTY	TOTAL SHEETS	SHEET NO.
2691	3434.1-BR(13)	COOK	58	22
CONTRACT NO. 60W53				
ILLINOIS FED. AID PROJECT				



STANDARD DESIGN FOR VALVE VAULT  
(TYPE A)

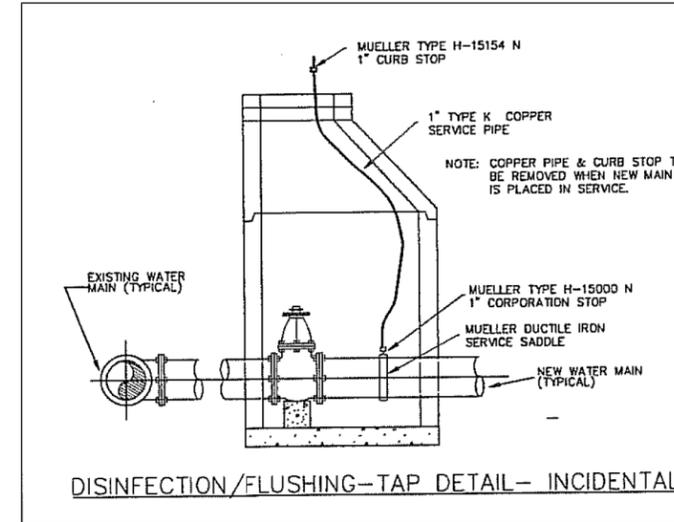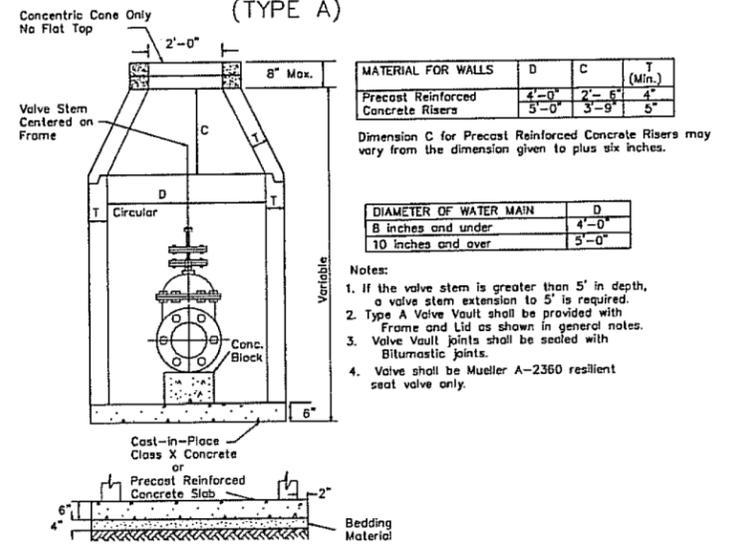

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PLOT DATE = 3/12/2018	DATE - 3/12/2018	REVISED - _____

STATE OF ILLINOIS  
DEPARTMENT OF TRANSPORTATION

WATER MAIN DETAILS  
WOLF ROAD AT WELLER'S DITCH

SCALE: \_\_\_\_\_ SHEET \_\_\_\_ OF SHEETS STA. \_\_\_\_\_ TO STA. \_\_\_\_\_

F.A.U. RTE.	SECTION	COUNTY	TOTAL SHEETS	SHEET NO.
2691	3434.1-BR(13)	COOK	58	24
				CONTRACT NO. 60W53
ILLINOIS FED. AID PROJECT				



STATE OF ILLINOIS  
 DEPARTMENT OF PUBLIC WORKS & BUILDING  
 DIVISION OF HIGHWAYS  
**R/W STRIP MAP**  
 EYANSTON ELGIN ROAD  
 S.B.I. ROUTE 582

CHECKED BY: \_\_\_\_\_ REVISION: \_\_\_\_\_  
 DRAWN BY: \_\_\_\_\_ DATE: \_\_\_\_\_

**FOR INFORMATION ONLY**

FILE NAME = G:\Engineering\LiveProjects\13003 IDOT DUR\13003a - W0 1 Contract No. 60W53\CADD\CADD Sheets\Civil\13003a-Sht-Strip Map01.dgn



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STATE OF ILLINOIS  
 DEPARTMENT OF TRANSPORTATION


RIGHT OF WAY STRIP MAP			
WOLF ROAD AT WELLER'S DITCH			
SCALE:	SHEET	OF SHEETS	STA. TO STA.

F.A.U. RTE.	SECTION	COUNTY	TOTAL SHEETS	SHEET NO.
2691	3434.1-BR(13)	COOK	58	25
CONTRACT NO. 60W53				
ILLINOIS FED. AID PROJECT				




**PAVEMENT MARKING LEGEND**

- ① POLYUREA PAVEMENT MARKING TYPE I-LINE 4", WHITE (SKIP DASH, 30' SKIP - 10' DASH)
- ② THERMOPLASTIC PAVEMENT MARKING-LINE 4", YELLOW
- ③ THERMOPLASTIC PAVEMENT MARKING-LINE 12", YELLOW
- ④ THERMOPLASTIC PAVEMENT MARKING-LINE 4", YELLOW (SKIP DASH, 30' SKIP - 10' DASH)
- ⑤ POLYUREA PAVEMENT MARKING TYPE I-LINE 4", YELLOW (SKIP DASH, 30' SKIP - 10' DASH)
- ⑥ THERMOPLASTIC PAVEMENT MARKING-LINE 24", WHITE
- ⑦ THERMOPLASTIC PAVEMENT MARKING-LINE 6", WHITE
- ⑧ THERMOPLASTIC PAVEMENT MARKING-LINE 4", DOUBLE YELLOW
- ⑨ REPLACEMENT REFLECTOR
- ⑩ THERMOPLASTIC PAVEMENT MARKING-LINE 4", WHITE (SKIP DASH, 30' SKIP - 10' DASH)
- ⑪ THERMOPLASTIC PAVEMENT MARKING-LETTERS AND SYMBOLS
- ⑫ POLYUREA PAVEMENT MARKING TYPE I-LINE 4", YELLOW

**LANDSCAPING LEGEND**

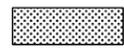 SEEDING, CLASS 1A WITH EROSION CONTROL BLANKET

**DETAIL FOR CROSSWALKS AND STOP BARS**

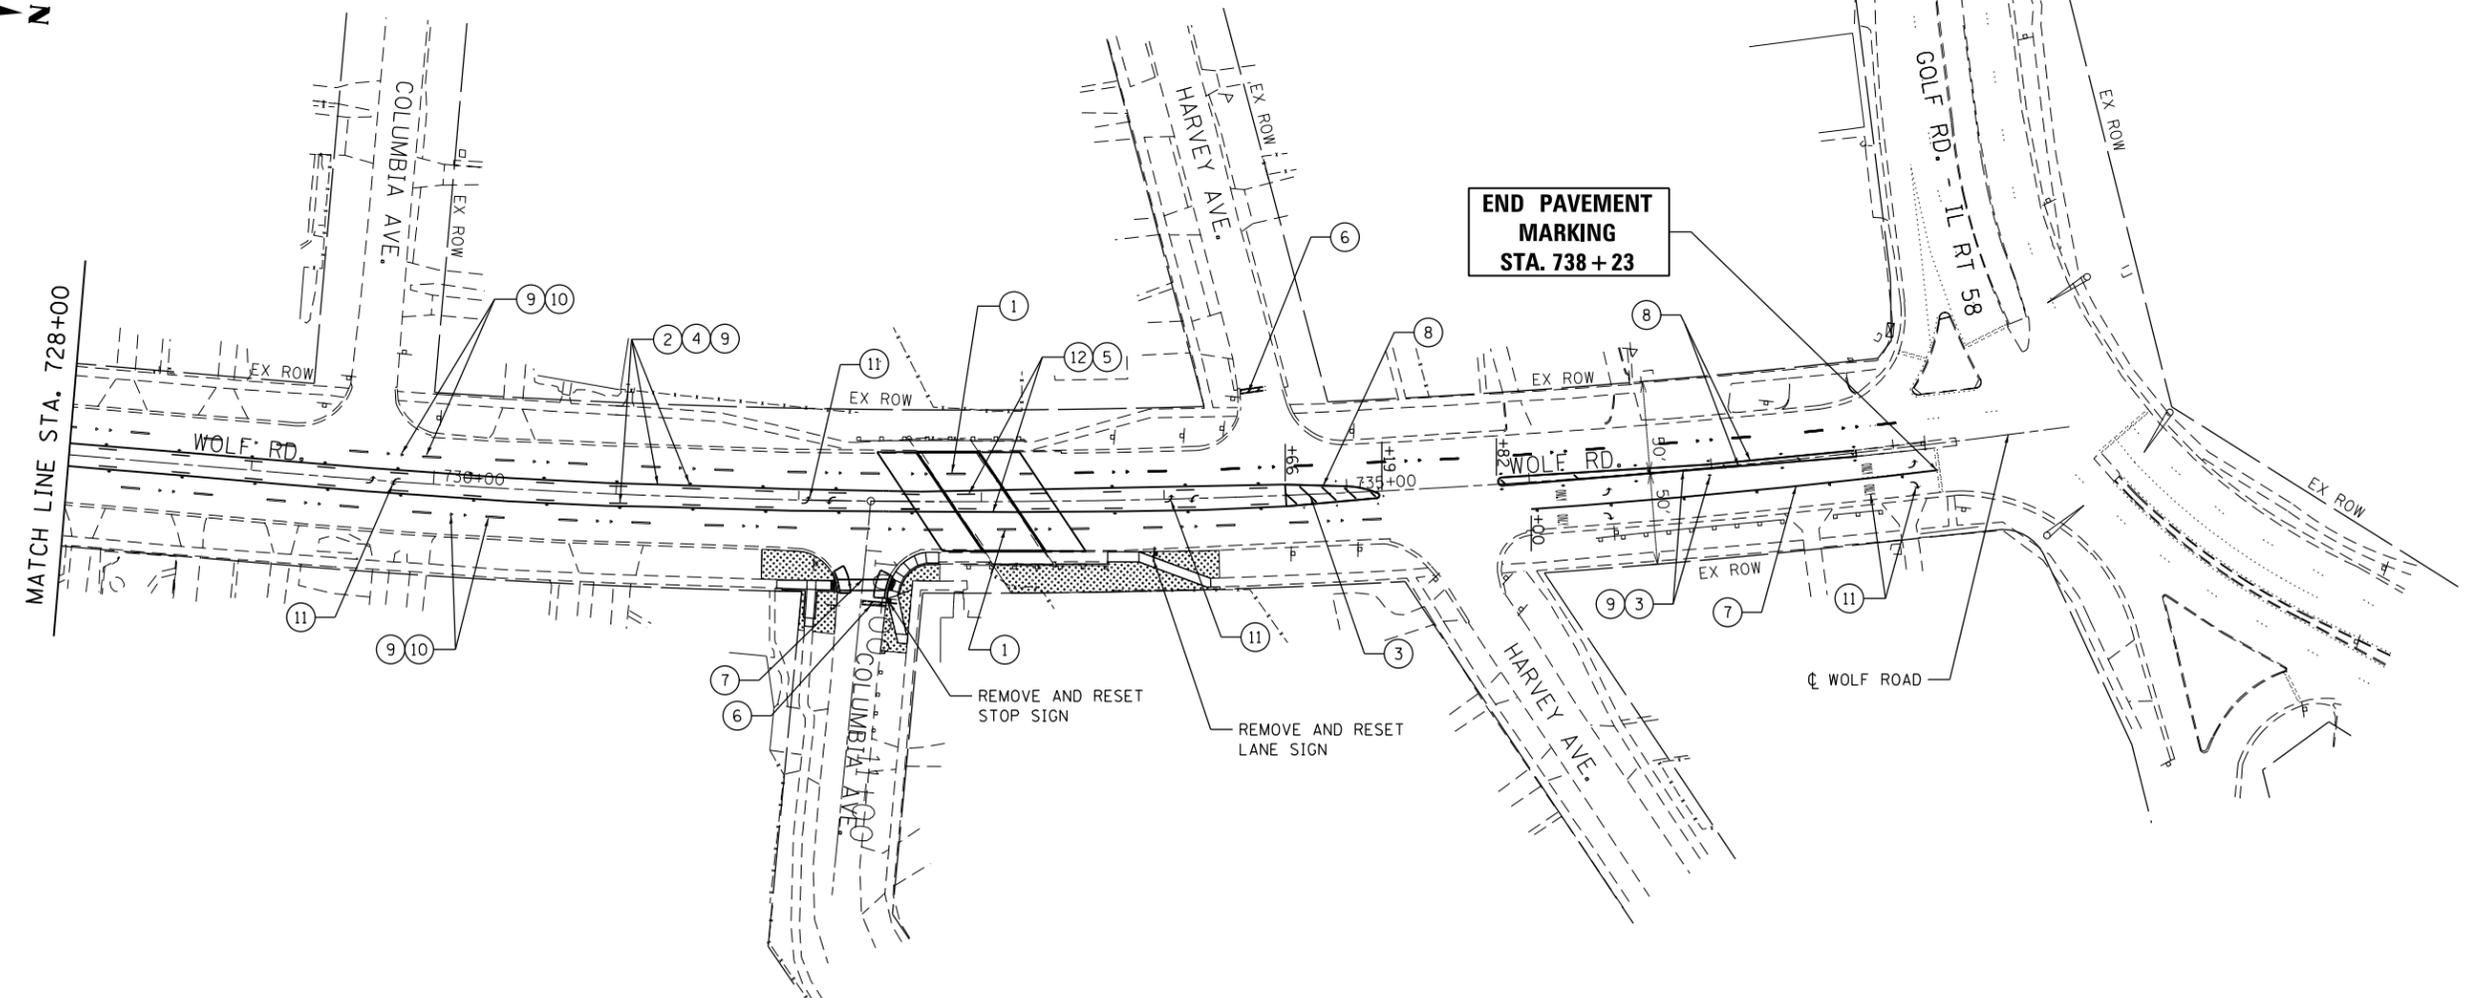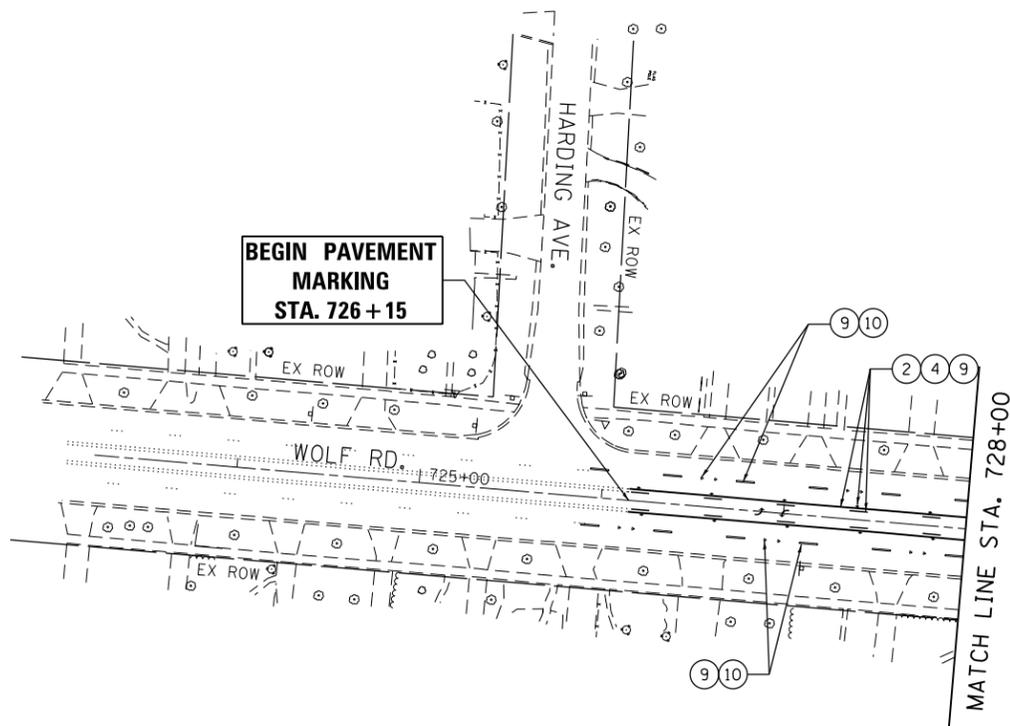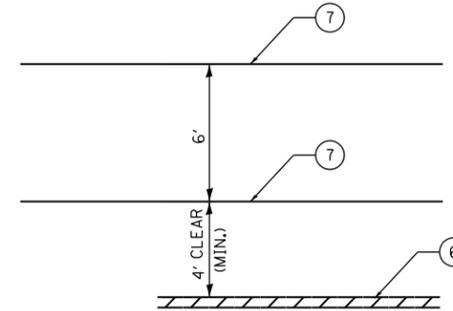

**END PAVEMENT MARKING  
STA. 738 + 23**

FILE NAME = Q:\Engineering\LiveProjects\13003 IDOT DURV13003a - W01 Contract No. 60W53\CADD\CADD Sheets\Civil\180M53-Sht-Pavt-Mark.dgn



USER NAME = dheyden	DESIGNED - TGM	REVISED -
DRAWN - CEC	REVISIONS -	
PLOT SCALE = 100.0000' / 1" =	CHECKED - JMT	REVISED -
PLOT DATE = 3/27/2018	DATE - 3/27/2018	REVISED -


**STATE OF ILLINOIS  
DEPARTMENT OF TRANSPORTATION**

**PAVEMENT MARKING AND LANDSCAPING DETAILS  
WOLF ROAD AT WELLER'S DITCH**

SCALE: SHEET OF SHEETS STA. 725+15 TO STA. 737+79

F.A.U. RTE.	SECTION	COUNTY	TOTAL SHEETS	SHEET NO.
2691	3434.1-BR(13)	COOK	58	26
CONTRACT NO. 60W53				
ILLINOIS FED. AID PROJECT				


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**SW RAMP**

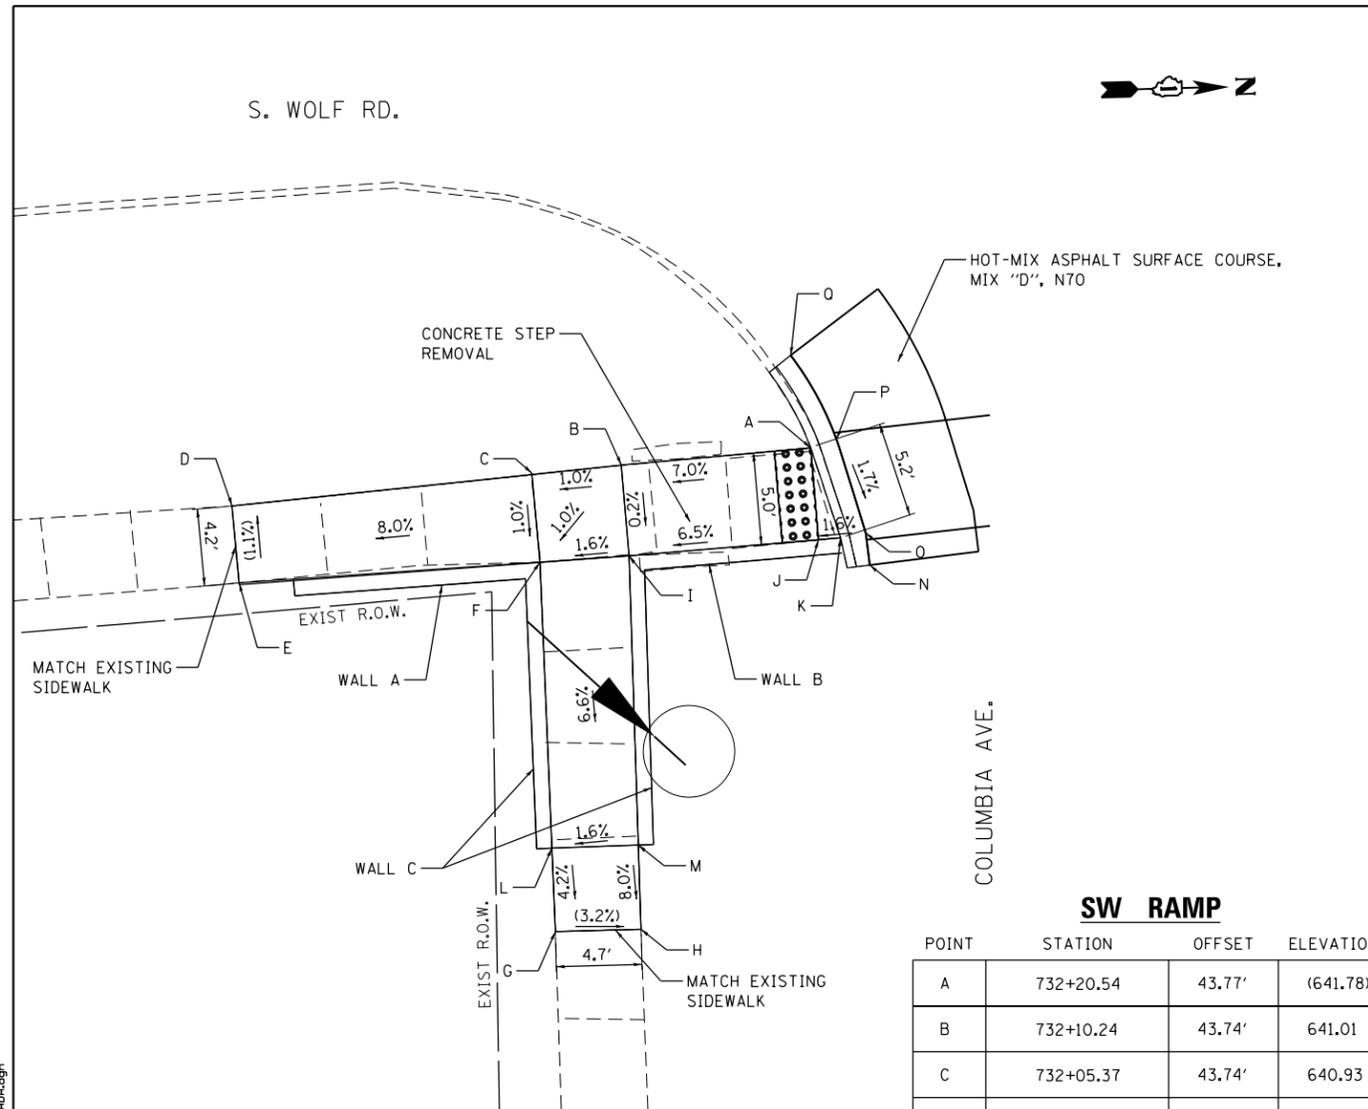POINT	STATION	OFFSET	ELEVATION
A	732+20.54	43.77'	(641.78)
B	732+10.24	43.74'	641.01
C	732+05.37	43.74'	640.93
D	731+89.03	43.80'	(639.61)
E	731+89.06	48.40'	(639.66)
F	732+05.38	48.64'	640.98
G	732+04.43	68.78'	(639.75)
H	732+09.03	69.07'	(639.60)
I	732+10.21	48.72'	641.00
J	732+20.50	48.80'	641.68
K	732+21.70	48.81'	641.69
L	732+04.64	64.23'	639.94
M	732+09.30	64.49'	639.96
N	732+20.50	50.44'	(641.49)
O	732+23.08	48.67'	641.70
P	732+22.06	43.77'	(641.79)
Q	732+19.92	38.63'	(642.00)

NOTES:  
1. SEE SHEETS 27 THRU 30 FOR WALL DETAILS.



**SE RAMP**

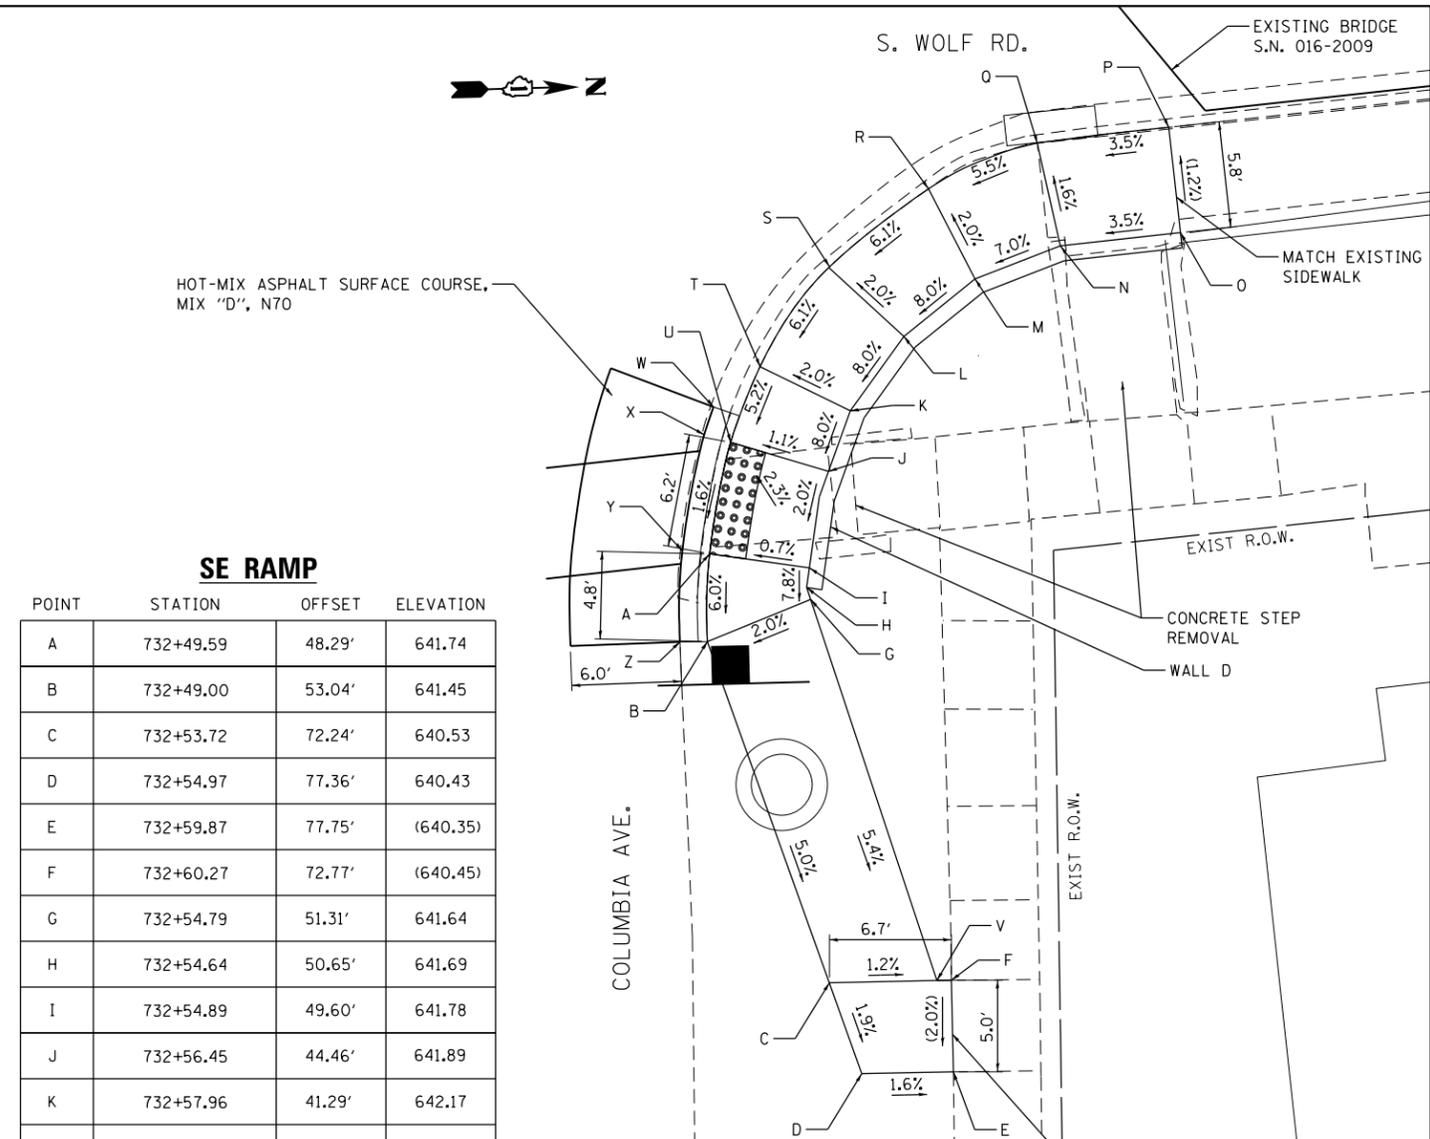POINT	STATION	OFFSET	ELEVATION
A	732+49.59	48.29'	641.74
B	732+49.00	53.04'	641.45
C	732+53.72	72.24'	640.53
D	732+54.97	77.36'	640.43
E	732+59.87	77.75'	(640.35)
F	732+60.27	72.77'	(640.45)
G	732+54.79	51.31'	641.64
H	732+54.64	50.65'	641.69
I	732+54.89	49.60'	641.78
J	732+56.45	44.46'	641.89
K	732+57.96	41.29'	642.17
L	732+61.26	37.56'	642.57
M	732+65.42	34.83'	642.97
N	732+70.20	33.52'	643.32
O	732+76.77	33.49'	(643.55)
P	732+76.74	27.70'	(643.48)
Q	732+69.54	27.81'	643.23
R	732+63.40	29.67'	642.88
S	732+57.58	33.40'	642.46
T	732+53.32	38.40'	642.06
U	732+51.32	42.35'	641.83
V	732+59.49	72.71'	640.46
W	732+50.60	40.33'	(641.95)
X	732+49.94	41.79'	(641.84)
Y	732+48.14	47.97'	641.74
Z	732+47.53	52.91'	(641.96)

**LEGEND**

-  DETECTABLE WARNINGS
-  EXISTING ELEVATION/SLOPE



USER NAME = dhejden	DESIGNED - PP	REVISED - _____
PLOT SCALE = 10.000' / 1"	DRAWN - PP	REVISED - _____
PLOT DATE = 3/12/2018	CHECKED - TGM	REVISED - _____
	DATE - 3/12/2018	REVISED - _____

STATE OF ILLINOIS  
DEPARTMENT OF TRANSPORTATION

ADA RAMP DETAILS  
WOLF ROAD AT WELLER'S DITCH

SCALE: \_\_\_\_\_ SHEET \_\_\_\_\_ OF \_\_\_\_\_ SHEETS STA. \_\_\_\_\_ TO STA. \_\_\_\_\_


F.A.U. RTE. 2691	SECTION 3434.1-BR(13)	COUNTY COOK	TOTAL SHEETS 58	SHEET NO. 27
CONTRACT NO. 60W53				ILLINOIS FED. AID PROJECT

**DESIGN SPECIFICATIONS**


2014 AASHTO LRFD Bridge Design Specifications, 7th Edition with 2016 Interims

**DESIGN STRESSES**


$f'_c = 3,500$  psi  
 $f_y = 60,000$  psi (Reinforcement)

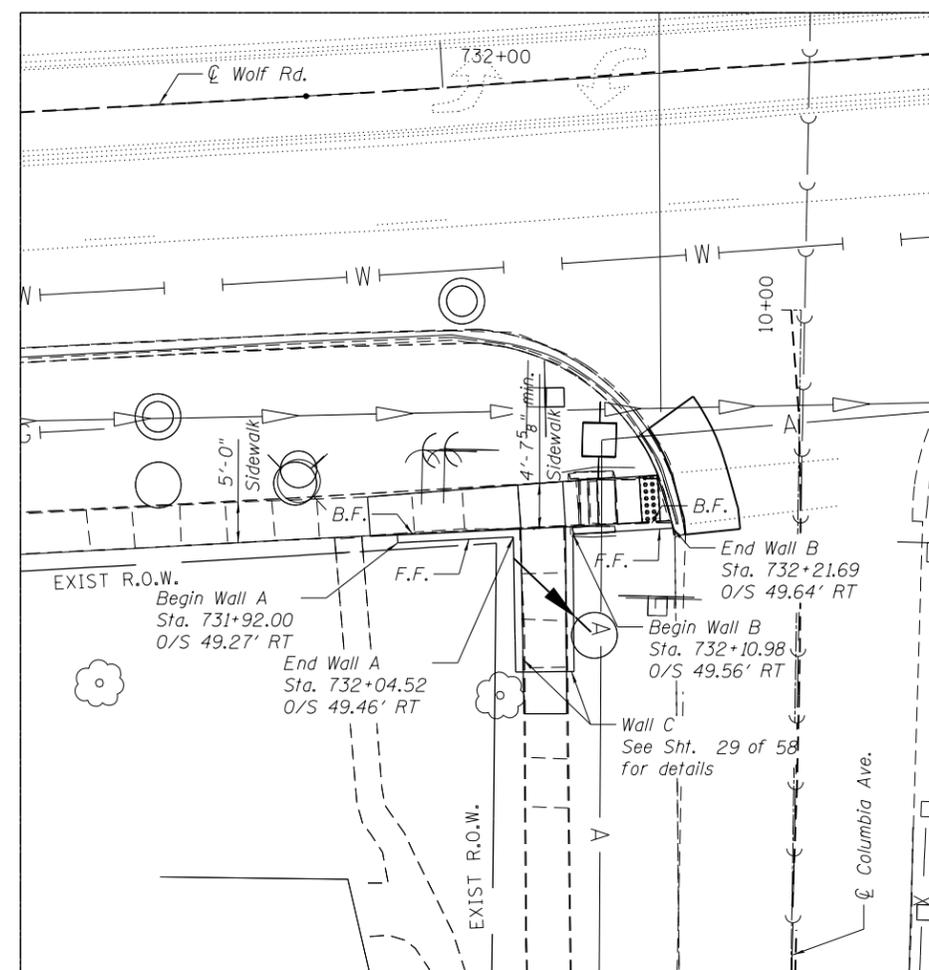

**PLAN WALLS A & B**  
**SOUTHEAST CORNER WOLF RD. & COLUMBIA AVE.**

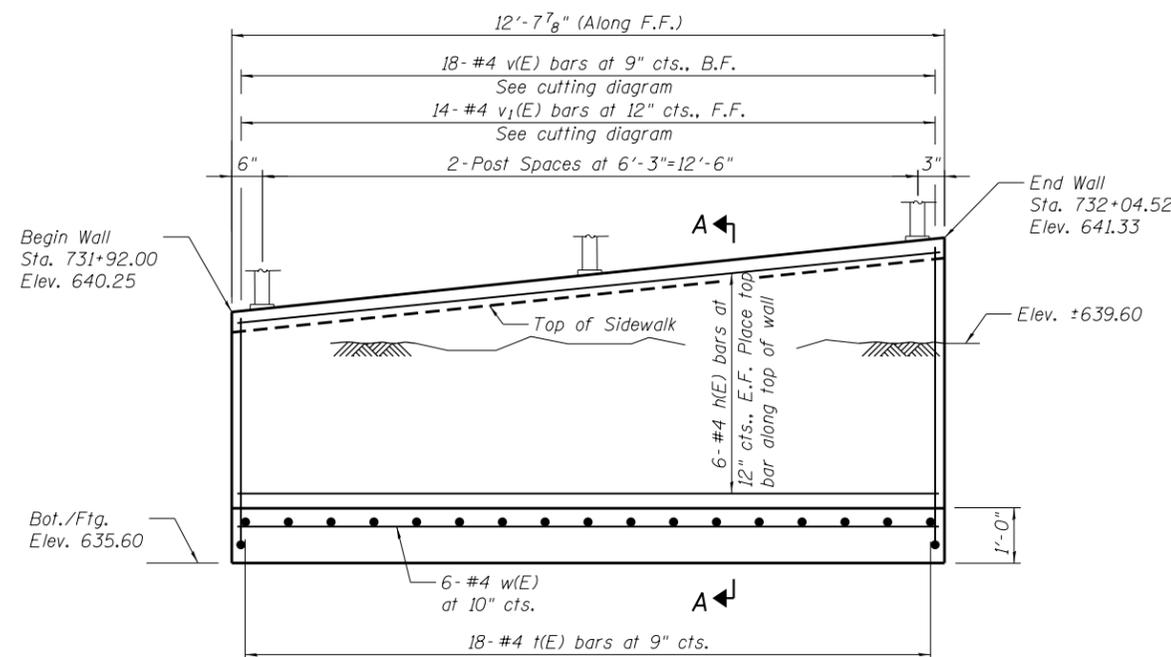


**WALL A - ELEVATION**  
 (Looking at Front Face of wall)

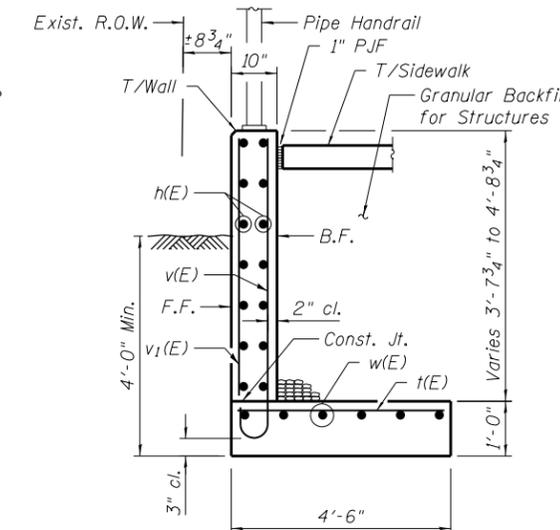


**SECTION A-A**


- Notes:
1. Reinforcement bars shall conform to the requirements of ASTM A 706 Gr. 60.
  2. Reinforcement bars designated (E) shall be epoxy coated.
  3. Wall stations, offsets and dimensions are measured at front face of wall.
  4. All exposed front face edges shall have a  $\frac{3}{4}$ " chamfer.
  5. Bracing shall be installed as per Special Provisions for "Braced Excavation."
  6. See Sheet 27 of 58 for ADA Ramp Details.
  7. See Sheet 30 of 58 for Retaining Walls Bill of Material and Reinforcing Details.
  8. See Sheets 31 of 58 for Handrail and Anchorage Details.
  9. P.J.F. is included in the cost of Concrete Structures.
  10. F.F. denotes Front Face
  11. B.F. denotes Back Face
  12. E.F. denotes Each Face
  13. Max. bearing pressure allowed = 1900 lb/ft<sup>2</sup>

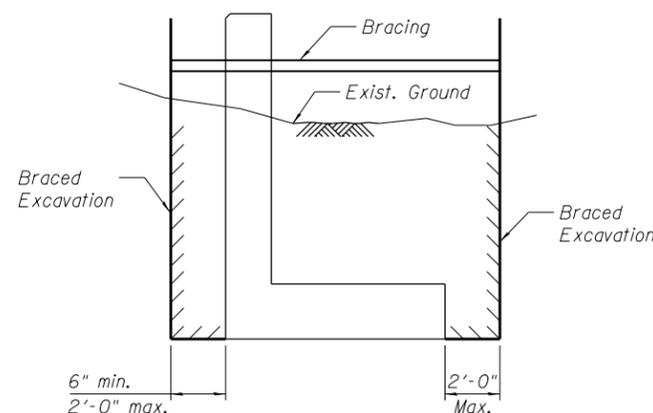

**BRACED EXCAVATION DETAIL**  
 (Typical for all walls)

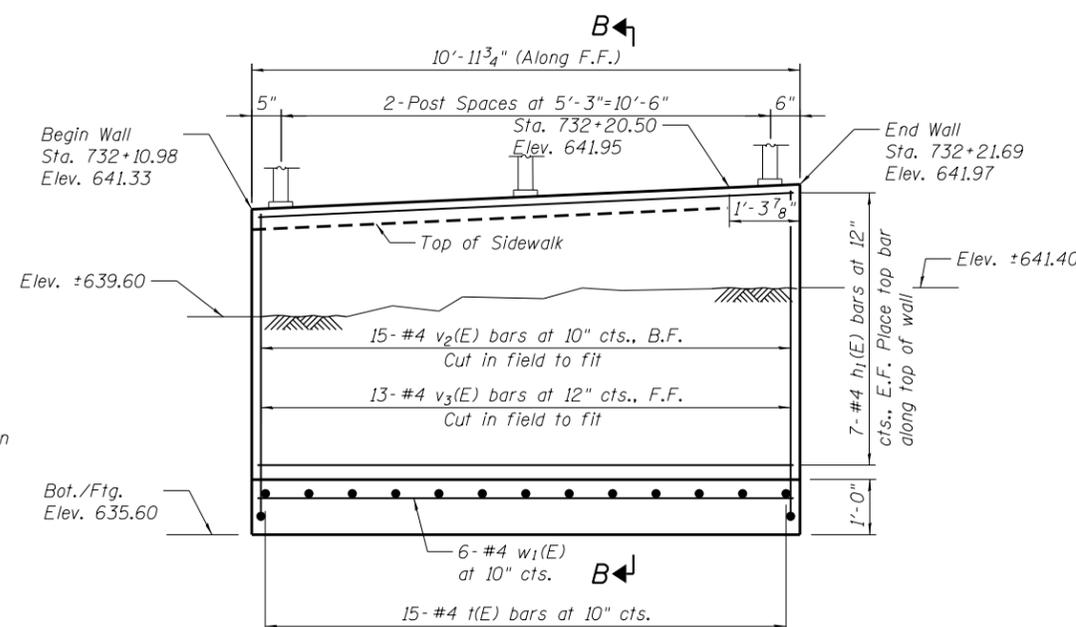

**WALL B - ELEVATION**  
 (Looking at Front Face of wall)

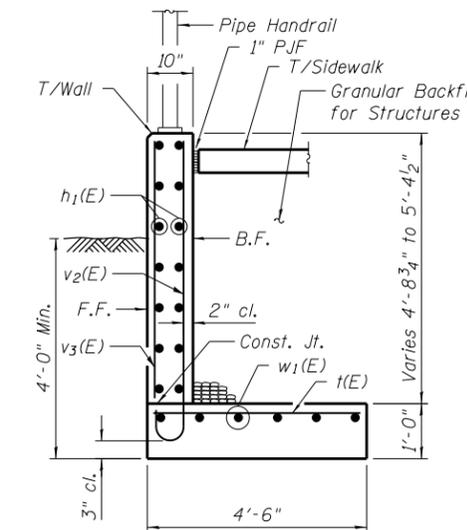

**SECTION B-B**

**STATE OF ILLINOIS**  
**DEPARTMENT OF TRANSPORTATION**

**RETAINING WALLS A AND B**  
**WOLF ROAD AT WELLER'S DITCH**

SCALE: SHEET 1 OF 4 SHEETS STA. TO STA.


F.A.U. RTE.	SECTION	COUNTY	TOTAL SHEETS	SHEET NO.
2691	3434.1-BR(13)	COOK	58	28
CONTRACT NO. 60W53				

ILLINOIS FED. AID PROJECT


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USER NAME = dheiden	DESIGNED - SAT	REVISED -
PLOT SCALE = 100.000' / in.	DRAWN - JN	REVISED -
PLOT DATE = 3/12/2018	CHECKED - JMT	REVISED -
	DATE - 3/12/2018	REVISED -




**PLAN WALLS C & D**  
WOLF RD. & COLUMBIA AVE.

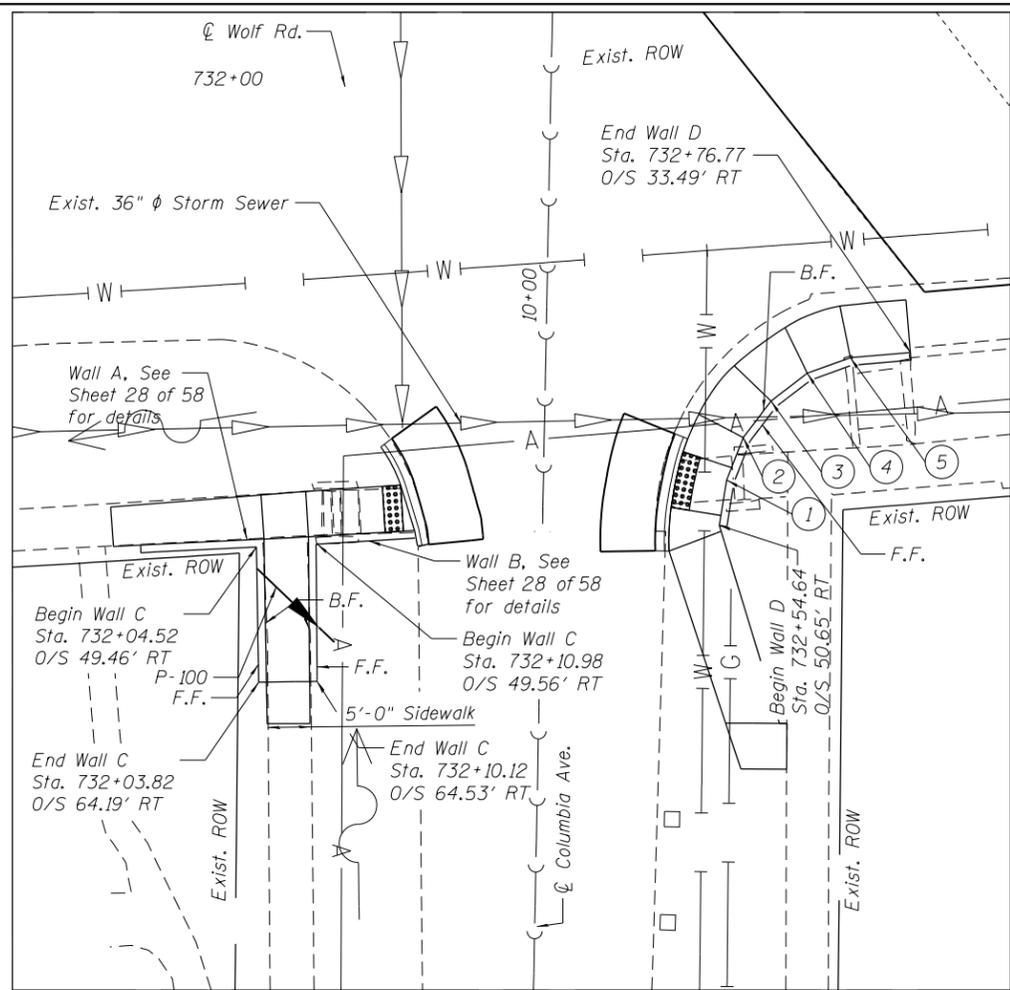

**WALL C - ELEVATION**  
(Looking at Front Face of West Portion of Wall)  
(East portion of the wall similar)

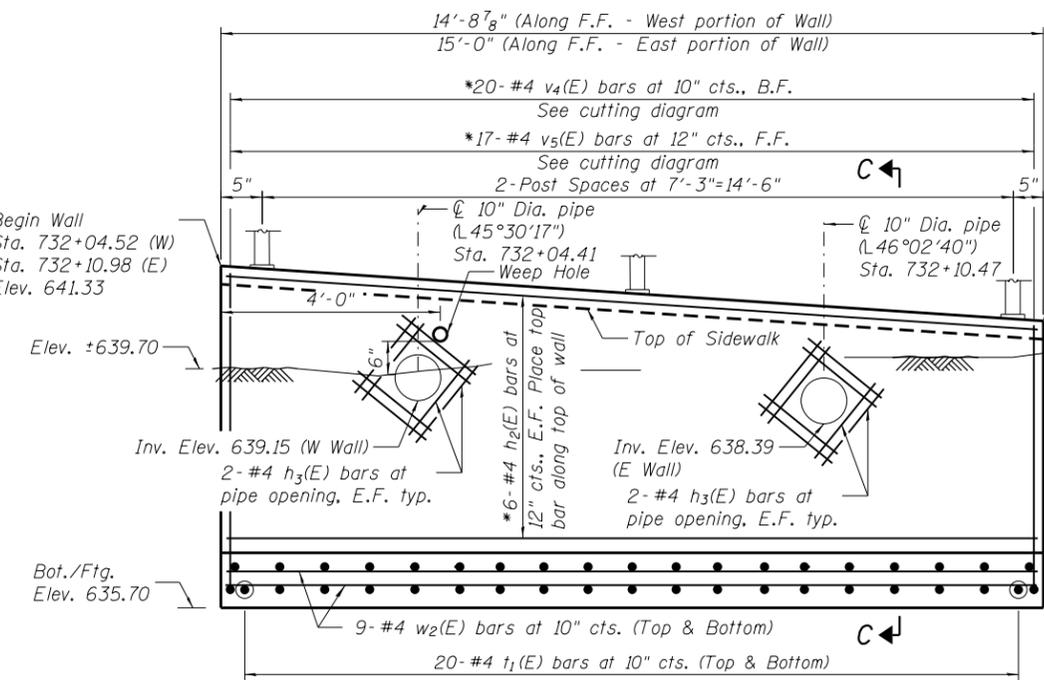\* Space  $h_2(E)$  bars,  $v_4(E)$  and  $v_5(E)$  bars to miss pipe opening.

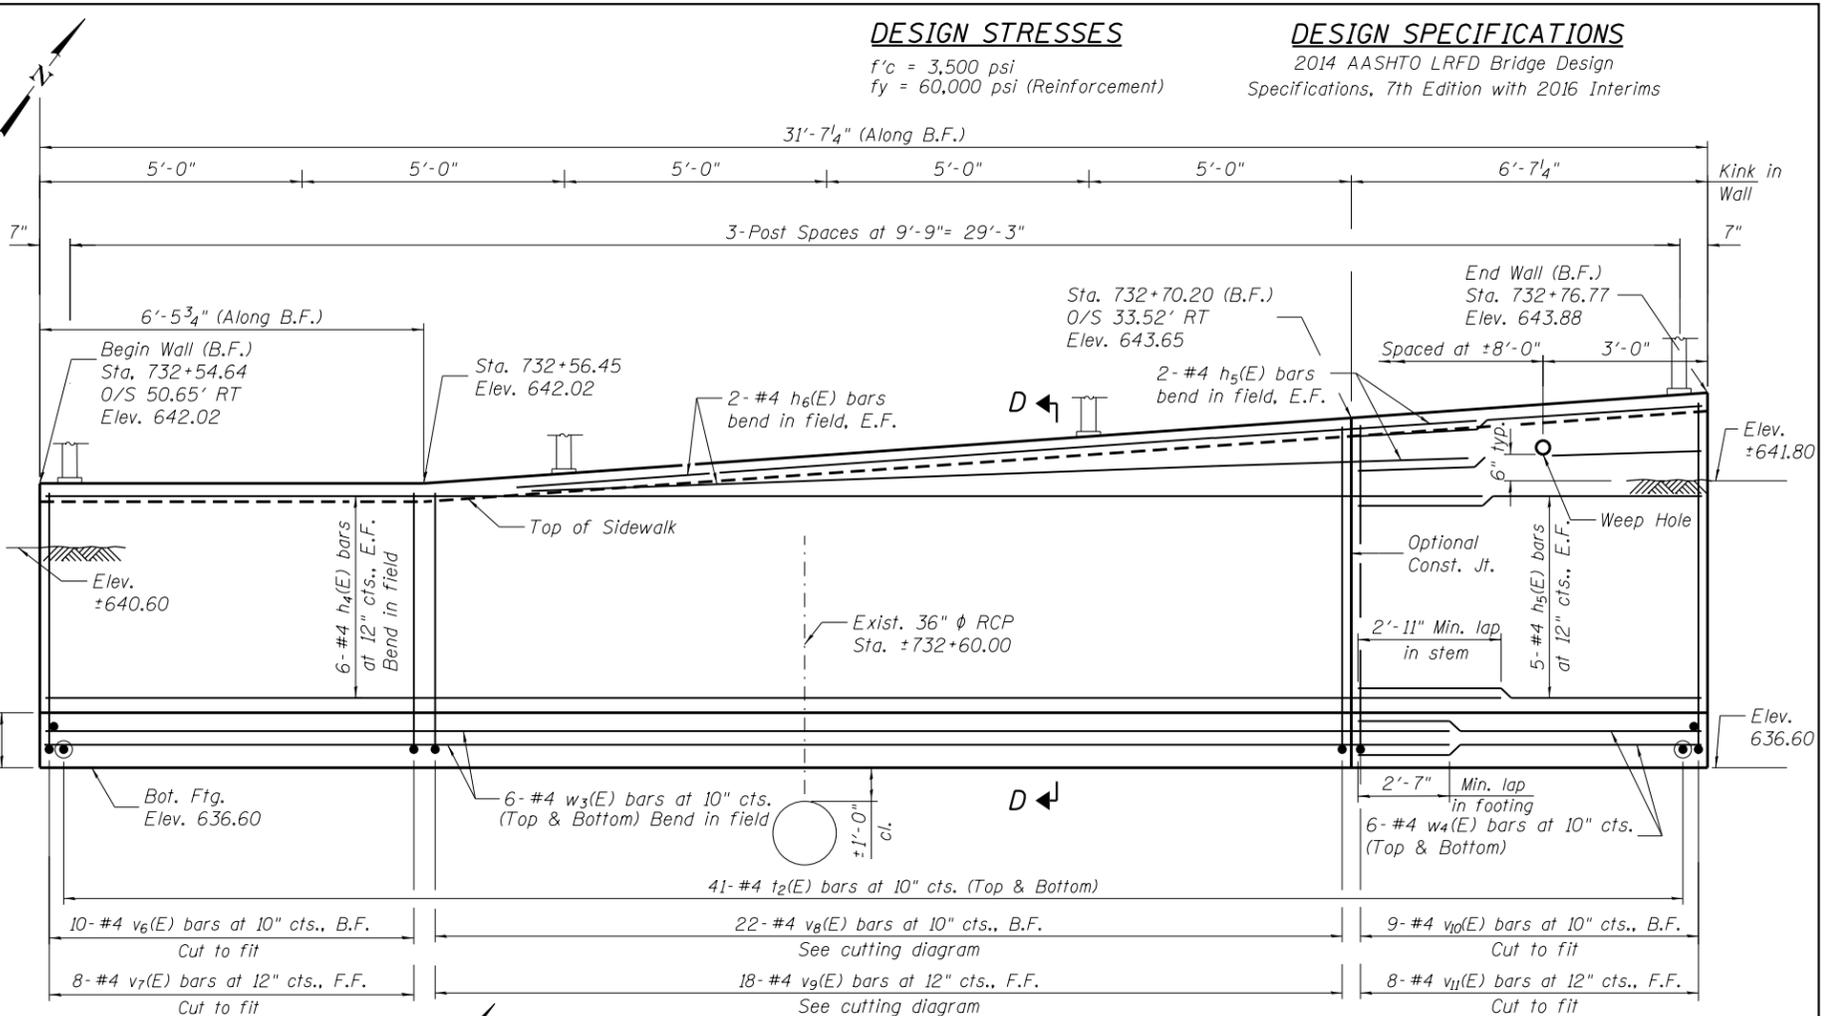


**DESIGN STRESSES**

$f'_c = 3,500$  psi  
 $f_y = 60,000$  psi (Reinforcement)


**DESIGN SPECIFICATIONS**

2014 AASHTO LRFD Bridge Design Specifications, 7th Edition with 2016 Interims


**WALL D - ELEVATION**  
(Looking at Front Face of Wall)

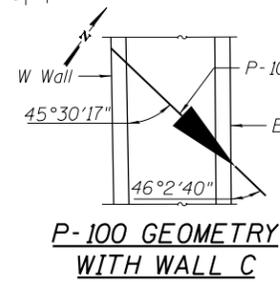

**P-100 GEOMETRY WITH WALL C**

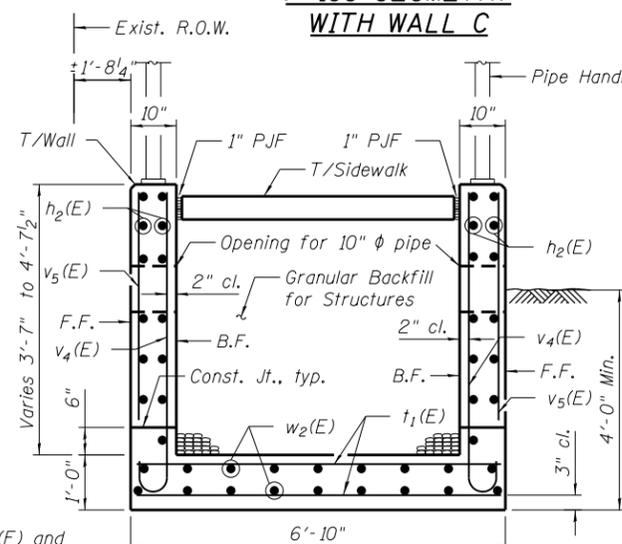

**SECTION C-C**

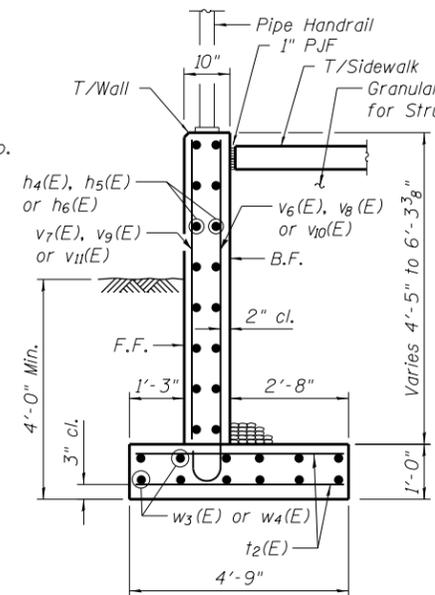

**SECTION D-D**

**KINK POINTS FOR WALL D**  
(Along Wolf Rd.)

No.	Station	Offset
①	732+55.81	45.79' RT
②	732+57.96	41.29' RT
③	732+61.26	37.56' RT
④	732+65.42	34.83' RT
⑤	732+70.20	33.52' RT

- Notes:
- Reinforcement bars shall conform to the requirements of ASTM A 706 Gr. 60.
  - Reinforcement bars designated (E) shall be epoxy coated.
  - Wall stations, offsets and dimensions are measured at front face of wall.
  - All exposed front face edges shall have a 3/4" chamfer.
  - See Sheet 27 of 58 for ADA Ramp Details.
  - See Sheet 30 of 58 for Retaining Walls Bill of Material and Reinforcing Details.
  - See Sheets 31 of 58 for Handrail and Anchorage Details.
  - P.J.F. is included in the cost of Concrete Structures.
  - F.F. denotes Front Face
  - B.F. denotes Back Face
  - E.F. denotes Each Face
  - Max. bearing pressure allowed = 1900 lb/ft

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PLOT SCALE = 100.000' / in.	DRAWN - JN	REVISED -
PLOT DATE = 5/14/2018	CHECKED - JMT	REVISED -
	DATE - 5/14/2018	REVISED -

**STATE OF ILLINOIS**  
**DEPARTMENT OF TRANSPORTATION**

**RETAINING WALLS C AND D**  
**WOLF ROAD AT WELLER'S DITCH**

SCALE: SHEET 2 OF 4 SHEETS STA. TO STA.

F.A.U. RTE.	SECTION	COUNTY	TOTAL SHEETS	SHEET NO.
2691	3434.1-BR(13)	COOK	58	29
CONTRACT NO. 60W53				
ILLINOIS FED. AID PROJECT				

**WALL A BILL OF MATERIAL**

Bar	No.	Size	Length	Shape
h(E)	12	#4	12'-11"	—
t(E)	18	#4	4'-2"	—
v(E)	9	#4	10'-7"	U
v <sub>1</sub> (E)	7	#4	7'-7"	—
w(E)	6	#4	12'-11"	—
Item		Unit	Total	
Concrete Structures		Cu. Yd.	4.0	
Reinforcement Bars, Epoxy Coated		Pound	310	
Protective Coat		Sq. Yd.	4	
Pipe Handrail		Foot	13	
Braced Excavation		Cu. Yd.	15.8	
Granular Backfill for Structures		Cu. Yd.	10.5	

**WALL B BILL OF MATERIAL**


Bar	No.	Size	Length	Shape
h <sub>1</sub> (E)	14	#4	11'-1"	—
t(E)	15	#4	4'-2"	—
v <sub>2</sub> (E)	15	#4	6'-5"	U
v <sub>3</sub> (E)	13	#4	5'-0"	—
w <sub>1</sub> (E)	6	#4	11'-1"	—
Item		Unit	Total	
Concrete Structures		Cu. Yd.	3.8	
Reinforcement Bars, Epoxy Coated		Pound	300	
Protective Coat		Sq. Yd.	3	
Pipe Handrail		Foot	11	
Braced Excavation		Cu. Yd.	20.2	
Granular Backfill for Structures		Cu. Yd.	11.2	

**WALL C BILL OF MATERIAL**

Bar	No.	Size	Length	Shape
h <sub>2</sub> (E)	24	#4	15'-3"	—
h <sub>3</sub> (E)	32	#4	2'-3"	—
t <sub>1</sub> (E)	40	#4	6'-6"	—
v <sub>4</sub> (E)	20	#4	10'-4"	U
v <sub>5</sub> (E)	17	#4	7'-4"	—
w <sub>2</sub> (E)	18	#4	15'-3"	—
Item		Unit	Total	
Concrete Structures		Cu. Yd.	8.1	
Reinforcement Bars, Epoxy Coated		Pound	880	
Protective Coat		Sq. Yd.	9	
Pipe Handrail		Foot	30	
Braced Excavation		Cu. Yd.	24.8	
Granular Backfill for Structures		Cu. Yd.	10.2	


**WALL D BILL OF MATERIAL**

Bar	No.	Size	Length	Shape
h <sub>4</sub> (E)	12	#4	27'-11"	—
h <sub>5</sub> (E)	14	#4	6'-3"	—
h <sub>6</sub> (E)	4	#4	19'-8"	—
t <sub>2</sub> (E)	82	#4	4'-5"	—
v <sub>6</sub> (E)	10	#4	5'-6"	U
v <sub>7</sub> (E)	8	#4	4'-1"	—
v <sub>8</sub> (E)	11	#4	12'-7"	U
v <sub>9</sub> (E)	9	#4	9'-7"	—
v <sub>10</sub> (E)	9	#4	7'-4"	U
v <sub>11</sub> (E)	8	#4	6'-10"	—
w <sub>3</sub> (E)	12	#4	30'-9"	—
w <sub>4</sub> (E)	12	#4	6'-3"	—
Item		Unit	Total	
Concrete Structures		Cu. Yd.	10.9	
Reinforcement Bars, Epoxy Coated		Pound	1170	
Protective Coat		Sq. Yd.	11	
Pipe Handrail		Foot	30	
Braced Excavation		Cu. Yd.	55.3	
Granular Backfill for Structures		Cu. Yd.	27.0	

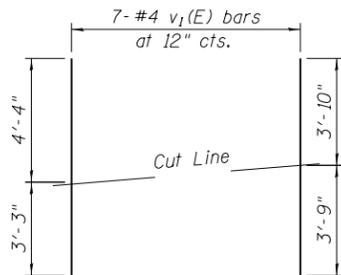


**FIELD CUTTING DIAGRAM**

Order v<sub>1</sub>(E) bars full length. Cut as shown and use remainder of bars as shown in Wall A Elevation

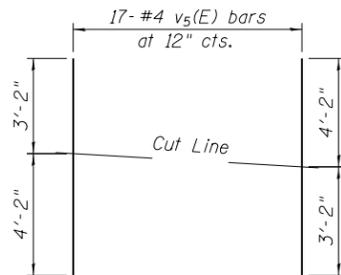


**FIELD CUTTING DIAGRAM**

Order v<sub>5</sub>(E) bars full length. Cut as shown and use remainder of bars as shown in Wall C Elevation

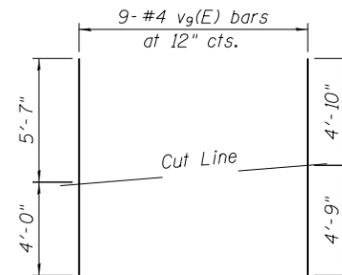


**FIELD CUTTING DIAGRAM**

Order v<sub>9</sub>(E) bars full length. Cut as shown and use remainder of bars as shown in Wall D Elevation

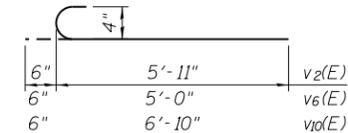


**BARS v<sub>2</sub>(E), v<sub>6</sub>(E) and v<sub>10</sub>(E)**

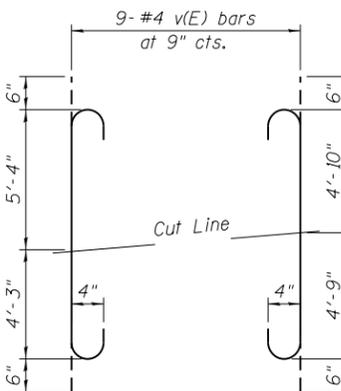


**FIELD CUTTING DIAGRAM**

Order v(E) bars full length. Cut as shown and use remainder of bars as shown in Wall A Elevation

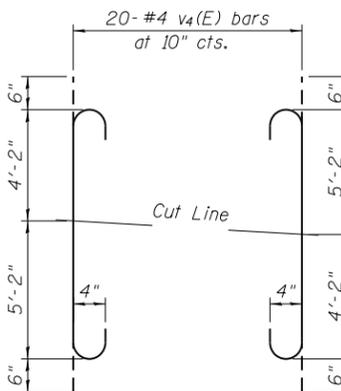


**FIELD CUTTING DIAGRAM**

Order v<sub>4</sub>(E) bars full length. Cut as shown and use remainder of bars in opposite stem as shown in Wall C Elevation

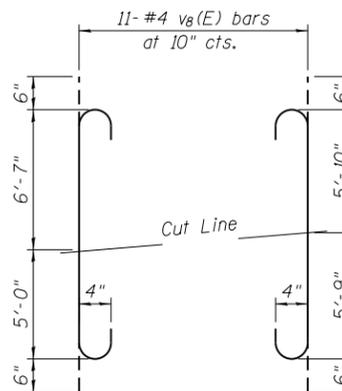

**FIELD CUTTING DIAGRAM**

Order v<sub>8</sub>(E) bars full length. Cut as shown and use remainder of bars as shown in Wall D Elevation.

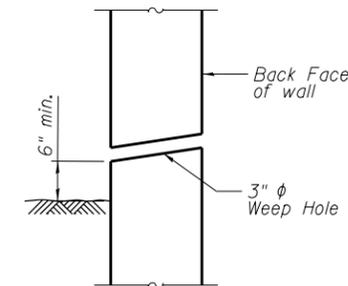

**WEEP HOLE DRAIN DETAIL**

**TOTAL BILL OF MATERIAL**

Item	Unit	Total
Concrete Structures	Cu. Yd.	26.8
Reinforcement Bars, Epoxy Coated	Pound	2660
Protective Coat	Sq. Yd.	27
Pipe Handrail	Foot	84
Braced Excavation	Sq. Yd.	116.1
Granular Backfill for Structures	Cu. Yd.	58.9

FILE NAME = Q:\Engineering\LiveProjects\13003 IDOT DURV13003 - W0 1 Contract No. 60W53\CADD\CADD Sheets\Cv1\0160W53-Sht-Ret Walls BILL.dgn




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	DATE - 5/14/2018	REVISED -

**STATE OF ILLINOIS  
DEPARTMENT OF TRANSPORTATION**


**RETAINING WALLS DETAILS  
WOLF ROAD AT WELLER'S DITCH**

SCALE: SHEET 3 OF 4 SHEETS STA. TO STA.

F.A.U. RTE.	SECTION	COUNTY	TOTAL SHEETS	SHEET NO.
2691	3434.1-BR(13)	COOK	58	30
CONTRACT NO. 60W53				
ILLINOIS FED. AID PROJECT				

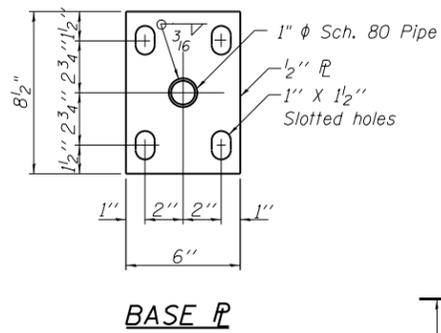


**BASE PL**

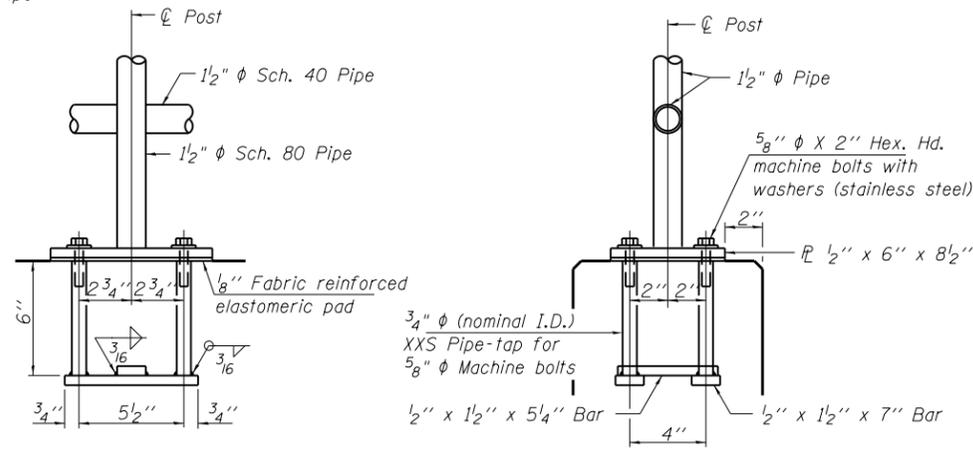

**ANCHOR BOLT DETAILS**

In lieu of the cast-in-place anchor device shown, the Contractor has the option of drilling and setting 5/8" dia. anchor rods according to Article 509.06 of the Standard Specifications. Embedment shall be according to the manufacturer's specifications.

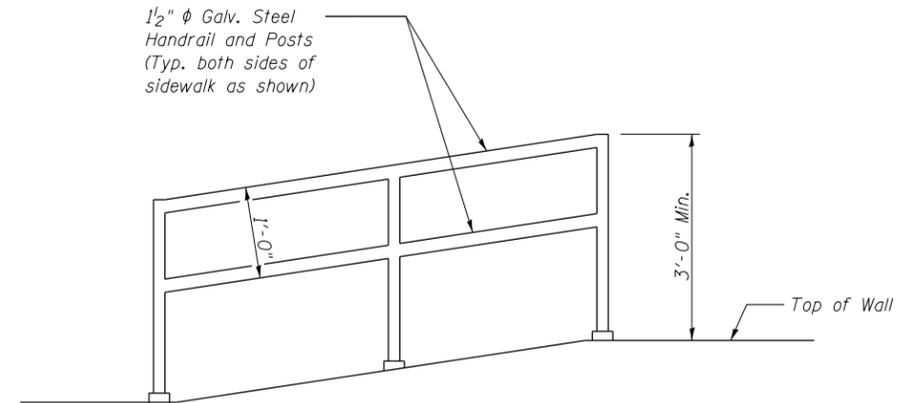

**HANDRAIL**  
N.T.S.

**Notes:**  
Handrail installation shall conform with current A.D.A. requirements.  
Location of posts shown in Sheets 28 and 29 of 58.

FILE NAME = Q:\Engineering\LiveProjects\13003 IDOT DUR\13003 - WD 1 Contract No. 60W53\CADD\CADD Sheets\Civil\0160W53-Sht-Handrail Det.dgn



USER NAME = dheiden	DESIGNED - JMT	REVISED -
	DRAWN - CEC	REVISED -
PLOT SCALE = 20.0000' / in.	CHECKED - TGM	REVISED -
PLOT DATE = 3/12/2018	DATE - 3/12/2018	REVISED -

**STATE OF ILLINOIS  
DEPARTMENT OF TRANSPORTATION**

**HANDRAIL DETAILS  
WOLF ROAD AT WELLER'S DITCH**


SCALE: SHEET 4 OF 4 SHEETS STA. TO STA.

F.A.U. RTE.	SECTION	COUNTY	TOTAL SHEETS	SHEET NO.
269I	3434.1-BR(13)	COOK	58	31
CONTRACT NO. 60W53				
ILLINOIS FED. AID PROJECT				

Benchmark: Chiseled "square" on top step of southeast wingwall. Elev. 650.79  
 Existing Structure: Structure 016-2009 was built as SA-16 Section 016-3134-15D in 1960. The superstructure consists of a single span prestressed concrete box beam bridge, 32'-3 1/2" between  $\mathcal{C}$  to  $\mathcal{C}$  of bearings and 68'-0" wide with a skew of 33°40'. In 1990, the existing asphalt overlay was removed and a new waterproofing and bituminous overlay was installed. In 2009, the structure was resurfaced with an asphalt overlay. Stage construction will be utilized to maintain traffic during construction.

**CURVE DATA**

(Along PGL Wolf Rd.)  
 Curve Wolf-1  
 P.I. Sta. = 733+88.82  
 $\Delta = 12^\circ 06' 40''$  (LT)  
 $D = 1^\circ 17' 02''$   
 $R = 4,462.30'$   
 $T = 473.38'$   
 $L = 943.24'$   
 $E = 25.04'$   
 P.C. Sta. = 729+15.43  
 P.T. Sta. = 738+58.67

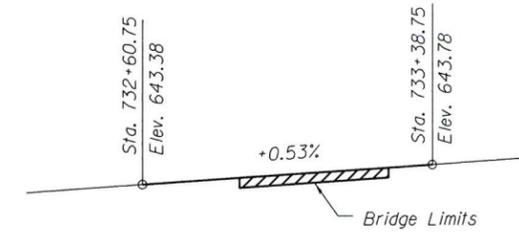

**PROFILE GRADE**

(Along  $\mathcal{C}$  Wolf Rd.)

**DESIGN SPECIFICATIONS**

2002 AASHTO Standard Specifications for Highway Bridges (17th Edition)

**LOADING HS20-44**

Allow 25 psf for future wearing surface.


**DESIGN STRESSES**

**EXISTING UNITS**

Structural Steel = 18,000 psi  
 Reinforcement Bars = 20,000 psi  
 Concrete (w/o Earth Pressure) = 1,200 psi  
 Concrete (with Earth Pressure) = 800 psi

**PROPOSED FIELD UNITS**

$f'_c = 4,000$  psi  
 $f_y = 60,000$  psi (Reinforcement)

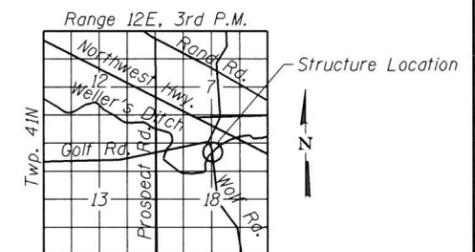


**LOCATION SKETCH**



DATE SIGNED: 03/10/2018  
 EXP. DATE: 11/30/2018  
 (FOR SHEETS 28 TO 40 OF 58)


**GENERAL PLAN & ELEVATION**  
**WOLF ROAD OVER WELLER'S DITCH**  
**FAU 2691 - SEC. 3434.1-BR(13)**  
**COOK COUNTY**  
**STATION 732+99.91**  
**STRUCTURE NO. 016-2009**

No Salvage.

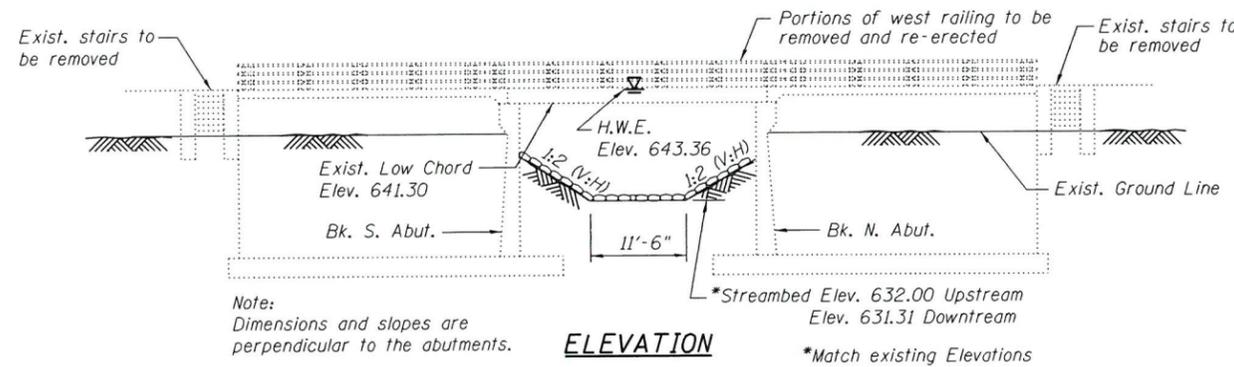

**ELEVATION**

Note: Dimensions and slopes are perpendicular to the abutments.  
 \*Streambed Elev. 632.00 Upstream Elev. 631.31 Downstream  
 \*Match existing Elevations

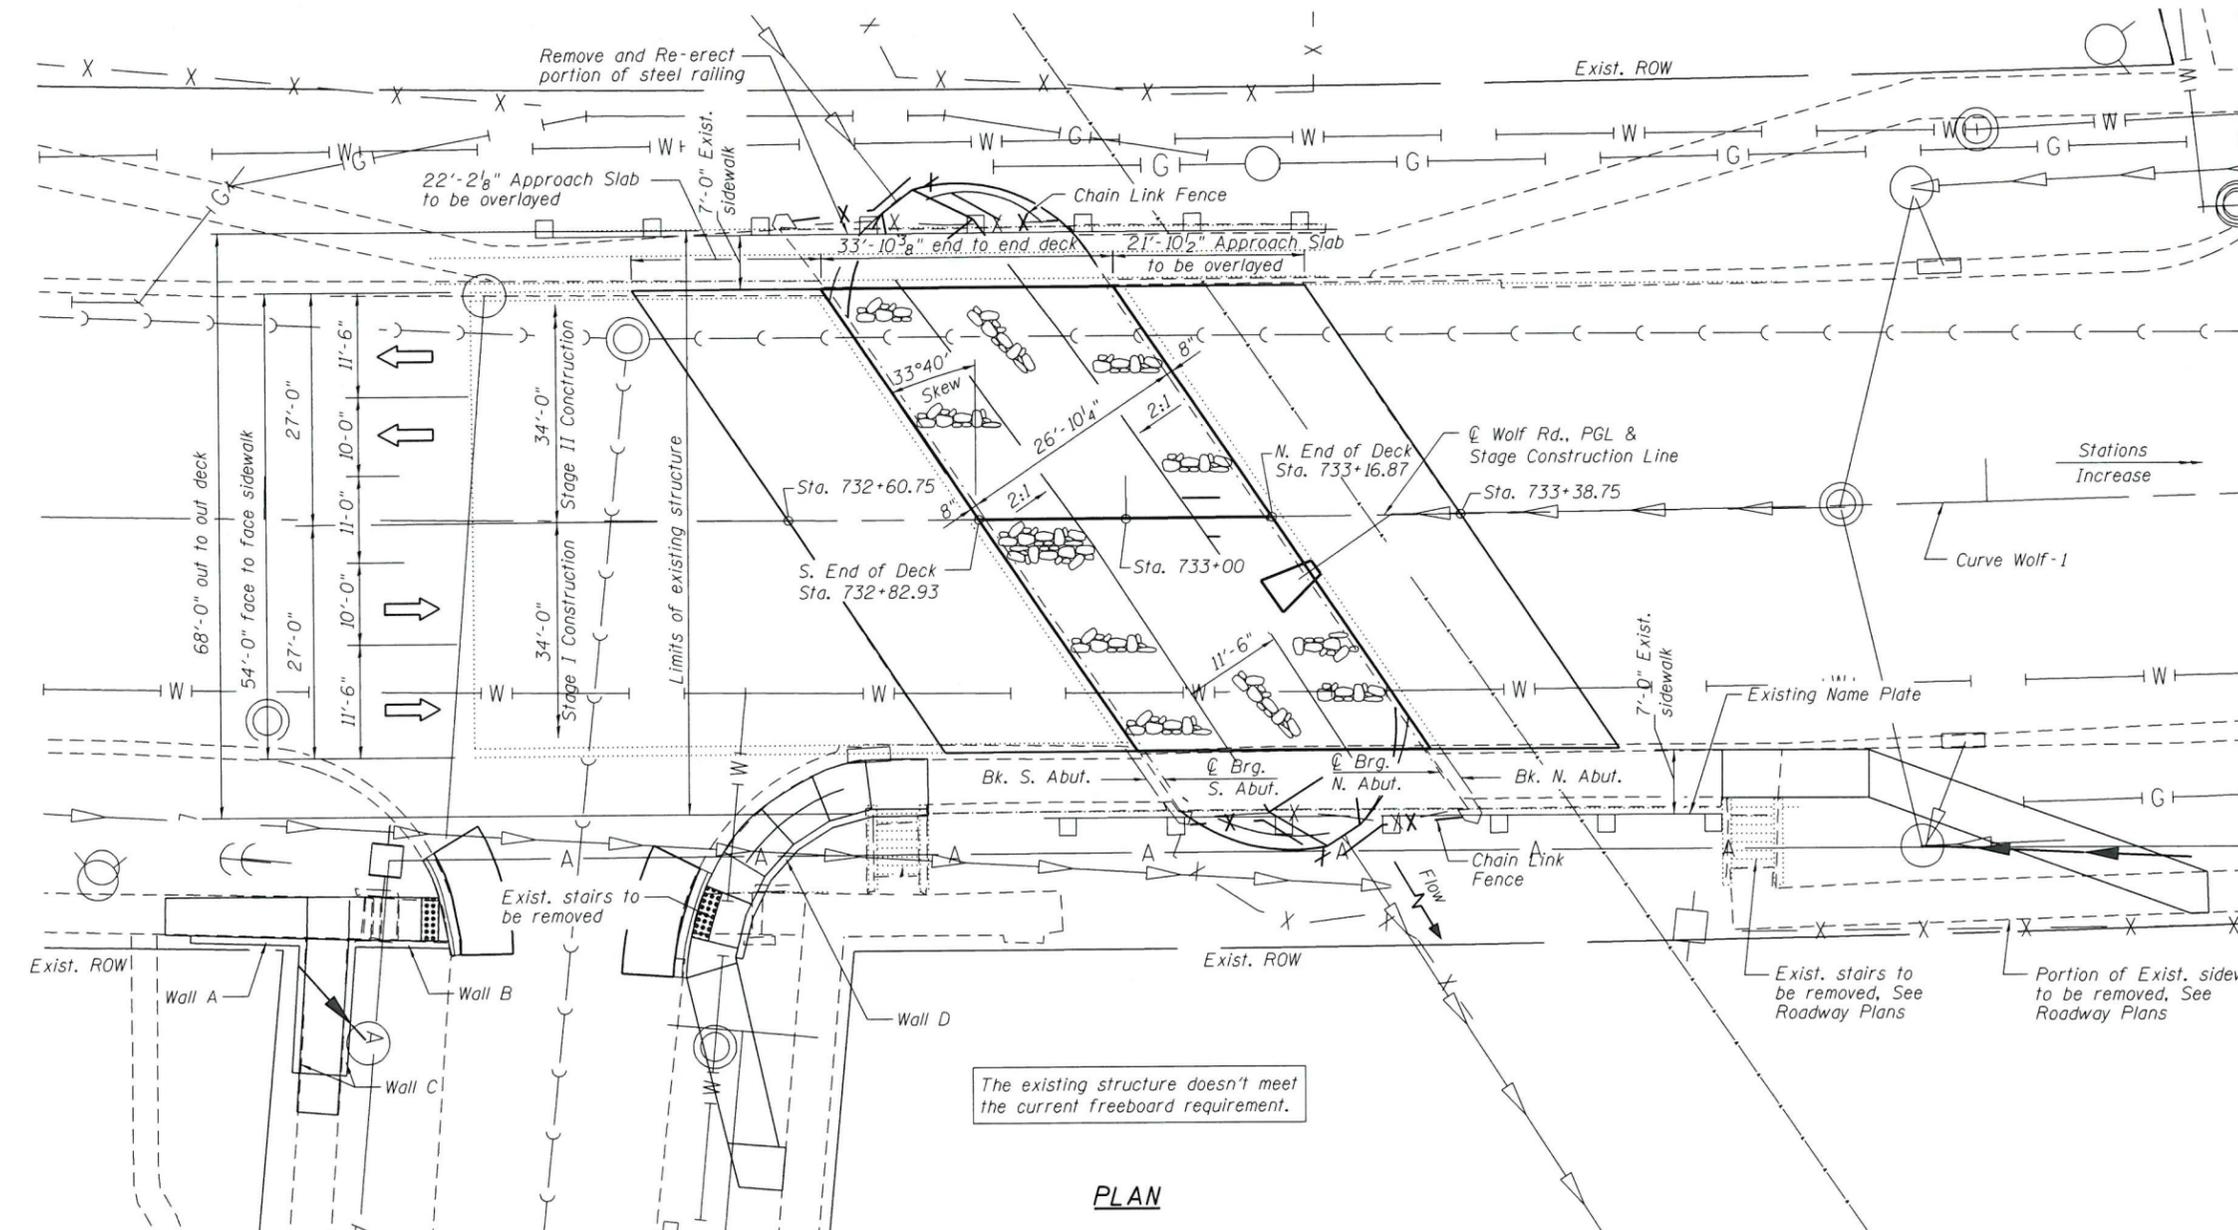

**PLAN**

The existing structure doesn't meet the current freeboard requirement.

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PLOT DATE = 3/10/2018	CHECKED - JMT	REVISED

**STATE OF ILLINOIS**  
**DEPARTMENT OF TRANSPORTATION**

SHEET NO. 1 OF 9 SHEETS

F.A.U. RTE. 2691	SECTION 3434.1-BR(13)	COUNTY COOK	TOTAL SHEETS 58	SHEET NO. 32
				CONTRACT NO. 60W53
ILLINOIS FED. AID PROJECT				

**GENERAL NOTES**

1. Reinforcement bars designated (E) shall be epoxy coated.
2. The minimum thickness of the concrete overlay shall be 5" and varies as required to adjust for the existing profile grade and beam camber.
3. Plan dimensions and details relative to existing plans are subject to nominal construction variations. The Contractor shall field verify existing dimensions and details affecting new construction and make necessary approved adjustments prior to construction or ordering of materials. Such variations shall not be cause for additional compensation for a change in scope of the work, however, the Contractor will be paid for the quantity actually furnished at the unit price bid for the work.
4. Protective Coat shall be applied on top of Concrete Wearing Surface, top and vertical faces of sidewalks.
5. The Contractor shall use extreme care during concrete removal so as not to damage the PPC deck beam.
6. Existing reinforcement bars extending into the removal area shall be cleaned, straightened and incorporated into the new construction. Any reinforcement bars that are damaged during concrete removal shall be replaced with an approved bar splicer or anchorage system. Cost included with Concrete Removal.
7. Area of concrete repairs shown are estimated. The Engineer shall show actual locations on As-Built Plans.
8. During construction operations, loose material deposits that obstruct the flow of water in draining the area shall be removed before the end of each work day. At the conclusion of construction operations, all drainage structures shall be free from all dirt and debris. This work will not be paid for separately but shall be considered included in the cost of Stone Riprap, Class A3.
9. Protective Coat shall be applied to new concrete on the north and south abutments and wingwalls as shown on the plans.
10. Details for Walls A-D can be found in the Roadway Plans on Sheets 28 thru 31 of 58.
11. Cleaning and painting of steel railing shall be done under a separate Painting Contract.
12. The information concerning the type and location of underground and other utilities is not guaranteed to be accurate or all inclusive. It shall be the contractor's responsibility to verify the location of all utilities prior to starting construction. Contact J.U.L.I.E. 800-892-0123.

**SCOPE OF WORK**

1. Remove existing HMA overlay on PPC deck beams.
2. Remove concrete haunch in existing beams as shown in the plans.
3. Remove and Re-erect the existing steel railing and name plate in locations shown on plans.
4. Install 5" min. concrete wearing surface.
5. Remove all debris from under the bridge. Engineer shall verify actual areas.
6. Remove 24" and 54" CMP pipe, Install end sections in locations shown in Roadway Plans.
7. Fill existing scour hole with Stone Riprap, Class A3. See Roadway Plans.
8. Excavate channel and place Stone Riprap, Class A3 with Filter Fabric under bridge between abutments as shown in Roadway Plans.
9. Repair sidewalks, abutments and wingwalls as shown in Structural Plans.

**INDEX OF SHEETS**

1. General Plan & Elevation
2. General Notes and Total Bill of Material
3. Stage Construction Details
4. Deck and Sidewalk Repair Details
5. Deck Overlay Plan and Cross Section
6. Railing Details
7. North Abutment and Wingwall Repairs
8. South Abutment and Wingwall Repairs
9. Bar Splicer Assembly and Mechanical Splicer Details

**TOTAL BILL OF MATERIAL**

ITEM	UNIT	SUPER	SUB	TOTAL
Concrete Removal	Cu Yd	0.6	0.4	1.0
Concrete Structures	Cu Yd		0.3	0.3
Bridge Deck Grooving	Sq Yd	196		196
Protective Coat	Sq Yd	259	3	262
Reinforcement Bars, Epoxy Coated	Pound	2880		2880
Bar Splicers	Each	35		35
Concrete Wearing Surface, 5"	Sq Yd	204		204
Bearing Pad Adjustment	Each	44		44
Removing and Re-Erecting Existing Railing	Foot	43		43
Structural Repair of Concrete (Depth Equal to or Less than 5 Inches)	Sq Ft	41	62	103
Structural Repair of Concrete (Depth Greater than 5 Inches)	Sq Ft	24	14	38
Debris Removal	L Sum			1
Silicone Joint Sealer, 1"	Foot	34		34
Keyway Repair	Foot	269		269
Hot-Mix Asphalt Surface Removal Complete	Foot	204		204

FILE NAME = Q:\Engineering\LiveProjects\13003 IDOT DUR\13003a - W0 1 Contract No. 60W53\CADD\CADD\CADD Sheets\Structural\016-2009-60W53-02-GNTBILL.dgn



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PLOT DATE = 3/12/2018	CHECKED - JMT	REVISED


**STATE OF ILLINOIS  
DEPARTMENT OF TRANSPORTATION**

**GENERAL NOTES AND TOTAL BILL OF MATERIAL  
STRUCTURE NO. 016-2009**


SHEET NO. 2 OF 9 SHEETS

F.A.U. RTE.	SECTION	COUNTY	TOTAL SHEETS	SHEET NO.
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ILLINOIS FED. AID PROJECT			CONTRACT NO. 60W53	


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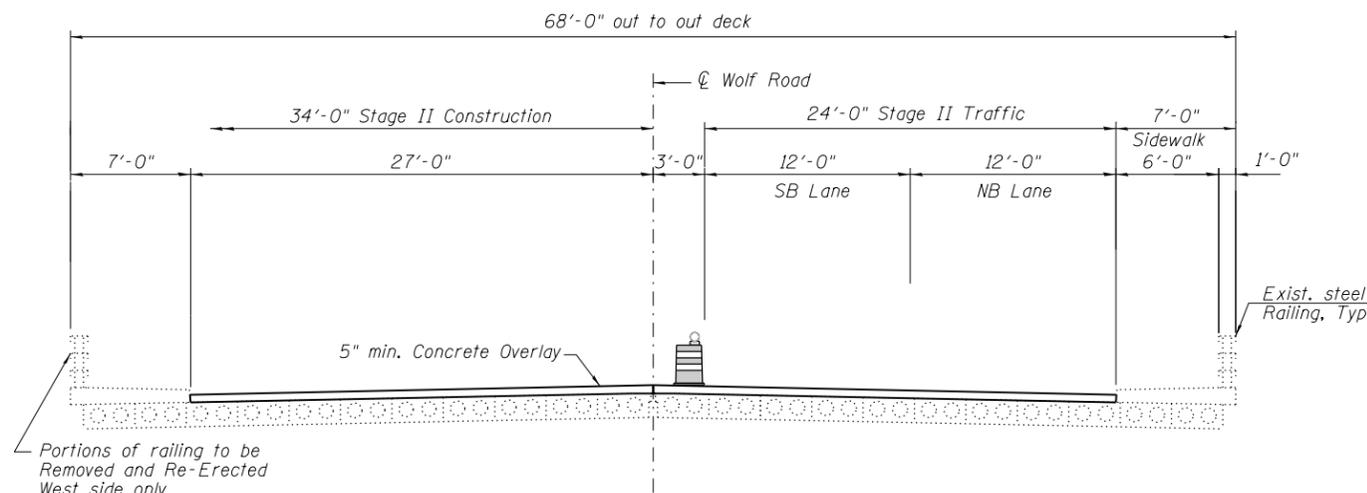
**STAGE I - REMOVAL**

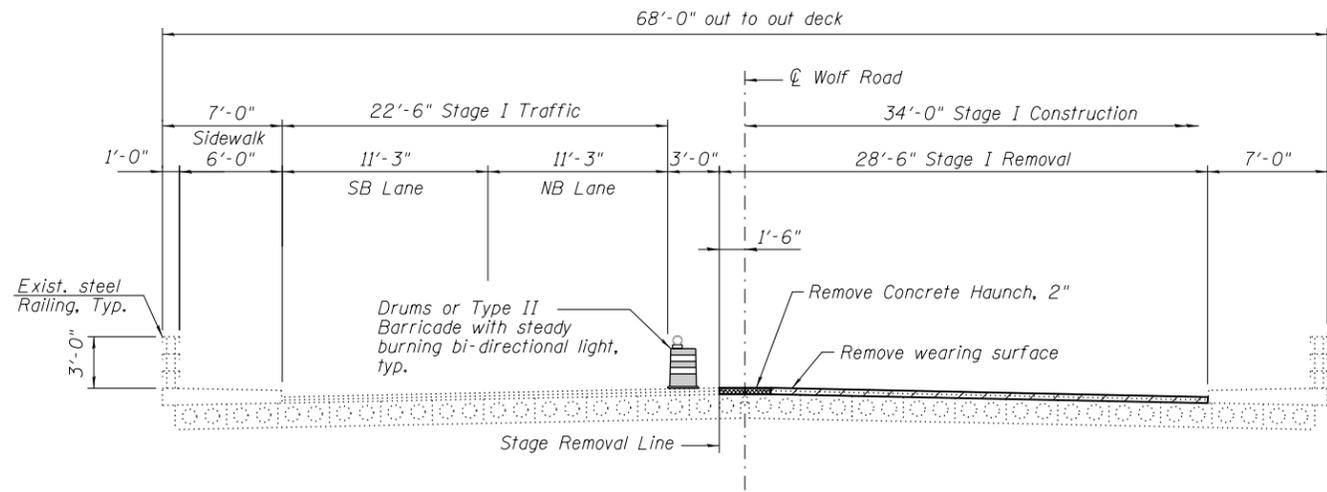

**STAGE II - REMOVAL**

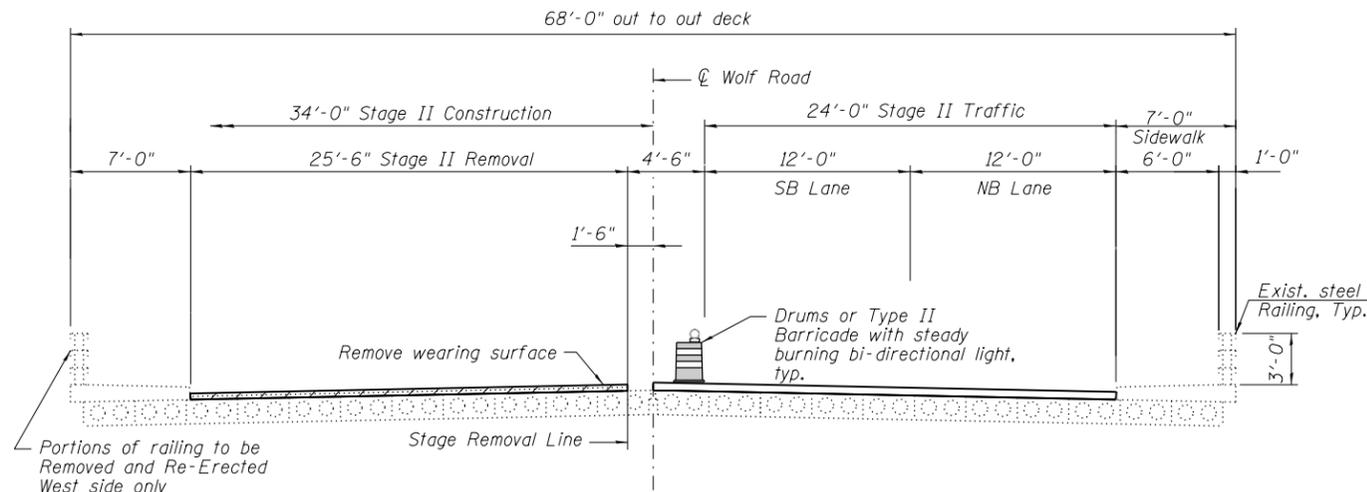

**STAGE I - CONSTRUCTION**

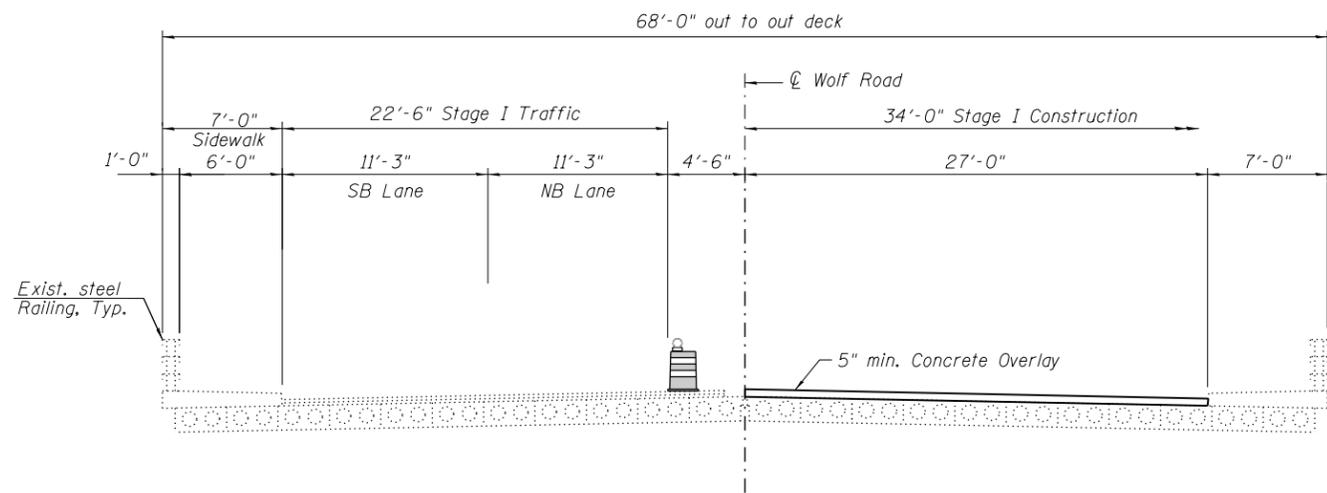

**STAGE II - CONSTRUCTION**

**Notes:**

Removal, storage and replacement of railings included in the cost of Removing and Re-Erecting Existing Railing.

See Sheet 6 of 9 for locations of Railing Removal.

All sections are looking North.

Removal of Concrete Haunch will be paid for as Concrete Removal. See Sheet 4 of 9.

**LEGEND**

Hot Mix Asphalt Surface Removal Complete

Remove Concrete Haunch, 2"



USER NAME = dheijden	DESIGNED - AB	REVISED
PLOT SCALE = 1/8" = 1' / in.	CHECKED - JMT	REVISED
PLOT DATE = 3/12/2018	DRAWN - JN	REVISED
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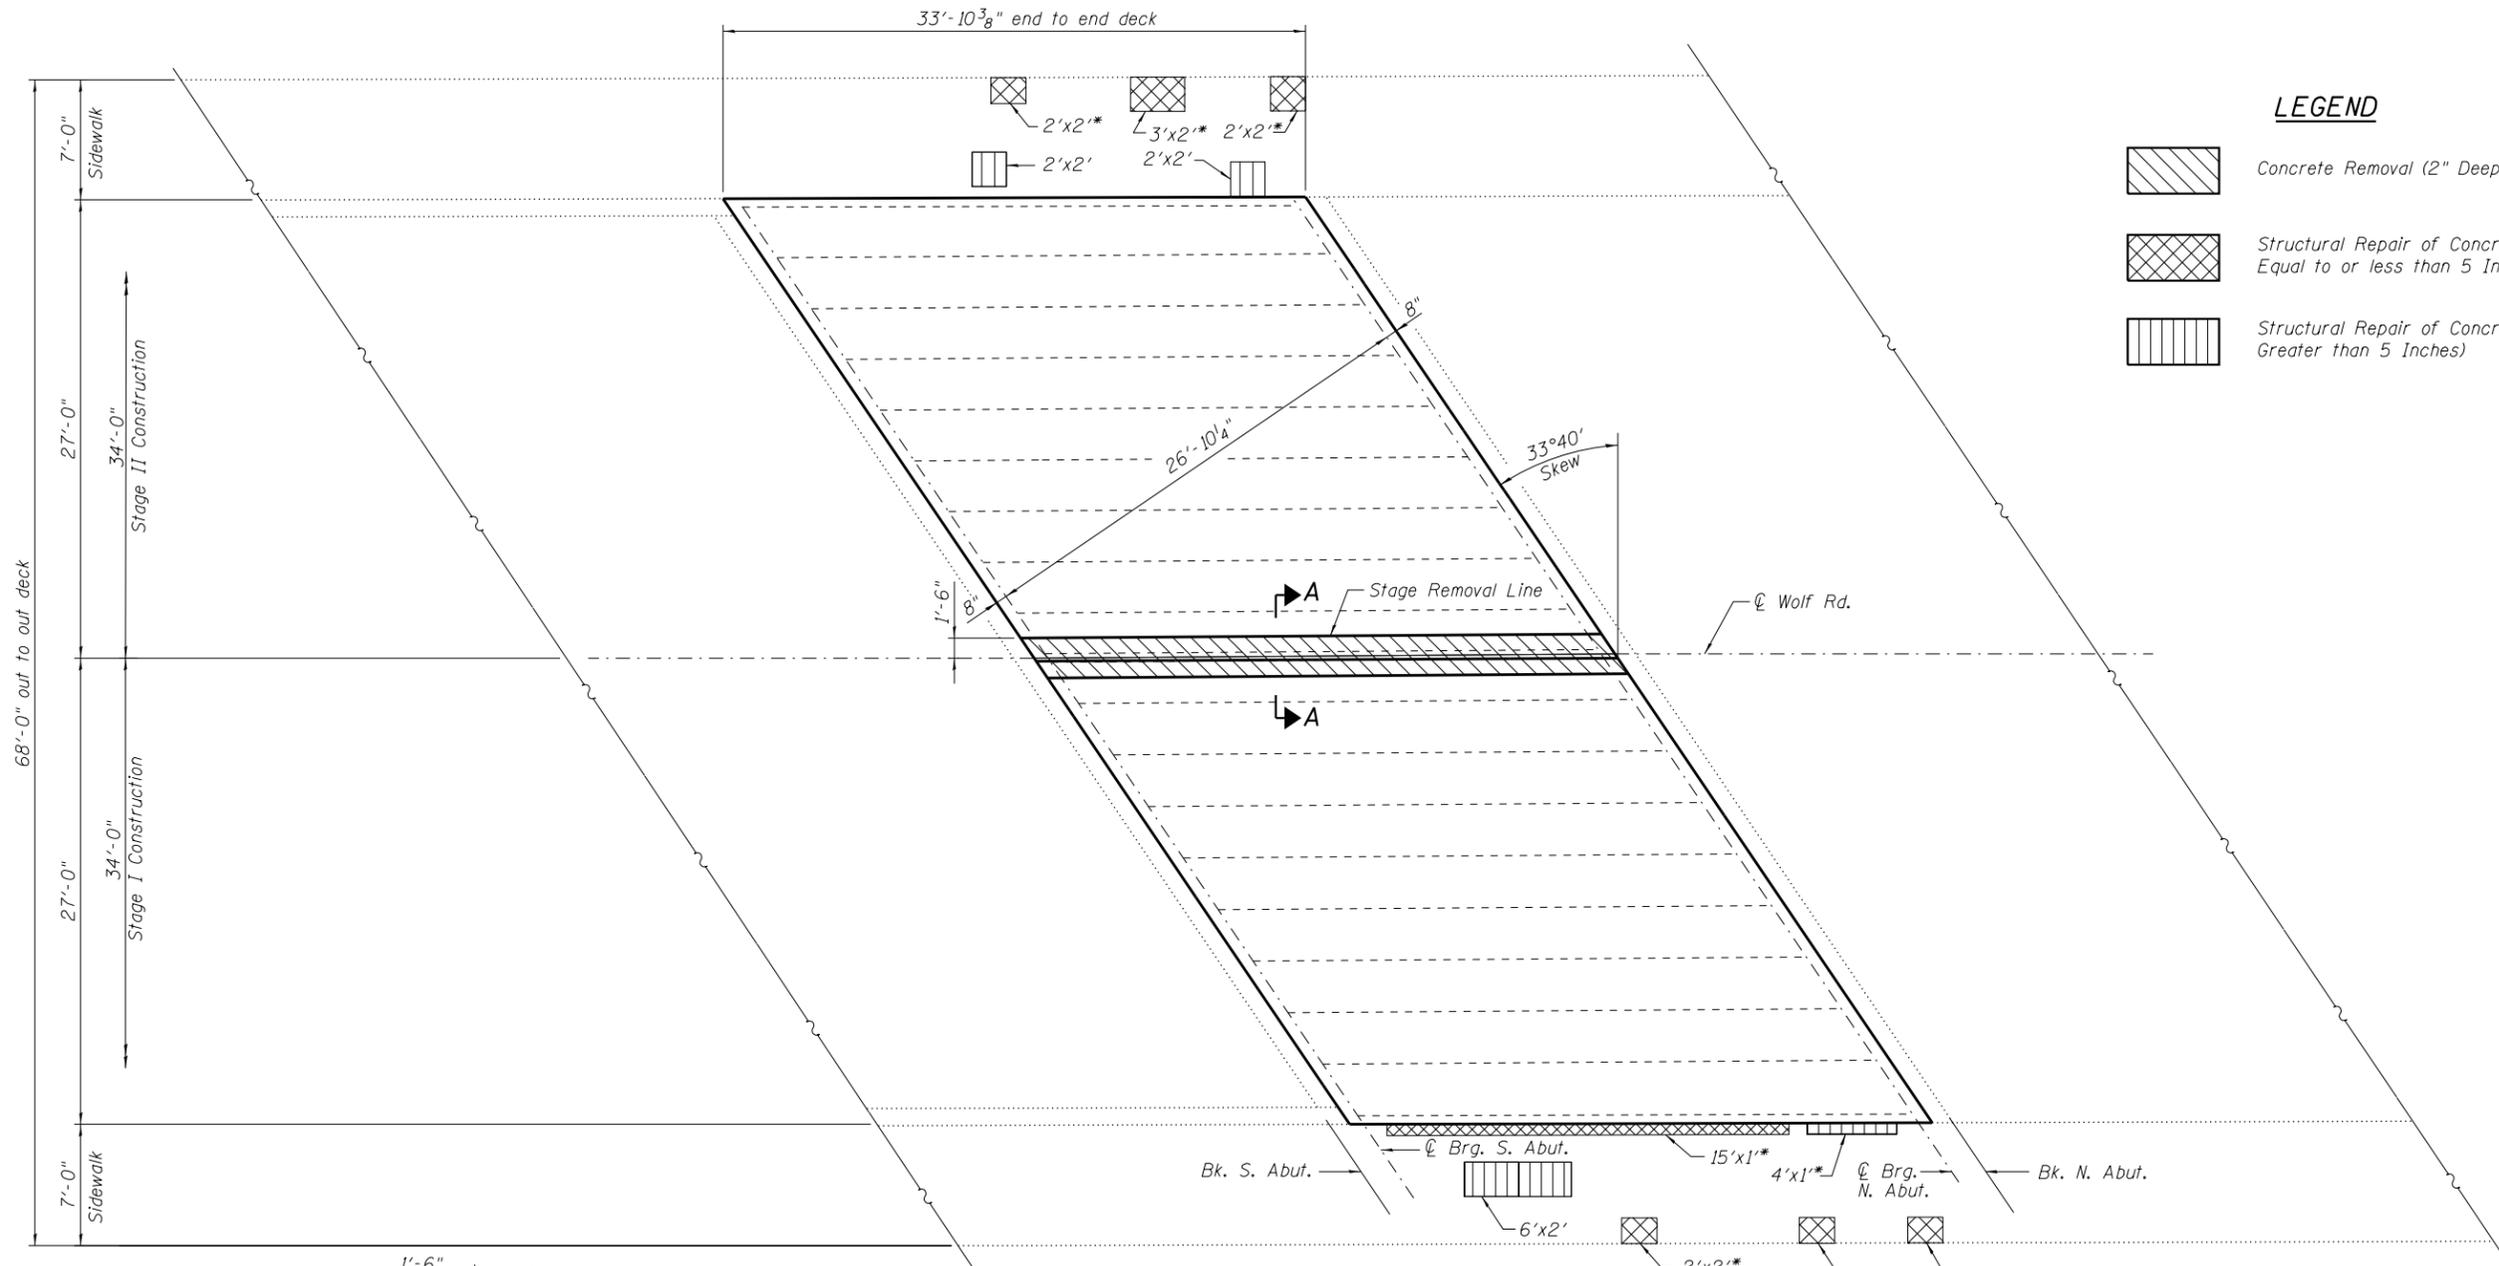
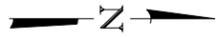
**STATE OF ILLINOIS  
DEPARTMENT OF TRANSPORTATION**

**STAGE CONSTRUCTION DETAILS  
STRUCTURE NO. 016-2009**

SHEET NO. 3 OF 9 SHEETS

F.A.U. RTE.	SECTION	COUNTY	TOTAL SHEETS	SHEET NO.
2691	3434.1-BR(13)	COOK	58	34
CONTRACT NO. 60W53				


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**LEGEND**

	Concrete Removal (2" Deep)
	Structural Repair of Concrete (Depth Equal to or less than 5 Inches)
	Structural Repair of Concrete (Depth Greater than 5 Inches)

**PLAN**  
(Beams under sidewalk not shown for clarity)



\* Repairs extend onto vertical face of sidewalk.  
 \*\* Existing reinforcement in beam haunch exposed during Concrete Removal shall be cut off flush and removed. Cost included with Concrete Removal.

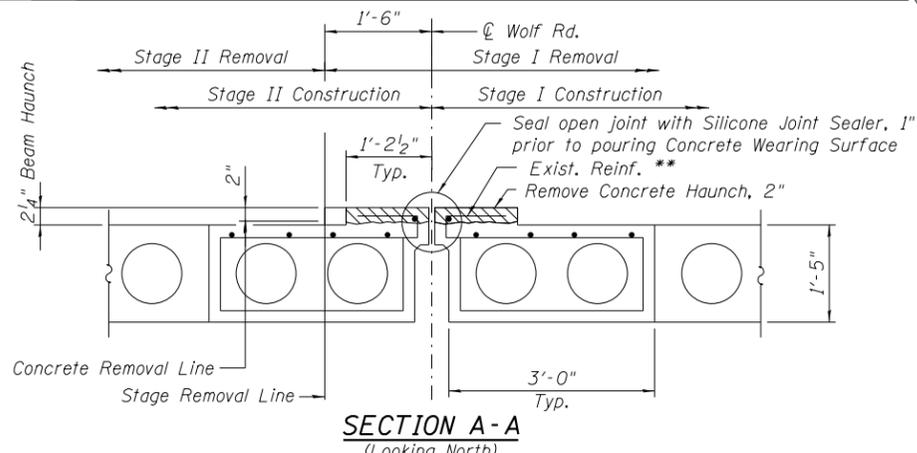Note:  
 Concrete Removal shall be performed using 15 lb. chipping hammers or hand tools according to Art. 501.05(a). The Contractor must exercise extreme care as to not damage the portion of the deck beams that are to remain. Any damage is to be repaired at the Contractor's expense to the satisfaction of the Engineer. Cost included in Concrete Removal.

**BILL OF MATERIAL**

Item	Unit	Total
Hot Mix Asphalt Surface Removal Complete	Sq. Yd.	204
Structural Repair of Concrete (Depth Equal to or less than 5 Inches)	Sq. Ft.	41
Structural Repair of Concrete (Depth Greater than 5 Inches)	Sq. Ft.	24
Concrete Removal	Cu. Yd.	0.6
Silicone Joint Sealer, 1"	Foot	34

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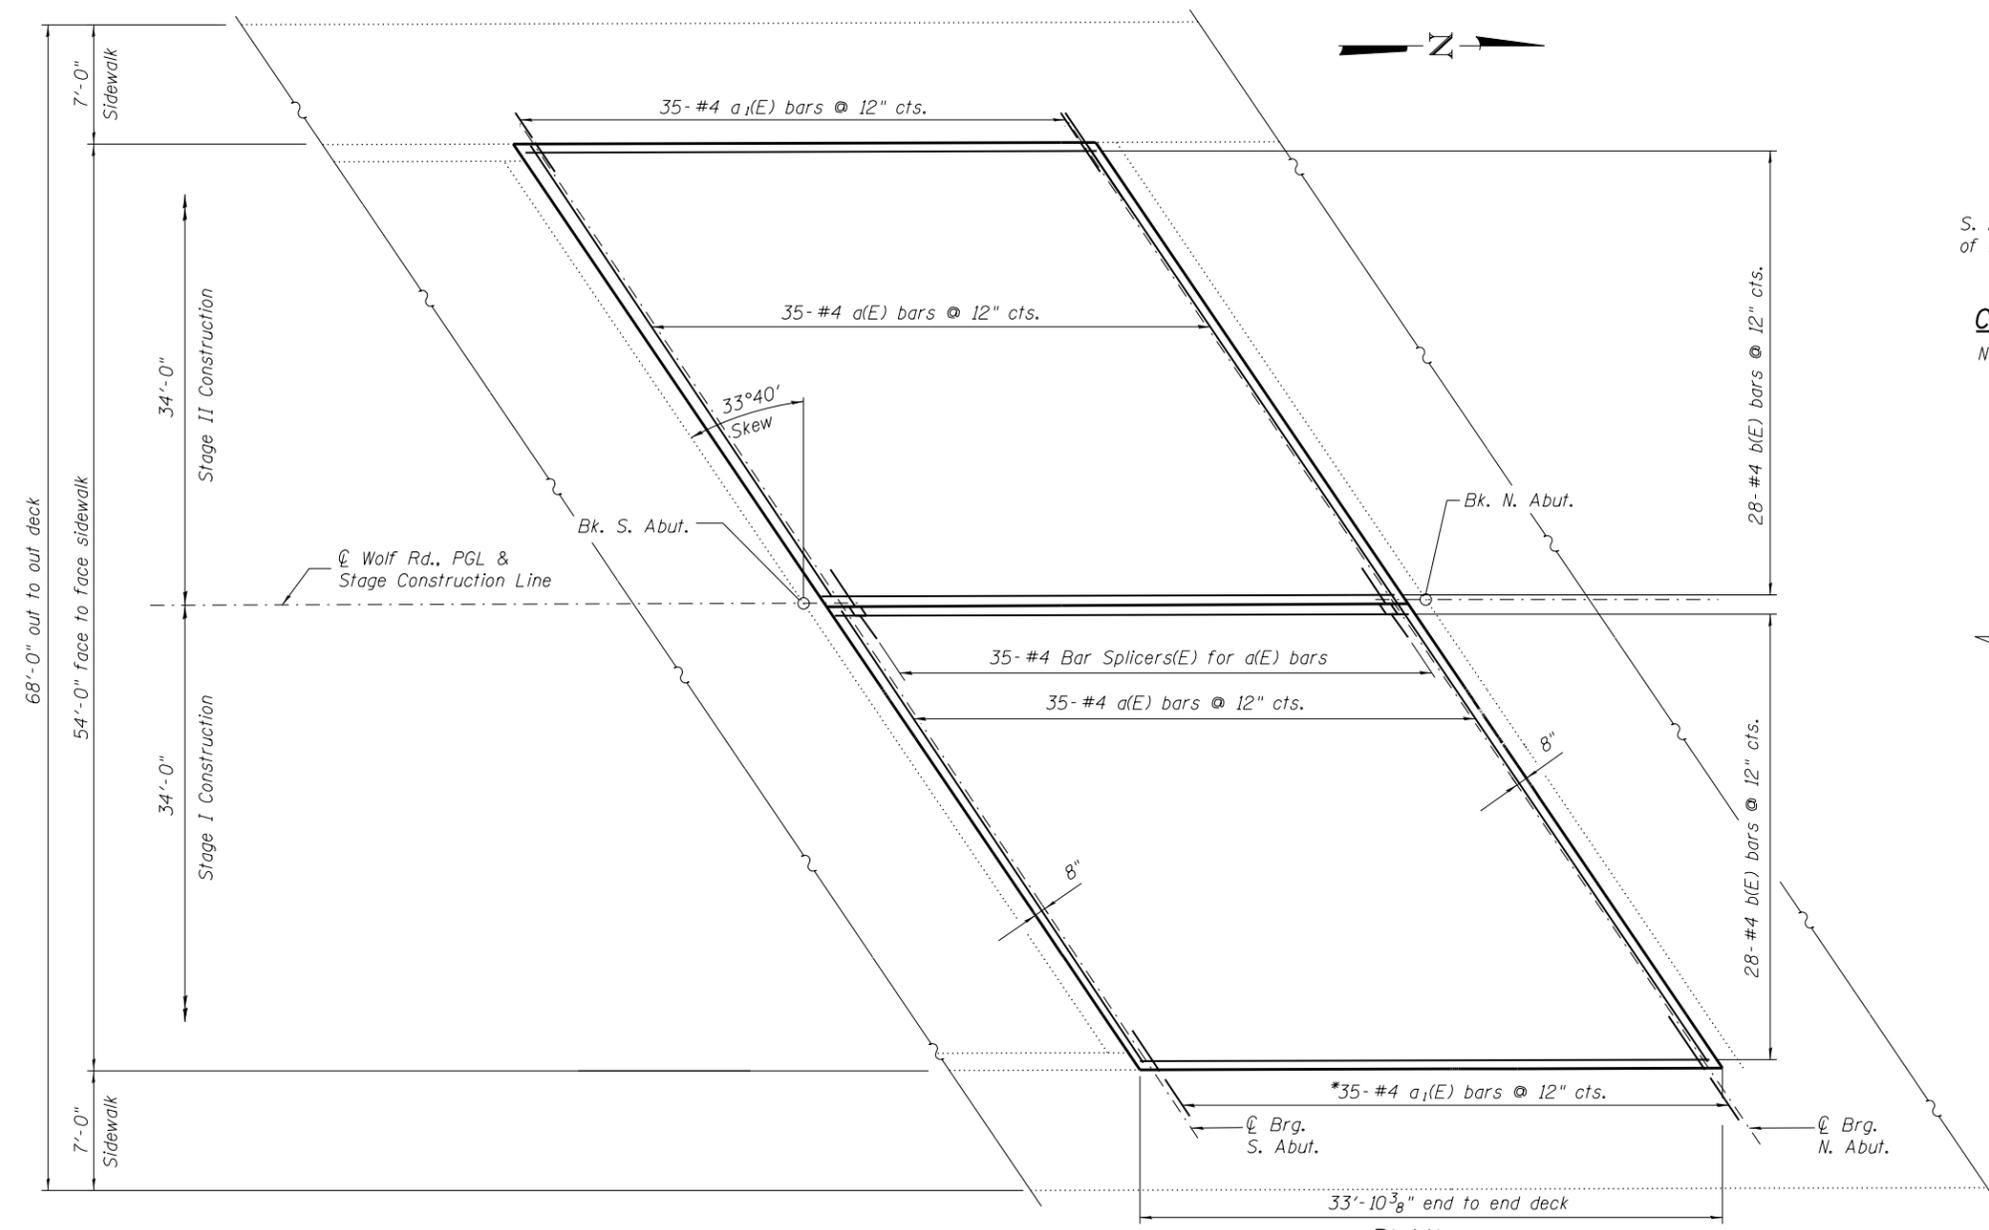
**STATE OF ILLINOIS  
DEPARTMENT OF TRANSPORTATION**

**DECK AND SIDEWALK REPAIR DETAILS  
STRUCTURE NO. 016-2009**


SHEET NO. 4 OF 9 SHEETS

F.A.U. RTE.	SECTION	COUNTY	TOTAL SHEETS	SHEET NO.
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CONTRACT NO. 60W53				

ILLINOIS FED. AID PROJECT




PLAN

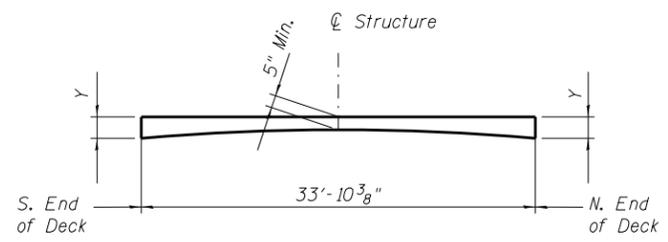

**CONCRETE WEARING SURFACE (CWS) PROFILE**

Note: For overlay on top of the approach slabs see roadway plans.

Y = 5" + Estimated Camber  
 Estimated Camber = ± 1/2"  
 Y = ± 5 1/2"

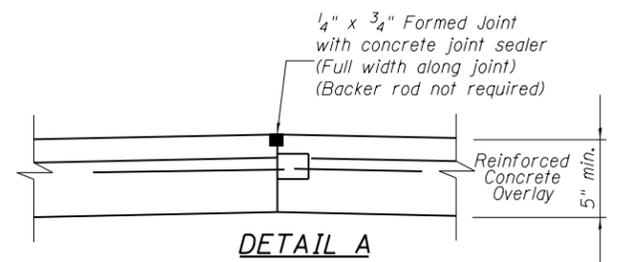


DETAIL A

**SUPERSTRUCTURE BILL OF MATERIAL**

Bar	No.	Size	Length	Shape
a(E)	70	#4	32'-1"	—
a1(E)	70	#4	2'-6"	—
b(E)	56	#4	33'-6"	—
Item	Unit	Total		
Bridge Deck Grooving	Sq. Yd.	196		
Protective Coat	Sq. Yd.	259		
Reinforcement Bars, Epoxy Coated	Pound	2880		
Concrete Wearing Surface, 5"	Sq. Yd.	204		
Keyway Repair	Foot	269		
Bearing Pad Adjustment	Each	44		

Note: Keyway Repair is an estimate only. The Engineer is to determine the actual quantity after the HMA surface is removed and show on the As-Built Plans.

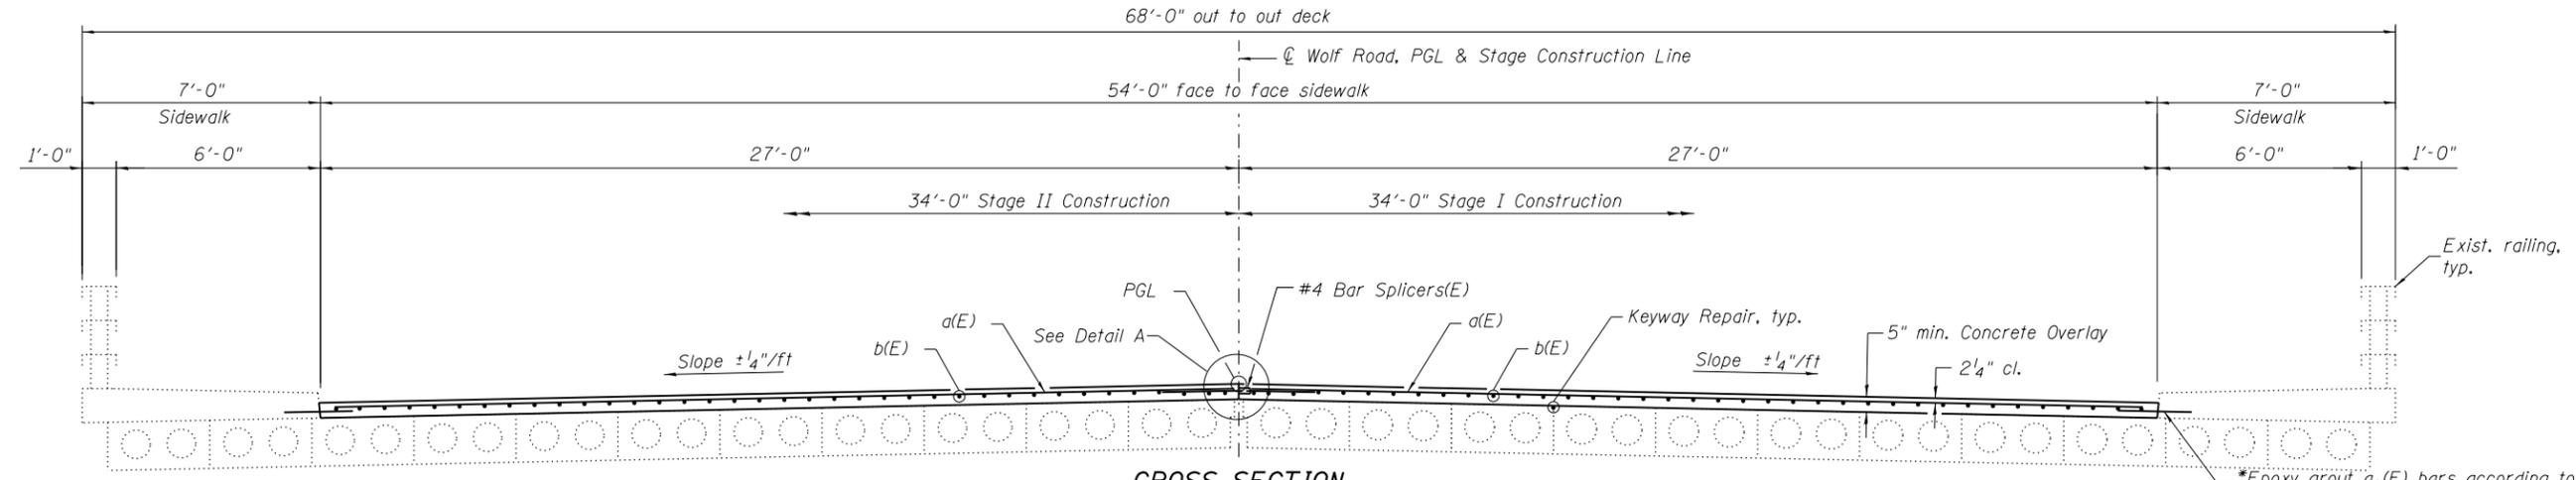

**CROSS SECTION**

(Looking North)

\*Epoxy grout a1(E) bars according to Article 584 of the Standard Specifications, typ. Cost of Grout included with the cost of Concrete Wearing Surface.

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**STATE OF ILLINOIS  
DEPARTMENT OF TRANSPORTATION**


**DECK OVERLAY PLAN AND CROSS SECTION  
STRUCTURE NO. 016-2009**

SHEET NO. 5 OF 9 SHEETS

F.A.U. RTE.	SECTION	COUNTY	TOTAL SHEETS	SHEET NO.
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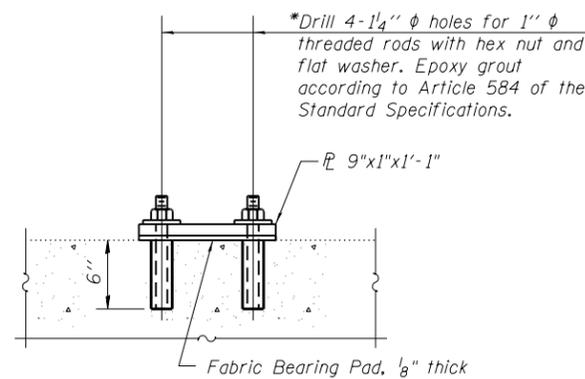
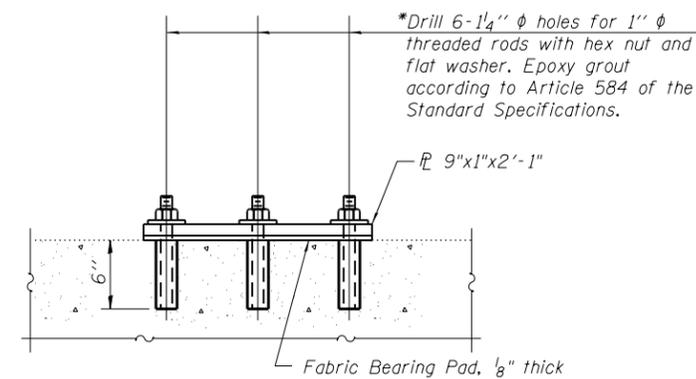
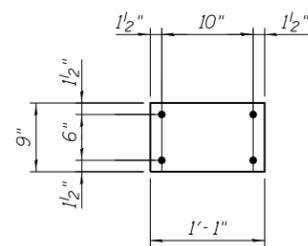
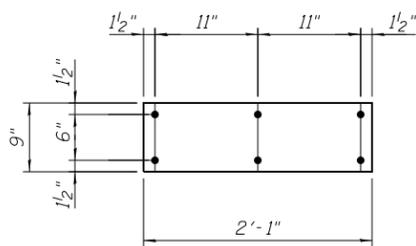
CONTRACT NO. 60W53

ILLINOIS FED. AID PROJECT

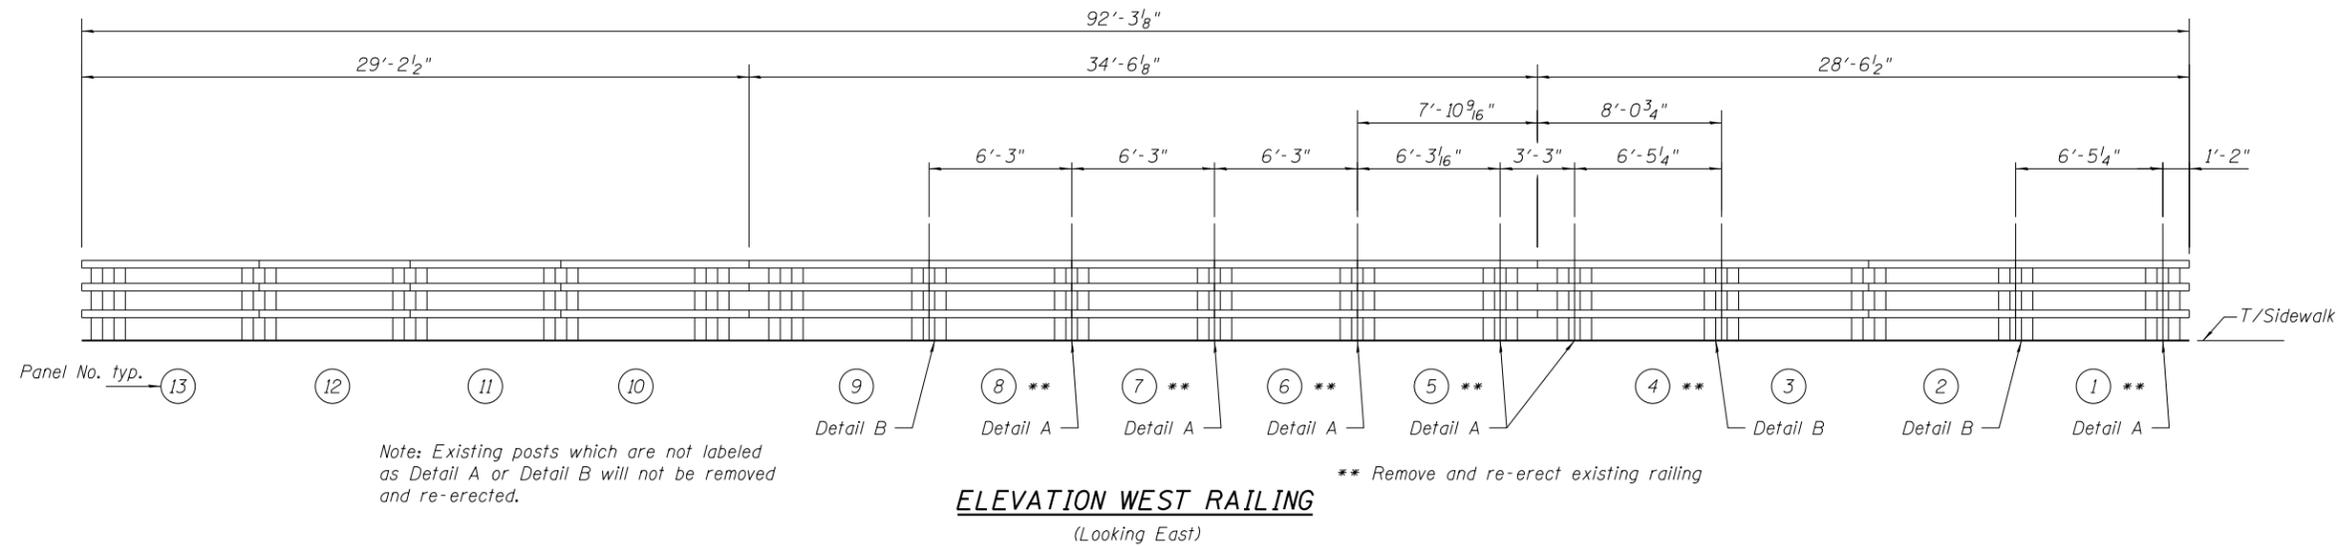

Note: Existing posts which are not labeled as Detail A or Detail B will not be removed and re-erected.

\*\* Remove and re-erect existing railing



**DETAIL A**

**DETAIL B**

**ANCHORAGE DETAILS**

\* Drilled holes for existing Sidewalk

**Notes:**

Bolts, cap screws and nuts shall conform to the requirements of ASTM designation A307 except for high strength bolts, nuts and washers noted which shall conform to AASHTO M164.

All bolts, nuts, cap screws, washers and lock washers shall be galvanized according to AASHTO M232.

The lower portion of the post flange in contact with concrete shall receive two coats of asphalt paint conforming to Section 1060.07 Type II or place new 1/8" fabric bearing pad between the post and concrete. Fabric bearing pads shall meet the requirements of Article 1082.01 of the Standard Specifications.

Removal and re-erection of the existing railing shall be accomplished in a manner that will avoid scratching, denting or other damage that may affect the durability or appearance of the railing. Contractor will be responsible for the repair in case of any damage.

The length paid for will be the overall length along the rail from end to end, in place, at the location of re-erection.

This work will be paid for at the contract unit price per foot for Removing and Re-erection Existing Railing, which price shall include removal, temporary storage, re-erection, asphalt paint or new bearing pads, shims and all new hardware required to satisfactorily complete the work.

**BILL OF MATERIAL**

Item	Unit	Total
Removing and Re-erection Existing Railing	Foot	43

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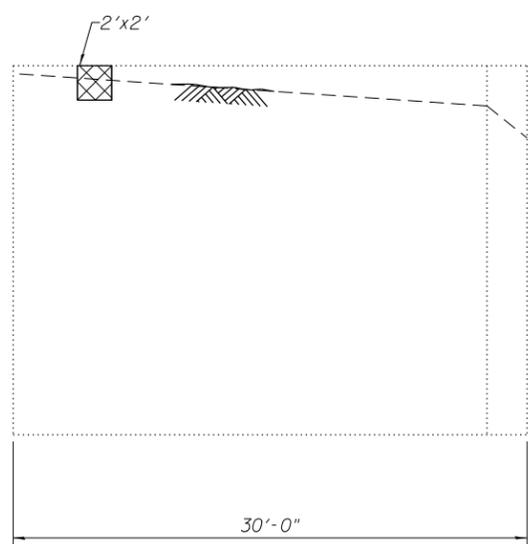
**STATE OF ILLINOIS  
 DEPARTMENT OF TRANSPORTATION**

**RAILING DETAILS  
 STRUCTURE NO. 016-2009**


SHEET NO. 6 OF 9 SHEETS

F.A.U. RTE.	SECTION	COUNTY	TOTAL SHEETS	SHEET NO.
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CONTRACT NO. 60W53				


ILLINOIS FED. AID PROJECT




**NW WING ELEVATION**

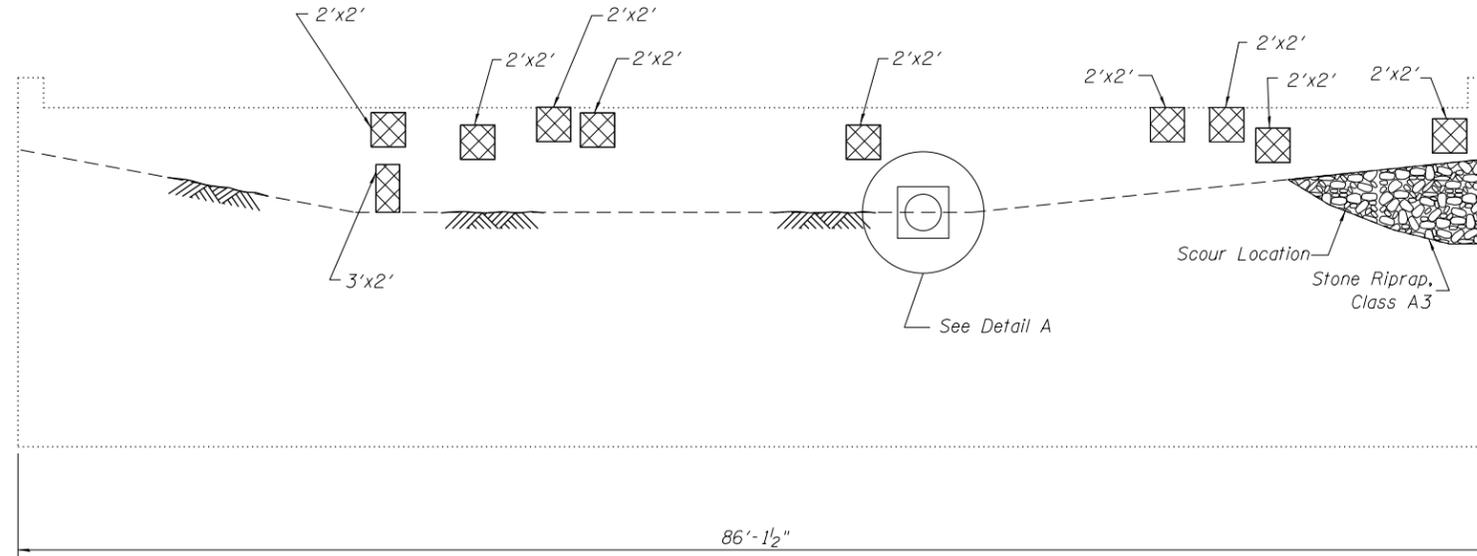


**NORTH ABUTMENT ELEVATION**

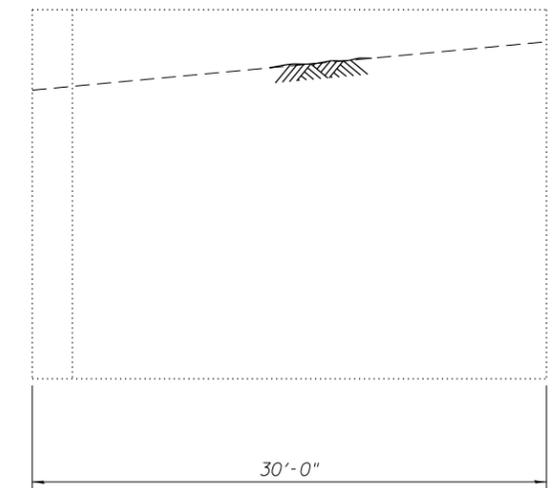

**NE WING ELEVATION**

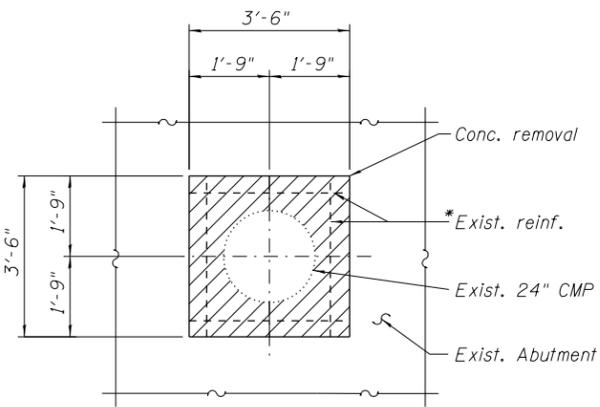


**EXISTING**

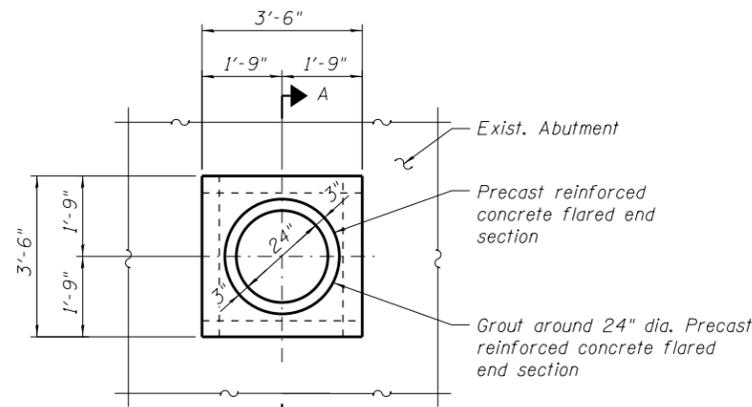

**PROPOSED**

**DETAIL A**

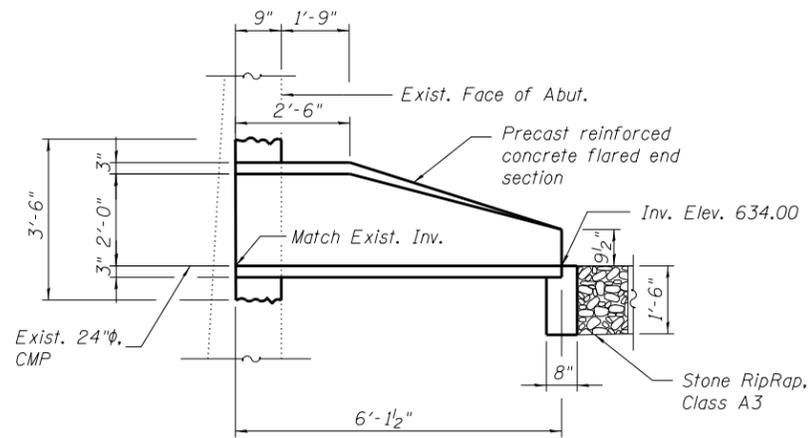

**SECTION A-A**

\* Existing reinforcement bars extending into the concrete removal area shall be cleaned, straightened and incorporated into the new construction. Any reinforcement bars damaged during concrete removal shall be replaced with an approved bar splicer or anchorage system. Cost included with Concrete Removal.

**LEGEND**

- Structural Repair of Concrete (Depth Equal to or Less Than 5 Inches)
- Concrete Removal

**NORTH ABUTMENT & WINGWALLS  
BILL OF MATERIAL**

Item	Unit	Total
Concrete Removal	Cu. Yd.	0.3
Concrete Structures	Cu. Yd.	0.2
Protective Coat	Sq. Yd.	2
Structural Repair of Concrete (Depth Equal to or Less Than 5 Inches)	Sq. Ft.	46

**NOTES:**

Protective Coat shall be applied to the new concrete on face of abutment around the precast end section.  
Stone Riprap, Class A3 included in Roadway Plans.

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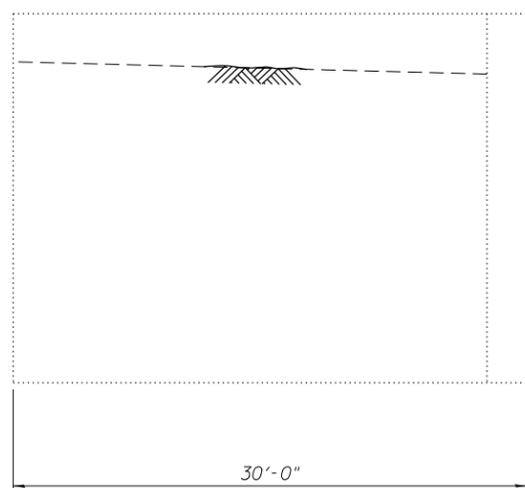
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**STATE OF ILLINOIS  
DEPARTMENT OF TRANSPORTATION**


**NORTH ABUTMENT AND WINGWALL REPAIRS  
STRUCTURE NO. 016-2009**

SHEET NO. 7 OF 9 SHEETS


F.A.U. RTE.	SECTION	COUNTY	TOTAL SHEETS	SHEET NO.
2691	3434.1-BR(13)	COOK	58	38
CONTRACT NO. 60W53			ILLINOIS FED. AID PROJECT	




SE WING ELEVATION

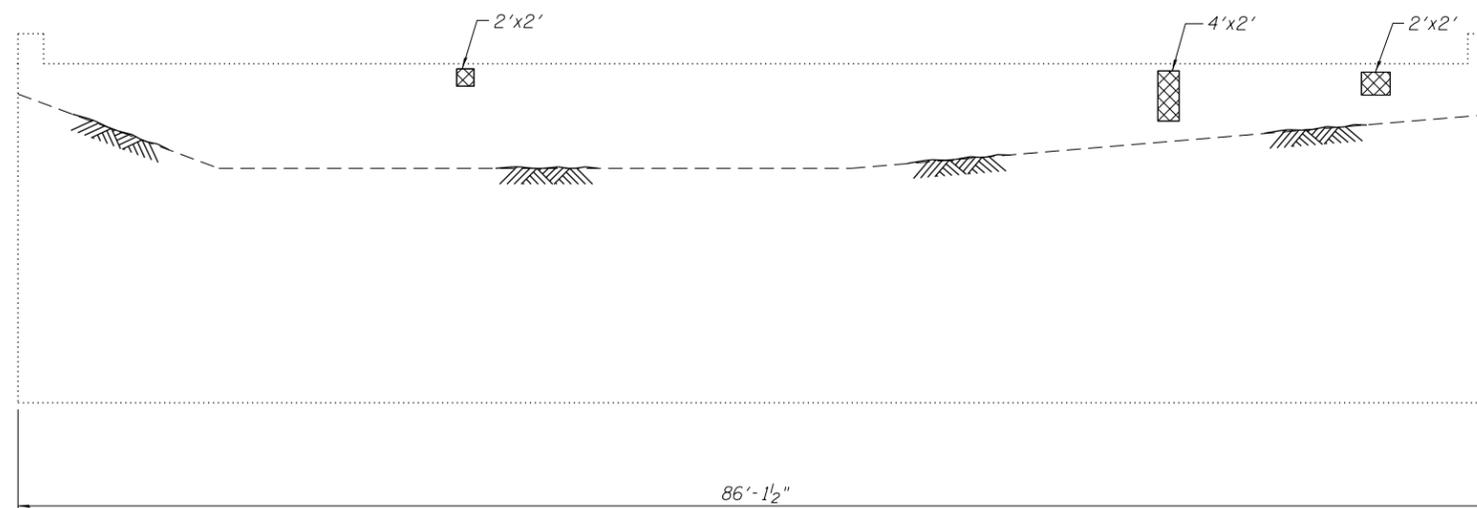


SOUTH ABUTMENT ELEVATION

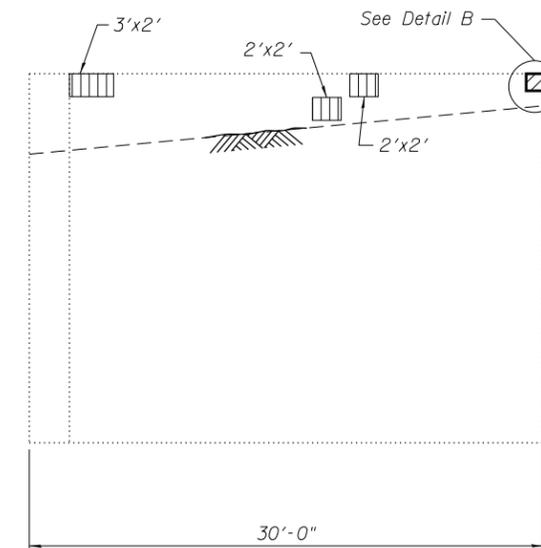

SW WING ELEVATION

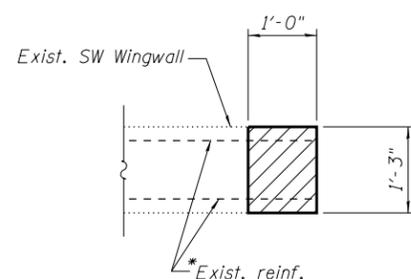

PLAN

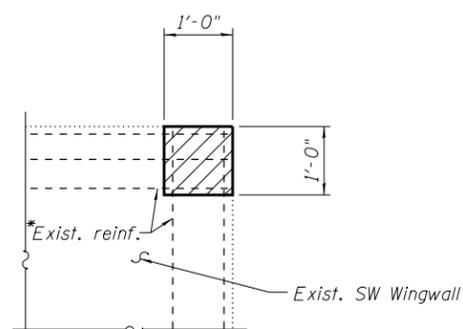

ELEVATION

DETAIL B

To be paid for as Concrete Removal and Concrete Structures

\* Existing reinforcement bars extending into the concrete repair area shall be cleaned, straightened and incorporated into the new construction. Any reinforcement bars damaged during concrete removal shall be replaced with an approved bar splicer or anchorage system. Cost included with Concrete Removal.

LEGEND

- Structural Repair of Concrete (Depth Equal to or Less Than 5 Inches)
- Structural Repair of Concrete (Depth Greater Than 5 Inches)
- Concrete Removal

SOUTH ABUTMENT & WINGWALLS  
BILL OF MATERIAL

Item	Unit	Total
Concrete Removal	Cu. Yd.	0.1
Concrete Structures	Cu. Yd.	0.1
Protective Coat	Sq. Yd.	1
Structural Repair of Concrete (Depth Equal to or Less Than 5 Inches)	Sq. Ft.	16
Structural Repair of Concrete (Depth Greater Than 5 Inches)	Sq. Ft.	14

NOTES:

Protective Coat shall be applied to the new concrete on the face and top of SW wingwall.

FILE NAME = Q:\Engineering\LiveProjects\13003 IDOT DUR\13003a - WD 1 Contract No. 60W53\CADD\CADD Sheets\Structural\016-2009-60W53-08-SABTREF.dgn




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	CHECKED - JMT	REVISED
PLOT SCALE = 1/8" = 1' / in.	DRAWN - JN	REVISED
PLOT DATE = 3/12/2018	CHECKED - JMT	REVISED

STATE OF ILLINOIS  
DEPARTMENT OF TRANSPORTATION

SOUTH ABUTMENT AND WINGWALL REPAIRS  
STRUCTURE NO. 016-2009

SHEET NO. 8 OF 9 SHEETS

F.A.U. RTE.	SECTION	COUNTY	TOTAL SHEETS	SHEET NO.
2691	3434.1-BR(13)	COOK	58	39
CONTRACT NO. 60W53			ILLINOIS FED. AID PROJECT	

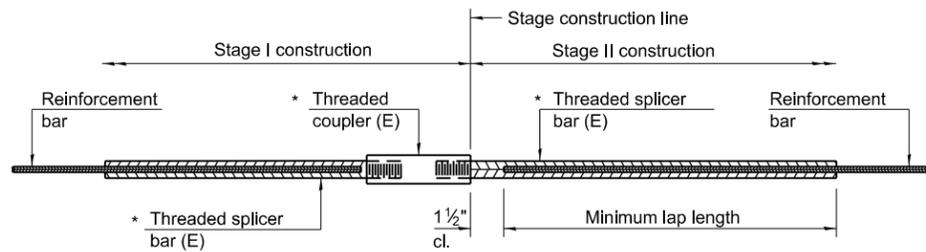


**STANDARD BAR SPLICER ASSEMBLY**

Threaded splicer bar length = min. lap length + 1 1/2" + thread length


\* Epoxy not required on Bar Splicer Assembly components used in conjunction with black bars.

Location	Bar size	No. assemblies required	Minimum lap length
Conc. Wearing Surface	#4	35	2'-5"

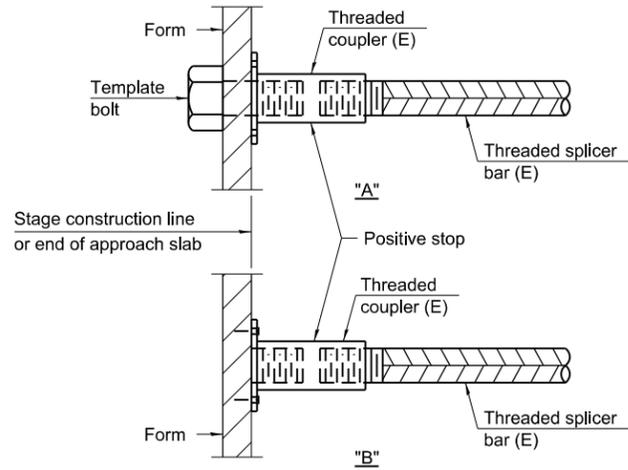


**INSTALLATION AND SETTING METHODS**

"A" : Set bar splicer assembly by means of a template bolt.  
 "B" : Set bar splicer assembly by nailing to wood forms or cementing to steel forms.  
 (E) : Indicates epoxy coating.

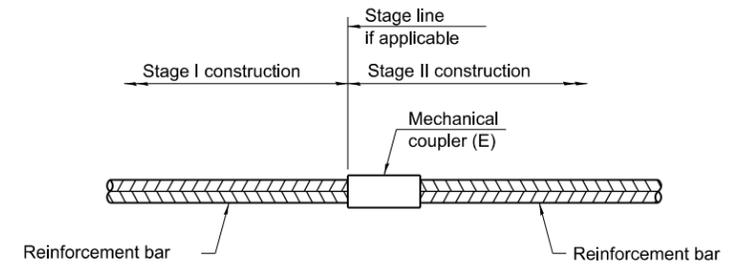

**STANDARD MECHANICAL SPLICER**

Location	Bar size	No. assemblies required

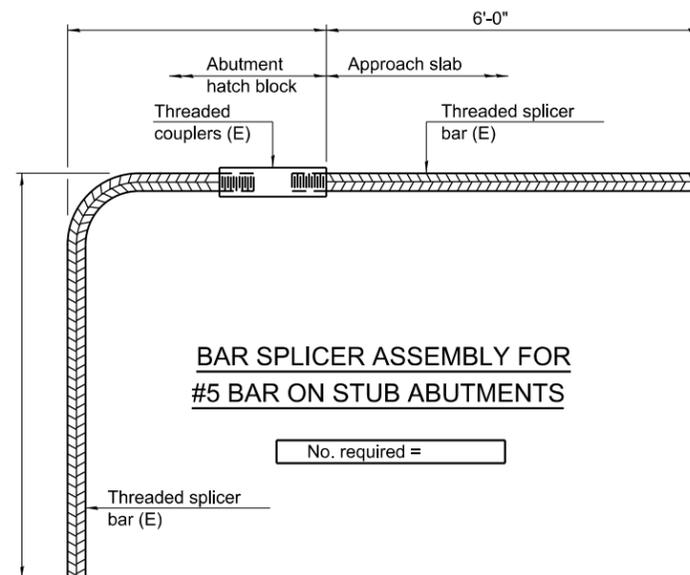

**BAR SPLICER ASSEMBLY FOR #5 BAR ON STUB ABUTMENTS**

No. required =

**NOTES**

Splicer bars shall be deformed with threaded ends and have a minimum 60 ksi yield strength.  
 All reinforcement shall be lapped and tied to the splicer bars.  
 Bar splicer assemblies shall be epoxy coated according to the requirements for reinforcement bars. See Section 508 of the Standard Specifications.  
 See approved list of bar splicer assemblies and mechanical splicers for alternatives.

FILE NAME = Q:\Engineering\LiveProjects\13003 IDOT DURV\3003a - WD 1 Contract No. 60W53\CADD\CADD Sheets\Structural\016-2009-60W53-01-BARSPLI.Cad

BSD-1 2-17-2017



USER NAME = dhejden	DESIGNED - PP	REVISED
PLOT SCALE = 0:2.0000 '1' / in.	CHECKED - JMT	REVISED
PLOT DATE = 3/12/2018	DRAWN - JN	REVISED
	CHECKED - JMT	REVISED


STATE OF ILLINOIS  
DEPARTMENT OF TRANSPORTATION

BAR SPLICER ASSEMBLY AND MECHANICAL SPLICER DETAILS  
STRUCTURE NO. 016-2009

SHEET NO. 9 OF 9 SHEETS


F.A.U. RTE.	SECTION	COUNTY	TOTAL SHEETS	SHEET NO.
2691	3434.1-BR(13)	COOK	58	40
CONTRACT NO. 60W53				

ILLINOIS FED. AID PROJECT

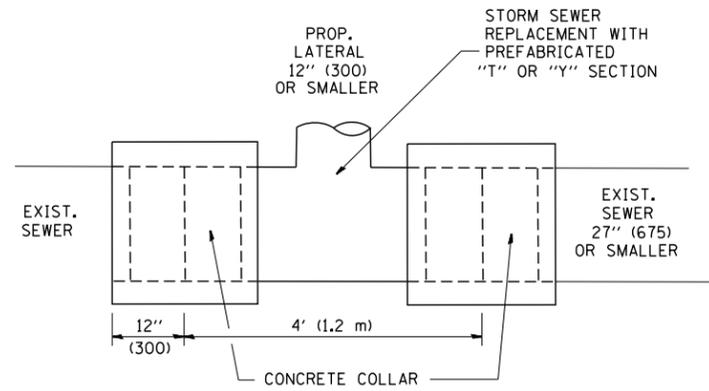

**DETAIL "A"**

LATERAL CONNECTION TO EXISTING SEWER OF 27" (675) OR SMALLER

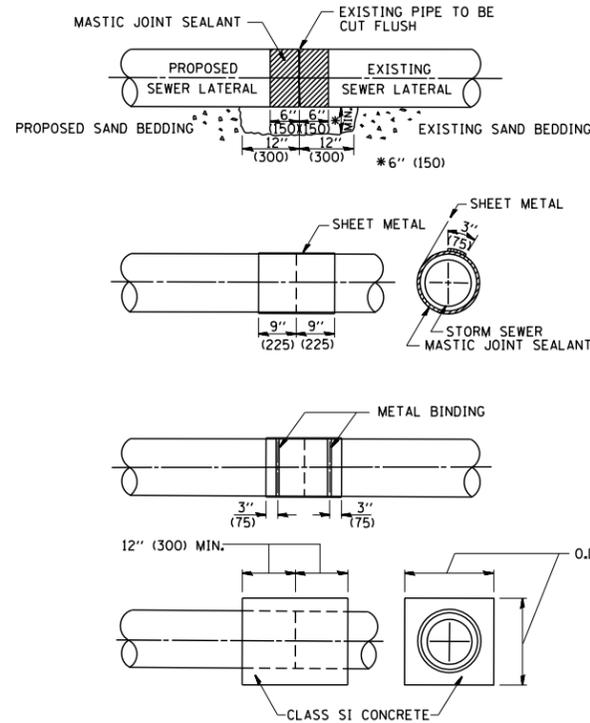


**DETAIL "B"**

CLASS SI CONCRETE COLLAR

**CONSTRUCTION SEQUENCE**

1. CUT THE EXISTING END OF THE PIPE SO AS TO PRESENT A FLUSH BUTT JOINT. BRUSH AND CLEAN ALL PIPES.
2. APPLY THE MASTIC JOINT SEALANT TO THE FIRST 6" (150) OF EACH PIPE.
3. BUTT THE PIPES TOGETHER LEAVING A MINIMUM OF 12" x 6" (300 x 150) DEEP EXCAVATION UNDER AND AROUND EACH PIPE END.
4. CUT A PIECE OF SHEET METAL GAGE NO. 19 1.1 (0.0418) 18" (450) WIDE BY THE OUTSIDE CIRCUMFERENCE OF THE PIPE PLUS 3" (75) LONG.
5. WRAP THE SHEET METAL AROUND THE PIPES, 9" (225) ON EACH SIDE OF THE JOINT, STARTING AT THE TOP OF THE PIPE.
6. LAP THE SHEET METAL AT LEAST 3" (75) AT THE TOP OF THE PIPE AND PLACE THE MASTIC JOINT SEALANT BETWEEN THE LAP.
7. PLACE TWO METAL BANDS AROUND THE SHEET METAL AND TIGHTEN.
8. WIPE OFF ANY EXCESS MASTIC JOINT SEALANT THAT OOOZES OUT FROM BETWEEN THE SHEET METAL AND THE PIPES.
9. PLACE CLASS SI CONCRETE AROUND THE JOINT.

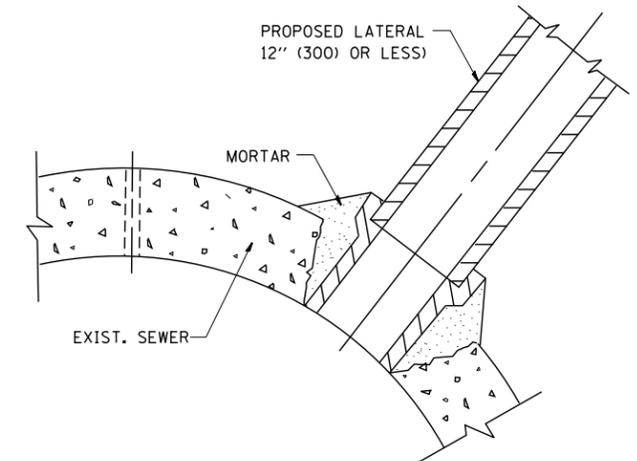

**DETAIL "C"**

PROPOSED LATERAL CONNECTION TO EXISTING SEWER OF 30" (750) OR LARGER

**NOTES**

**MATERIAL**

MATERIAL USED FOR THE TEE OR WYE SECTION SHALL BE COMPATIBLE WITH THE EXISTING STORM SEWER OR THE PROPOSED STORM SEWER.

**CONSTRUCTION METHODS**

- I. THIS WORK SHALL BE CONSTRUCTED IN CONFORMANCE WITH THE APPLICABLE PORTIONS OF SECTION 550 OF THE STANDARD SPECIFICATIONS.
- II. CONNECTION TO AN EXISTING STORM SEWER SHALL BE BY EITHER OF THE FOLLOWING METHODS:
  - A) PROPOSED STORM SEWER CONNECTION TO EXISTING SEWER OF 27" (675) OR SMALLER SEE DETAIL "A" AND "B".
  - B) PROPOSED STORM SEWER CONNECTION TO EXISTING SEWER OF 30" (750) OR LARGER SEE DETAIL "C".

IF THE EXISTING SEWER PIPE IS CRACKED, BROKEN OR OTHERWISE DAMAGED BY THE CONTRACTOR IN MAKING THE CIRCULAR OPENING, THE CONTRACTOR SHALL REPLACE THAT SECTION OF PIPE WITH PIPE EQUAL AND SIMILAR IN ALL RESPECTS TO THE PIPE IN THE EXISTING SEWER, IN A CAREFUL WORKMANLIKE MANNER, WITHOUT EXTRA COMPENSATION.

**GENERAL**

CARE MUST BE TAKEN TO PREVENT DEBRIS FROM ENTERING THE SEWER. ALL DEBRIS WHICH ENTERS THE SEWER MUST BE REMOVED. THE SEWER MUST BE LEFT CLEAN AND UNOBSTRUCTED UPON COMPLETION OF THE CONTRACT.

CARE MUST BE TAKEN TO PREVENT ANY PART OF THE NEW PIPE CONNECTION FROM PROJECTING INTO THE EXISTING SEWER.

**BASIS OF PAYMENT**

TEE OR WYE CONNECTIONS SHALL BE PAID FOR AT THE CONTRACT UNIT PRICE EACH FOR STORM SEWER TEE OR WYE OF THE TYPE AND SIZE SPECIFIED IN THE PLANS. THIS PRICE SHALL INCLUDE ALL EXCAVATION OF THE TRENCH, REMOVAL OF THE EXISTING STORM SEWER, FURNISHING AND INSTALLING THE SPECIFIED TEE OR WYE SECTION, FURNISHING AND INSTALLING THE REQUIRED CONCRETE COLLAR, AND ALL OTHER MATERIAL NECESSARY TO COMPLETE THIS WORK AS SHOWN AND SPECIFIED.

REMOVAL AND REINSTALLATION OF EXISTING STORM SEWER ADJACENT TO THE PROPOSED TEE OR WYE SECTION, FOR THE PURPOSE OF FACILITATING THE INSTALLATION OF THE TEE OR WYE SECTION, WILL NOT BE PAID FOR SEPARATELY BUT SHALL BE INCLUDED IN THE UNIT PRICE BID FOR THE WORK.

TRENCH BACKFILL, EXCAVATION IN ROCK AND REMOVAL AND REPLACEMENT OF UNSUITABLE MATERIAL BELOW PLAN BEDDING GRADE WILL BE PAID FOR SEPARATELY.

CONCRETE COLLAR FOR CONNECTING A PROPOSED STORM SEWER TO AN EXISTING STORM SEWER WILL NOT BE PAID FOR SEPARATELY BUT SHALL BE INCLUDED IN THE COST OF THE PROPOSED STORM SEWER.

ALL DIMENSIONS ARE IN INCHES (MILLIMETERS) UNLESS OTHERWISE SHOWN.

FILE NAME = W:\diststd\22x34\bd07.dgn	USER NAME = geglionbt	DESIGNED - M. DE YONG	REVISED - M. DE YONG 05-08-92
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	PLOT SCALE = 50.000' / IN.	CHECKED -	REVISED - R. SHAH 10-25-94
	PLOT DATE = 1/4/2008	DATE - 07-25-90	REVISED - R. SHAH 06-12-96

**STATE OF ILLINOIS  
DEPARTMENT OF TRANSPORTATION**

**DETAIL OF STORM SEWER  
CONNECTION TO EXISTING SEWER**

SCALE: NONE SHEET NO. 1 OF 1 SHEETS STA. TO STA.

F.A.U. RTE.	SECTION	COUNTY	TOTAL SHEETS	SHEET NO.
2691	3434.1-BR(13)	COOK	58	41
<b>BD500-01 (BD-7)</b>		CONTRACT NO. 60W53		
FED. ROAD DIST. NO. 1 ILLINOIS FED. AID PROJECT				

VARIABLE - TO MEET EXISTING DIMENSIONS AND FIELD CONDITIONS (SEE NOTE ②)

PROP. CONC. CURB OR CURB AND GUTTER REPLACEMENT IN ACCORDANCE WITH STATE STANDARD 606001. (SEE NOTE ②)

SAW CUT FULL DEPTH - INCLUDED IN THE COST OF SIDEWALK, DRIVEWAY OR MEDIAN SURFACE REMOVAL PAY ITEM.

SEE STATE STANDARD 606001  
EXISTING OR PROPOSED HMA SURFACE (IF APPLICABLE)

18" (450) MAX.

1/4" (5) \*\*

EXISTING SIDEWALK, DRIVEWAY, MEDIAN SURFACE, SOD OR GROUND.

PROPOSED SIDEWALK, DRIVEWAY PAVEMENT, MEDIAN SURFACE OR SODDING SALT TOLERANT WITH TOP SOIL, 4" (100) SOD RESTORATION (SEE NOTE ①).

EXISTING CONCRETE PAVEMENT, CONCRETE BASE COURSE OR FLEXIBLE PAVEMENT

3" (75) MIN.

SUITABLE BACKFILL MATERIAL (INCLUDED IN THE COST OF CURB OR CURB AND GUTTER REMOVAL AND REPLACEMENT)

PROPOSED 3/4" (20) PREFORMED EXPANSION JOINT AT CONCRETE SIDEWALKS, DRIVEWAYS, AND MEDIANS. (INCLUDED IN THE COST OF CURB OR CURB AND GUTTER REMOVAL AND REPLACEMENT.)

\* 3" (75) MINIMUM FROM TOP AND BOTTOM OF THE CONCRETE PAVEMENT OR BASE COURSE.

\*\* IF THE FINAL SURFACE OF THE PAVEMENT IS CONCRETE, THE GUTTER IS TO BE FLUSH WITH THE PAVEMENT.

UNSUITABLE SUB-BASE MATERIAL TO BE REMOVED, IF DIRECTED BY THE ENGINEER, SHALL BE REPLACED WITH EITHER SUB-BASE GRANULAR MATERIAL, TYPE B OR ADDITIONAL THICKNESS OF CONCRETE.

NOTE: ① SIDEWALK, DRIVEWAY PAVEMENT OR MEDIAN SURFACE SHALL BE SIMILAR TO THE MATERIAL BEING REMOVED AND WILL BE PAID FOR SEPARATELY.

SODDING, SALT TOLERANT AND TOP SOIL, FURNISH AND PLACE 4" WILL BE PAID FOR SEPARATELY.

REMOVAL AND REPLACEMENT 4" (100) OR LESS IS INCLUDED IN THE COST OF CURB OR CURB AND GUTTER REMOVAL AND REPLACEMENT.

② FERTILIZER FOR THE PLACEMENT OF THE SOD IS NOT REQUIRED

③ CURB OR CURB AND GUTTER REPLACEMENT SHALL MATCH THE SHAPE OF THE EXISTING CURB OR CURB AND GUTTER UNLESS OTHERWISE SPECIFIED.

REMOVAL AND REPLACEMENT IN EXCESS OF 4" (100) WILL BE PAID FOR IN ACCORDANCE WITH ARTICLE 109.04 OF THE STANDARD SPECIFICATIONS.

④ FOR CURB OR CURB AND GUTTER REMOVAL AND REPLACEMENT ADJACENT TO FLEXIBLE PAVEMENT DELETE EPOXY COATED TIE BARS.

PROPOSED #6 (20) EPOXY COATED TIE BARS 24" (600) LONG AT 24" (600) CENTERS WILL NOT BE PAID FOR SEPARATELY. DELETE EPOXY COATED TIE BARS IF EXISTING TIE BARS ARE USABLE AS DETERMINED BY THE ENGINEER. (SEE NOTE ③).

⑤ LONGITUDINAL BARS, IF ENCOUNTERED IN THE EXISTING CURB OR CURB AND GUTTER, ARE NOT TO BE REPLACED. CUTTING AND REMOVING LONGITUDINAL BARS SHALL BE INCLUDED IN THE COST OF CURB OR CURB AND GUTTER REMOVAL AND REPLACEMENT.

⑥ THE COST OF HMA SURFACE REMOVAL IN THE EXISTING GUTTER FLAG SHALL BE INCLUDED IN THE COST OF THE CURB AND GUTTER REMOVAL AND REPLACEMENT.

BASIS OF PAYMENT:  
THIS WORK WILL BE PAID FOR AT THE CONTRACT UNIT PRICE PER FOOT (METER) FOR "CURB REMOVAL AND REPLACEMENT" OR "COMBINATION CONCRETE CURB AND GUTTER REMOVAL AND REPLACEMENT".


⑦ THE REMOVAL AND REPLACEMENT OF THE EXISTING CURB OR CURB AND GUTTER SHALL BE DONE IN ACCORDANCE WITH THE APPLICABLE PORTIONS OF SECTION 440 AND 606 OF THE STANDARD SPECIFICATIONS.

⑧ THE LOCATIONS OF REMOVAL AND REPLACEMENT OF EXISTING CURB OR CURB AND GUTTER SHALL BE DETERMINED BY THE RESIDENT ENGINEER AT THE TIME OF CONSTRUCTION.

# CURB OR CURB AND GUTTER REMOVAL AND REPLACEMENT

ALL DIMENSIONS ARE IN INCHES (MILLIMETERS) UNLESS OTHERWISE SHOWN.

FILE NAME =	USER NAME = drivakosgn	DESIGNED - A. HOUSEH	REVISED - R. SHAH 10-03-96	<b>STATE OF ILLINOIS DEPARTMENT OF TRANSPORTATION</b>	<b>CURB OR CURB AND GUTTER REMOVAL AND REPLACEMENT</b>			F.A.U. RE.	SECTION	COUNTY	TOTAL SHEETS	SHEET NO.	
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	PLOT DATE = 12/15/2009	DATE - 03-11-94	REVISED - R. BORO 12-15-09		FED. ROAD DIST. NO. 1 ILLINOIS FED. AID PROJECT								

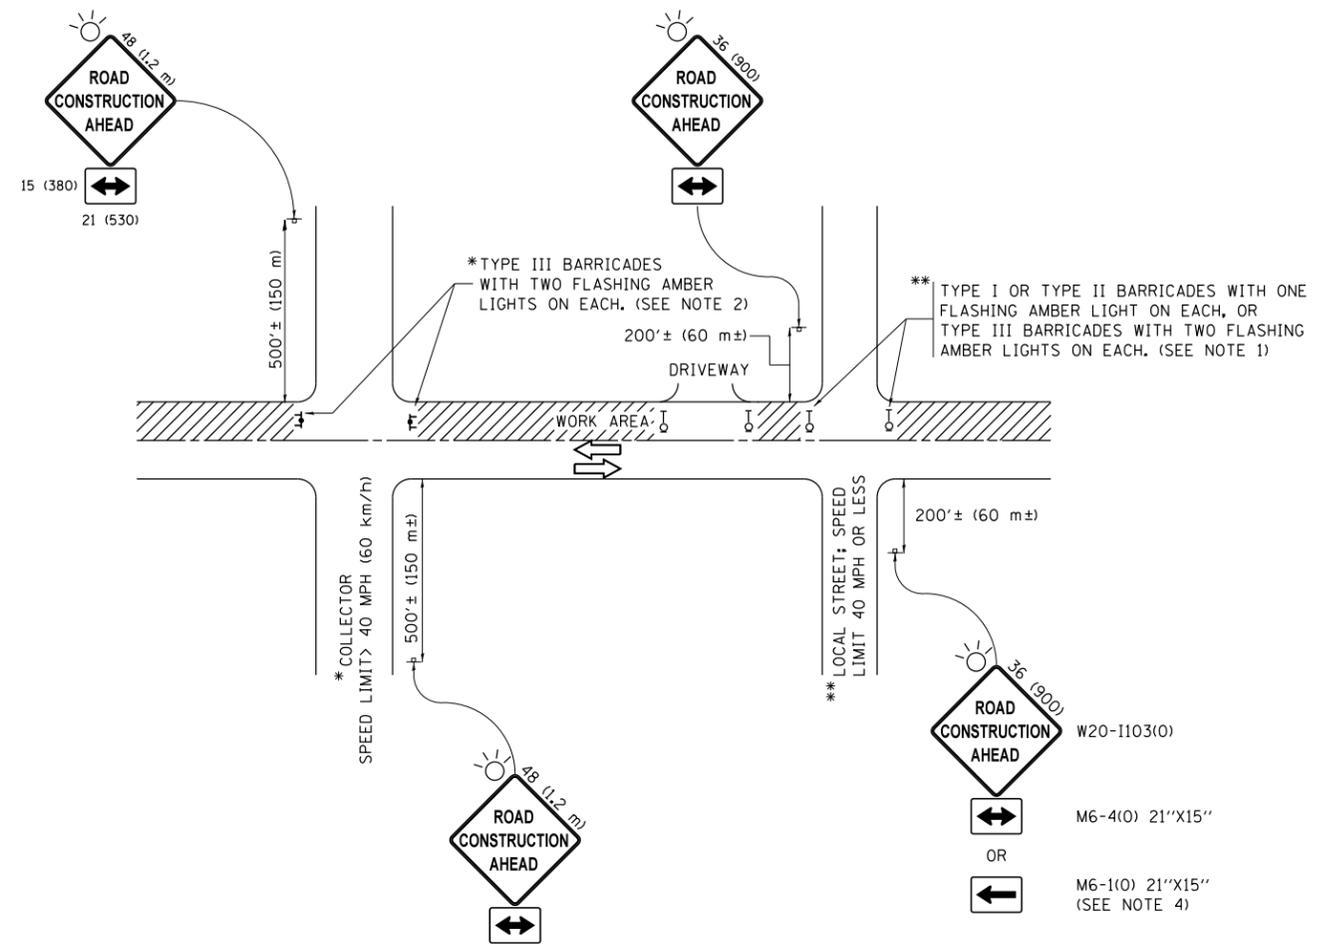

**NOTES:**

1. SIDE ROAD WITH A SPEED LIMIT OF 40 MPH (60 km/h) OR LESS AS SHOWN ON THE DRAWING AND AS DIRECTED BY THE ENGINEER:
  - a) ONE "ROAD CONSTRUCTION AHEAD" SIGN 36 x 36 (900x900) WITH A FLASHER MOUNTED ON IT APPROXIMATELY 200' (60 m) IN ADVANCE OF THE MAIN ROUTE.
  - b) THE CLOSED PORTION OF THE MAIN ROUTE SHALL BE PROTECTED BY BLOCKING WITH TYPE I, TYPE II OR TYPE III BARRICADES, 1/3 OF THE CROSS SECTION OF THE CLOSED PORTION.
2. SIDE ROAD WITH A SPEED LIMIT GREATER THAN 40 MPH (60 km/h) AS SHOWN ON THE DRAWING AND AS DIRECTED BY THE ENGINEER:
  - a) ONE "ROAD CONSTRUCTION AHEAD" SIGN 48 x 48 (1.2 m x 1.2 m) WITH A FLASHER MOUNTED ON IT APPROXIMATELY 500' (150 m) IN ADVANCE OF THE MAIN ROUTE.
  - b) THE CLOSED PORTION OF THE MAIN ROUTE SHALL BE PROTECTED BY BLOCKING WITH TYPE III BARRICADES, 1/2 OF THE CROSS SECTION OF THE CLOSED PORTION.
3. CONES MAY BE SUBSTITUTED FOR BARRICADES OR DRUMS AT HALF THE SPACING DURING DAY OPERATIONS. CONES SHALL BE A MINIMUM OF 28 (710) IN HEIGHT.
4. WHEN THE SIDE ROAD LIES BETWEEN THE BEGINNING OF THE MAINLINE SIGNING AND THE WORK ZONE, A SINGLE HEADED ARROW (M6-1) SHALL BE USED IN LIEU OF THE DOUBLE HEADED ARROW (M6-4).
5. WHEN WORK IS BEING PERFORMED ON A SIDE ROAD OR DRIVEWAY, FOLLOW THE APPLICABLE STANDARD(S). THE DIRECTIONAL ARROW (M6-1 OR M6-4) SHALL BE COVERED OR REMOVED WHEN NO LONGER CONSISTENT WITH THE TRAFFIC CONTROL SET-UP.
6. ADVANCE WARNING SIGNS ARE TO BE OMITTED ON DRIVEWAYS UNLESS OTHERWISE SPECIFIED IN THE PLANS OR BY THE ENGINEER.
7. THE TRAFFIC CONTROL AND PROTECTION FOR SIDE ROADS, INTERSECTIONS, AND DRIVEWAYS SHALL BE INCLUDED IN THE COST OF SPECIFIED TRAFFIC CONTROL STANDARDS OR ITEMS.

All dimensions are in inches (millimeters) unless otherwise shown.


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	PLOT DATE = 9/15/2016	DATE - 06-89	REVISED - A. SCHUETZE 09-15-16

**STATE OF ILLINOIS  
DEPARTMENT OF TRANSPORTATION**

**TRAFFIC CONTROL AND PROTECTION FOR  
SIDE ROADS, INTERSECTIONS, AND DRIVEWAYS**


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F.A.U. RTE.	SECTION	COUNTY	TOTAL SHEETS	SHEET NO.
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<b>TC-10</b>			<b>CONTRACT NO. 60W53</b>	
ILLINOIS FED. AID PROJECT				

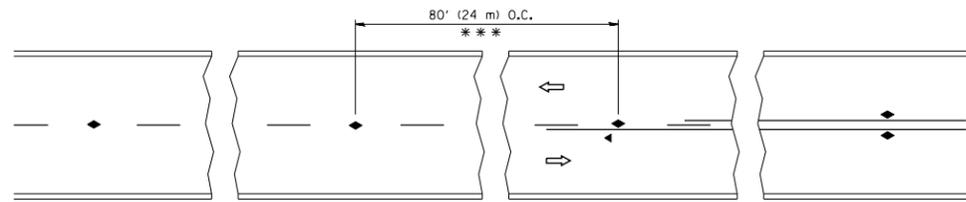


\*\*\* REDUCE TO 40' (12 m) O.C. ON CURVES WITH POSTED OR ADVISORY SPEED 45 M.P.H. (70 km/h) OR LESS.


TWO-LANE/TWO-WAY

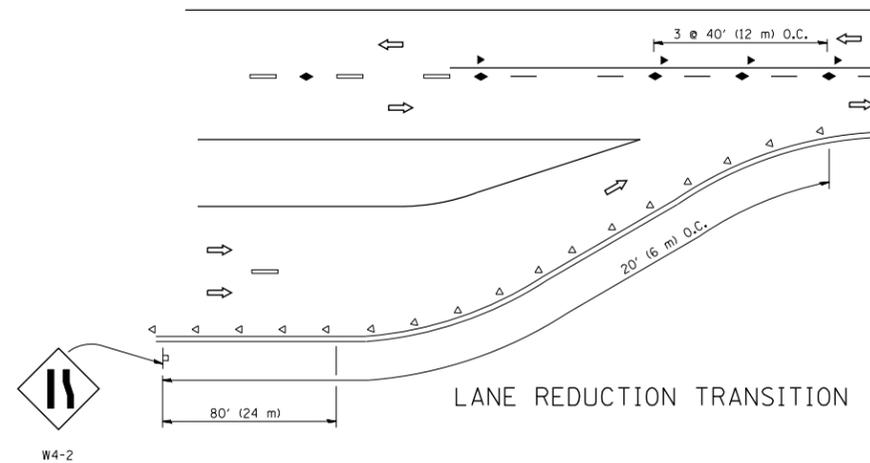


LANE REDUCTION TRANSITION

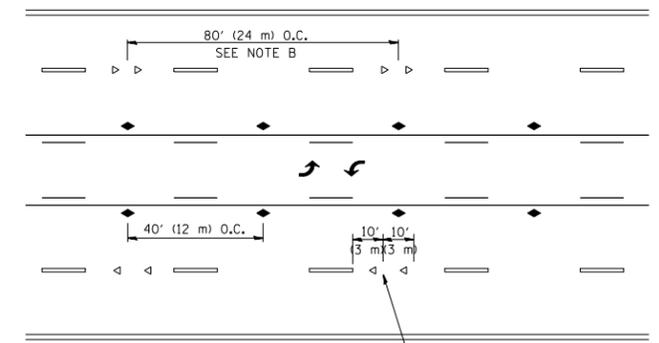

TWO-WAY LEFT TURN

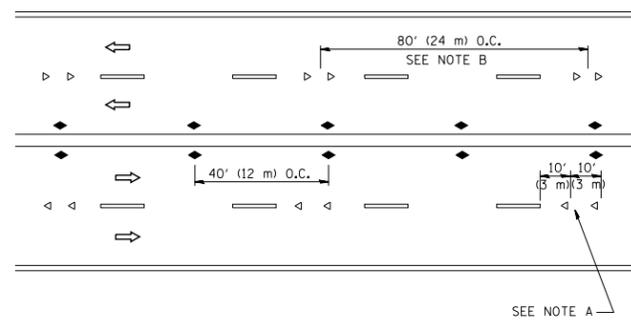

MULTI-LANE/UNDIVIDED

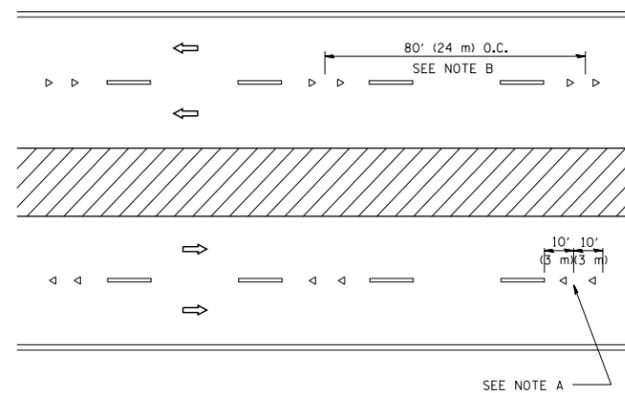

MULTI-LANE/DIVIDED

GENERAL NOTES

1. MARKERS USED WITH DASHED LINES SHALL BE CENTERED IN THE GAP BETWEEN SEGMENTS.
2. MARKERS USED ADJACENT TO SOLID LINES SHALL BE OFFSET 2 TO 3 (50 TO 75) TOWARD TRAFFIC AS SHOWN.
3. MARKERS THROUGH TANGENTS LESS THAN 500' (150 m) IN LENGTH BETWEEN CURVES SHALL BE INSTALLED AT THE LESSER OF THE TWO CURVE SPACINGS.

SYMBOLS


- YELLOW STRIPE
- WHITE STRIPE
- ◀ ONE-WAY AMBER MARKER
- ◁ ONE-WAY CRYSTAL MARKER (W/O)
- ◆ TWO-WAY AMBER MARKER

LANE MARKER NOTES

- A. USE DOUBLE LANE LINE MARKERS SPACED AS SHOWN.
- B. REDUCE TO 40' (12 m) O.C. ON CURVES WHERE ADVISORY SPEEDS ARE 10 M.P.H. (20 km/h) LOWER THAN POSTED SPEEDS.

DESIGN NOTES

1. DOUBLE LANE LINE MARKERS SHALL BE USED UNLESS SPECIFIED OTHERWISE.
2. EXCEPT AS SHOWN ON THE LANE REDUCTION TRANSITION AND FREEWAY EXIT RAMP DETAIL, MARKERS ARE NOT TO BE SPECIFIED ON RIGHT EDGE LINES.
3. THE EXACT MARKER LIMITS, SPACING, AND COLOR SHALL BE INCLUDED IN THE PLANS WHEN STANDARD SPECIFICATIONS ARE NOT BEING USED.
4. MARKERS SHOULD NOT BE USED ALONGSIDE CURBS EXCEPT FOR EXTREMELY SHORT SECTIONS OF CURBS WHERE NOT MORE THAN TWO MARKERS WOULD BE INVOLVED.

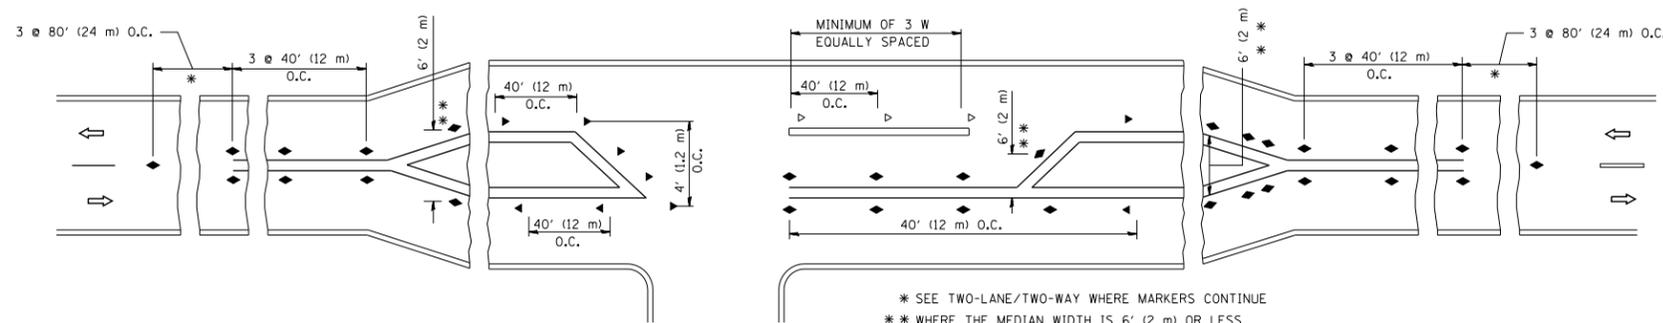

LEFT TURN

\* SEE TWO-LANE/TWO-WAY WHERE MARKERS CONTINUE  
 \*\* WHERE THE MEDIAN WIDTH IS 6' (2 m) OR LESS USE TWO-WAY MARKERS.

All dimensions are in inches (millimeters) unless otherwise shown.

FILE NAME =	USER NAME = lryso	DESIGNED -	REVISED - T. RAMMACHER 09-19-94
cr:\pw\work\p\dot\lryso\d0108315\l1.dgn		DRAWN -	REVISED - T. RAMMACHER 03-12-99
	PLOT SCALE = 50.000' / IN.	CHECKED -	REVISED - T. RAMMACHER 01-06-00
	PLOT DATE = 3/2/2011	DATE -	REVISED - C. JUCIUS 09-09-09


STATE OF ILLINOIS  
 DEPARTMENT OF TRANSPORTATION

TYPICAL APPLICATIONS  
 RAISED REFLECTIVE PAVEMENT MARKERS (SNOW-PLOW RESISTANT)

SCALE: NONE SHEET NO. 1 OF 1 SHEETS STA. TO STA.

F.A.U. RTE.	SECTION	COUNTY	TOTAL SHEETS	SHEET NO.
2691	3434.1-BR(13)	COOK	58	44
TC-11		CONTRACT NO. 60W53		
FED. ROAD DIST. NO. 1 ILLINOIS FED. AID PROJECT				



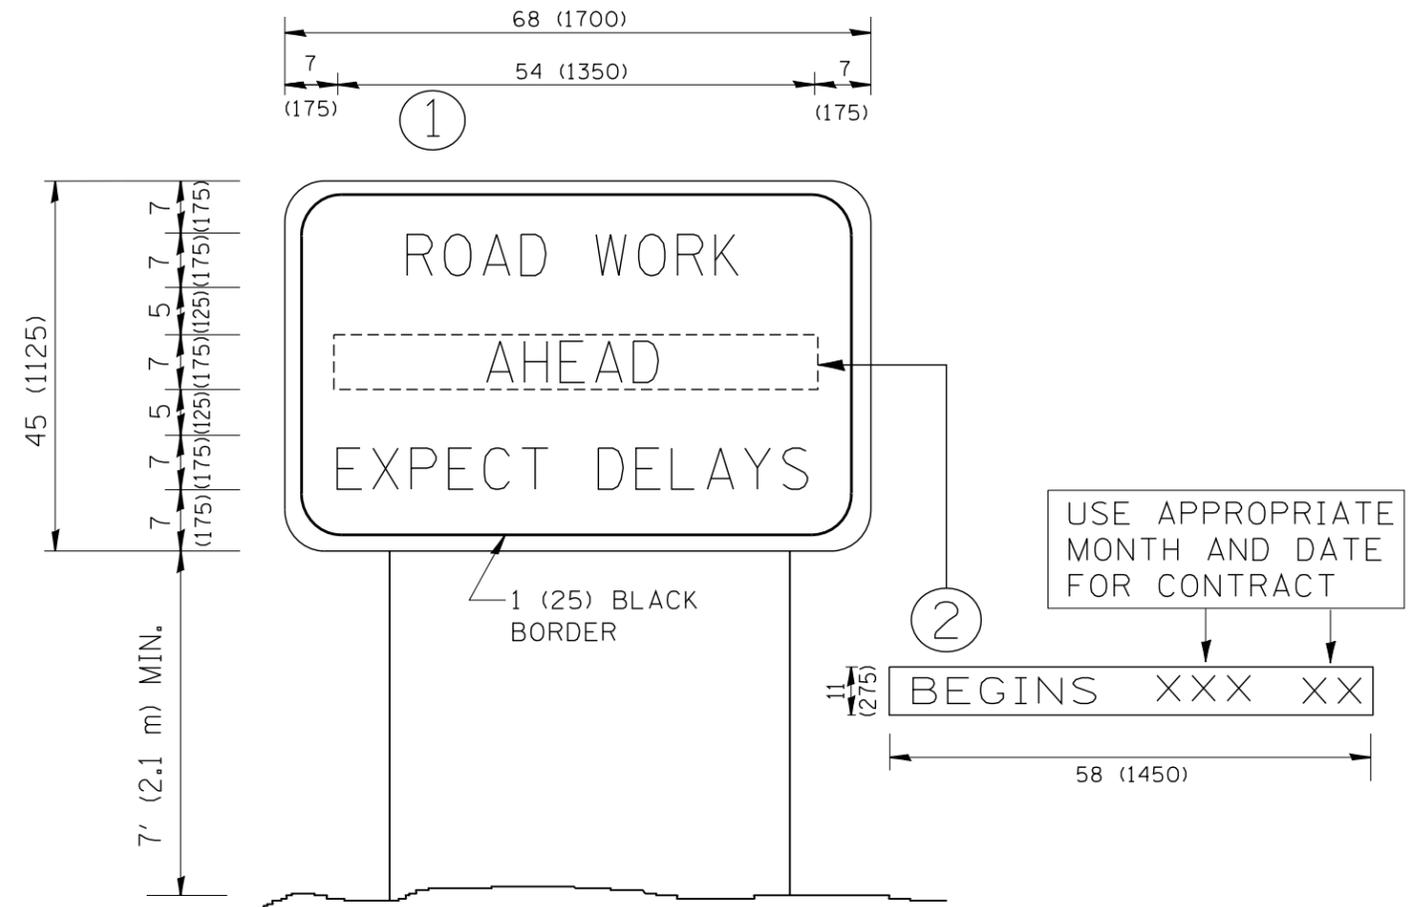


**NOTES:**

1. USE BLACK LETTERING ON ORANGE BACKGROUND.
2. ERECT SIGNS IN ADVANCE OF THE LOCATION FOR THE "ROAD CONSTRUCTION AHEAD" SIGN AT LOCATIONS AS DIRECTED BY THE ENGINEER.
3. ERECT SIGN ① WITH INSTALLED PANEL ② ONE WEEK PRIOR TO THE START OF CONSTRUCTION.
4. REMOVE PANEL ② SOON AFTER THE START OF CONSTRUCTION.
5. SEE SPECIAL PROVISION FOR "TEMPORARY INFORMATION SIGNING" FOR ADDITIONAL INFORMATION.
6. ONE SIGN ASSEMBLY EQUALS 25.70 SQ. FT. (2.3 SQ. M.)
7. SHALL BE PAID FOR AS TEMPORARY INFORMATION SIGNING.

ALL DIMENSIONS ARE IN INCHES (MILLIMETERS) UNLESS OTHERWISE SHOWN.

FILE NAME = W:\diststd\22x34\tc22.dgn	USER NAME = gaglianobt	DESIGNED - DRAWN -	REVISED - R. MIRS 09-15-97 REVISED - R. MIRS 12-11-97	<b>STATE OF ILLINOIS DEPARTMENT OF TRANSPORTATION</b>	<b>ARTERIAL ROAD INFORMATION SIGN</b>			F.A.U. RTE. 2691	SECTION 3434.1-BR (13)	COUNTY COOK	TOTAL SHEETS 58	SHEET NO. 46
	PLOT SCALE = 50.000' / IN.	CHECKED -	REVISED - T. RAMMACHER 02-02-99		SCALE: NONE	SHEET NO. 1	OF 1	SHEETS	STA.	TO STA.	<b>TC-22</b> CONTRACT NO. 60W53	
	PLOT DATE = 1/4/2008	DATE -	REVISED - C. JUCIUS 01-31-07		FED. ROAD DIST. NO. 1   ILLINOIS   FED. AID PROJECT							

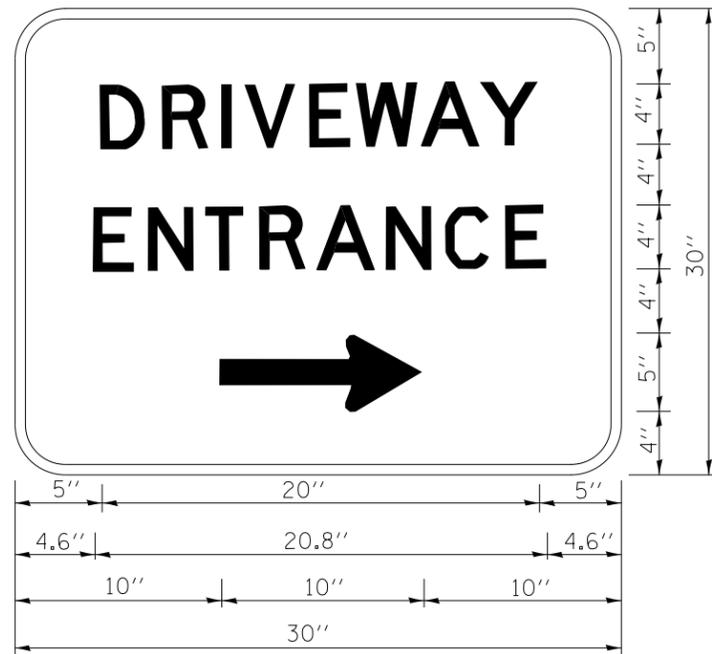

3.0" RADIUS, 0.5" BORDER, WHITE ON GREEN; REFLECTORIZED  
 "DRIVEWAY" D; "ENTRANCE" D; STANDARD ARROW CUSTOM 12.0" x 5.0"

**NOTES:**

1. HALF OF THE SIGNS WILL REQUIRE A LEFT HAND FACING ARROW.
2. TWO SIGNS SHALL BE USED AT EACH COMMERCIAL ENTRANCE  
 PLACED BACK-TO-BACK; ONE WITH A RIGHT HAND ARROW (SHOWN)  
 SHALL BE PLACED ON THE NEAR RIGHT SIDE THE DRIVEWAY  
 AND ONE WITH A LEFT HAND ARROW SHALL BE PLACED ON THE  
 FAR LEFT SIDE OF THE DRIVEWAY.
3. SIGNS TO BE PAID FOR AS ITEM "TEMPORARY INFORMATION SIGNING".

FILE NAME =	USER NAME = gegl1enobt	DESIGNED -	REVISED - C. JUCIUS 02-15-07
ct:\pwork\pwork\gagl1enobt\d0108315\to26.dgn		DRAWN -	REVISED -
	PLOT SCALE = 50.000' / in.	CHECKED -	REVISED -
	PLOT DATE = 12/13/2012	DATE -	REVISED -

**STATE OF ILLINOIS  
 DEPARTMENT OF TRANSPORTATION**

**DRIVEWAY ENTRANCE SIGNING**


SCALE: NONE SHEET NO. 1 OF 1 SHEETS STA. TO STA.

F.A.U. RTE.	SECTION	COUNTY	TOTAL SHEETS	SHEET NO.
2691	3434.1-BR(13)	COOK	58	47
<b>TC-26</b>			CONTRACT NO. 60W53	
FED. ROAD DIST. NO. 1 ILLINOIS FED. AID PROJECT				

FINAL SURVEY	SURVEYED	BY	DATE
NOTE BOOK	PLOTTED		
AREAS CHECKED	TEMPLATE		
NO.	AREAS CHECKED		

ORIGINAL SURVEY	SURVEYED	BY	DATE
NOTE BOOK	PLOTTED		
AREAS CHECKED	TEMPLATE		
NO.	AREAS CHECKED		

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USER NAME = jent	DESIGNED - TGM	REVISED -
PLOT SCALE = 20.000' / in.	DRAWN - CC	REVISED -
PLOT DATE = 3/12/2018	CHECKED - JMT	REVISED -
	DATE - 3/12/2018	REVISED -

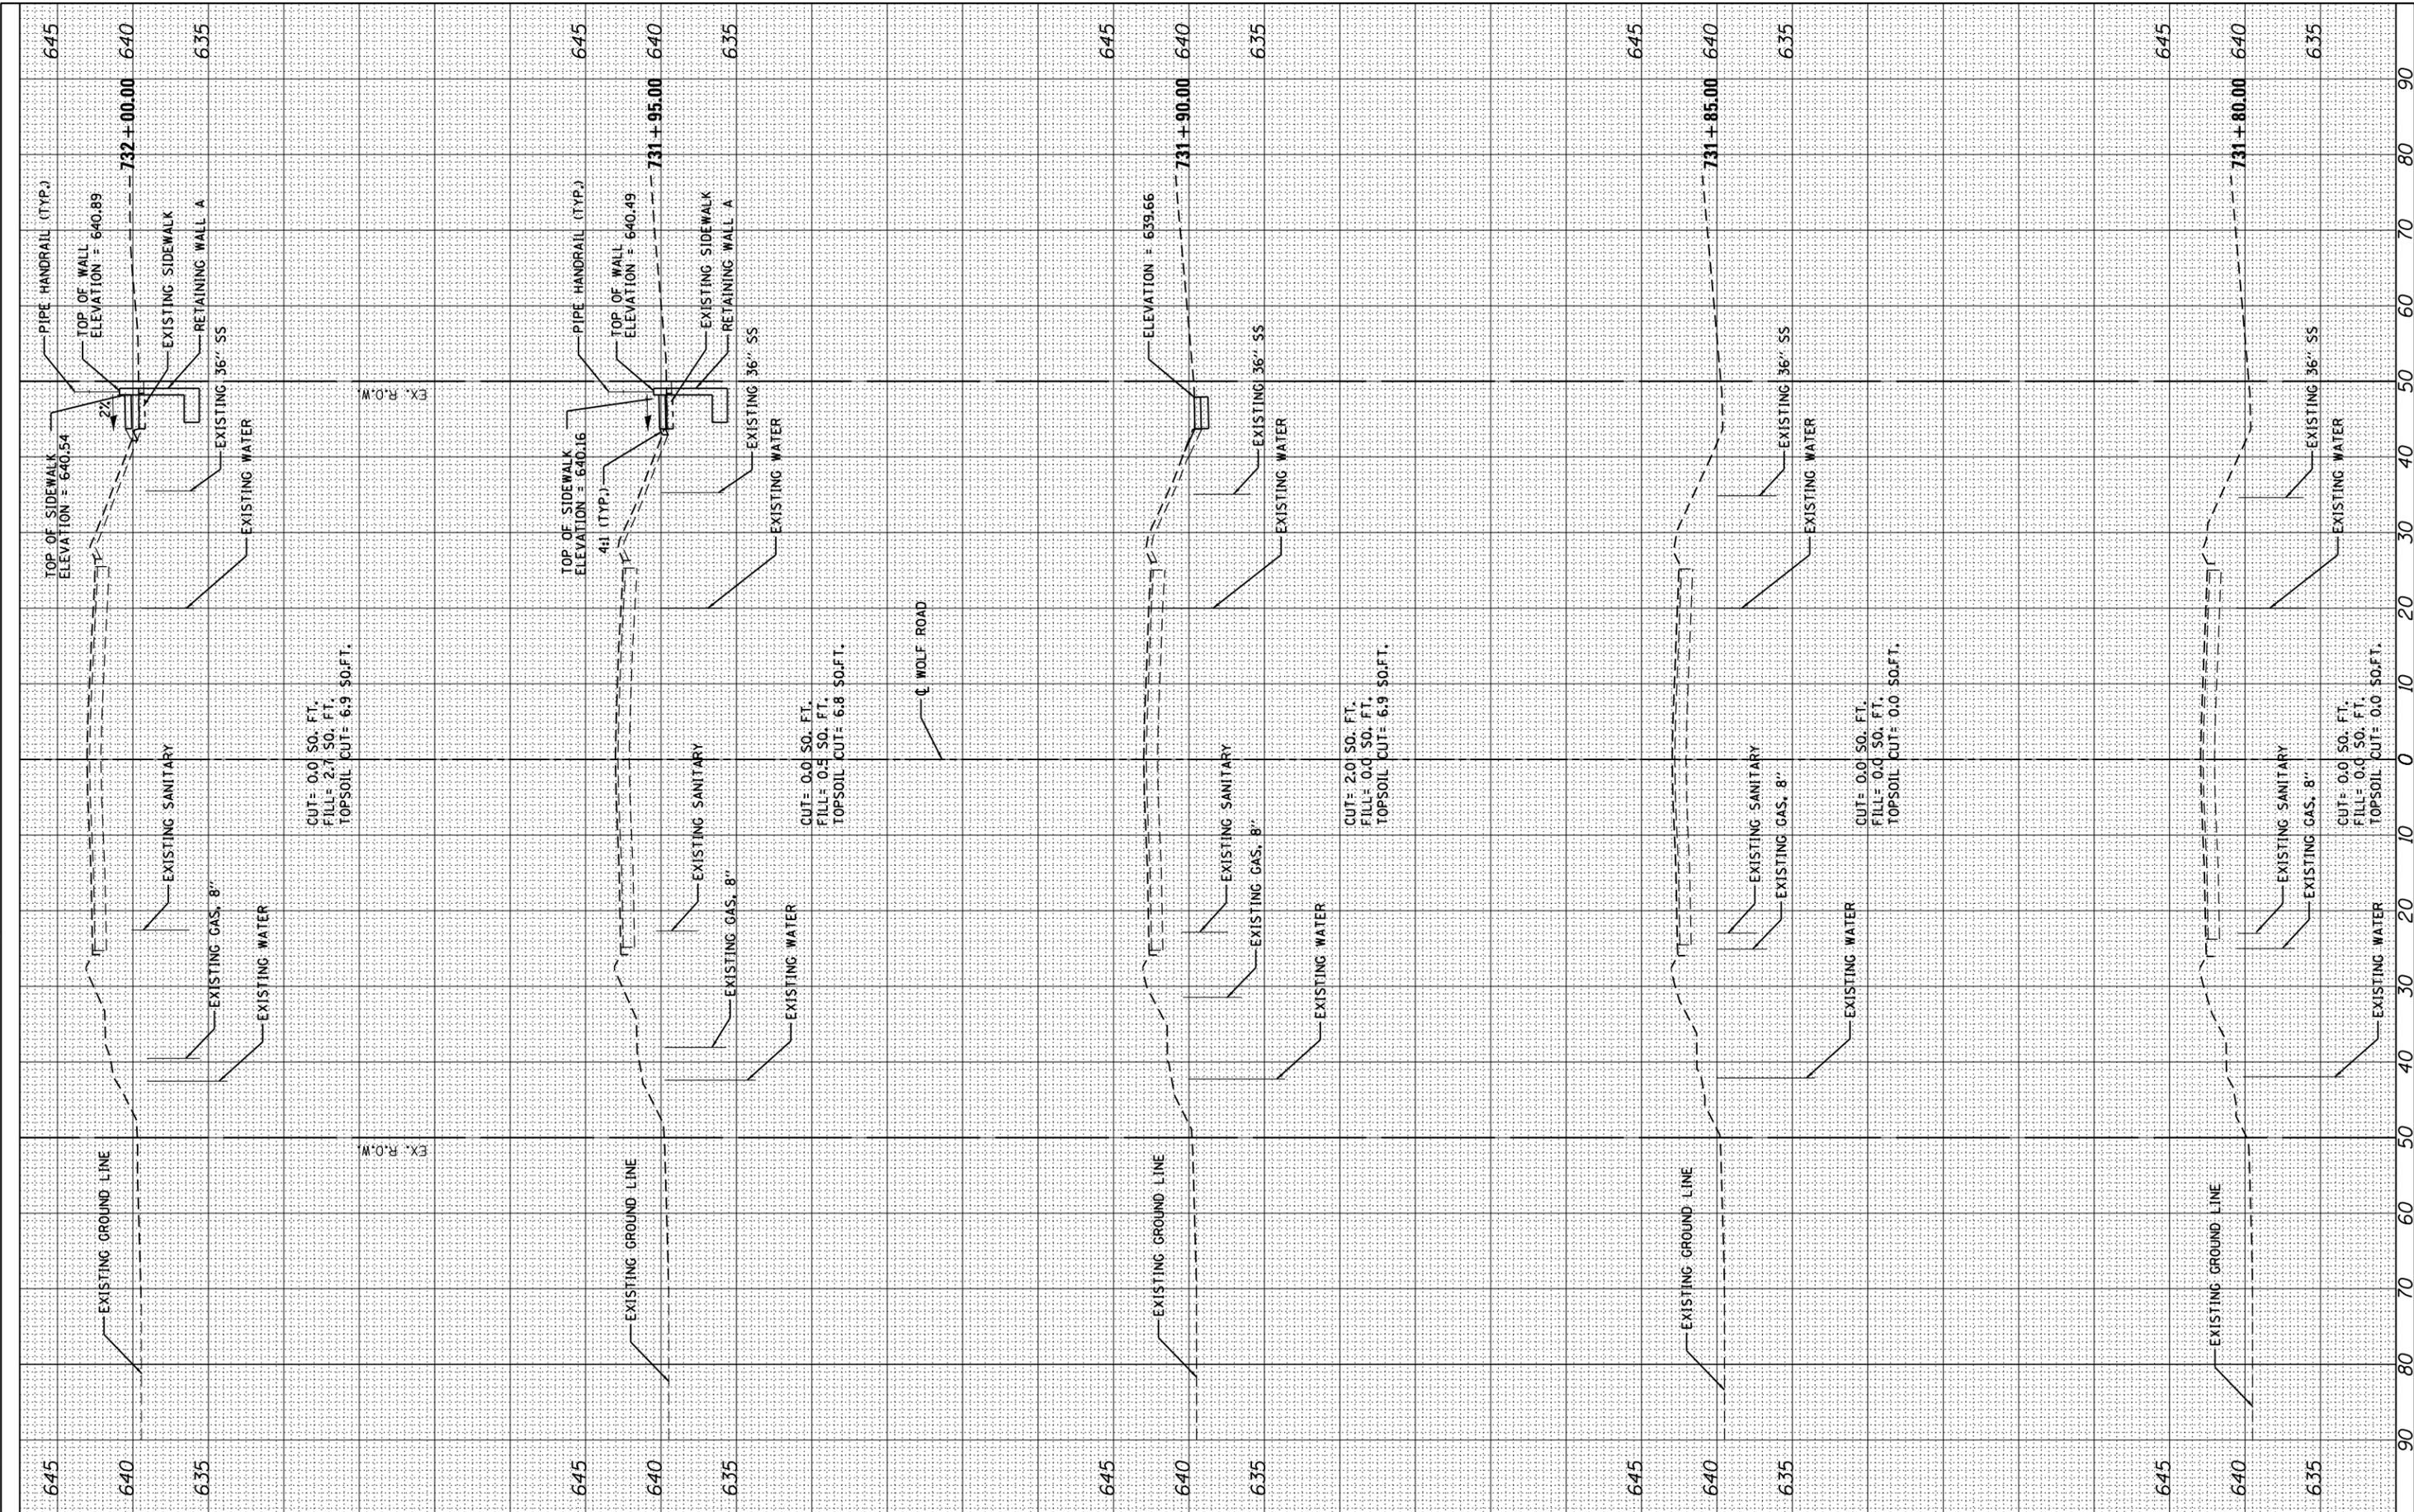DESIGNED - TGM	REVISED -
DRAWN - CC	REVISED -
CHECKED - JMT	REVISED -
DATE - 3/12/2018	REVISED -

**STATE OF ILLINOIS  
DEPARTMENT OF TRANSPORTATION**

SCALE:		SHEET OF SHEETS		STA. 731+80.00 TO STA. 732+00.00	
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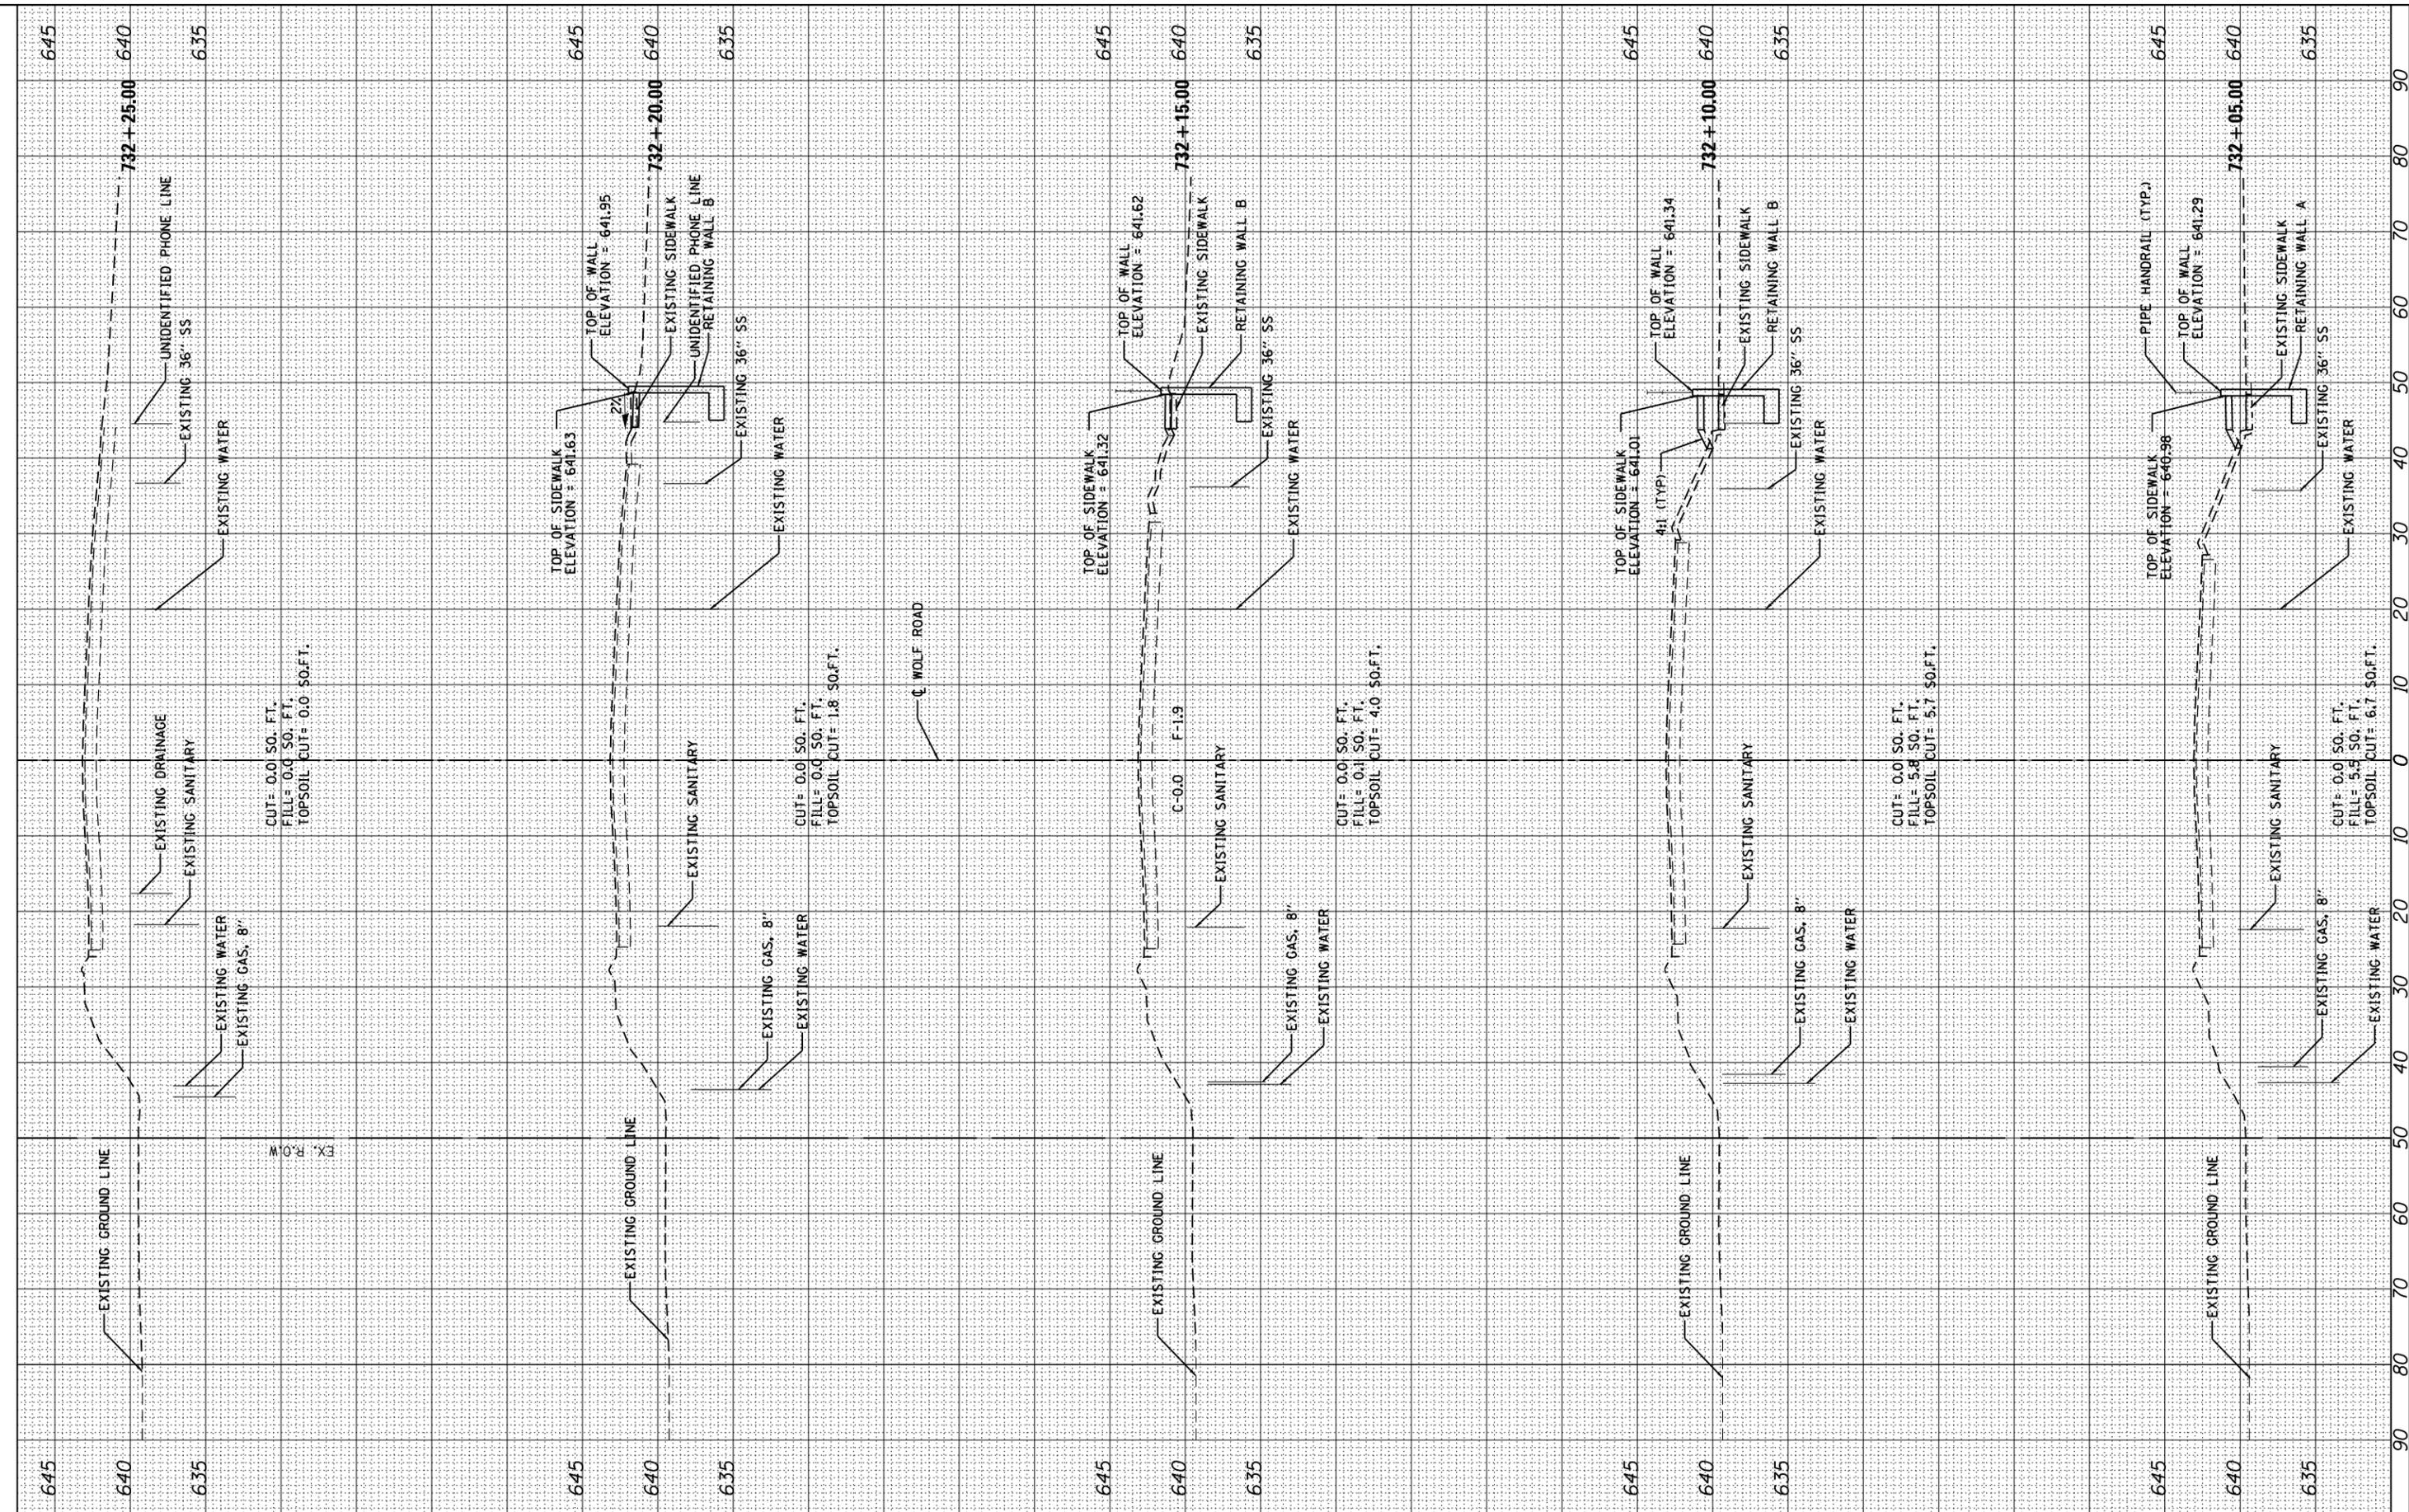
**WOLF ROAD - CROSS SECTION  
WOLF ROAD AT WELLER'S DITCH**

F.A.U. RTE.	SECTION	COUNTY	TOTAL SHEETS	SHEET NO.
2691	3434.1-BR(13)	COOK	58	48
CONTRACT NO. 60W53				
ILLINOIS FED. AID PROJECT				

FINAL SURVEY	SURVEYED	BY	DATE
NOTE BOOK	PLOTTED		
AREAS CHECKED	TEMPLATE		
	AREAS CHECKED		

ORIGINAL SURVEY	SURVEYED	BY	DATE
NOTE BOOK	PLOTTED		
AREAS CHECKED	TEMPLATE		
	AREAS CHECKED		

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USER NAME = jent
DESIGNED - TGM
DRAWN - CC
CHECKED - JMT
DATE - 3/12/2018

REVISED -
REVISED -
REVISED -
REVISED -

**STATE OF ILLINOIS  
DEPARTMENT OF TRANSPORTATION**

SCALE:	SHEET	OF	SHEETS	STA. 732+05.00	TO	STA. 732+25.00
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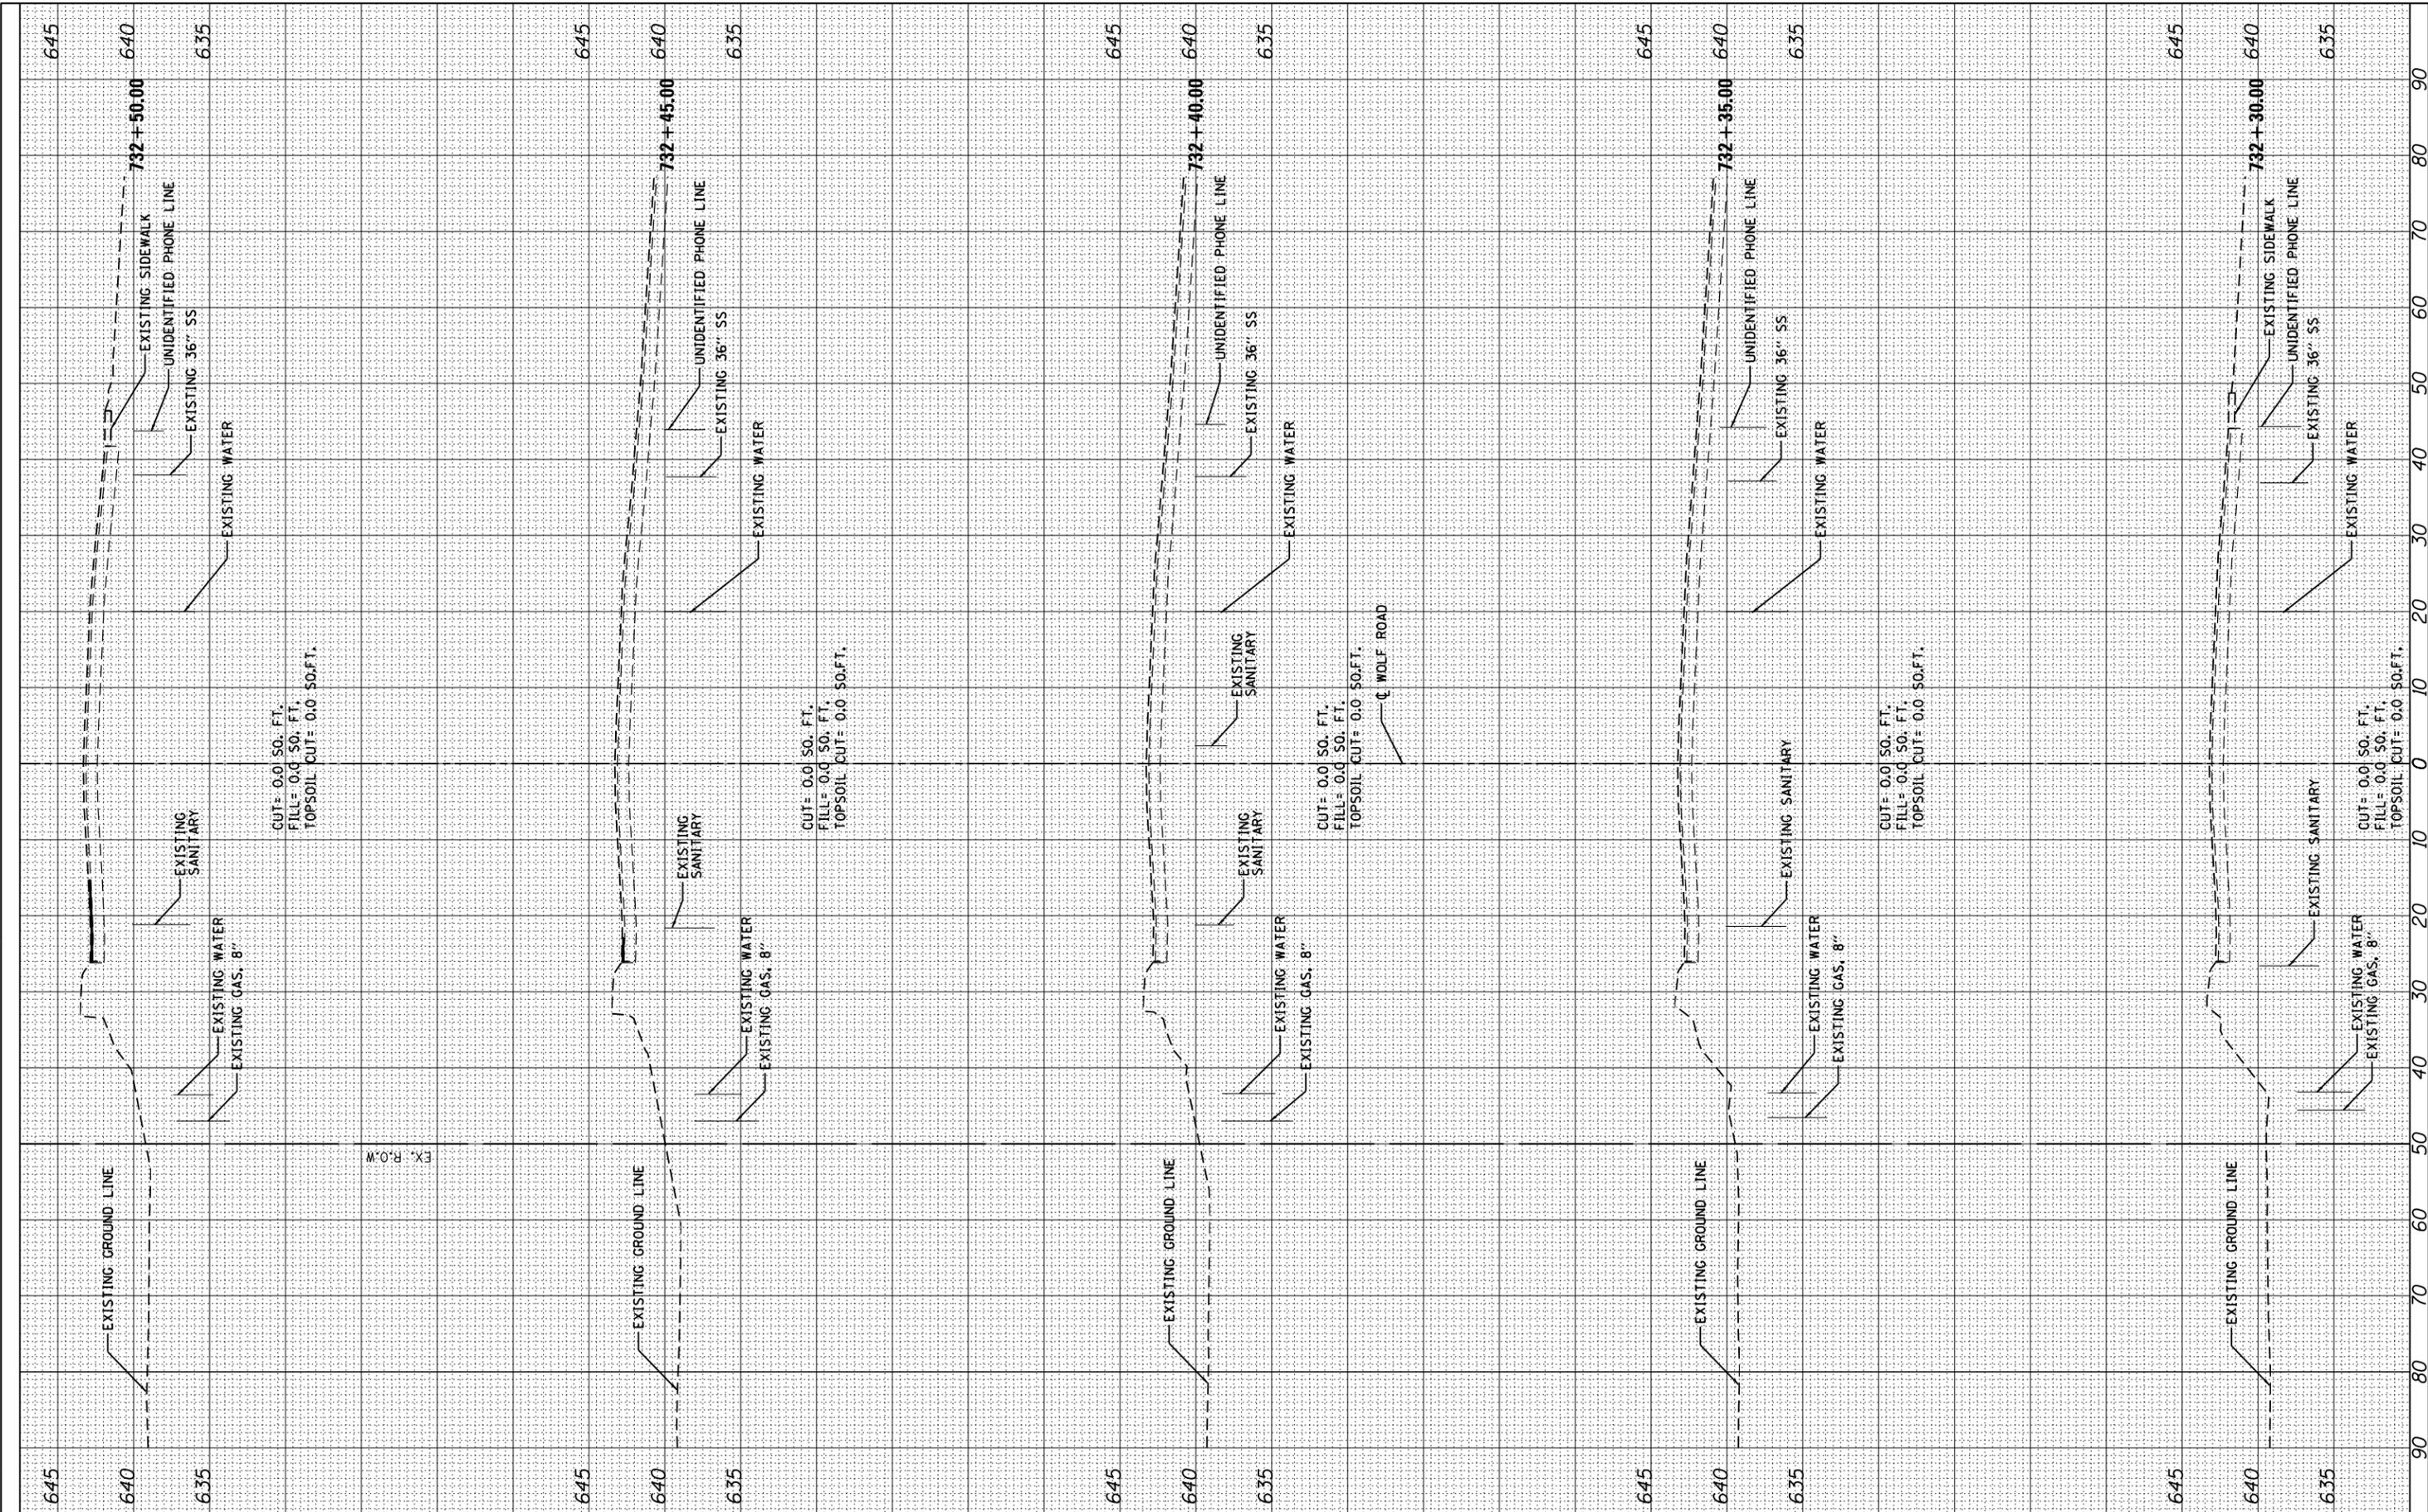
**WOLF ROAD - CROSS SECTION  
WOLF ROAD AT WELLER'S DITCH**

F.A.U. RTE.	SECTION	COUNTY	TOTAL SHEETS	SHEET NO.
2691	3434.1-BR(13)	COOK	58	49
CONTRACT NO. 60W53				
ILLINOIS FED. AID PROJECT				

FINAL SURVEY	SURVEYED	BY	DATE
NOTE BOOK	PLOTTED		
AREAS CHECKED	TEMPLATE		
NO.	AREAS CHECKED		

ORIGINAL SURVEY	SURVEYED	BY	DATE
NOTE BOOK	PLOTTED		
AREAS CHECKED	TEMPLATE		
NO.	AREAS CHECKED		

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USER NAME = jent  
 PLOT SCALE = 20.000' / in.  
 PLOT DATE = 3/12/2018

DESIGNED - TGM  
 DRAWN - CC  
 CHECKED - JMT  
 DATE - 3/12/2018

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 REVISED -

**STATE OF ILLINOIS  
 DEPARTMENT OF TRANSPORTATION**

**WOLF ROAD - CROSS SECTION  
 WOLF ROAD AT WELLER'S DITCH**

SCALE: SHEET OF SHEETS STA. 732+30.00 TO STA. 732+50.00

F.A.U. RTE.	SECTION	COUNTY	TOTAL SHEETS	SHEET NO.
2691	3434.1-BR(13)	COOK	58	50
CONTRACT NO. 60W53				
ILLINOIS FED. AID PROJECT				






FINAL SURVEY	SURVEYED	BY	DATE
NOTE BOOK	PLOTTED		
NO.	TEMPLATE		
	AREAS CHECKED		
	AREAS CHECKED		

ORIGINAL SURVEY	SURVEYED	BY	DATE
NOTE BOOK	PLOTTED		
NO.	TEMPLATE		
	AREAS CHECKED		
	AREAS CHECKED		

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USER NAME = jent	DESIGNED - TGM	REVISED -
	DRAWN - CC	REVISED -
PLOT SCALE = 20.000' / in.	CHECKED - JMT	REVISED -
PLOT DATE = 3/12/2018	DATE - 3/12/2018	REVISED -

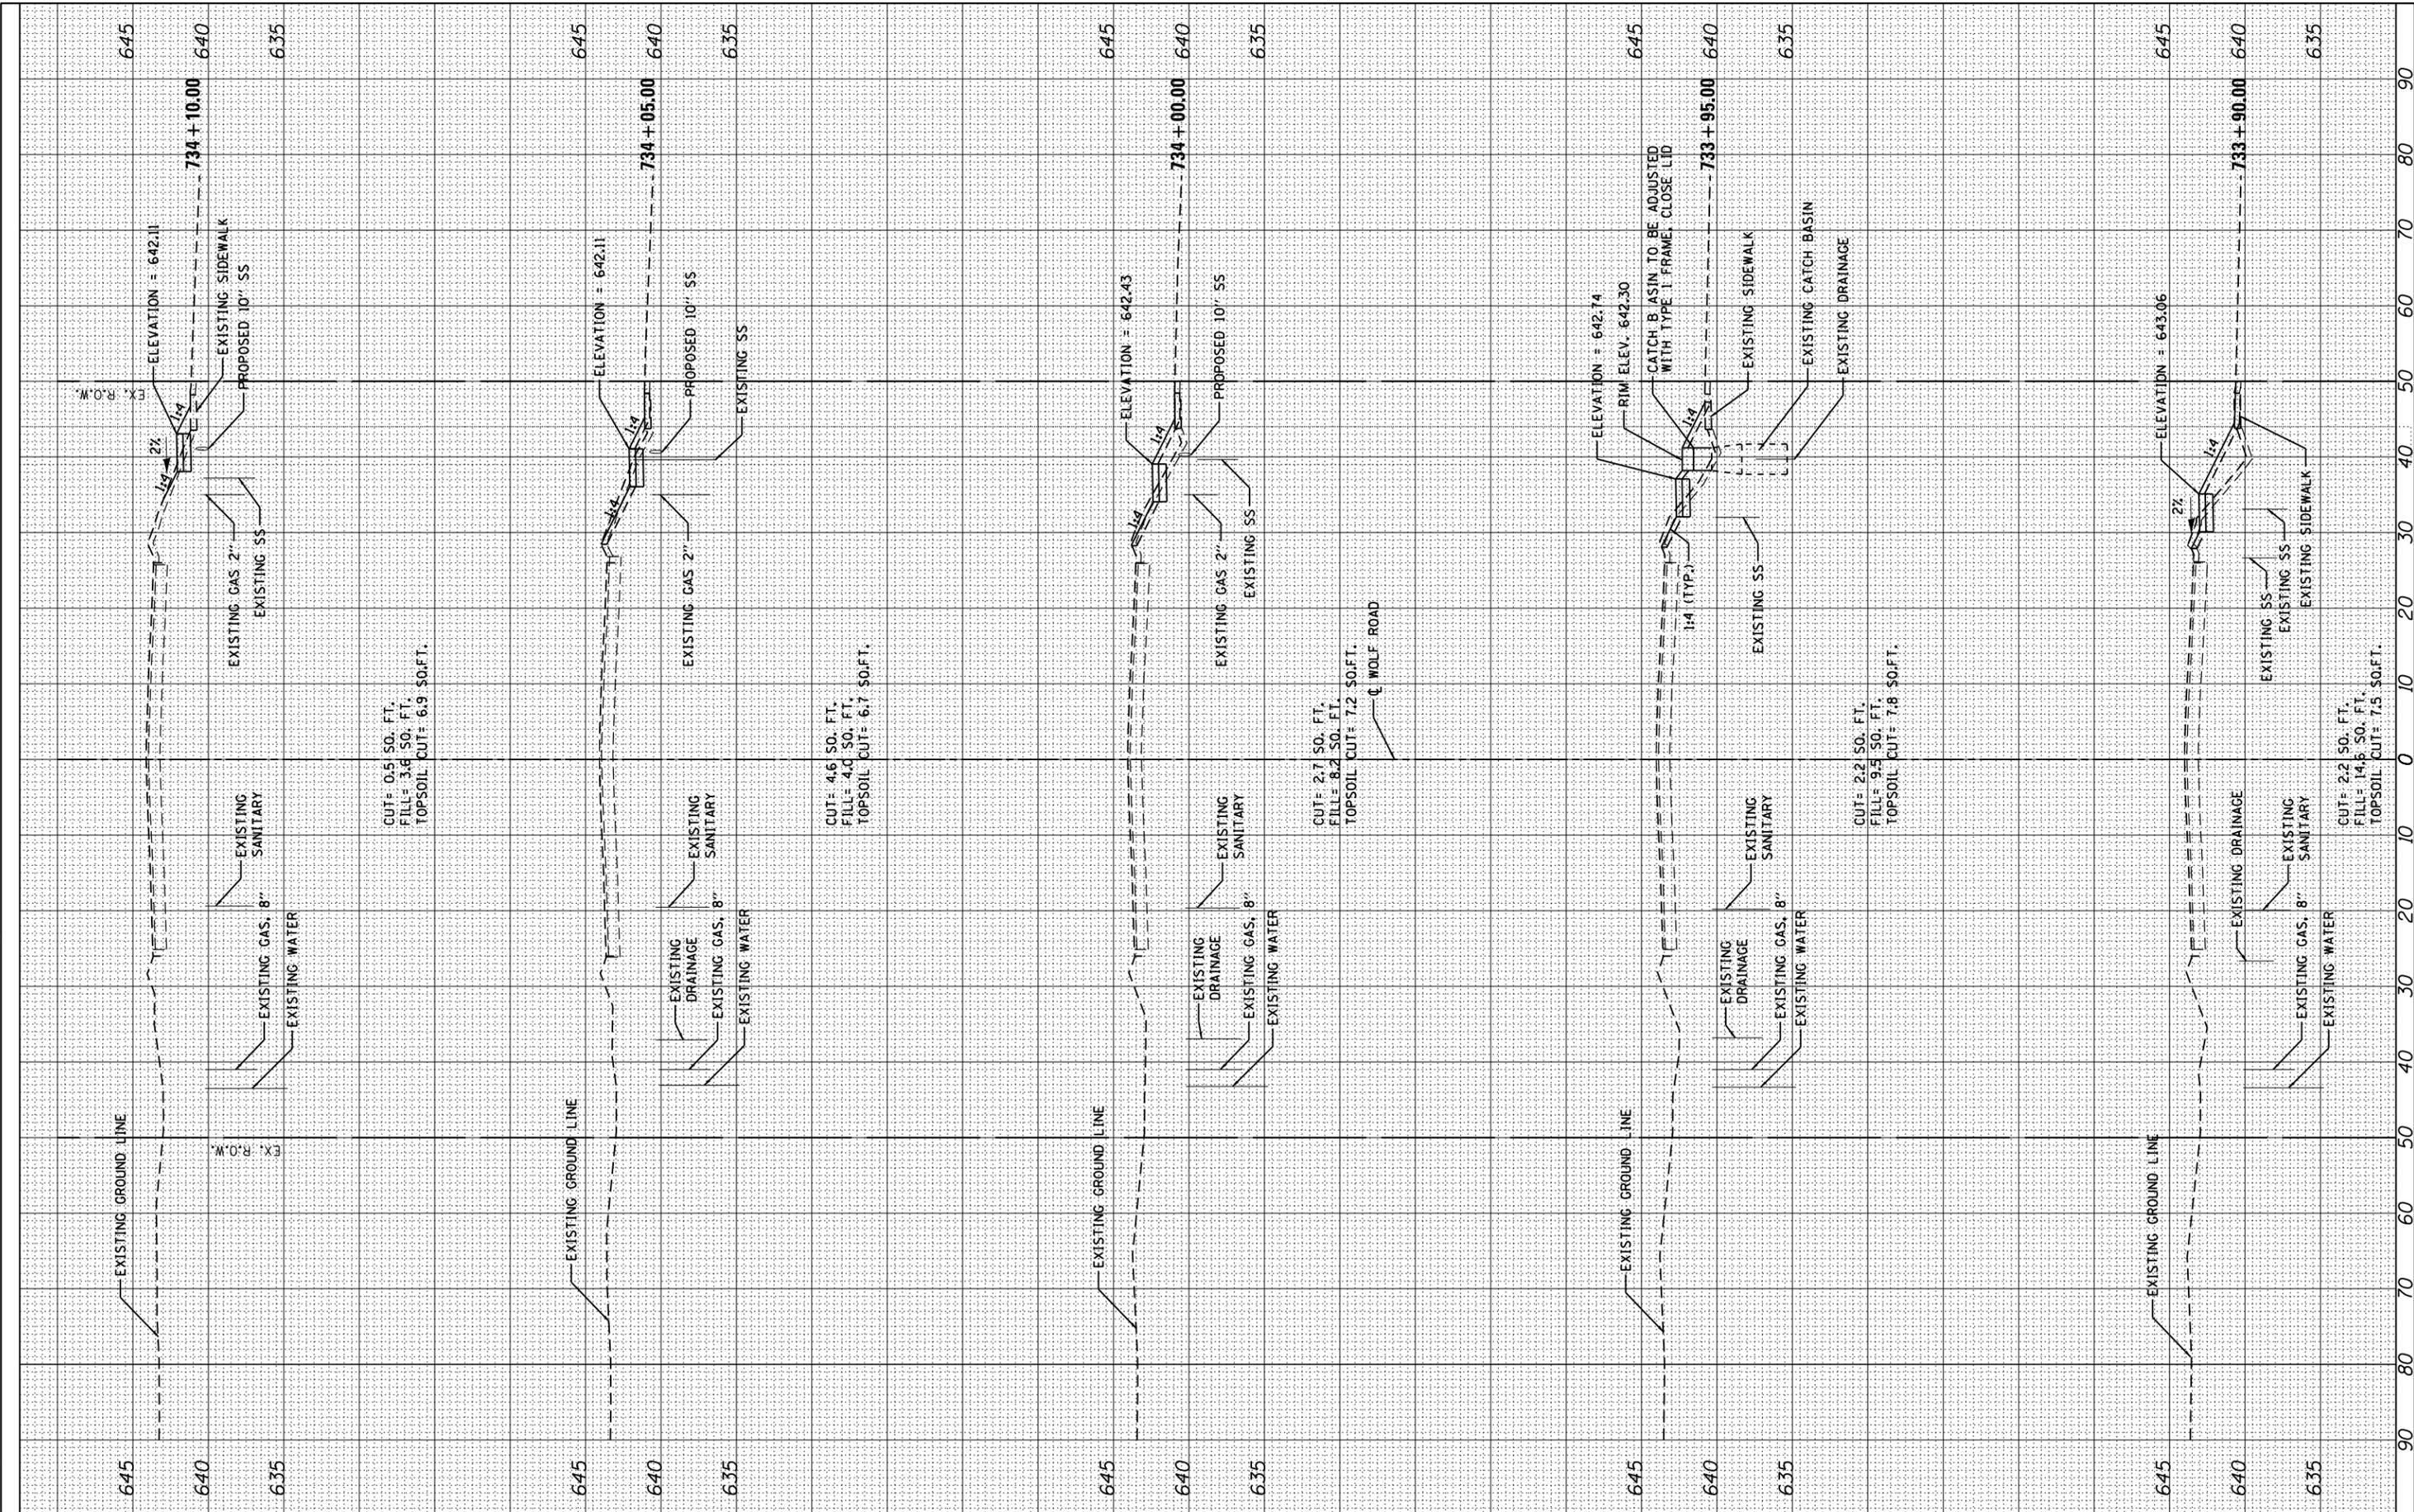STATE OF ILLINOIS  
DEPARTMENT OF TRANSPORTATION

WOLF ROAD - CROSS SECTION  
WOLF ROAD AT WELLER'S DITCH


SCALE: SHEET OF SHEETS STA. 733+90.00 TO STA. 734+10.00

F.A.U. RTE.	SECTION	COUNTY	TOTAL SHEETS	SHEET NO.
2691	3434.1-BR(13)	COOK	58	53
CONTRACT NO. 60W53				
ILLINOIS FED. AID PROJECT				

FINAL SURVEY	SURVEYED	BY	DATE
NOTE BOOK	PLOTTED		
NO.	TEMPLATE		
	AREAS CHECKED		

ORIGINAL SURVEY	SURVEYED	BY	DATE
NOTE BOOK	PLOTTED		
NO.	TEMPLATE		
	AREAS CHECKED		

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USER NAME	= jent
DESIGNED	- TGM
DRAWN	- CC
CHECKED	- JMT
DATE	- 3/12/2018

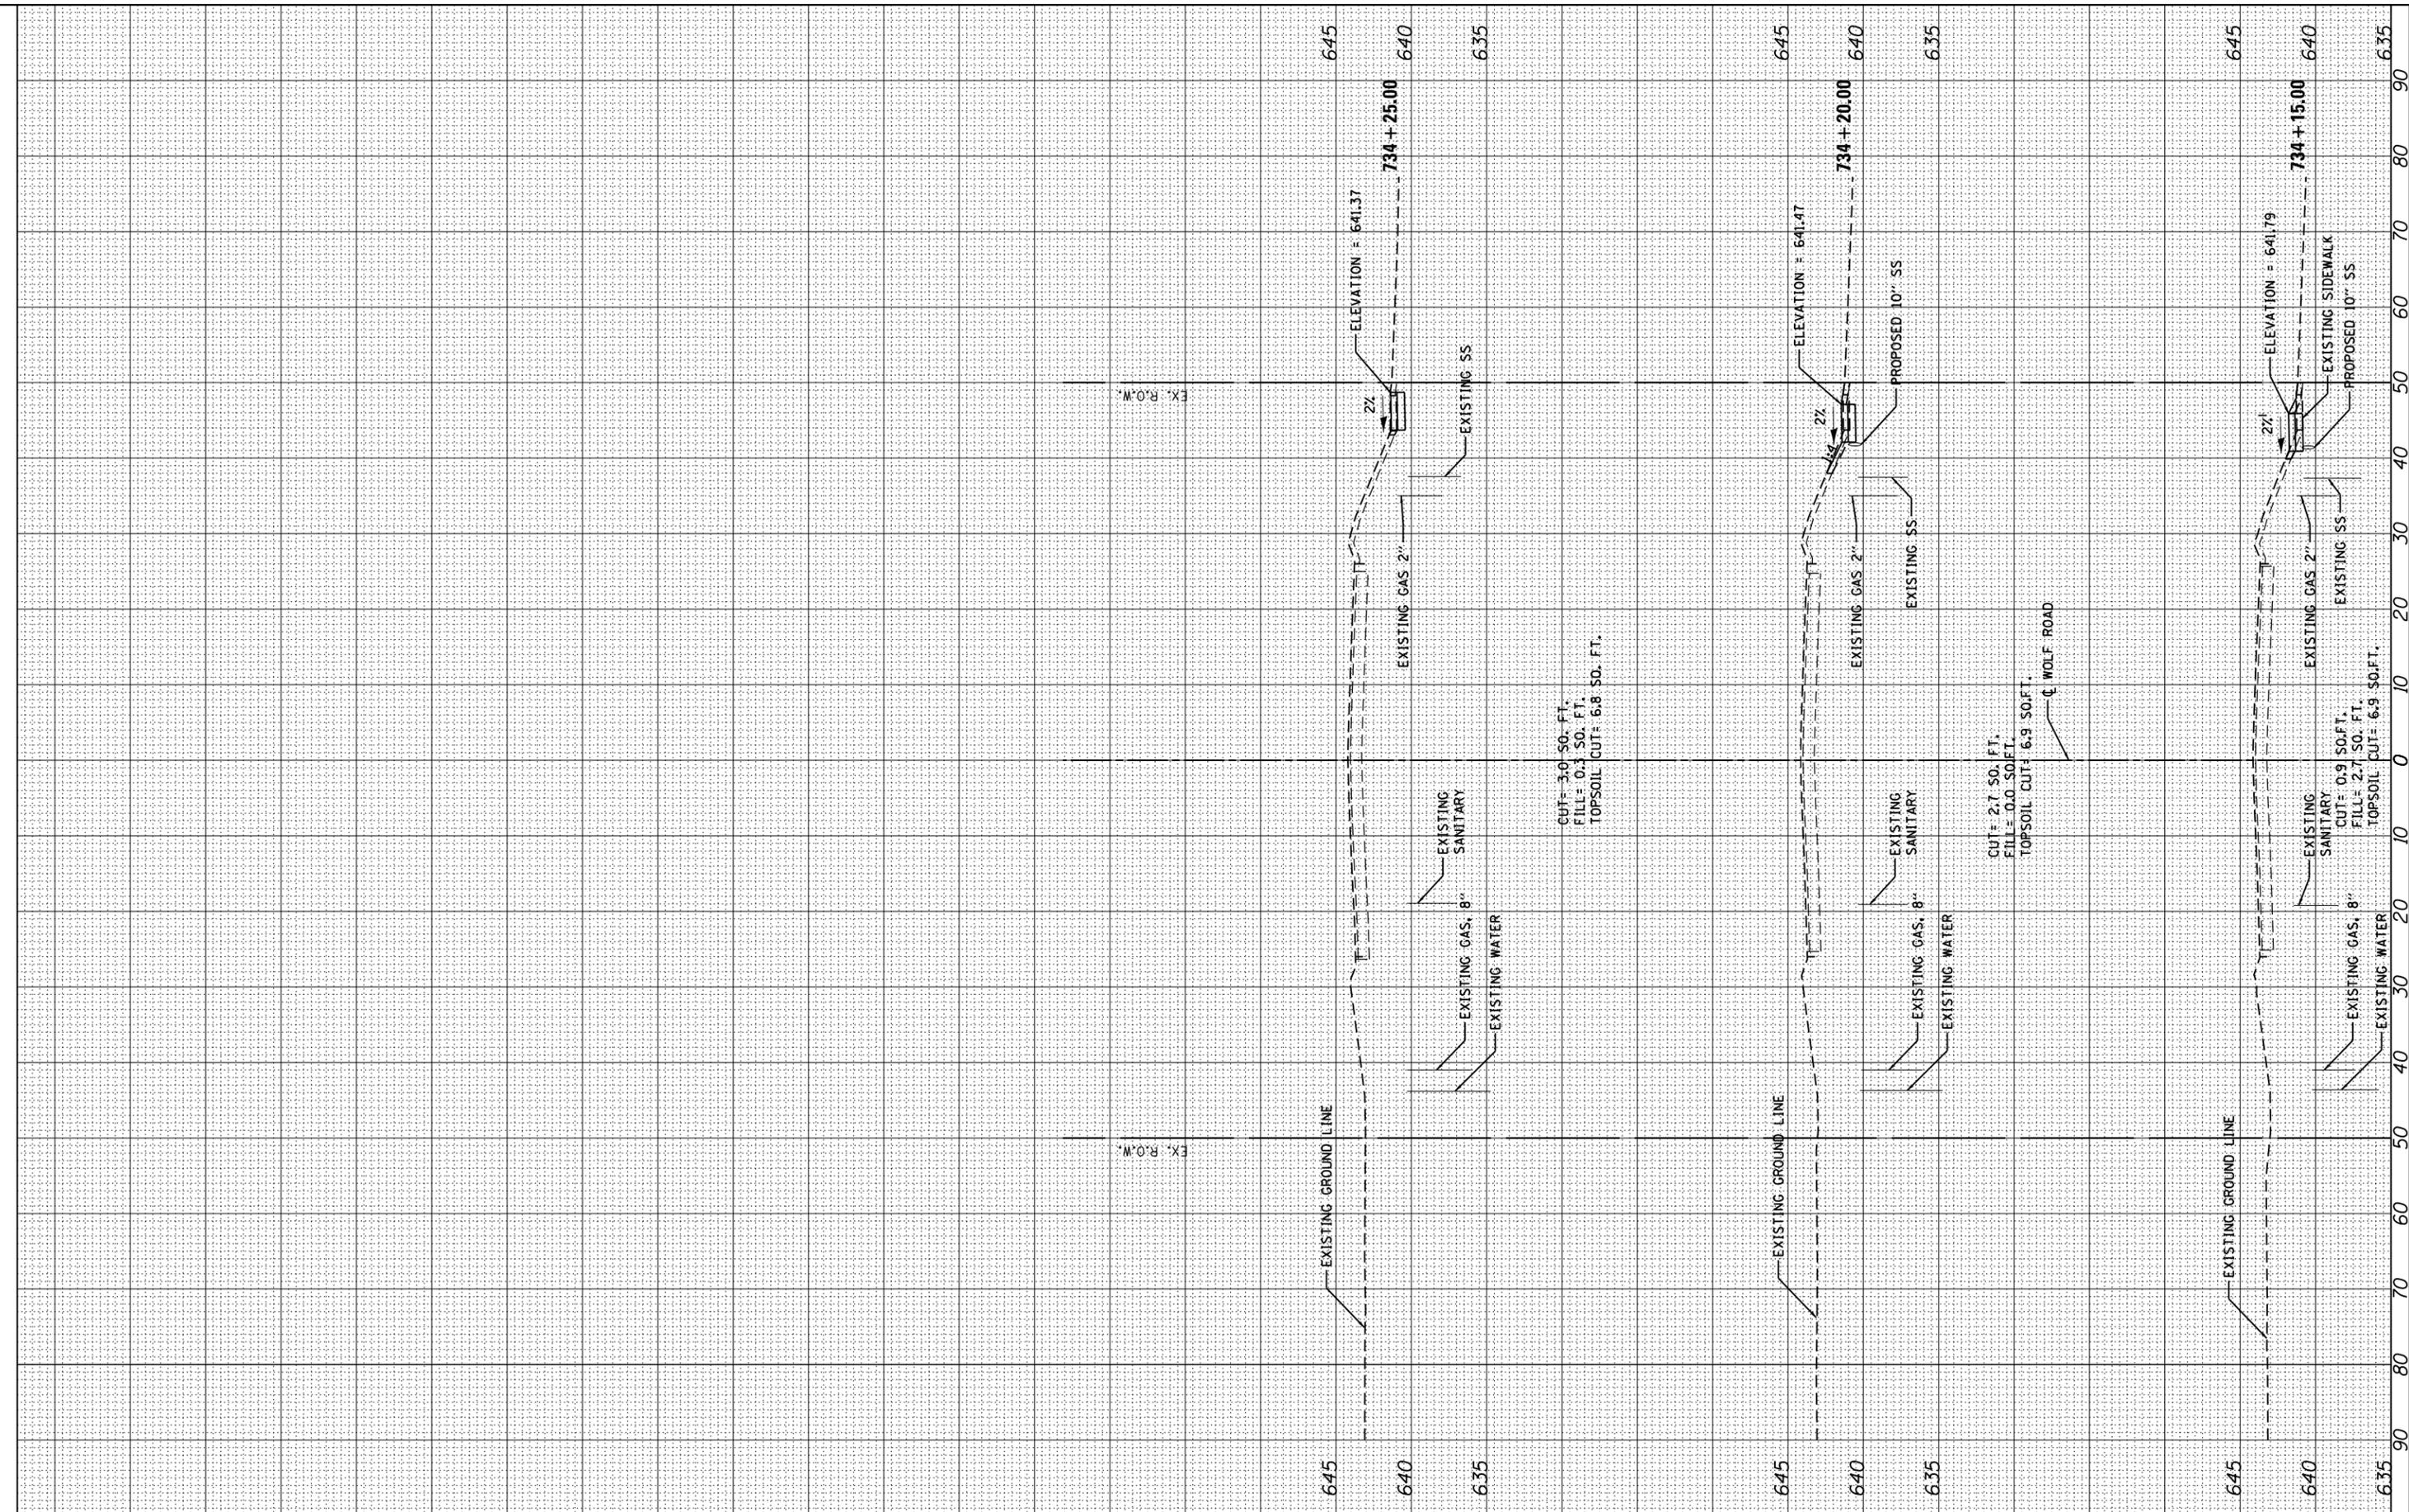REVISIONS	
REVISED	-

**STATE OF ILLINOIS  
DEPARTMENT OF TRANSPORTATION**

SCALE:		SHEET	OF	SHEETS	STA. 734+15.00	TO	STA. 734+25.00
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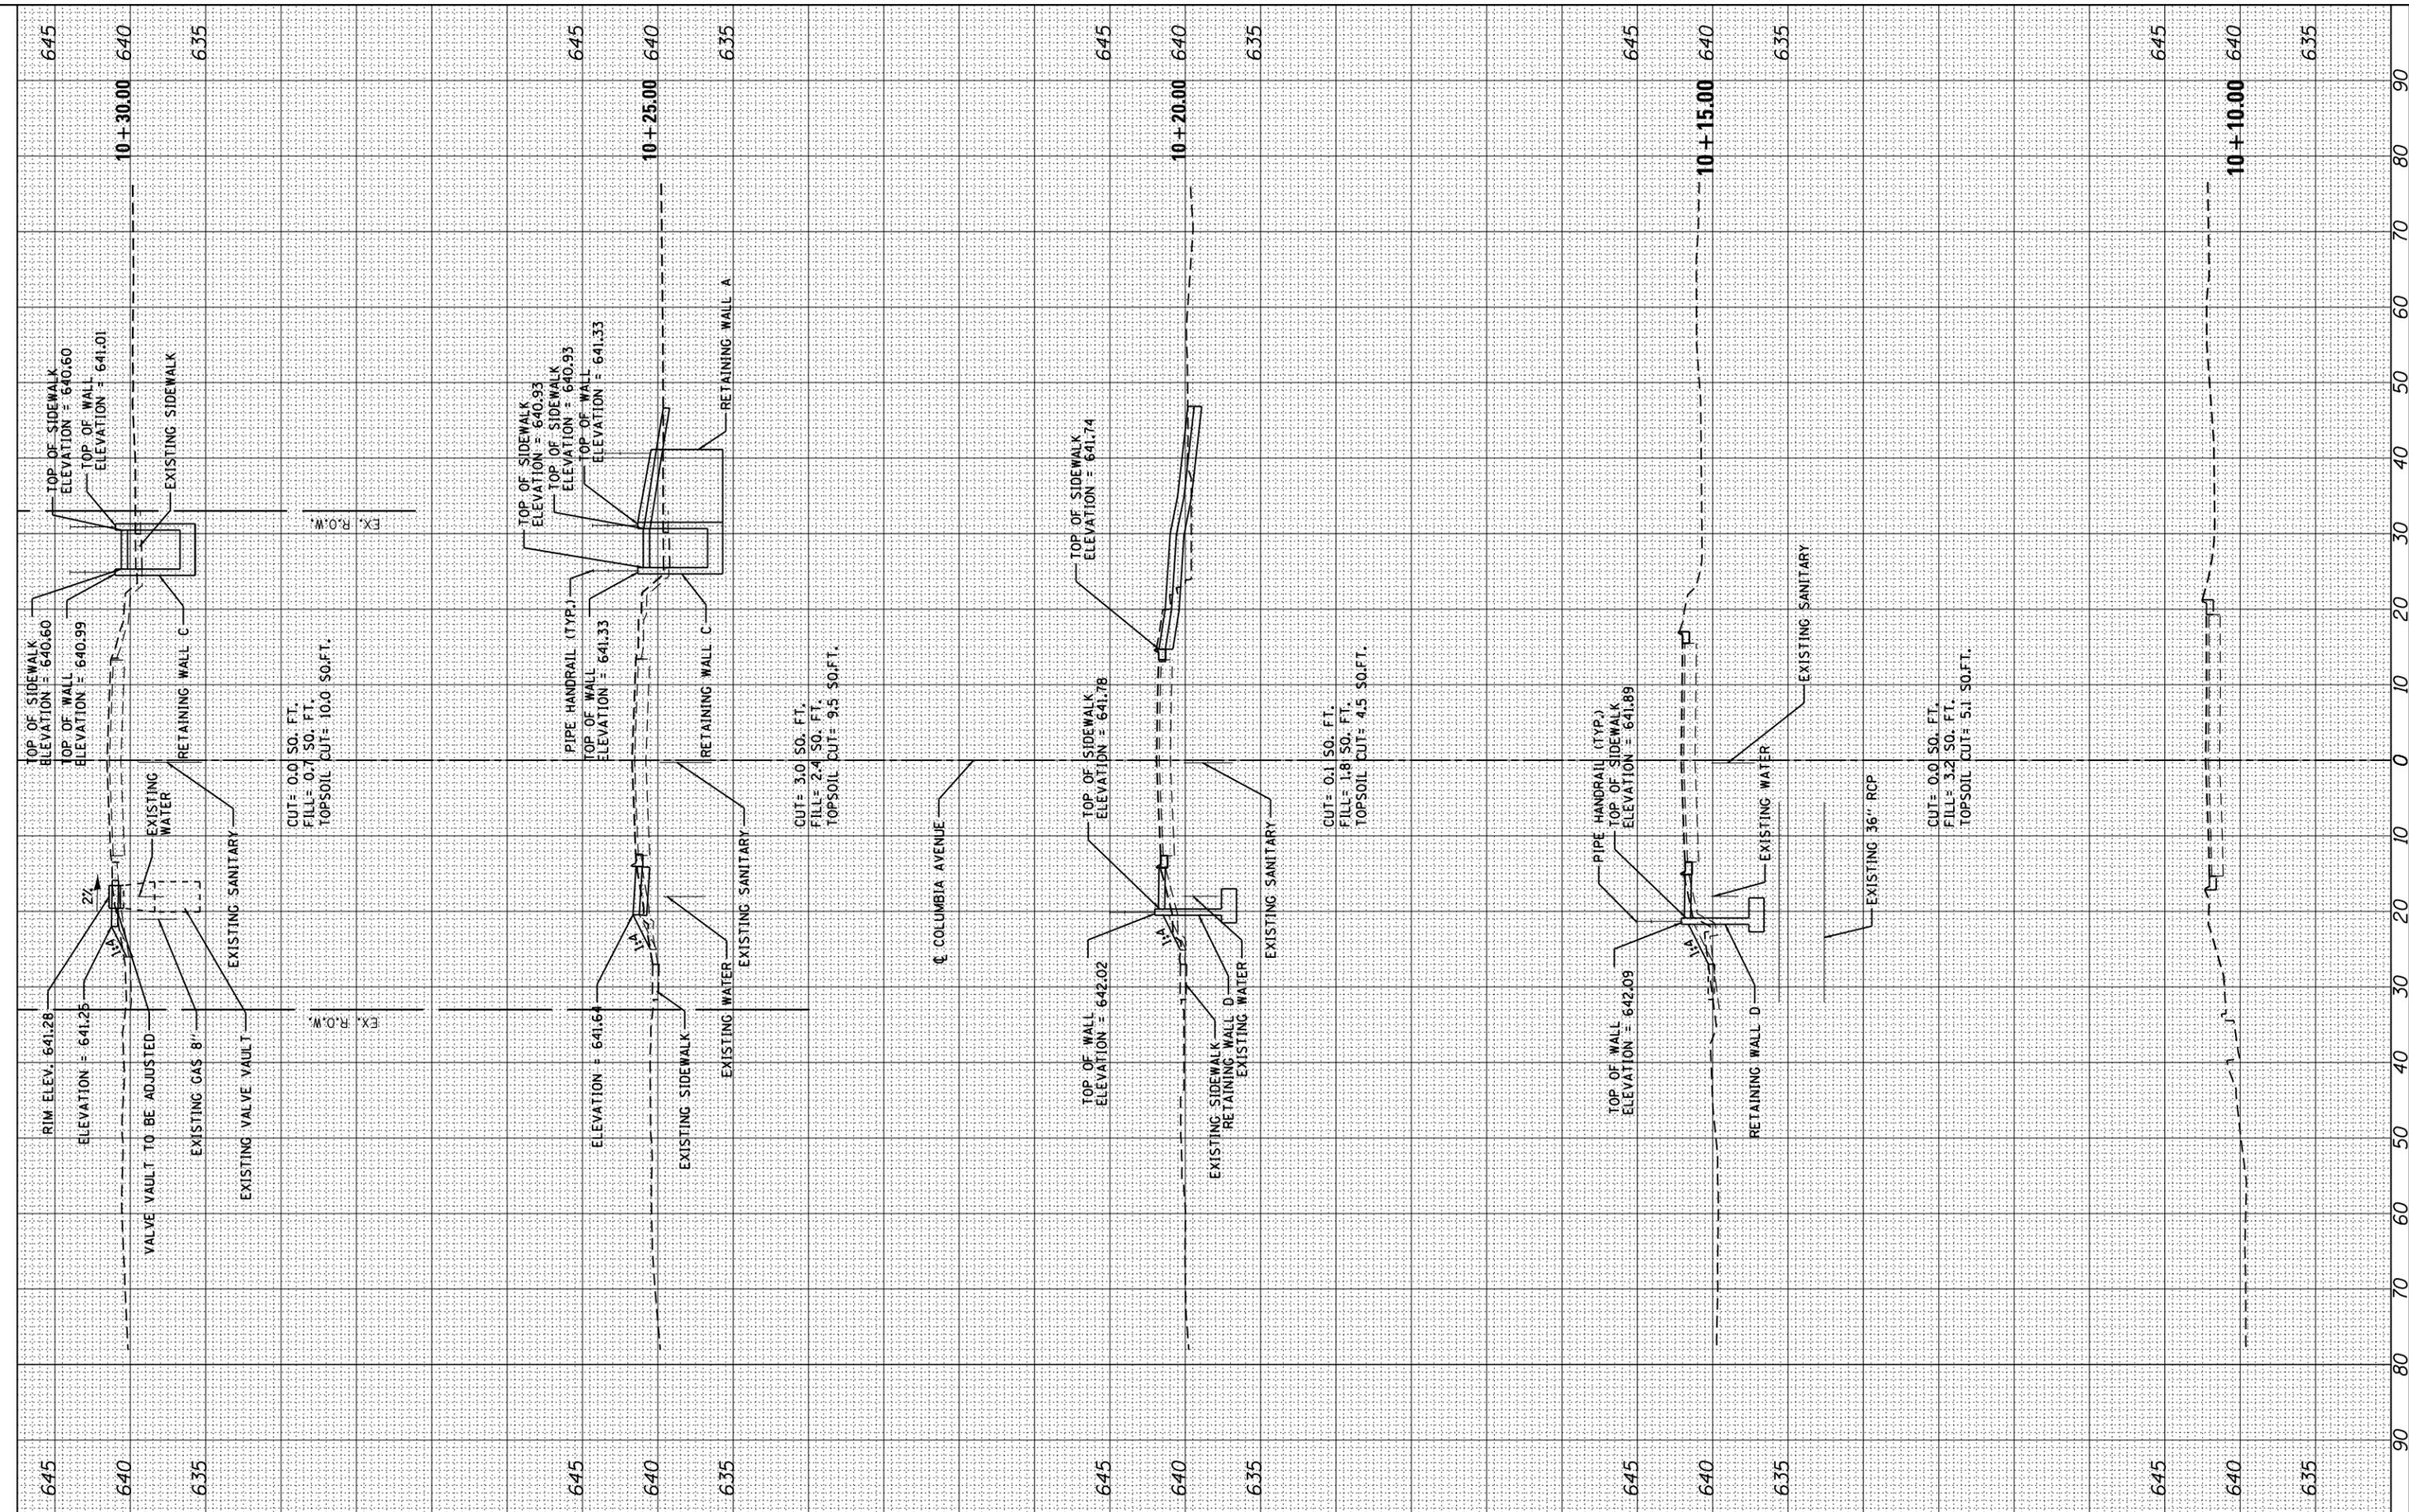
**WOLF ROAD - CROSS SECTION  
WOLF ROAD AT WELLER'S DITCH**

F.A.U. RTE.	SECTION	COUNTY	TOTAL SHEETS	SHEET NO.
2691	3434.1-BR(13)	COOK	58	54
CONTRACT NO. 60W53				
ILLINOIS FED. AID PROJECT				

FINAL SURVEY	SURVEYED	BY	DATE
NOTE BOOK	PLOTTED		
NO.	TEMPLATE		
	AREAS CHECKED		

ORIGINAL SURVEY	SURVEYED	BY	DATE
NOTE BOOK	PLOTTED		
NO.	TEMPLATE		
	AREAS CHECKED		

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USER NAME = jent
DESIGNED - TGM
DRAWN - CC
CHECKED - JMT
DATE - 3/12/2018

REVISED -
REVISED -
REVISED -
REVISED -

STATE OF ILLINOIS  
DEPARTMENT OF TRANSPORTATION

COLUMBIA AVENUE CROSS SECTIONS  
WOLF ROAD AT WELLER'S DITCH


SCALE: SHEET OF SHEETS STA. 10+10.00 TO STA. 10+30.00

F.A.U. RTE.	SECTION	COUNTY	TOTAL SHEETS	SHEET NO.
2691	3434.1-BR(13)	COOK	58	55
CONTRACT NO. 60W53				
ILLINOIS FED. AID PROJECT				

FINAL SURVEY	SURVEYED	BY	DATE
NOTE BOOK	PLOTTED		
NO.	TEMPLATE		
	AREAS CHECKED		
	AREAS CHECKED		

ORIGINAL SURVEY	SURVEYED	BY	DATE
NOTE BOOK	PLOTTED		
NO.	TEMPLATE		
	AREAS CHECKED		
	AREAS CHECKED		

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USER NAME	= jent
DESIGNED	- TGM
DRAWN	- CC
CHECKED	- JMT
DATE	- 3/12/2018

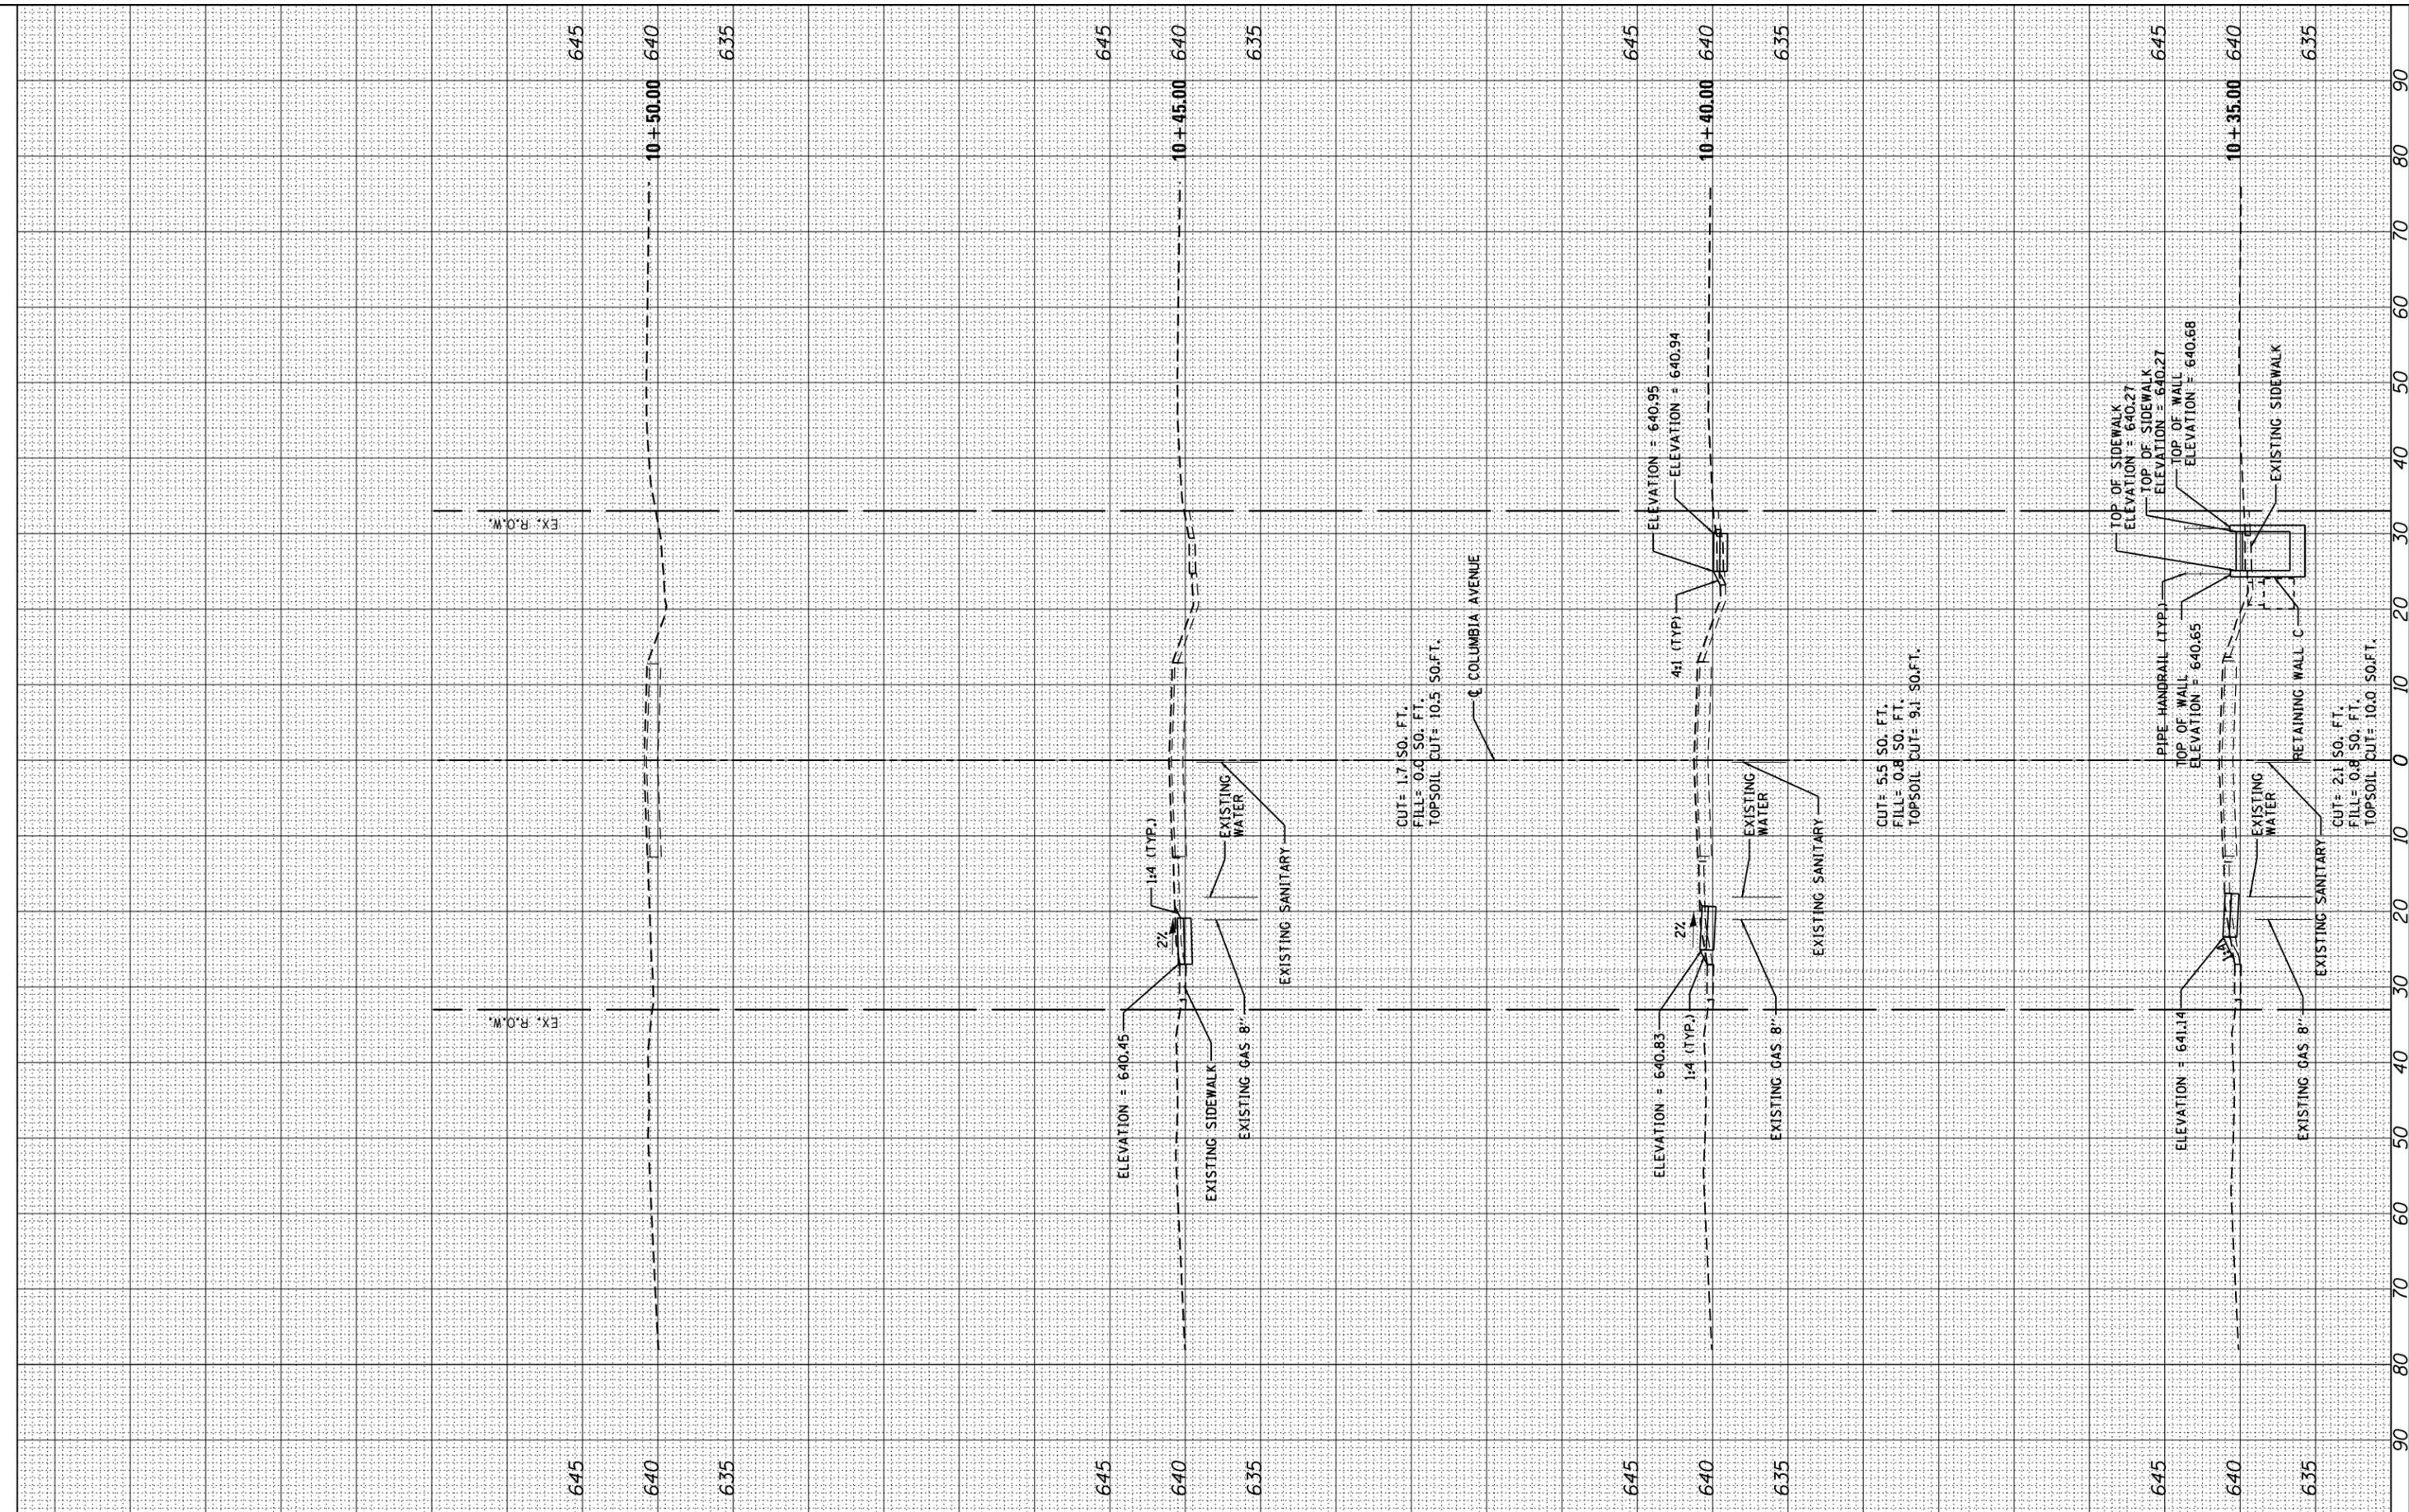REVISED	-

**STATE OF ILLINOIS  
DEPARTMENT OF TRANSPORTATION**


<b>COLUMBIA AVENUE CROSS SECTIONS WOLF ROAD AT WELLER'S DITCH</b>			
SCALE:	SHEET	OF	SHEETS
			STA. 10+35.00 TO STA. 10+50.00

F.A.U. RTE.	SECTION	COUNTY	TOTAL SHEETS	SHEET NO.
2691	3434.1-BR(13)	COOK	58	56
CONTRACT NO. 60W53				
ILLINOIS FED. AID PROJECT				

FINAL SURVEY	SURVEYED	BY	DATE
NOTE BOOK	PLOTTED		
NO.	TEMPLATE		
	AREAS CHECKED		

ORIGINAL SURVEY	SURVEYED	BY	DATE
NOTE BOOK	PLOTTED		
NO.	TEMPLATE		
	AREAS CHECKED		

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(WEST R.O.W. WOLF ROAD) 6.30

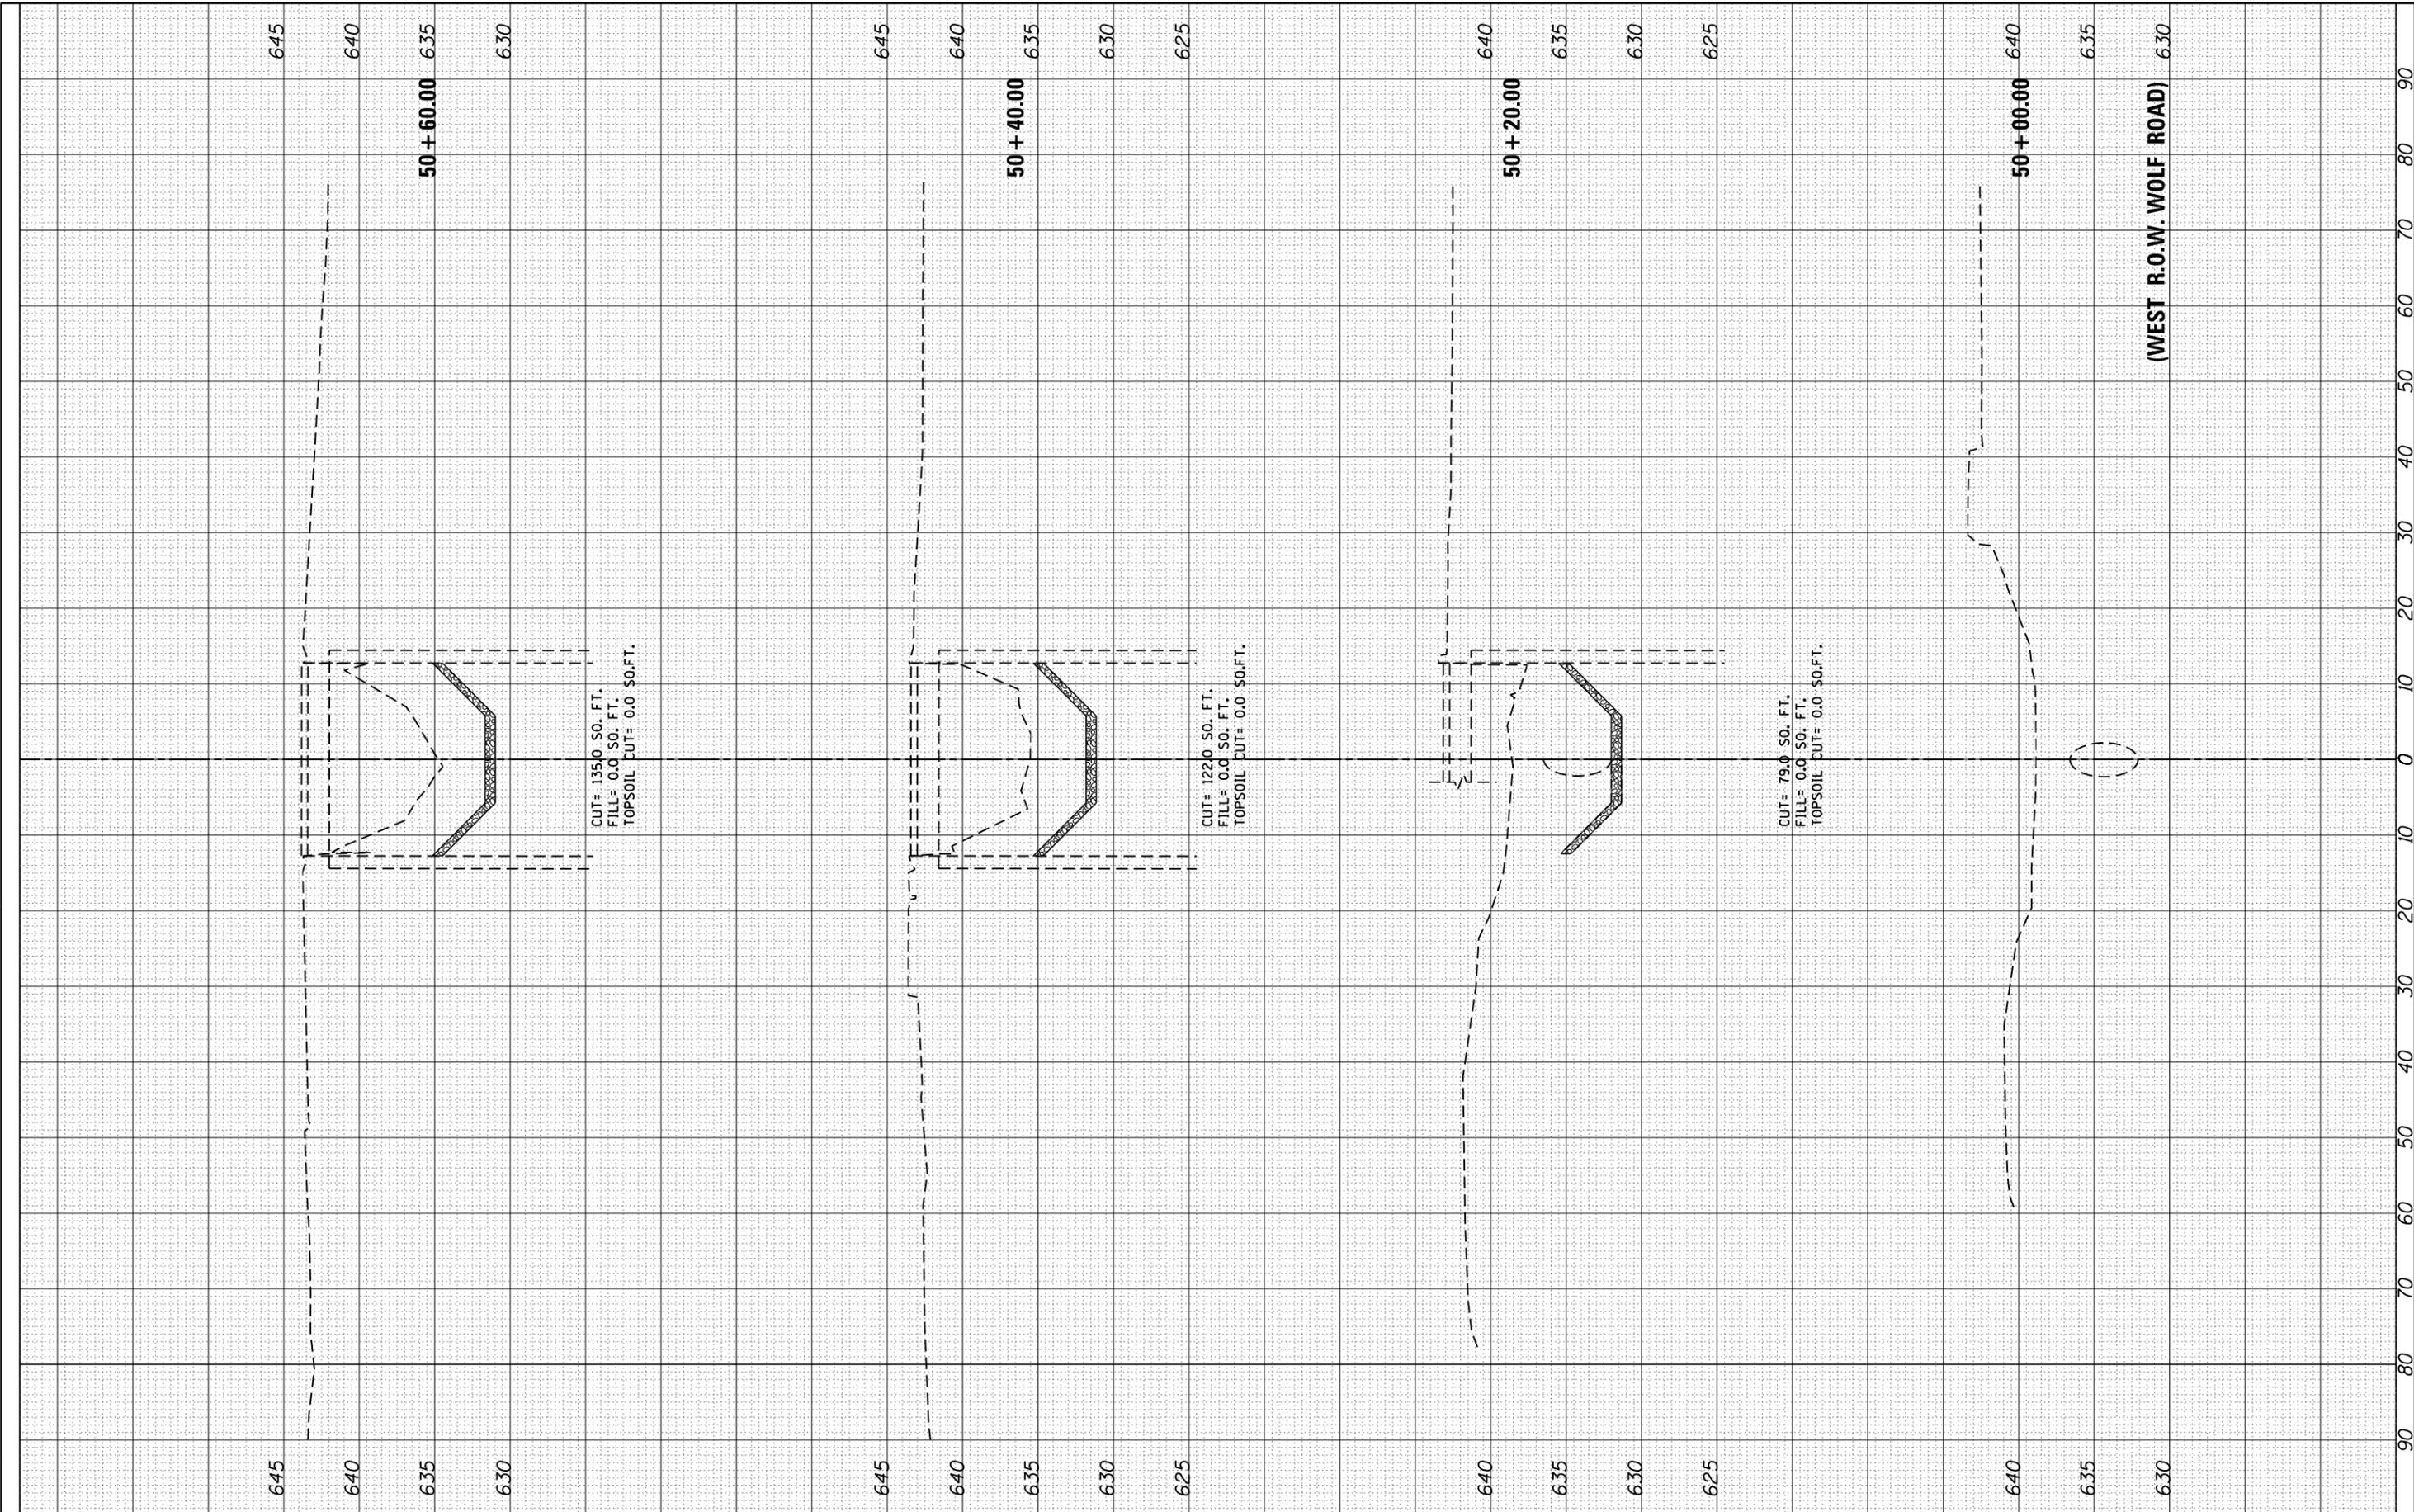STATE OF ILLINOIS  
DEPARTMENT OF TRANSPORTATION

WELLER'S DITCH CROSS SECTIONS  
WOLF ROAD AT WELLER'S DITCH

USER NAME = jent	DESIGNED - TGM	REVISED -
PLOT SCALE = 20.000' / in.	DRAWN - CC	REVISED -
PLOT DATE = 3/12/2018	CHECKED - JMT	REVISED -
	DATE - 3/12/2018	REVISED -

SCALE: SHEET OF SHEETS STA. 50+00.00 TO STA. 50+60.00


F.A.U. RTE.	SECTION	COUNTY	TOTAL SHEETS	SHEET NO.
2691	3434.1-BR(13)	COOK	58	57
CONTRACT NO. 60W53				
ILLINOIS FED. AID PROJECT				



FINAL SURVEY NO.	SURVEYED PLOTTED AREAS CHECKED	BY	DATE
	NOTE BOOK AREAS CHECKED		

ORIGINAL SURVEY NO.	SURVEYED PLOTTED AREAS CHECKED	BY	DATE
	NOTE BOOK AREAS CHECKED		

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USER NAME = jent	DESIGNED - TGM	REVISED -
PLOT SCALE = 20.000' / in.	DRAWN - CC	REVISED -
PLOT DATE = 3/12/2018	CHECKED - JMT	REVISED -
	DATE - 3/12/2018	REVISED -

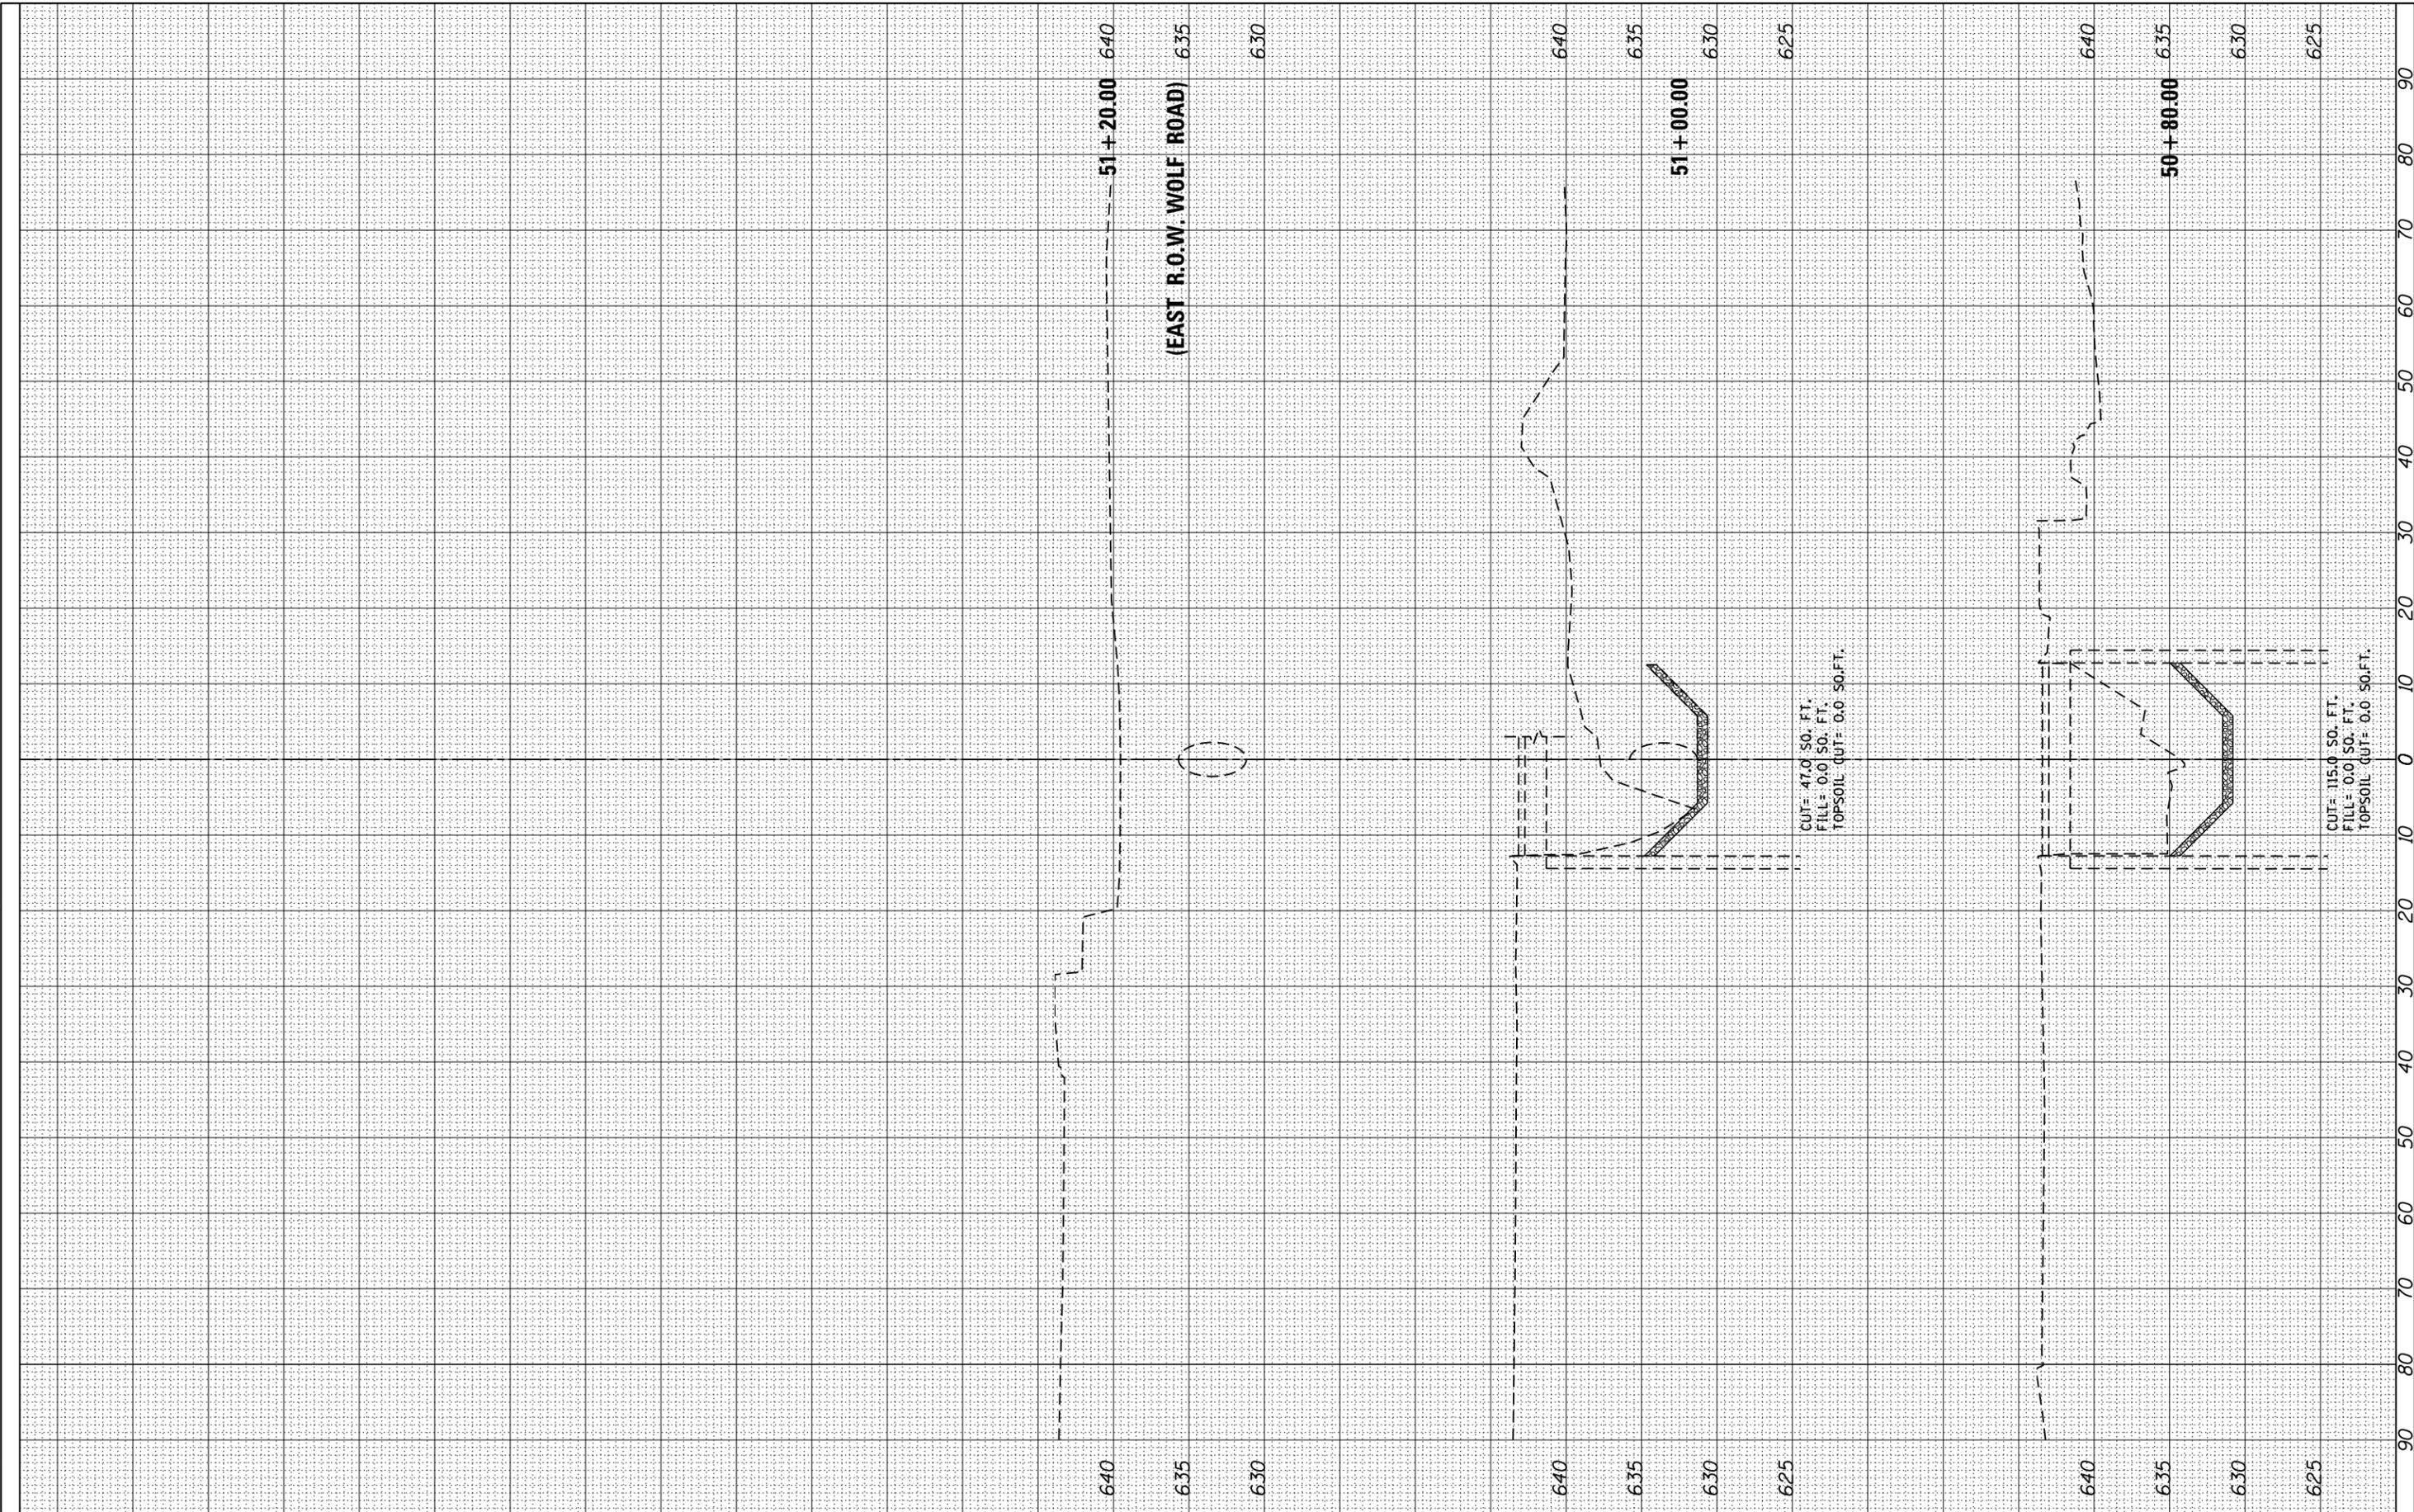DESIGNED - TGM	REVISED -
DRAWN - CC	REVISED -
CHECKED - JMT	REVISED -
DATE - 3/12/2018	REVISED -

STATE OF ILLINOIS  
DEPARTMENT OF TRANSPORTATION

WELLER'S DITCH CROSS SECTIONS  
WOLF ROAD AT WELLER'S DITCH

SCALE: SHEET OF SHEETS STA. 50+80.00 TO STA. 51+20.00

F.A.U. RTE.	SECTION	COUNTY	TOTAL SHEETS	SHEET NO.
2691	3434.1-BR(13)	COOK	58	58
CONTRACT NO. 60W53				
ILLINOIS FED. AID PROJECT				